INDEX OF SHEETS

GENERAL PLANS

- COVER SHEET
- EXISTING CONDITIONS
- DEMOLITION PLAN
- GRADING & EROSION CONTROL
- OVERALL SITE & DIMENSION
- SPOT ELEVATIONS
- UTILIY PLAN
- SITE LAT. LONG. & LEASE INFORMATION
- DETAILS SHEET 9

APPENDIX

LIGHTING & PHOTOMETRIC PLAN



MIDWEST AVIONICS HANGAR LEE'S SUMMIT AIRPORT FINAL DEVELOPMENT PLAN CITY OF LEE'S SUMMIT, JACKSON COUNTY, MISSOURI



City of Lee's Summit Public Works 220 SE Green Lee's Summit, MO 64063 816-969-1800

City of Lee's Summit Water and Sewer 1200 SE Hamblen Road Lee's Summit, MO 64081 816-969-1900

Spire

(Administrative Offices) 3025 S.E. Clover Drive Lee's Summit, MO 64082 816-537-4681

UTILITIES

Evergy 401 SE Bailey Road Lee's Summit, MO. 64081 816-347-4320

AT&T Rick Bryan 500 E. 8th Street Kansas City, MO 64106 913-727-9809

Comcast Cable New Construction Hotline 866-771-2281

Missouri One-Call 1-800-344-7483



Know what's below. Call before you dig.

PROJECT BENCHMARK:

#1 Top of Sanitary Manhole lid at northwest corner of site. N: 1018226.45 E: 2823698.81 TOP ELEV. = 993.94

NOT TO SCALE

RELEASED FOR CONSTRUCTION As Noted on Plan Review

Development Services Department Lee's Summit, Missouri 05/27/2025

			DATE	REVISION	NO.	BΥ	CK/APP
			55/2/25	55/2/25 Revised per City Comment Letter dated 4/29/25	~	ZW RKS	SKS
		RICH	55/2/25	Revised for waterline size change	5	ΜZ	RKS
		OF M HARD I FERRE					
I AVIUNICS HANGAK							
MMIT, JACKSON COUNTY, MISSOURI	1533 Locust Street, Kansas City, Missouri 64108	R. KEVIN STERRETT, MO E-26440	IF THIS IS NOT UNAUTHORIZED	THIS IS NOT A BLUE INK SEAL AND THE SIGNATURE IN BLUE INK, THE PLAN IS A COPY AND MAY CONTAIN NAUTHORIZED ALTERATIONS. THE CERTIFICATION CONTAINED ON THIS DOCUMENT SHALL NOT APPLY TO ANY COPIES	S A COPY AND M SHALL NOT APPL	AY CONTAIL Y TO ANY	1 COPIES
	CORPORATE LICENSE No. E201000573 (MO.) / E-1736 (KS.) / LS 2019005467	May 2, 2025					

CO

MIDWEST A

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9

X-REF NO.

24.092 Base

DRAWING NO.

24.092 DATE

May 2, 2025

JOB NO.

24.092


SHEET OF

GENERAL NOTES:


- 1. The underground utilities shown herein have been plotted from available information and do not necessarily reflect the actual existence, or nonexistence, size, type, number, or locations of these or other utilities. The contractor shall be responsible for verifying the actual locations of all underground utilities, shown or not shown, and said utilities shall be located in the field prior to any grading, excavation, or construction of improvements. These provisions shall in now way absolve any party from complying with the "UNDERGROUND FACILITY SAFETY AND DAMAGE PREVENTION ACT", Chapter 319, RSMO.
- 2. Gas, Water, and other Utilities shall not conflict with the depth or horizontal location of existing and proposed sanitary and storm sewers, including building laterals.
- Prior to submittal of construction bids, the Contractor shall be required to visit the site to verify existing
- conditions and proposed improvements. The Contractor shall be responsible for notification and coordination with all Utility Companies.
 The Contractor shall notify the Engineer immediately of any discrepancies in the plans "PRIOR" to
- installation or fabrication of structures. All sidewalk shall be ADA compliant.
- 7. There are no oil or gas wells located on the subject property as of September 1, 2022 as shown by the Missouri Geological Survey GEOSTRAT (Geosciences Technical Resource Assessment Tool).

OWNER **MIDWEST AVIONICS** 2525 NE Douglas Street Lee's Summit, MO 64064 (620) 719-0673 Contact - Levi Self


ENGINEER Hg CONSULT, INC. 1533 Locust Street Kansas City, MO 64086 (816) 703-7098 Contact - Kevin Sterrett

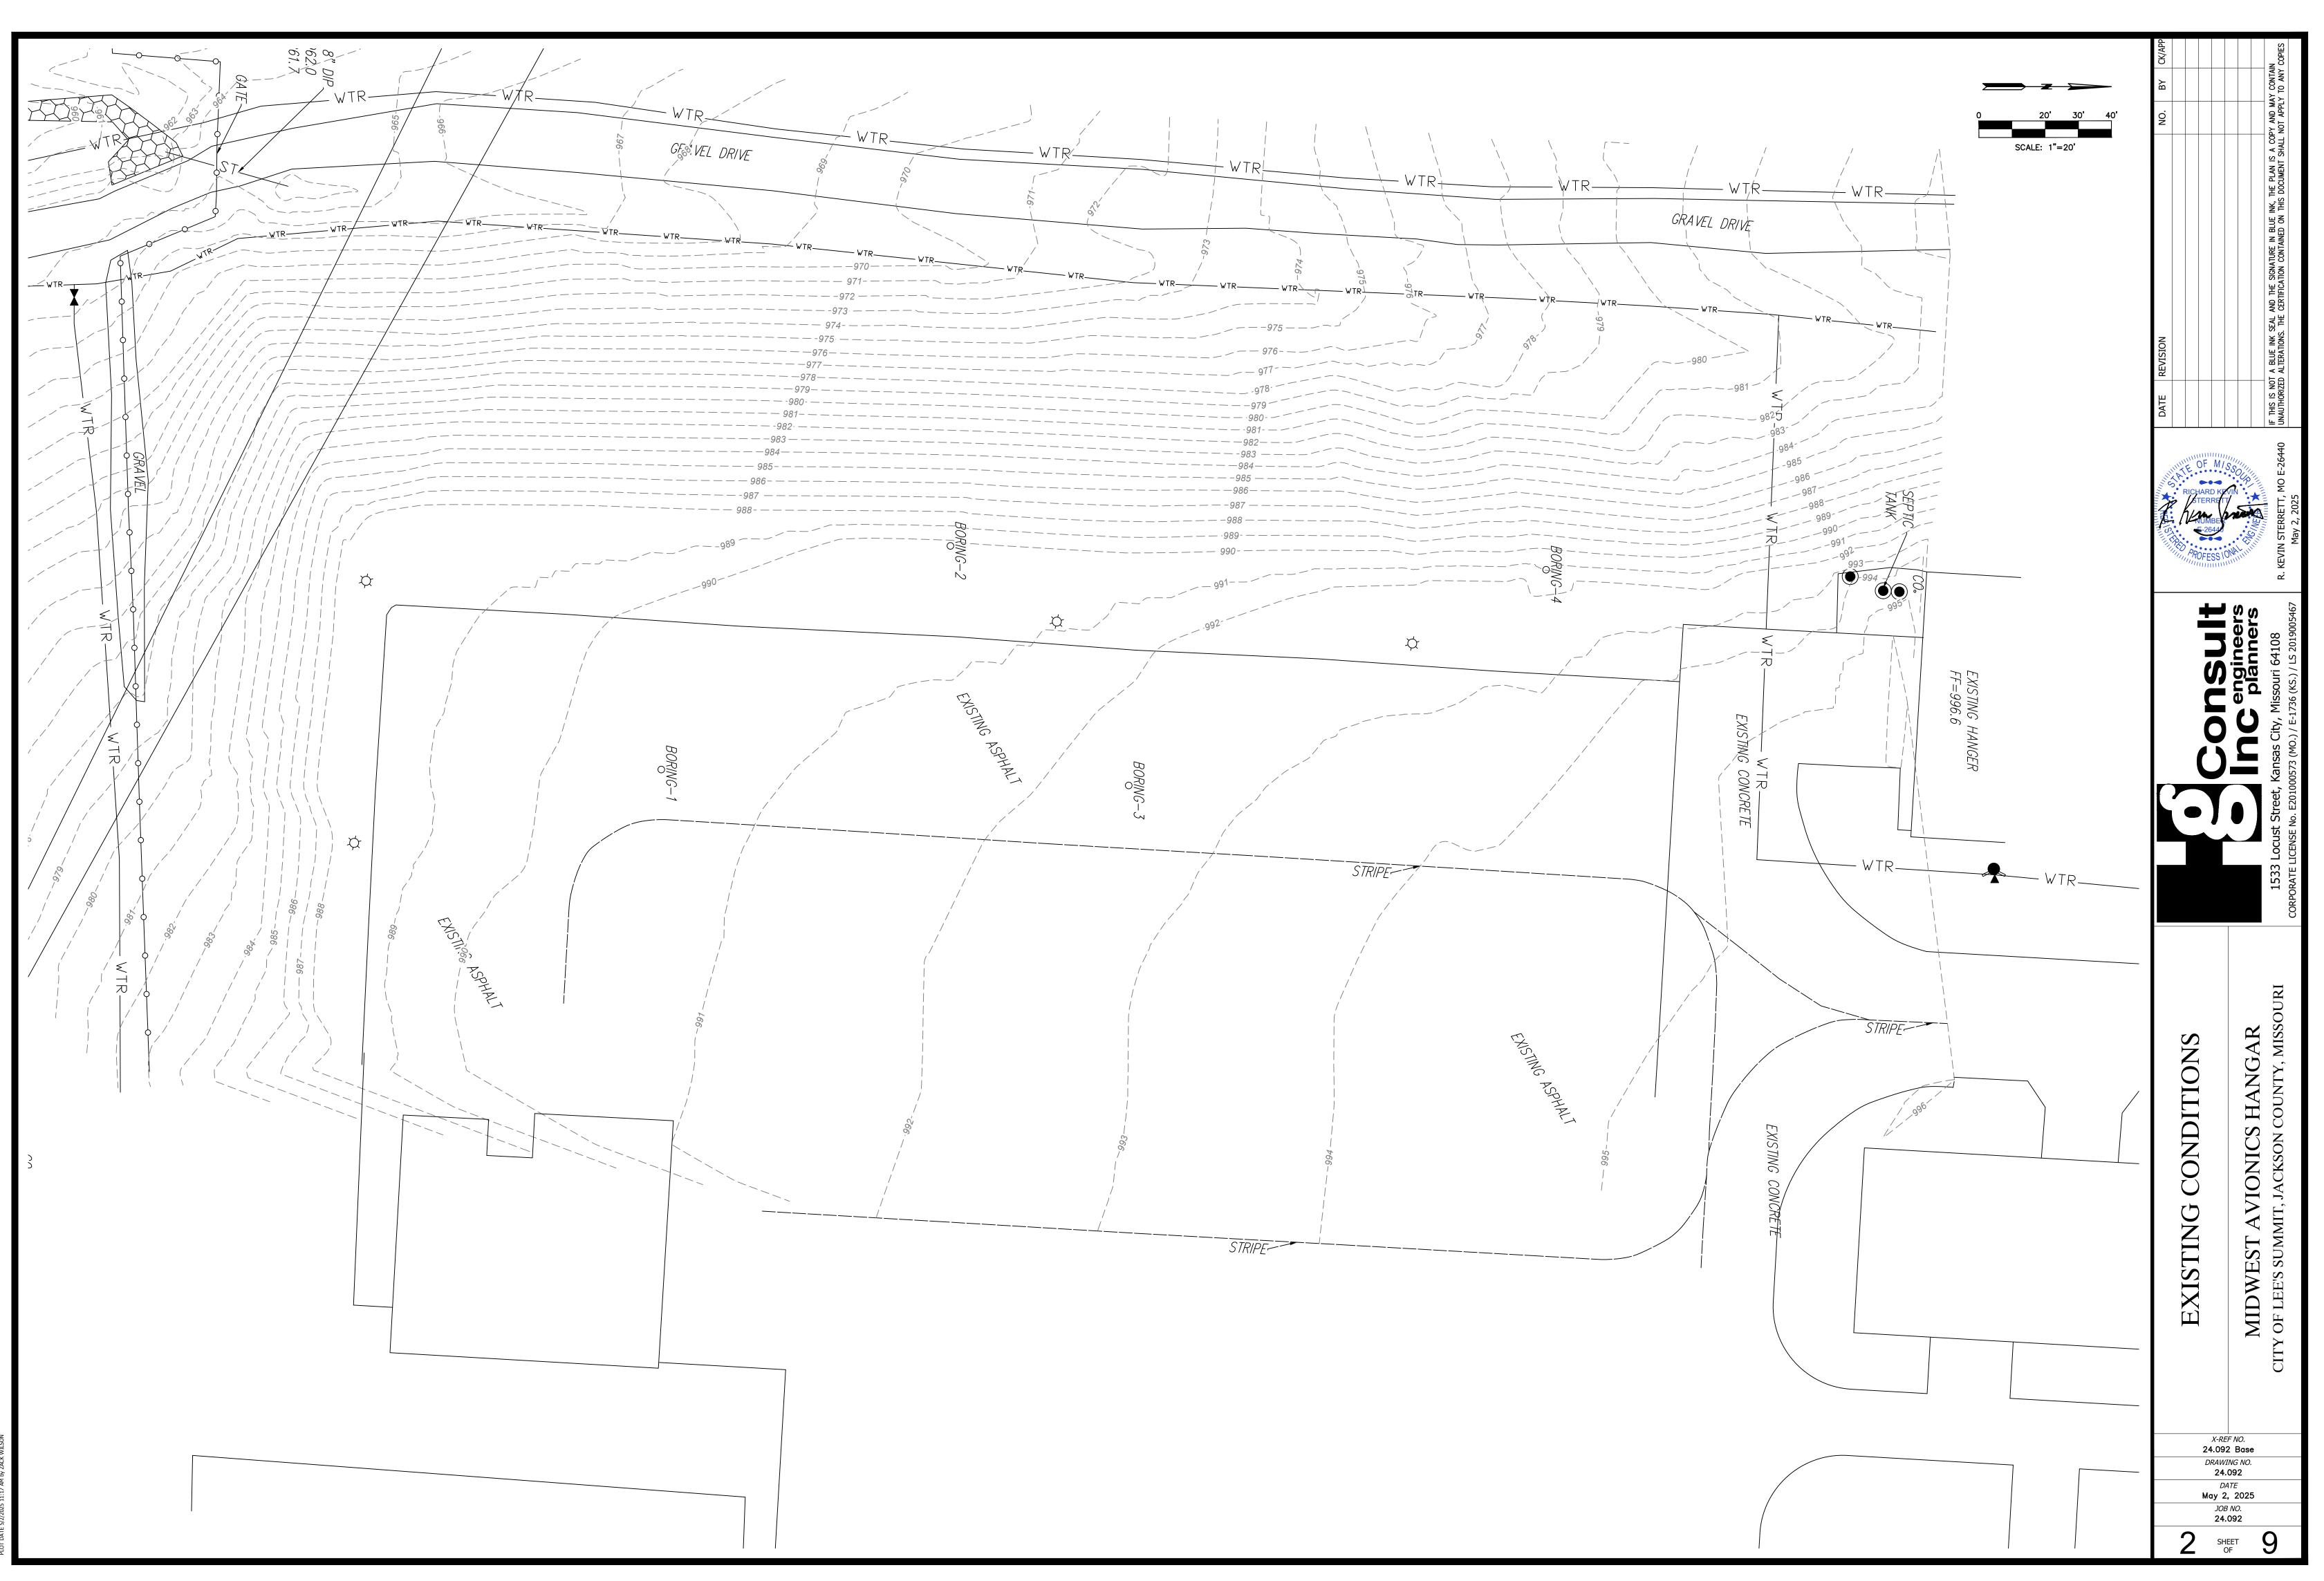


FILE LOCATION G:\SHARED DRIVES\HG PROJECTS (YR 2023-2024)\2024\24.092 LEE'S SUMMIT AIRPORT HANGER (KOEHN)\CIVIL\SHEET_FILES\24.092-EX.COND & DEMO P

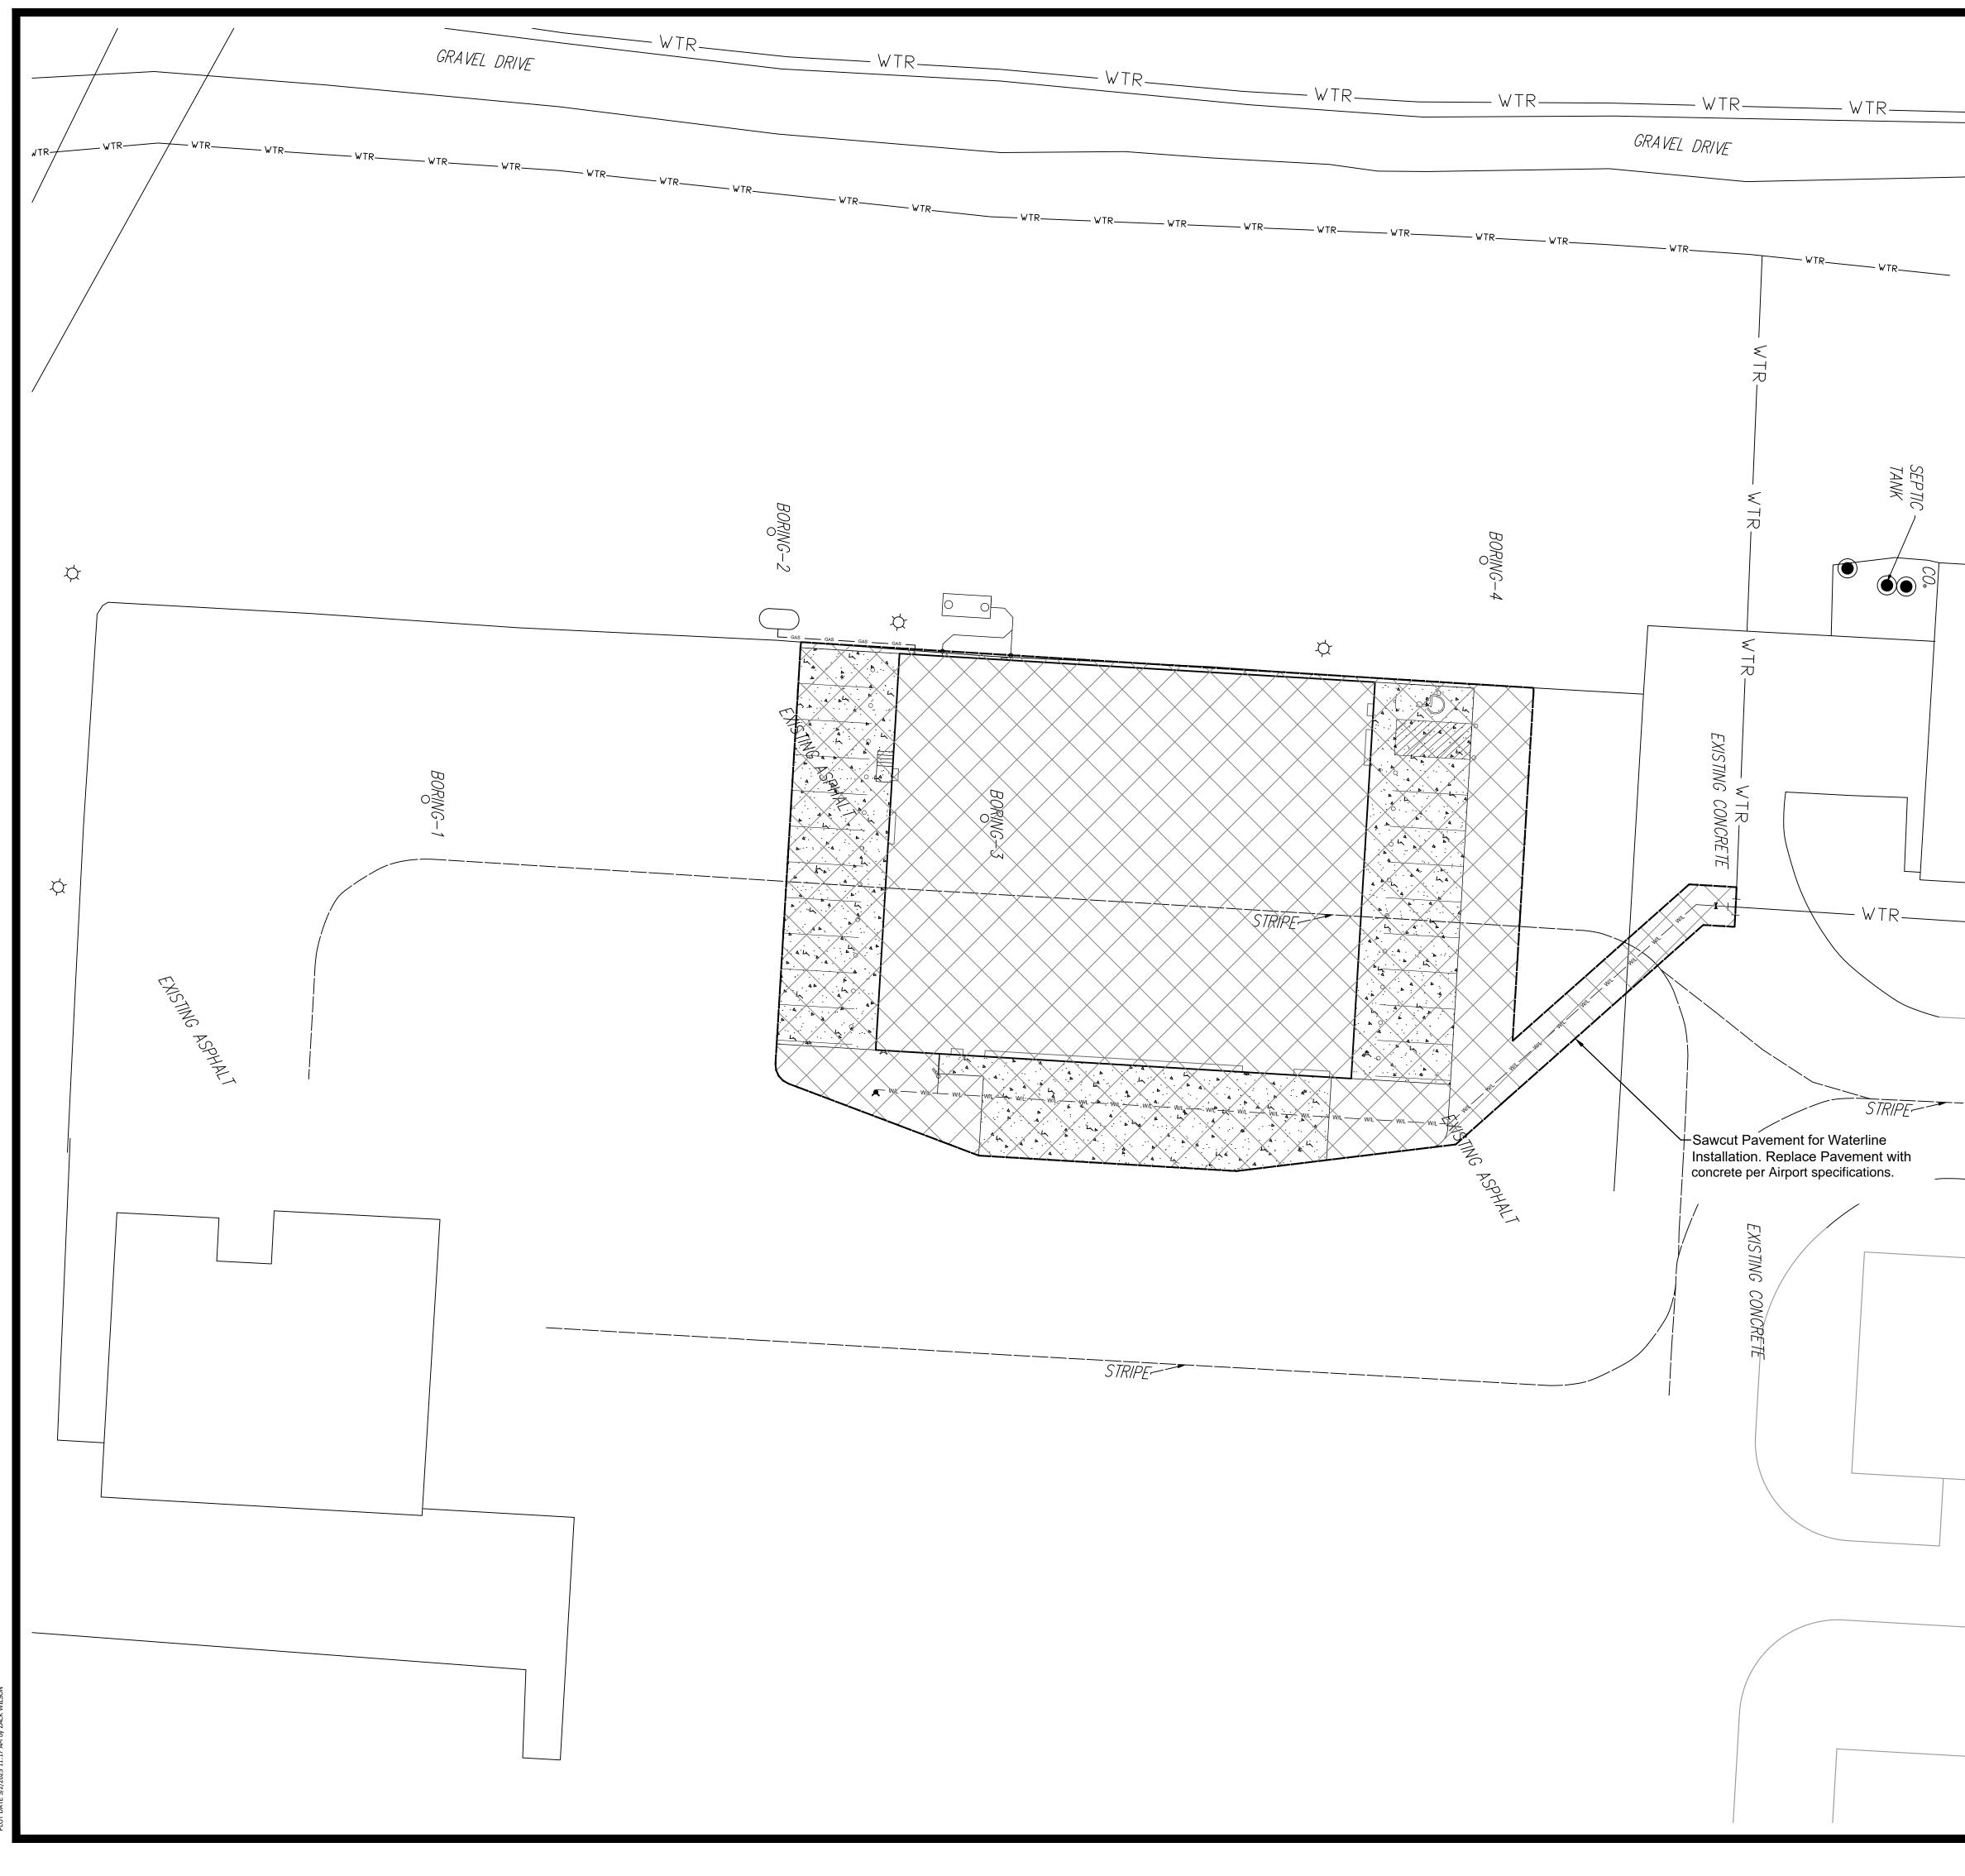

FILE LOCATION G:\SHARED DRIVES\HG PROJECTS (YR 2023-2024)\2024\24.092 LEE'S SUMMIT AIRPORT HANGER (KOEHN)\CIVIL\SHEET_FILES\24.092-EX.COND & DEN IN OT DATE 517300 51117 AM IN 2000 VIII COM

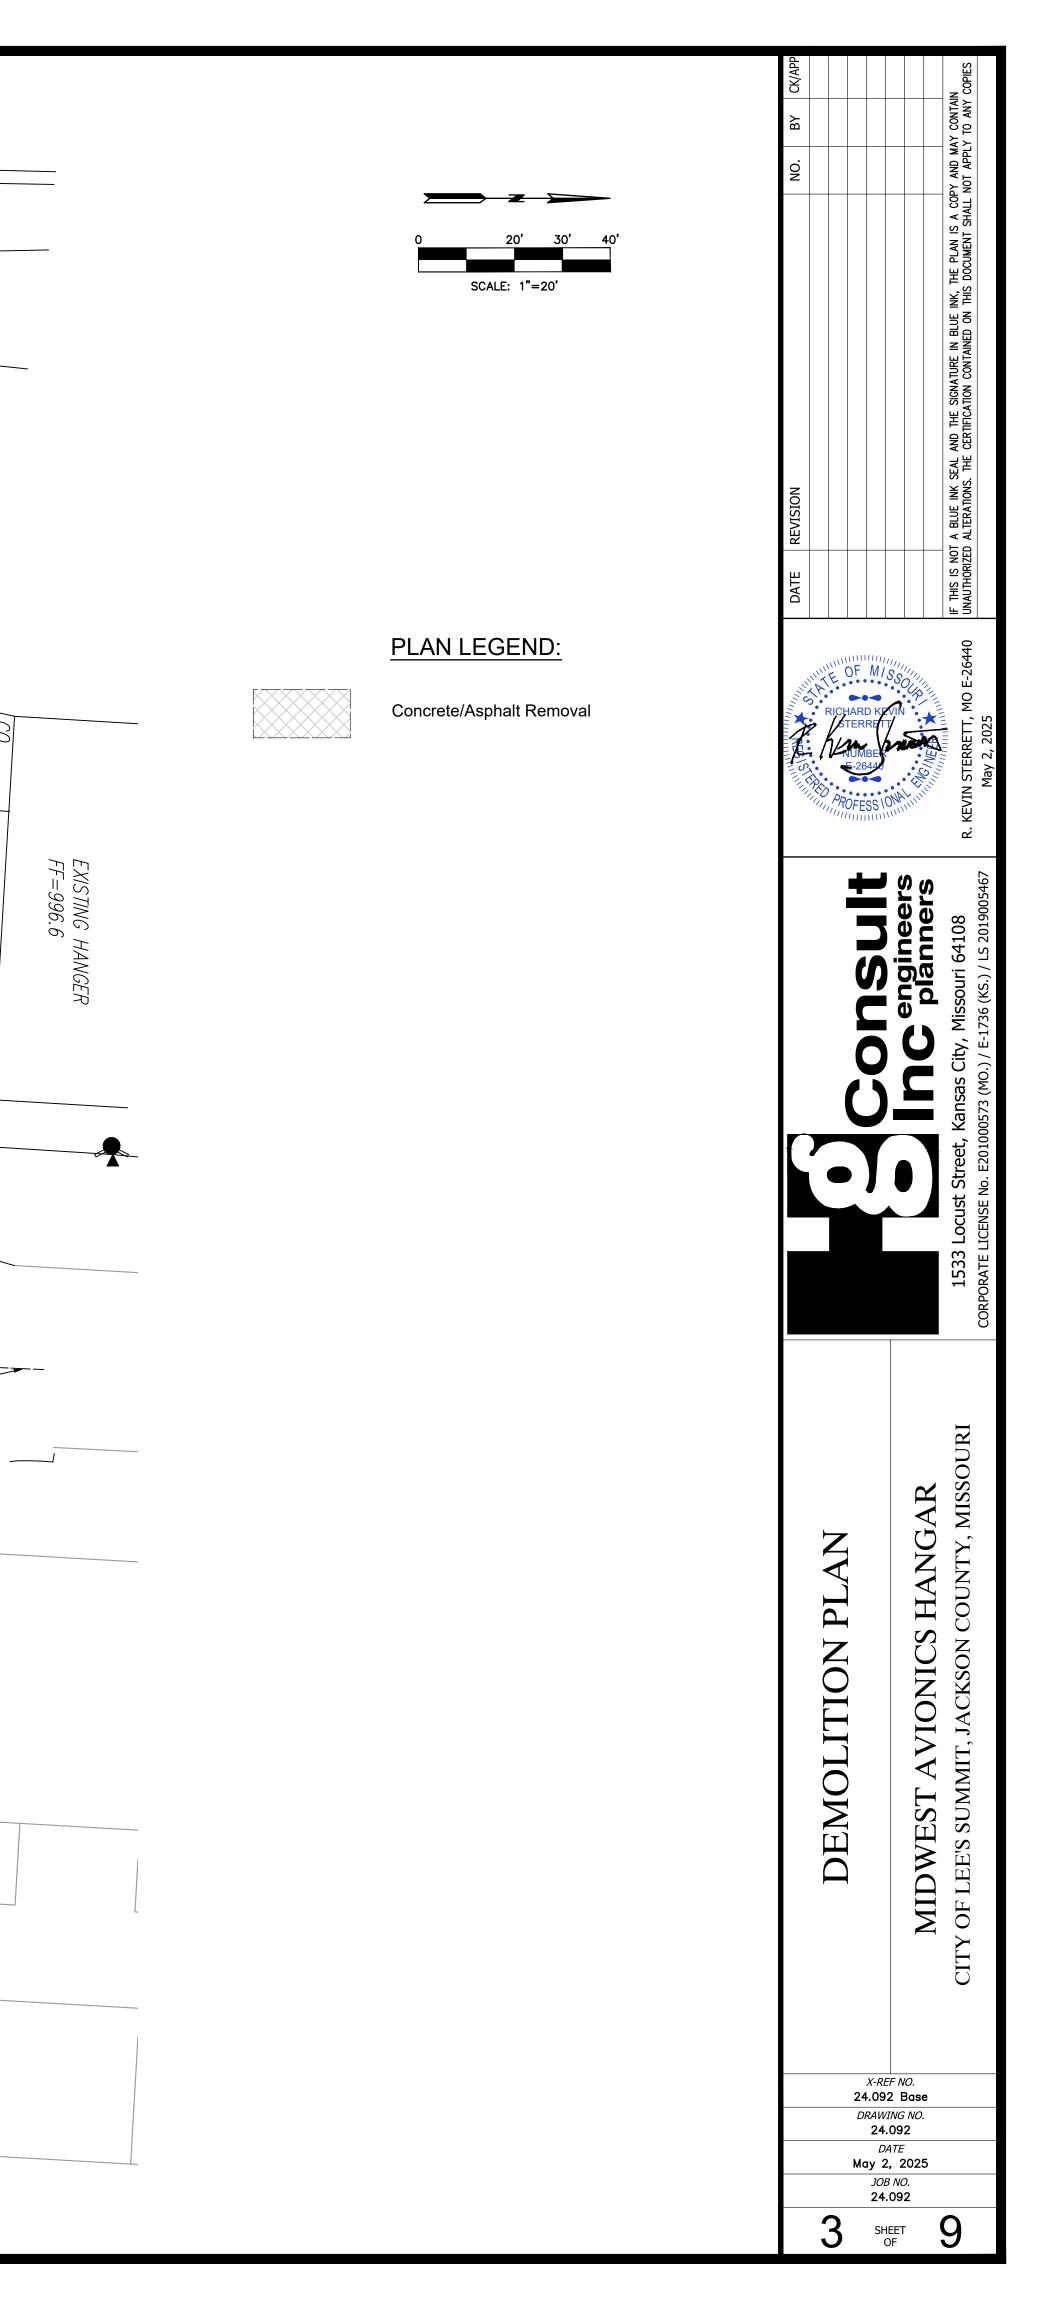

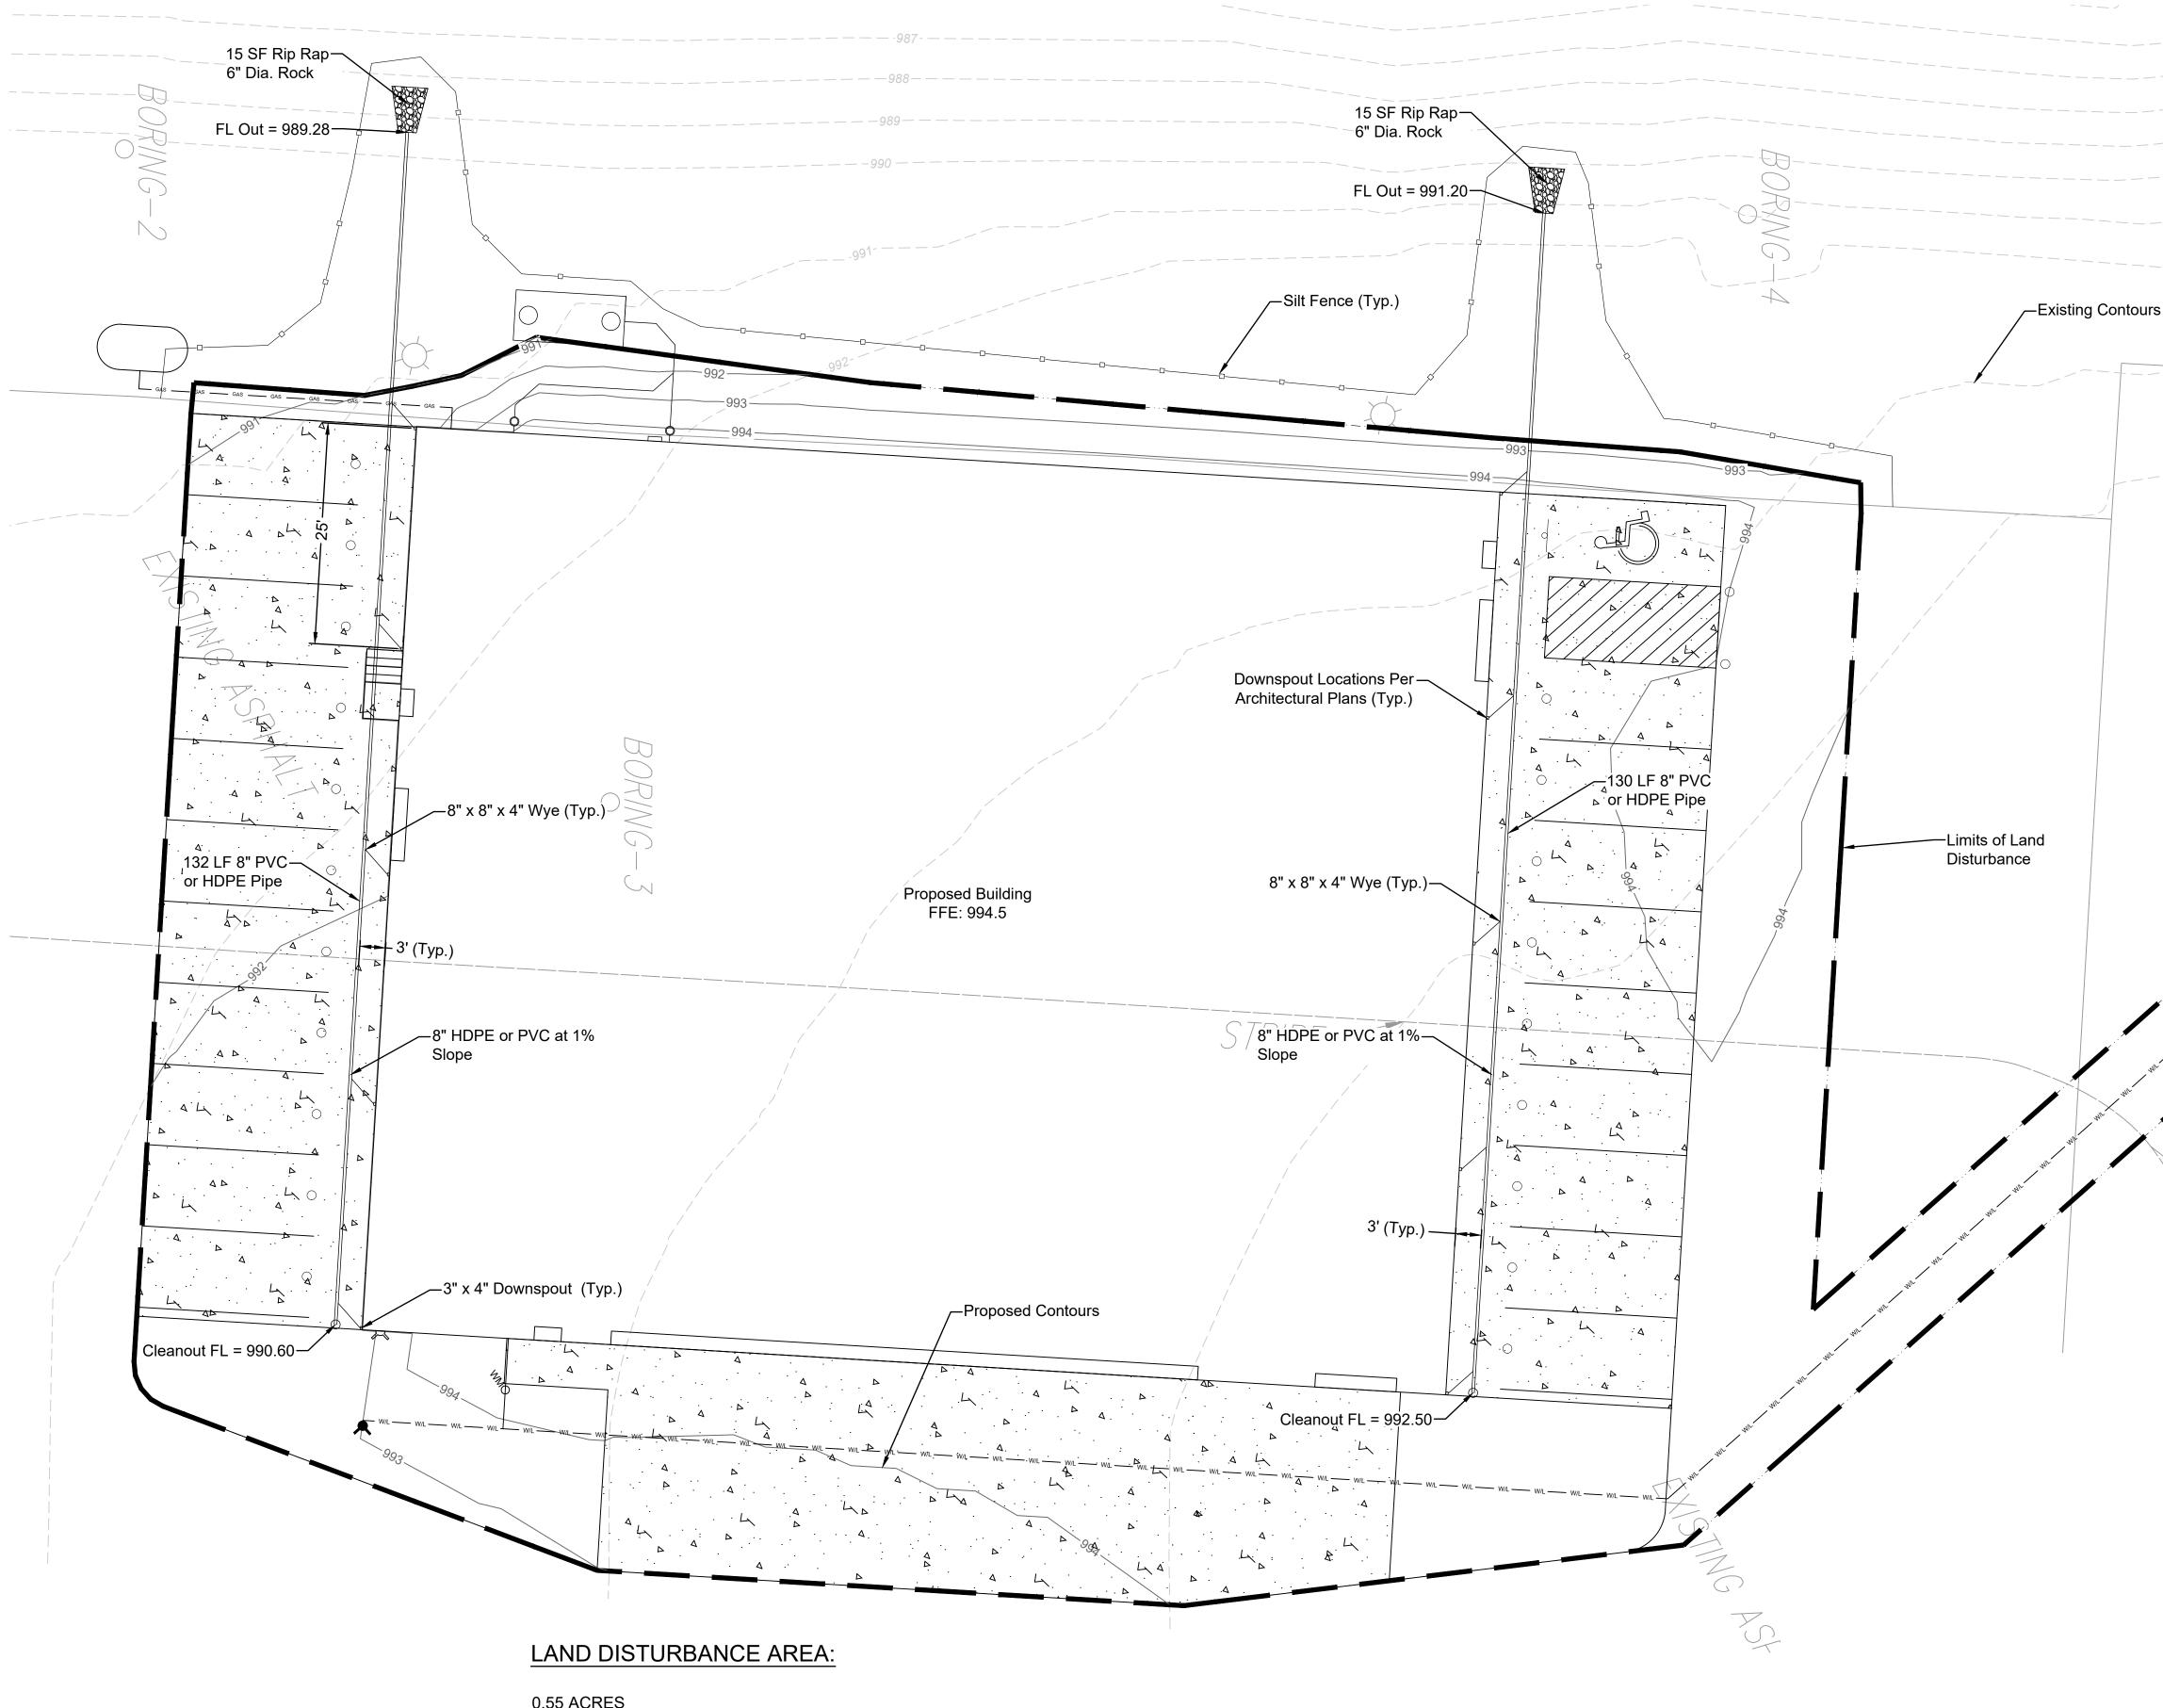

0.55 ACRES

EROSION CONTROL PHASING:

Phase 1: Install Perimeter Containment Measures (Silt Fence) Prior to Grading Activities and/or Construction Entrance

Phase 2: Install Additional Inlet & Outlet Protection on New Structures if applicable, Prior to Paving

Phase 3: Remove all ESC Measures Upon Revegetation of the Site

LEGEND

Silt Fence (APWA ESC-03)


Limits of Land Disturbance Line





1. Contractor to construct stormwater management facilities, specifically those features related to detention, prior to any land disturbance of the site and prior to the construction of any other site development work as not to effect downstream neighbors with undetained stormwater discharge.

SCALE: 1"=10'

- 2. The Developer shall be responsible for erosion control within the boundaries of this development. Erosion control shall be the responsibility of said Developer until all development work on site is complete, and all appropriate permits have been released and/or terminated. The Developer is responsible for seeing that all Development Contractors comply with the requirements of any and all land disturbance permits, grading permits and storm water discharge permits.
- 3. Erosion Control and Siltation Control methods shall be in place prior to commencement of any grading and/or excavation of the site. All erosion control measures shall remain in place until final grade and sod is completed by the Builder, and shall be maintained throughout the project until the acceptance of the work by the City.
- 4. No grading shall be steeper than 3H:1V. All areas graded should have the soil surface lightly roughened and loosened to a depth of 2 to 4 inches prior to seeding. Areas that have been graded and will not be stabilized immediately shall be roughened to reduce runoff velocity until seeding takes place.
- 5. Sediment Fences shall be inspected periodically and after every rain event for damage and for the amount of sediment which has accumulated. Removal of sediment will be required when it reaches one-third (1/3) the height of the sediment fence. Sediment fences to be repaired or replaced as necessary.
- 6. Inspect and repair the collection system (i.e. sediment traps, catch basins, piping, swales, riprap, etc.) after rain events to maintain proper function. 7. After every significant runoff producing rainfall event of 1/2" or greater and at least
- once a week: • Inspect the detention basin/sediment trap system for sediment accumulation,
- erosion, trash accumulation, vegetated cover, and general condition. • Check and clear the outfall device of any obstructions.
- 8. Parking on non-surfaced areas is prohibited in order to eliminate the condition whereby mud and debris from construction and employee vehicles is tracked onto existing pavement. The Contractor shall keep the existing roadways free of mud, rock and debris at all times. The site shall have a temporary construction access installed to prevent mud and debris from being tracked onto the public street. The contractor shall inspect, repair, and add stone to the construction entrance when it becomes saturated with mud to insure it functions as it was intended.
- 9. Permanently stabilize all graded areas immediately after final grading is complete on each area in the Grading Plan. If clearing and/or grading operations are suspended for a period of thirty (30) days or longer, temporary stabilization measures are required. These measures may include seeding, periodic wetting, mulching or other suitable measures.

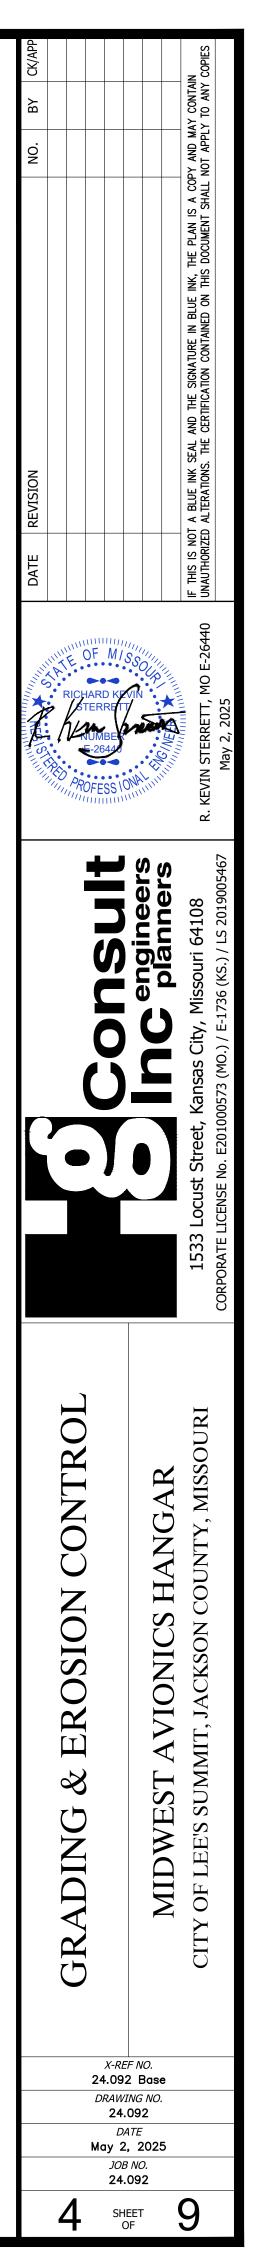

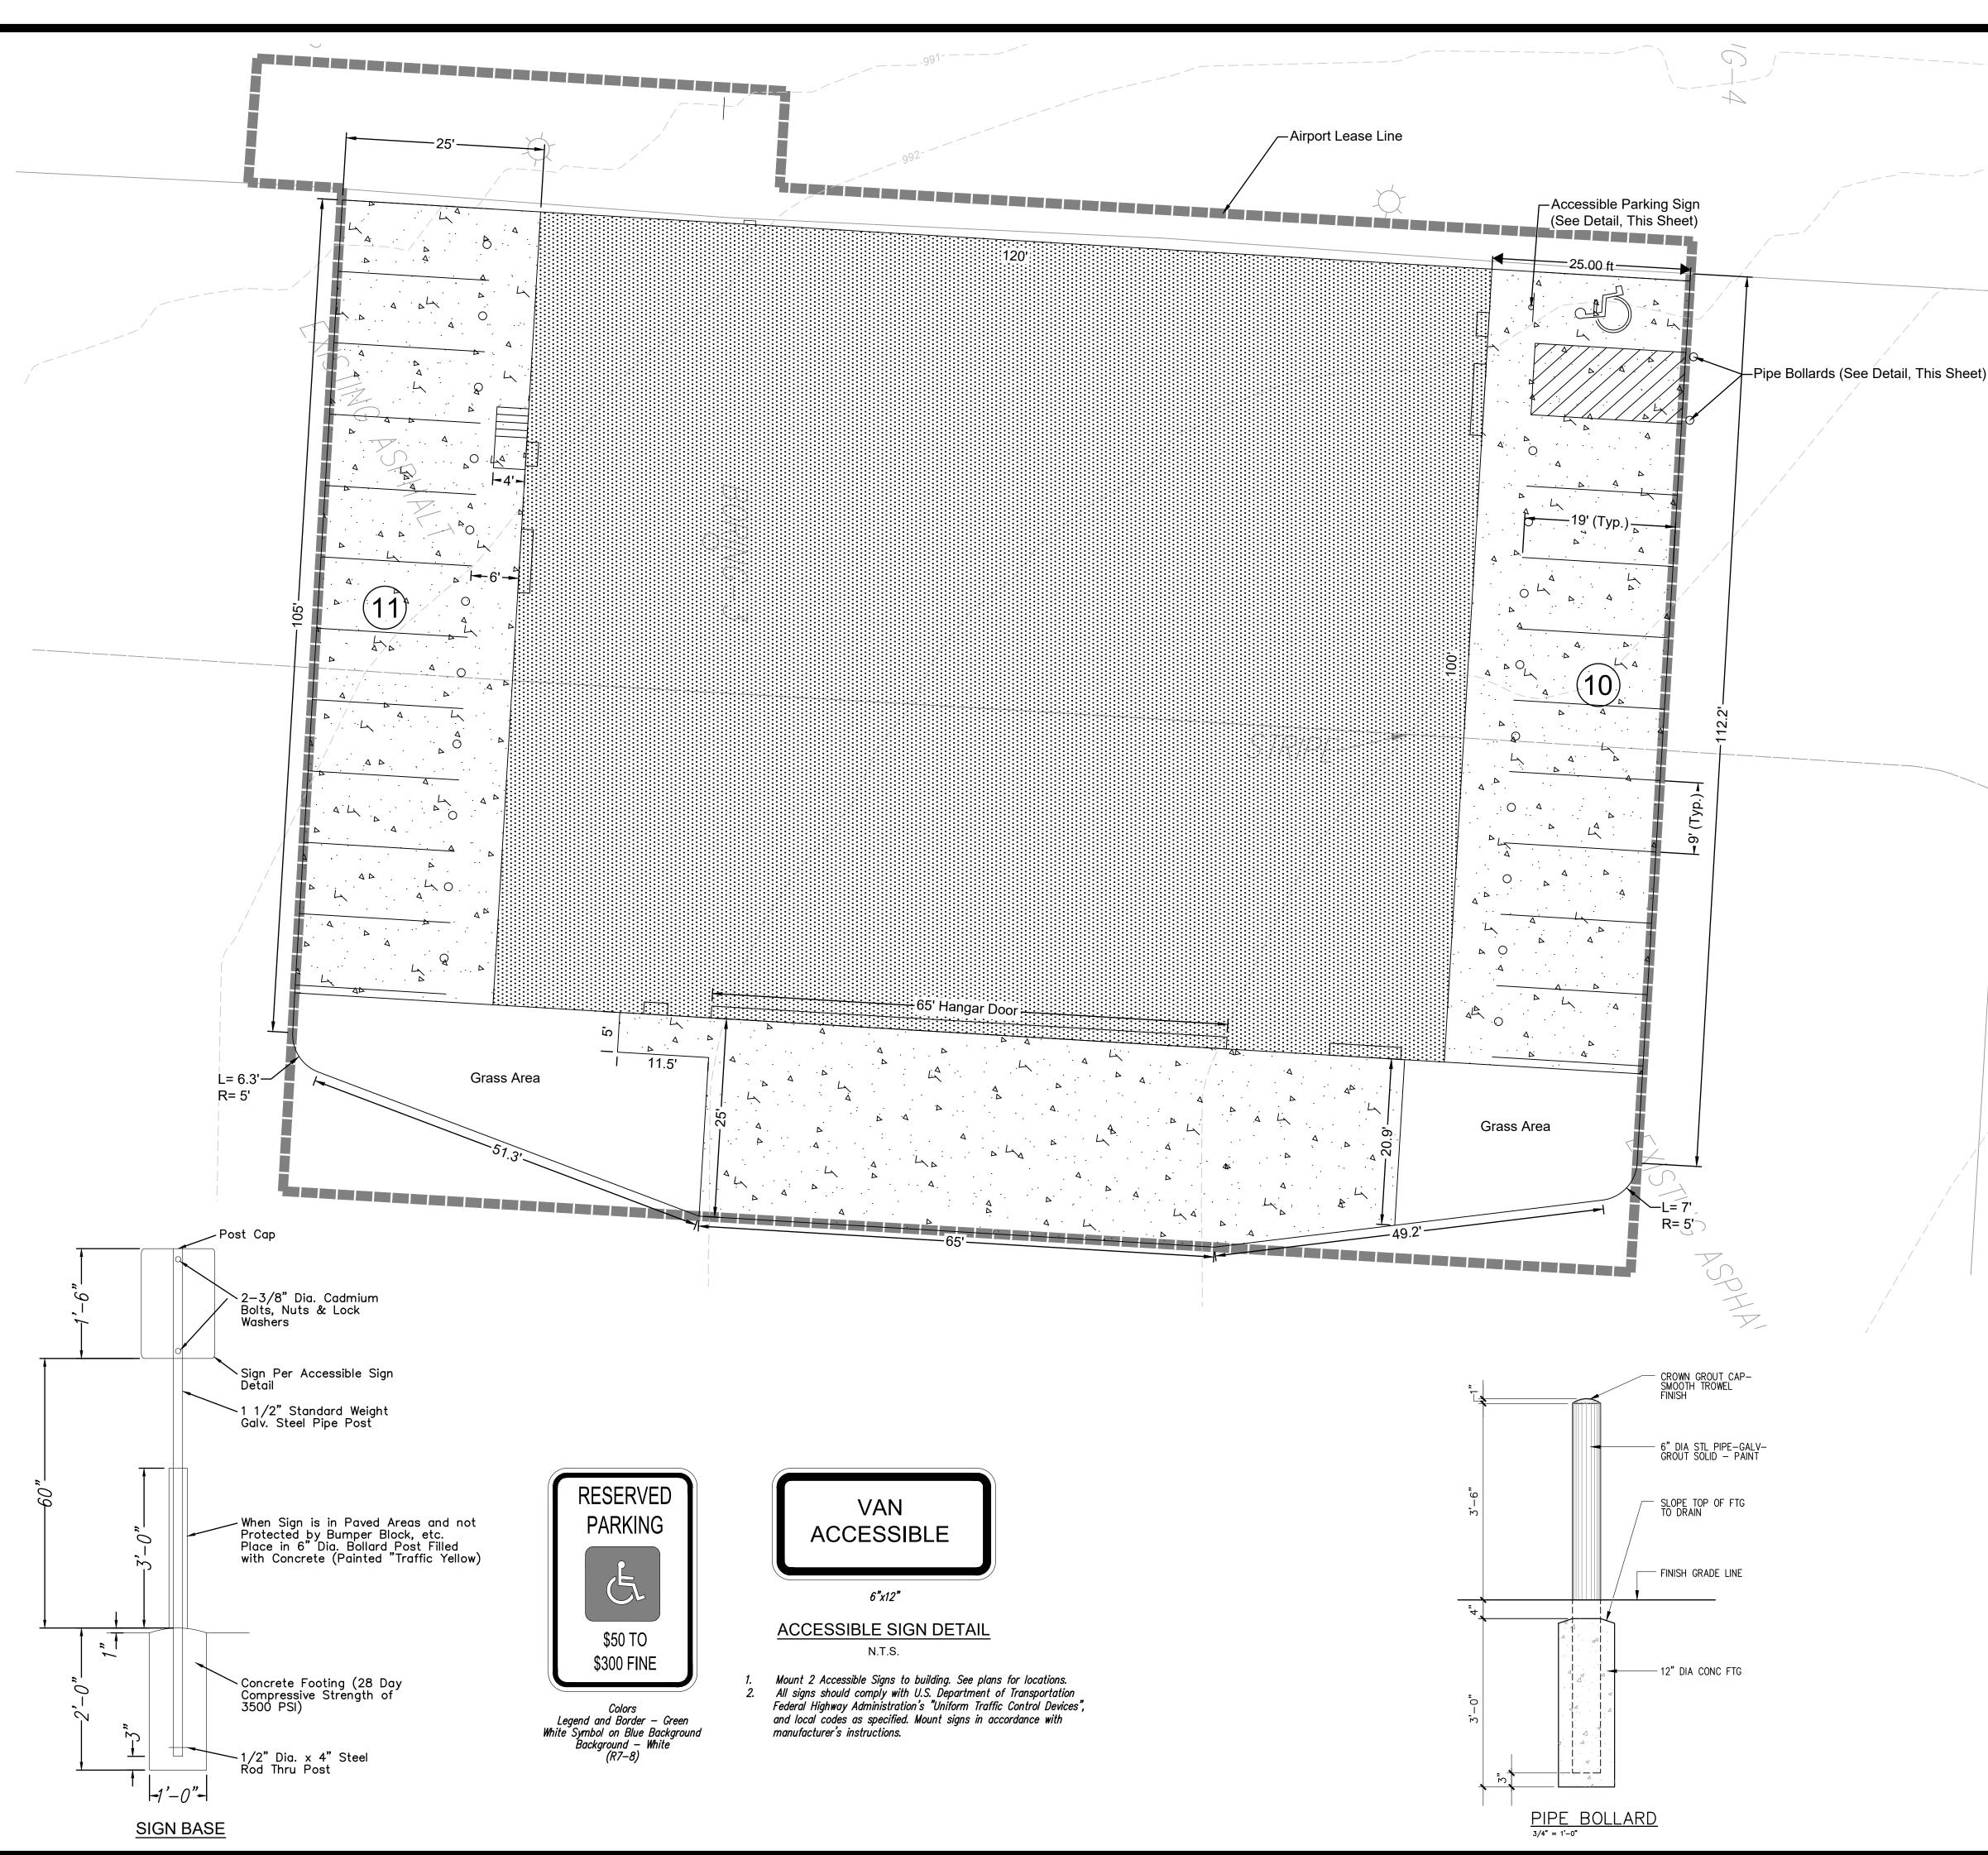

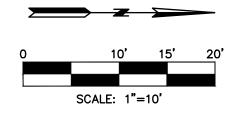

GENERAL NOTES:

- 1. See architectural submittal for all building details, lighting details, and MEP plans
- 2. All curb to be CG-1 unless otherwise stated
- 3. All dimensions are to back of curb, unless otherwise stated

PARKING ANALYSIS:

Total required:	15 Spaces (650 SF at 4/1000 SF & 11,350 SF at 1/1000 SF)
Total Provided:	21 Spaces

PLAN LEGEND:

(10)

FAA Spec. Concrete (SEE NOTE 5 BELOW)

of Parking Stalls

SITE PLAN TABLE							
Site Area SF	24,145.5						
Building SF	12,000.0						
Lease Area SF	22,950.2						
PARKING REQUIREMENTS							
Required	21						
Provided	21						


NOTE:

- 1. According to the F.E.MA. FIRM Map No. 29095C0409G, dated January 20, 2017 and FIRM Map No. 29095C0430G, dated January 20, 2017, this tract graphically lies in OTHER AREAS, ZONE X, defined as areas determined to be outside the 0.2% annual chance floodplain.
- 2. This site lies in the MAYBROOK WATER SHED.
- 3. There are no Oil and Gas Wells on this site per Missouri Department of Natural Resources GIS.
- 4. Trash will be collected inside and removed from site by owner.


5. Concrete Requirements:

- 12 inch Cement Treated Subgrade
- 6 inch Aggregate Base Course
 8 inch PCCP.


These specifications are per FAA Guidelines, and are required for any/all concrete poured on this site.

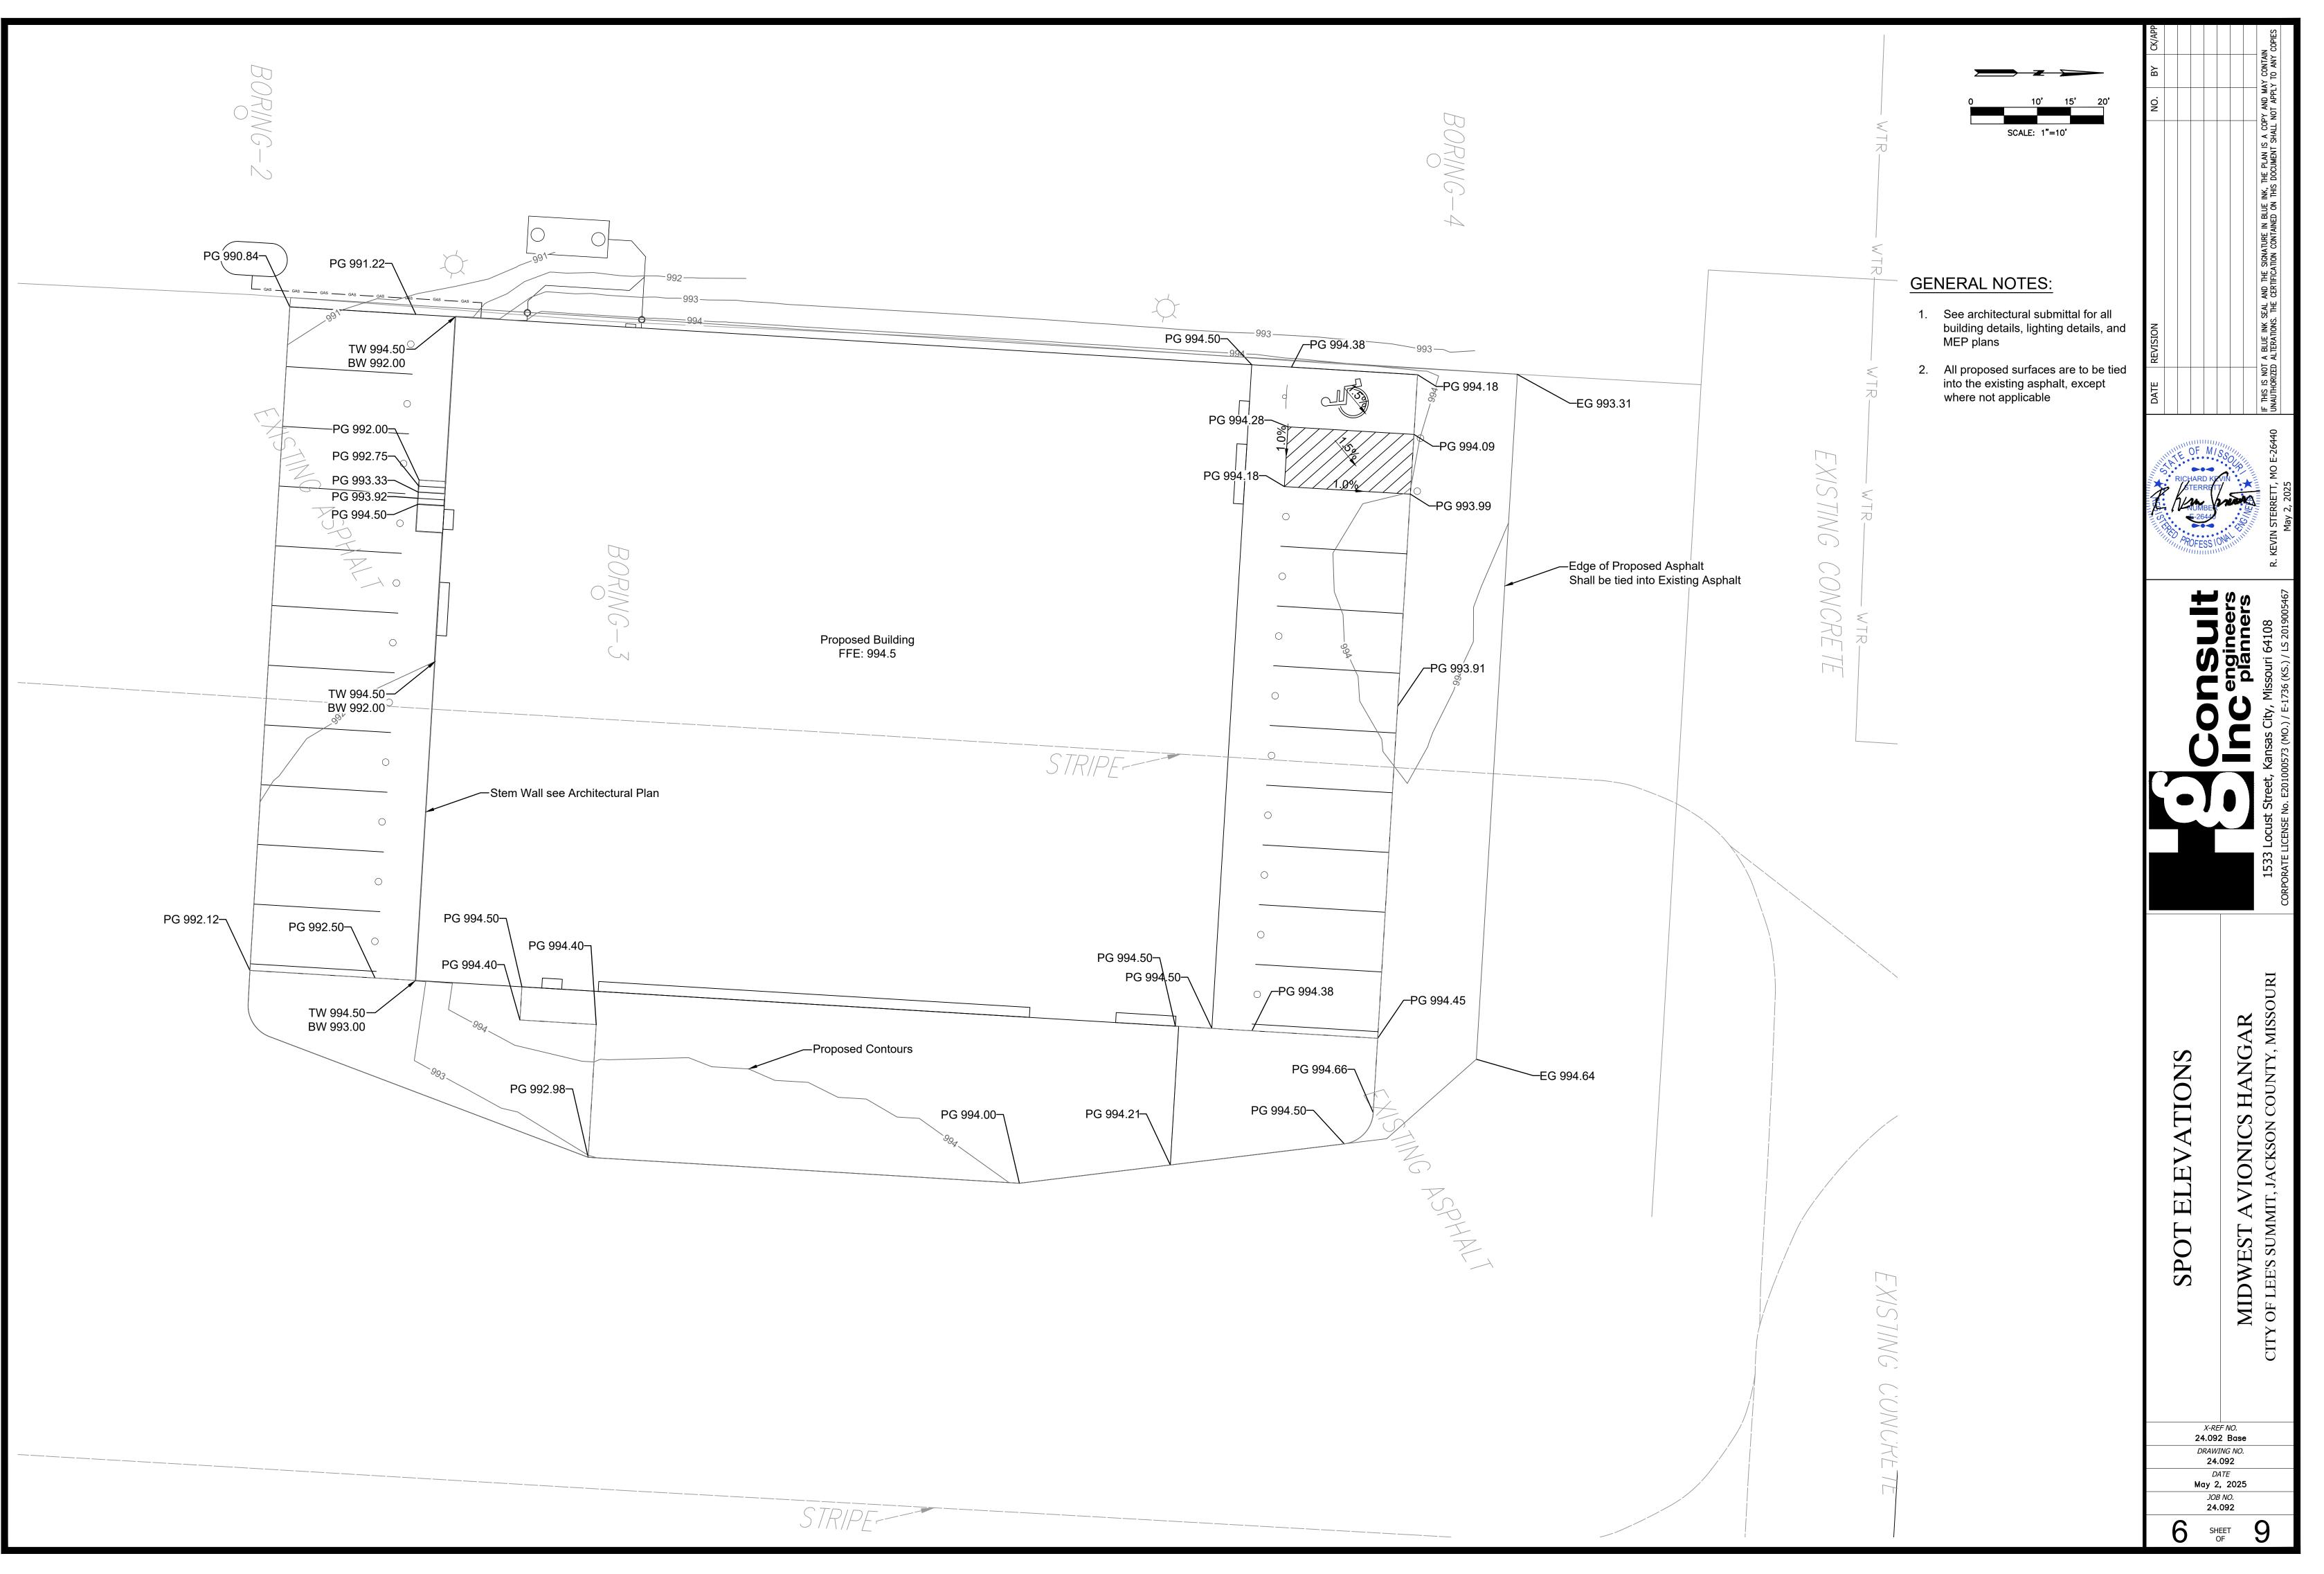




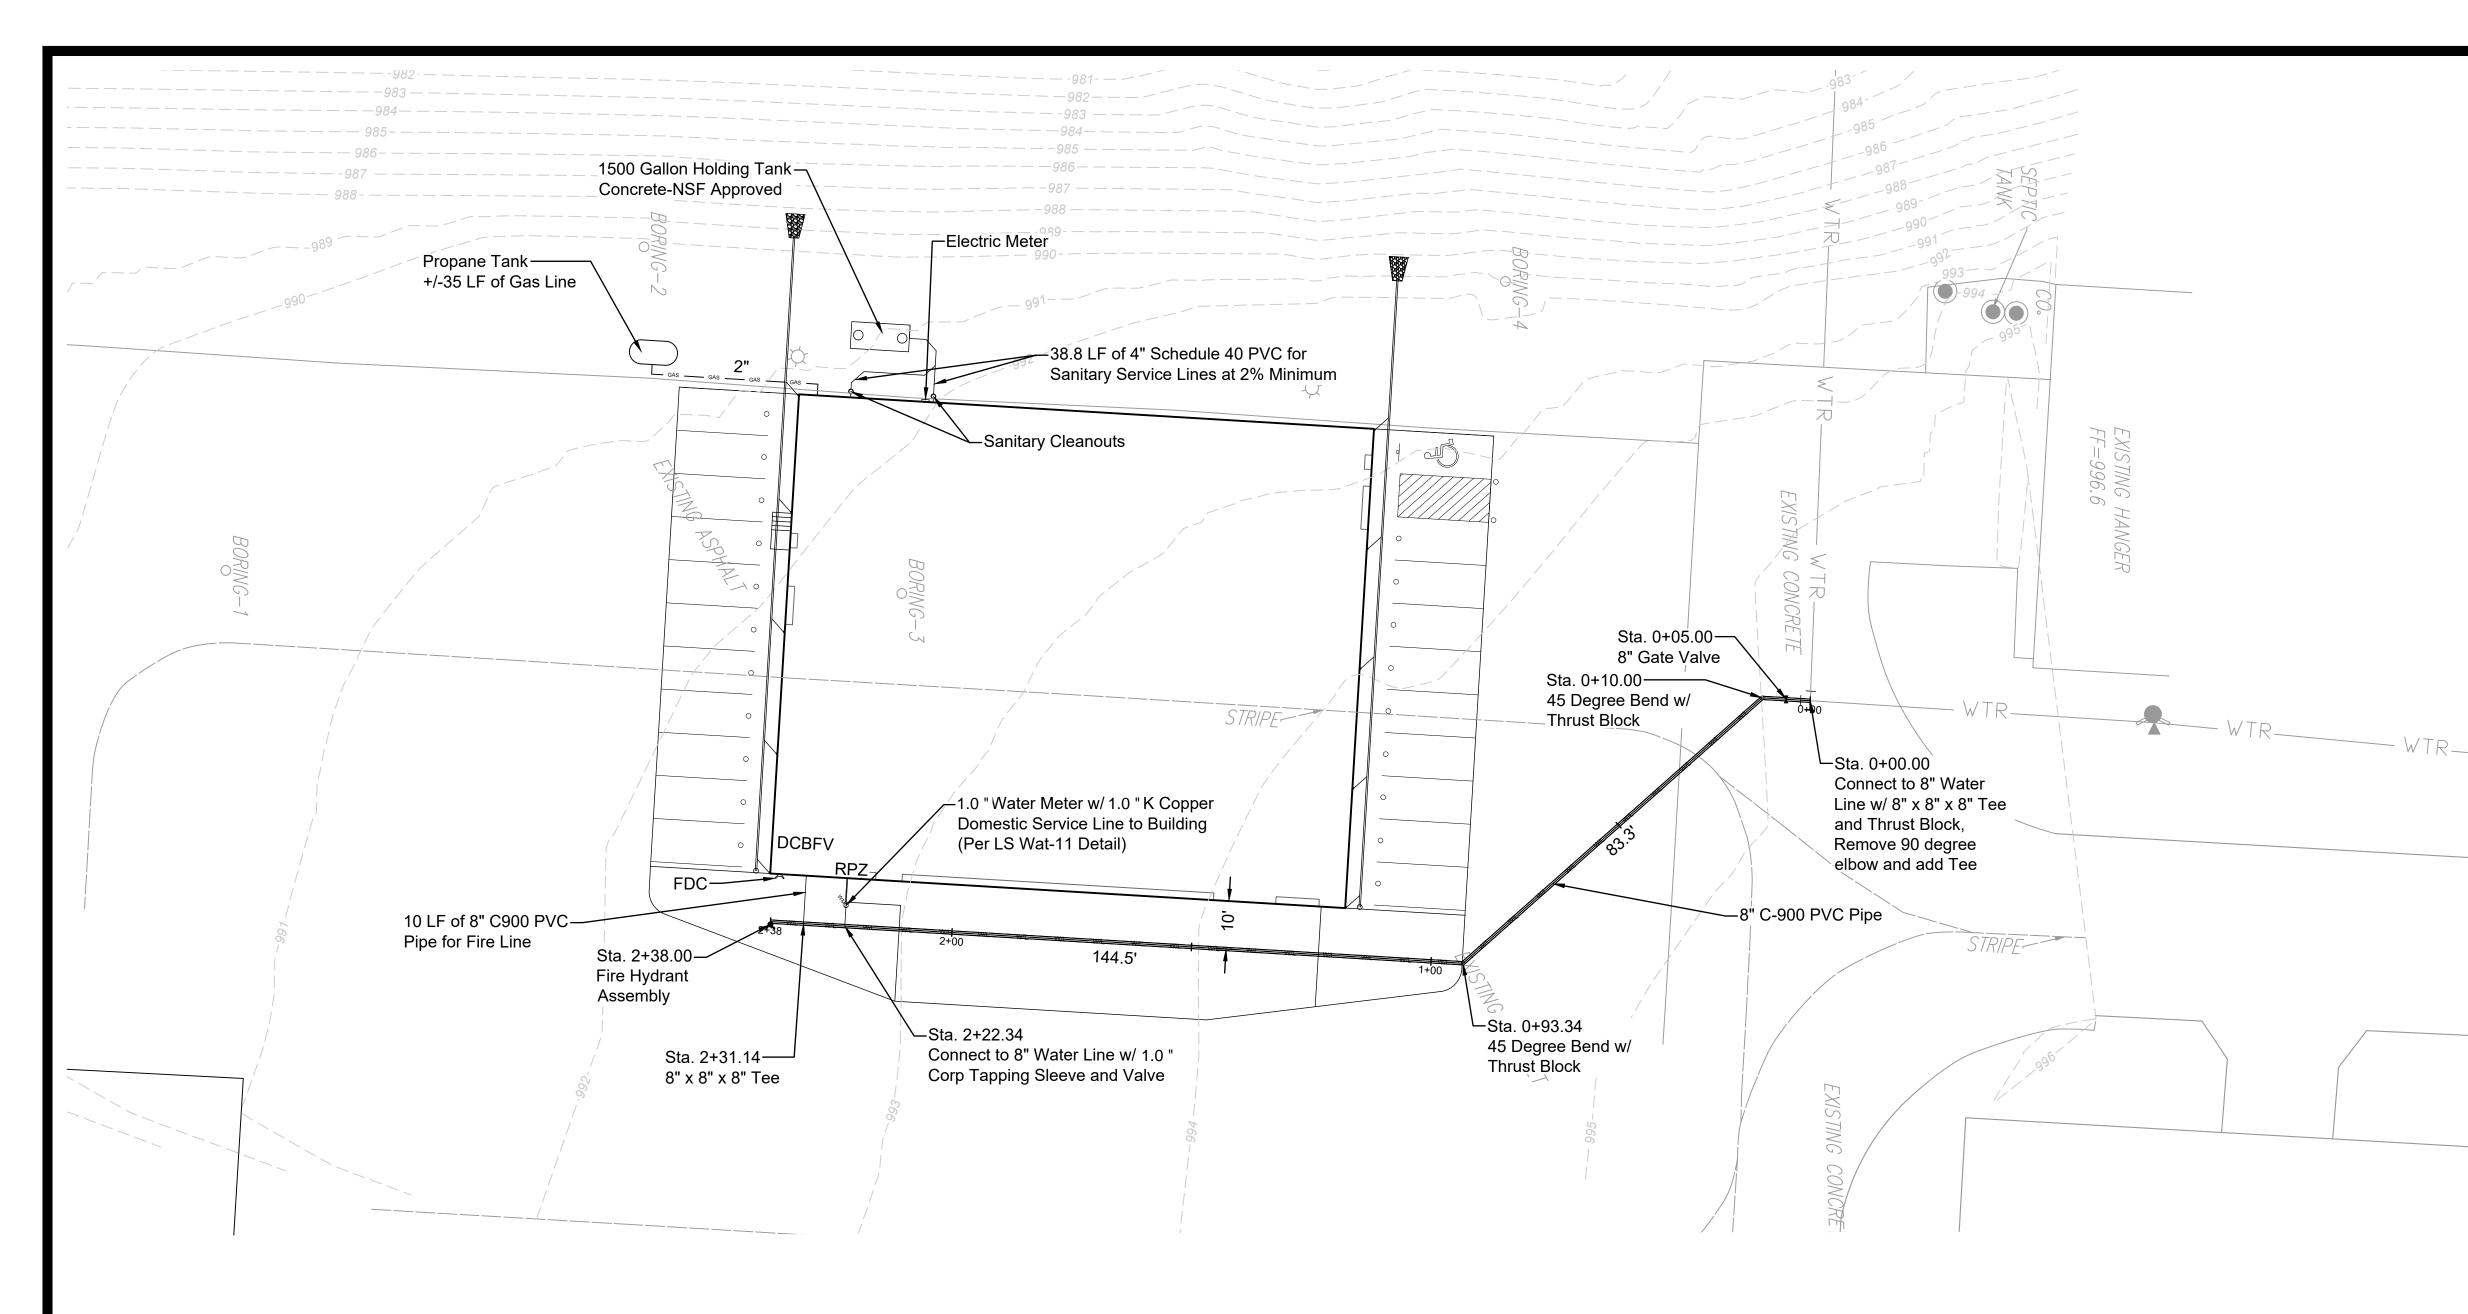

1"=10'

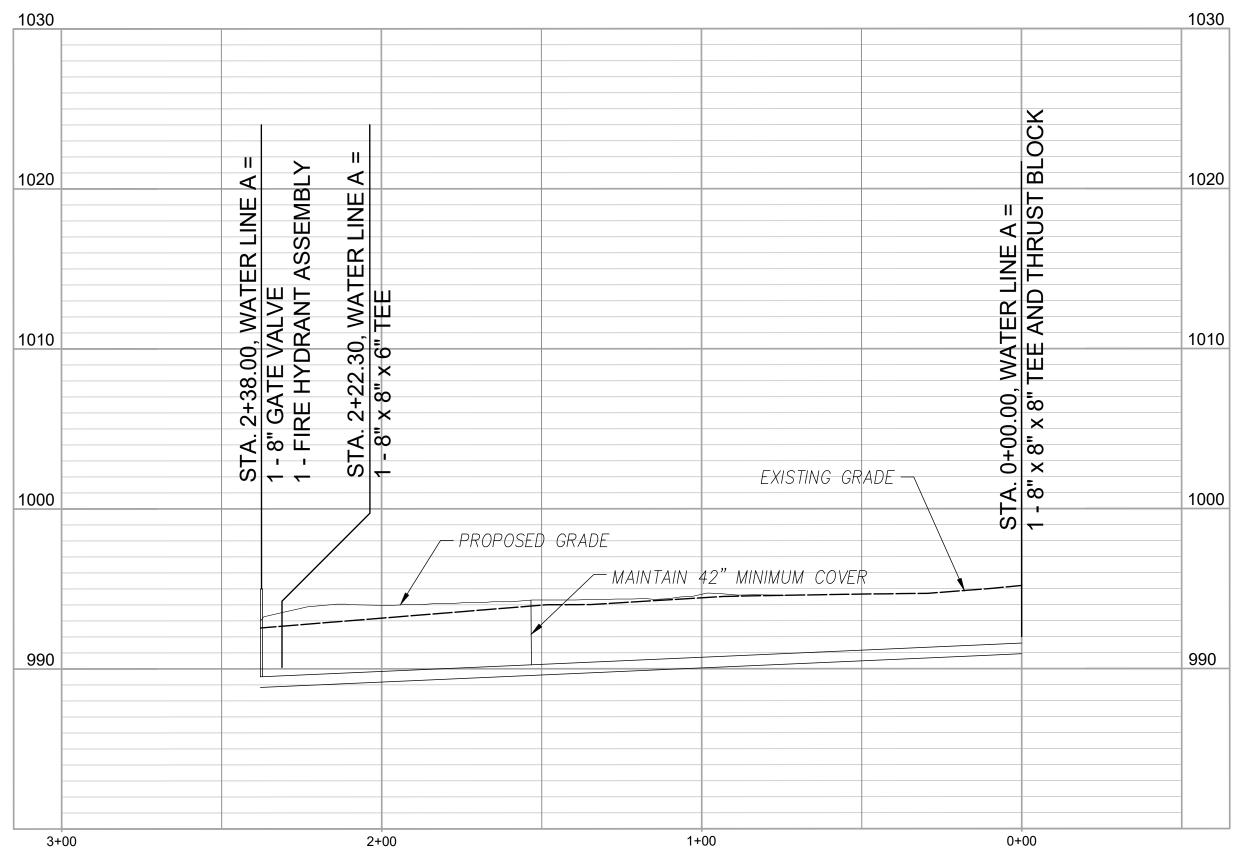

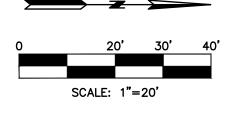

GENERAL NOTES:

1. See architectural submittal for all building details, lighting details, and MEP plans

UTILITY NOTES:


- All utility installation to be in accordance to Lee's Summit "DESIGN AND CONSTRUCTION MANUAL" per Ordinance 5813. See manual for specifications and standard details.
 Roof Drains (RD) to be released directly to detention pond
- 2. Roof Drains (RD) to be released directly to detention point (Where applicable)
 3. Contractor to contact the Water Utilities Department, Operations
- Division, at (816) 969-7606 to schedule water main taps and cut-ins 48 hours in advance.
- 4. Thrust Blocks to be provided at all water line bend and tee locations.
- 5. Domestic water lines to be 1" diameter Type K Copper from main to meter and $1\frac{1}{2}$ " diameter C900 PVC from meter to building.
- 6. Contractor to coordinate with KCPL for temporary and permanent electric alignment and connection
- See MEP plans for all utility, double check backflow and RPZ valves inside of building.
 DVC COOD ping many he used in lieu of DID
- 8. PVC C900 pipe may be used in lieu of DIP.


NOTE:


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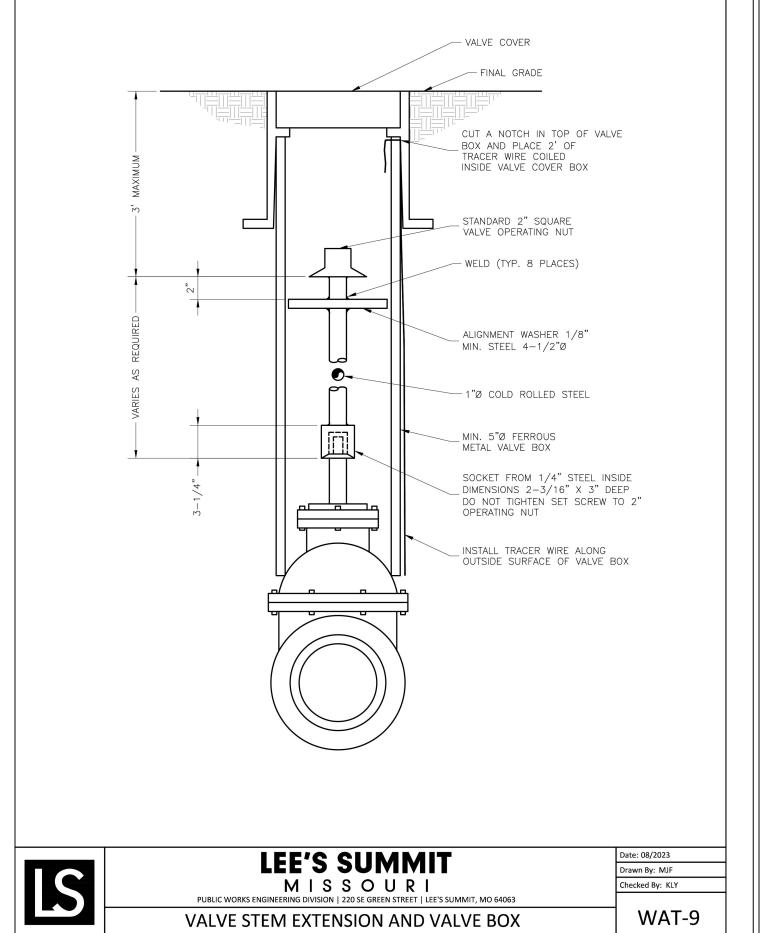
The double check back flow valve (DCBFV) will be located inside the hangar in the SE corner as shown.


6. The domestic water RPZ will be located inside the hangar.




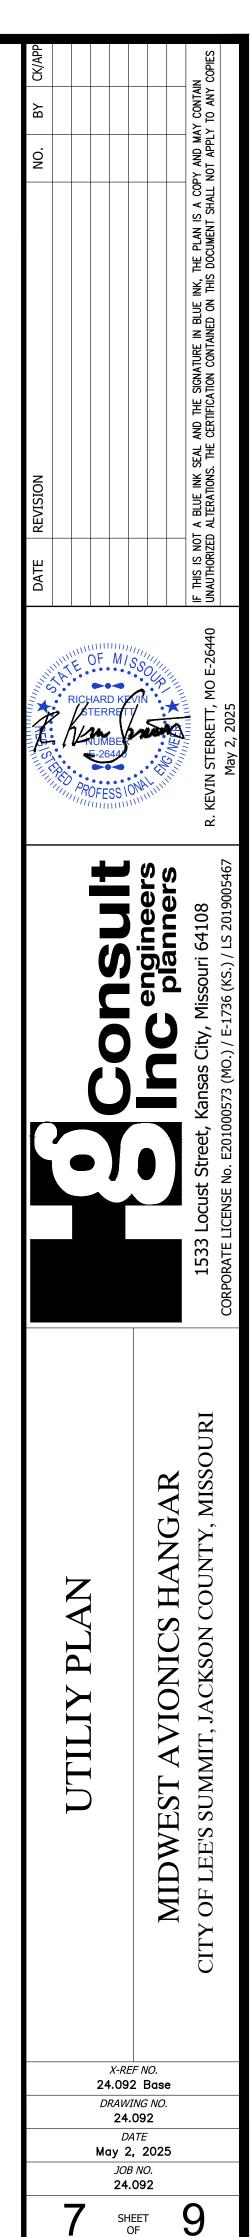


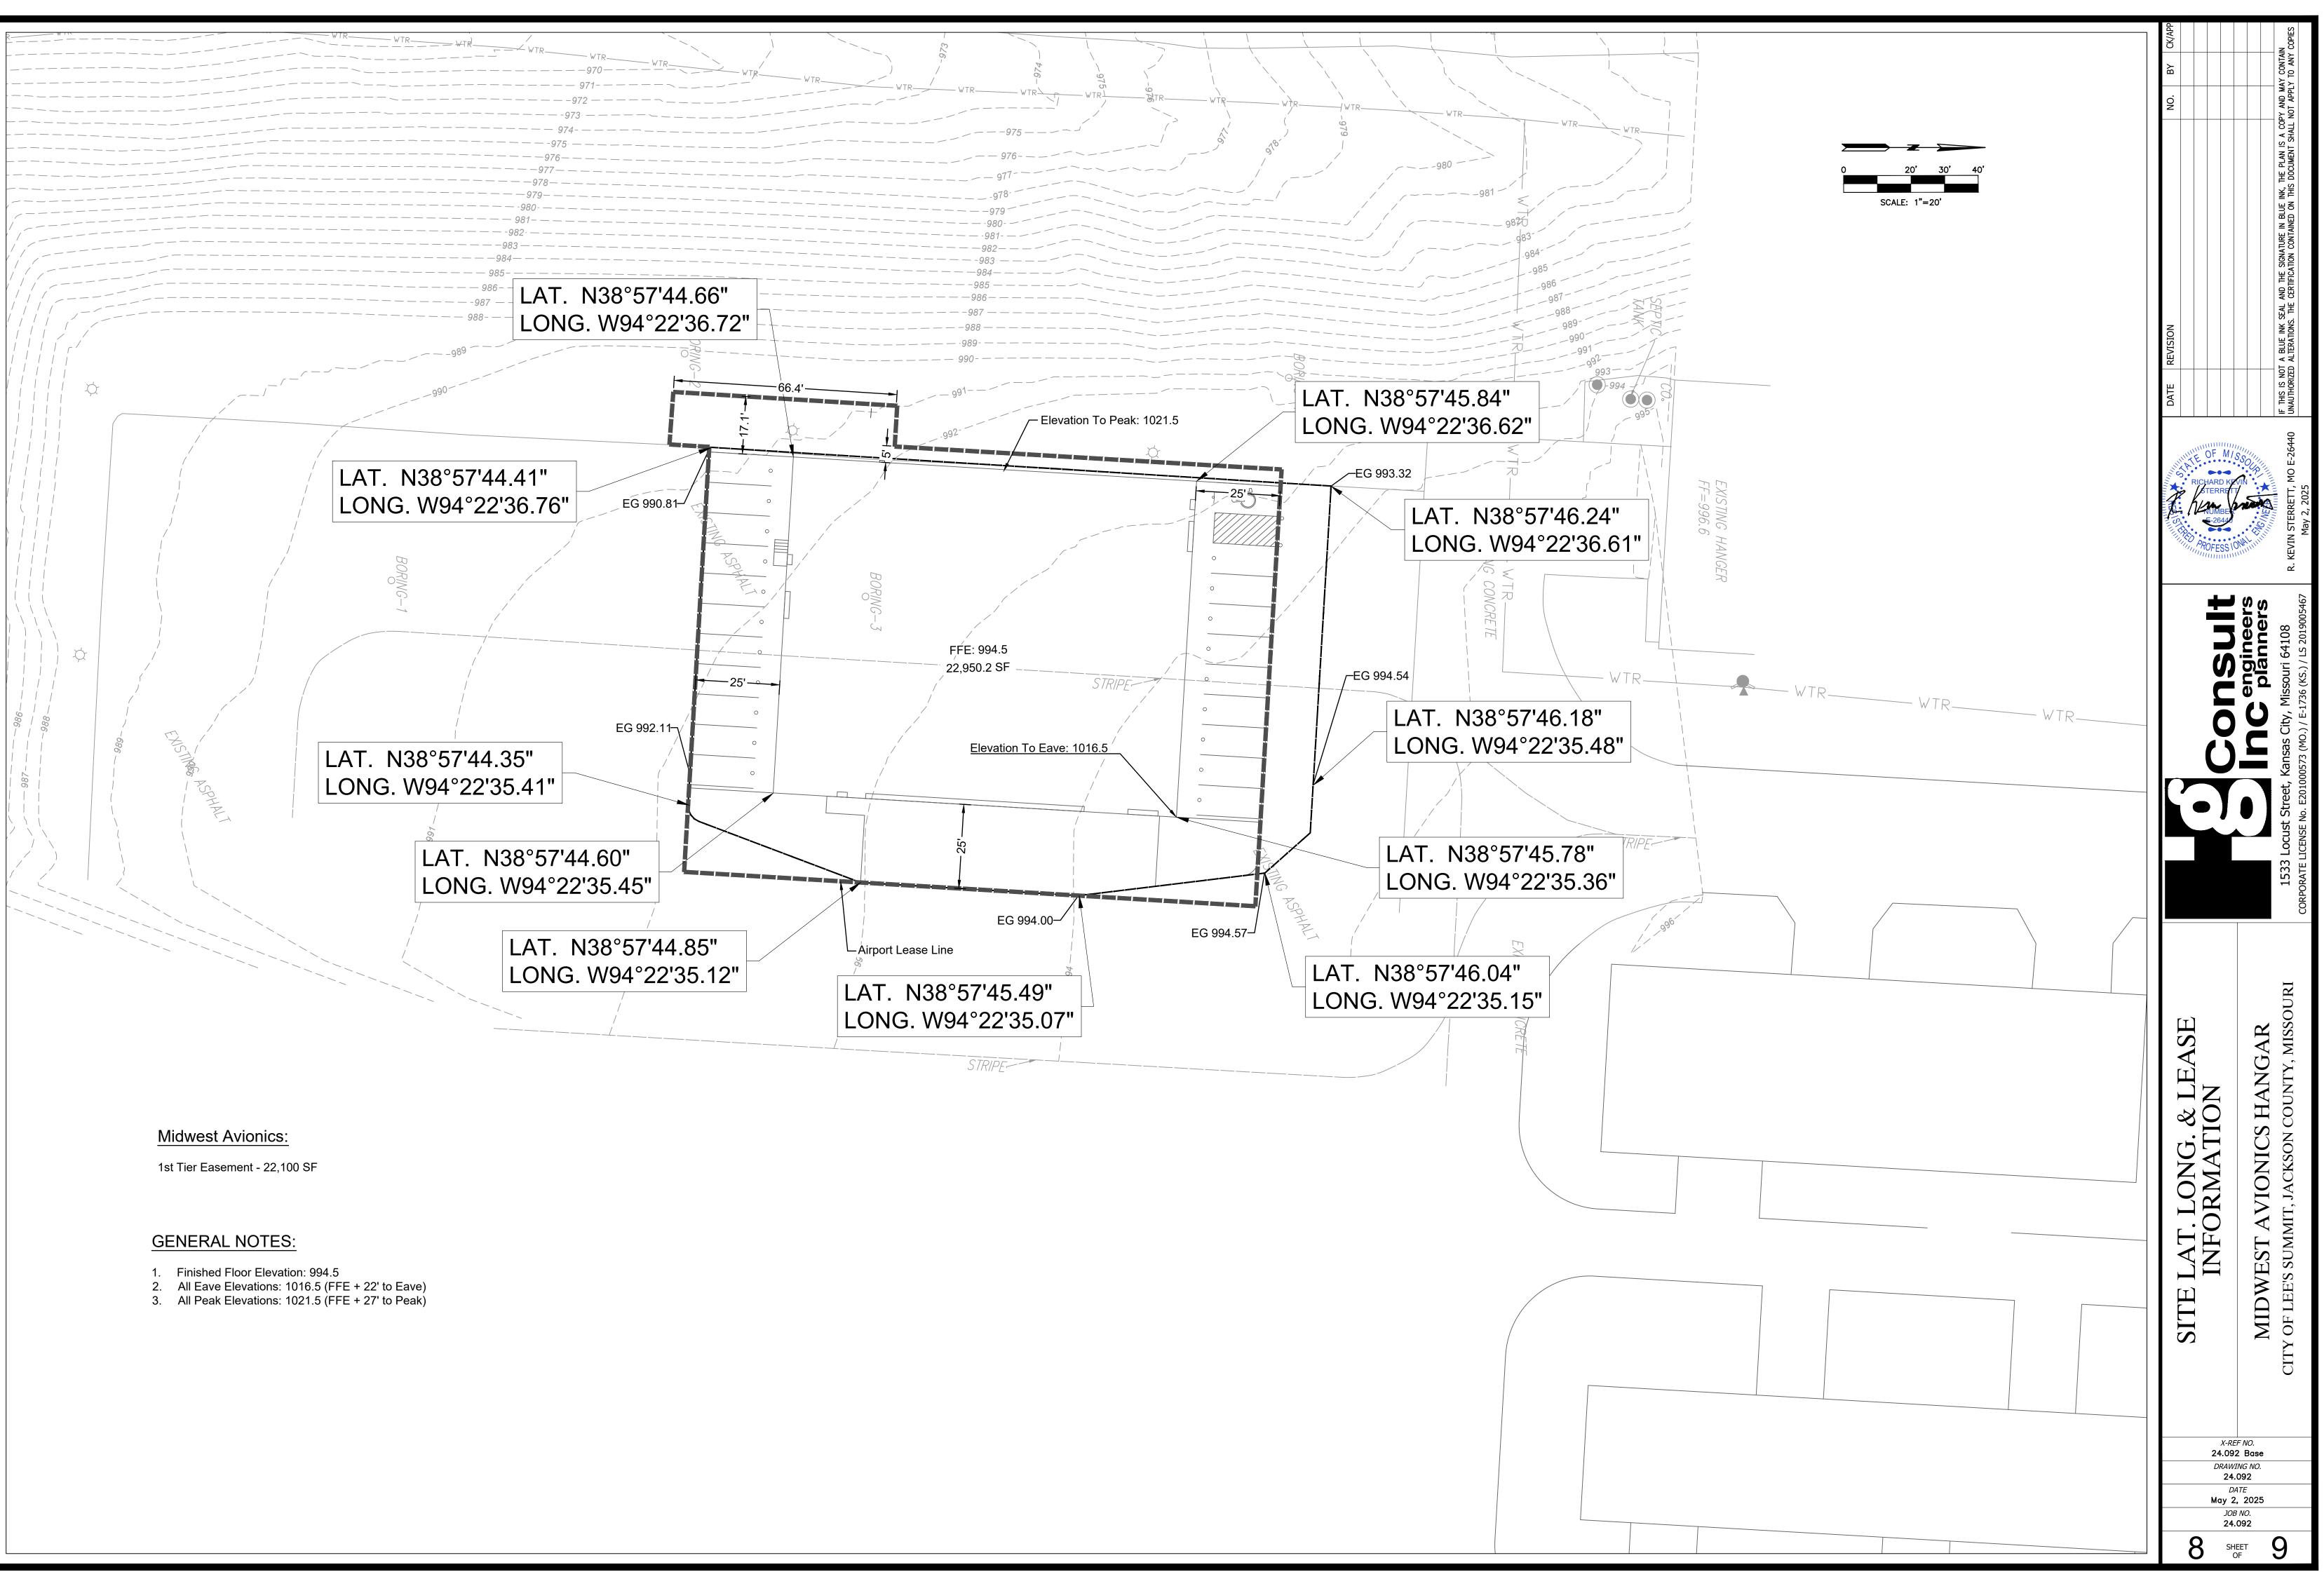

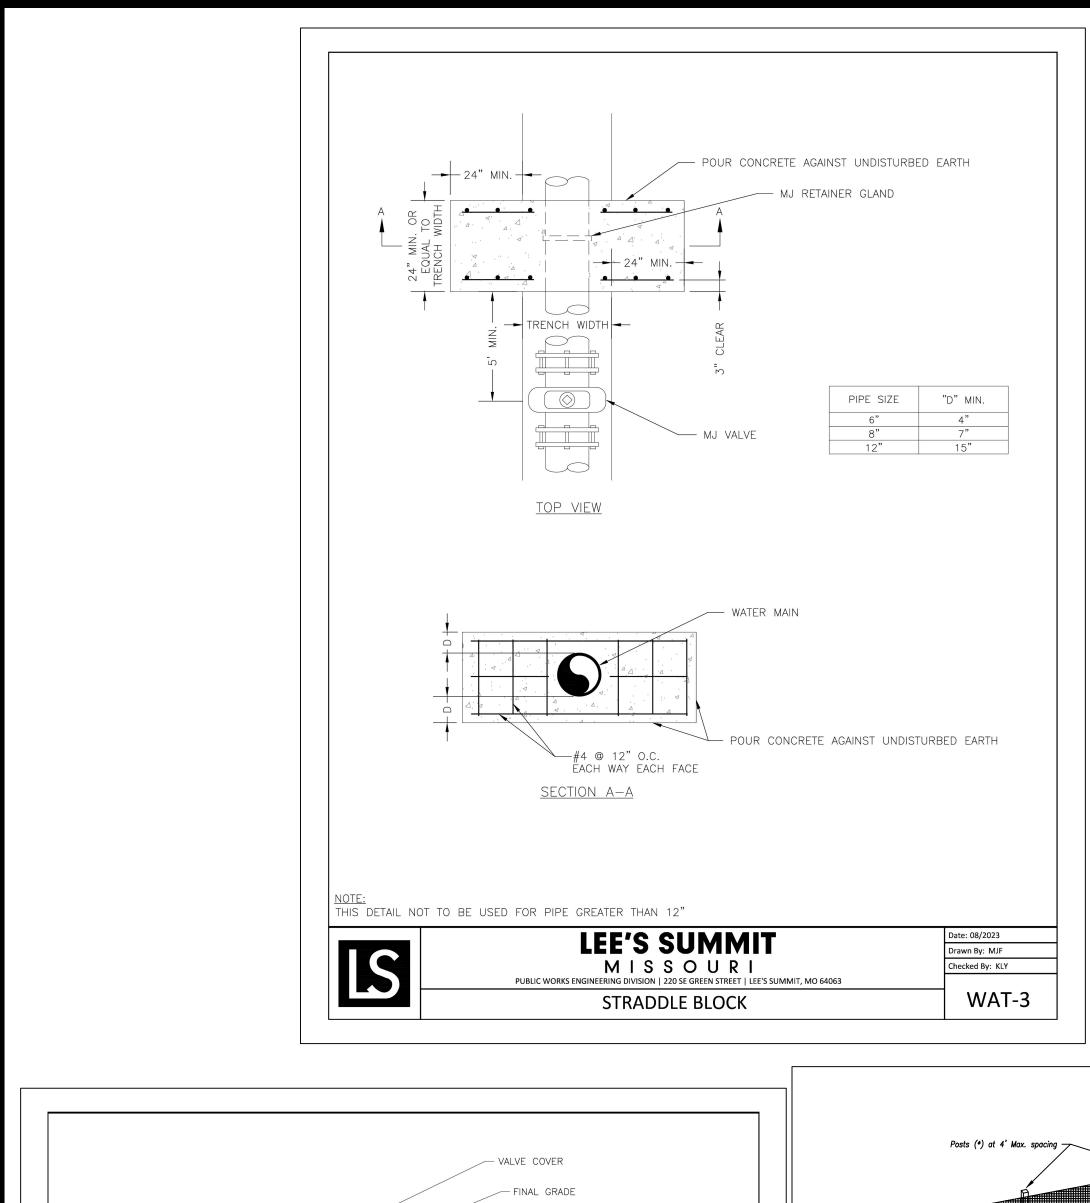

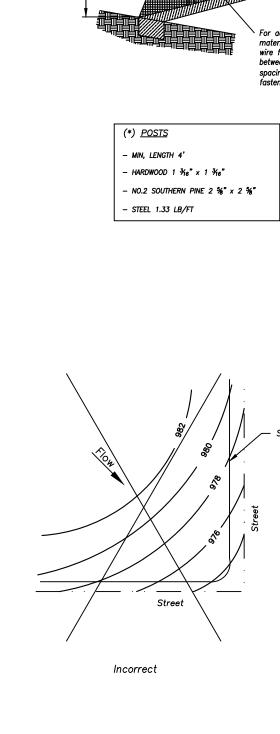

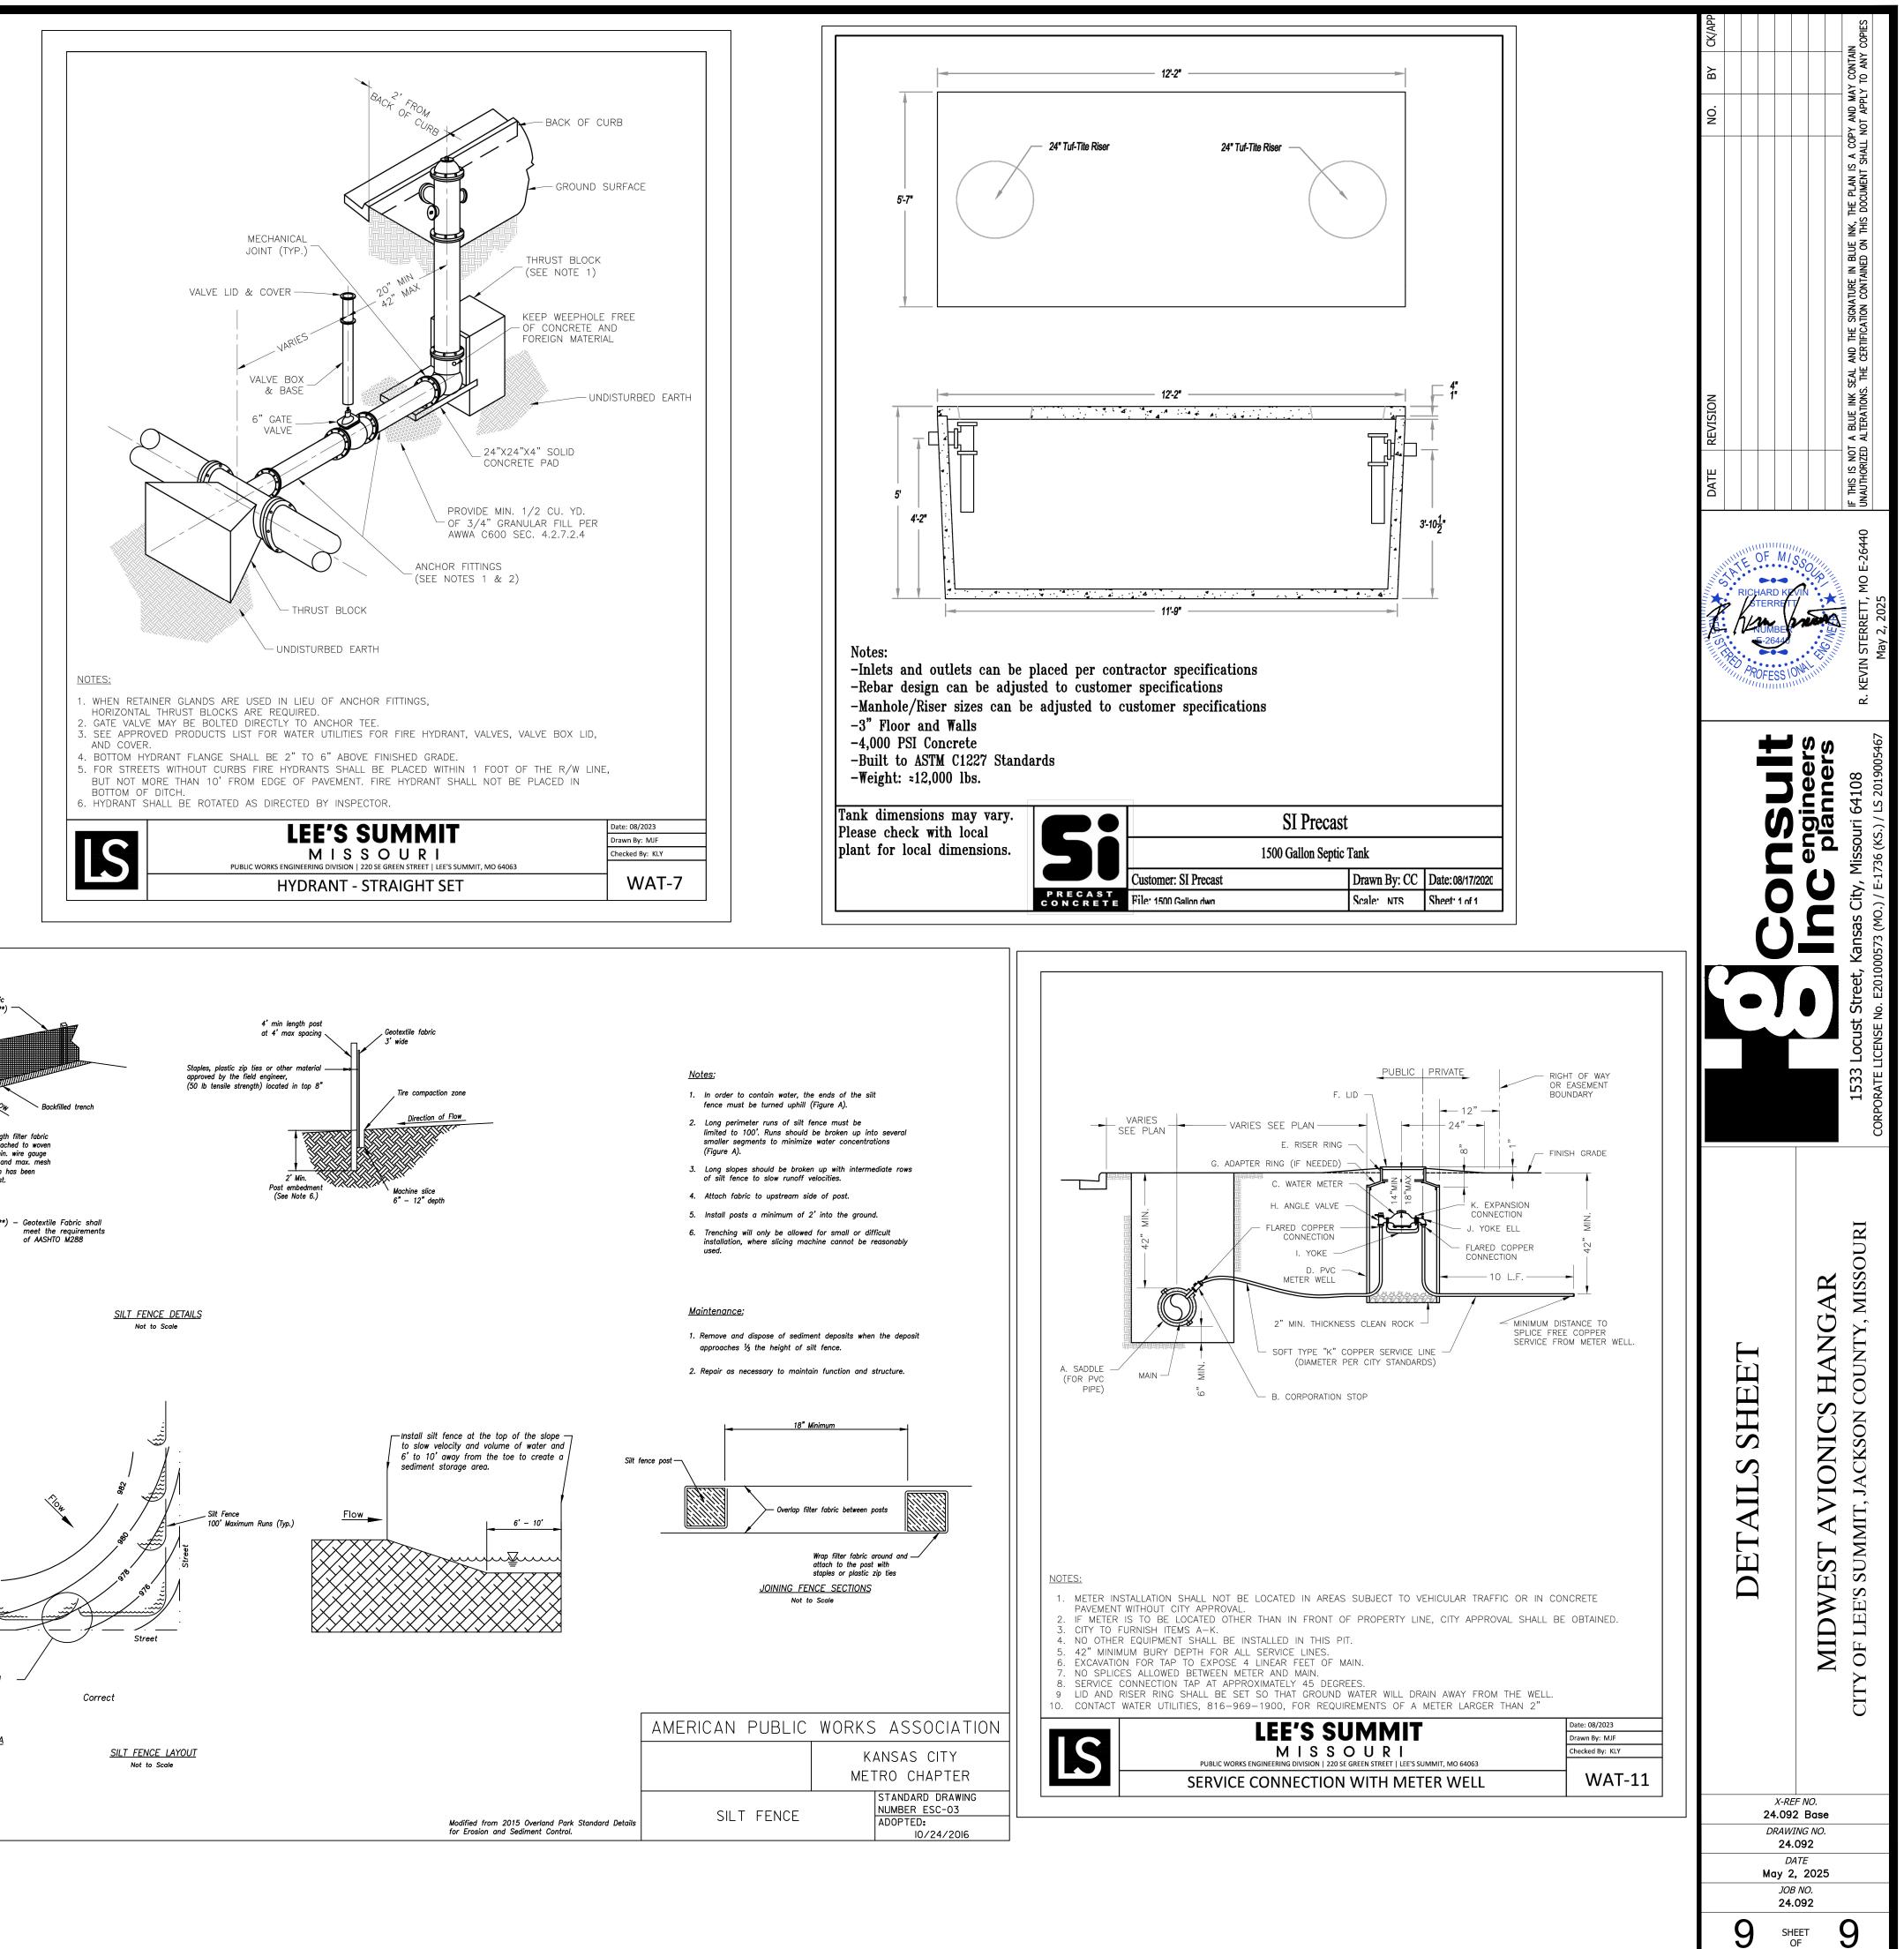

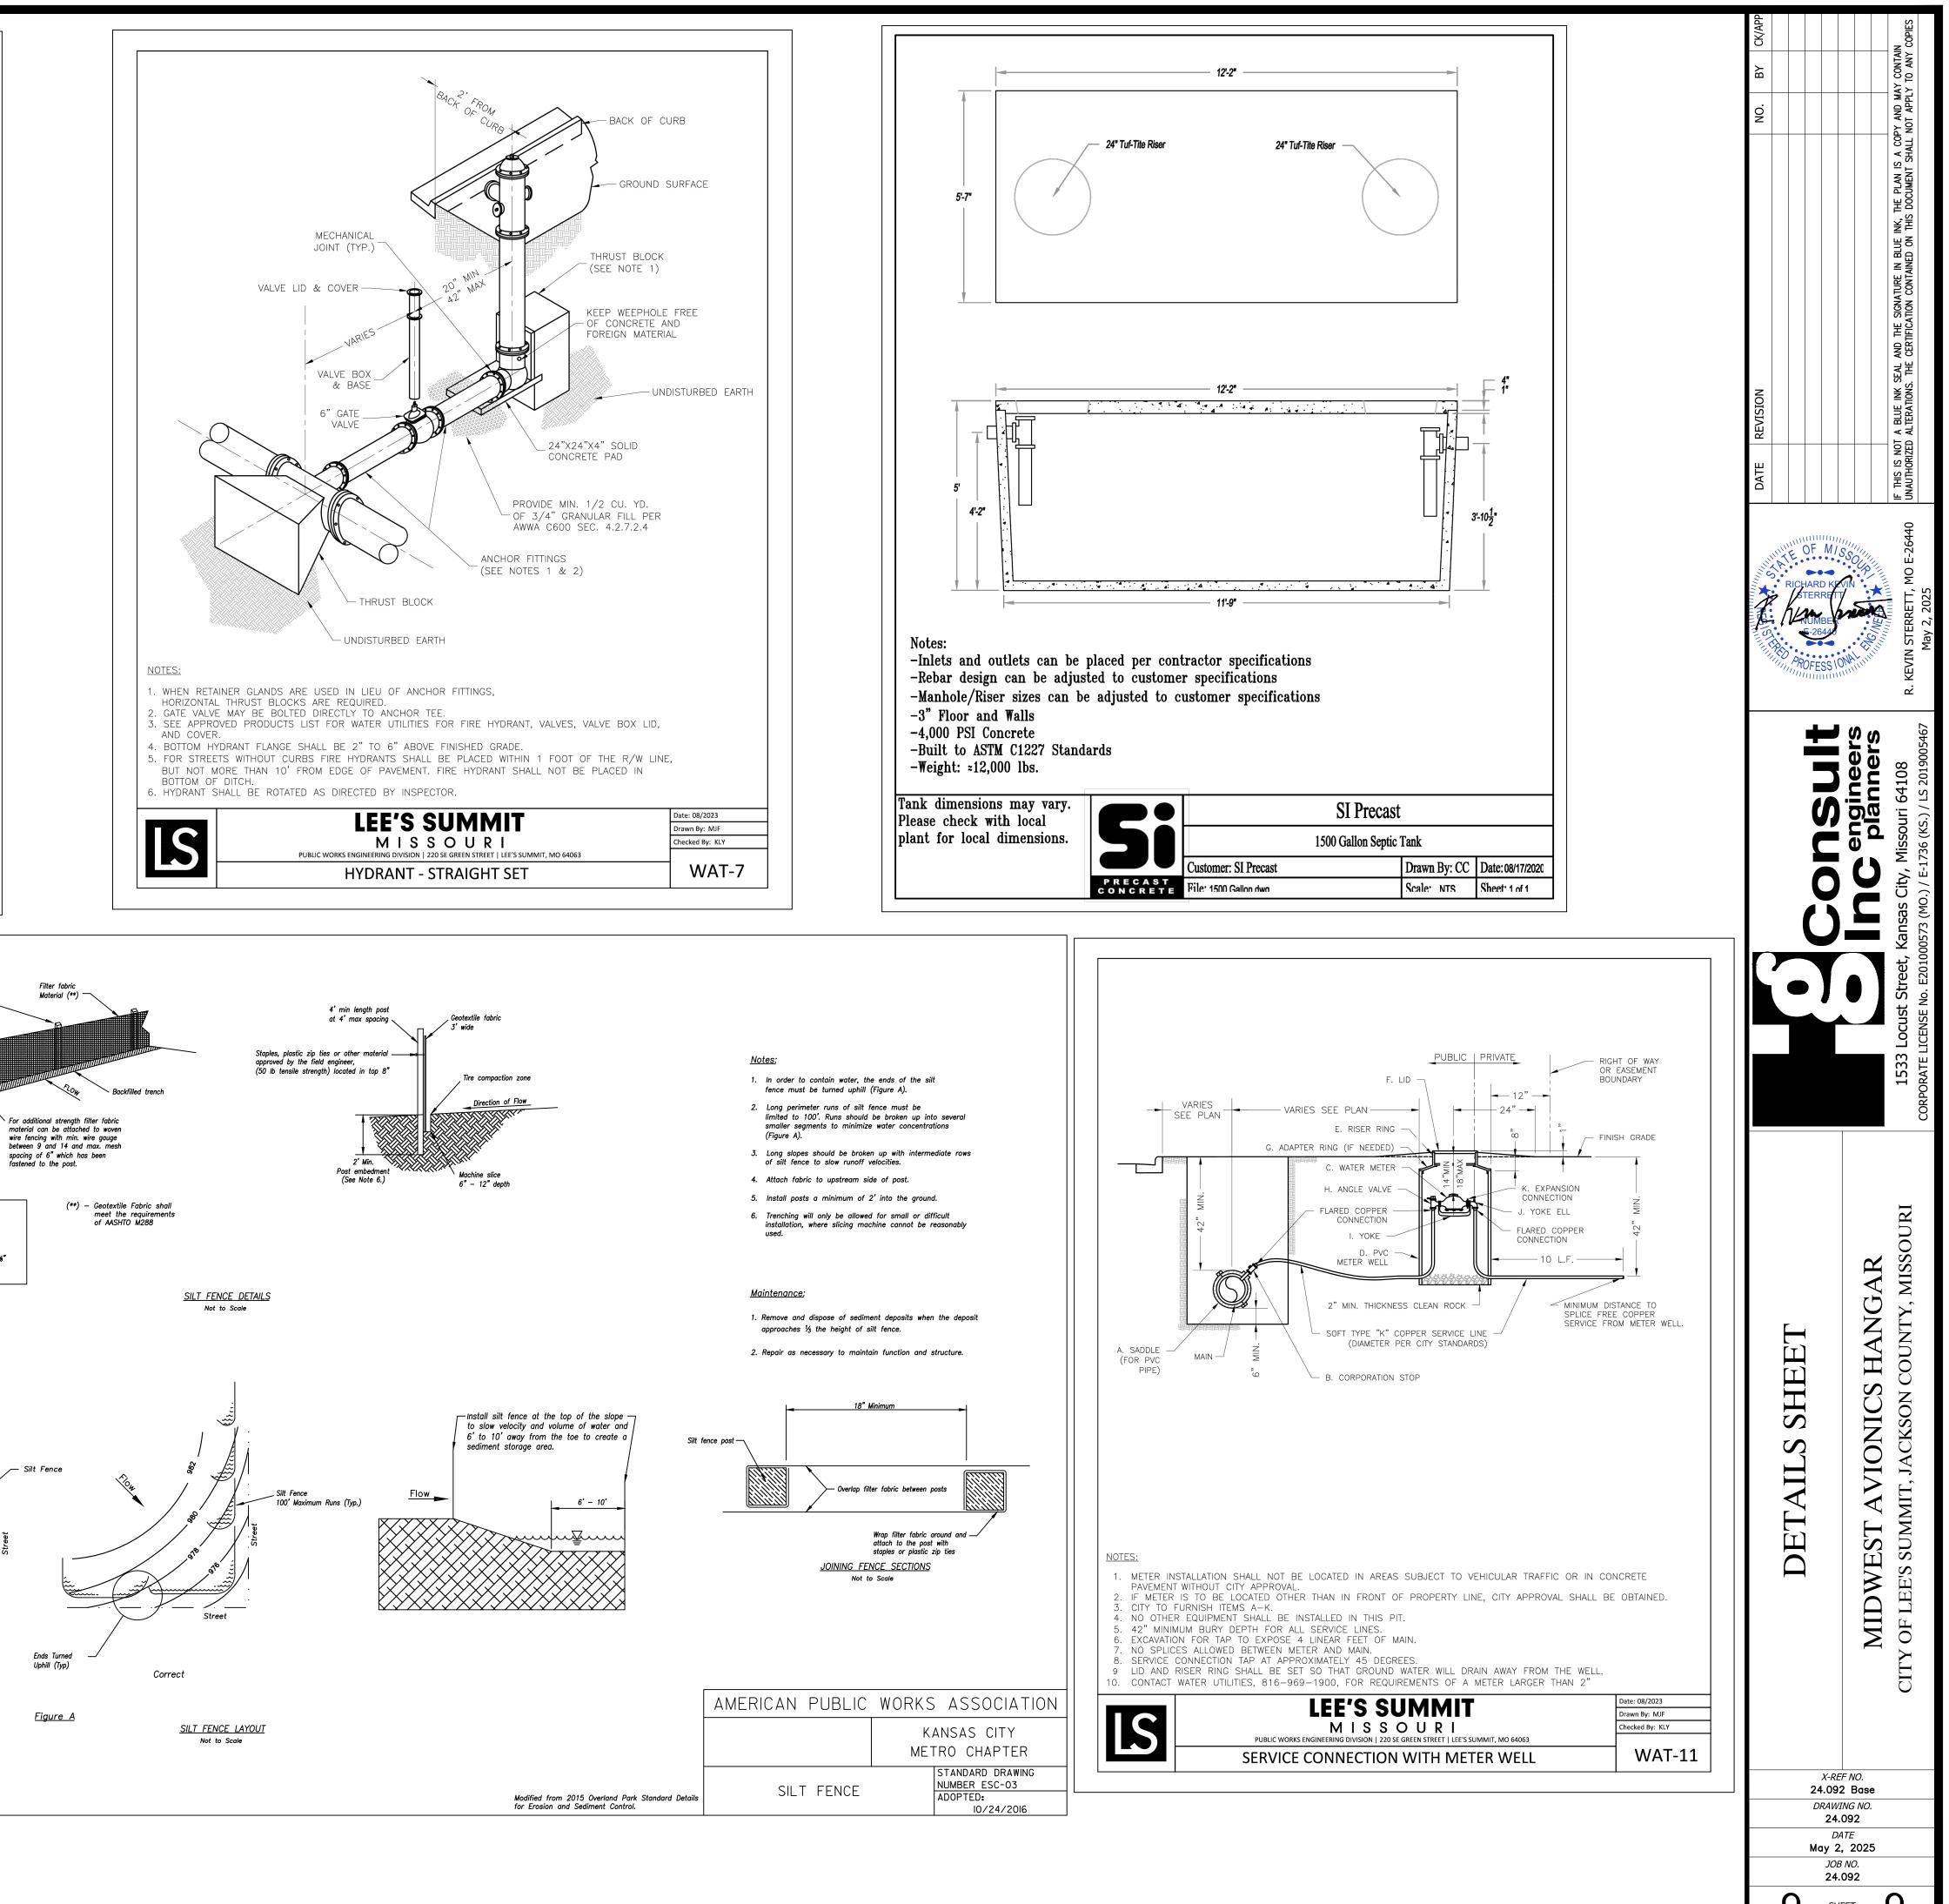


ELECTRICAL LIGHTING PLAN NOTES


- PROVIDE 4-WAY SWITCH FOR HIGH BAY HANGAR LIGHTING. VERIFY SWITCH LOCATIONS AND CONTROL 1
- ZONES WITH OWNER PRIOR TO INSTALL.
- PROVIDE REMOTE EMERGENCY LIGHT MOUNTED AT 8'-0" AFF. COORDINATE EXACT LOCATION WITH OWNER 2 AND CONCEAL LOW VOLTAGE WIRING TO INTERIOR EXIT SIGN.
- WALL MOUNT THE EMERGENCY LIGHT FIXTURE AT 6" BELOW THE CEILING. PROVIDE UNSWITCHED HOT TO 3
- FIXTURE, CIRCUITED AHEAD OF ALL LOCAL AND GLOBAL SWITCHING.
- VERIFY MOUNTING HEIGHT OF EXIT SIGN PRIOR TO ROUGH IN. 4 INSTALL WALL-MOUNTED OCCUPANCY SENSOR AT 42" AFF. ADJUST OCCUPANCY SENSOR TO PROVIDE 5
- AUTOMATIC ON/AUTOMATIC OFF OPERATION WITH A FIXED TIMER OF 30 MINUTES AND WITH BOTH THE PASSIVE INFRARED AND ULTRASONIC SENSORS ENABLED.
- 6 EMERGENCY LIGHT FIXTURE SHALL BE SWITCHED DURING NORMAL OPERATION. UPON LOSS OF POWER, FIXTURE SHALL BE ENERGIZED VIA THE EMERGENCY FIXTURE, ONBOARD EMERGENCY LIGHTING INVERTER.
- 7 INTERLOCK EXHAUST FAN OPERATION WITH RESTROOM LIGHTING.

LIGHTING FIXTURE SCHEDULE

							BASIS FOR DESIGN		
TAG	COUNT	DESCRIPTION	MOUNTING	VOLTAGE	WATTS	MANUFACTURER	MODEL	LAMP	REMA
A1	20	MODULAR HIGH BAY	SUSPENDED	120 V	295 W	GH-4-L400-840-FA-UNIV	HE WILLIAMS	LED	COORDINATE MOUNTING HEIGH TO E100 FOR FIXTURES THAT SH EMERGENCY FEATURE. FIXTURES
C1	4	RECESSED 6IN CAN LIGHT	CEILING	120 V	17 W	NORA LIGHTING	NHIC-6G24ATFL WITH NLCBC-65130WW LED TRIM	LED	LED TRIM FURNISHED WITH GU2
E1	2	EMERGENCY LIGHT - DUAL HEAD	WALL	120 V	2 W	EXITRONIX	LED-90	INTEGRAL LED	90 MINUTE BATTERY BACKUP
E2	3	EXTERIOR REMOTE EMERGENCY LIGHT	WALL	4 V	1 W	EXITRONIX	MLED1-WP	INTEGRAL LED	LOW VOLTAGE REMOTE EMERG
E4	3	EXIT SIGN WITH EMERGENCY LIGHT -STANDARD RED LETTERS	WALL	120 V	2 W	EXITRONIX	CLED-U	INTEGRAL LED	90 MINUTE BATTERY BACKUP W LIGHT, REMOTE HEAD CAPABLE
X1	6	EXTERIOR WALL PACK	WALL	120 V	49 W	> HE WILLIAMS	VWPH-L60-840-T3-SDGL	LED	MOUNT AT 15'-0". COORDINATE

Junium

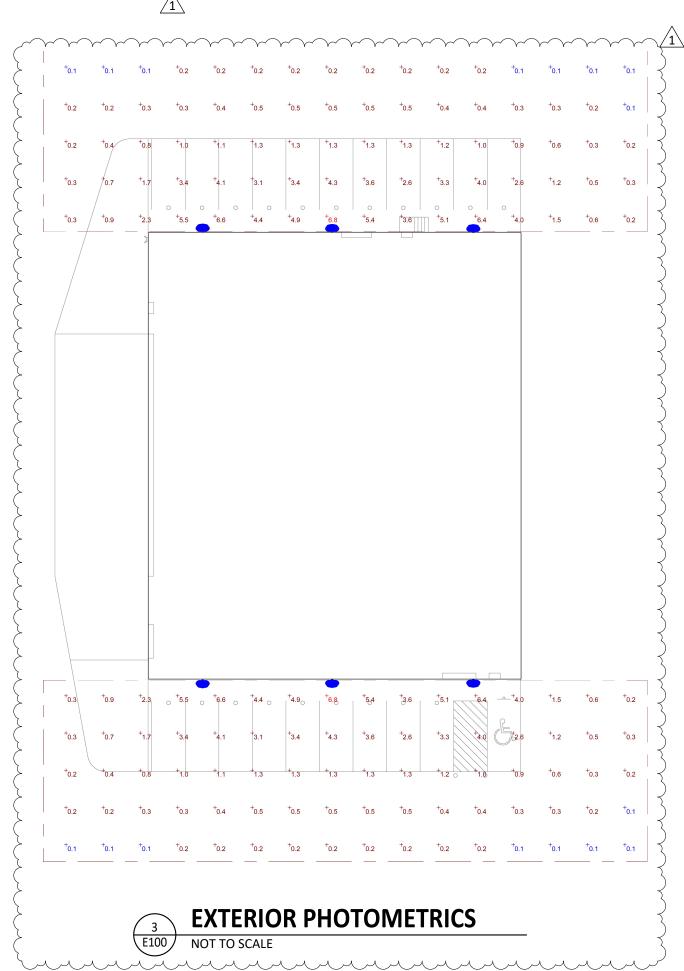

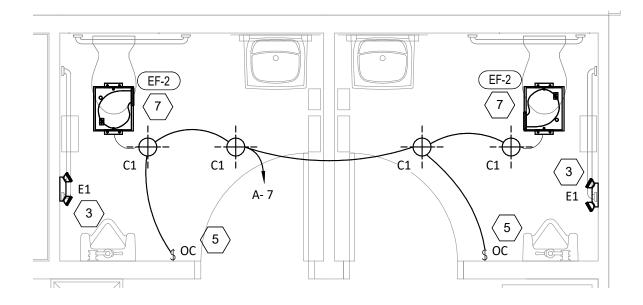





REMARKS UNTING HEIGHT WITH ARCHITECT. REFER URES THAT SHALL BE PROVIDED WITH AN URE. FIXTURES DENOTED WITH 'EM'. HED WITH GU24 SOCKET ADAPTER

MOTE EMERGENCY LIGHT POWERED BY EXIT SIGN WITH MOUNTING PLATE RY BACKUP WITH INTEGRAL EMERGENCY EAD CAPABLE

. COORDINATE FINSIH WITH ARCHITECT.

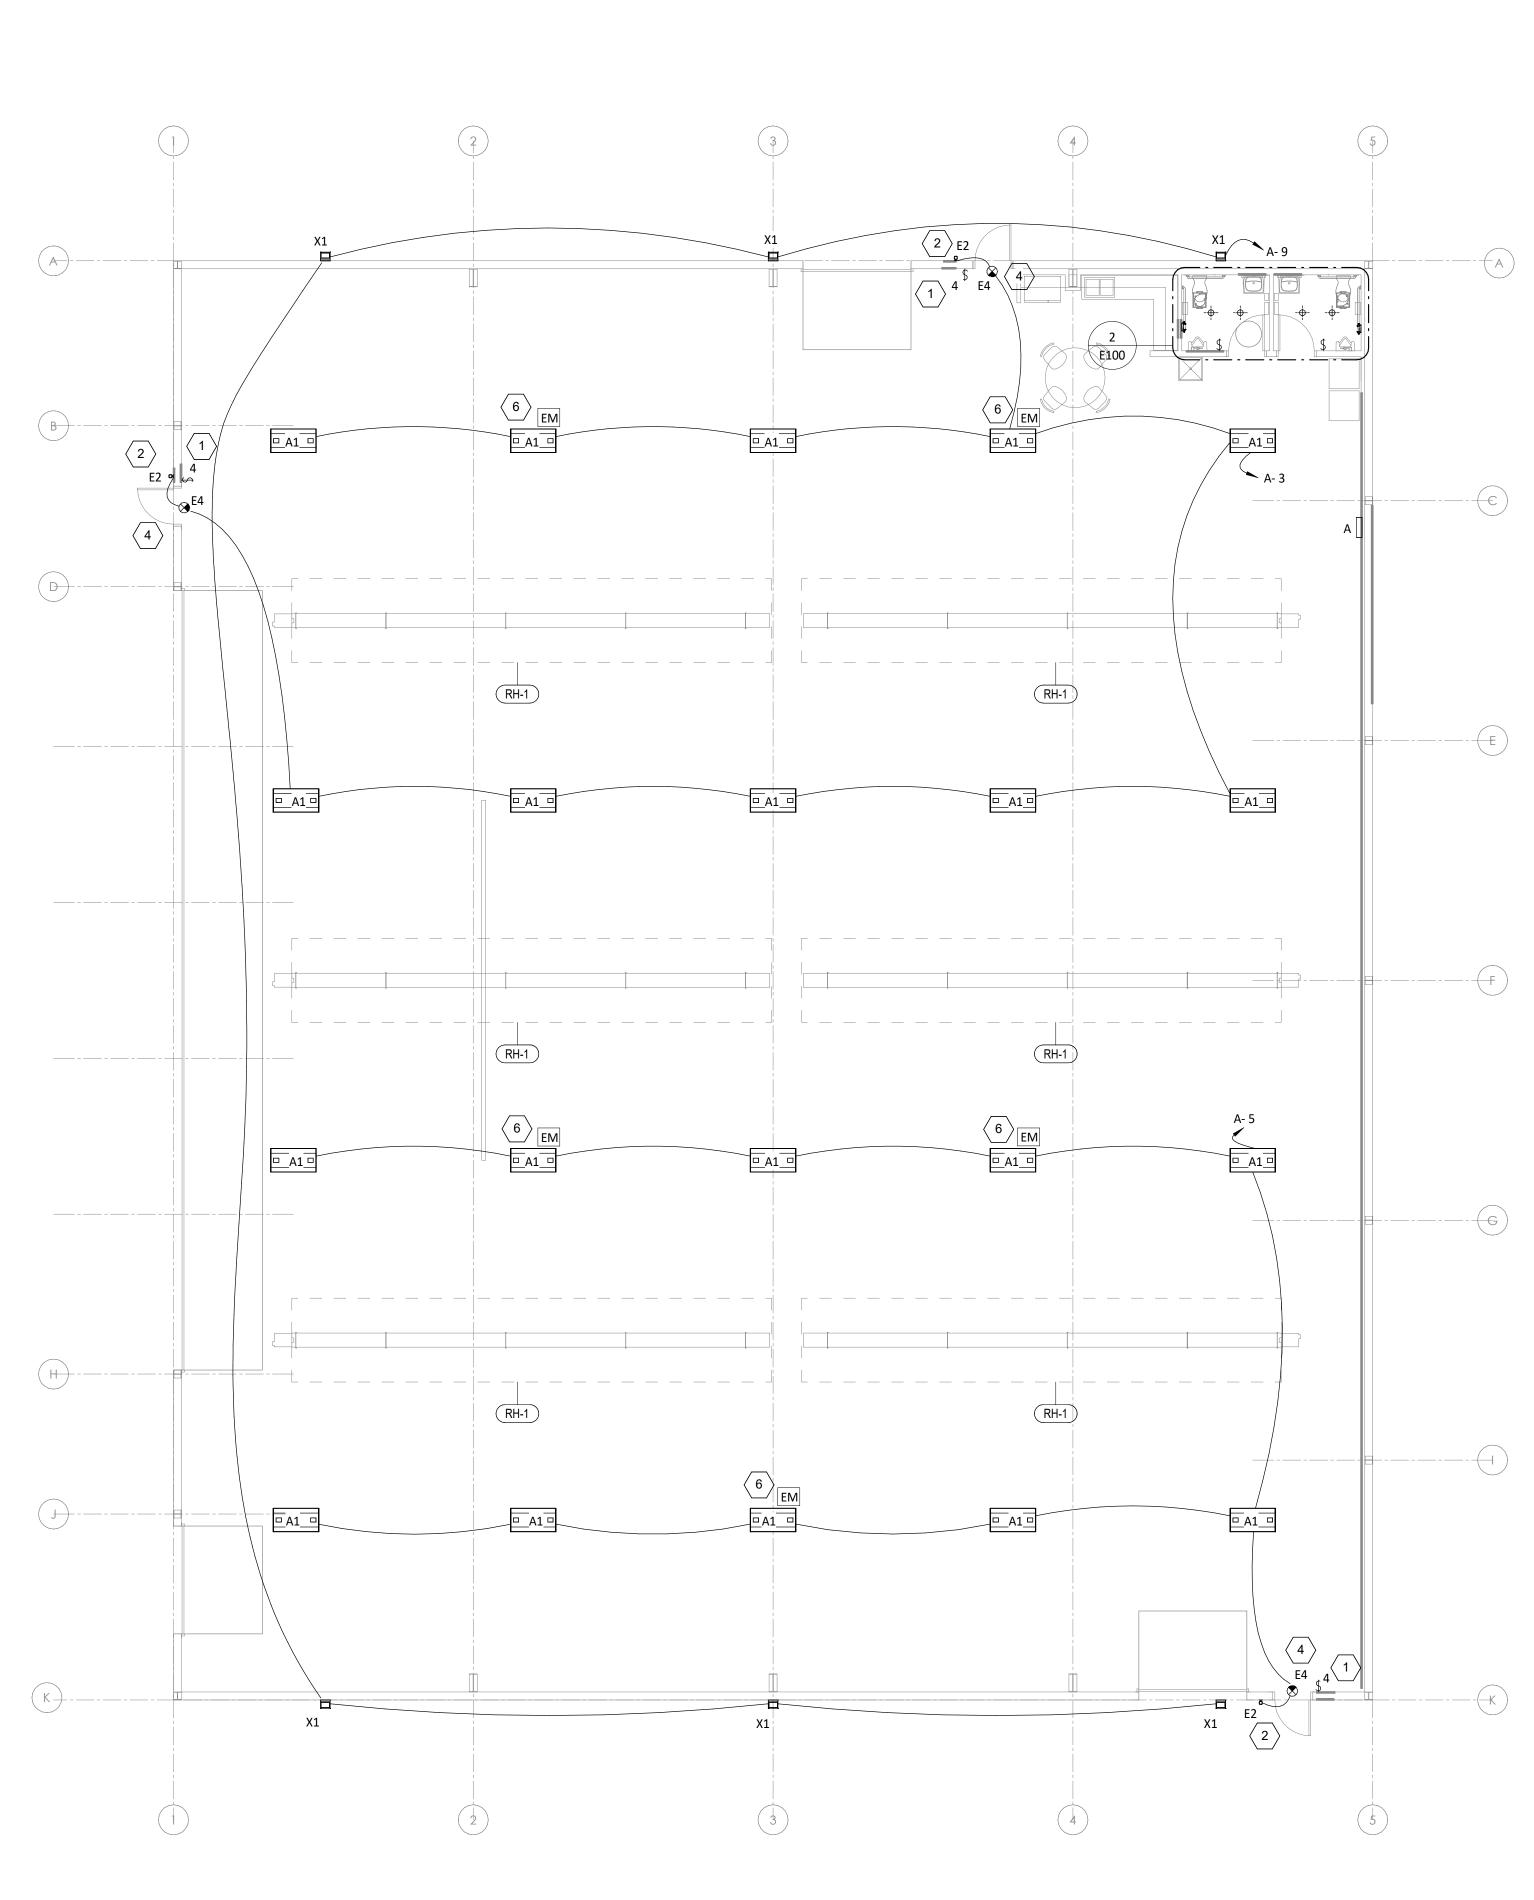

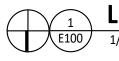

LIGHTING FLOOR PLAN

LLC NEW BUILDING FOR: S MANAGEMENT SERVICES, L STREET ADDRESS TBD LEE'S SUMMIT, MO L N Blanchard AE Group 1425 WAKARUSA DR. STE B LAWRENCE, KS 66049 Ph:785-993-0300 REISSUE DATE ADDENDUM 1 - 05/02/2025 PROFESSIONAL OF RECORD LAURA MICHELLE BLANCHARD COPYRIGHT 2025 C THESE PRINTS ARE THE PROPERTY OF INSIGHT DESIGN A AND SHALL BE USED ONLY FOR THE PROJECT REFERE ARCHITECT RAPP PROJECT NO. 241121 DATE 04/14/2025 DRAWING TITLE ELECTRICAL LIGHTING PLAN SHEET NO. E100