----- FOC_x ----- FIBER OPTIC CABLE - EXISTING

---- OHP_y ---- OVERHEAD POWER LINE - EXIST

----- UGE, ----- UNDERGROUND ELECTRIC - EX.

WATERLINE - EXISTING

LIGHT - EXISTING

EXISTING MANHOLE

EXISTING AREA INLET

EXISTING CURB INLET

EXISTING GRATE INLET

EXISTING JUNCTION BOX

EXISTING STORM MANHOLE

CONNECT TO EXISTING WATER LINE

END OF LINE TEMPORARY FIRE HYDRANT ASSEMBLY

REMOVE AND RELOCATE TEMPORARY FIRE HYDRANT ASSEMBLY

FIRE HYDRANT ASSEMBLY

8" C-900 PVC

8" X 8" TEE

8" GATE VALVE

8 8" 11.25° PVC BEND

9 8" 22.5° PVC BEND

10 8" 45° PVC BEND

EXISTING SANITARY MANHOLE

PROPOSED SANITARY MANHOLE

GAS LINE - EXISTING

——Ty—— TELEPHONE LINE - EXIST.

WATERLINE

CLEANOUT

CITY OF LEES SUMMIT PUBLIC WORKS 220 SE Green Street Lee's Summit, MO 64063 (816) 969-1800

LOCATION

Mark Manion or Marty Loper Kansas City, MO 64106 (816) 275-2341 or (816) 275-1550

COMCAST CABLE John Meadows 4700 Little Blue Parkway Independence, MO 64057 (816) 795-2257

CITY OF LEE'S SUMMIT WATER UTILITIES Mark Schaufler

1200 SE Hamblen Road Lee's Summit, MO 64081 (816) 969-1900

SUMMARY OF QUANTITIES



QUANTITY

UNITS

EΑ

EΑ

EΑ

EΑ LF

EΑ

EΑ

EΑ

EΑ

EΑ

WATER LINE PLANS RETREAT AT BAILEY FARMS, FIRST PLAT

IN THE CITY OF LEE'S SUMMIT JACKSON COUNTY, MISSOURI

ALL CONSTRUCTION TO FOLLOW THE CITY OF LEE'S SUMMIT DESIGN AND CONSTRUCTION MANUAL AS

GENERAL NOTES

- ALL WORKMANSHIP AND MATERIALS SHALL BE SUBJECT TO THE INSPECTION AND APPROVAL OF THE ENGINEERING DEPARTMENT OF THE CITY OF LEE'S SUMMIT, MISSOURI.
- LINEAL FOOT MEASUREMENTS SHOWN ON THE PLANS ARE HORIZONTAL MEASUREMENTS, NOT SLOPE

- EXCAVATION ON PUBLIC RIGHT OF WAY DO SO ONLY AFTER GIVING NOTICE TO, AND OBTAINING INFORMATION FROM, UTILITY COMPANIES. STATE LAW REQUIRES 48 HOURS ADVANCE NOTICE. THE CALL SYSTEM, INC.": 1-800-DIG-RITE. THIS PHONE NUMBER IS APPLICABLE ANYWHERE WITHIN THE STATE OF MISSOURI. PRIOR TO COMMENCEMENT OF WORK, THE CONTRACTOR SHALL NOTIFY ALL THOSE COMPANIES WHICH HAVE FACILITIES IN THE NEAR VICINITY OF THE CONSTRUCTION TO BE PERFORMED.
- THE CONTRACTOR SHALL PROTECT ALL MAJOR TREES FROM DAMAGE. NO TREE SHALL BE REMOVED
- WITHOUT PERMISSION OF THE OWNER, UNLESS SHOWN OTHERWISE. CLEARING AND GRUBBING OPERATIONS AND DISPOSAL OF ALL DEBRIS THEREFROM SHALL BE PERFORMED BY THE CONTRACTOR IN STRICT ACCORDANCE WITH ALL LOCAL CODES AND ORDINANCES.
- ALL WASTE MATERIAL RESULTING FROM THE PROJECT SHALL BE DISPOSED OF OFF-SITE BY THE CONTRACTOR, OR AS DIRECTED BY THE OWNER AT NO ADDITIONAL COST.
- 11. ALL EXCAVATIONS SHALL BE UNCLASSIFIED. NO SEPARATE PAYMENT WILL BE MADE FOR ROCK
- 12. THE CONTRACTOR SHALL CONTROL THE EROSION AND SILTATION DURING ALL PHASED OF CONSTRUCTION AND SHALL KEEP THE STREETS CLEAN OF MUD AND DEBRIS. 13. THE CONTRACTOR SHALL CONTACT DEVELOPMENT SERVICES INSPECTIONS AT: 816-969-1800 TO OBTAIN A DEVELOPMENT SERVICES CONSTRUCTION PERMIT. A MINIMUM 48 HOUR NOTICE SHALL BE GIVEN PRIOR TO
- 14. THE CONTRACTOR SHALL CONTACT THE RIGHT OF WAY INSPECTOR AT 816-969-1800 PRIOR TO ANY LAND DISTURBANCE ACTIVITIES WITHIN THE RIGHT OF WAY. THESE ACTIVITIES MAY REQUIRE A PERMIT.
- THE CONTRACTOR SHALL PROVIDE AND MAINTAIN ALL TRAFFIC HANDLING MEASURES NECESSARY TO ENSURE THAT THE GENERAL PUBLIC IS PROTECTED AT ALL TIMES. TRAFFIC CONTROL SHALL CONFORM TO
- THE MANUAL ON UNIFORM TRAFFIC CONTROL DEVICES (MUTCD-LATEST EDITION). ALL SANITARY SEWER LATERALS SHALL HAVE A TRENCH CHECK, CONSISTING OF FLOWABLE BACKFILL INSTALLED DURING CONSTRUCTION. TRENCH CHECK SHALL EXTEND TO BOTTOM OF TRENCH. TO WIDTH OF TRENCH, TO 12 INCHES ABOVE PIPE, FOR A MINIMUM LENGTH OF 12 INCHES. TRENCH CHECK SHALL BE

LOCATED AT LEAST 5 FEET FROM SANITARY MAIN.

EARTHWORK

- PRIOR TO EARTHWORK ACTIVITIES, PRE-DISTURBANCE EROSION AND SEDIMENT CONTROL DEVICES SHALI BE IN PLACE PER THE STORM WATER POLLUTION PREVENTION PLAN AND/OR THE EROSION AND SEDIMENT
 - ALL BACKFILL MATERIAL SHALL BE PLACED IN MAXIMUM 6-INCH LIFTS AND COMPACTED TO 95-PERCENT OF MAXIMUM DENSITY AS DEFINED USING A STANDARD PROCTOR TEST (AASHTO T99/ASTM 698).
- BACKFILL MATERIALS SHALL NOT INCLUDE ORGANIC MATTER, DEBRIS OR TOPSOIL
- LANDSCAPED AREAS TO A MINIMUM DEPTH OF 6-INCHES BELOW FINAL GRADE.
- ALL AREAS SHALL BE GRADED FOR POSITIVE DRAINAGE. UNLESS NOTED OTHERWISE THE FOLLOWING
- A. TURF AREAS 2.5% MINIMUM, 4H:1V MAXIMUM
- DEVICES SHALL BE PROPERLY MAINTAINED AND KEPT CLEAN OF SILT AND DEBRIS AND IN GOOD WORKING

New City Requirements:

Flowable fill required per City

specifications at all water structures.

- EXISTING UTILITIES HAVE BEEN SHOWN TO THE GREATEST EXTENT POSSIBLE BASED UPON INFORMATION PROVIDED TO THE ENGINEER. THE CONTRACTOR IS RESPONSIBLE FOR CONTACTING THE RESPECTIVE UTILITY COMPANIES AND FIELD LOCATING UTILITIES PRIOR TO CONSTRUCTION AND IDENTIFYING ANY POTENTIAL CONFLICTS. ALL CONFLICTS SHALL IMMEDIATELY BE BROUGHT TO THE ATTENTION OF THE
- THE CONTRACTOR SHALL BE RESPONSIBLE FOR COORDINATING ANY REQUIRED UTILITY RELOCATIONS. UTILITIES DAMAGED THROUGH THE NEGLIGENCE OF THE CONTRACTOR SHALL BE REPAIRED AT THE
- CONTRACTOR SHALL VERIFY FLOW-LINES AND STRUCTURE TOPS PRIOR TO CONSTRUCTION, AND SHALL NOTIFY ENGINEER OF ANY DISCREPANCIES. PROVIDE SHOP DRAWINGS FOR ALL PRECAST AND MANUFACTURED UTILITY STRUCTURES FOR REVIEW BY THE ENGINEER PRIOR TO CONSTRUCTION OF THE
- SEPARATION FROM ALL SANITARY AND STORM SEWER LINES. IF MINIMUM SEPARATIONS CAN NOT BE OBTAINED, DUCTILE IRON PIPE, DIP, SHALL BE REQUIRED 10 FEET IN EACH DIRECTION OF THE CONFLICT ON
- 5. PAYMENT FOR TRENCHING, BACKFILLING, PIPE EMBEDMENT, FLOWABLE FILL, BACKFILL MATERIALS, CLEAN UP, SEEDING, SODDING AND ANY OTHER ITEMS NECESSARY FOR THE CONSTRUCTION OF THE UTILITY LINE
- 6. THE CONTRACTOR SHALL BE RESPONSIBLE FOR CONTACTING RESPECTIVE UTILITY COMPANIES 48-HOURS IN ADVANCE FOR THE INSPECTION OF ANY PROPOSED UTILITY MAIN EXTENSION OR SERVICE LINE OR SERVICE
- PREVENT SATURATION AND EXCESS SEDIMENT RUNOFF. UNSUITABLE MATERIALS, ROCK AND SHALE, ASPHALT, CONCRETE, TREES, BRUSH ETC. SHALL BE PROPERLY DISPOSED OF OFFSITE. MATERIALS MAY BE WASTED ONSITE AT THE DIRECTION OF THE OWNER OR HIS APPOINTED REPRESENTATIVE.

- CONTROL PLAN PREPARED FOR THIS SITE.
- THE CONTRACTOR SHALL BE RESPONSIBLE FOR REDISTRIBUTING THE TOPSOIL OVER PROPOSED TURF AND
- GRADES SHALL APPLY:

- ORDER. ADDITIONAL EROSION AND SEDIMENT CONTROL MEASURES SHALL BE INSTALLED AS REQUIRED.

- 4. UTILITY SEPARATION: WATERLINES SHALL HAVE A MINIMUM OF 10 FEET HORIZONTAL AND 2 FEET VERTICAL
- SHALL BE INCLUDED IN THE CONTRACT PRICE FOR THE UTILITY INSTALLATION.
- CONNECTION TO ANY EXISTING MAIN.
- 7. TRENCH SPOILS SHALL BE NEATLY PLACED ONSITE ADJACENT TO THE TRENCH, AND COMPACTED TO

APPROVED BY

CITY ENGINEER APPROVED FOR ONE YEAR FROM THIS DATE

Sheet List Table

COVER SHEET

GENERAL LAYOUT

WATER LINE DETAILS

Sheet Title

WATER LINE 8 PLAN AND PROFILE

WATER LINE 10 PLAN AND PROFILE

WATER LINE 12 PLAN AND PROFILE

Sheet Number

OWNER/DEVELOPER

CLAYTON PROPERTIES GROUP, INC., DBA SUMMIT HOMES DBA SUMMIT HOMES BRADLEY KEMPF 120 SE 30TH STREET

LEE'S SUMMIT, MO 64082 p (816) 246-6700

RECORD DRAWING

The information provided on this drawing conforms to construction records; it is not intended for construction, implementation or recording purposes; and it is solely based on information obtained by Schlagel and Associates.

"100.00 100.10", "1.00% 1.15% slope", or "8-inch HDPE PVC pipe" are all typical examples of revisions that indicate that design data has been replaced with "as-built" information. All other data is as designed and has not been field verified.

Date: 3/19/2025 Certified by: JLL Title: Senior Project Engineer Firm: Schlagel and Associates, P.A.

BM JA-45, IS A KC METRO ALUMINUM GRS DISK SET IN CONCRETE AND ABOUT 3 INCHES BELOW THE PAVEMENT ON THE SHOULDER OF SE

PROJECT BENCHMARK:

Brass Disk at the Northeast Corner of the Northeast One-Quarter of Section 16, Township 47 N, Range 31 W. Intersection of SE. Bailey Road and SE. Ranson


ELEV. = 939.19

MISSOURI GEOGRAPHIC REFERENCE SYSTEM **BENCHMARK:**

RANSON ROAD. IT IS STAMPED JA45, 1987.

ELEV. = 1046.25




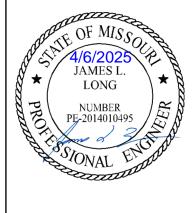

SCHLAGEL & ASSOCIATES, P.A.

COVER SHEET

SHEET

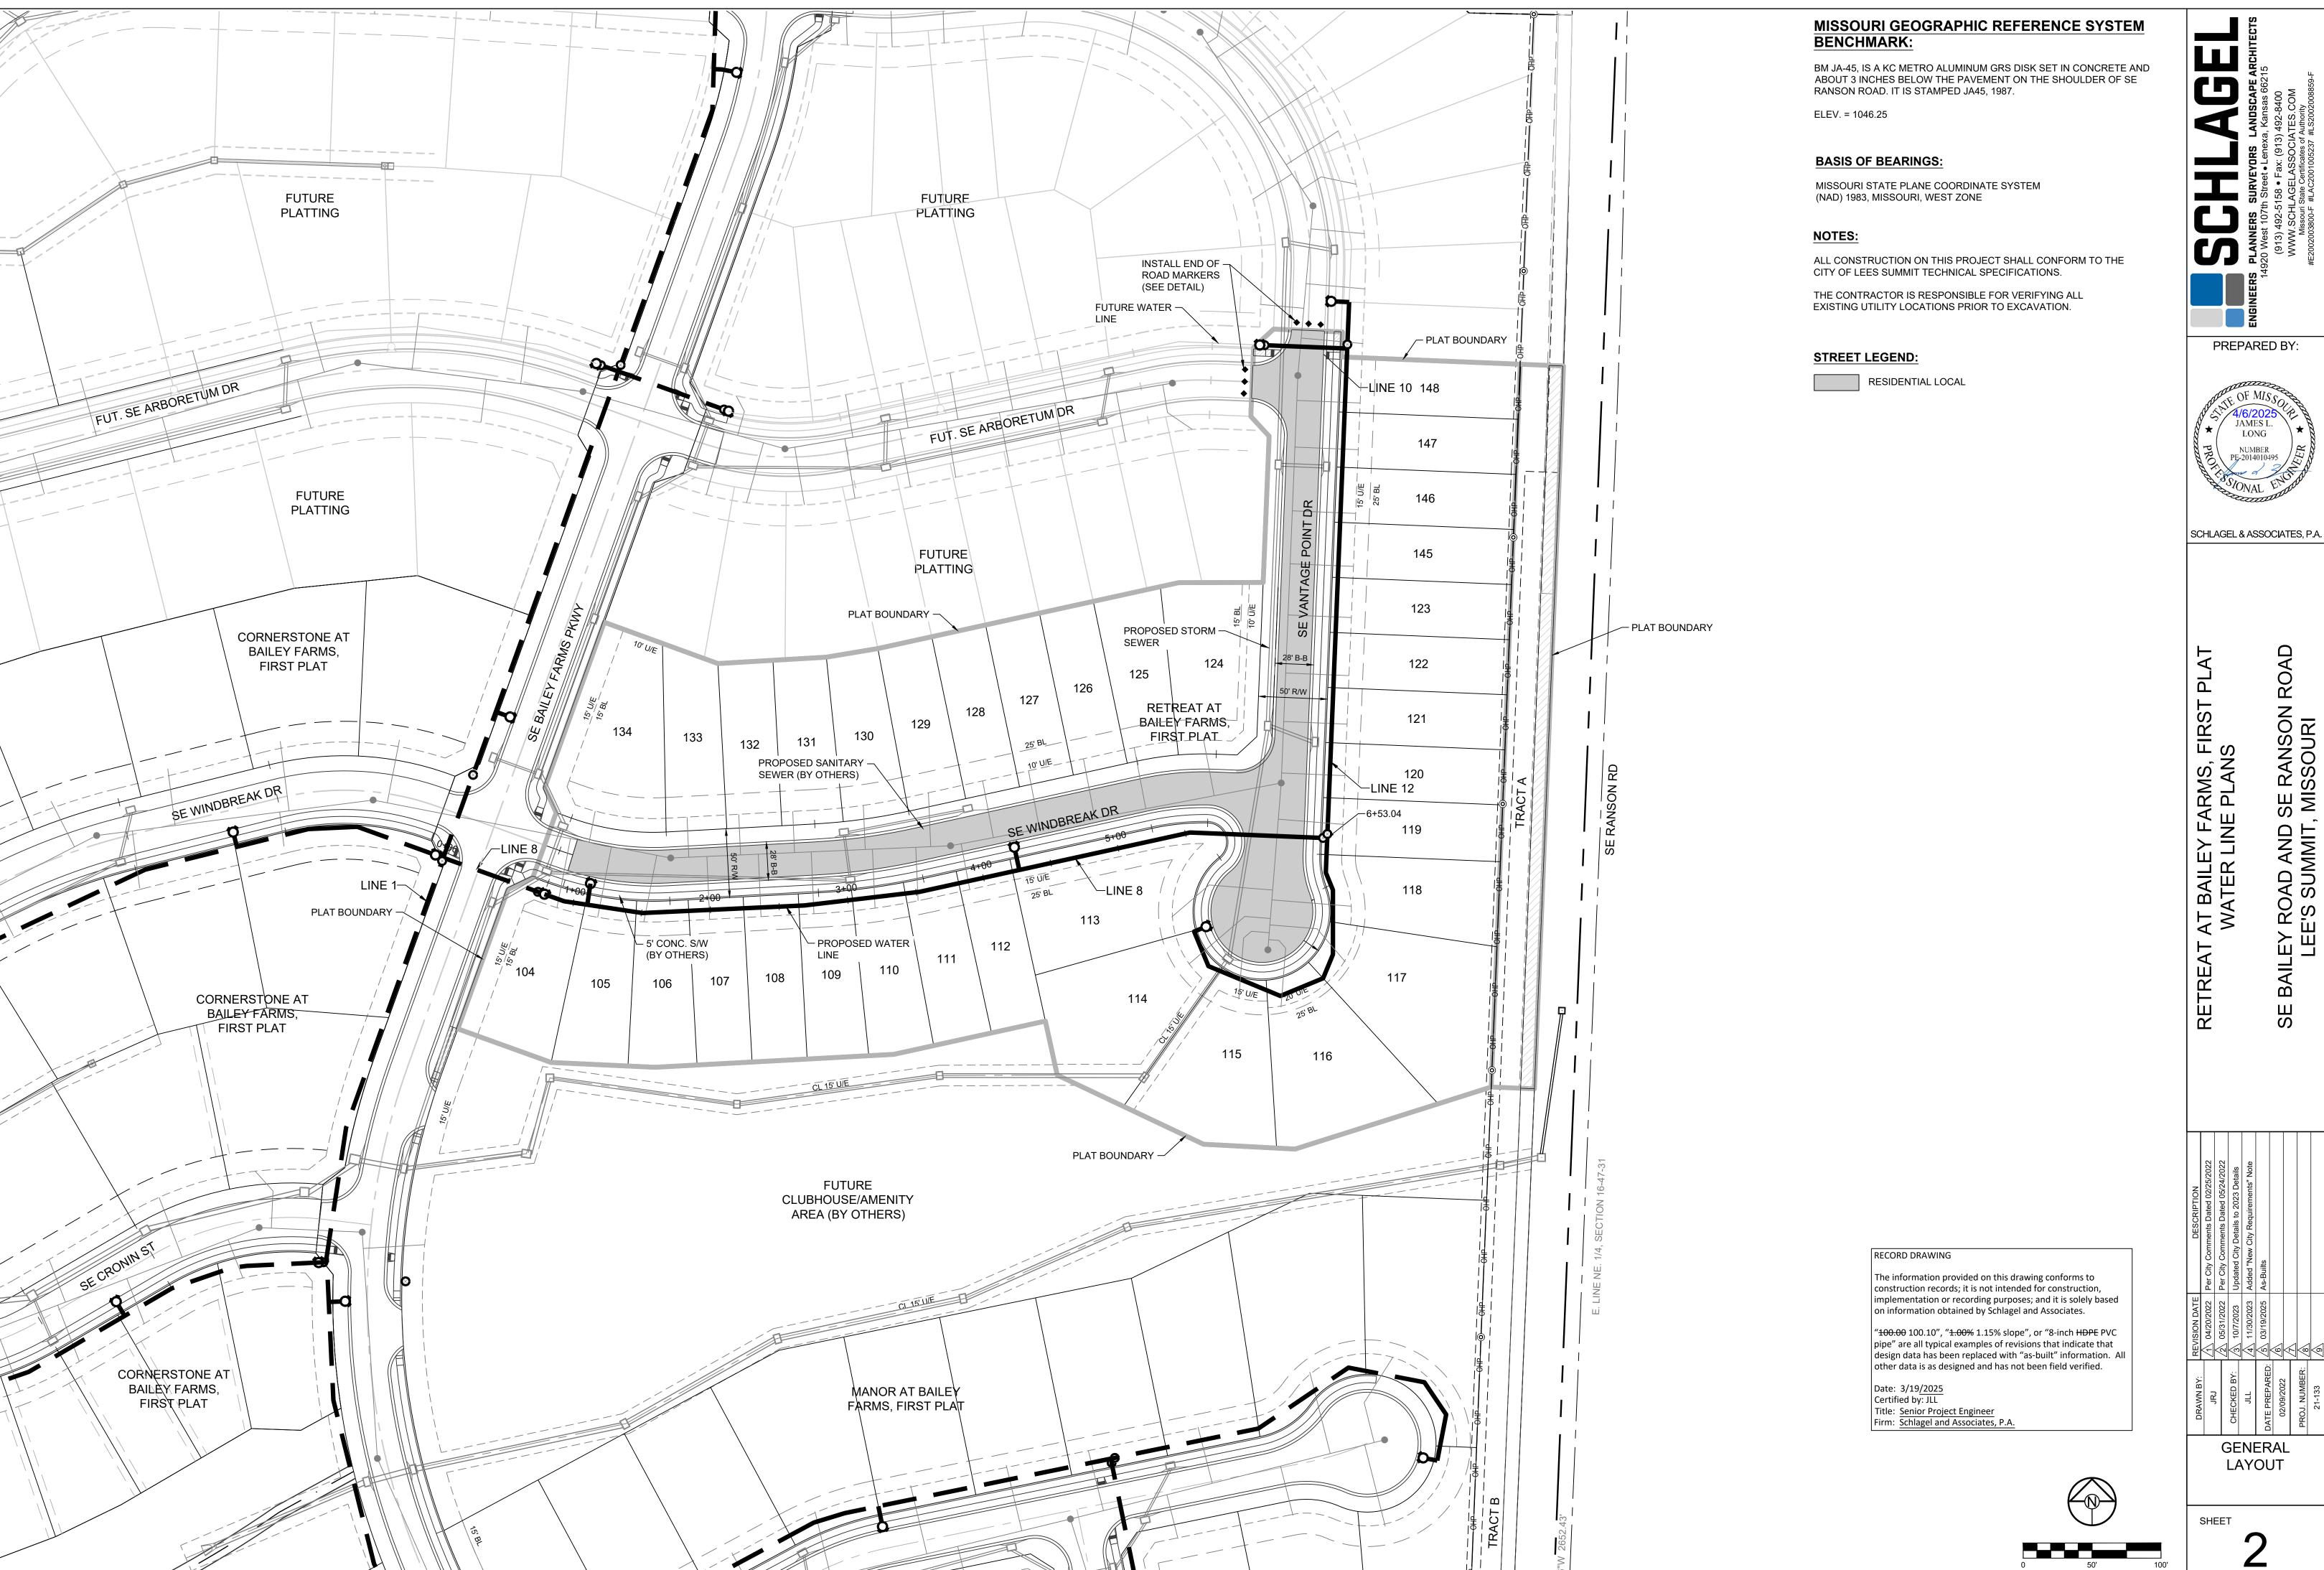

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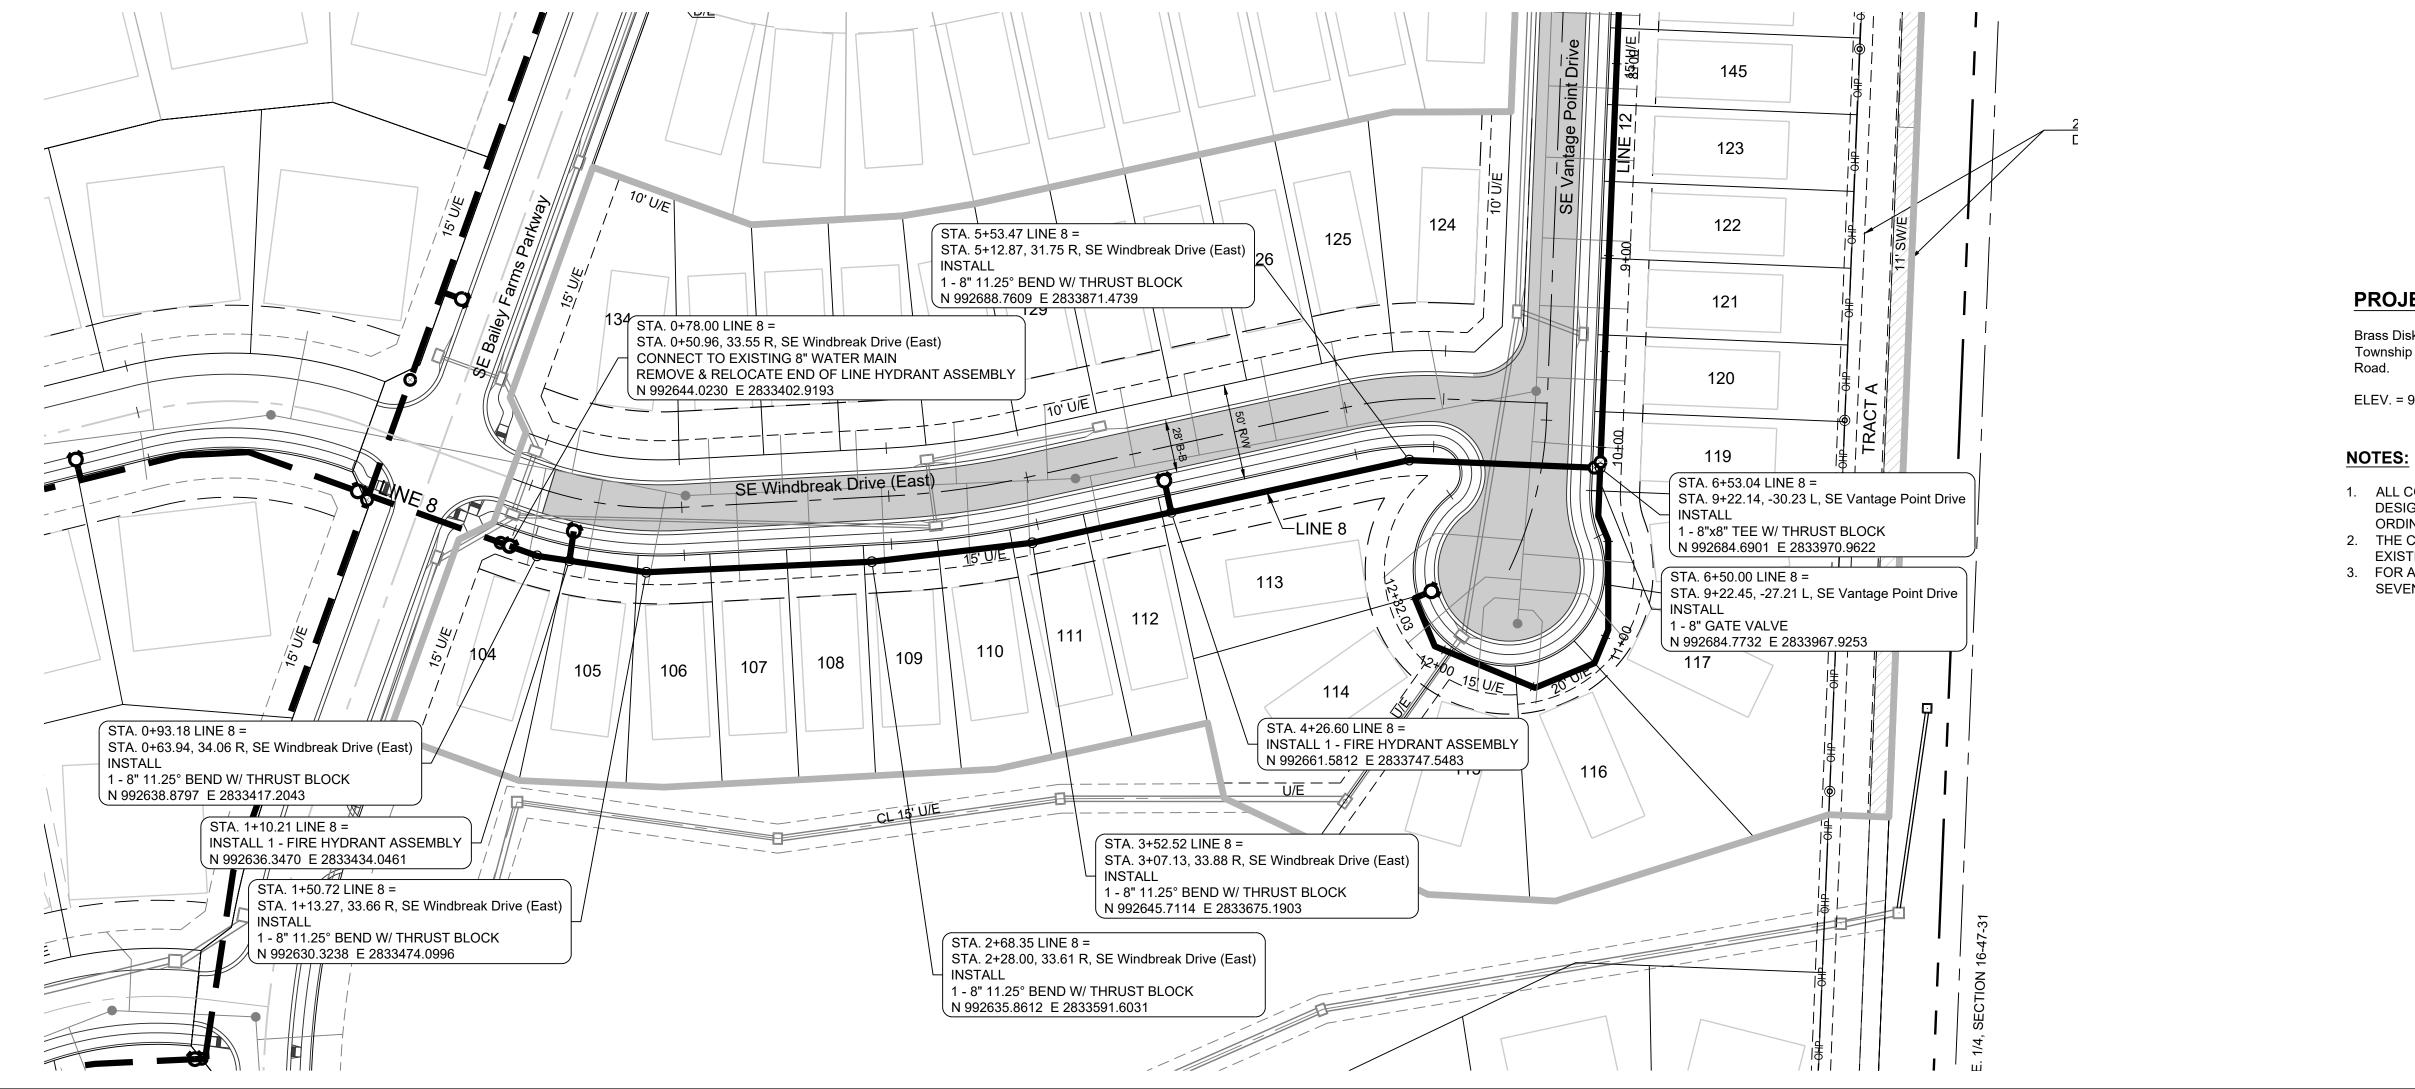
ROAD

GENERAL

LAYOUT

SHEET

SCALE: 1" = 50'



PROJECT BENCHMARK:

Brass Disk at the Northeast Corner of the Northeast One-Quarter of Section 16, Township 47 N, Range 31 W. Intersection of SE. Bailey Road and SE. Ranson

ELEV. = 939.19

- 1. ALL CONSTRUCTION TO FOLLOW THE CITY OF LEE'S SUMMIT DESIGN AND CONSTRUCTION MANUAL AS ADOPTED BY ORDINANCE 5813.
- 2. THE CONTRACTOR IS RESPONSIBLE FOR VERIFYING ALL EXISTING UTILITY LOCATIONS PRIOR TO EXCAVATION.
- 3. FOR ALL WATER LINES THE MAXIMUM DEPTH OF COVER IS SEVEN (7) FEET.

JAMES L. LONG

PREPARED BY:

SCHLAGEL & ASSOCIATES, P.A.

SUMMI

SCALE: 1" = 50'

RETREAT

 $\mathbf{\Omega}$

WATER LINE 8 PLAN AND PROFILE

SHEET


LINE 8 1" = 50' HORIZ. 1" = 10' VERT. 1050 1040 PROPOSED GRADE -1030 1030 EXISTING GRADE 1020 18" Storm PLACE MINIMUM 1.5 FEET -OF COMPACTED SOIL CENTER SECTION OF PIPE OVER STORM FL=1019.02 EXISTING 8" —/ WATER LINE ABOVE TOP OF PIPE ELEVATION PRIOR TO STA. 6+17 24" Storm 1010 8" Sanitary Sewer FL=1012.01 TRENCHING AND FL=1013.82 INSTALLATION. 1000 575 LF - 8" C-900 PVC PIPE 990 0+00 1+00 2+00 3+00 4+00 5+00 6+00 7+00 8+00

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Date: 3/19/2025
Certified by: JLL
Title: Senior Project Engineer
Firm: Schlagel and Associates, P.A.




PROJECT BENCHMARK:

Brass Disk at the Northeast Corner of the Northeast One-Quarter of Section 16, Township 47 N, Range 31 W. Intersection of SE. Bailey Road and SE. Ranson Road

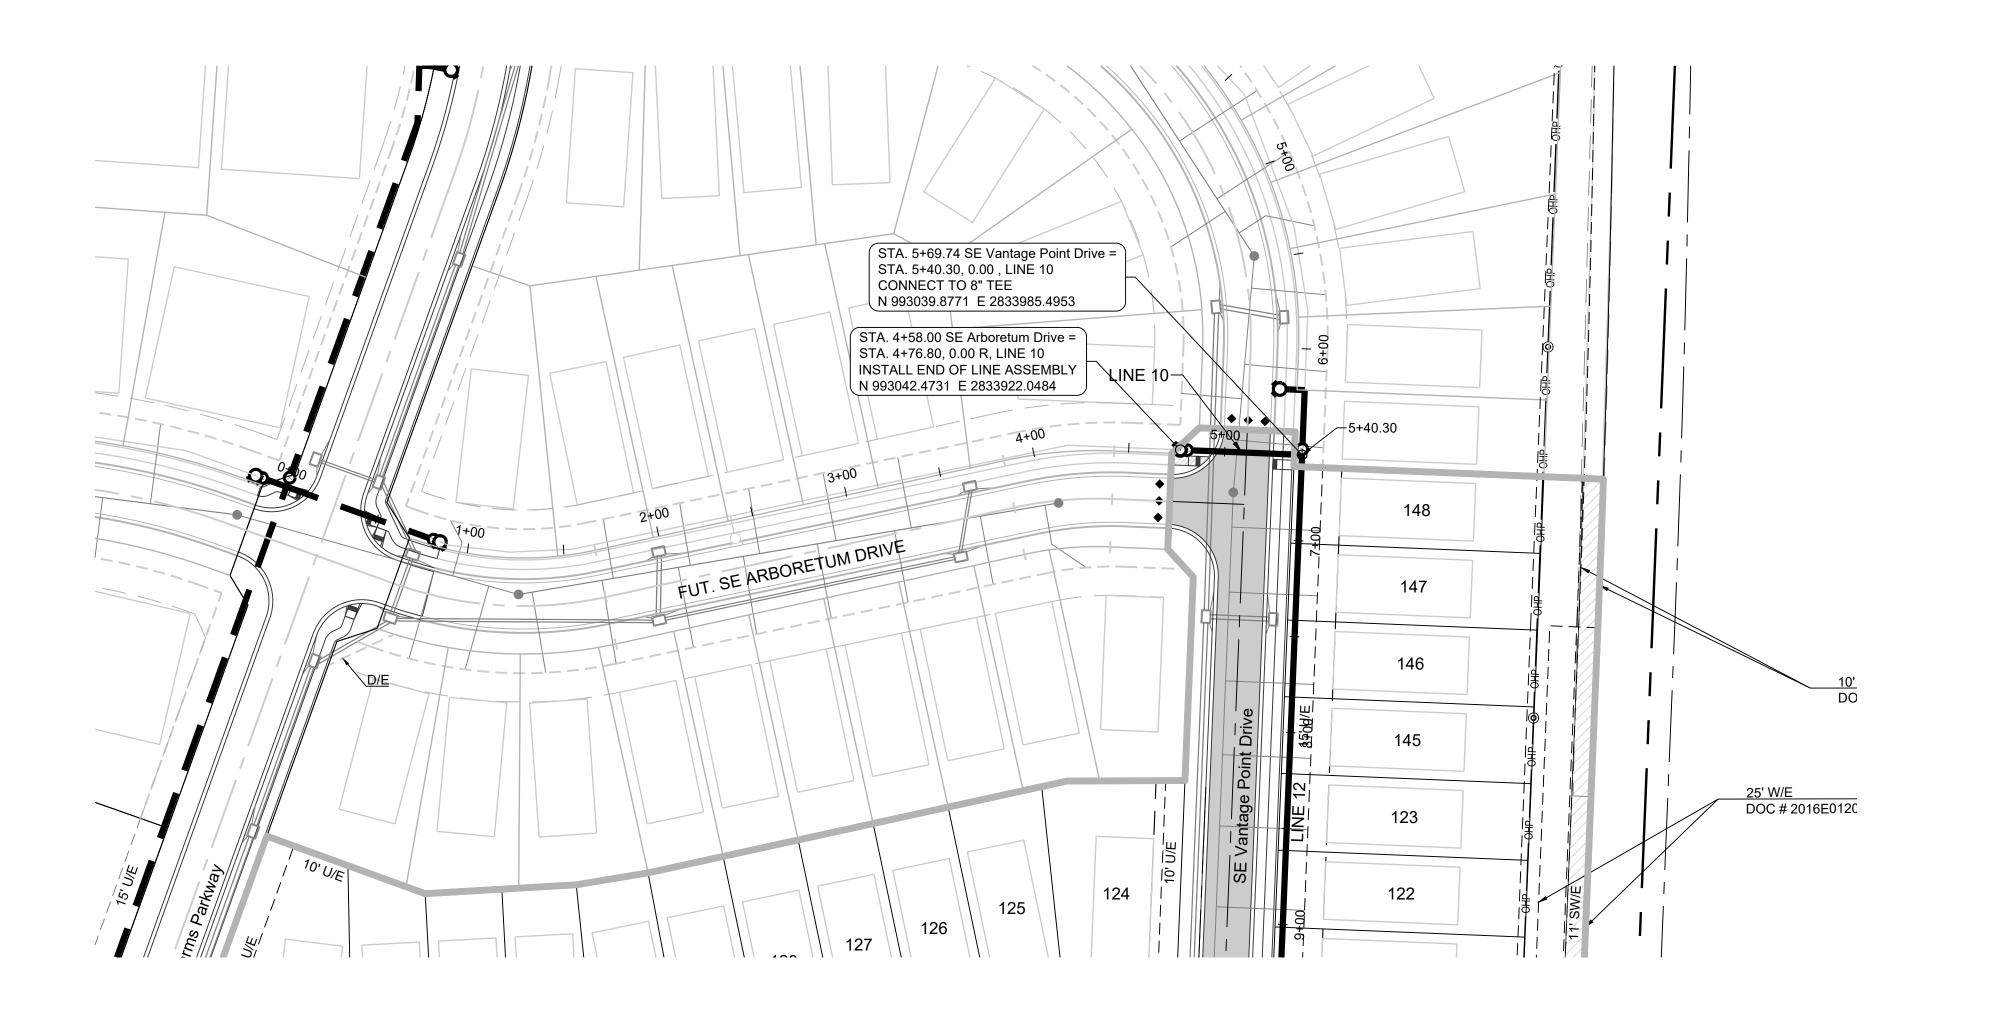ELEV. = 939.19

NOTES:


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- 3. FOR ALL WATER LINES THE MAXIMUM DEPTH OF COVER IS SEVEN (7) FEET.

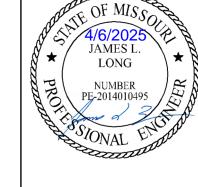

PREPARED BY:

SCHLAGEL & ASSOCIATES, P.A.

ROAD

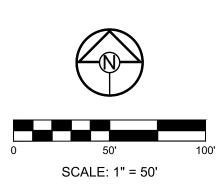

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RETREAT


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CHECKED IN JILL DATE PREPA

WATER LINE 10 PLAN AND PROFILE

SHEET

4

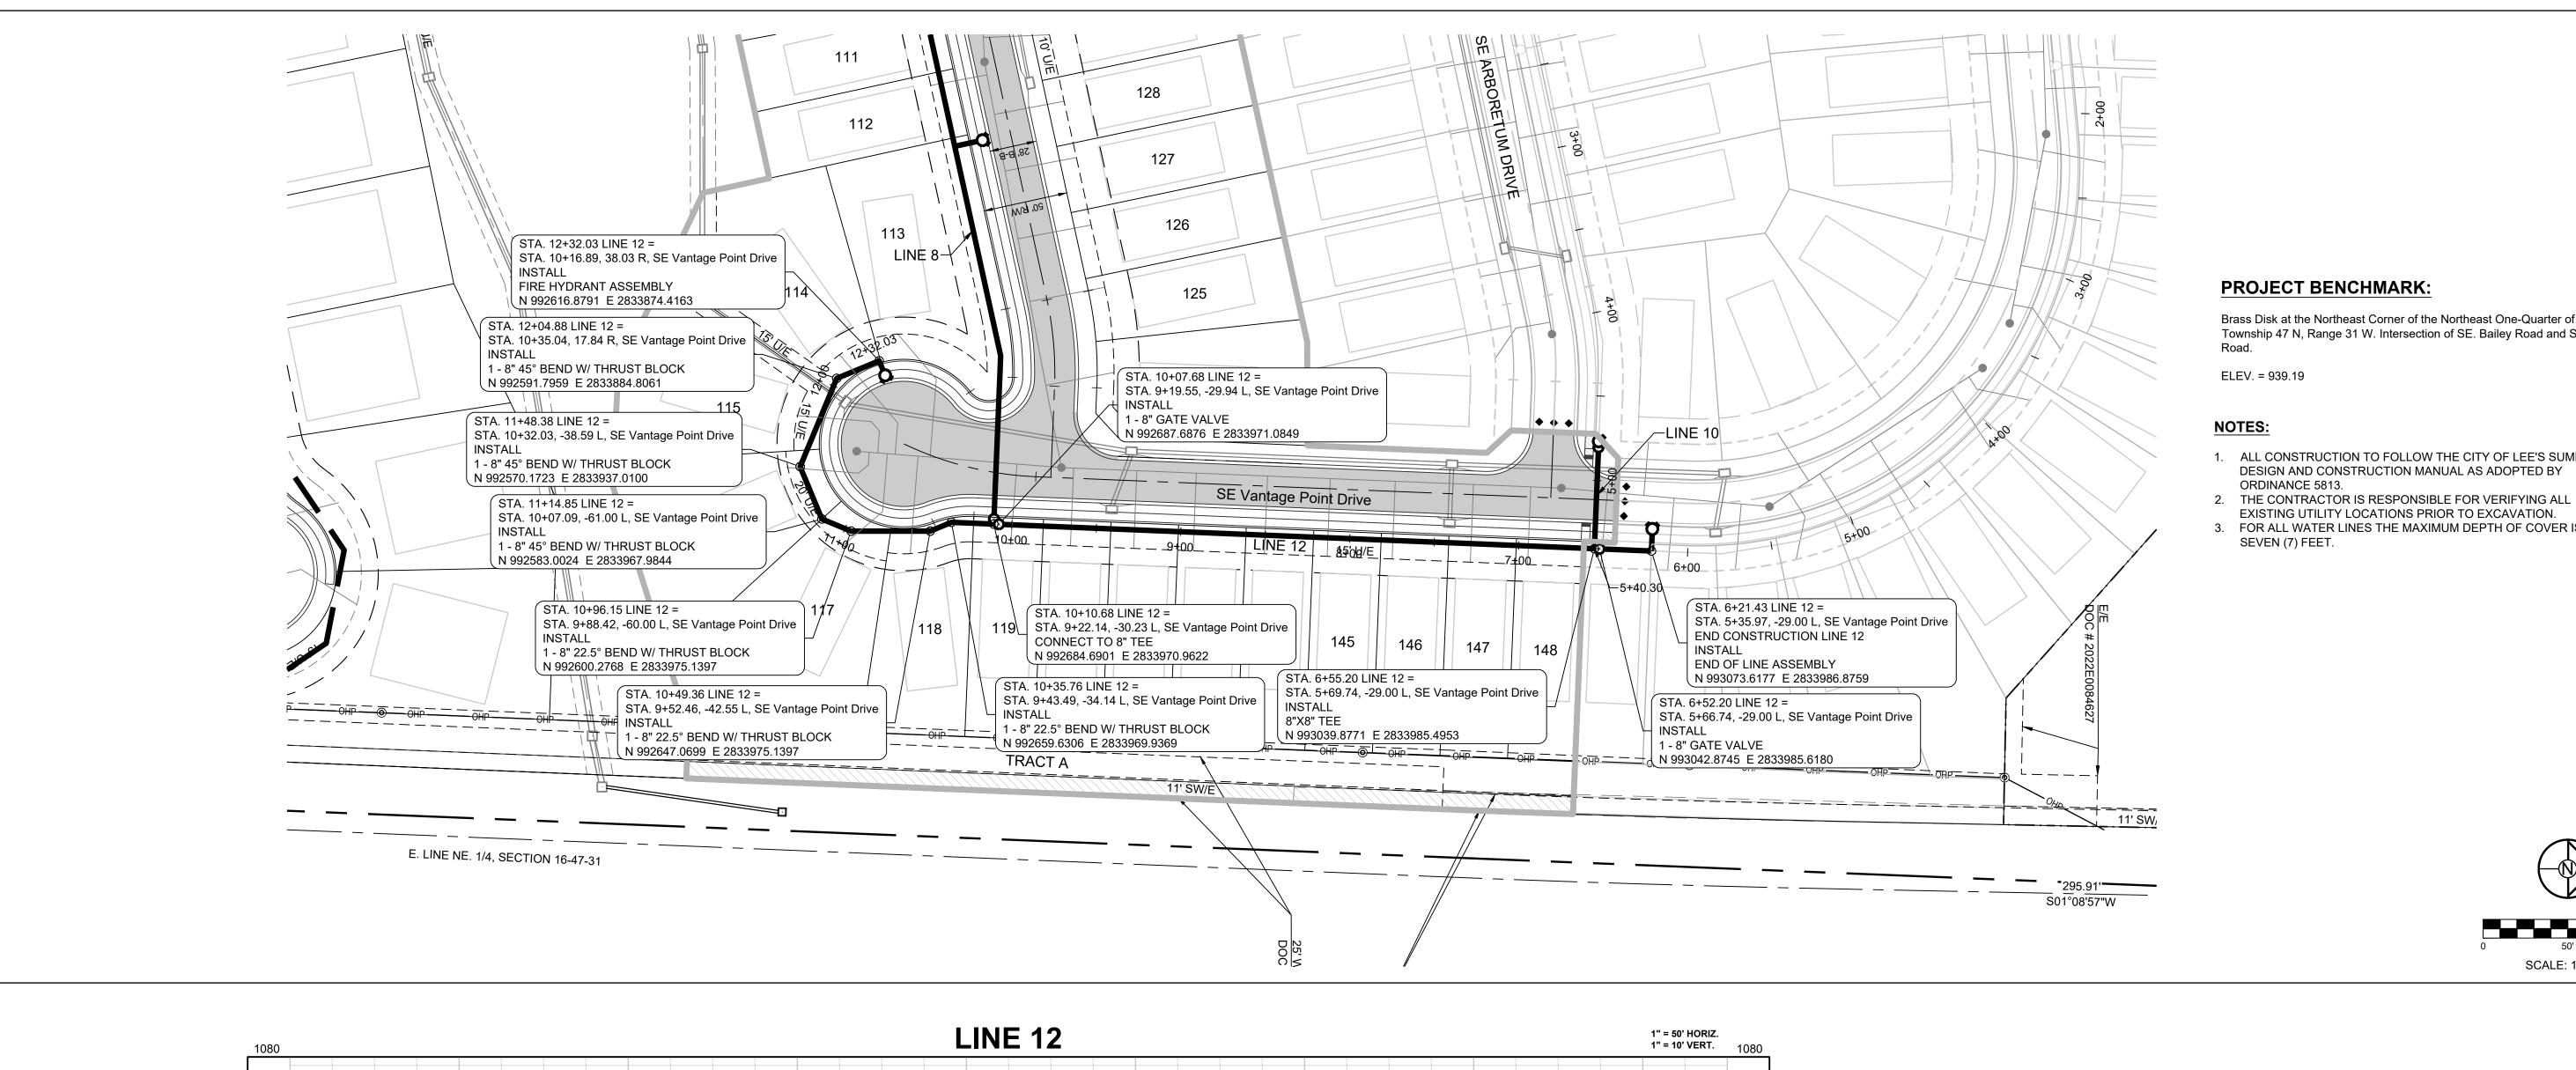

Brass Disk at the Northeast Corner of the Northeast One-Quarter of Section 16, Township 47 N, Range 31 W. Intersection of SE. Bailey Road and SE. Ranson

- 1. ALL CONSTRUCTION TO FOLLOW THE CITY OF LEE'S SUMMIT DESIGN AND CONSTRUCTION MANUAL AS ADOPTED BY
- 3. FOR ALL WATER LINES THE MAXIMUM DEPTH OF COVER IS



PREPARED BY:

SCHLAGEL & ASSOCIATES, P.A.

RETREAT $\mathbf{\Omega}$

SCALE: 1" = 50'

The information provided on this drawing conforms to

pipe" are all typical examples of revisions that indicate that design data has been replaced with "as-built" information. All other data is as designed and has not been field verified.

Title: Senior Project Engineer Firm: Schlagel and Associates, P.A.

RECORD DRAWING

Date: 3/19/2025

Certified by: JLL

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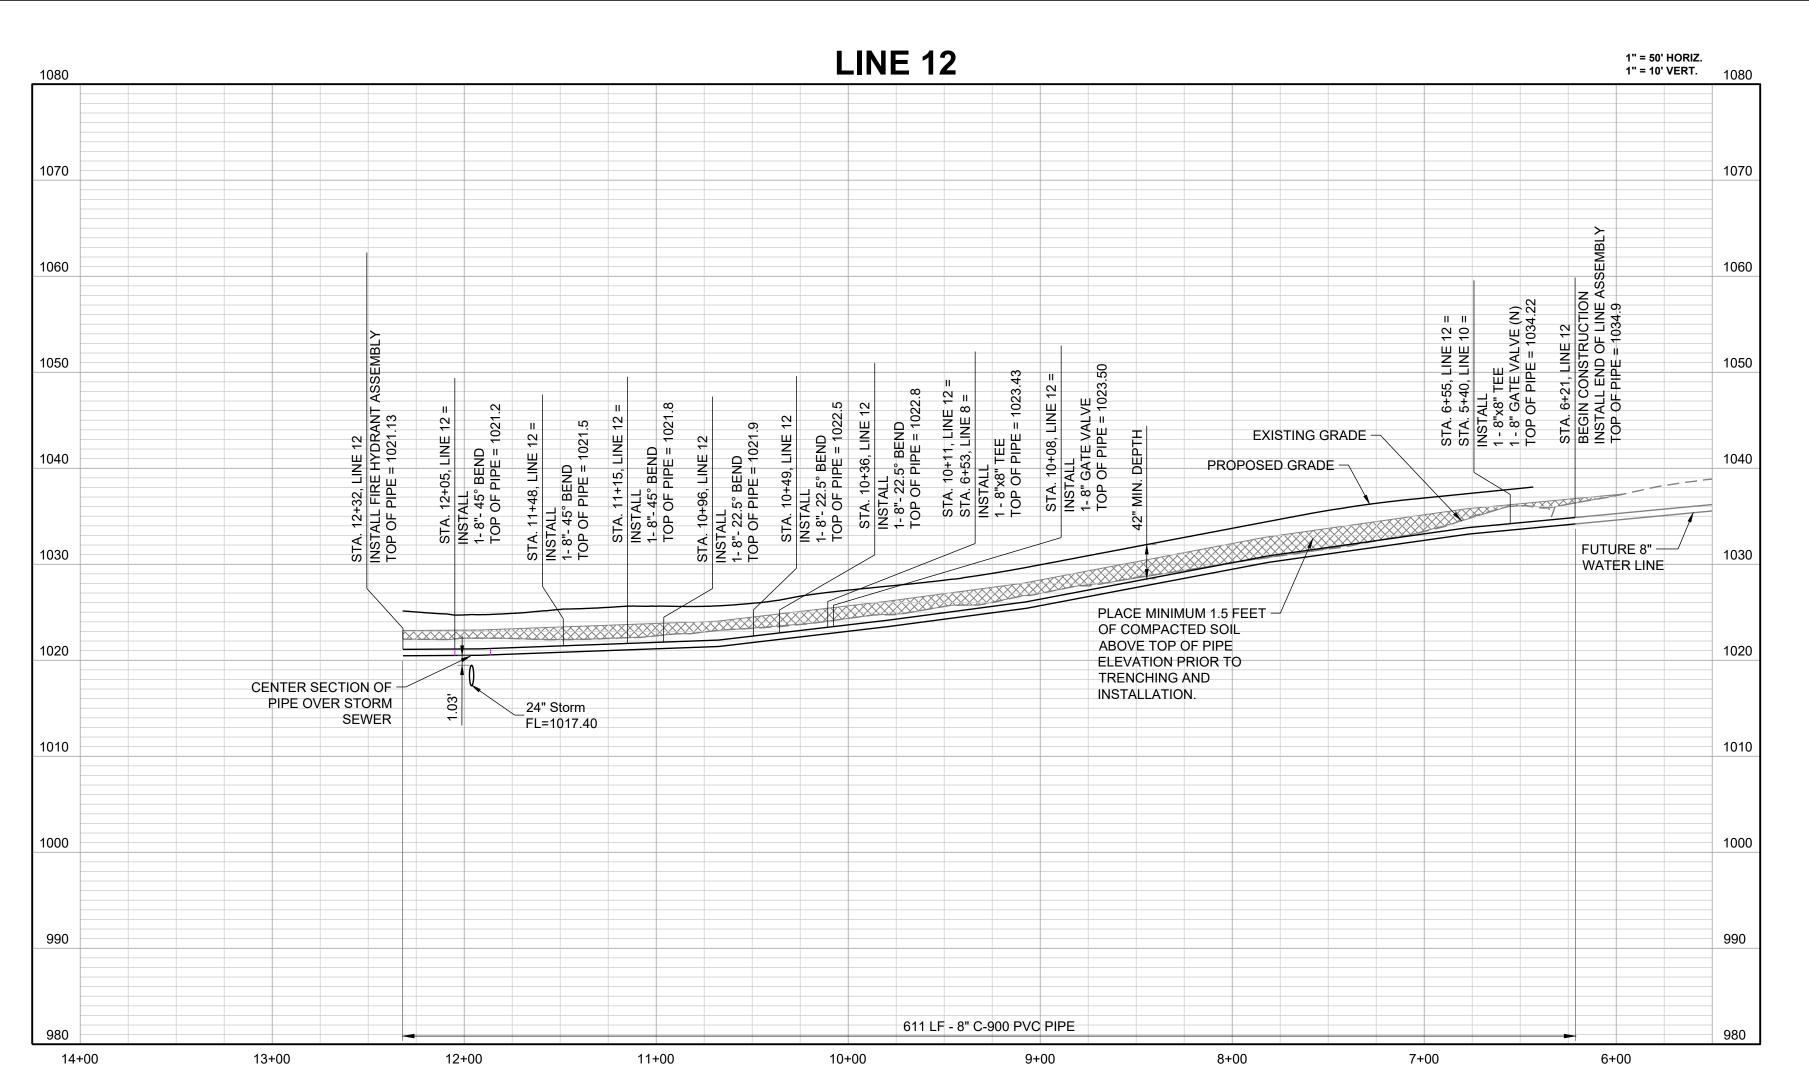
"100.00 100.10", "1.00% 1.15% slope", or "8-inch HDPE PVC


SHEET

WATER LINE 12

PLAN AND

PROFILE



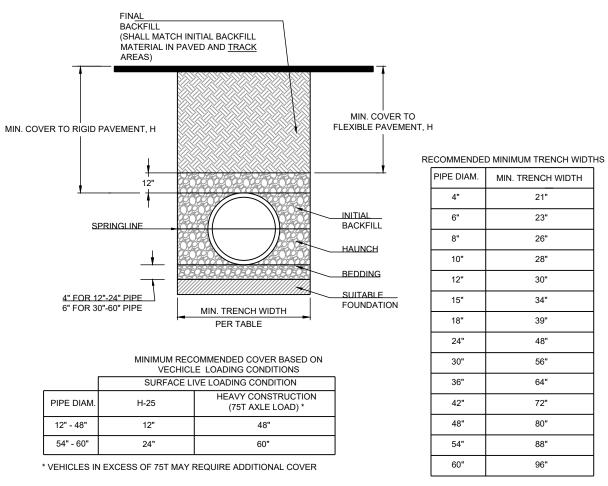

NOTES:

ASTM D2321, LATEST EDITION.

1. ALL PIPE SYSTEMS SHALL BE INSTALLED IN ACCORDANCE WITH ASTM D2321, "STANDARD PRACTICE FOR UNDERGROUND INSTALLATION OF THERMOPLASTIC PIPE FOR SEWERS AND OTHER GRAVITY FLOW APPLICATIONS", LATEST EDITION


2. MEASURES SHOULD BE TAKEN TO PREVENT MIGRATION OF NATIVE FINES INTO BACKFILL MATERIAL, WHEN REQUIRED.

3. <u>FOUNDATION:</u> WHERE THE TRENCH BOTTOM IS UNSTABLE, THE CONTRACTOR SHALL EXCAVATE TO A DEPTH REQUIRED BY THE ENGINEER AND REPLACE WITH SUITABLE MATERIAL AS SPECIFIED BY THE ENGINEER. AS AN ALTERNATIVE AND AT THE DISCRETION OF THE DESIGN ENGINEER, THE TRENCH BOTTOM MAY BE STABILIZED USING A GEOTEXTILE MATERIAL.


4. BEDDING: SUITABLE MATERIAL SHALL BE CLASS I, II OR III. THE CONTRACTOR SHALL PROVIDE DOCUMENTATION FOR MATERIAL SPECIFICATION TO ENGINEER. UNLESS OTHERWISE NOTED BY THE ENGINEER, MINIMUM BEDDING THICKNESS SHALL BE 4" (100mm) FOR 4"-24" (100mm-600mm); 6" (150mm) FOR 30"-60" (750mm-900mm).

5. <u>INITIAL BACKFILL:</u> SUITABLE MATERIAL SHALL BE CLASS I, II OR III IN THE PIPE ZONE EXTENDING NOT LESS THAN 6" ABOVE CROWN OF PIPE. THE CONTRACTOR SHALL PROVIDE DOCUMENTATION FOR MATERIAL SPECIFICATION TO ENGINEER. MATERIAL SHALL BE INSTALLED AS REQUIRED IN


6. MINIMUM COVER: MINIMUM COVER, H, IN NON-TRAFFIC APPLICATIONS (GRASS OR LANDSCAPE AREAS) IS 12" FROM THE TOP OF PIPE TO GROUND SURFACE. ADDITIONAL COVER MAY BE REQUIRED TO PREVENT FLOATION. FOR TRAFFIC APPLICATIONS, MINIMUM COVER, H, IS 12" UP TO 48" DIAMETER PIPE AND 24" OF COVER FOR 54"-60" DIAMETER PIPE, MEASURED FROM TOP OF PIPE TO BOTTOM OF FLEXIBLE PAVEMENT OR TO TOP OF

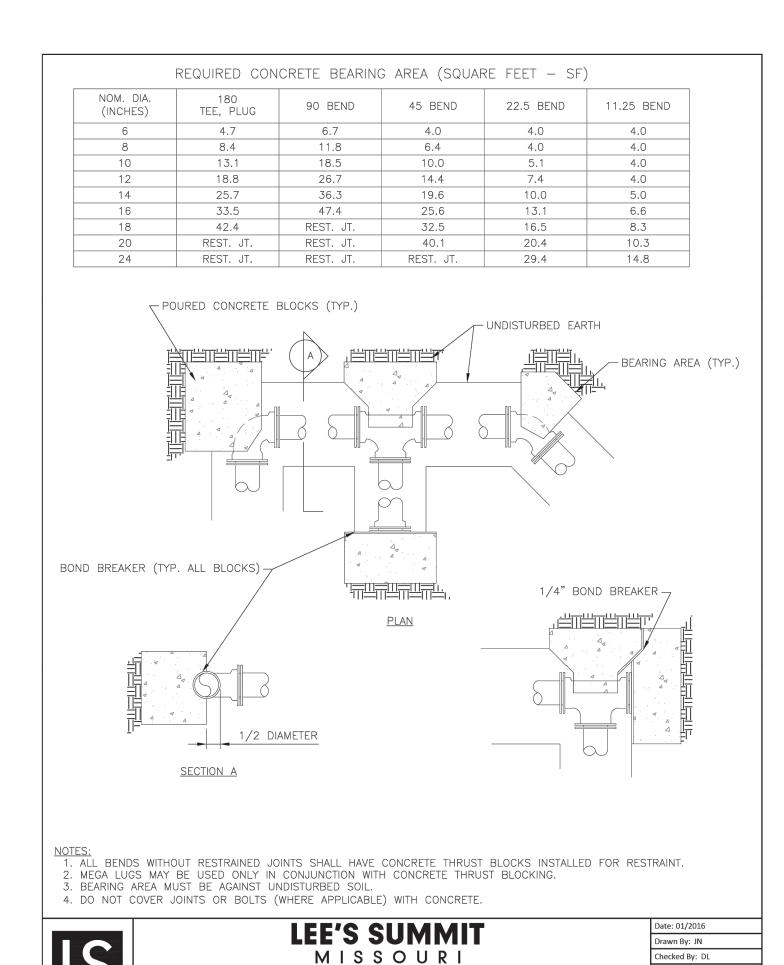



HORIZONTAL THRUST BLOCK

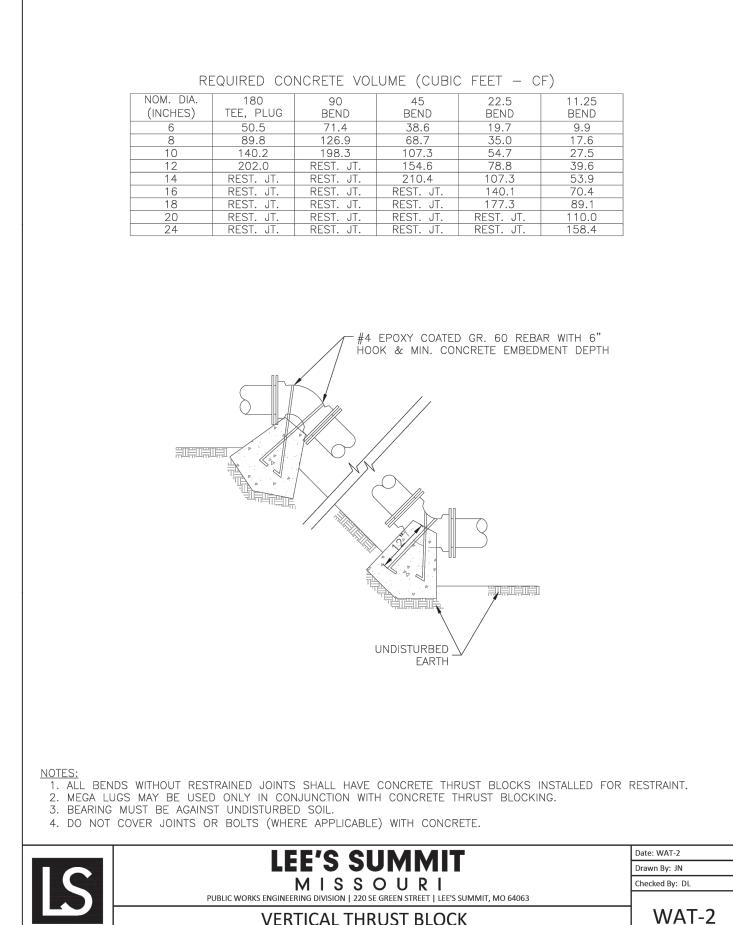


VERTICAL THRUST BLOCK

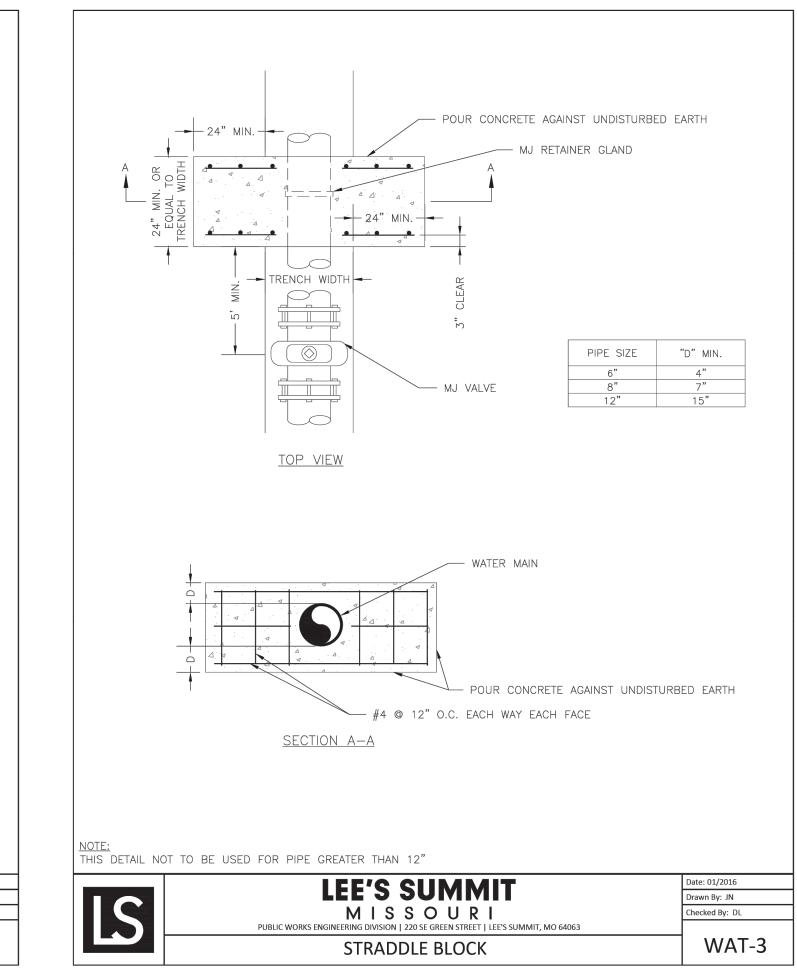

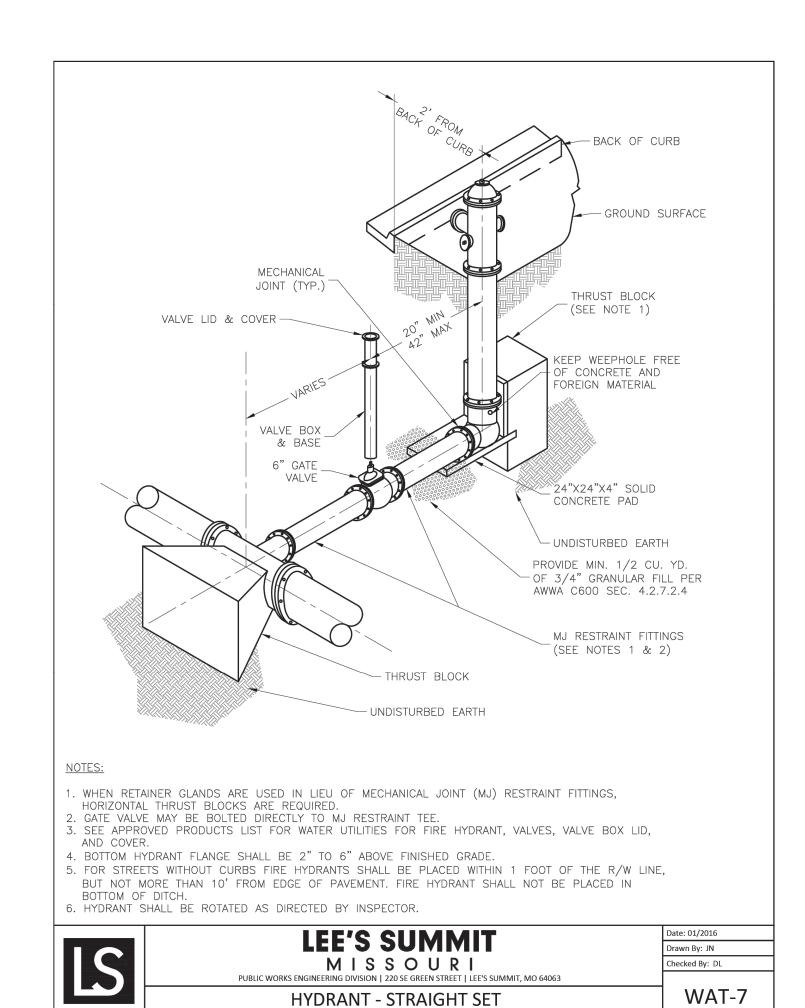

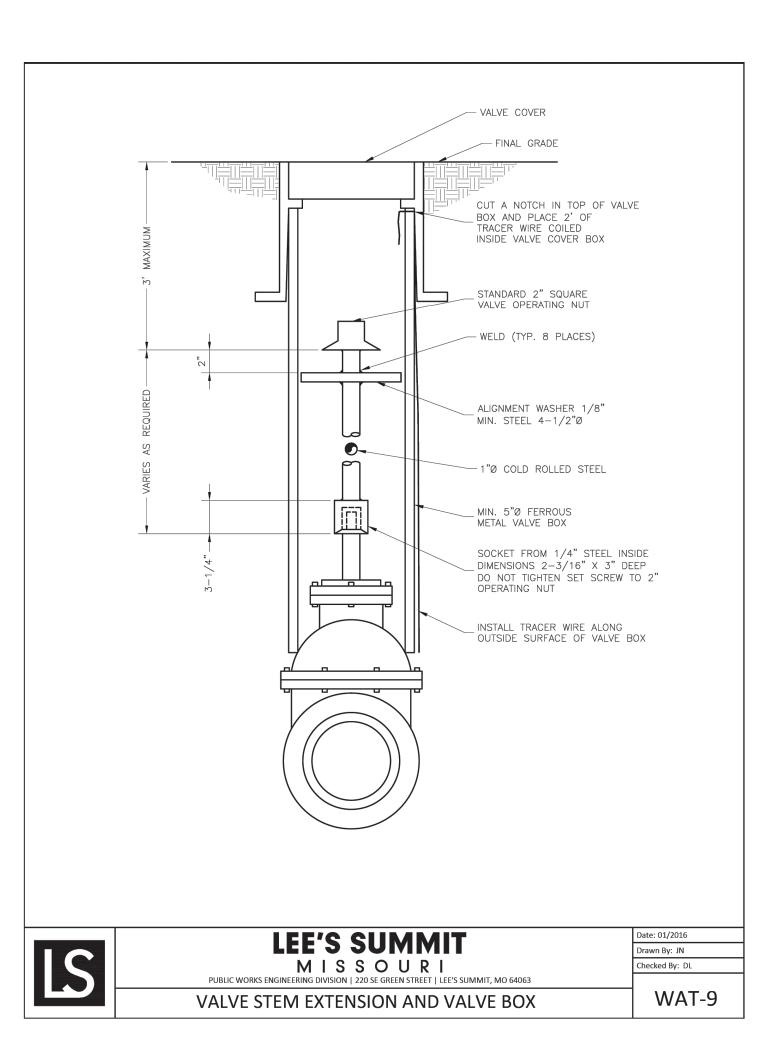

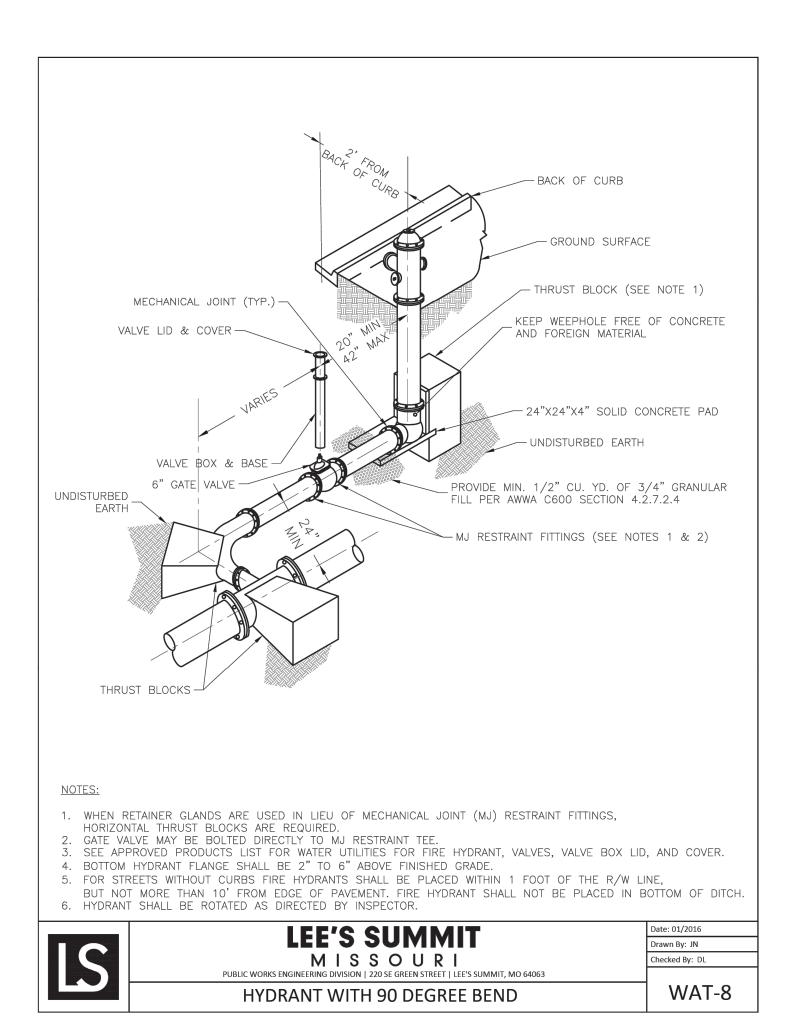

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other data is as designed and has not been field verified.

Certified by: JLL

Title: Senior Project Engineer Firm: Schlagel and Associates, P.A. DETAILS

SHEET



PREPARED BY:

JAMES L

SCHLAGEL & ASSOCIATES, P.A.