2751 NORTHEAST DOUGLAS STREET LEE'S SUMMIT, MISSOURI 64064

CONSTRUCTION PLANS FOR

KANSAS CITY - LEE'S SUMMIT REGIONAL AIRPORT

CITY PROJECT NO. 17932172

GENERAL AVIATION TERMINAL

IFB PLAN SET

DECEMBER 13, 2024

CALL MISSOURI ONE-CALL SYSTEMS
BEFORE EXCAVATING
1-800-DIG-RITE

DESIGN AIRCRAFT - GEOMETRY

CANADAIR CL-600

AIRCRAFT APPROACH CATEGORY C

AIRPLANE DESIGN GROUP II

DESIGN AIRCRAFT - STRUCTURE

GRUMMAN GULFSTREAM IV

GROSS WEIGHT - 71,800 LBS

EQUIVALENT ANNUAL DEPARTURES - 651

MAXIMUM EQUIPMENT HEIGHT: 100'

UNICOM/CTAF FREQUENCY - 122.80



22001238

PROFESSIONAL ENGINEERING - 000631

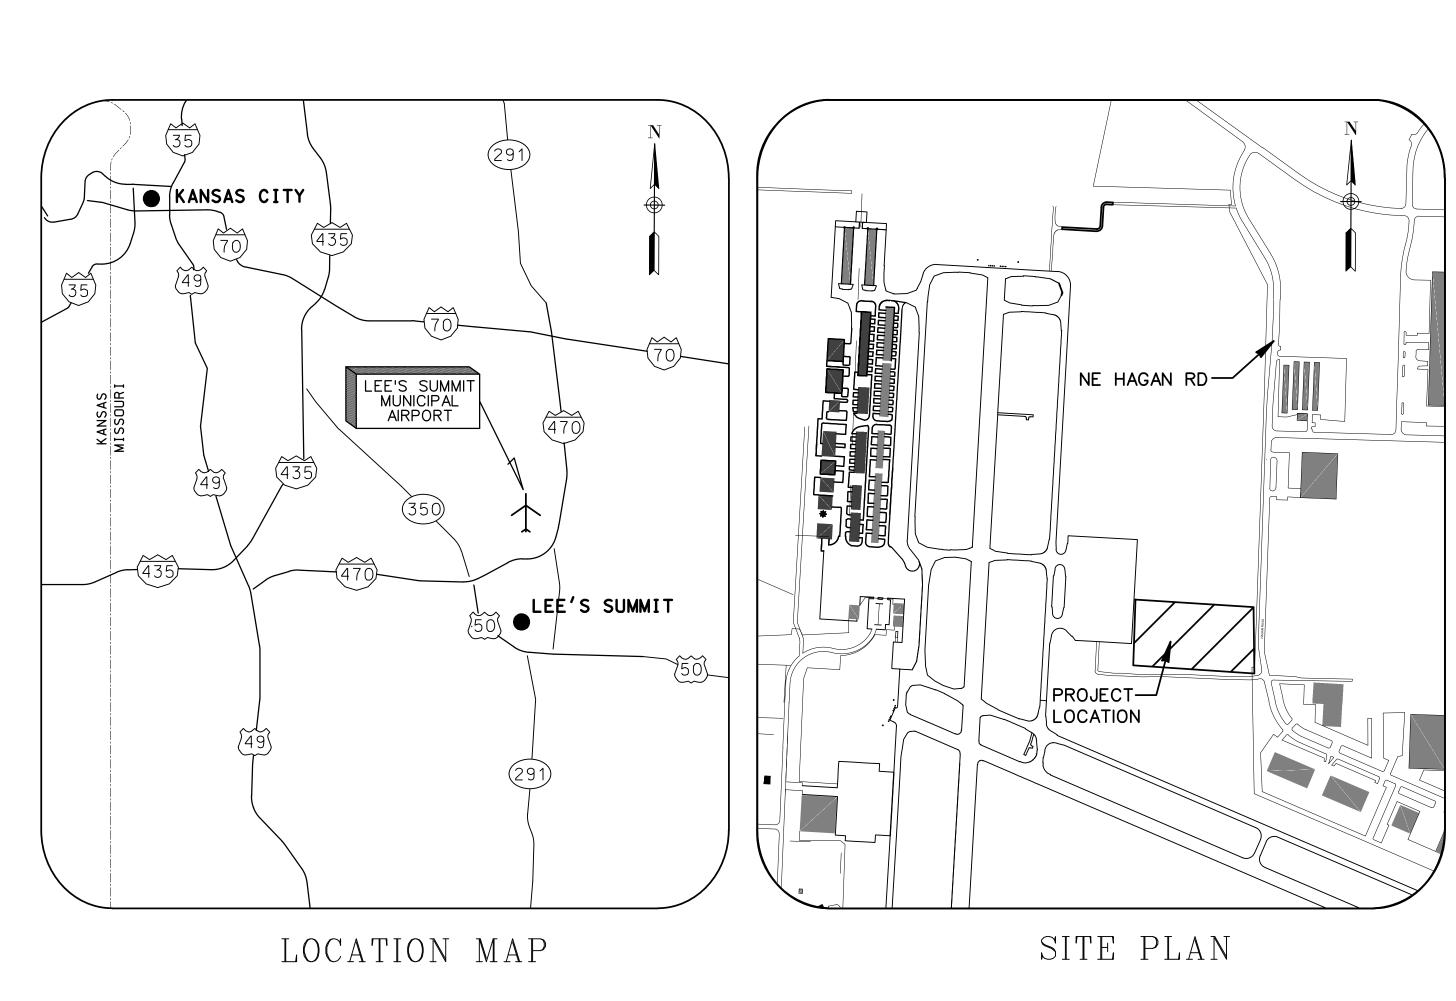
CRAWFORD MURPHY & TILLY, INC.

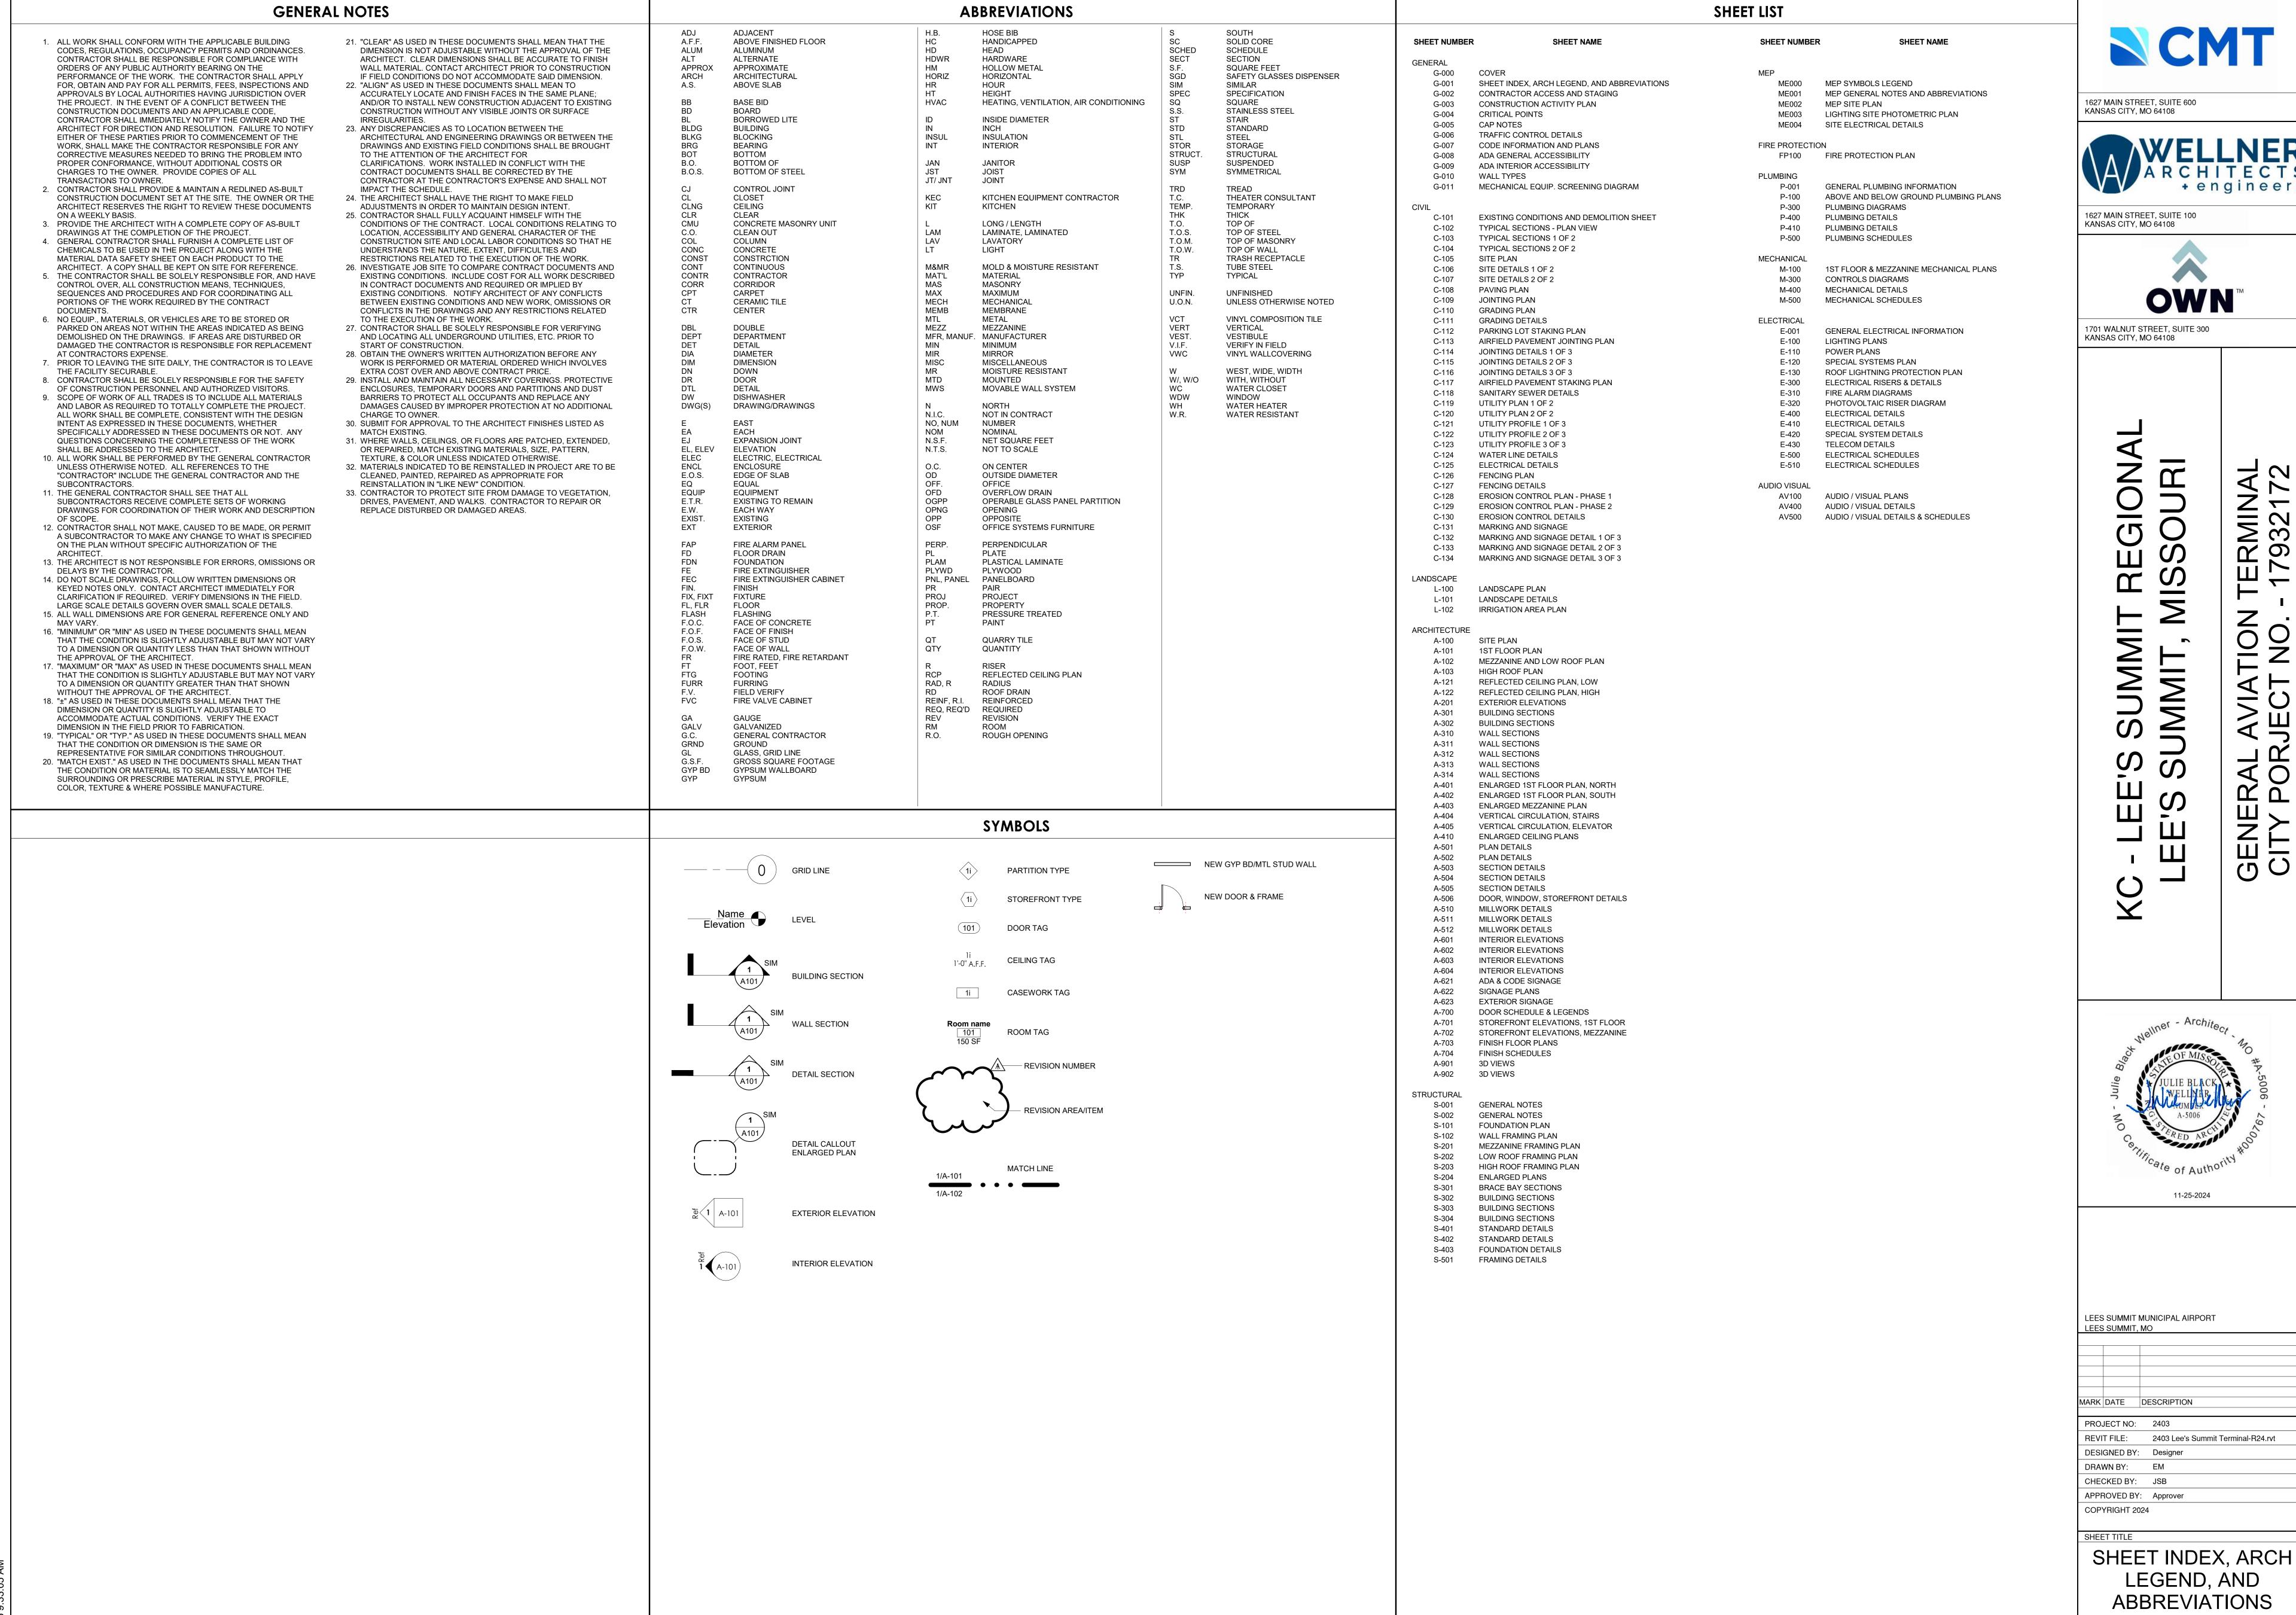
CONSULTING ENGINEERS

SPRINGFIELD, IL AURORA, IL ST. LOUIS, MO

■ EDWARDSVILLE, IL■CHICAGO, IL■ PEORIA, IL■ ROCKFORD, IL
■ INDIANAPOLIS, IN■ COLUMBUS, OH■ SPRINGFIELD, MO
■ KANSAS CITY, MO ■ LA BELLE, FL ■ MOLINE, IA
SUBMITTED BY GERALD BOLLINGER

DATE _____DECEMBER 13, 2024











LEGEND, AND **ABBREVIATIONS**

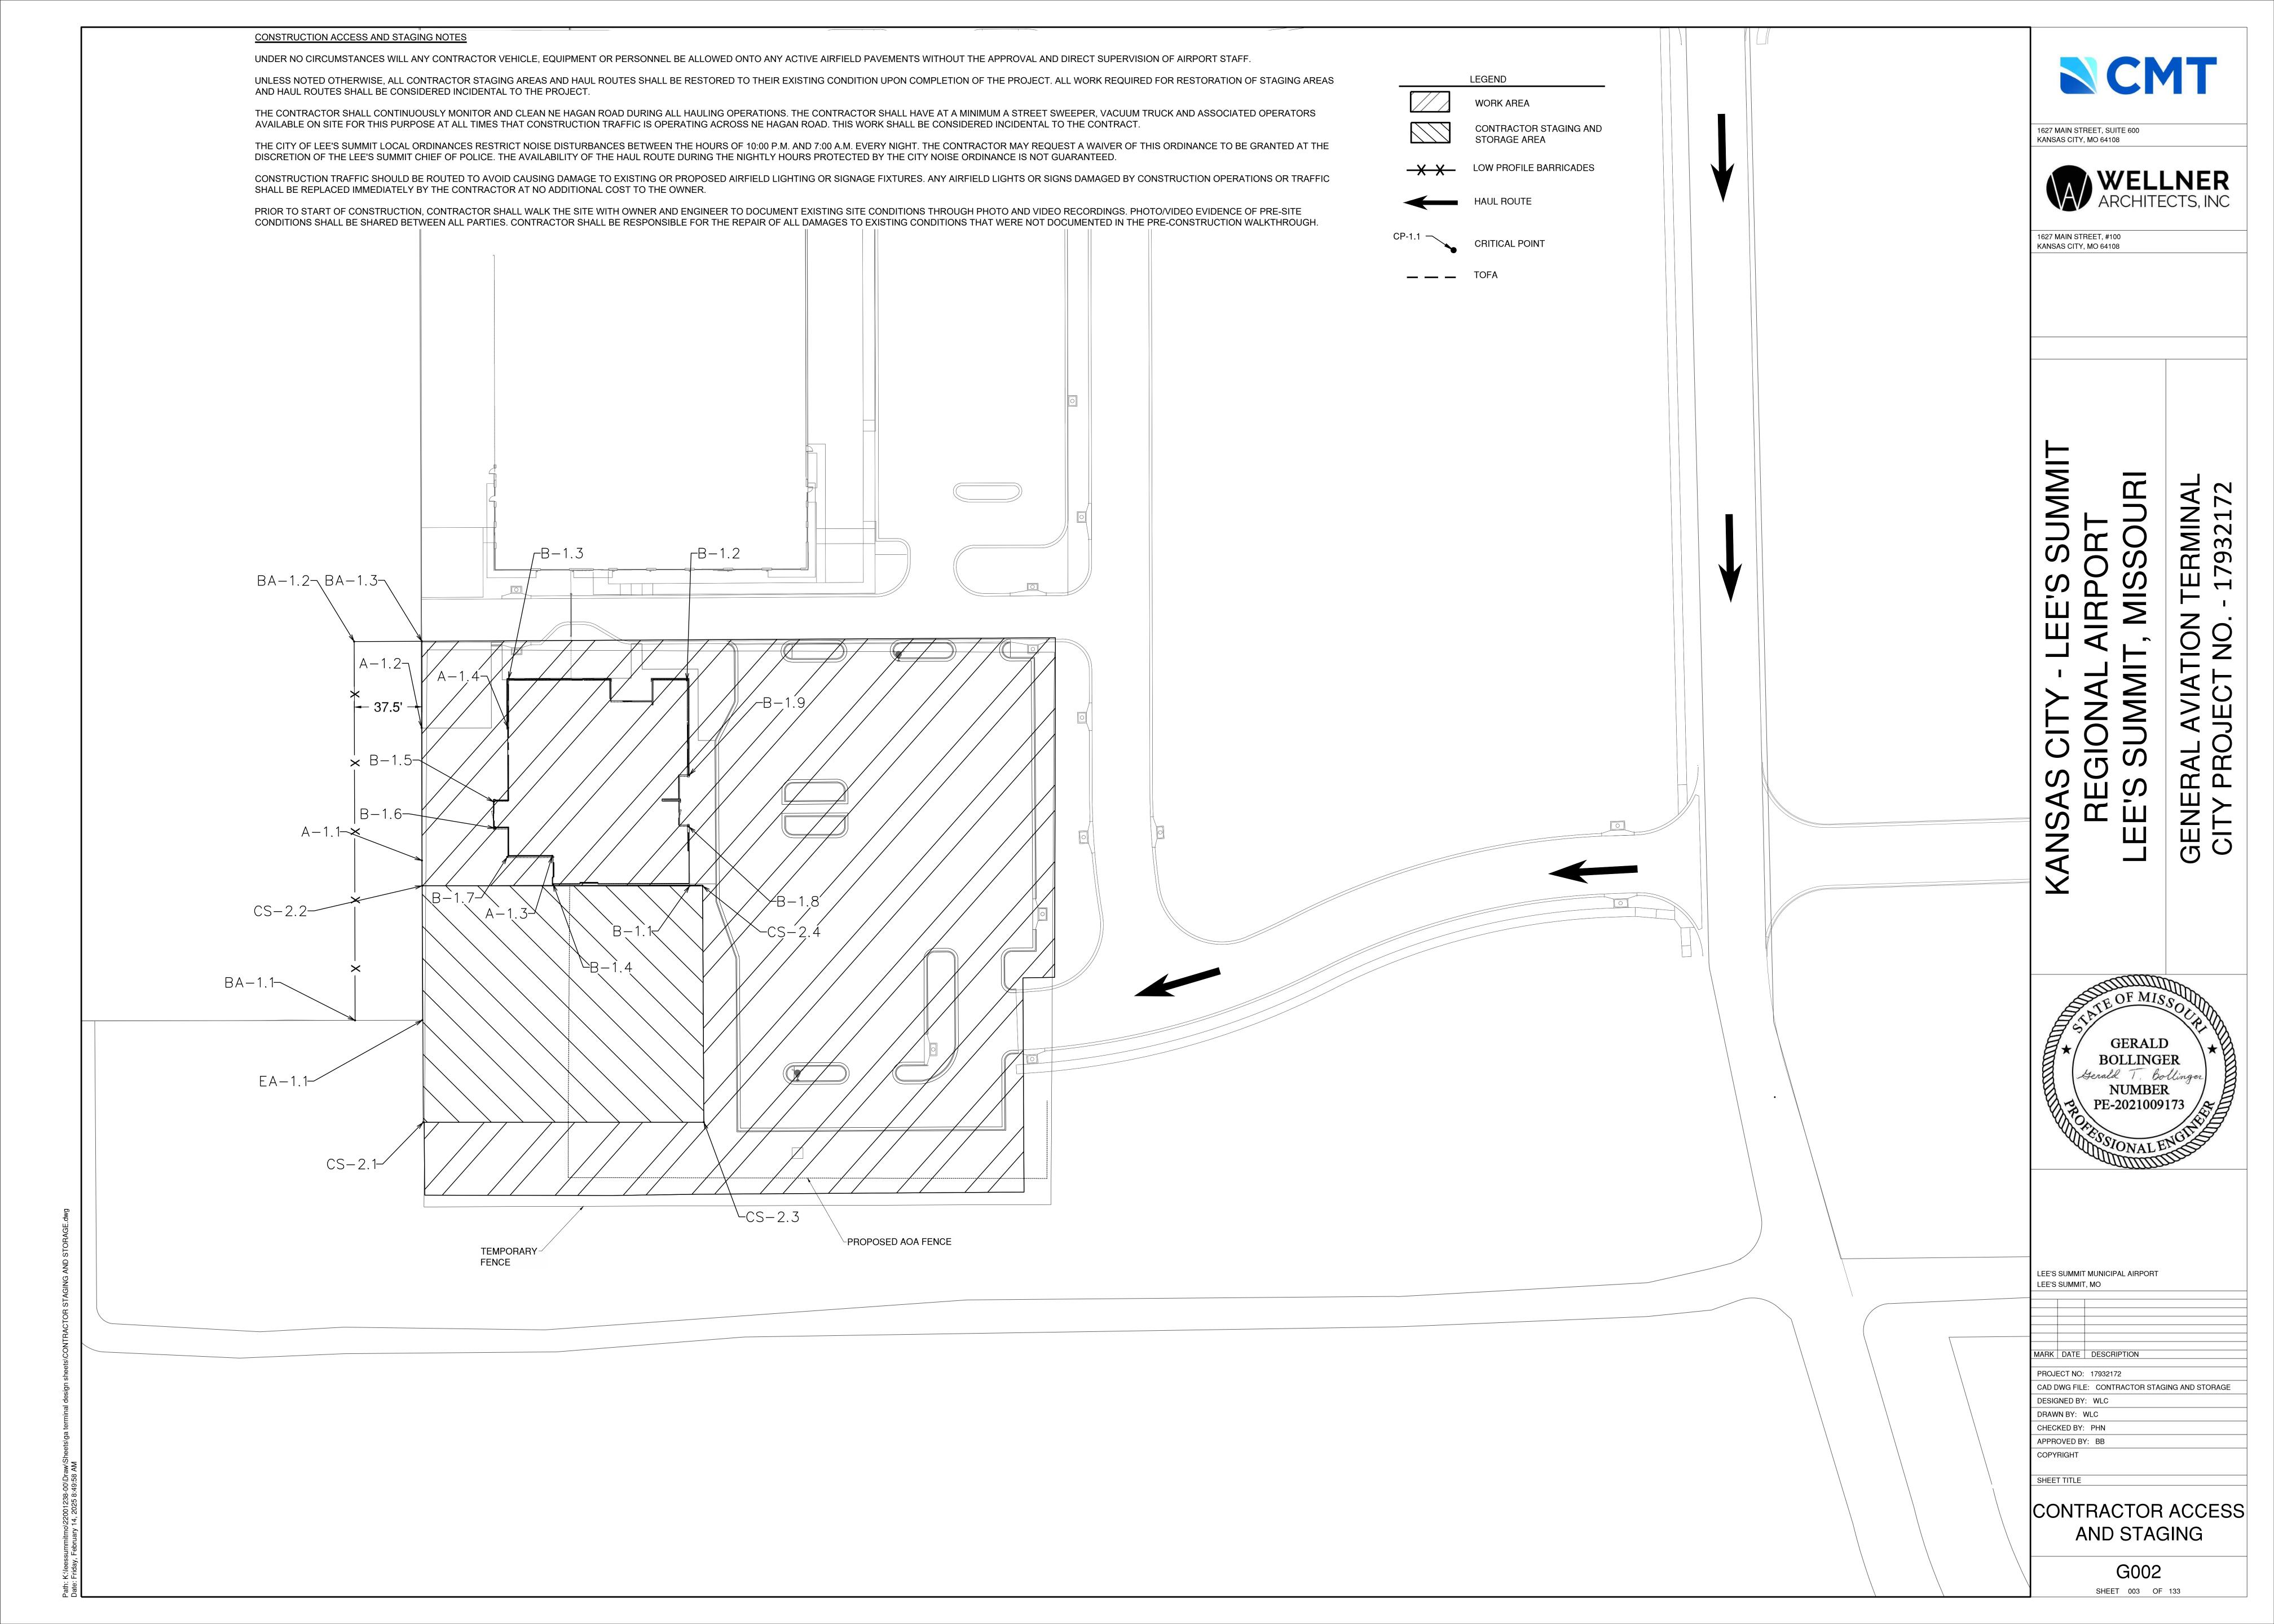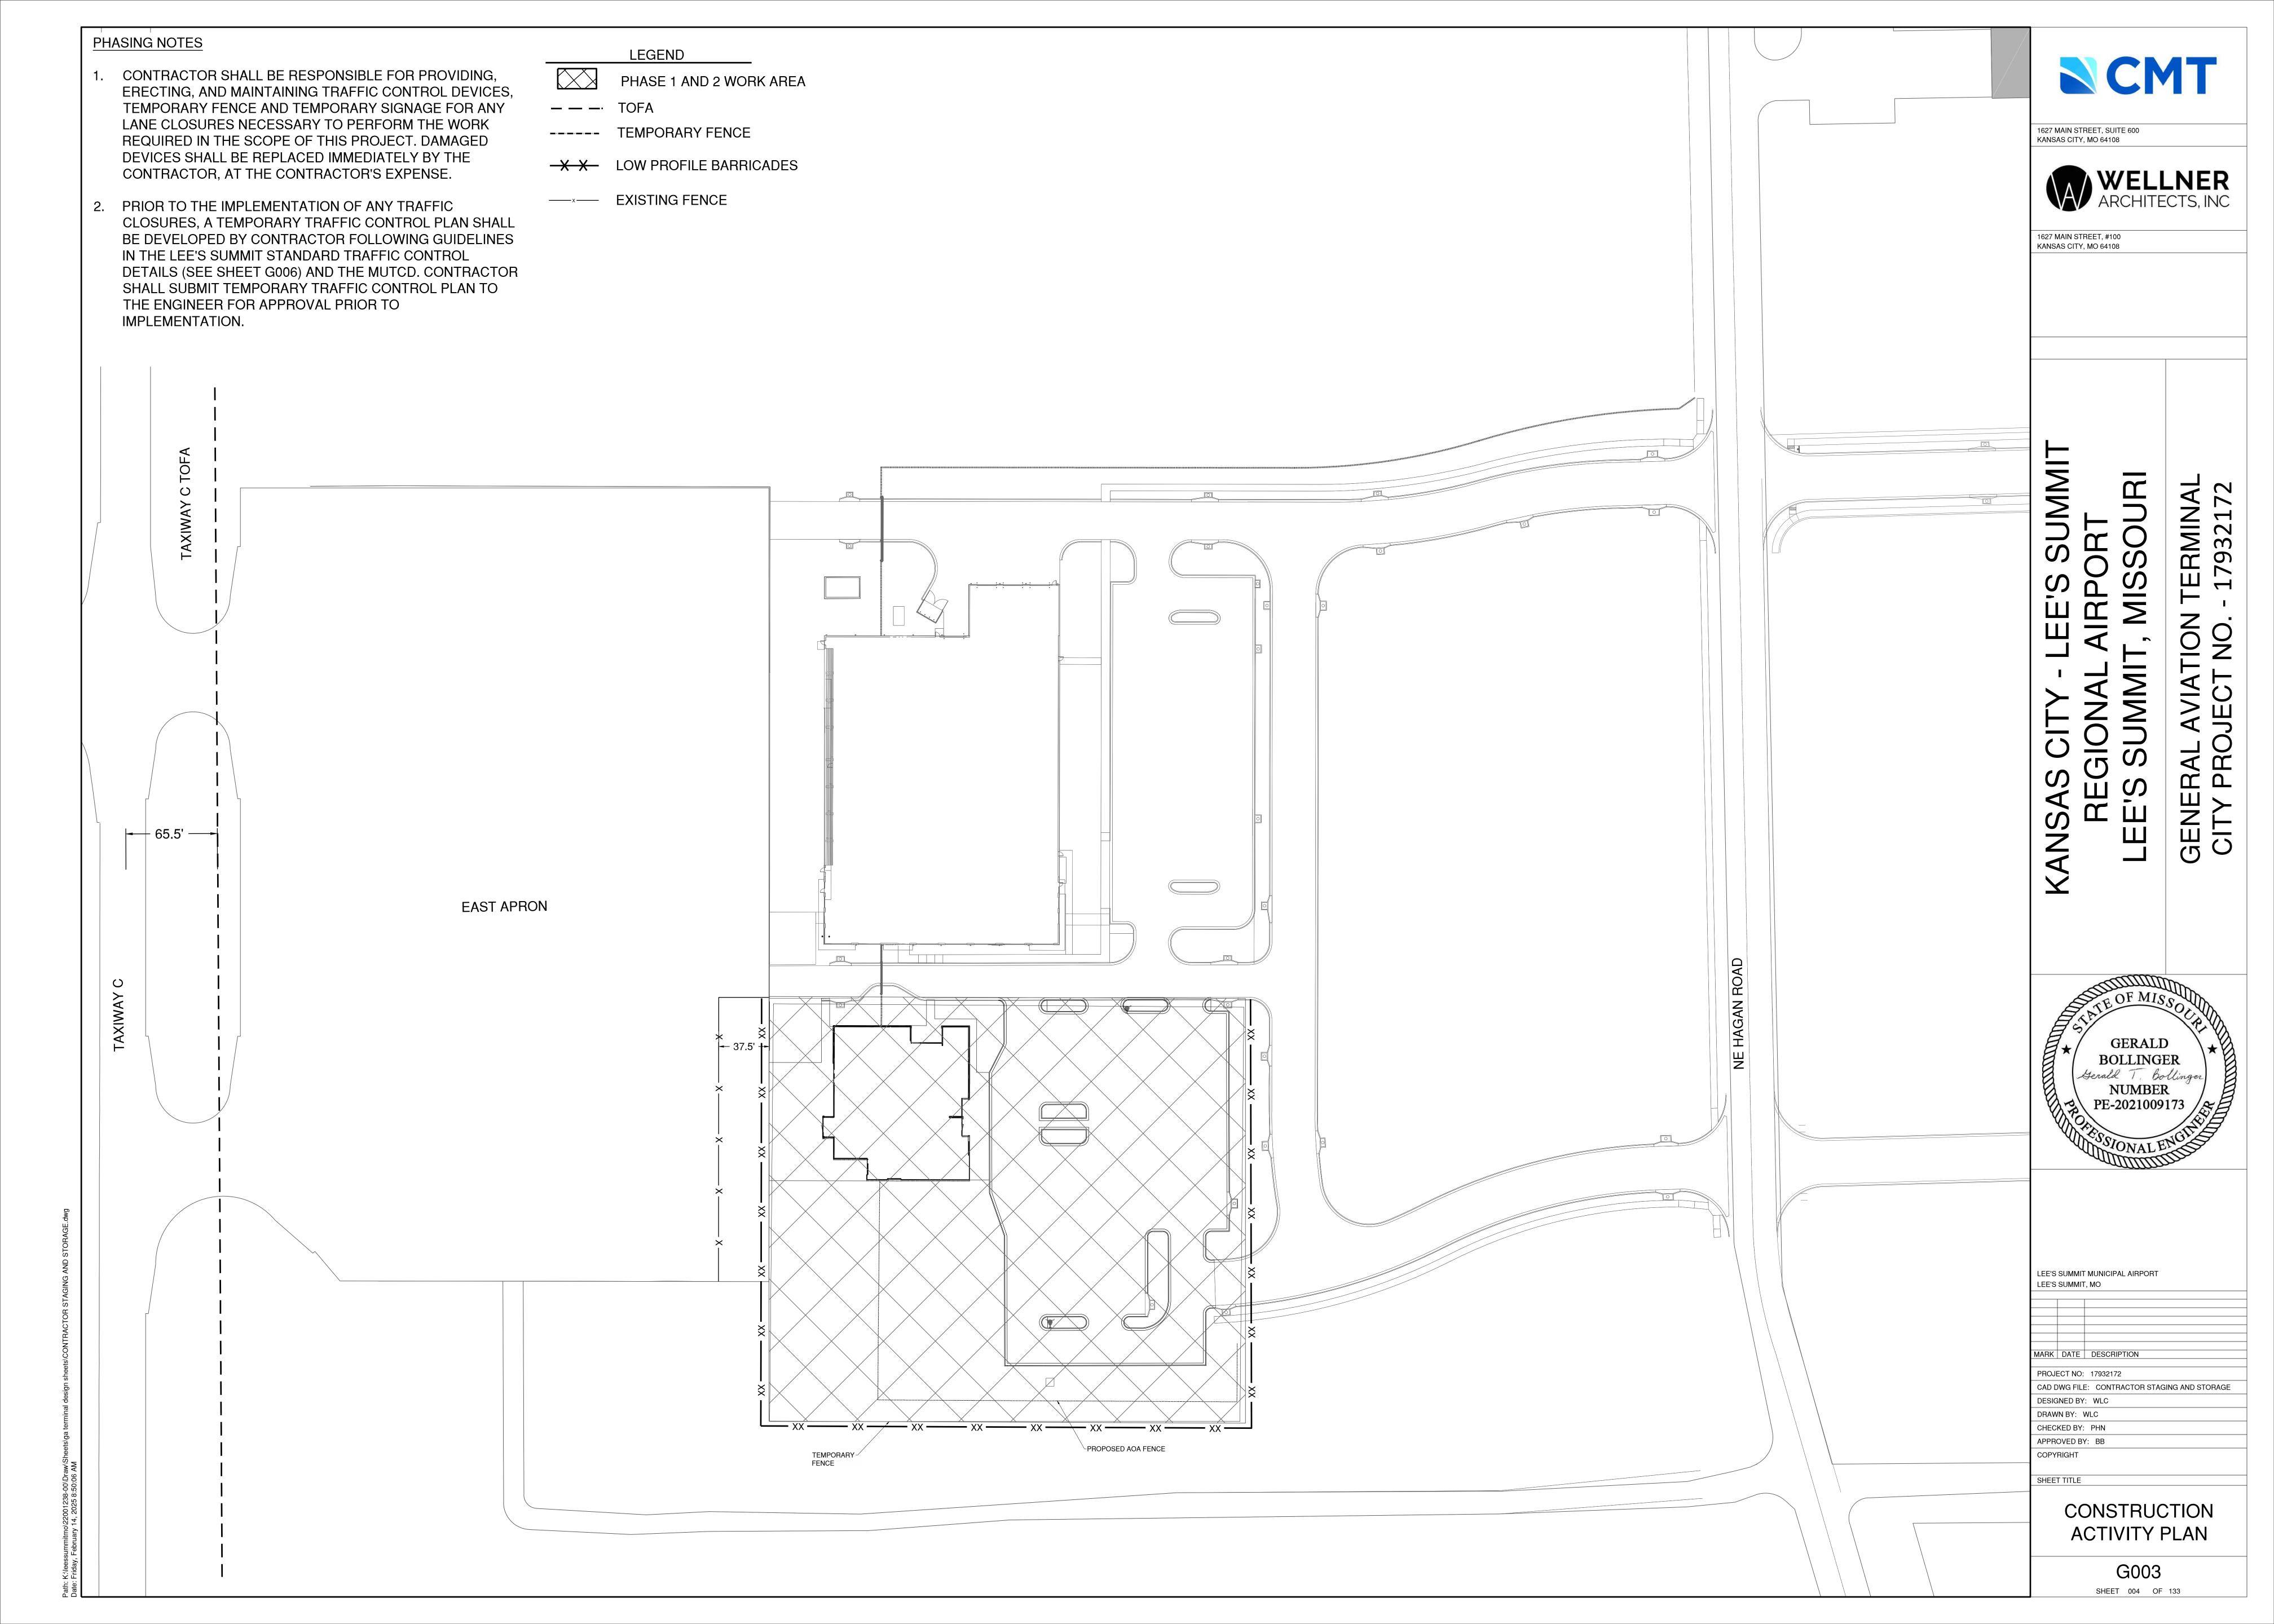G-001






-					
		CRITICAL ELEVATI	ON POINTS		
		EASTSIDE DEVE	LOPMENT		
	IEE	'S SUMMIT MUNIC		•	
		EW PCC APRON CRI		1 1	
POINT	DESCRIPTION	GROUND ELEVATION	MAX* ELEVATION	NORTHING	EASTING
A-1.1	NEW PCC APRON	993.17	1093.17	2825746.6471	1017840.6767
A-1.2	NEW PCC APRON	993.22	1093.22	2825750.8508	1017911.3128
A-1.3	NEW PCC APRON	993.00	1093.00	2825819.2854	1017836.4593
A-1.4	NEW PCC APRON	993.00	1093.00	2825797.9266	1017908.5892'
		NEW GA TERMINAL	BUILDING		
POINT	DESCRIPTION	GROUND ELEVATION	MAX* ELEVATION	NORTHING	EASTING
B-1.1	GA TERMINAL	993.00	1093.00	2825893.7851	1017816.5998'
B-1.2	GA TERMINAL	993.00	1093.00	2825900.3990	1017930.4472
B-1.3	GA TERMINAL	993.00	1093.00	2825799.5342	1017936.3068
B-1.4	GA TERMINAL	993.00	1093.00	2825817.8895	1017821.0089
B-1.5	GA TERMINAL	993.00	1093.00	2825788.1565	1017869.8317
B-1.6	GA TERMINAL	993.00	1093.00	2825787.2398	1017853.8629
B-1.7	GA TERMINAL	993.00	1093.00	2825794.3189	1017837.9097'
B-1.8	GA TERMINAL	993.00	1093.00	2825895.1626	1017848.5340'
B-1.9	GA TERMINAL	993.00	1093.00	2825897.1192	1017877.0036
		EXISTING APRON	CORNERS		
POINT	DESCRIPTION	GROUND ELEVATION	MAX* ELEVATION	NORTHING	EASTING
EA-1.1	EXISTING APRON CORNER	991.22	1091.22	2825741.5663	1017750.0302
EA-1.2	EXISTING APRON CORNER	992.60	1092.60	2825775.4280	1018336.3199
		LOW PROFILE BAI	RRICADES		
POINT	DESCRIPTION	GROUND ELEVATION	MAX* ELEVATION	NORTHING	EASTING
BA-1.1	LOW-PROFILE BARRICADES	995.00	1095.00	2825703.6080	1017752.2276
BA-1.2	LOW-PROFILE BARRICADES	995.00	1095.00	2825717.1968	1017990.4666'
BA-1.3	LOW-PROFILE BARRICADES	995.00	1095.00	2825754.6378	1017988.3649
		CONTRACTOR STA	GING AREA		
POINT	DESCRIPTION	GROUND ELEVATION	MAX* ELEVATION	NORTHING	EASTING
CS-2.1	CONTRACTOR STAGING AREA	991.79	1091.79	2825738.6619	1017693.5905'
CS-2.2	CONTRACTOR STAGING AREA	992.19	1092.19	2825745.7663	1017824.4198
CS-2.3	CONTRACTOR STAGING AREA	992.61	1092.61	2825893.8241	1017684.2987
CS-2.4	CONTRACTOR STAGING AREA	993.21	1093.21	2825900.9834	1017815.0493'
	CONSTRUCTIO	N ACTIVITY MAXIMUM I	HEIGHT: 100' FROM	1 GROUND	
		The same of the sa			V.





1627 MAIN STREET, #100 KANSAS CITY, MO 64108

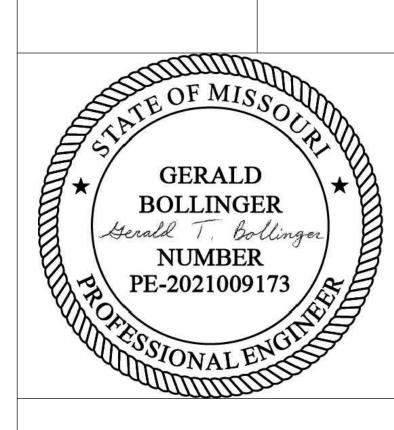SUMMIT



LEE'S SUMMIT MUNICIPAL AIRPORT LEE'S SUMMIT, MO

MARK DATE DESCRIPTION

PROJECT NO: 17932172

CAD DWG FILE: CAP NOTES DESIGNED BY: WLC

DRAWN BY: WLC CHECKED BY: PHN

APPROVED BY: BB COPYRIGHT

SHEET TITLE

CRITICAL POINTS

G004

SHEET 005 OF 133

- 1. THE CONTRACTOR AND ALL SUBCONTRACTORS SHALL FOLLOW THE REQUIREMENTS OF THE AIRPORT'S APPROVED CONSTRUCTION SAFETY AND PHASING PLAN (CSPP), FAA AC 150/5370-2G, AND ALL AIRPORT SAFETY AND SECURITY REQUIREMENTS.
- 2. PRIOR TO THE START OF CONSTRUCTION THE CONTRACTOR SHALL SUBMIT TO THE CITY FOR APPROVAL A SAFETY PLAN COMPLIANCE DOCUMENT (SPCD) IN ACCORDANCE WITH FAA AC 150/5370-2G. NO CONSTRUCTION ACTIVITY SHALL BEGIN UNTIL THE CITY HAS APPROVED THE SPCD.
- 3. THE CSPP COVERS OPERATIONAL SAFETY. THE CONTRACTOR SHALL BE RESPONSIBLE FOR THE INDIVIDUAL SAFETY OF HIS/HER PERSONNEL AND MEETING OSHA REQUIREMENTS.
- 4. A MINIMUM OF 10 DAYS PRIOR TO THE PRE-CONSTRUCTION MEETING THE CONTRACTOR SHALL PROVIDE A LIST OF SUBCONTRACTORS AND MATERIAL SUPPLIERS.
- 5. THE CONTRACTOR SHALL EXERCISE BEST MANAGEMENT PRACTICES IN ACCORDANCE WITH STORM WATER POLLUTION PREVENTION AND PROJECT SPECIFICATION C-102 EROSION AND SEDIMENT CONTROL THROUGHOUT THE LIFE OF THE PROJECT TO CONTROL WATER POLLUTION.
- 6. ALL CONTRACTOR COSTS ASSOCIATED WITH THE REQUIREMENTS LISTED ON THIS SHEET SHALL BE CONSIDERED INCIDENTAL TO THE CONTRACT UNLESS A SPECIFIC PAY ITEM IS PROVIDED.
- 7. THE EXISTING FEATURES SHOWN ON THESE PLANS ARE THOSE NOTED IN THE FIELD AND THOSE TAKEN FROM RECORD DRAWINGS. THIS DOES NOT GUARANTEE THAT ALL FEATURES ARE SHOWN ON THE PLANS. THERE WILL BE NO ADDITIONAL PAYMENT TO THE CONTRACTOR DUE TO VARIATIONS IN SIZE, QUANTITY OR LOCATION OF EXISTING FEATURES.
- 8. CRAWLER TYPE EQUIPMENT SHALL NOT BE ALLOWED ON ANY PAVED SURFACE ON THE AIRPORT, ONLY RUBBER-TIRED VEHICLES, WHICH WILL NOT CAUSE DAMAGE TO THE PAVEMENTS, SHALL BE ALLOWED WITHOUT PROVIDING SOME TYPE OF PROTECTION.
- 9. THE CONTRACTOR SHALL HAVE PROPER IDENTIFICATION ON ALL EQUIPMENT AND VEHICLES ON THE AIRPORT.
- 10. NO EDGE DROP GREATER THAN 3 INCHES WILL BE ALLOWED AT ANY ACTIVE RUNWAY PAVEMENT EDGE OR SAFETY AREA. IF NECESSARY. THE CONTRACTOR SHALL PLACE TEMPORARY MATERIAL TO ELIMINATE VERTICAL DROPS GREATER THAN 3 INCHES OR SLOPES GREATER THAN 5% IN THESE AREAS. THIS WORK SHALL BE SUBSIDIARY TO OTHER ITEMS IN THE PROJECT.
- 11. THE CONTRACTOR SHALL CONSTRUCT HAUL ROADS FOR ALL PHASES OF CONSTRUCTION. THE HAUL ROADS SHALL BE CONSTRUCTED OF MATERIALS THAT ALLOW ACCESS TO THE SITE DURING POOR CONDITIONS. THE HAUL ROADS SHALL BE REMOVED AFTER CONSTRUCTION OF EACH PHASE IS COMPLETE. THE AREAS WHERE HAUL ROADS WERE CONSTRUCTED SHALL BE RESTORED BACK TO THEIR ORIGINAL CONDITION. CONSTRUCTION OF THE HAUL ROADS, REMOVAL OF THE HAUL ROADS AND RESTORING THE AREAS BACK TO THEIR ORIGINAL CONDITION SHALL BE INCIDENTAL TO THE PROJECT.

1. COORDINATION

- 1. PRIOR TO THE START OF CONSTRUCTION THE CONTRACTOR SHALL ATTEND A PRECONSTRUCTION CONFERENCE WITH THE AIRPORT AND THE ENGINEER. THE COST OF PREPARING FOR AND ATTENDING THE PRECONSTRUCTION CONFERENCE SHALL BE INCIDENTAL TO THE CONTRACT.
- 2. ON OR BEFORE THE PRECONSTRUCTION CONFERENCE, THE CONTRACTOR SHALL SUBMIT A PROPOSED SCHEDULE FOR THE PROJECT. THE SCHEDULE SHALL INCLUDE A START AND COMPLETION DATE FOR EACH ITEM OF WORK. THE SCHEDULE SHALL BE UPDATED ON A WEEKLY BASIS. ALL COSTS ASSOCIATED WITH THE SCHEDULE SHALL BE INCIDENTAL TO THE CONTRACT.
- 3. DURING CONSTRUCTION THE CONTRACTOR SHALL ATTEND A WEEKLY COORDINATION MEETING WITH THE RESIDENT ENGINEER/OBSERVER. ALL COSTS ASSOCIATED WITH ATTENDING THE WEEKLY MEETING SHALL BE INCIDENTAL TO THE CONTRACT.
- 4. CHANGES MADE TO THE SCOPE OR DURATION OF THE PROJECT MAY NECESSITATE REVISIONS TO THE CSPP AND SHALL REQUIRE REVIEW AND APPROVAL BY THE ENGINEER AND AIRPORT OPERATOR.

2. CONSTRUCTION ACTIVITY

- 1. THE SOUTHEAST CORNER OF THE EAST APRON SHALL BE CLOSED FOR THE DURATION OF THE
- NO CONSTRUCTION TRAFFIC SHALL CROSS INTO ANY OPEN AIRFIELD PAVEMENT OR AIRFIELD OBJECT FREE AREAS FOR ANY REASON WHATSOEVER. SHALL ACCESS BE NECESSARY FOR ANY REASON, CONTRACTOR SHALL COORDINATE WITH THE AIRPORT WHO SHALL PROVIDE ESCORT.
- UNAUTHORIZED ENTRY BY ANY PERSONNEL, VEHICLE OR EQUIPMENT WOULD BE A MAJOR INFRACTION OF AIRPORT SAFETY. THE PERSONNEL RESPONSIBLE FOR THE INCURSION SHALL BE SUSPENDED FROM ACCESS ONTO AIRPORT PROPERTY AND WILL NOT BE ALLOWED RE-ENTRY WITHOUT THE CONSENT OF THE AIRPORT. IF MULITPLE INCURSIONS OCCUR, THE AIRPORT RESERVES THE RIGHT TO SUSPEND ALL ACCESS ONTO AIRPORT PROPERTY UNTIL ALL KEY CONTRACTOR STAFF ARE RETRAINED IN AIRPORT SAFETY. PROJECT CALENDAR DAYS WILL CONTINUE TO BE COUNTED DURING THE WORK SUSPENSION.

3. PROTECTION OF NAVIGATION AIDS (NAVAIDS)

- 1. THE CONTRACTOR SHALL REMAIN CLEAR OF THE PAPI SYSTEMS, WIND CONE. BEACON, AWOS AND OTHER NAVAIDS FACILITIES AT ALL TIMES, UNLESS SPECIFICALLY NOTED OTHERWISE.
- 2. THE CONTRACTOR SHALL LOCATE FAA UTILITIES WITH FAA TECHNICAL OPERATIONS PRIOR TO START OF ALL CONSTRUCTION.

4. CONTRACTOR ACCESS

- 1. CONTRACTOR ACCESS SHALL BE AS NOTED BELOW AND AS SHOWN ON THE SITE PLAN AND CONSTRUCTION ACTIVITY PLAN SHEETS.
- 2. THE CONTRACTOR SHALL DESIGNATE AT LEAST ONE PERSON TO MONITOR THE AIRPORT UNICOM FREQUENCY OF 122.80. THE PERSON DESIGNATED SHALL HAVE THE ABILITY TO EASILY COMMUNICATE WITH OTHER CONTRACTOR PERSONNEL WORKING ON THE JOBSITE. THE CONTRACTOR SHALL PROVIDE THEIR OWN WORKING RADIO(S).
- 3. THE STORAGE AND STAGING AREAS SHALL BE AS SHOWN ON THE SITE
- 4. THE CONTRACTOR SHALL KEEP A RECORD OF THE NAMES OF ALL EMPLOYEES ENTERING THE JOB SITE ON A DAILY BASIS AND BE RESPONSIBLE FOR MAINTAINING THE SECURITY OF THE ACCESS GATES BY KEEPING THE GATES LOCKED AND GUARDED AT ALL TIMES. A RECORD OF EACH SUBCONTRACTOR ENTERING THE JOB SITE SHALL ALSO BE KEPT BY THE CONTRACTOR.
- 5. WHEN THE CONTRACTOR IS NOT WORKING, EQUIPMENT SHALL BE STORED AT THE STAGING AREA OR WITHIN THE WORK AREA LIMITS
- 6. THE CONTRACTOR SHALL STORE EQUIPMENT AND MATERIALS ONLY AT THE LOCATIONS SHOWN. PARKED EQUIPMENT AND MATERIAL STOCKPILES SHALL NOT PENETRATE SURFACES DEFINED BY F.A.R. TITLE 14 PART 77 - OBJECTS AFFECTING NAVIGABLE AIRSPACE.
- 7. ALL CONSTRUCTION TRAFFIC OPERATING WITHIN AN ACTIVE RUNWAY OR TAXIWAY SAFETY AREA OR ON AN ACTIVE APRON SHALL BE UNDER CONTROL BY A FLAGMAN OR ESCORT WHO IS MONITORING THE AIRPORT UNICOM FREQUENCY. THE CONTRACTOR SHALL PROVIDE HIS/HER OWN FLAGMEN.
- 8. THE CONTRACTOR SHALL THOROUGHLY AND CONTINUOUSLY CLEAN ALL CONSTRUCTION AREAS AND HAUL ROUTES WHICH WILL BE OPENED TO AIR TRAFFIC TO THE SATISFACTION OF THE ENGINEER. A POWER BROOM AND OPERATOR SHALL BE ON SITE AT ALL TIMES WHEN ACTIVE PAVEMENTS ARE UTILIZED FOR CONSTRUCTION TRAFFIC.
- 9. ALL PAVEMENTS, DRIVES OR ANY OTHER AREAS UTILIZED BY THE CONTRACTOR FOR HAUL ROADS OR STORAGE AREAS SHALL BE MAINTAINED AND REPAIRED TO THE SAME CONDITION OR BETTER THAN THEY WERE PRIOR TO BEGINNING CONSTRUCTION. NO ADDITIONAL COMPENSATION WILL BE MADE TO THE CONTRACTOR FOR THIS WORK
- ALL VEHICLE AND EQUIPMENT OPERATORS USED BY THE CONTRACTOR SHALL BE PROPERLY TRAINED BY THE CONTRACTOR. VEHICLE OPERATORS HAVING ACCESS TO THE MOVEMENT AREA SHALL BE FAMILIAR WITH AIRPORT PROCEDURES FOR THE OPERATION OF GROUND VEHICLES AND THE CONSEQUENCES OF NONCOMPLIANCE OR BE ESCORTED BY SOMEONE WHO IS
- 11. THE CONTRACTOR SHALL NOTIFY THE LOCAL FIRE DEPARTMENT IF CONSTRUCTION ACTIVITY WILL REQUIRE THE BLOCKAGE OF EMERGENCY ACCESS TO THE AIRPORT.

5. TEMPORARY FENCING AND PROJECT ACCESS NOTES

- 1. SEE FENCING PLAN FOR LAYOUT OF PROPOSED FENCE AND FOR LAYOUT OF FENCE REMOVALS
- 2. ALL PROPOSED FENCING SHALL BE INSTALLED PRIOR TO REMOVAL OF EXISTING. ANY GAPS IN FENCING SHALL ONLY BE ALLOWED TEMPORARILY AND UNDER DIRECT SUPERVISION OF CONTRACTOR PERSONNEL.

6. WILDLIFE MANAGEMENT

- 1. THE CONTRACTOR SHALL NOTIFY THE ENGINEER OR AIRPORT MANAGER IF ANY WILDLIFE IS SEEN ENTERING THE AIRPORT.
- 2. THE CONTRACTOR SHALL DISPOSE OF ALL TRASH INCLUDING FOOD SCRAPS IN APPROVED CONTRACTOR PROVIDED CONTAINERS.

7. FOREIGN OBJECT DEBRIS (FOD) MANAGEMENT

- 1. THE CONTRACTOR SHALL PICK UP ANY FOREIGN OBJECT DEBRIS (FOD) SEEN ON THE AIRFIELD PAVEMENTS.
- 2. THE CONTRACTOR SHALL SECURE ALL LOOSE ITEMS FROM VEHICLES PRIOR TO DRIVING ON AIRFIELD PAVEMENTS.

8. HAZARDOUS MATERIALS (HAZMAT) MANAGEMENT

1. THE CONTRACTOR SHALL DEVELOP A HAZMAT MANAGEMENT PLAN AND KEEP COPIES ON THE JOBSITE OF MATERIAL SAFETY DATA SHEETS (SDS) FOR ALL MATERIALS HANDLED ON THE JOBSITE.

9. NOTIFICATION OF CONSTRUCTION ACTIVITIES

- 1. THE CONTRACTOR SHALL PROVIDE A 24 HOUR EMERGENCY CONTACT PERSON AND PHONE NUMBER.
- 2. THE CONTRACTOR SHALL GIVE A MINIMUM OF 72 HOURS NOTICE TO THE AIRPORT PRIOR TO CLOSING ANY PAVEMENTS SO THAT PROPER NOTAMS MAY BE ISSUED BY THE AIRPORT AND TO ALLOW FOR COORDINATION WITH THE AIRPORT TENANTS BY THE AIRPORT.
- FOR ANY EQUIPMENT USED BY THE CONTRACTOR WITH A HEIGHT GREATER THAN 100', THE CONTRACTOR SHALL SUBMIT FAA FORM 7460-1 TO THE FAA FOR AN AIRSPACE STUDY. NO EQUIPMENT WITH A HEIGHT GREATER THAN 100' SHALL BE USED UNTIL A DETERMINATION FROM FAA IS RECEIVED.
- 4. IN THE EVENT OF AN EMERGENCY, THE CONTRACTOR SHALL CALL 911
- 5. CONTACTS FOR THIS PROJECT ARE AS LISTED BELOW.

CITY (OWNER)

EMERGENCY

MIKE ANDERSON - DEPUTY DIRECTOR OF LSPW	(816) 969-1800
AIRPORT JOEL ARRINGTON - AIRPORT MANAGER AIRPORT FRONT DESK	(816) 969-1181 (816) 969-1186
ENGINEER BRIAN BLOODWORTH - PROJECT MANAGER	(314) 571-9094
WATER UTILITIES	(816) 989-1900
FIRE DEPARTMENT	(816) 969-1300
POLICE DEPARTMENT	(816) 969-1700
FAA TECHNICAL OPERATIONS BRIAN CHITTUM	(816) 329-2828

10. INSPECTION REQUIREMENTS

- 1. THE CONTRACTOR SHALL INSPECT THE JOBSITE DAILY TO ENSURE COMPLIANCE WITH THE CSPP. THE CHECKLIST FOUND IN APPENDIX 3 OF FAA AC 150/5370-2G MAY BE USED TO AID IN THE INSPECTIONS.
- 2. THE CONTRACTOR SHALL ATTEND A FINAL INSPECTION OF EACH PHASE WORK AREA PRIOR TO OPENING THE AREA TO AIRPORT OPERATIONS.

11. UNDERGROUND UTILITIES

- THE CONTRACTOR SHALL MAKE HIS OWN FIELD INVESTIGATION TO DETERMINE THE EXACT LOCATION OF THE UNDERGROUND UTILITIES AT CRITICAL POINTS. THE LOCATION OF UNDERGROUND UTILITIES AS INDICATED ON THE PLANS HAS BEEN OBTAINED FROM EXISTING RECORDS. NEITHER THE OWNER NOR THE ENGINEER ASSUMES ANY RESPONSIBILITY IN RESPECT TO THE ACCURACY, COMPLETENESS OR SUFFICIENCY OF THE INFORMATION.
- BEFORE INITIATING ANY DIGGING, DRILLING OR EXCAVATING ON THE AIRPORT PROPERTY, THE CONTRACTOR SHALL CALL 1-800-DIG-RITE AND FAA TECHNICAL OPERATIONS TO ARRANGE FOR UTILITY LOCATES.

12. PENALTIES

1. NONCOMPLIANCE BY THE CONTRACTOR WITH AIRPORT RULES AND REGULATIONS OR FAILURE TO COMPLY WITH THE AIRPORT'S APPROVED CSPP AND THE CONTRACTOR'S APPROVED SPCD MAY RESULT IN FINES AS ALLOWED BY LAW OR APPLICABLE REGULATION.

13. RUNWAY AND TAXIWAY VISUAL AIDS

- . AIRPORT PAVEMENT SHALL BE CLOSED DURING THIS PROJECT. THE CONTRACTOR SHALL USE MARKING, LIGHTING AND SIGNS THAT FOLLOW THE REQUIREMENTS OF FAA AC 150/5370-2G.
- 2. BARRICADES SHALL BE USED AND MAINTAINED AS SHOWN ON THE CONSTRUCTION ACTIVITY PLAN SHEETS.

14. TRAFFIC CONTROL AND SIGNAGE NOTES

- PRIOR TO BEGINNING PROJECT CONSTRUCTION, A CONSTRUCTION TRAFFIC CONTROL PLAN SHALL BE DEVELOPED BY THE CONTRACTOR FOLLOWING GUIDELINES AS DESCRIBED IN THE CITY OF LEE'S SUMMIT TRAFFIC CONTROL PLAN ON SHEET G006 TRAFFIC CONTROL DETAILS, CONTRACTOR SHALL SUBMIT THE TRAFFIC CONTROL PLAN TO THE ENGINEER FOR APPROVAL PRIOR TO IMPLEMENTATION.
- CONTRACTOR SHALL BE RESPONSIBLE FOR PROVIDING, ERECTING, AND MAINTAINING TRAFFIC CONTROL DEVICES AND TEMPORARY SIGNAGE FOR SURROUNDING ROADWAYS AS IDENTIFIED ON THE SUBMITTED TRAFFIC CONTROL PLAN. DAMAGED DEVICES SHALL BE REPLACED IMMEDIATELY BY THE CONTRACTOR, AT THE CONTRACTOR'S EXPENSE.
- CONTRACTOR SHALL INSTALL 'AUTHORIZED PERSONNEL ONLY' SIGN AT ACCESS ROAD ENTRANCE FOR PROJECT DURATION.

15. EROSION CONTROL NOTES

- PRIOR TO COMMENCING ANY SITE GRADING OR DEMOLITION. CONTRACTOR MUST INSTALL EROSION CONTROL MEASURES PER THE REQUIRED MINIMUM PERMANENT STORMWATER MANAGEMENT PRACTICES TO SATISEY STORMWATER PLANS, LOCAL PERMITTING REQUIREMENTS, AND THE EROSION CONTROL DEVICES AS DESIGNATED PER THESE PROJECT PLANS
- 2. ALL EROSION CONTROL MEASURES SHALL BE INSTALLED AS EARLY AS PRACTICAL. ALL CONTROLS SHALL BE MONITORED REGULARLY, MAINTAINED, AND MODIFIED TO MAINTAIN EFFECTIVENESS.

16. HAZARD MARKING AND LIGHTING

- 1. THE CONTRACTOR SHALL FURNISH, ERECT, AND MAINTAIN MARKINGS AND ASSOCIATED LIGHTING OF OPEN TRENCHES, EXCAVATIONS, TEMPORARY STOCKPILES, AND HIS/HER CONSTRUCTION EQUIPMENT.
- 2. ALL CONSTRUCTION EQUIPMENT SHALL BE FLAGGED AND/OR LIGHTED IN ACCORDANCE WITH FAA ADVISORY CIRCULAR 150/5370-2G AND
- 150/5210-5D AT ALL TIMES WHILE OPERATING ON AIRPORT PROPERTY. B. BARRICADES SHALL BE PLACED AT THE LOCATIONS SHOWN ON THE
- CONSTRUCTION ACTIVITY PLAN SHEET OR AS DIRECTED BY THE
- 4. THE CONTRACTOR SHALL INSPECT THE BARRICADES ONCE DURING EACH WORK DAY TO ENSURE PROPER PLACEMENT AND PROPER OPERATION OF THE RED LIGHTS.

17. PROTECTION

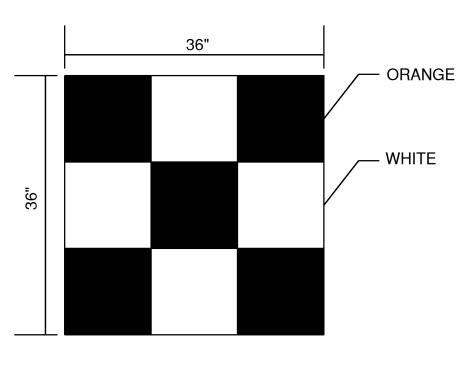
- 1. THE CONTRACTOR SHALL NOT OPERATE ON ANY ACTIVE AIRFIELD PAVEMENTS
- 2. IF THE CONTRACTOR DAMAGES OR DIRTIES ANY ACTIVE PAVEMENTS THEY SHALL BE FIXED/CLEANED IMMEDIATELY.
- 3. THE CONTRACTOR SHALL STAY CLEAR OF ALL TAXIWAY OBJECT FREE AREAS AND RUNWAY OBJECT FREE AREAS. THESE LIMITS CAN BE FOUND ON THE CONSTRUCTION ACTIVITY PLAN.
- 4. THE RUNWAY APPROACH/DEPARTURE SURFACE IS A PROTECTED AIRSPACE SURFACE BEGINNING 200 FEET BEYOND ALL RUNWAY ENDS AND EXTENDS OUTWARED FROM THE RUNWAY AT A SLOPE OF 34:1 FOR 1,000 FEET. ALL CONSTRUCTION EQUIPMENT AND PERSONNEL SHALL NOT BE PERMITTED TO PENETRATE THIS SURFACE.

18. OTHER LIMITATIONS ON CONSTRUCTION

- 1. IF, DURING CONSTRUCTION, AN EMERGENCY IS DECLARED BY THE AIRPORT, THE CONTRACTOR SHALL IMMEDIATELY CLEAR THE PAVEMENT OF ALL VEHICLES, PERSONNEL AND EQUIPMENT.
- 2. BROKEN CONCRETE, BROKEN ASPHALT, UNUSED PAINT, UNUSED SEALANT AND OTHER MISCELLANEOUS DEBRIS SHALL BE DISPOSED OF OFF AIRPORT PROPERTY IN ACCORDANCE WITH APPLICABLE LAWS AND REGULATIONS, UNLESS OTHERWISE SPECIFIED.
- . PER AC 150/5370-2G, SECTION 2.22.2, EQUIPMENT MUST BE REMOVED FROM THE ROFA WHEN NOT IN USE.


19. SITE CONSIDERATIONS

- 1. AS OF JANUARY 2, 2025, THE SITE LOCATION IS NOT IN A 100 YEAR FLOODPLAIN USING THE FIRM PANEL 29095C0430G, WHICH WAS EFFECTIVE JANUARY 20, 2017.
- 2. AS OF JANUARY 2, 2025, THE SITE IS NOT LOCATED IN THE PRESENCE OF ANY ACTIVE, INACTIVE, OR CAPPED OIL OR GAS WELLS PER THE MISSOURI DEPARTMENT OF NATURAL RESOURCES'S GEOSTRAT DATABASE



CONSTRUCTION EQUIPMENT AND TRUCK SIGNAL FLAG

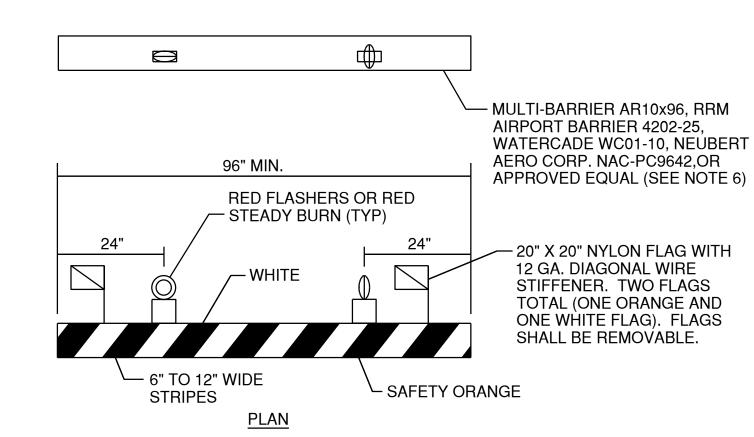N.T.S



BARRICADE NOTES:

- 1. FLASHER OR STEADY BURN LIGHTS SHALL BE BATTERY OR SOLAR POWER OPERATED AND SHALL BE SECURED FIRMLY TO THE BARRICADES. AS APPROVED BY THE RESIDENT ENGINEER. LENS SHALL BE RED AND BE ABLE TO ROTATE 90^.
- 2. FACING OF BARRICADE SHALL BE COVERED WITH REFLECTIVE TAPE OR PAINT.
- 3. BARRICADES TO BE PLACED AT SPACINGS AS INDICATED ON THE CAP SHEETS. BARRICADES WILL EITHER BE PLACED WITH MAXIMUM 4' GAPS FROM EACH OTHER, OR 0' GAPS (OR INTERLOCKING BARRICADES) PER FAA AC 150/5370-2F. IN THE LOCATIONS AS SHOWN ON THE CONSTRUCTION ACTIVITY PLAN SHEETS.
- 4. BARRICADES SHALL BE OF LOW MASS, EASILY COLLAPSIBLE UPON CONTACT WITH AN AIRCRAFT OR ANY OF IT COMPONENTS. AND WEIGHTED OR STURDILY ATTACHED TO THE SURFACE. IF AFFIXED TO THE SURFACE. THE BARRICADE MUST BE FRANGIBLE AT GRADE LEVEL OR LOW AS POSSIBLE, BUT NOT TO EXCEED 3 INCHES ABOVE THE GROUND.
- 5. BARRICADES SHALL BE OF A COMMERCIAL DESIGN AND SHALL MEET CURRENT FAA REQUIREMENTS.
- 6. THE COST OF FURNISHING AND MAINTAINING BARRICADES THROUGHOUT THE LIFE OF THE PROJECT SHALL BE CONSIDERED INCIDENTAL TO THE CONTRACT.
- 7. ALL BARRICADES ON RUNWAY, TAXIWAY OR APRONS SHALL BE LOW PROFILE BARRICADES.

LOW PROFILE LIGHTED BARRICADE N.T.S.



1627 MAIN STREET, SUITE 600

KANSAS CITY, MO 64108

1627 MAIN STREET, #100 KANSAS CITY, MO 64108

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LEE'S SUMMIT, MO

MARK DATE DESCRIPTION PROJECT NO: 17932172

CAD DWG FILE: CAP NOTES DESIGNED BY: WLC DRAWN BY: WLC

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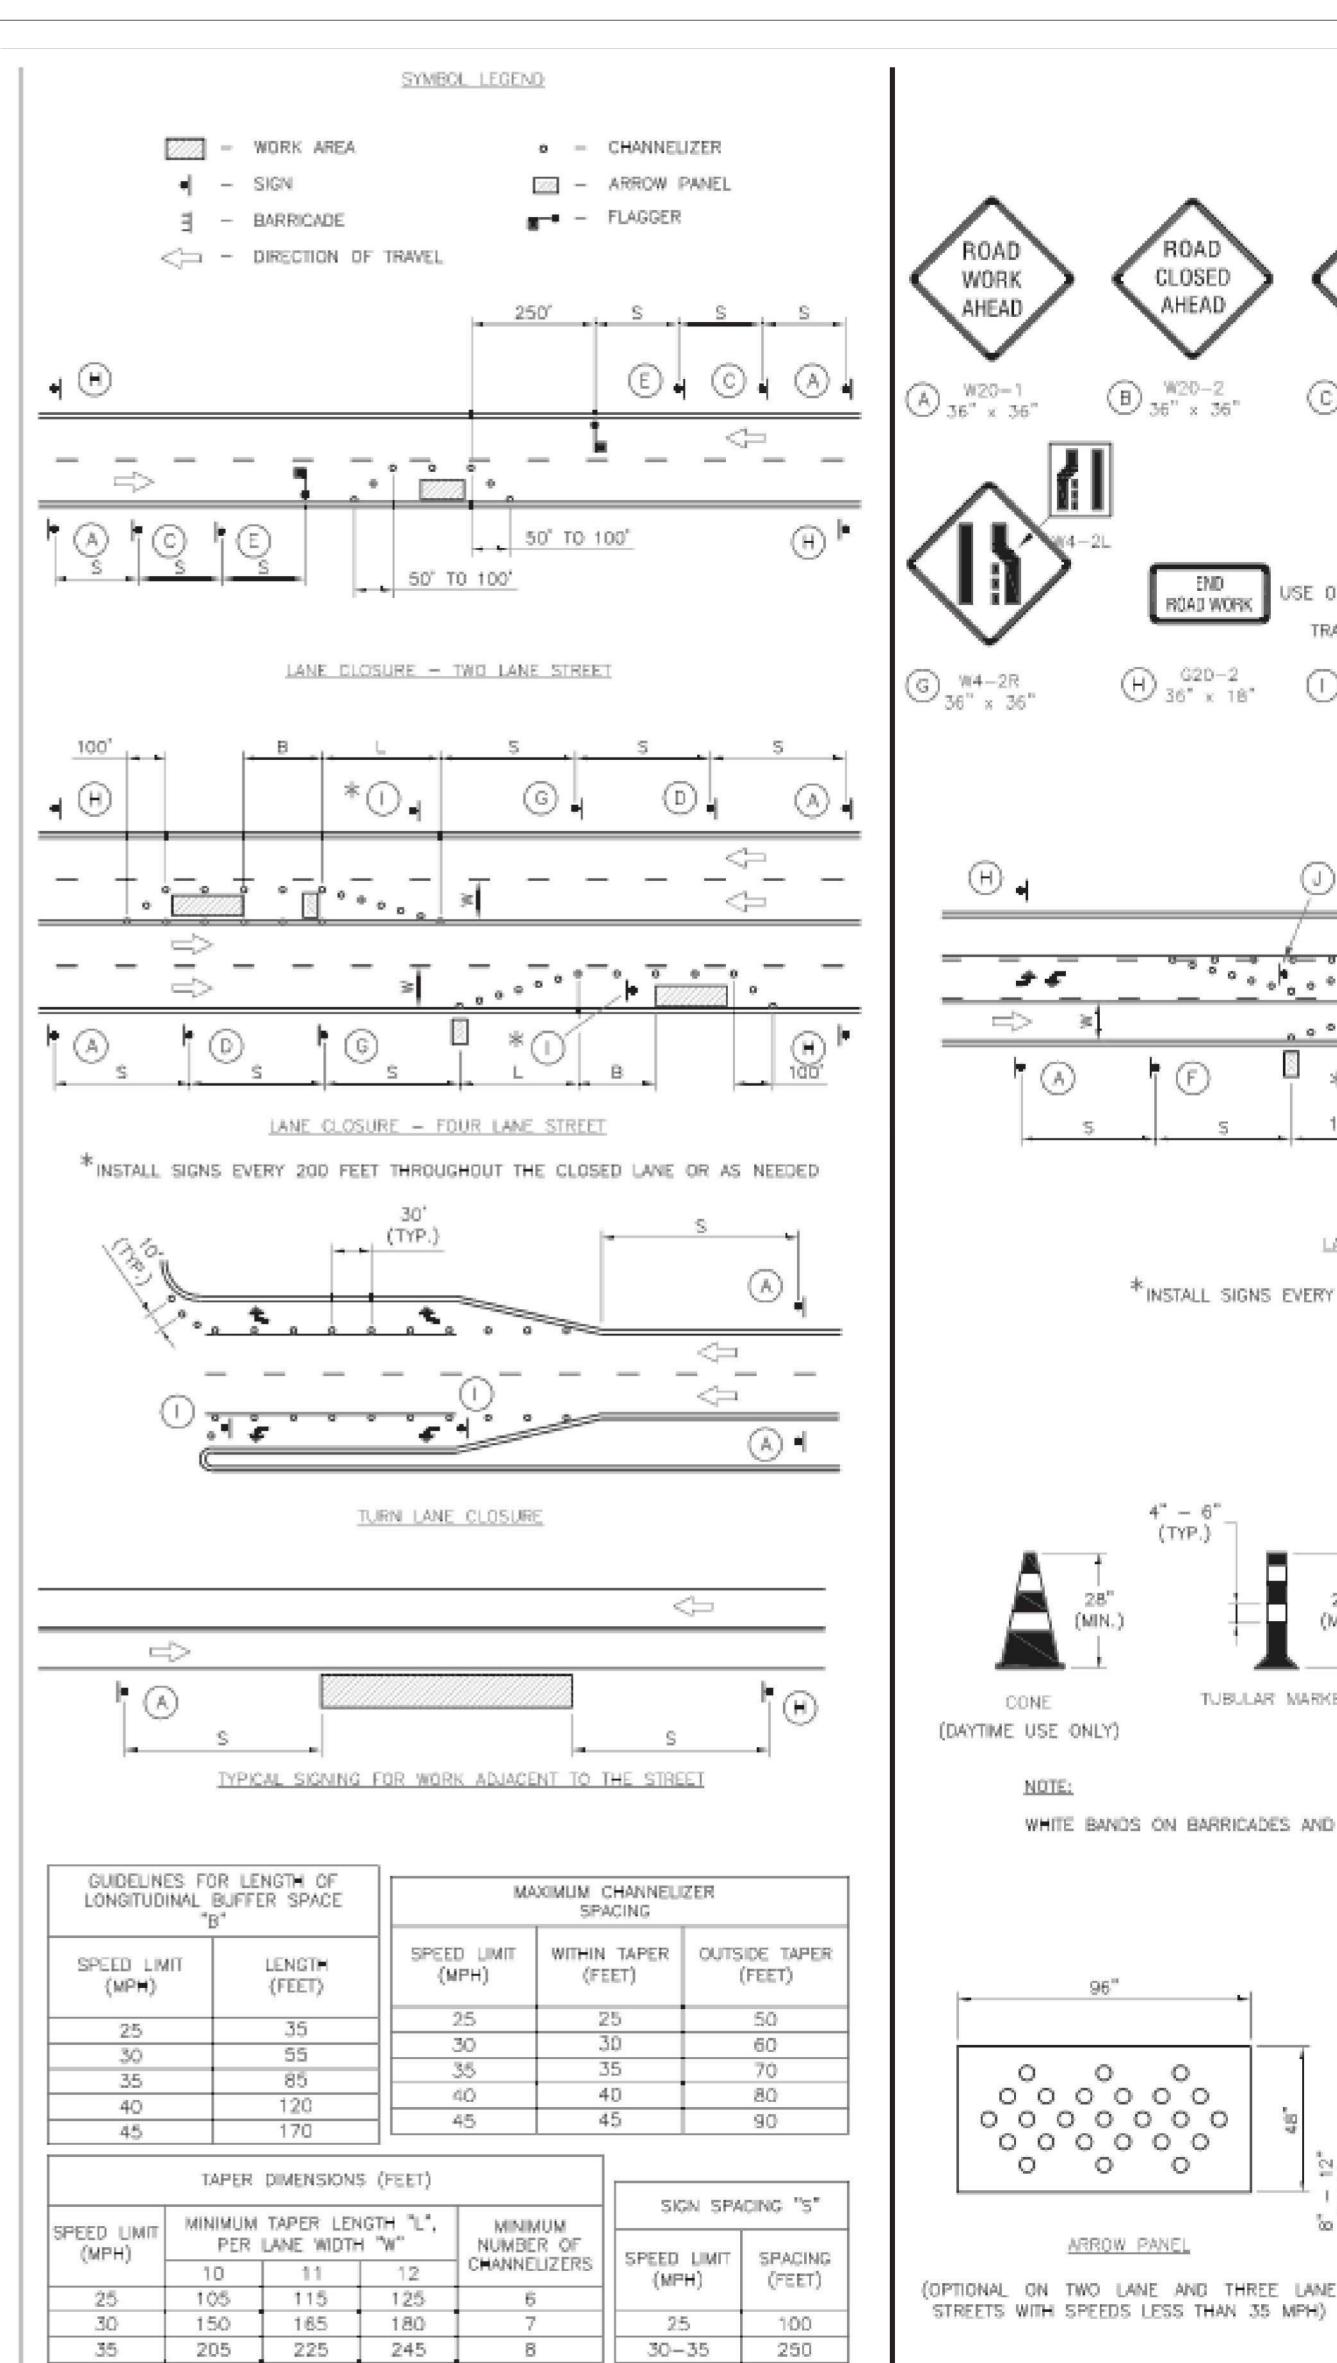
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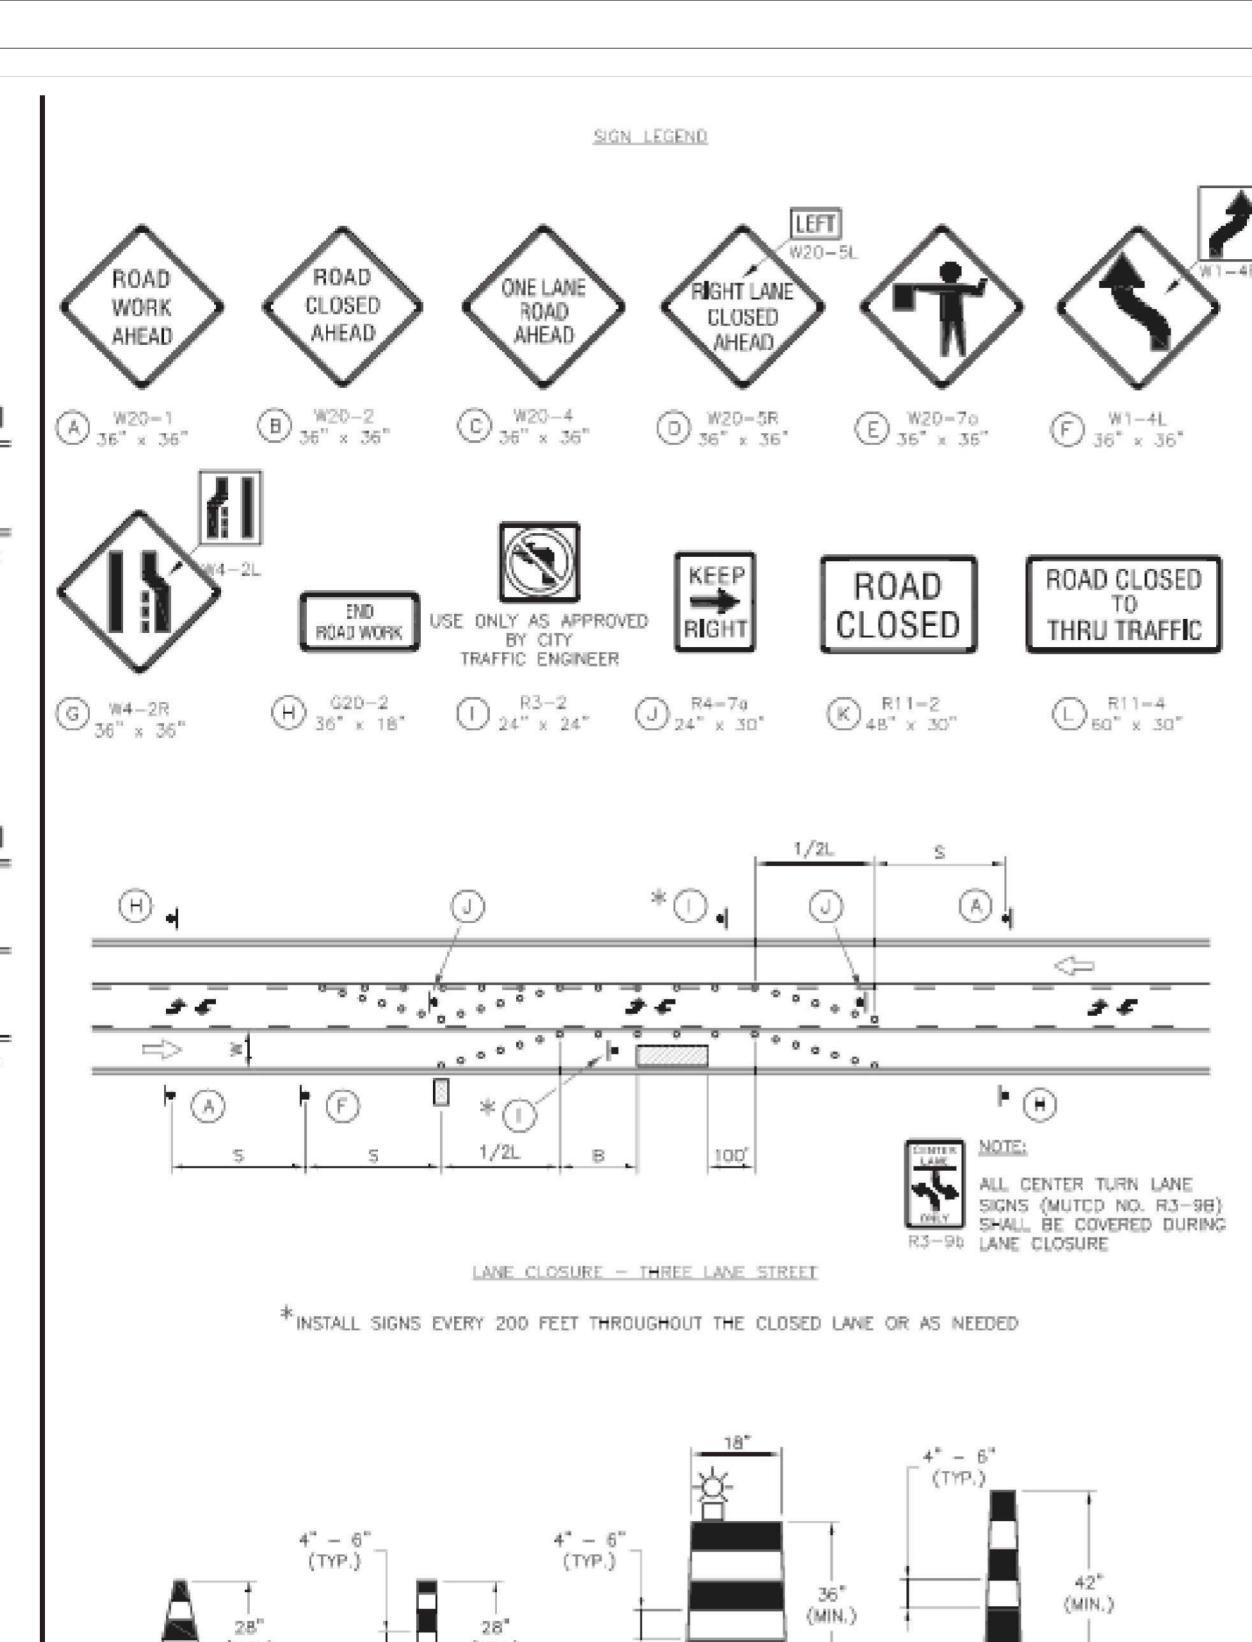
APPROVED BY: BB


CAP NOTES

G005 SHEET 006 OF 133



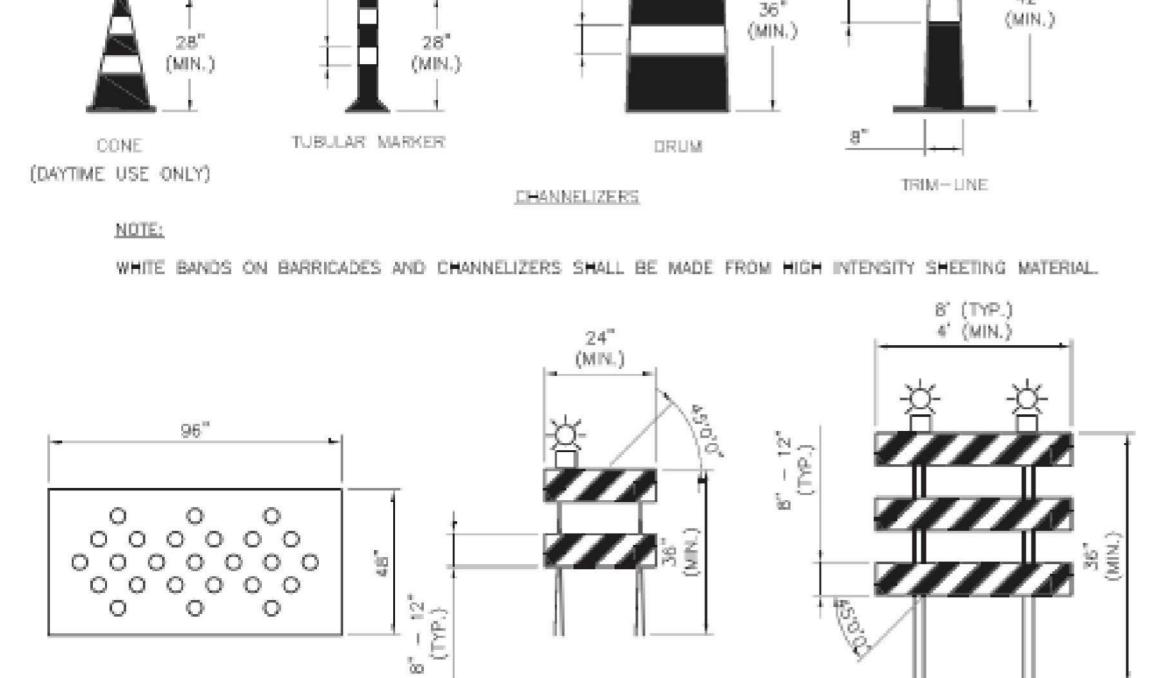270 295 320 9 450 495 540 13





TYPE 2

TYPE 3

BARRICADES

ARROW PANEL


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GENERAL NOTES:

- ALL SIGNS, BARRICADES, CHANNELIZERS, MARKINGS AND OTHER TRAFFIC CONTROL DEVICES SHALL CONFORM TO THE LATEST EDITION OF THE MANUAL ON UNIFORM TRAFFIC CONTROL DEVICES (MUTCD)

- TRIM-LINES ARE THE CITY'S PREFERRED CHANNELIZING DEVICE. CONES MAY NOT BE USED AT NIGHTTIME. FROM THE WORK AREA
- THE CONTRACTOR SHALL USE BARRICADES, STREET PLATES, OR FENCING AS NEEDED TO EFFECTIVELY SHIELD PEDESTRIAN AND VEHICULAR TRAFFIC FROM EXPOSED OBJECTS, EXCAVATIONS, AND CONSTRUCTION **ACTIVITIES**
- ACCESS SHALL BE MAINTAINED TO ALL DRIVEWAYS AND SIDE STREETS UNLESS NOTED OTHERWISE ON THE PLANS.
- TRAFFIC ENGINEER AT LEAST 7 DAYS IN ADVANCE OF ANY STREET CLOSURE, IF A ROUTE AROUND THE CLOSURE IS TO BE PROVIDED, ALL DETOUR SIGNING SHALL BE AS SHOWN ON
- CONSTRUCTION VEHICLES PARKED ALONG STREETS SHALL BE LOCATED WITHIN THE WORK AREA (TRAFFIC CONTROL) OR WHERE OTHERWISE NORMALLY PERMITTED. CONSTRUCTION MATERIALS, INCLUDING TRAFFIC CONTROL AND VEHICLES SHALL NOT RESTRICT SIGHT DISTANCE FOR VEHICLES EXITING AT STREETS OR

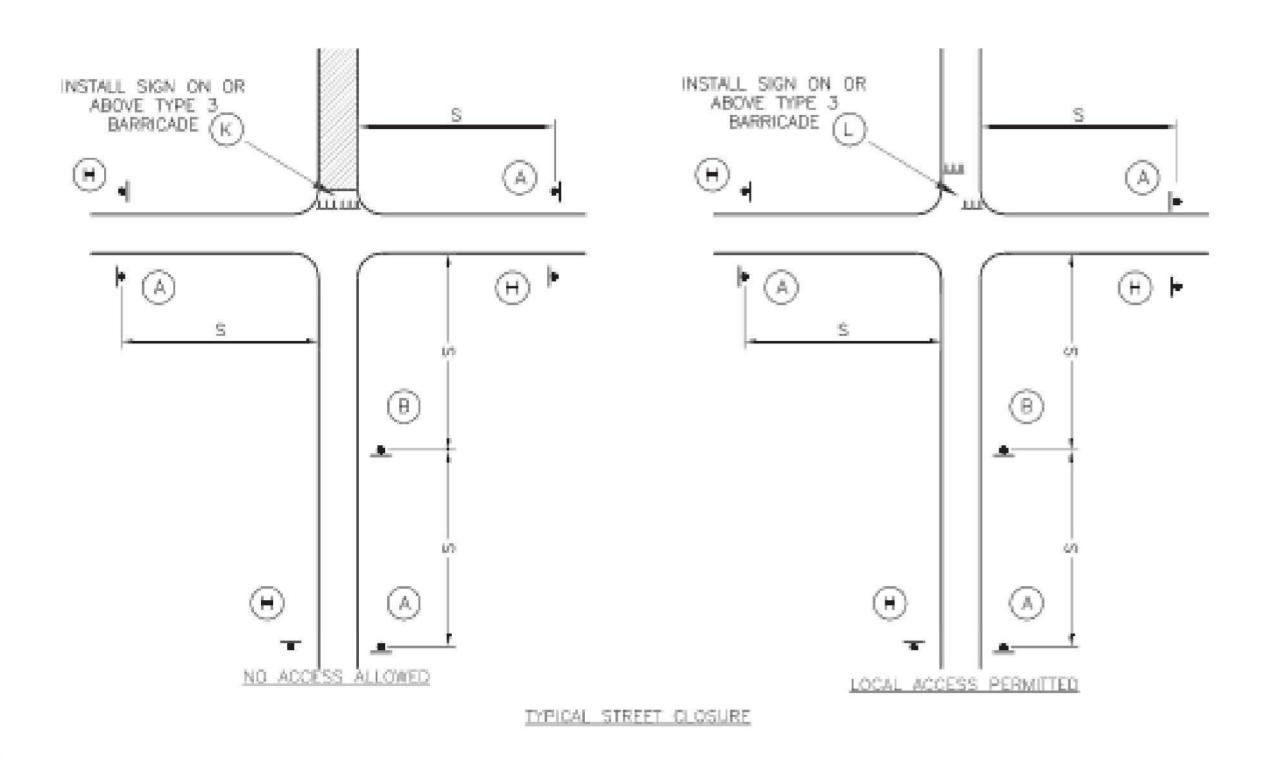- LANES SHOULD BE AT LEAST 11 FEET WIDE UNLESS OTHERWISE AUTHORIZED BY THE CITY TRAFFIC ENGINEER, A "NARROW LANES" SIGN SHALL BE INSTALLED IN ADVANCE OF A LANE WIDTH
- ALL EDGE DROP-OFFS OF MORE THAN 2 INCHES AND LESS THAN 4 INCHES SHOULD BE PROTECTED BY A DROP-OFFS GREATER THAN 4 INCHES SHALL HAVE EDGE PROTECTION (SEE TRAFFIC CONTROL SPECIFICATIONS FOR EDGE TREATMENT REQUIREMENTS).
- 15. THE "WORKERS" SYMBOLIC SIGN (MUTCO NO. W21-1A) MAY BE USED INSTEAD OF THE "ROAD WORK AHEAD" SIGN FOR WORK WITH A DURATION OF 12 HOURS OR LESS. THE "END ROAD WORK" SIGN IS NOT
- REQUIRED TO BE INSTALLED AFTER THE "WORKERS" SIGN. 16. NO TRAFFIC SIGNAL SHALL BE ALTERED OR MODIFIED IN ANY WAY WITHOUT A PLAN APPROVED BY THE
- 17. THE CONTRACTOR SHALL BE RESPONSIBLE FOR MAINTAINING ALL TRAFFIC CONTROL DEVICES ON AN AROUND-THE-CLOCK BASIS, WHETHER OR NOT WORK IS ACTIVELY BEING PURSUED AND ANY DEFICIENCIES
- CONSTRUCTION HAS STARTED. IN NO WAY DO THE REQUIREMENTS SHOWN ON THESE PLANS RELIEVE THE CONTRACTOR OF HIS RESPONSIBILITY FOR SELECTING THE PROPER TRAFFIC CONTROL IMPLEMENTATION PROCEDURES THAT WILL ASSURE THE SAFETY OF DRIVERS, PEDESTRIANS, AND WORKERS AT ALL TIMES.
- 19. SHOULD THE CONTRACTOR FAIL TO ENFORCE THE TRAFFIC CONTROL PLAN OR FAIL TO CLEAN, REPLACE OR OTHERWISE MAINTAIN THE TRAFFIC CONTROL DEVICES WHEN DIRECTED TO DO SO BY THE CITY TRAFFIC ENGINEER OR REPRESENTATIVE, THE CITY MAY TAKE ONE OR MORE OF THE FOLLOWING ACTIONS:
- EMPLOY ANOTHER AGENCY TO CORRECT DEFICIENCIES IN TRAFFIC CONTROL DEVICES AND DEDUCT THE COST FROM THE CONTRACTOR'S PAY ESTIMATE
- STOP THE WORK UNTIL DEFICIENCIES ARE CORRECTED.
- SUSPEND ALL PAY ESTIMATES UNTIL DEFICIENCIES ARE CORRECTED, OR
- D. PLACE THE CONTRACTOR IN DEFAULT.






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SUMMIT LEE'S SA Z

TERMINAL - 17932172



LEE'S SUMMIT MUNICIPAL AIRPORT LEE'S SUMMIT, MO

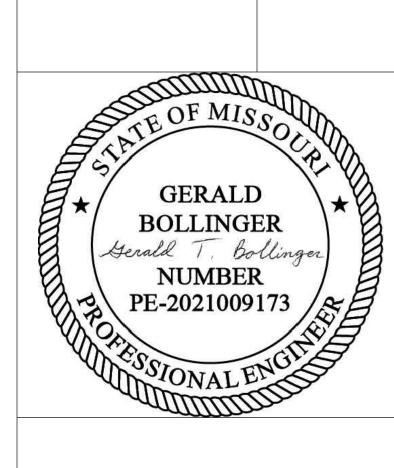MARK DATE DESCRIPTION

PROJECT NO: 17932172

CAD DWG FILE: CAP NOTES DESIGNED BY: WLC DRAWN BY: WLC

CHECKED BY: PHN APPROVED BY: BB

SHEET TITLE

TRAFFIC CONTROL **DETAILS**

> G006 SHEET 007 OF 133

ADDRESS: NE HAGAN RD LEE'S SUMMIT MISSOURI THE CITY OF LEE'S SUMMIT

PROJECT SCOPE

NEW APPROXIMATELY 10,600 SF FOOTPRINT AIRPORT TERMINAL

ADOPTED CODES

2018 INTERNATIONAL BUILDING CODE

2018 INTERNATIONAL MECHANICAL CODE
 2018 INTERNATIONAL PLUMBING CODE
 2017 NATIONAL ELECTRICAL CODE

2018 INTERNATIONAL FIRE CODE2021 LIFE NFPA SAFETY CODE

ICC/ANSI A117.1-2009 ORDINANCES OF THE UNITED GOVERNMENT OF LEE'S SUMMIT, MISSOURI

BUILDING OCCUPANCY, HEIGHT, AND AREA (TABLES 504.3, 504.4 & 506.2) FOR TYPE II-B, FULLY SPRINKLED CONSTRUCTION.

B OCCUPANCY: ALLOWABLE: 69,000 SF, 4 STORIES, 75FT HEIGHT
A-3 OCCUPANCY: ALLOWABLE: 28,500 SF, 3 STORY, 75FT HEIGHT
10,600 SF, 1 STORY + 749 SF MEZZANINE, 27FT HIGH

NON SEPARATED OCCUPANCIES: ALLOWABLE BUILDING AREA IS BASED ON MOST RESTRICTIVE USE.

TYPES OF CONSTRUCTION

FIRE-RESISTANCE RATING REQUIREMENTS OF II-B CONSTRUCTION FOR BUILDING ELEMENTS

BUILDING ELEMENT	FR RATING (HOURS)
PRIMARY STRUCTURAL FRAME	0
EXTERIOR WALLS WITH FIRE SEPARATION DISTANCE > 10'	0
INTERIOR BEARING WALLS	0
NONBEARING WALLS & PARTITIONS	0
FLOOR CONSTRUCTION & ASSOCIATED SECONDARY MEMBERS	0
ROOF CONSTRUCTION & ASSOCIATED SECONDARY MEMBERS	0

FIRE PROTECTION AND LIFE SAFETY SYSTEMS

AUTOMATIC SPRINKLER SYSTEM SHALL BE INSTALLED THROUGHOUT IN ACCORDANCE WITH NFPA 13

NOTE: SPRINKLER SYSTEM IS TO BE DESIGN BUILD BY G.C. - DEFERRED SUBMITTAL ALARM SYSTEM IS TO BE DESIGN BUILD BY GC - DEFERRED SUBMITTAL

-G.C.SHALL PROVIDE CUT SHEETS FOR IMPACT RESISTANT DOORS, WINDOWS, ETC TO THE CITY AS REQUIRED, DEFERRED SUBMITTAL

EXITING

1004.2 OCCUPANT LOAD			
BUSINESS	150 GROSS	1,637 SF	15
ASSEMBLY CONCENTRATED (QUEUING)	7 NET	126 SF	18
ASSEMBLY UNCONCENTRATED	15 NET	4,374 SF	289
ACCESSORY STORAGE/MECHANICAL	300 GROSS	874 SF	5
LOCKER ROOM	50 GROSS	226 SF	5
TOTAL OCCUPANT LOAD	•		332

EXIT ACCESS - COMMON PATH OF EGRESS TRAVEL PER TABLE 1006.2.1
B & A3 OCCUPANCY WITH SPRINKLER SYSTEM
B OCCUPANTS = 100'

A OCCUPANCY = 75'

EXITS REQUIRED BASED ON OCCUPANCY: 2

EXIT AND EXIT ACCESS DOORWAYS

B OCCUPANCY: MORE THAN ONE EXIT REQUIRED WHEN OCCUPANT LOAD EXCEEDS 49

EXIT ARRANGEMENT WITH SPRINKLER: NOT LESS THE ONE-THIRD THE LENGTH OF THE

EXIT ACCESS TRAVEL DISTANCE WITH SPRINKLER SYSTEM PER TABLE 1017.2

MAXIMUM OVERALL DIAGONAL DIMENSION OF AREA TO BE SERVED

B OCCUPANCY: 300' A OCCUPANCY: 250'

REFER TO CODE PLANS FOR EGRESS WIDTHS REQUIRED AND PROVIDED AT DOORS.

MINIMUM CORRIDOR WIDTH:

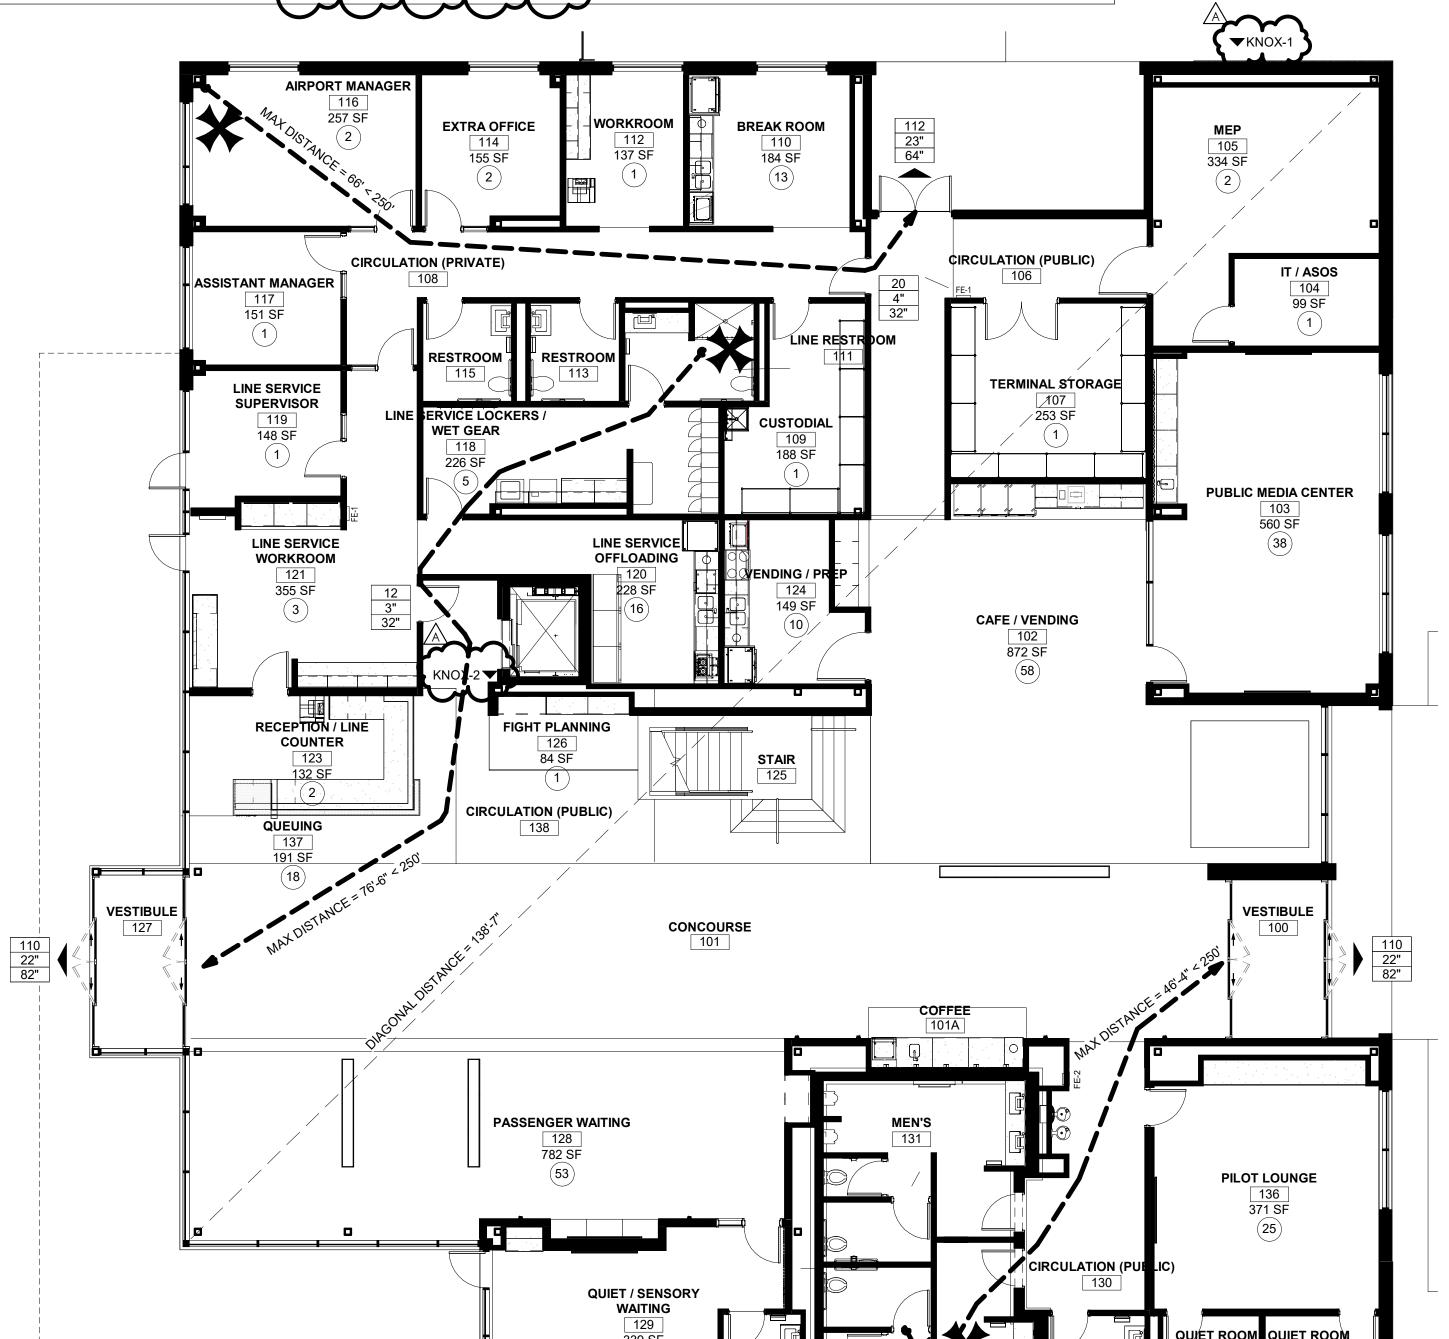
REQUIRED OCCUPANCY CAPACITY < 50 = 36" REQUIRED OCCUPANCY CAPACITY > 50 = 44"

SEISMIC INFORMATION - REFER TO STRUCTURAL DRAWINGS
RISK CATEGORY:
SEISMIC IMPORTANCE FACTOR: 1.0
SITE CLASS:
D

SEISMIC DESIGN CATEGORY: B

CODE PLANS LEGEND START LOCATION OF MAXIMUM

◀ FE-1 SEMI RECESSED MOUNTED 2-A:20-B:C **ROOM NAME →**XXXXXX FIRE EXTINGUISHER ROOM NUMBER • XXX TRAVEL DISTANCE SQUARE FEET → XXX SF RECESSED MOUNTED 2-A:20-B:C FIRE EXTINGUISHER TRAVEL PATH NUMBER OF OCCUPANTS **→** (X) FIRE EXTINGUISHER AND CABINET TYPE DESIGNATION. • XXXX PORTABLE FIRE EXTINGUISHERS ARE REQUIRED TO BE OCCUPANT EGRESS -INSTALLED IN ACCORDANCE WITH SECTION 906. → XXXX EGRESS WIDTH REQUIRED EXIT LOAD (PERSON) EGRESS WIDTH PROVIDED -• XXXX 1 HR RATED **▼** KNOX-1 **____** 2 HR RATED **♦** KNOX-2 ELEVATOR KNOX BOX



PLUMBING FIXTURES: (SECTION 29 TABLE 2902.1)

PLUMBING FIXTURE CALCULATIONS:

	WATER CLC	<u>SETS</u>	<u>URINALS</u>	<u>LAVATORIES</u>	
BUSINESS ASSEMBLY	REQUIRED 2 2	PROVIDED 2 6	PROVIDED 0 2	REQUIRED 1 1	PROVIDED 3 5
TOTAL	4	8	2	2	8
	DRINKING F	<u>OUNTAIN</u>	SERVICE	<u>SINK</u>	
BUSINESS ASSEMBLY (LO	REQUIRED 1 3BY) 1	PROVIDED: 1 1	REQUIREI 1 1	D PROVIDED: 1 0	

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1701 WALNUT STREET, SUITE 300 KANSAS CITY, MO 64108

KANSAS CITY, MO 64108

E'S SUMMIT, MISSOURI

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of Auth

11-25-2024

LEES SUMMIT MUNICIPAL AIRPORT LEES SUMMIT, MO

A 01.03.25 CITY REVIEW COMMENTS
MARK DATE DESCRIPTION

PROJECT NO: 2403

REVIT FILE: 2403 Lee's Summit Terminal-R24.rvt

CHECKED BY: JSB

APPROVED BY: Approver

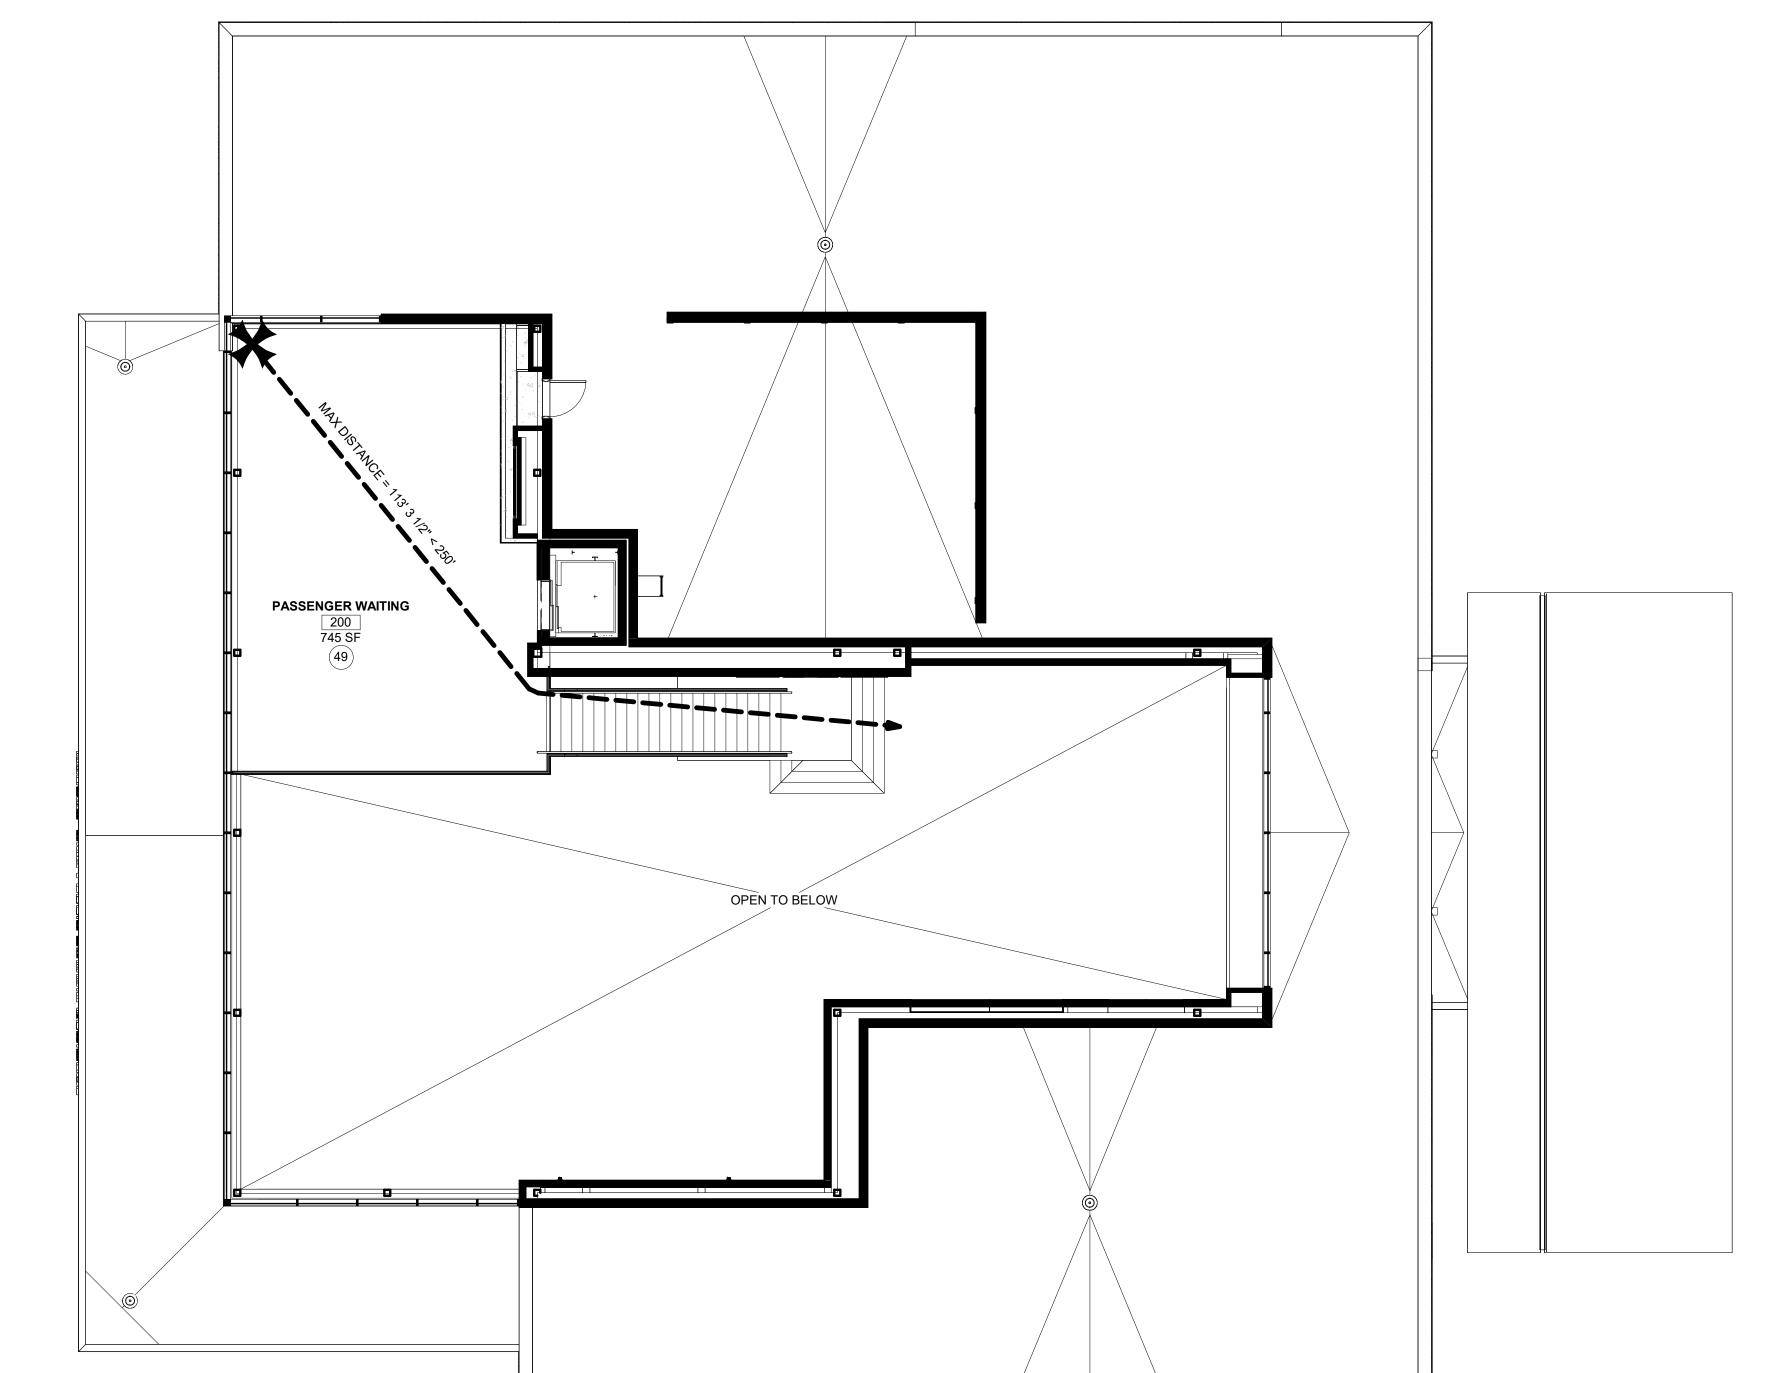
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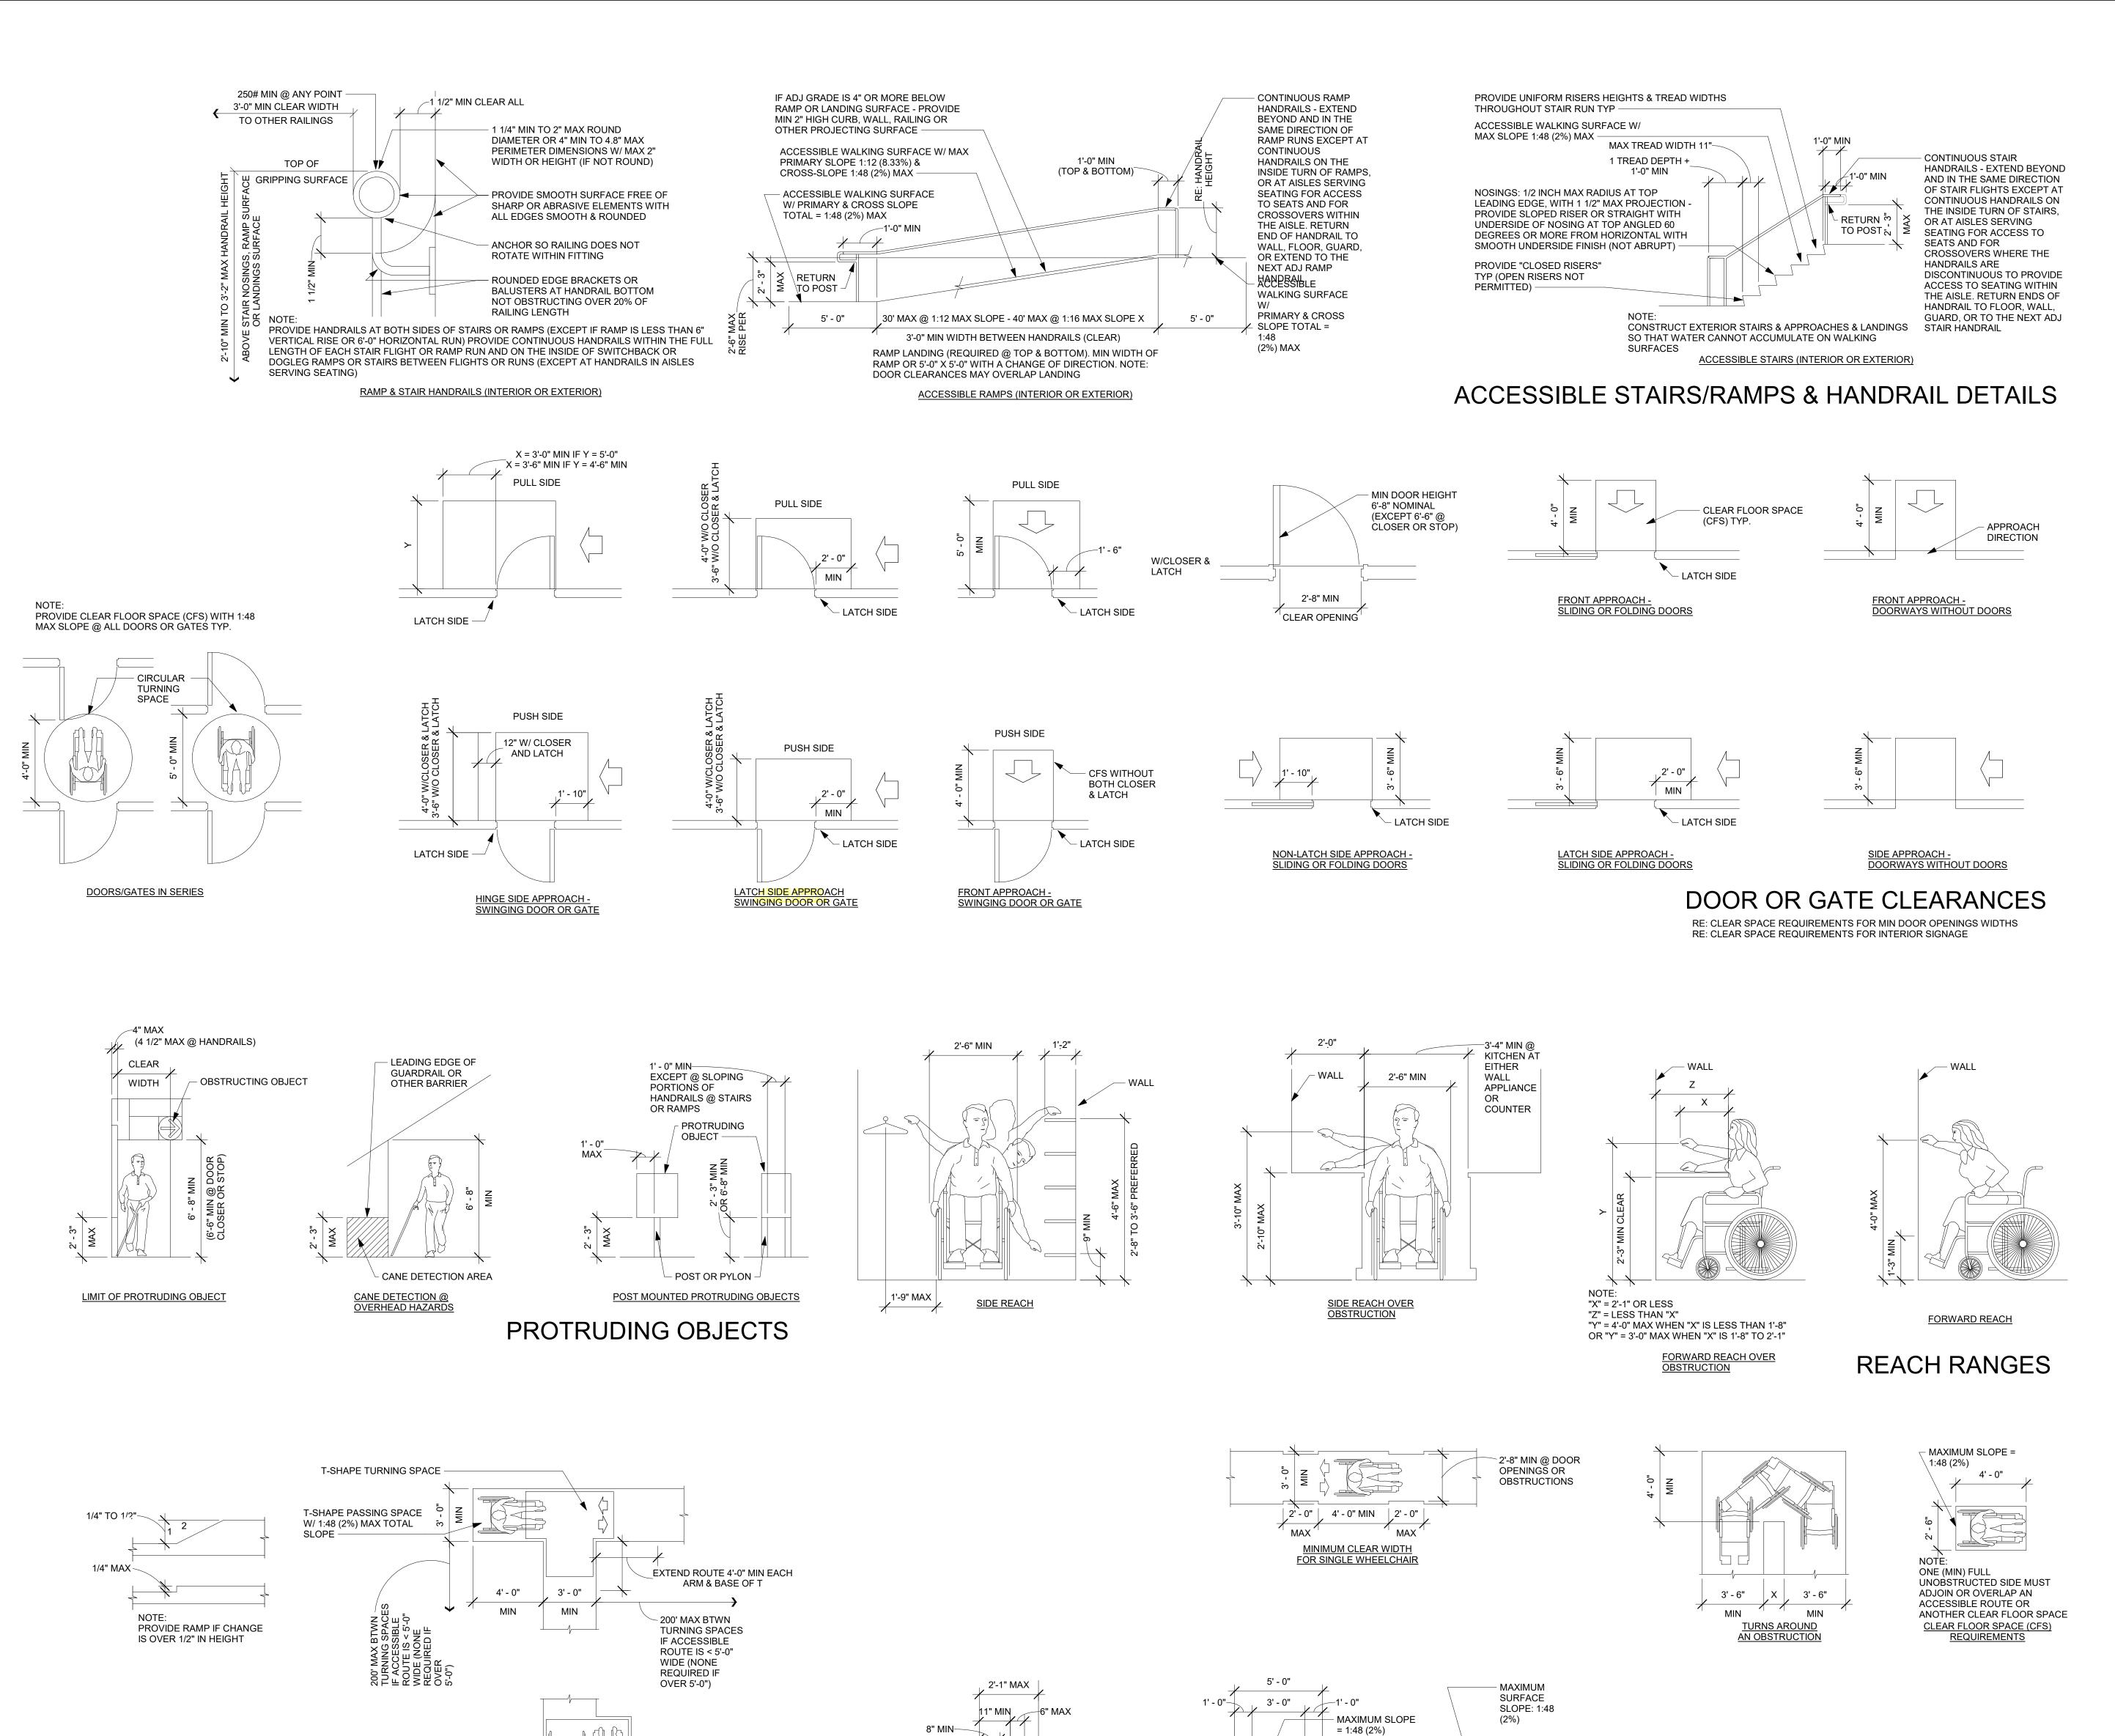
1ST FLOOR CODE PLAN 1

DRAWN BY: EM

CODE INFORMATION
AND PLANS

G-007
SHEET OF





ACCESSIBLE ELEMENT

MIN KNEE CLEARANCE

MIN TOE CLEARANCE —

KNEE AND TOE CLEARANCES

MINIMUM @ ACCESSIBLE ELEMENT

MINIMUM ALLOWABLE IN CLEAR FLOOR SPACE

UNDER ELEMENT OR @ TURNING SPACE

THE INFORMATION ON THESE ACCESSIBILITY DRAWINGS IS PROVIDED AS A GUIDE TO THE CONTRACTOR AND TO ANY OTHER ENTITIES INSTALLING BUILDING EQUIPMENT OR FIXTURES. THESE DRAWINGS ARE ABBREVIATED AND DO NOT INDICATE ALL CONDITIONS THAT MAY BE ENCOUNTERED AND THEY DO NOT INCLUDE ALL REQUIREMENTS OF EITHER THE ADA OR ICC/ANSI A117.1 IN THEIR ENTIRETY.

THE AMERICANS WITH DISABILITIES ACT (ADA) IS A CIVIL-RIGHTS LAW (NOT A BUILDING CODE) AND IS THEREFORE NOT NECESSARILY ENFORCEABLE BY AUTHORITIES HAVING JURISDICTION. EXCEPT IN CERTAIN STATES WITH THEIR OWN ACCESSIBILITY REQUIREMENTS

CERTAIN STATES WITH THEIR OWN ACCESSIBILITY REQUIREMENTS (INCLUDING BUT NOT LIMITED TO CALIFORNIA, TEXAS & ILLINOIS), THE ACCESSIBILITY REQUIREMENTS OF ICC/ANSI A117.1 ARE TYPICALLY REQUIRED THROUGH THE BUILDING CODE.

COMPLY WITH REQUIREMENTS OF THE AMERICANS WITH DISABILITIES ACT (ADA) EVEN IF NOT REQUIRED BY BUILDING CODES, REGULATIONS OR ORDINANCES (ADA IS A FEDERAL LAW), AND AS INDICATED ON THESE DRAWINGS:

ACCESSIBLE ROUTE:

PROVIDE AN ACCESSIBLE ROUTE CONNECTING ALL ACCESSIBLE SPACES AND ELEMENTS, INCLUDING WALKING SURFACES, RAMPS & CURB-RAMPS (EXCLUDING THE FLARED SIDES), DOORS & DOORWAYS, AND/OR ELEVATORS & PLATFORM LIFTS. AN ACCESSIBLE ROUTE MAY BE LOCATED AT EXTERIOR WALKS, AISLES, HALLS, CORRIDORS, SKYWALKS OR TUNNELS

ACCESSIBLE WALKING SURFACES: PROVIDE STABLE, FIRM, & SLIP-RESISTANT SURFACE FINISHES W/ SURFACE OPENINGS (GRATINGS) NOT TO PERMIT PASSAGE OF A 1/2" DIAMETER SPHERE - WITH LONGEST DIMENSION PERPENDICULAR TO DIRECTION OF TRAVEL

MINIMUM WHEELCHAIR TURNING SPACE CAN INCLUDE ALLOWABLE FIXTURE KNEE & TOE CLEARANCES UNO. DOOR SWINGS ARE PERMITTED TO OVERLAP TURNING SPACE UNO.

ACCESSIBLE BUILDING ENTRANCES:

PROVIDE 60% (MIN) OF ALL PUBLIC BUILDING ENTRANCES (EXCLUDING THOSE FOR LOADING OR SERVICE USE) ACCESSIBLE FROM: ACCESSIBLE PARKING, A PUBLIC TRANSPORTATION STOP, OR FROM A PASSENGER LOADING ZONE (AS APPLICABLE) WITHOUT STEPS OR ABRUPT CHANGES IN LEVEL.

PROVIDE ONE (1 - MIN) ACCESSIBLE BUILDING ENTRANCE AT THE GROUND FLOOR LEVEL AND ONE (1 - MIN) ACCESSIBLE ENTRANCE TO EACH PROPOSED TENANT SPACE IN A MULTIPLE-TENANT BUILDING.

PROVIDE ACCESSIBLE ENTRANCE AT SERVICE OR LOADING ENTRIES (NOT INTENDED FOR ENTRANCE BY THE PUBLIC) IF THAT IS THE ONLY ENTRANCE TO A SPACE OR BUILDING.

MULTI-LEVEL BUILDINGS: PROVIDE ONE (1 - MIN) ACCESSIBLE ROUTE (INCLUDING AN ELEVATOR TO CONNECT EACH BUILDING LEVEL ABOVE OR BELOW ACCESSIBLE LEVELS INCLUDING MEZZANINES) UNLESS THE FLOOR-AREA IS LESS THAN 3,000 SF AND DOES NOT INCLUDE FIVE (5) OR MORE MULTIPLE MERCANTILE (GROUP M) TENANTS, OR THE OFFICES OF HEALTH CARE PROVIDERS.

OPERABLE PARTS:

ACCESSIBLE OPERABLE PARTS INCLUDE CONTROLS AND OPERATING MECHANISMS (DOOR HARDWARE, WINDOW OPERATORS, DISPENSERS, LIGHT SWITCHES, CONVENIENCE OUTLETS, THERMOSTATS, ALARM CONTROLS, AND SIMILAR ELEMENTS).

OPERATION: BY USE OF ONE (1) HAND WITH A SINGLE EFFORT

PROVIDE AN ACCESSIBLE CLEAR-FLOOR SPACE AT ALL OPERATIONAL PARTS

WITHOUT TIGHT GRASPING, PINCHING, OR TWISTING OF THE WRIST WITH FIVE (5.0) POUNDS MAXIMUM OPERATIONAL FORCE. COMPLY WITH ALLOWABLE REACH RANGES FOR HEIGHT OF OPERABLE PARTS.

ACCESSIBLE DOOR & GATE REQUIREMENTS:

SECURITY & MAINTENANCE DOORS (INCLUDING SERVICE-ACCESS DOORS) DO NOT NEED TO COMPLY WITH ACCESSIBILITY REQUIREMENTS.

REVOLVING DOORS OR GATES ARE NOT ACCESSIBLE.

DOUBLE-LEAF DOORS OR GATES: ONLY ONE LEAF (MIN) MUST COMPLY WITH ACCESSIBILITY REQUIREMENTS

RECESSED DOORS: PROVIDE FORWARD APPROACH CLEARANCE WITH ANY OBSTRUCTION WITHIN 18 INCH OF LATCH SIDE OF DOORWAY PROJECTING MORE THAN 8 INCHES BEYOND THE FACE OF DOOR MEASURED PERPENDICULAR TO FACE OF DOOR.

DOOR SURFACES: PROVIDE SMOOTH SURFACE WITHIN TEN (10) INCH AFF ON PUSH-SIDE EXTENDING FULL WIDTH WITH MAX 1/16 INCH BETWEEN SURFACE PLANE AND ANY PARTS (KICKPLATE). CAP CAVITIES FORMED BY KICKPLATES EXCEPT AT SLIDING DOORS, TEMPERED GLASS DOORS WITHOUT SIDE STILES WITH A BOTTOM RAIL WITH ITS TOP EDGE SLOPED 60 DEGREES FROM HORIZONTAL OR MORE, OR AT DOORS NOT EXTENDING TO 10 INCHES AFF

SIDELITES OR VISION LITES: AT DOORS AND SIDELITES ADJACENT TO DOORS WITH ONE OR MORE GLAZING PANELS PERMITTING VIEWING, PROVIDE BOTTOM EDGE OF AT LEAST ONE PANEL ON EITHER THE DOOR OR THE ADJACENT SIDELITE AT 43 INCHES MAXIMUM AFF, EXCEPT AT VISION LITES (ONLY) WITH THE LOWEST PART MORE THAN 66 INCHES AFF.

ACCESSIBLE DOOR & GATE HARDWARE:

PROVIDE ACCESSIBLE HARDWARE WITH AN EASY-TO-GRASP SHAPE COMPLYING WITH OPERABLE PARTS REQUIREMENTS (LEVERS PUSH/PULLS, OR PANIC DEVICES ARE ACCEPTABLE), MOUNTED BETWEEN 2'-10" AND 4'-0" AFF, WITH MAX PROJECTION (INTO REQUIRED MIN CLEARANCES) OF 4 INCH BTWN 34 - 80 INCH AFF

SLIDING DOOR/GATE HARDWARE: OPERABLE PARTS MUST BE EXPOSED AND USABLE FROM BOTH SIDES WHEN DOOR IS FULLY OPEN

DOOR/GATE CLOSERS: ADJUST UNITS TO PROVIDE FIVE (5) SECOND (MIN) TIME TO MOVE DOOR/GATE FROM 90-DEGREE OPEN-POSITION TO 12-DEGREE OPEN-POSITION.

DOOR/GATE SPRING-HINGES: ADJUST TO PROVIDE 1-1/2 SECOND MINIMUM TIME TO MOVE DOOR/GATE FROM 70-DEGREE OPEN-POSITION TO CLOSED-POSITION

OPENING-FORCE OF CLOSERS OR SPRING-HINGES: 5.0 LBS MAX @ INTERIOR HINGED, SLIDING OR FOLDING DOORS OR GATES (NOT APPLICABLE TO LATCH-BOLT RETRACTION FORCE AND NOT APPLICABLE TO OPENING FORCE AT FIRE-DOORS - TO BE AS REQD BY AJH)

AUTOMATIC DOORS OR GATES:

REFERENCED STANDARDS: COMPLY WITH ANSI/BHMA A156.10. AND FOR POWER-ASSIST AND LOW-ENERGY DOORS, COMPLY WITH ANSI/BHMA A156.19 (UNLESS DOORS OR GATES ARE DESIGNED TO BE OPERATED ONLY BY SECURITY PERSONNEL)

COMPLY WITH ACCESSIBLE CLEAR-FLOOR SPACE, THRESHOLD / FLOOR-SURFACE, AND DOORS-IN- SERIES REQUIREMENTS.

MANUAL CONTROLS: COMPLY WITH "OPERABLE PARTS" REQMTS WITH THE CLEAR FLOOR SPACE ADJACENT TO THE CONTROL SWITCH LOCATED BEYOND THE DOOR/GATE SWING.

ACCESSIBLE WINDOWS:

PROVIDE OPERATIONAL PARTS LOCATED PER "OPERABLE PARTS" REQMTS W/ MIN ACCESSIBLE CLEAR-FLOOR SPACE ADJACENT TO THE WINDOW.

SPECIAL ACCESS (PLATFORM) LIFTS (INTERIOR OR EXTERIOR):

COMPLY WITH ASME A17.1 SAFETY CODE FOR ELEVATORS AND ESCALATORS, SECTION XX (WITH ACCESSIBLE KEY-CONTROLS IF LIFT TRAVEL AREA IS NOT ENCLOSED) AND AS FOLLOWS:

MAXIMUM TRAVEL HEIGHT: 60 INCHES

MINIMUM CAPACITY: 400 POUNDS MINIMUM PLATFORM SIZE: 30 X 48 INCH MAXIMUM SPEED: 20 FPM



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LEES SUMMIT MUNICIPAL AIRPORT

LEES SUMMIT. MO

MARK DATE DESCRIPTION

PROJECT NO: 2403

PROJECT NO: 2403

REVIT FILE: 2403 Lee's Summit Terminal-R24.rvt

DESIGNED BY: Designer

DRAWN BY: EM

CHECKED BY: JSB

SHEET TITLE

APPROVED BY: Approver

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ADA GENERAL ACCESSIBILITY

> G-008 SHEET OF

//2025 9:33:10 AN

ALLOWABLE CHANGE IN LEVEL

- MAX SLOPE = 1:20 (5%) WITH MAX 1:48 (2%)

2'-0" LEVEL

MAX SLOPE OF WALKING SURFACE @ ACCESSIBLE ROUTE

CROSS-SLOPE & STABLE, FIRM

SLIP-RESISTANT SURFACE -

MAX TOTAL SLOPE @

TRANSITION =

1:48 (2%) -

ACCESSIBLE-ROUTE

WALKING SURFACE

PASSING SPACES @ ACCESSIBLE-ROUTE

ACCESSIBLE ROUTES REQUIREMENTS

- 5'-0" X 5'-0"

PASSING SPACE

TOTAL SLOPE

W/ 1:48 (2%) MAX

(OR WALLS)

CLEAR SPACE REQUIREMENTS

WALKIN

SURFAC

SPACE

CLEAR FLOOR

(FORWARD

APPROACH)

5'-0" IF D IS 1'-3" OR MORE

4"-0" IF D IS LESS THAN 1'-3"

ACCESSIBLE ROUTE

SIDE APPROACH IN ALCOVE

3'-0" IF D IS 2'-0" OR 2'-6" IF D IS LESS THAN

WALKING

- CLEAR

FLOOR

SPACE

ACCESSIBLE ROUTEPROACH)

FORWARD APPROACHING ALCOVE

(FORWARD

SURFACE

 \bigcirc

5' - 0"

MIN

BELOW AN OBSTRUCTION ARE

CIRCULAR TURNING SPACE

KNEE & TOE CLEARANCES

PERMITTED

APPROACH

FROM

EITHER

"ARM" OR


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KNEE & TOE CLEARANCE BELOW AN


OBSTRUCTION PERMITTED AT EITHER AN

"ARM" OR AT THE "BASE" (BUT NOT AT BOTH)

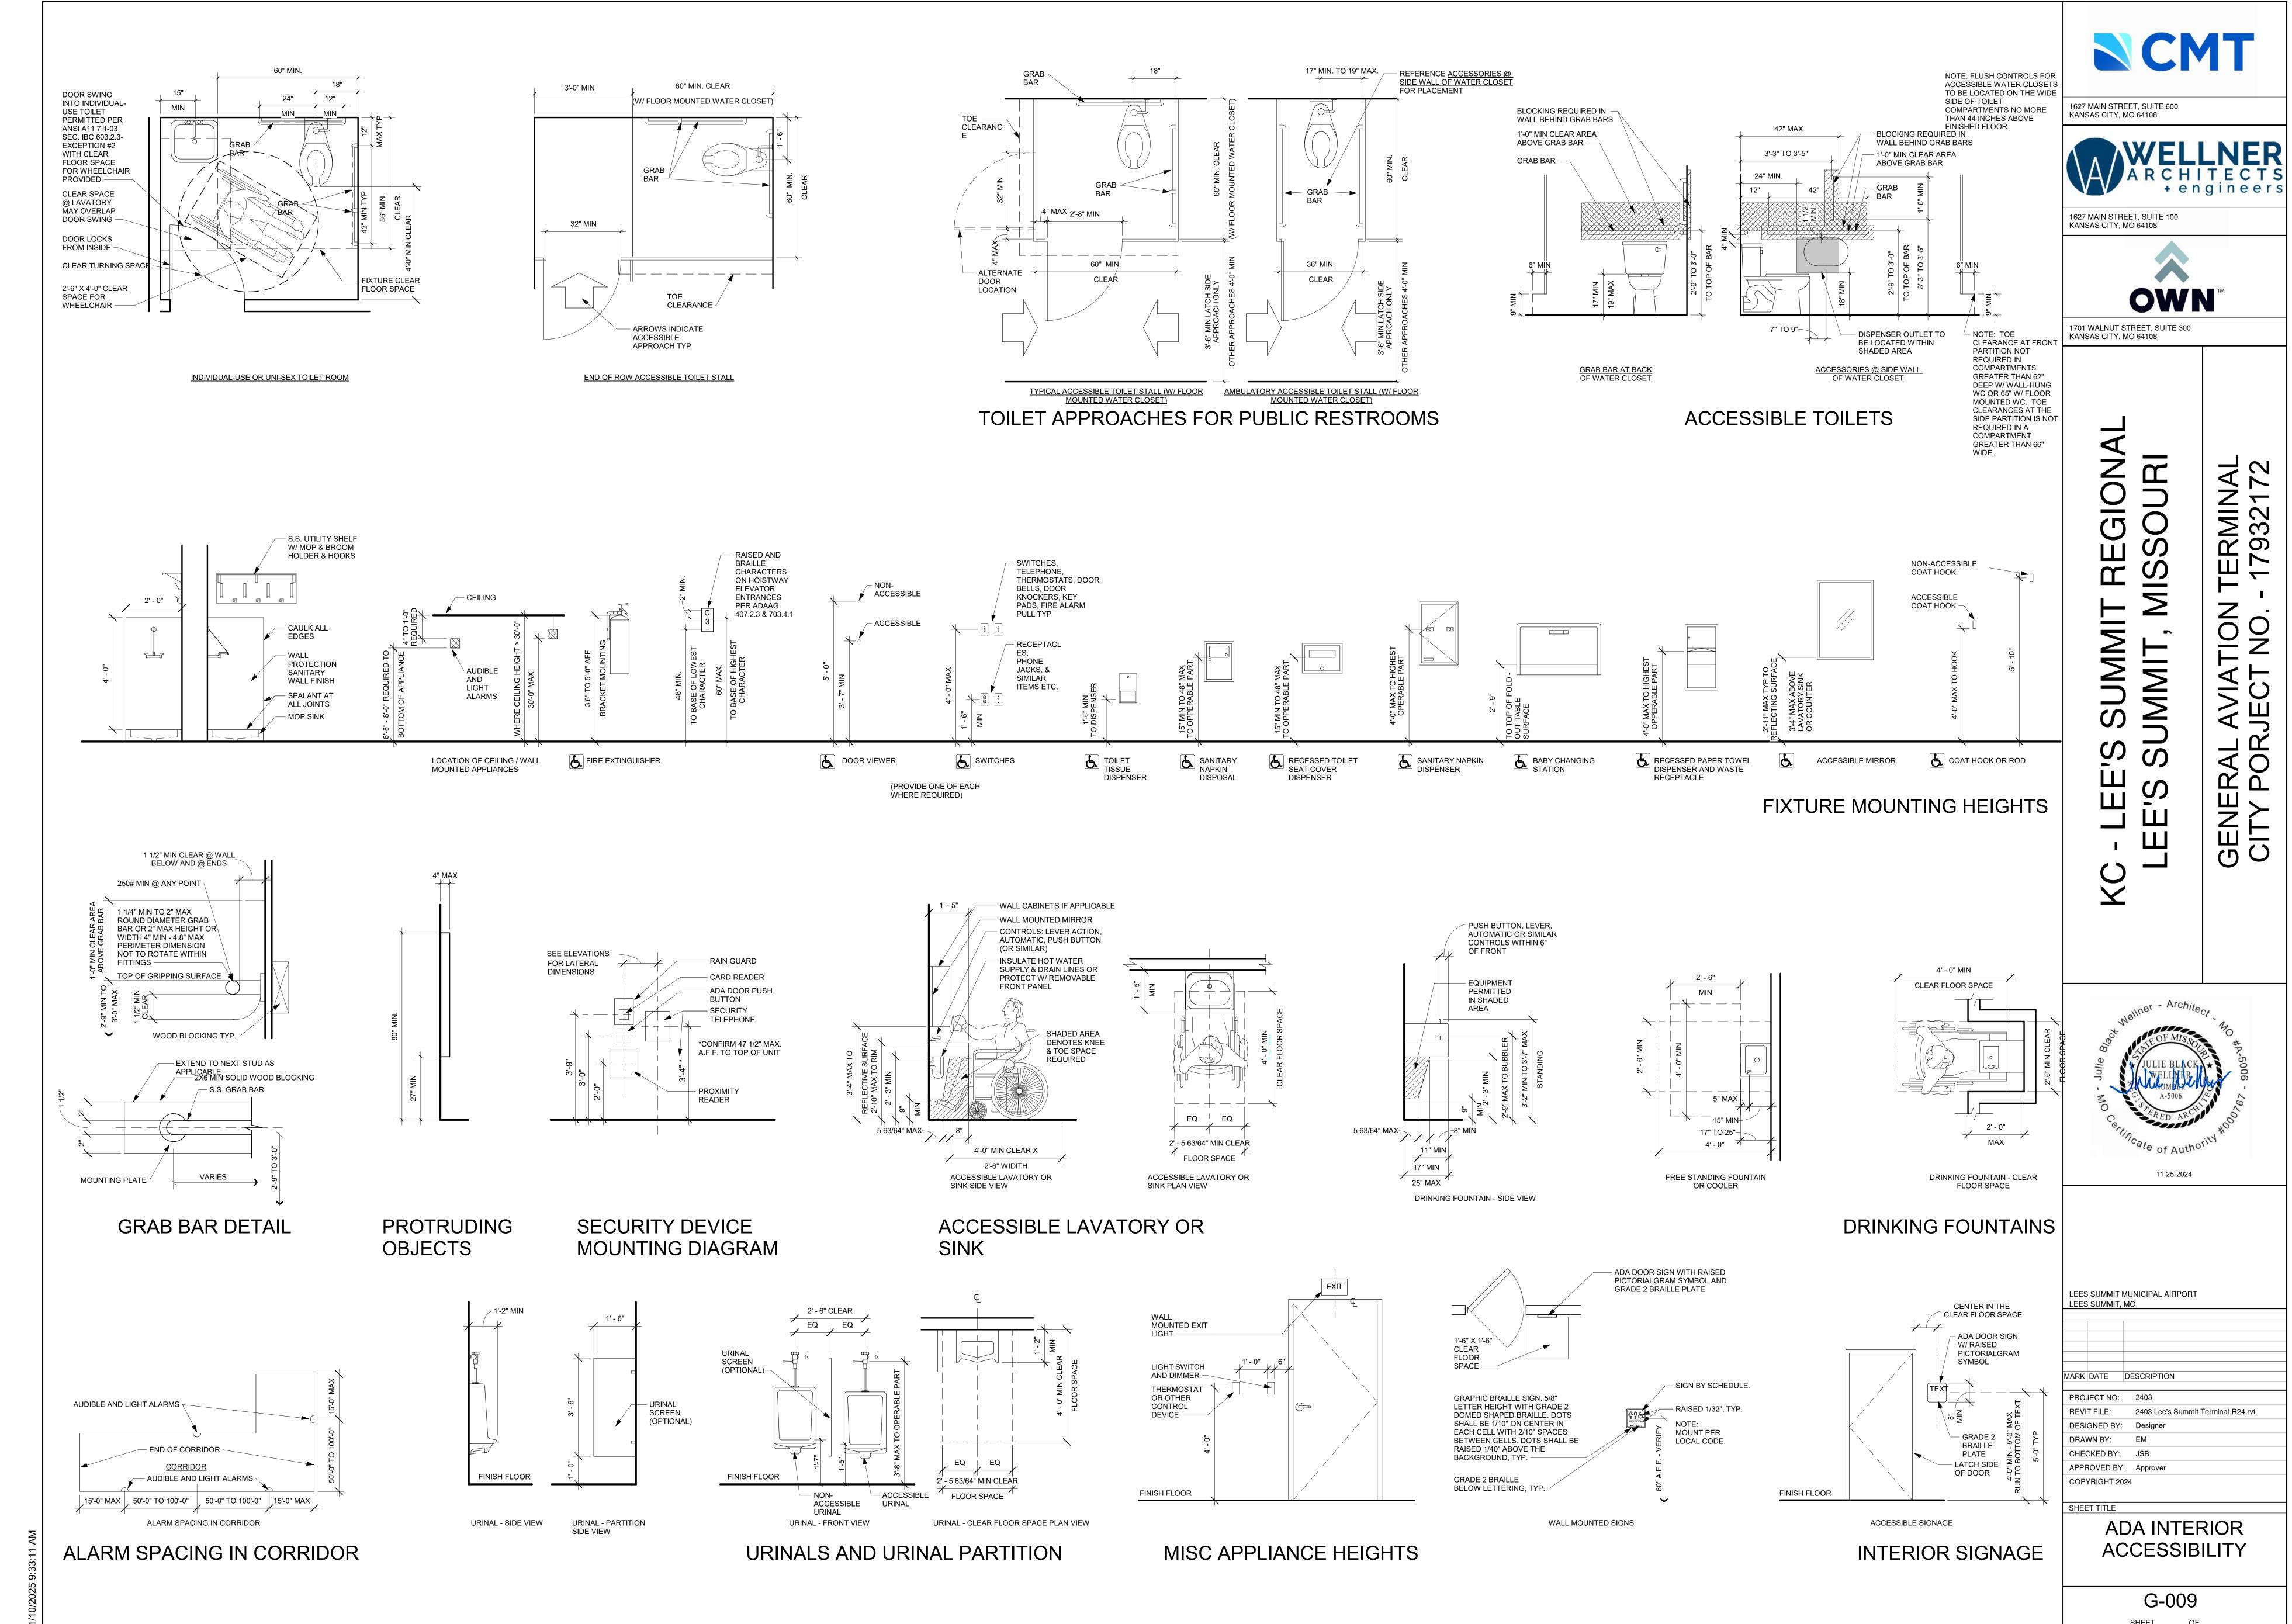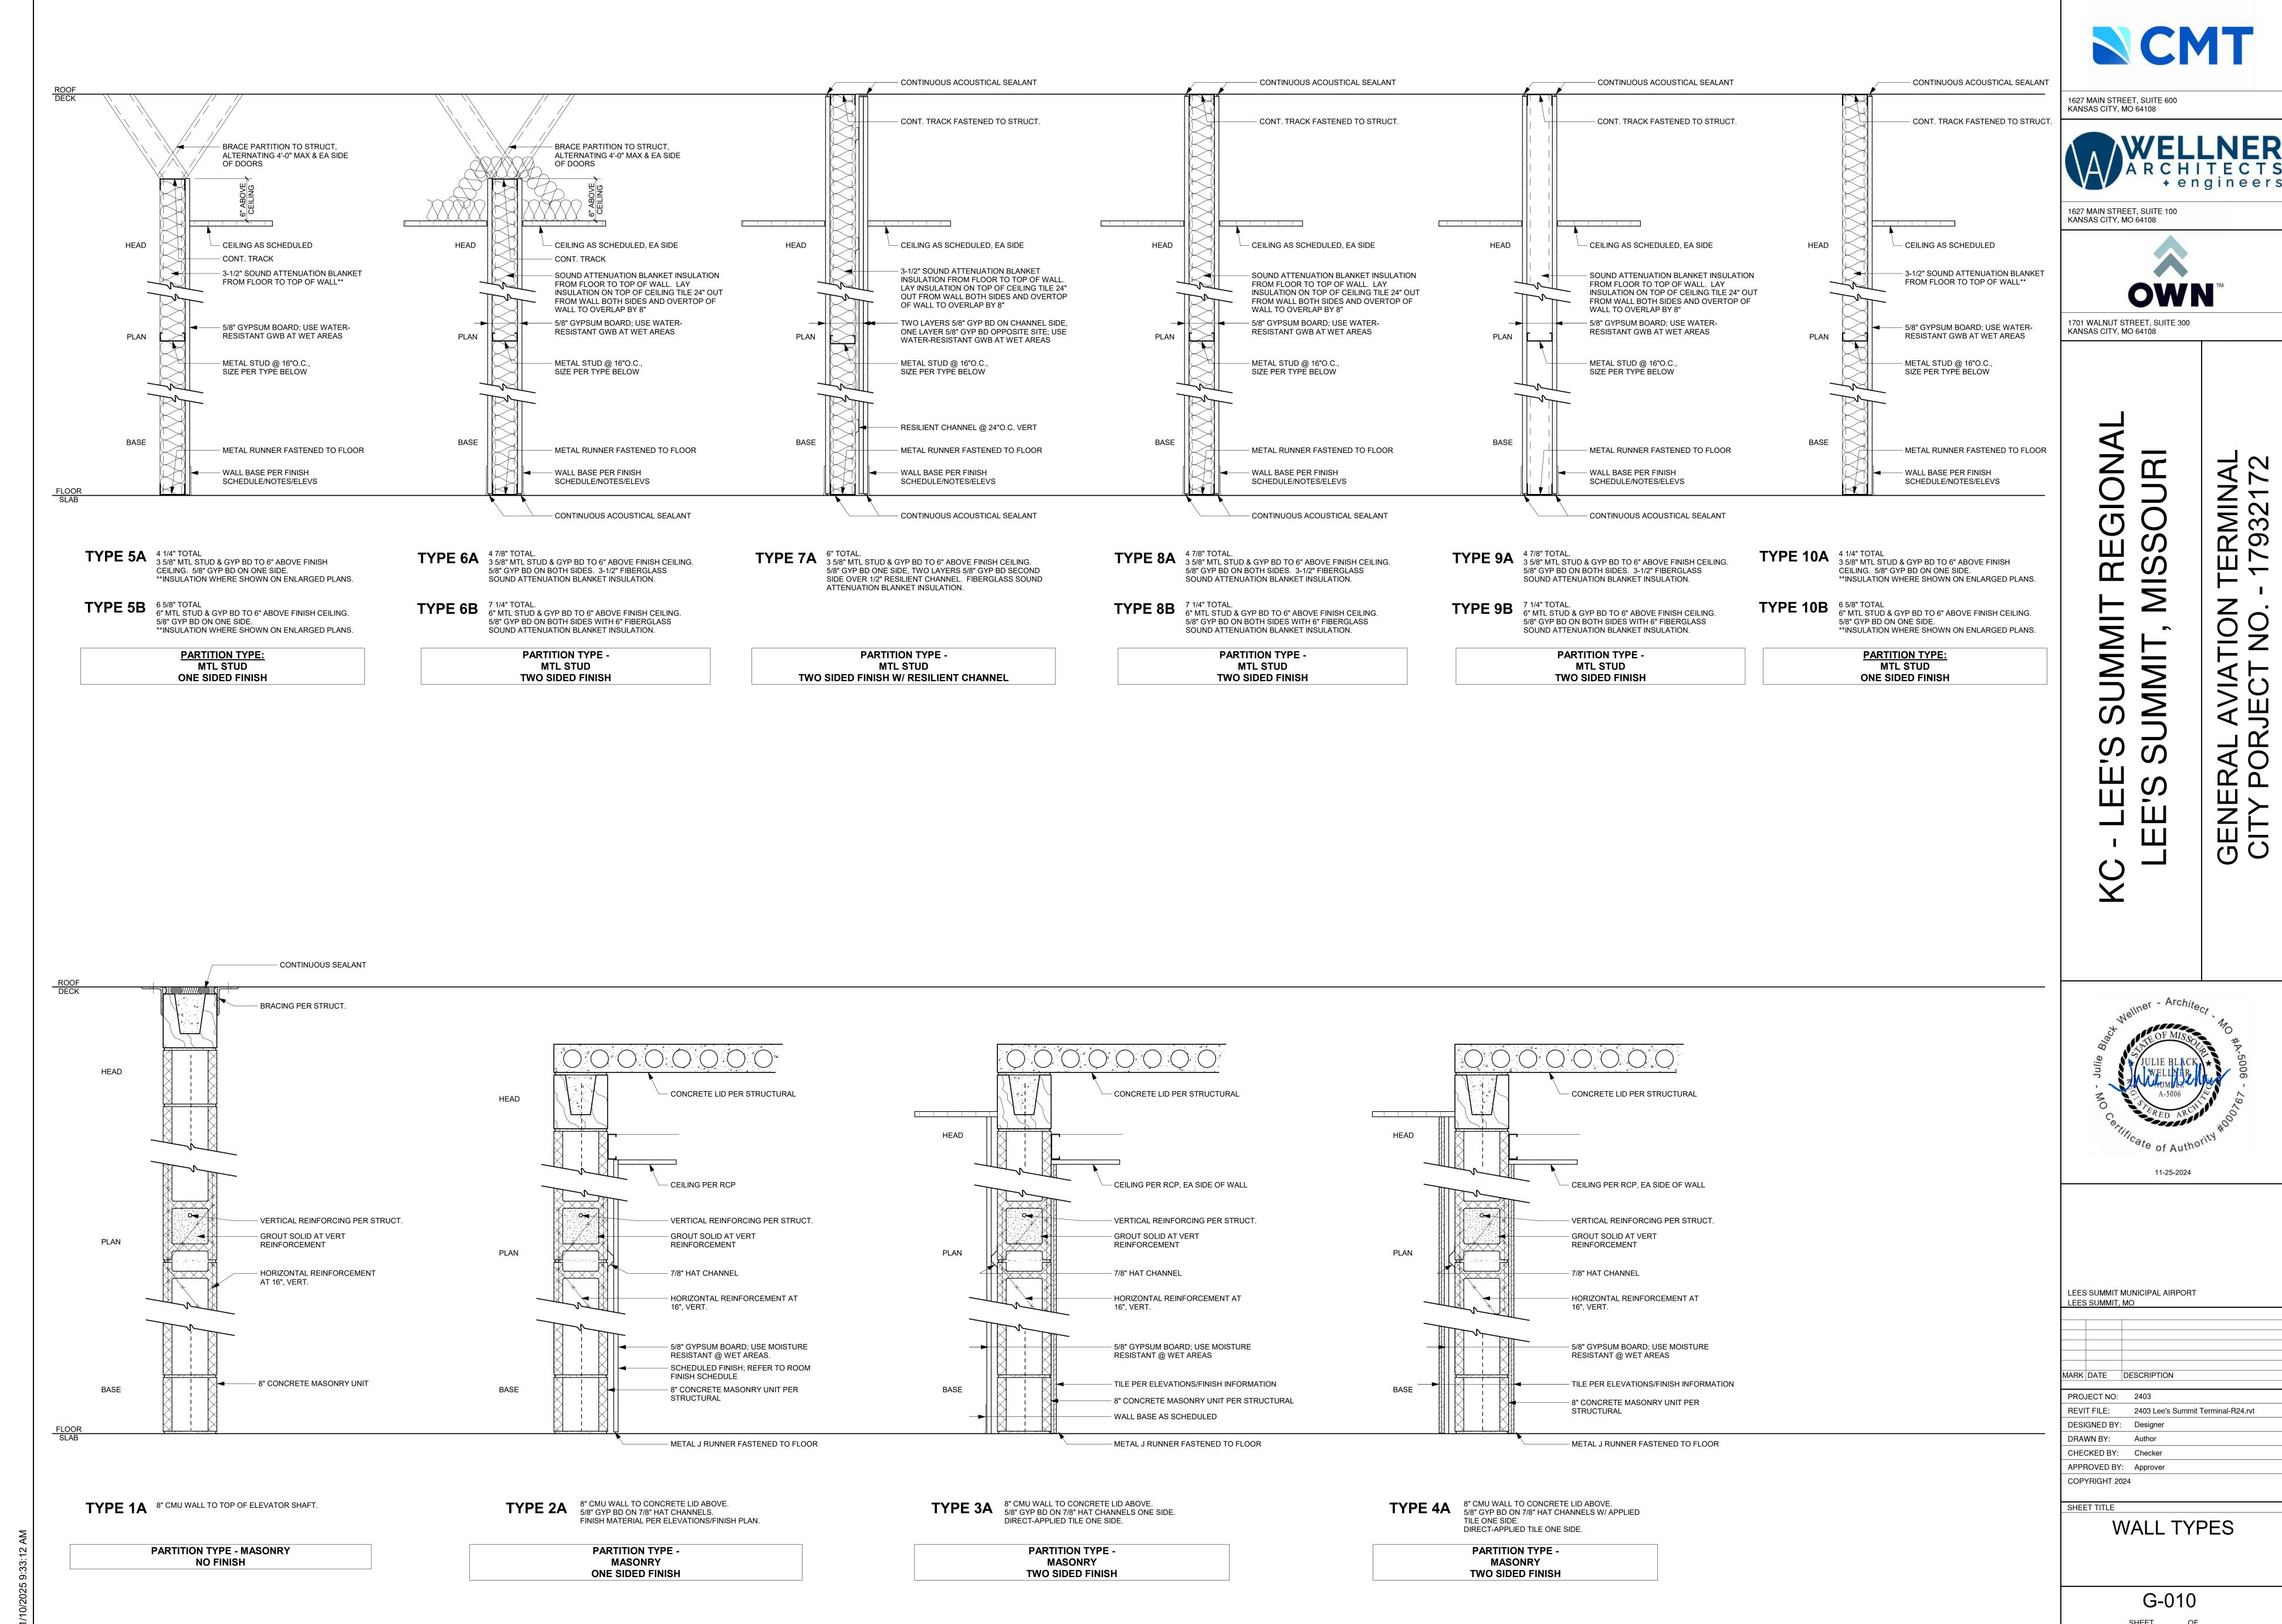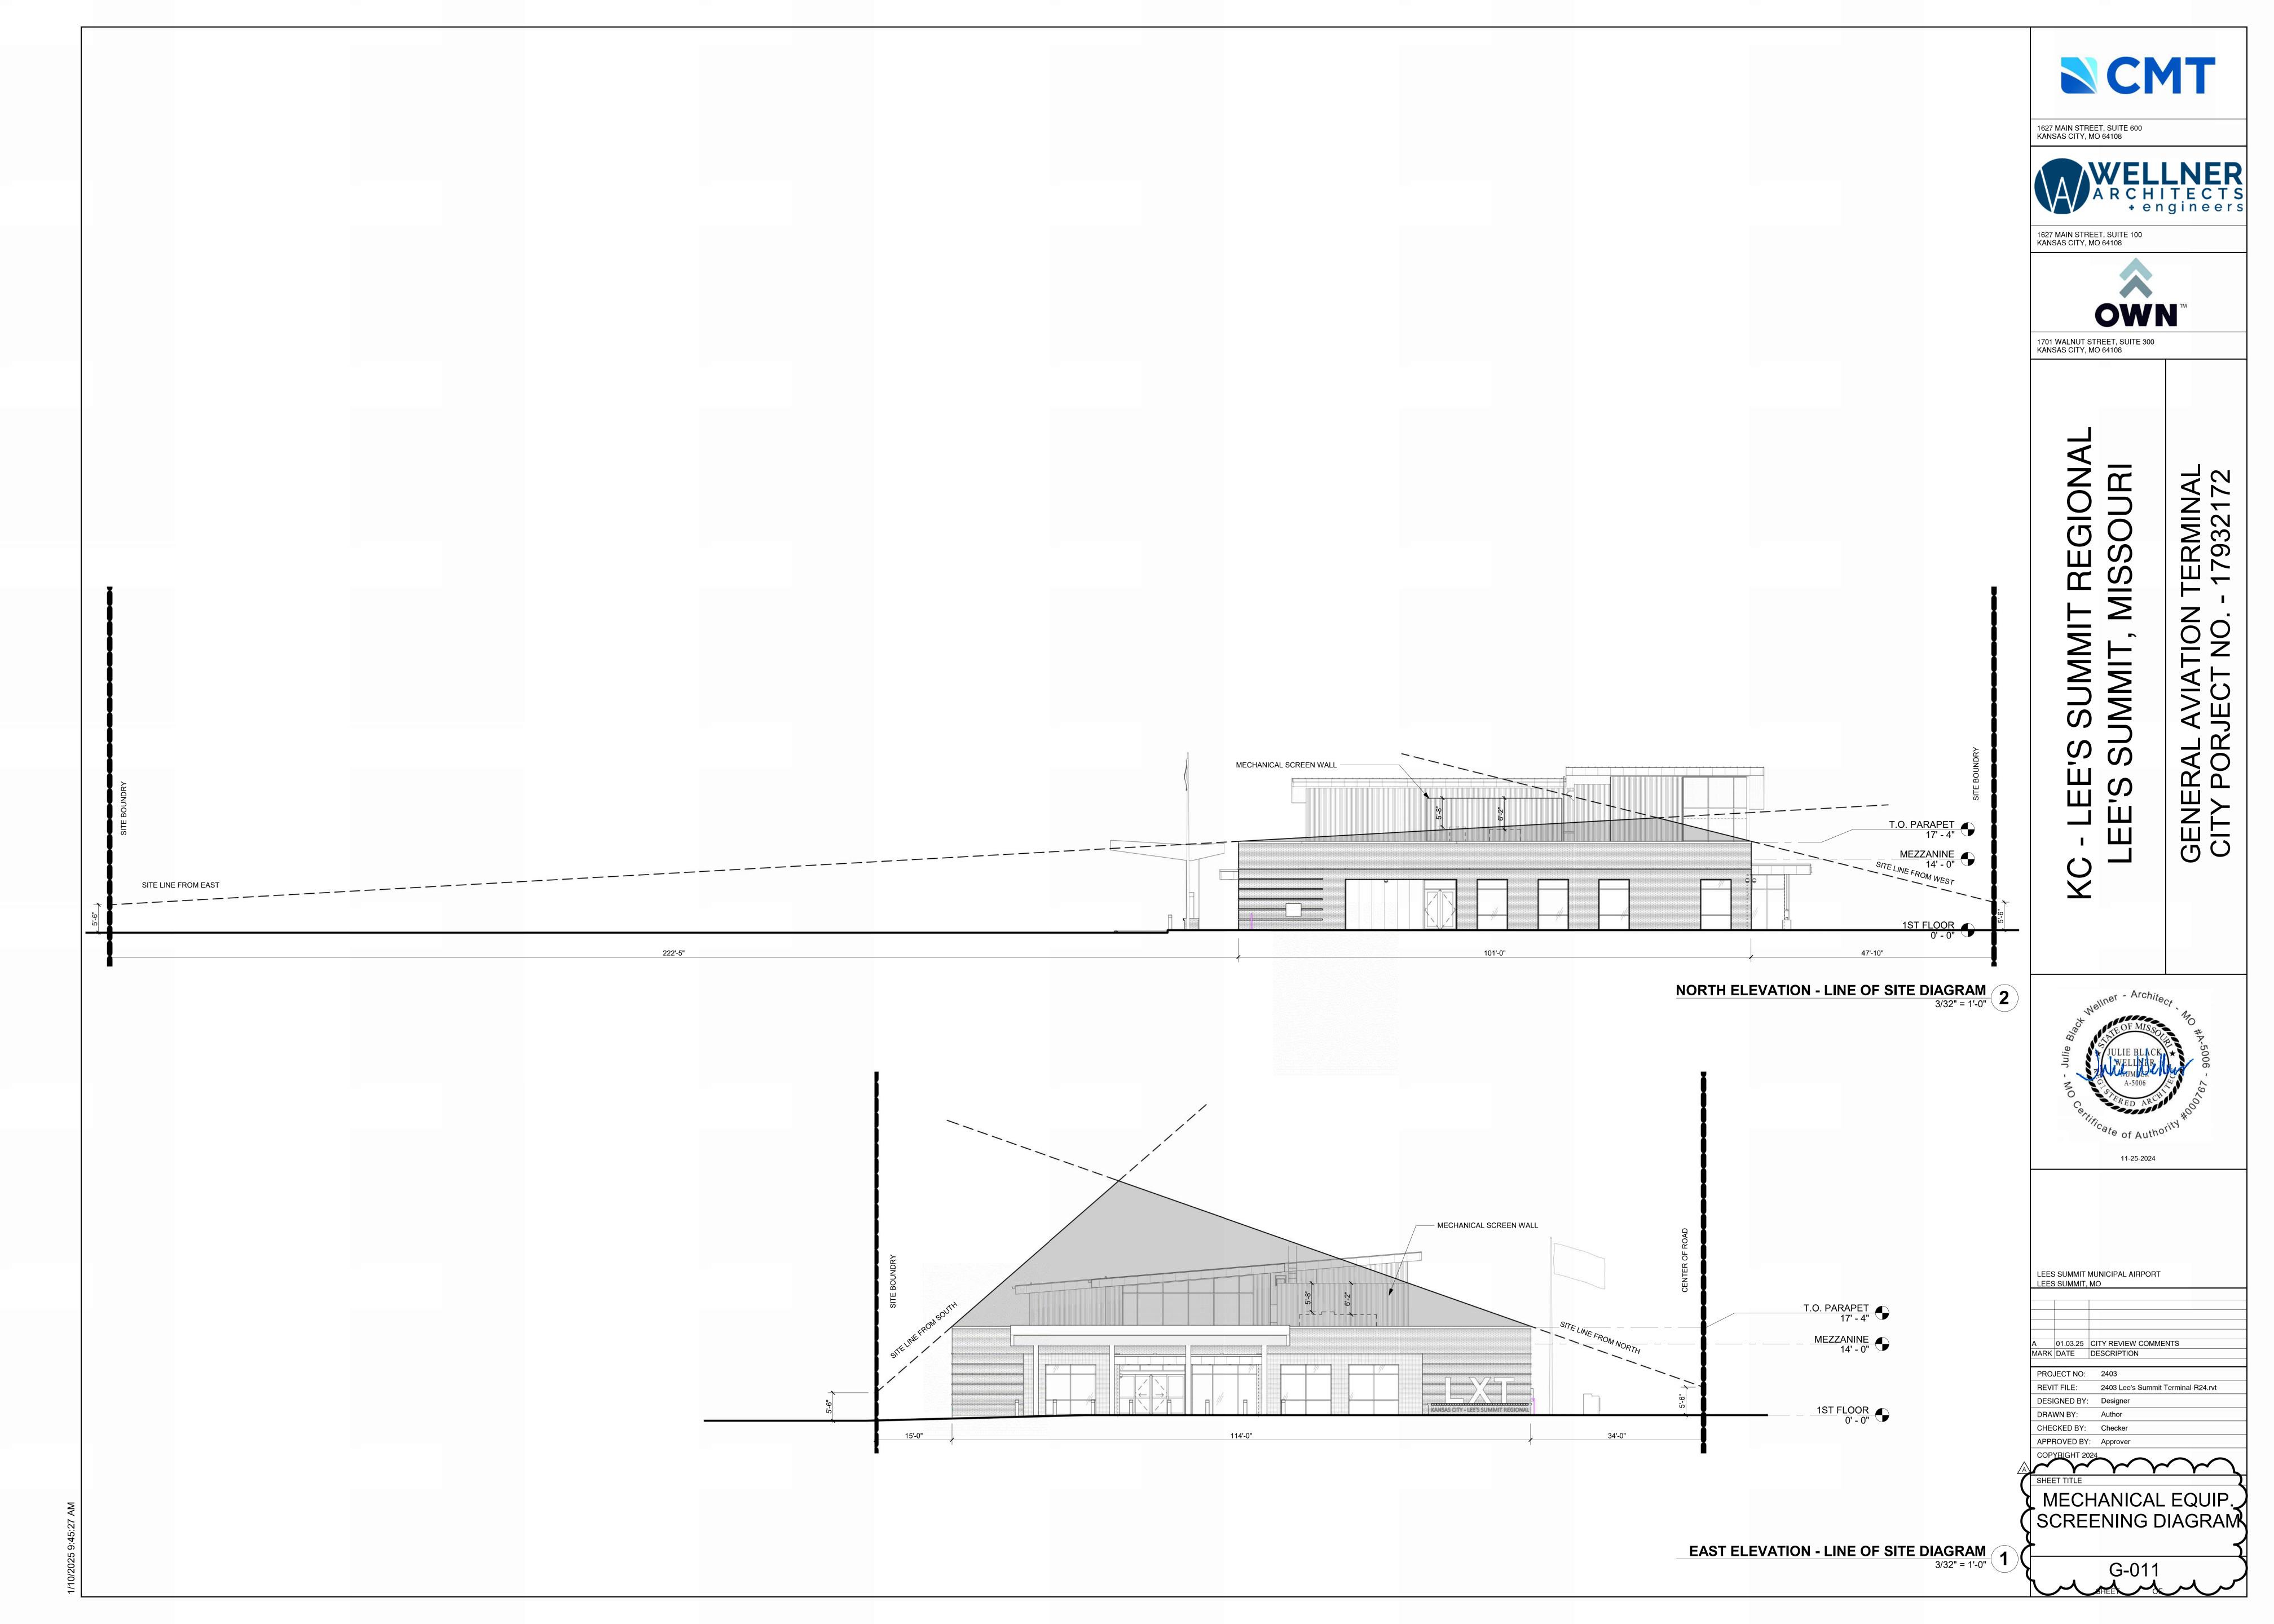
T-SHAPED TURNING SPACE

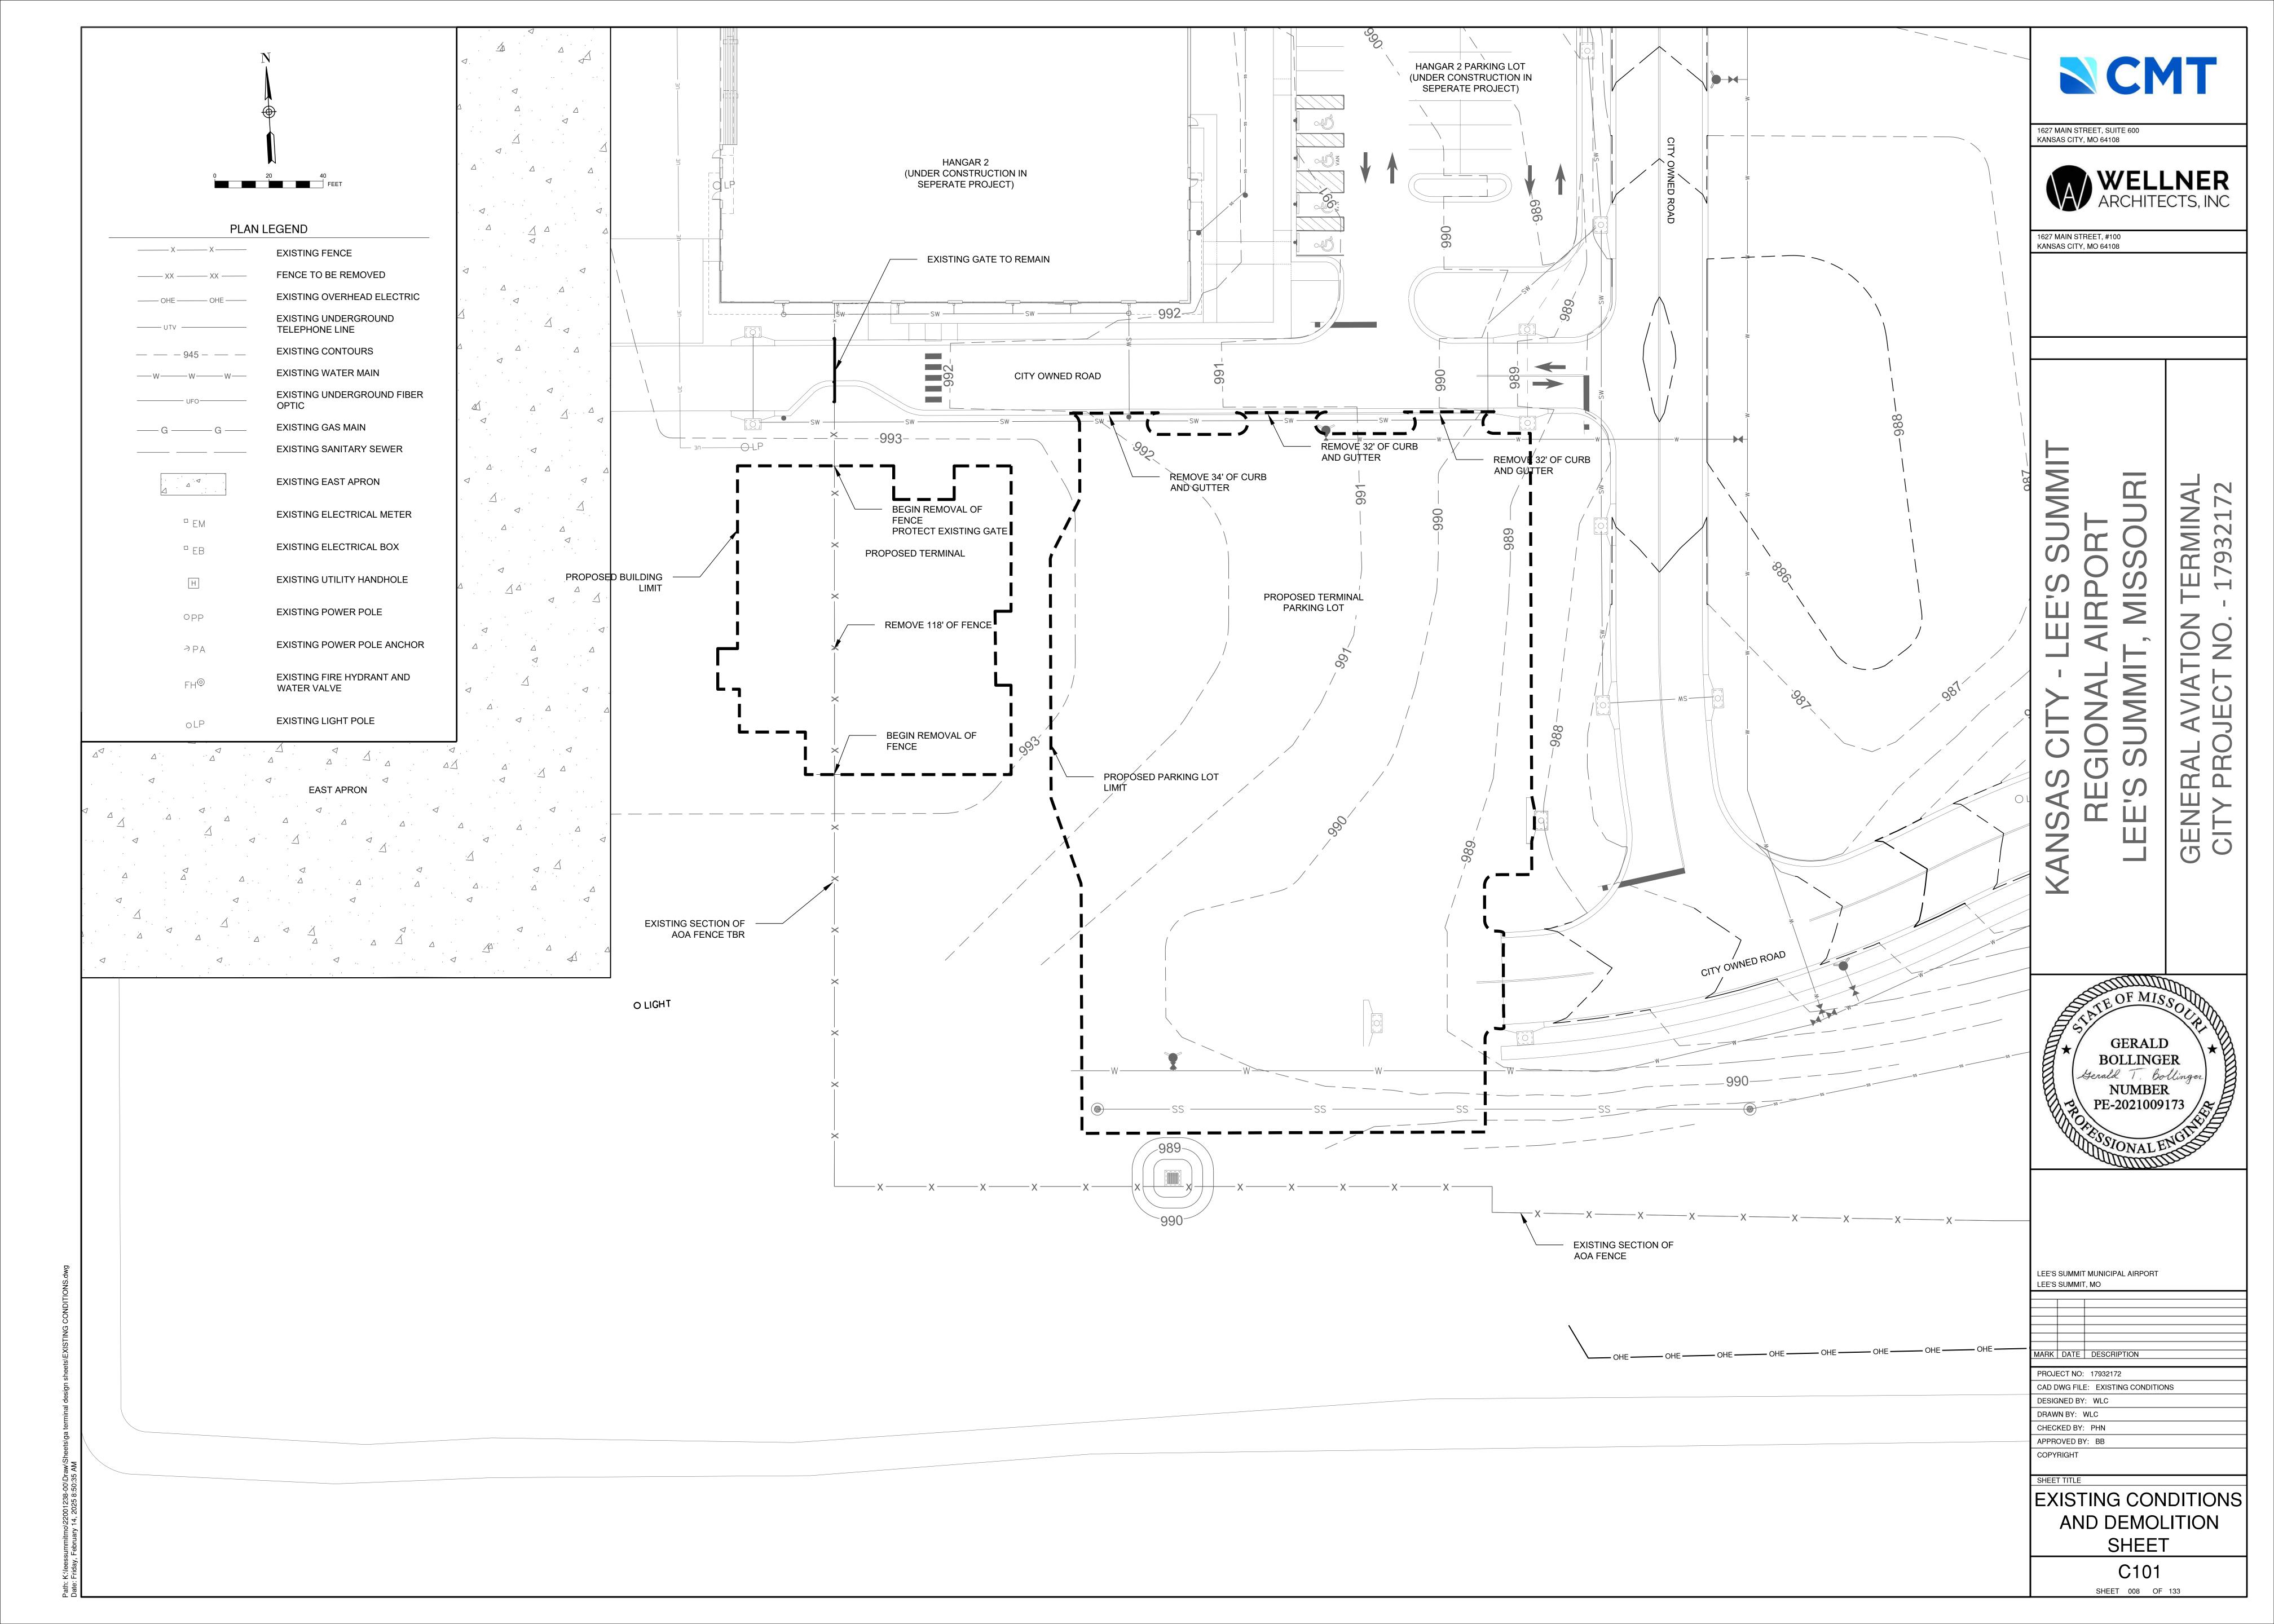


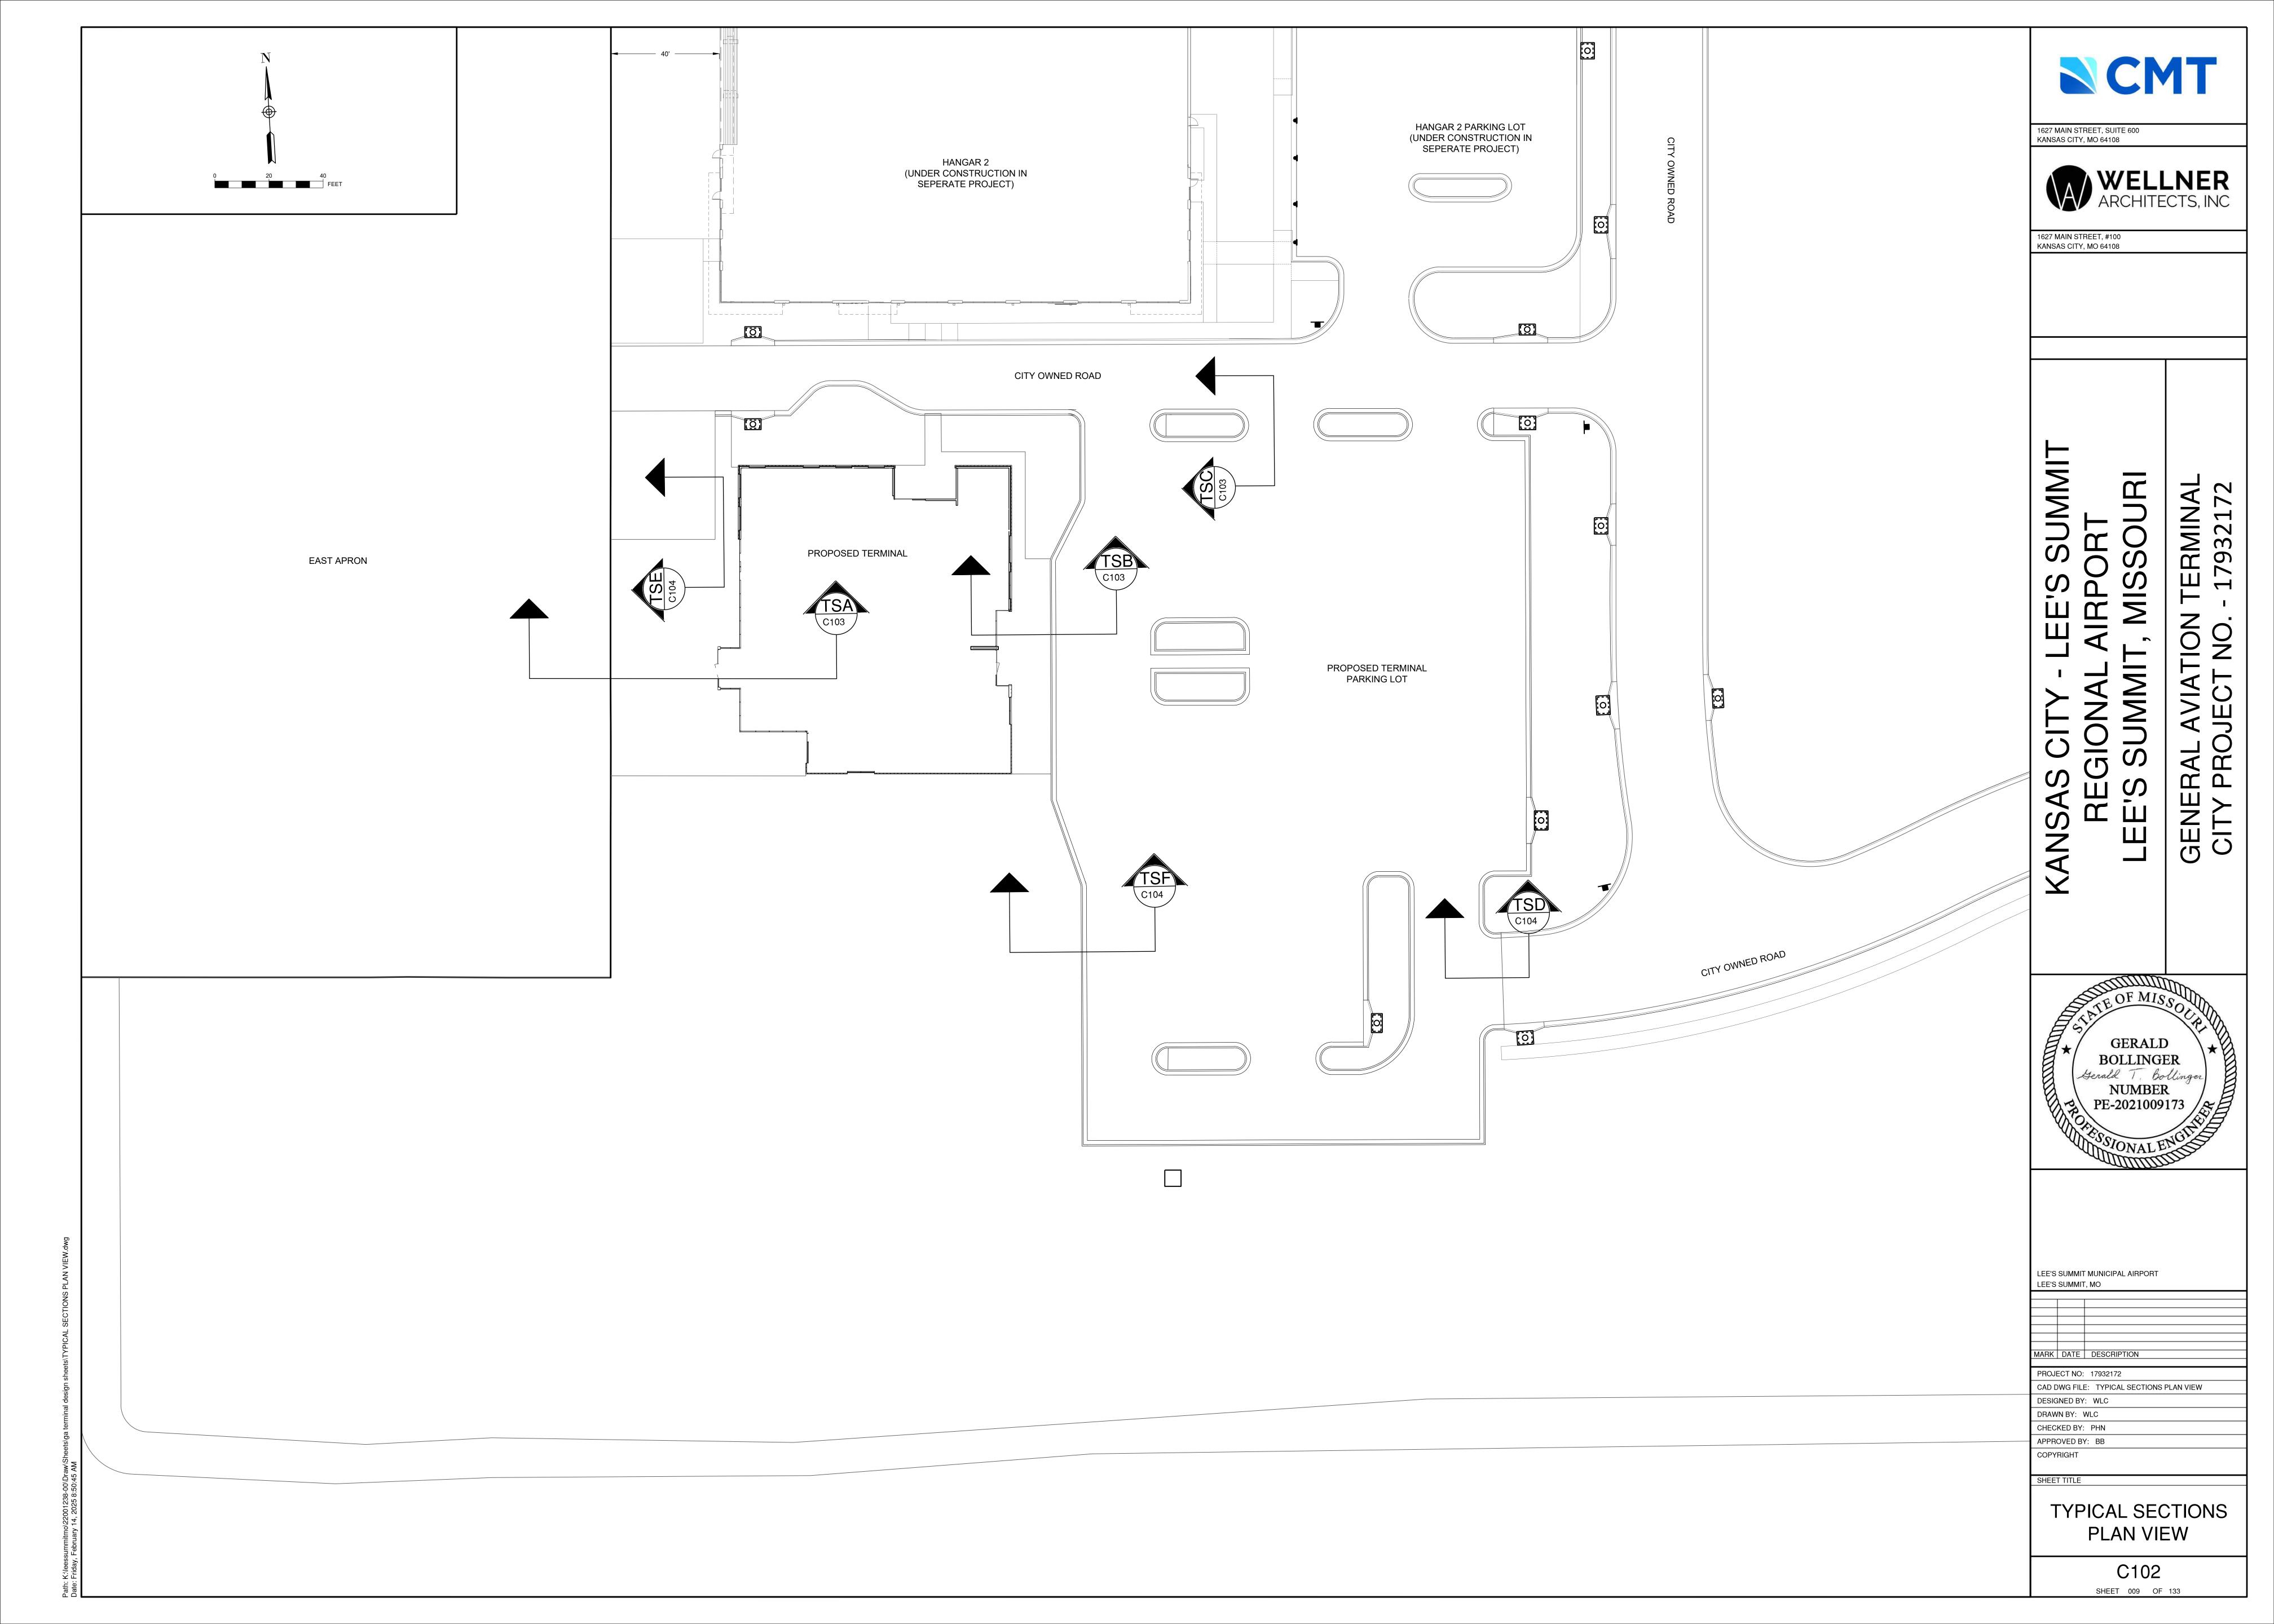
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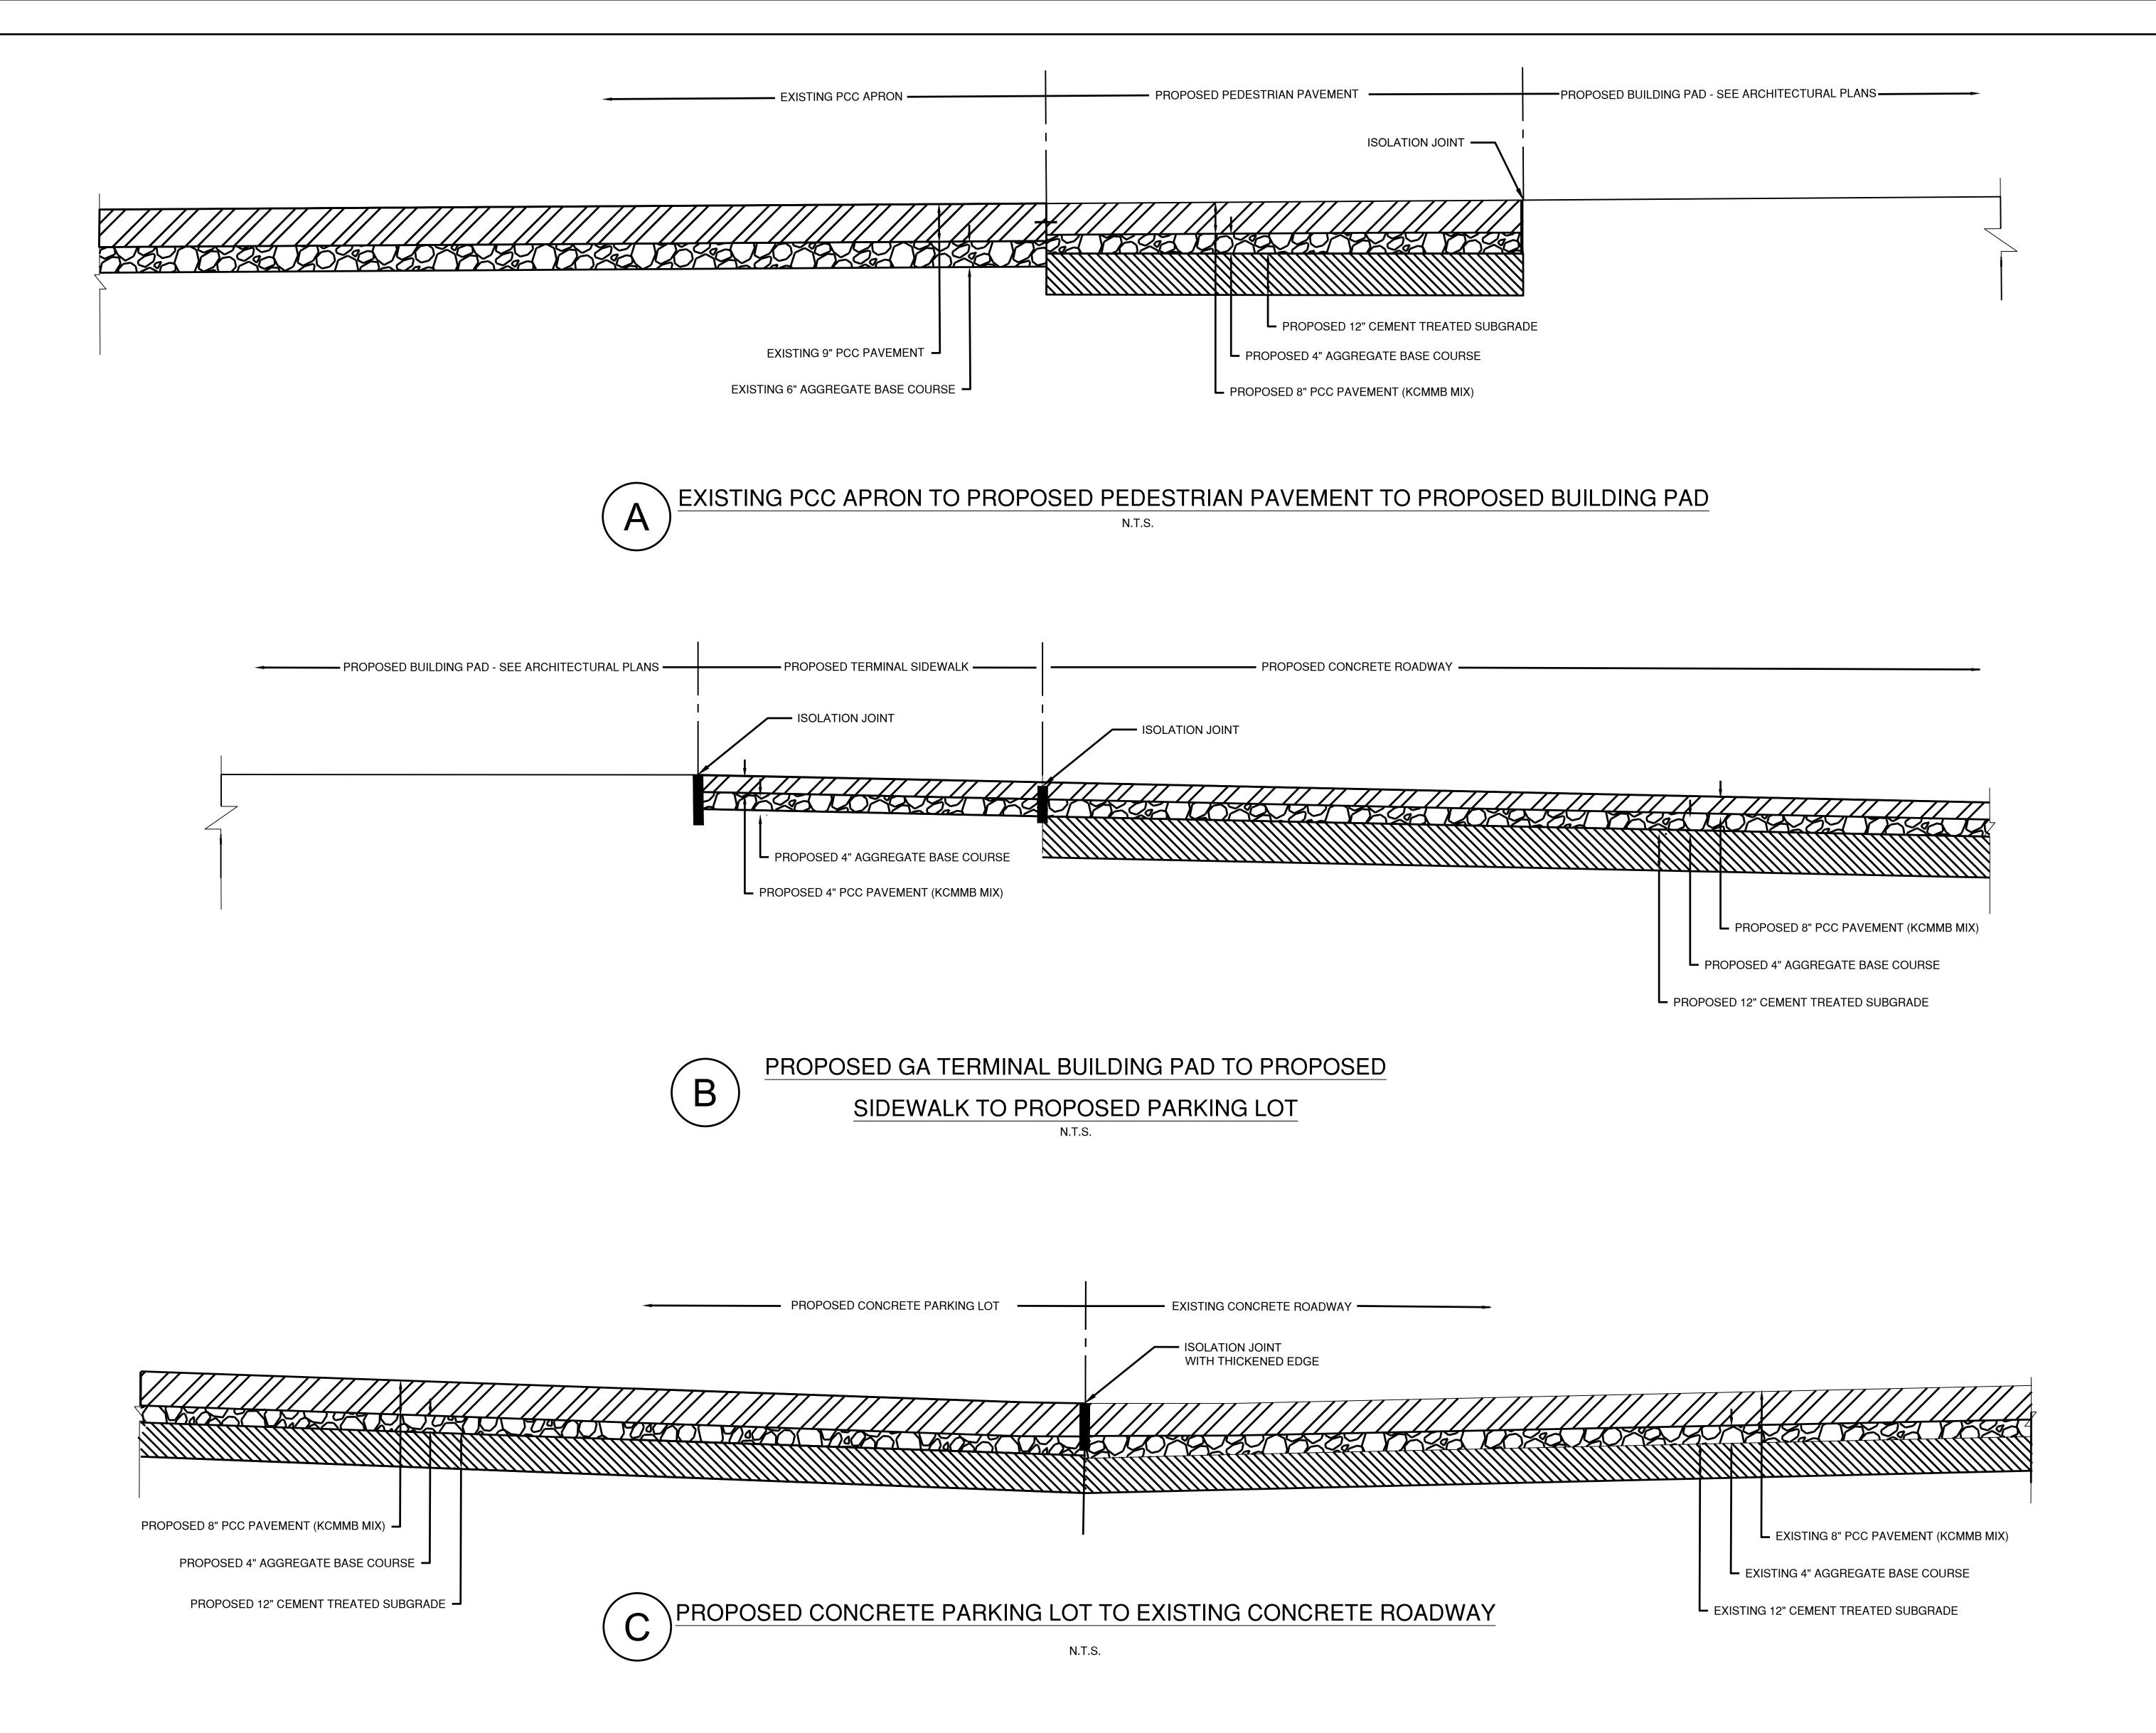


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LEE'S SUMMIT MUNICIPAL AIRPORT LEE'S SUMMIT, MO

MARK | DATE | DESCRIPTION

PROJECT NO: 17932172


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DRAWN BY: WLC CHECKED BY: PHN APPROVED BY: BB


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TYPICAL SECTIONS 1

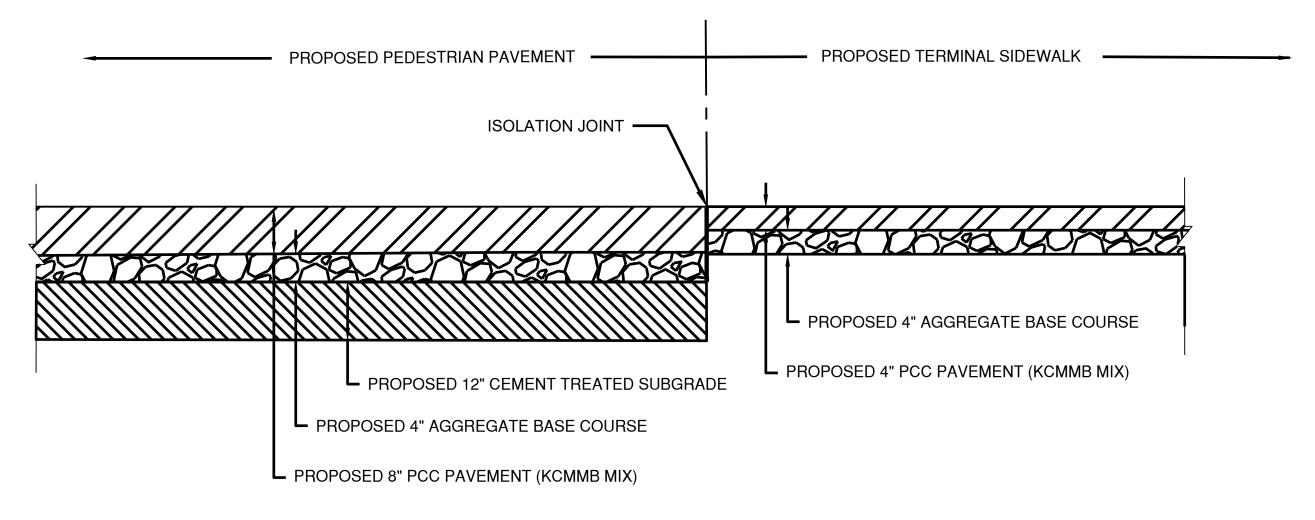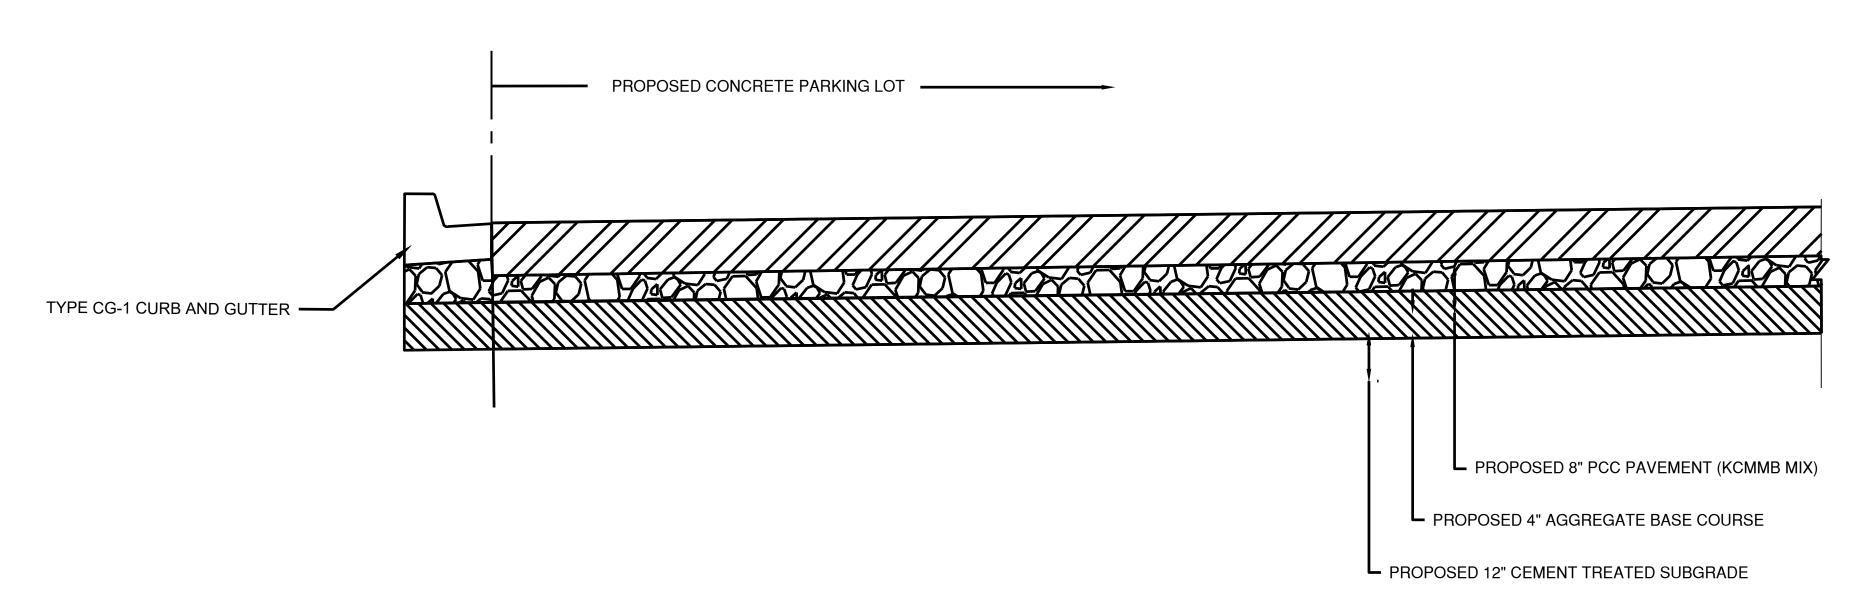C103 SHEET 010 OF 133










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LEE'S SUMMIT MUNICIPAL AIRPORT LEE'S SUMMIT, MO

MARK | DATE | DESCRIPTION

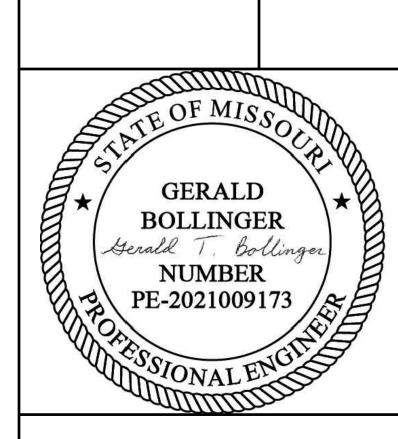PROJECT NO: 17932172

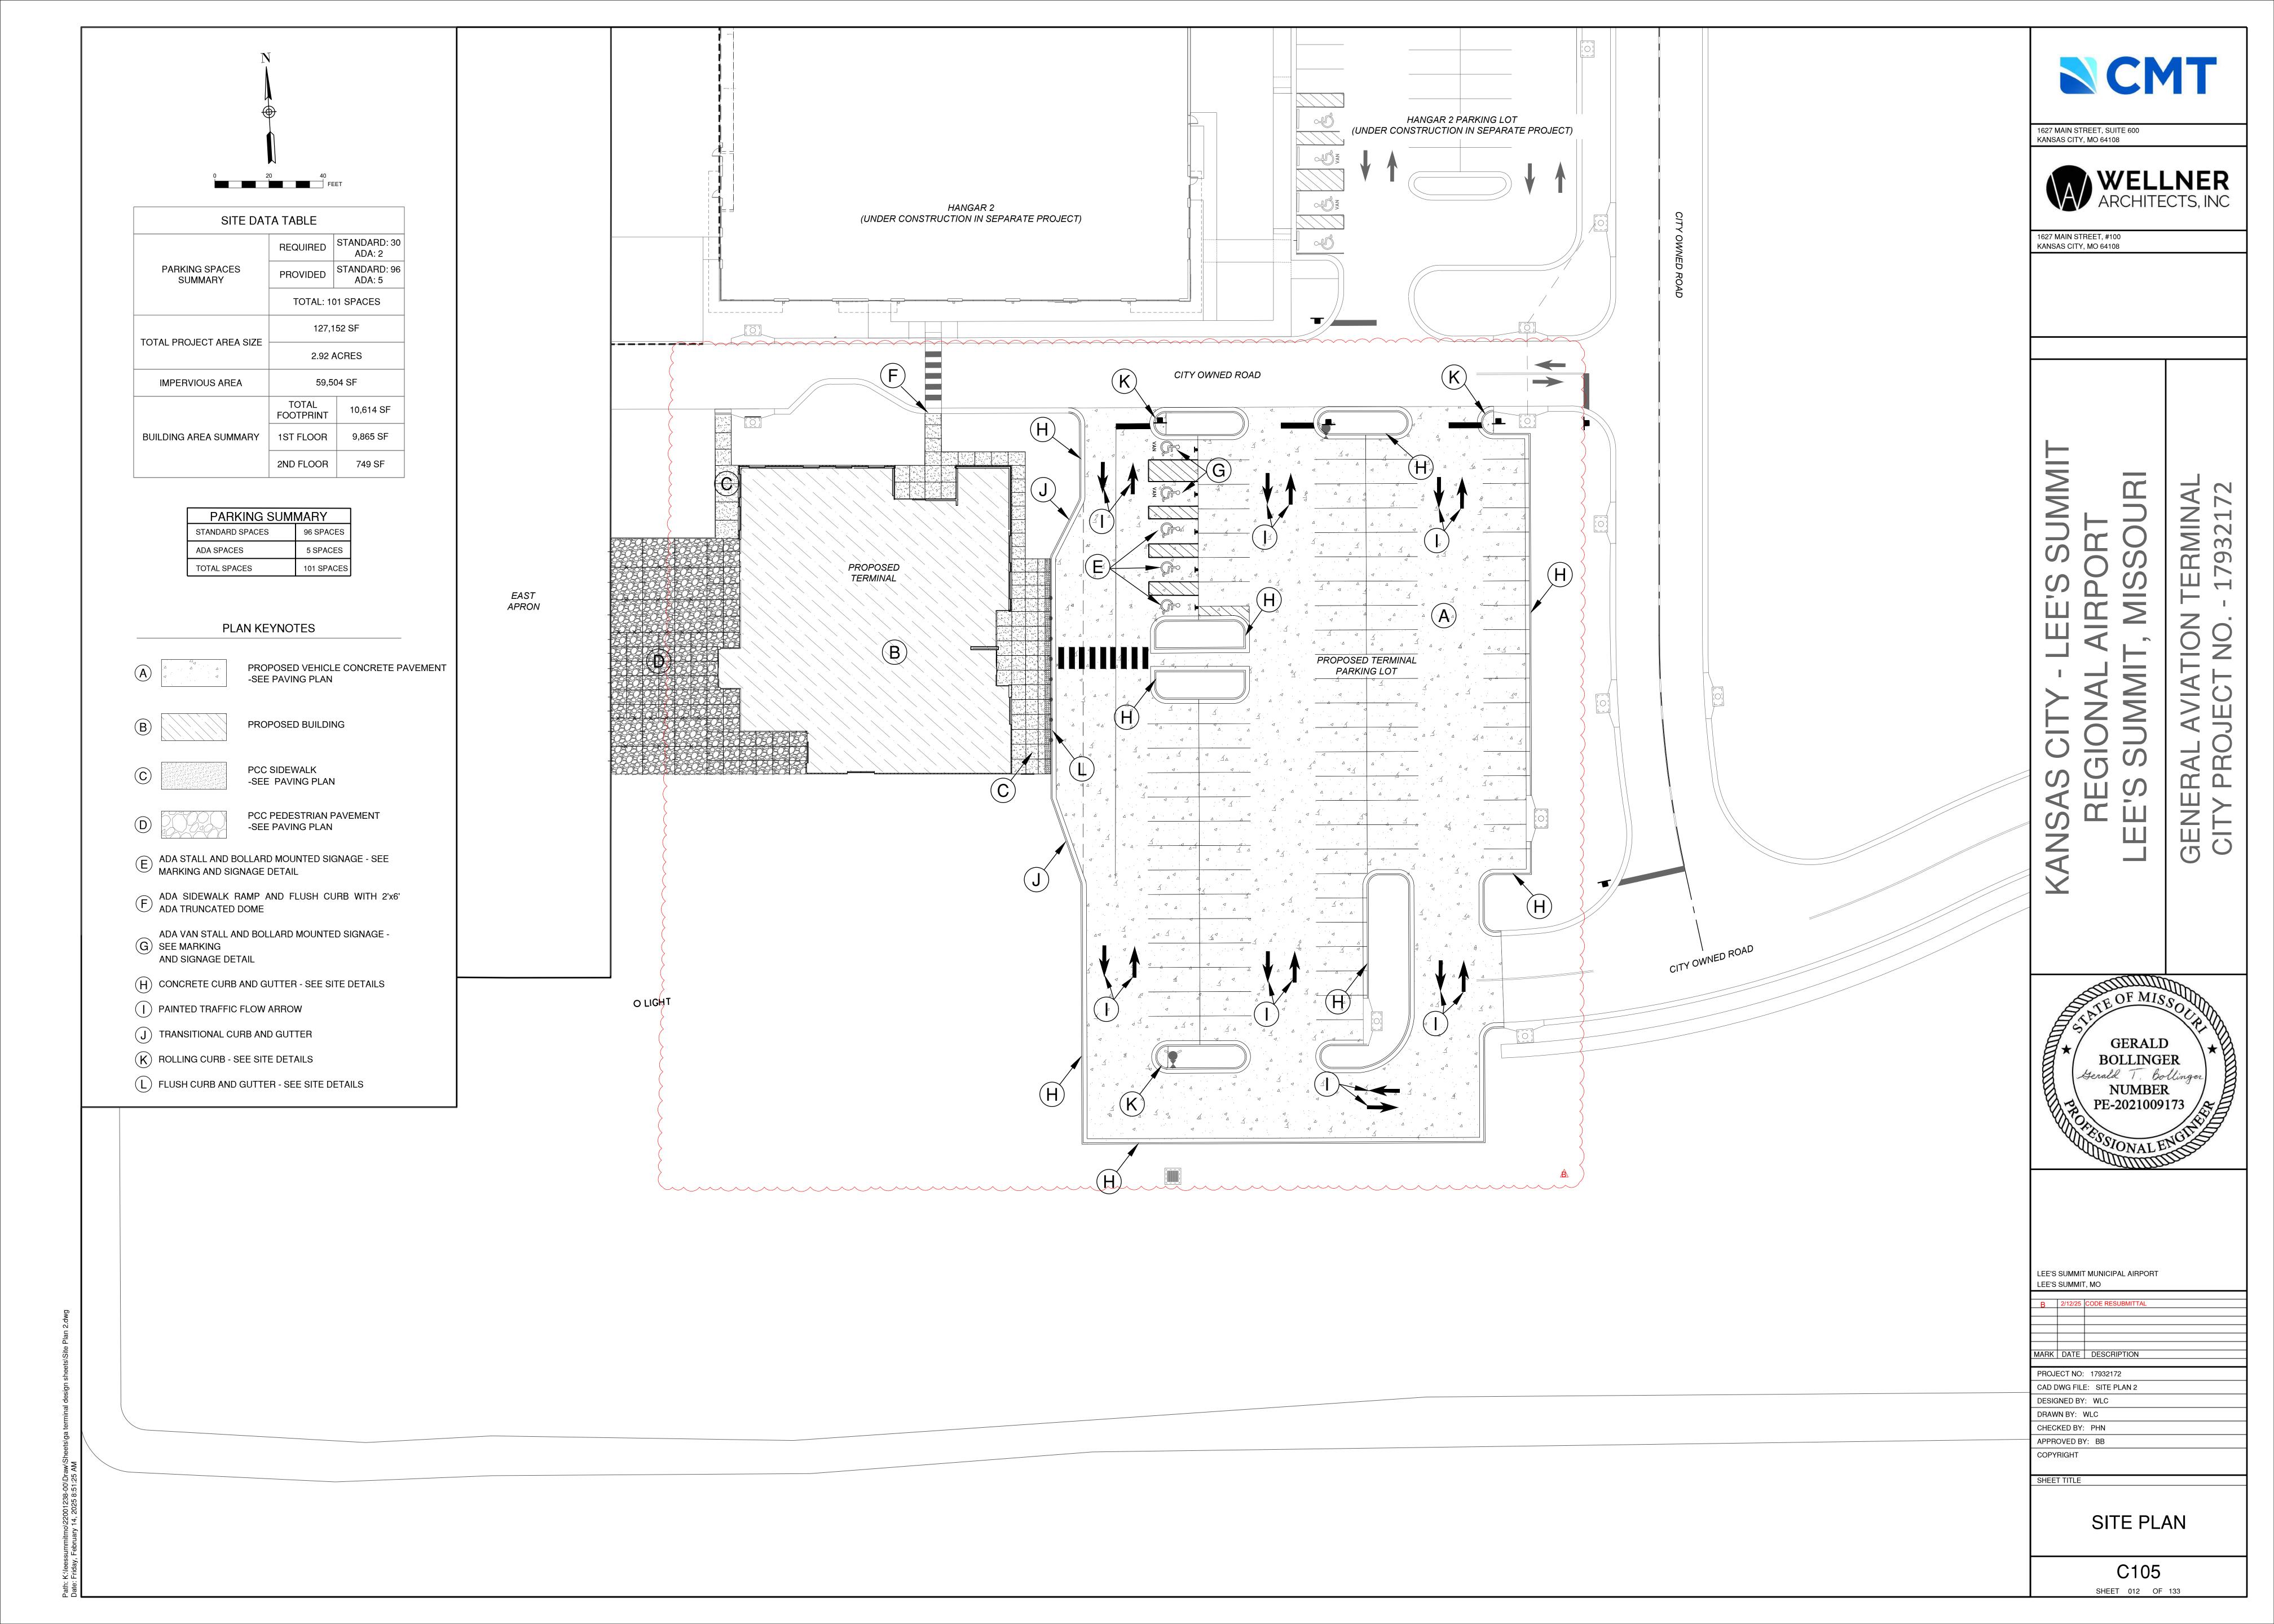
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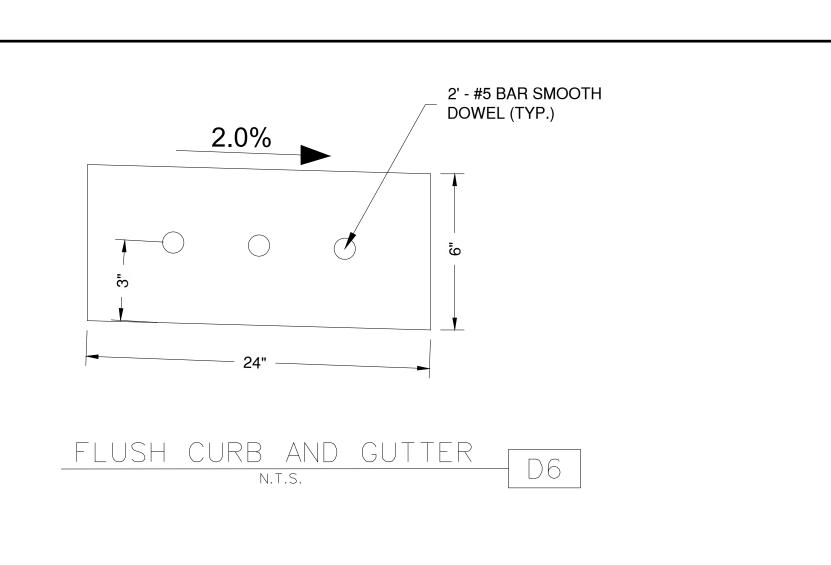
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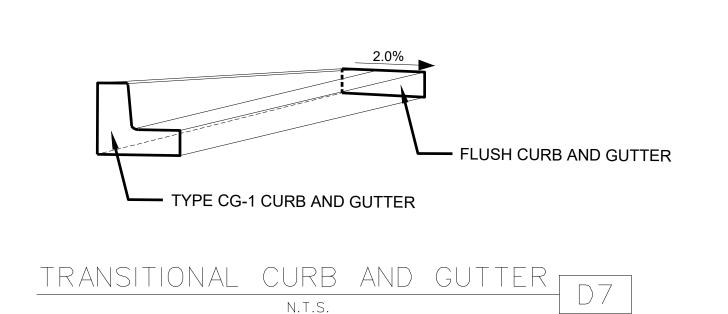
SHEET TITLE

TYPICAL SECTIONS 2

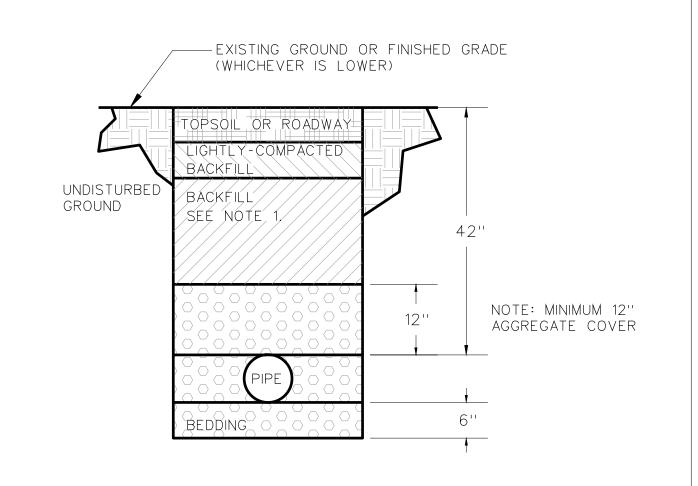
C104 SHEET 011 OF 133








TYPE A & B SIDEWALK RAMP




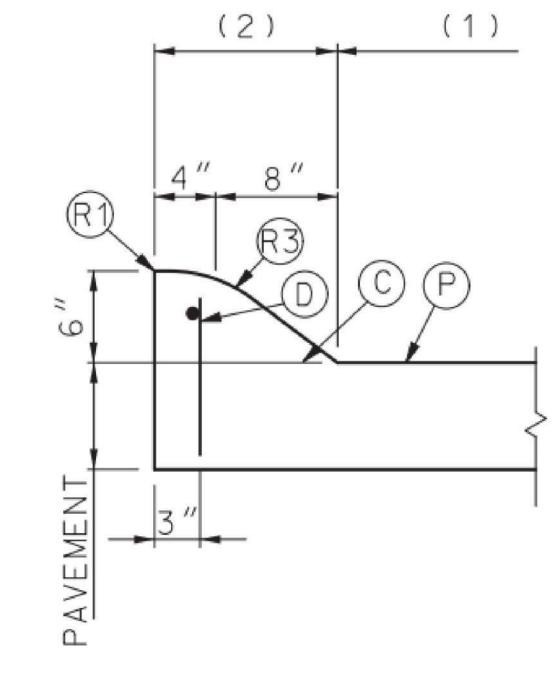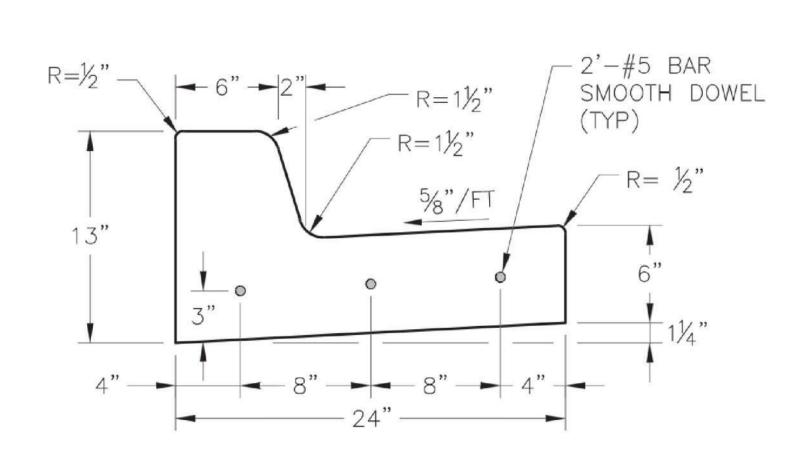NOTES: 1. BACKFILL OF ALL PIPES UNDER ROADWAYS, CURB AND GUTTER AND ALL OTHER PAVED AREAS WITHIN THE RIGHT OF WAY SHALL CONSIST OF FLOWABLE BACKFILL AS SPECIFIED IN SECTION 2602.2.H MIX DESIGN TYPE. A. THE FLOWABLE FILL SHALL EXTEND TO 2 FEET FROM BACK OF CURB TO 2 FEET BACK OF CURB, UP TO 18 INCHES BELOW FINISHED GRADE. FOR EXISTING ROADWAYS FLOWABLE SHALL BE EXTEND UP TO THE BASE OF PAVEMENT.



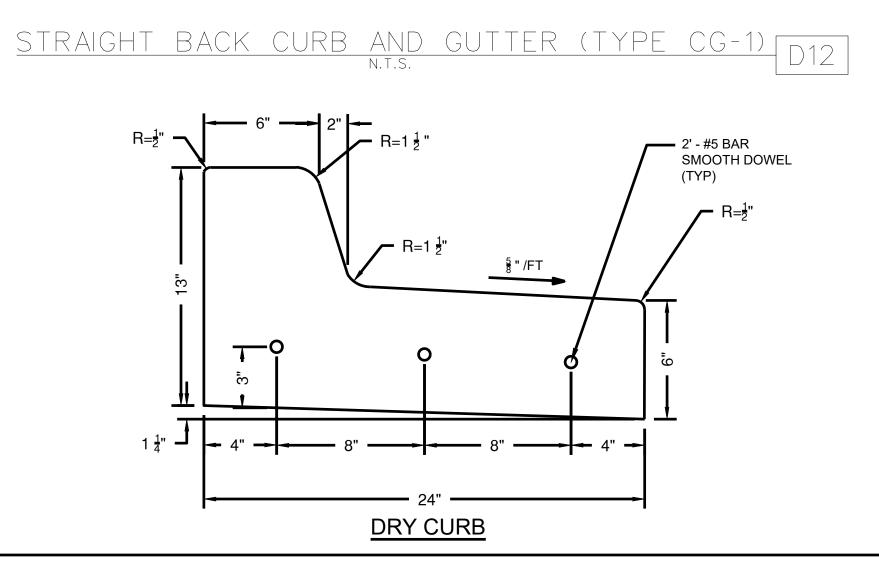
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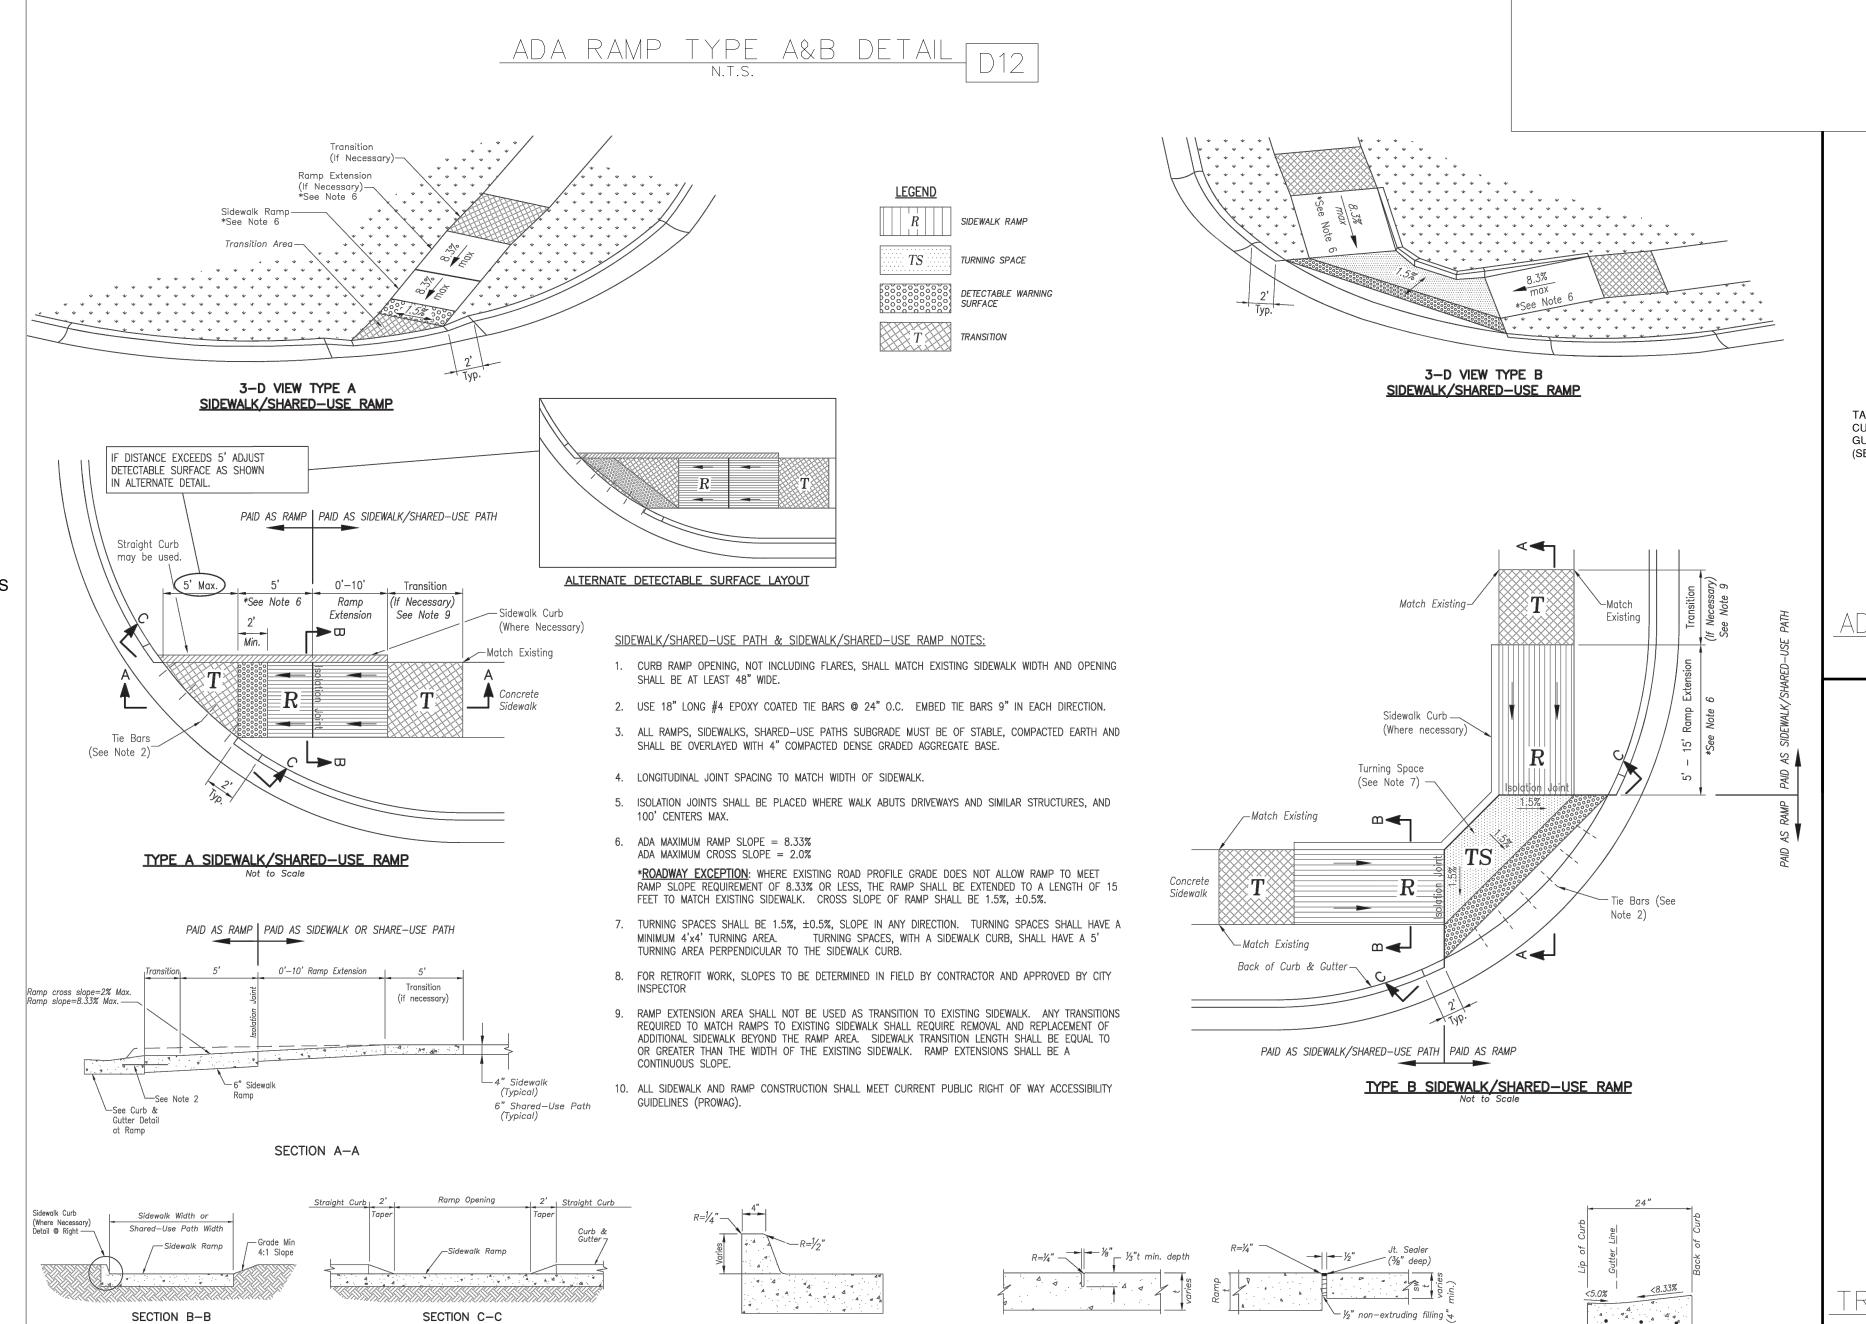
- C. PERMISSIBLE CONSTRUCTION JOINT. IF CONSTRUCTED IN THIS MANNER LONGITUDIONAL AND TIE BARS MUST BE USED
- D. #3 OF #4 EPOXY COATED LONGITUDIONAL AND TIE BARS. LONGITUDIONAL BAR GAPPED 4" AT JOINTS AND ANY SPLICES LAPPED 8". TIE BARS ARE 24" CENTERS AND LENGTH EQUALS THICKNESS OF PAVEMENT PLUS HEIGHT OF CURB MINUS 3". MINIMUM 1" COVER OVER ALL BARS.
- P. TOP OF PAVEMENT OR CONCRETE BASE.
- R1. ROUND TO $\frac{1}{4}$ " RADIUS (EXCEPT FOR SAWED JOINTS).
- R3. CONSTRUCT TO 9" RADIUS.



- 1/2" EXPANSION JOINTS WITH 2' DOWELS SHALL BE PLACED AT RADIUS POINTS AND AT 150' INTERVALS. THESE DOWELS SHALL BE GREASED AND WRAPPED ON ONE END WITH EXPANSION TUBES.
- 2. 1" DEEP CONTRACTION JOINTS SHALL BE INSTALLED TO MATCH TRANSVERSE JOINTS OF THE ADJACENT PAVEMENT. THESE JOINTS SHALL PASS ACROSS THE ENTIRE CURB SECTION.
- 3. FIX DOWELS WITH BAR SUPPORTS
- 4. CONCRETE SHALL CONFORM TO KCMMB 4K UNLESS OTHERWISE SPECIFIED IN THE PLANS AND PROJECT MANUAL. SEE SECTION 02290 - CURBING.
- 5. AT CENTER MARKS USE $\frac{1}{8}$ " Ø X 2' SMOOTH DOWELS AT LOCATIONS SHOWN ON EACH TYPICAL SECTION.
- 6. DEPTH OF CURB SHALL BE MINIMUM OF 8" THRU THE HANDICAP ACCESS RAMP.
- 7. JOINT NOT NEEDED IF CURB & GUTTER IS MONOLITHICALLY POURED

* DRAWING COURTESY OF KANSAS CITY, MO PUBLIC WORKS DEPARTMENT, ENGINEERING DIVISION: STANDARD DRAWING NUMBER C





SIDEWALK CURB DETAIL

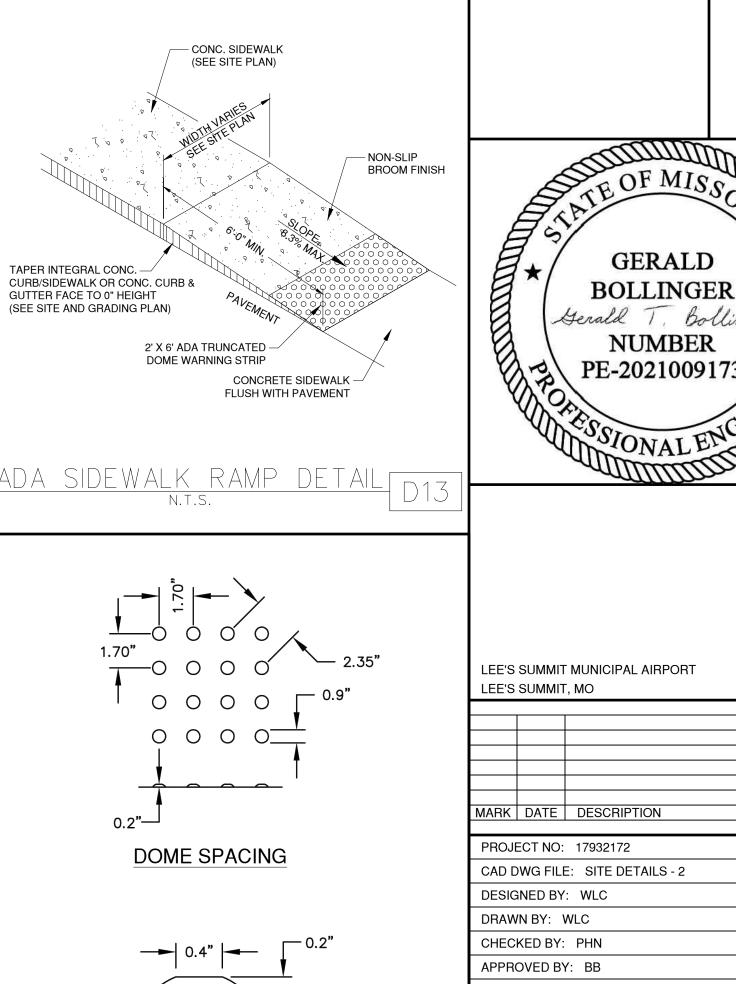
CONTRACTION JOINT

ISOLATION JOINT

JOINT DETAILS

Not to Scale

CURB & GUTTER DETAIL AT RAMP



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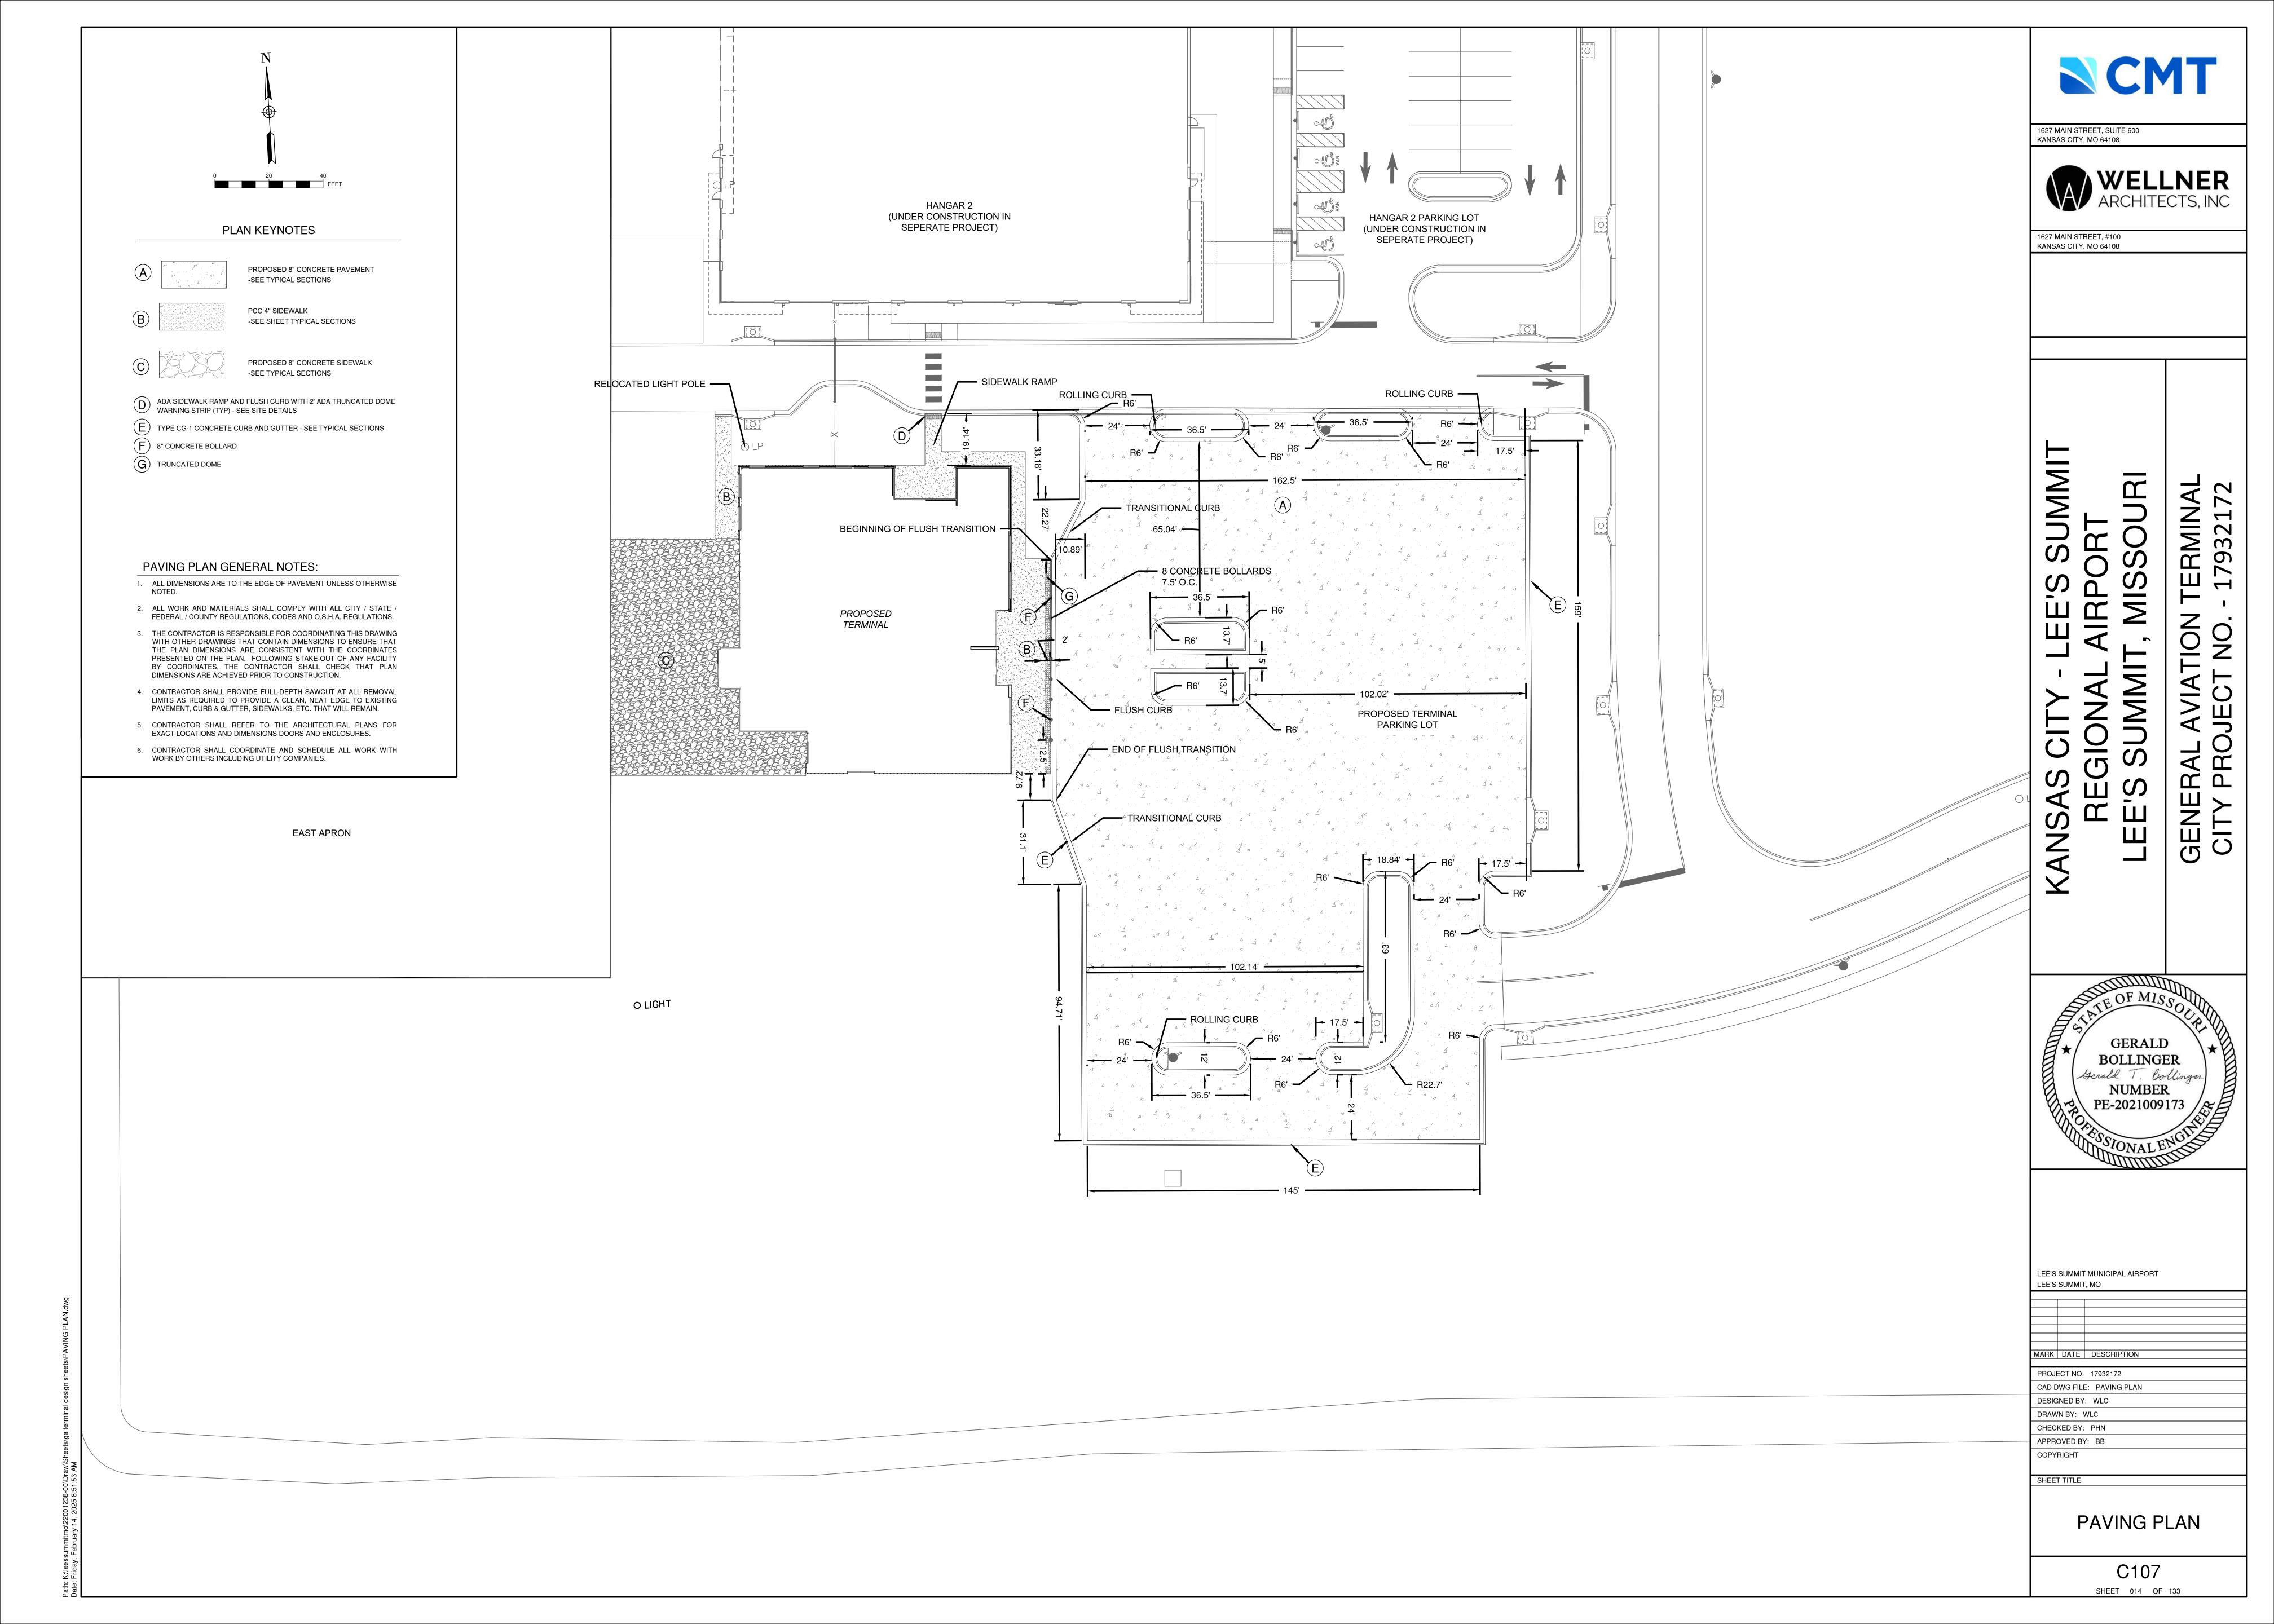
1627 MAIN STREET, #100 KANSAS CITY, MO 64108

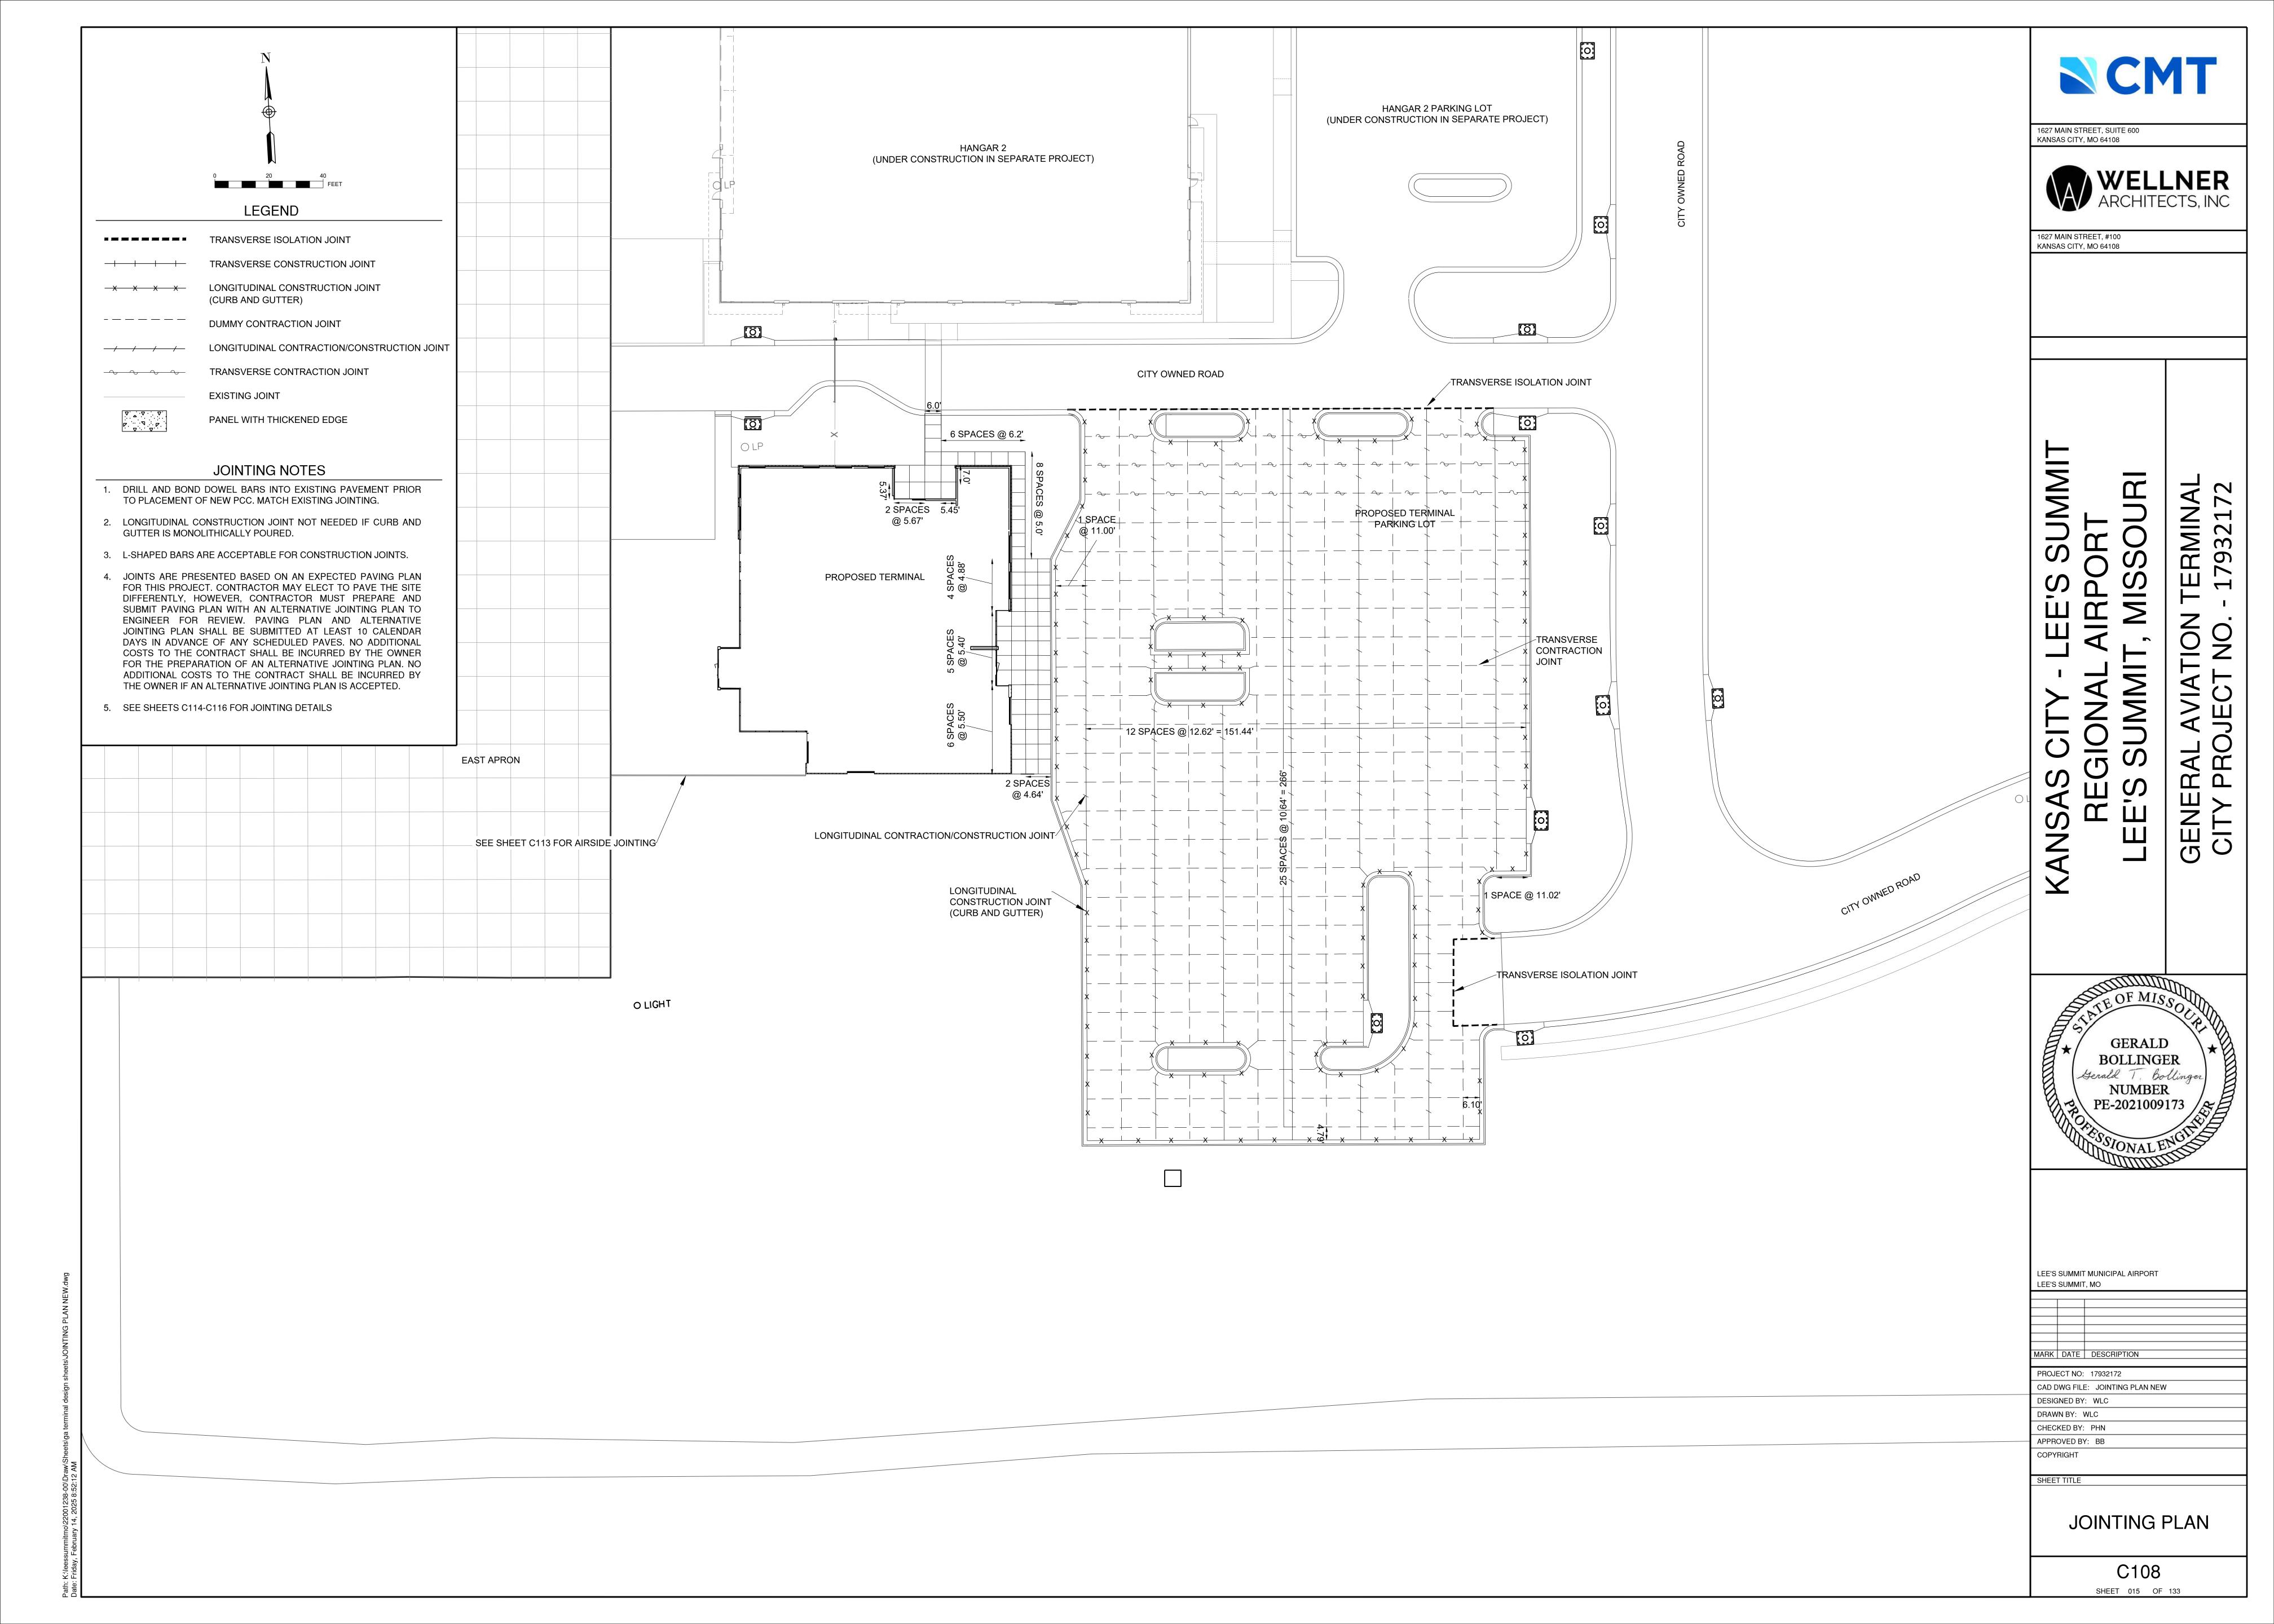
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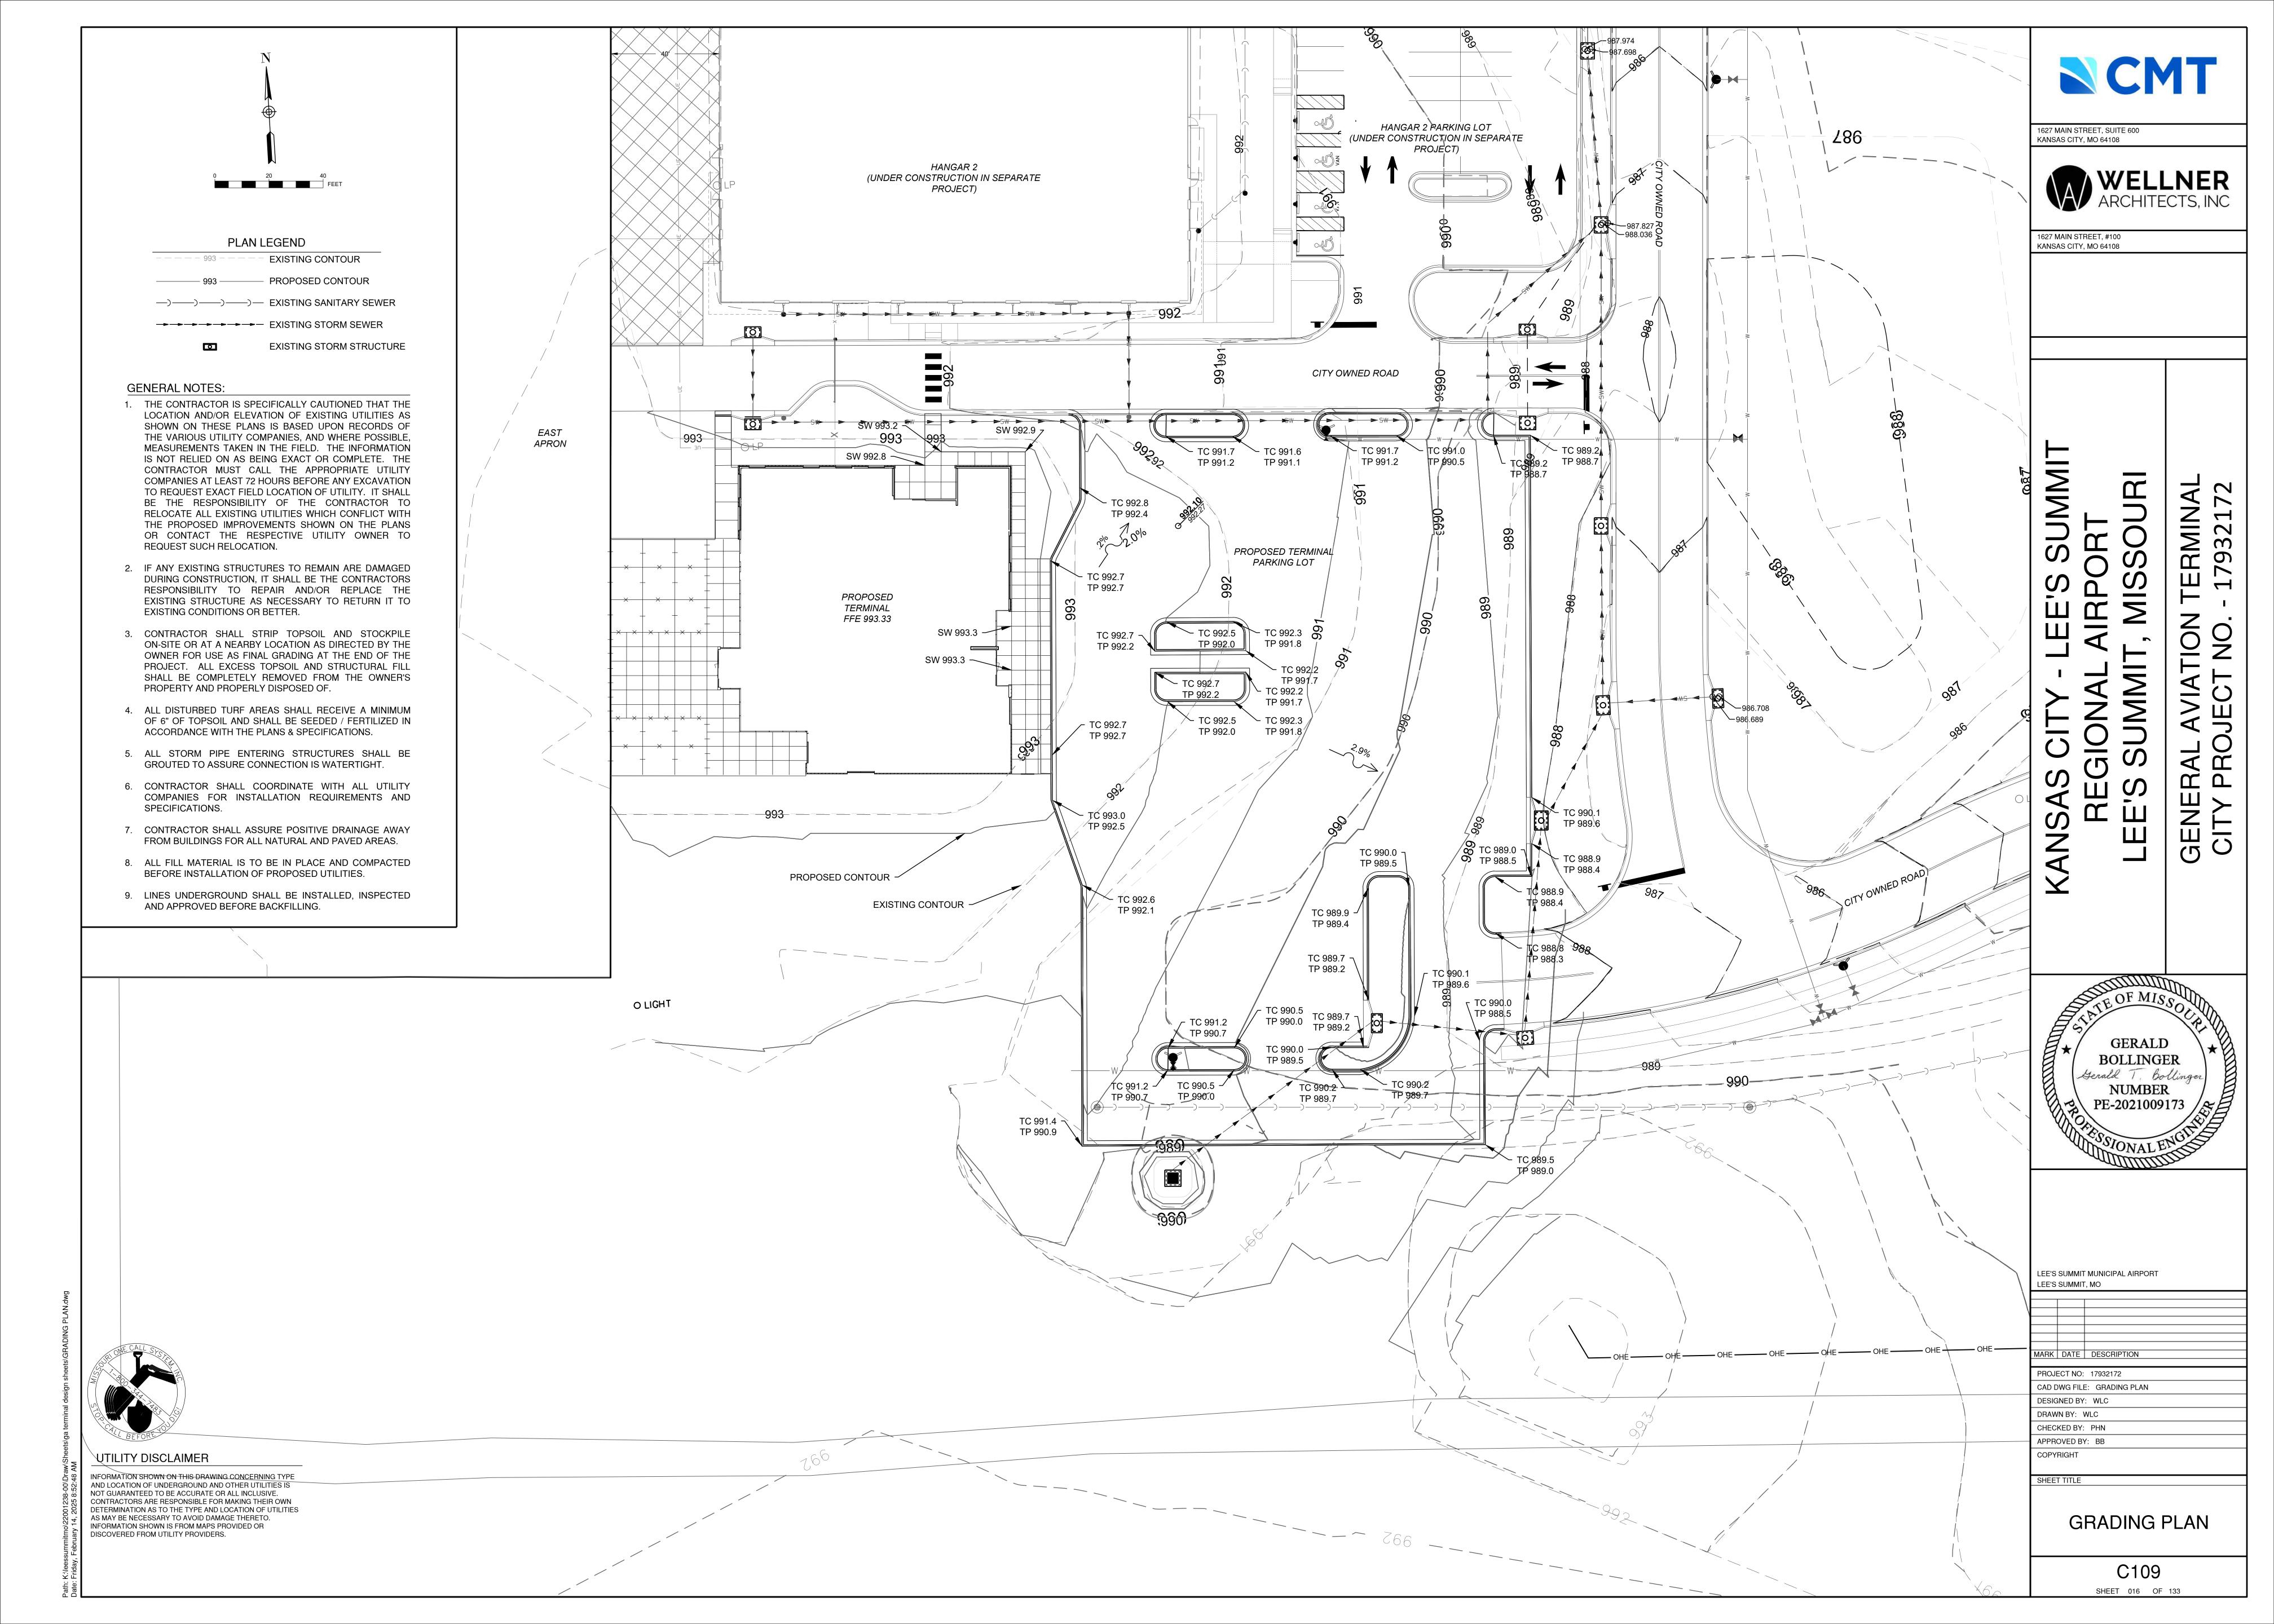
SHEET TITLE

DOME SECTION

C106 SHEET 013 OF 133



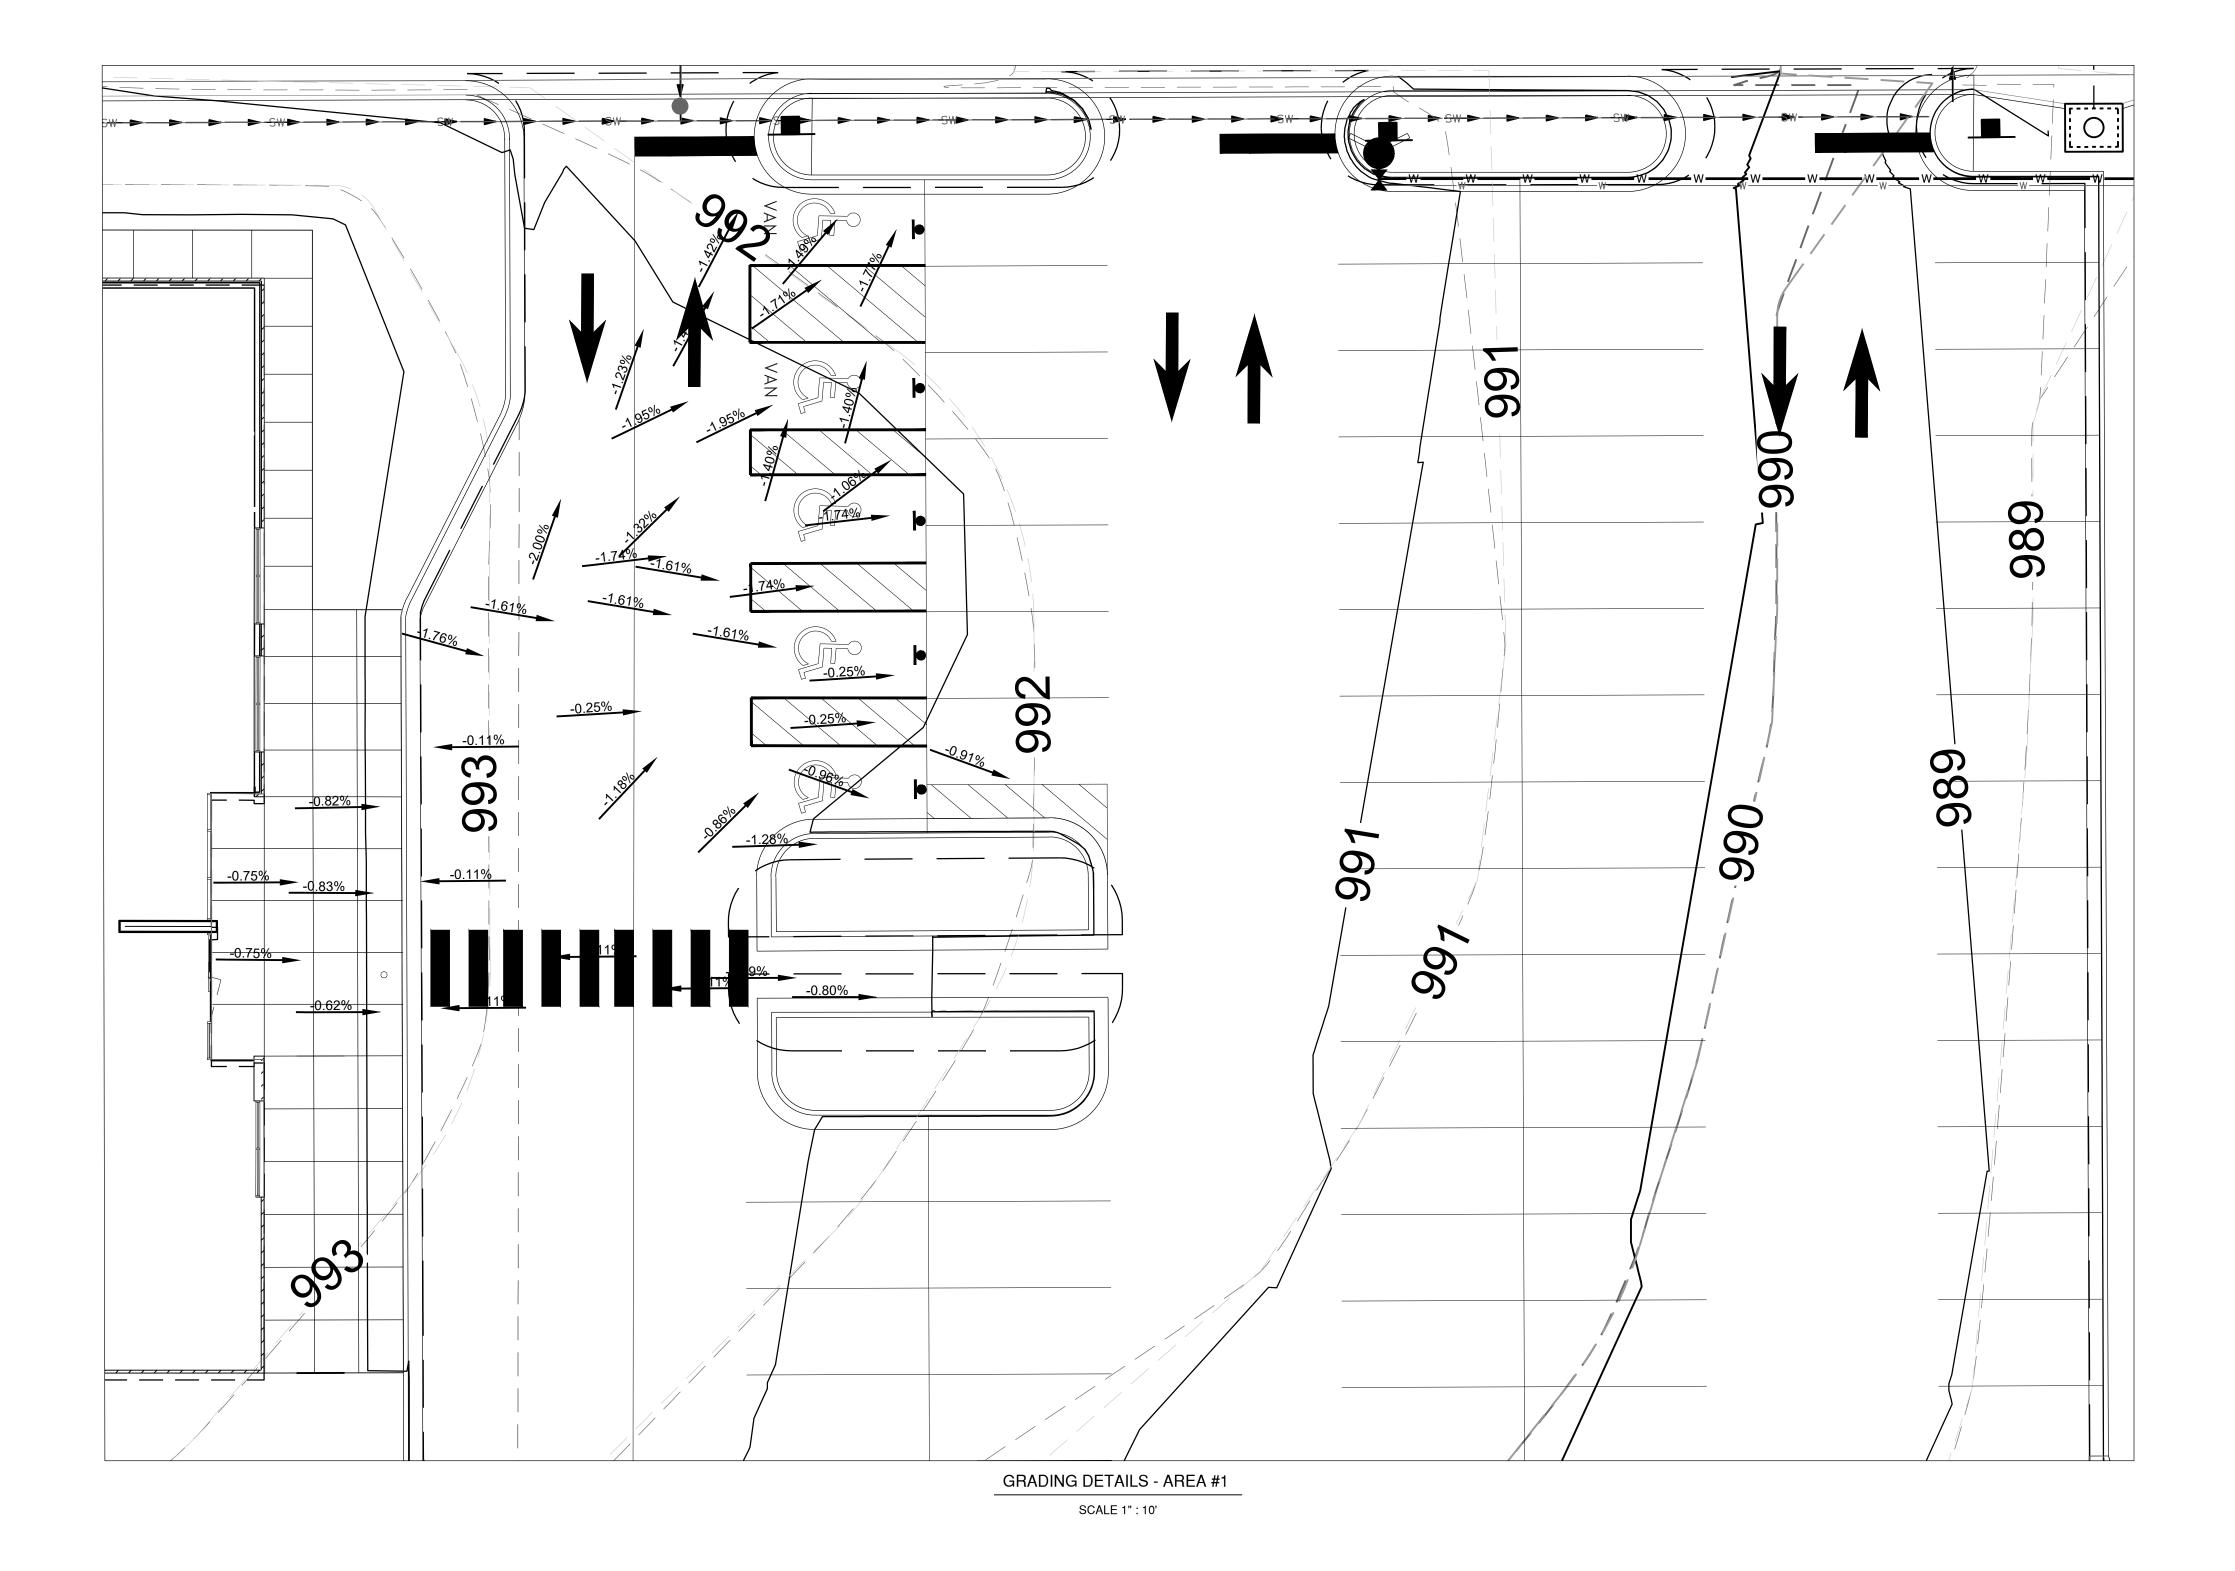




GENERAL NOTES:

1. THE CONTRACTOR IS SPECIFICALLY CAUTIONED THAT THE LOCATION AND/OR ELEVATION OF EXISTING UTILITIES AS SHOWN ON THESE PLANS IS BASED UPON RECORDS OF THE VARIOUS UTILITY COMPANIES, AND WHERE POSSIBLE, MEASUREMENTS TAKEN IN THE FIELD. THE INFORMATION IS NOT RELIED ON AS BEING EXACT OR COMPLETE. THE CONTRACTOR MUST CALL THE APPROPRIATE UTILITY COMPANIES AT LEAST 72 HOURS BEFORE ANY EXCAVATION TO REQUEST EXACT FIELD LOCATION OF UTILITY. IT SHALL BE THE RESPONSIBILITY OF THE CONTRACTOR TO RELOCATE ALL EXISTING UTILITIES WHICH CONFLICT WITH THE PROPOSED IMPROVEMENTS SHOWN ON THE PLANS OR CONTACT THE RESPECTIVE UTILITY OWNER TO REQUEST SUCH RELOCATION.

- 2. IF ANY EXISTING STRUCTURES TO REMAIN ARE DAMAGED DURING CONSTRUCTION, IT SHALL BE THE CONTRACTORS RESPONSIBILITY TO REPAIR AND/OR REPLACE THE EXISTING STRUCTURE AS NECESSARY TO RETURN IT TO EXISTING CONDITIONS OR
- 3. CONTRACTOR SHALL STRIP TOPSOIL AND STOCKPILE ON-SITE OR AT A NEARBY LOCATION AS DIRECTED BY THE OWNER FOR USE AS FINAL GRADING AT THE END OF THE PROJECT. ALL EXCESS TOPSOIL AND STRUCTURAL FILL SHALL BE COMPLETELY
- REMOVED FROM THE OWNER'S PROPERTY AND PROPERLY DISPOSED OF. 4. ALL DISTURBED TURF AREAS SHALL RECEIVE A MINIMUM OF 6" OF TOPSOIL AND SHALL
- BE SEEDED / FERTILIZED IN ACCORDANCE WITH THE PLANS & SPECIFICATIONS. 5. ALL STORM PIPE ENTERING STRUCTURES SHALL BE GROUTED TO ASSURE CONNECTION IS WATERTIGHT.
- 6. CONTRACTOR SHALL COORDINATE WITH ALL UTILITY COMPANIES FOR INSTALLATION
- REQUIREMENTS AND SPECIFICATIONS. 7. CONTRACTOR SHALL ASSURE POSITIVE DRAINAGE AWAY FROM BUILDINGS FOR ALL
- 8. ALL FILL MATERIAL IS TO BE IN PLACE AND COMPACTED BEFORE INSTALLATION OF
- 9. LINES UNDERGROUND SHALL BE INSTALLED, INSPECTED AND APPROVED BEFORE BACKFILLING.





UTILITY DISCLAIMER

INFORMATION SHOWN ON THIS DRAWING CONCERNING TYPE AND LOCATION OF UNDERGROUND AND OTHER UTILITIES IS NOT GUARANTEED TO BE ACCURATE OR ALL INCLUSIVE. CONTRACTORS ARE RESPONSIBLE FOR MAKING THEIR OWN DETERMINATION AS TO THE TYPE AND LOCATION OF UTILITIES AS MAY BE NECESSARY TO AVOID DAMAGE THERETO. INFORMATION SHOWN IS FROM MAPS PROVIDED OR DISCOVERED FROM UTILITY PROVIDERS.

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1627 MAIN STREET, #100 KANSAS CITY, MO 64108

TERMINAL 17932172

LEE'S SUMMIT MUNICIPAL AIRPORT LEE'S SUMMIT, MO

MARK | DATE | DESCRIPTION

PROJECT NO: 17932172 CAD DWG FILE: GRADING PLAN DETAIL

DESIGNED BY: WLC

DRAWN BY: WLC CHECKED BY: PHN

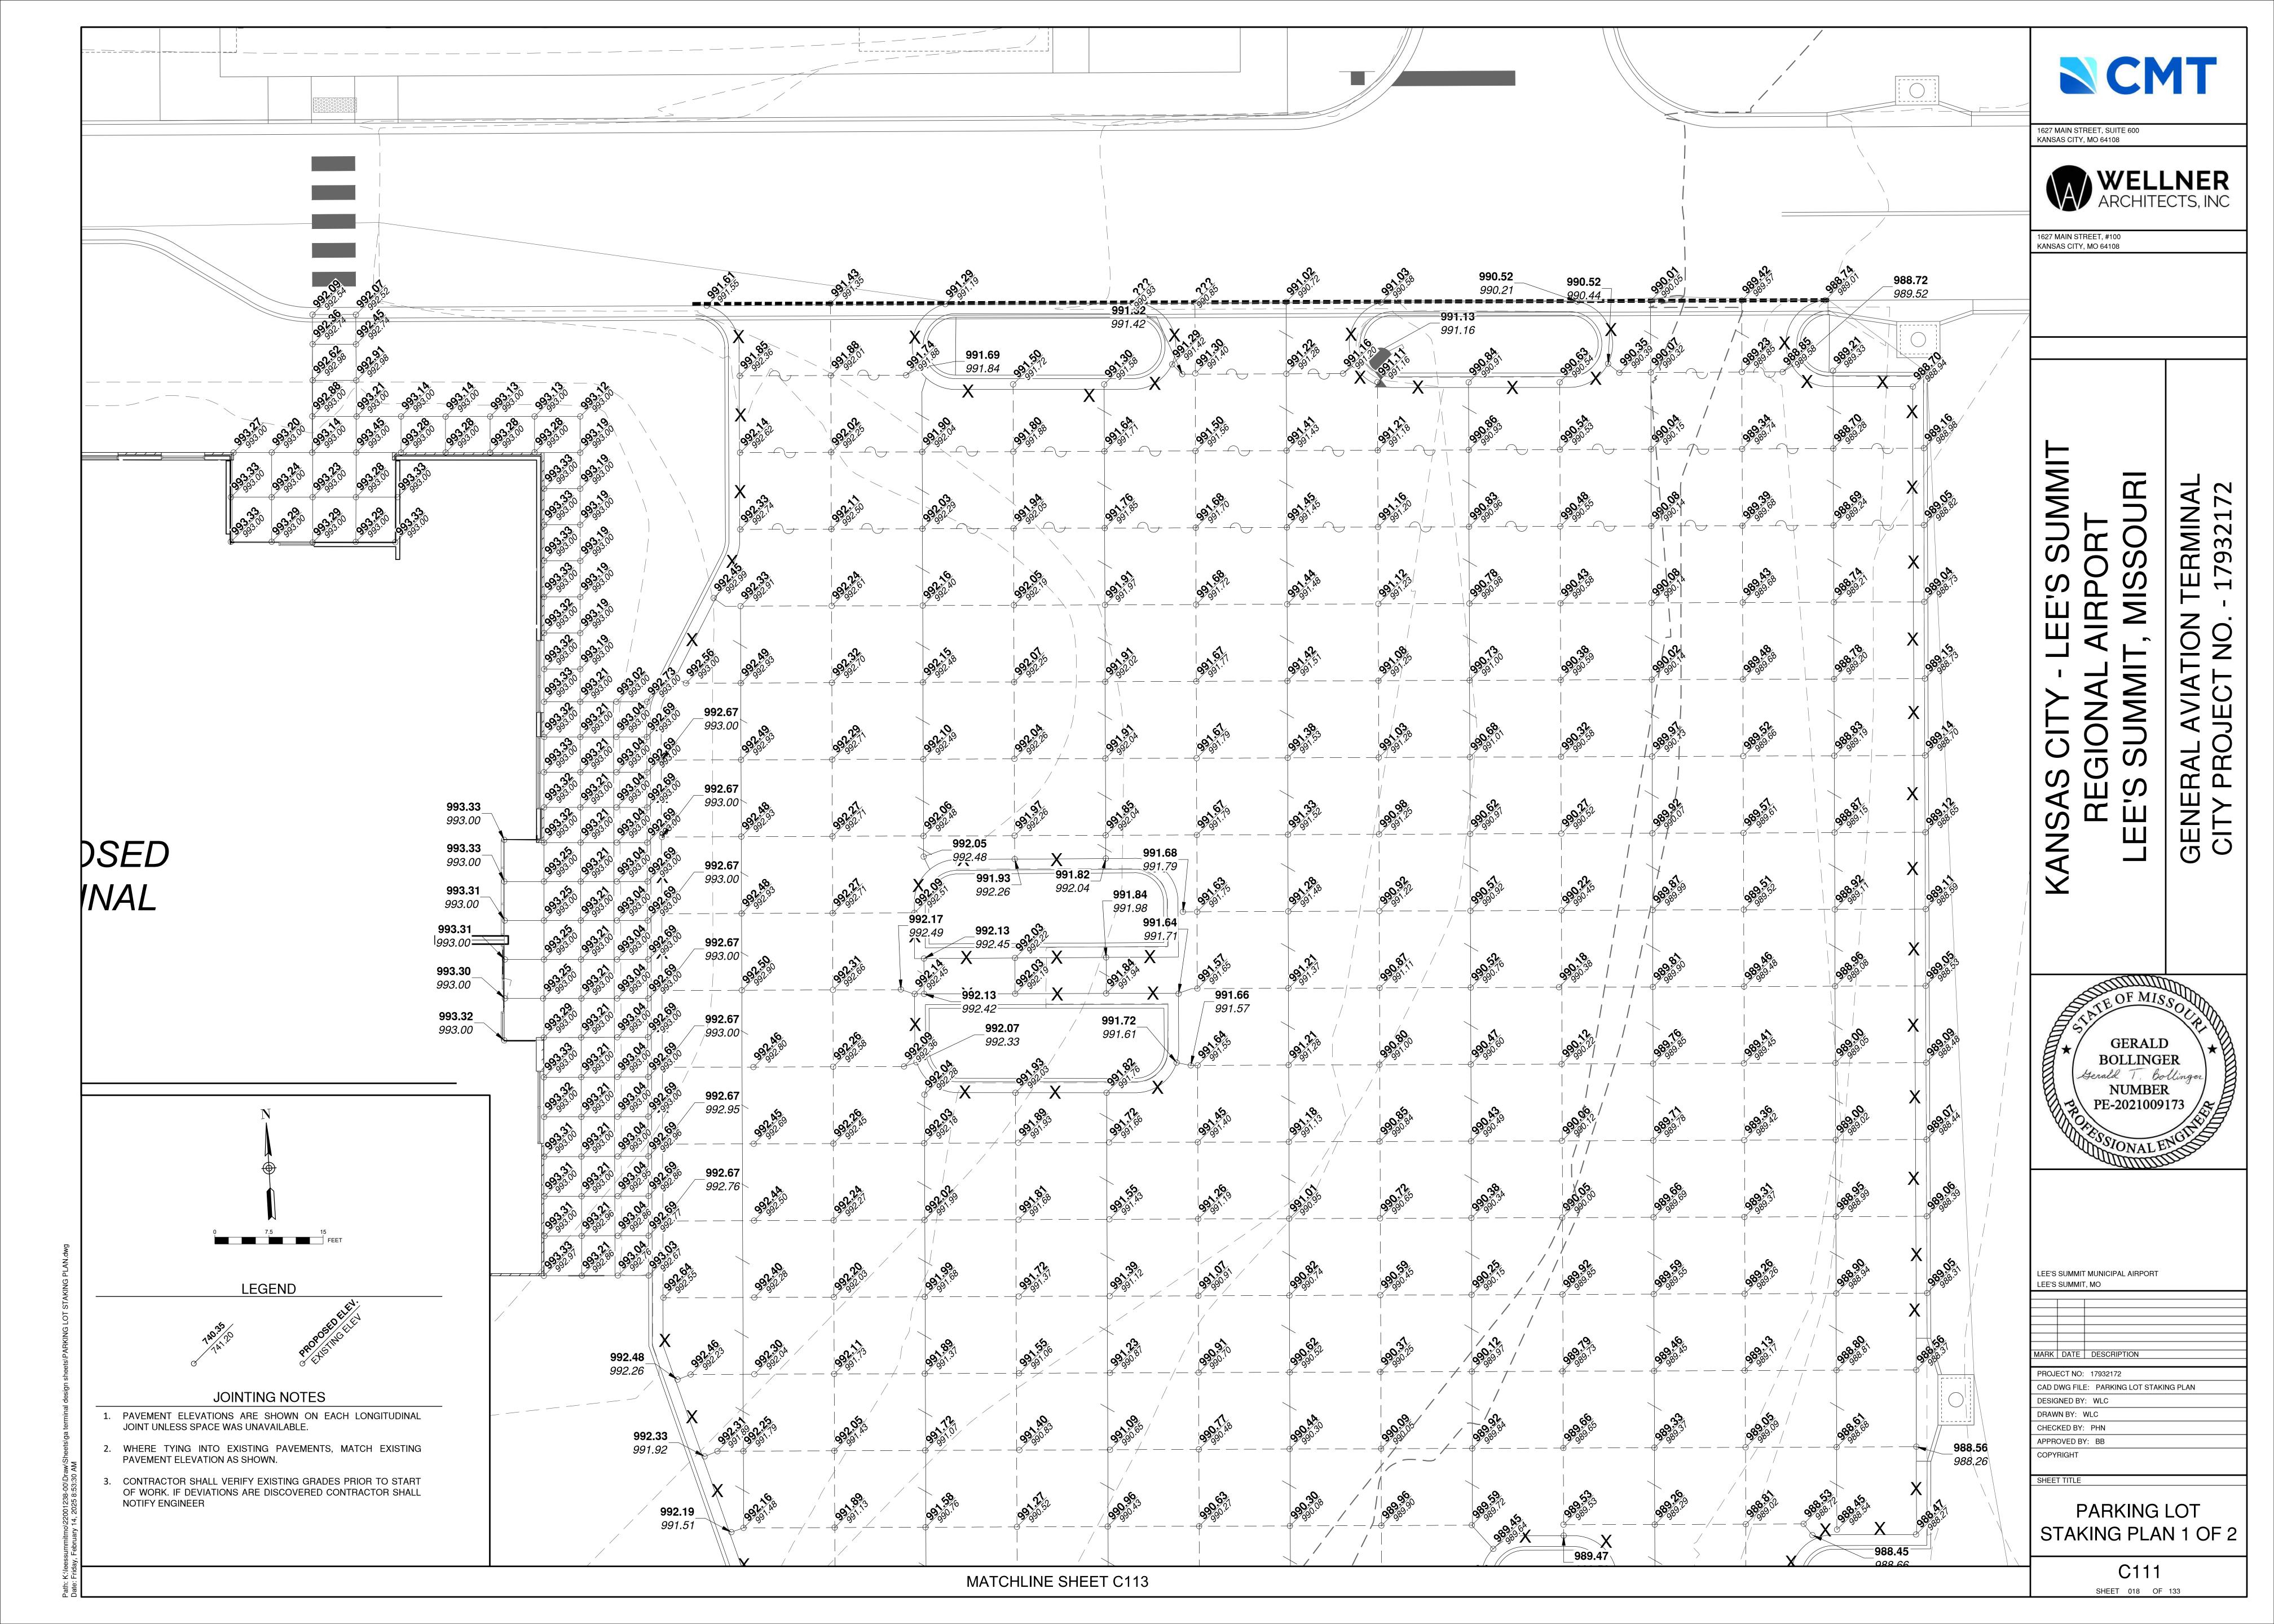
APPROVED BY: BB COPYRIGHT

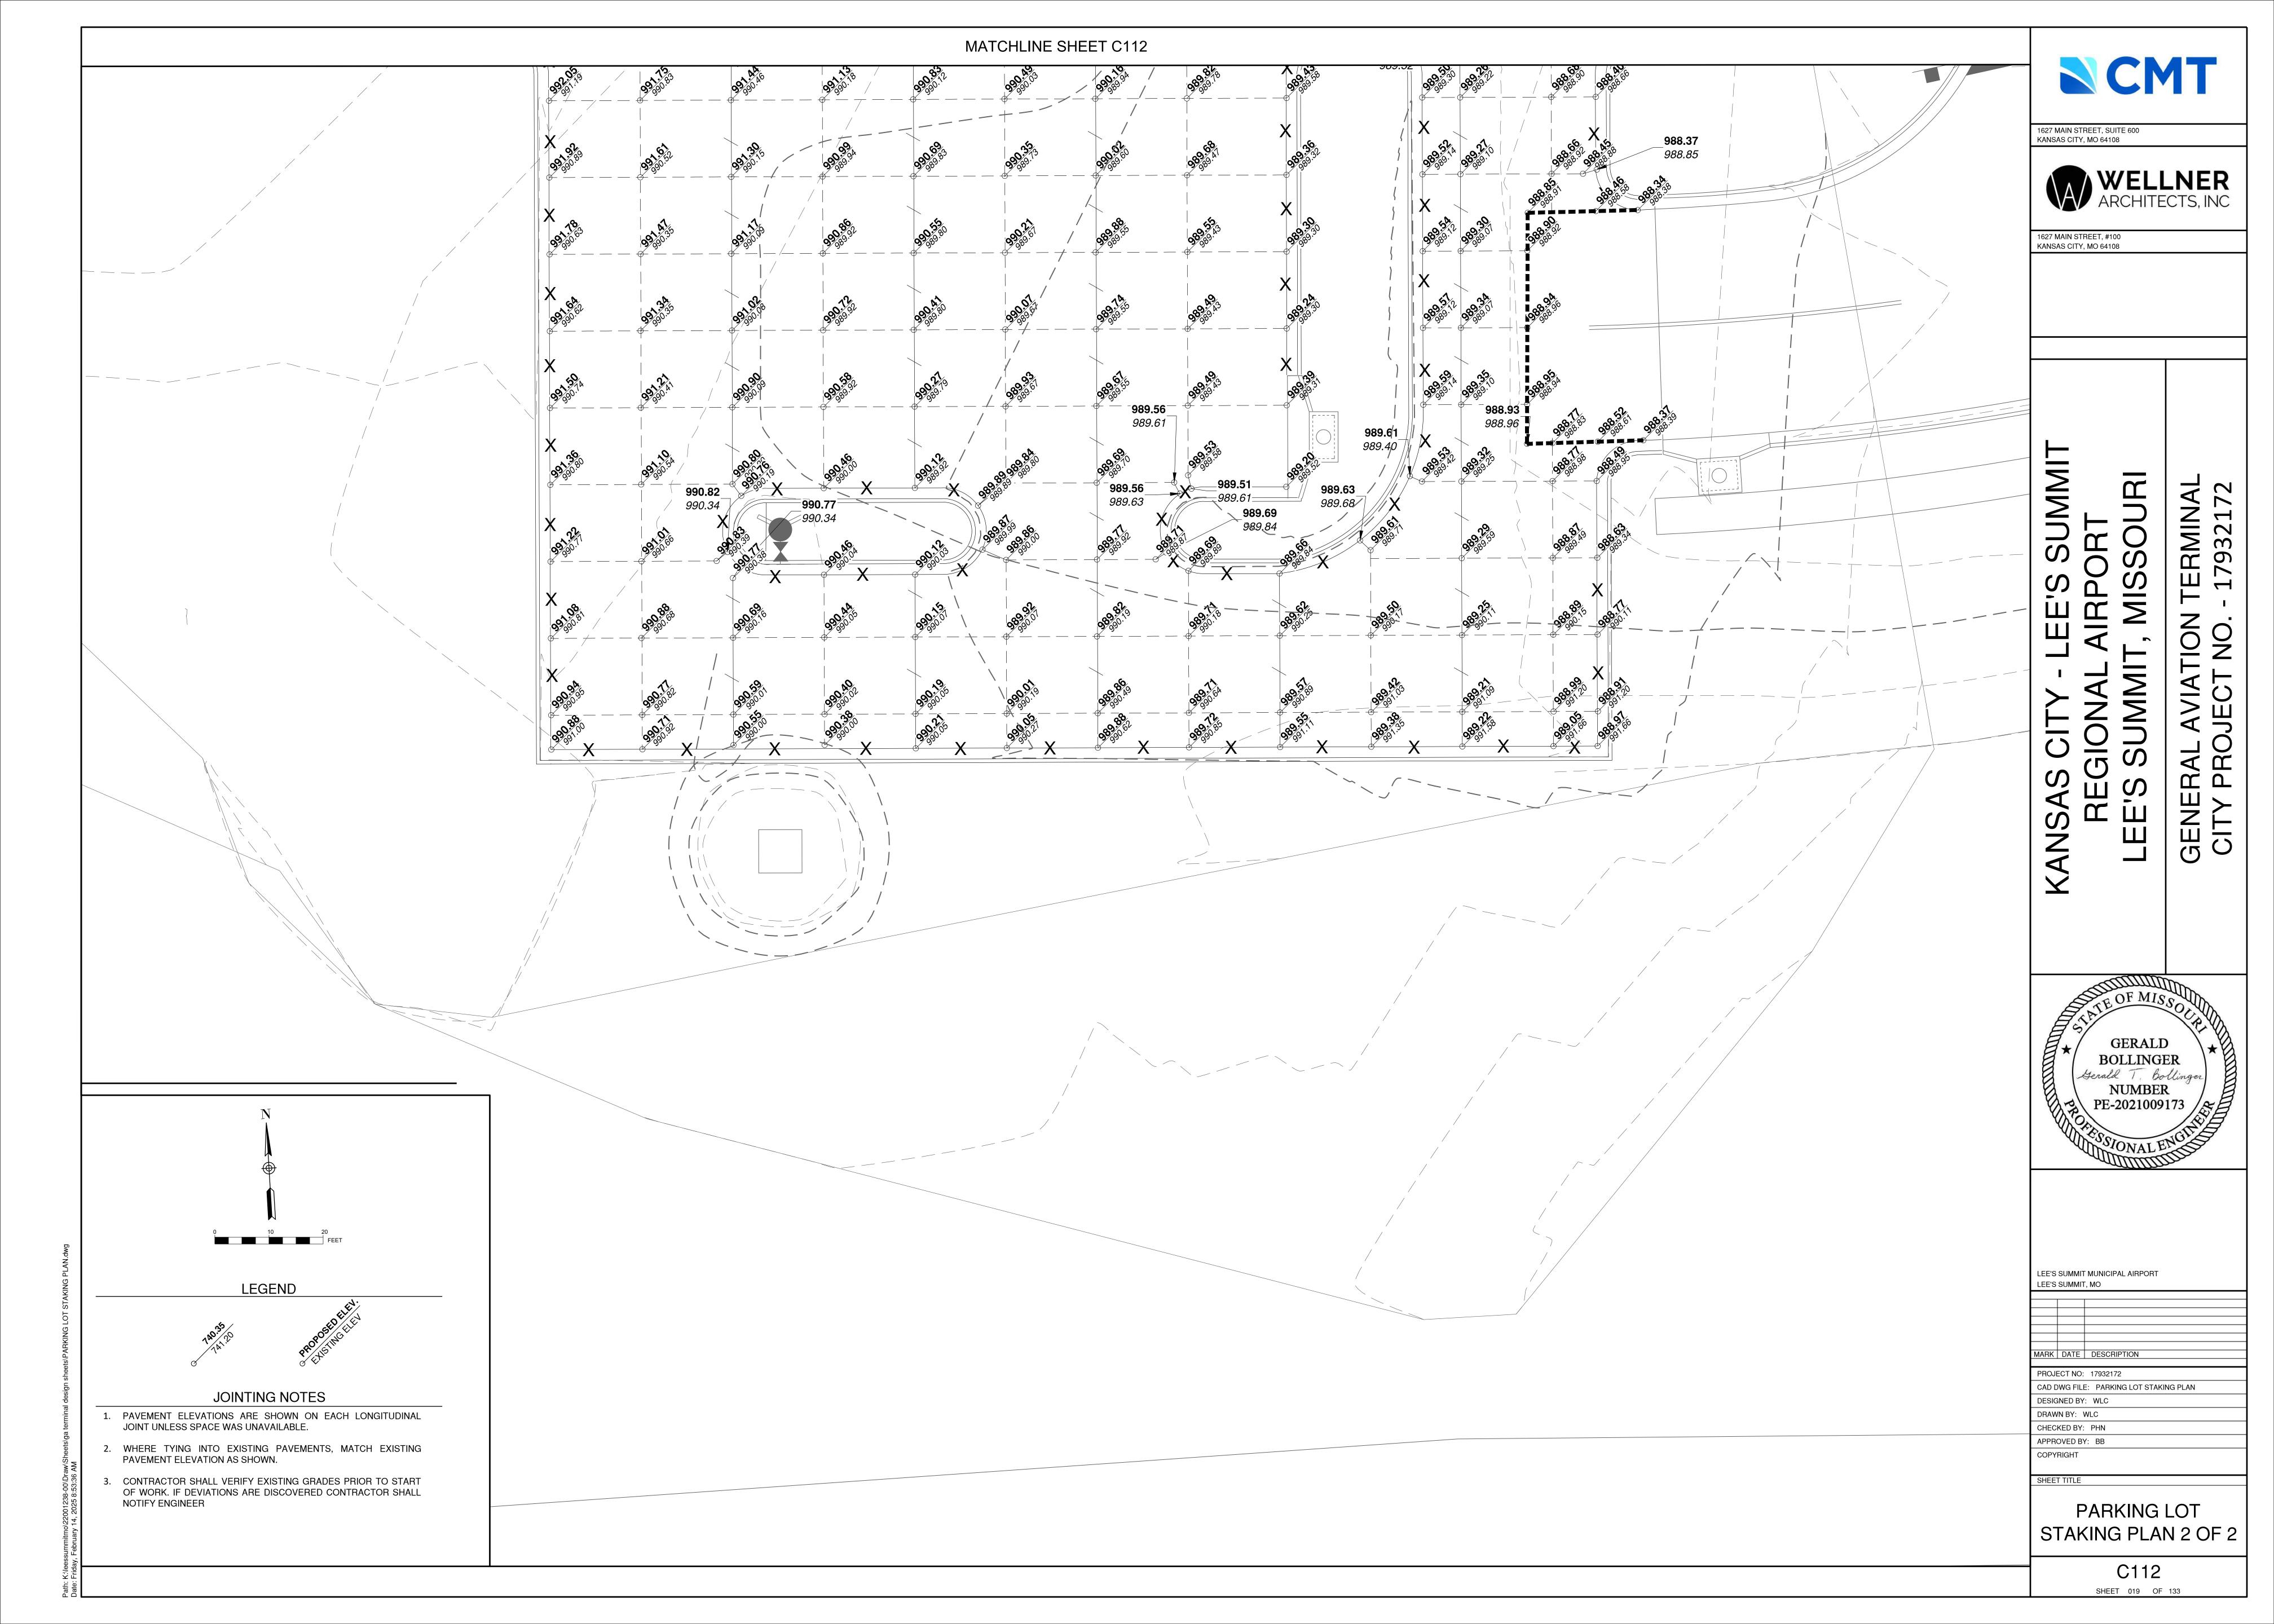
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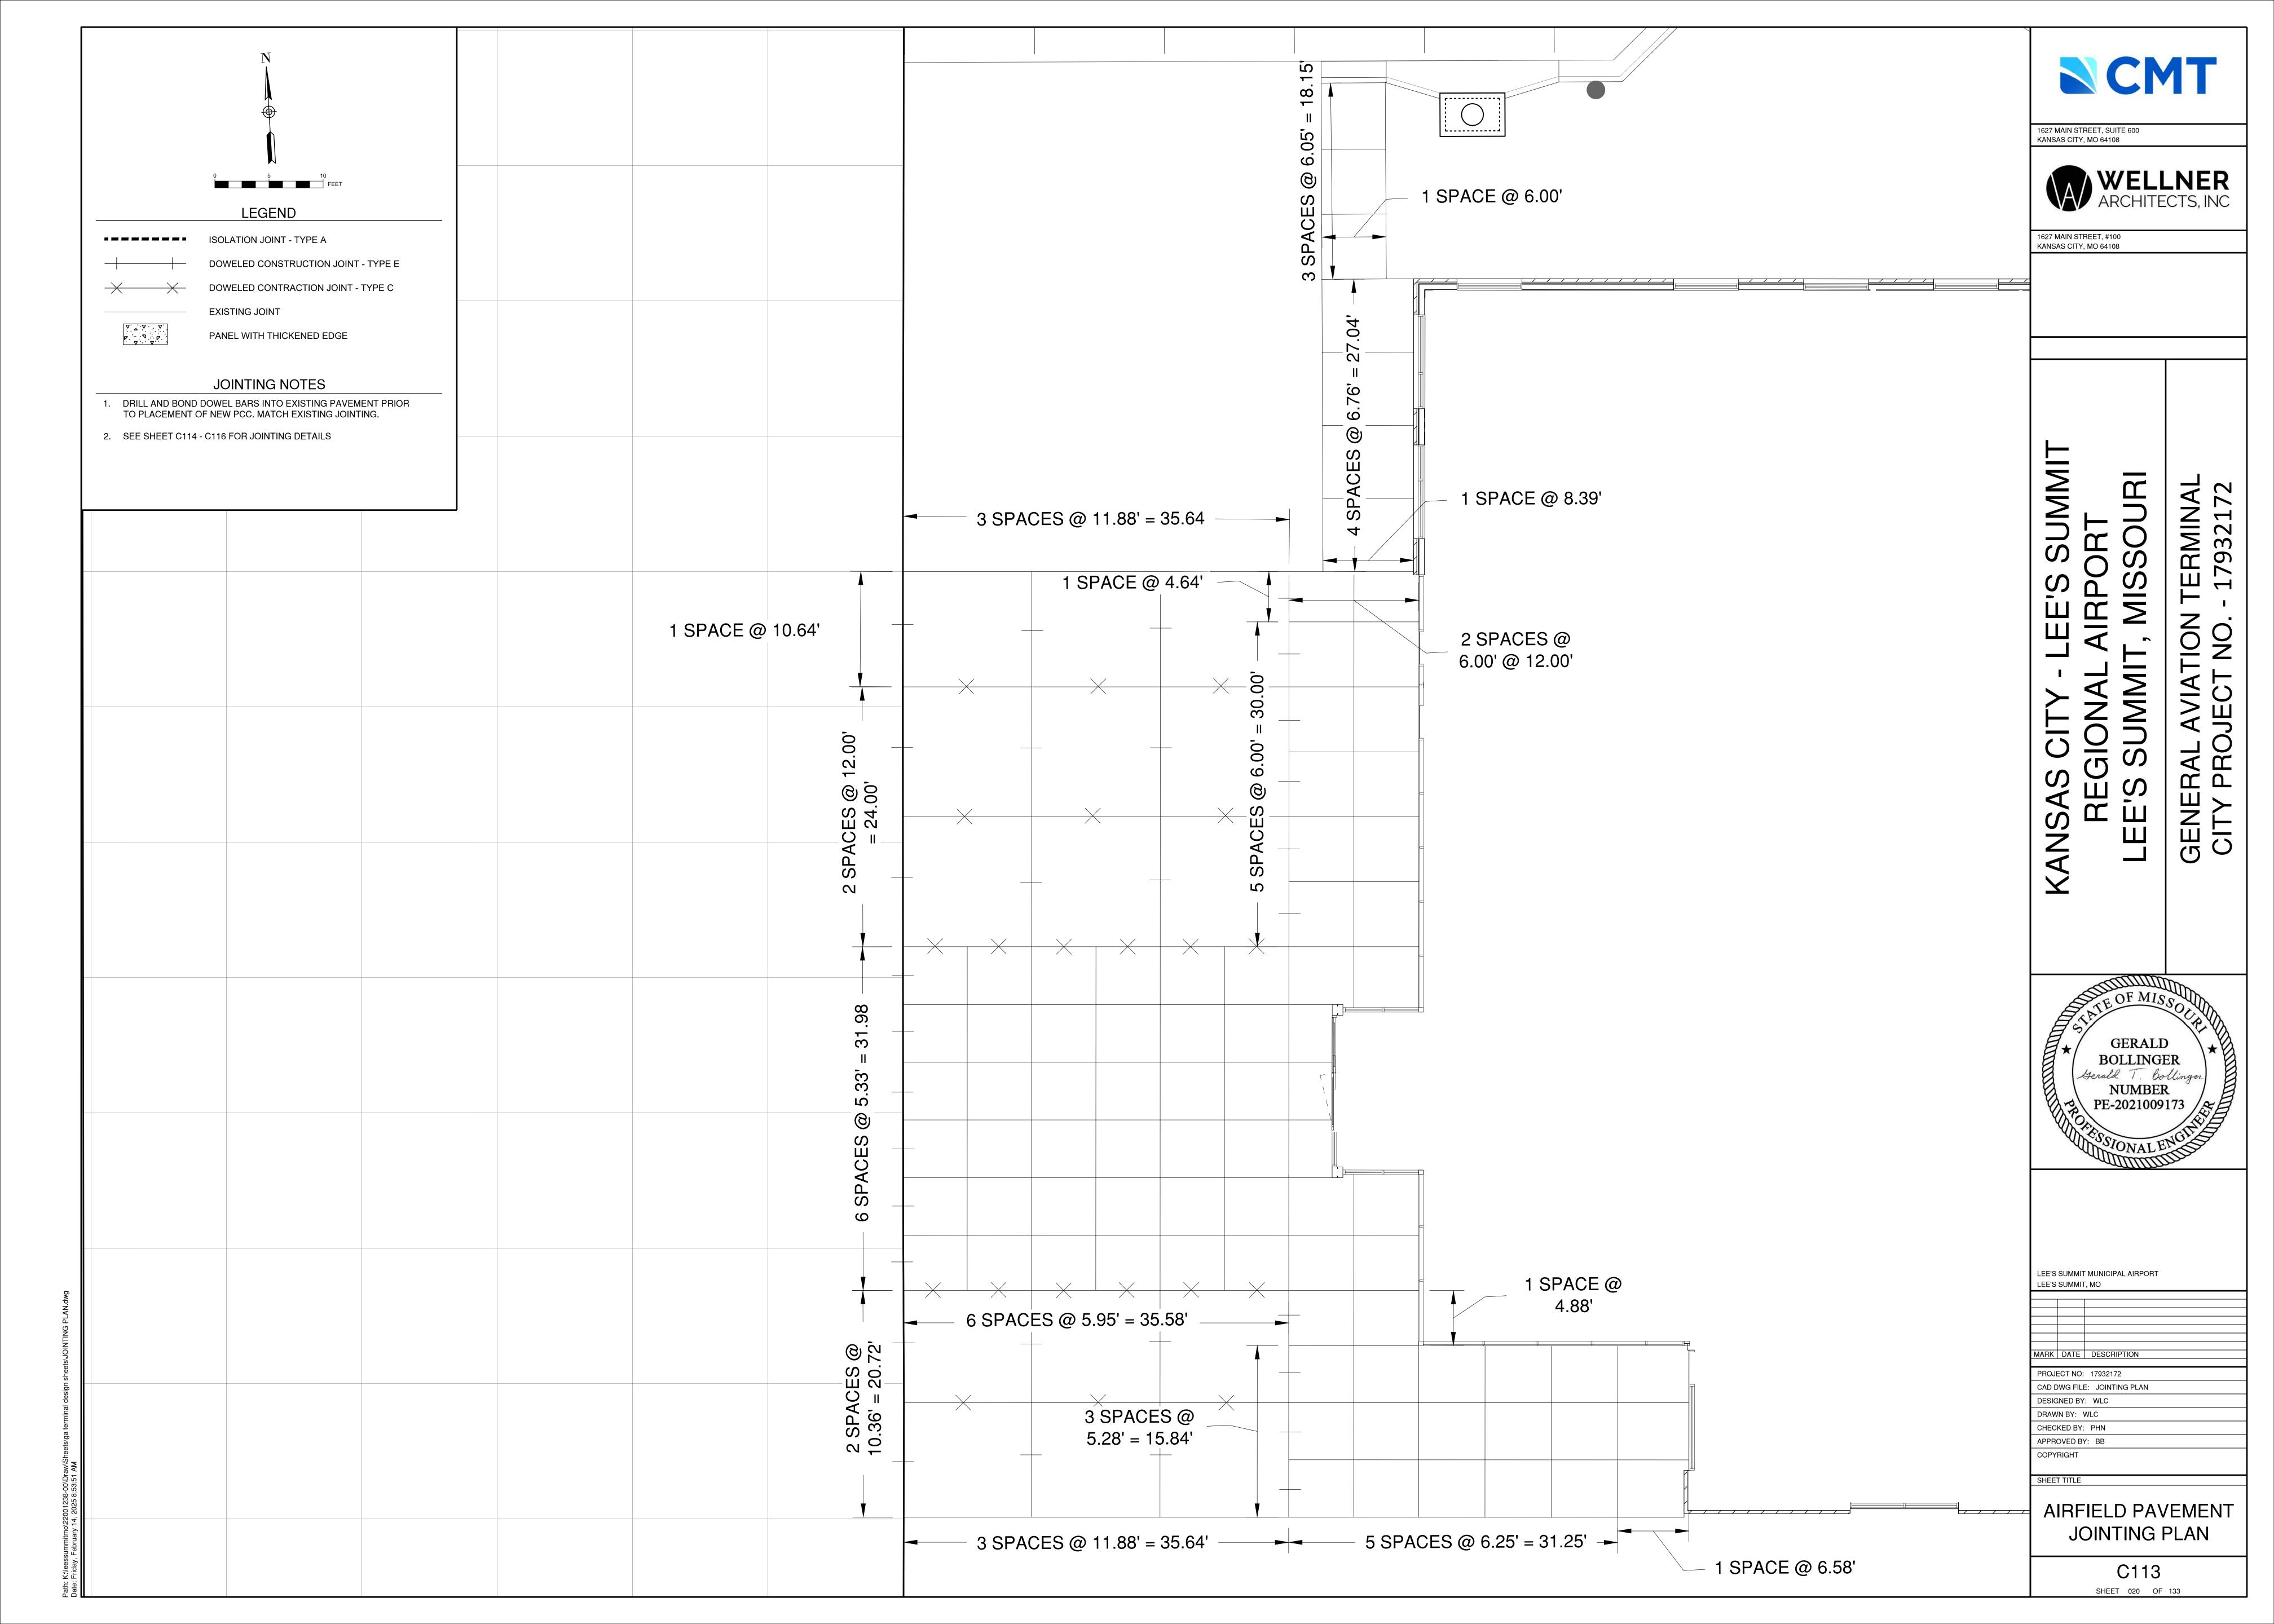
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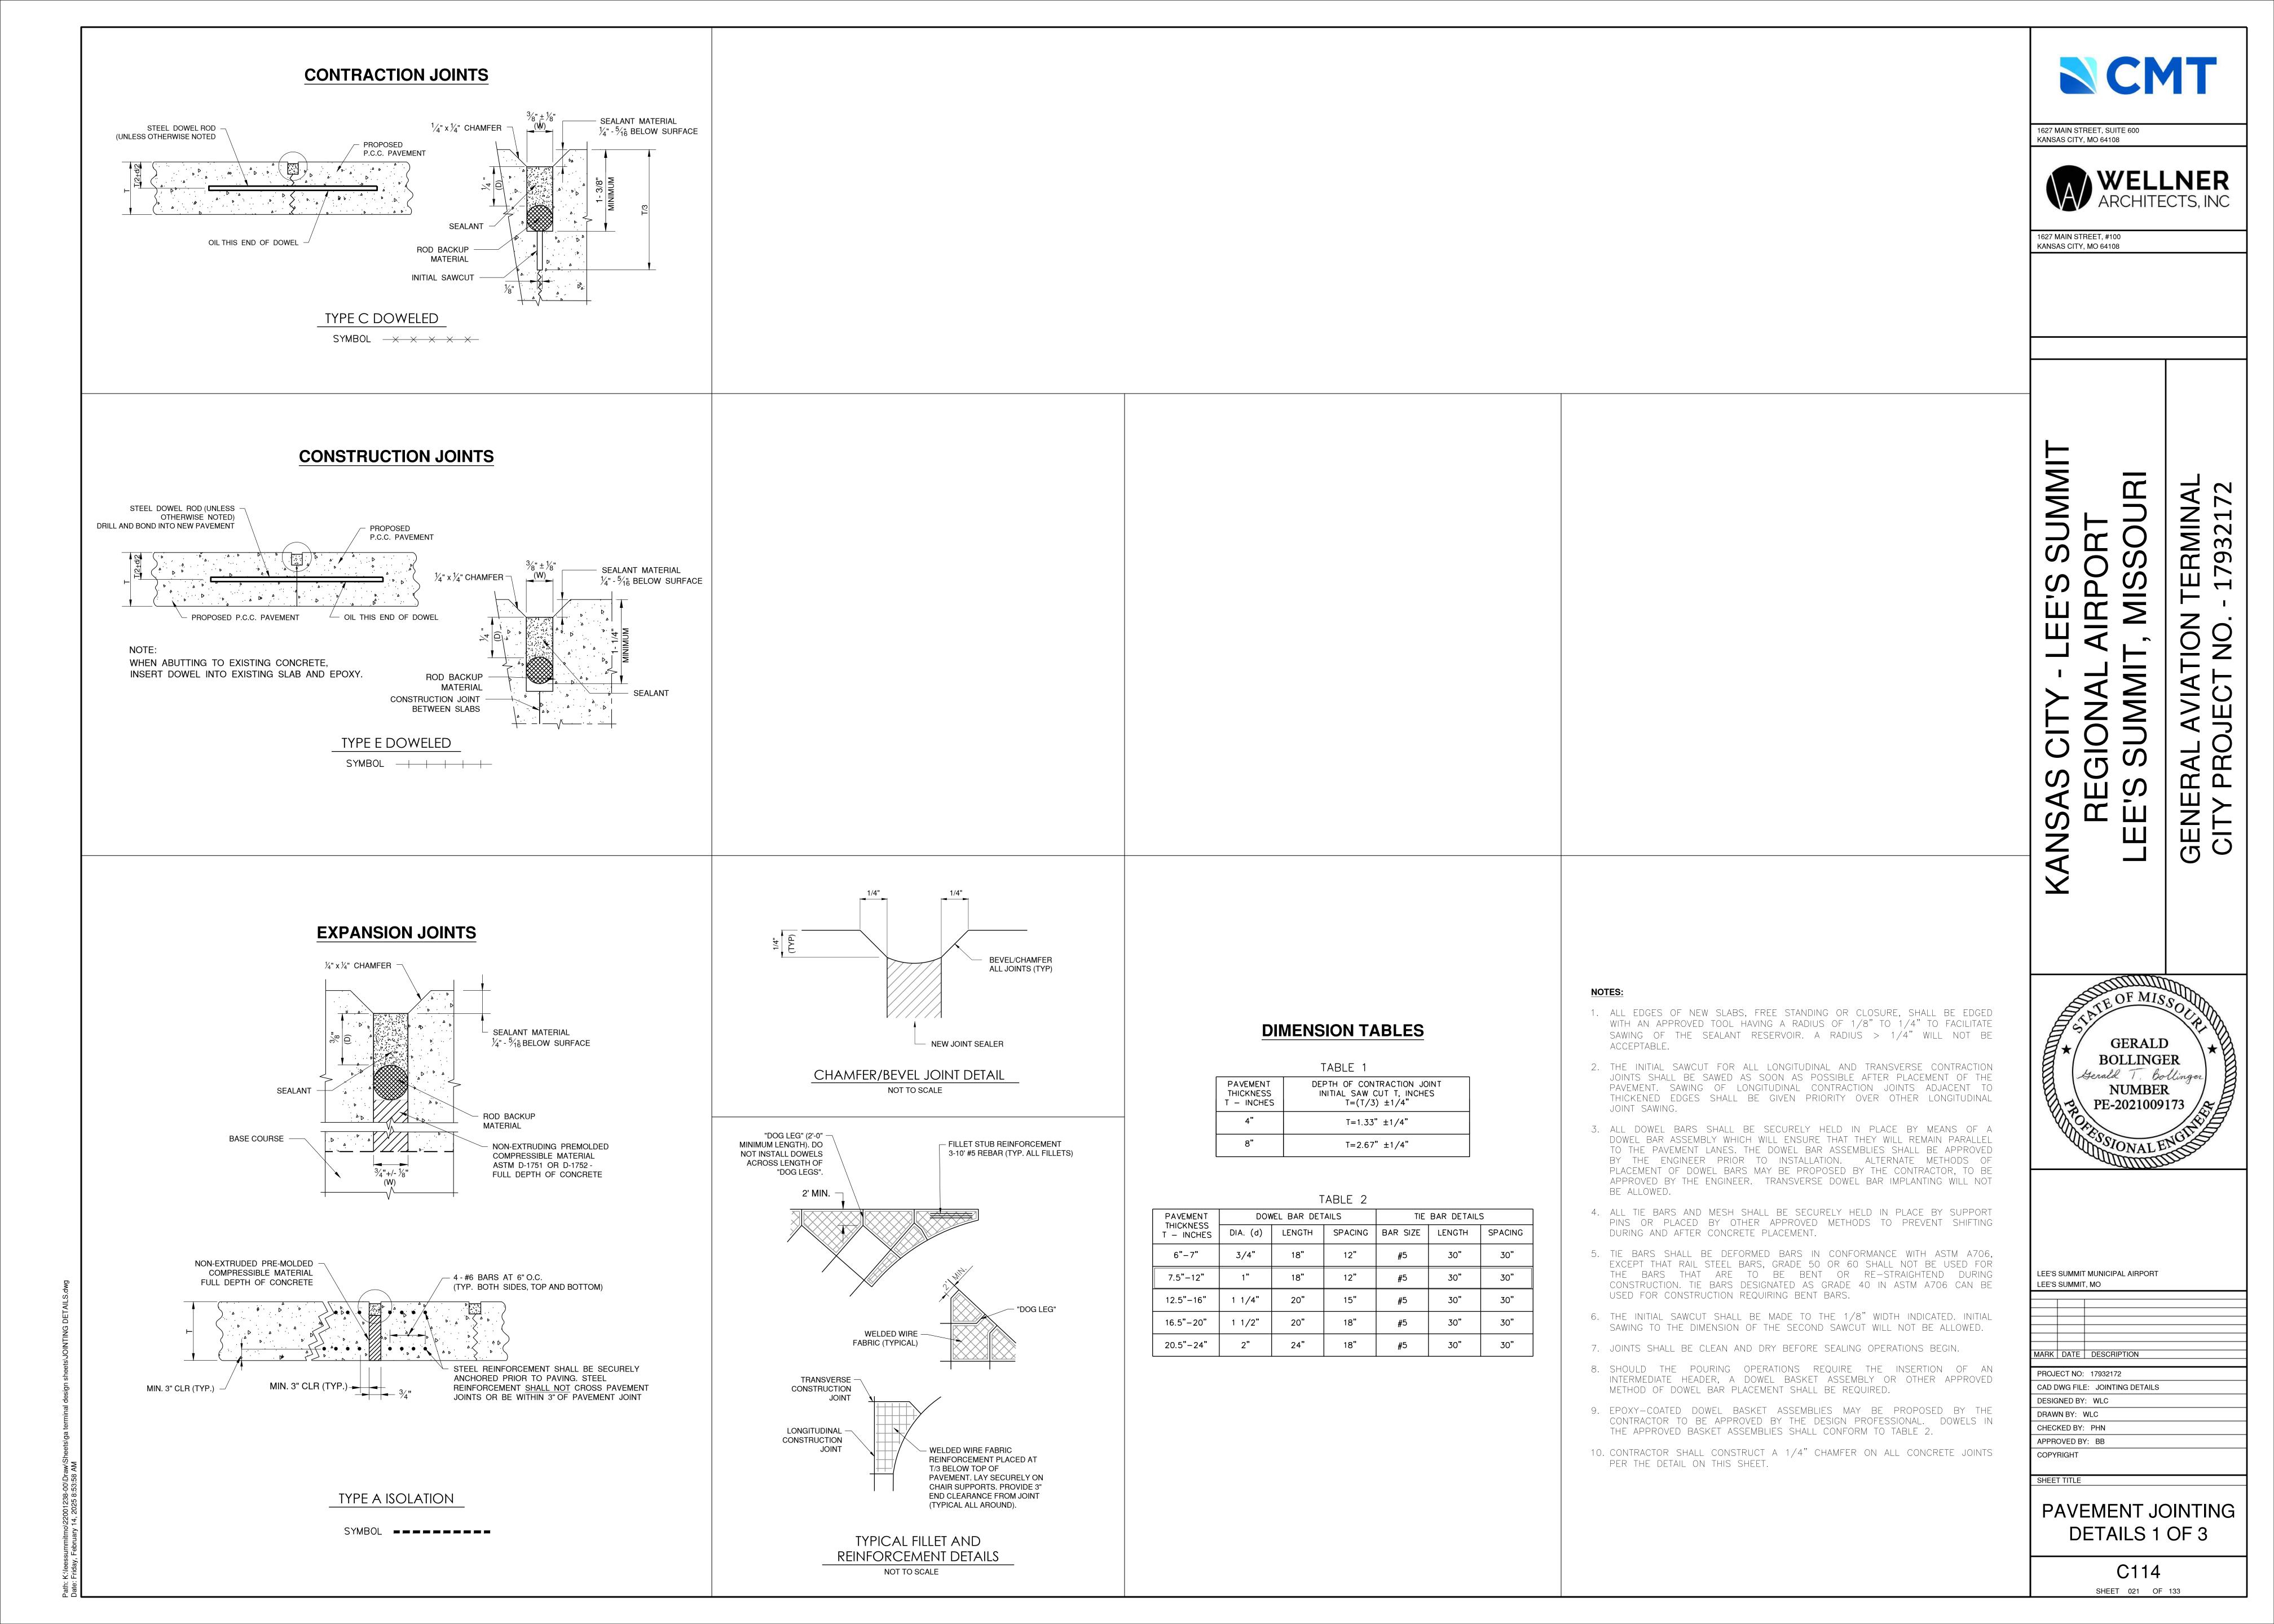
C110

SHEET 017 OF 133



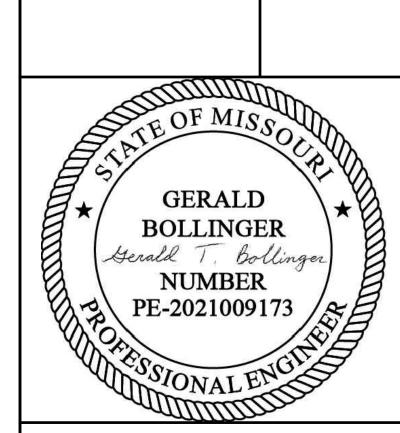








KANSAS CITY, MO 64108



LEE'S SUMMIT MUNICIPAL AIRPORT

PROJECT NO: 17932172

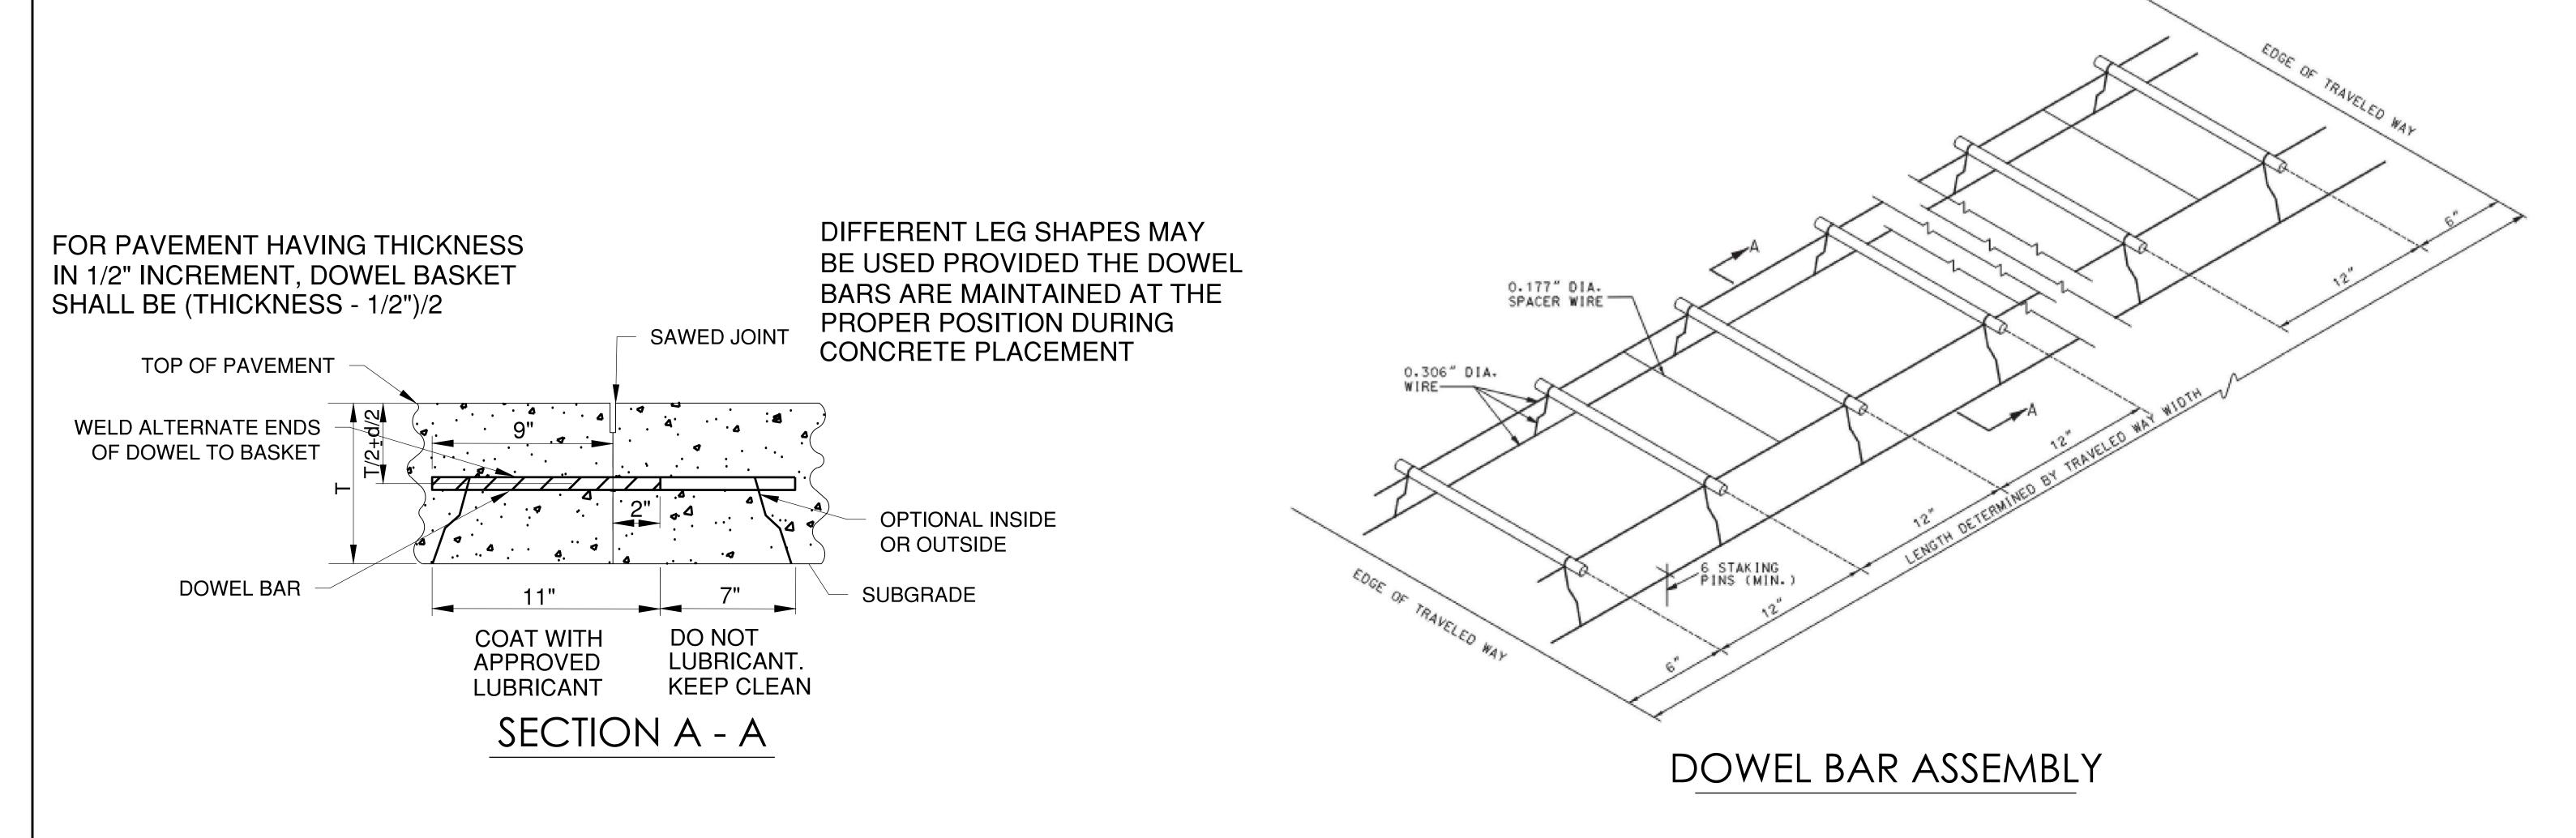
CAD DWG FILE: JOINTING DETAILS

DESIGNED BY: WLC DRAWN BY: WLC

CHECKED BY: PHN APPROVED BY: BB


PAVEMENT JOINTING DETAILS 2 OF 3

C115



NOTES:

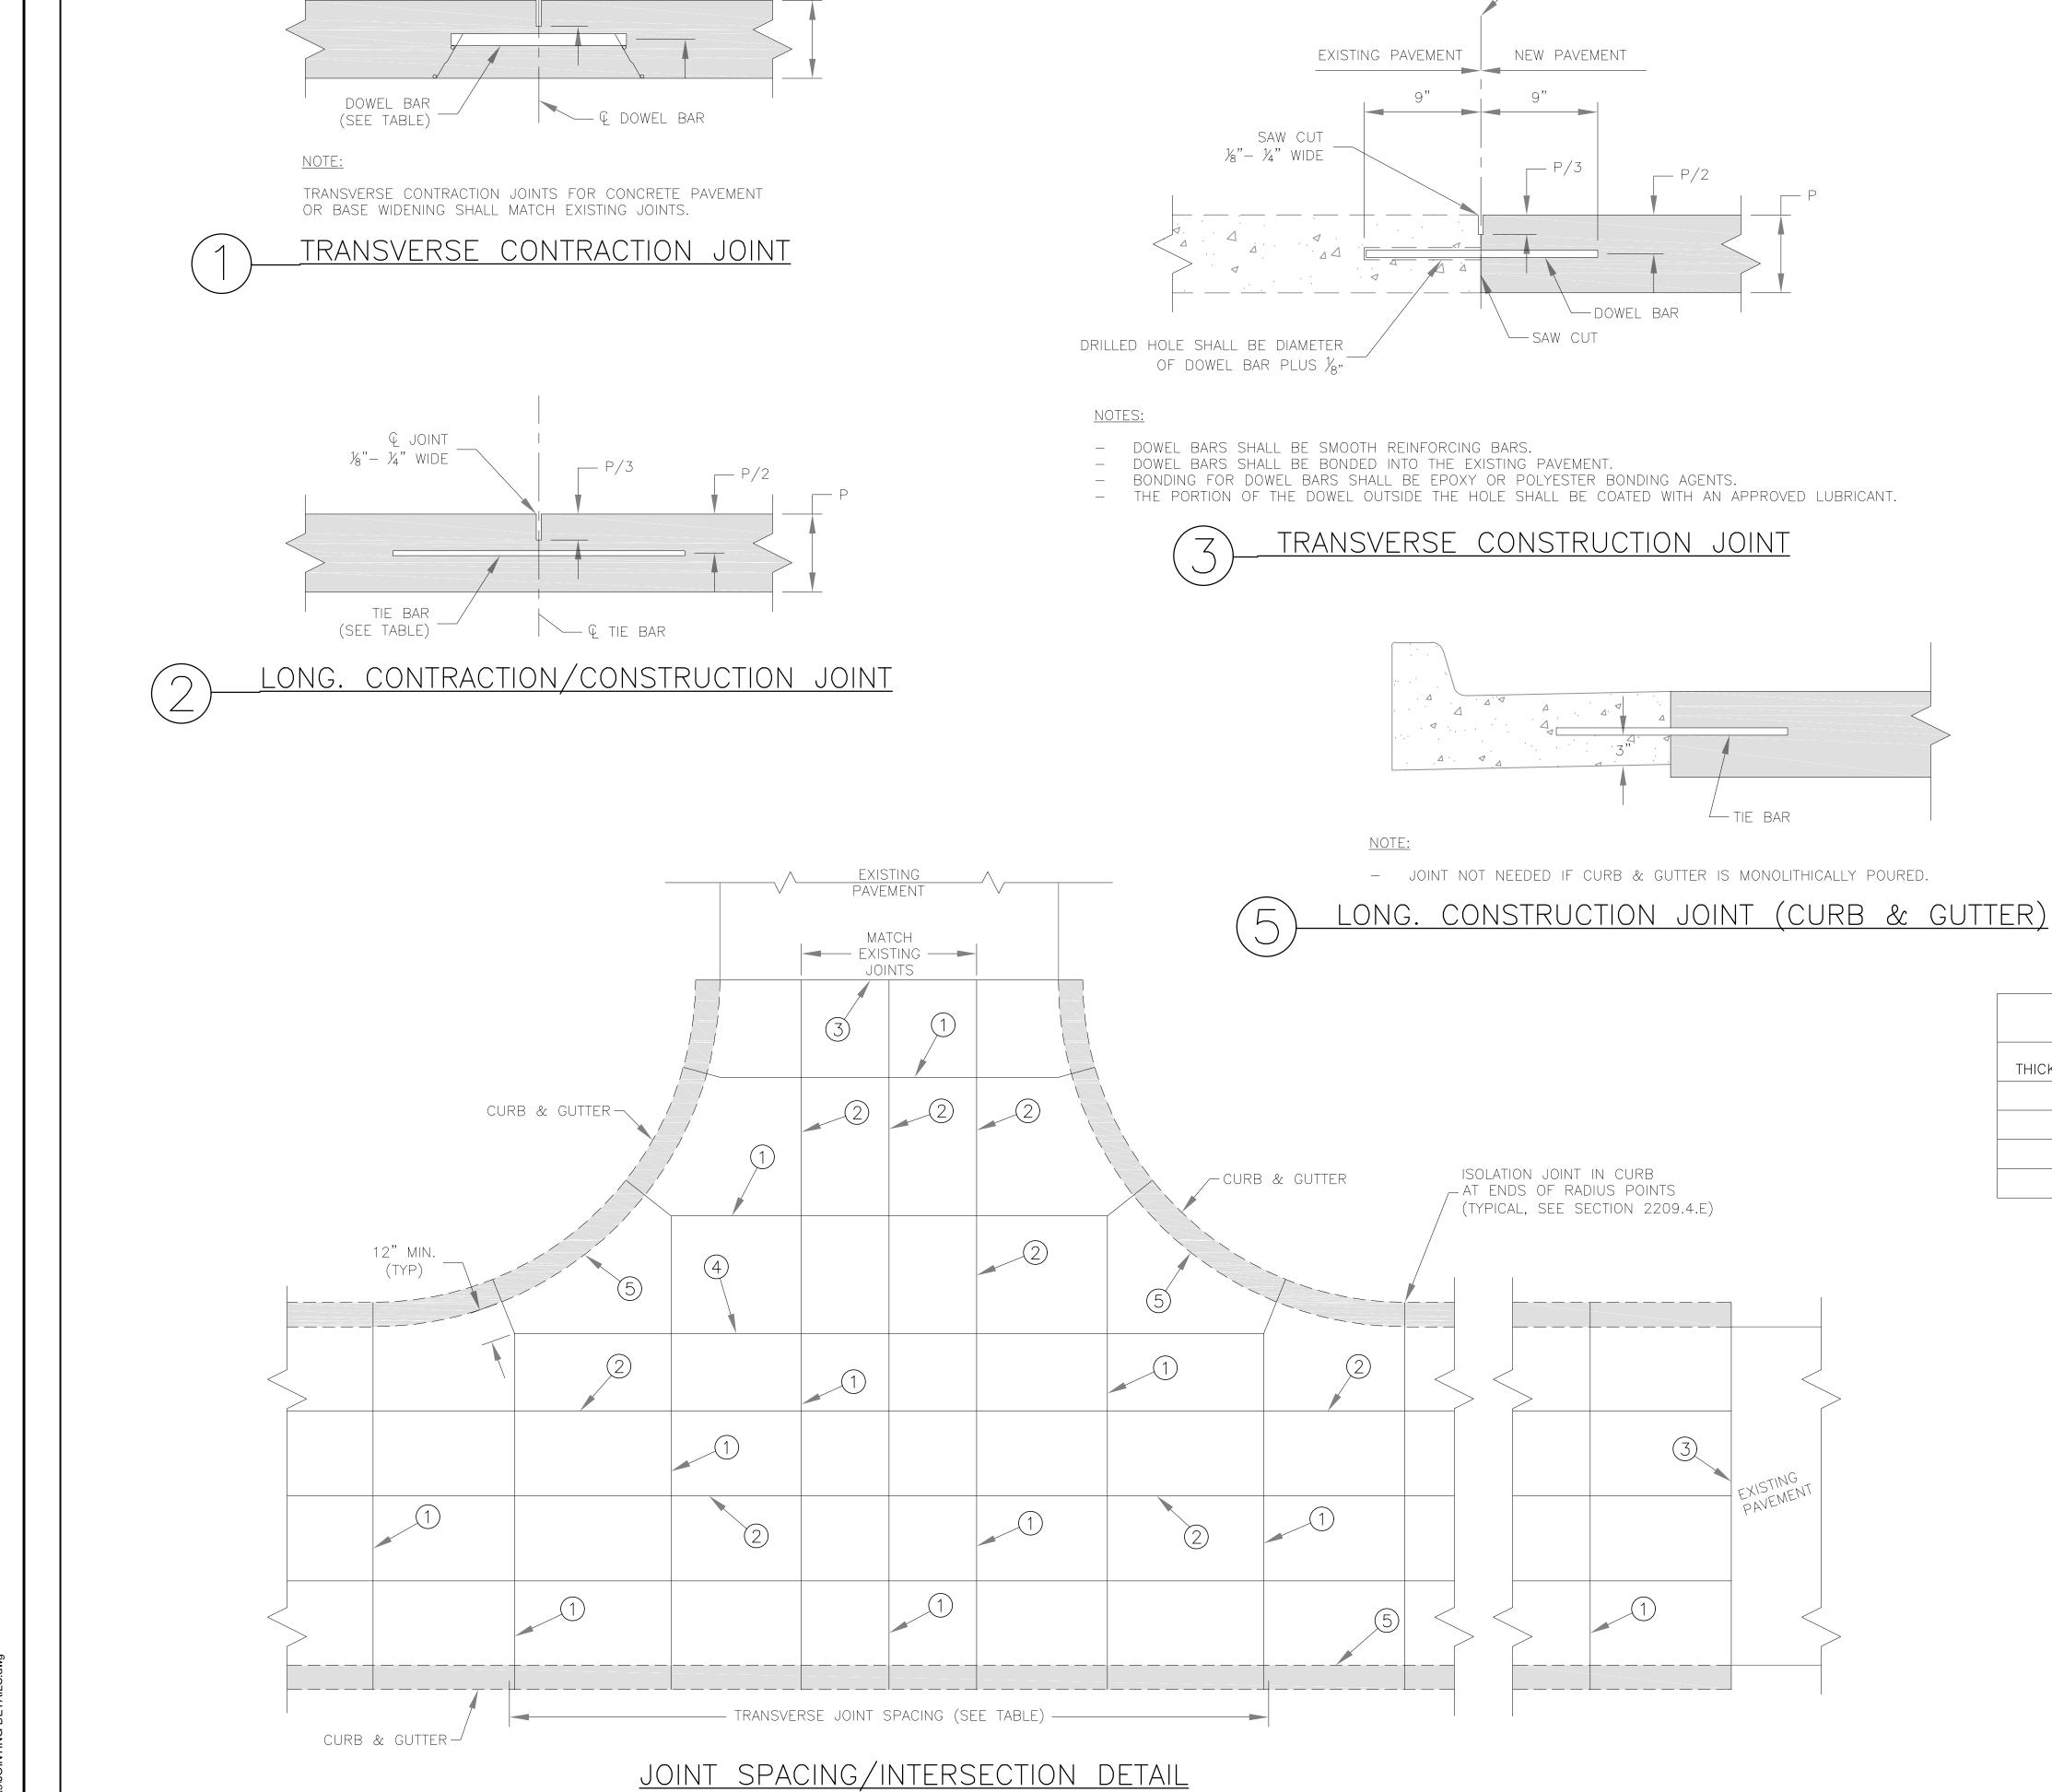
- 1. THE DOWEL SUPPORTING UNITS SHALL BE FACTORY ASSEMBLED AND CAPABLE OF HOLDING THE DOWELS IN THEIR REQUIRED POSITIONS. IN THE COMPLETED JOINT INSTALLATION, DOWELS SHALL BE POSITIONED WITHIN $\frac{1}{2}$ " OF THE VERTICAL AND HORIZONTAL PLANE AND IN THE LONGITUDINAL DIRECTION. THE SKEW TOLERANCE SHALL BE $\frac{1}{4}$ ".
- 2. THE FREE END OF EACH EPOXY COATED DOWEL SHALL BE MARKED WITH A SPOT OF PAINT AT LEAST ONE INCH IN DIAMETER AND CONTRASTING IN COLOR WITH THE EPOXY COATING.
- 3. WIRE SIZES SHOWN ARE MINIMUM REQUIRED.
- 4. WIRES, BARS, OR CLIPS SHALL BE USED AS NECESSARY TO STRENGTHEN ASSEMBLIES.
- 5. THE DIAMETER OF THE SPACER WIRE SHALL NOT EXCEED 0.200".
- 6. SPACER WIRE MAY BE CUT OR LEFT INTACT.
- 7. STAKING PINS SHALL BE FABRICATED FROM 0.306" DIAMETER WIRE SHALL BE MINIMUM WITH A SUITABLE HOOK. STAKING PINS SHALL HAVE A MINIMUM LENGTH OF 12" FOR DOWEL ASSEMBLIES UNLESS OTHERWISE DIRECTED BY THE ENGINEER.
- 8. MINOR VARIATIONS IN THE CONFIGURATION OF THE SUPPORT UNITS WILL BE ALLOWED.



, Q DOWEL

Q JOINT 1/8"- 1/4" WIDE

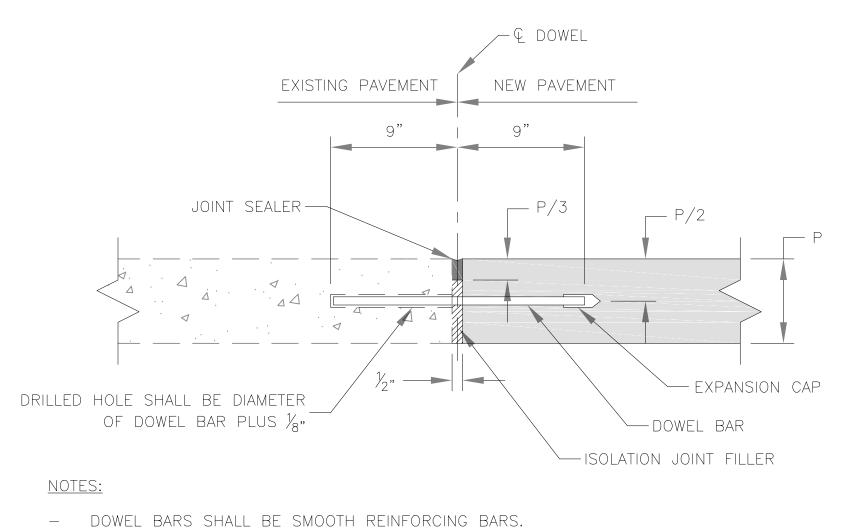___ P/3



- DOWEL BARS SHALL BE BONDED INTO THE EXISTING PAVEMENT. - BONDING FOR DOWEL BARS SHALL BE EPOXY OR POLYESTER BONDING AGENTS. - THE PORTION OF THE DOWEL OUTSIDE THE HOLE SHALL BE COATED WITH AN APPROVED LUBRICANT. TRANSVERSE ISOLATION JOINT

TABLE

DOWEL SPACING

N/A

12" CTRS.

12" CTRS.

12" CTRS.

- THE FINAL POSITION OF ALL DOWELS AND TIE BARS SHALL BE

- ALL DOWELS & TIE BARS SHALL BE EPOXY COATED.

- DOWEL BASKET SHIPPING WIRE SHALL NOT BE CUT.

CL JOINT

1/8/" -1/4" WIDE

WEEKS BEFORE PAVING OPERATIONS.

SURFACE OF THE PAVEMENT AND PARALLEL TO EACH OTHER.

- PANEL LENGTH TO WIDTH RATIO SHALL NOT EXCEED 1.25 TO 1.

PERPENDICULAR TO THE PLANE OF THE JOINT AND PARALLEL TO THE

DOWEL BARS SHALL BE PLACED AT 9 INCHES FROM LONGITUDINAL JOINTS.
 TIE BARS SHALL BE PLACED AT 12 INCHES FROM TRANSVERSE JOINTS.

- CONTRACTOR SHALL SUBMIT PROJECT SPECIFIC JOINTING PLAN AT LEAST TWO

IN ACCORDANCE WITH 2208.4.D, ALL JOINTS SHALL BE SEALED, INCLUDING

DUMMY CONTRACTION JOINT

TIE BAR

SPACING

30" CTRS.

30" CTRS.

30" CTRS.

30" CTRS.

TIE BAR SIZE

#5 × 30"

#5 × 30"

DOWEL

SIZE

N/A

1" x 18"

1 ¼" × 18"

GENERAL NOTES:

1 ½" × 18" #5 × 30"

CUPB & GUTTER

THICKNESS (P)

MAX. TRAN. | MAX. LONG.

SPACING

12'

14'

14'

15'

- PROPOSED P.C.C. PAVEMENT

SPACING

STANDARD DETAILS
CITY OF LEE'S SUMMIT, MO
S SUMMIT, JACKSON COUNTY, N

TYPICAL PAVEMENT JOINT DETAILS

Drawn By: MJF Checked By: GMB Date: 08/2023

GEN-10

| ERMINAL | 17932172

GENERAL A

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1627 MAIN STREET, #100

KANSAS CITY, MO 64108

BOLLINGER

LEE'S SUMMIT MUNICIPAL AIRPORT LEE'S SUMMIT, MO

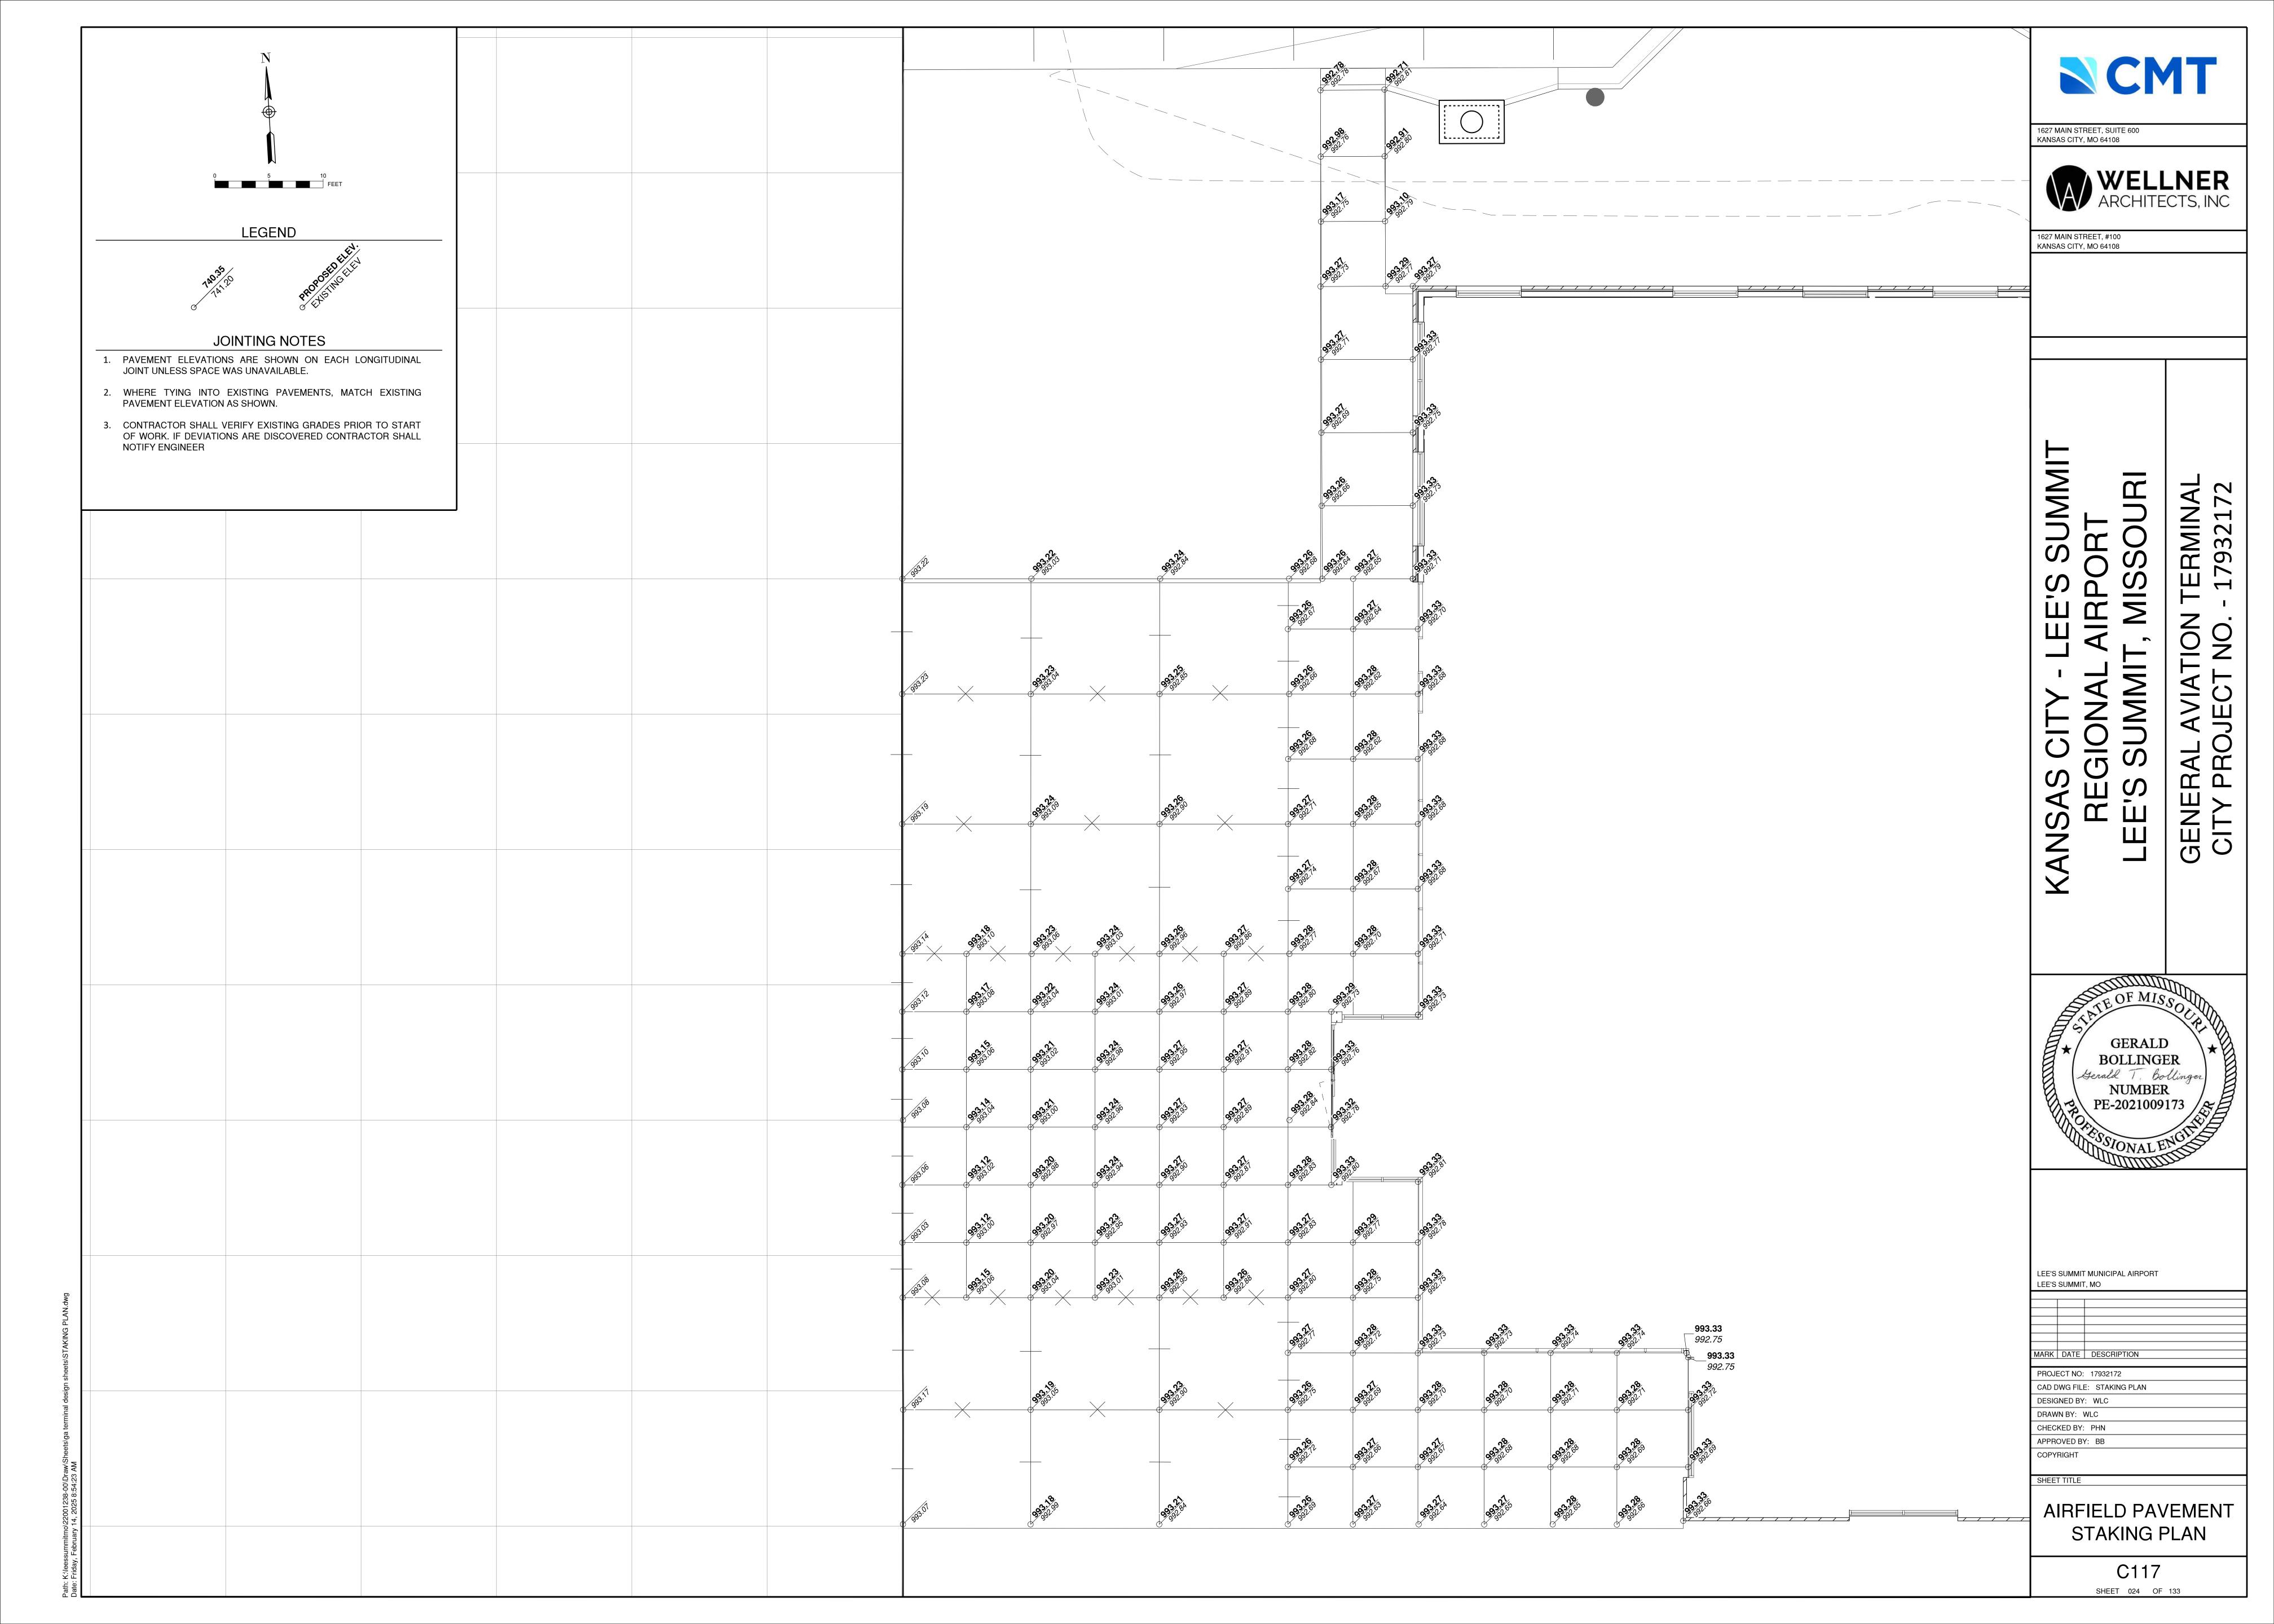
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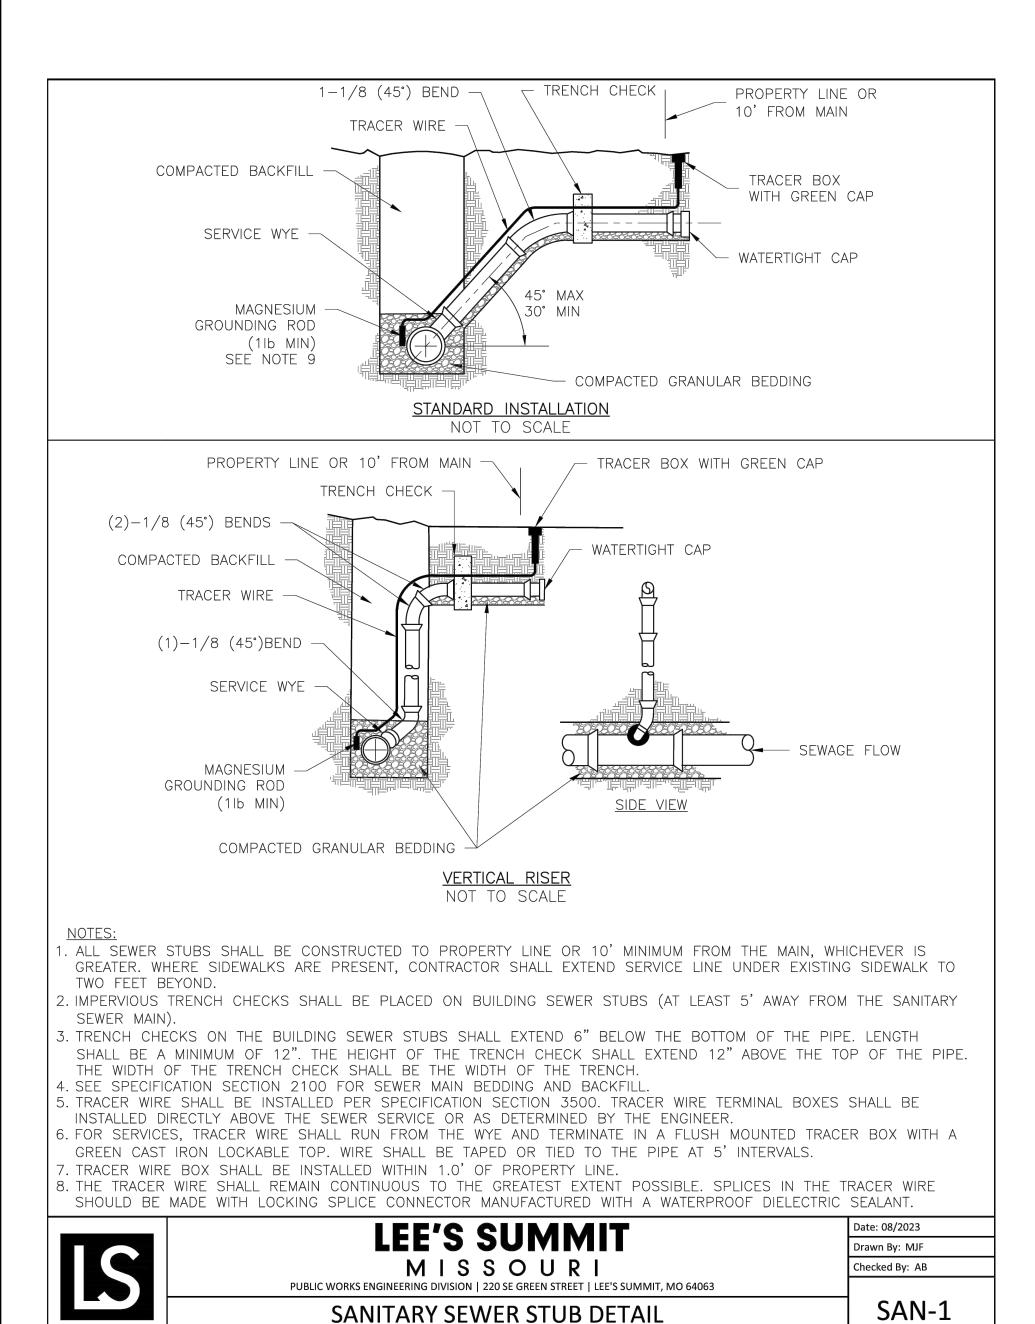
PROJECT NO: 17932172 CAD DWG FILE: JOINTING DETAILS DESIGNED BY: WLC DRAWN BY: WLC


CHECKED BY: PHN APPROVED BY: BB

PAVEMENT JOINTING DETAILS 3 OF 3
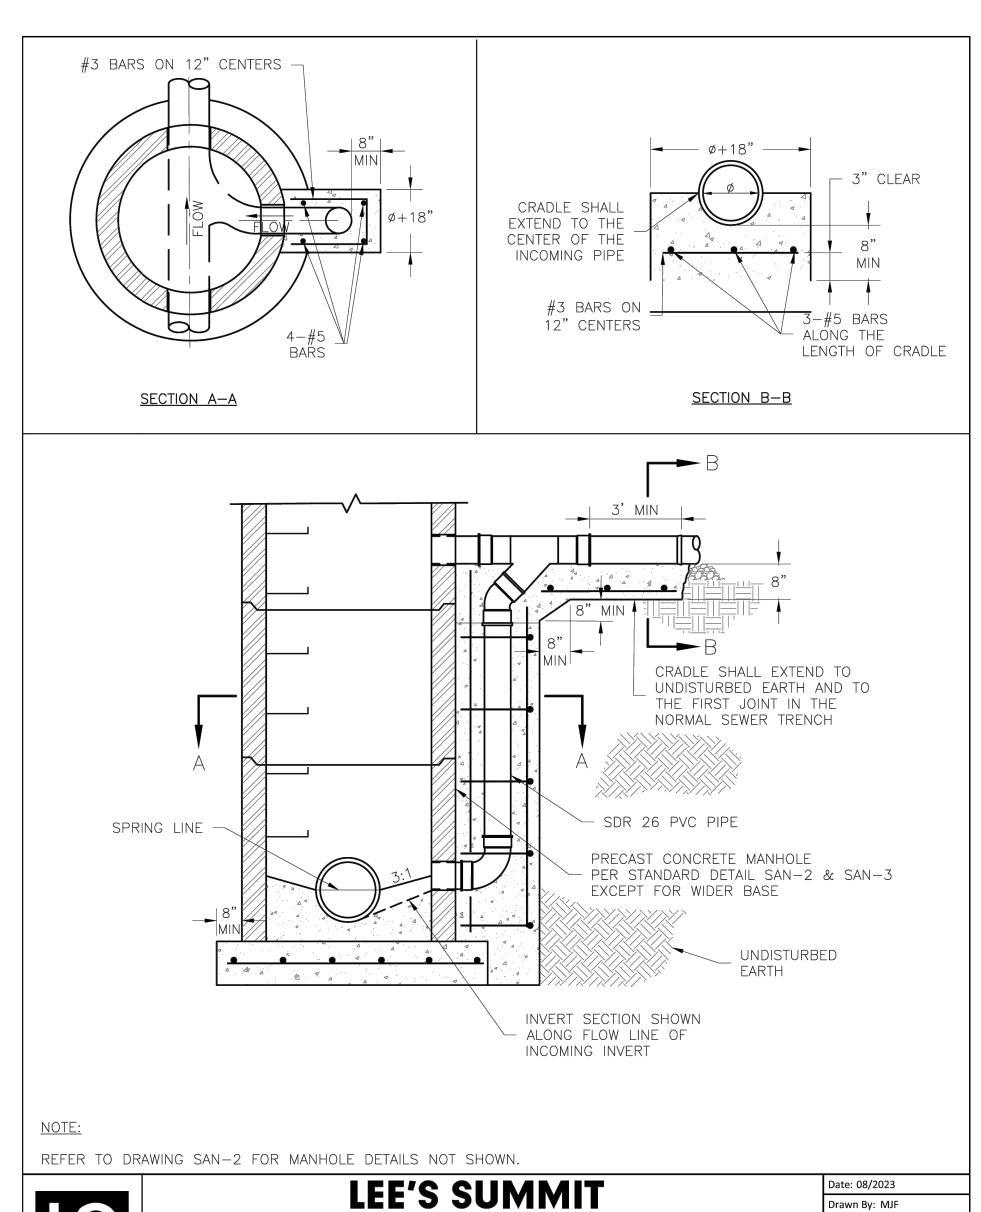
> C116 SHEET 023 OF 133







MISSOURI


PUBLIC WORKS ENGINEERING DIVISION | 220 SE GREEN STREET | LEE'S SUMMIT, MO 64063


STANDARD OUTSIDE DROP MANHOLE


Drawn By: MJF


Checked By: AB

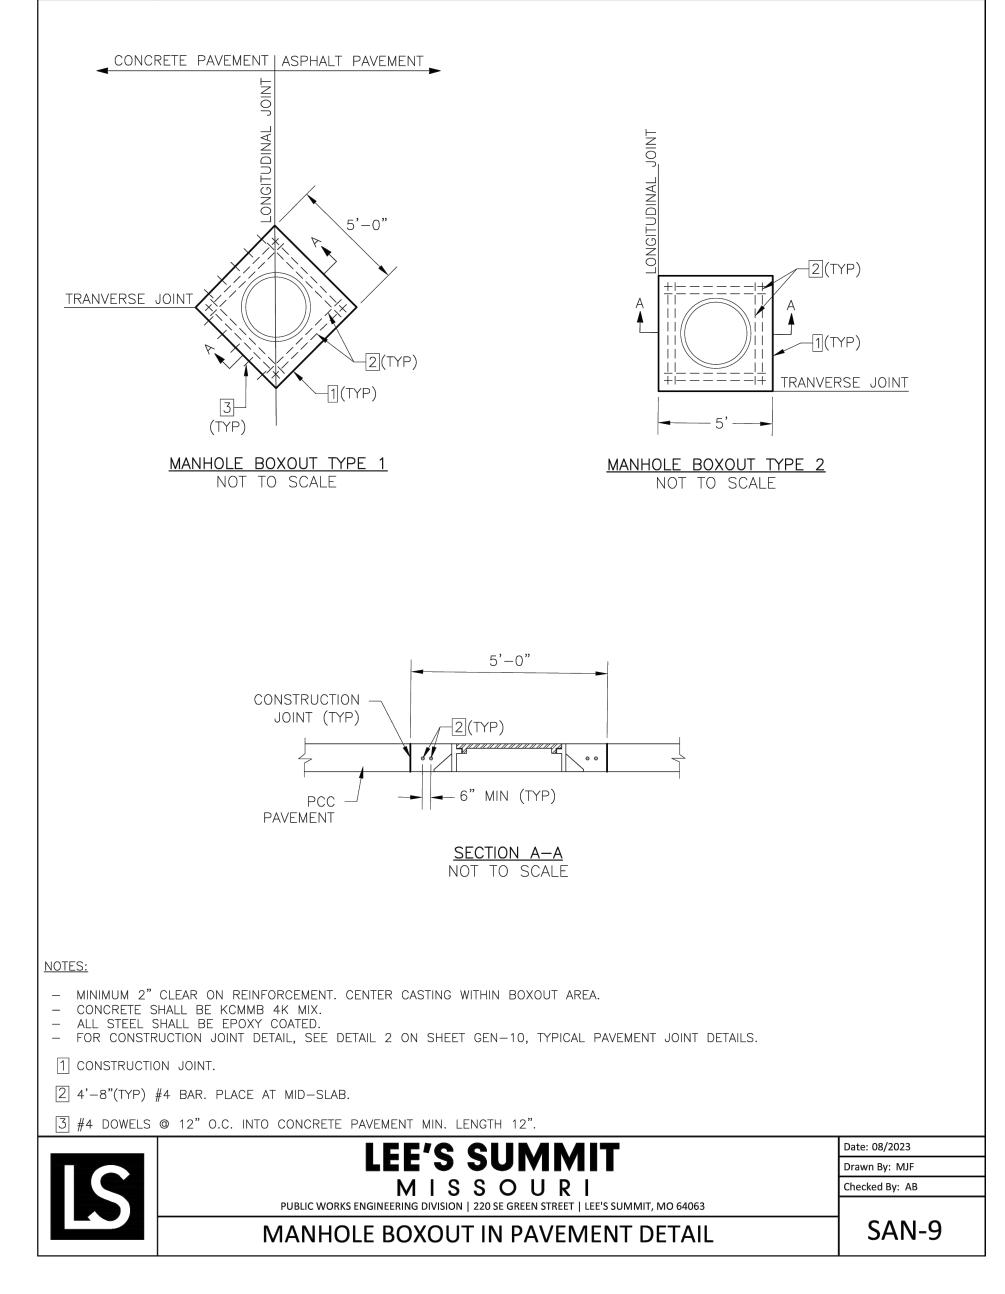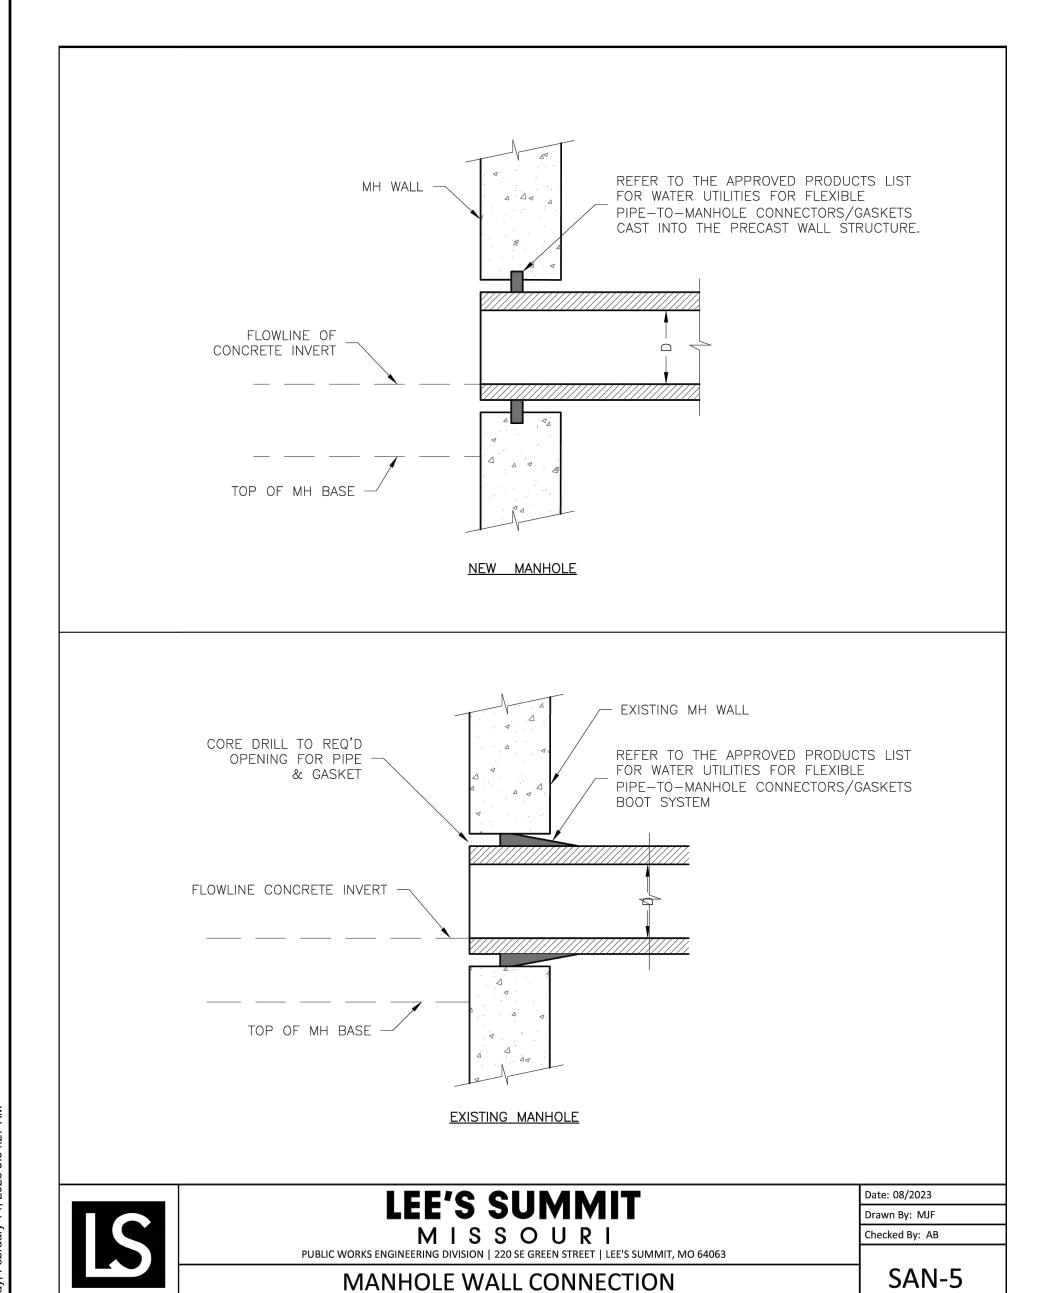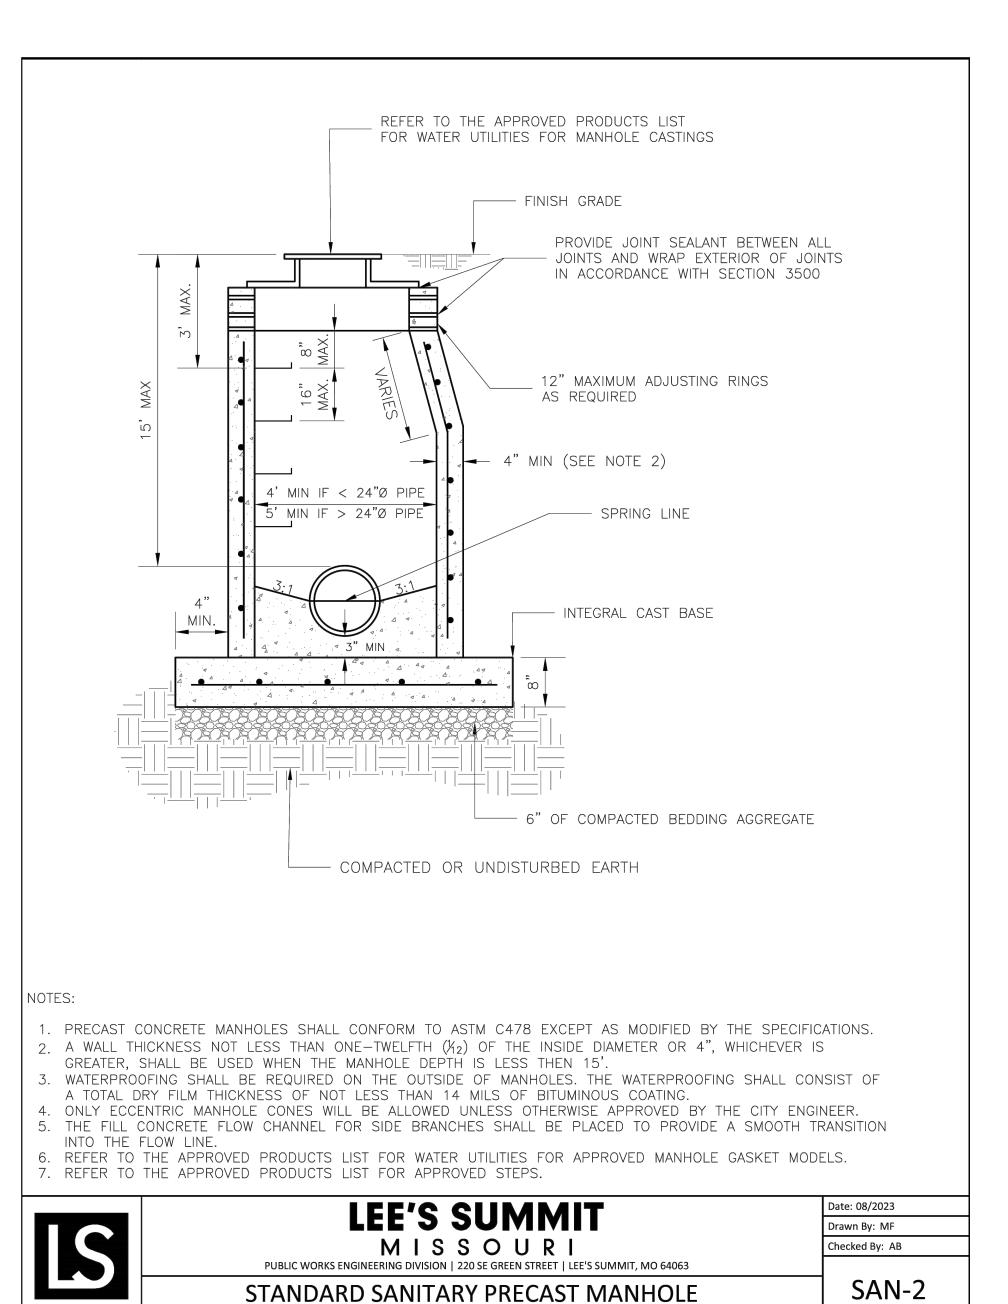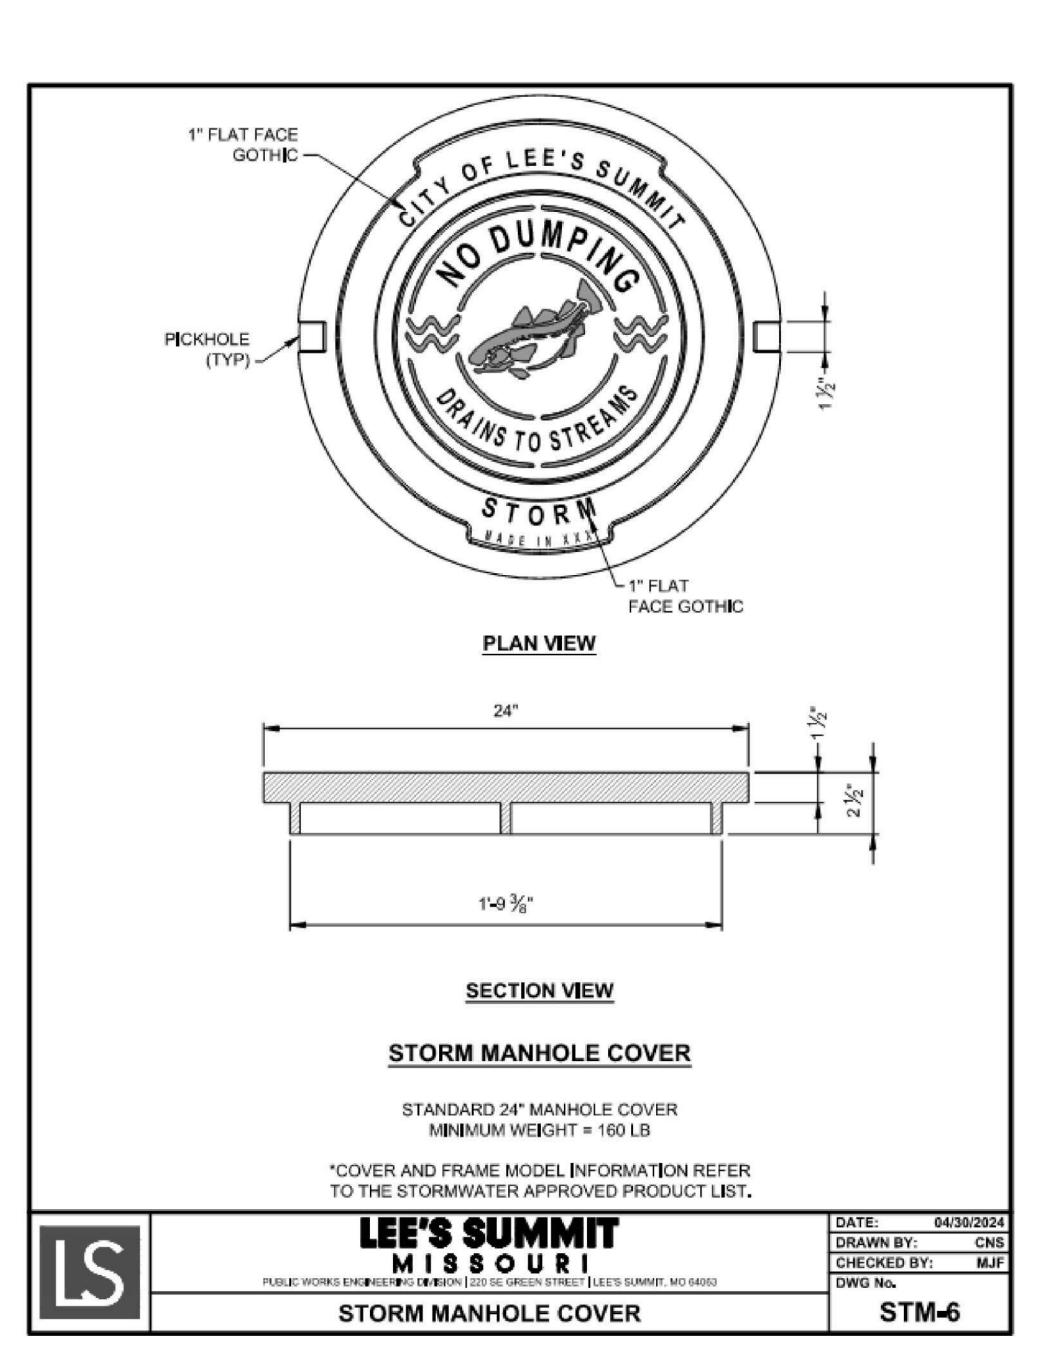SAN-4











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7

RMIN

LEE'S SUMMIT MUNICIPAL AIRPORT LEE'S SUMMIT, MO

MARK | DATE | DESCRIPTION PROJECT NO: 17932172 CAD DWG FILE: SAN-DETAILS-GA

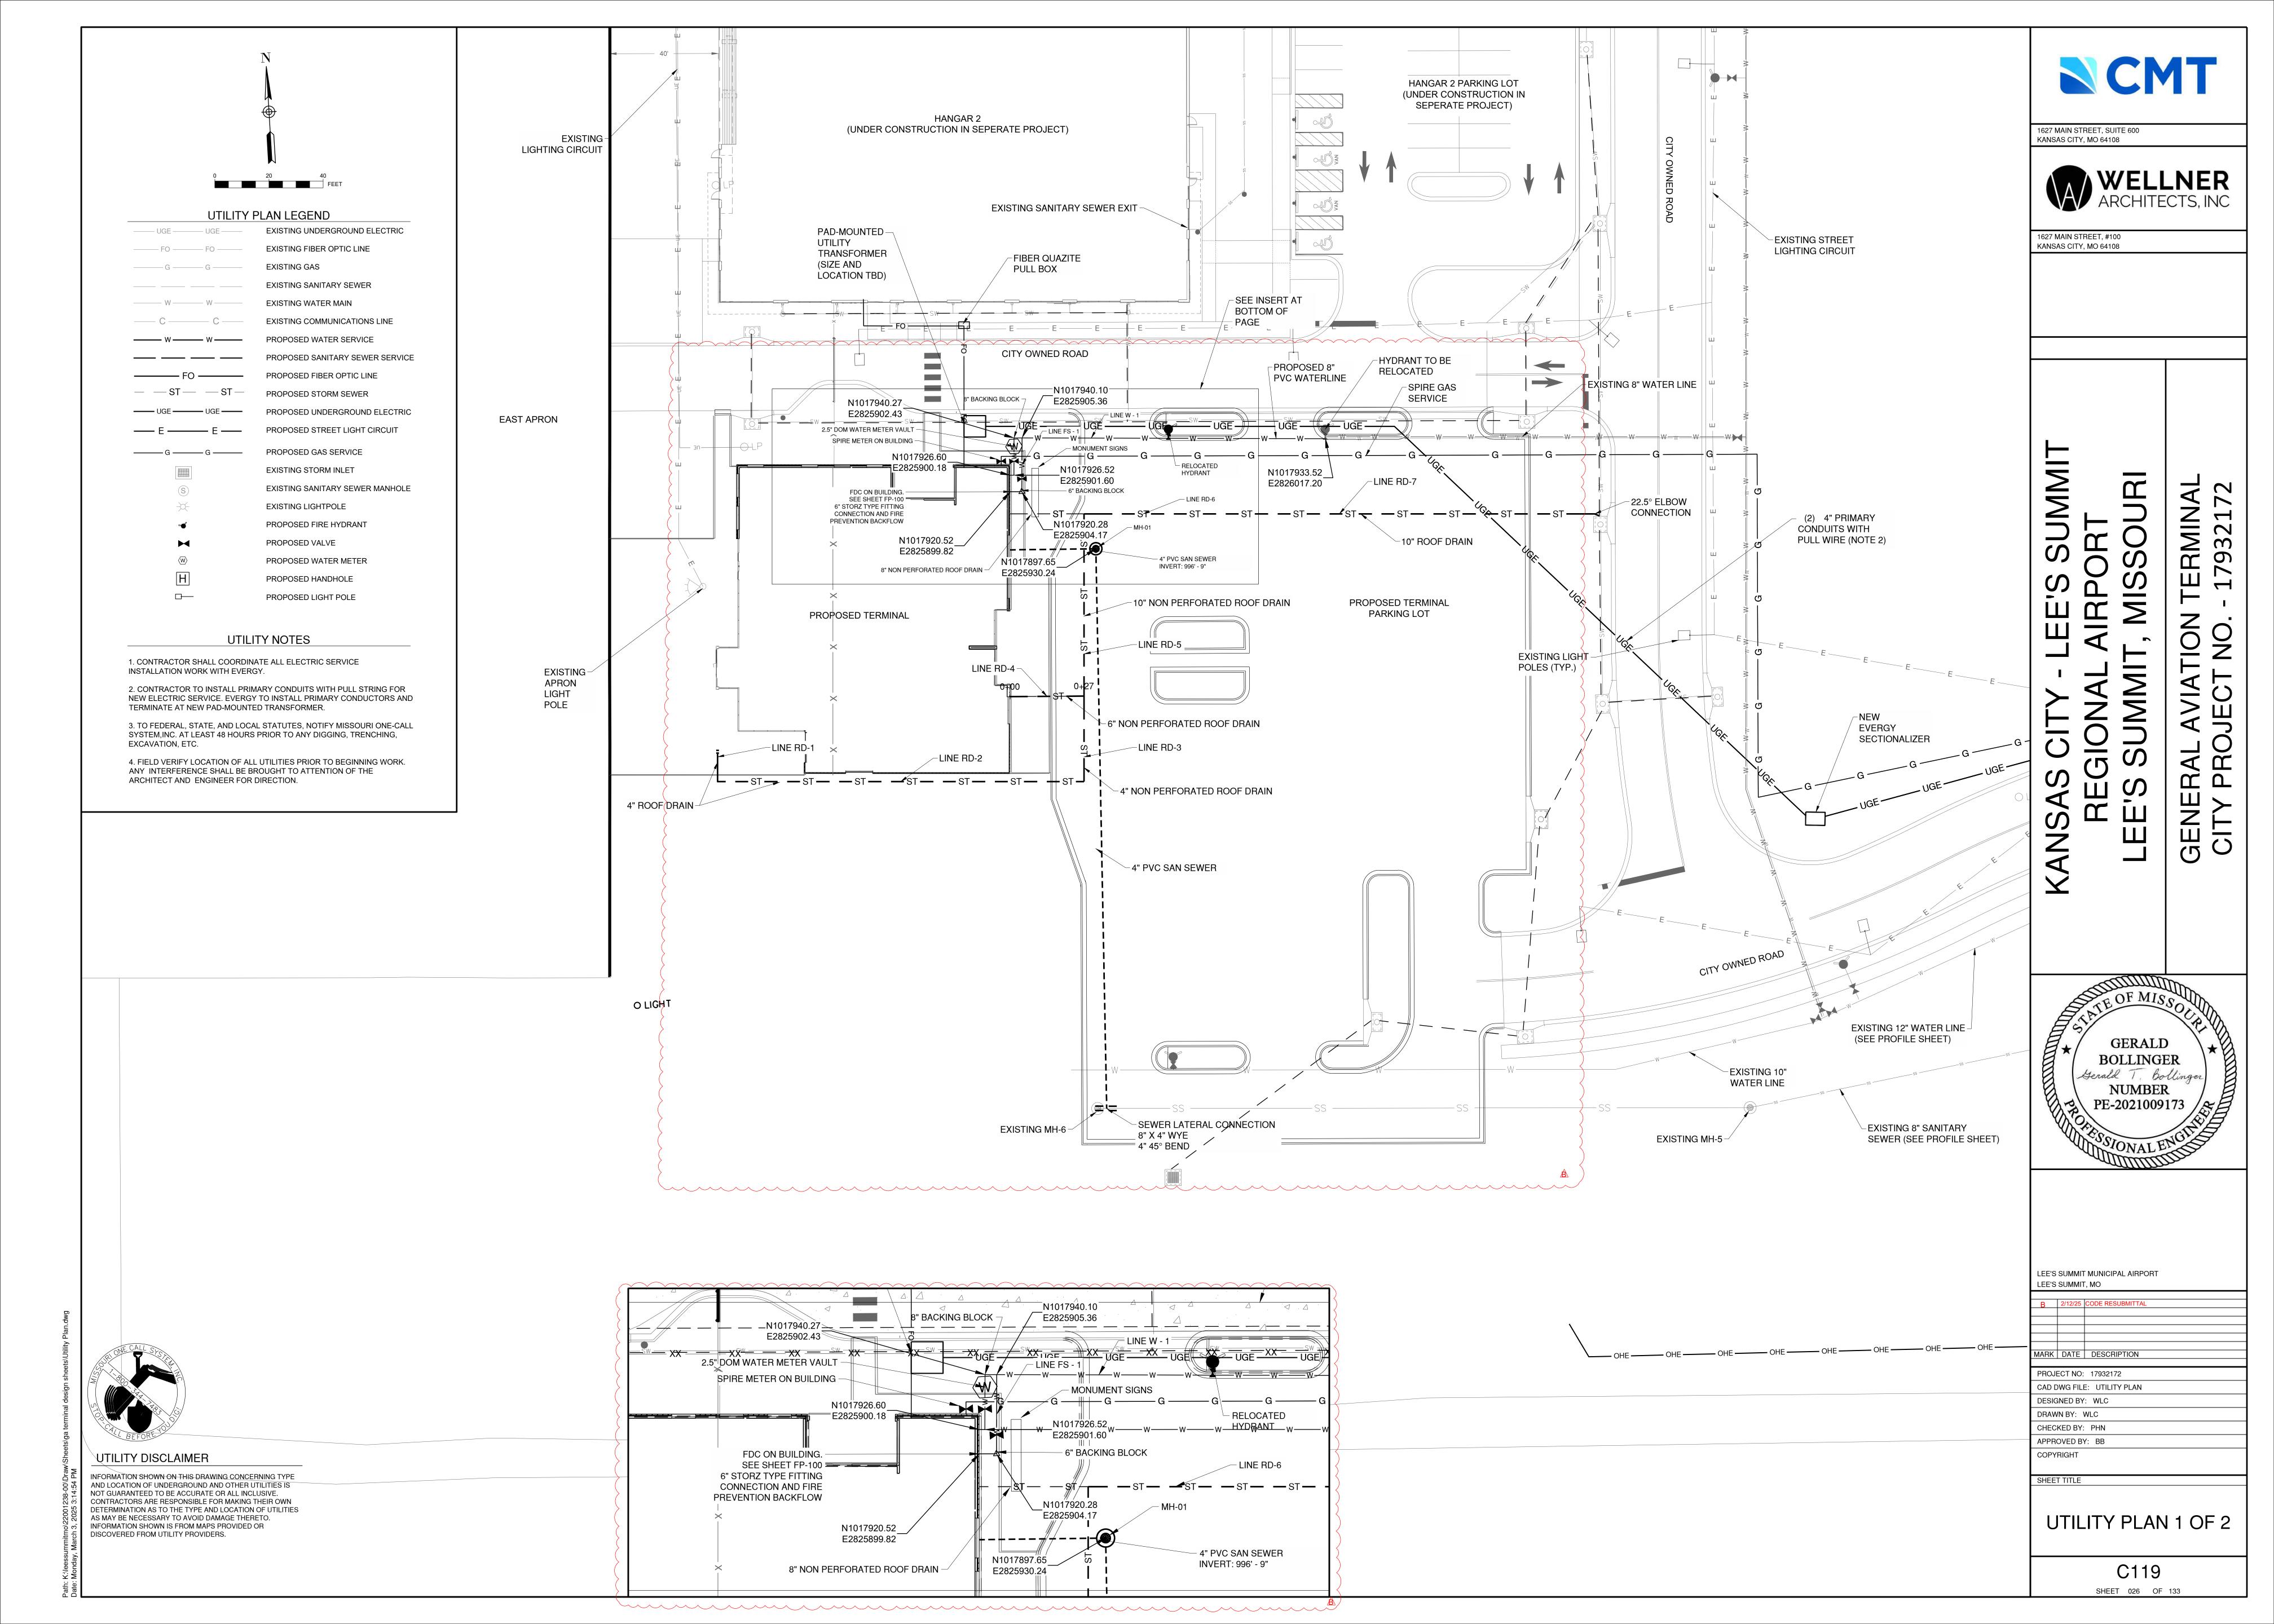
DESIGNED BY: WLC DRAWN BY: WLC CHECKED BY: PHN APPROVED BY: BB

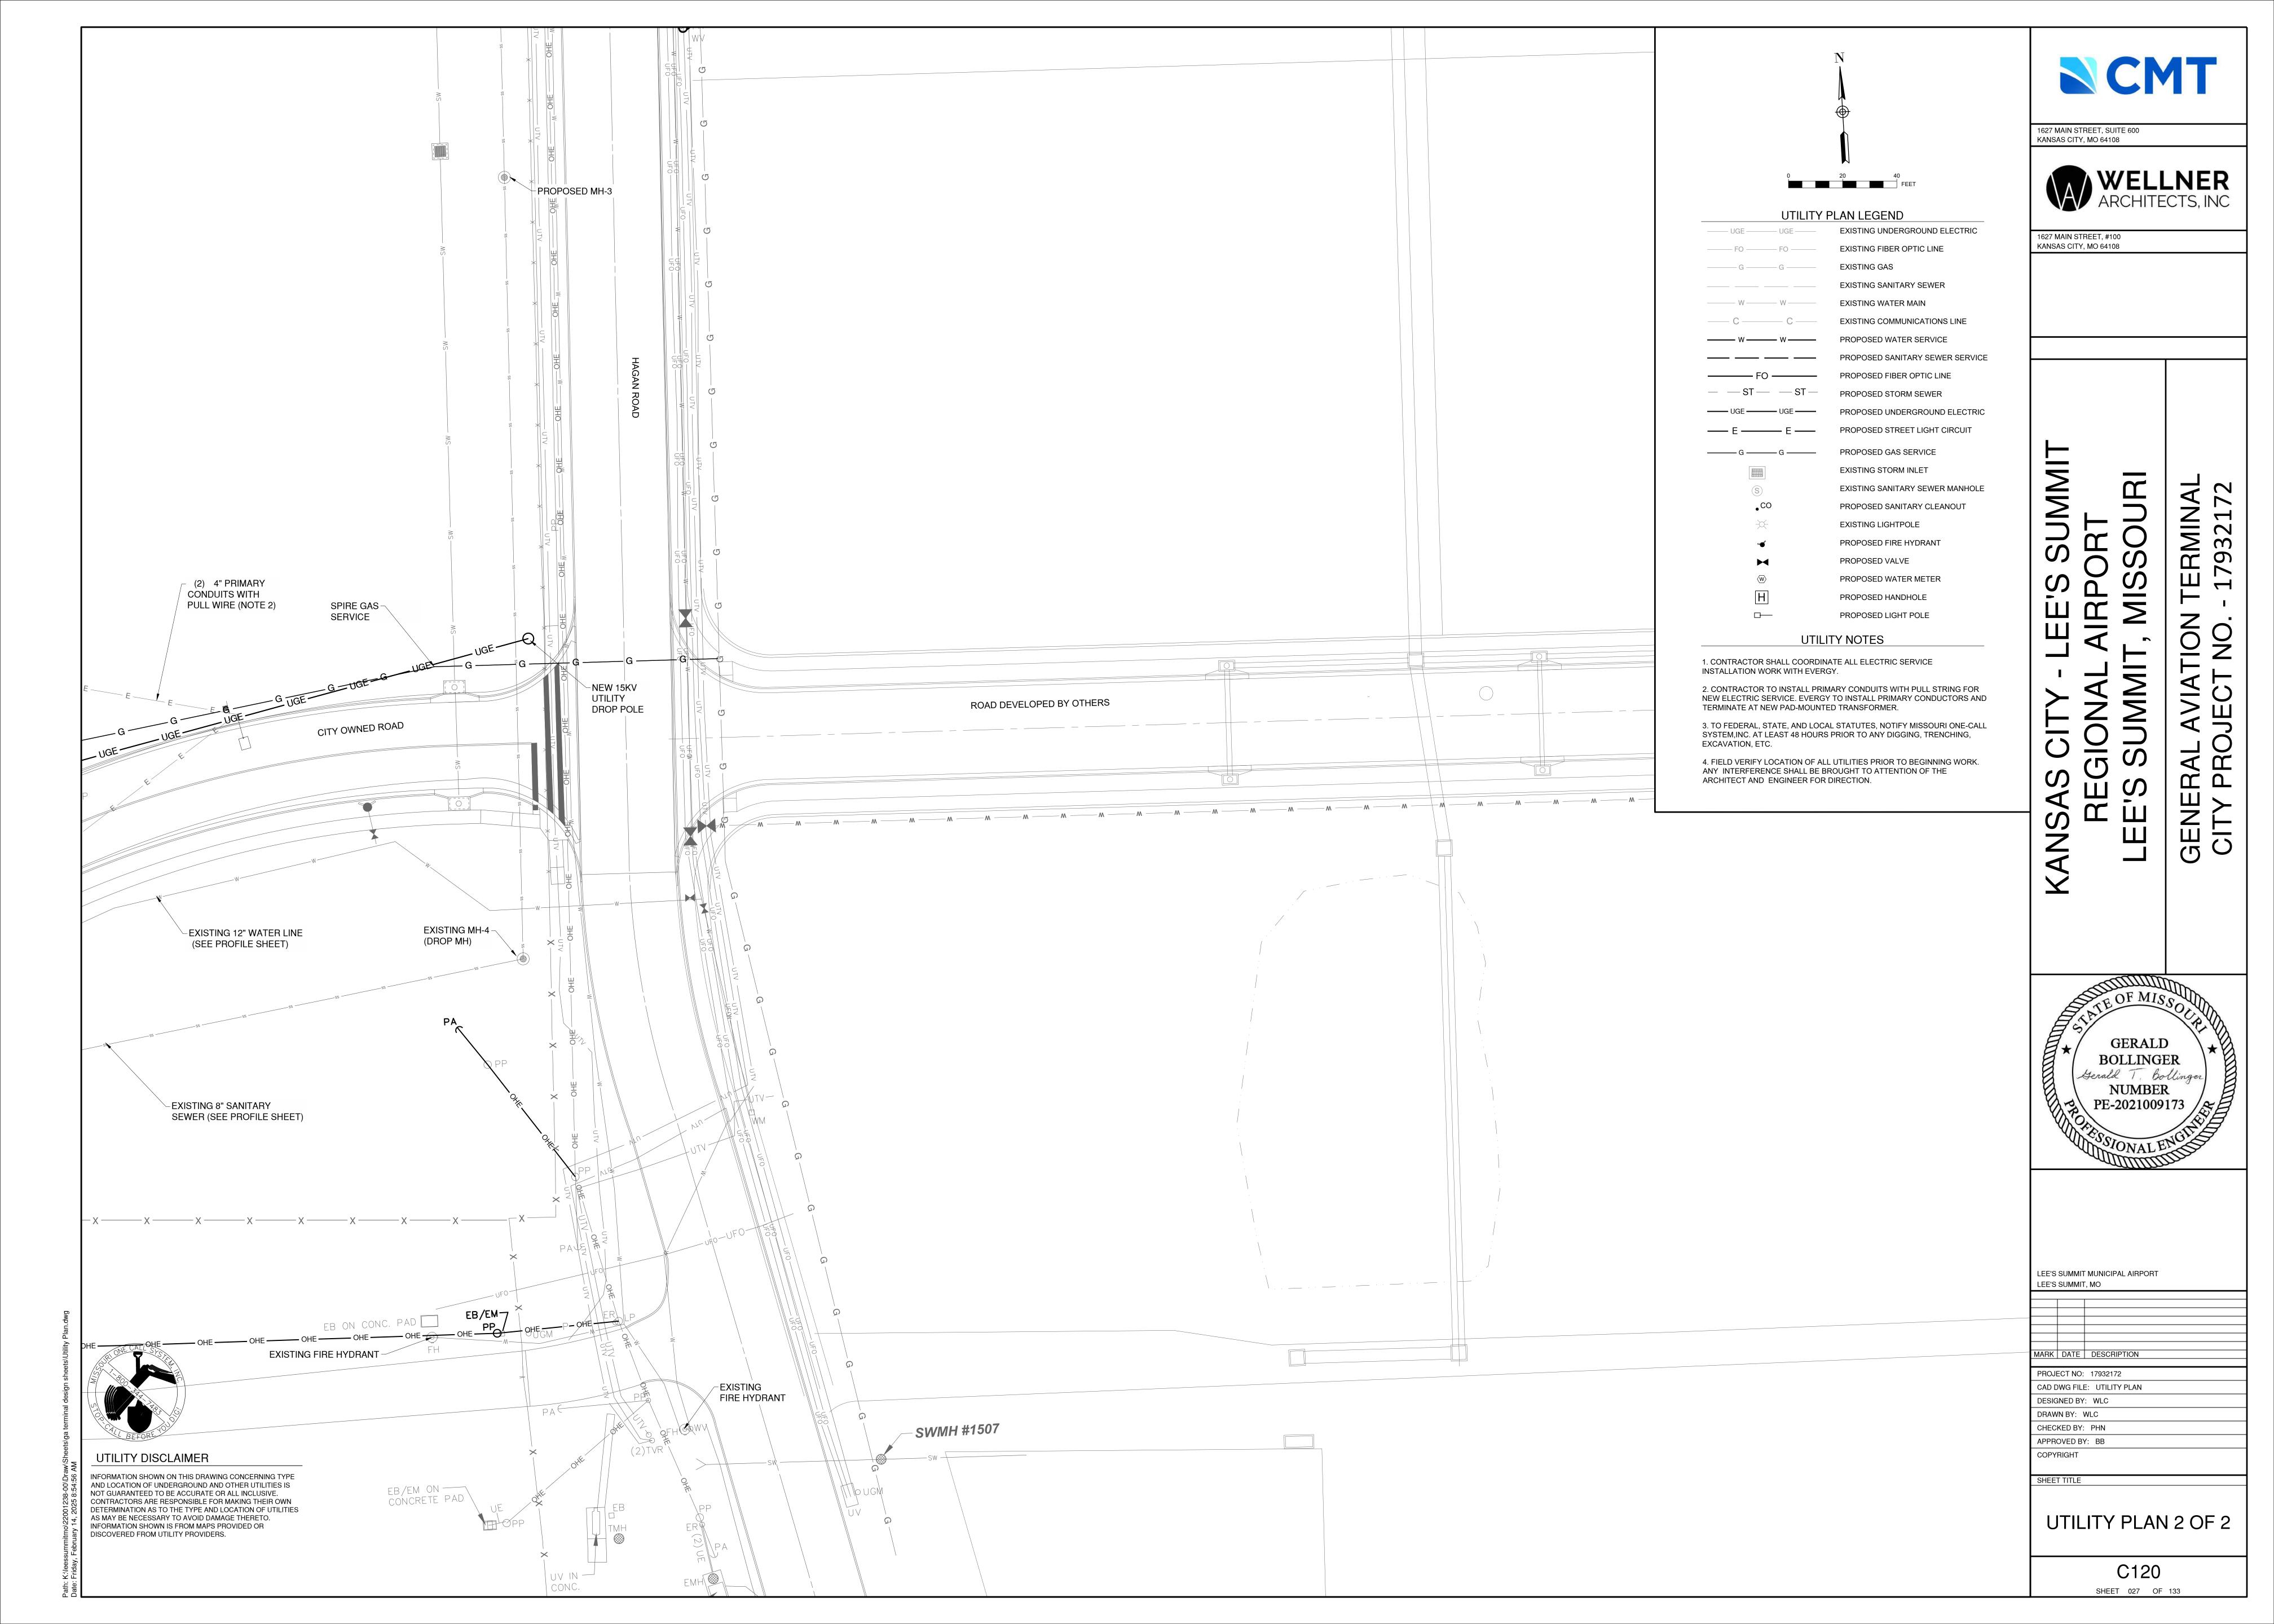
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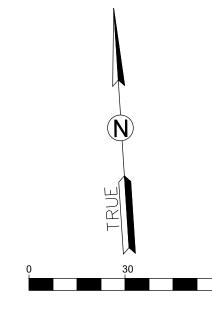
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SANITARY SEWER **DETAILS**

> C118 SHEET 025 OF 133











1627 MAIN STREET, #100 KANSAS CITY, MO 64108

SUMMIT

GENERAL /

KANSAS

LEE'S SUMMIT MUNICIPAL AIRPORT LEE'S SUMMIT, MO

MARK DATE DESCRIPTION

PROJECT NO: 17932172

CAD DWG FILE: UTILITY PROFILES - GA

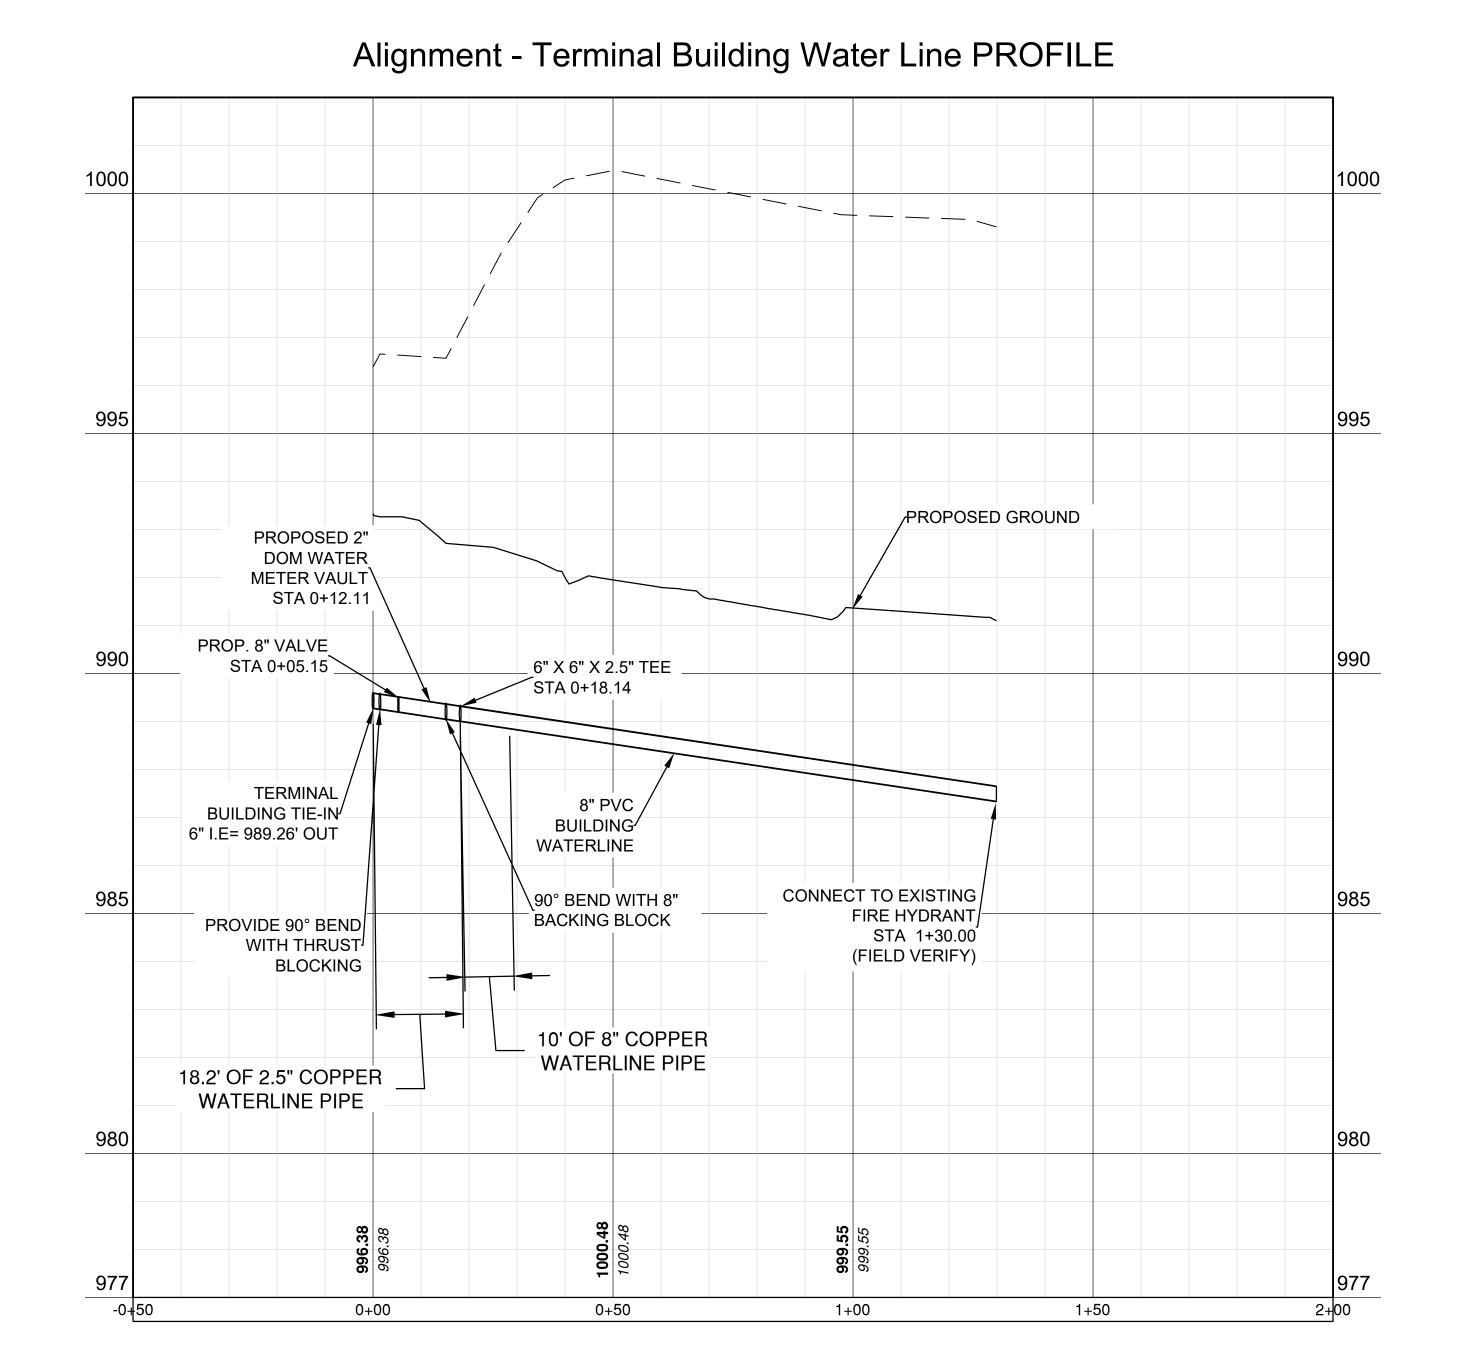
DESIGNED BY: WLC DRAWN BY: WLC

CHECKED BY: PHN APPROVED BY: BB


SHEET TITLE

UTILITY PROFILE 1 OF 3


> C121 SHEET ---- OF 133



LINE W - 1

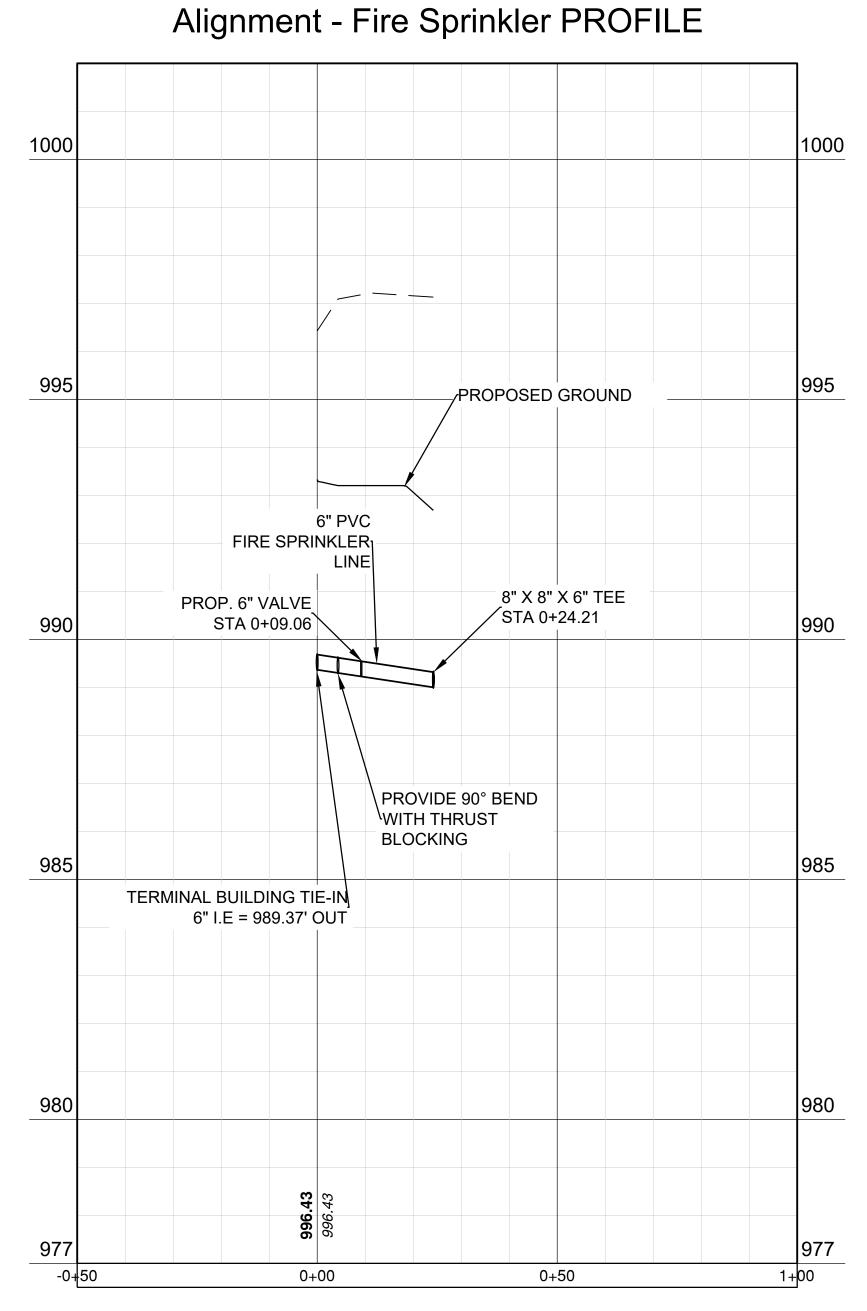

LINE FS - 1

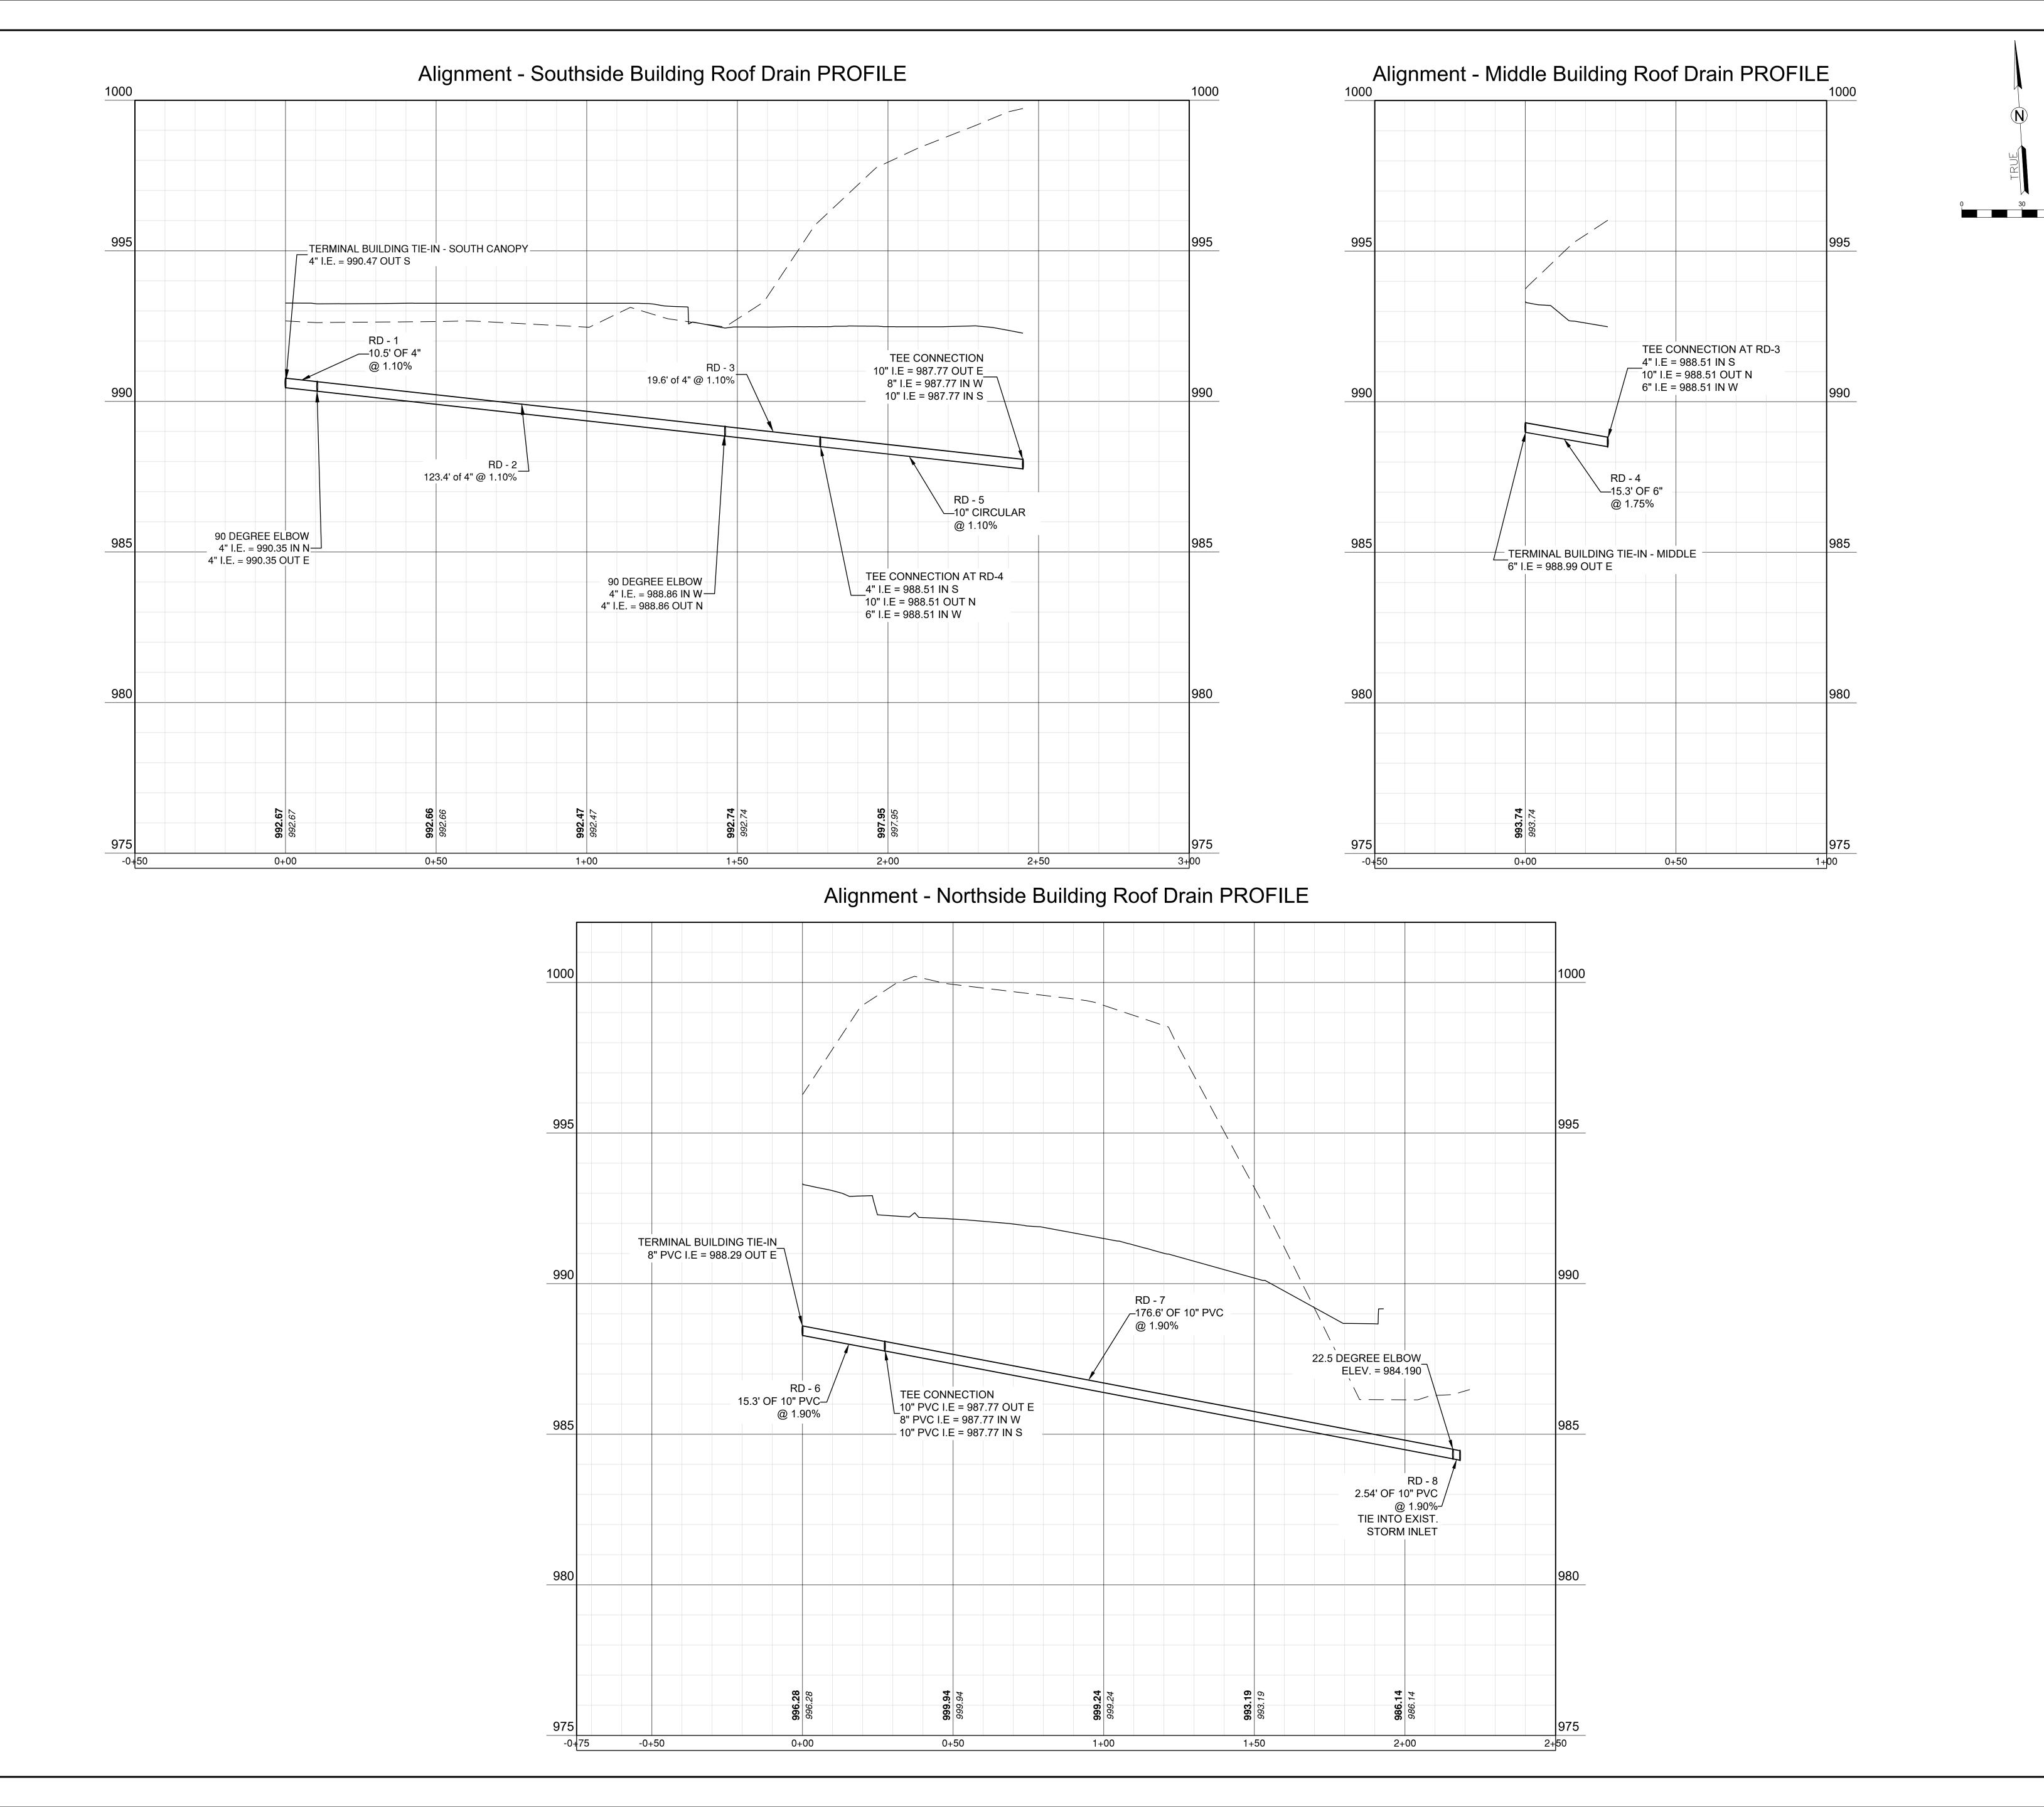

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S SUMMIT OORT

LEE'S SUMMIT, MISSOURI GENERAL AVIATION TERMINAL CITY PROJECT NO. - 17932172

GERALD
BOLLINGER
Serall T. Bollinger
NUMBER
PE-2021009173

LEE'S SUMMIT MUNICIPAL AIRPORT LEE'S SUMMIT, MO

MADIC DATE DESCRIPTION

MARK DATE DESCRIPTION
PROJECT NO: 17932172

PROJECT NO: 17932172

CAD DWG FILE: UTILITY PROFILES - GA

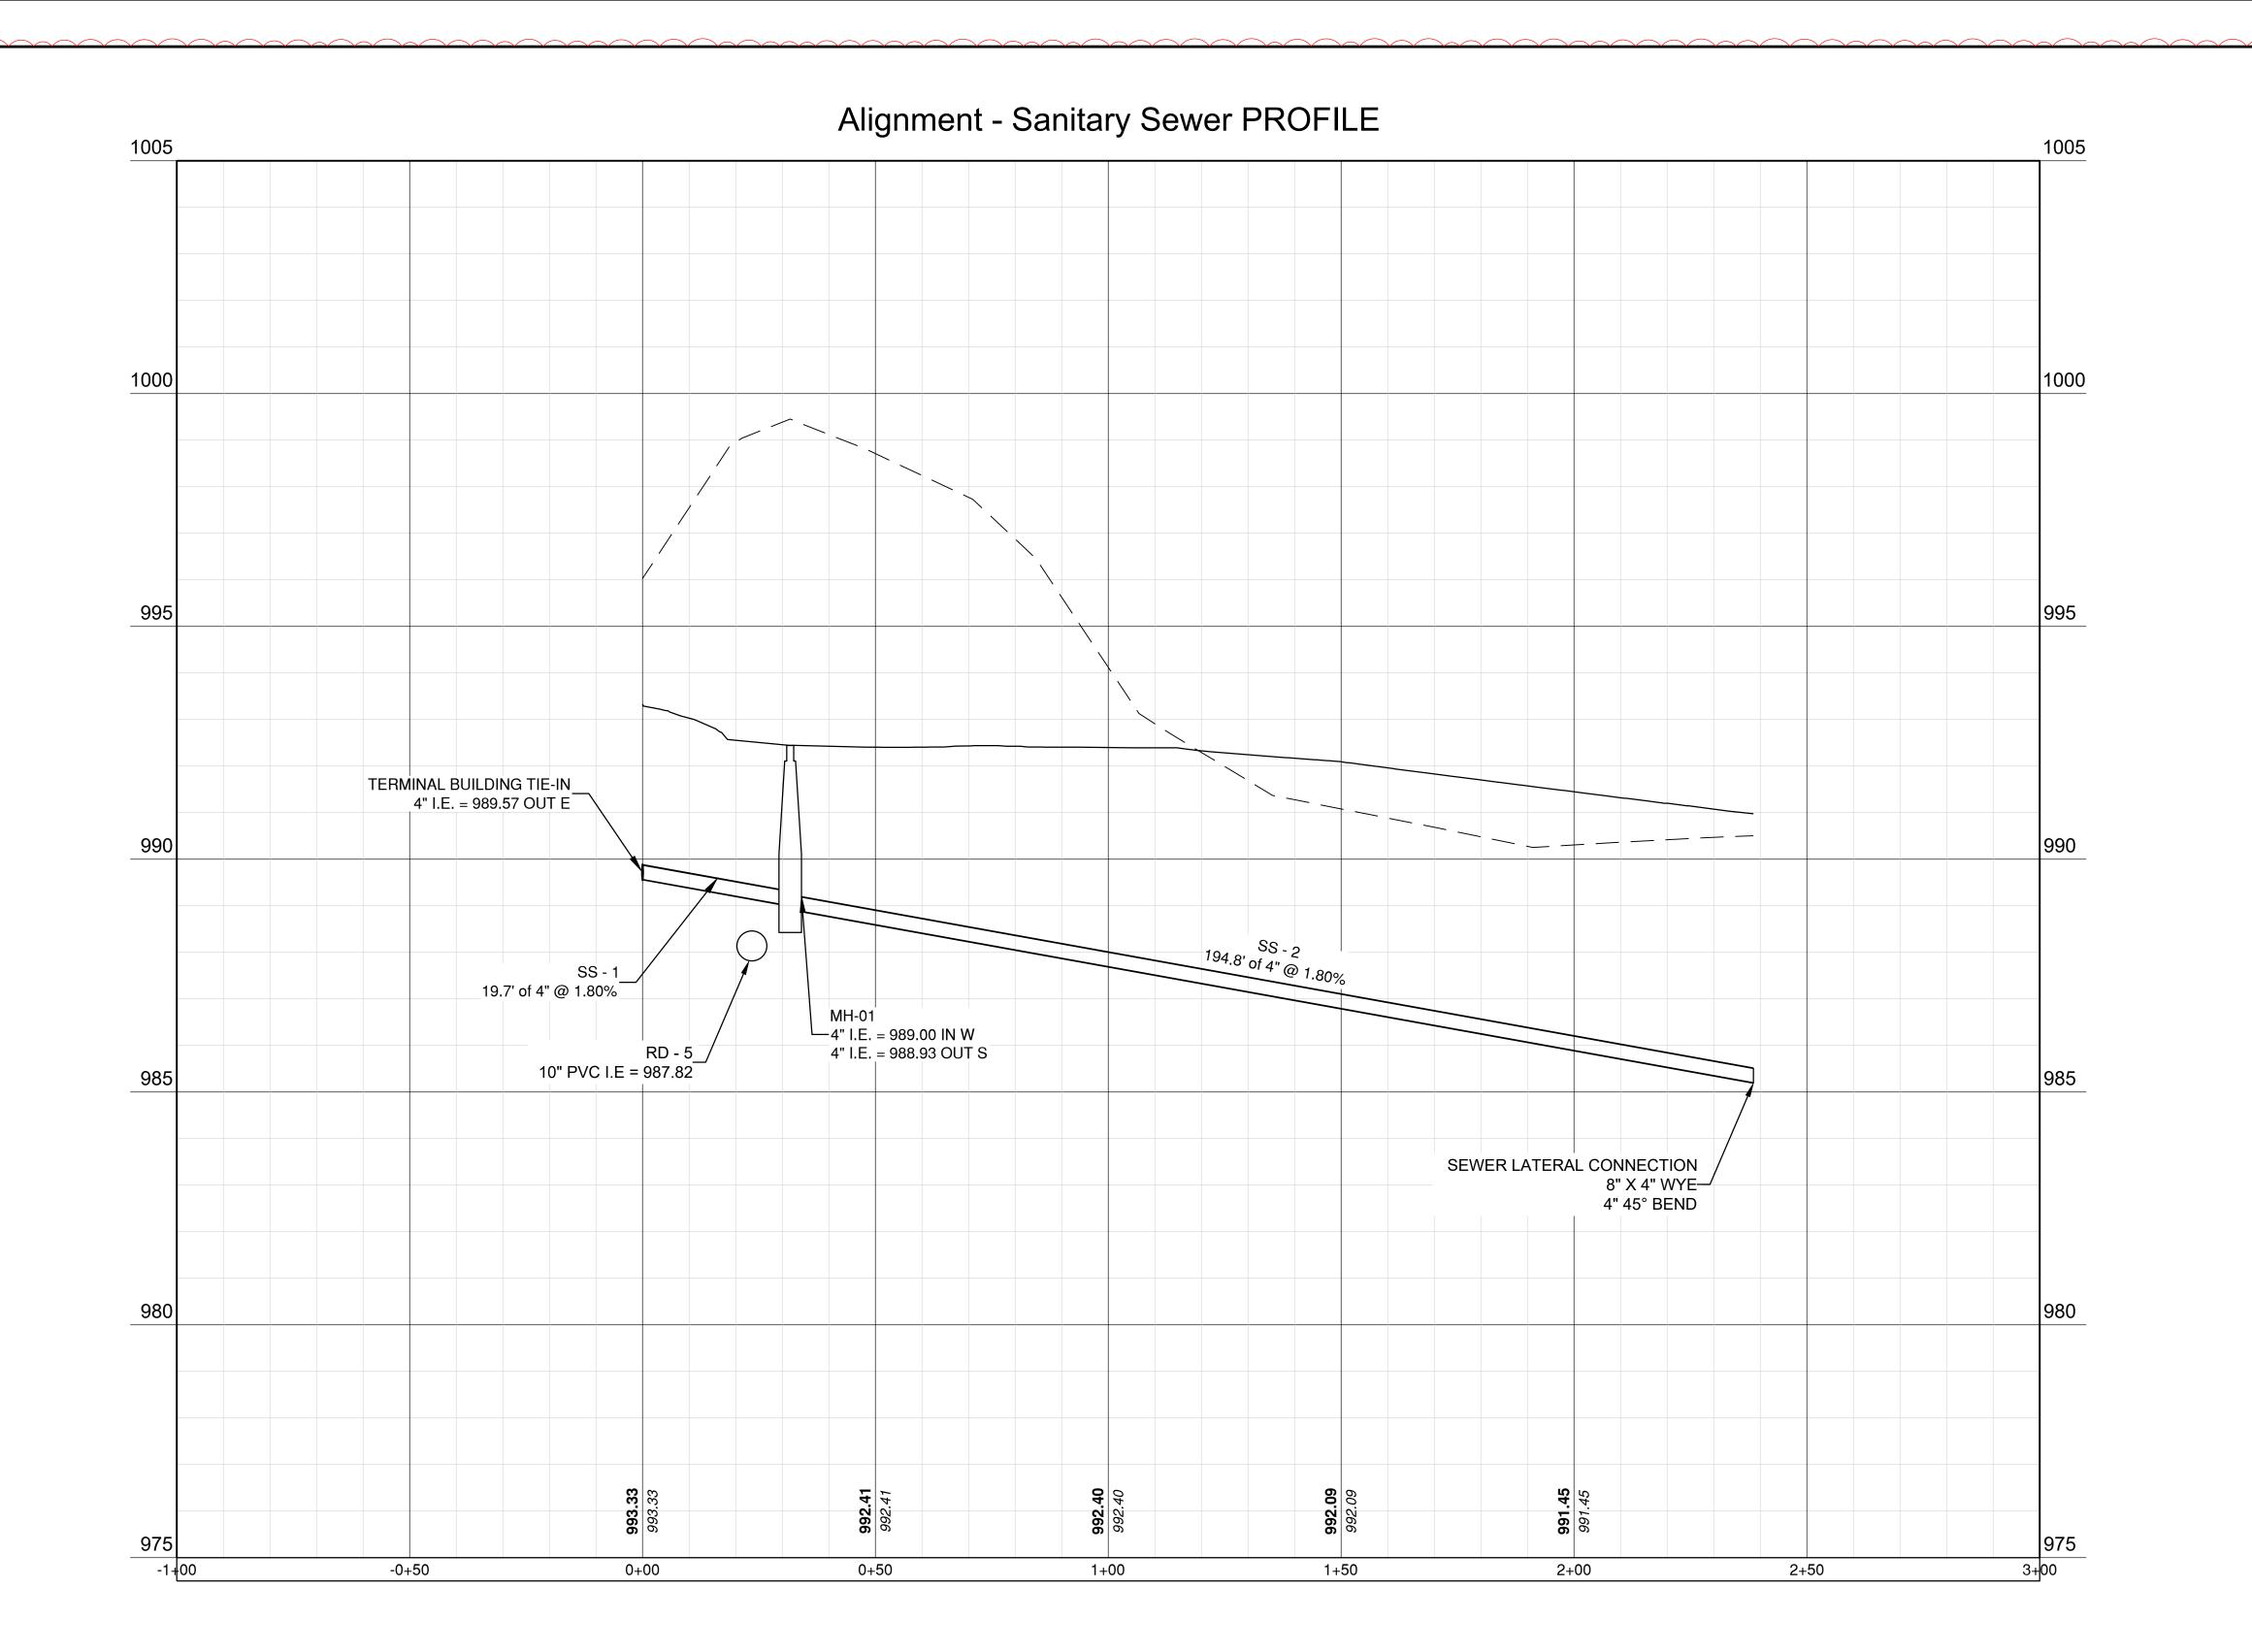
DESIGNED BY: WLC

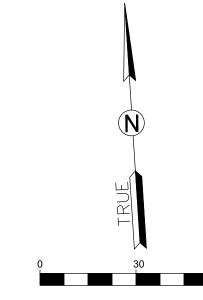
DRAWN BY: WLC
CHECKED BY: PHN
APPROVED BY: BB

SHEET TITLE

UTILITY PROFILE 2 OF 3

C122









1627 MAIN STREET, #100 KANSAS CITY, MO 64108

KANSAS

TERMINAL - 17932172

LEE'S SUMMIT MUNICIPAL AIRPORT LEE'S SUMMIT, MO

MARK DATE DESCRIPTION

PROJECT NO: 17932172

CAD DWG FILE: UTILITY PROFILES - GA

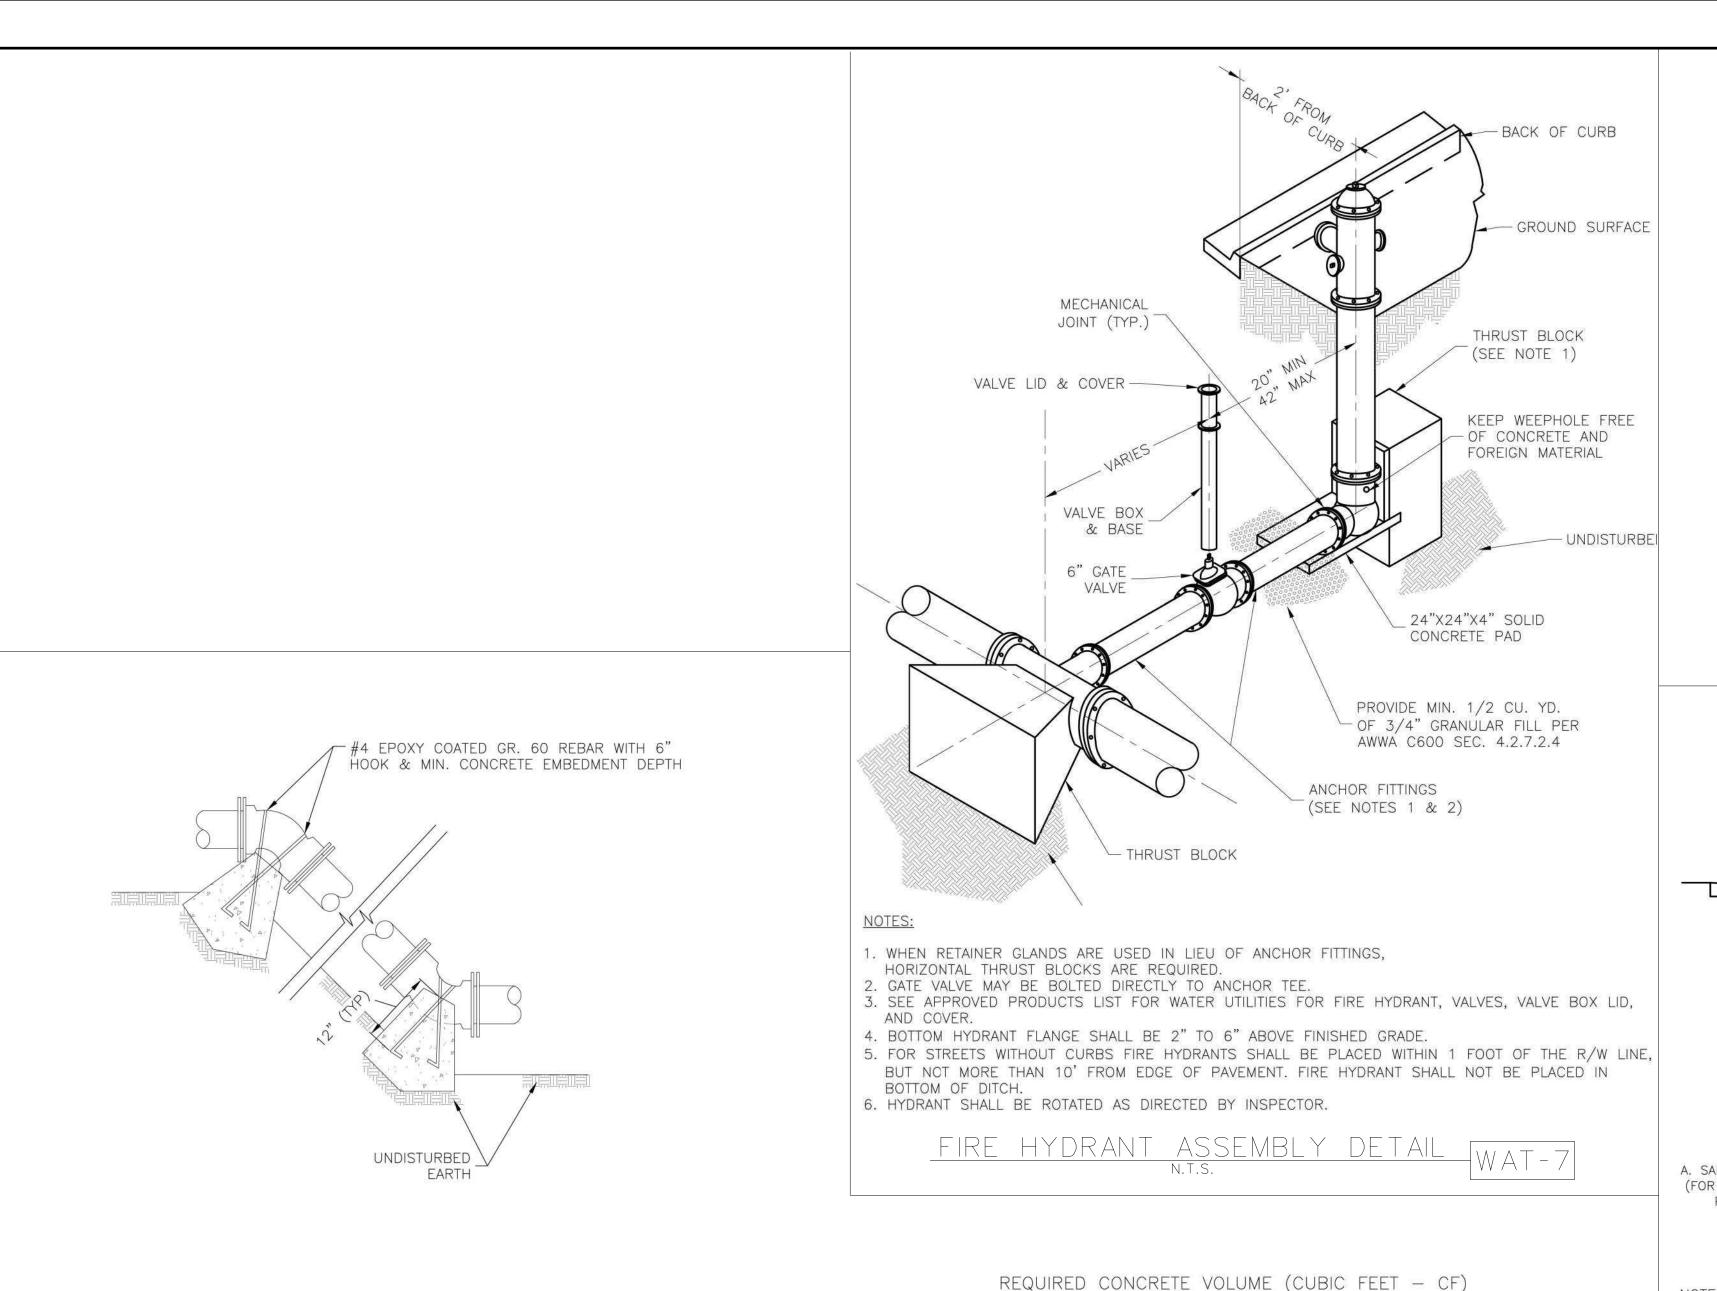
DESIGNED BY: WLC DRAWN BY: WLC

CHECKED BY: PHN APPROVED BY: BB

SHEET TITLE

UTILITY PROFILE 3 OF 3

> C123 SHEET ---- OF 133



NOM DIA	100	0.0	1.5	00.5	44.05
NOM. DIA.	180	90	45	22.5	11.25
(INCHES)	TEE, PLUG	BEND	BEND	BEND	BEND
6	50.5	71.4	38.6	19.7	9.9
8	89.8	126.9	68.7	35.0	17.6
10	140.2	198.3	107.3	54.7	27.5
12	202.0	REST. JT.	154.6	78.8	39.6
14	REST. JT.	REST. JT.	210.4	107.3	53.9
16	REST. JT.	REST. JT.	REST. JT.	140.1	70.4
18	REST. JT.	REST. JT.	REST. JT.	177.3	89.1
20	REST. JT.	REST. JT.	REST. JT.	REST. JT.	110.0
24	REST. JT.	REST. JT.	REST. JT.	REST. JT.	158.4

VERTICAL THRUST BLOCK WAT-2

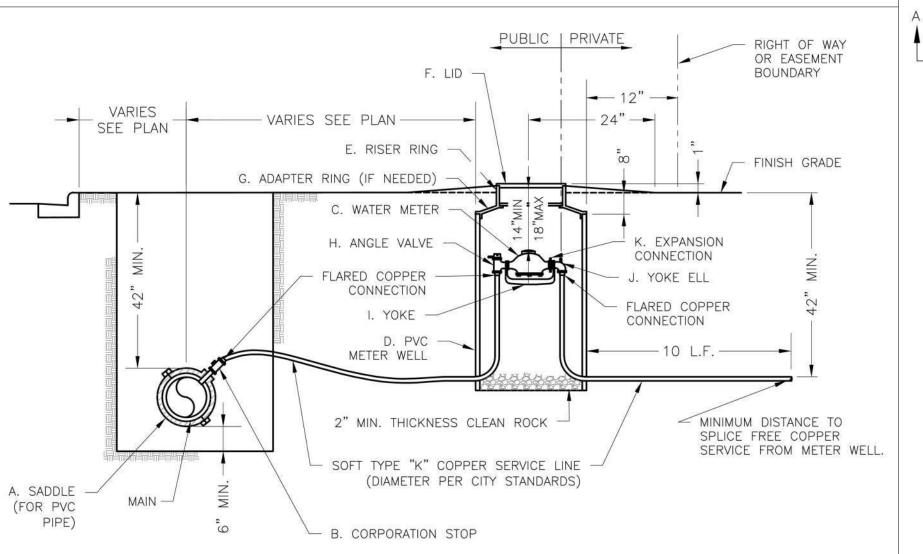
1. ALL BENDS WITHOUT RESTRAINED JOINTS SHALL HAVE CONCRETE THRUST BLOCKS INSTALLED FOR RESTRAINT.

2. MEGA LUGS MAY BE USED ONLY IN CONJUNCTION WITH CONCRETE THRUST BLOCKING.

4. DO NOT COVER JOINTS OR BOLTS (WHERE APPLICABLE) WITH CONCRETE.

POURED CONCRETE BLOCKS (TYP.)


3. BEARING MUST BE AGAINST UNDISTURBED SOIL.



NOTES:


- 1. METER INSTALLATION SHALL NOT BE LOCATED IN AREAS SUBJECT TO VEHICULAR TRAFFIC OR IN CONCRETE PAVEMENT WITHOUT CITY APPROVAL.
- 2. IF METER IS TO BE LOCATED OTHER THAN IN FRONT OF PROPERTY LINE, CITY APPROVAL SHALL BE OBTAINED. 3. CITY TO FURNISH ITEMS A-K.
- 4. NO OTHER EQUIPMENT SHALL BE INSTALLED IN THIS PIT. 5. 42" MINIMUM BURY DEPTH FOR ALL SERVICE LINES.
- 6. EXCAVATION FOR TAP TO EXPOSE 4 LINEAR FEET OF MAIN. 7. NO SPLICES ALLOWED BETWEEN METER AND MAIN.
- 8. SERVICE CONNECTION TAP AT APPROXIMATELY 45 DEGREES. 9 LID AND RISER RING SHALL BE SET SO THAT GROUND WATER WILL DRAIN AWAY FROM THE WELL.

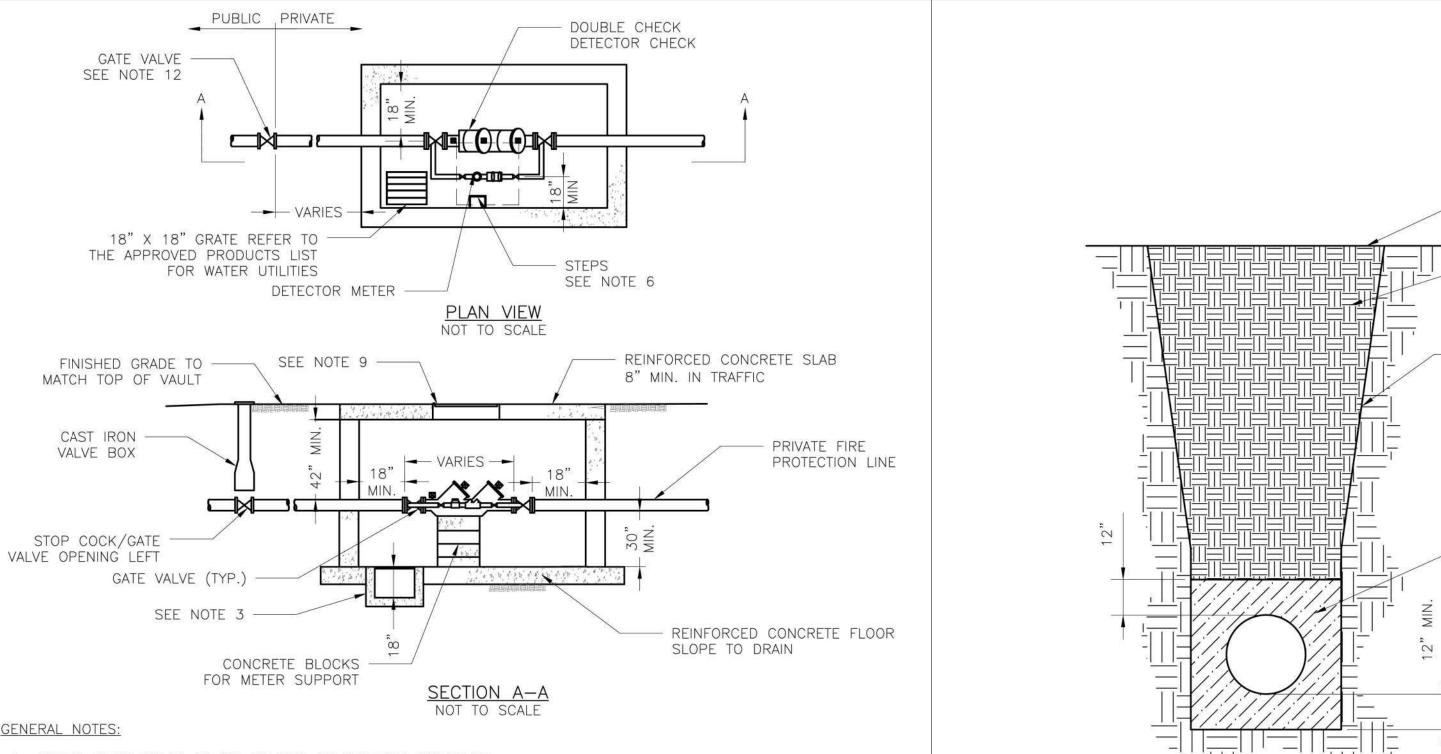10. CONTACT WATER UTILITIES, 816-969-1900, FOR REQUIREMENTS OF A METER LARGER THAN 2"



GENERAL NOTES:

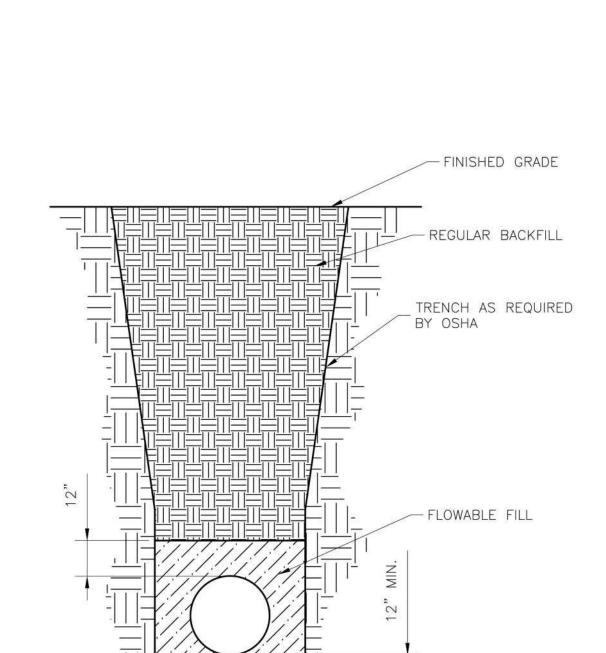- 1. METER VAULT WALLS TO BE POURED OR PRECAST CONCRETE. 2. METER VAULT ROOF TO BE REINFORCED CONCRETE OPENING CENTERED OVER DETECTOR METER. 3. METER VAULT TO BE LOCATED, WHEN POSSIBLE, OUTSIDE TRAFFIC AREA WHERE SURFACE WATER WILL NOT DRAIN INTO IT. VAULT MUST BE KEPT FREE OF WATER. PROVIDE CONCRETE SUMP AS A MINIMUM. WHERE PRACTICAL, PROVIDE A 2" PIPE DRAIN WITH AN ABOVE-GROUND DISCHARGE POINT. PROJECT OWNER MAY DESIRE A PERMANENTLY
- INSTALLED SUMP PUMP. 4. ALL PIPE SHALL BE DUCTILE IRON CLASS 50. ALL PIPE FITTINGS FROM THE CITY WATER MAIN THROUGH THE VAULT SHALL BE PROVIDED WITH RESTRAINED JOINT FITTINGS. 5. ALL FITTINGS TO BE BRASS.
- 6. STEPS SHALL BE IN ACCORDANCE WITH THE APPROVED PRODUCTS LIST FOR WATER UTILITIES AND SHALL BE ON 16" CENTERS.
- 7. A DEPARTMENT OF NATURAL RESOURCES APPROVED DOUBLE CHECK DETECTOR CHECK BACKFLOW PREVENTER MUST BE USED. FOR A COPY OF THE MISSOURI DEPARTMENT OF NATURAL RESOURCES APPROVED BACKFLOW PREVENTION ASSEMBLIES, CONTACT THE WATER UTILITIES OPERATIONS DIVISION AT 816-969-1940. AS OF JANUARY 1, 1987, THE DNR REQUIRES FIRE SPRINKLER SYSTEMS USING CHEMICALS TO HAVE A DNR APPROVED PRESSURE BACKFLOW
- PREVENTER INSTALLED, PRIOR TO THE MIXING POINT. 8. ALL VALVES SHALL HAVE RISING STEMS. 9. FOR MANHOLE COVERS, SELECT A MANHOLE FOUND ON THE APPROVED PRODUCTS LIST FOR WATER UTILITIES SUITABLE FOR EITHER TRAFFIC OR NON-TRAFFIC CONDITIONS.
- 10. A MINIMUM OF 18" CLEARANCE SHALL BE PROVIDED AROUND ALL PIPING, VALVES, APPURTENANCES, ETC. 11. METER SHALL BE OWNED AND MAINTAINED BY THE WATER UTILITIES DEPARTMENT. 12. IF PUBLIC WATER IS LOCATED ON THE OPPOSITE SIDE OF THE STREET, THEN THE PUBLIC WATER MAIN



1. FLOWABLE FILL SHALL MEET THE REQUIREMENTS OF THE CITY OF LEE'S SUMMIT DESIGN AND CONSTRUCTION MANUAL. 2. REGULAR BACKFILL ABOVE THE TRENCH CHECK SHALL BE FREE OF DEBRIS, ORGANIC MATTER, AND STONES > 6" IN ANY DIMENSION.

3. TOP OF FLOWABLE BACKFILL SHALL EXTEND 12" ABOVE THE TOP OF THE PIPE. 4. LENGTH OF TRENCH CHECK SHALL BE A MINIMUM OF 12".

EMIN, 793217

CMT

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1627 MAIN STREET, #100

KANSAS CITY, MO 64108

POUR CONCRETE AGAINST UNDISTURBED EARTH

MJ RETAINER GLAND

POUR CONCRETE AGAINST UNDISTURBED EARTH

TRENCH WIDTH

TOP VIEW

-#4 @ 12" O.C. EACH WAY EACH FACE

SECTION A-A

NOTE: THIS DETAIL NOT TO BE USED FOR PIPE GREATER THAN 12"

GERALD BOLLINGER

LEE'S SUMMIT MUNICIPAL AIRPORT LEE'S SUMMIT, MO

MARK | DATE | DESCRIPTION

PROJECT NO: 17932172 CAD DWG FILE: WATER-DETAILS-GA DESIGNED BY: WLC

DRAWN BY: WLC CHECKED BY: PHN APPROVED BY: BB COPYRIGHT

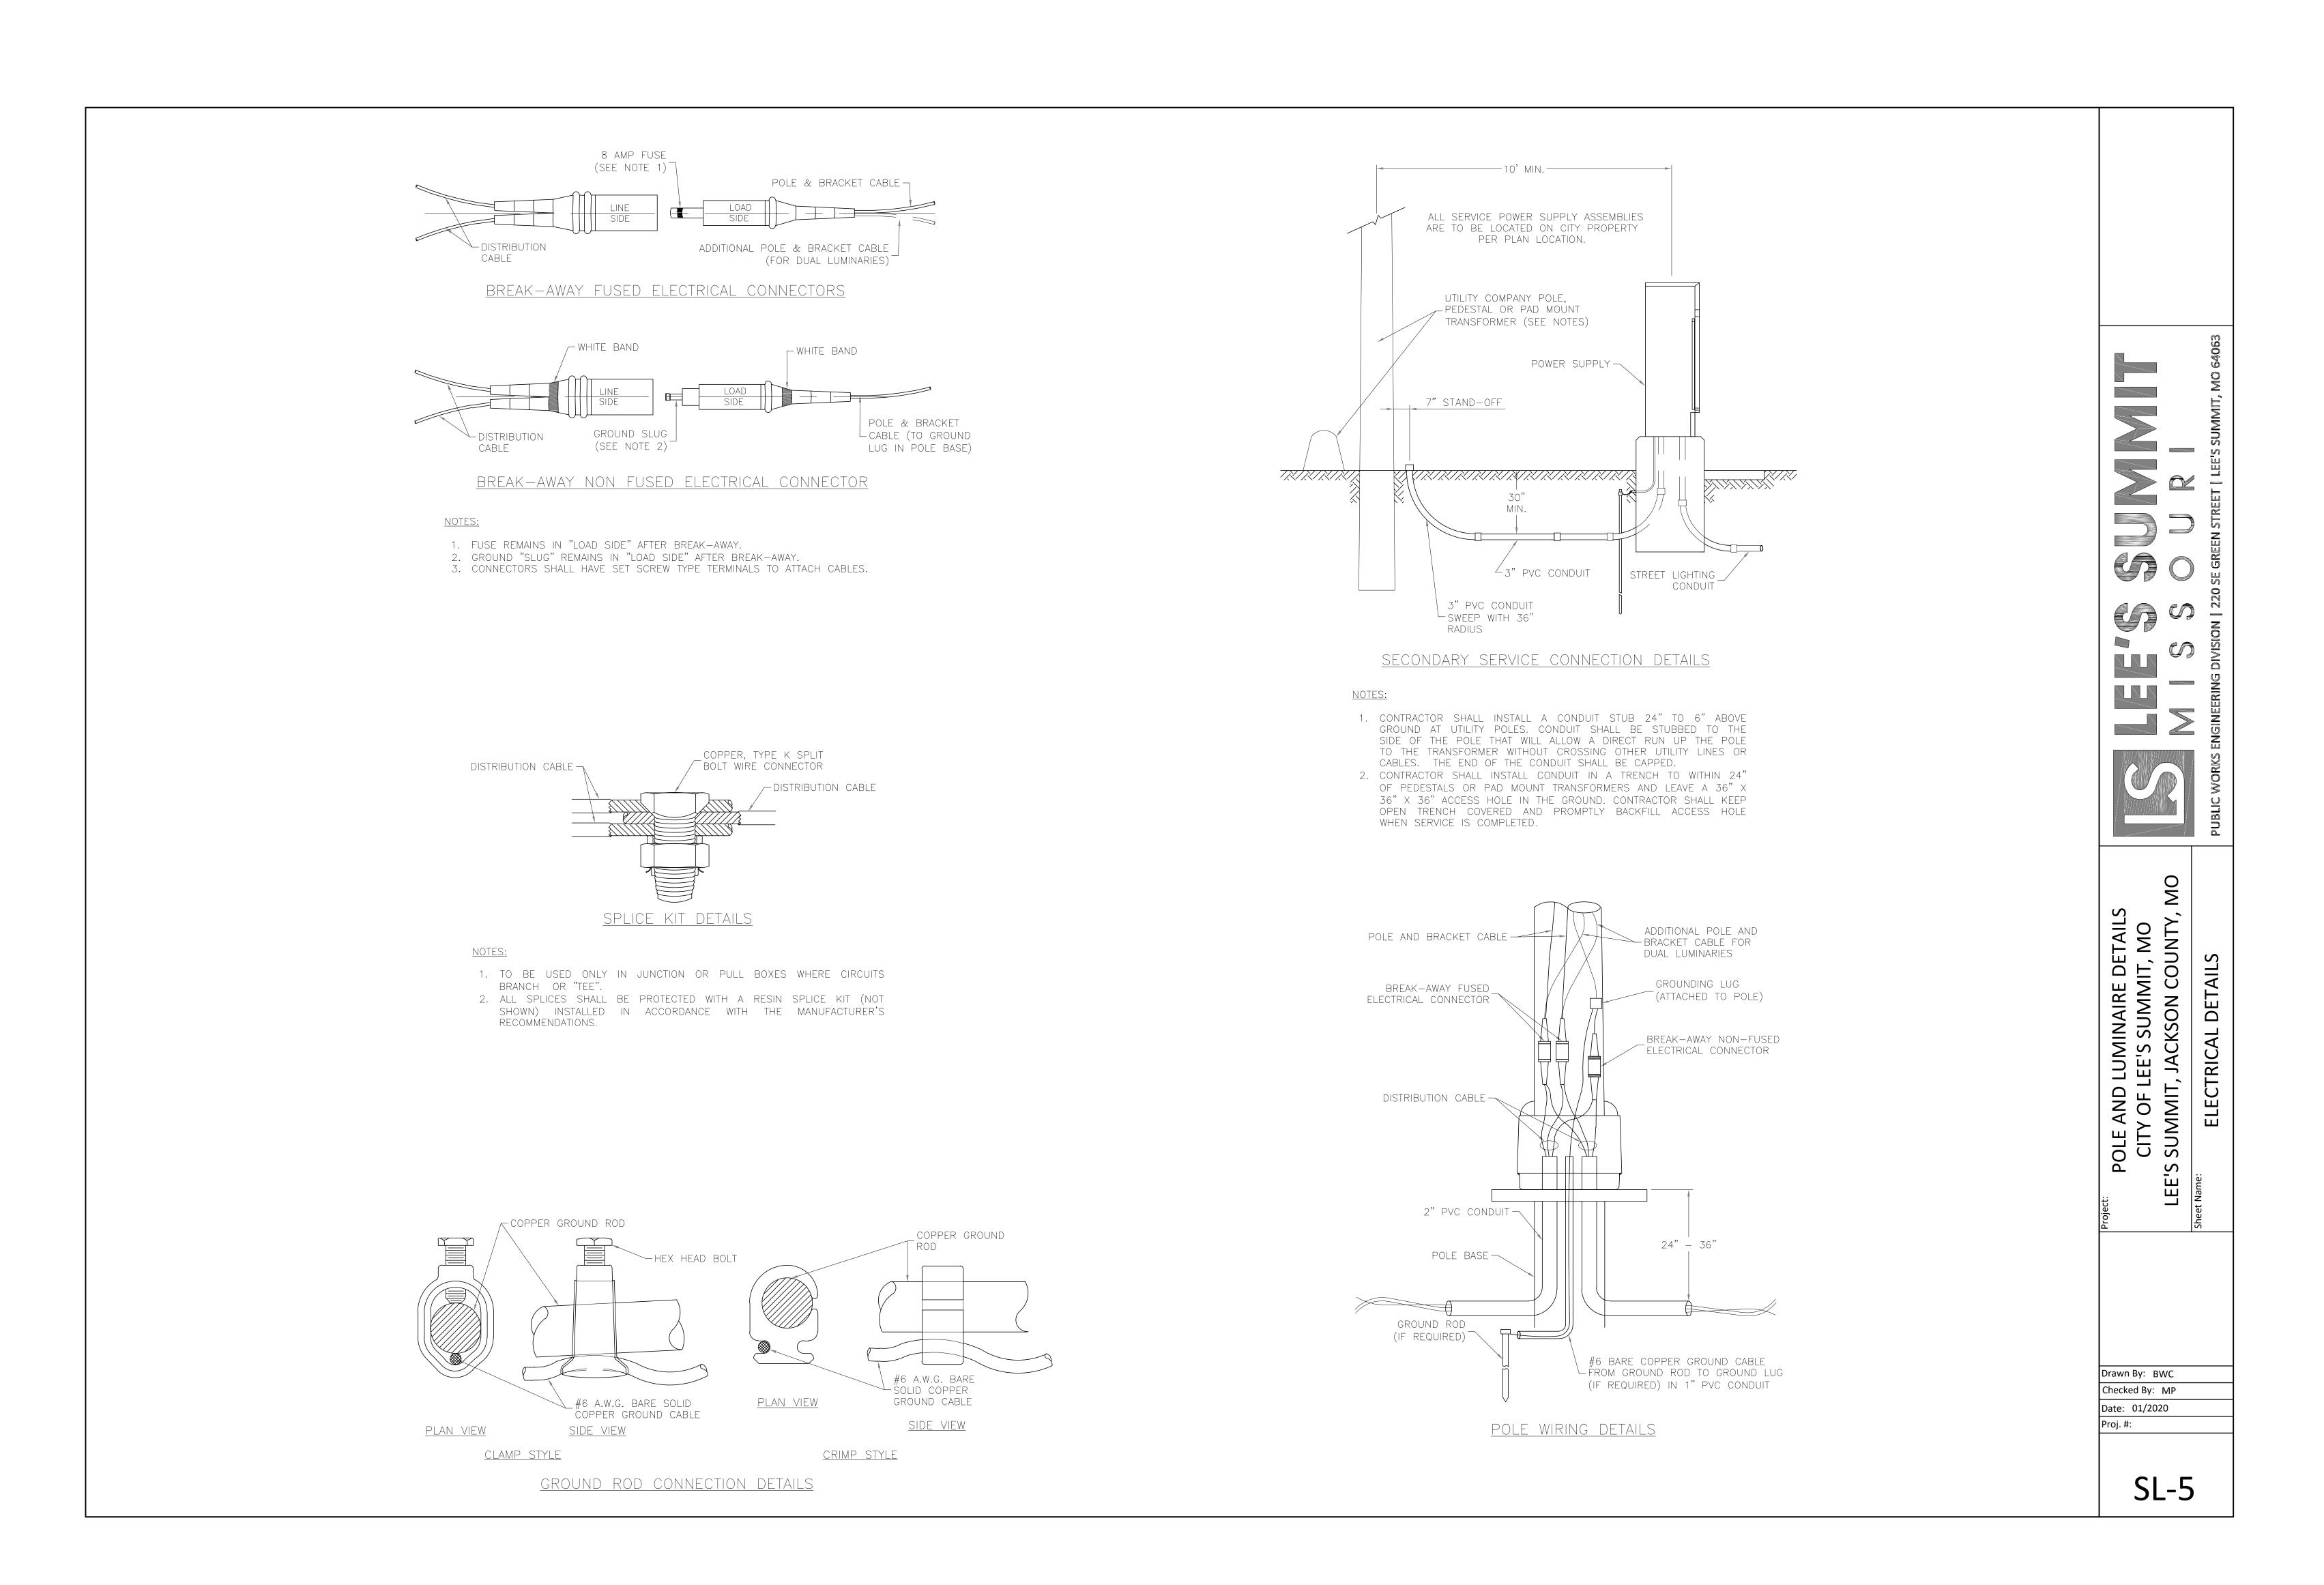
SHEET TITLE

WATER LINE DETAILS

C124

RESPONSIBILITY OF THE WATER UTILITIES DEPARTMENT ENDS AT THE GATE VALVE NEAREST THE VAULT. SHEET 028 OF 133

UNDISTURBED EARTH - BEARING AREA (TYP.) REQUIRED CONCRETE BEARING AREA (SQUARE FEET - SF) NOM. DIA. 90 BEND 45 BEND 22.5 BEND 11.25 BEND (INCHES) TEE, PLUG 4.7 6.7 8.4 11.8 6.4 4.0 4.0 13.1 18.5 10.0 5.1 4.0 18.8 26.7 14.4 7.4 4.0 36.3 19.6 25.6 47.4 6.6 42.4 REST. JT. 32.5 16.5 8.3 REST. JT. REST. JT. 40.1 20.4 10.3 BOND BREAKER (TYP. ALL BLOCKS) REST. JT. REST. JT. REST. JT 29.4 14.8 1/4" BOND BREAKER -PLAN 1/2 DIAMETER SECTION A 1. ALL BENDS WITHOUT RESTRAINED JOINTS SHALL HAVE CONCRETE THRUST BLOCKS INSTALLED FOR RESTRAINT. 2. MEGA LUGS MAY BE USED ONLY IN CONJUNCTION WITH CONCRETE THRUST BLOCKING. 3. BEARING AREA MUST BE AGAINST UNDISTURBED SOIL. 4. DO NOT COVER JOINTS OR BOLTS (WHERE APPLICABLE) WITH CONCRETE.



1627 MAIN STREET, SUITE 600 KANSAS CITY, MO 64108



1627 MAIN STREET, #100 KANSAS CITY, MO 64108



1301 BURLINGTON STREET

NORTH KANSAS CITY, MO 64116

PMENT 477324 STSIDE PROJE

SEALED DIGITALLY

JANUARY 4, 2024

LEE'S SUMMIT MUNICIPAL AIRPORT LEE'S SUMMIT, MO

MARK DATE DESCRIPTION

PROJECT NO: 47732472


CAD DWG FILE: ELECTRICAL DETAILS DESIGNED BY: WLC DRAWN BY: WLC


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ELECTRICAL DETAILS

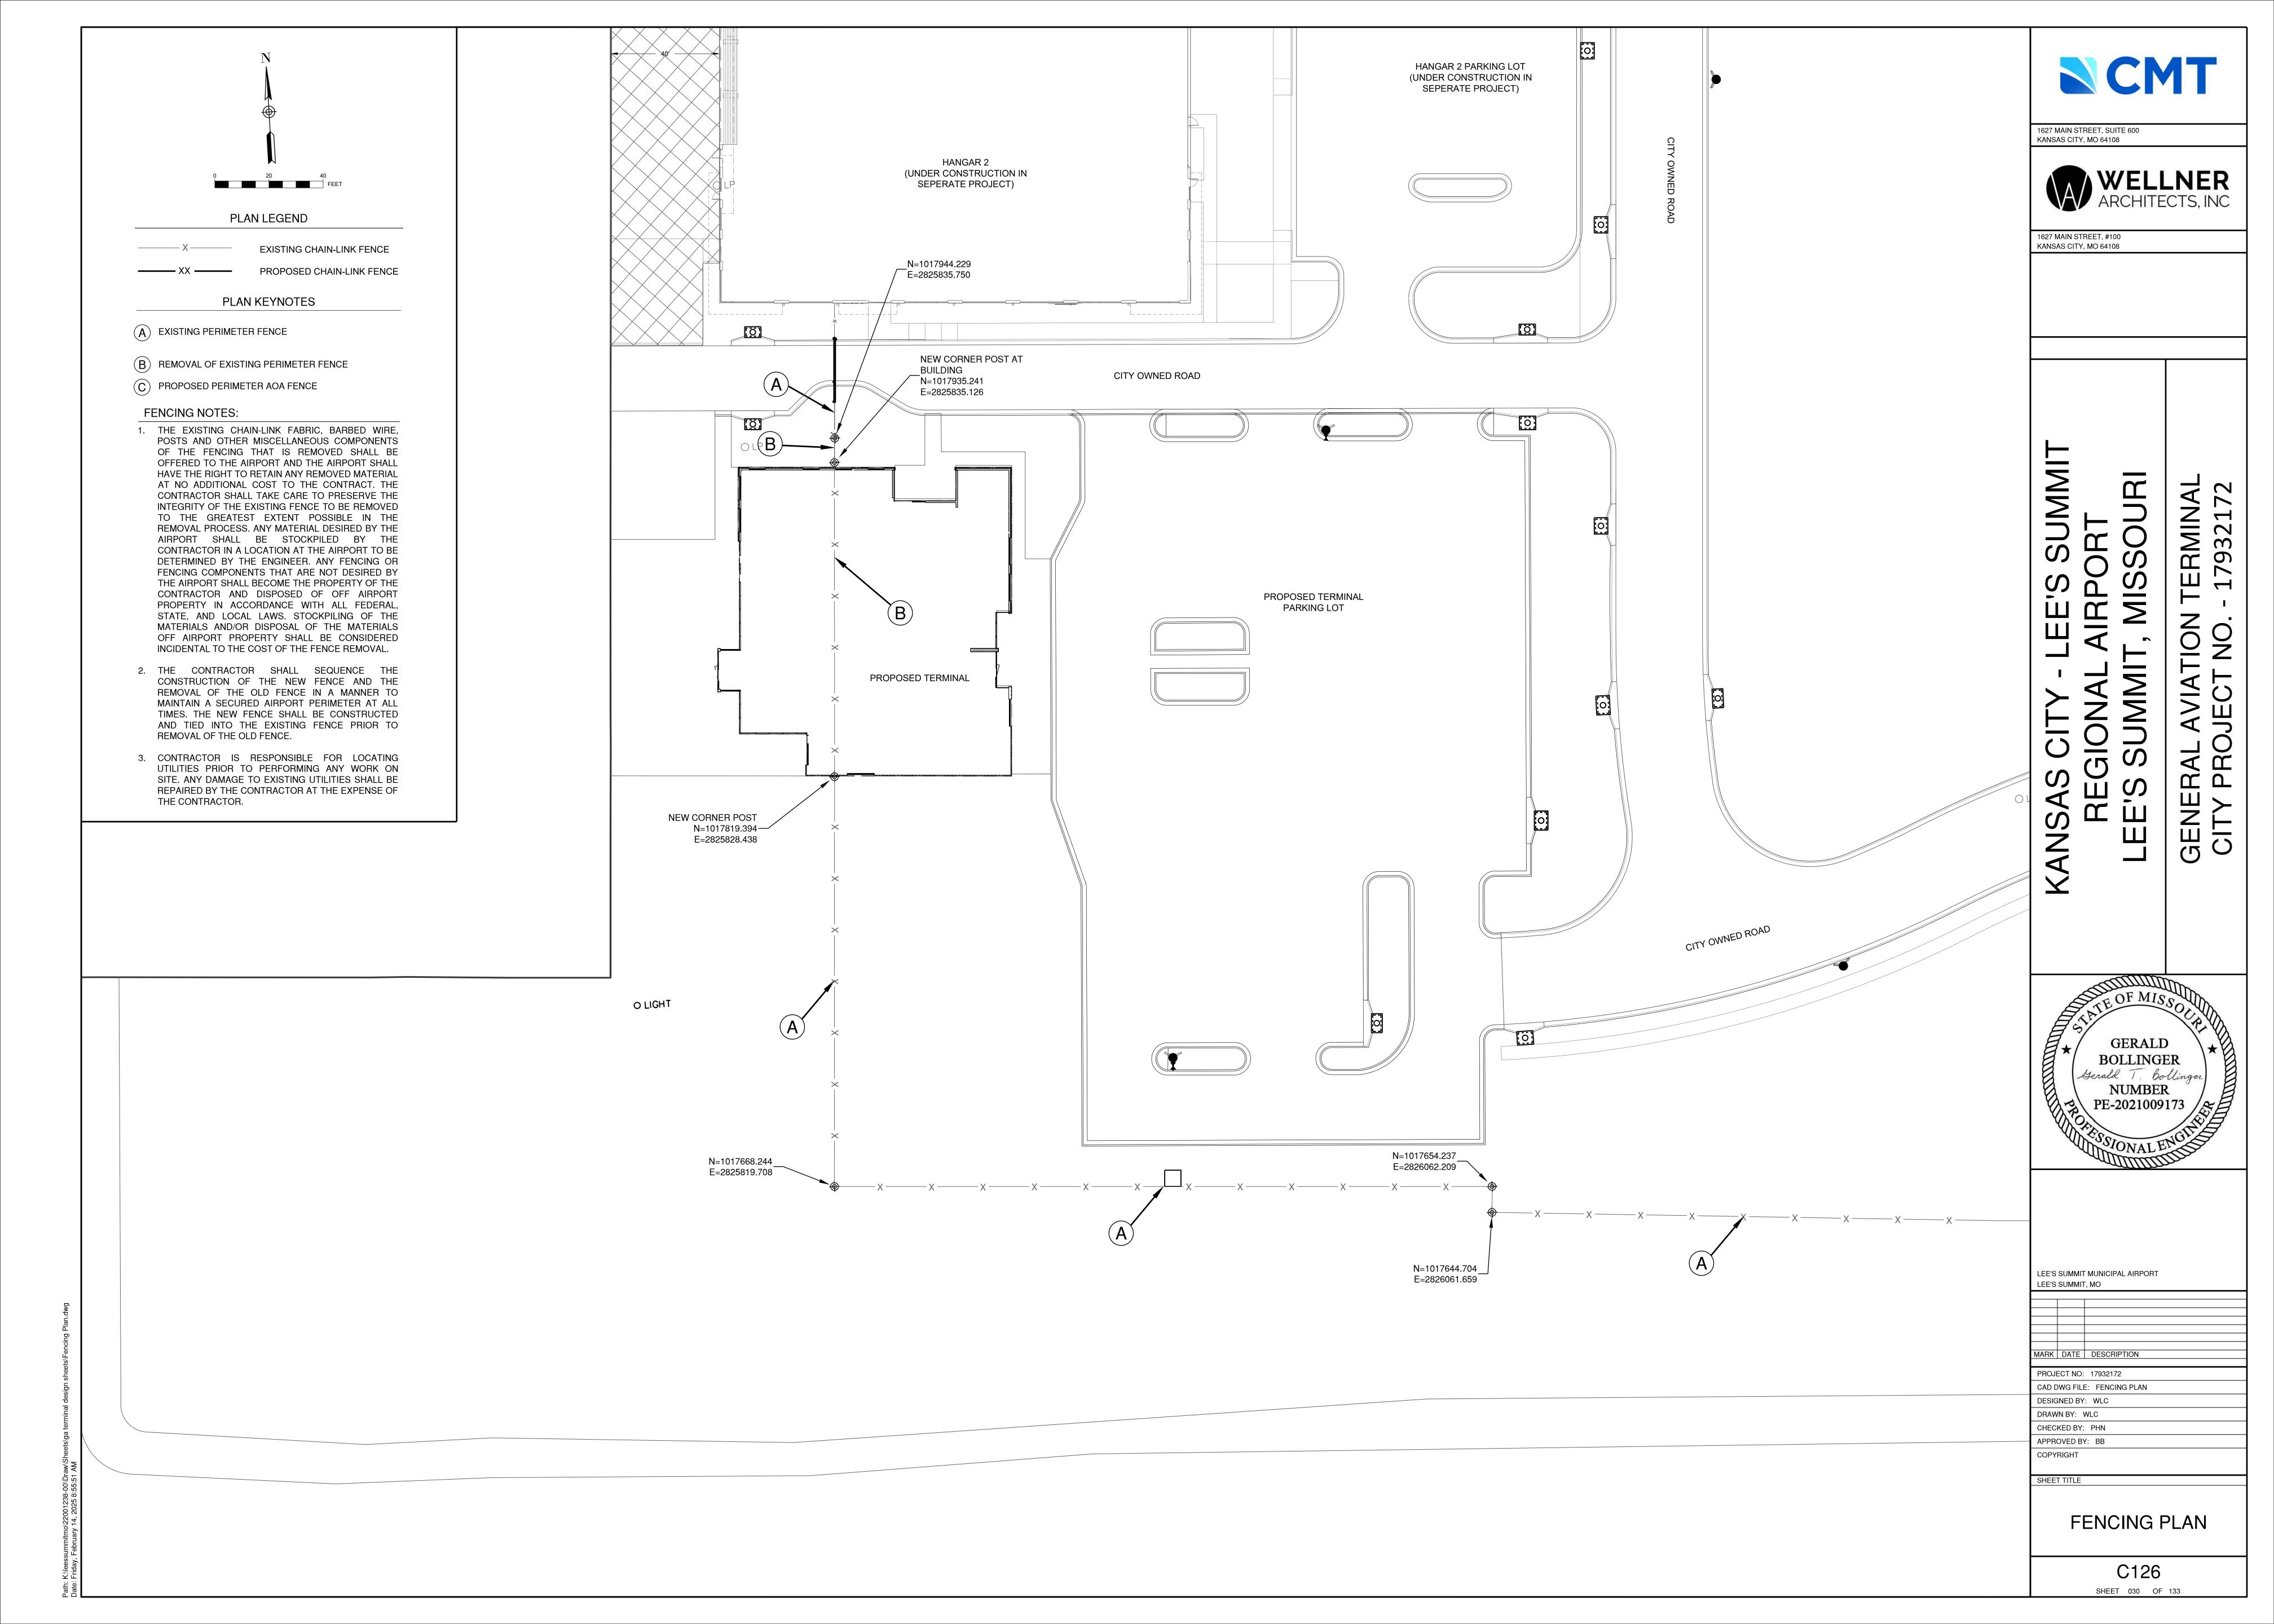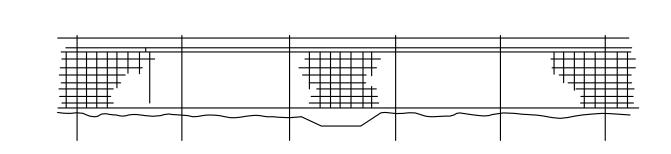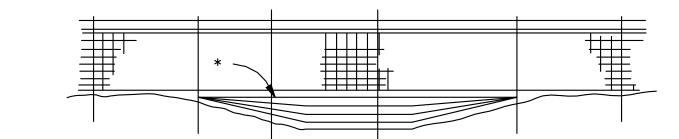
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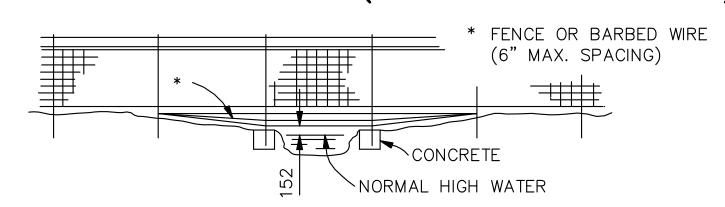




ROADWAY DITCHES OR SMALL SHALLOW CHANNELS (SPAN WITH NORMAL LINE POST SPACING)

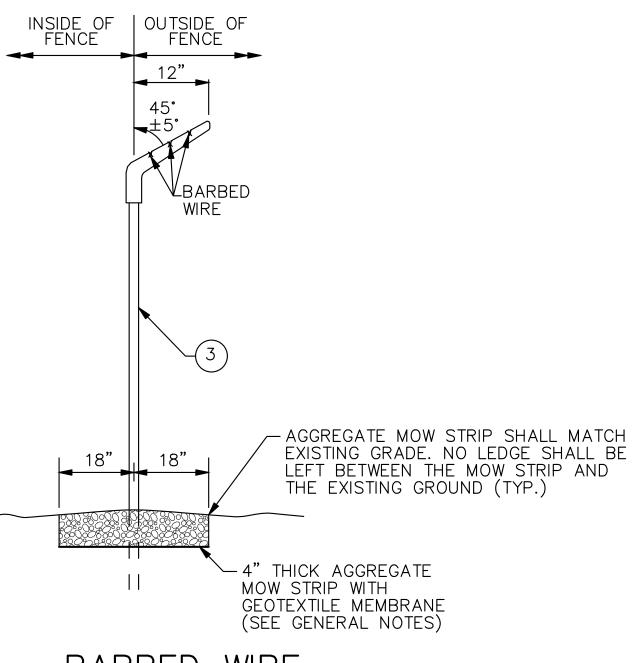


POORLY DEFINED CHANNELS (SMALL DRAINAGE AREAS)




WELL DEFINED CHANNELS (LARGE DRAINAGE AREAS)

TYPICAL FENCING AT CHANNEL CROSSING



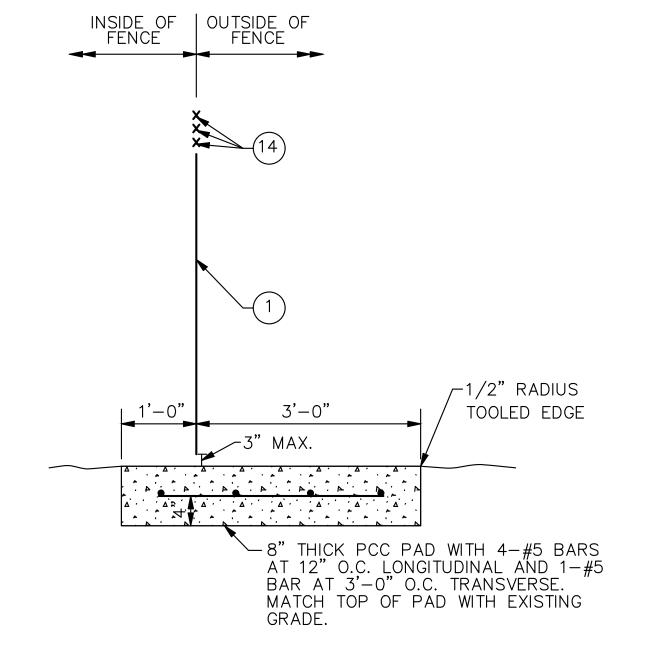BARBED WIRE EXTENSION BRACKET AND MOW STRIP



CONCRETE PAD AT GATES

WIRE	F FABRIC		
Ç	AMETER	HEIGHT OF FABRIC	
INCHES	MIN. GAGE	MESH INCHES	INCHES
0.120	11	2	36 - 42
0.148	9	2	48 – 96

FABRIC	× ♥
4"	1:1 SLOPE
TYPICAL	TRENCH

DETAILS

MINIMUM SIZ	ZE FOR F	FENCE HARD	WARE
	WIDTH	SIZE (IN.)	LBS/FT.
2 END CORNER OR PULL POST	N/A	31/2 DIA.	9.10
3 LINE POST	N/A	2" DIA.	3.65
4 GATE POST	î 6'	21/2 DIA.	5.79
(SINGLE GATE OR 1 LEAF OF	î 13'	31/2 DIA.	9.10
DOUBLE)	î 18'	6 DIA.	18.97
	Ç 18'	8 DIA.	24.70
5 BRACE	N/A	11/4 DIA.	2.27
6 TRUSS ROD	N/A	3/8	_
7GATE FRAME	N/A	11/2 DIA.	2.72

LEGEND

1 FABRIC
2 END, CORNER OR PULL POST
3 LINE POST

(3)LINE POST (4)GATE POST (5)BRACE

6) TRUSS ROD

7) GATE FRAME

8) STRETCHER BAR

1/4" X 3/4" PLATE

9 STRETCHER BAR BAND

10 END OR CORNER CLAMP

11 TENSION WIRE

12) FABRIC TIES

ONE-HALF FABRIC HEIGHT OR AS RECOMMENDED BY MANUFACTURER

14) BARBED WIRE

GENERAL NOTES:

- WEIGHTS OF MATERIALS SHOWN IN TABLE ARE FOR ASTM F 1043, GROUP IA. SIZES SHOWN ARE FOR STEEL AND ALUMINUM. EQUIVALENT ASTM F 1043 ALTERNATIVES MAY BE USED.
- 2. PULL POSTS SHALL BE USED AT SHARP BREAKS IN VERTICAL GRADE OR AT APPROXIMATE 300' CENTERS ON STRAIGHT RUNS OR AS DIRECTED BY THE ENGINEER.
- 3. DRILLED HOLES ON SOLID ROCK SHALL PROVIDE A DIAMETER OF NOT LESS THAN 2" GREATER THAN THE MAXIMUM TRANSVERSE DIMENSION OF THE POST SECTION.
- 4. ALL POSTS SHALL HAVE PROVISIONS TO SECURELY HOLD THE TOP TENSION WIRE IN POSITION AND ALLOW FOR REMOVAL AND REPLACEMENT OF A POST WITHOUT DAMAGING THE TOP TENSION WIRE.
- 5. THE MESH SIZE SHALL BE 2 INCHES \pm 1/8 IN. MEASURED IN EITHER DIRECTION AS THE MINIMUM CLEAR DISTANCE BETWEEN THE WIRES FORMING THE PARALLEL SIDES OF THE MESH
- 6. THE AGGREGATE MOW STRIP SHALL RUN THE ENTIRE LENGTH OF THE FENCELINE AND SHALL BE SURFACED WITH 4" OF WELL-GRADED CRUSHED ROCK AGGREGATE. GEOTEXTILE MEMBRANE SHALL BE INSTALLED UNDER THE AGGREGATE. MEMBRANE SHALL BE NON-WOVEN POLYPROPYLENE FIBERS TO A MINIMUM DENSITY OF 80Z PER SY. TOP OF ROCK SHALL BE BETWEEN 0" TO 1" FROM THE BOTTOM OF THE CHAIN-LINK FABRIC. THIS WORK SHALL BE INCIDENTAL TO THE FENCE PAY ITEM.
- 7. ALL POSTS SHALL BE ROUND AND SHALL BE SET IN CONCRETE WITH 1 FOOT OF COMPACTED SOIL ABOVE THE CONCRETE.
- 8. THE MAXIMUM GAP ALLOWED WHERE THE FENCE ABUTS BUILDINGS, AT GATE AND HINGE CLOSURE POSTS, AT CENTER OF DOUBLE GATES, AND AT THE BOTTOM OF GATES SHALL BE 3" OR LESS.
- 9. THE PCC PAD AT GATES SHALL BE INCIDENTAL TO THE GATE PAY ITEM.

CMT


1627 MAIN STREET, SUITE 600 KANSAS CITY, MO 64108



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KANSAS CITY - LEE'S SUMMI REGIONAL AIRPORT LEE'S SUMMIT, MISSOURI

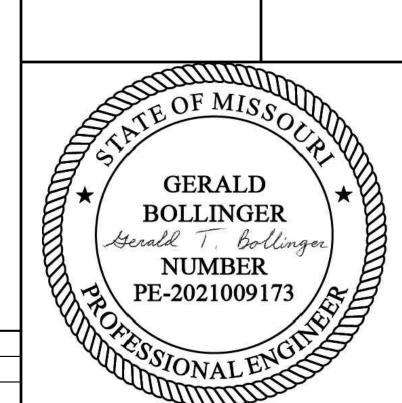RMINAL



LEE'S SUMMIT MUNICIPAL AIRPORT
LEE'S SUMMIT, MO

96"

SIZE (IN.)

60**"**

48"

54"

12"

42"

CONCRETE PAD TO BE INSTALLED AT ALL GATE LOCATIONS WHERE PORTLAND CEMENT CONCRETE OR BITUMINOUS CONCRETE DOES NOT ALREADY EXIST.

SIZE (IN.)

12"

36"

36"

MISSOURI HIGHWAYS AND TRANSPORTATION

COMMISSION

HEIGHT OF FENCE

CHAIN-LINK FENCE

72"

SIZE (IN.)

42"

42"

36"

42"

607.10V

MINIMUM DEPTH FOR SETTING POSTS

SIZE (IN.)

DESCRIPTION

2 END CORNER & PULLPOST

3 LINE POST

4) GATE POST

REVISED BY CMT:

DATE: <u>03-27-2015</u> EFFECTIVE: 02-01-2007

MARK	DATE	DESCRIPTION	

PROJECT NO: 17932172

CAD DWG FILE: FENCING PLAN

DESIGNED BY: WLC

DRAWN BY: WLC

CHECKED BY: PHN

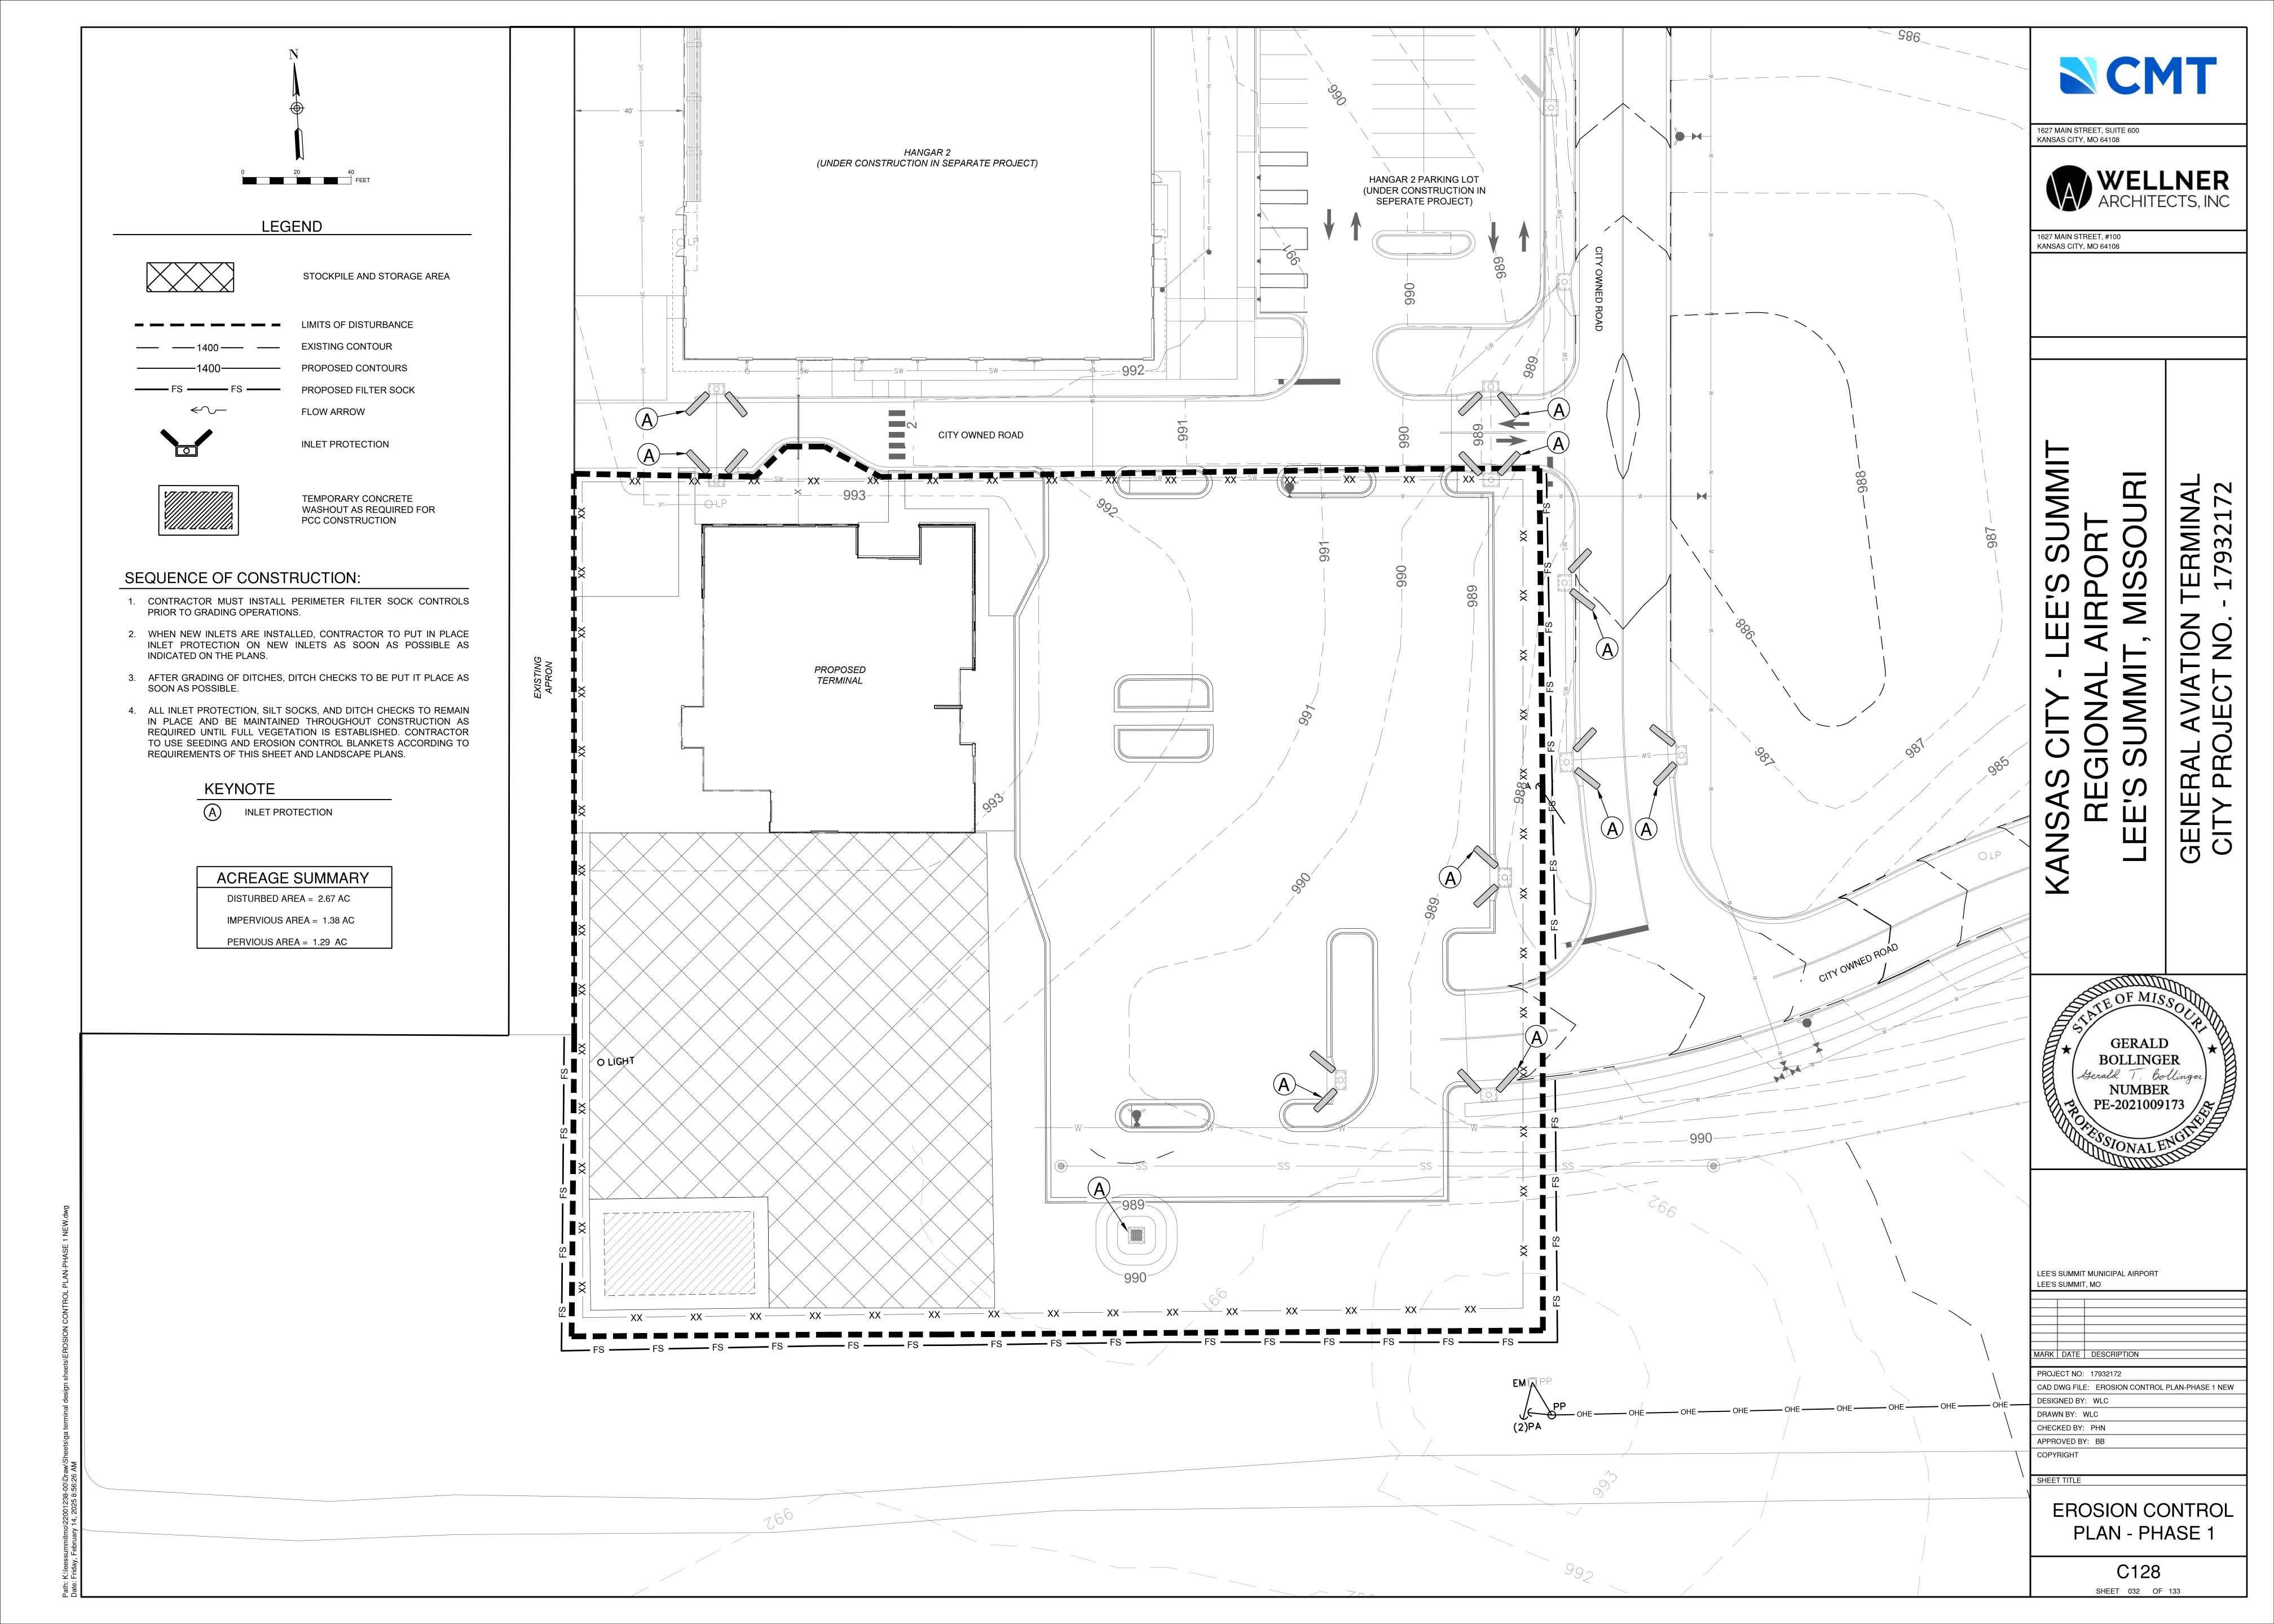
APPROVED BY: BB

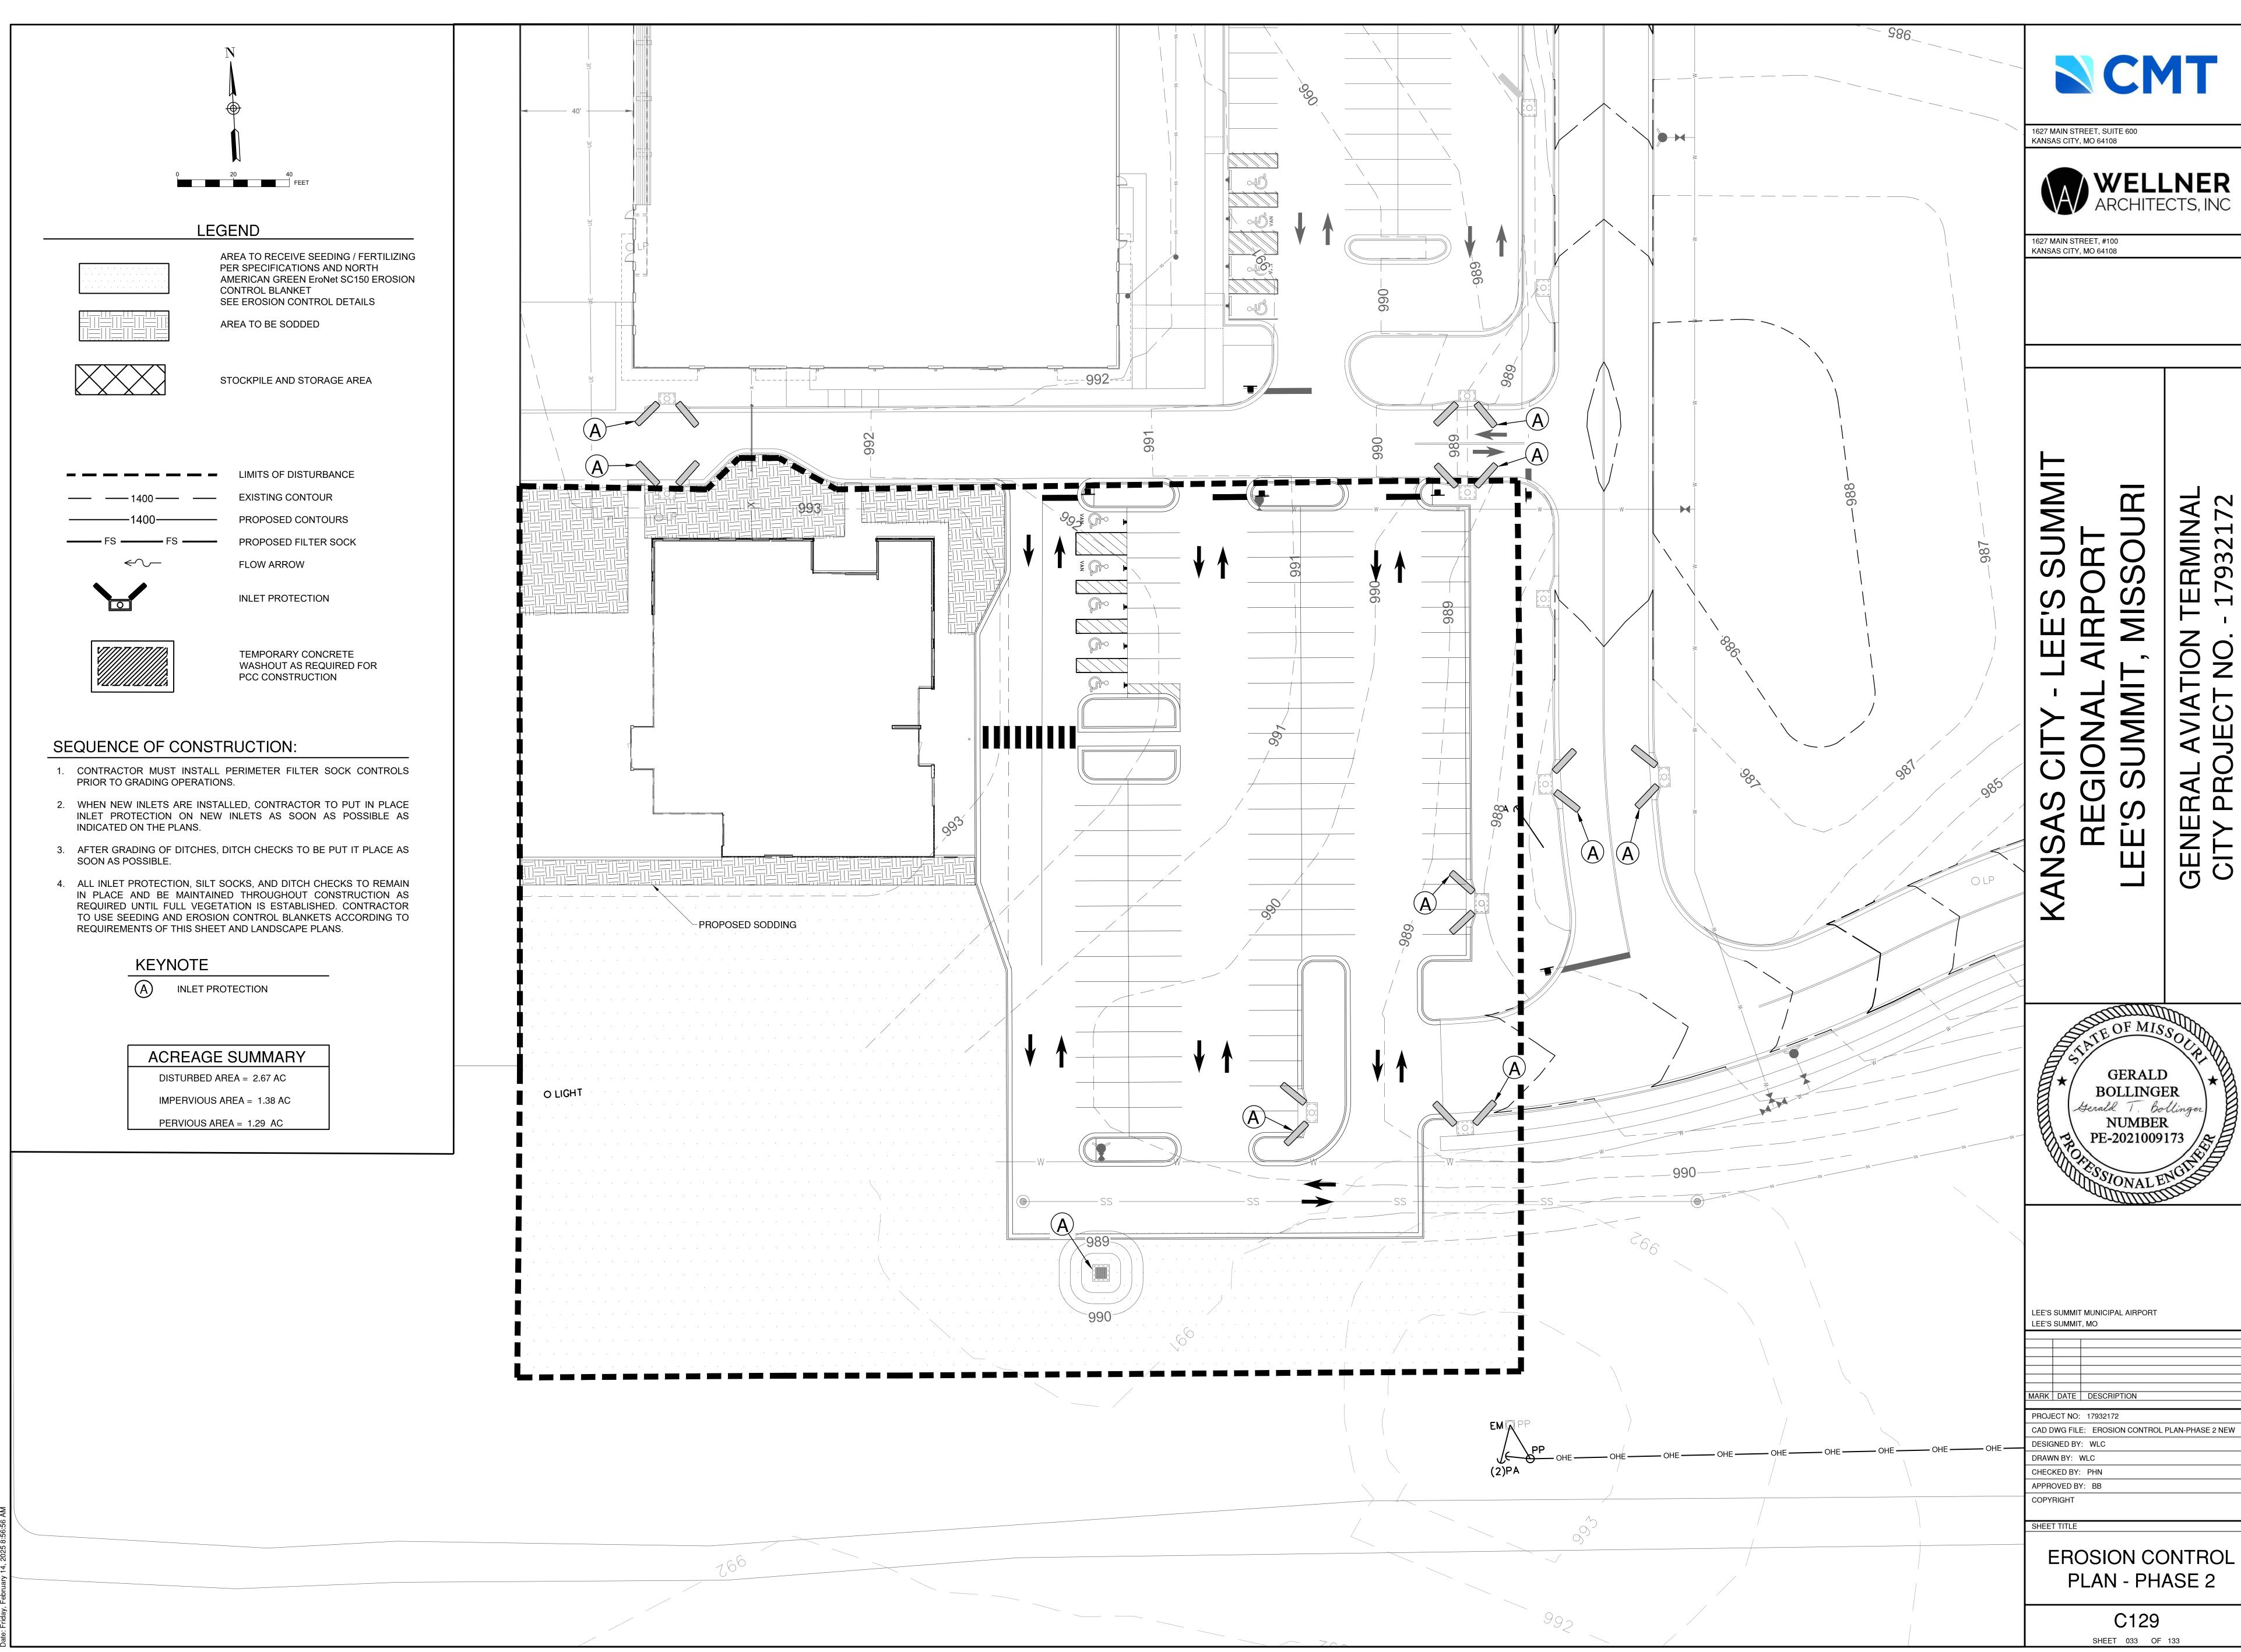
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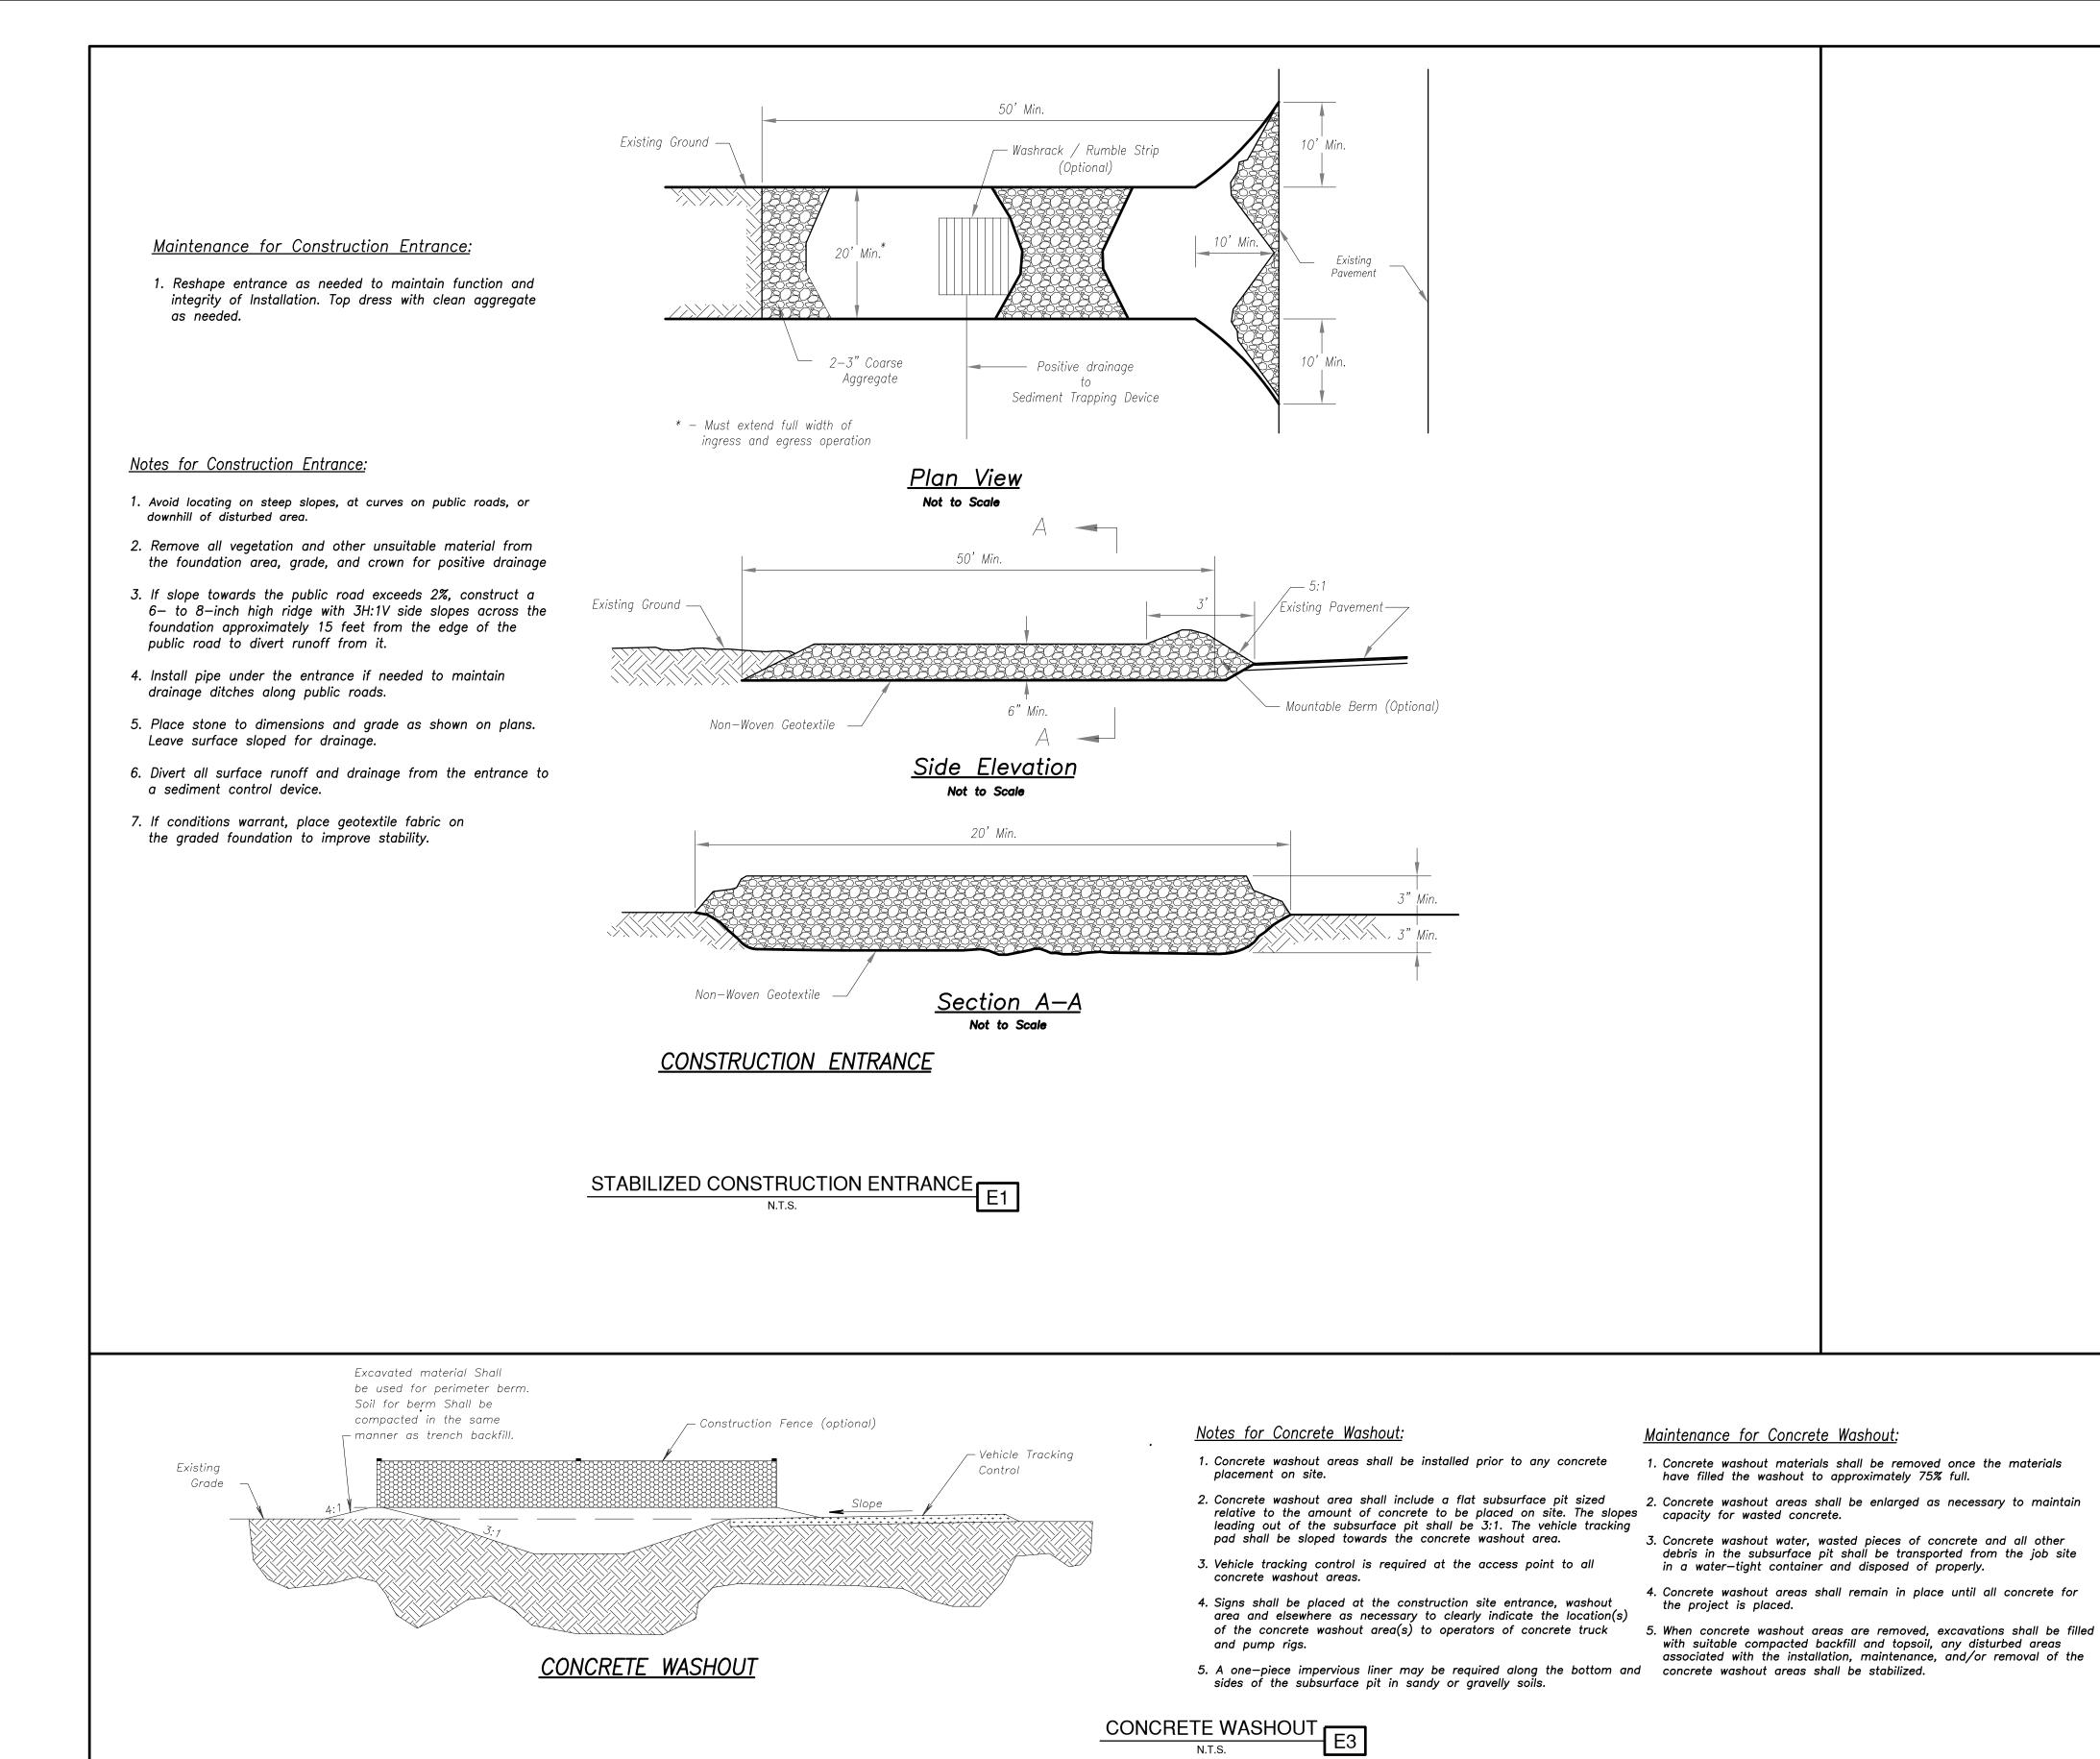
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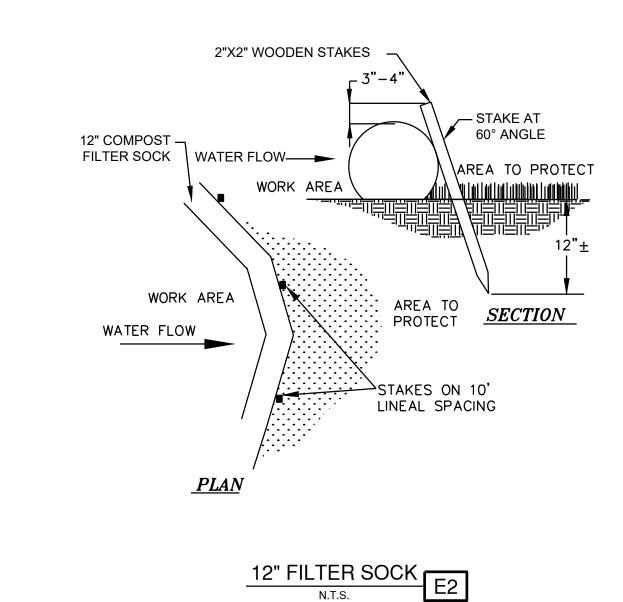
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SHEET 031 OF 133











KANSAS CITY - LEE'S SUMMIT REGIONAL AIRPORT LEE'S SUMMIT, MISSOURI

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GERALD
BOLLINGER

Serall T. Bollinger

NUMBER
PE-2021009173

LEE'S SUMMIT MUNICIPAL AIRPORT LEE'S SUMMIT, MO

MARK DATE DESCRIPTION

MARK DATE DESCRIPTION
PROJECT NO: 17932172

PROJECT NO: 17932172

CAD DWG FILE: EROSION CONTROL DETAILS

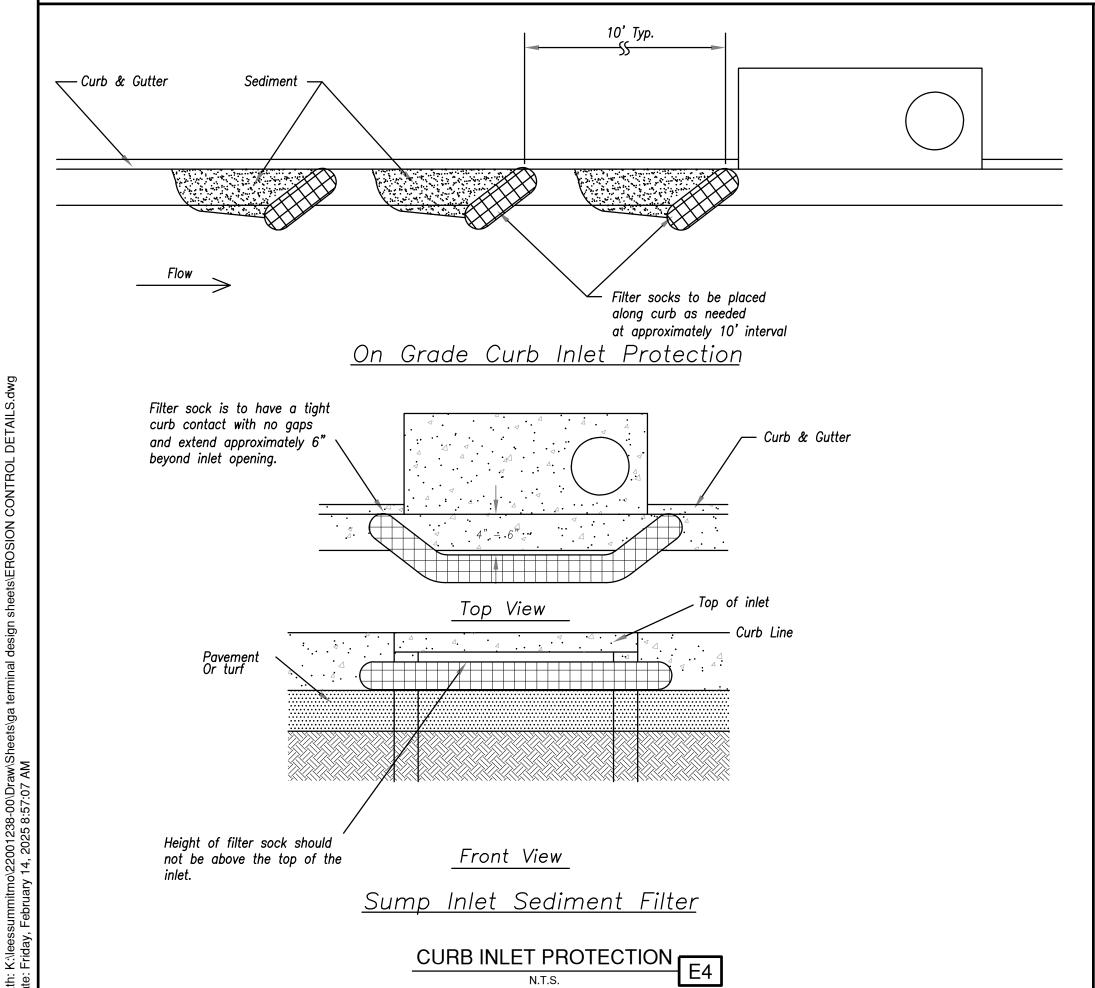
DESIGNED BY: WLC
DRAWN BY: WLC
CHECKED BY: PHN

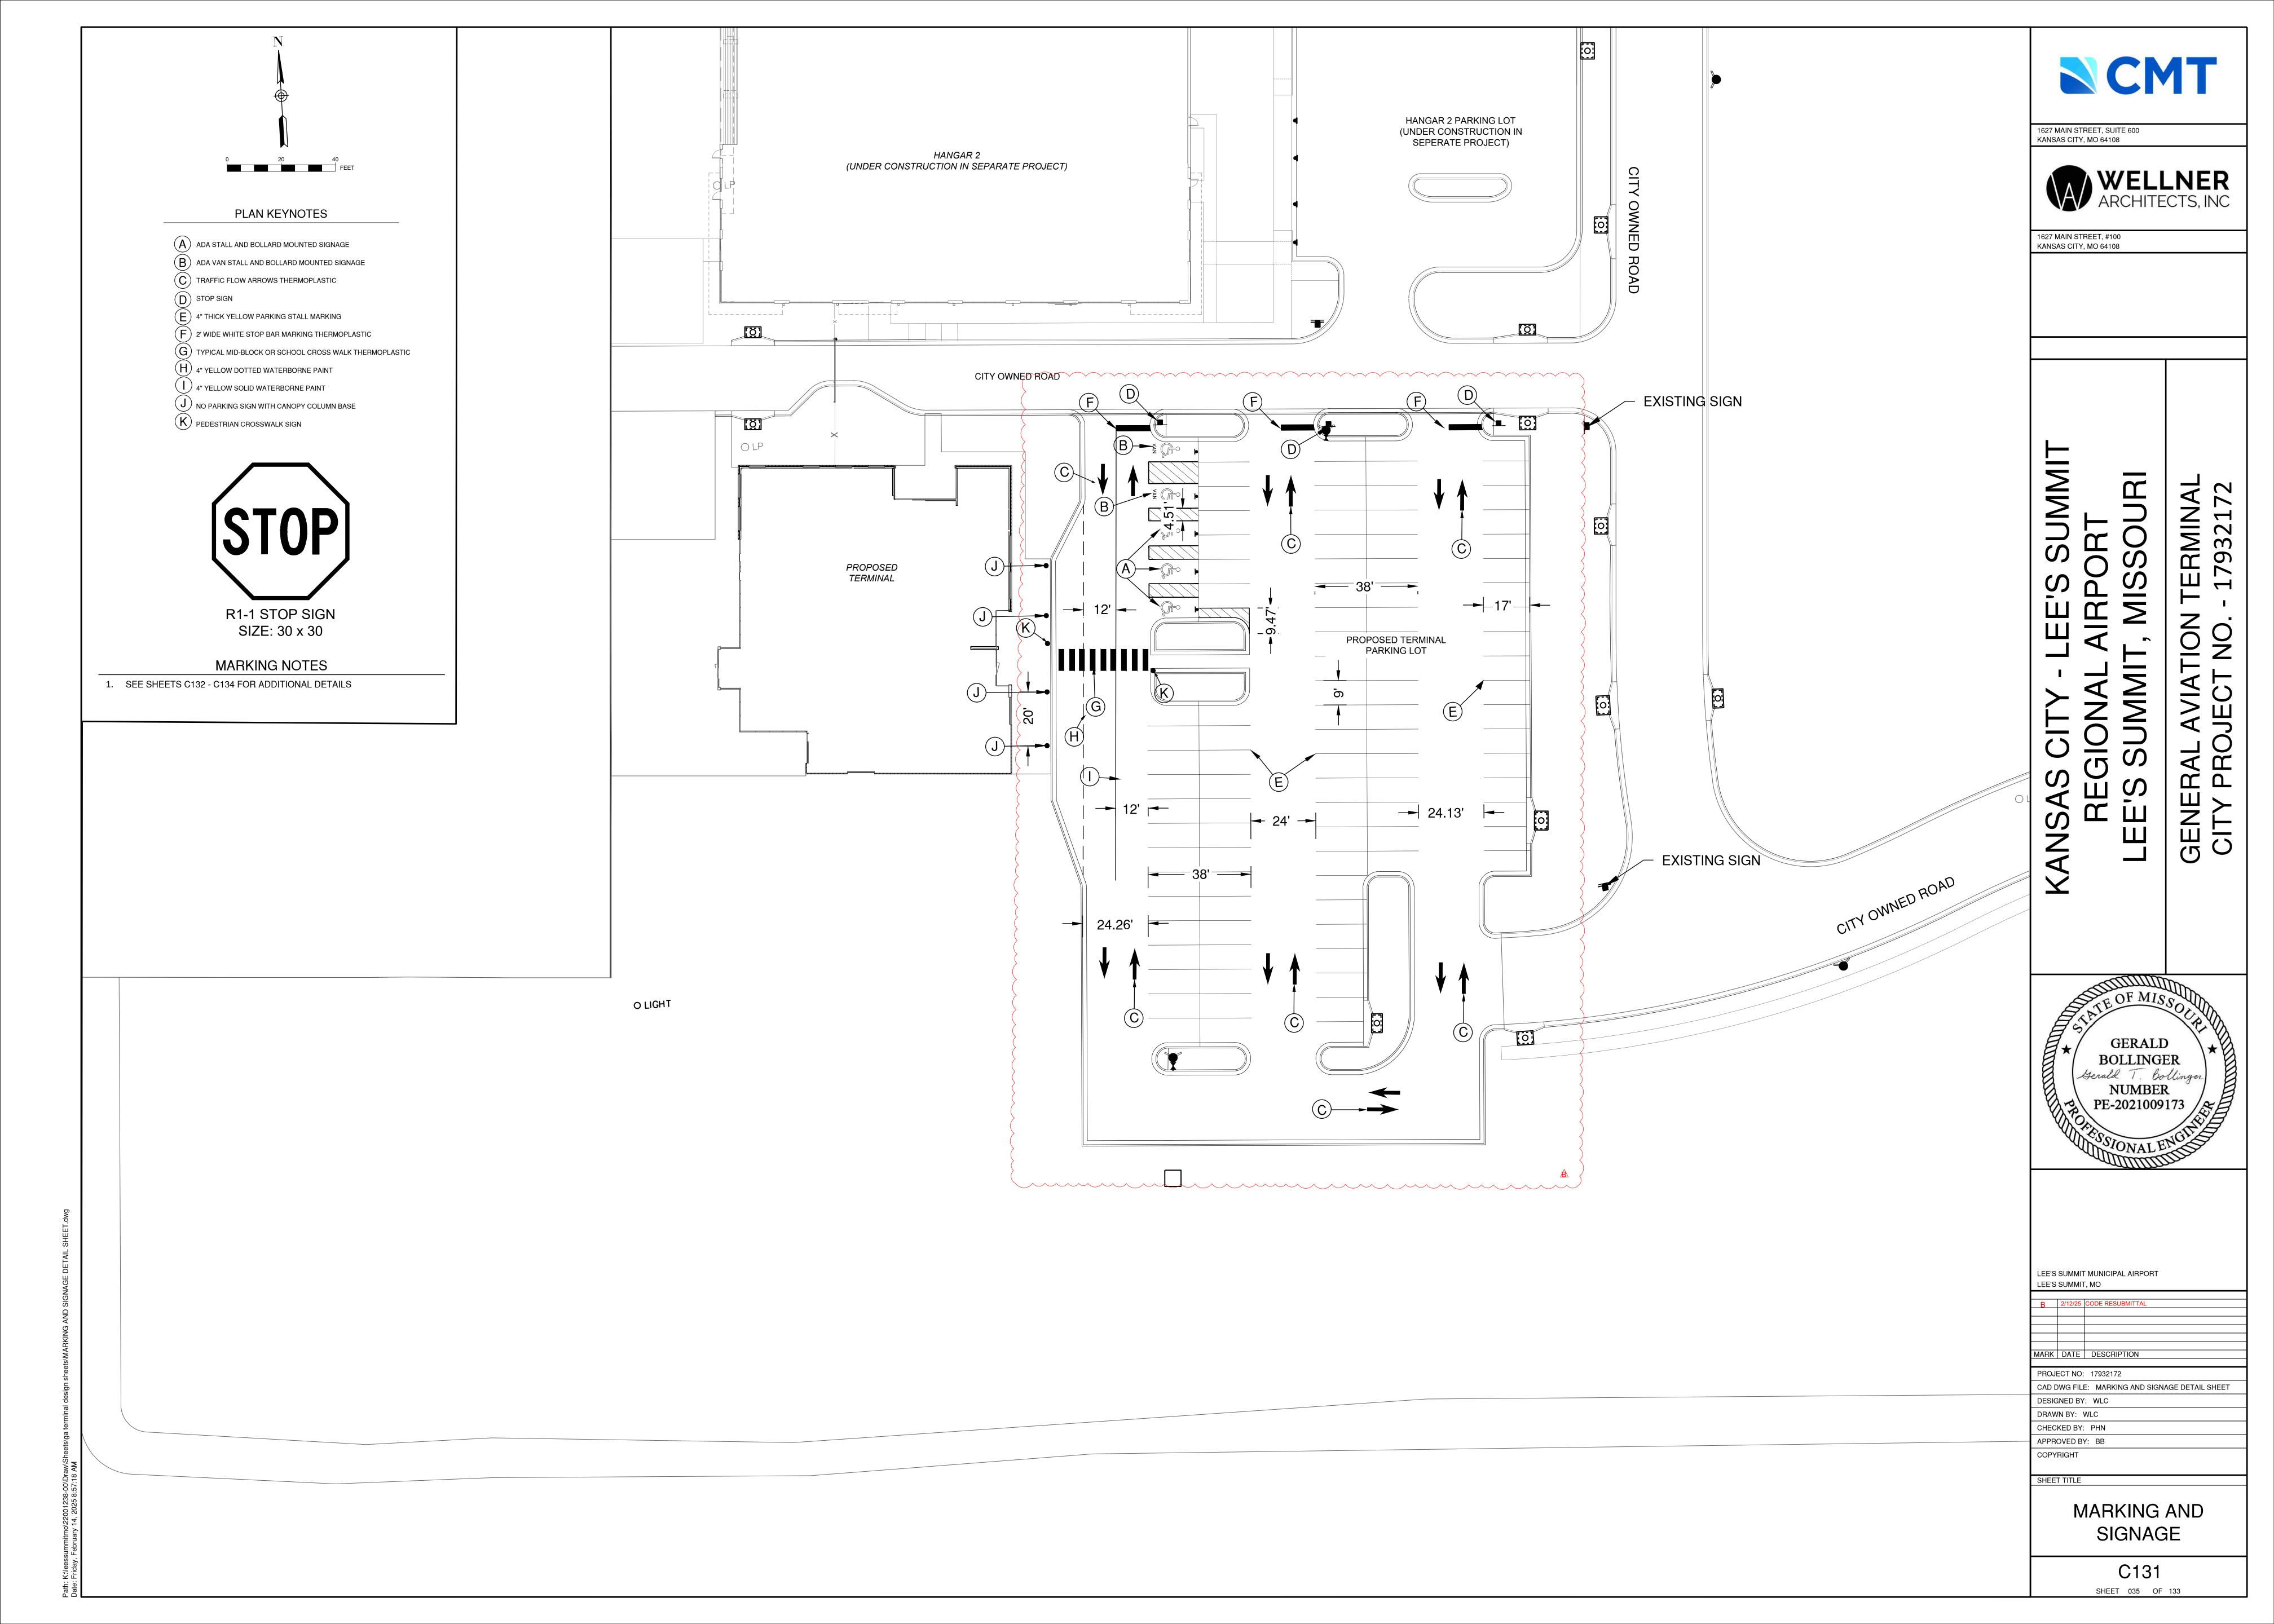
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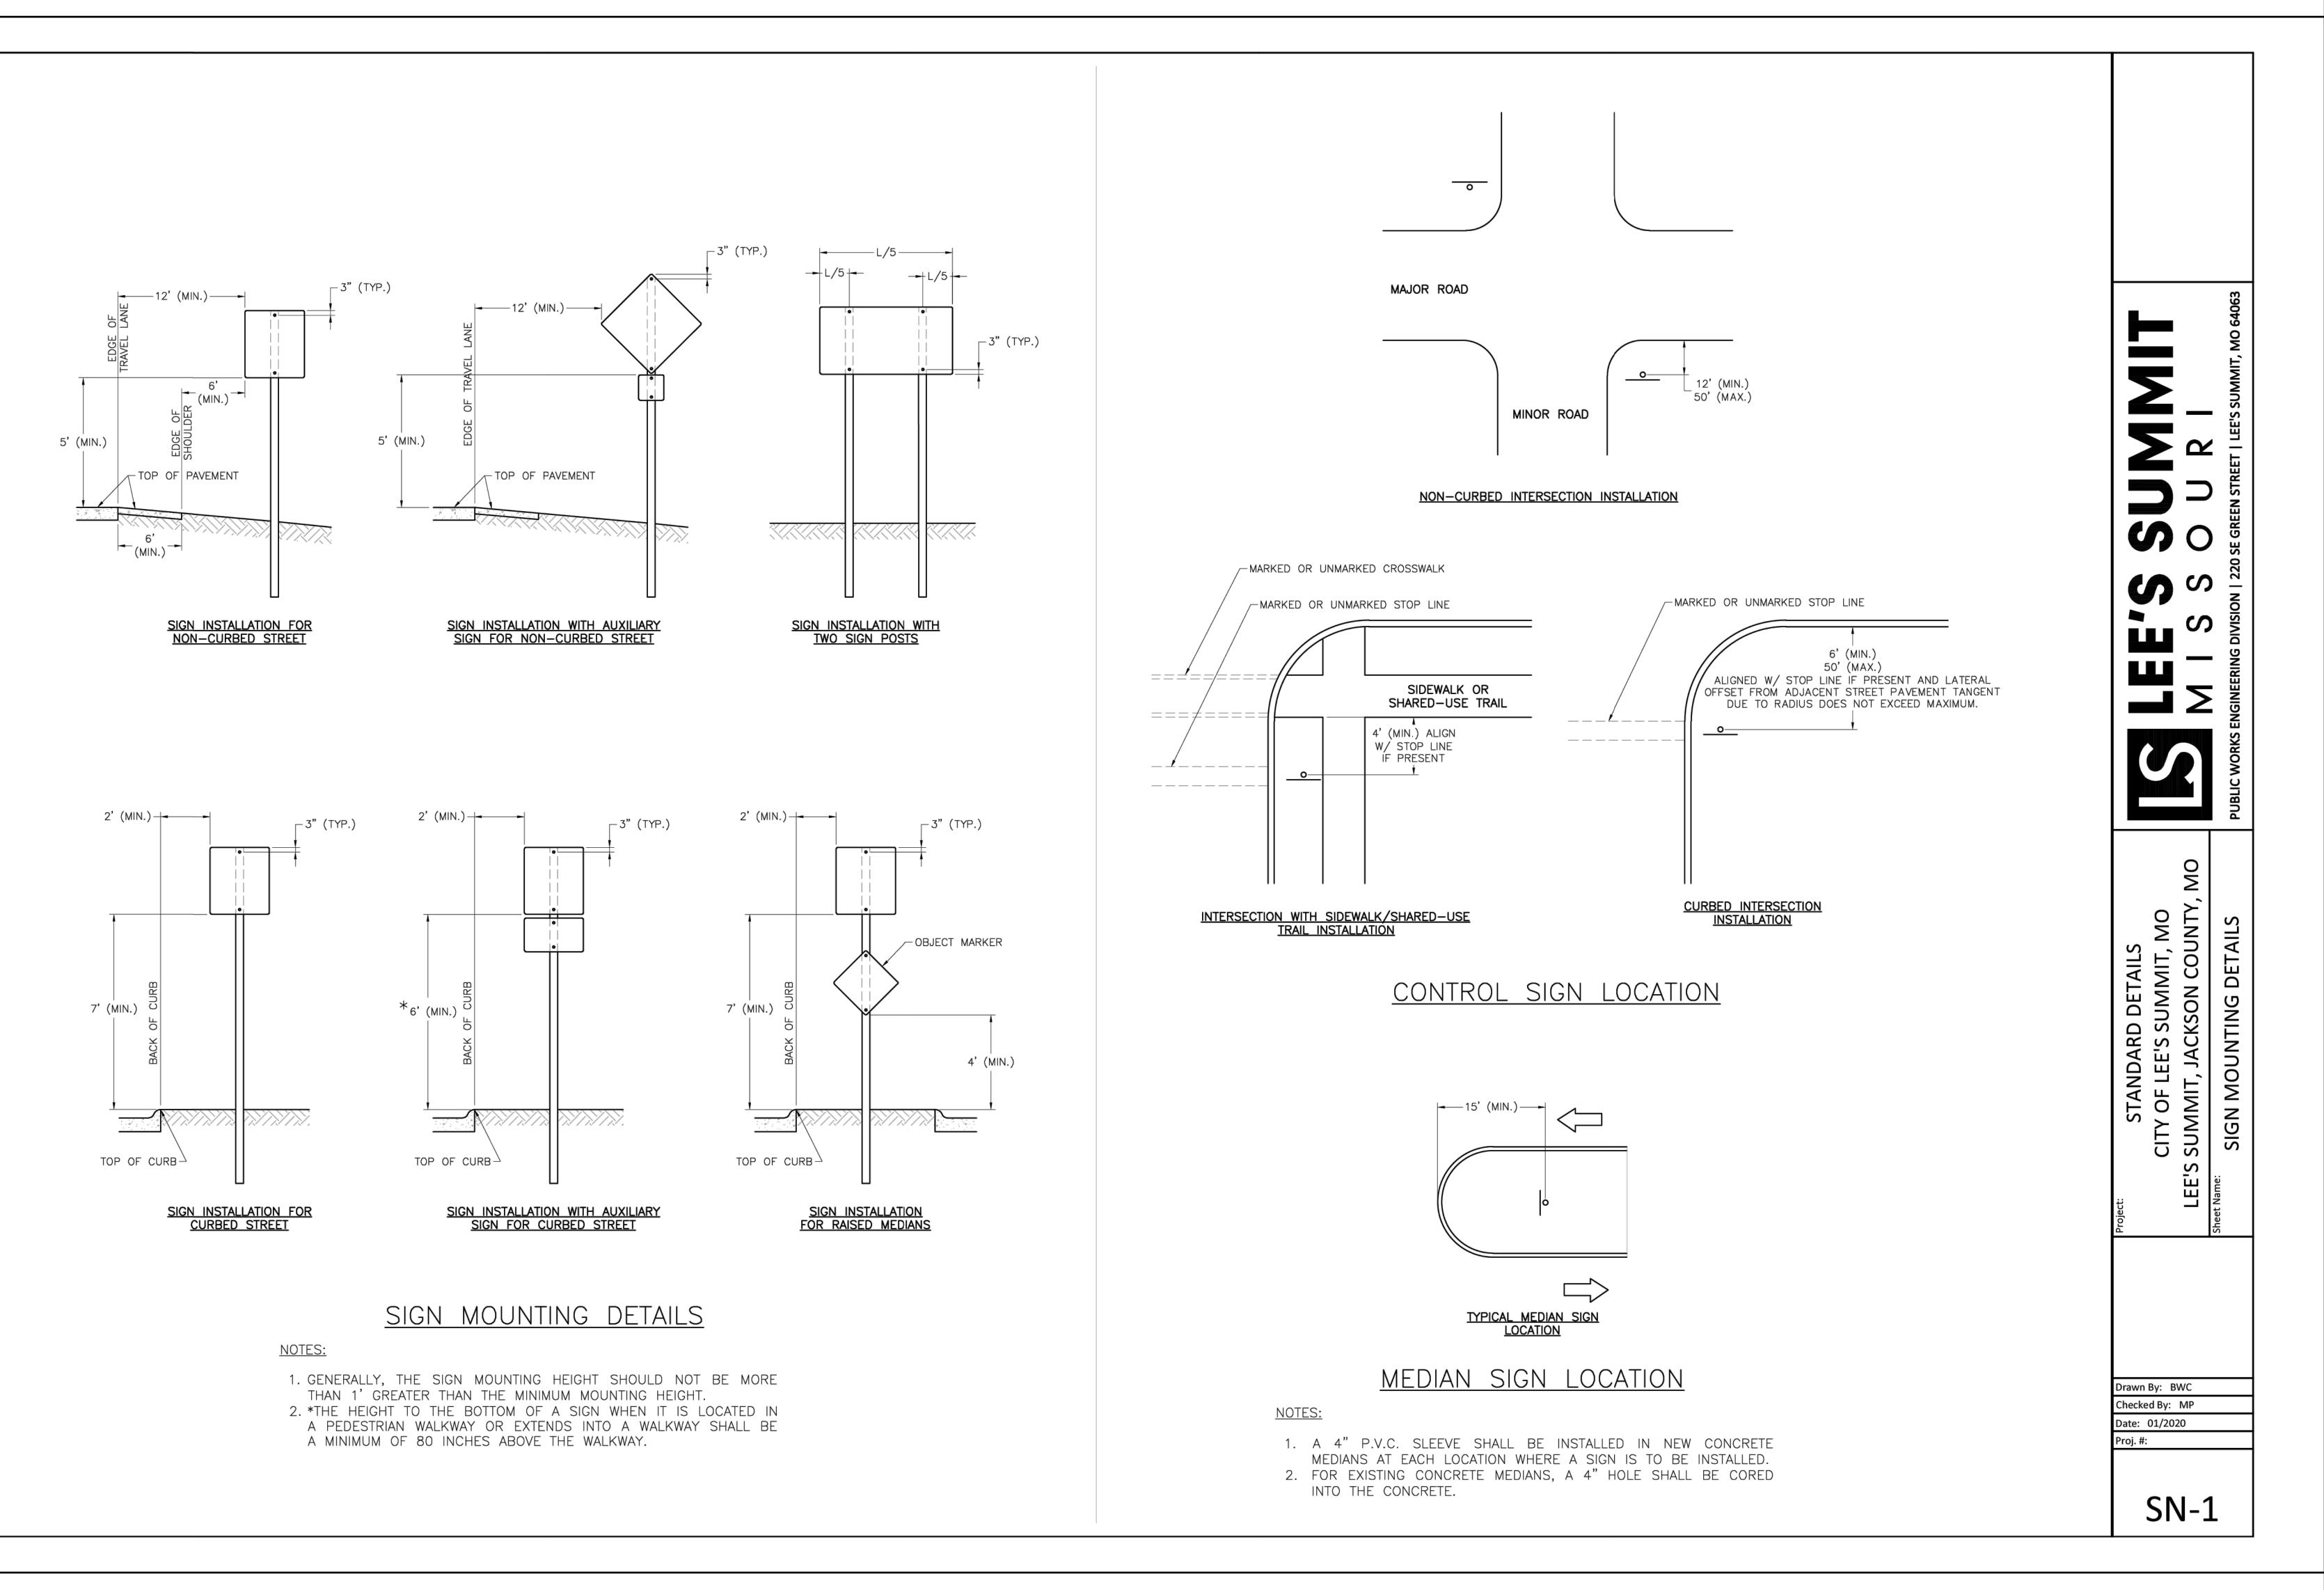
SHEET TITLE

EROSION CONTROL DETAILS

C130
SHEET 034 OF 133







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1627 MAIN STREET, #100

KANSAS CITY, MO 64108

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LEE'S SUMMIT MUNICIPAL AIRPORT LEE'S SUMMIT, MO


MARK | DATE | DESCRIPTION

PROJECT NO: 17932172 CAD DWG FILE: MARKING AND SIGNAGE DETAIL SHEET DESIGNED BY: WLC

DRAWN BY: WLC CHECKED BY: PHN APPROVED BY: BB


MARKING AND SIGNAGE DETAIL 1 OF 3
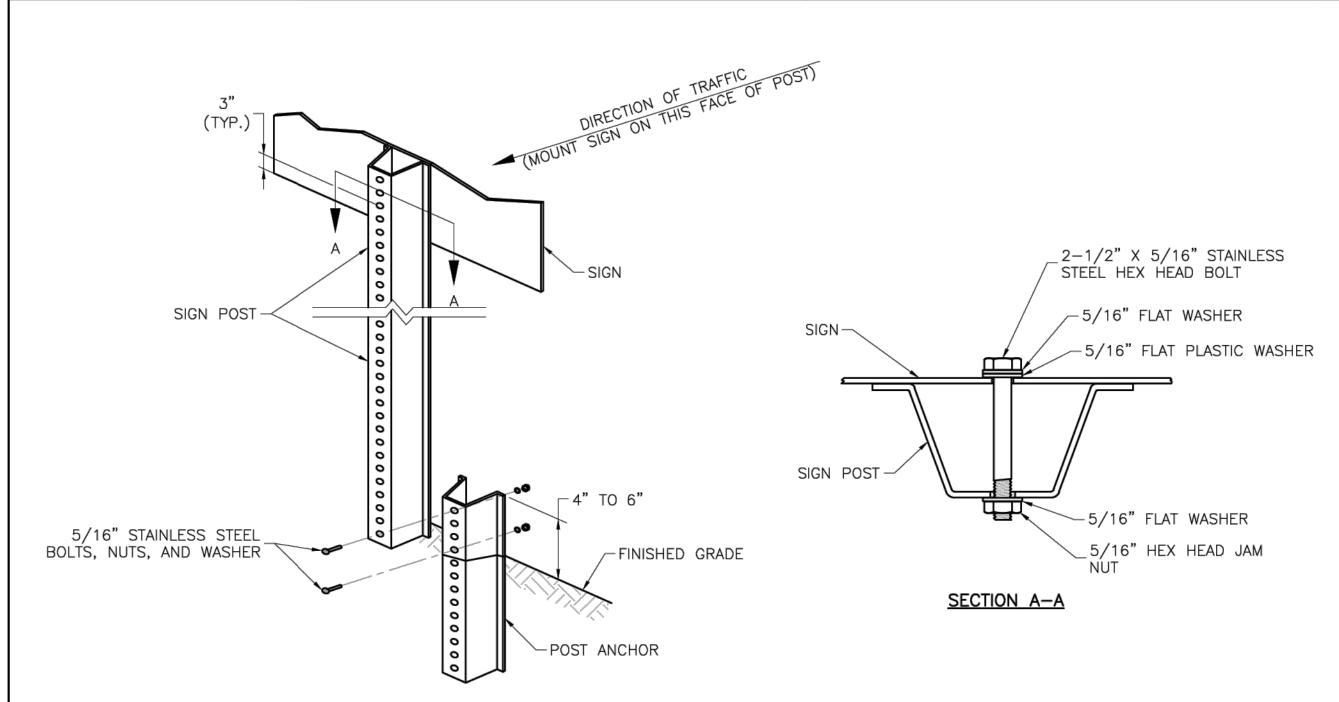
> C132 SHEET 036 OF 133



U-STEEL POST DETAILS

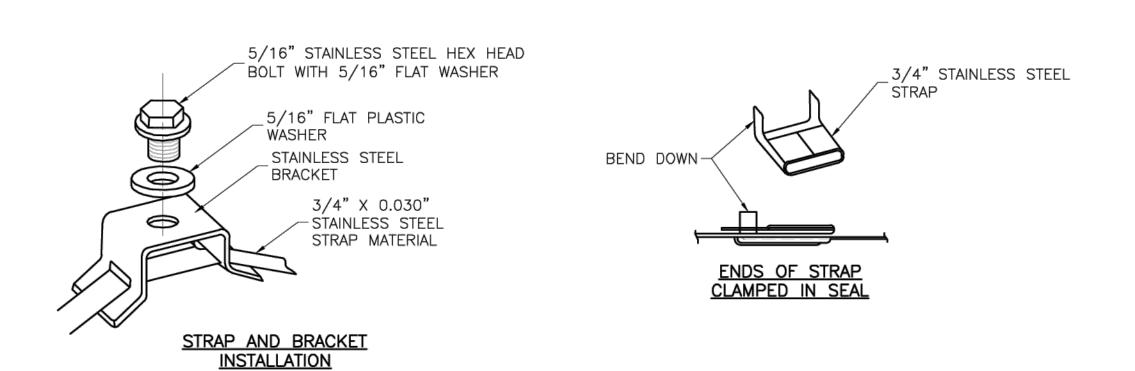- 1. SPLICE SHALL BE POSITIONED ENTIRELY BETWEEN FINISHED GRADE LINE AND 18" ABOVE FINISHED GRADE LINE. ONLY ONE SPLICE WILL BE ALLOWED PER POST.
- 2. U-STEEL POST SHALL BE 3 LB./FT., GALVANIZED ACCORDING TO ASTM
- 3. U-STEEL POST CAN BE USED FOR INSTALLATION OF SIGNS WITH AN AREA OF LESS THAN 2.5 SQUARE FEET.
- 4. ALL POSTS SHALL BE EMBEDDED A MINIMUM OF 3 FEET.



STRAP TYPE SIGN SUPPORT DETAILS

- 1. SIGNS ON METAL POLES SHALL BE ATTACHED WITH TWO BRACKETS AND STAINLESS STEEL BANDS
- 2. HOLES IN SIGN FOR ATTACHMENT TO THE MOUNTING BRACKETS SHALL BE OFFSET A MINIMUM OF 2 INCHES FROM THE EDGE OF THE SIGN.
- 3. HOLES IN SIGN SHALL BE LOCATED SUCH THAT THE SIGN IS LEVEL.
- 4. ALL STRAP, BRACKET, AND SEAL MATERIALS SHOULD BE TYPE 201 STAINLESS STEEL.

PERMANENT SIGNING GENERAL NOTES:

- 1. ALL SIGNING SHALL BE IN ACCORDANCE WITH THE LATEST EDITION OF THE MANUAL ON UNIFORM TRAFFIC CONTROL DEVICES (MUTCD)
- 2. THE CONTRACTOR IS RESPONSIBLE FOR AVOIDING ANY AND ALL UTILITIES WHEN INSTALLING SIGN POSTS, WHETHER THE UTILITY IS INDICATED ON THE PLANS OR NOT.
- 3. ALL WORKMANSHIP AND MATERIALS SHALL BE SUBJECT TO THE INSPECTION AND APPROVAL OF THE PUBLIC WORKS DEPARTMENT OF THE CITY OF LEE'S SUMMIT
- STAINLESS STEEL STRAPS OR WING BRACKETS AS DETAILED. NO SIGNS ARE TO BE INSTALLED ON WOOD POLES. SEE TRAFFIC SIGNAL STANDARD DRAWINGS FOR THE INSTALLATION OF SIGNS ON MAST ARMS.
- 6. ALL POST MOUNTED SIGNS SHALL BE INSTALLED WITH BREAKAWAY ANCHORS ACCORDING TO
- 7. ALL EXISTING SIGNS WILL BE USED IN PLACE DURING CONSTRUCTION AND PROTECTED FROM DAMAGE UNLESS OTHERWISE INDICATED IN THE PLANS. IF THE CONTRACTOR DAMAGES ANY EXISTING SIGN OR POSTS DURING CONSTRUCTION, THE CONTRACTOR WILL BE REQUIRED TO REPLACE THE DAMAGED MATERIALS WITH NEW SIGNS OR POSTS AT THE CONTRACTOR'S EXPENSE. THE CONTRACTOR SHALL BE RESPONSIBLE FOR REMOVING AND STORING ANY SIGNS THAT ARE TO BE REINSTALLED ON THE PROJECT. ALL EQUIPMENT SHALL BE REINSTALLED IN GOOD CONDITION.
- 8. EXISTING PERMANENT SIGNS AND POSTS REMOVED BY THE CONTRACTOR FOR CONSTRUCTION PURPOSES WHICH ARE NOT TO BE REINSTALLED SHALL BE DELIVERED TO THE CITY'S PUBLIC WORKS MAINTENANCE FACILITY (1971 SE HAMBLEN ROAD). THE CONTRACTOR SHALL BE RESPONSIBLE FOR REMOVING AND STORING EQUIPMENT IN GOOD CONDITION AND IS FULLY RESPONSIBLE FOR THE EQUIPMENT UNTIL IT IS DELIVERED.
- 9. ALL STOP, YIELD, OR STREET NAME SIGNS SHALL BE MAINTAINED IN A CONSPICUOUS LOCATION FOR THE DRIVING PUBLIC. ALL STOP AND YIELD SIGNS REMOVED FOR CONSTRUCTION PURPOSES CAN BE TEMPORARILY ERECTED IN REFLECTORIZED DRUMS (NO LESS THAN 7 FEET ABOVE THE PAVEMENT SURFACE) UNTIL THEY CAN BE REINSTALLED. ANY TEMPORARY STOP OR YIELD SIGN INSTALLATION TO BE LEFT IN PLACE OVERNIGHT WILL REQUIRE PRIOR APPROVAL FROM THE CITY INSPECTOR.

SQUARE STEEL POST INSTALLATION SEQUENCE:

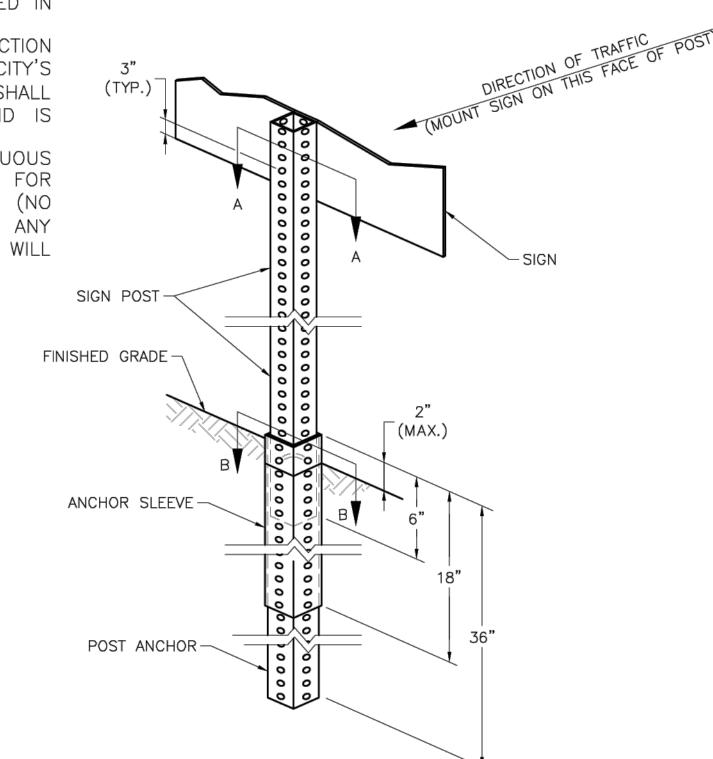
PLACE.

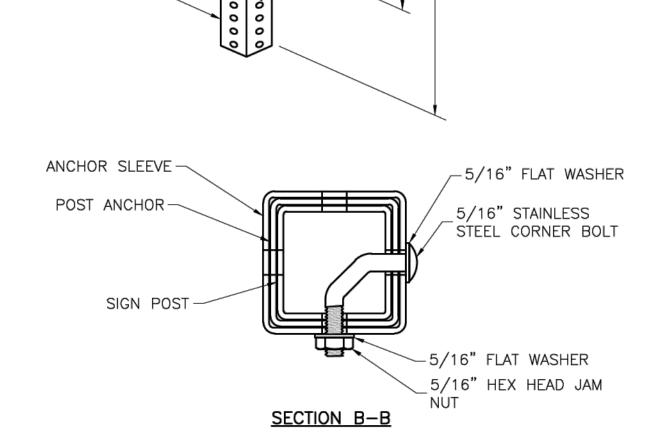
1. SIGN POST ANCHOR DRIVEN PARTIALLY INTO THE GROUND USING A DRIVE CAP WITH A SLEDGE OR POWER EQUIPMENT 2. ANCHOR SLEEVE SLIPPED OVER ANCHOR AND DRIVE INTO THE GROUND TOGETHER WITH THE SIGN POST ANCHOR. 3. INSERT SIGN POST INTO THE POST ANCHOR AND BOLT IN

_2-1/2" X 5/16" STAINLESS STEEL HEX HEAD BOLT

-5/16" FLAT WASHER

5/16" FLAT PLASTIC





-5/16" FLAT WASHER 5/16" HEX HEAD JAM CORNER BOLT

SQUARE STEEL POST DETAILS

NOTES:

- 1. SQUARE STEEL SIGN POSTS AND BREAK-AWAY ANCHOR SHALL CONSIST OF THE FOLLOWING MATERIALS: SIGN POST - 14 GA. 2" X 2" SQUARE STEEL POST
 - POST ANCHOR 12 GA. 2 1/4" X 2 1/4" X 36" SQUARE STEEL POST
- 2. 14 GA. POSTS MUST MEET A CERTIFIED MINIMUM YIELD STRENGTH OF 60,000 PSI.
- 4. THE MAXIMUM AREA FOR ONE SIGN POST IS 9.0 SQUARE FEET. A SIGN OR COMBINATION OF SIGNS WITH AN AREA GREATER THAN 9.0 SQUARE FEET WILL REQUIRE TWO POSTS. ALSO, SIGNS WITH A WIDTH GREATER THAN OR EQUAL TO 48" (NOT INCLUDING 36" X 36" DIAMOND SHAPED SIGNS) WILL REQUIRE TWO POSTS.

STANDARD DETAILS CITY OF LEE'S SUMMIT, N S SUMMIT, JACKSON COUN

rawn By: BWC

hecked By: MP

SN-2

oate: 01/2020

BOLLINGER PE-2021009173

CMT

ERMINAL 7932172

1627 MAIN STREET, SUITE 600 KANSAS CITY, MO 64108

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LEE'S SUMMIT MUNICIPAL AIRPORT LEE'S SUMMIT, MO

MARK | DATE | DESCRIPTION

DRAWN BY: WLC CHECKED BY: PHN APPROVED BY: BB

DESIGNED BY: WLC

PROJECT NO: 17932172

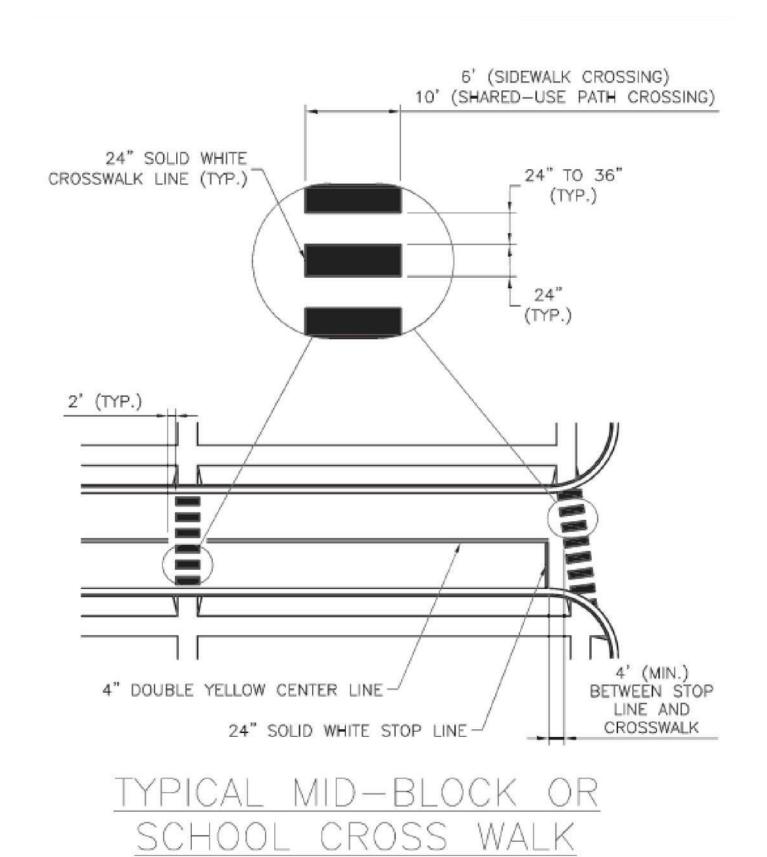
MARKING AND SIGNAGE DETAIL 2 OF 3

CAD DWG FILE: MARKING AND SIGNAGE DETAIL SHEET

C133 SHEET 037 OF 133


NOTES:

- ALL ARROW AND SYMBOL MARKINGS SHALL BE WHITE, AND SHALL BE CENTERED IN THEIR RESPECTIVE TRAFFIC LANES.
- RIGHT-TURN AND COMBINATION RIGHT-TURN/STRAIGHT ARROWS ARE REVERSE OF ARROWS SHOWN.




PAVEMENT MARKING GENERAL NOTES:

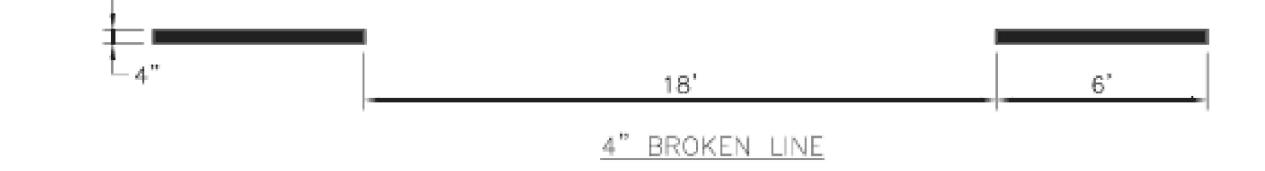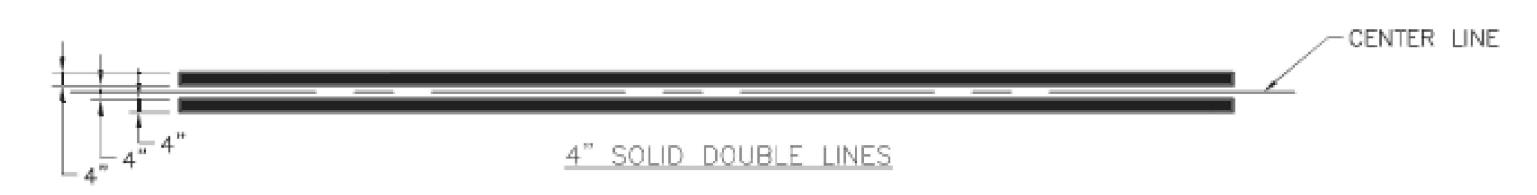- ALL PAVEMENT MARKINGS SHALL BE IN ACCORDANCE WITH THE LATEST EDITION OF THE MANUAL ON UNIFORM TRAFFIC CONTROL DEVICES (MUTCD).
- 2. ALL WORDS AND SYMBOLS SHALL CONFORM TO THE LATEST EDITION OF <u>STANDARD ALPHABETS FOR HIGHWAY SIGNS AND PAVEMENT MARKINGS</u> PRINTED BY THE U.S. DEPARTMENT OF TRANSPORTATION, FEDERAL HIGHWAY ADMINISTRATION.
- 3. PAVEMENT MARKINGS, EITHER TEMPORARY OR PERMANENT ARE REQUIRED AT ALL TIMES IF THE ROADWAY IS OPEN TO TRAFFIC.
- 4. ALL PAVEMENT MARKINGS THAT CONFLICT WITH THE DESIRED MARKINGS SHALL BE COMPLETELY REMOVED. REMOVALS SHALL NOT LEAVE THE ROAD SURFACE SCARRED WITH AN IMAGE THAT MISLEADS TRAFFIC. ANY EXCESS DAMAGE OR SCARRING OF PAVEMENT SHALL BE REPAIRED AT THE CONTRACTOR'S EXPENSE.
- 5. THE PROPOSED PERMANENT MARKINGS SHALL BE LAID OUT BY THE CONTRACTOR IN ADVANCE OF THE MARKING INSTALLATION. MARKINGS SHALL NOT BE APPLIED UNTIL THE LAYOUT HAS BEEN APPROVED BY THE CITY TRAFFIC ENGINEER.
- 6. CENTER LINES SHALL BE MARKED ON ALL UNDIVIDED ARTERIAL STREETS, AND ANY OTHER UNDIVIDED STREET WITH MORE THAN TWO LANES AND/OR A SPEED LIMIT OF 30 MPH OR MORE.
- 7. EDGE LINES SHALL BE MARKED ON ALL NON-CURBED STREETS.








TYPICAL LINE DETAILS

NOTES:

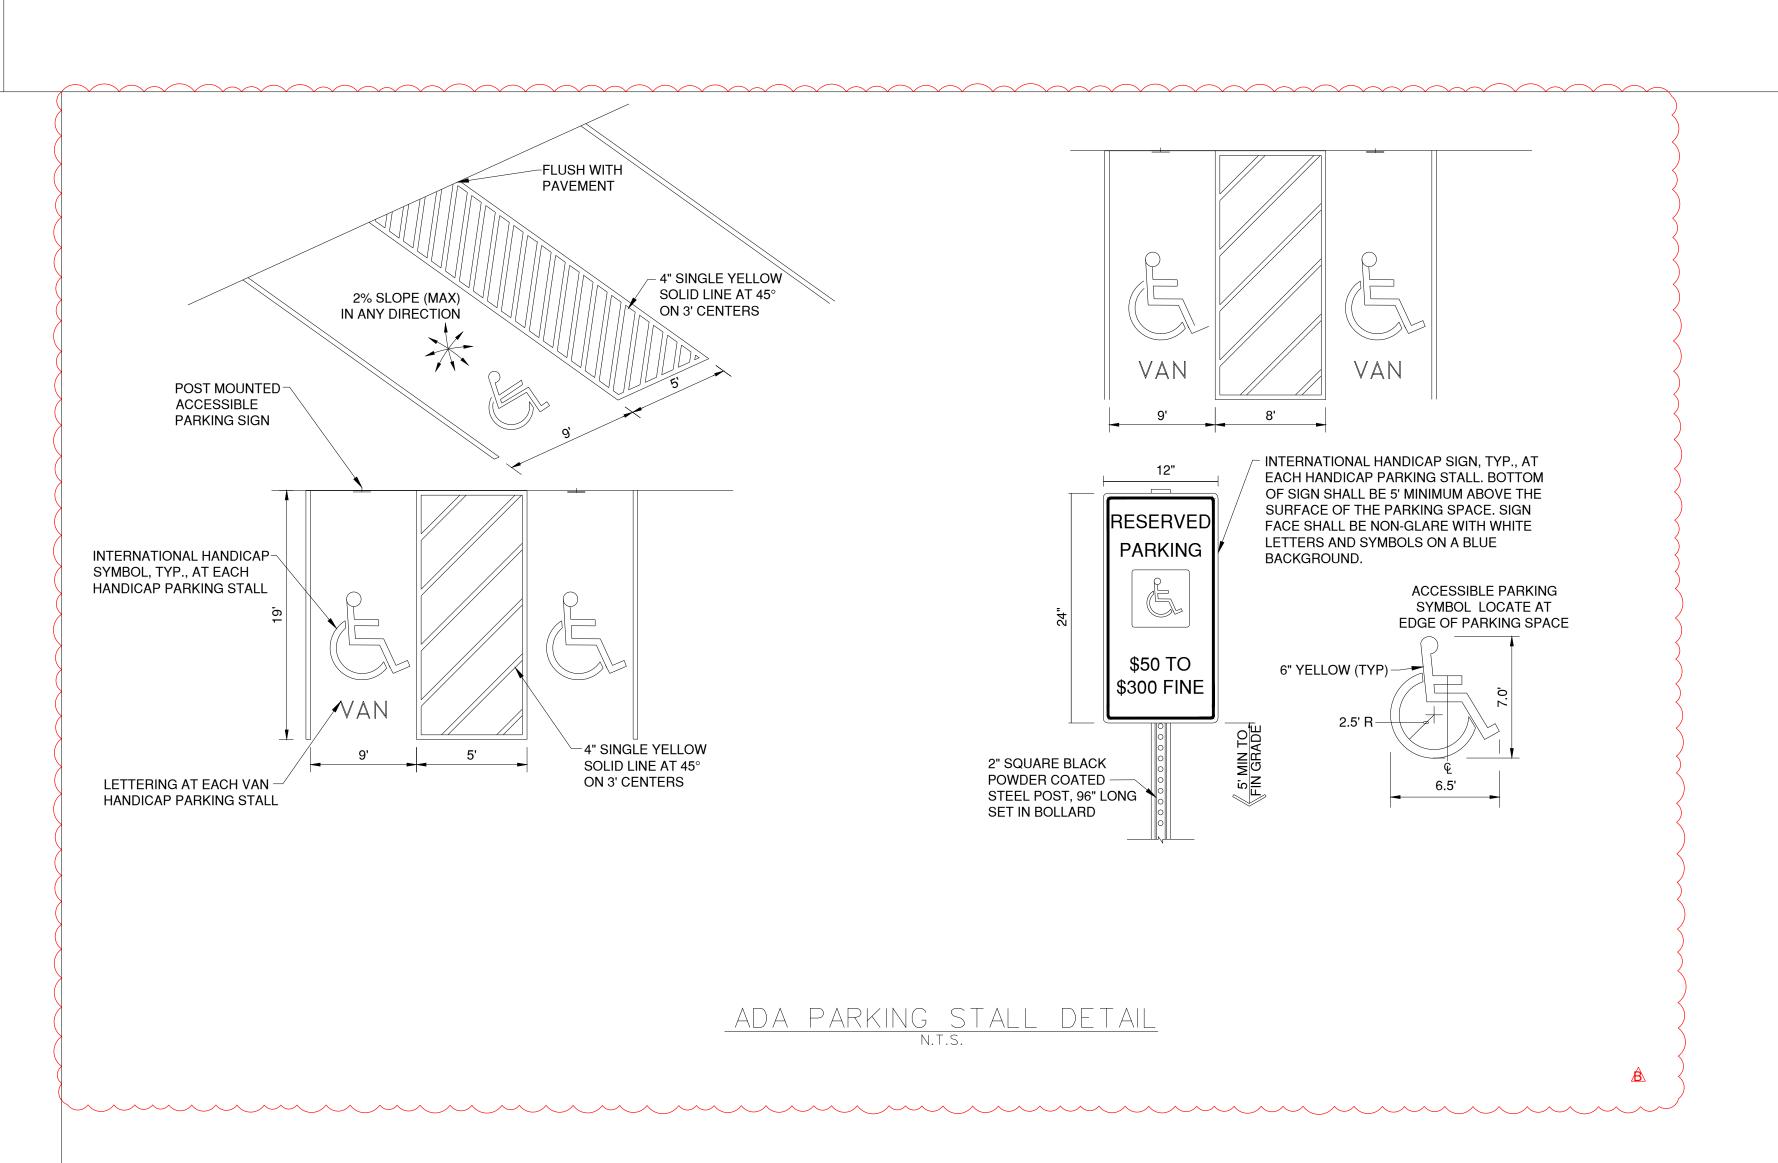- ALL EDGE LINE, CENTER LINE, AND LANE LINE PAVEMENT MARKINGS SHALL BE 4".
 WIDE UNLESS OTHERWISE NOTED.
- EDGE LINES SHALL BE CONTINUOUS SOLID WHITE OR YELLOW LINES. RIGHT SIDE EDGE LINES SHALL BE SOLID WHITE. MEDIAN OR LEFT SIDE EDGE LINES ON DIVIDED ROADWAYS ARE TO BE SOLID YELLOW. EDGE LINES AND CENTER LINES SHALL BE CONTINUOUS ACROSS DRIVEWAYS.





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RPORT

SUMMIT

GENERAL AVIATION TERMINAL CITY PROJECT NO. - 17932172

GERALD
BOLLINGER
Serall T. Bollinger
NUMBER
PE-2021009173

LEE'S SUMMIT MUNICIPAL AIRPORT LEE'S SUMMIT, MO

MARK DATE DESCRIPTION

PROJECT NO: 17932172

CAD DWG FILE: MARKING AND SIGNAGE DETAIL SHEET


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CHECKED BY: PHN
APPROVED BY: BB

SHEET TITLE

MARKING AND SIGNAGE DETAIL 3 OF 3

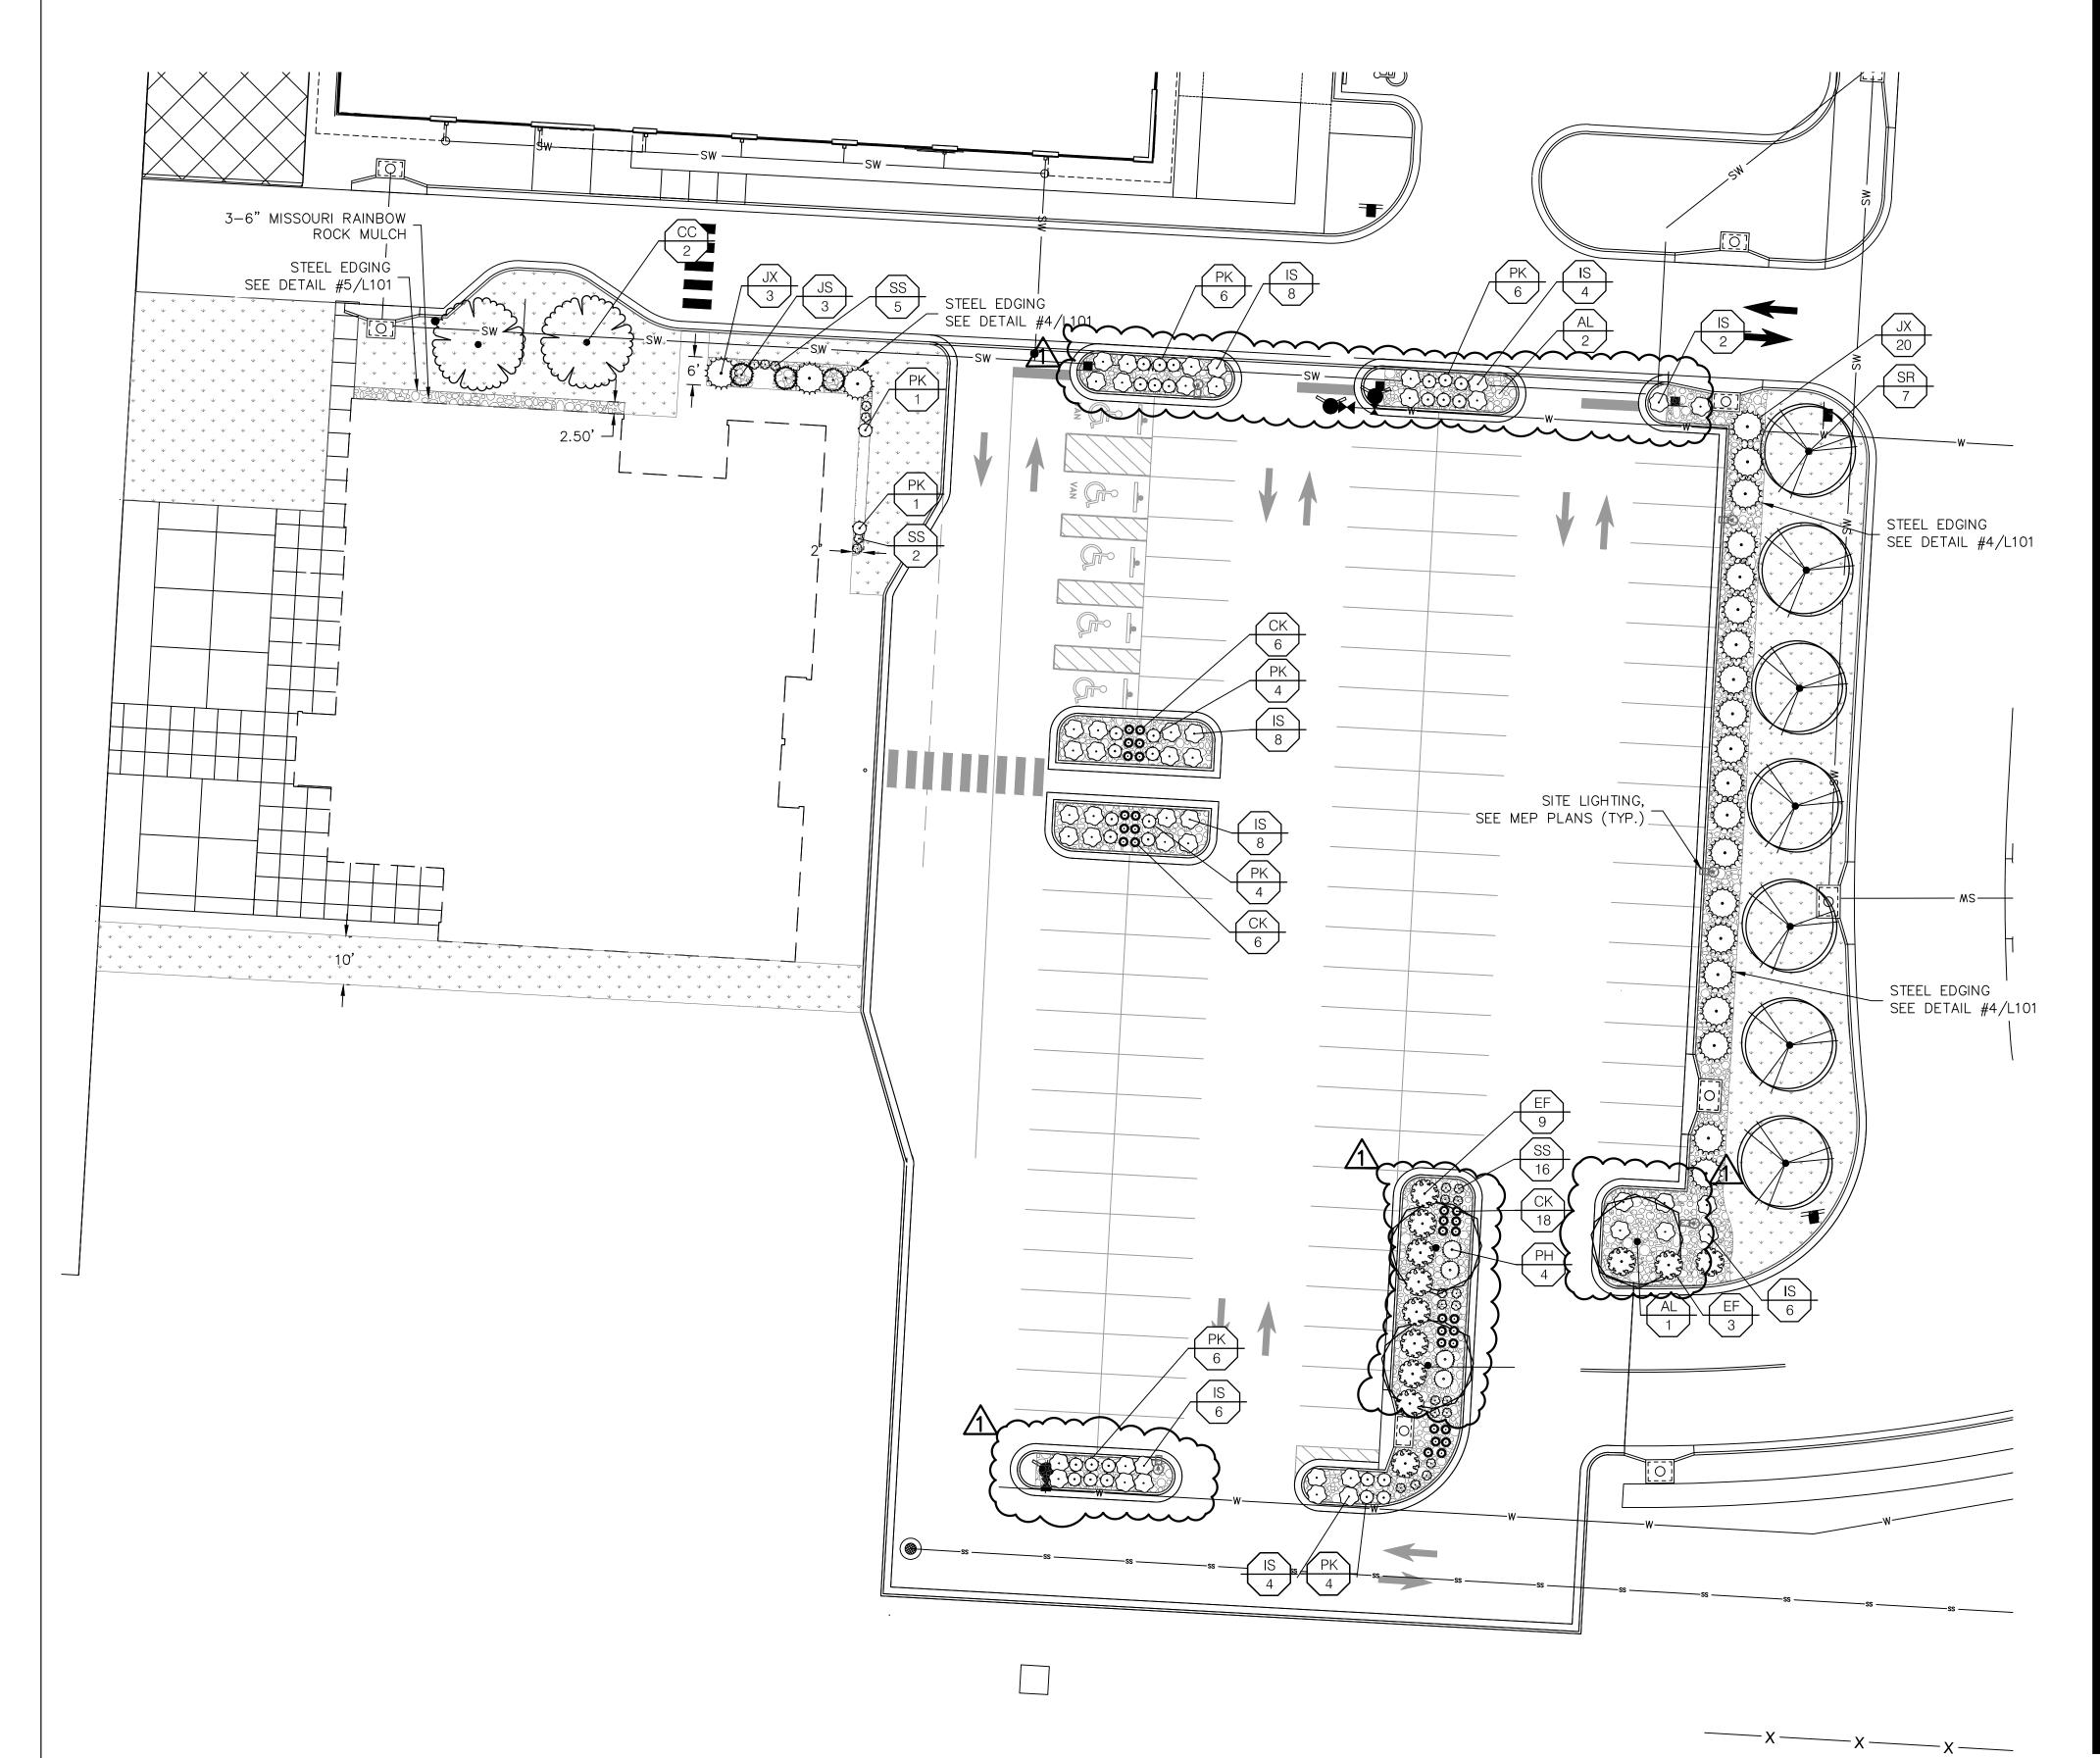C134
SHEET 038 OF 133



LEE'S SUMMIT AIRPORT TERMINAL- LANDSCAPE CALCULATIONS

BUILDING COVERAGE (SF)	PARKING SPACES	LANDSCAPE ISLANDS AREA (SF)	PARKING LOT AREA (SF)	PARKING AREA LANDSCAPE ISLAND % (5% MIN.)	R/W LENGTH (LF)		(1) LANDSCAPE STRIP BETWEEN PARKING/LOADING AREA AND R/W	(1) STREET FRONTAGE TREES	(2) STREET FRONTAGE SHRUBS	(3) OPEN YARD AREA PROVIDED (SF)	(3A) OPEN YARD AREA TREES	(3B) OPEN YARD AREA SHRUBS	(4A) BUFFER TREES: DECIDUOUS / ORNAMENTAL / EVERGREEN	(4B) BUFFER SHRUBS	(5) PARKING LOT SCREENING SHRUBS
11,000	107	2,927	31,845	9.19%	N/A	REQUIRE	N/A	N/A	N/A	14,259	3	6	N/A	N/A	14
11,500	107	2,321	51,045	3.1970	IN/A	PROVIDE	N/A	N/A	N/A	14,209	3+	6+	N/A	N/A	14+

LANDSCAPE REQUIREMENTS DESCRIPTIONS (1) ANY PARKING OR LOADING AREA VISIBLE FROM A STREET SHALL BE SEPARATED FROM THE STREET RIGHT-OF-WAY WITH A LANDSCAPE STRIP AT LEAST 20' WIDE, PLANTED WITH 1 TREE PER 30 LF OF STREET

(2) ANY PARKING OF LOADING AREA LANDSCAPE STRIP SHALLL BE PLANTED WITH ONE (1) SHRUB FOR EVERY 20 LF OF STREET FRONTAGE.

(3A) IN ADDITION TO STREET FRONTAGE TREES, ONE (1) TREE SHALL BE PROVIDED FOR EVERY 5,000 SF OF OPEN YARD AREA

(3B) OPEN YARD AREAS SHALL BE LANDSCAPED WITH TWO (2) SHRUBS PER 5,000 SF OF TOTAL LOT AREA (4) A 20' WIDE BUFFER SCREEN SHALL BE PROVIDED PER PLAN, IN THE FORM OF (4A) 1 SHADE TREE PER 1,000 SF; 1 ORNAMENTAL TREE PER 500 SF; 1 EVERGREEN TREE PER 500; AND (4B) 1 SHRUB PER 500 SF

(5) A HEDGE CONSISTING OF AT LEAST 12 SHRUBS PER 40 LINEAR FEET


PLANT SCHEDULE

SYMBOL	CODE	QTY	BOTANICAL / COMMON NAME	SIZE	CONTAINER
1REES	~~~	~~~~	······································	·····	· · · · · · · · · · · · · · · · · · ·
	AL	3	ACER GINNALA 'BERGIANA FLAME' BERGIANA FLAME AMUR MAPLE	3" CAL	B&B
	CC	2	CORNUS FLORIDA 'CHEROKEE BRAVE' CHEROKEE BRAVE DOGWOOD	2" CAL	B&B
A CHARLES TO THE CONTROL OF THE CONT	JS	3	JUNIPERUS CHINENSIS 'SPARTAN' SPARTAN JUNIPER	6`-8` HT	B&B
	SR	7	SYRINGA RETICULATA JAPANESE TREE LILAC	3" CAL	B&B
SYMBOL	CODE	QTY	BOTANICAL / COMMON NAME	SIZE	CONDITION
SHRUBS					
5 - 5 - 5 - 5 - 5 - 5 - 5 - 5 - 5 - 5 -	EF	12	EUONYMUS FORTUNEI WINTERCREEPER	3 GAL	
•	IS	46	ILEX GLABRA `ILEXFARROWTRACEY` STRONGBOX® INKBERRY HOLLY	3 GAL	
•	JX	23	JUNIPERUS X 'GREY OWL' GREY OWL JUNIPER	3 GAL	
	PK	32	PHYSOCARPUS OPULIFOLIUS 'SMPOTW' TINY WINE TINY WINE NINEBARK	3 GAL	
GRASSES					
37000	CK	30	CALAMAGROSTIS X ACUTIFLORA 'KARL FOERSTER' KARL FOERSTER FEATHER REED GRASS	2 GAL	
	PH	4	PANICUM VIRGATUM 'HEAVY METAL' HEAVY METAL SWITCH GRASS	2 GAL	
	SS	23	SCHIZACHYRIUM SCOPARIUM 'THE BLUES' THE BLUES LITTLE BLUESTEM	2 GAL	
GROUND CO	OVERS				
	MR	4,565 SF	3 - 6" MISSOURI RAINBOW ROCK	N/A	
\(\psi\) \(\psi\) \(\psi\) \(\psi\)	TS	11,879 SF	TURF SOD DROUGHT TOLERANT FESCUE BLEND	SOD	

- 1. ALL DISTURBED AREA NOT OTHERWISE SPECIFIED WITH GROUNDCOVER SHALL BE PLANTED WITH TURF SEED DROUGHT TOLERANT
- 2. PLANTING BEDS AND TREE PLANTING AREAS SHALL RECEIVE MISSOURI RAINBOW ROCK AT A DEPTH OF 3" WITH SHOVEL—CUT EDGE OR V—TRENCH STEEL EDGING AS CALLED OUT ON PLAN.
- 3. AREAS OF TURF SEED PLANTED ON SLOPES EXCEEDING 4:1 (SEE GRADING PLANS) SHALL BE INSTALLED WITH AN EROSION
- CONTROL MEASURERS PER MANUFACTURER'S SPECIFICATIONS.
- 4. QUANTITIES LISTED IN THE PLANT LIST SCHEDULE ARE FOR ESTIMATES ONLY. TREES, SHRUBS, AND GROUND COVER OF CONTRACT QUANTITIES SHALL BE THE NUMBER OF ITEMS SHOWN ON THE DRAWINGS. LANDSCAPE CONTRACTOR IS RESPONSIBLE FOR VERIFYING ALL QUANTITIES SHOWN ON THESE PLANS BEFORE PRICING THE WORK. ANY DIFFERENCE IN QUANTITIES SHOULD BE BROUGHT TO THE ATTENTION OF THE LANDSCAPE ARCHITECT FOR CLARIFICATION.
- CONTRACTOR SHALL REFER TO ENGINEERING DRAWINGS FOR ANY AND ALL EXISTING AND/OR PROPOSED UTILITIES. IF THERE ARE ANY DISCREPANCIES, CONFLICTS AND/OR DEVIATIONS BETWEEN THE LANDSCAPE DRAWINGS AND THE EXISTING OR PROPOSED CONDITIONS, THE CONTRACTOR IS TO CONTACT THE LANDSCAPE ARCHITECT IMMEDIATELY.
- ALL UNDERGROUND UTILITIES ARE TO BE FIELD-VERIFIED PRIOR TO COMMENCEMENT OF WORK. LANDSCAPE CONTRACTOR SHALL SUBMIT SPECIFICATIONS OF SEED, SOIL, AND MULCH, AND REPRESENTATIVE PHOTOS OF TREES AND
- SHRUBS, TO LANDSCAPE ARCHITECT FOR REVIEW AND ACCEPTANCE PRIOR TO COMMENCEMENT OF WORK. SUBSTITUTIONS MUST BE APPROVED BY LANDSCAPE ARCHITECT. 9. INSTALLATION OF LANDSCAPING SHALL TAKE PLACE DURING EITHER THE SPRING (MARCH 15 - JUNE 15) OR FALL (SEPTEMBER
- 15-DECEMBER 1) PLANTING SEASON AND WITH WATER AVAILABLE FOR IRRIGATION PURPOSES. 10. IF UNDERGROUND OBSTRUCTIONS ARE ENCOUNTERED IN EXCAVATION FOR PLANTING OF TREES OR SHRUBS, NOTIFY LANDSCAPE ARCHITECT IMMEDIATELY. NEW LOCATIONS MAY BE SELECTED BY LANDSCAPE ARCHITECT OR INSTRUCTIONS MAY BE ISSUED TO
- DIRECT REMOVAL OF OBSTRUCTIONS. PROCEED WITH WORK ONLY AFTER APPROVAL OF LANDSCAPE ARCHITECT. 11. LANDSCAPE CONTRACTOR SHALL REMOVE ALL CONSTRUCTION DEBRIS AND MATERIALS INJURIOUS TO PLANT GROWTH FROM PLANTING

ACCEPTANCE. CONTRACTOR WILL MAKE ALL REPLACEMENTS PROMPTLY UNDER THIS GUARANTEE (AS PER DIRECTION OF OWNER).

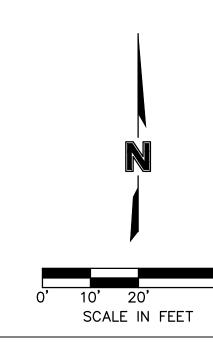- PITS AND BEDS PRIOR TO BACKFILLING WITH PLANTING MIX. 12. A PRE-EMERGENT HERBICIDE SHALL BE APPLIED TO ALL PLANTING BEDS PRIOR TO THE INSTALLATION OF ANY PLANT MATERIAL.
- 13. AMEND SOIL IN PLANTING BEDS TO A DEPTH OF 12 INCHES USING A 1:1 MIX OF ON-SITE SOIL AND ORGANIC-RICH COMPOST.
- ENSURE THOROUGH MIXING FOR OPTIMAL NUTRIENT DISTRIBUTION AND SOIL STRUCTURE IMPROVEMENT. 14. LANDSCAPE CONTRACTOR IS RESPONSIBLE FOR WATERING AND GENERAL HEALTH OF ALL PLANT MATERIALS UNTIL FINAL
- ACCEPTANCE. ANY MATERIAL WHICH DIES PRIOR TO ACCEPTANCE OF WORK SHALL BE PROMPTLY REMOVED AND REPLACED.
- 15. LANDSCAPE BEDS SHALL BE FREE OF WEEDS AND VOLUNTEER PLANT MATERIAL. 16. LANDSCAPE CONTRACTOR SHALL COMPLETELY GUARANTEE ALL WORK FOR A PERIOD OF ONE YEAR BEGINNING AT THE DATE OF





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1301 BURLINGTON STREET NORTH KANSAS CITY, MO 64116



LEES SUMMIT MUNICIPAL AIRPORT

LEES SUMMIT, MO

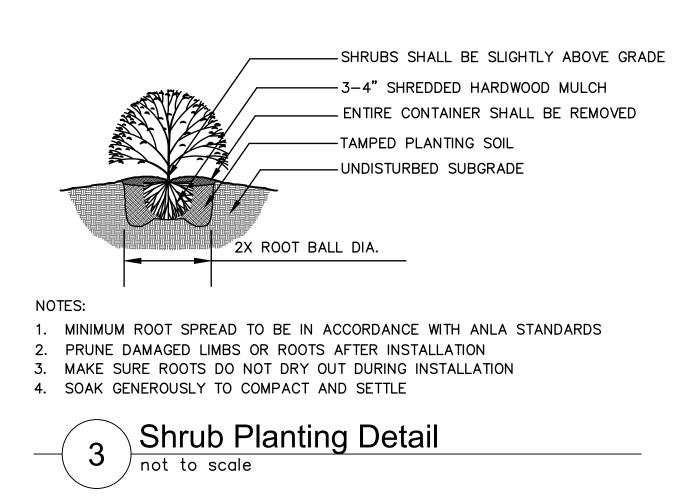
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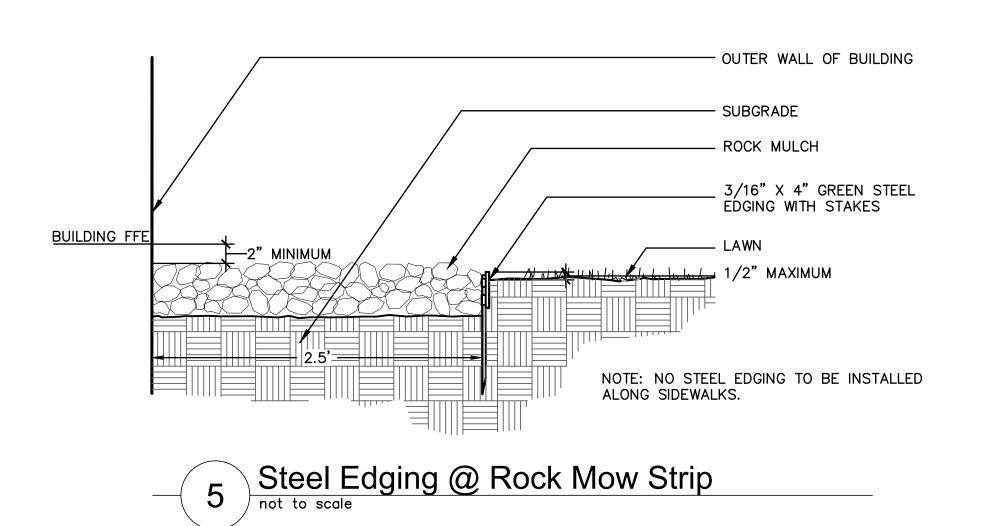
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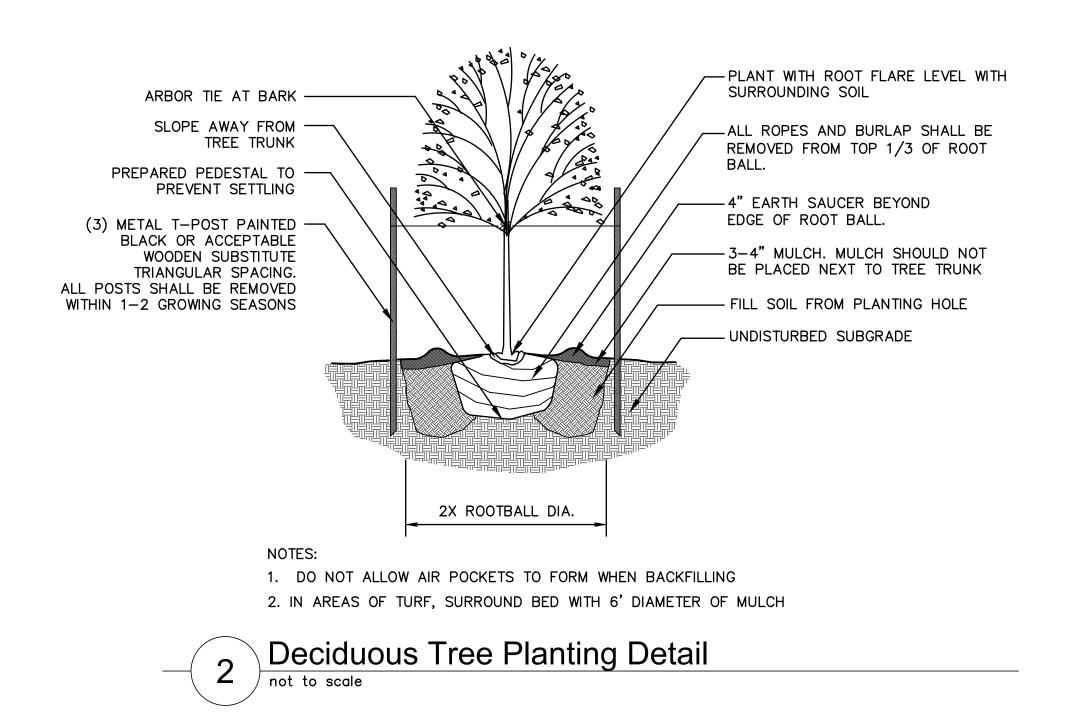
LANDSCAPE PLAN


1 Evergreen Tree Planting Detail

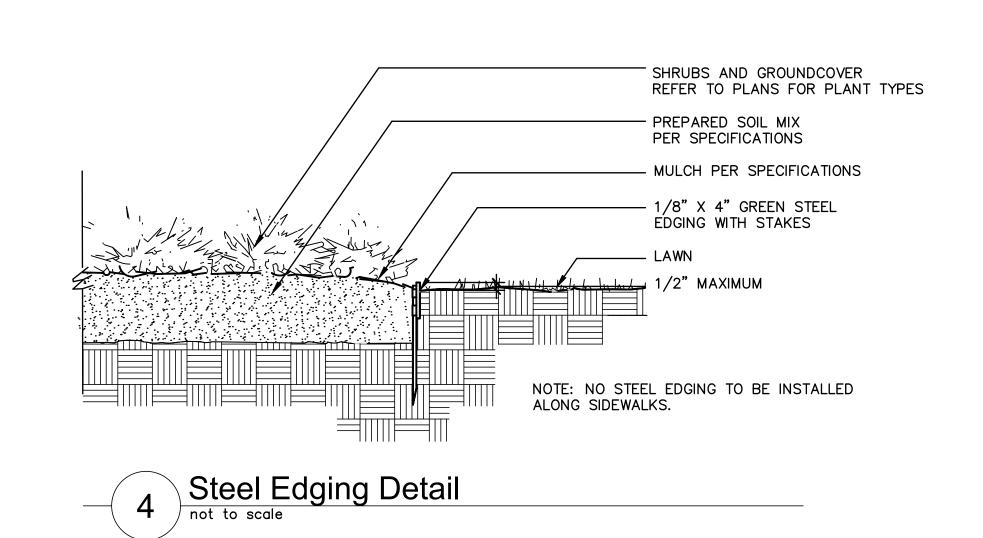2. IN AREAS OF TURF, SURROUND BED WITH 6' DIAMETER OF MULCH











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10/22/2024

LEES SUMMIT MUNICIPAL AIRPORT LEES SUMMIT, MO


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CAD	WG FILI	E: Lee's Summit - Hangar 2.DWG
DESIG	NED BY	r: QEM


DRAWN BY: QEM CHECKED BY: JIH APPROVED BY: JIH COPYRIGHT 2024

SHEET TITLE

LANDSCAPE **DETAILS**

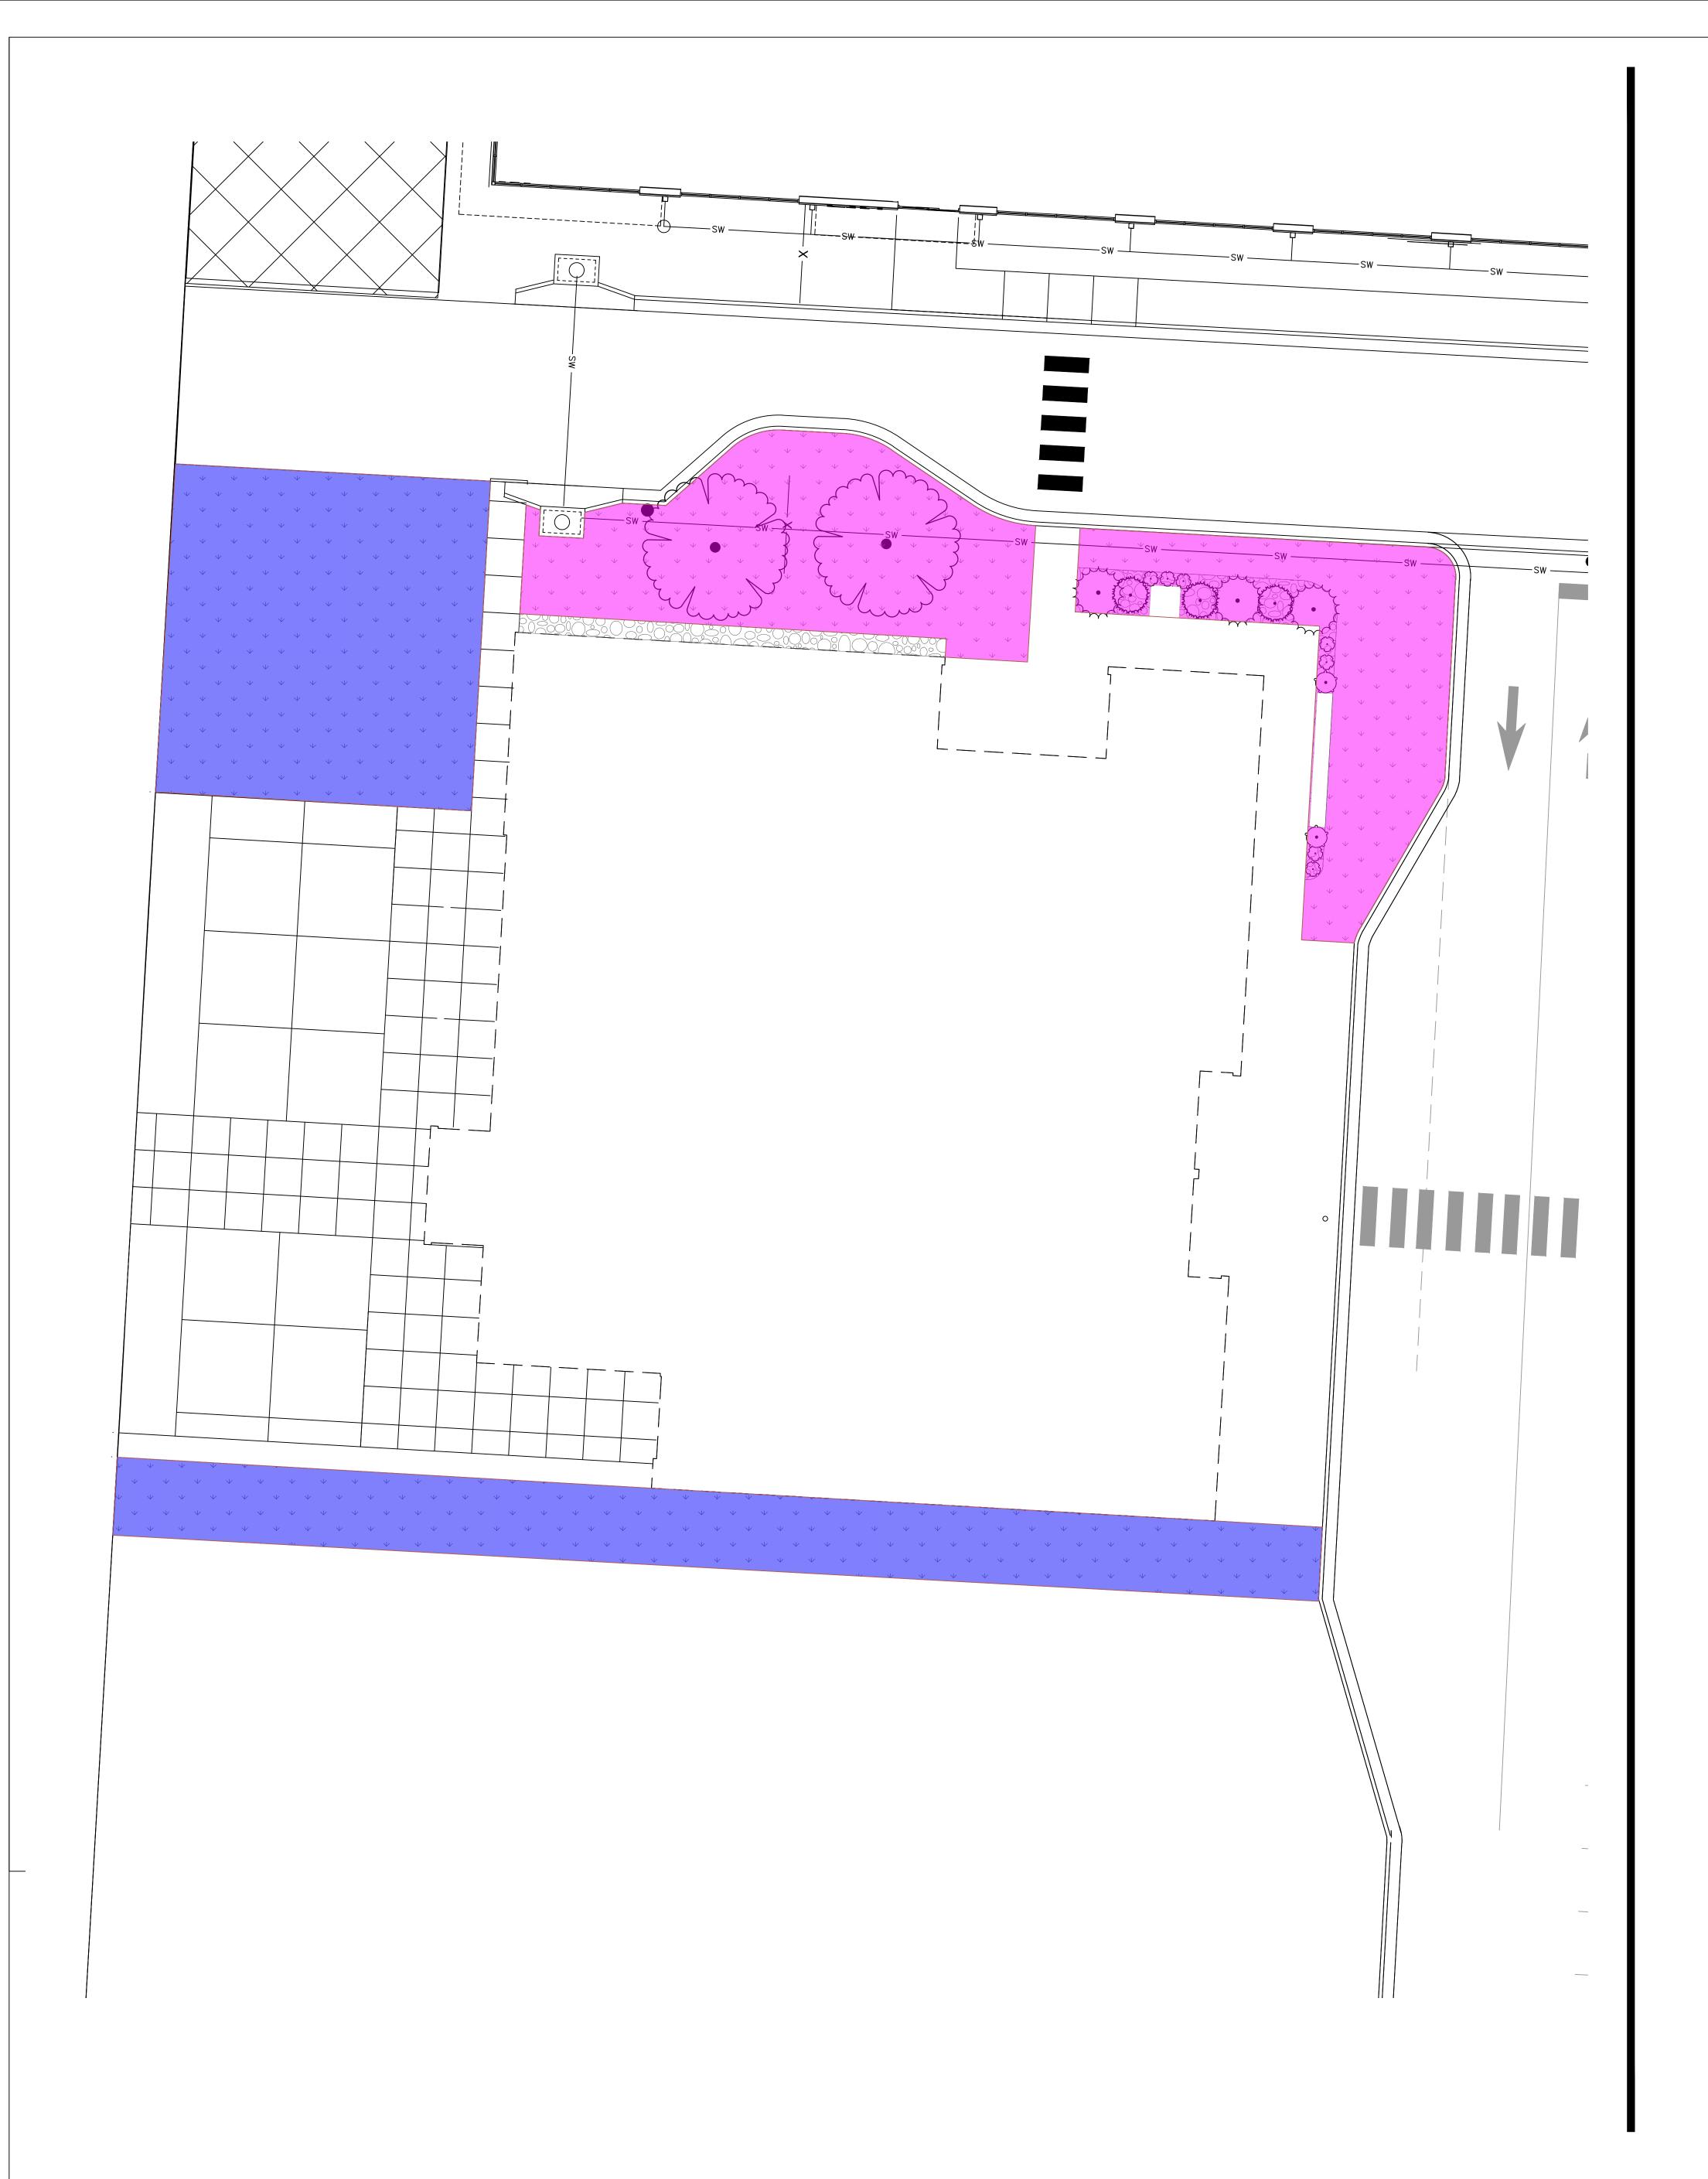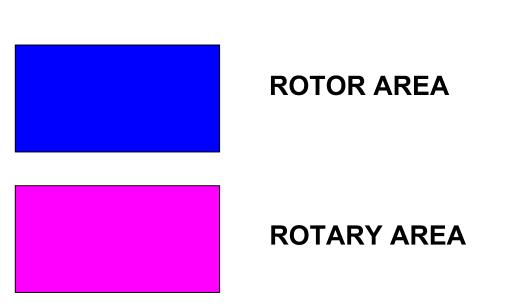L101





NOTES

- 1. ALL MATERIALS AND WORKMANSHIP SHALL BE TRUE TO TYPE, FORM, FINISH AND OF THE HIGHEST STANDARDS OF THE TRADE. DAMAGED OR INFERIOR MATERIALS SHALL BE REMOVED FROM THE SITE WITHOUT DELAY. CONTRACTOR SHALL FURNISH AND INSTALL MATERIAL AND EQUIPMENT PERTAINING TO THE IRRIGATION SYSTEM. THIS SHALL INCLUDE ALL ITEMS OF A MINOR NATURE NECESSARY TO COMPLETE INSTALLATION.
- 2. IF THE CONTRACT DRAWINGS AND/OR SPECIFICATIONS DO NOT THOROUGHLY DESCRIBE THE METHOD OR TECHNIQUES TO BE USED, THEN THE CONTRACTOR SHALL INSTALL AS PER MANUFACTURERS SPECIFICATIONS. IF A CONTRADICTION OCCURS, NOTIFY THE LANDSCAPE
- 4. MANUAL GATE VALVES SHALL BE PORTED TO PROVIDE FOR FULL FLOW. GATE VALVES SHALL BE THE SAME SIZE AS THE MAINLINE AND LABELED PER SPECIFICATIONS.
- 5. WINTERIZATION: A MANUAL DRAIN VALVE IS TO BE INSTALLED AT THE END OF THE LINES AND LOW POINTS OF IRRIGATION PIPING. PRIOR TO FIRST FREEZE, SHUT OFF IRRIGATION WATER SUPPLY AND OPEN MANUAL DRAIN VALVES. REMEMBER TO CLOSE VALVES ONCE WATER HAS DRAINED.
- 6. ALL VALVES ARE TO INCLUDE FACTORY INSTALLED DC LATCHING
- SOLENOIDS AND DECODERS FOR THIS TWO-WIRE SYSTEM.
- 7. CONTRACTOR TO REDUCE THROW OF HEADS NO MORE THAN 25% TO ELIMINATE OVERTHROW ON WALKWAYS.
- 8. SUBMIT IRRIGATION DESIGN SHOP DRAWING TO LANDSCAPE ARCHITECT FOR APPROVAL PRIOR TO INSTALLATION.



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MARK DATE DESCRIPTION

PROJECT NO: 024-05133 CAD DWG FILE: Lee's Summit - Hangar 2.DWG DESIGNED BY: QEM

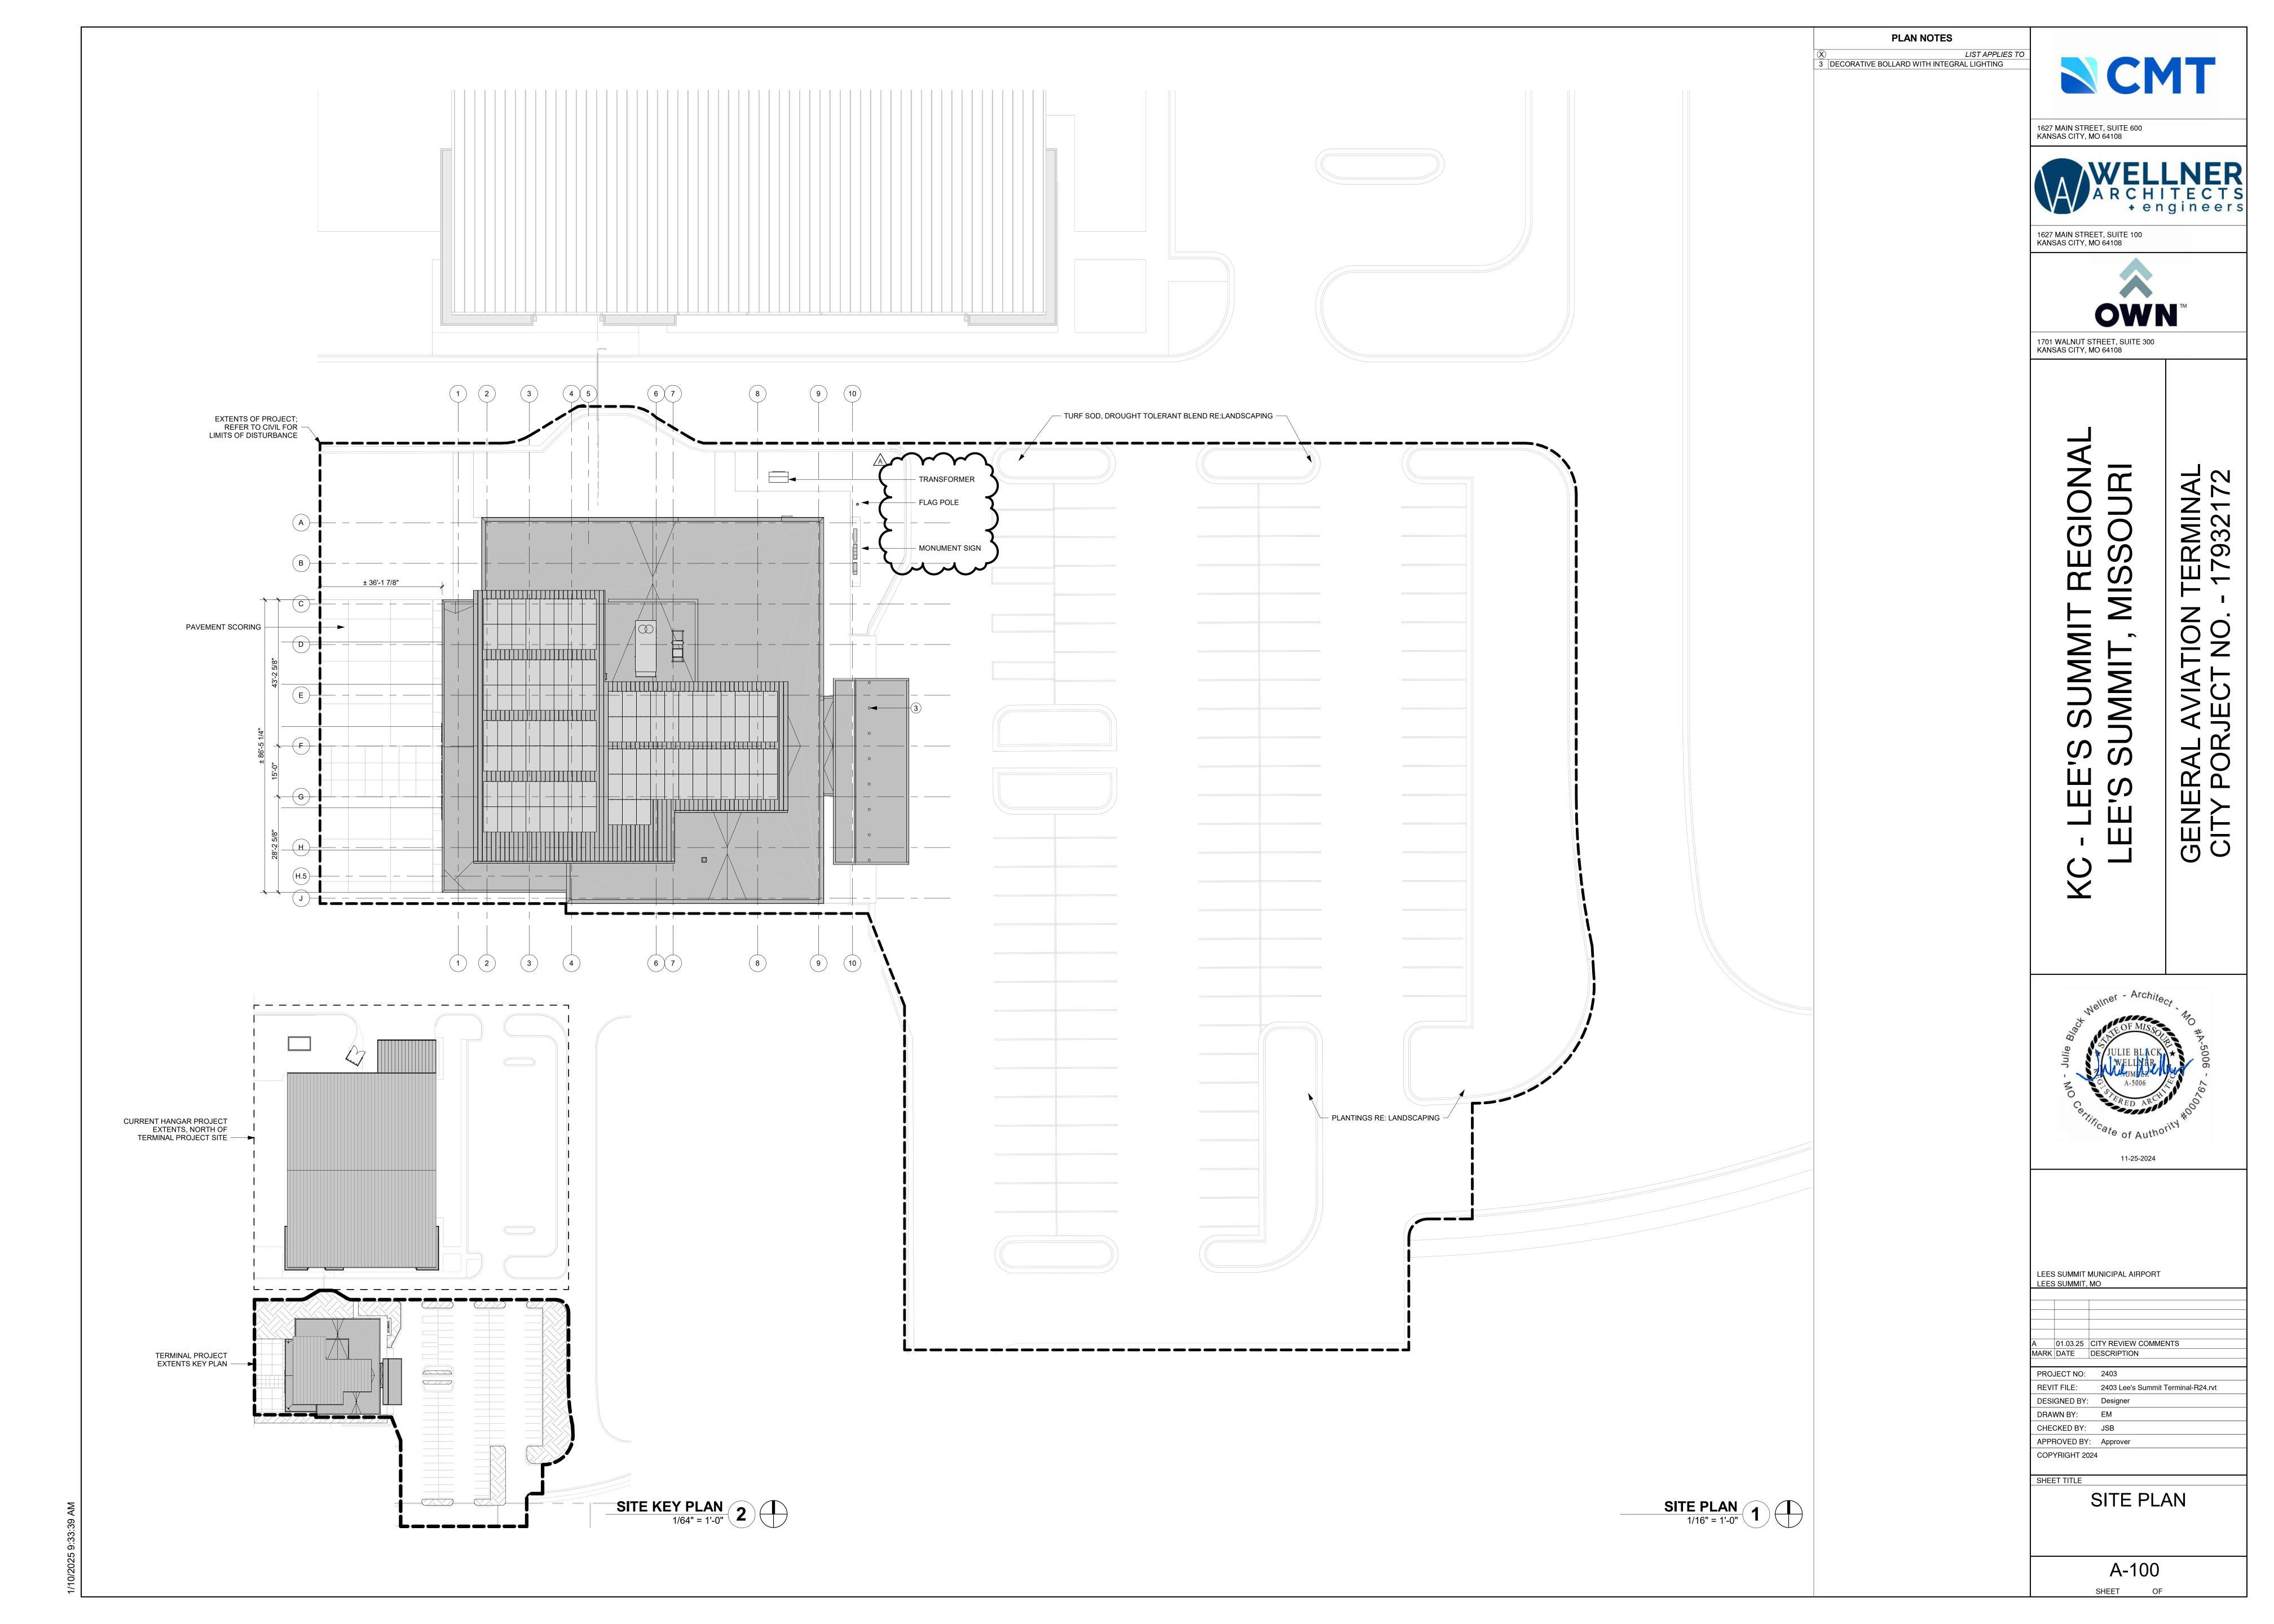
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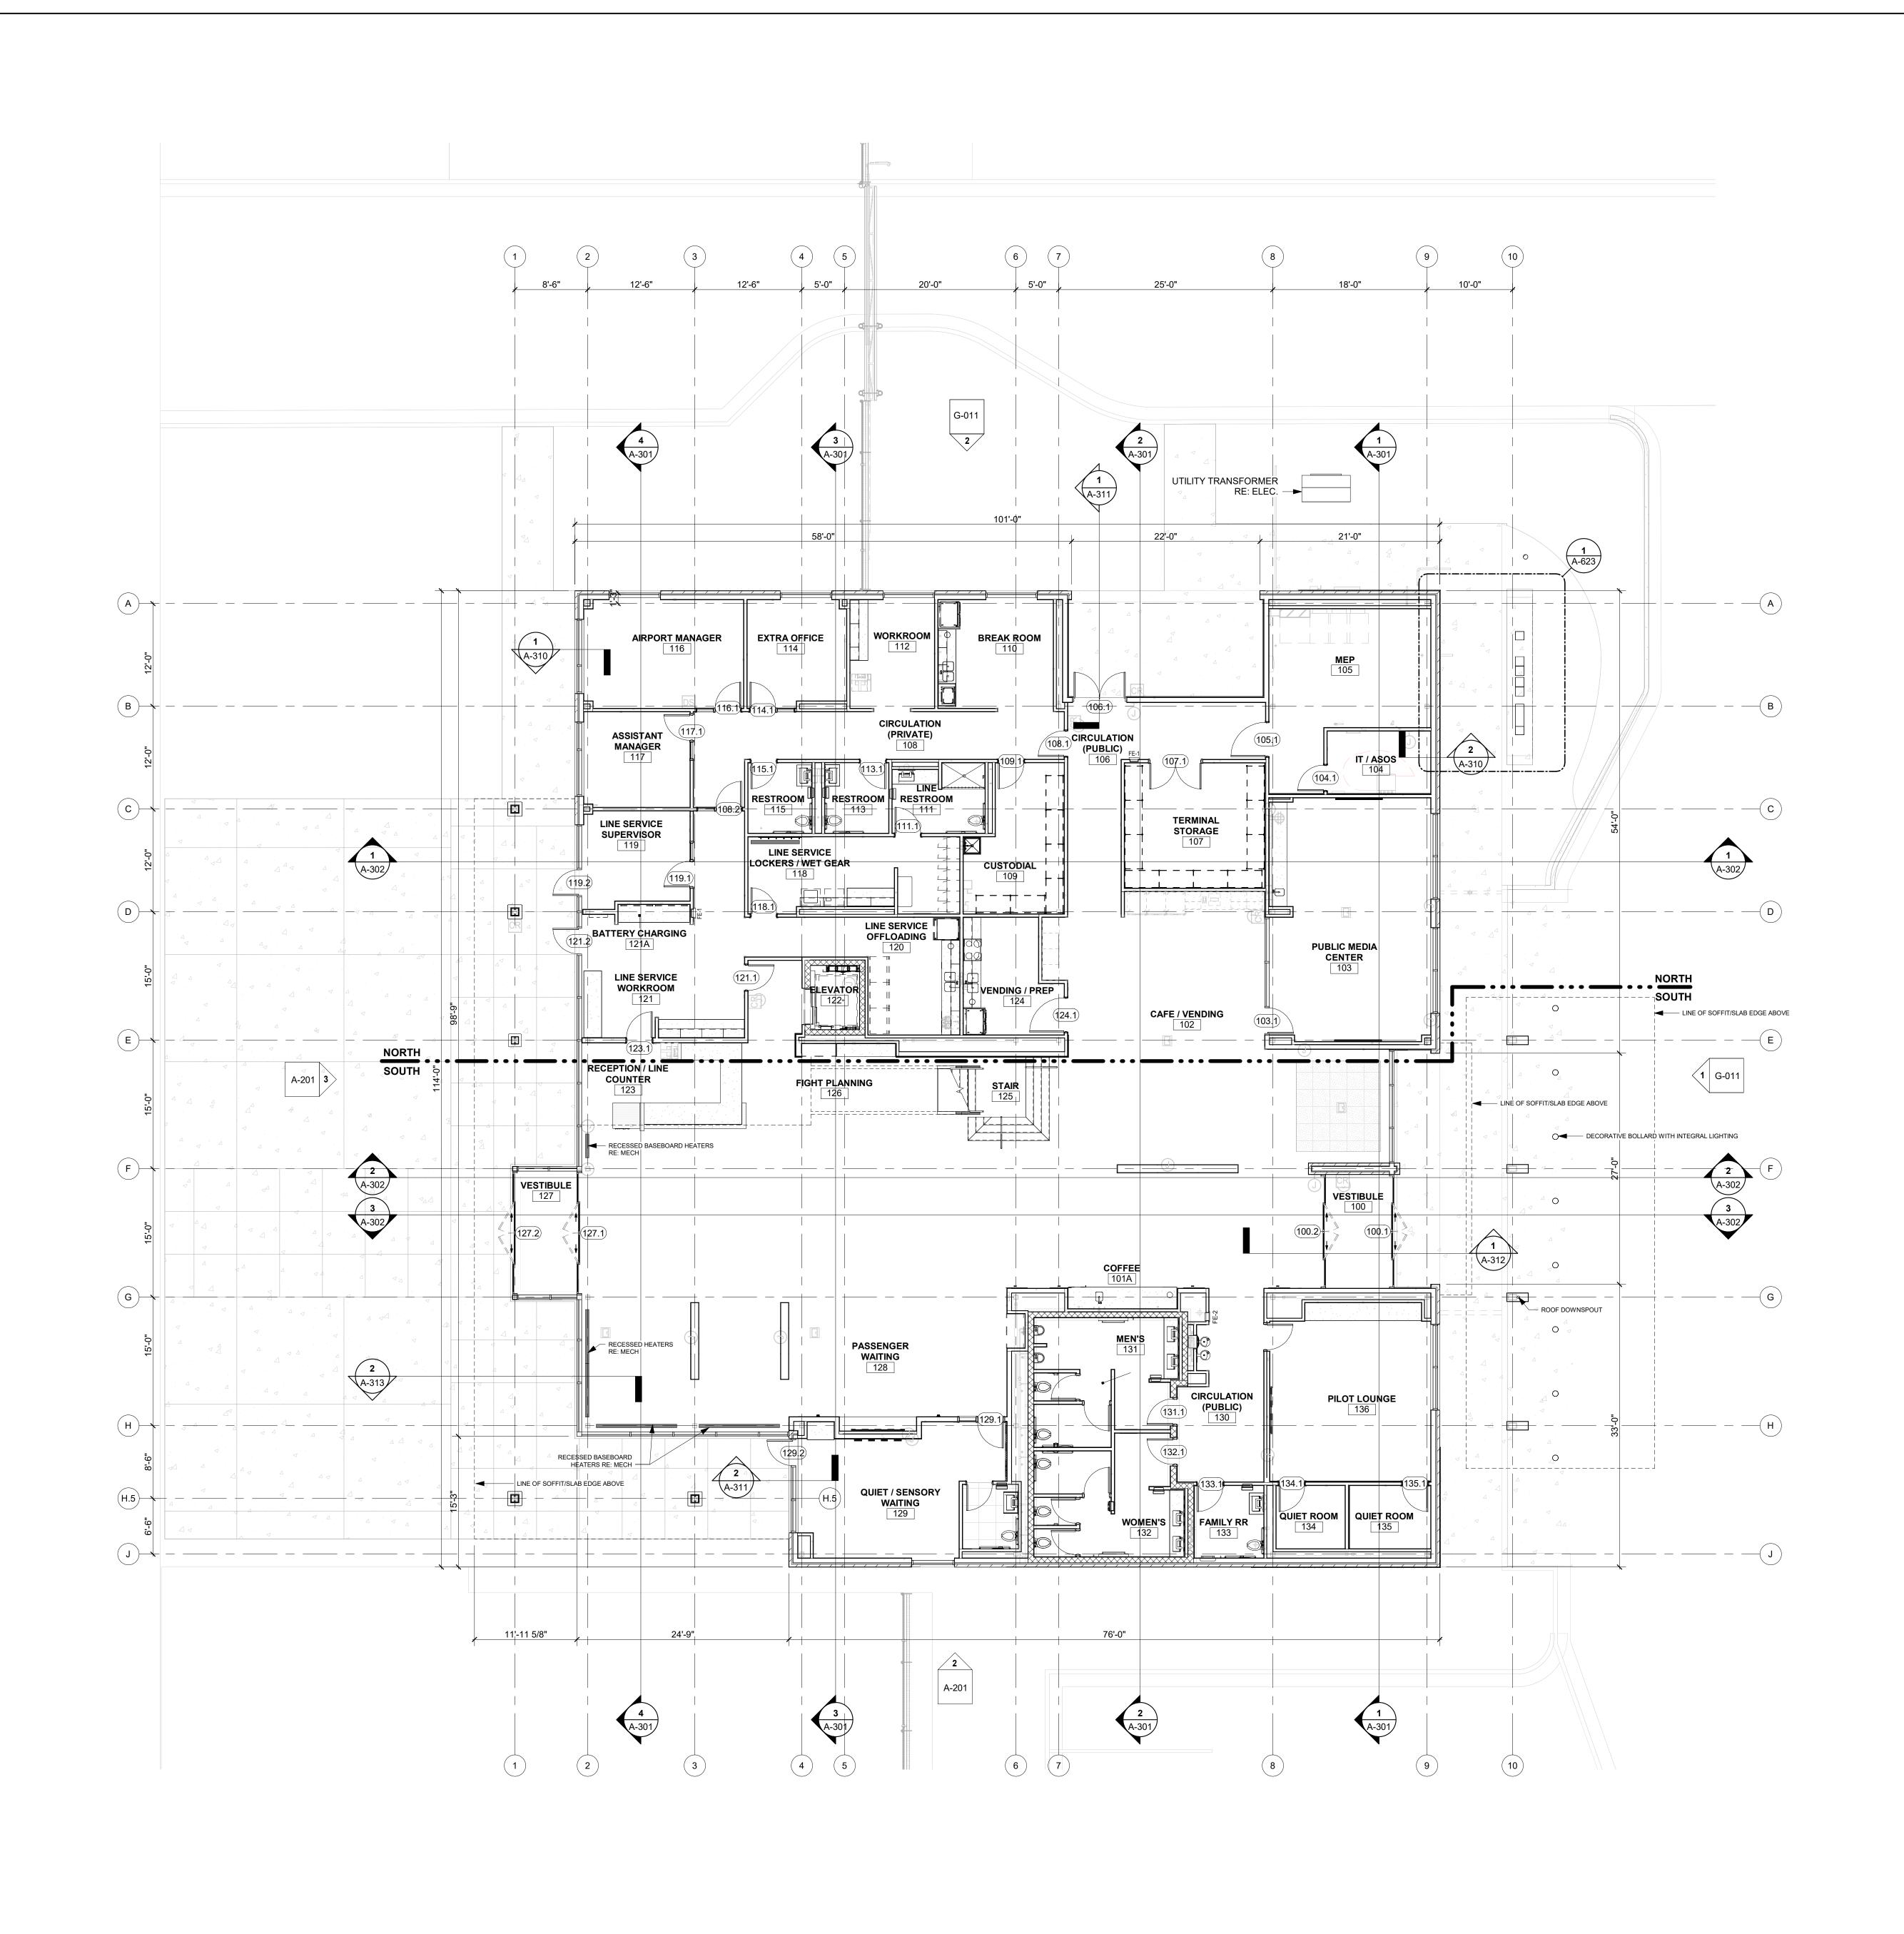
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IRRIGATION AREA PLAN

L102







TERMINAL - 17932172

11-25-2024

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MARK DATE DESCRIPTION PROJECT NO: 2403


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1ST FLOOR PLAN
1/8" = 1'-0"
1

1ST FLOOR PLAN

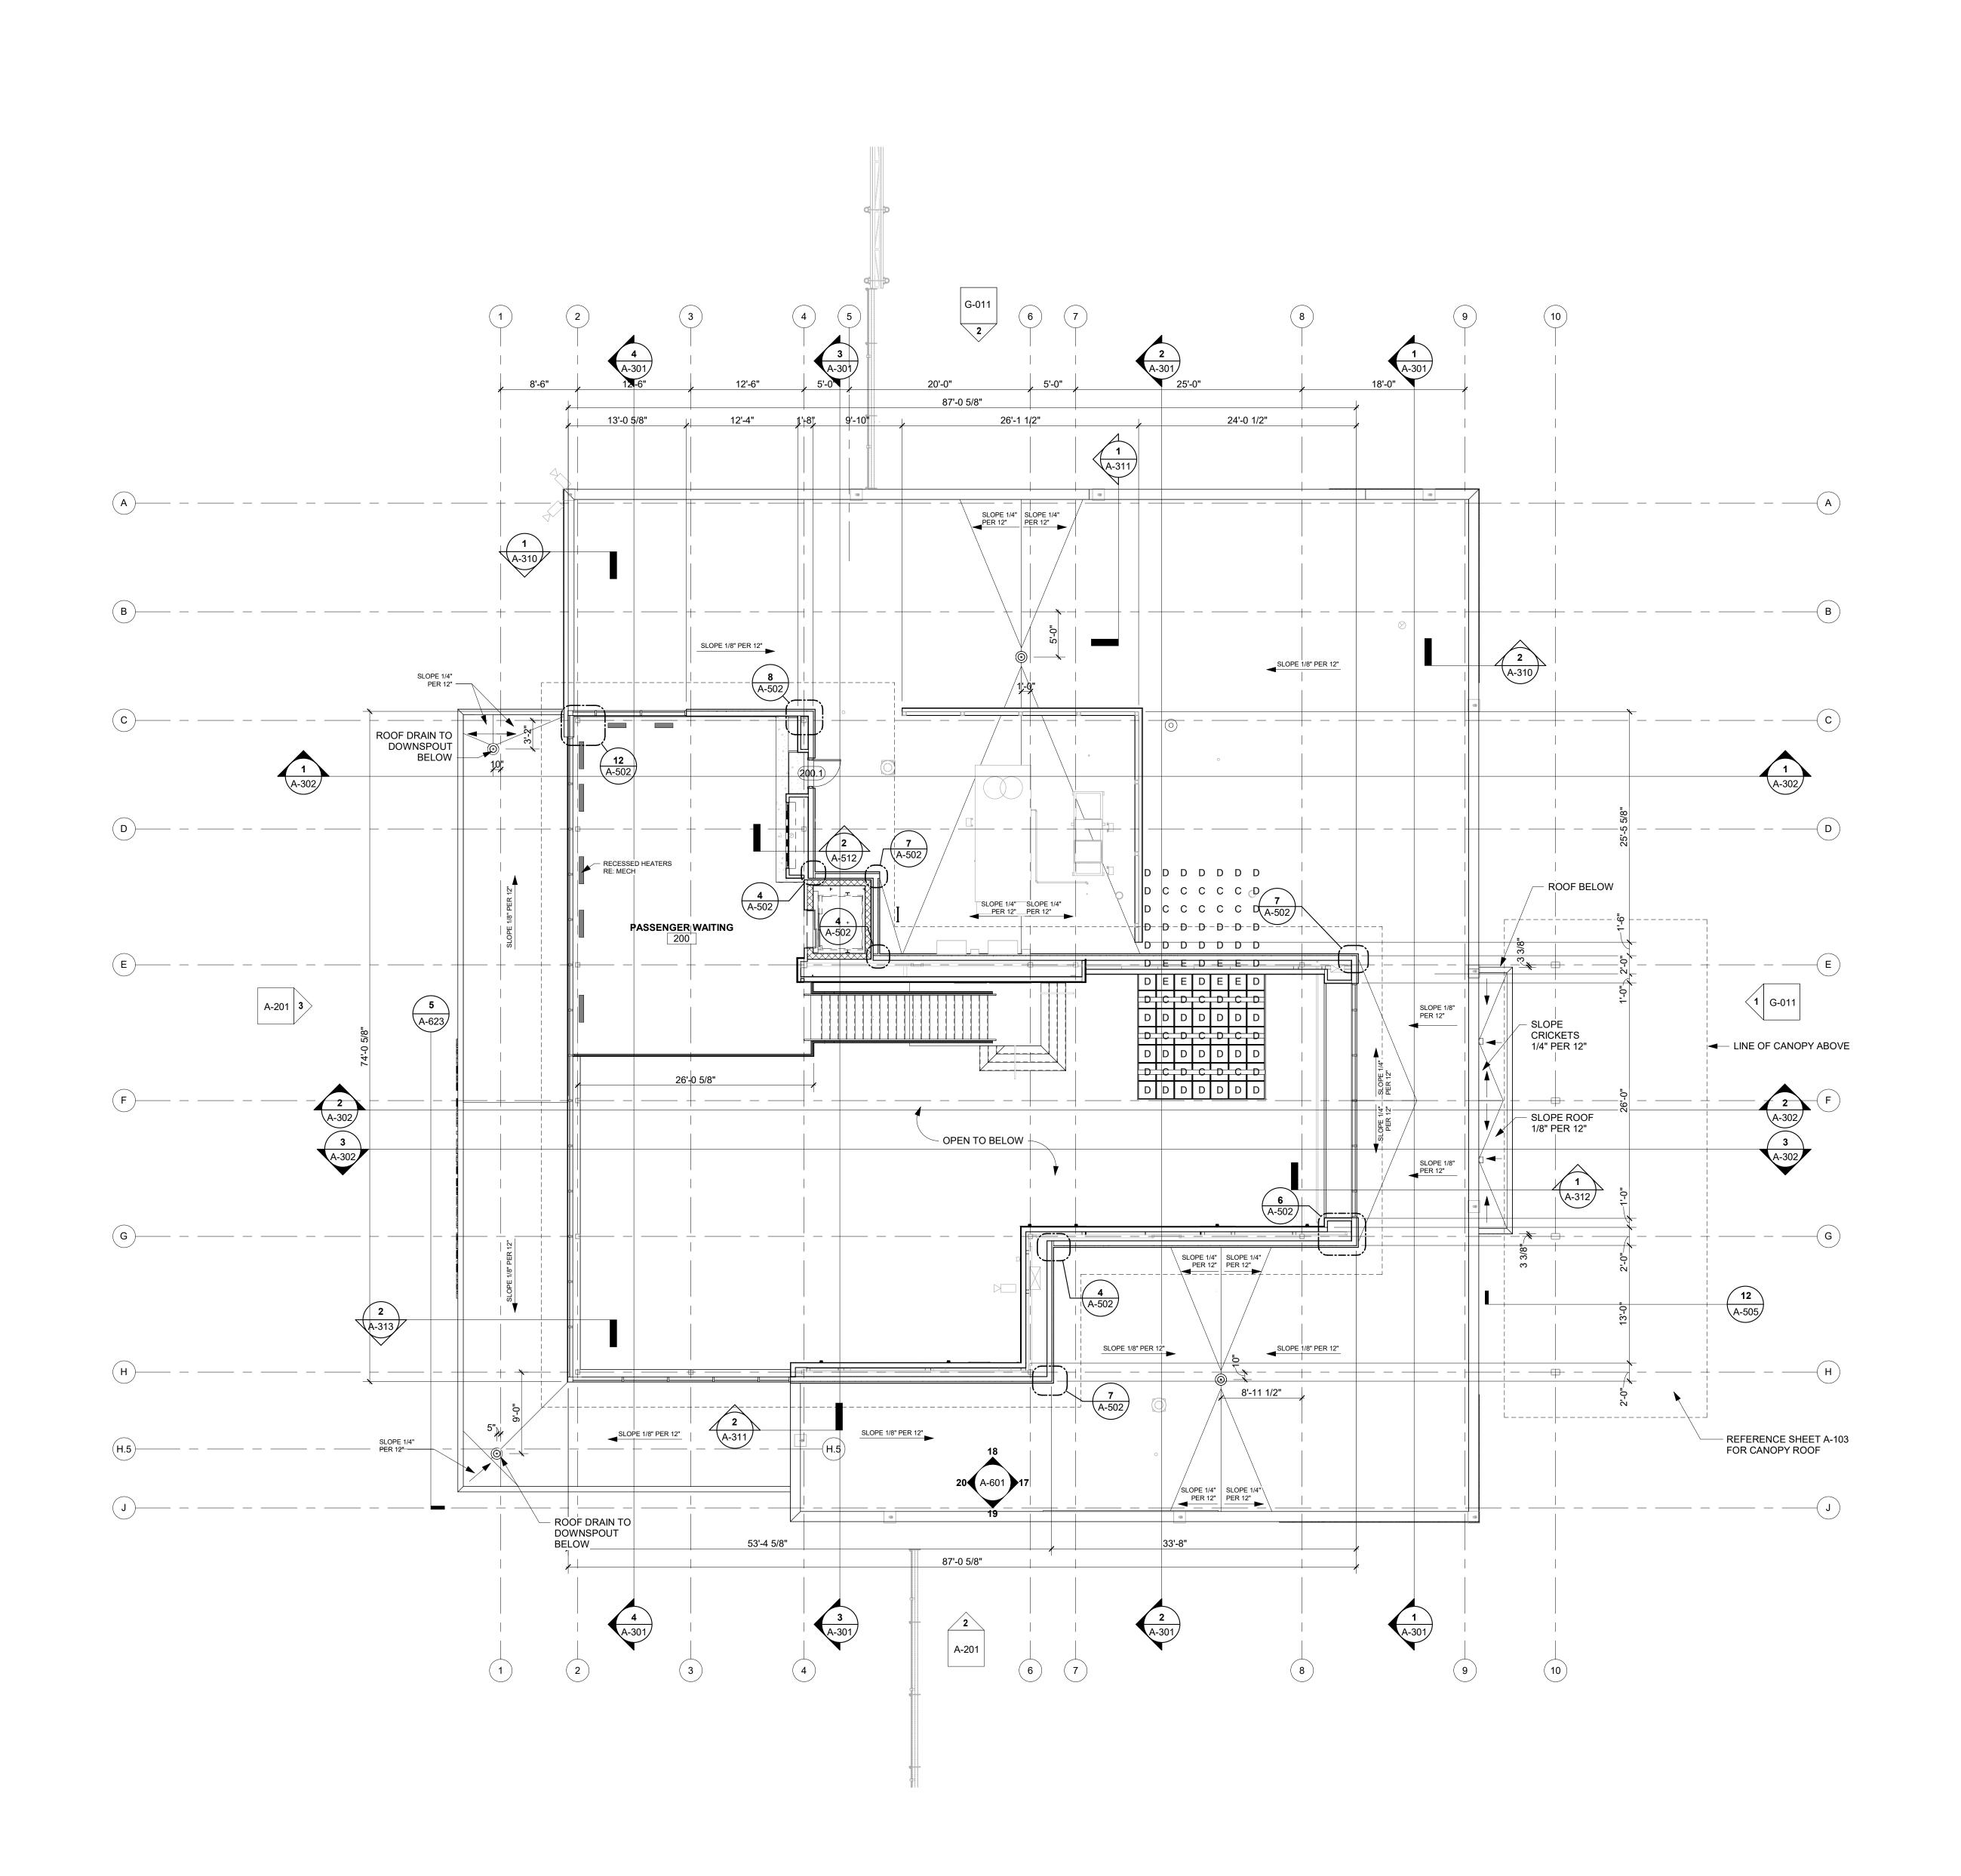A-101 SHEET OF





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1701 WALNUT STREET, SUITE 300 KANSAS CITY, MO 64108

TERMIN/ - 1793217

11-25-2024

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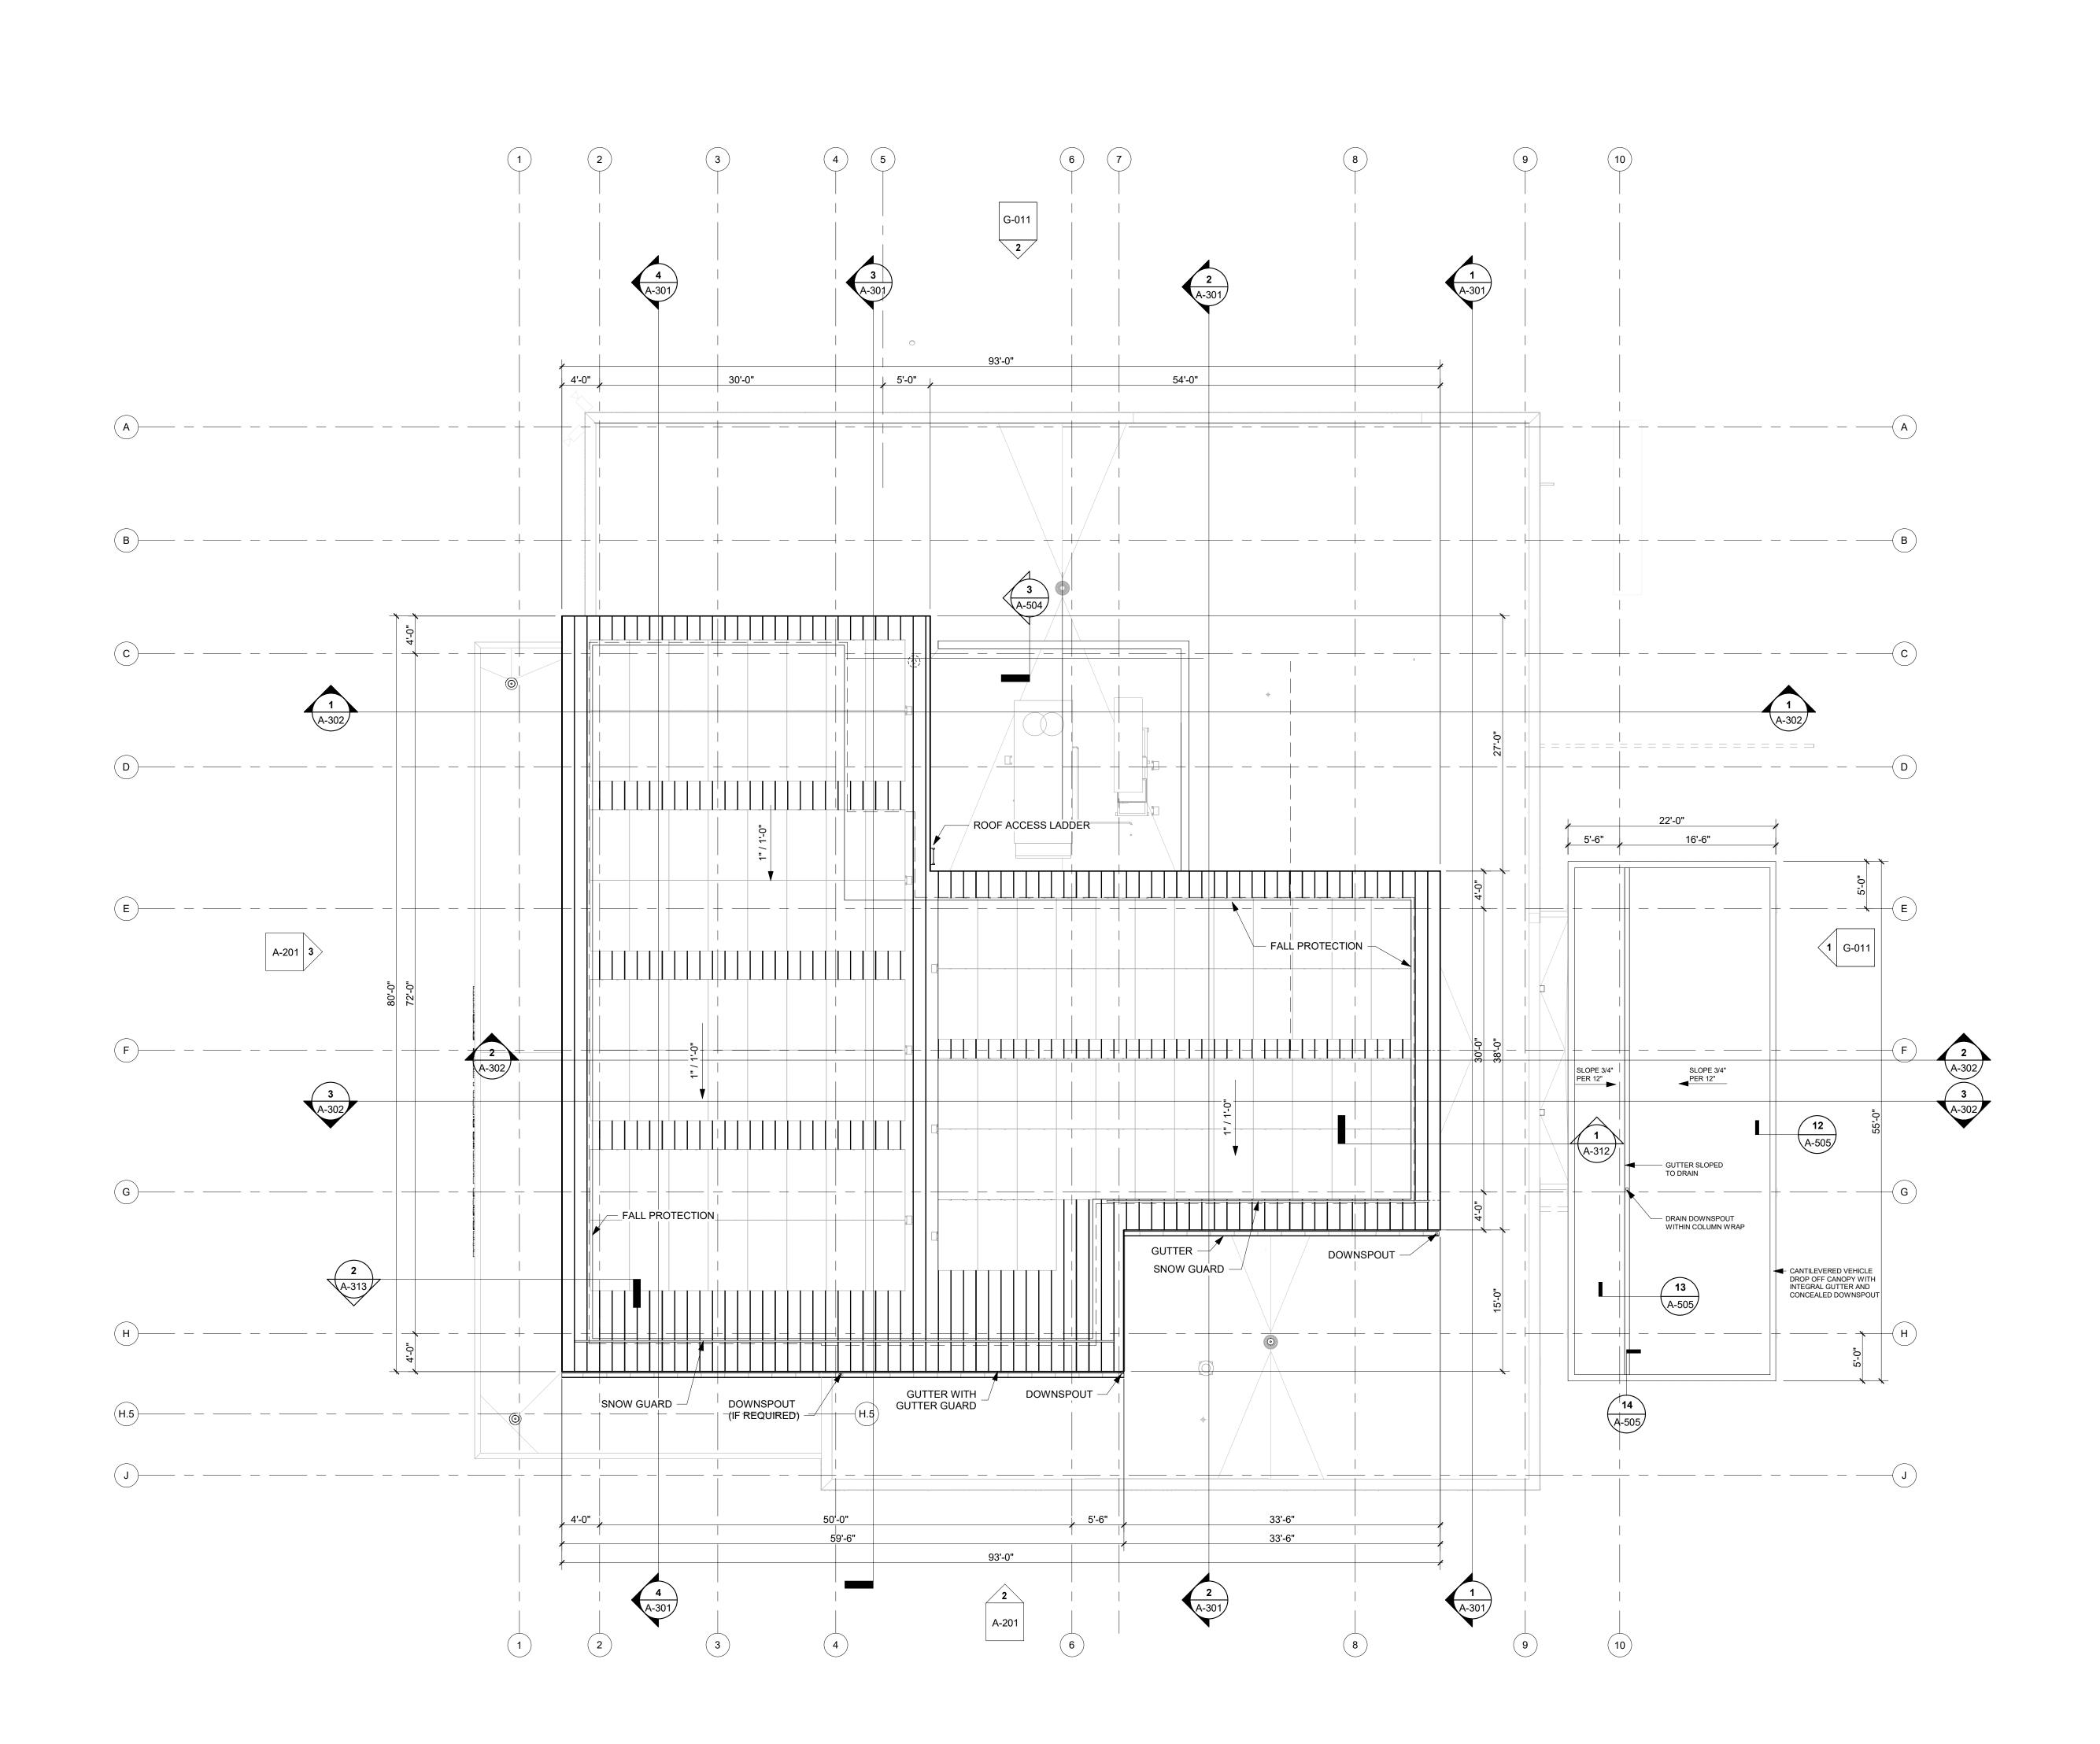
PROJECT NO: 2403 REVIT FILE: 2403 Lee's Summit Terminal-R24.rvt DESIGNED BY: Designer

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MEZZANINE AND LOW ROOF PLAN
1/8" = 1'-0"

MEZZANINE AND LOW **ROOF PLAN**

A-102





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11-25-2024

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MARK DATE DESCRIPTION

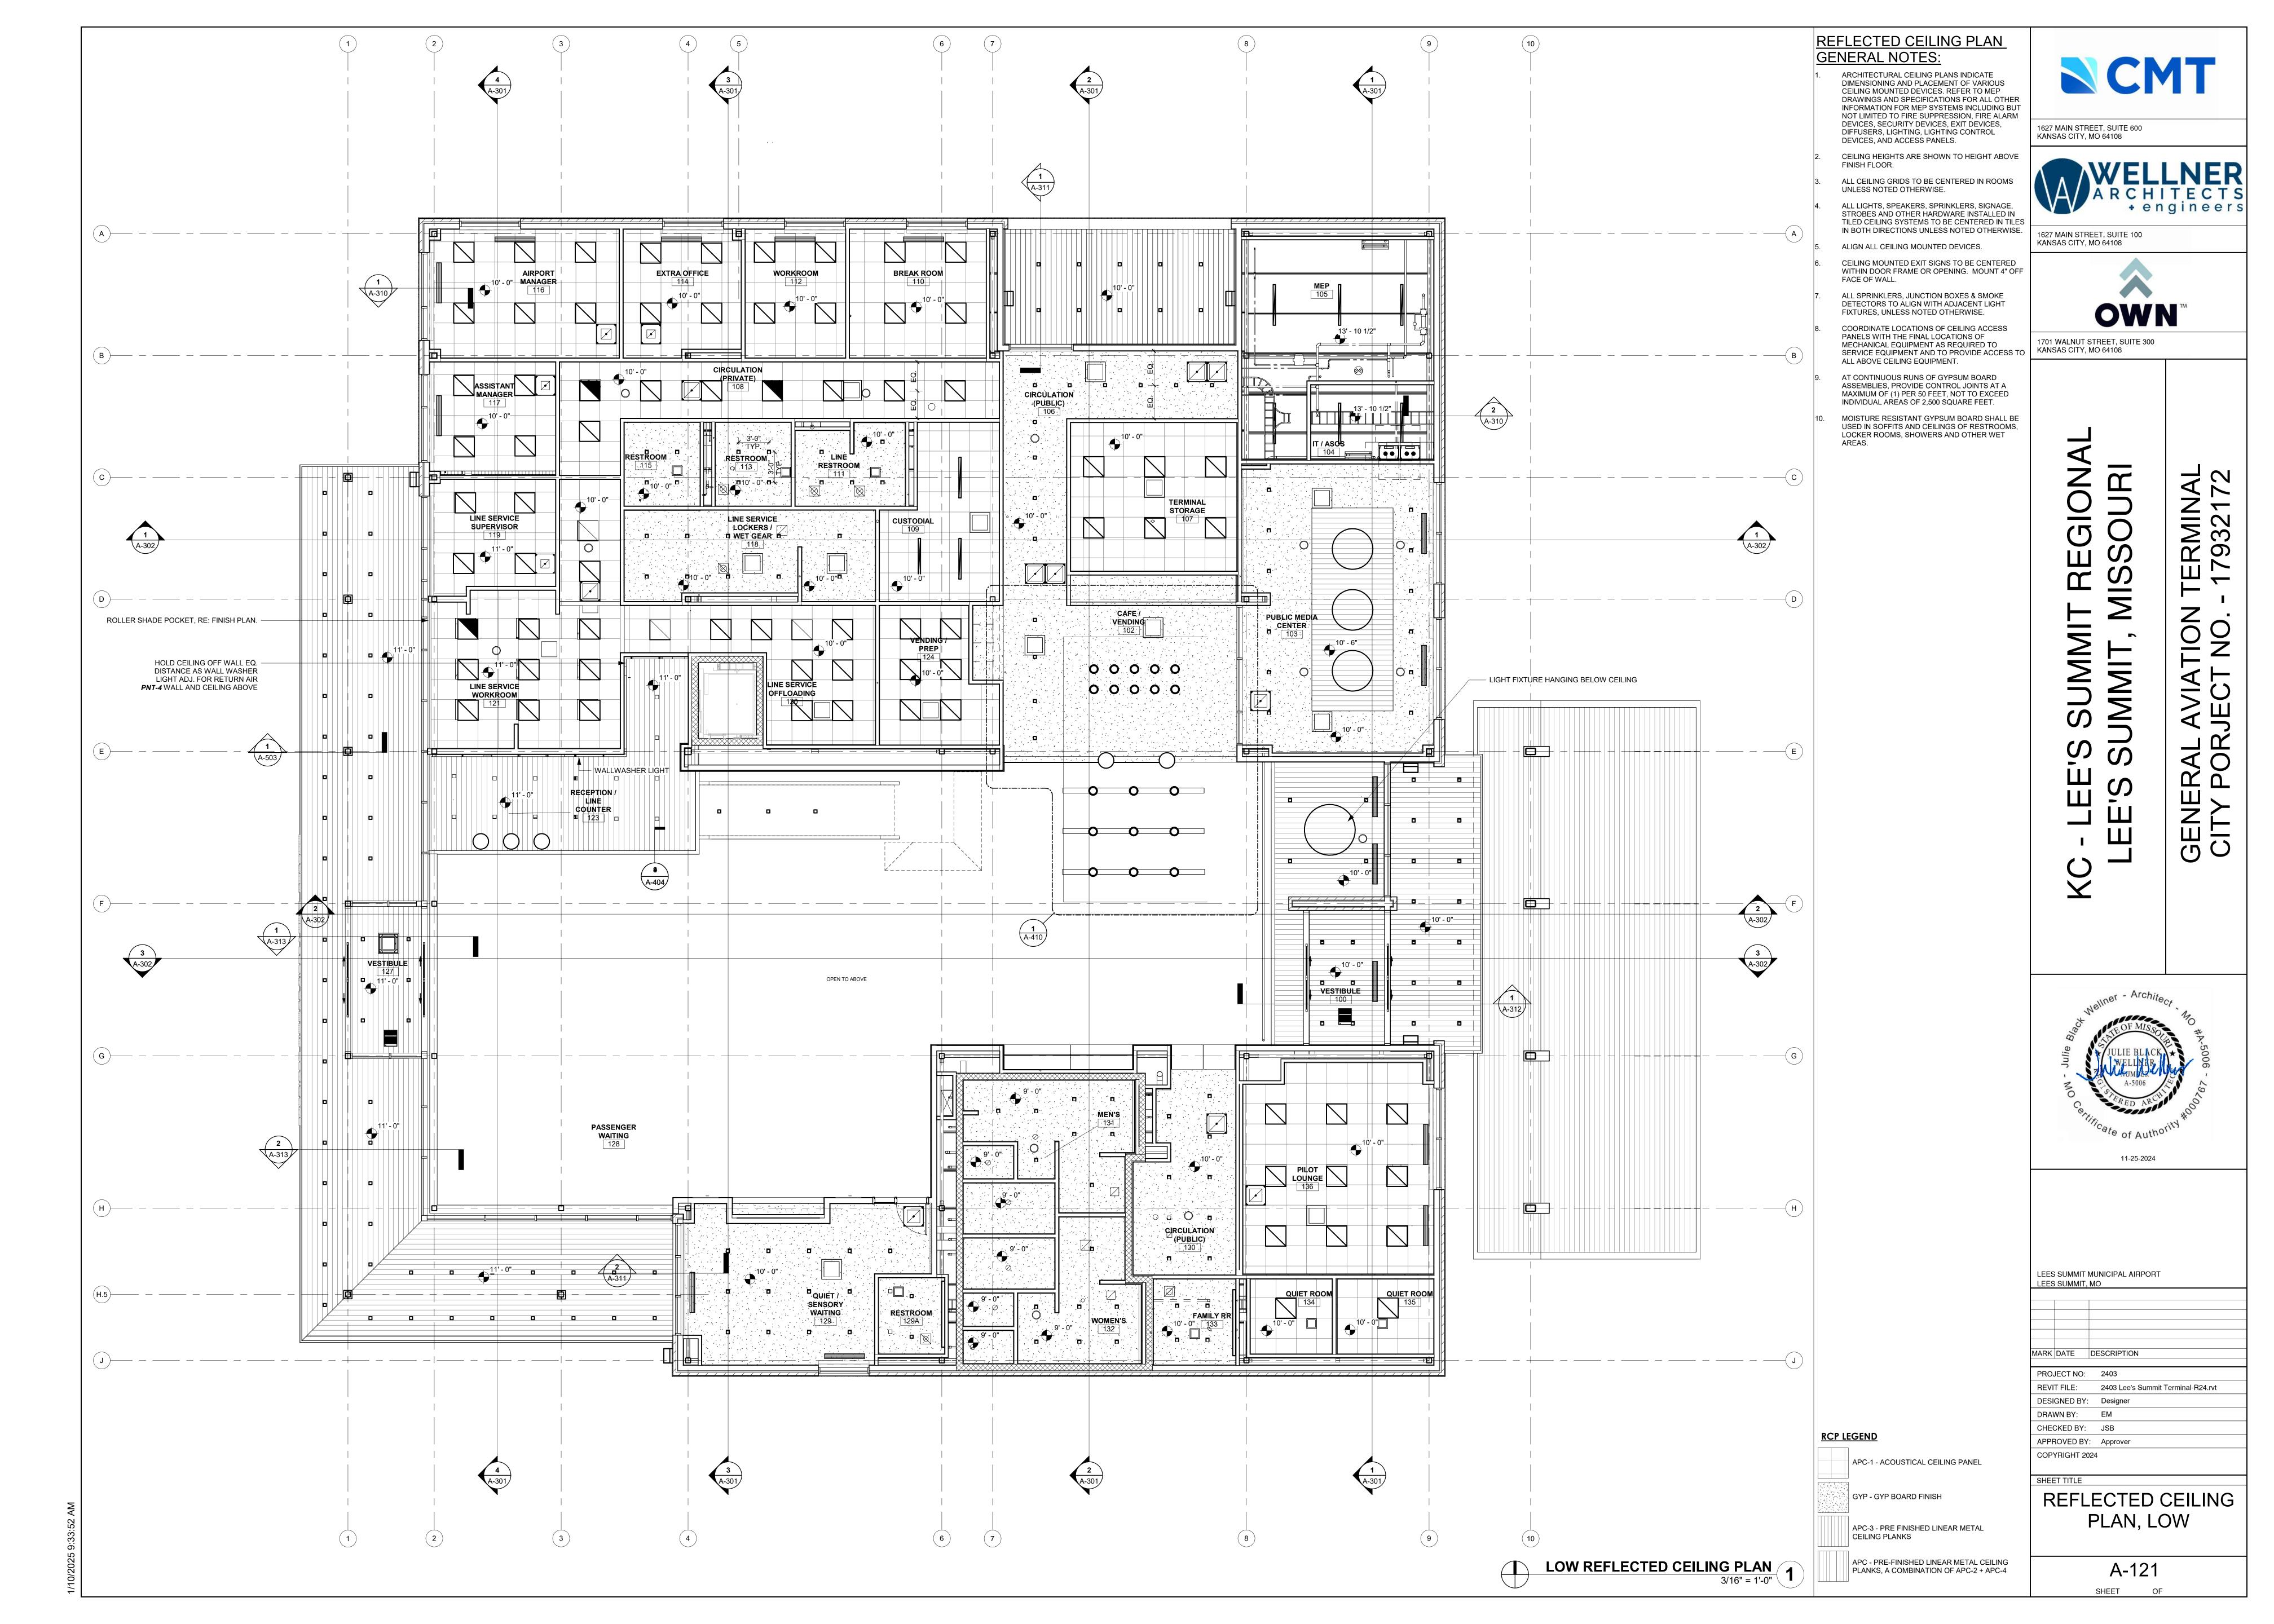
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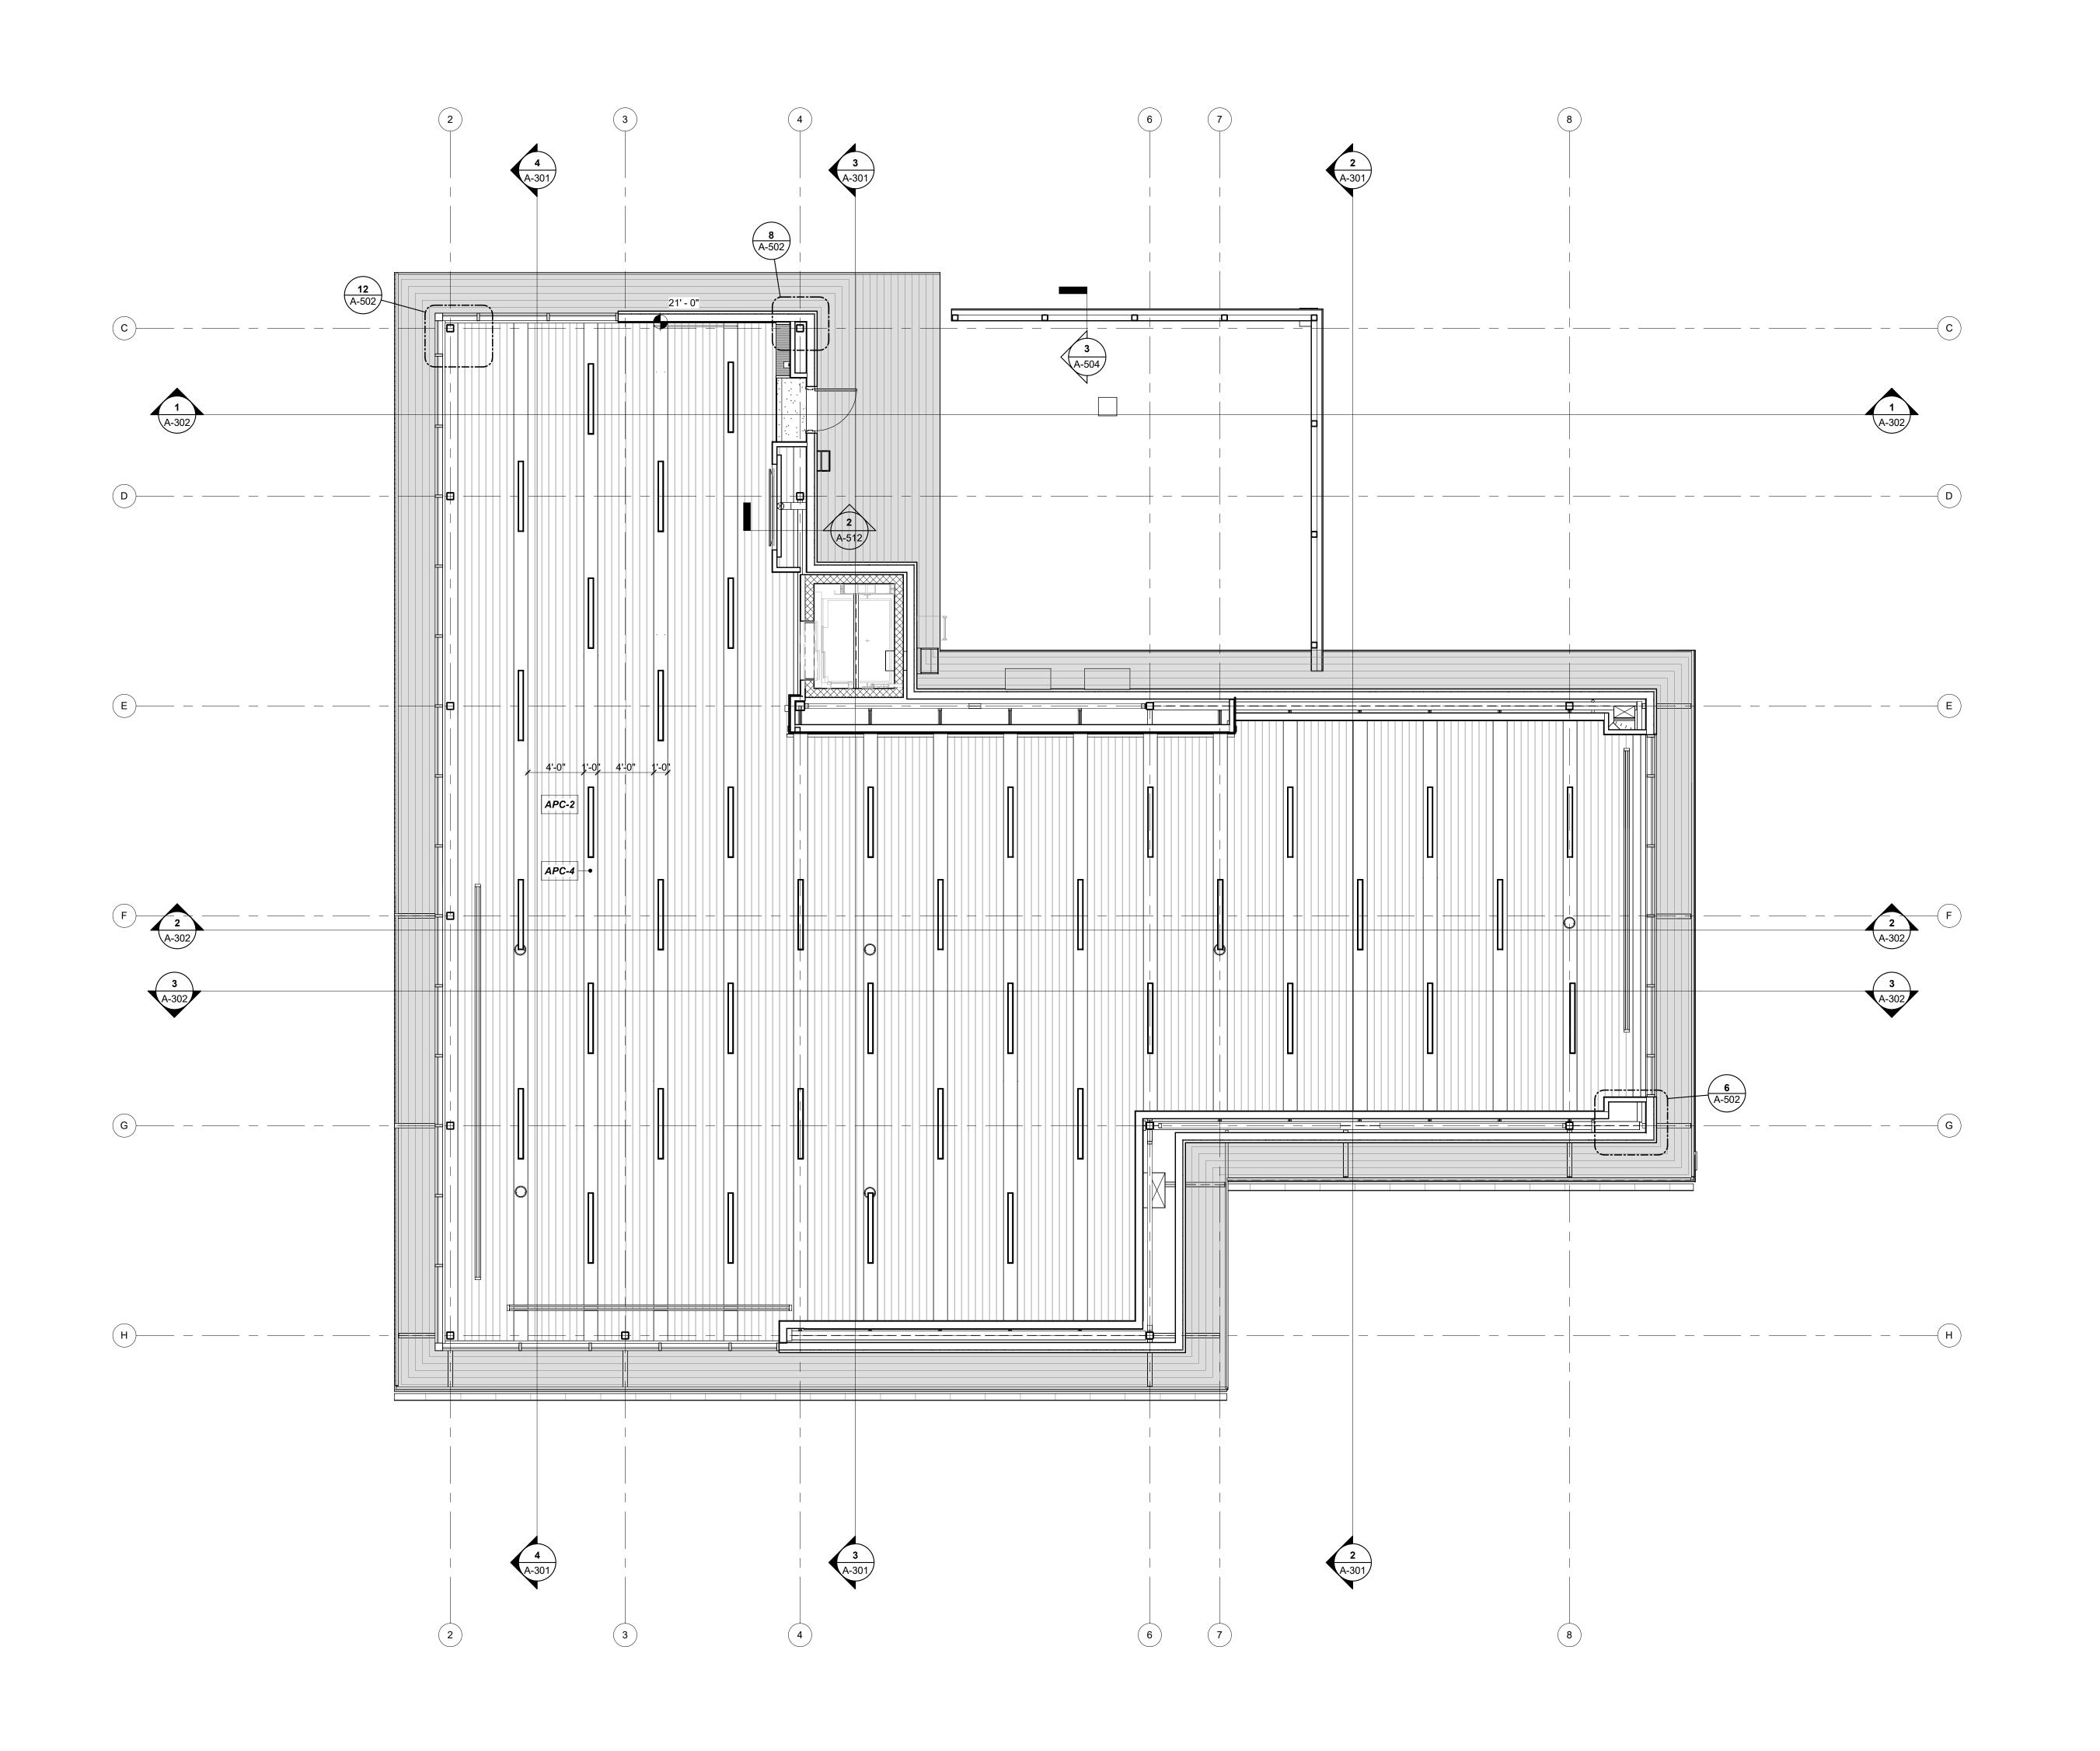
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HIGH ROOF PLAN
1/8" = 1'-0"

SHEET TITLE HIGH ROOF PLAN

> A-103 SHEET OF





REFLECTED CEILING PLAN **GENERAL NOTES:**

- ARCHITECTURAL CEILING PLANS INDICATE DIMENSIONING AND PLACEMENT OF VARIOUS CEILING MOUNTED DEVICES. REFER TO MEP DRAWINGS AND SPECIFICATIONS FOR ALL OTHER INFORMATION FOR MEP SYSTEMS INCLUDING BUT NOT LIMITED TO FIRE SUPPRESSION, FIRE ALARM DEVICES, SECURITY DEVICES, EXIT DEVICES, DIFFUSERS, LIGHTING, LIGHTING CONTROL DEVICES, AND ACCESS PANELS.
- CEILING HEIGHTS ARE SHOWN TO HEIGHT ABOVE FINISH FLOOR.
- ALL CEILING GRIDS TO BE CENTERED IN ROOMS UNLESS NOTED OTHERWISE.
- ALL LIGHTS, SPEAKERS, SPRINKLERS, SIGNAGE, STROBES AND OTHER HARDWARE INSTALLED IN TILED CEILING SYSTEMS TO BE CENTERED IN TILES IN BOTH DIRECTIONS UNLESS NOTED OTHERWISE.
- ALIGN ALL CEILING MOUNTED DEVICES.
- CEILING MOUNTED EXIT SIGNS TO BE CENTERED WITHIN DOOR FRAME OR OPENING. MOUNT 4" OFF FACE OF WALL.
- ALL SPRINKLERS, JUNCTION BOXES & SMOKE DETECTORS TO ALIGN WITH ADJACENT LIGHT FIXTURES, UNLESS NOTED OTHERWISE.
- COORDINATE LOCATIONS OF CEILING ACCESS PANELS WITH THE FINAL LOCATIONS OF MECHANICAL EQUIPMENT AS REQUIRED TO SERVICE EQUIPMENT AND TO PROVIDE ACCESS TO ALL ABOVE CEILING EQUIPMENT.
- AT CONTINUOUS RUNS OF GYPSUM BOARD ASSEMBLIES, PROVIDE CONTROL JOINTS AT A MAXIMUM OF (1) PER 50 FEET, NOT TO EXCEED INDIVIDUAL AREAS OF 2,500 SQUARE FEET.
- MOISTURE RESISTANT GYPSUM BOARD SHALL BE USED IN SOFFITS AND CEILINGS OF RESTROOMS, LOCKER ROOMS, SHOWERS AND OTHER WET



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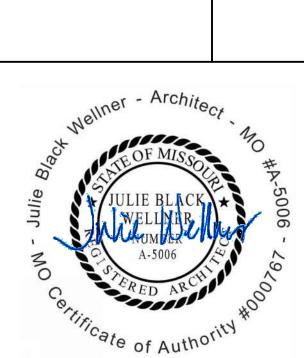
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KANSAS CITY, MO 64108

1701 WALNUT STREET, SUITE 300

TERMINAL - 17932172



LEES SUMMIT MUNICIPAL AIRPORT LEES SUMMIT, MO

PROJECT NO: 2403

REVIT FILE: 2403 Lee's Summit Terminal-R24.rvt DESIGNED BY: Designer DRAWN BY: EM

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SHEET TITLE REFLECTED CEILING PLAN, HIGH

A-122

HIGH REFLECTED CEILING PLAN
3/16" = 1'-0"

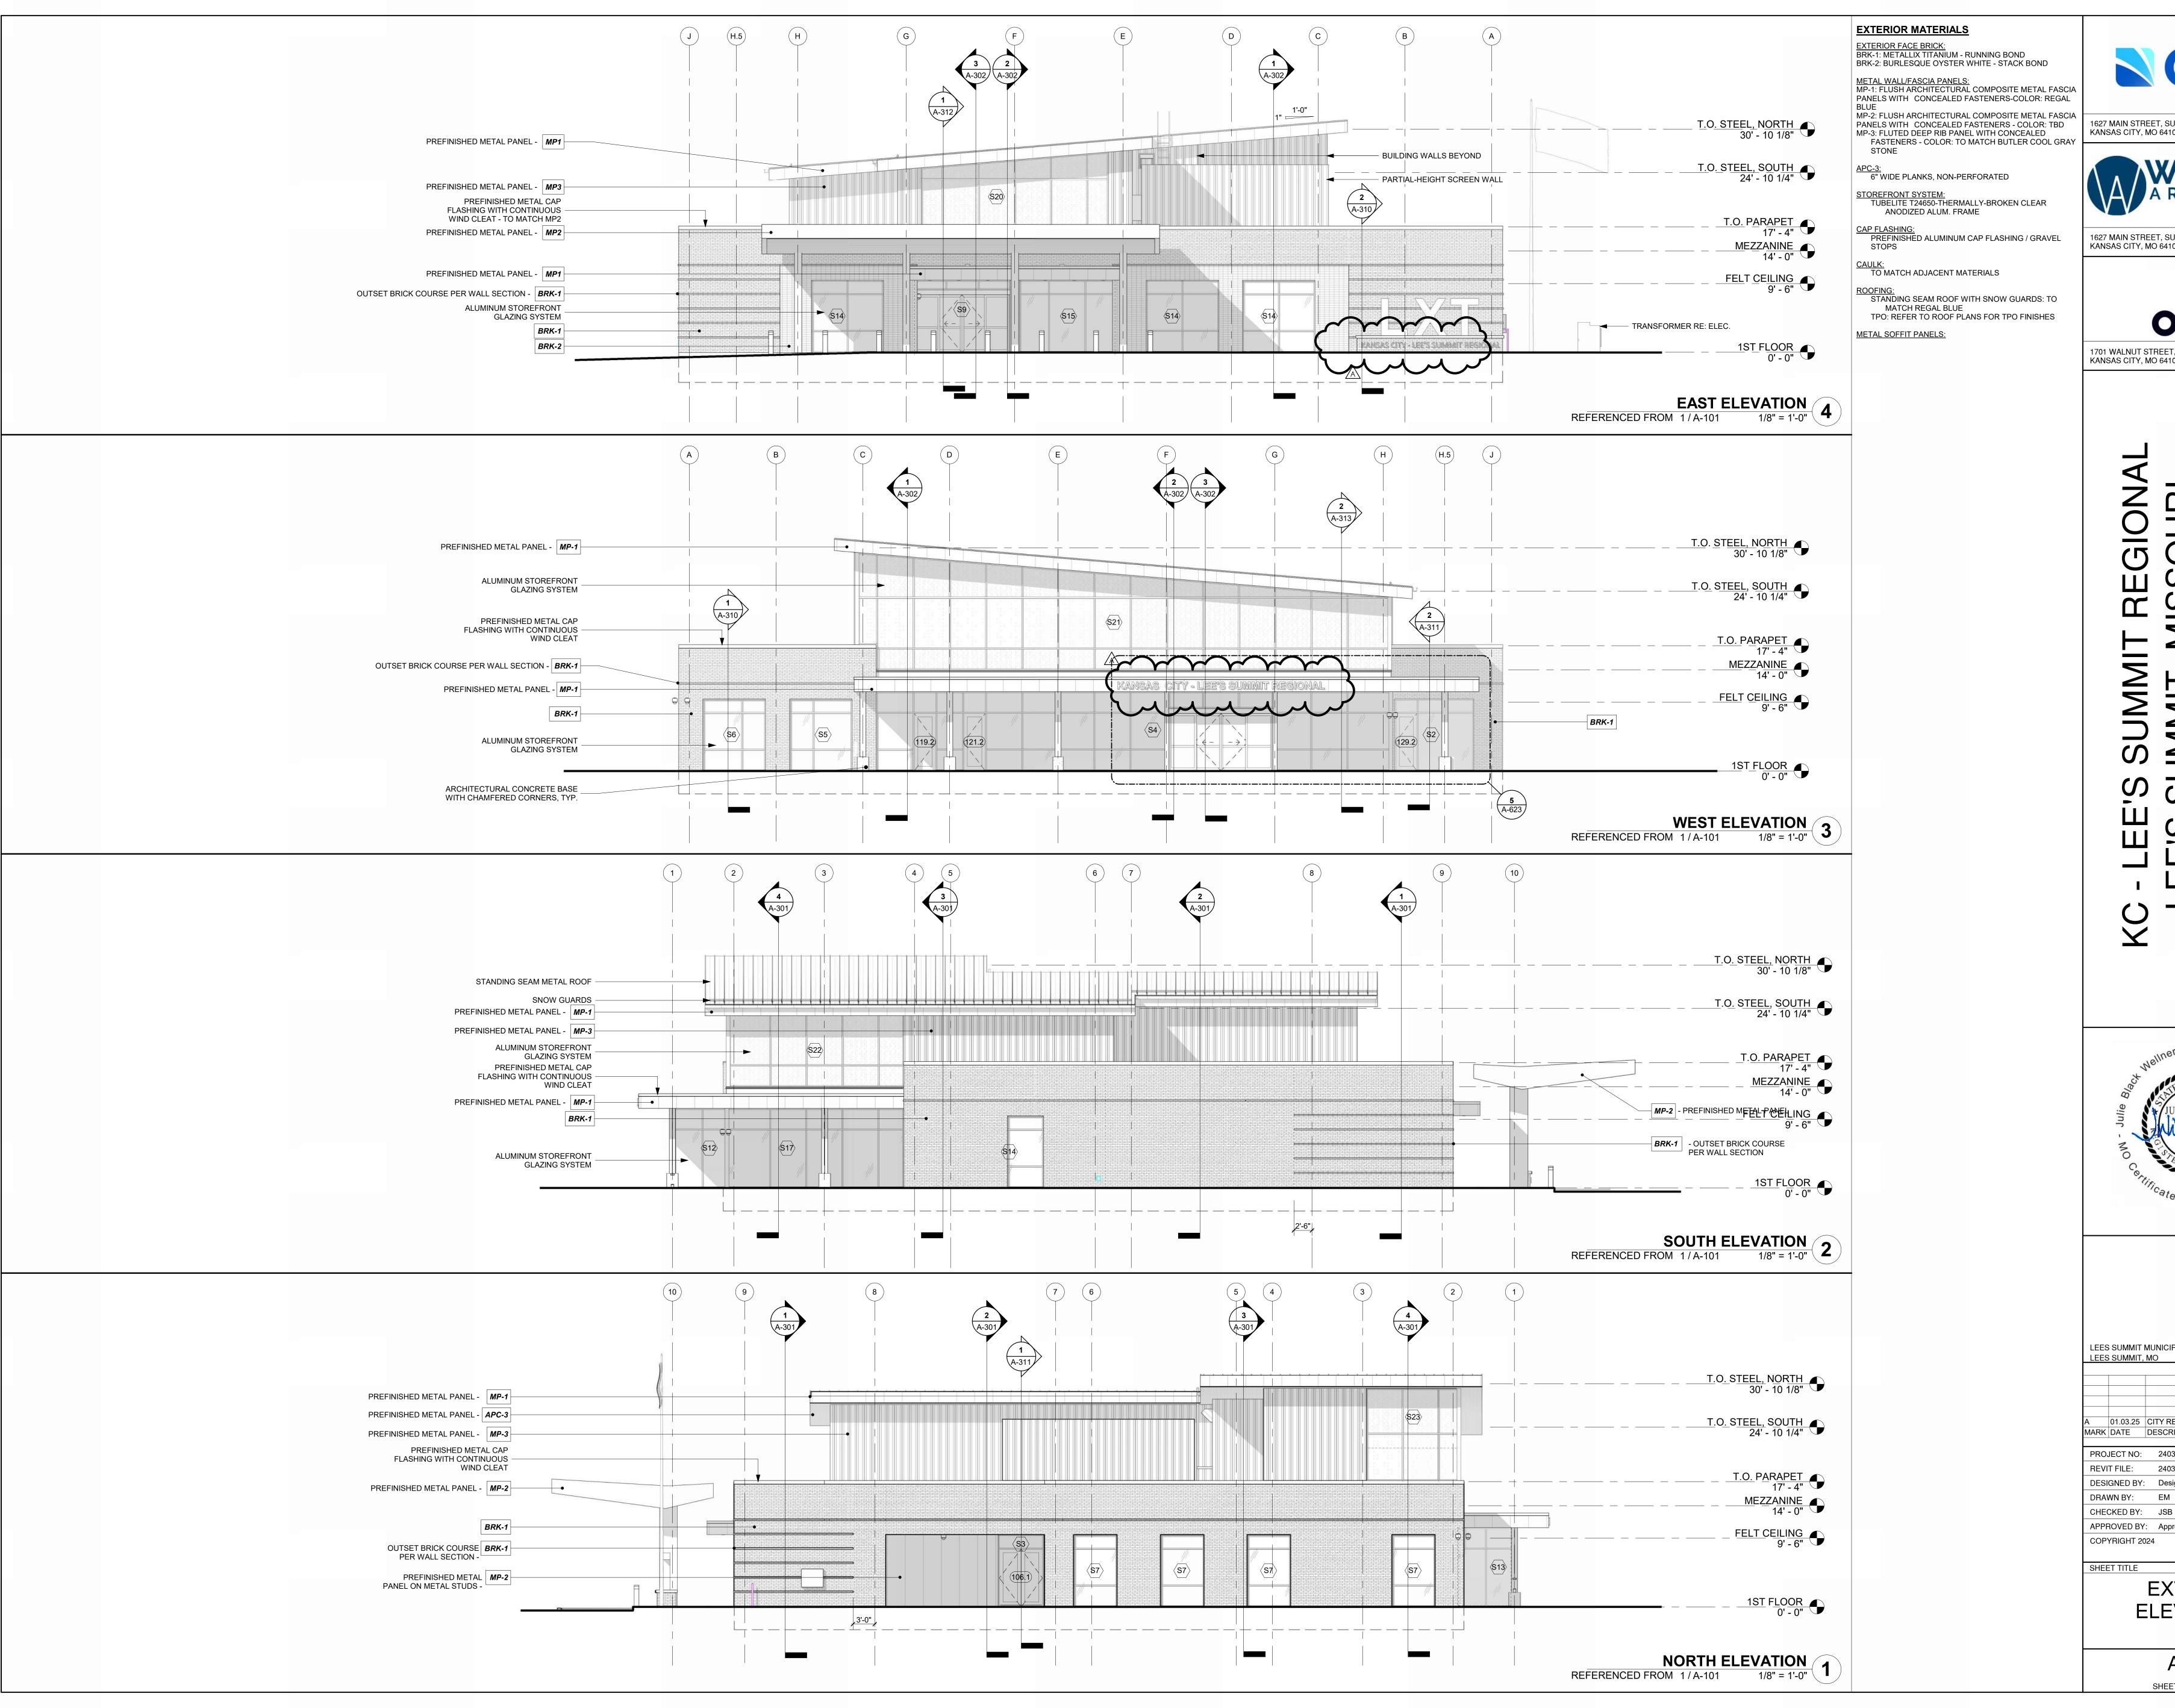
APC - PRE-FINISHED LINEAR METAL CEILING PLANKS, A COMBINATION OF APC-2 + APC-4

RCP LEGEND

APC-1 - ACOUSTICAL CEILING PANEL

APC-3 - PRE FINISHED LINEAR METAL CEILING PLANKS

GYP - GYP BOARD FINISH





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LEES SUMMIT MUNICIPAL AIRPORT

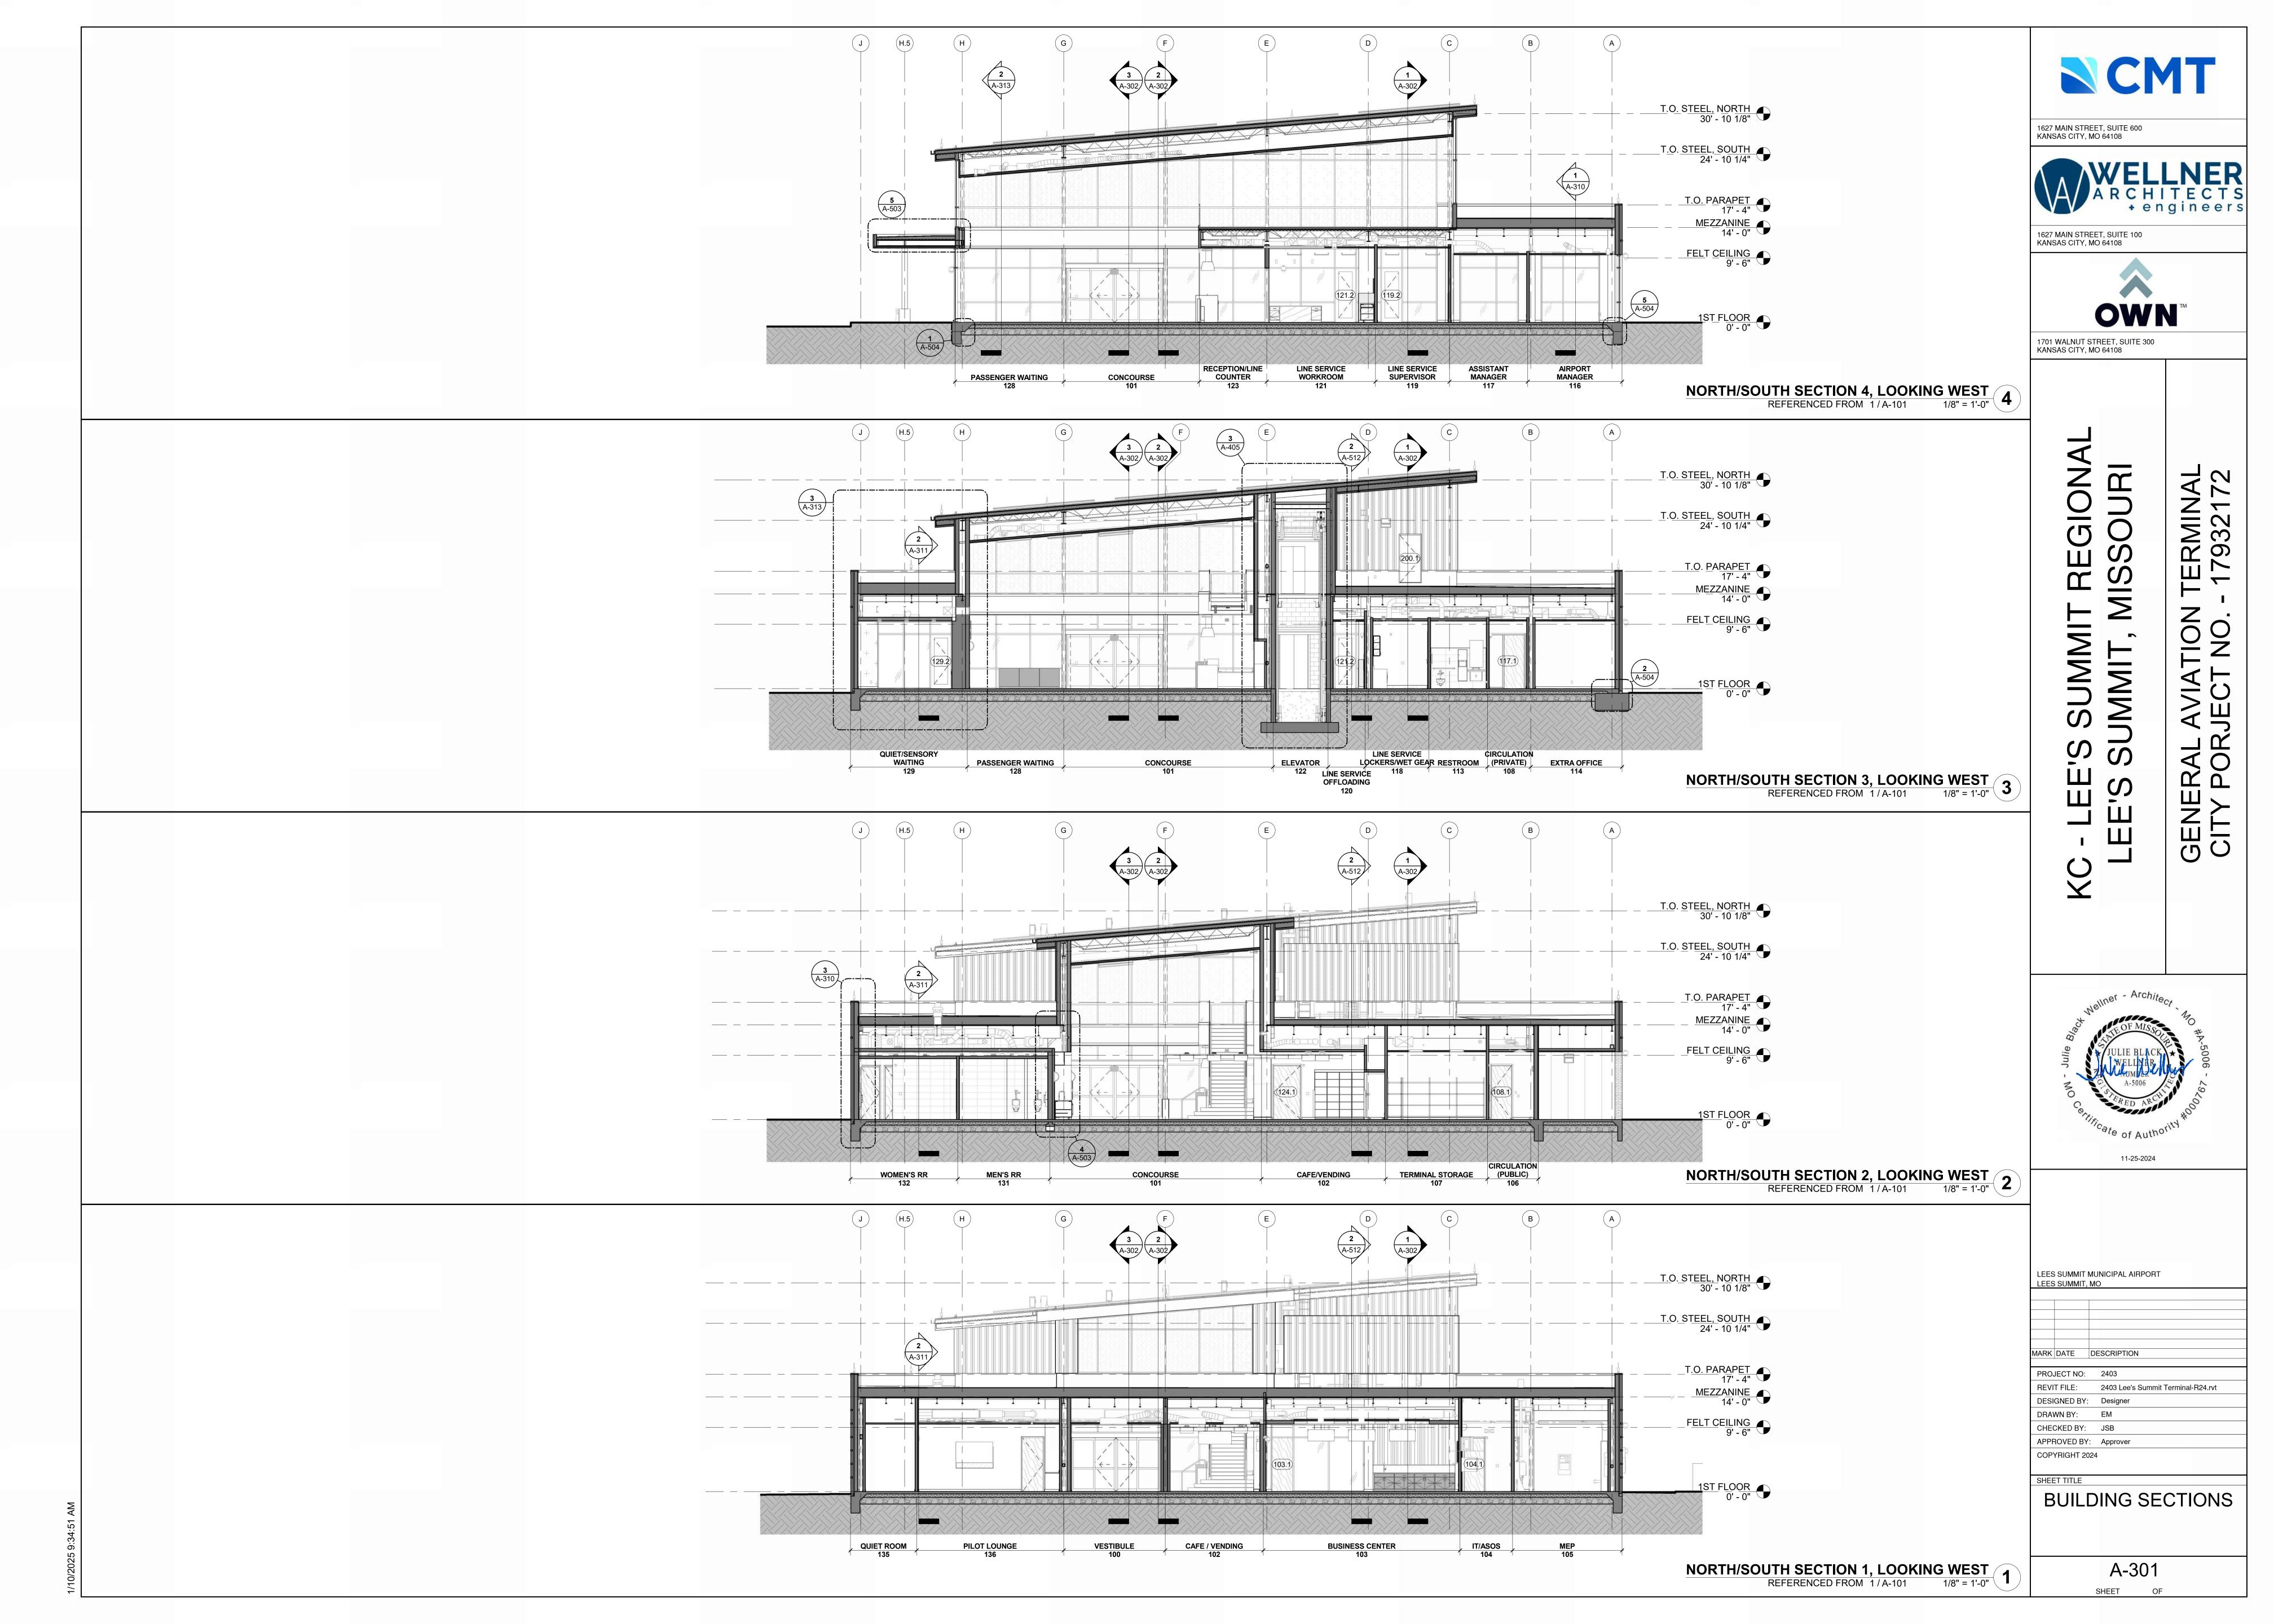
01.03.25 CITY REVIEW COMMENTS MARK DATE DESCRIPTION PROJECT NO: 2403

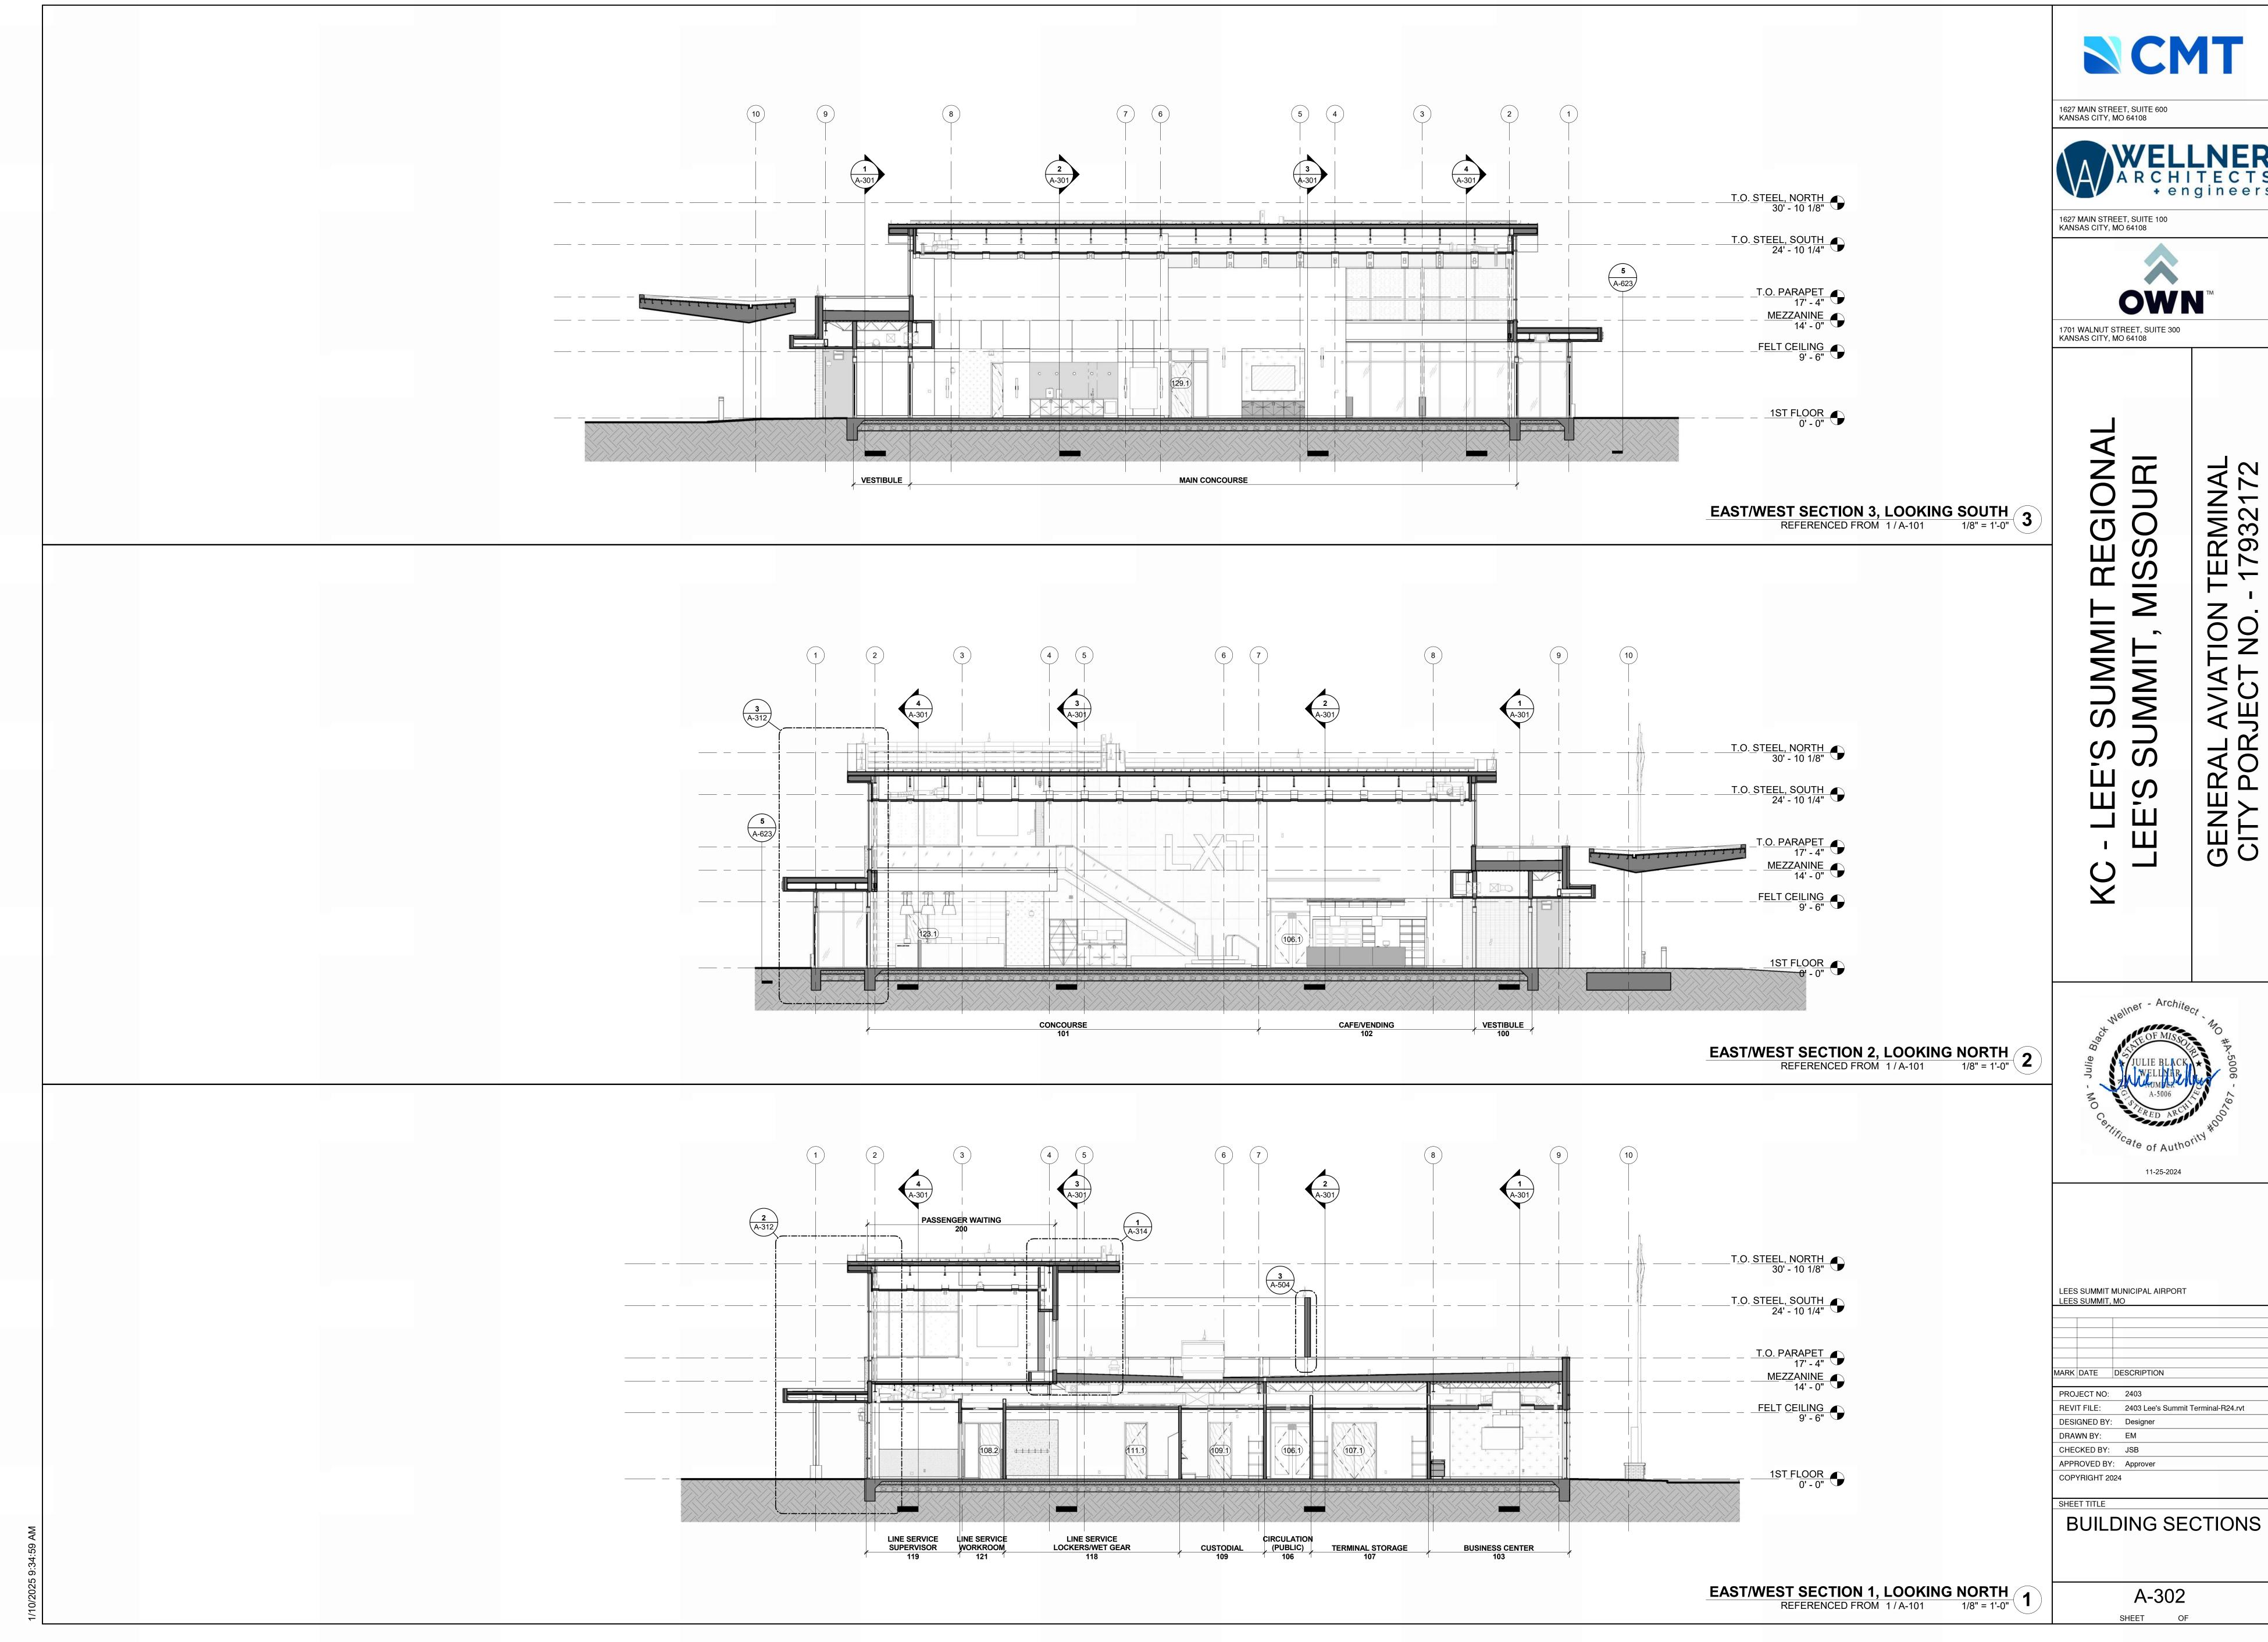
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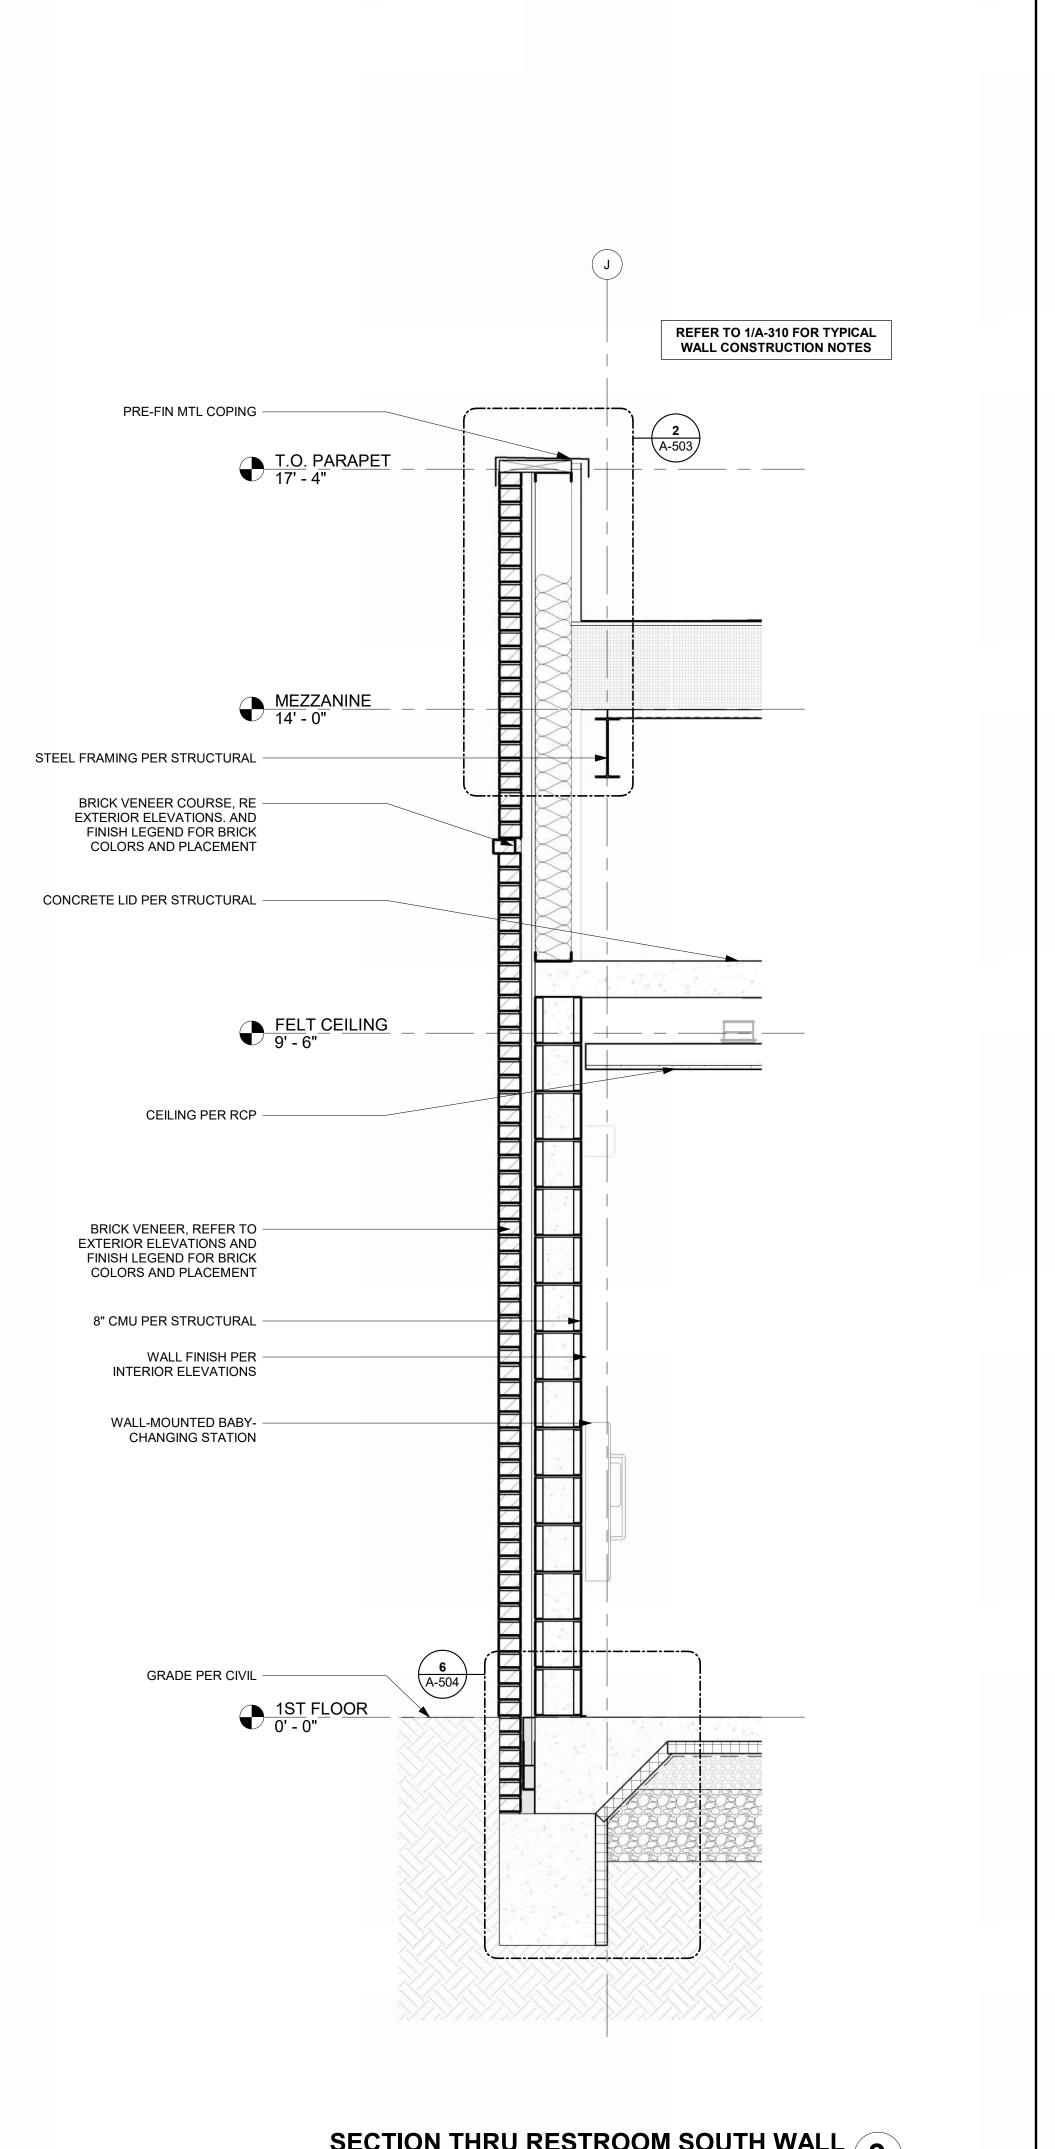
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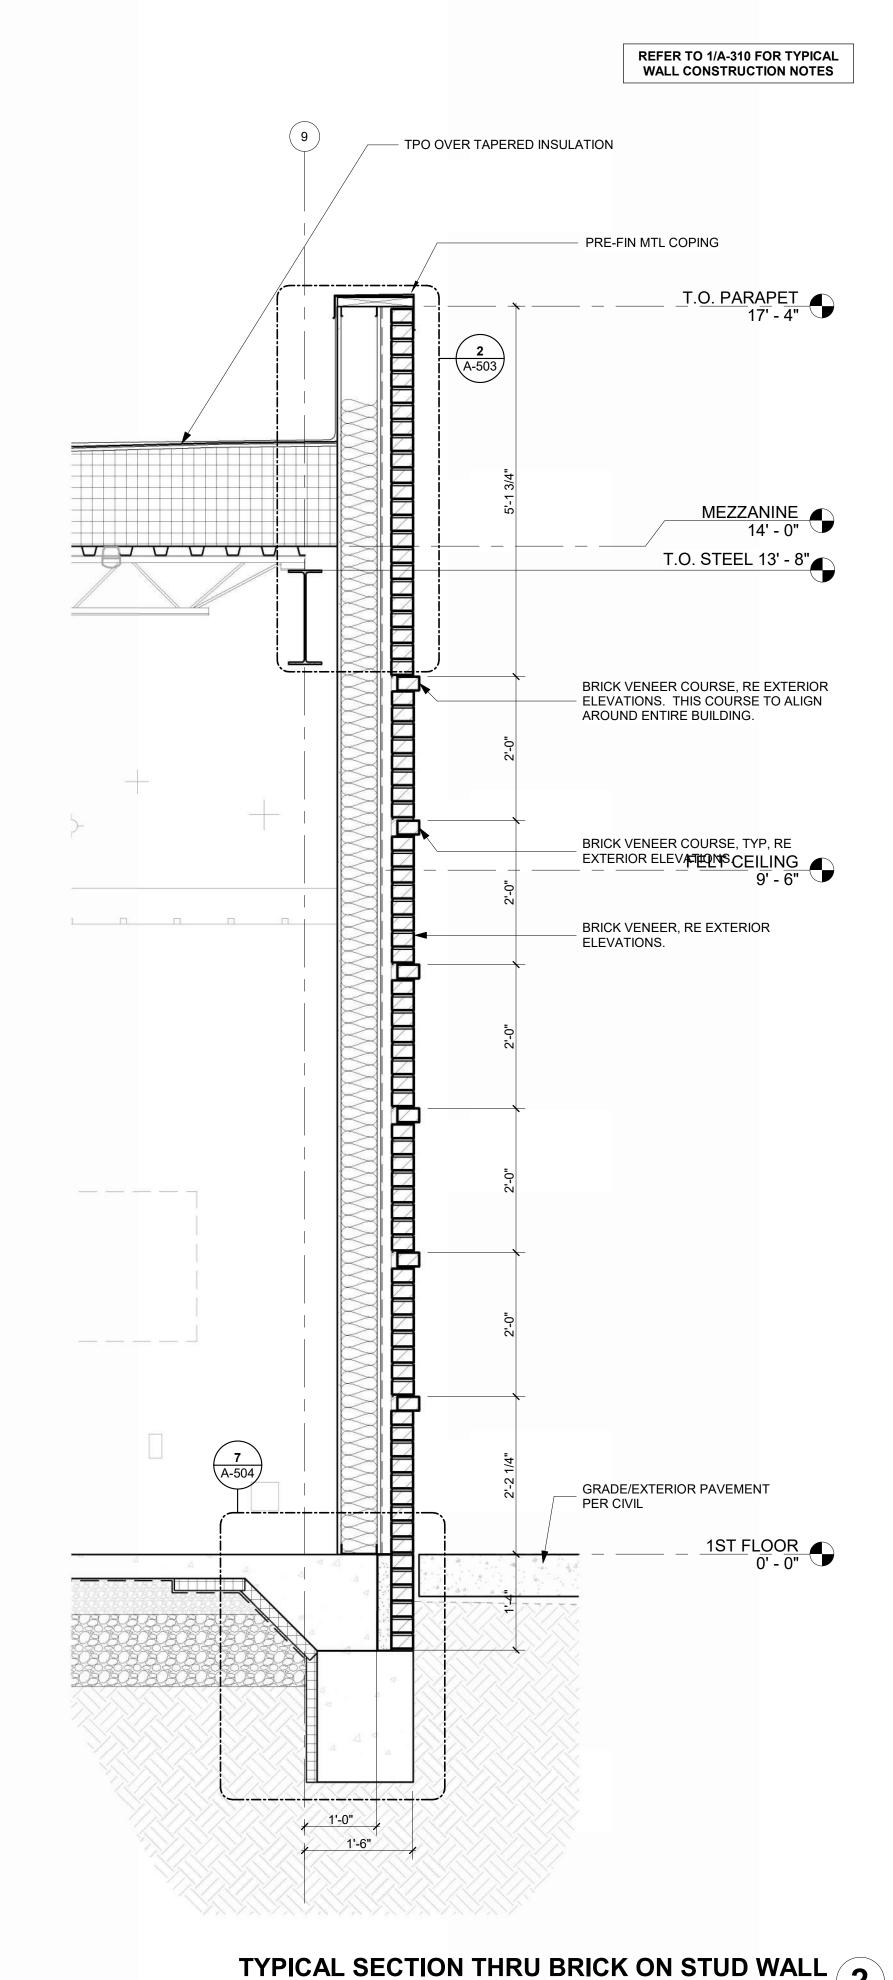
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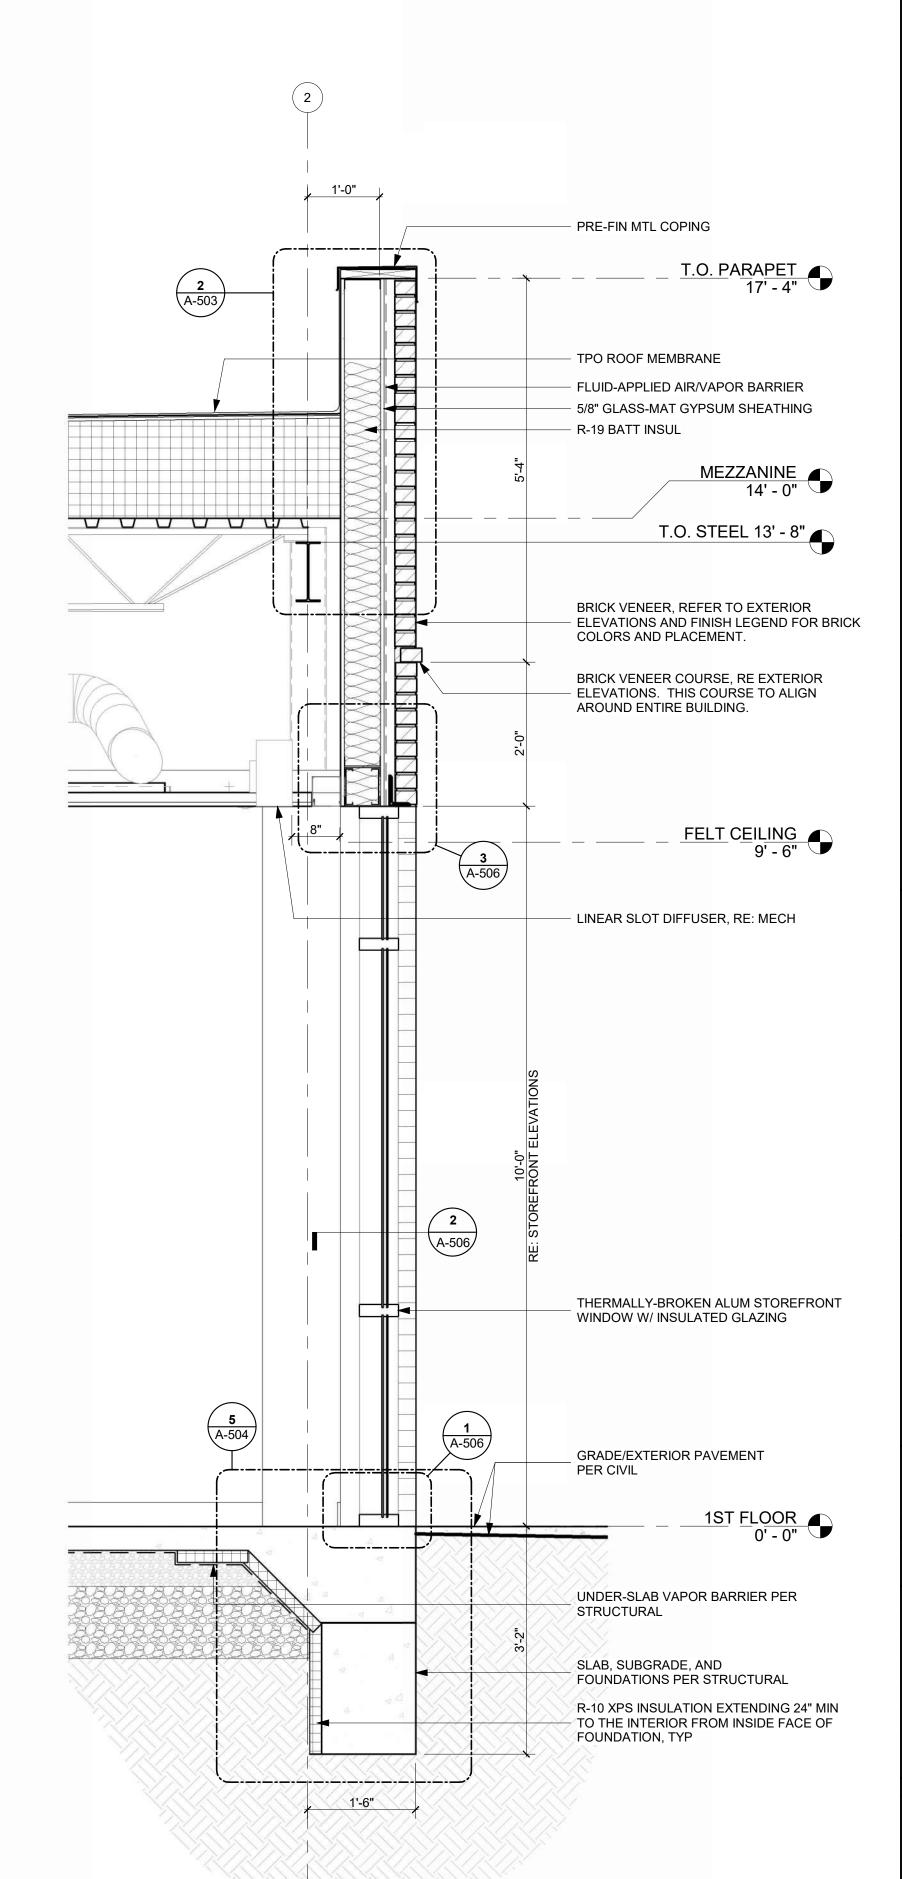
> A-201 SHEET OF













TERMINAL - 17932172

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11-25-2024 LEES SUMMIT MUNICIPAL AIRPORT LEES SUMMIT, MO

APPROVED BY: Approver COPYRIGHT 2024 WALL SECTIONS

> A-310 SHEET OF

SECTION THRU RESTROOM SOUTH WALL
REFERENCED FROM 2 / A-301 3/4" = 1'-0"

3

TYPICAL SECTION THRU BRICK ON STUD WALL

3/4" = 1'-0"

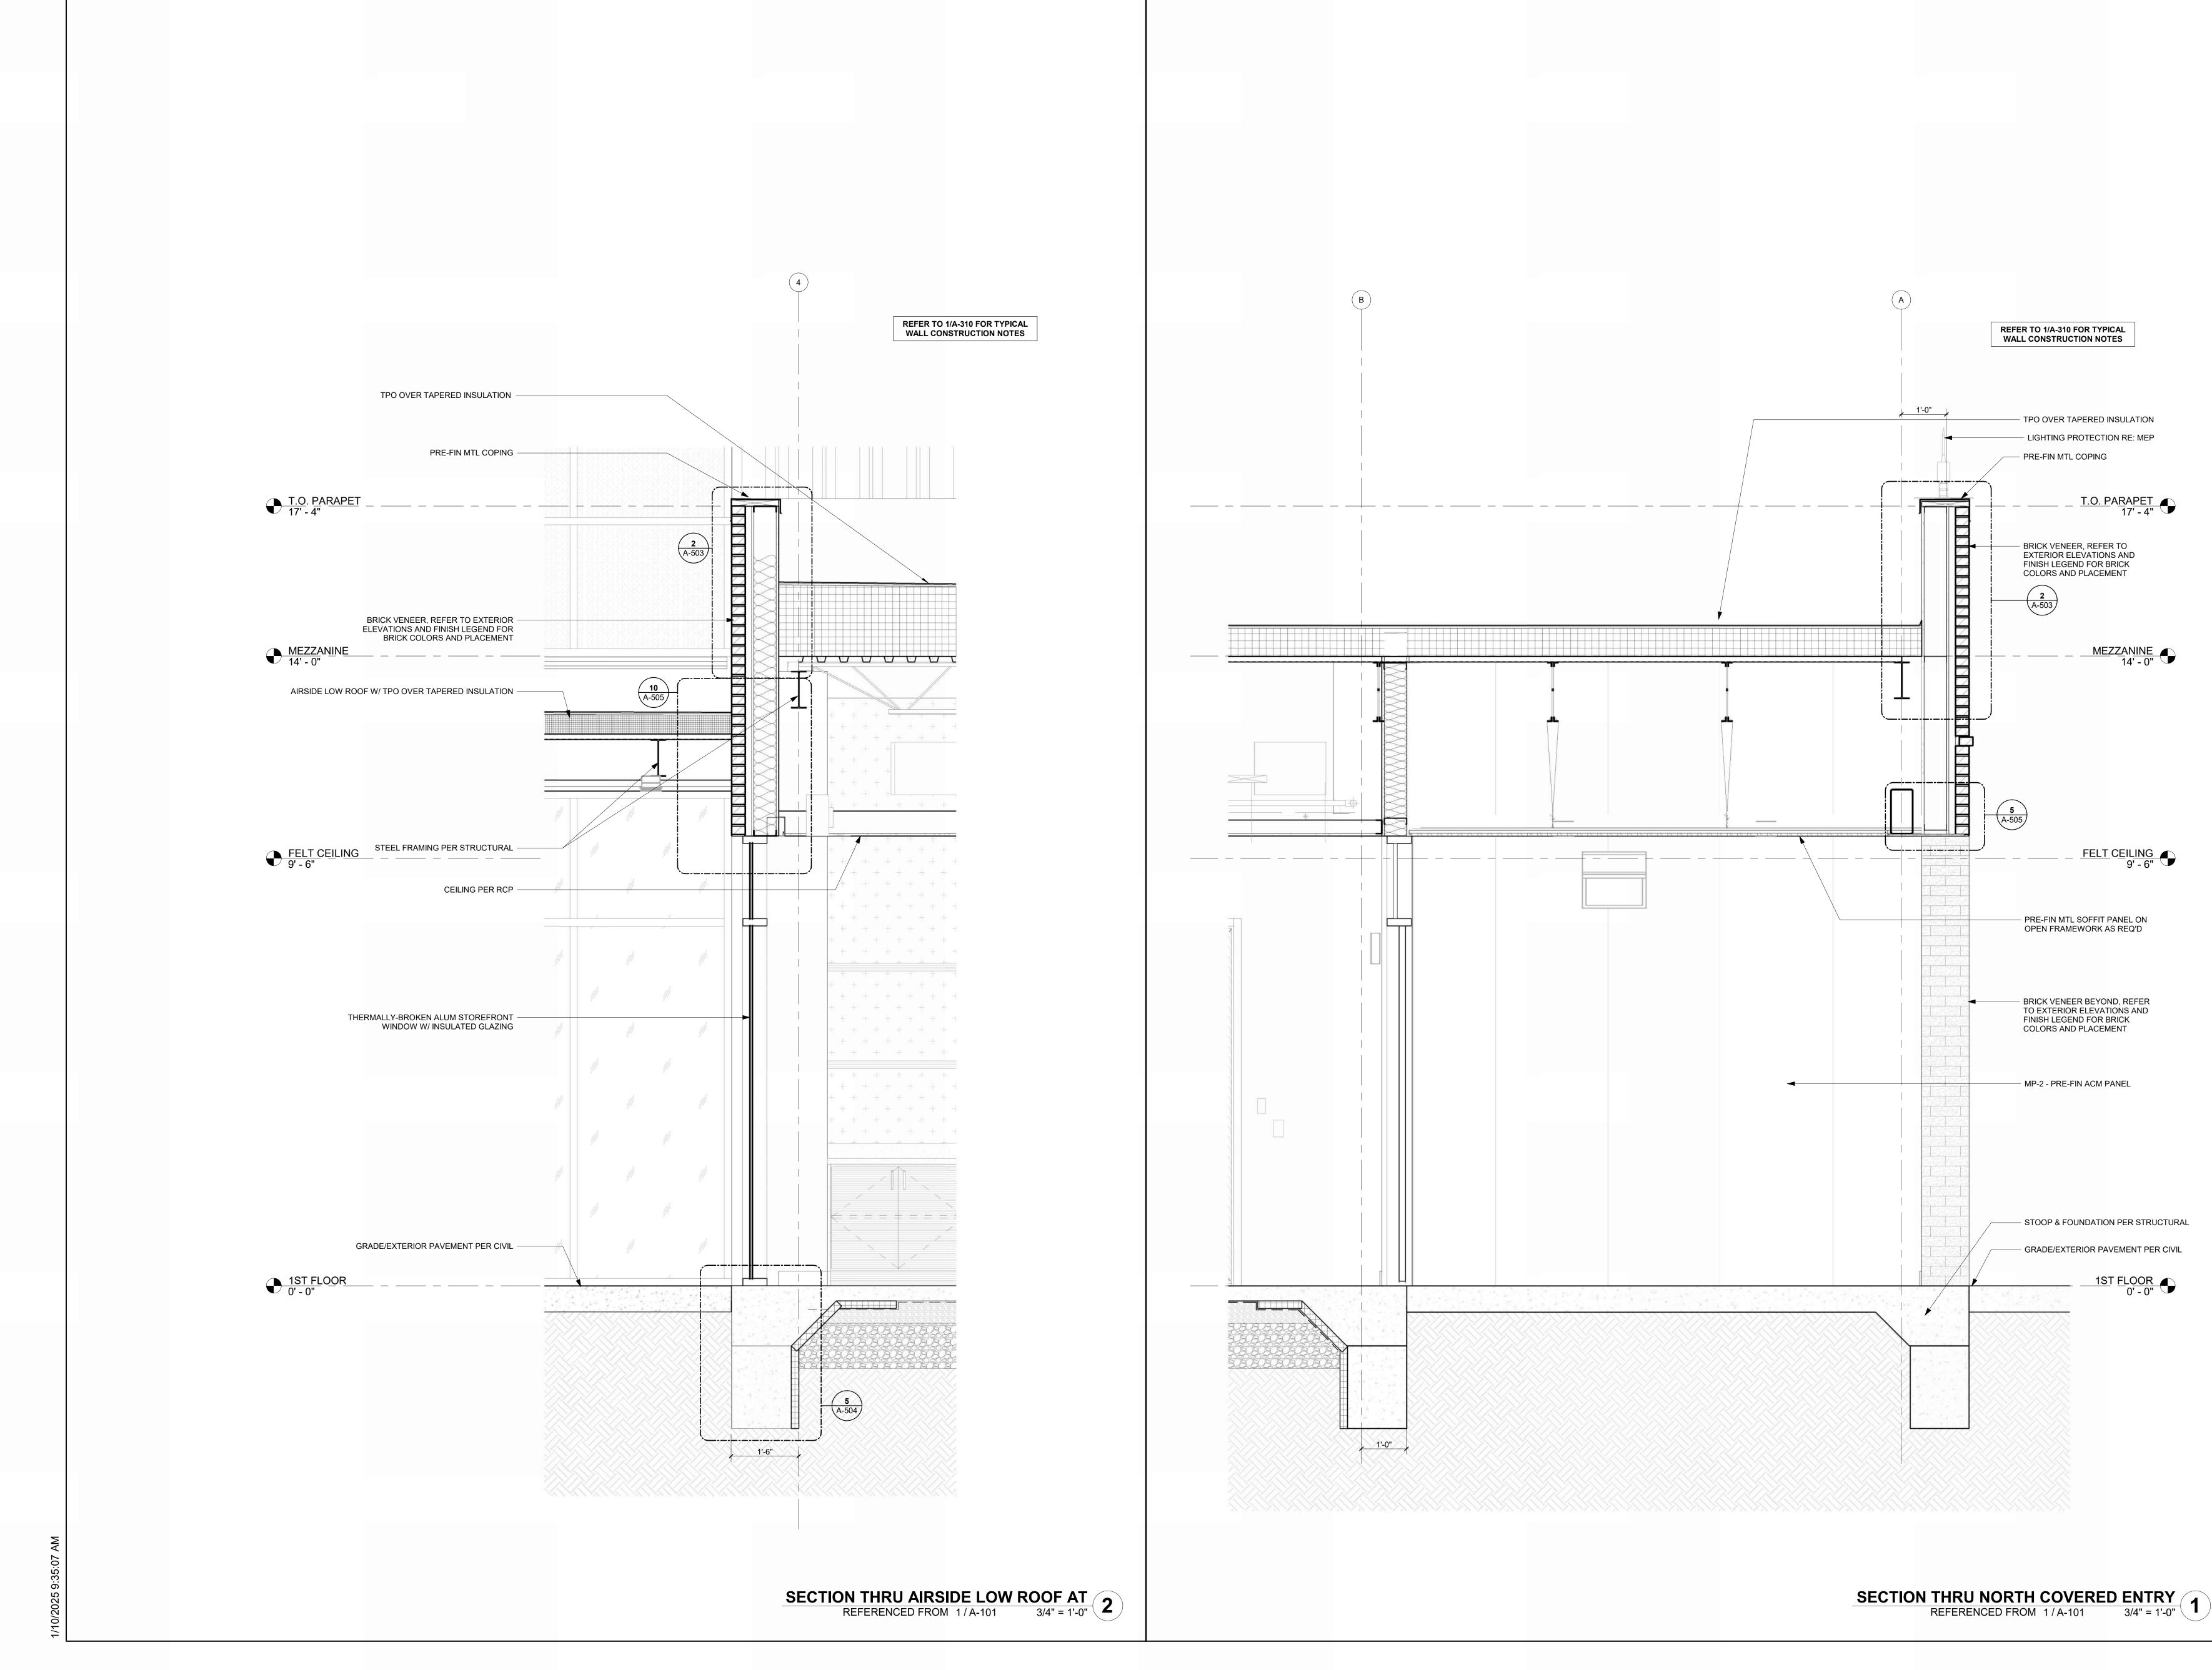
2

TYPICAL SECTION THRU STOREFRONT IN MTL STUD WALL

MARK DATE DESCRIPTION

PROJECT NO: 2403 REVIT FILE: 2403 Lee's Summit Terminal-R24.rvt DESIGNED BY: Designer DRAWN BY: EM CHECKED BY: JSB

SHEET TITLE



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MARK DATE DESCRIPTION

REVIT FILE: 2403 Lee's Summit Terminal-R24.rvt

WALL SECTIONS

A-311

SHEET OF

PROJECT NO: 2403

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LEES SUMMIT, MO

TERMINAL - 17932172

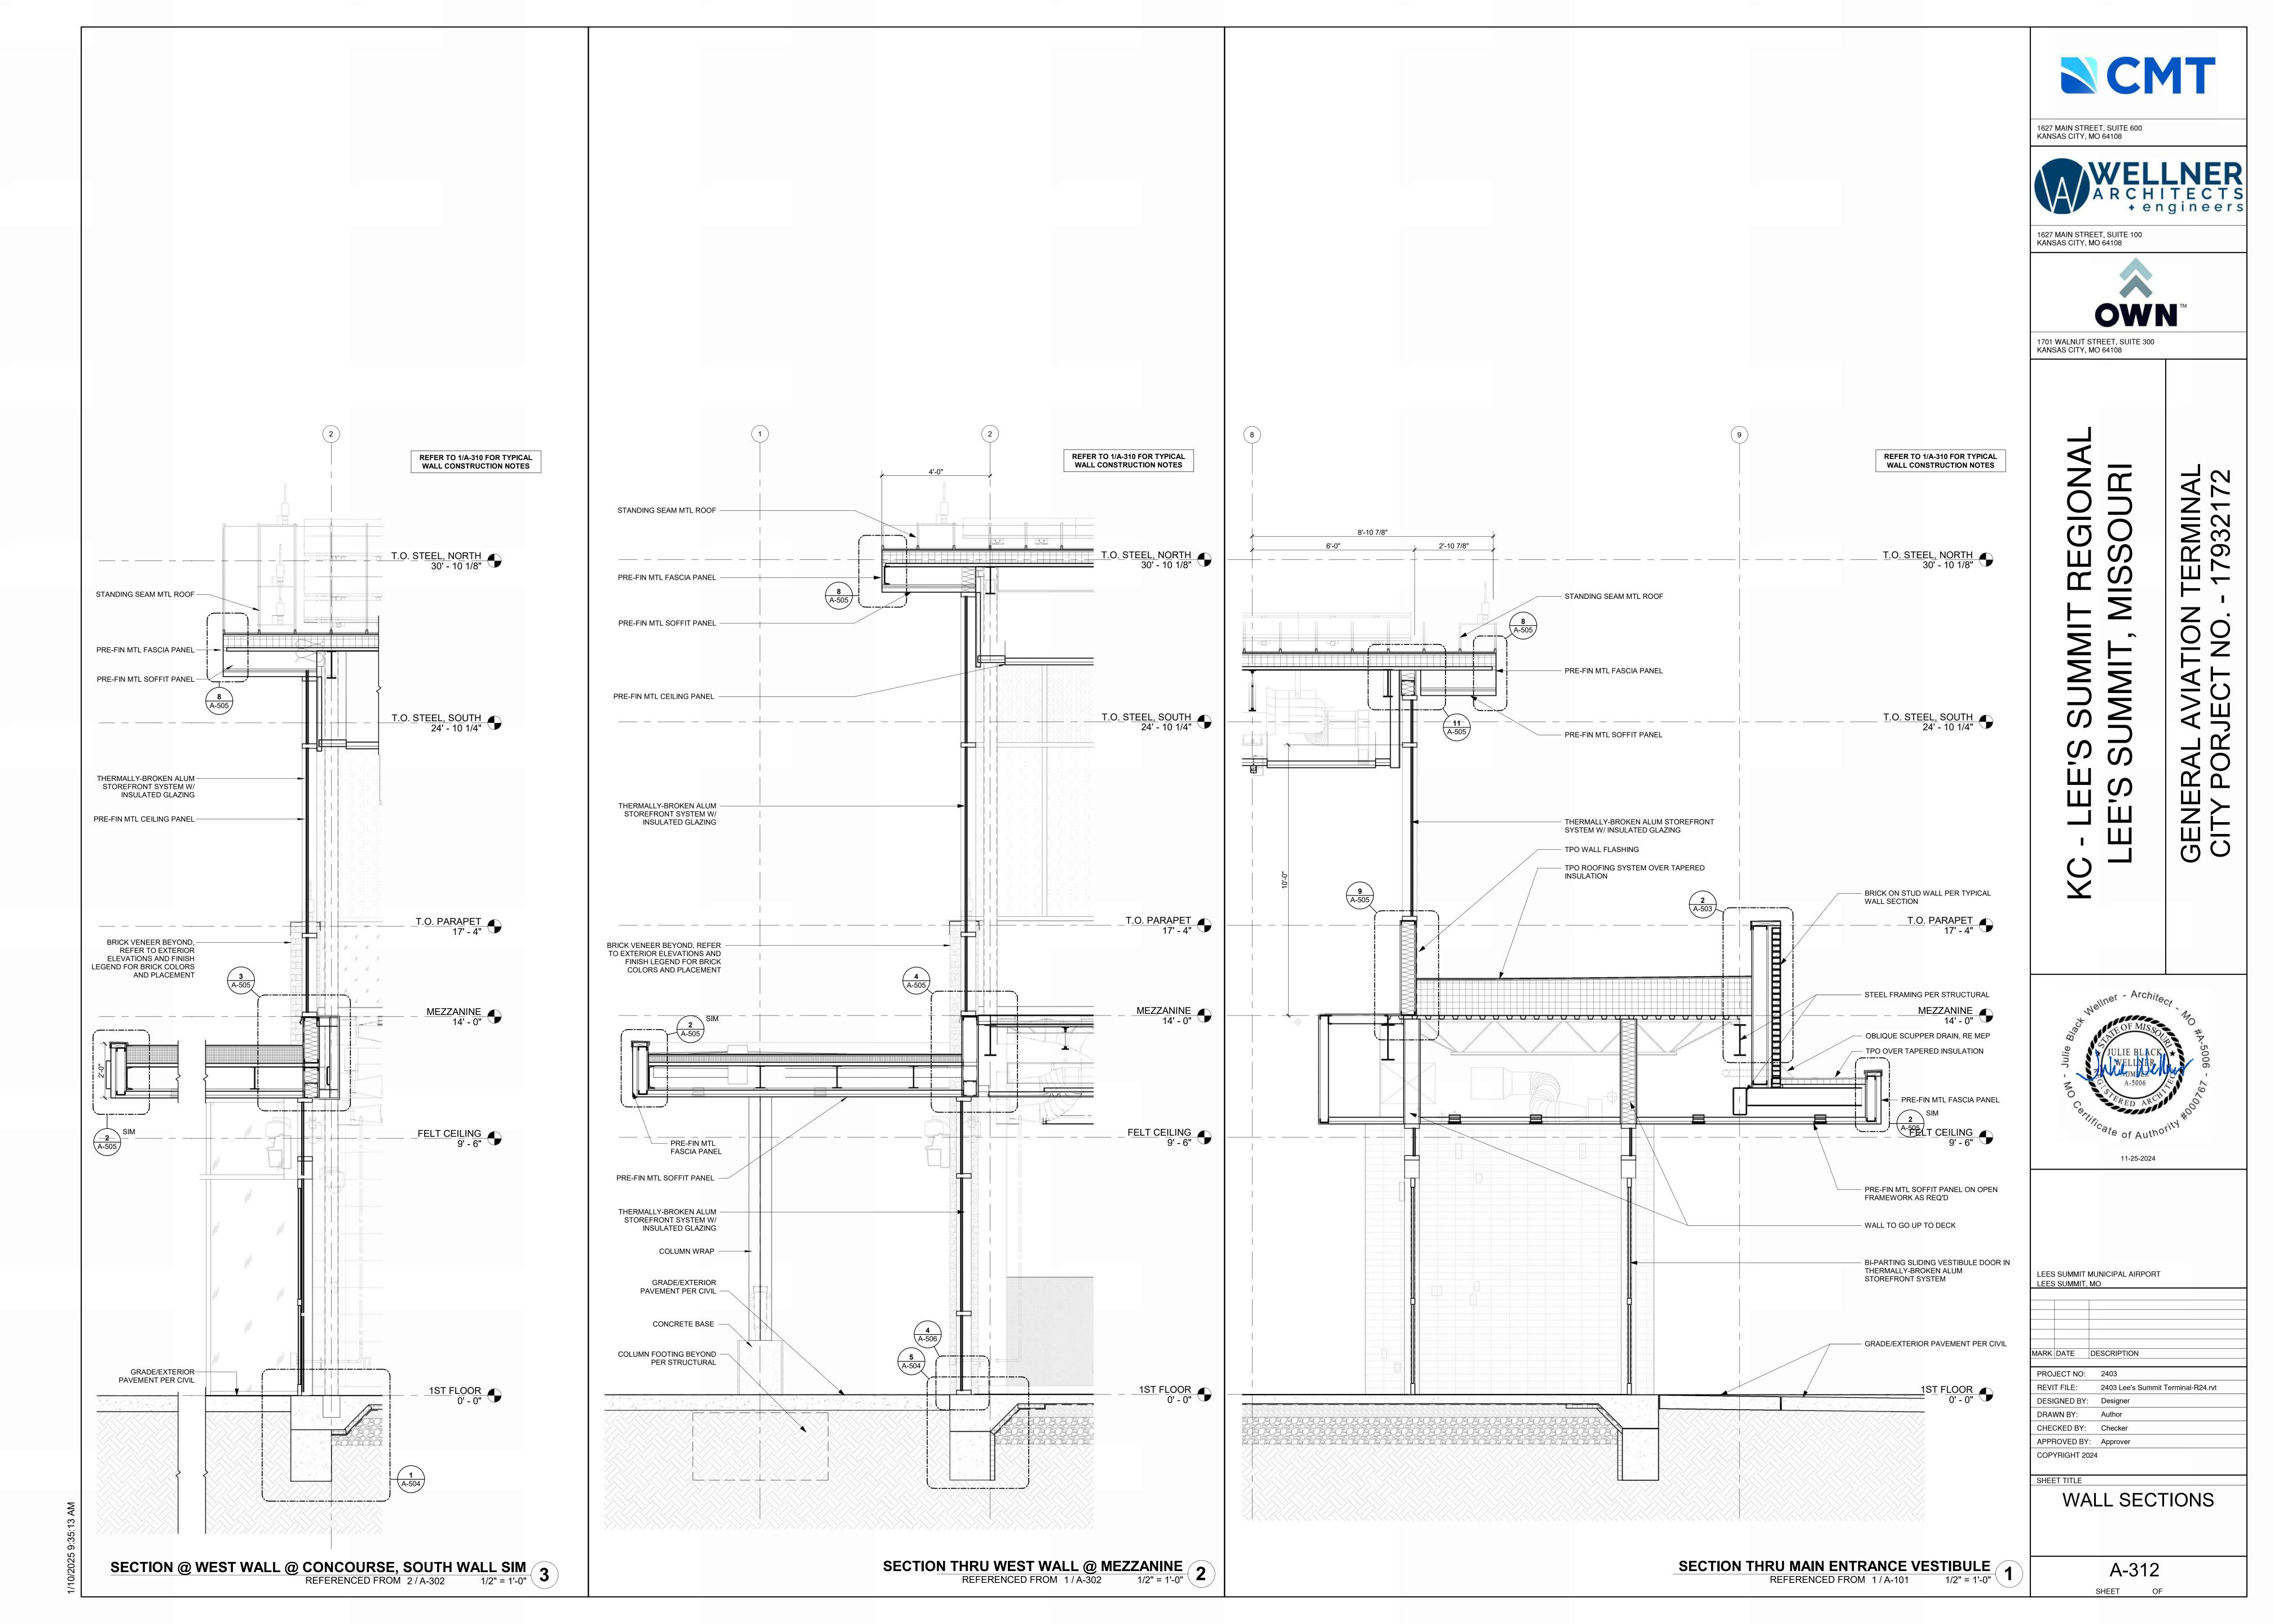
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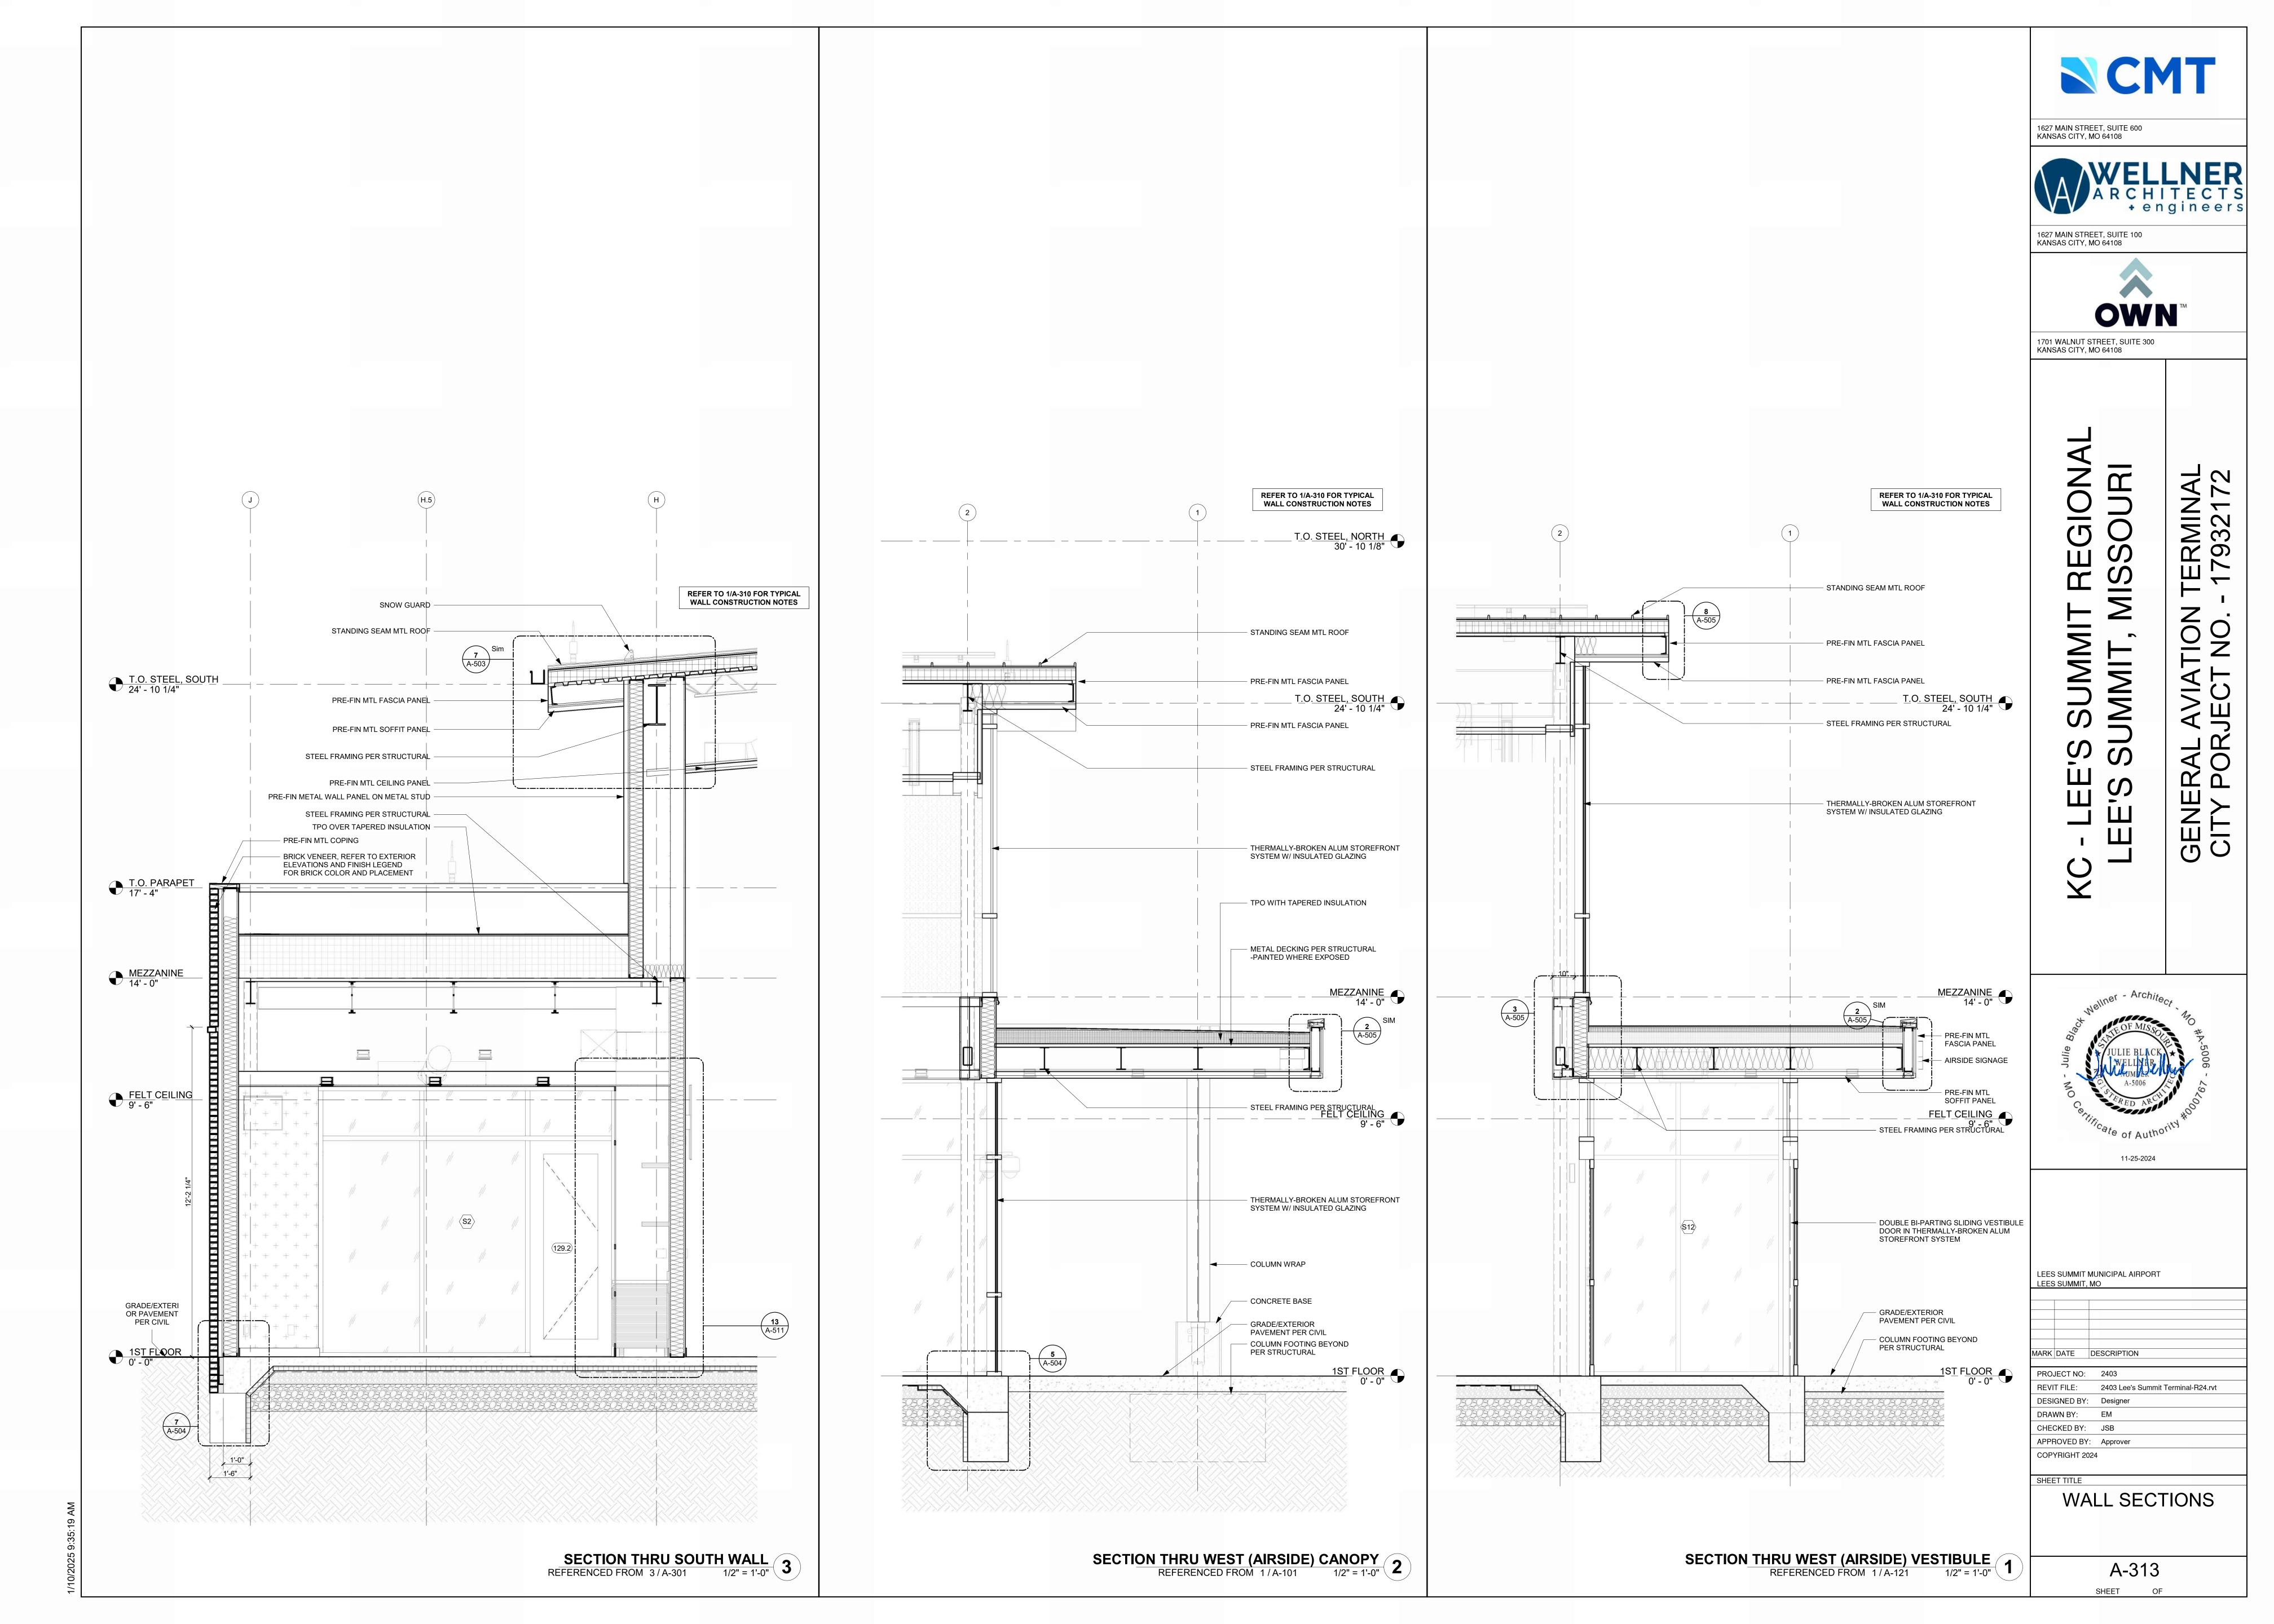


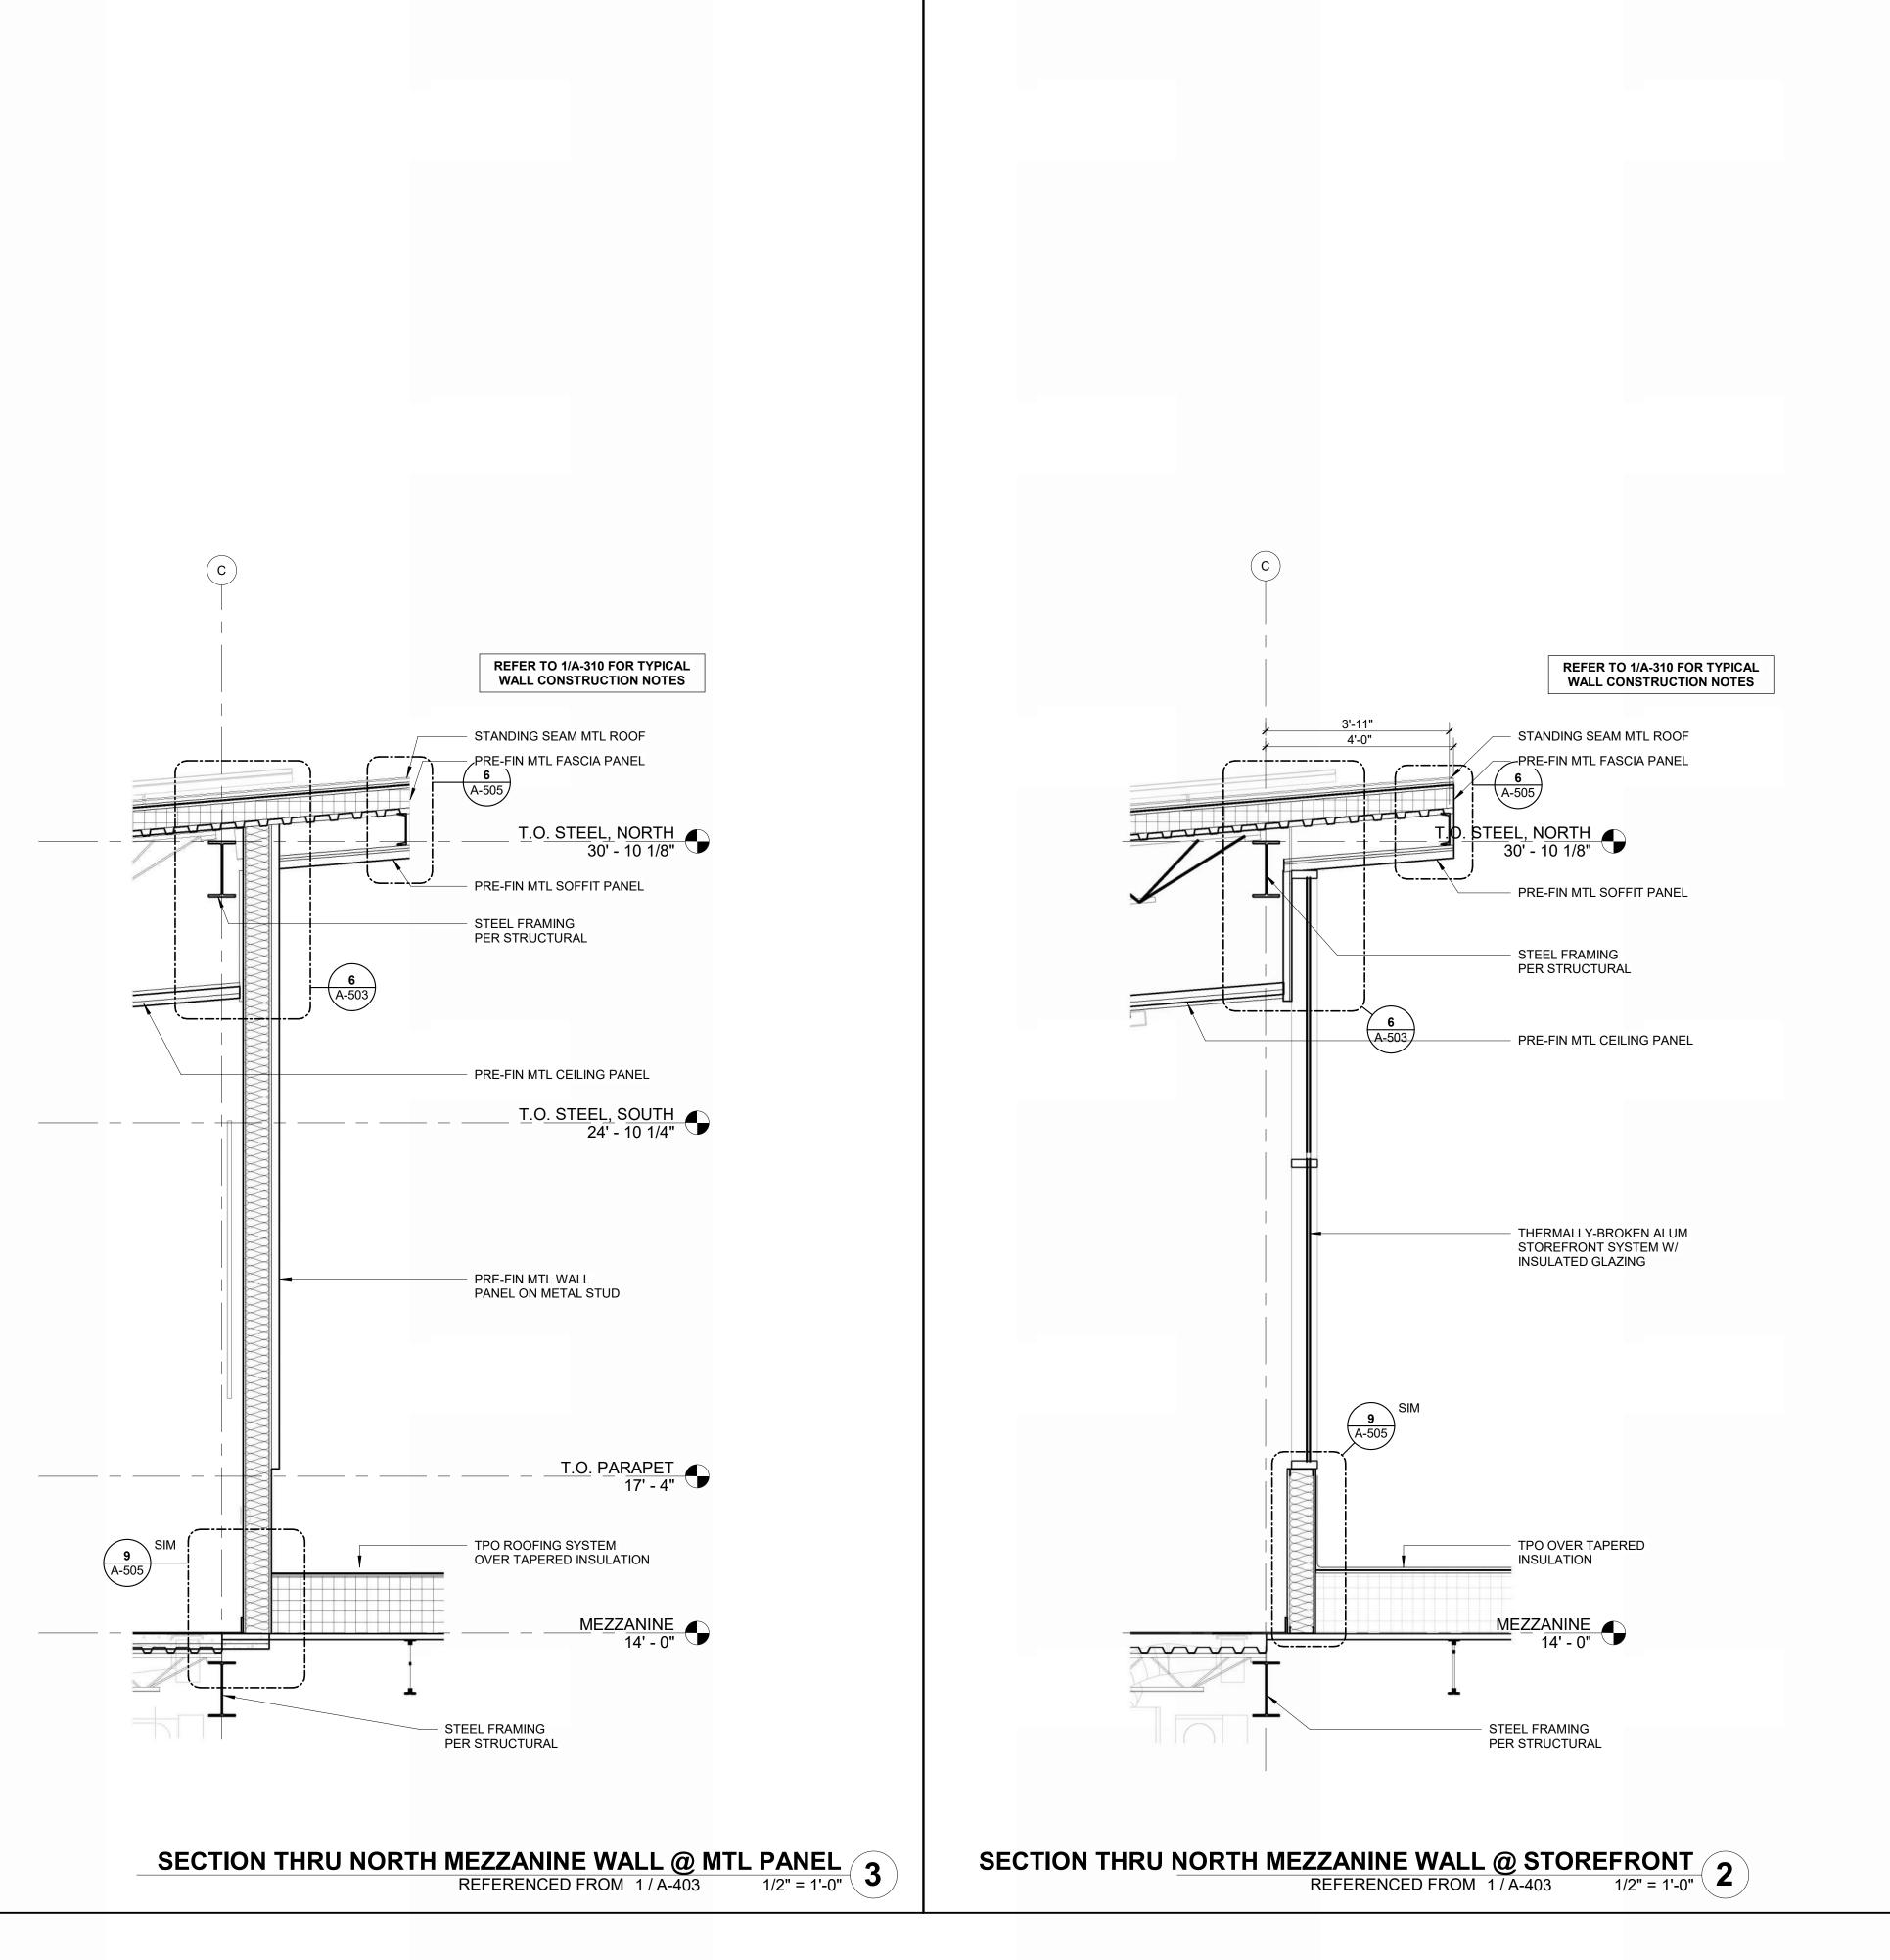
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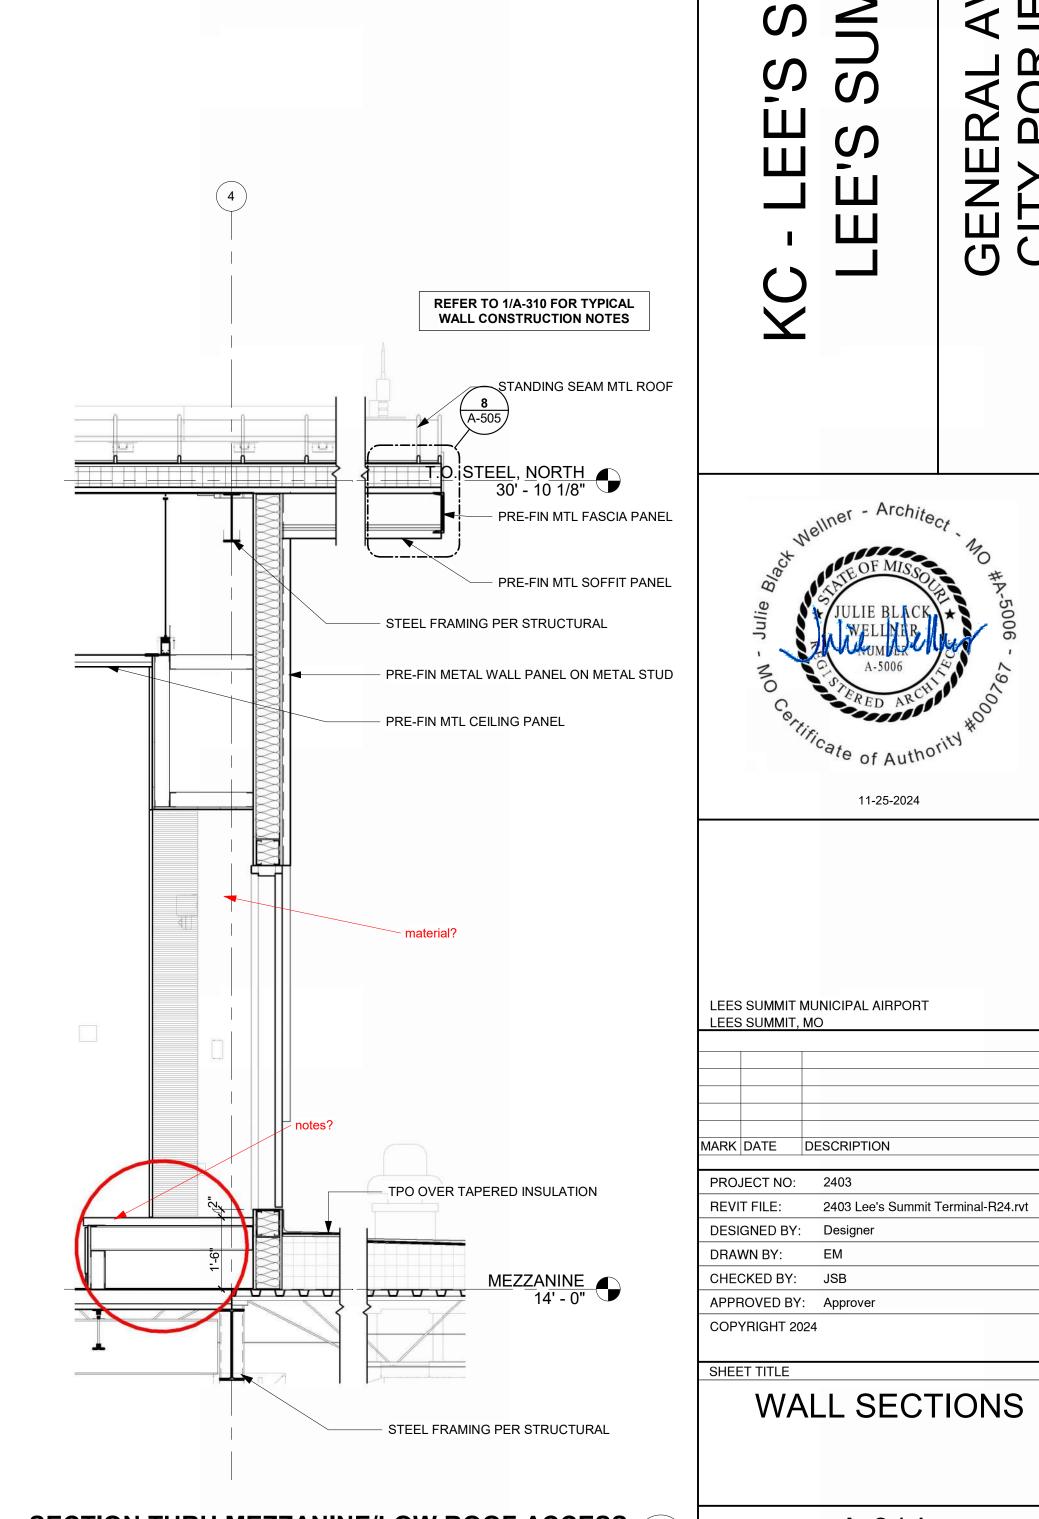
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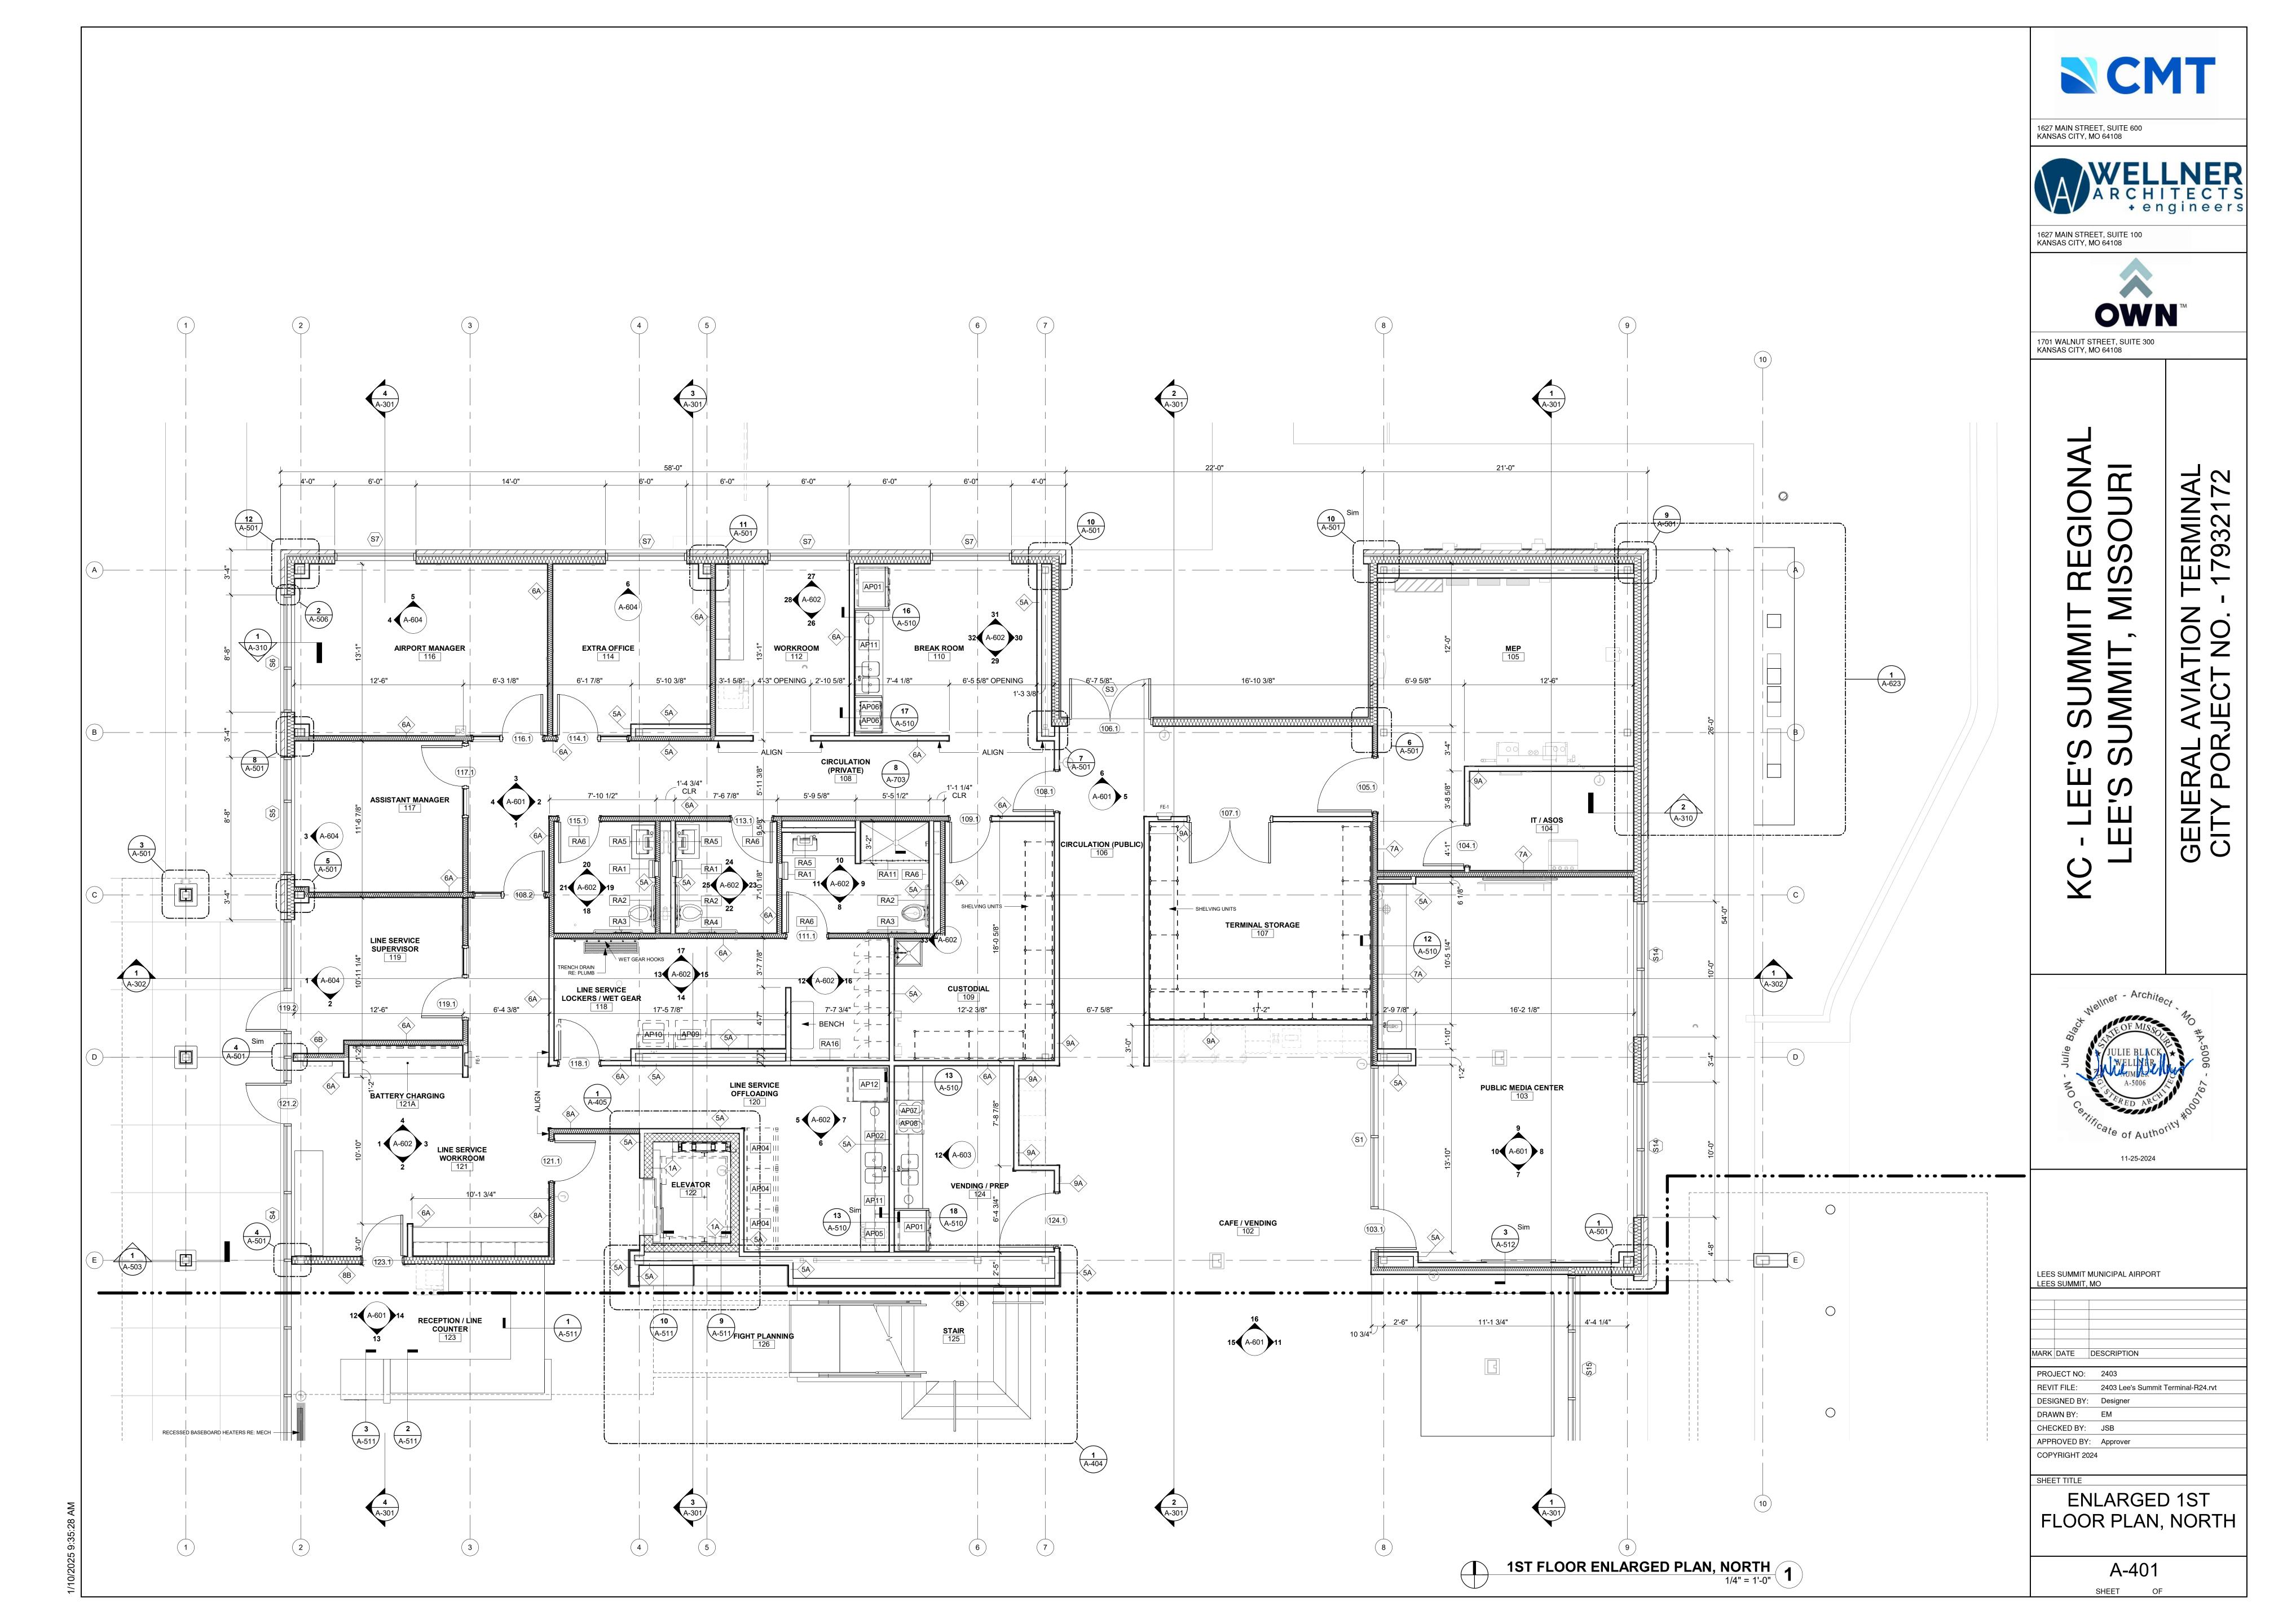
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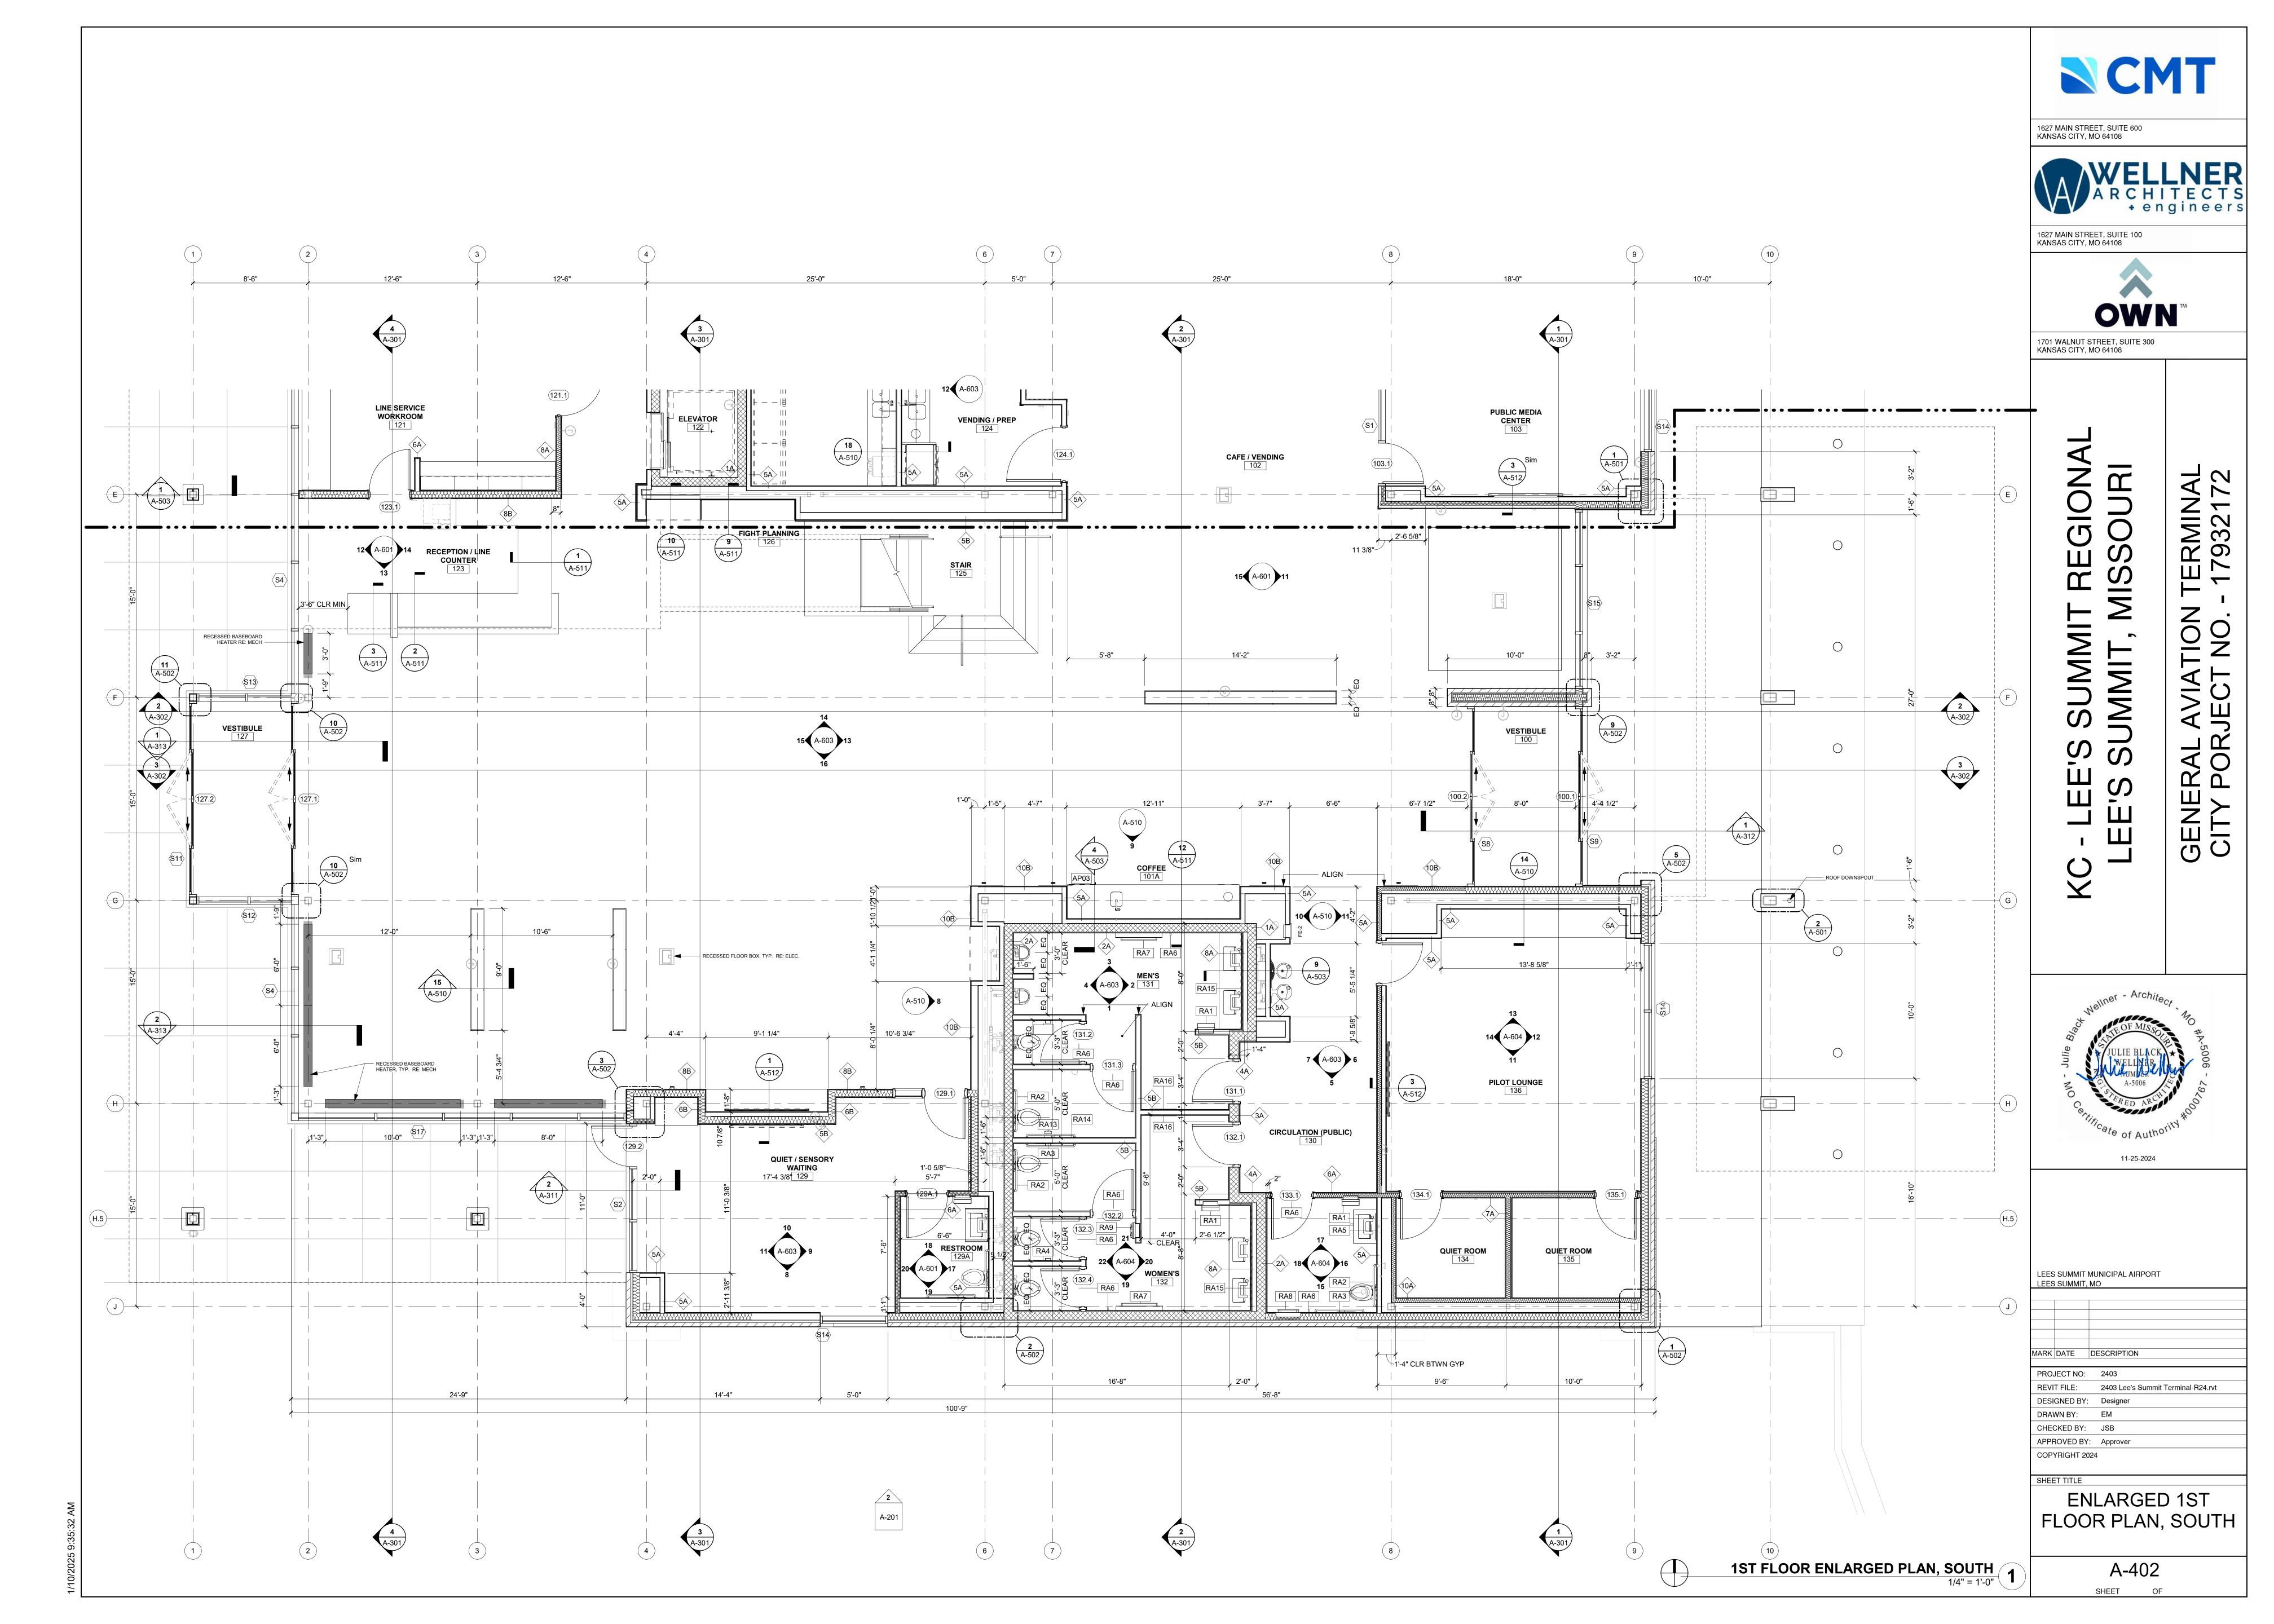
11-25-2024 LEES SUMMIT MUNICIPAL AIRPORT LEES SUMMIT, MO PROJECT NO: 2403


WALL SECTIONS

A-314 SHEET OF

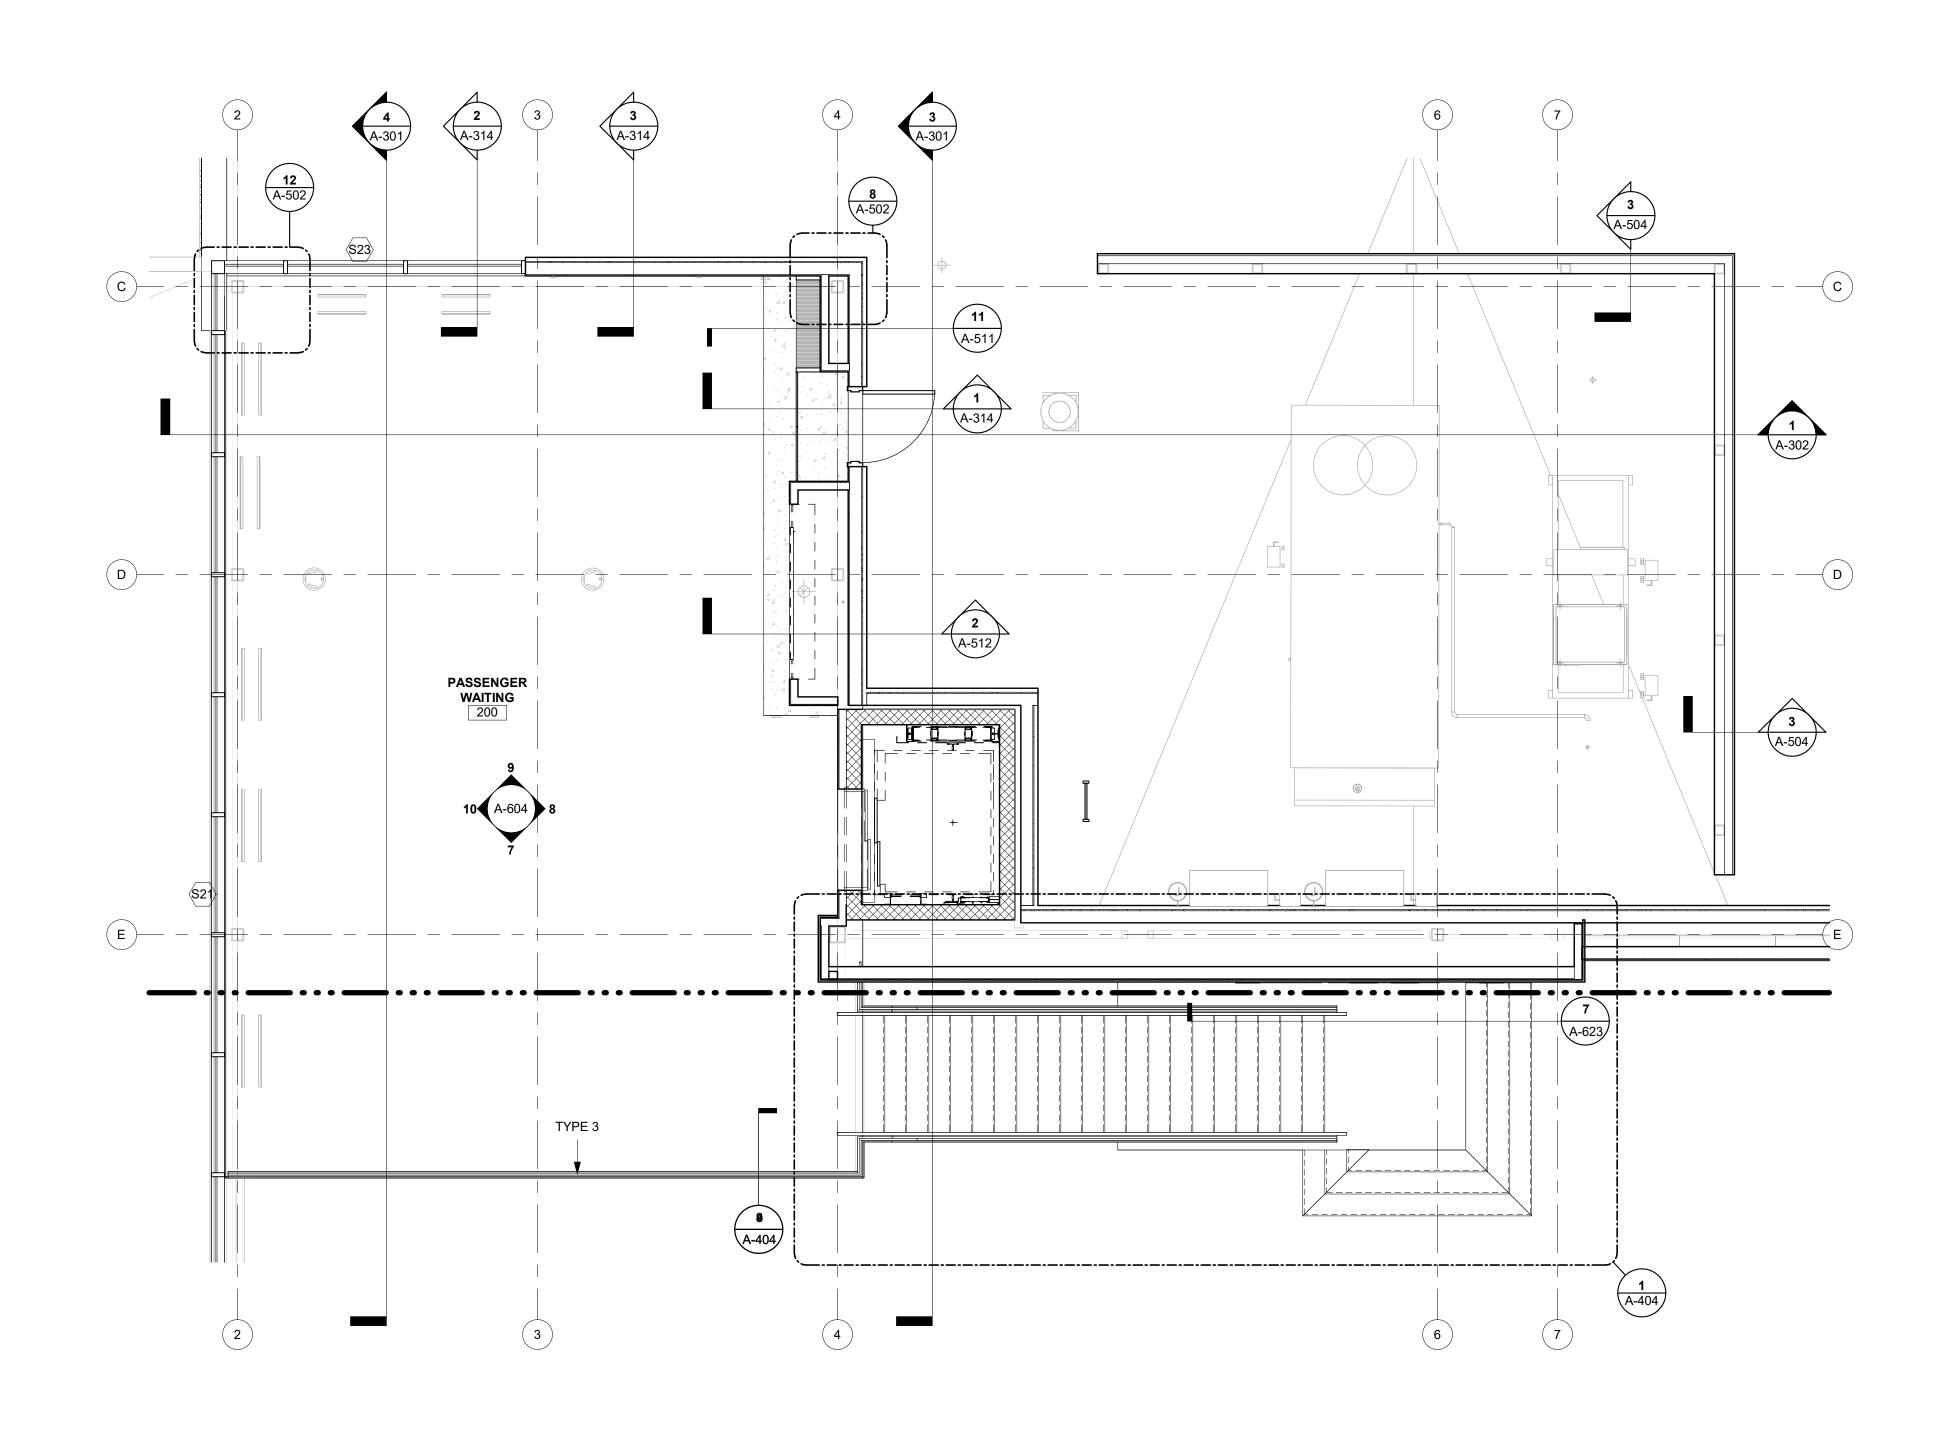SECTION THRU MEZZANINE/LOW ROOF ACCESS
REFERENCED FROM 1/A-302 1/2" = 1'-0"









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TERMINAL - 17932172

11-25-2024

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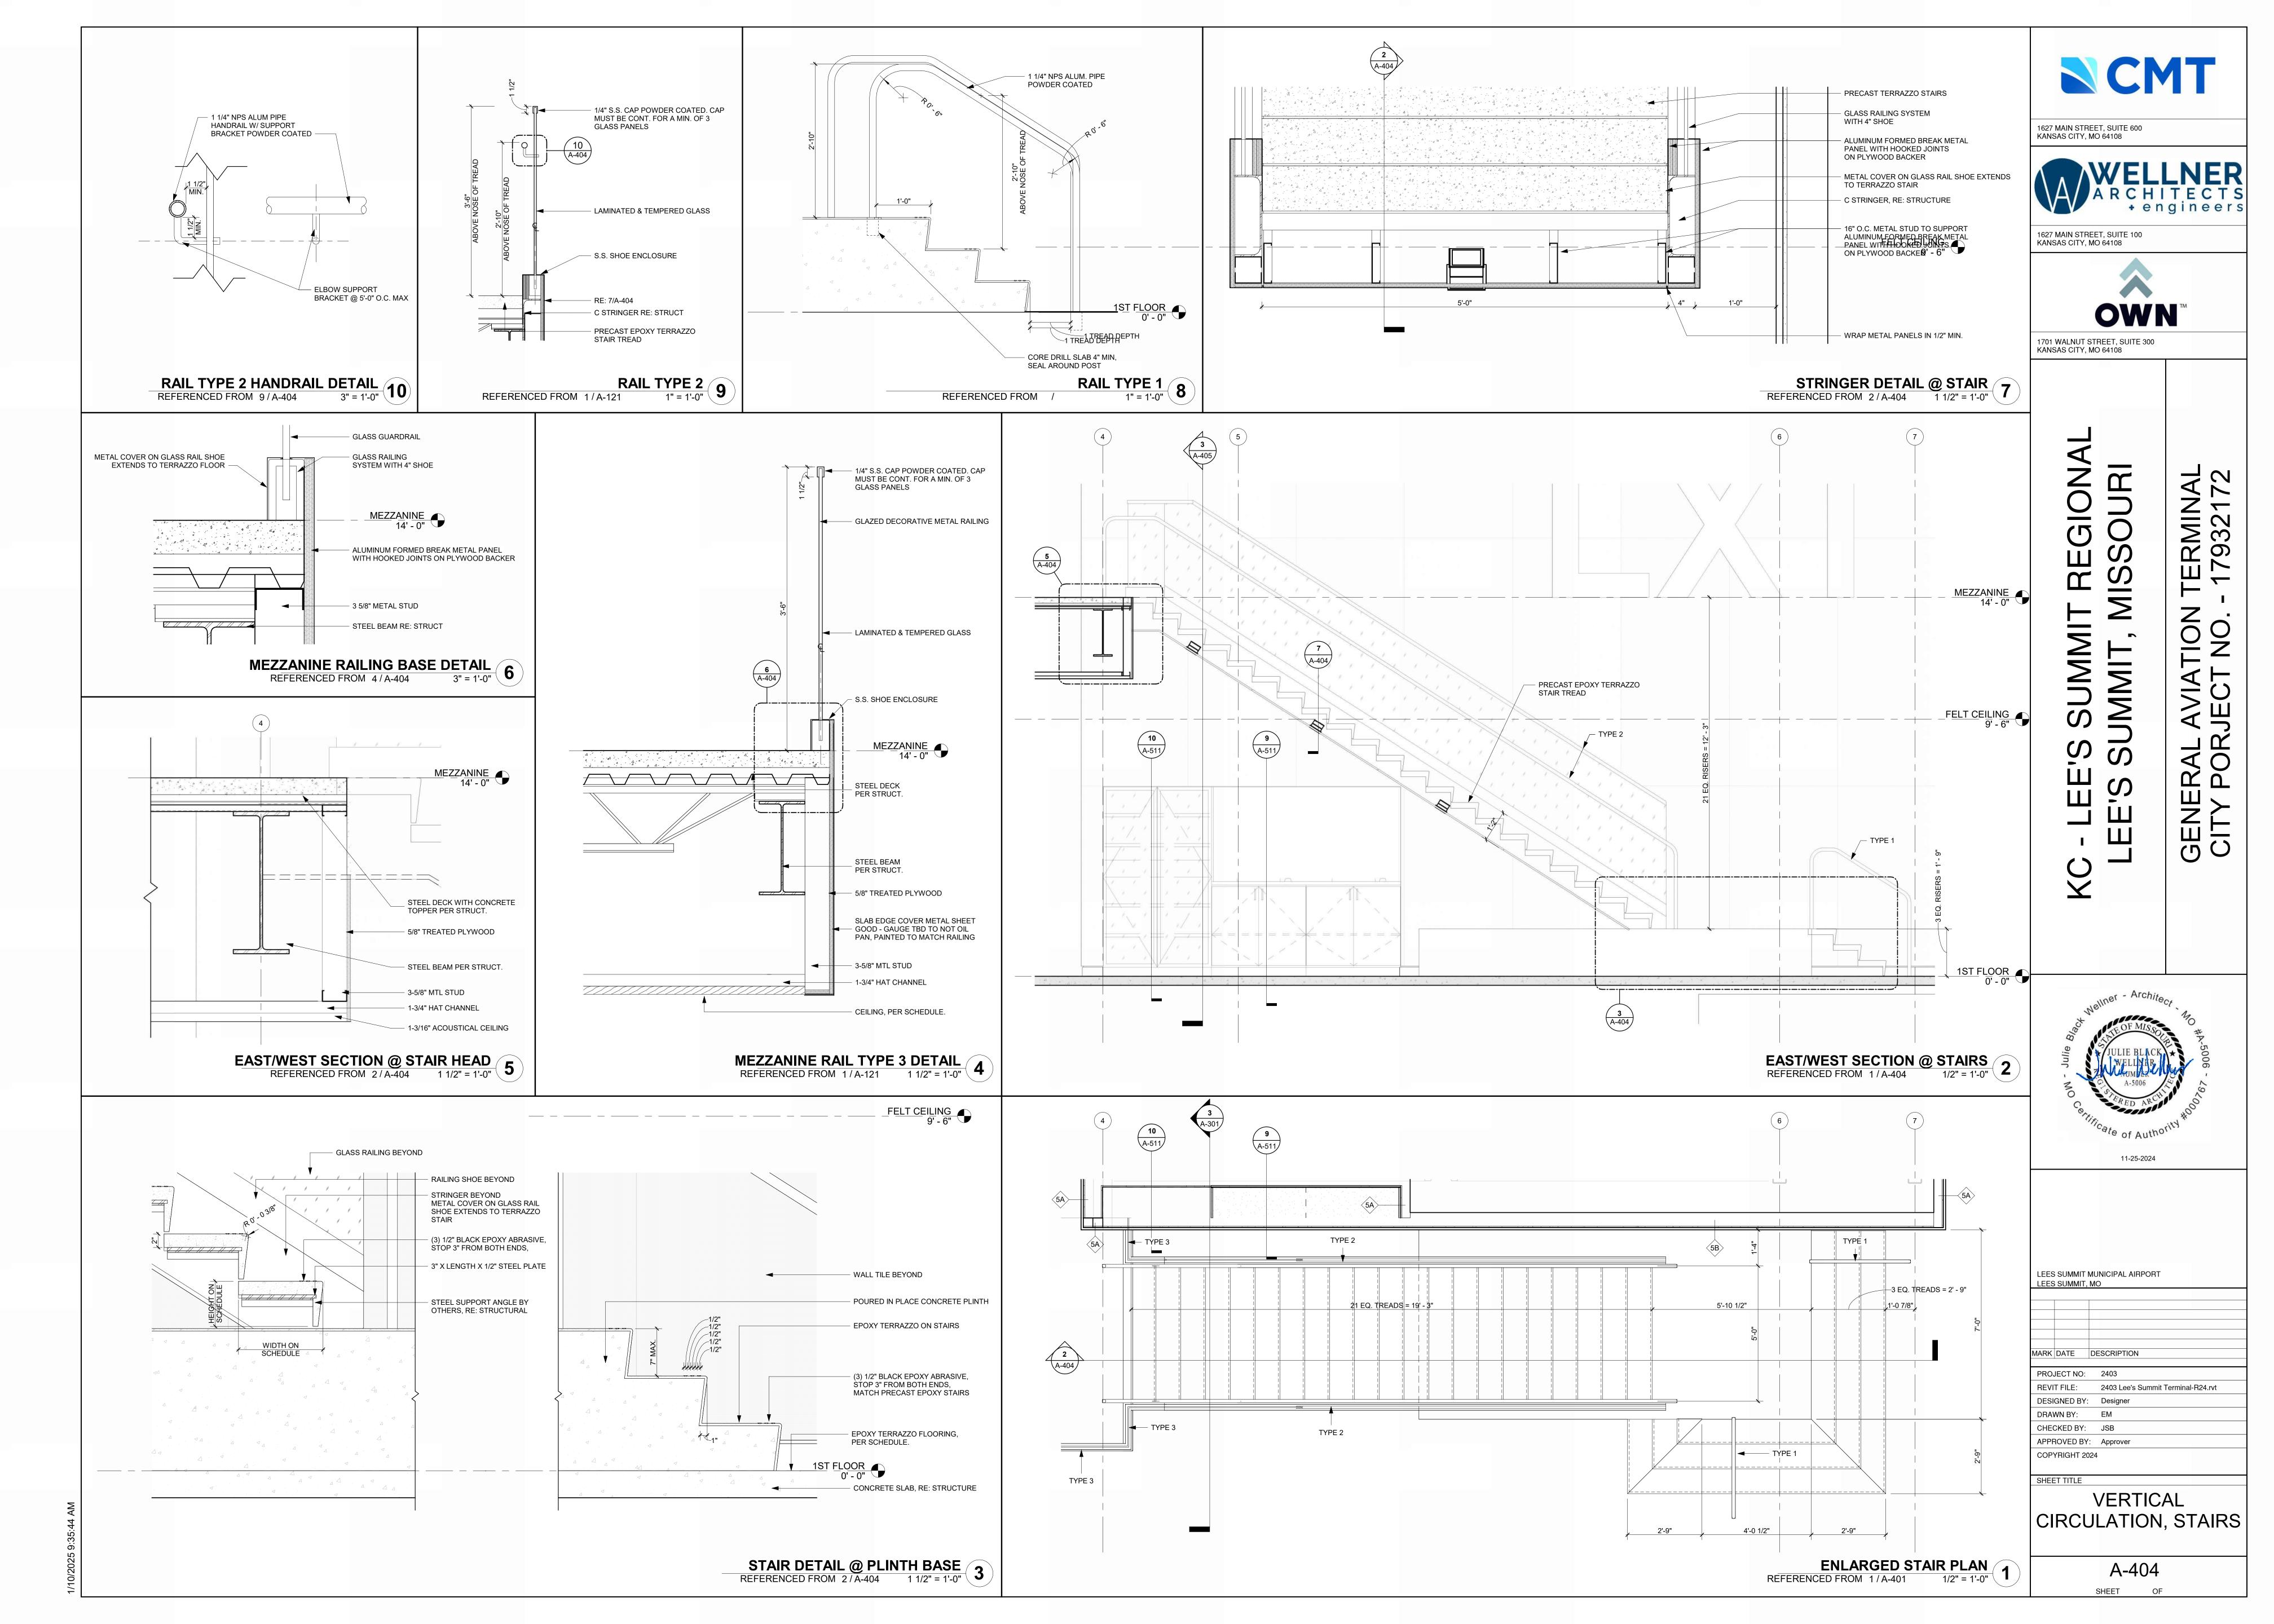
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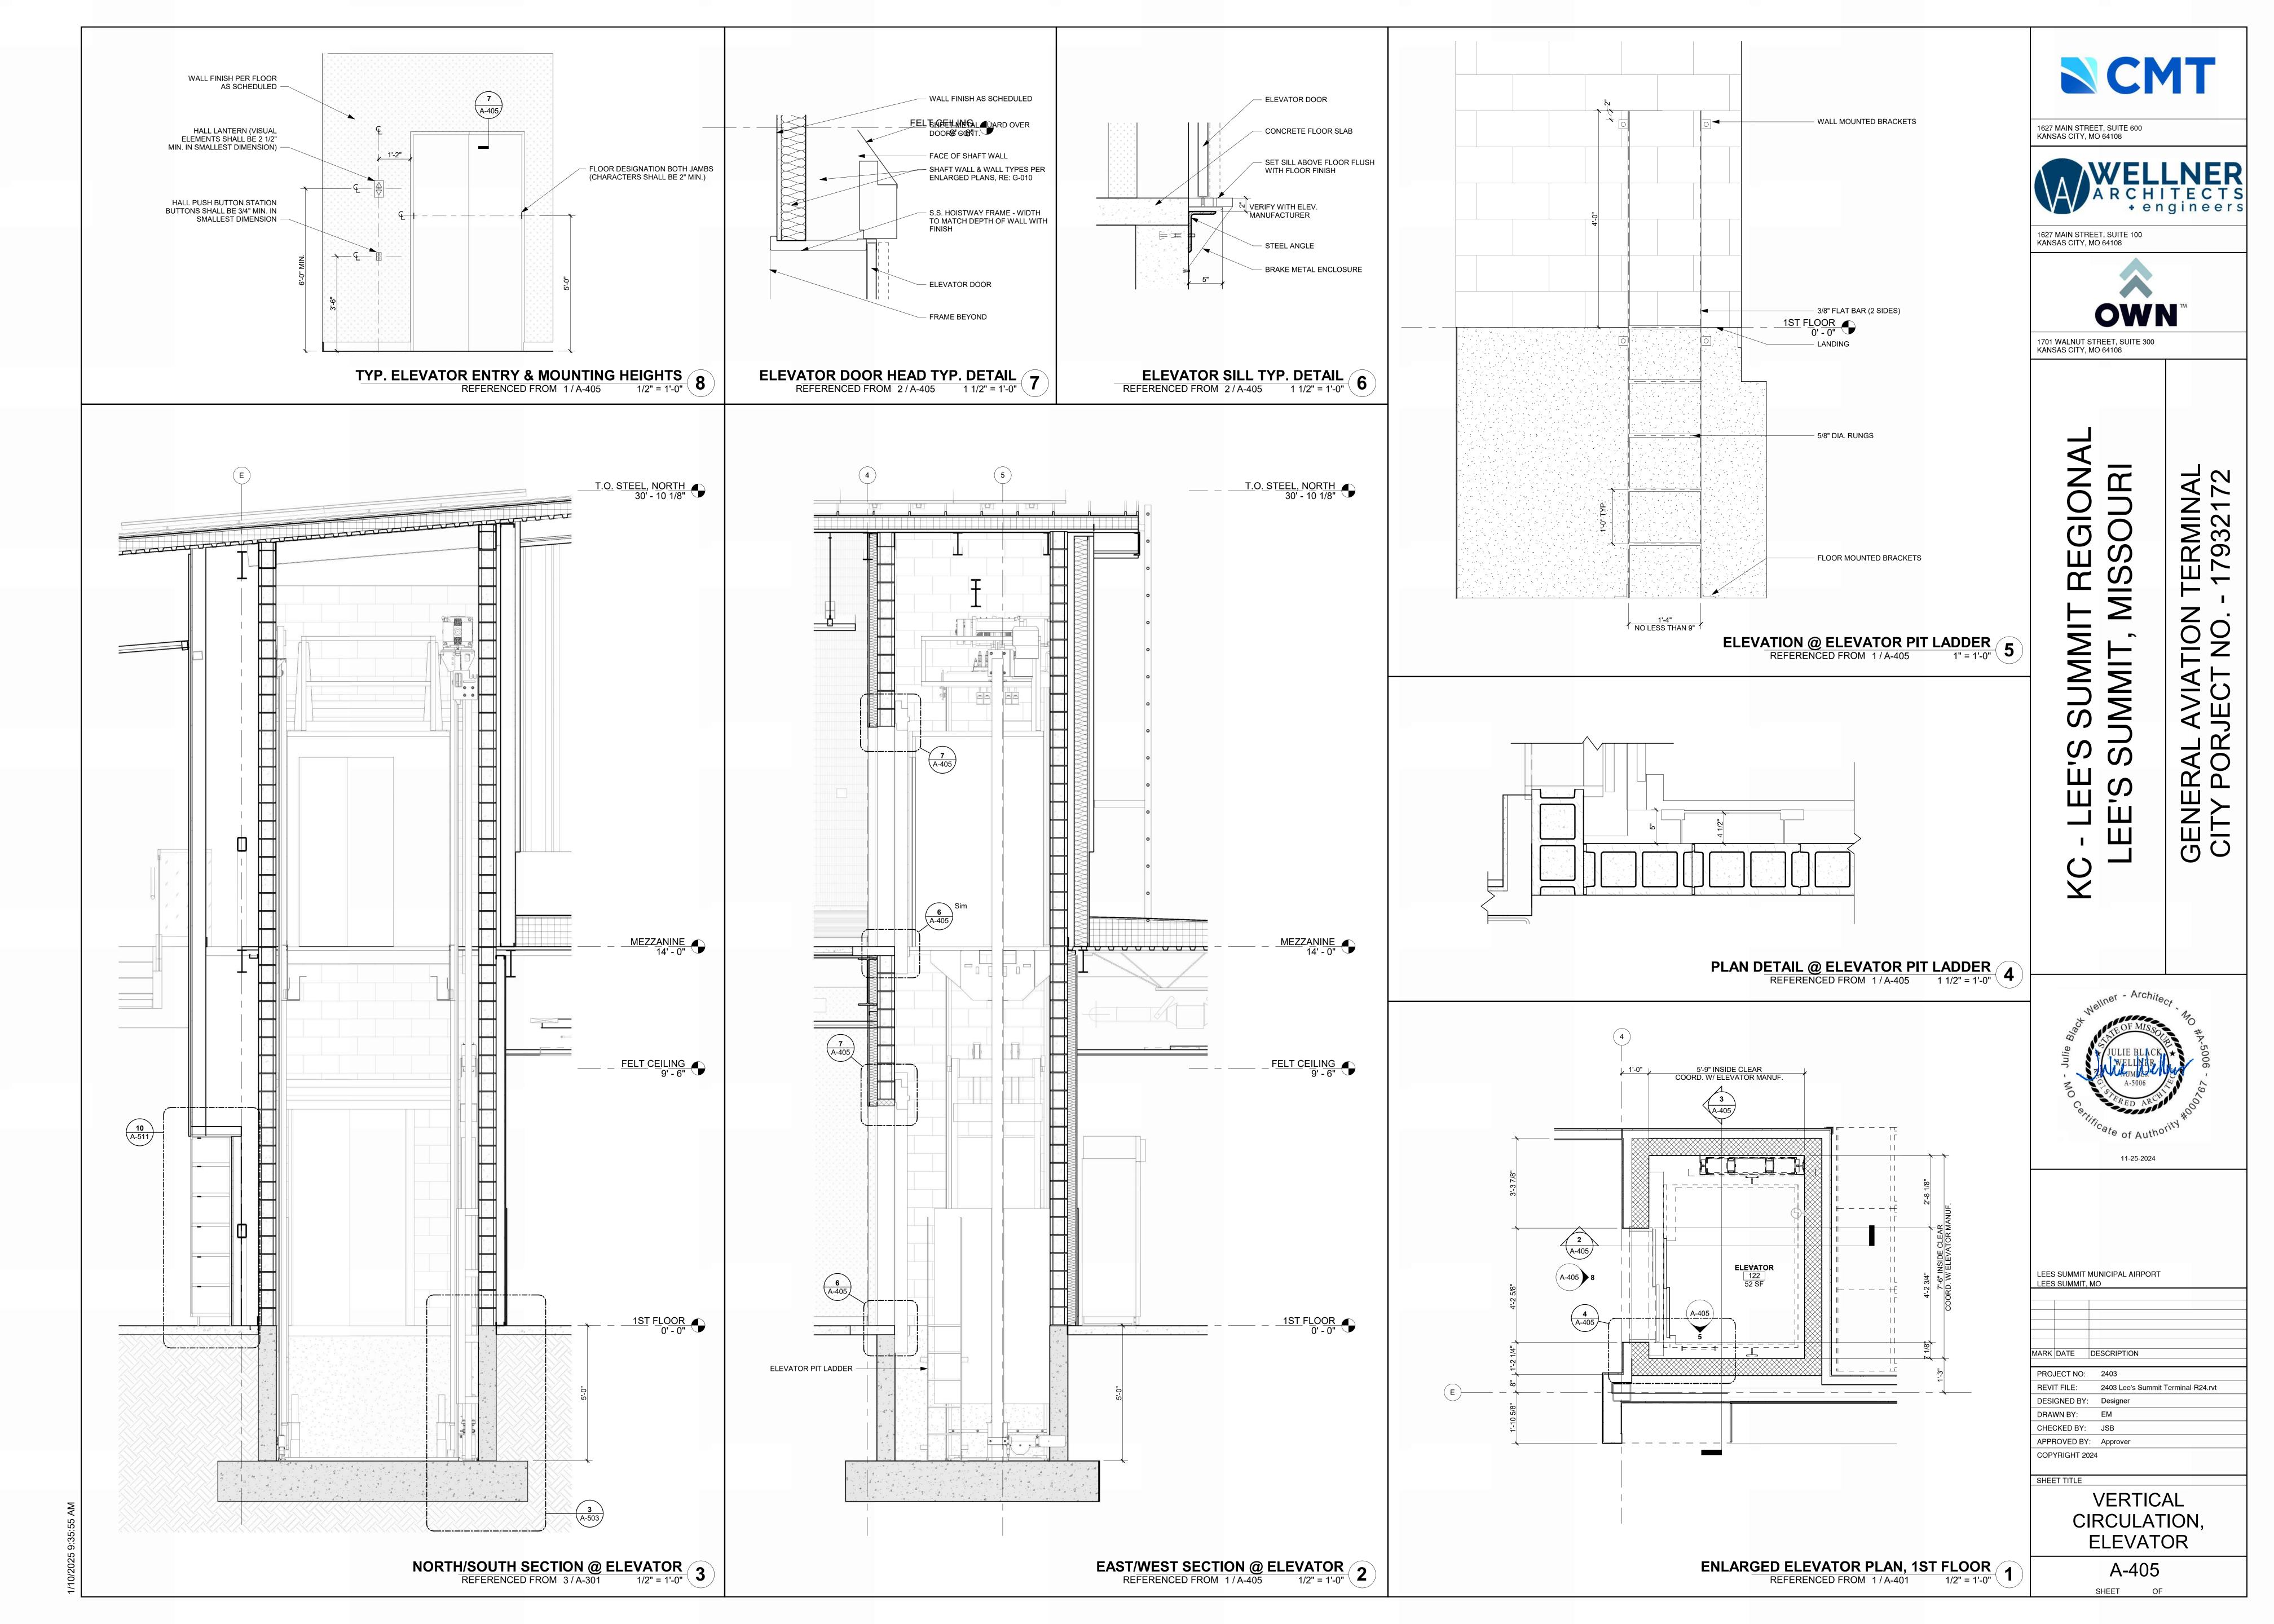
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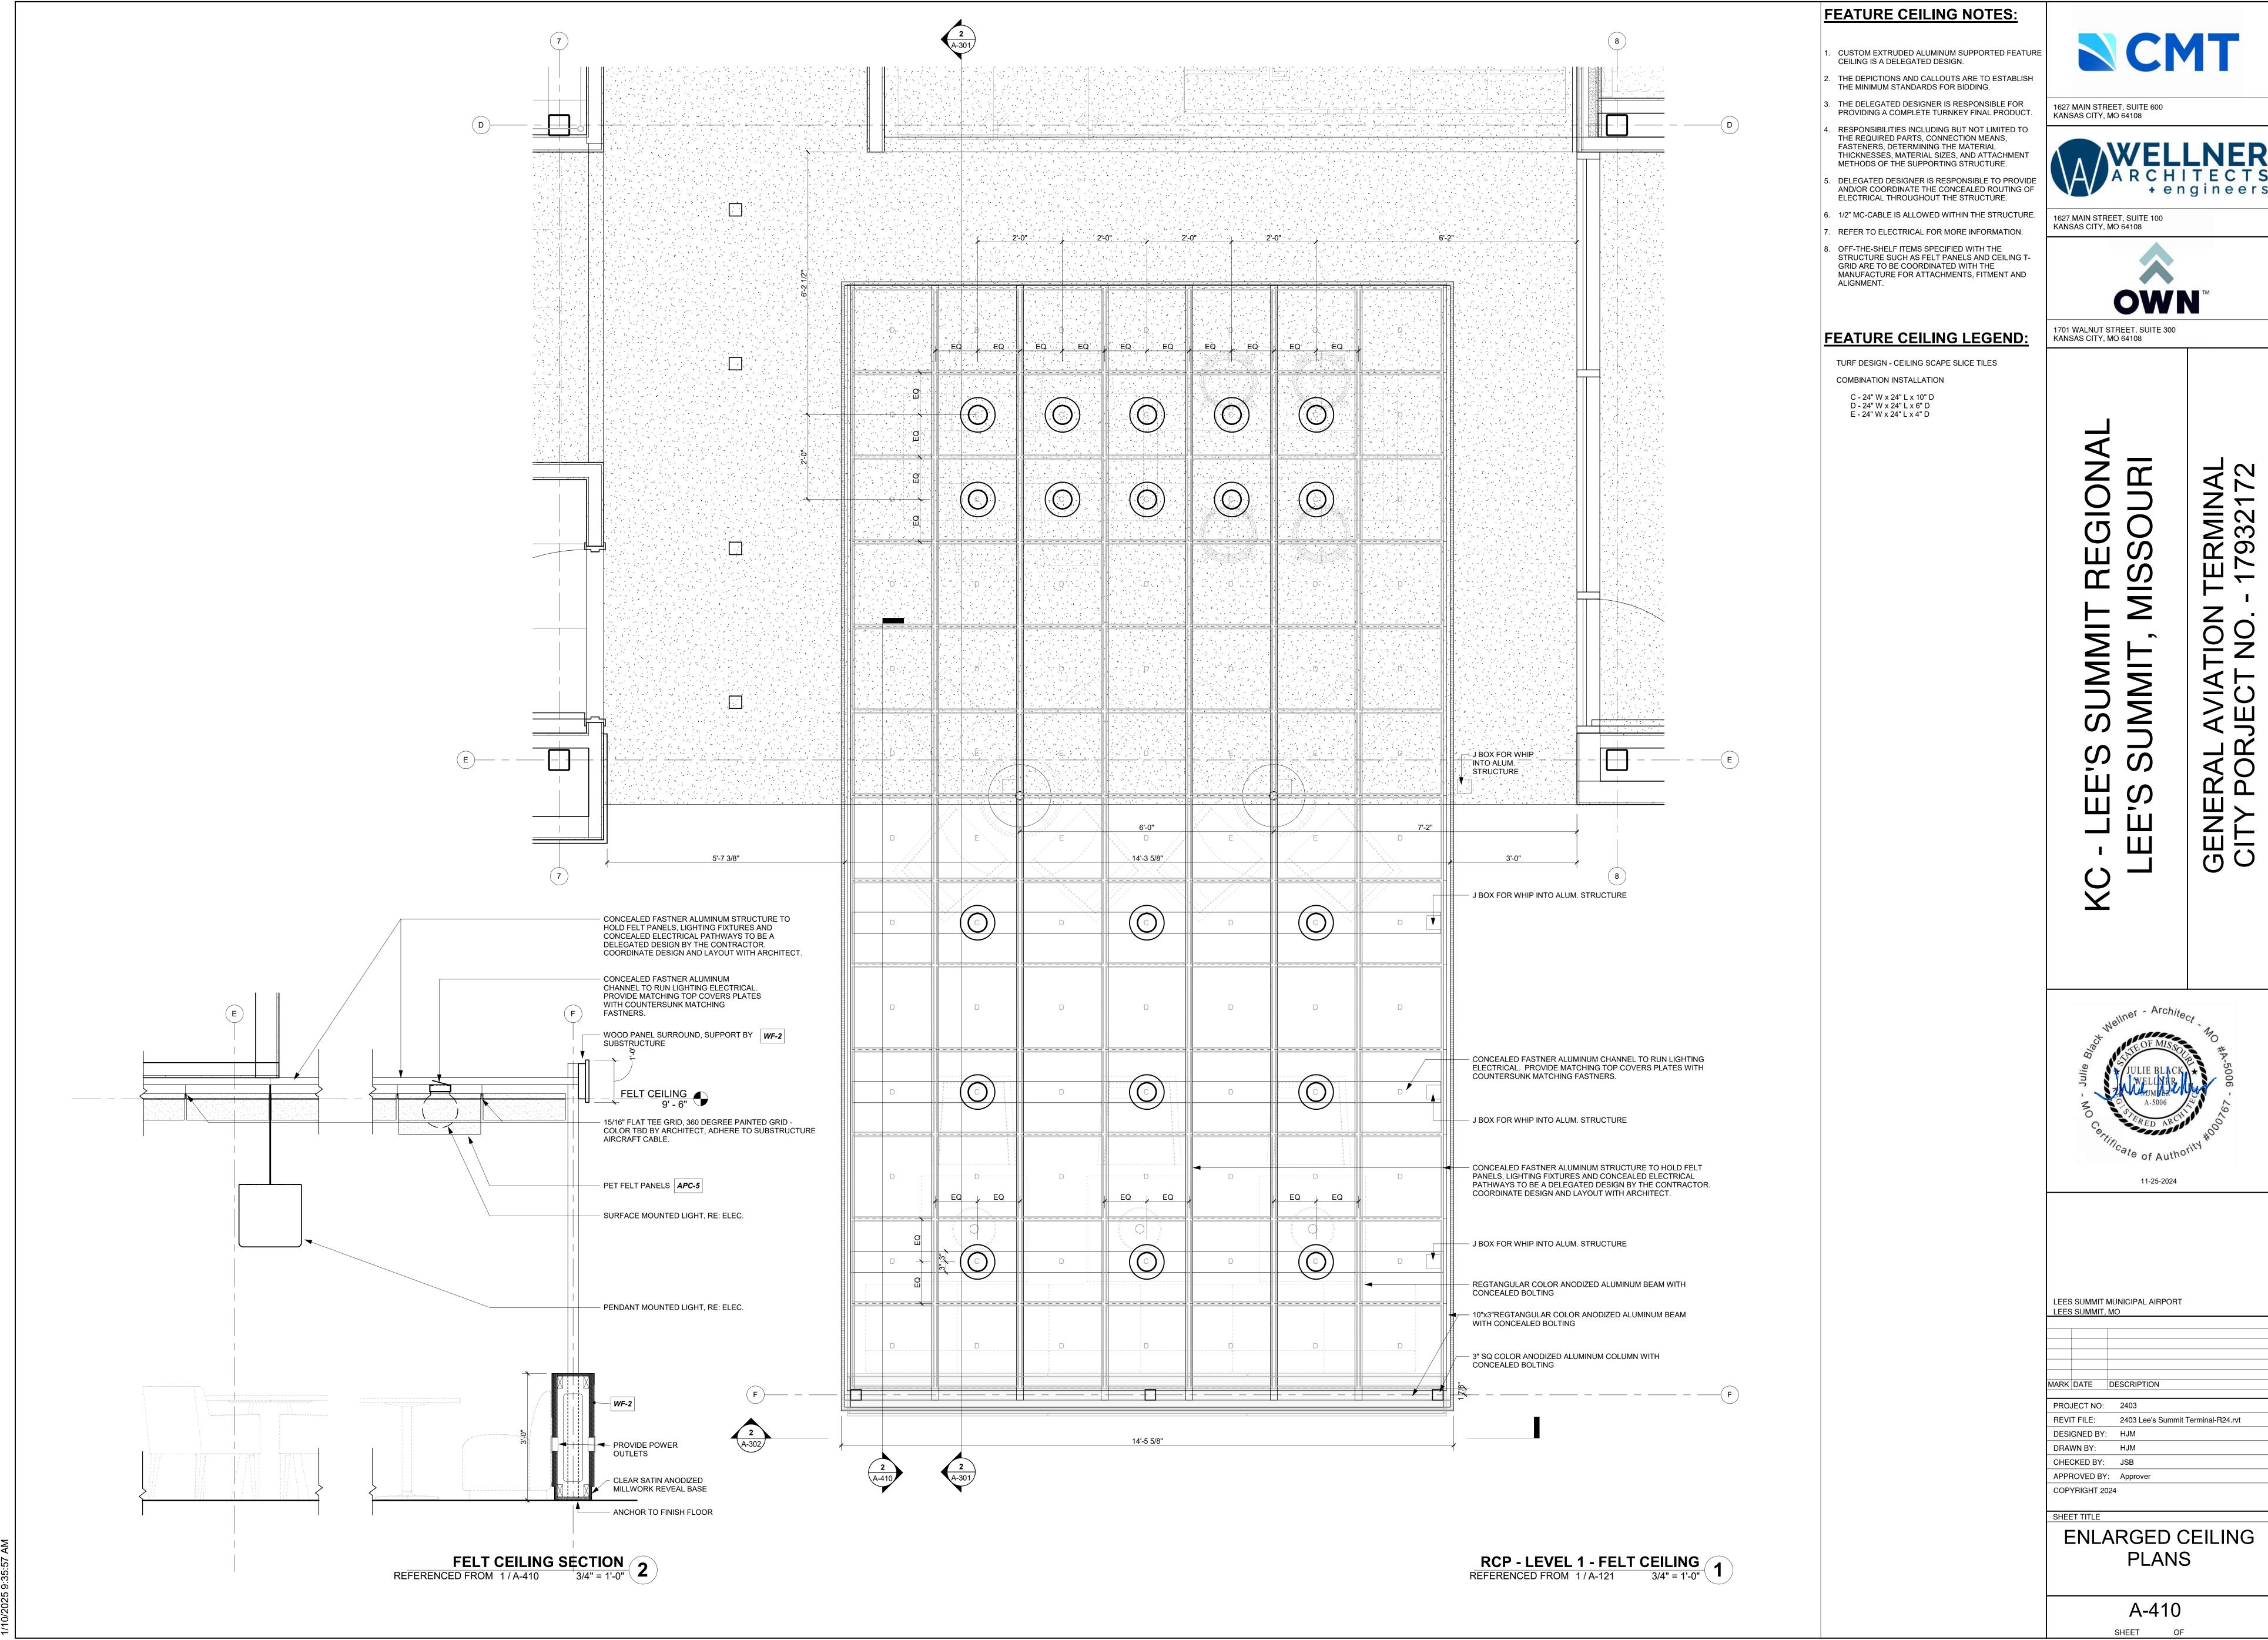
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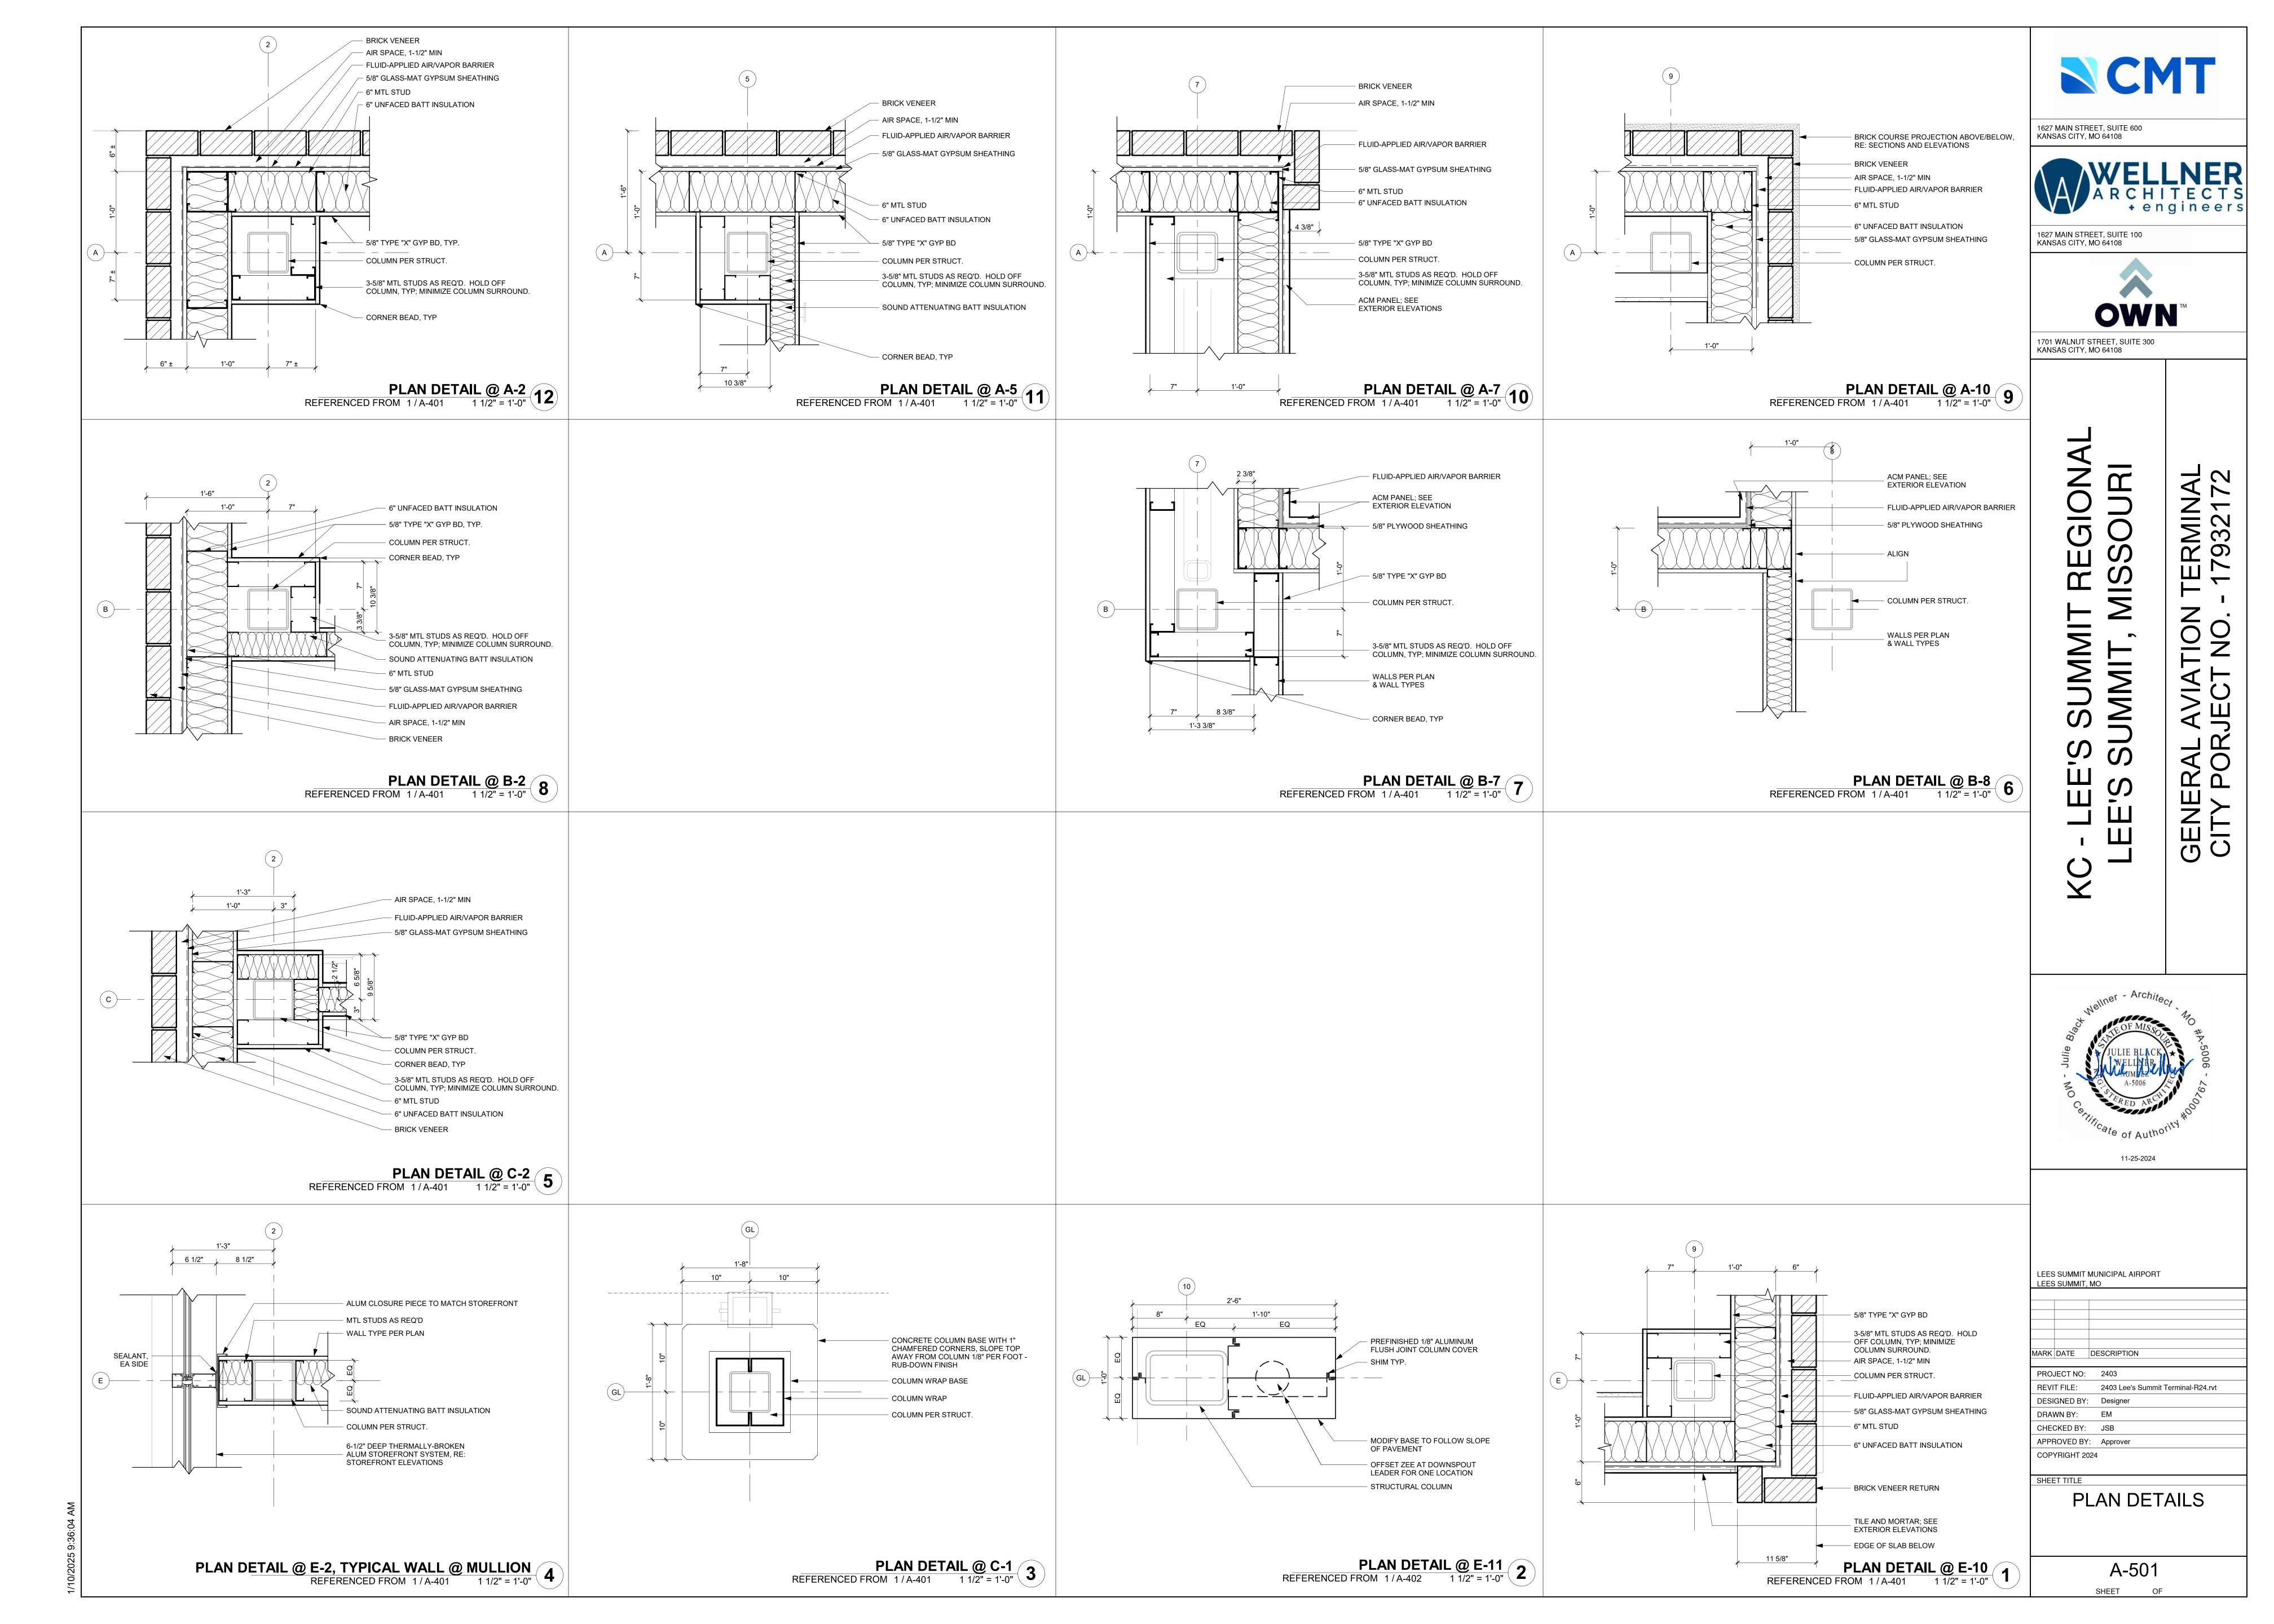
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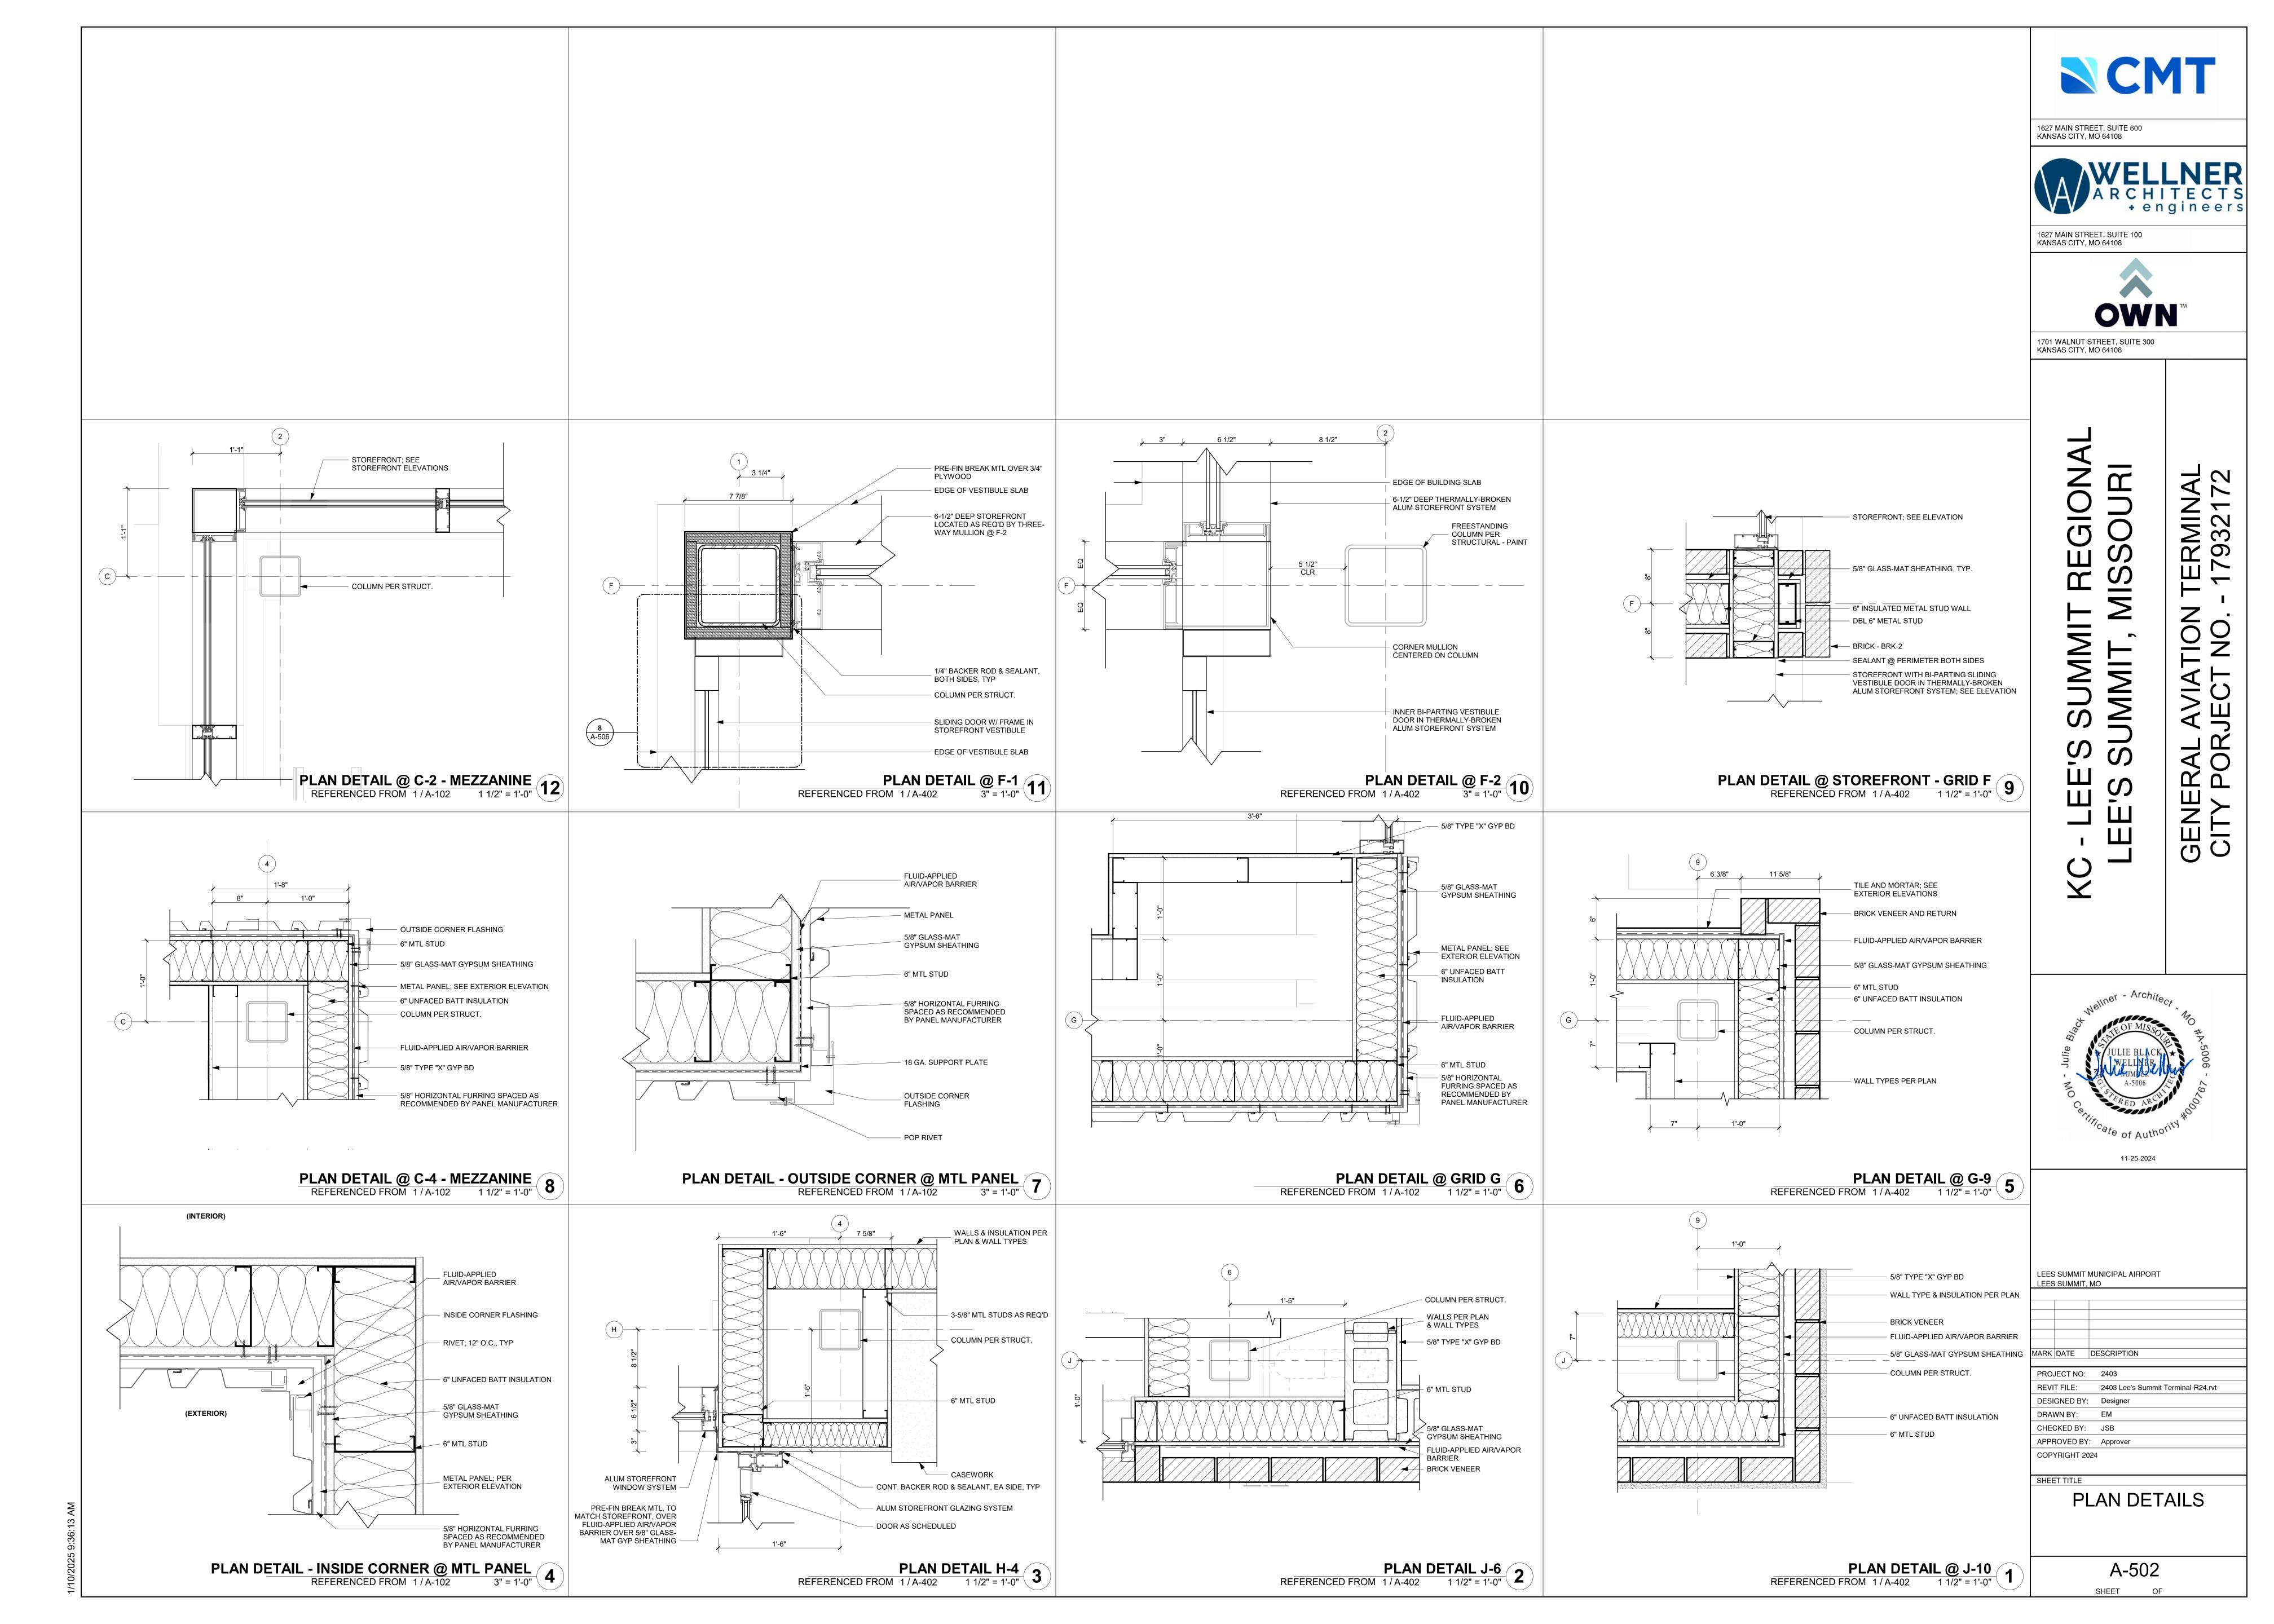
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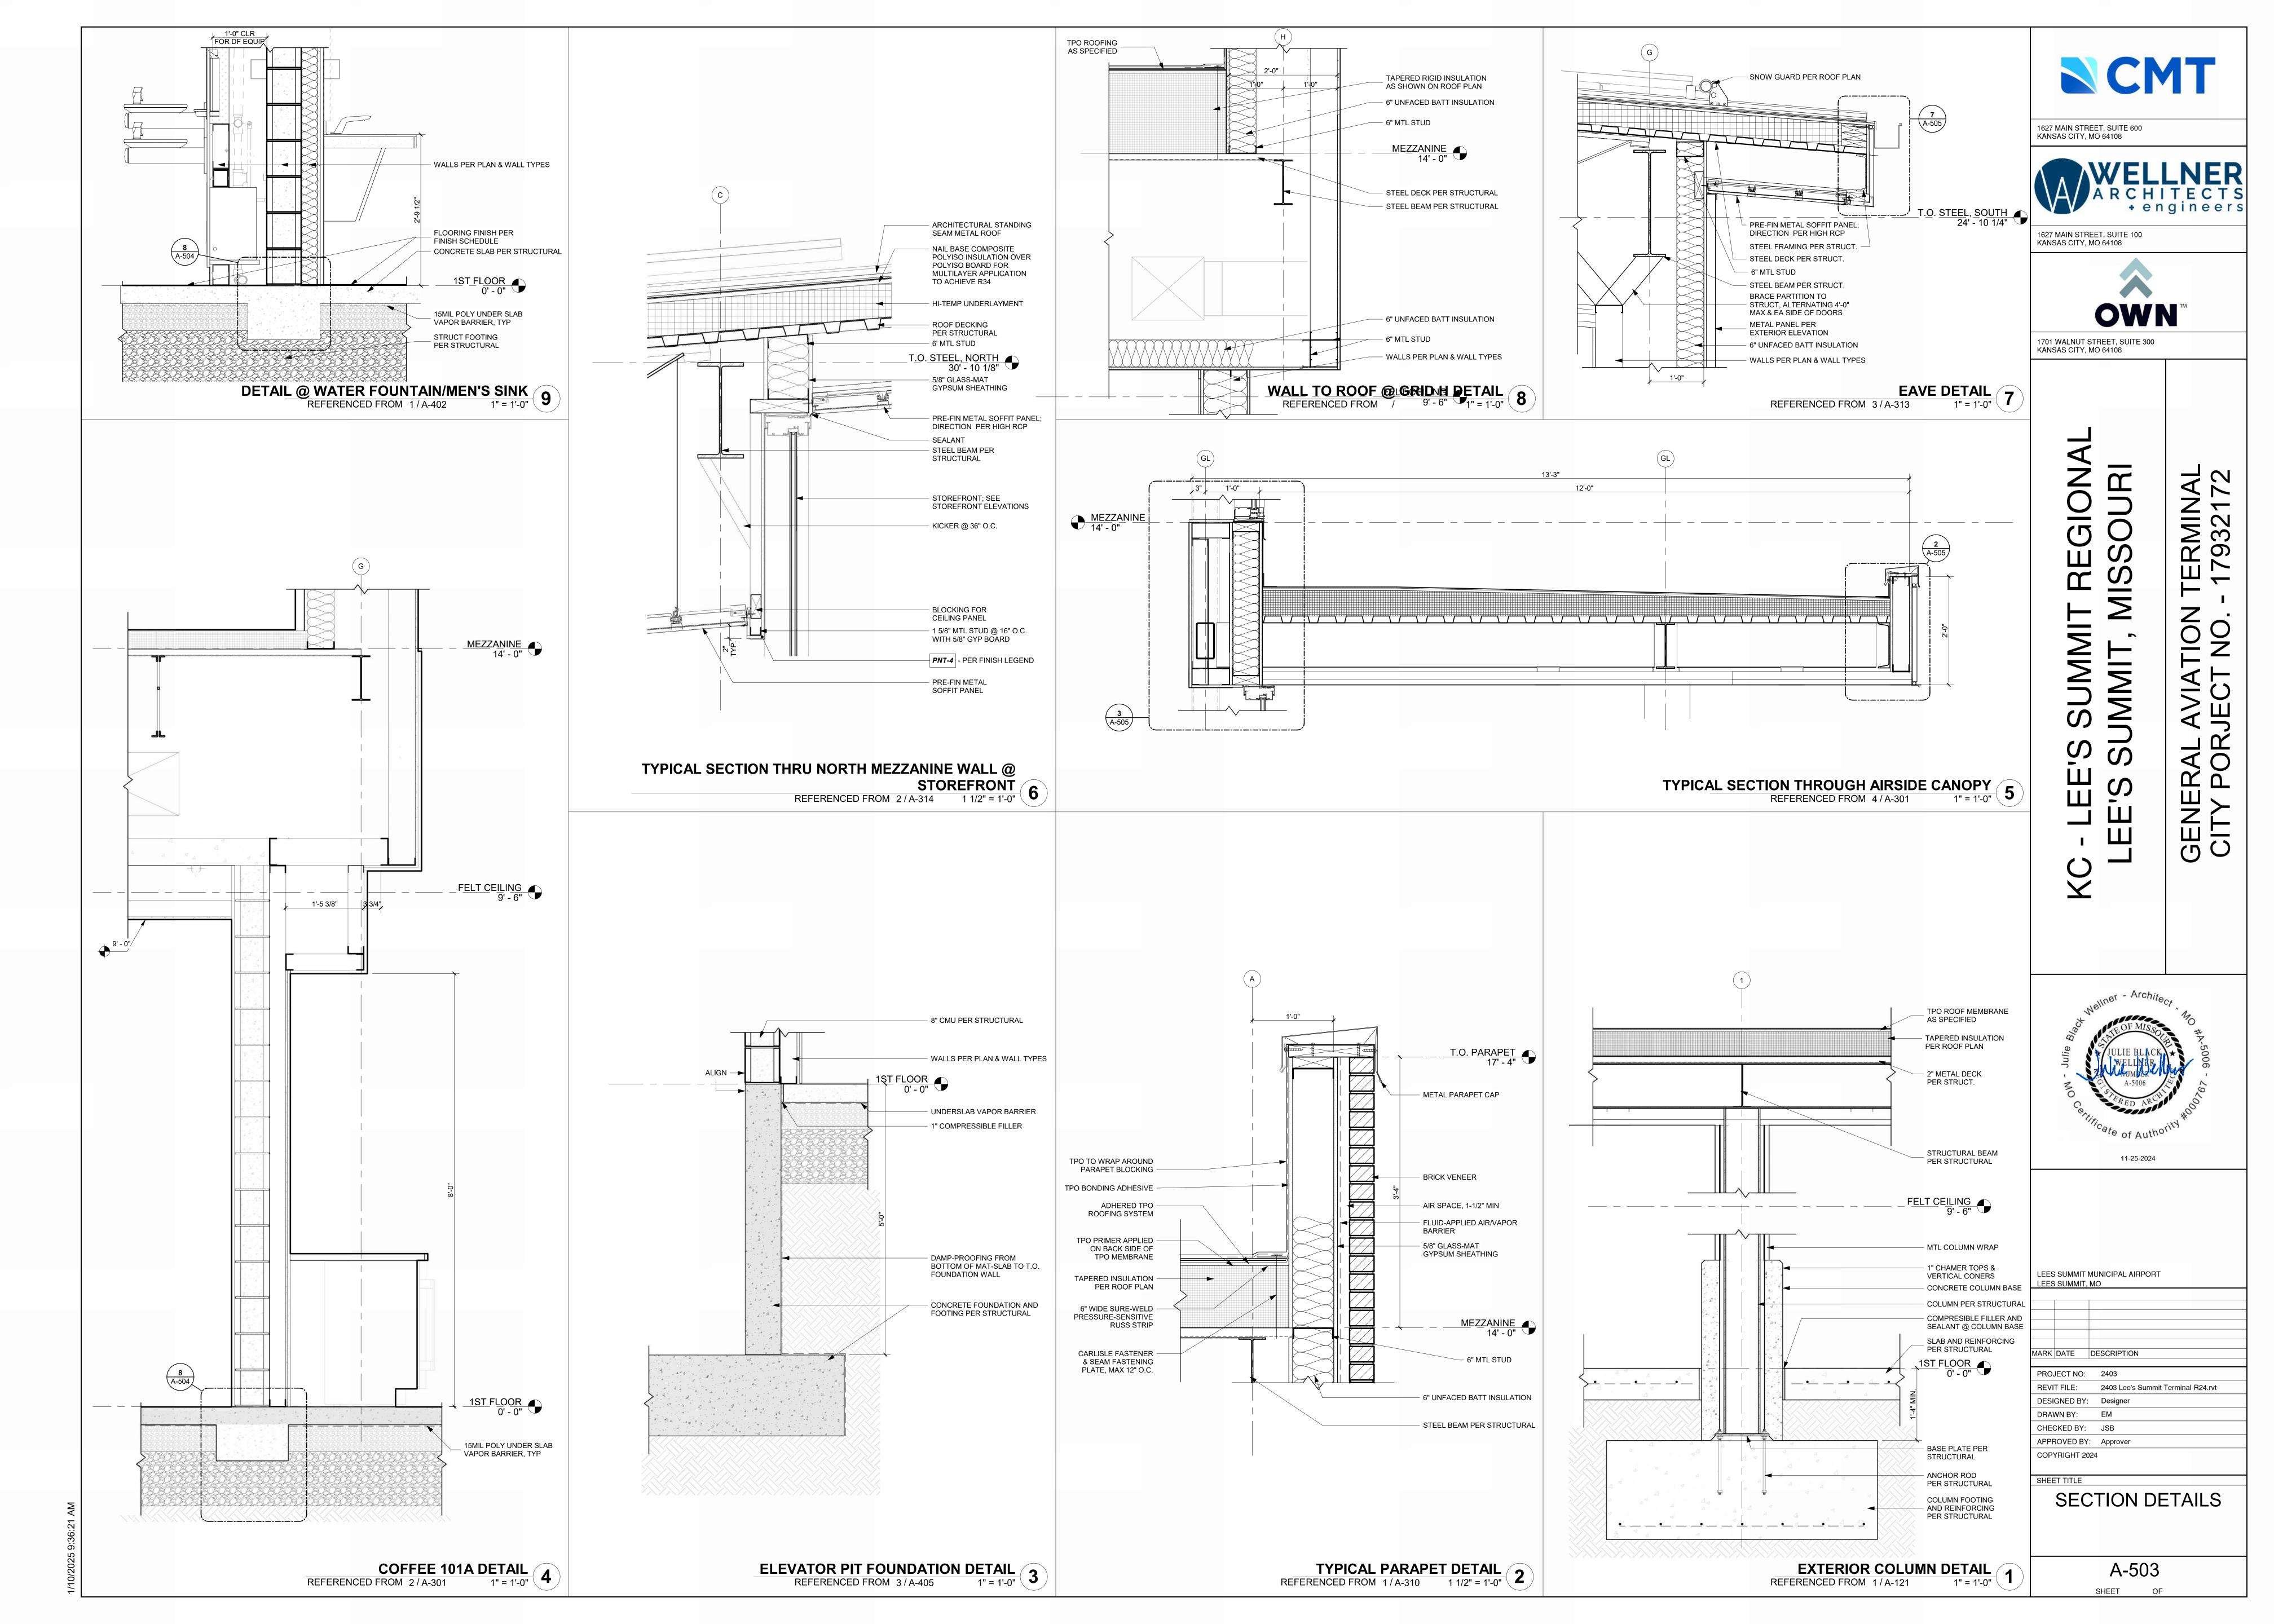


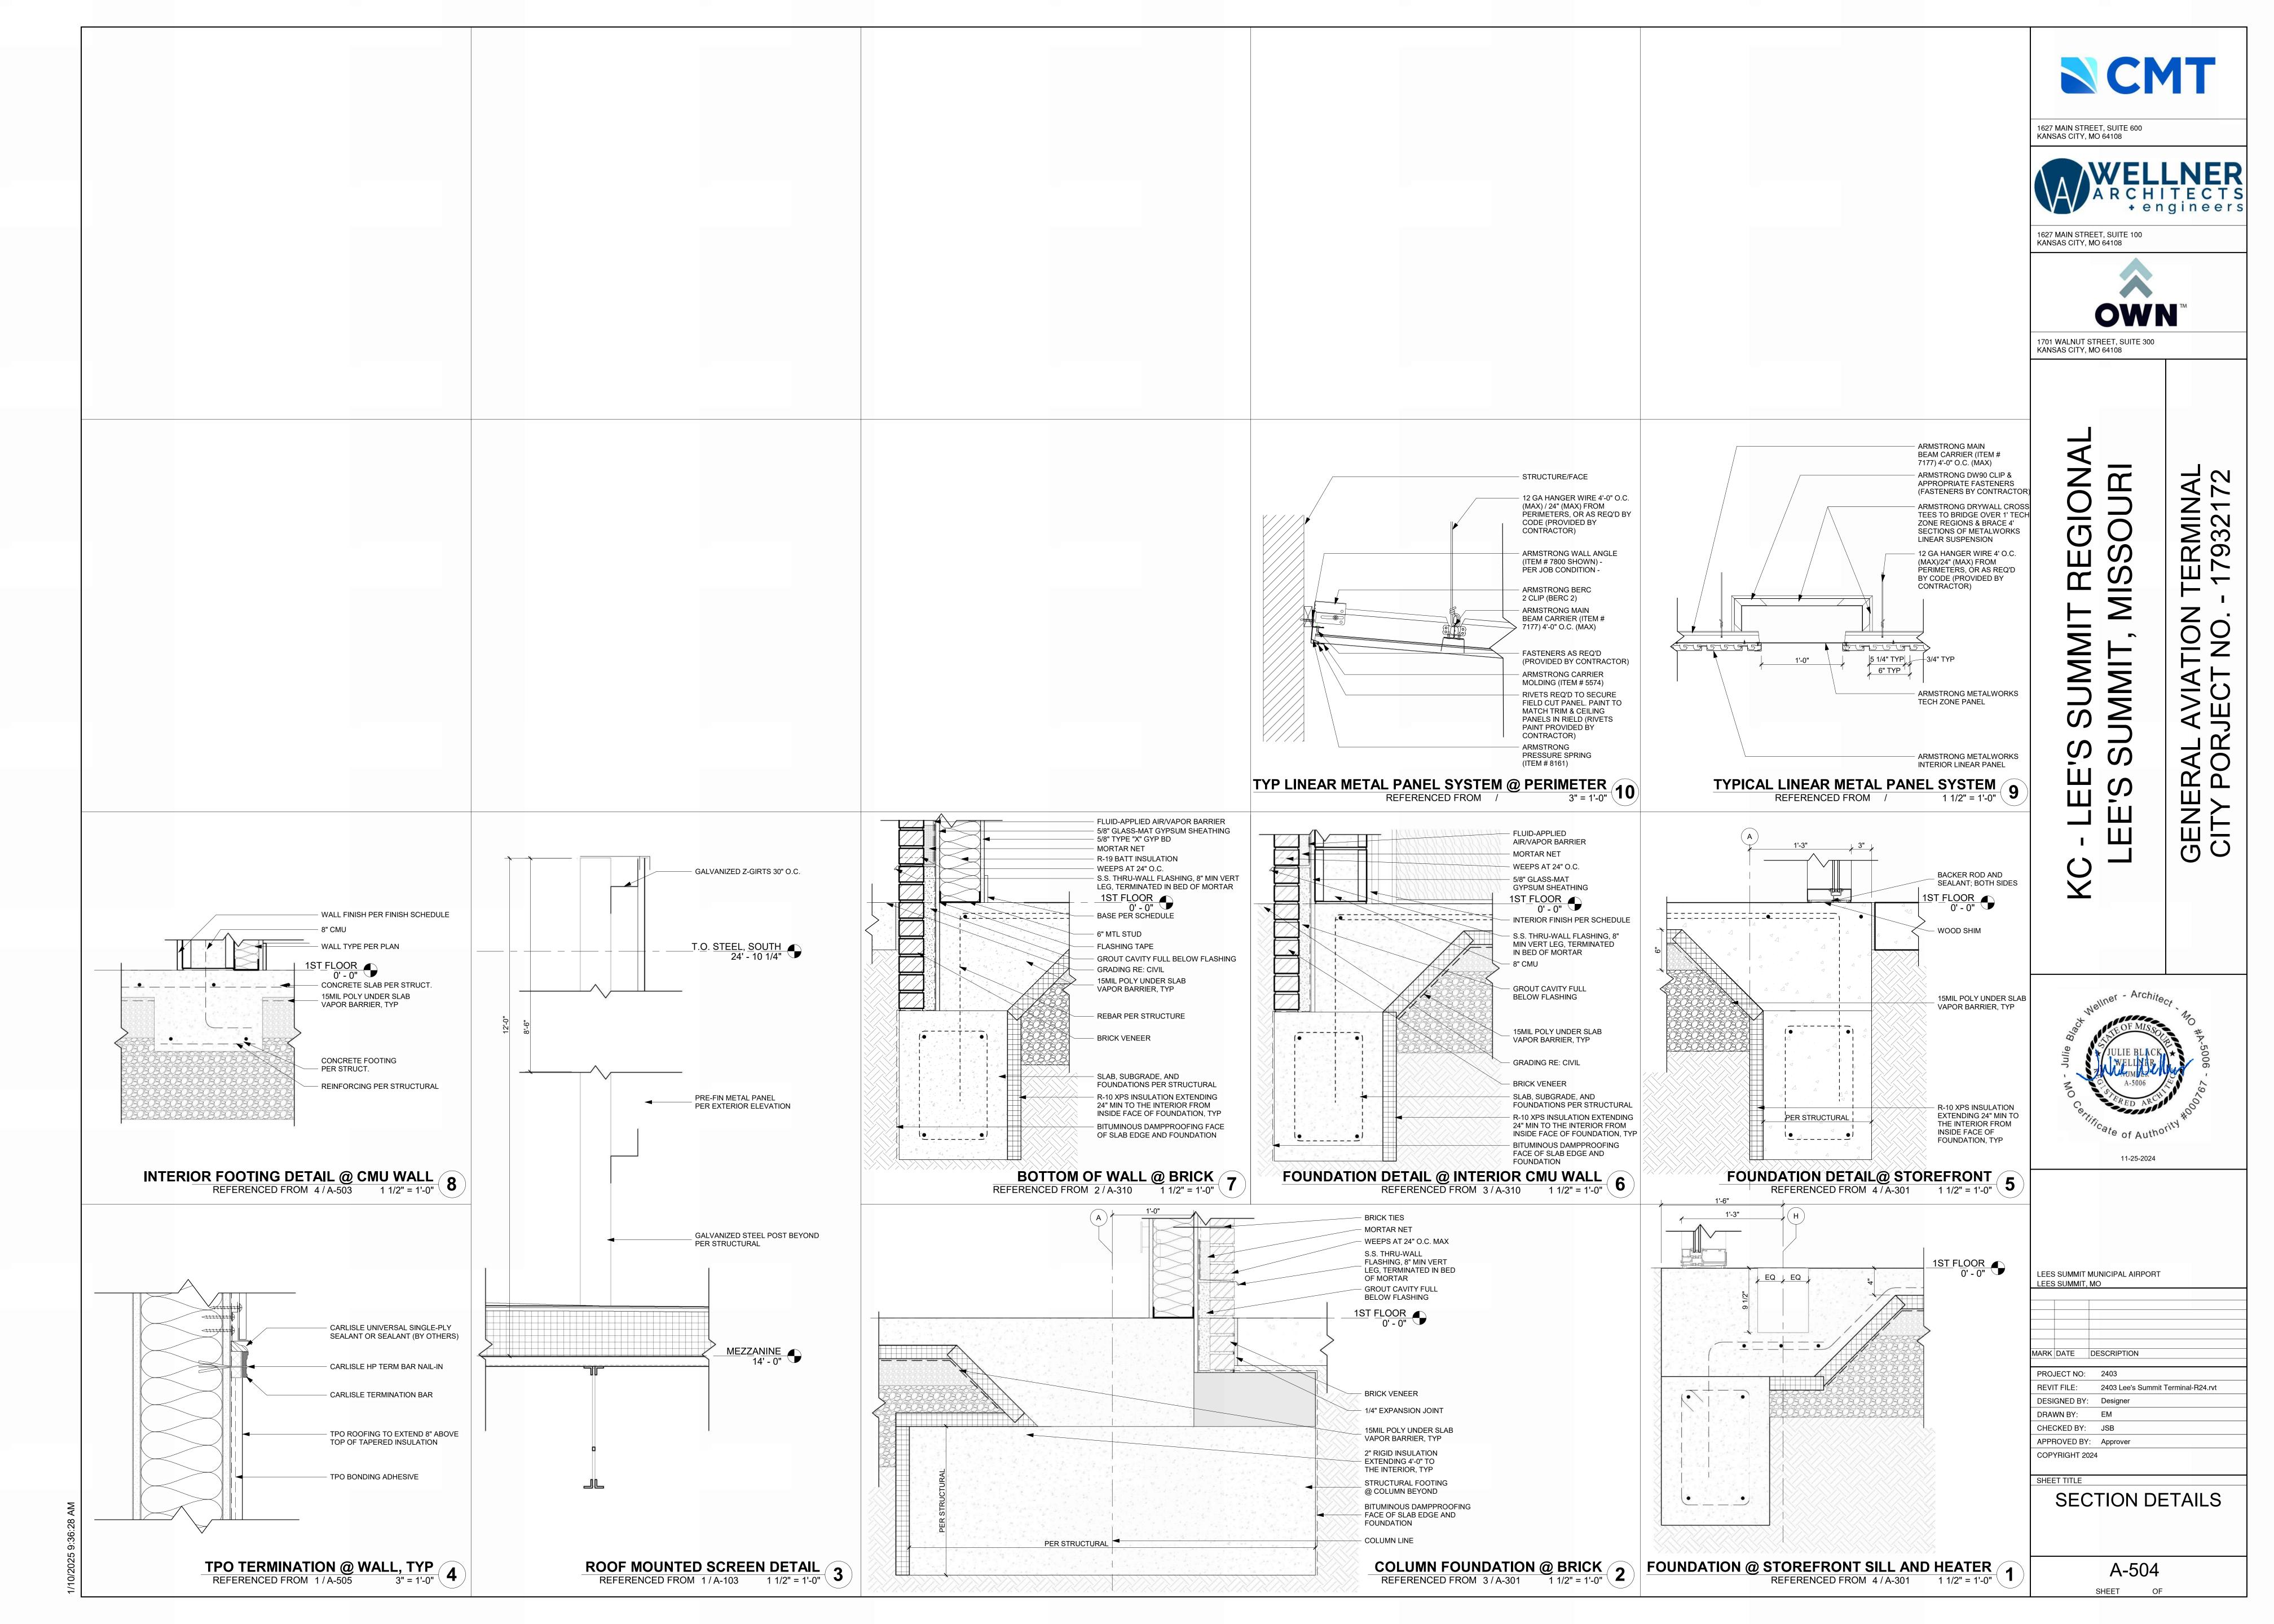


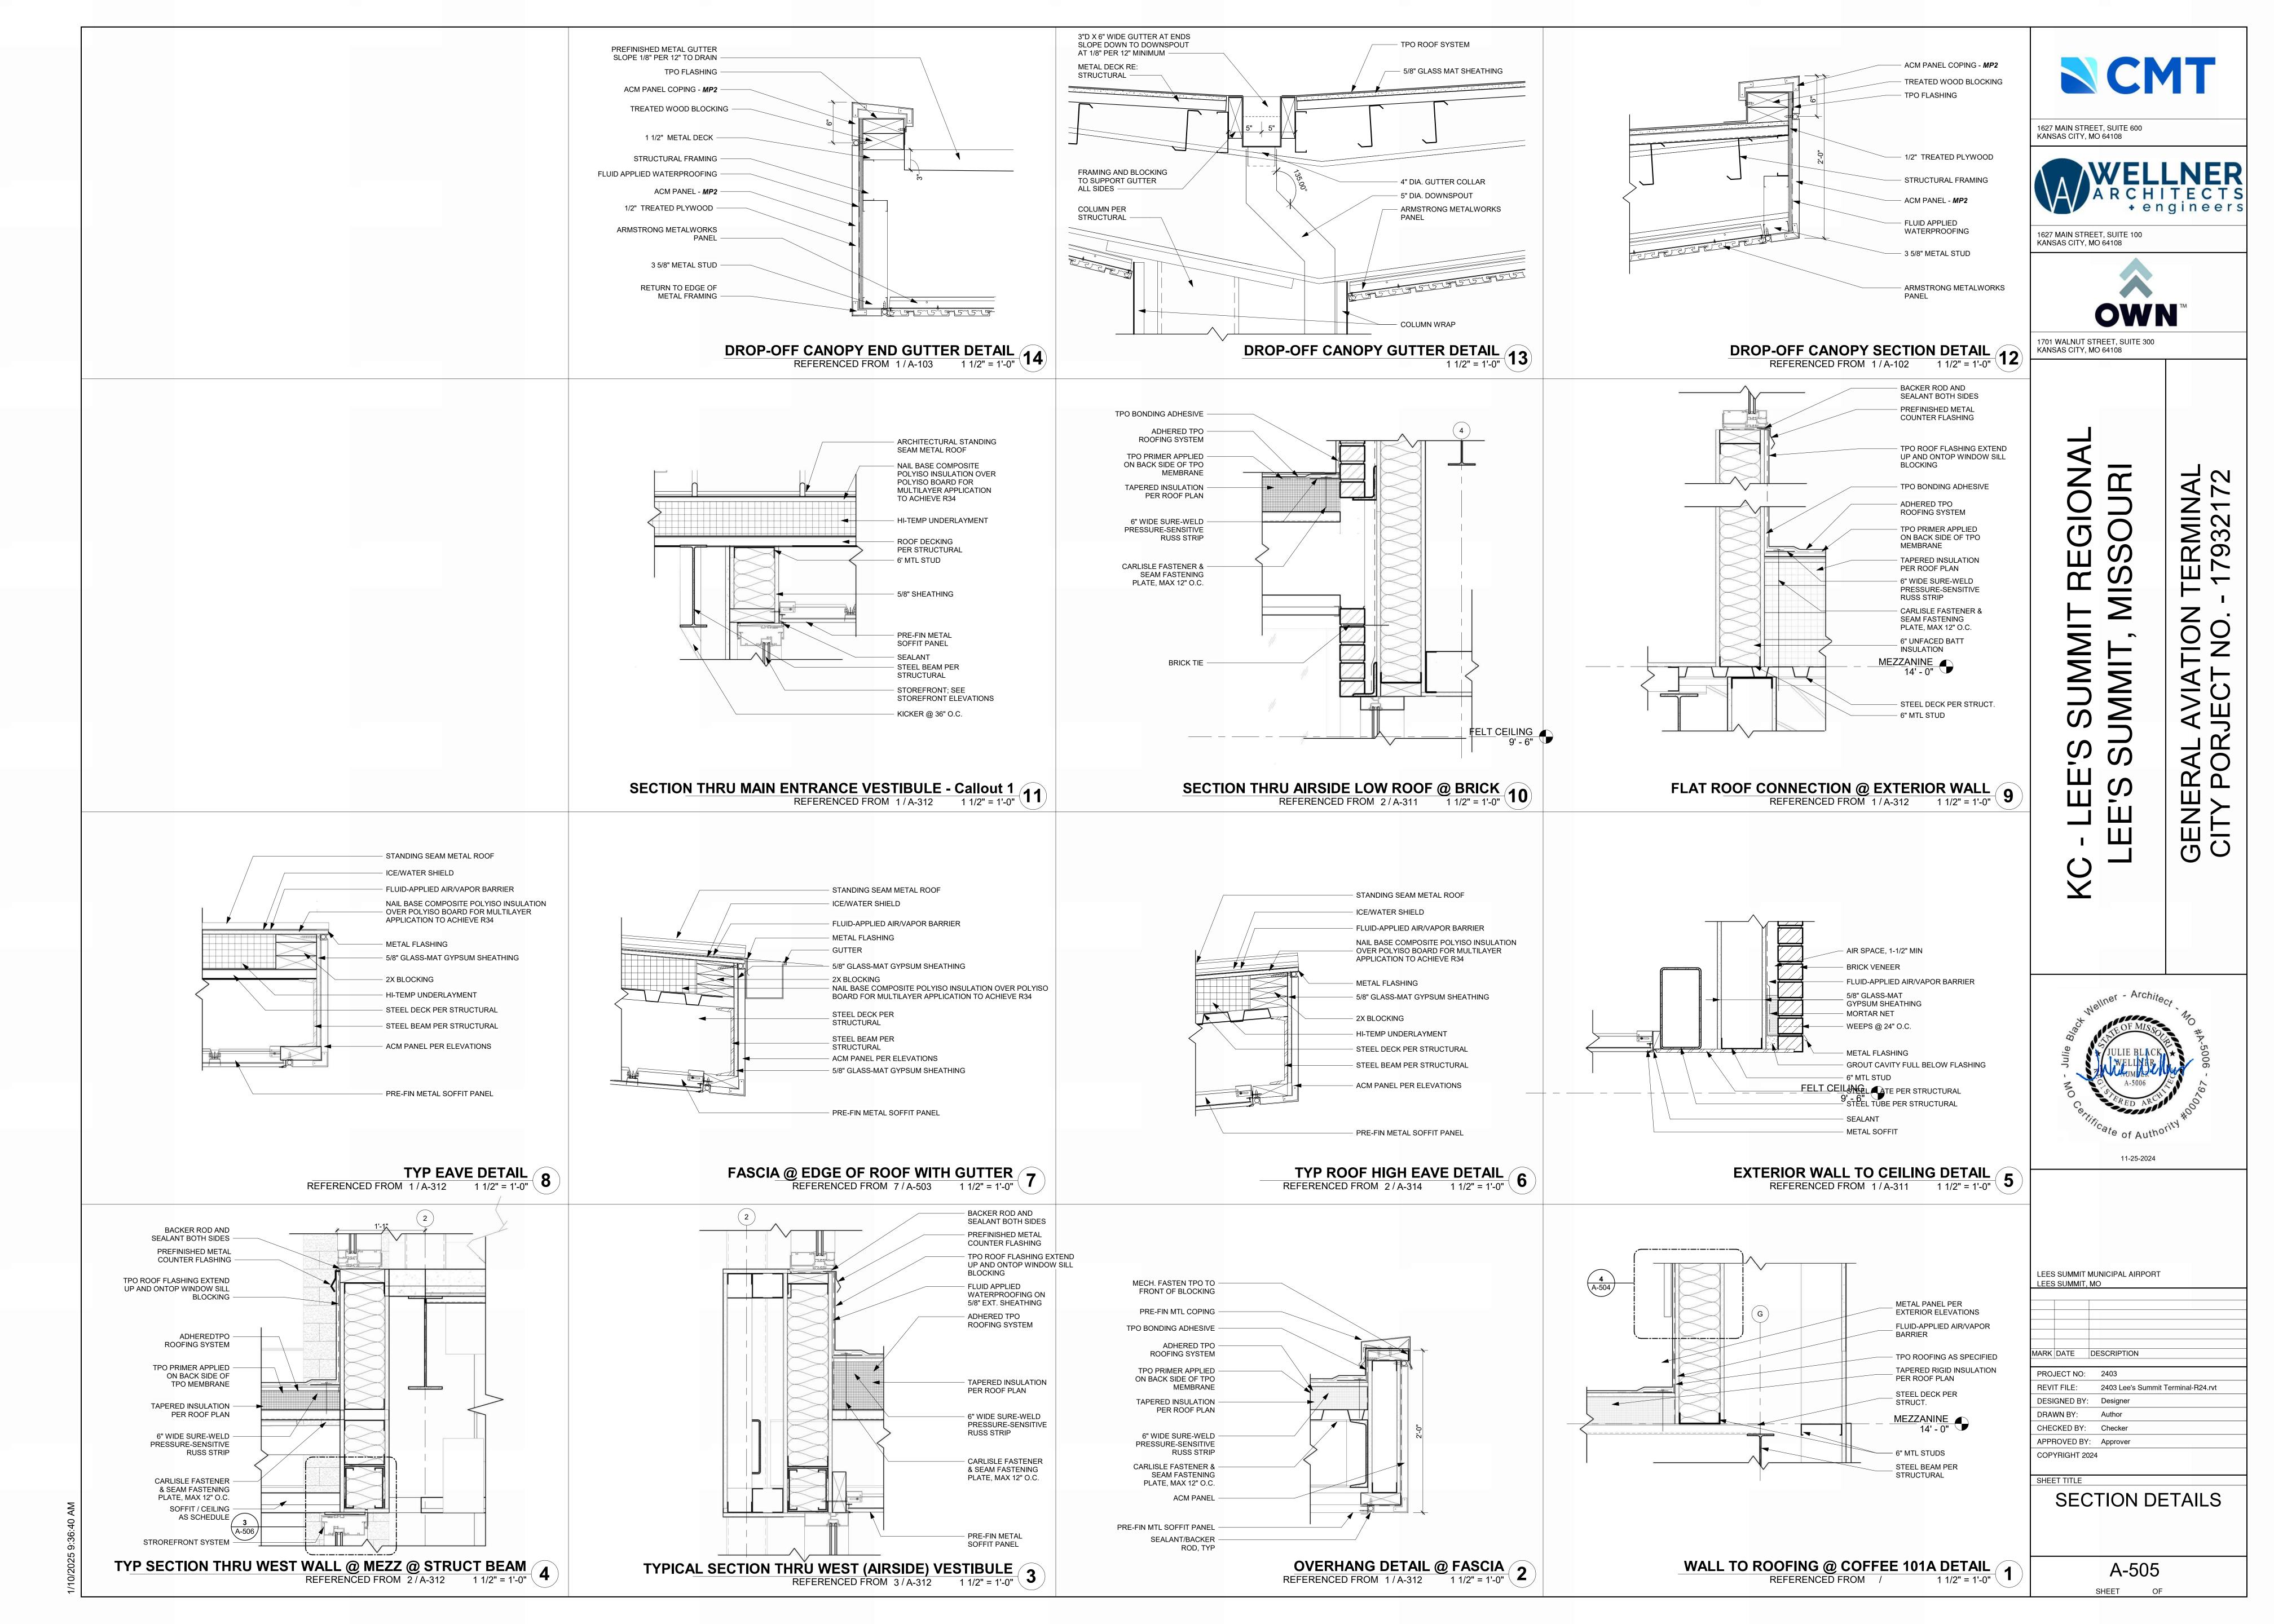


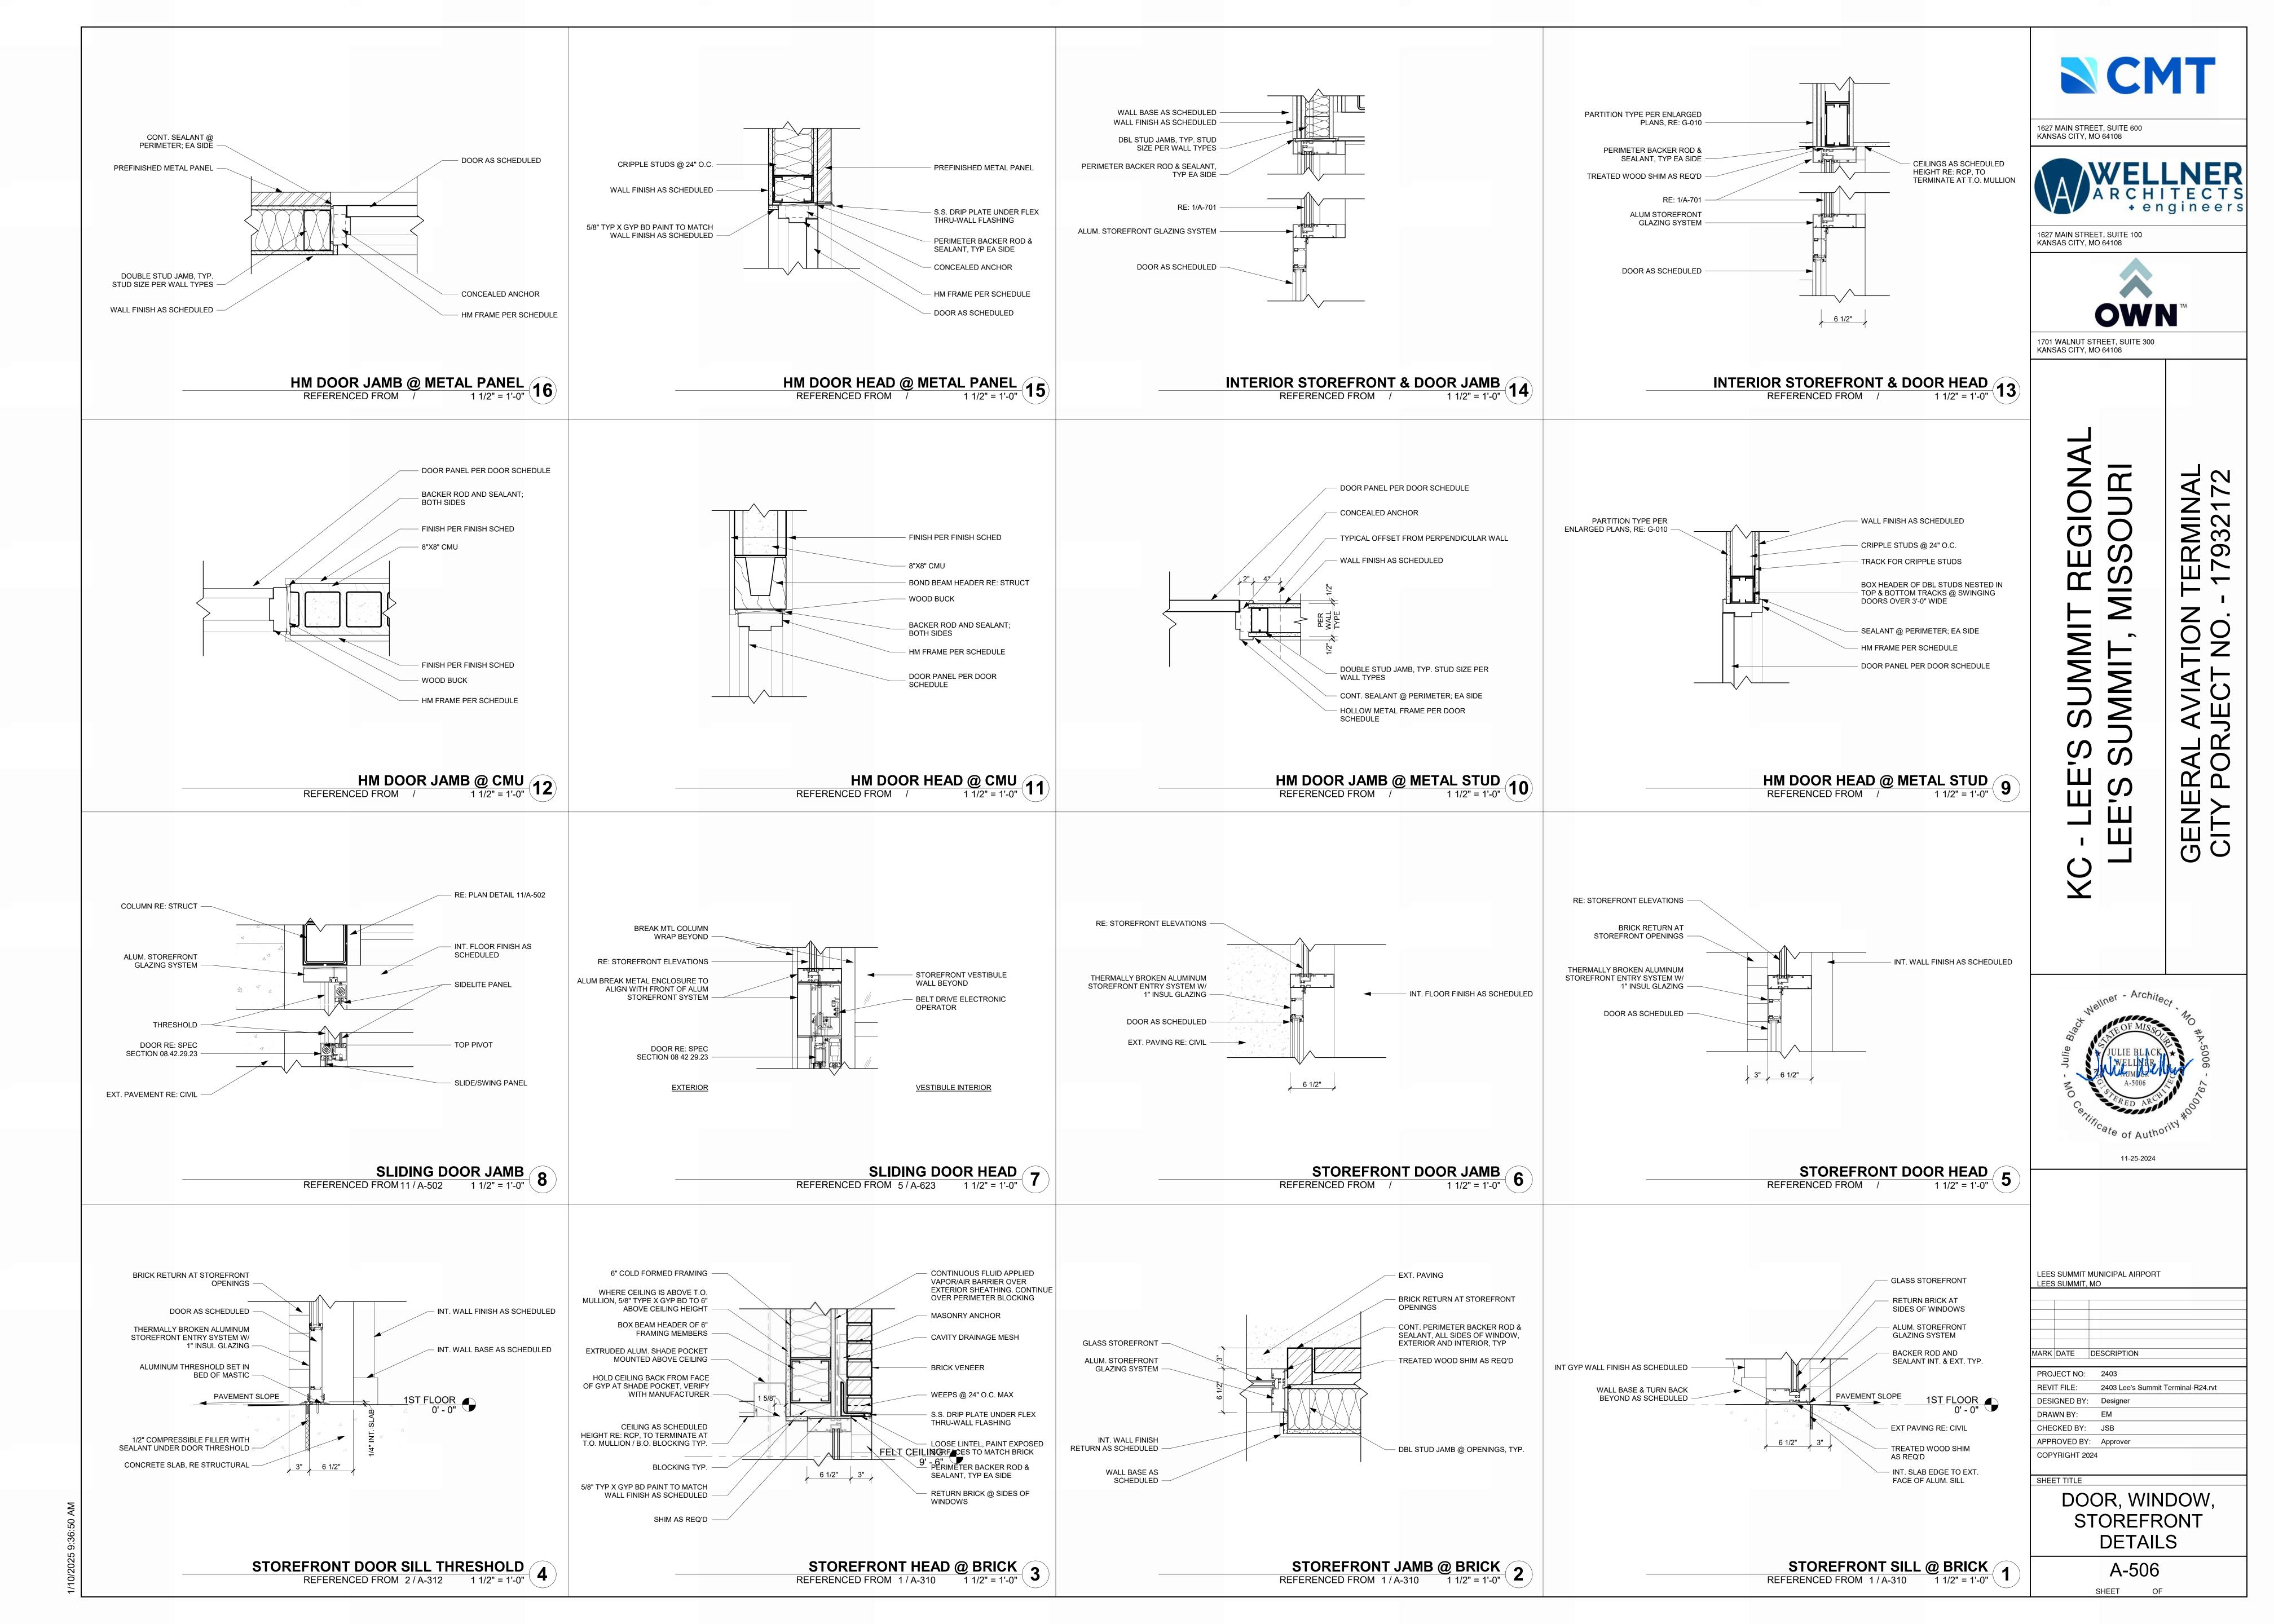


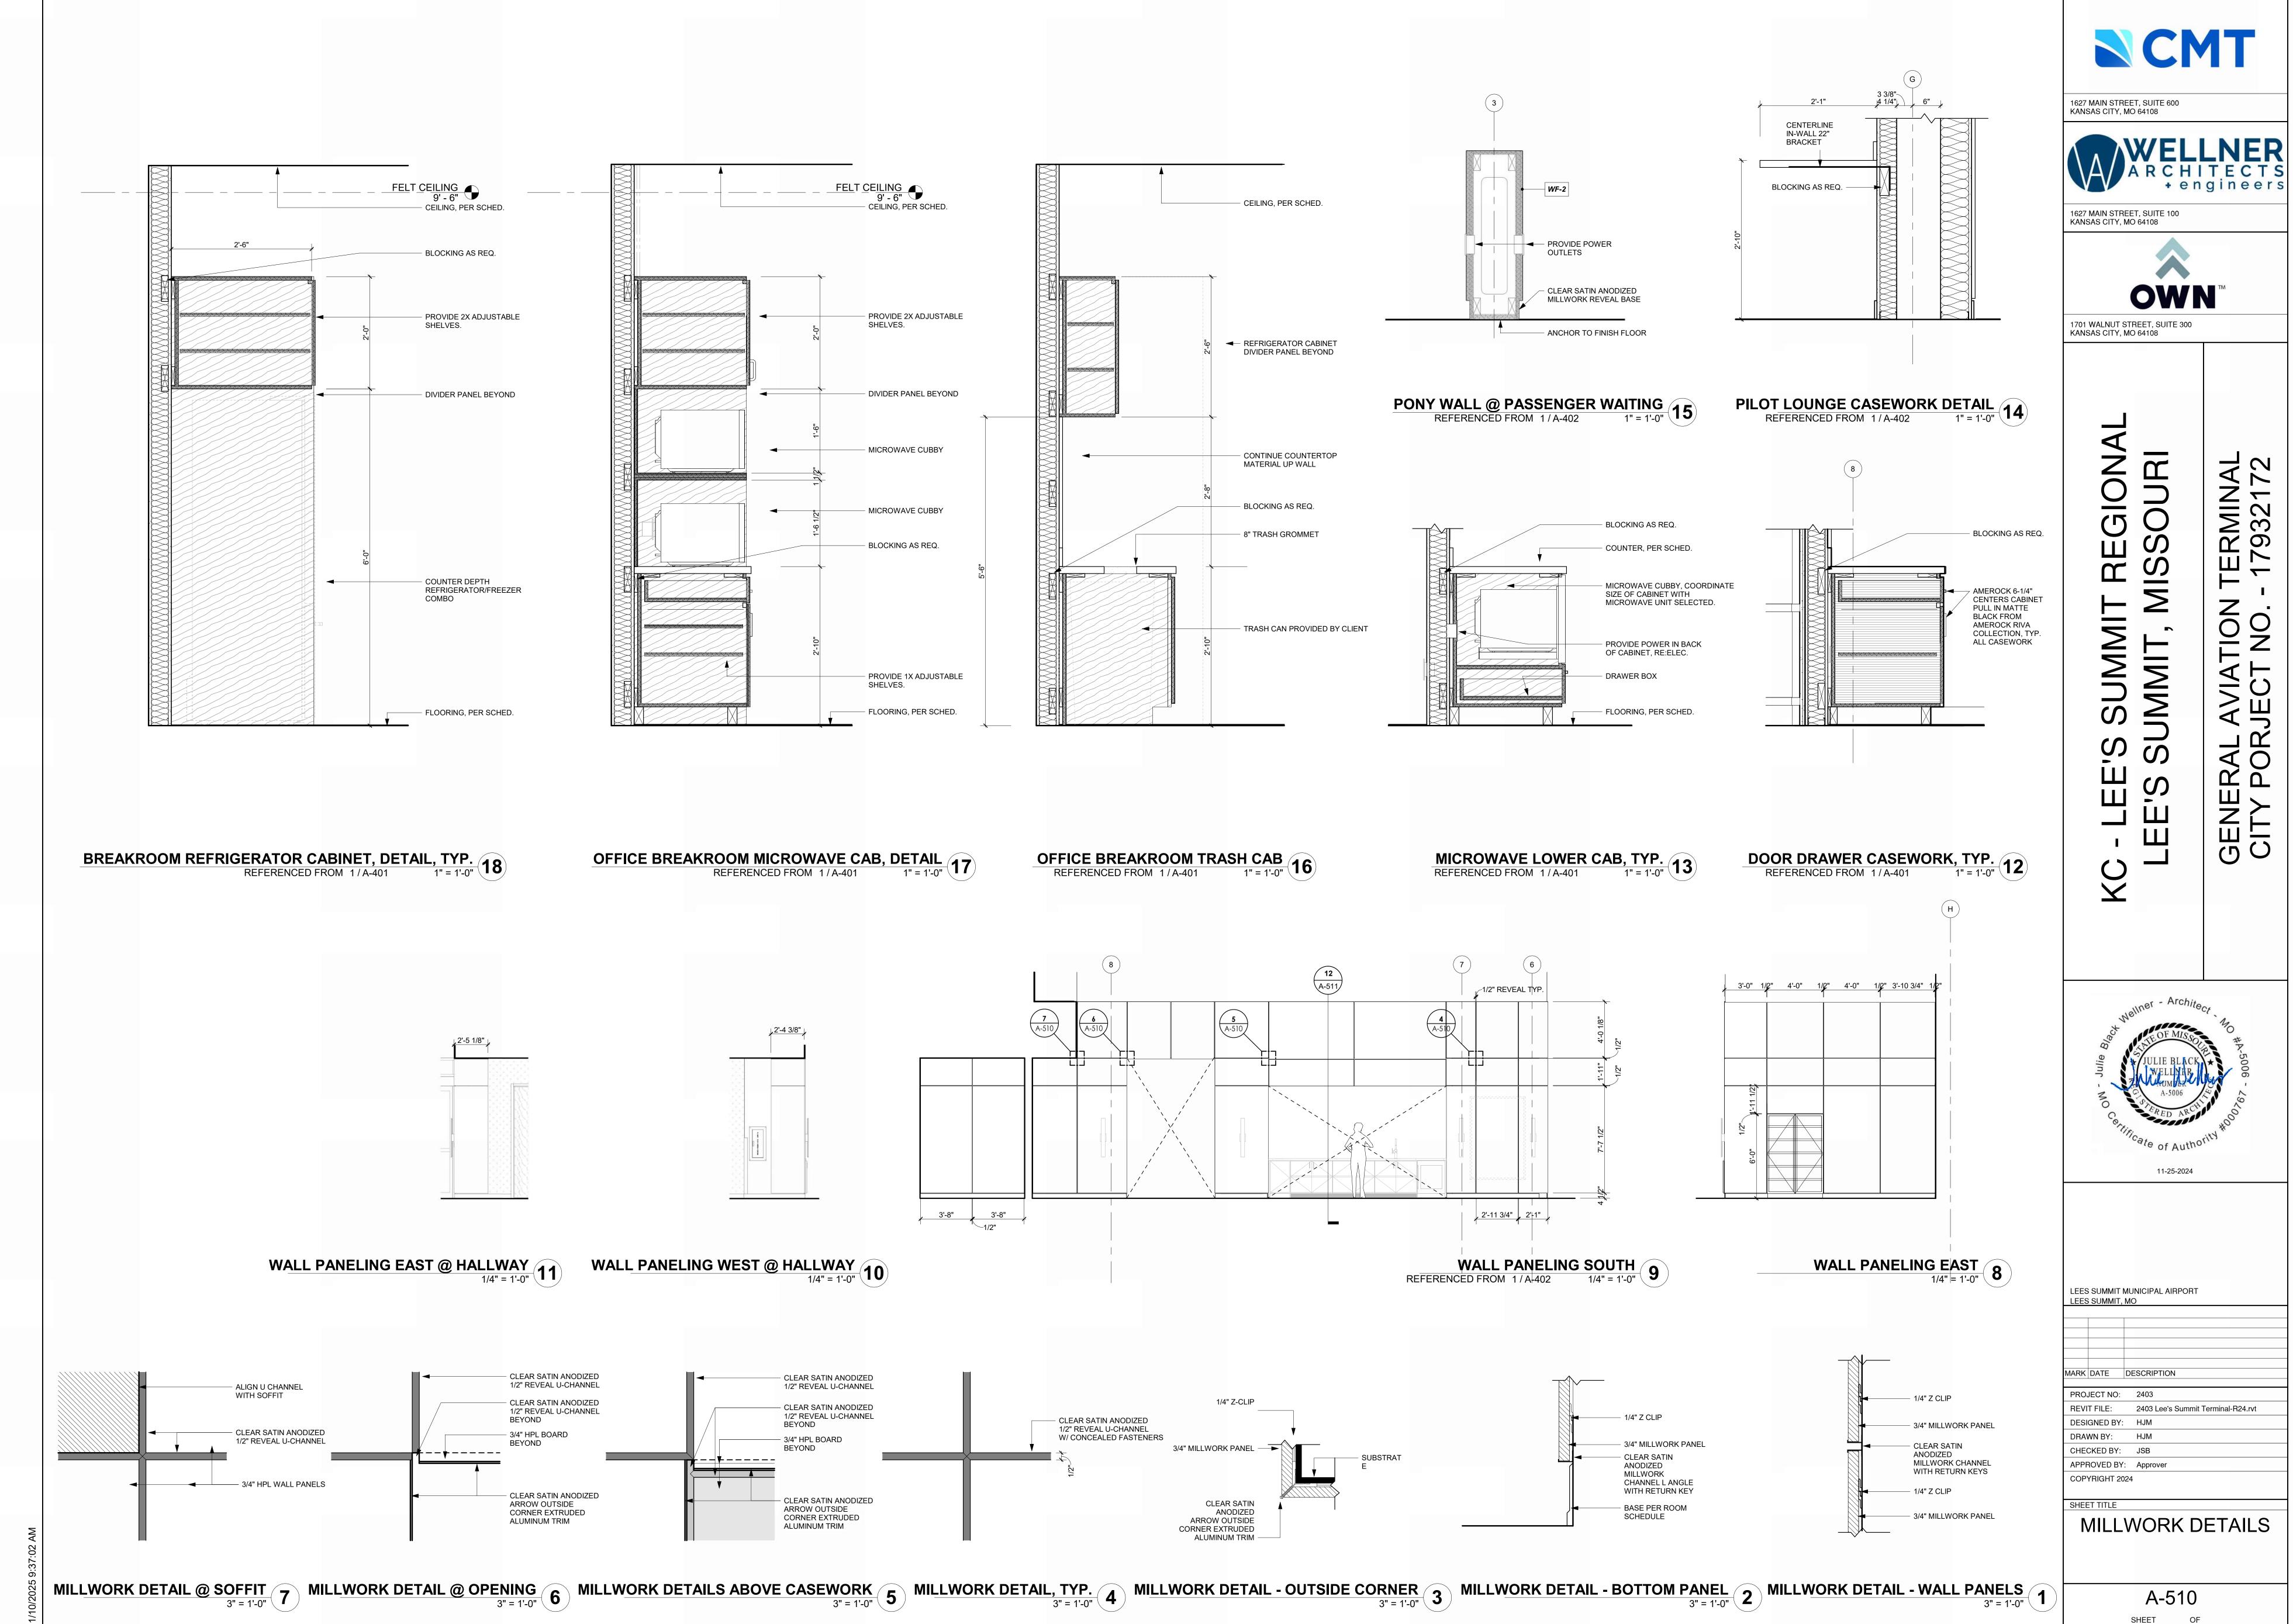


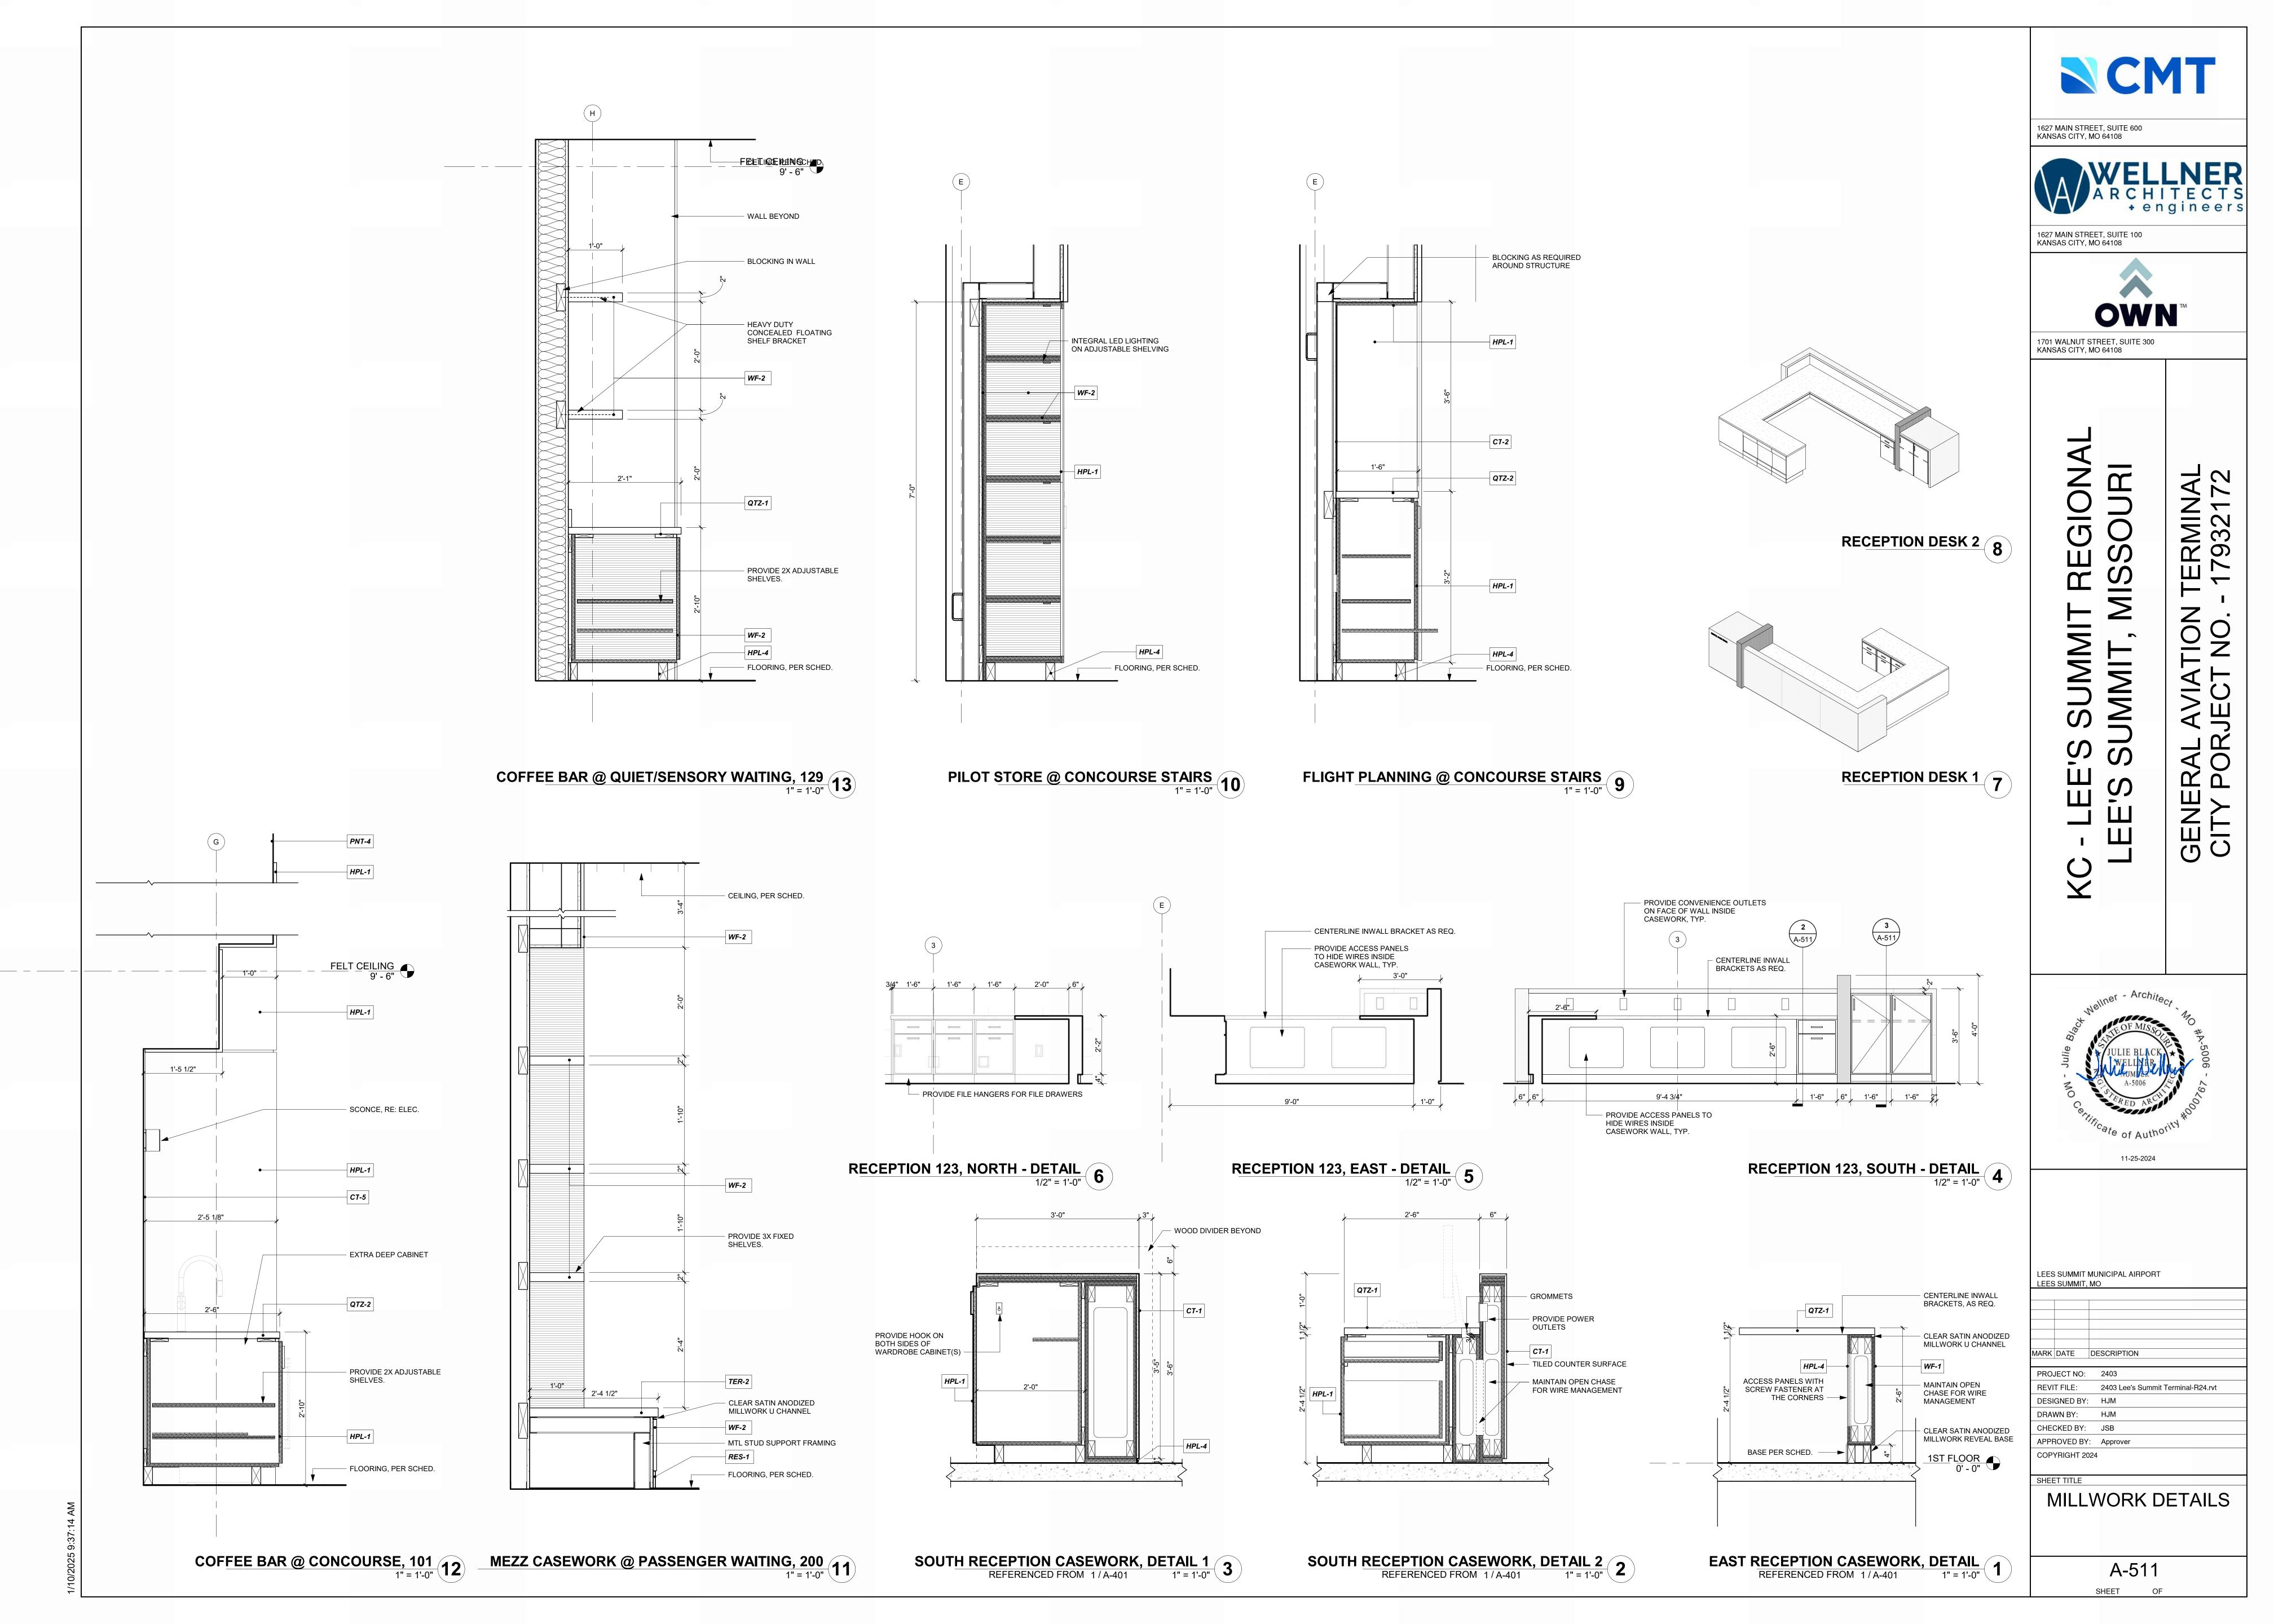


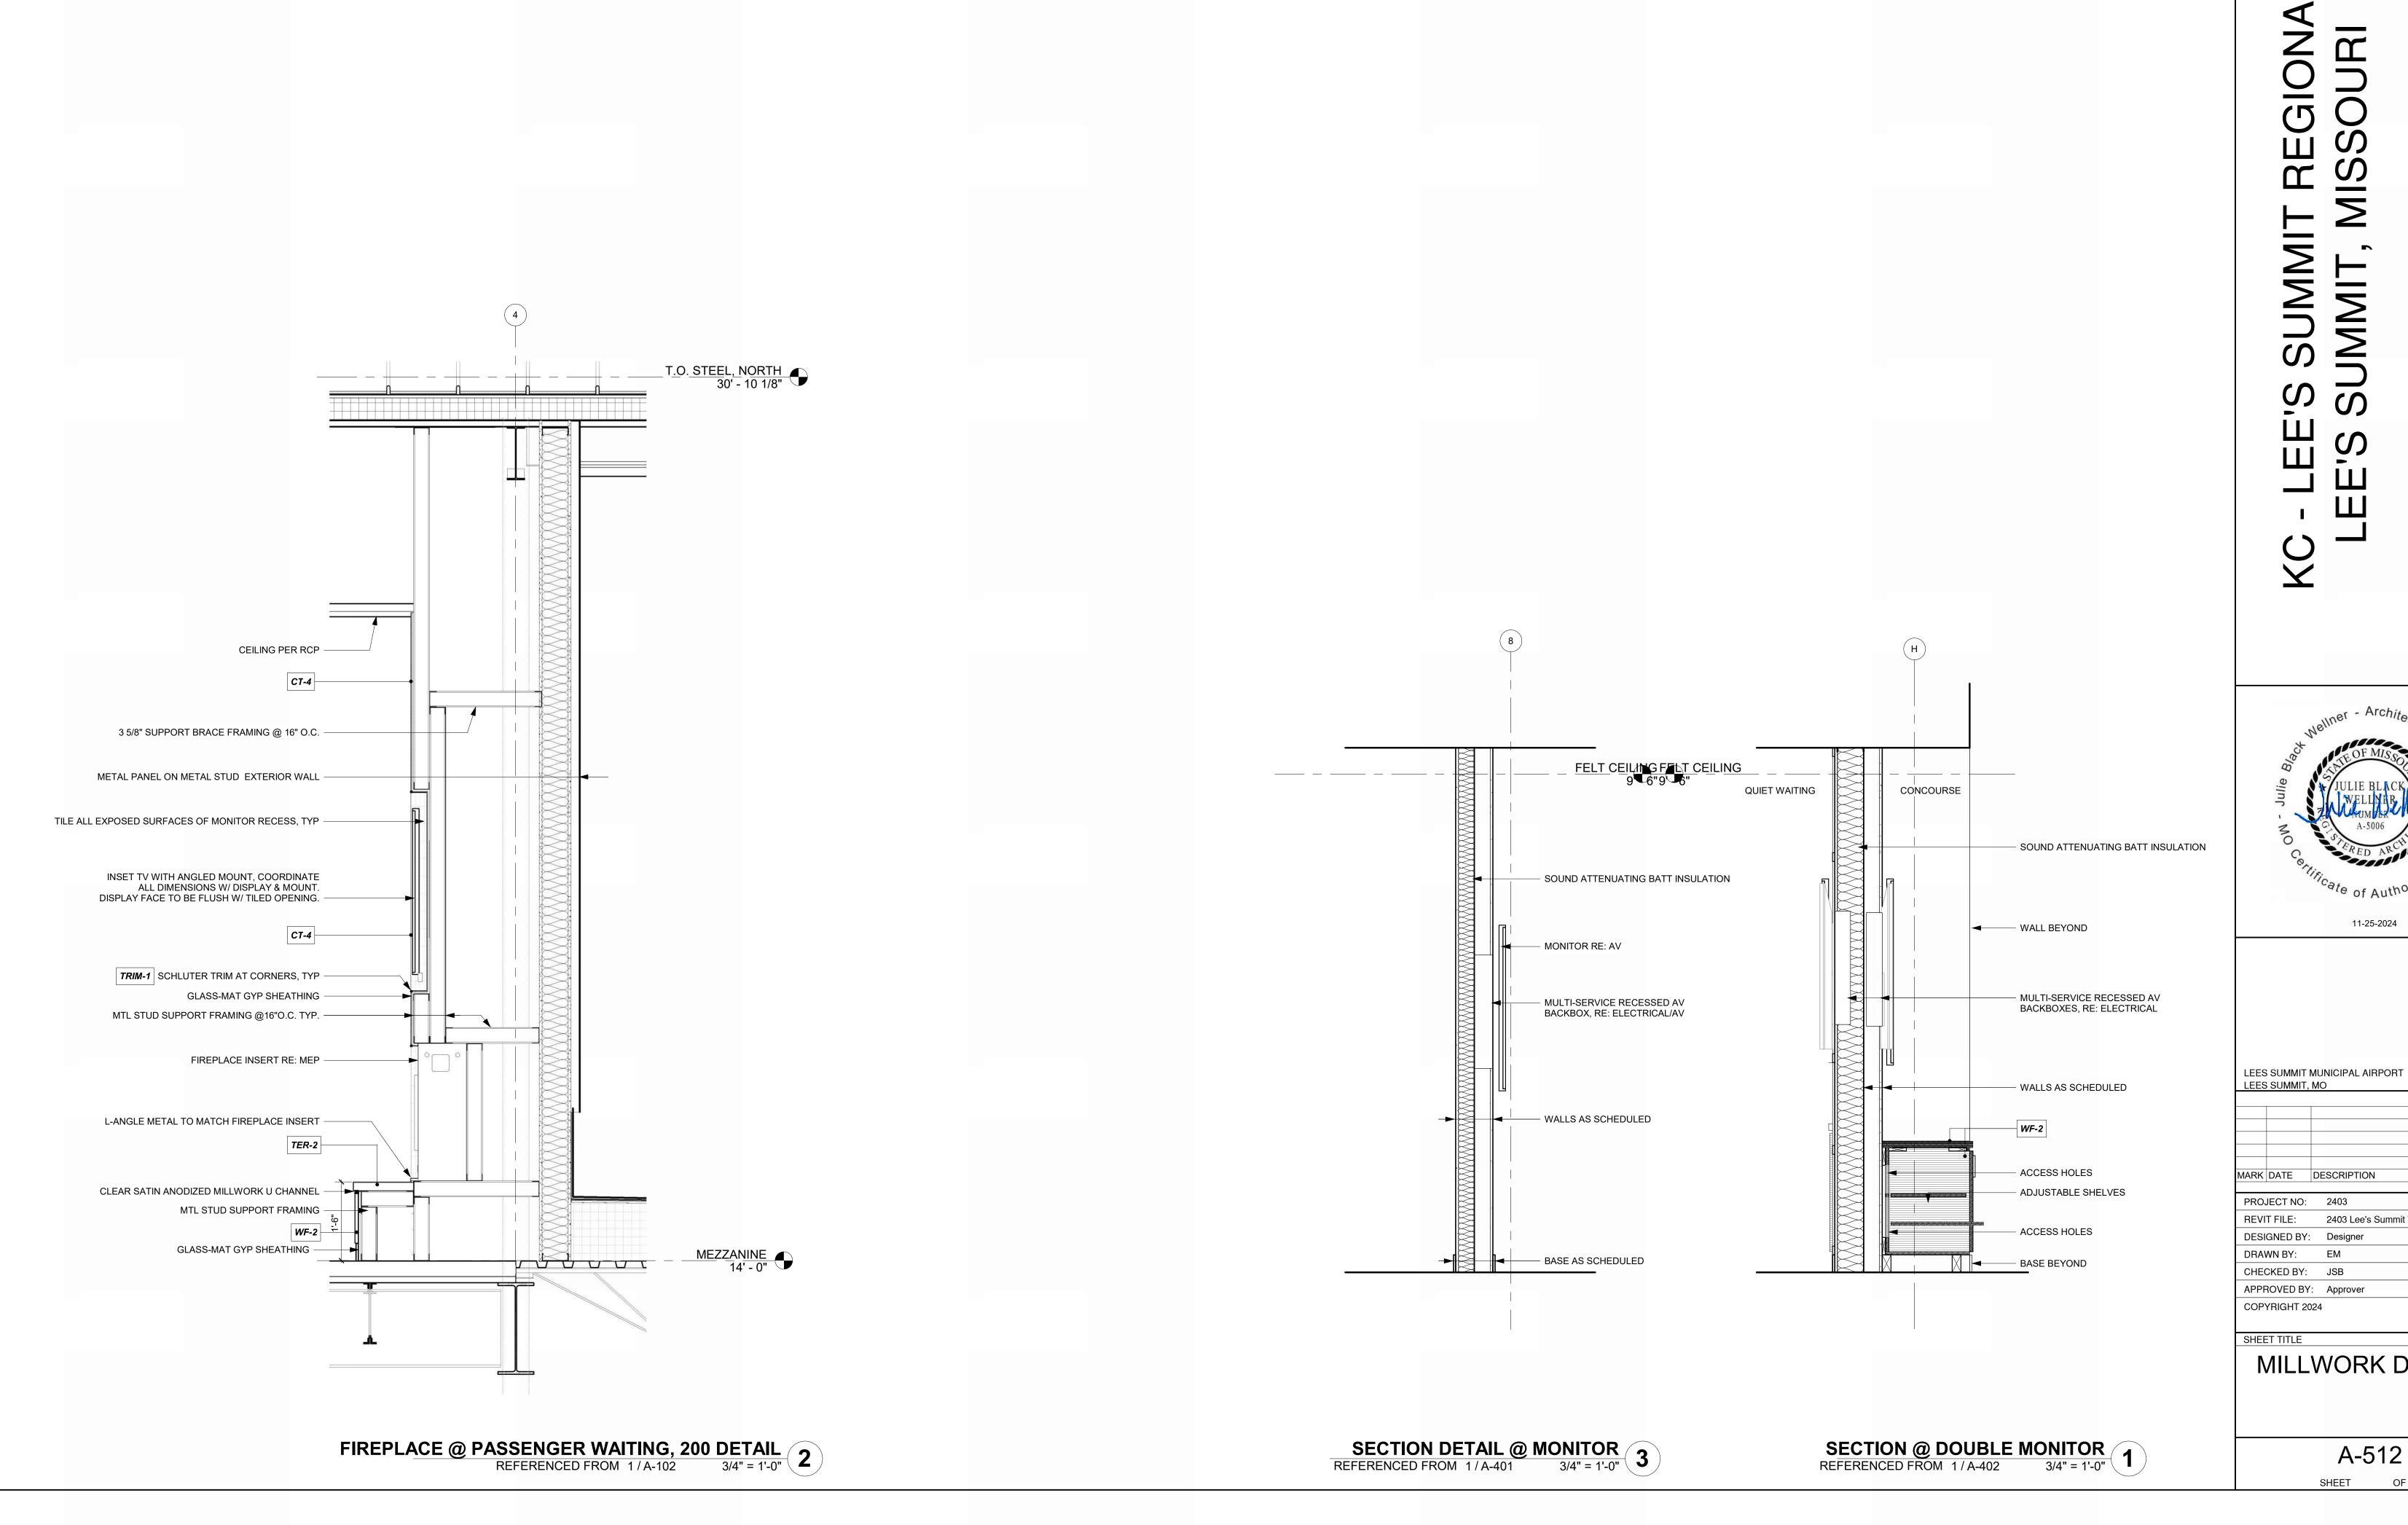












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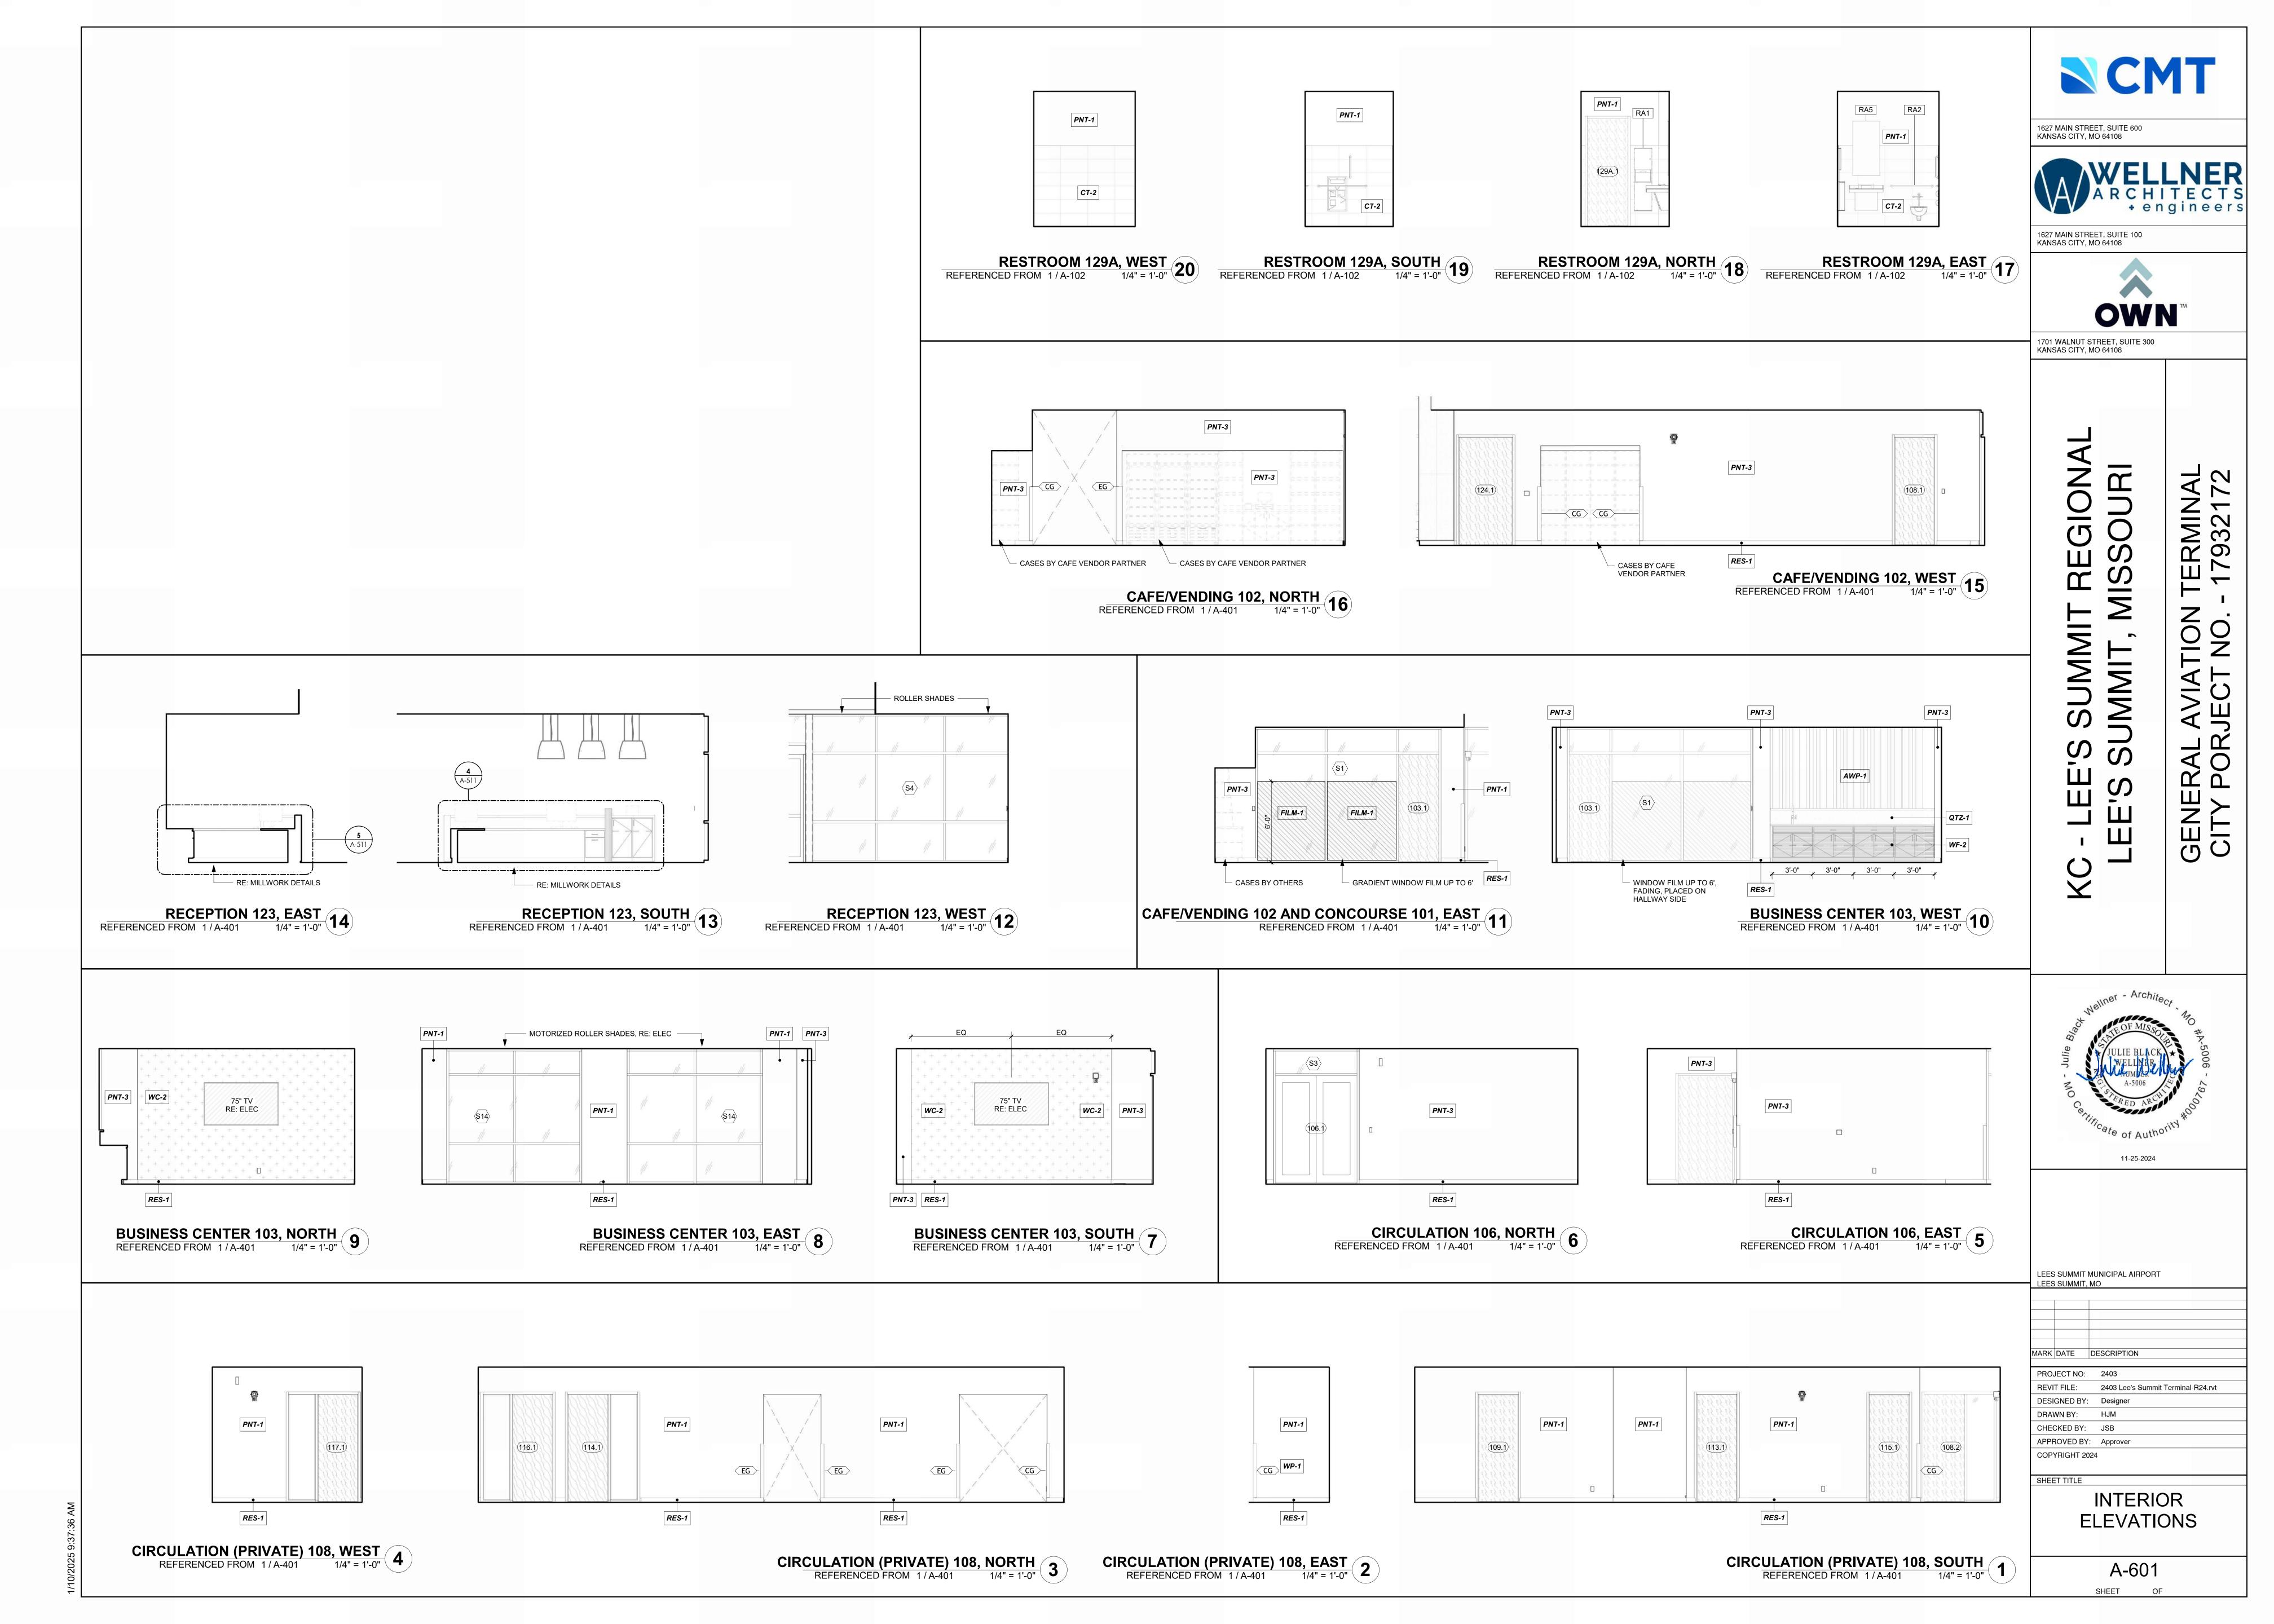
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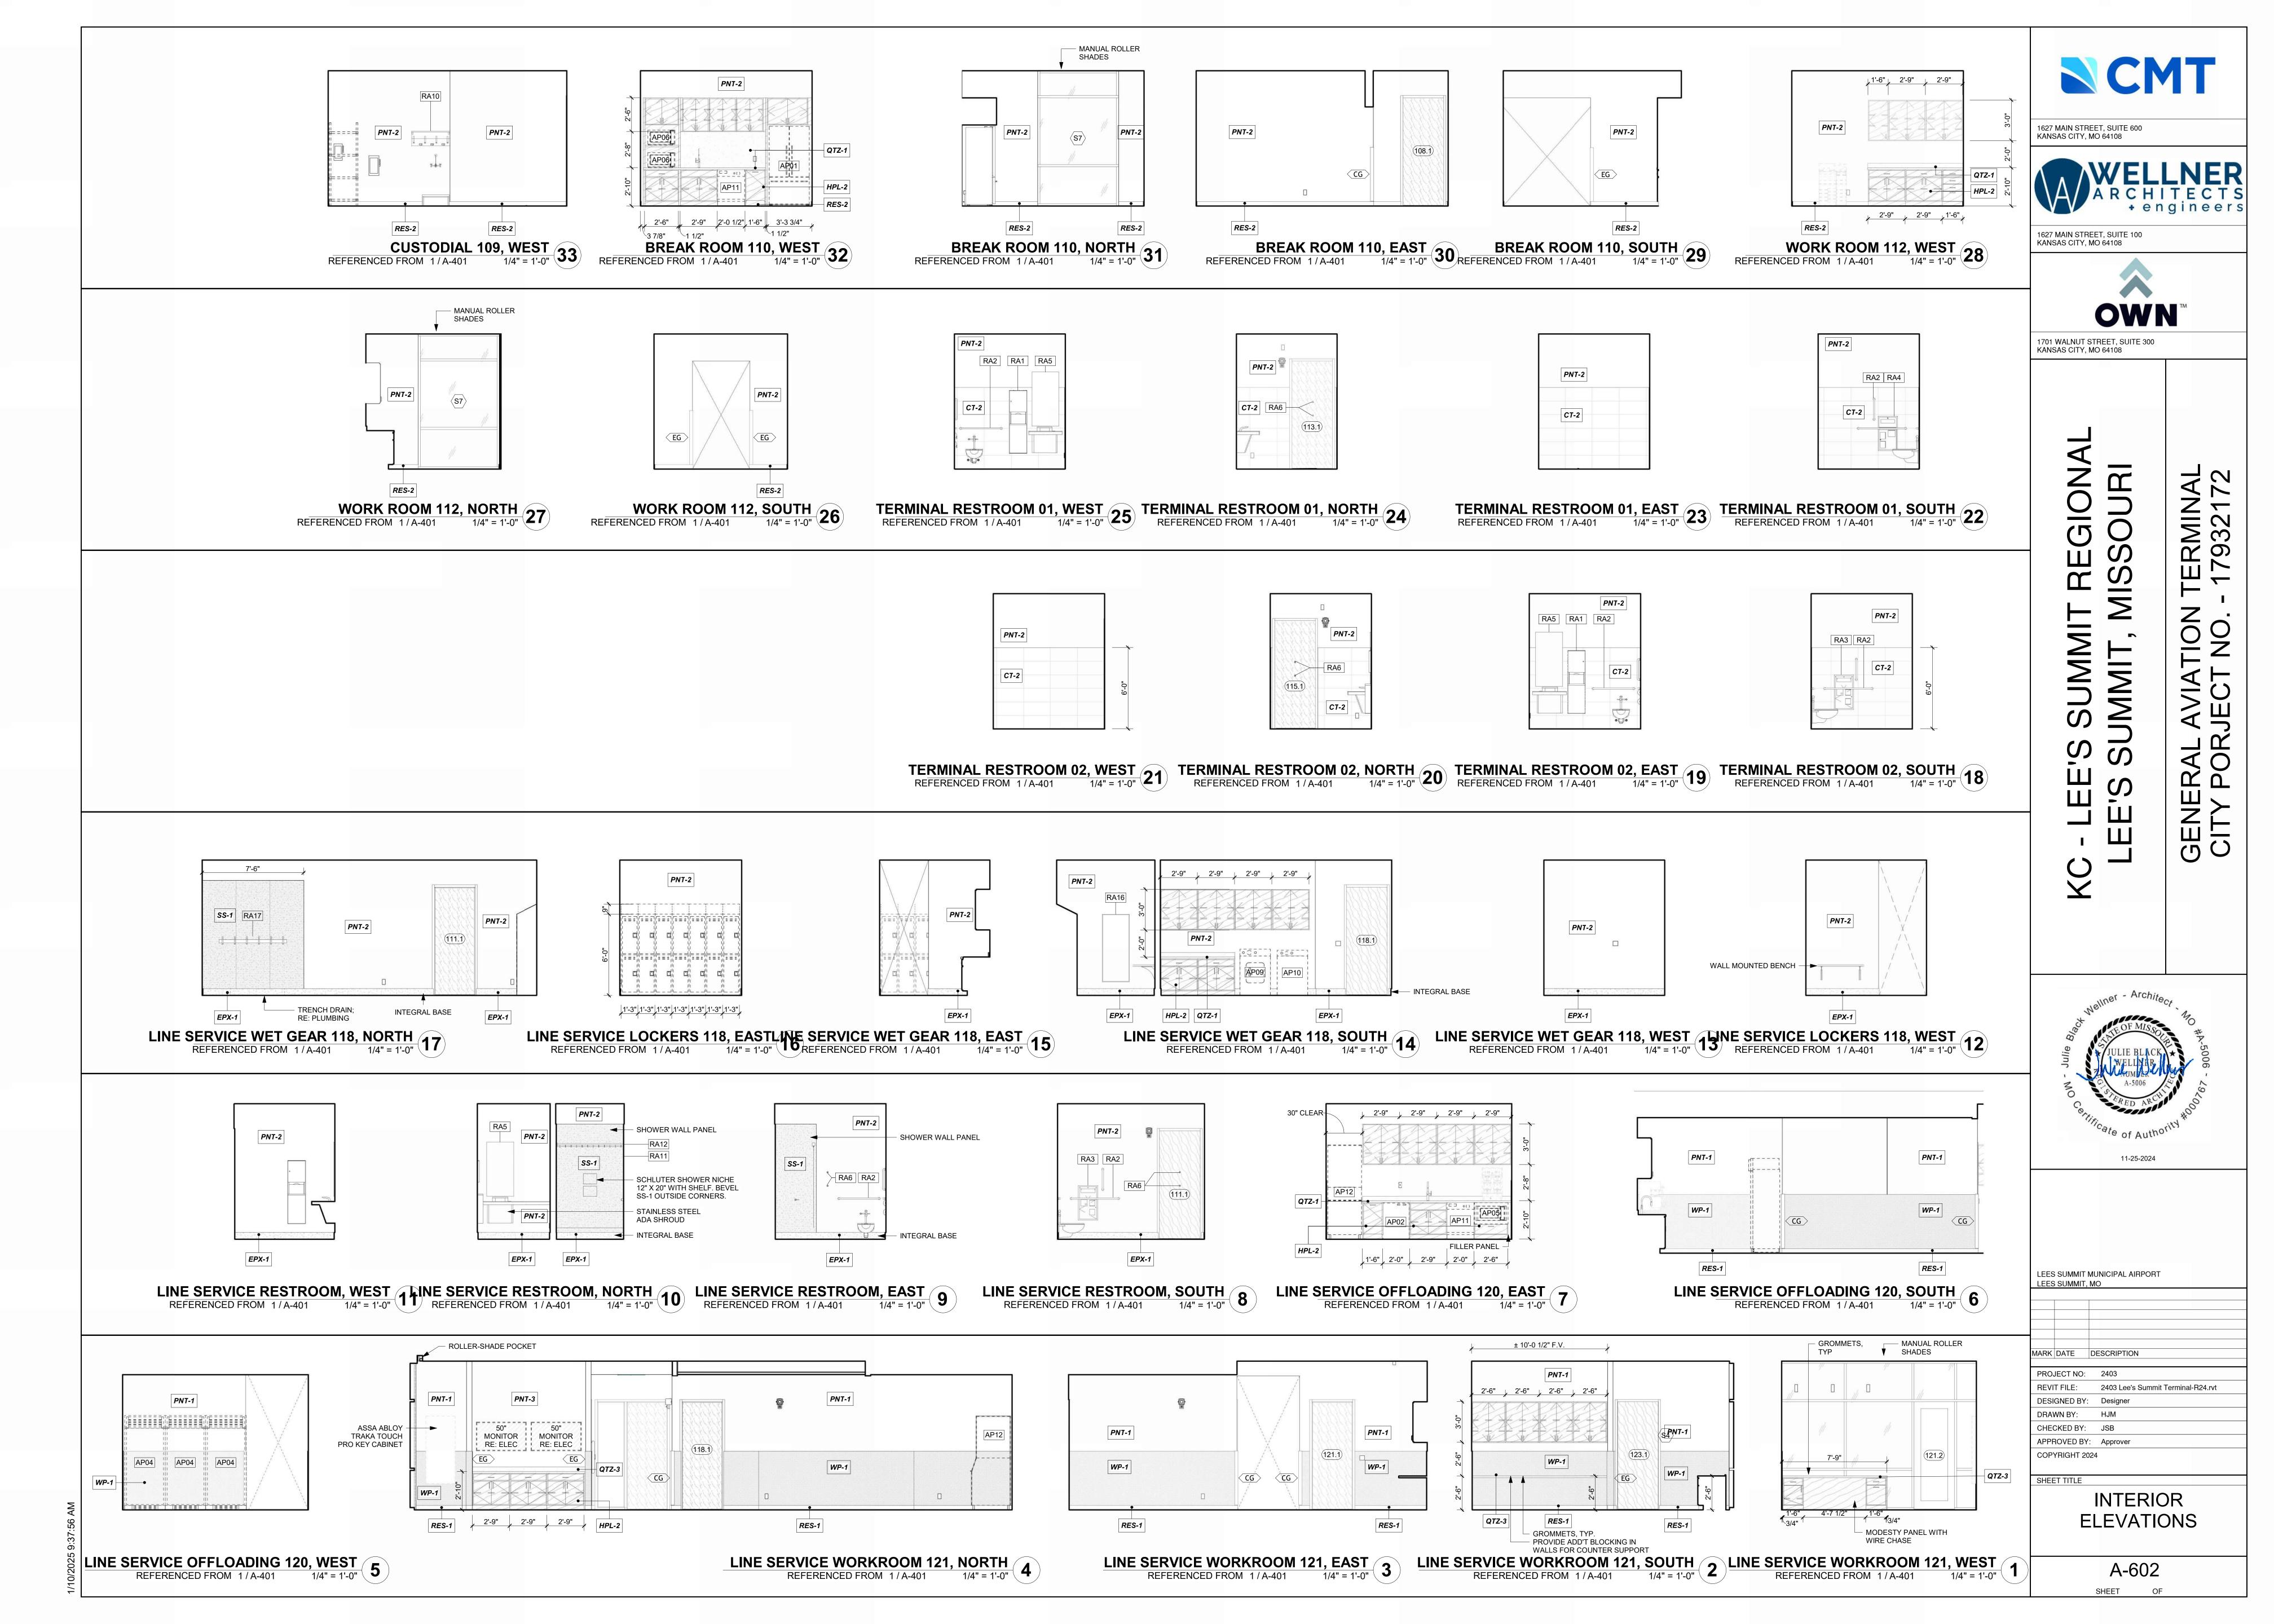
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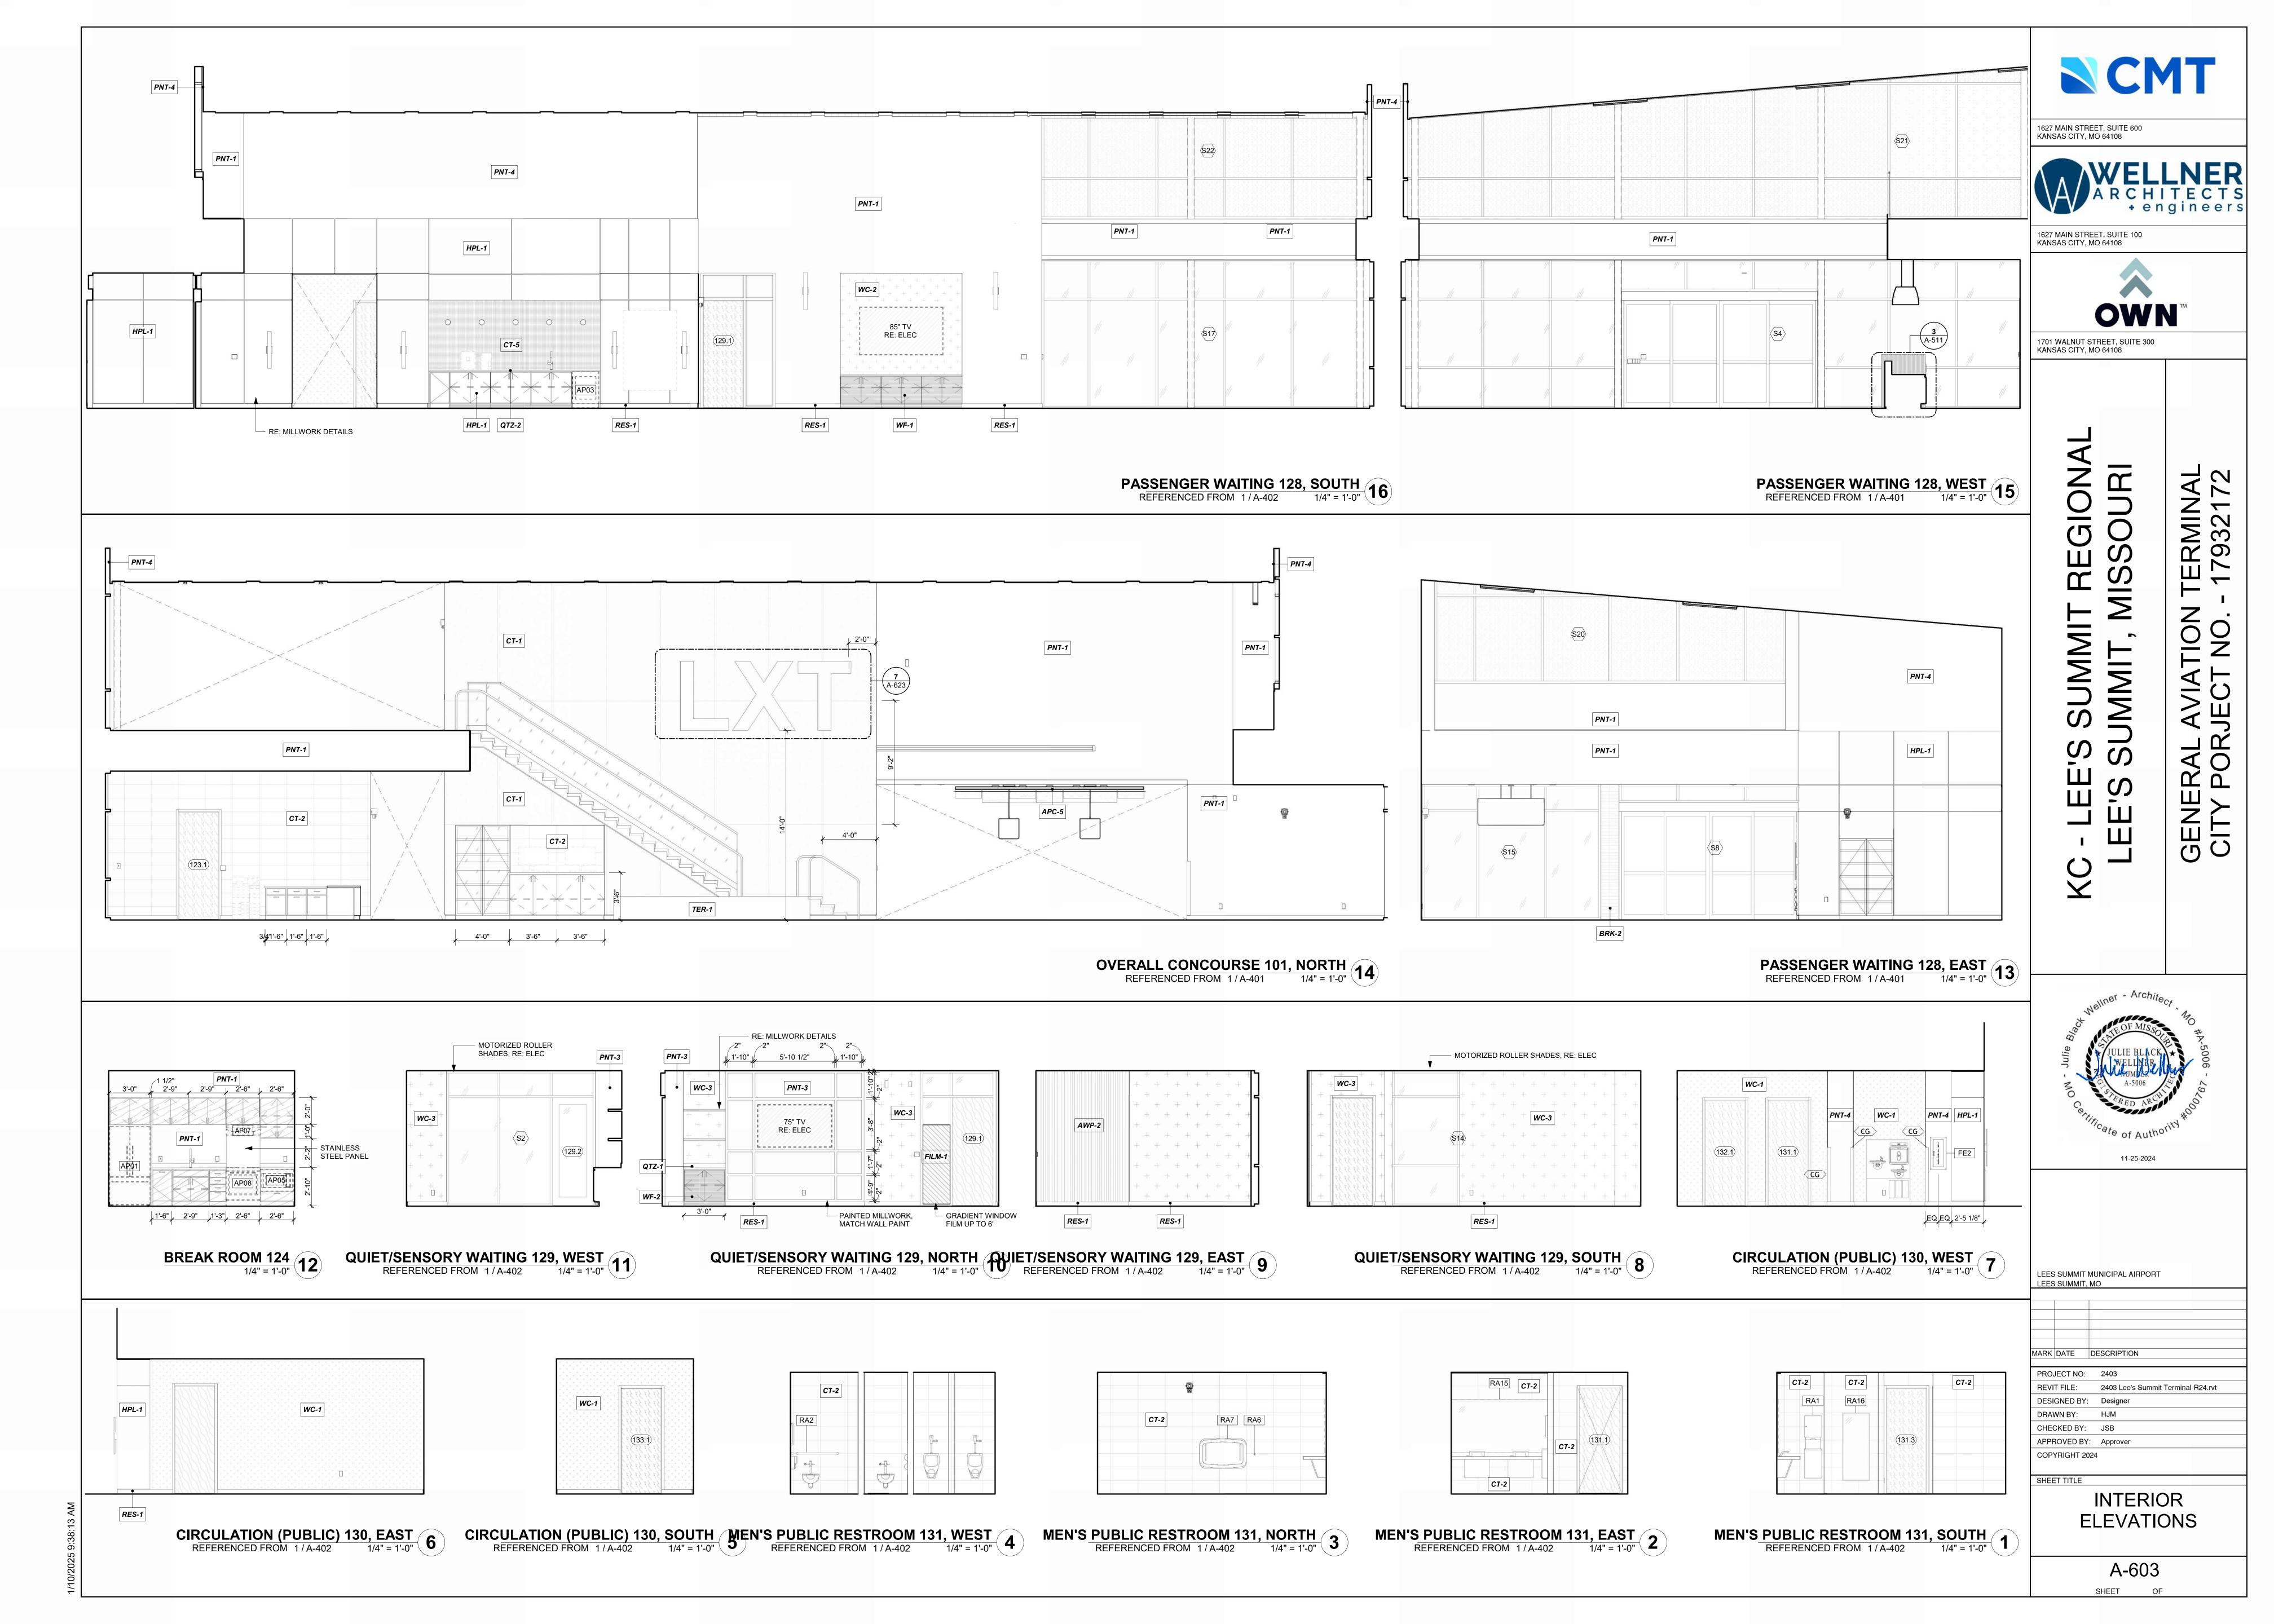
11-25-2024

A-512

SHEET OF









RESTROOM PICTOGRAM KEY

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WOMEN'S RESTROOM	MEN'S RESTROOM	FAMILY RESTROOM	RESTROOM
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ALL RESTROOM ARE ADA COMPLIANT

WOMENS RESTROOM - WOMEN + ACCESSIBLE PICTOGRAM MEN'S RESTROOM - MEN + ACCESSIBLE PICTOGRAM FAMILY RESTROOM - ACCESSIBLE PICTOGRAM RESTROOM - ACCESSIBLE PICTOGRAM

				SIGNAG	E SCHEDULE	
Room Name	Room #	Level	Туре	Type Mark	Message	Comments
CONCOURSE	101	1ST FLOOR	ID-01	21	CONCOURSE	
BUSINESS CENTER	103	1ST FLOOR	ID-02	01	BUSINESS CENTER	
BUSINESS CENTER	103	1ST FLOOR	ID-02	30	MAXIMUM OCCUPANCY 37	
IT/ASOS	104	1ST FLOOR	ID-01	06	IT	
MEP	105	1ST FLOOR	ID-01	05	MECHANICAL	
CIRCULATION	106	1ST FLOOR	ID-01	07	CIRCULATION	
TERMINAL STORAGE	107	1ST FLOOR	ID-01	04	STORAGE	
CIRCULATION (PRIVATE)	108	1ST FLOOR	ID-01	03	CIRCULATION	
CUSTODIAL	109	1ST FLOOR	ID-01	08	CUSTODIAL	
BREAK ROOM	110	1ST FLOOR	ID-01	09	BREAK ROOM	
LINE RESTROOM	111	1ST FLOOR	ID-01	18	RESTROOM	
WORKROOM	112	1ST FLOOR	ID-01	10	WORKROOM	
RESTROOM	113	1ST FLOOR	ID-04	11	RESTROOM	
EXTRA OFFICE	114	1ST FLOOR	ID-01	12	OFFICE	
RESTROOM	115	1ST FLOOR	ID-04	13	RESTROOM	
AIRPORT MANAGER	116	1ST FLOOR	ID-01	14	AIRPORT MANAGER	
ASSISTANT MANAGER	117	1ST FLOOR	ID-01	15	ASSISTANT MANAGER	
LINE SERVICE LOCKERS/WET GEAR	118	1ST FLOOR	ID-01	17	LINE SERVICE LOCKERS & WET GEAR	
LINE SERVICE SUPERVISOR	119	1ST FLOOR	ID-01	16	LINE SERVICE SUPERVISOR	
LINE SERVICE WORKROOM	121	1ST FLOOR	ID-01	22	LINE SERVICE WORKROOM	
LINE SERVICE WORKROOM	121	1ST FLOOR	ID-01	20	LINE SERVICE WORKROOM	
RECEPTION/LINE COUNTER	123	1ST FLOOR	ID-01	19	RECEPTION/LINE COUNTER	
BREAK ROOM	124	1ST FLOOR	ID-01	02	BREAK ROOM	
PASSENGER WAITING	128	1ST FLOOR	ID-02	35	MAXIMUM OCCUPANCY 112	TO BE PLACED ON THE HEADER ABOVE DOO
PASSENGER WAITING	128		ID-02	36	MAXIMUM OCCUPANCY 112	TO BE PLACED ON GYP BD ABOVE
QUIET/SENSORY WAITING	129	1ST FLOOR	ID-01	23	QUIET/SENSORY WAITING	
QUIET/SENSORY WAITING	129	1ST FLOOR	ID-02	32	MAXIMUM OCCUPANCY 27	
MEN'S	131	1ST FLOOR	ID-01	24	MEN'S RESTROOM	
WOMEN'S	132	1ST FLOOR	ID-01	25	WOMEN'S RESTROOM	
FAMILY RR	133	1ST FLOOR	ID-04	26	FAMILY RESTROOM	
QUIET ROOM	134	1ST FLOOR	ID-01	28	QUIET ROOM	
QUIET ROOM	135	1ST FLOOR	ID-01	29	QUIET ROOM	
PILOT LOUNGE	136		ID-01	27	PILOT LOUNGE	
PILOT LOUNGE	136	1ST FLOOR	ID-02	31	MAXIMUM OCCUPANCY 26	
PASSENGER WAITING	200		ID-02	33	MAXIMUM OCCUPANCY 49	
DACCENCED WAITING	200	NACZZANINIC		2.4	IN CACE OF FIRE DO NOT LICE	


MEZZANINE ID-05 34

SIGNAGE TYPES

ID01, ID02, ID03, ID04, ID05, ID06 - FLAT PROFILE 1/4"

- THICK BACKPAINTED ACRYLIC SIGNS SIGNS MOUNTED ON GLASS TO RECEIVE BACKER
- SHEET MATCHING SIGN MATERIAL AND FINISH, IN SIZE MATCHING SIGN, MOUNTED ONTO OPPOSITE SIDE OF GLASS TO CONCEAL BACK OF SIGN
- TACTILE CHARACTERS AND PICTOGRAMS TIPPED

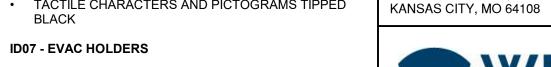 TEXT FOR INSERTS (PERSONNEL NAMES, ET.AL.) TO BE PROVIDED BY THE OWNER; PRINTED



1627 MAIN STREET, SUITE 600

1627 MAIN STREET, SUITE 100 KANSAS CITY, MO 64108

1701 WALNUT STREET, SUITE 300

MIN. 3217

TEF

GENERAL AVIAT
CITY PORJECT I

KANSAS CITY, MO 64108

INSERTS TO BE PROVIDED AND INSTALLED BY

GENERAL SIGNAGE REQUIREMENTS

- SIGNAGE TO MEET IBC AND A117.1 SIGNAGE REQUIREMENTS
- GRADE II BRAILLE NOT TIPPED

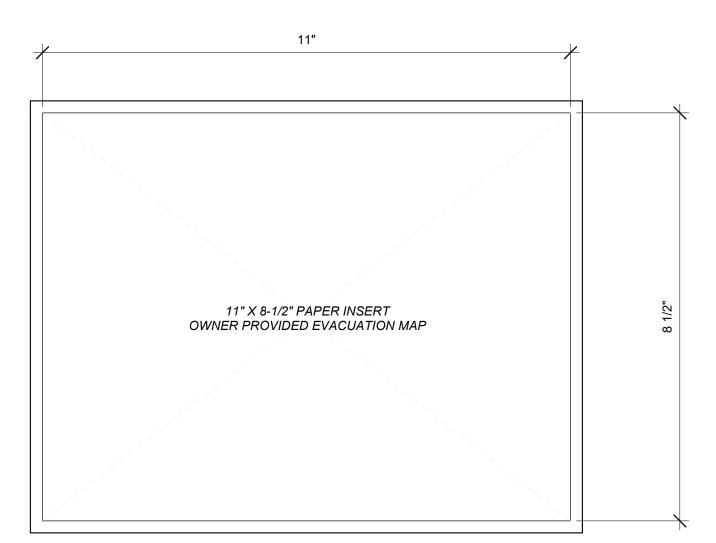
CONTRACTOR

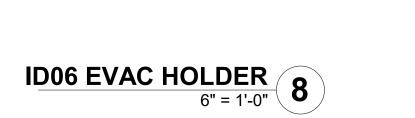
DISCHARGE

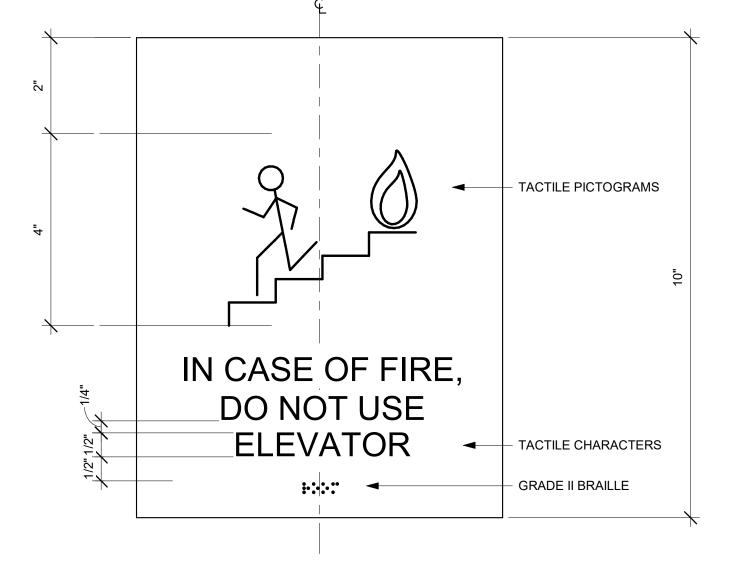
BY ARCHITECT

- PICTOGRAMS TO BE REVIEWED BY ARCHITECT FONT: HELVETICA NEUE, REGULAR
- ALL SIGNAGE SHALL BE CODE COMPLIANT
- BRAILLE TO BE VERIFIED BY CERTIFIED EXPERT
- A SIGN STATING "EXIT" COMPLYING WITH ICC A117.1 SHALL BE PROVIDED ADJACENT TO EACH DOOR LEADING TO THE EXTERIOR, AN AREA OF REFUGE, AN EXIT STAIRWAY, OR OTHER EXIT
- TEMPORARY SIGNAGE TO BE PLACED AND REVIEWED WITH OWNER PRIOR TO INSTALLATION OF PERMANENT SIGNAGE
- PROVIDE 10 ADDITIONAL SIGNS 11" X 9" MAX, IN BASE BID, TO BE USED AS REQUIRED TO ADDRESS OWNER REVISIONS ARTWORK TO BE REVIEWED
- ALL DIMENSIONS AND MOUNTING CONDITIONS MUST BE VERIFIED IN THE FIELD PRIOR TO FINAL ARTWORK RELEASE
- ALL ATTACHMENTS TO BE CONCEALED UNO. PROVIDE BLOCKING AS REQUIRED FOR SECURE ANCHORAGE. SEE ARCHITECTURAL WALL FOR CONSTRUCTION
- SIGNAGE COLOR TO BE VERIFIED WITH OWNER AND CONFIRMED BY ARCHITECT













PASSENGER WAITING

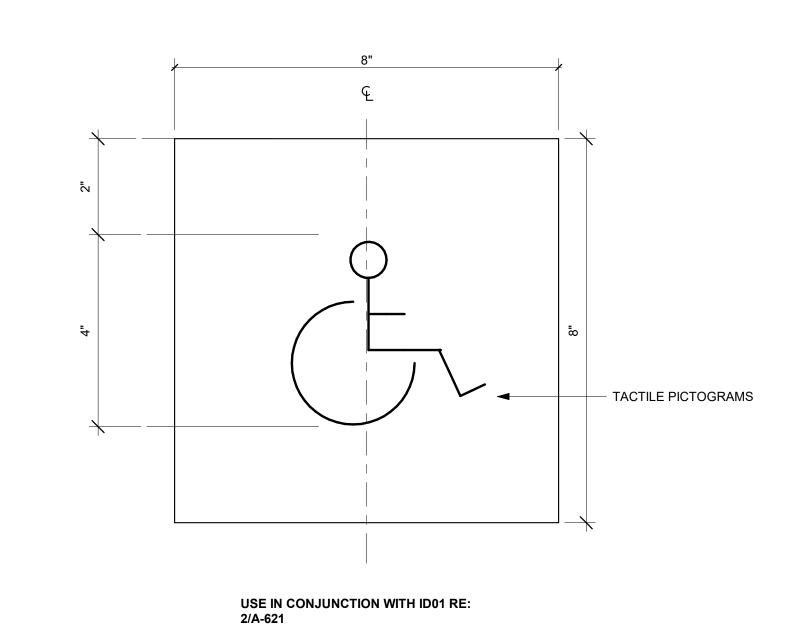



IN CASE OF FIRE, DO NOT USE

ELEVATORS

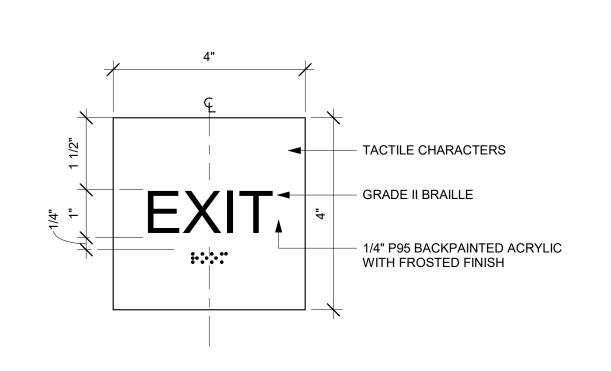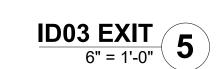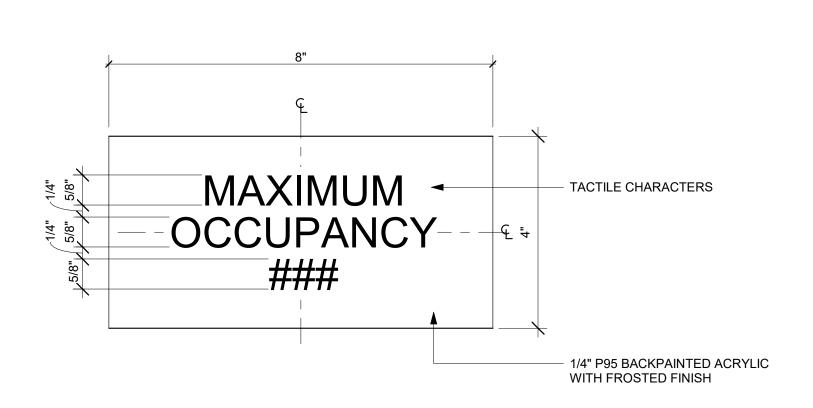
ID04 RESTROOM 6" = 1'-0" 6









ID02 MAXIMUM OCCUPANCY
6" = 1'-0"

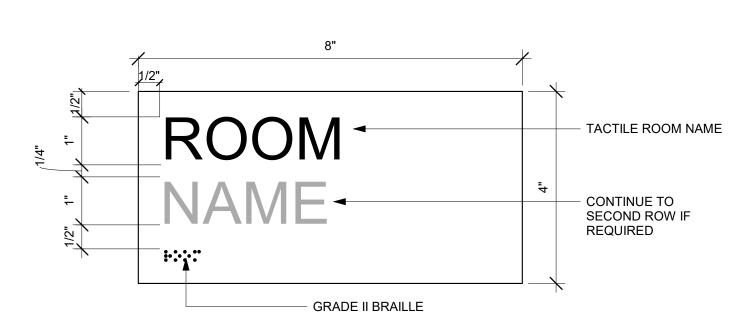

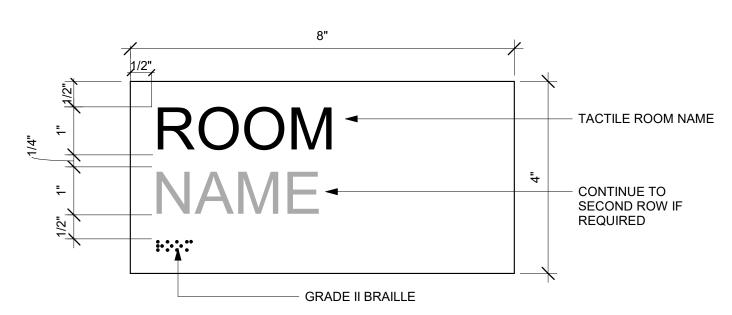


ID01 ROOM NAME 6" = 1'-0" 3

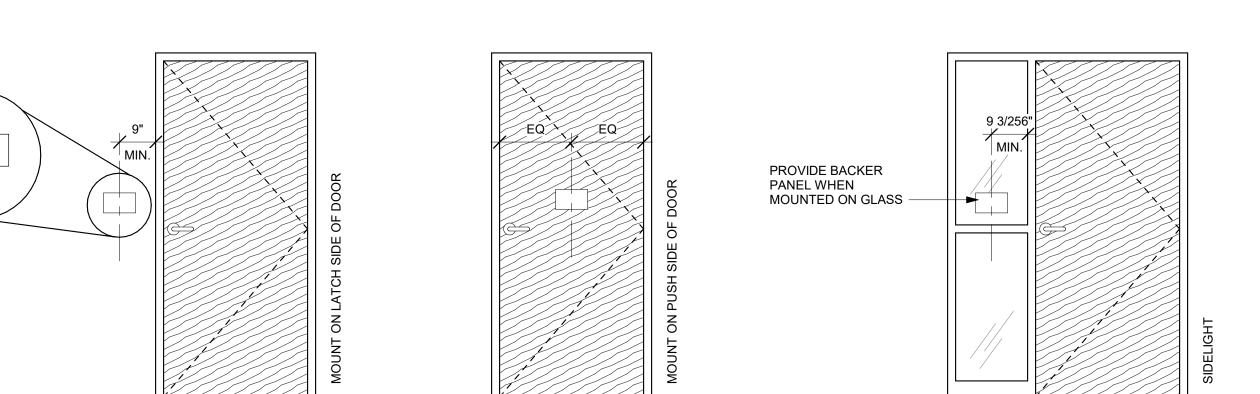


ID04 + ID01 STANDARD LAYOUT
3" = 1'-0"
2

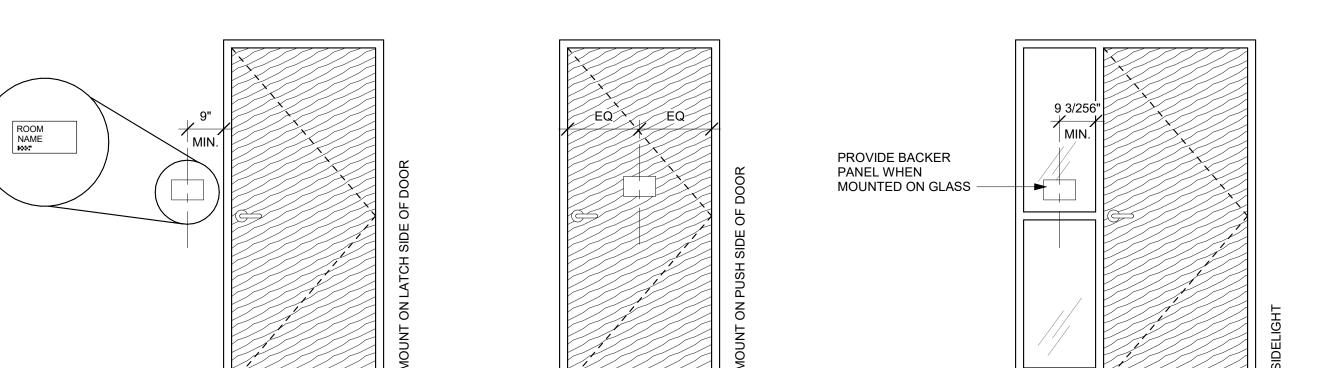
PICTOGRAM TOBE DETERMINEDBY ROOM TYPE



DOOR SIGNAGE ELEVATION
1/2" = 1'-0"

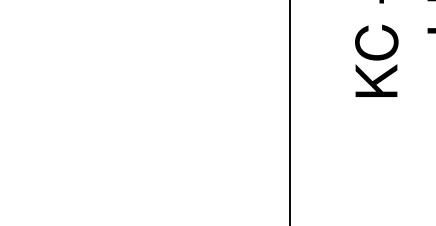


PROJECT PICTOGRAMS

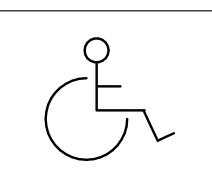

ACCESSIBLE




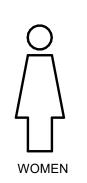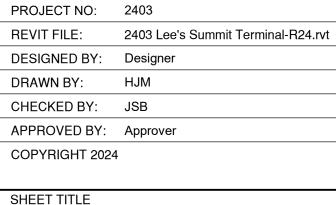IN CASE OF EMERGENCY










LEES SUMMIT MUNICIPAL AIRPORT


LEES SUMMIT, MO

11-25-2024

ADA & CODE SIGNAGE

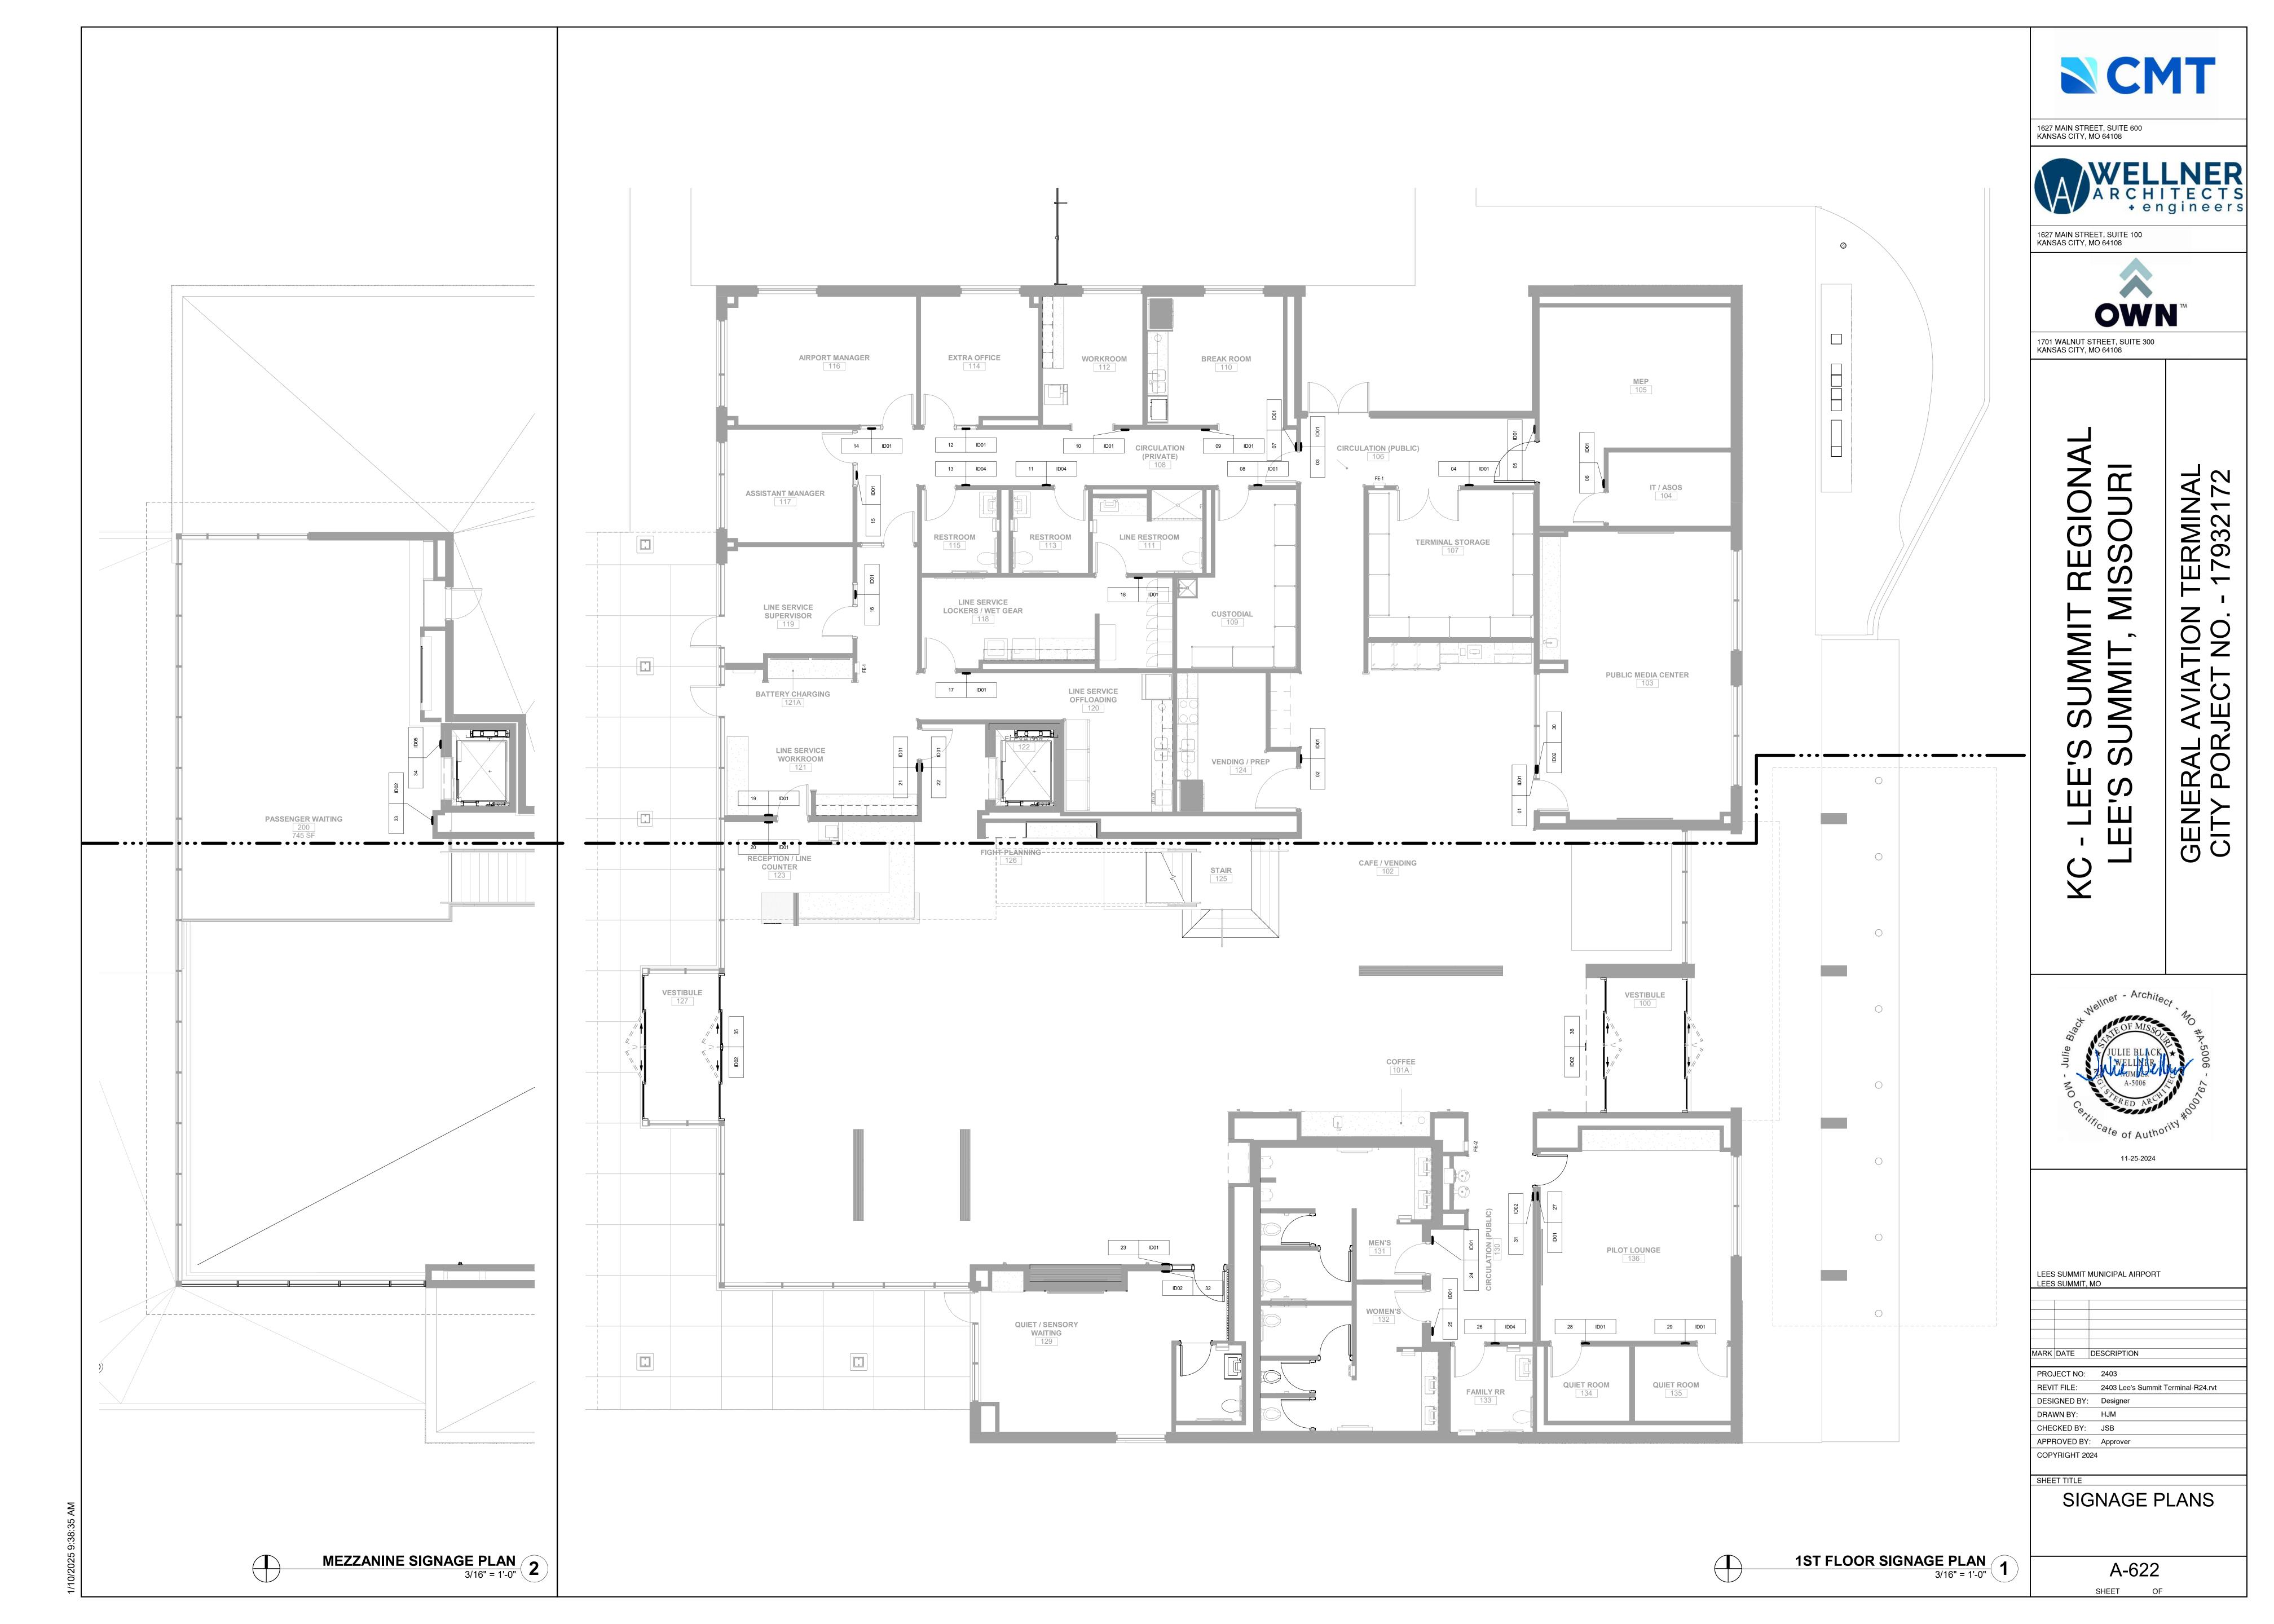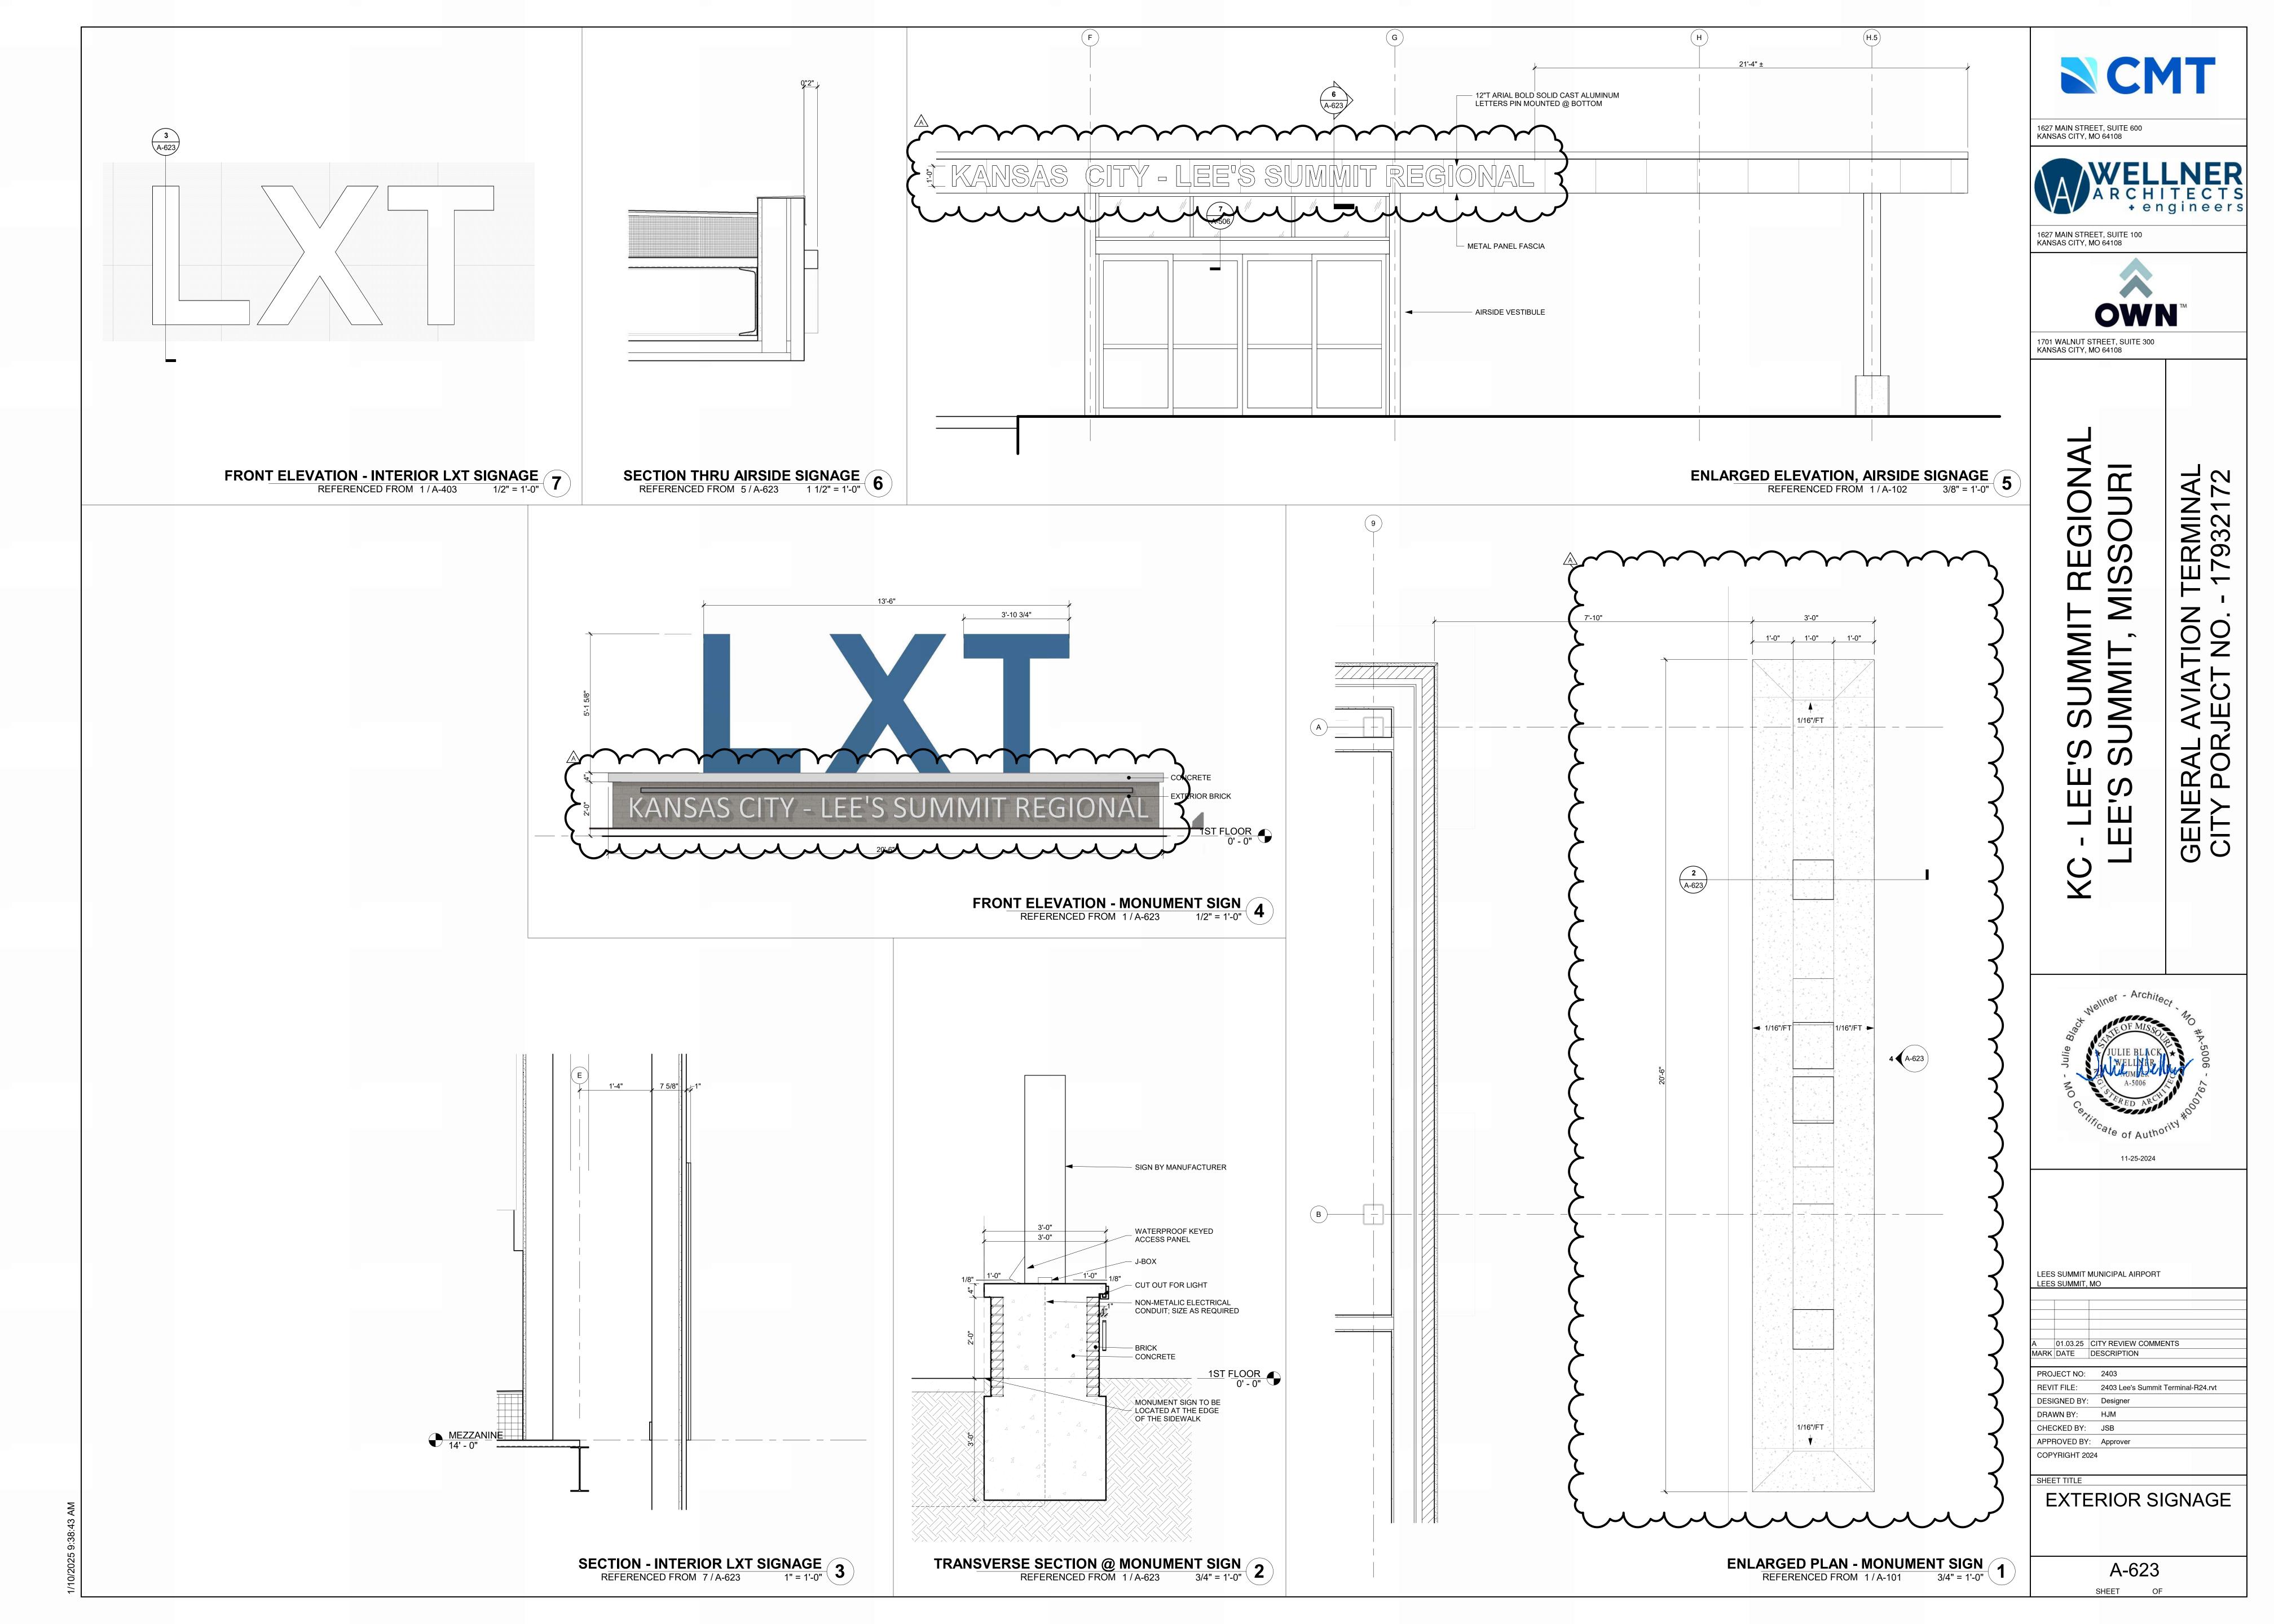A-621 SHEET OF







IT STREET, SUITE 300	

O1 WALNUT STREET, SUITE 300 ANSAS CITY, MO 64108	

OWN ™	
IT STREET, SUITE 300 Y, MO 64108	

REGION	TERMINAL - 17932172

	NUMBER: 119.2 121.2					RDWARE SET: 07 DR NUMBER: 109.1				
QTY	DESCRIPTION	CATALOG NUMBER	FINISH	MFR	EAC QTY	CH TO HAVE: Output O	CATALOG NUMBER	FINISH	MFR	
	HINGE POWER TRANSFER	5BB1HW NRP EPT10 CON	630 689	IVE VON		A HINGE	5BB1HW	652	IVE	
	ELEC PANIC HARDWARE	RX-LC-QEL-98-NL-CON 24 VDC	626	VON	1 E/	A STOREROOM LOCK	ND80P6D RHO	626	SCH	
	RIM HOUSING	20-079	626	SCH		A SURFACE CLOSER A KICK PLATE	4040XP RW/PA 8400 10" X 2" LDW B-CS	689 630	LCN IVE	
	FSIC PERM. CORE FSIC CONSTR. CORE	23-030 EV29 T 23-030 ICX	626 ORG	SCH SCH		WALL STOP	WS406/407CCV	630	IVE	
	SURFACE CLOSER	4040XP SCUSH	689	LCN	1 EA	A GASKETING	488SBK PSA (AT RATED DOORS)	BK	ZER	
	KICK PLATE	8400 10" X 2" LDW B-CS	630	IVE		A SILENCER	SR64 SED AND LOCKED. ACCESS VIA VALID CAI	GRY	IVE	
	DOOR SWEEP THRESHOLD	8198AA 103A-223	AA A	ZER ZER		E EGRESS.	SED AND LOCKED. ACCESS VIA VALID CAI	NU KEAU. AL	WAIS	
	WIRE HARNESS	CON X LENGTH REQ'D	Α	SCH		-				
	DOOR CONTACT	7764	628	SCE		RDWARE SET: 08	2.4			
	POWER SUPPLY DOOR CALL STATION	BY SECURITY SYSTEM INTEGRATOR BY SECURITY SYSTEM INTEGRATOR		B/O		DR NUMBER: 108.2 124.1 129.1 136 :H TO HAVE:). I			
	CARD READER	BY SECURITY SYSTEM INTEGRATOR			QTY	DESCRIPTION	CATALOG NUMBER	FINISH	MFR	
	WEATHERSTRIP	BY DOOR/FRAME MANUFACTURER		B/O		A HINGE	5BB1HW	652	IVE	
	WIRING DIAGRAM	BY SECURITY SYSTEM INTEGRATOR SED AND LOCKED. ACCESS VIA VALID CAF		ANIC		A CLASSROOM LOCK A SURFACE CLOSER	ND70P6D RHO 4040XP	626 689	SCH LCN	
) ELECTRONICALLY. OUTSIDE ADA ACTUA		AINIC		KICK PLATE	8400 10" X 2" LDW B-CS	630	IVE	
OPERA		OR AFTER VALID CARD READ, INSIDE AC		WAYS	1 E <i>A</i> 1 E <i>A</i>	A WALL STOP A GASKETING	WS406/407CCV 488SBK PSA	630 BK	IVE ZER	
	'ARE SET: 02				HAF	RDWARE SET: 09				
DOOR N	NUMBER: 106.1				DOC	OR NUMBER: 103.1 114.1 116.1 117	7.1 119.1			
EACH TO		CATALOG NUMBER	FINISH	MFR	QTY	CH TO HAVE: ' DESCRIPTION	CATALOG NUMBER	FINISH	MFR	
	DESCRIPTION CONT. HINGE	CATALOG NUMBER 112XY EPT	628	IVE		A HINGE	5BB1HW	652	IVE	
2 EA	POWER TRANSFER	EPT10 CON	689	VON		A ENTRANCE LOCK	ND53P6D RHO	626	SCH	
	REMOVABLE MULLION	KR4954	689	VON		A WALL STOP A SILENCER	WS406/407CCV SR64	630 GRY	IVE IVE	
	ELEC PANIC HARDWARE ELEC PANIC HARDWARE	RX-LC-QEL-98-EO-CON 24 VDC RX-LC-QEL-98-NL-CON 24 VDC	626 626	VON VON			J OF WALL STOP WHERE REQUIRED.	OIVI	1 V L	
1 EA	RIM HOUSING	20-079	626	SCH						
	FSIC PERM. CORE	23-030 EV29 T	626 OBC	SCH		RDWARE SET: 10 DR NUMBER: 111.1 113.1 115.1 133	3.1			
	FSIC CONSTR. CORE SURFACE CLOSER	23-030 ICX 4040XP SCUSH	ORG 689	SCH LCN		OR NUMBER: 111.1 113.1 115.1 133 CH TO HAVE:	%. I			
2 EA	CUSH SHOE SUPPORT	4040XP-30 SRT	689	LCN	QTY	DESCRIPTION	CATALOG NUMBER	FINISH	MFR	
2 EA	BLADE STOP SPACER	4040XP-61 SRT	689	LCN		A HINGE	5BB1HW	652 626	IVE SCH	
	MULLION SEAL DOOR SWEEP	8780NBK PSA 8198AA	BK AA	ZER ZER	1 EA	OFFICE W/SIM RETRACT W/ OUTSIDE INDICATOR	F90901 00W F909-309 (Q2-OCC	020	SCH	
	THRESHOLD	103A-223	AA	ZER		A FSIC PERM. CORE	23-030 EV29 T	626	SCH	
4 EA	WIRE HARNESS	CON X LENGTH REQ'D		SCH		A SURFACE CLOSER A KICK PLATE	4040XP RW/PA 8400 10" X 2" LDW B-CS	689 630	LCN IVE	
	DOOR CONTACT POWER SUPPLY	7764 BY SECURITY SYSTEM INTEGRATOR	628	SCE B/O		A WALL STOP	WS406/407CCV	630	IVE	
	DOOR CALL STATION	BY SECURITY SYSTEM INTEGRATOR BY SECURITY SYSTEM INTEGRATOR		D/O	1 E/		488SBK PSA	BK	ZER	
1 EA	CARD READER	BY SECURITY SYSTEM INTEGRATOR				ADWARE OFT 11				
	WEATHERSTRIP	BY DOOR/FRAME MANUFACTURER		B/O		RDWARE SET: 11 DR NUMBER: 131.1 132.1 135.1				
	WIRING DIAGRAM TION: DOOR NORMALLY CLOS	BY SECURITY SYSTEM INTEGRATOR SED AND LOCKED. ACCESS VIA VALID CAF	D READ PA	ANIC		CH TO HAVE:				
MAY BE	DOGGED (MADE PUSH/PULL) ELECTRONICALLY. OUTSIDE ADA ACTUA	TOR ONLY			DESCRIPTION	CATALOG NUMBER	FINISH	MFR	
		OR AFTER VALID CARD READ, INSIDE AC	TUATOR AL	WAYS		A CONT. HINGE A CLASSROOM SEC W/DB	224XY L9457J 06A	628 626	IVE SCH	
OPERAL	BLE. ALWAYS FREE EGRESS.					A FSIC PERM. CORE	23-030 EV29 T	626	SCH	
HARDW	ARE SET: 03					SURFACE CLOSER	4040XP RW/PA	689	LCN	
	NUMBER: 129.2					A KICK PLATE A WALL STOP	8400 10" X 2" LDW B-CS WS406/407CCV	630 630	IVE IVE	
EACH TO QTY	O HAVE: DESCRIPTION	CATALOG NUMBER	FINISH	MFR		A SILENCER	SR64	GRY	IVE	
	HINGE	5BB1HW NRP	630	IVE				• • • • • • • • • • • • • • • • • • • •		
1 EA	PANIC HARDWARE	98-EO	626	VON		RDWARE SET: 12				
	ACCESSORY	LESS DOGGING PLATE	626 689	VON		OR NUMBER: 134.1 :H TO HAVE:				
	SURFACE CLOSER KICK PLATE	4040XP SCUSH 8400 10" X 2" LDW B-CS	630	LCN IVE		DESCRIPTION	CATALOG NUMBER	FINISH	MFR	
	RAIN DRIP	142AA	AA	ZER		A HINGE	5BB1HW	652	IVE	
	GASKETING	429AA-S	AA	ZER		A PASSAGE SET A WALL STOP	ND10S RHO WS406/407CCV	626 630	SCH IVE	
	DOOR SWEEP THRESHOLD	8197AA 103A-223	AA A	ZER ZER		A SILENCER	SR64	GRY	IVE	
	DOOR CONTACT	679-05 HM/WD AS REQ'D	BLK	SCE						
1 EA	MOTION SENSOR	SCANII 12/24 VDC	WHT	SCE		RDWARE SET: 13				
	WIRING DIAGRAM TION: DOOR CONTACT MONIT	BY SECURITY SYSTEM INTEGRATOR				OR NUMBER: 100.1 100.2 127.1 127 :H TO HAVE:	.2			
		FRAME HEAD FIRST, THEN INSTALL CLOSE	R PA BRAC	KET ON	QTY	DESCRIPTION	CATALOG NUMBER	FINISH	MFR	
	ERSTRIP.	,				MORTISE HOUSING	26-064	626	SCH	
	ADE SET: 04					A FSIC PERM. CORE A LOCAL CONTROL SWITCH	23-030 EV29 T BY DOOR MANUFACTURER	626	SCH	
	'ARE SET: 04 IUMBER: 200.1				NOT	E: BALANCE OF HARDWARE BY I	DOOR SYSTEM MANUFACTURER. VERIFY	CYLINDER		
EACH TO	O HAVE:		_		TYP	E/QUANTITY REQUIRED WITH DO	OOR MANUFACTURER.			
	DESCRIPTION	CATALOG NUMBER	FINISH	MFR	ЦЛС	RDWARE SET: 14				
	HINGE POWER TRANSFER	5BB1HW EPT10 CON	652 689	IVE VON		DR NUMBER: 118.1				
	EU STOREROOM LOCK	ND80P6DEU RHO RX CON 12V/24V DC	626	SCH	EAC	CH TO HAVE:				
1 EA	SURFACE CLOSER	4040XP RW/PA	689	LCN		DESCRIPTION	CATALOG NUMBER	FINISH		
	KICK PLATE	8400 10" X 2" LDW B-CS	630	IVE	4 E <i>F</i> 1 E <i>F</i>		5BB1HW B663P6	652 626	IVE SCH	
	WALL STOP GASKETING	WS406/407CCV 488SBK PSA	630 BK	IVE ZER	1 EA	A PUSH PLATE	8200 6" X 16"	630	IVE	
1 EA	DOOR SWEEP	39A	A	ZER	1 EA	A PULL PLATE	8303 8" 6" X 16"	630	IVE	
		655A-223	Α	ZER	1 E <i>F</i> 1 E <i>F</i>		4040XP RW/PA 8400 10" X 2" LDW B-CS	689 630	LCN IVE	
	THRESHOLD		D1 17		ı ⊏ <i>F</i>		0+00 10 AZ LDVV D-C3	บอบ	IVE	
	THRESHOLD DOOR CONTACT	679-05 HM/WD AS REQ'D	BLK	SCE B/O		WALL STOP	WS406/407CCV		1 V L	
	THRESHOLD		BLK	B/O	1 EA 1 EA		WS406/407CCV 488SBK PSA	630 BK	ZER	
	THRESHOLD DOOR CONTACT POWER SUPPLY CARD READER ARE SET: 05	679-05 HM/WD AS REQ'D BY SECURITY SYSTEM INTEGRATOR BY SECURITY SYSTEM INTEGRATOR	BLK		1 EA 1 EA HAF	A GASKETING ROWARE SET: 15		630		\
DOOR N	THRESHOLD DOOR CONTACT POWER SUPPLY CARD READER ARE SET: 05 NUMBER: 104.1 108.1 121.1 123	679-05 HM/WD AS REQ'D BY SECURITY SYSTEM INTEGRATOR BY SECURITY SYSTEM INTEGRATOR	BLK		1 EA 1 EA HAF DOO	A GASKETING RDWARE SET: 15 DR NUMBER: 105.1		630		7
DOOR N EACH TO	THRESHOLD DOOR CONTACT POWER SUPPLY CARD READER ARE SET: 05 NUMBER: 104.1 108.1 121.1 123 O HAVE:	679-05 HM/WD AS REQ'D BY SECURITY SYSTEM INTEGRATOR BY SECURITY SYSTEM INTEGRATOR 3.1		В/О	1 EA 1 EA HAF DOO	A GASKETING RDWARE SET: 15 DR NUMBER: 105.1 CH TO HAVE:		630	ZER	7
DOOR N EACH TO QTY	THRESHOLD DOOR CONTACT POWER SUPPLY CARD READER ARE SET: 05 NUMBER: 104.1 108.1 121.1 123	679-05 HM/WD AS REQ'D BY SECURITY SYSTEM INTEGRATOR BY SECURITY SYSTEM INTEGRATOR	BLK FINISH 652		1 EA 1 EA HAF DOO EAC QTY 3 EA	A GASKETING RDWARE SET: 15 OR NUMBER: 105.1 CH TO HAVE: ' DESCRIPTION A HINGE	CATALOG NUMBER 5BB1HW 4.5 X 4.5 NRP	630 BK	MFR IVE	3
DOOR N EACH TO QTY 3 EA 1 EA	THRESHOLD DOOR CONTACT POWER SUPPLY CARD READER ARE SET: 05 NUMBER: 104.1 108.1 121.1 123 O HAVE: DESCRIPTION HINGE POWER TRANSFER	679-05 HM/WD AS REQ'D BY SECURITY SYSTEM INTEGRATOR BY SECURITY SYSTEM INTEGRATOR 3.1 CATALOG NUMBER 5BB1HW 4.5 X 4.5 NRP EPT10 CON	FINISH 652 689	B/O MFR IVE VON	1 EA 1 EA DOO EAO QTY 3 EA 1 EA	A GASKETING RDWARE SET: 15 OR NUMBER: 105.1 CH TO HAVE: OR DESCRIPTION A HINGE A POWER TRANSFER	CATALOG NUMBER 5BB1HW 4.5 X 4.5 NRP EPT10 CON 689	630 BK FINISH 652	MFR IVE VON	>
DOOR N EACH TO QTY 3 EA 1 EA 1 EA	THRESHOLD DOOR CONTACT POWER SUPPLY CARD READER ARE SET: 05 NUMBER: 104.1 108.1 121.1 123 O HAVE: DESCRIPTION HINGE POWER TRANSFER EU STOREROOM LOCK	679-05 HM/WD AS REQ'D BY SECURITY SYSTEM INTEGRATOR BY SECURITY SYSTEM INTEGRATOR 3.1 CATALOG NUMBER 5BB1HW 4.5 X 4.5 NRP EPT10 CON ND80P6DEU RHO RX CON 12V/24V DC	FINISH 652 689 626	B/O MFR IVE VON SCH	HAF DOO EAC QTY 3 EA 1 EA	A GASKETING RDWARE SET: 15 DR NUMBER: 105.1 CH TO HAVE: DESCRIPTION HINGE A POWER TRANSFER ELEC PANIC HARDWARE	CATALOG NUMBER 5BB1HW 4.5 X 4.5 NRP EPT10 CON 689 RX-LC-QEL-98-NL-CON 24 VDC	630 BK FINISH 652 626	MFR IVE VON VON	>
DOOR N EACH TO QTY 3 EA 1 EA 1 EA 1 EA	THRESHOLD DOOR CONTACT POWER SUPPLY CARD READER ARE SET: 05 NUMBER: 104.1 108.1 121.1 123 O HAVE: DESCRIPTION HINGE POWER TRANSFER EU STOREROOM LOCK SURFACE CLOSER	679-05 HM/WD AS REQ'D BY SECURITY SYSTEM INTEGRATOR BY SECURITY SYSTEM INTEGRATOR 3.1 CATALOG NUMBER 5BB1HW 4.5 X 4.5 NRP EPT10 CON ND80P6DEU RHO RX CON 12V/24V DC 4040XP RW/PA	FINISH 652 689 626 689	B/O MFR IVE VON SCH LCN	1 EA 1 EA DOO EAO QTY 3 EA 1 EA	A GASKETING RDWARE SET: 15 DR NUMBER: 105.1 CH TO HAVE: DESCRIPTION A HINGE A POWER TRANSFER A ELEC PANIC HARDWARE A RIM HOUSING	CATALOG NUMBER 5BB1HW 4.5 X 4.5 NRP EPT10 CON 689	630 BK FINISH 652	MFR IVE VON	>
DOOR N EACH TO QTY 3 EA 1 EA 1 EA 1 EA	THRESHOLD DOOR CONTACT POWER SUPPLY CARD READER ARE SET: 05 NUMBER: 104.1 108.1 121.1 123 O HAVE: DESCRIPTION HINGE POWER TRANSFER EU STOREROOM LOCK	679-05 HM/WD AS REQ'D BY SECURITY SYSTEM INTEGRATOR BY SECURITY SYSTEM INTEGRATOR 3.1 CATALOG NUMBER 5BB1HW 4.5 X 4.5 NRP EPT10 CON ND80P6DEU RHO RX CON 12V/24V DC	FINISH 652 689 626	B/O MFR IVE VON SCH	1 EA 1 EA DOO EAO QTY 3 EA 1 EA 1 EA 1 EA 1 EA	A GASKETING RDWARE SET: 15 DR NUMBER: 105.1 CH TO HAVE: DESCRIPTION A HINGE A POWER TRANSFER A ELEC PANIC HARDWARE A RIM HOUSING A FSIC PERM. CORE A SURFACE CLOSER	CATALOG NUMBER 5BB1HW 4.5 X 4.5 NRP EPT10 CON689 RX-LC-QEL-98-NL-CON 24 VDC 20-079 23-030 EV29 T 4040XP SCUSH	630 BK FINISH 652 626 626 626 626 689	MFR IVE VON VON SCH SCH LCN	>
DOOR N EACH TO QTY 3 EA 1 EA 1 EA 1 EA 1 EA 1 EA	THRESHOLD DOOR CONTACT POWER SUPPLY CARD READER ARE SET: 05 JUMBER: 104.1 108.1 121.1 123 O HAVE: DESCRIPTION HINGE POWER TRANSFER EU STOREROOM LOCK SURFACE CLOSER KICK PLATE FLOOR STOP WALL STOP	679-05 HM/WD AS REQ'D BY SECURITY SYSTEM INTEGRATOR BY SECURITY SYSTEM INTEGRATOR 3.1 CATALOG NUMBER 5BB1HW 4.5 X 4.5 NRP EPT10 CON ND80P6DEU RHO RX CON 12V/24V DC 4040XP RW/PA 8400 10" X 2" LDW B-CS FS410 (AT 123.1 ONLY) WS406/407CCV	FINISH 652 689 626 689 630 626 630	B/O MFR IVE VON SCH LCN IVE IVE IVE	1 EA 1 EA DOO EAO QTY 3 EA 1 EA 1 EA 1 EA 1 EA	A GASKETING RDWARE SET: 15 DR NUMBER: 105.1 CH TO HAVE: DESCRIPTION A HINGE A POWER TRANSFER A ELEC PANIC HARDWARE A RIM HOUSING A FSIC PERM. CORE A SURFACE CLOSER A KICK PLATE	488SBK PSA CATALOG NUMBER 5BB1HW 4.5 X 4.5 NRP EPT10 CON689 RX-LC-QEL-98-NL-CON 24 VDC 20-079 23-030 EV29 T 4040XP SCUSH 8400 10" X 2" LDW B-CS	630 BK FINISH 652 626 626 626 626 689 630	MFR IVE VON VON SCH SCH LCN IVE	7
DOOR N EACH TO QTY 3 EA 1 EA 1 EA 1 EA 1 EA 1 EA 1 EA	THRESHOLD DOOR CONTACT POWER SUPPLY CARD READER ARE SET: 05 JUMBER: 104.1 108.1 121.1 123 O HAVE: DESCRIPTION HINGE POWER TRANSFER EU STOREROOM LOCK SURFACE CLOSER KICK PLATE FLOOR STOP WALL STOP GASKETING	679-05 HM/WD AS REQ'D BY SECURITY SYSTEM INTEGRATOR BY SECURITY SYSTEM INTEGRATOR 3.1 CATALOG NUMBER 5BB1HW 4.5 X 4.5 NRP EPT10 CON ND80P6DEU RHO RX CON 12V/24V DC 4040XP RW/PA 8400 10" X 2" LDW B-CS FS410 (AT 123.1 ONLY) WS406/407CCV 488SBK PSA	FINISH 652 689 626 689 630 626 630 BK	B/O MFR IVE VON SCH LCN IVE IVE IVE IVE ZER	1 EA 1 EA DOO EAC QTY 3 EA 1 EA 1 EA 1 EA 1 EA 1 EA	A GASKETING RDWARE SET: 15 DR NUMBER: 105.1 CH TO HAVE: DESCRIPTION A HINGE A POWER TRANSFER A ELEC PANIC HARDWARE A RIM HOUSING A FSIC PERM. CORE A SURFACE CLOSER A KICK PLATE A WALL STOP	488SBK PSA CATALOG NUMBER 5BB1HW 4.5 X 4.5 NRP EPT10 CON689 RX-LC-QEL-98-NL-CON 24 VDC 20-079 23-030 EV29 T 4040XP SCUSH 8400 10" X 2" LDW B-CS WS406/407CCV	630 BK FINISH 652 626 626 626 626 630 630	MFR IVE VON VON SCH SCH LCN IVE IVE	7
DOOR N EACH TO QTY 3 EA 1 EA 1 EA 1 EA 1 EA 1 EA 1 EA	THRESHOLD DOOR CONTACT POWER SUPPLY CARD READER ARE SET: 05 JUMBER: 104.1 108.1 121.1 123 O HAVE: DESCRIPTION HINGE POWER TRANSFER EU STOREROOM LOCK SURFACE CLOSER KICK PLATE FLOOR STOP WALL STOP GASKETING DOOR CONTACT	679-05 HM/WD AS REQ'D BY SECURITY SYSTEM INTEGRATOR BY SECURITY SYSTEM INTEGRATOR 3.1 CATALOG NUMBER 5BB1HW 4.5 X 4.5 NRP EPT10 CON ND80P6DEU RHO RX CON 12V/24V DC 4040XP RW/PA 8400 10" X 2" LDW B-CS FS410 (AT 123.1 ONLY) WS406/407CCV 488SBK PSA 679-05 HM/WD AS REQ'D	FINISH 652 689 626 689 630 626 630	B/O MFR IVE VON SCH LCN IVE IVE IVE ZER SCE	1 EA 1 EA DOO EAO QTY 3 EA 1 EA 1 EA 1 EA 1 EA	A GASKETING RDWARE SET: 15 DR NUMBER: 105.1 CH TO HAVE: DESCRIPTION A HINGE A POWER TRANSFER A ELEC PANIC HARDWARE A RIM HOUSING A FSIC PERM. CORE A SURFACE CLOSER A KICK PLATE A WALL STOP A GASKETING	488SBK PSA CATALOG NUMBER 5BB1HW 4.5 X 4.5 NRP EPT10 CON689 RX-LC-QEL-98-NL-CON 24 VDC 20-079 23-030 EV29 T 4040XP SCUSH 8400 10" X 2" LDW B-CS	630 BK FINISH 652 626 626 626 626 630 630 BK	MFR IVE VON VON SCH LCN IVE IVE ZER SCH	
DOOR N EACH TO QTY 3 EA 1 EA 1 EA 1 EA 1 EA 1 EA 1 EA 1 EA	THRESHOLD DOOR CONTACT POWER SUPPLY CARD READER ARE SET: 05 JUMBER: 104.1 108.1 121.1 123 O HAVE: DESCRIPTION HINGE POWER TRANSFER EU STOREROOM LOCK SURFACE CLOSER KICK PLATE FLOOR STOP WALL STOP GASKETING	679-05 HM/WD AS REQ'D BY SECURITY SYSTEM INTEGRATOR BY SECURITY SYSTEM INTEGRATOR 3.1 CATALOG NUMBER 5BB1HW 4.5 X 4.5 NRP EPT10 CON ND80P6DEU RHO RX CON 12V/24V DC 4040XP RW/PA 8400 10" X 2" LDW B-CS FS410 (AT 123.1 ONLY) WS406/407CCV 488SBK PSA	FINISH 652 689 626 689 630 626 630 BK	B/O MFR IVE VON SCH LCN IVE IVE IVE IVE ZER	1 EA 1 EA DOO EAC QTY 3 EA 1 EA 1 EA 1 EA 1 EA 1 EA 1 EA 1 EA 1	A GASKETING RDWARE SET: 15 DR NUMBER: 105.1 CH TO HAVE: DESCRIPTION HINGE A POWER TRANSFER A ELEC PANIC HARDWARE A RIM HOUSING A FSIC PERM. CORE A SURFACE CLOSER A KICK PLATE A WALL STOP A GASKETING WIRE HARNESS DOOR CONTACT	CATALOG NUMBER 5BB1HW 4.5 X 4.5 NRP EPT10 CON 689 RX-LC-QEL-98-NL-CON 24 VDC 20-079 23-030 EV29 T 4040XP SCUSH 8400 10" X 2" LDW B-CS WS406/407CCV 488SBK PSA CON X LENGTH REQ'D 679-05 HM/WD AS REQ'D	630 BK FINISH 652 626 626 626 626 630 630	MFR IVE VON SCH SCH LCN IVE IVE ZER SCH SCE	
DOOR NEACH TO QTY 3 EA 1 EA 1 EA 1 EA 1 EA 1 EA 1 EA 1 EA 1	THRESHOLD DOOR CONTACT POWER SUPPLY CARD READER ARE SET: 05 JUMBER: 104.1 108.1 121.1 123 O HAVE: DESCRIPTION HINGE POWER TRANSFER EU STOREROOM LOCK SURFACE CLOSER KICK PLATE FLOOR STOP WALL STOP GASKETING DOOR CONTACT POWER SUPPLY	679-05 HM/WD AS REQ'D BY SECURITY SYSTEM INTEGRATOR BY SECURITY SYSTEM INTEGRATOR 3.1 CATALOG NUMBER 5BB1HW 4.5 X 4.5 NRP EPT10 CON ND80P6DEU RHO RX CON 12V/24V DC 4040XP RW/PA 8400 10" X 2" LDW B-CS FS410 (AT 123.1 ONLY) WS406/407CCV 488SBK PSA 679-05 HM/WD AS REQ'D BY SECURITY SYSTEM INTEGRATOR	FINISH 652 689 626 689 630 626 630 BK	B/O MFR IVE VON SCH LCN IVE IVE IVE ZER SCE	1 EA 1 EA DOO EAC QTY 3 EA 1 EA 1 EA 1 EA 1 EA 1 EA 2 EA	A GASKETING RDWARE SET: 15 DR NUMBER: 105.1 CH TO HAVE: DESCRIPTION HINGE A POWER TRANSFER A ELEC PANIC HARDWARE A RIM HOUSING A FSIC PERM. CORE A SURFACE CLOSER A KICK PLATE A WALL STOP A GASKETING WIRE HARNESS A DOOR CONTACT POWER SUPPLY	CATALOG NUMBER 5BB1HW 4.5 X 4.5 NRP EPT10 CON 689 RX-LC-QEL-98-NL-CON 24 VDC 20-079 23-030 EV29 T 4040XP SCUSH 8400 10" X 2" LDW B-CS WS406/407CCV 488SBK PSA CON X LENGTH REQ'D	630 BK FINISH 652 626 626 626 626 630 630 BK	MFR IVE VON VON SCH LCN IVE IVE ZER SCH	

FINISH 652

IVE VON IVE SCH

GLY LCN IVE ZER ZER

SCE B/O

CATALOG NUMBER

ND80P6DEU RHO RX CON 12V/24V DC

8400 10" X 1" LDW B-CS 488SBK PSA (AT RATED DOORS)

679-05 HM/WD AS REQ'D BY SECURITY SYSTEM INTEGRATOR

BY SECURITY SYSTEM INTEGRATOR

5BB1HW

EPT10 CON FB51T

90S 4040XP RW/PA

OPERATION: DOOR NORMALLY CLOSED AND LOCKED. ACCESS VIA VALID CARD READ. ALWAYS

HARDWARE SET: 01

6 EA HINGE

DOOR NUMBER: 107.1 EACH TO HAVE: QTY DESCRIPTION

1 EA POWER TRANSFER 1 EA CONST LATCHING BOLT

1 EA EU STOREROOM LOCK

2 EA OH STOP 2 EA SURFACE CLOSER

1 EA KICK PLATE 1 EA GASKETING

1 EA MEETING STILE

1 EA CARD READER

FREE EGRESS.

2 EA DOOR CONTACT 1 EA POWER SUPPLY

							D	OOR S	CHEDU	LE				
				PANEL	FRAN	ЛE			DET	AIL				
MARK	WIE LEAF 1	DTH LEAF 2	HEIGHT	TYPE	PANEL NOTE TYPE	HEAD HEIGHT	FIRE RATING	HARDWARE SET	HEAD	JAMB	COMMENTS	Throat By Wall Size	Throat Depth Actual	Throat Depth Manual
	1	-			-									
100.1	3' - 4"		8' - 0"	-		0' - 8"		13	7/A-506	8/A-506				
100.2	3' - 4"		8' - 0"	-		0' - 8"		13	7/A-506	8/A-506				
103.1	3' - 0"		8' - 0"	P00WD	FCW00AL	0' - 0"		09	13/A-506	14/A-506				
104.1	3' - 0"		8' - 0"	P00HM	F00HM	0' - 2"		05	9/A-506	10/A-506		Yes	0' - 4 7/8"	0' - 5 3/4"
105.1	4' - 0"		8' - 0"	P00HM	F00HM	0' - 2"		A 15	9/A-506	10/A-506		Yes	0' - 4 7/8"	0' - 5 3/4"
106.1	3' - 0"	3' - 0"	8' - 0"	P30AL	FCW00AL	0' - 0"			5/A-506 SIM.	16/A-506				
107.1	3' - 0"	3' - 0"	8' - 0"	P00HM	F00HM	0' - 2"		06	9/A-506	10/A-506		Yes	0' - 4 7/8"	0' - 5 3/4"
108.1	3' - 0"		8' - 0"	P00WD	F00HM	0' - 2"		05	9/A-506	10/A-506		Yes	0' - 4 7/8"	0' - 5 3/4"
108.2	3' - 0"		8' - 0"	P00WD	F25HM	0' - 2"		08	9/A-506	10/A-506	PASSAGE DOOR, NO LOCK	Yes	0' - 4 7/8"	0' - 5 3/4"
109.1	3' - 0"		8' - 0"	P00WD	F00HM	0' - 2"		07	9/A-506	10/A-506		Yes	0' - 4 7/8"	0' - 5 3/4"
111.1	3' - 0"		8' - 0"	P00WD	F00HM	0' - 2"		10	9/A-506	10/A-506		Yes	0' - 4 7/8"	0' - 5 3/4"
113.1	3' - 0"		8' - 0"	P00WD	F00HM	0' - 2"		10	9/A-506	10/A-506		Yes	0' - 4 7/8"	0' - 5 3/4"
114.1	3' - 0"		8' - 0"	P00WD	F25HM	0' - 2"		09	9/A-506	10/A-506			0' - 4 7/8"	0' - 5 3/4"
115.1	3' - 0"		8' - 0"	P00WD	F00HM	0' - 2"		10	9/A-506	10/A-506		Yes	0' - 4 7/8"	0' - 5 3/4"
116.1	3' - 0"		8' - 0"	P00WD	F25HM	0' - 2"		09	9/A-506	10/A-506		Yes	0' - 4 7/8"	0' - 5 3/4"
117.1	3' - 0"		8' - 0"	P00WD	F25HM	0' - 2"		09	9/A-506	10/A-506		Yes	0' - 4 7/8"	0' - 5 3/4"
118.1	3' - 0"		8' - 0"	P00WD	F00HM	0' - 2"		14	9/A-506	10/A-506		Yes	0' - 4 7/8"	0' - 5 3/4"
119.1	3' - 0"		8' - 0"	P00WD	F25HM	0' - 2"		09	9/A-506	10/A-506		Yes	0' - 4 7/8"	0' - 5 3/4"
119.2	3' - 0"		8' - 0"	P30AL	FCW00AL	0' - 0"		01	5/A-506	6/A506				
121.1	3' - 0"		8' - 0"	P00WD	F00HM	0' - 2"		05	9/A-506	10/A-506		Yes	0' - 4 7/8"	0' - 5 3/4"
121.2	3' - 0"		8' - 0"	P30AL	FCW00AL	0' - 0"		01	5/A-506	6/A506				
123.1	3' - 0"		8' - 0"	P00WD	F00HM	0' - 2"		05	9/A-506	10/A-506	CARD READER	Yes	0' - 7 1/4"	0' - 5 3/4"
124.1	4' - 0"		8' - 0"	P00WD	F00HM	0' - 2"		08	9/A-506	10/A-506		Yes	0' - 4 7/8"	0' - 5 3/4"
127.1	3' - 8"		8' - 0"	-		0' - 8"		13	7/A-506	8/A-506				
127.2	3' - 8"		8' - 0"	-		0' - 8"		13	7/A-506	8/A-506				
129.1	3' - 0"		8' - 0"	P00WD	F38HM	0' - 2"		08	9/A-506	10/A-506		Yes	0' - 7 1/4"	0' - 5 3/4"
129.2	3' - 0"		8' - 0"	P30AL	FCW00AL	0' - 0"		03	5/A-506	3/A-502				
129A.1	3' - 0"		8' - 0"	P00WD	F00HM	0' - 2"		10	9/A-506	10/A-506		Yes	0' - 4 7/8"	0' - 5 3/4"
131.1	3' - 0"		7' - 10"	P00WD	F00HM	0' - 2"		11	11/A-506	12/A-506			0' - 5 3/4"	0' - 5 3/4"
131.2	2' - 10"		7' - 10"	P00WD	F00HM	0' - 2"			9/A-506	10/A-506	UNDER CUT 4"	No	0' - 5 3/4"	0' - 5 3/4"
131.3	3' - 0"		7' - 10"	P00WD	F00HM	0' - 2"			9/A-506	10/A-506	UNDER CUT 4"	No	0' - 5 3/4"	0' - 5 3/4"
132.1	3' - 0"		7' - 10"	P00WD	F00HM	0' - 2"		11	11/A-506	12/A-506		No	0' - 5 3/4"	0' - 5 3/4"
132.2	3' - 0"		7' - 10"	P00WD	F00HM	0' - 2"			9/A-506	10/A-506	UNDER CUT 4"		0' - 5 3/4"	0' - 5 3/4"
132.3	2' - 10"		7' - 10"	P00WD	F00HM	0' - 2"			9/A-506	10/A-506	UNDER CUT 4"	No	0' - 5 3/4"	0' - 5 3/4"
132.4	2' - 10"		7' - 10"	P00WD	F00HM	0' - 2"			9/A-506	10/A-506	UNDER CUT 4"	No	0' - 5 3/4"	0' - 5 3/4"
133.1	3' - 0"		7' - 10"	P00WD	F00HM	0' - 2"		10	9/A-506	10/A-506			0' - 4 7/8"	0' - 5 3/4"
134.1	3' - 0"		8' - 0"	P00WD	F00HM	0' - 2"		12	9/A-506	10/A-506		Yes	0' - 6"	0' - 5 3/4"
135.1	3' - 0"		8' - 0"	P00WD	F00HM	0' - 2"		8	9/A-506	10/A-506		Yes	0' - 6"	0' - 5 3/4"
136.1	3' - 0"		8' - 0"	P00WD	F00HM	0' - 2"		08	9/A-506	10/A-506			0' - 4 1/4"	0' - 5 3/4"
200.1	3' - 0"		7' - 0"	P00WD	F00HM	0' - 2"		04	15/A-506	16/A-506		No	0' - 6 3/4"	0' - 6 3/4"

GENERAL NOTES:
1. ALL HM FRAMES ARE TO BE PAINTED, PNT-4

11-25-2024

LEES SUMMIT MUNICIPAL AIRPORT LEES SUMMIT, MO

A	01.03.25	CITY REVIEW COMMENTS
MARK	DATE	DESCRIPTION

PROJECT NO:	2403
REVIT FILE:	2403 Lee's Summit Terminal-R24.rvt
DESIGNED BY:	Designer
DRAWN BY:	EM


CHECKED BY: JSB APPROVED BY: Approver COPYRIGHT 2024


SHEET TITLE


DOOR SCHEDULE & LEGENDS


> A-700 SHEET OF

DOOR PANEL LE	PANEL 1 PANEL 2 WIDTH WIDTH	PANEL 1 WIDTH 5" 5"	PANEL 1 PANEL 2 WIDTH WIDTH
PANEL HEIGHT		PANEL HEIGHT	PANEL HEIGHT
P00 FLUSH DOOR WD = WOOD HM = HOLLOW METAL	P20 DOUBLE FLUSH DOOR WD = WOOD HM = HOLLOW METAL	P30 DOOR WITH FULL LITE AL = ALUMINUM WD = WOOD	P40 DOUBLE DOOR WITH FULL LITE AL = ALUMINUM WD = WOOD

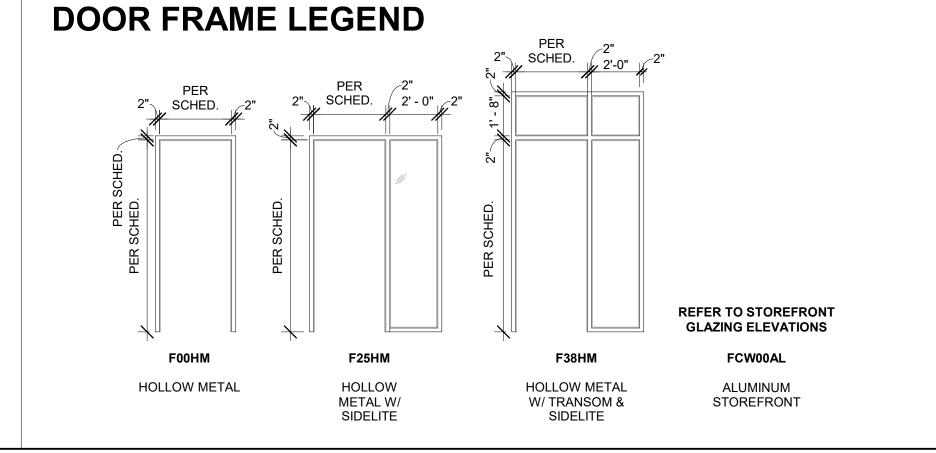

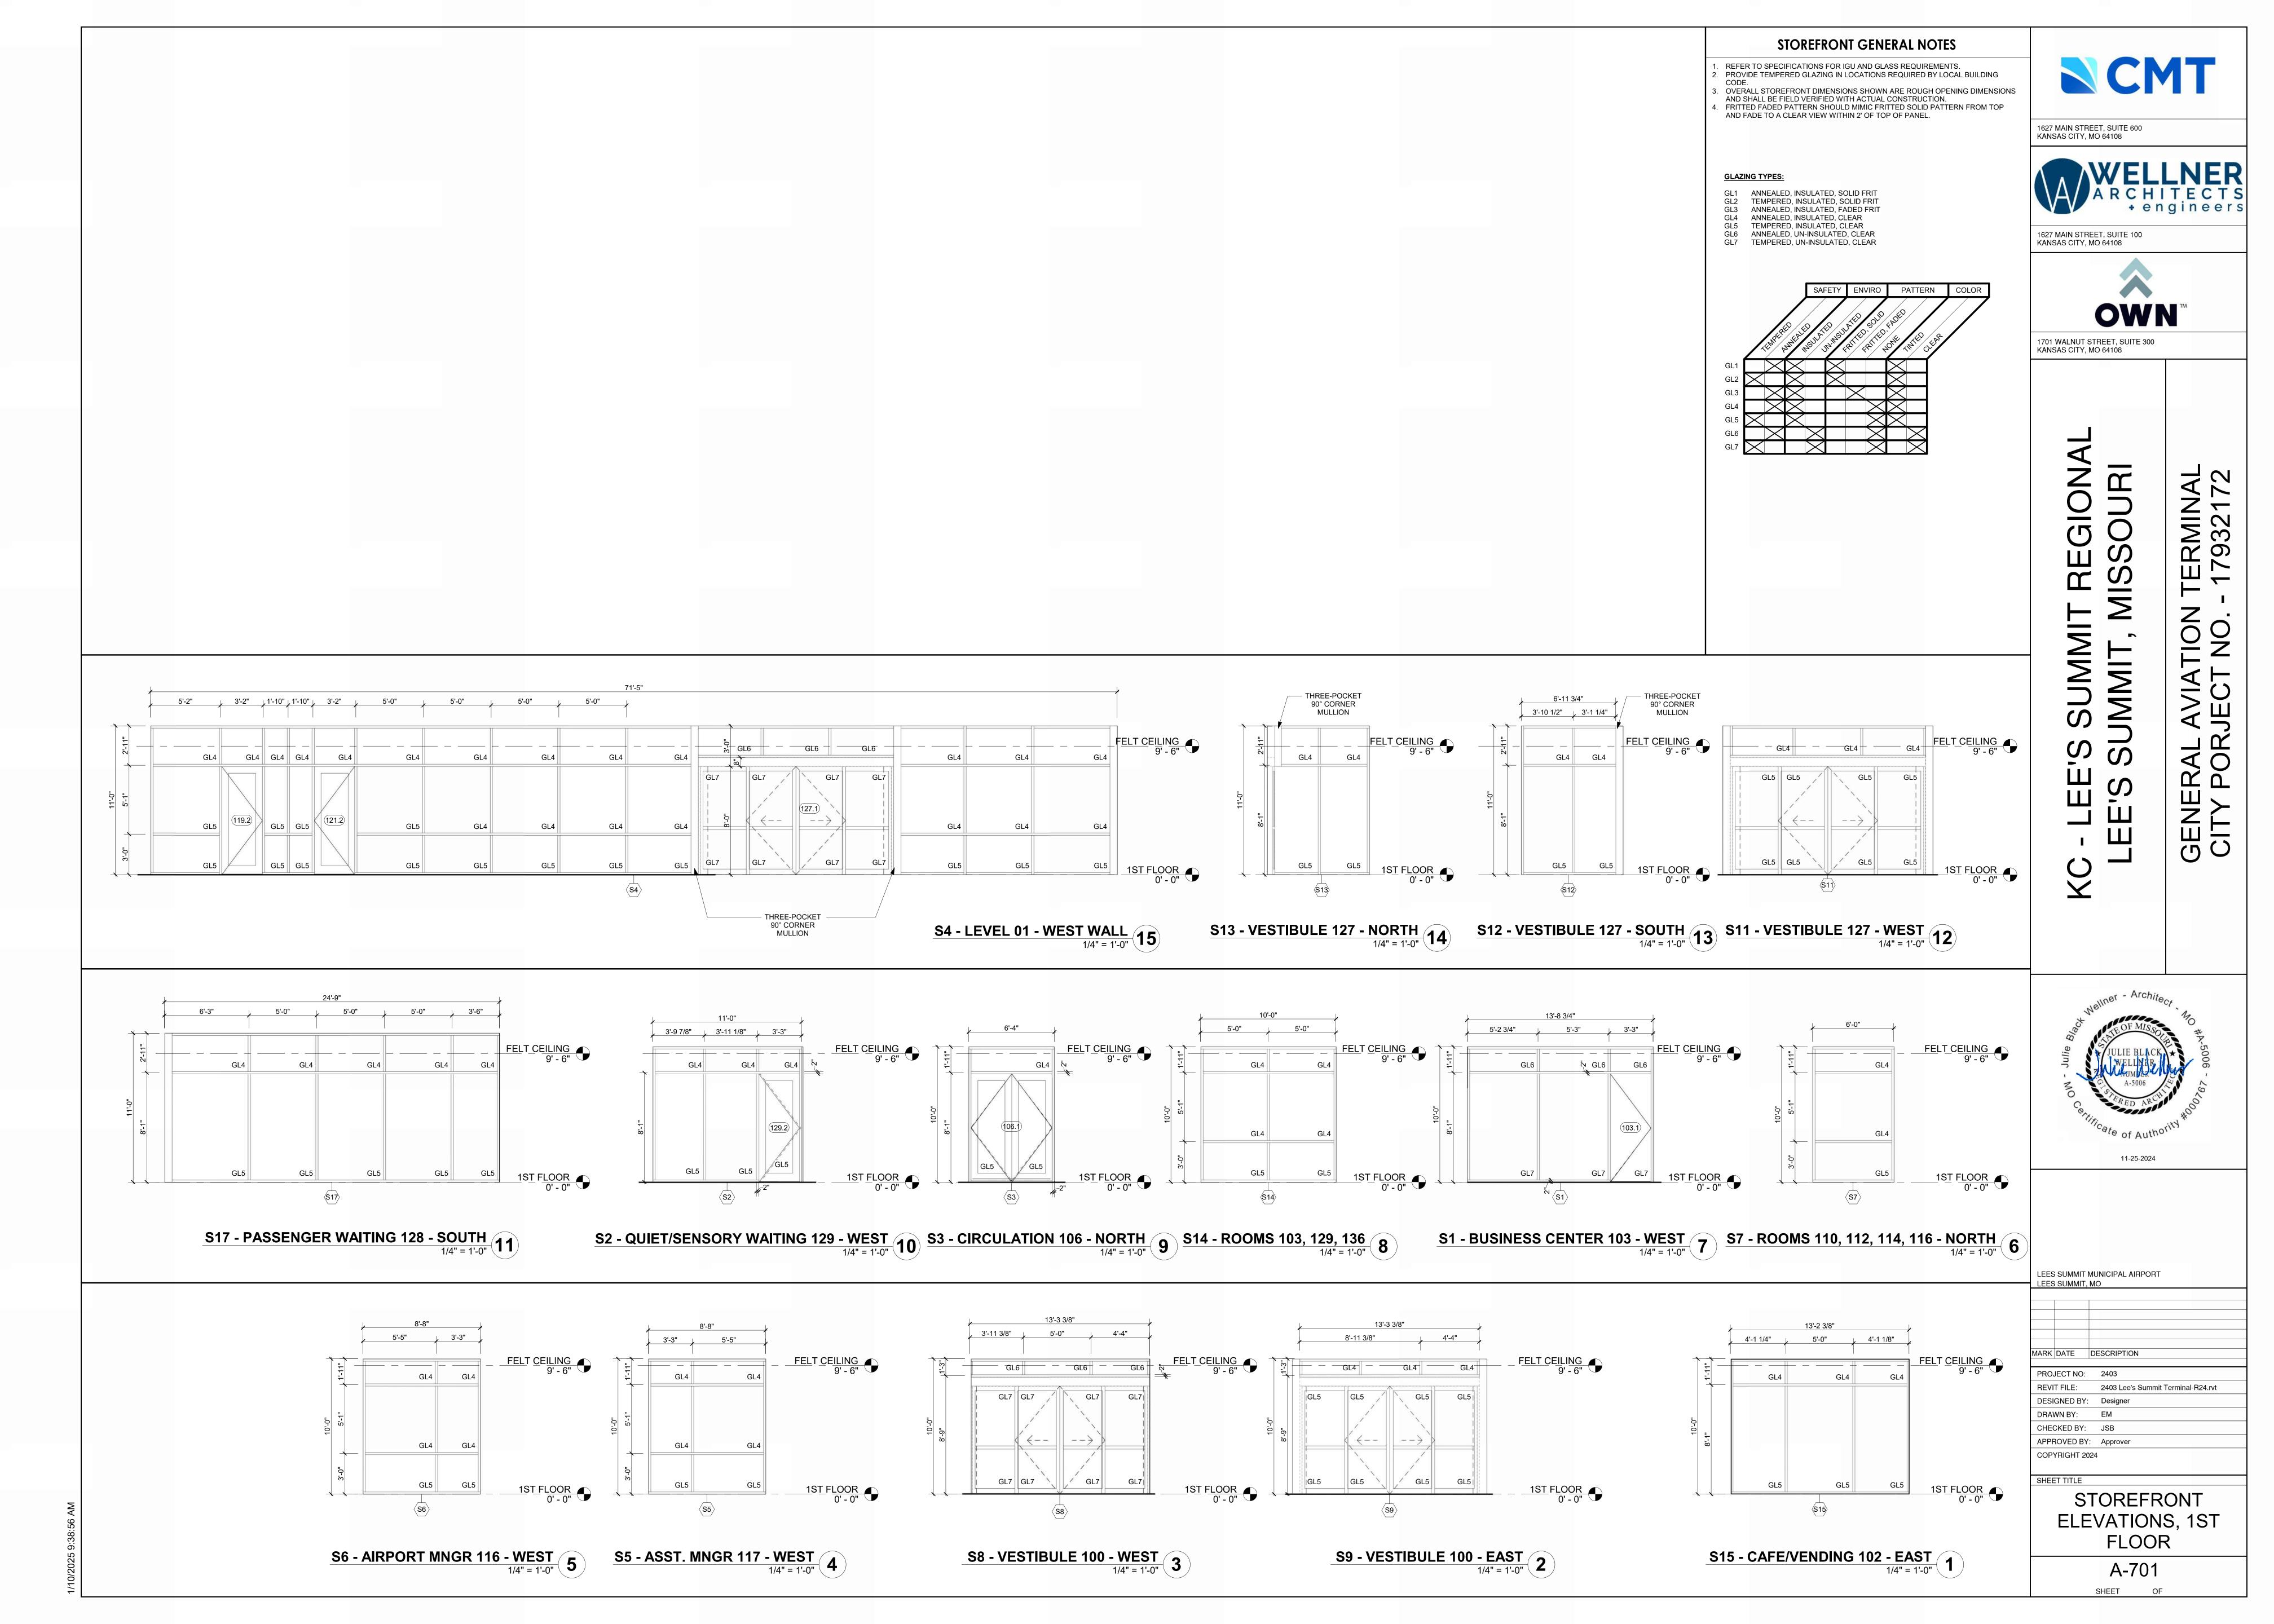

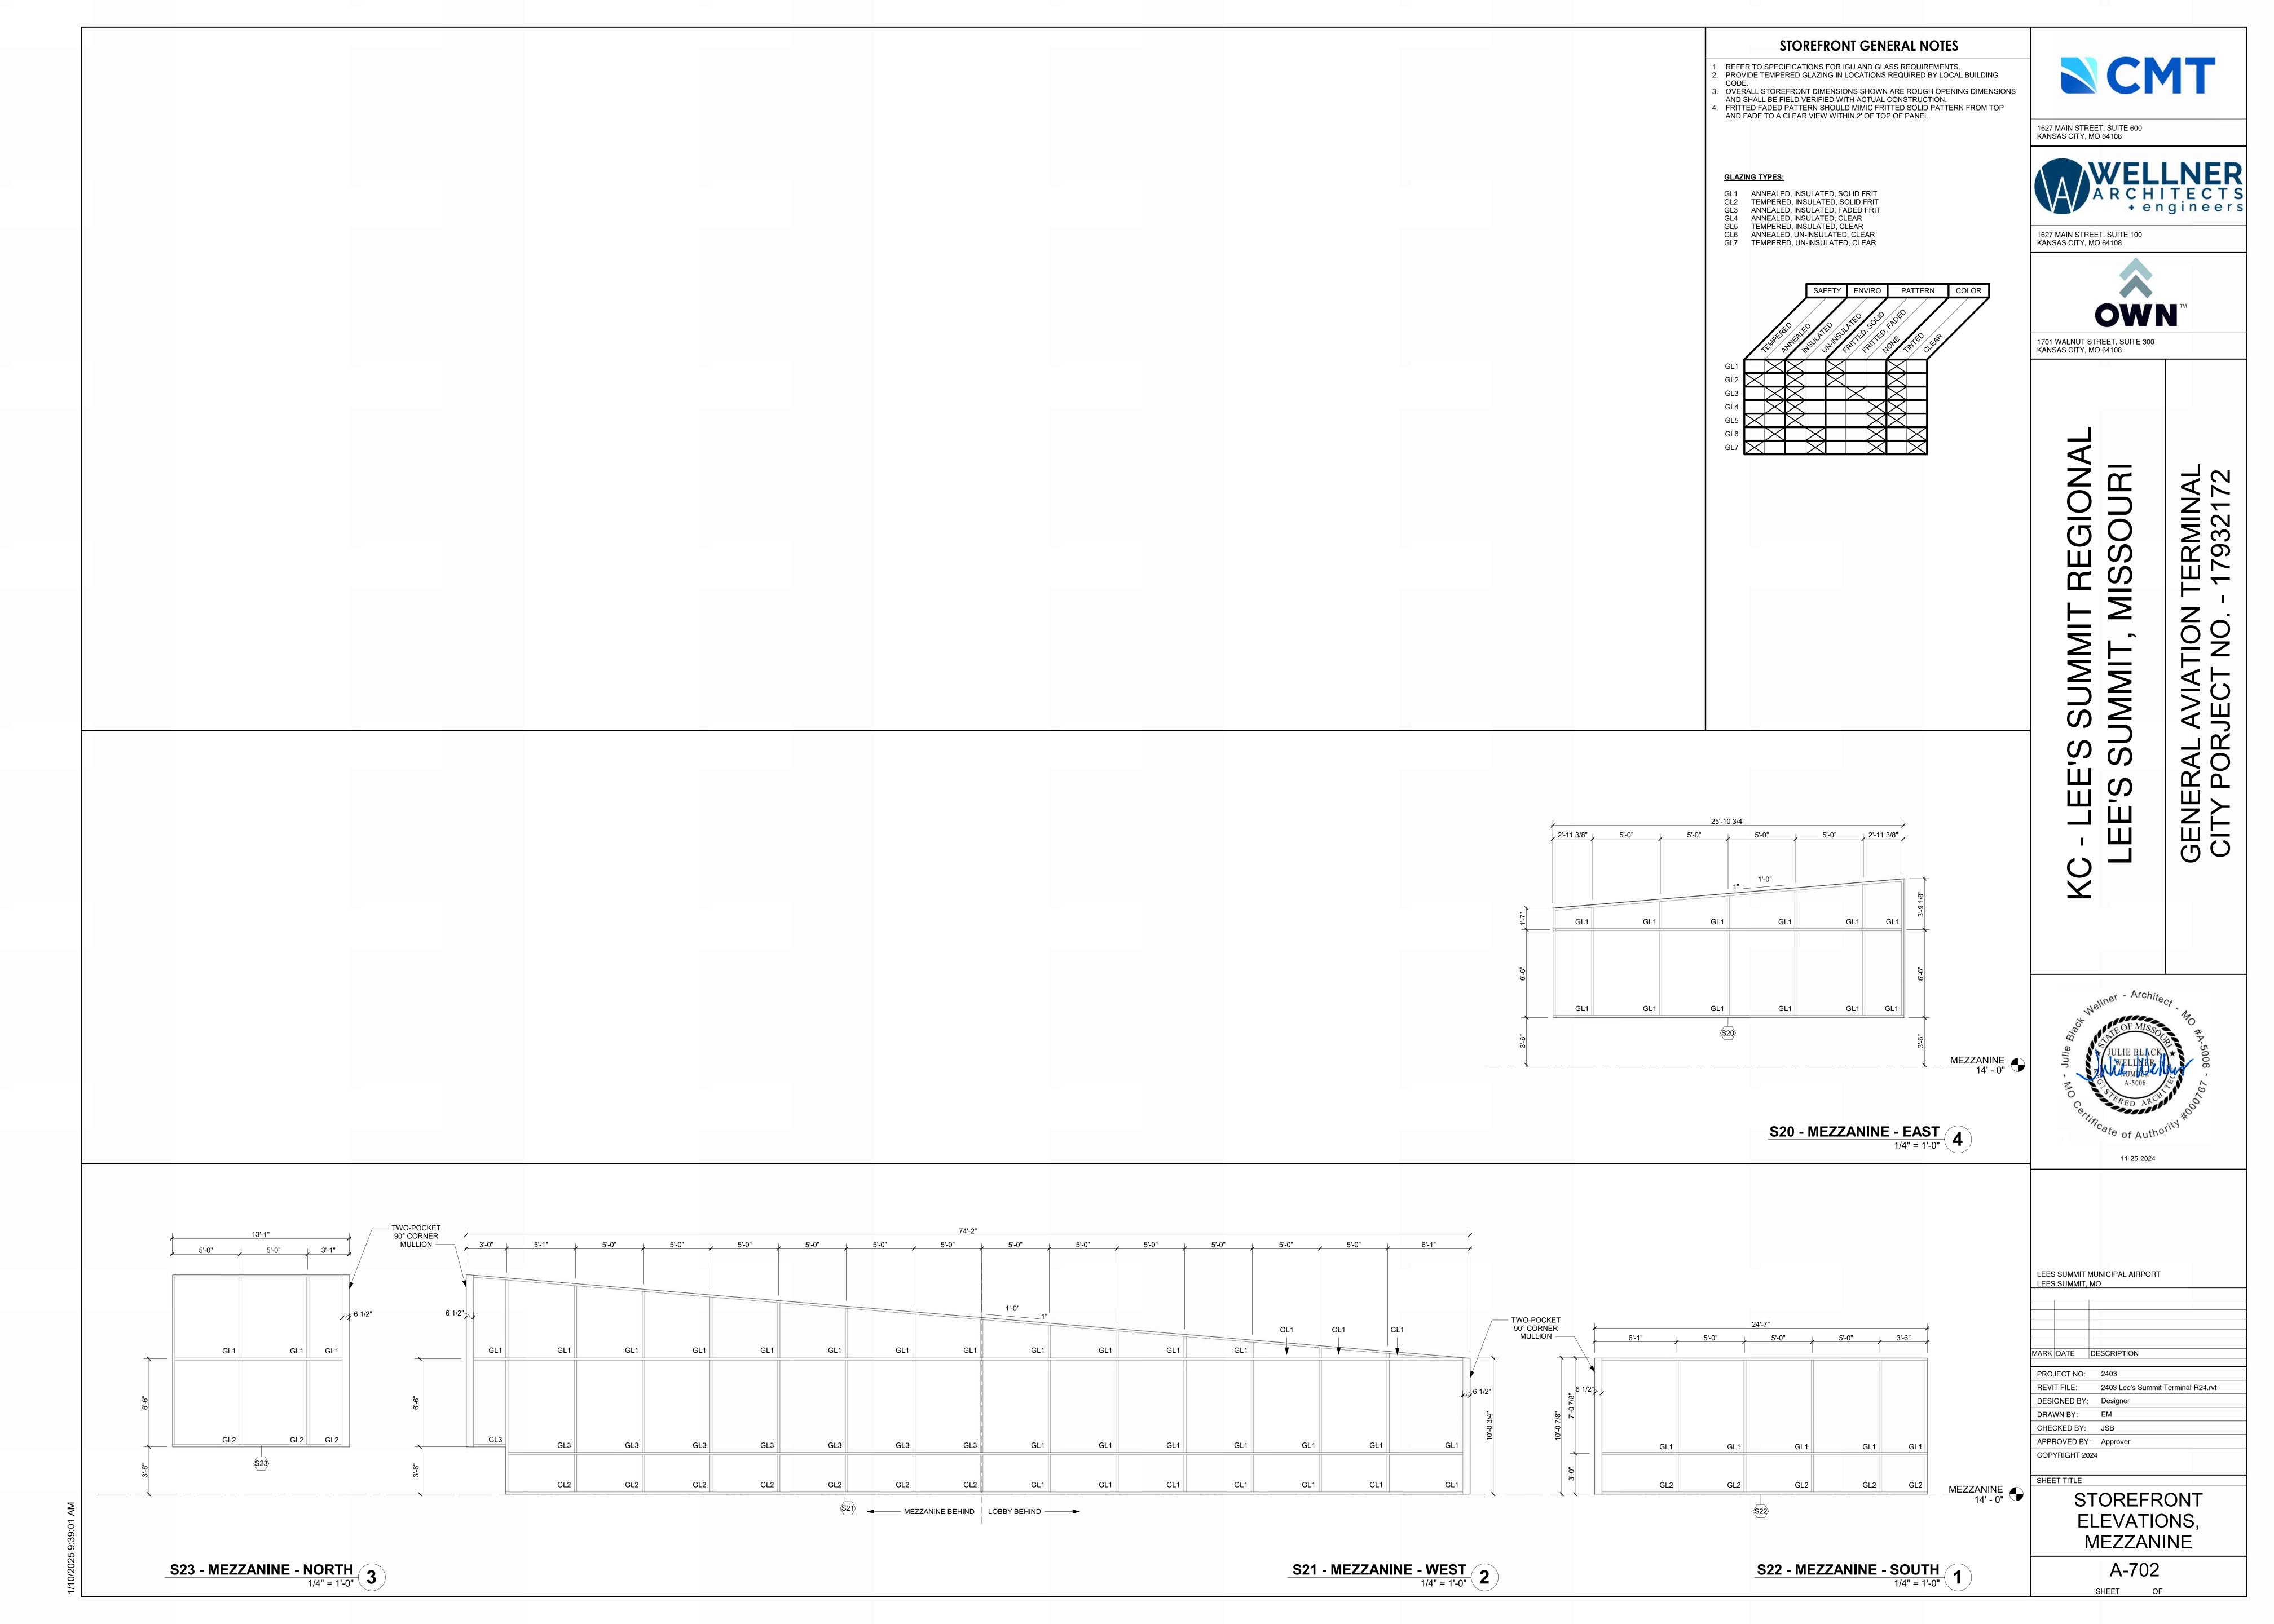

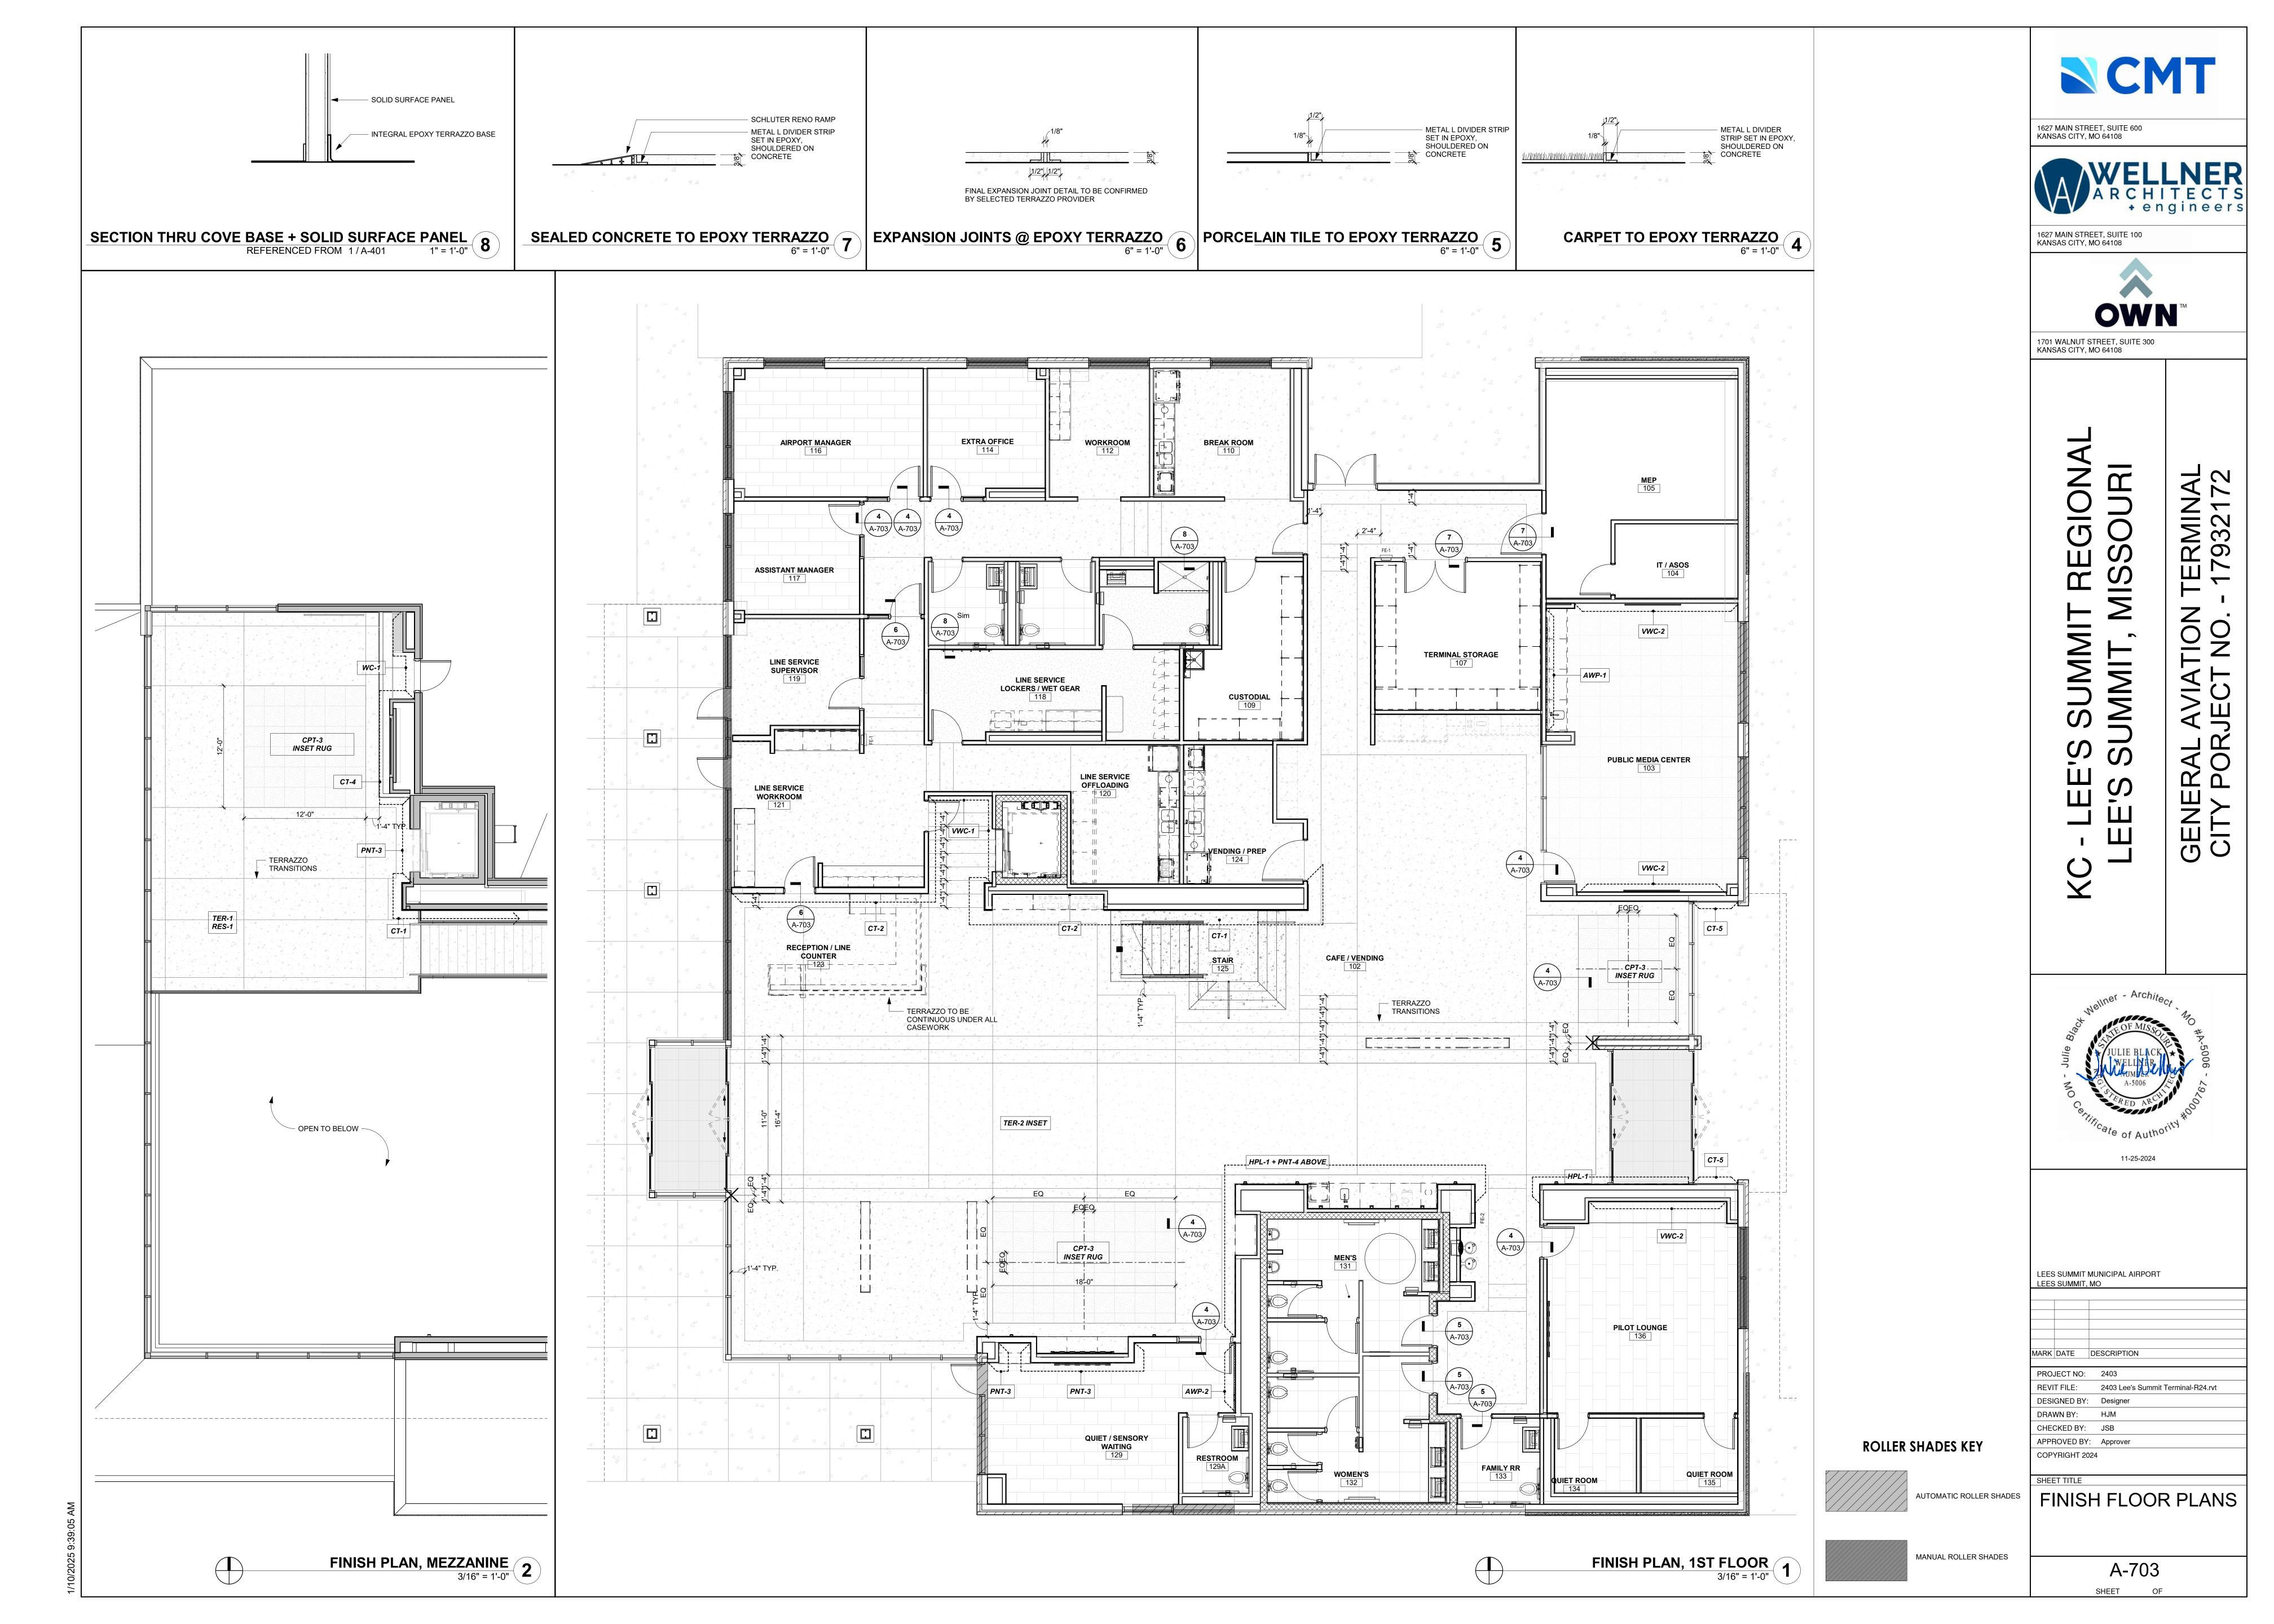

	Appliance Schedule									
MARK	Туре	Manufactuer	Model #/SKU	RM#	QTY	Furnished By	Comments			
AP01	23.3 Cu. Ft. Counter-Depth French Door Refrigerator	Frigidaire Professional	PRFG2383AF	110, 124	2	CP-CI				
AP02	24" W Undercounter Refrigerator	Summit	162-AL54 • MPN: AL54	120	1	CP-CI				
AP03	23 1/2"W Undercounter Refrigerator w/ Glass Door	Summit	162-ALBV2466CSS • MPN: ALBV2466CSS	101A	1	CP-CI				
AP04	Glass Front Refrigerator Reach-in One-section	True	MFG #TS-23G-HC-FGD01	120	3	CP-CI				
AP05	2.2 Cu. Ft. Built-In Microwave	Frigidaire Professional	PMBS3080BF	120, 124	2	CP-CI	Install with Trim Kit			
AP06	1.6 Cu. Ft. 1250Watt Countertop Microwave	Panasonic	NN-SN77HSATH SKU:6580627	110	2	CP-CI				
AP07	30" Electric Range ADA	Frigidaire Professional	PCFE3080AF	124	1	CP-CI				
AP08	Undercabinet Range Hood	Broan	BUEZ130SS	124	1	CP-CI				
AP09	Washer	Speed Queen	TR7003WN	118	1	CP-CI				
AP10	Dryer	Speed Queen	DR7004WE	118	1	CP-CI				
AP11	Dishwasher 24" Stainless Steel ADA	Bosch	SGE78C55UC	110, 124	2	CP-CI				
AP12	30" W Ice Maker	Koolaire	700-KYT0500A161 • MPN: KYT0500A 161	120	1	CP-CI				

Restroom Accessories Schedule							
MARK DESCRIPTION							
RA1	Bobrick B-43944 Semi-Recessed Towel Dispenser & Waste Receptacle						
RA2	ADA Grab Bar Set (18", 36", & 42")						
RA3	Bobrick B-3574 Recessed Toilet Tissue / Seat Cover Dispenser / Waste Disposal, Left Side While Seated						
RA4	Bobrick B-35745 Recessed Toilet Tissue / Seat Cover Dispenser / Waste Disposal, Right Side While Seated						
RA5	Channel-Frame Mirror, Anti-fog						
RA6	Bobrick B-9542 Fino Collection Surface Mounted Coat Hook						
RA7	KB310-SSWM Baby Changing Station Closed Position						
RA8	KB311-SSRE Baby Changing Station Closed Position						
RA9	Bobrick B-370634 25 TrimLine Series Semi-Recessed 50 Cent Napkin-Tampon Vendor						
RA10	Bobrick B-239 Utility Shelf with Rag Hooks and Broom Holders						
RA11	Bobrick B-204-3 Vinyl Shower Curtain with Shower Curtain Hooks, Bright Polished						
RA12	Bobrick B-6047x60 Classic Series Shower Curtain Rod						
RA13	Bobrick B-4288 Contura Series Surface Mounted Multi-roll Toilet Tissue Dispenser						
RA14	Bobrick B-4221 Contura Series Surface Mounted Seat Cover Dispenser						
RA15	RE:Interior Elevations Custom Mirror Anti-fog						
RA16	Glass Mirror with Stainless Steel Angle Frame, Full Height						
RA17	Bobrick B-232 x 24 Hat & Coat Rack w/3 Hooks						

Wall Guard Schedule						
MARK	DESCRIPTION					
CG	Corner Guard					
EG	End Wall Guard					

				Wall Finishes						
ROOM#	ROOM NAME	Floor Finish	Base Finish	North	East	South	West	Ceiling Finis	Notes	
00	VESTIBULE	WOG-1	RES-1	PNT-1	_	HPL-1	_	APC-2		
01	CONCOURSE	TER-1/TER-2	RES-1	PNT-1				APC-2 + APC-4		
01A	COFFEE	-	CWT-3	-	HPL-1	CT-5	HPL-1	HPL-1		
02	CAFE / VENDING	TER-1	RES-1	PNT-1	PNT-1	-	PNT-1	GYP/APC-5 + APC 2		
03	PUBLIC MEDIA CENTER	CPT-2	RES-1	VWC-2	PNT-1	PNT-1	PNT-1	GYP/APC-2		
04	IT / ASOS	SC-1	RES-2	PNT-1	PNT-1	PNT-1	PNT-1	-		
05	MEP	SC-1	RES-2	PNT-1	PNT-1	PNT-1	PNT-1	-		
06	CIRCULATION (PUBLIC)	TER-1	RES-1	-	PNT-1	PNT-1	PNT-3	GYP		
07	TERMINAL STORAGE	SC-1	RES-2	PNT-1	PNT-1	PNT-1	PNT-1	APC-1		
08	CIRCULATION (PRIVATE)	TER-1	RES-1	PNT-2	PNT-2	PNT-2	PNT-2	GYP		
09	CUSTODIAL	SC-1	RES-2	PNT-2	PNT-2	PNT-2	PNT-2	APC-1 1		
10	BREAK ROOM	TER-1	RES-2	PNT-2	PNT-2	PNT-2	PNT-2	APC-1		
11	LINE RESTROOM	EPX-1	EPX-1	PNT-2	PNT-2	PNT-2	PNT-2	GYP 1		
12	WORKROOM	TER-1	RES-2	PNT-2	PNT-2	PNT-2	PNT-2	APC-1		
13	RESTROOM	CT-3	-	CT-2/PNT-1	CT-2/PNT-1	CT-2/PNT-1	CT-2/PNT-1	GYP 1		
14	EXTRA OFFICE	CPT-1	RES-2	PNT-2	PNT-2	PNT-2	PNT-2	APC-1		
15	RESTROOM	CT-3	-	CT-2/PNT-1	CT-2/PNT-1	CT-2/PNT-1	CT-2/PNT-1	GYP		
16	AIRPORT MANAGER	CPT-1	RES-2	PNT-2	PNT-2	PNT-2	PNT-2	APC-1		
17	ASSISTANT MANAGER	CPT-1	RES-2	PNT-2	PNT-2	PNT-2	PNT-2	APC-1		
18	LINE SERVICE LOCKERS / WET GEAR	EPX-1	EPX-1	PNT-2	PNT-2	PNT-2	PNT-2	GYP 1		
19	LINE SERVICE SUPERVISOR	TER-1	RES-1	PNT-2	PNT-2	PNT-2	PNT-2	APC-1		
20	LINE SERVICE OFFLOADING	TER-1	RES-1	WP-1/PNT-2	WP-1/PNT-2	WP-1/PNT-2	WP-1/PNT-2	APC-1		
121	LINE SERVICE WORKROOM	TER-1	CWT-3	WP-1/PNT-2	WP-1/PNT-2	WP-1/PNT-2	WP-1/PNT-2	APC-1		
21A	BATTERY CHARGING	-	-	WP-1/PNT-2	WP-1/PNT-2	WP-1/PNT-2	WP-1/PNT-2	-		
22	ELEVATOR	CT-3	-	-	-	-	-	-		
23	RECEPTION / LINE COUNTER	CT-1/2	CWT-3	CT-2	-	-	-	APC-2		
24	VENDING / PREP	TER-1	RES-1	PNT-1	PNT-1	PNT-1	PNT-1	APC-1		
25	STAIR	TER-1	-	CT-1	-	-	-	-		
26	FIGHT PLANNING	TER-1	-	CT-1	-	-	-	-		
27	VESTIBULE	WOG-1	RES-1	-	-	-	-	APC-2		
28	PASSENGER WAITING	TER-1/CPT-3	RES-1	-	-	PNT-1	-	APC-2 + APC-4		
29	QUIET / SENSORY WAITING	CPT-1	RES-1	VWC-3/PNT-3	AWP-2	VWC-3	VWC-3	GYP		
30	CIRCULATION (PUBLIC)	TER-1	RES-1	-	VWC-1/PNT-4	VWC-1	VWC-1	GYP		
131	MEN'S	CT-3	-	CT-2	CT-2	CT-2	CT-2	GYP 1		
32	WOMEN'S	CT-3	-	CT-2	CT-2	CT-2	CT-2	GYP 1		
33	FAMILY RR	CT-3	-	CT-2/PNT-1	CT-2/PNT-1	CT-2/PNT-1	CT-2/PNT-1	GYP 1		
34	QUIET ROOM	CPT-1	RES-1	PNT-3	PNT-3	PNT-3	PNT-3	APC-1		
35	QUIET ROOM	CPT-1	RES-1	PNT-3	PNT-3	PNT-3	PNT-3	APC-1		
36	PILOT LOUNGE	CPT-1	RES-1	PNT-3	PNT-3	PNT-3	PNT-3	APC-1		
200	PASSENGER WAITING	TER-1/CPT-3	RES-1	PNT-1	PNT-3/CT-4	PNT-1	-	APC-2 + APC-4		

				Finish Legend	
Symbol	Manufacturer	Series/Pattern	Number	Color	Remarks
	anel Ceiling				
APC-1	Armstrong	Optima		White	24" x 24" 9/16" Grid
APC-2 APC-3	Armstrong	Metalworks Linear Metalworks Linear		Cherry	6" Wide Planks, Perforated - Interior
APC-3 APC-4	Armstrong Armstrong	Metalworks Linear Metalworks Linear		Cherry Black	6" Wide Planks, Non-Perforated - Exterior and some Lower Interior Locations 12" Wide Planks, Non Perforated - In Conjunction with APC-2
NPC-4 NPC-5	TURF	Slice	04	Light Gray	Classic C, D, & E Profiles
NPC-3	TURF	Slice	04	Light Gray	Classic C, D, & E Pioliles
Acoustical W	/all Panel				
WP-1	TURF	Reed	26	Faded Denim	
WP-2	TURF	Reed	28	Indigo	
Brick Venee	•				
BRK-1	Glen Gery	Metallix Series		Titanium Metallix	Running Bond Installation. RE:Elevations
BRK-2	Glen Gery	Burlesque Glazed Series		Oyster White with Speck Glazed	Stack Bond Installation, RE:Elevations
Carpet Tile	1				
CPT-1	Shaw Contract	Cross Weave Tile	5T526-25100	Cobblestone	18" x 36" Ashlar Installation
CPT-2	Shaw Contract	Local Time	5T523-21486	Vibrant Tejate	18" x 36" Ashlar Installation, Conference Room
CPT-3	Shaw Contract	Dye Lab	5T041-41496	Indigo	24" x 24" Monolitic Install, Inset Rugs
Ceramic Tile	*	Formal augusticities :		Cloto	Wall Danala
CT-1	Milestone	Farmhouse Living		Slate	Wall Panels
CT-2	Milestone	Area 51		Black	RR & Behind Main Counter
CT-3	Anatolia	La Marca		Nero Ventio Honed	RR Floors (Match Hangar 2)
CT-4	INAX	Japanese Tile World - Yohen Boarder		Dark Mix Blue	Mezz. Fireplace
CT-5	Tilebar	Splash		Lagoon	Exterior Mosaic + Above Coffee Bar
	Trim				
Ceramic Tile		Cable to - OLIA DEC		Class Anadimed	Outside Company on all Tile Tay Triby on Tile to Mark 1911 1911 1911
RIM-1	Schluter	Schluter®-QUADEC		Clear Anodized	Outside Corners on all Tile, Top Trim on Tile to Waiscott Level, Use Connectors
Encyc:					
poxy	Dooos	Cromono Corico	ED E40	Custom Color Match Taminal Court	Line Service Wet Coor Leeker Boom L Adiaining DD Incompanded Well Door
EPX-1	Desco	Cremona Series	FB-513	Custom Color Match Torginol Coyote	Line Service Wet Gear Locker Room + Adjoining RR, Incorporated Wall Base
Jiah D	ro Laminsts				
	re Laminate	F	10754	Div E.	Dublic Facing Tomain at Wall Dang lines at Outra Dang to
HPL-1	Formica	Fenix	J0754	Blu Fes	Public Facing Terminal Wall Paneling + Coffee Bar + Casework
HPL-2	Formica		6995-26	Cherry Walnut	Office Side Casework
HPL-3	MCI	Topologic	45505	White	Cabinet Interiors
HPL-4	Wilsonart	Traceless	15505	Black Velvet	Under Front Desk
Millwork Trin					
				Milly and Incort M/ Datum Kaya	Wall Densing
MWT-1	Fry Reglet			Millwork Insert W/ Return Keys	Wall Paneling
MWT-2	Fry Reglet			Millwork Channel L Angle w/ Return Ke Millwork U Channel	•
MWT-3	Fry Reglet				Front Desk
MWT-4	Fry Reglet			4" Millwork Reveal Base	Front Desk
Daint					
Paint	Daniansia Maana		00.05	Chantilla Laga	Tamasia al Dublia Cida Field Calan
PNT-1	Benjamin Moore		OC-65	Chantilly Lace	Terminal Public Side Field Color
PNT-2	Sherwin Williams		0055	Light French Gray	Office Side Field Color
PNT-3	Sherwin Williams		6517	Regatta	Accent
PNT-4	Sherwin Williams		7069	Iron Ore	Accent, Hollow Metal Doors, Stairs
	t. T				
	crete Terrazzo		T754	01	Duran de Otalian
PC-1	Wausau Tile		TZ51	Sleepy Hallow	Precast Stairs
PC-2	Wausau Tile		TZ32	Oyster Shell	For Background Color Reference Only, Match Aggregates of PC-1
Juort-					
Quartz	Cambric	Luxun/ Sorios		Harlow Motte	Front Dock + DD Countary
QTZ-1 QTZ-2	Cambria	Luxury Series		Harlow Matte	Front Desk + RR Counters Consource Flight Planning Counter + Coffee Bor Counter
Q1Z-2 QTZ-3	Cambria Cambria	Signature Series Coordinates Series		Hadley Black Rock Matte	Concourse Flight Planning Counter + Coffee Bar Counter Line Service Office Counters
x14-0	Calliblia	Journales Jelles		Plack Lock Matte	LING DELVICE OFFICE CONTINUES
Resilient Ba	se				
RES-1	Johnsonite	Millwork - Stance	4.5"		Public Areas
RES-1 RES-2	Johnsonite	Millwork - Stance Millwork - Mandalay	4.25"	+	Offices
,	Johnsonito	won wandalay	7.20	1	
Solid Surfac	e				
SS-1	Wilsonart		D354SL	Designer White	Shower Partitions
	onart	1	DUUTUL		E.E. Torradiano
Terrazzo					
TER-1	Desco			Custom Blend - Dark Color	MATCH PC-1, Concourse, Cafe/Vending Area, Plubic and Private Corridors + Line Service
ΓER-2	Desco			Custom Blend - Light Color	MATCH PC-1, Concourse Accent
	20000			Sastom Biona - Light Color	III. C. C. CONOCINGO / NOCON
/inyl Wallco	vering				
/WC-1	MDC Interior Solutions	Len-Tex Contract	7427AL	Silva	
/WC-2	MDC Interior Solutions	Thom Falica Affinity	TFC1873	Midnight	
/WC-3	MDC Interior Solutions	Thom Falica Affinity	TFC1866	Pebble	
0-0	Interior colutions	. Hom Famou /Ammily	11 0 1000		
Valk Off Gri	lle				
VOG-1	Mats Inc.				
/V UG-1	IVIALO IIIC.				
Mall Drote -+	on				
Wall Protect	UII			Diamond Plata	Rack Line Service + I Molding on Evaceed Edges
WP-1				Diamond Plate	Back Line Service + J Molding on Exposed Edges
Aller d. =···					741 Dall Haimle
		The state of the s	01/10=:=	1 E 41 • • • • • • • • • • • • • • • •	LATE HOLLHOUGH
	Decorative Films		SXJ-0547	Feather Gradient	71" Roll Height
FILM-1	Decorative Films		SXJ-0547	Feather Gradient	71 Koli Height
FILM-1 Wood Finish	Decorative Films		SXJ-0547		
Window Film FILM-1 Wood Finish WF-1 WF-2	Decorative Films		SXJ-0547	Cherry Clear Walnut	All Wood Doors Custom Casework / Wall Partitions



1627 MAIN STREET, SUITE 600 KANSAS CITY, MO 64108







TERMINAL - 17932172

1701 WALNUT STREET, SUITE 300 KANSAS CITY, MO 64108

11-25-2024

LEES SUMMIT MUNICIPAL AIRPORT LEES SUMMIT, MO

A 01.03.25 CITY REVIEW COMMENTS MARK DATE DESCRIPTION

PROJECT NO: 2403 REVIT FILE: 2403 Lee's Summit Terminal-R24.rvt DESIGNED BY: Designer DRAWN BY: HJM CHECKED BY: JSB

APPROVED BY: Approver

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FINISH SCHEDULES

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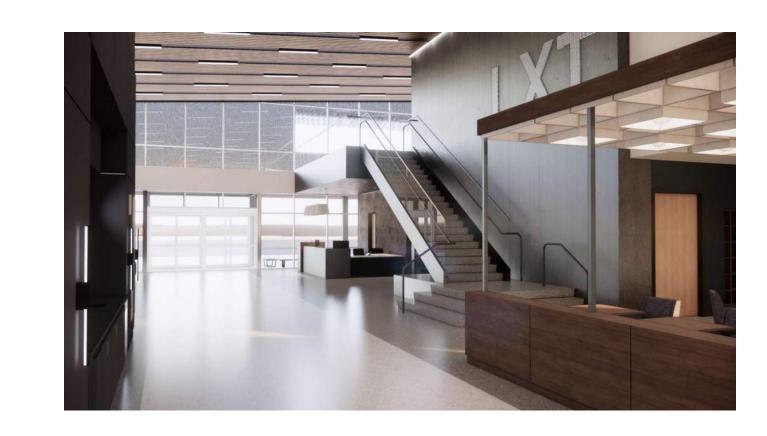


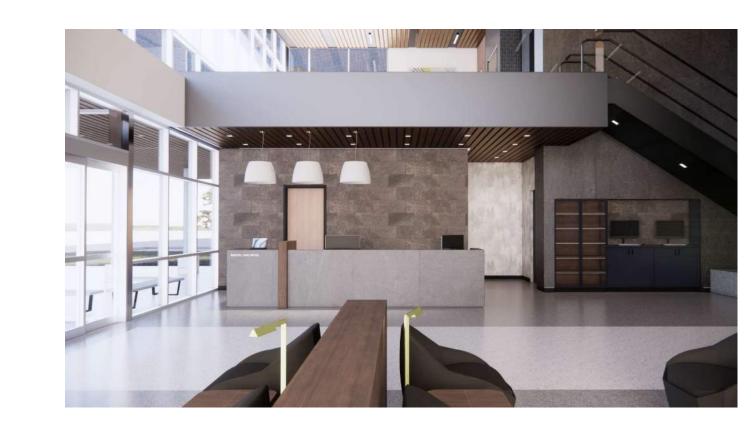


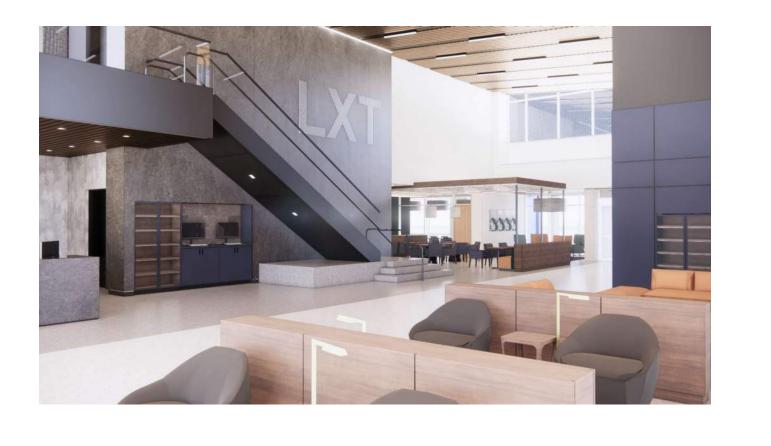


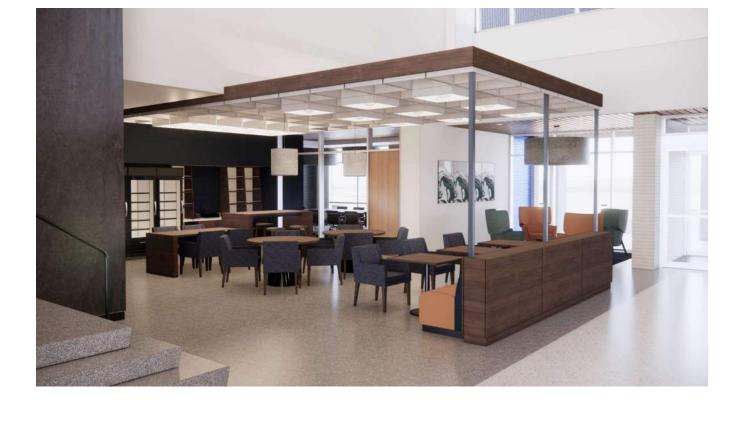


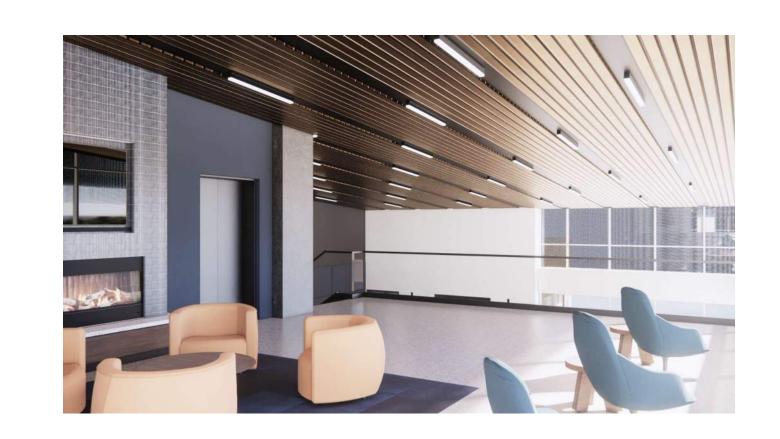




















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GENERAL AVIATION CITY PORJECT NO.

LEES SUMMIT MUNICIPAL AIRPORT LEES SUMMIT, MO

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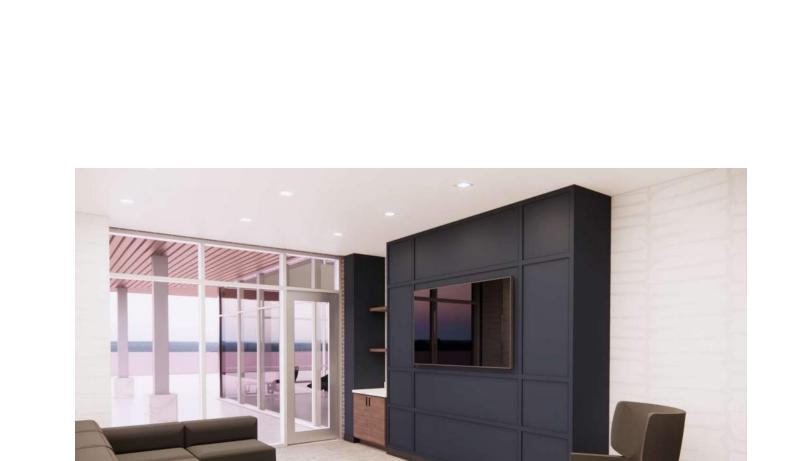
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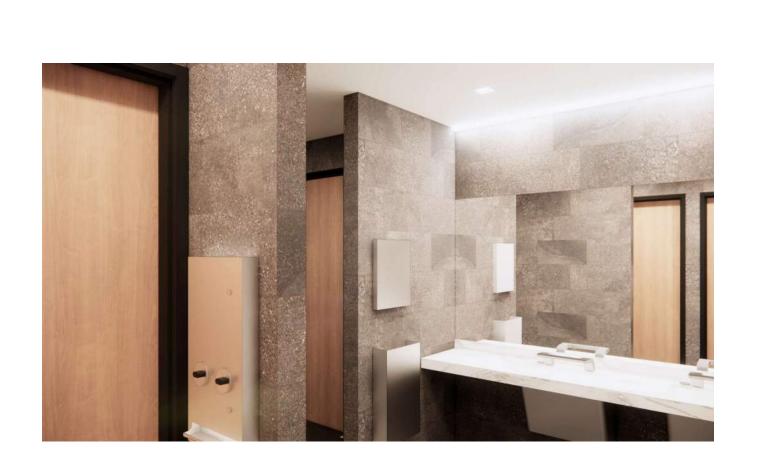
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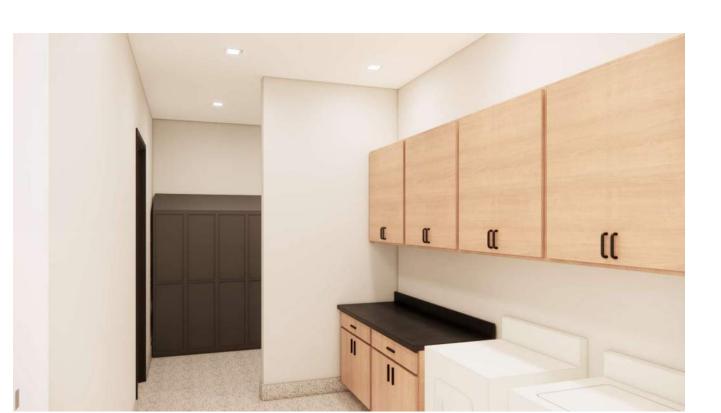


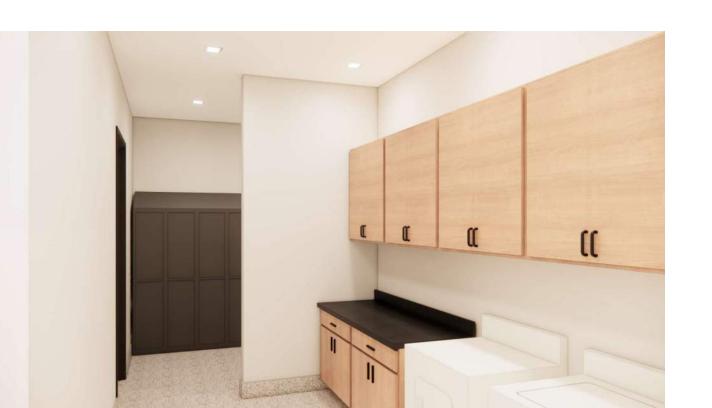
















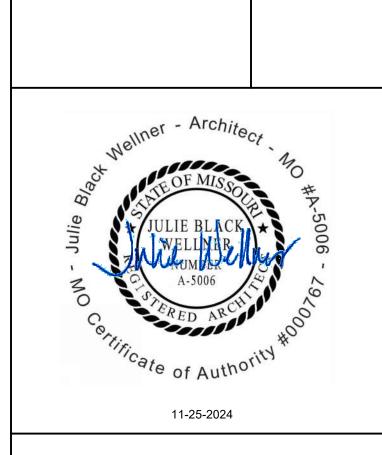
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