2751 NORTHEAST DOUGLAS STREET LEE'S SUMMIT, MISSOURI 64064

CONSTRUCTION PLANS FOR

KANSAS CITY - LEE'S SUMMIT REGIONAL AIRPORT

CITY PROJECT NO. 17932172

GENERAL AVIATION TERMINAL

IFB PLAN SET

DECEMBER 13, 2024

CALL MISSOURI ONE-CALL SYSTEMS
BEFORE EXCAVATING
1-800-DIG-RITE

DESIGN AIRCRAFT - GEOMETRY

CANADAIR CL-600

AIRCRAFT APPROACH CATEGORY C

AIRPLANE DESIGN GROUP II

DESIGN AIRCRAFT - STRUCTURE

GRUMMAN GULFSTREAM IV

GROSS WEIGHT - 71,800 LBS

EQUIVALENT ANNUAL DEPARTURES - 651

MAXIMUM EQUIPMENT HEIGHT: 100'

UNICOM/CTAF FREQUENCY - 122.80



22001238

PROFESSIONAL ENGINEERING - 000631

CRAWFORD MURPHY & TILLY, INC.

CONSULTING ENGINEERS

SPRINGFIELD, IL AURORA, IL ST. LOUIS, MO

■ SPRINGFIELD, IL ■ AURORA, IL ■ ST. LOUIS, MO ■ EDWARDSVILLE, IL■ CHICAGO, IL■ PEORIA, IL■ ROCKFORD, IL ■ INDIANAPOLIS, IN ■ COLUMBUS, OH ■ SPRINGFIELD, MO ■ KANSAS CITY, MO ■ LA BELLE, FL ■ MOLINE, IA

SUBMITTED BY GERALD BOLLINGER


DATE DECEMBER 13, 2024

LOCATION MAP


KANSAS CITY


LEE'S SUMMIT MUNICIPAL AIRPORT


LEE'S SUMMIT

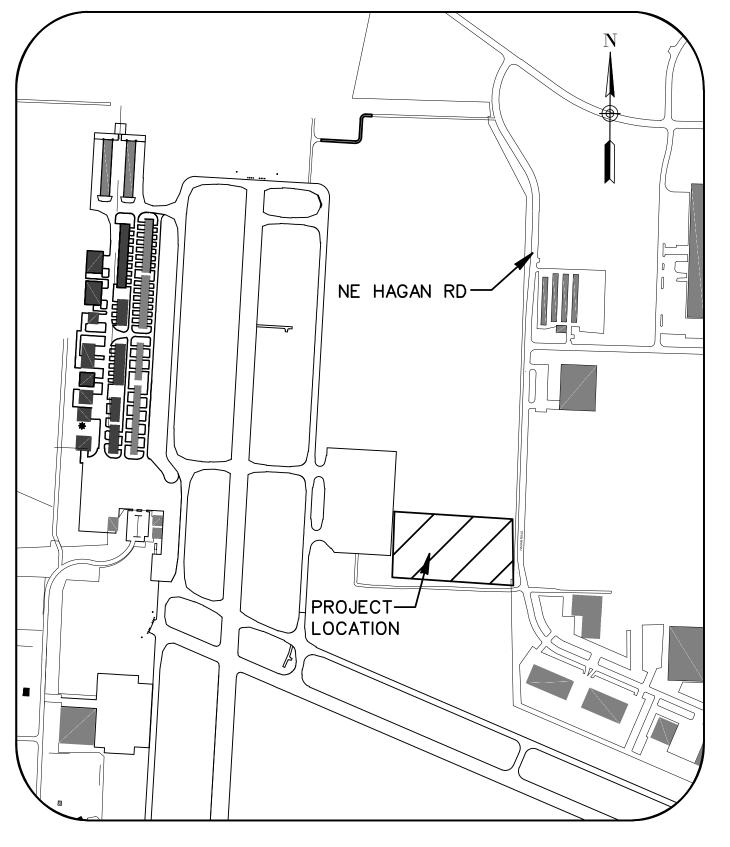

SITE PLAN

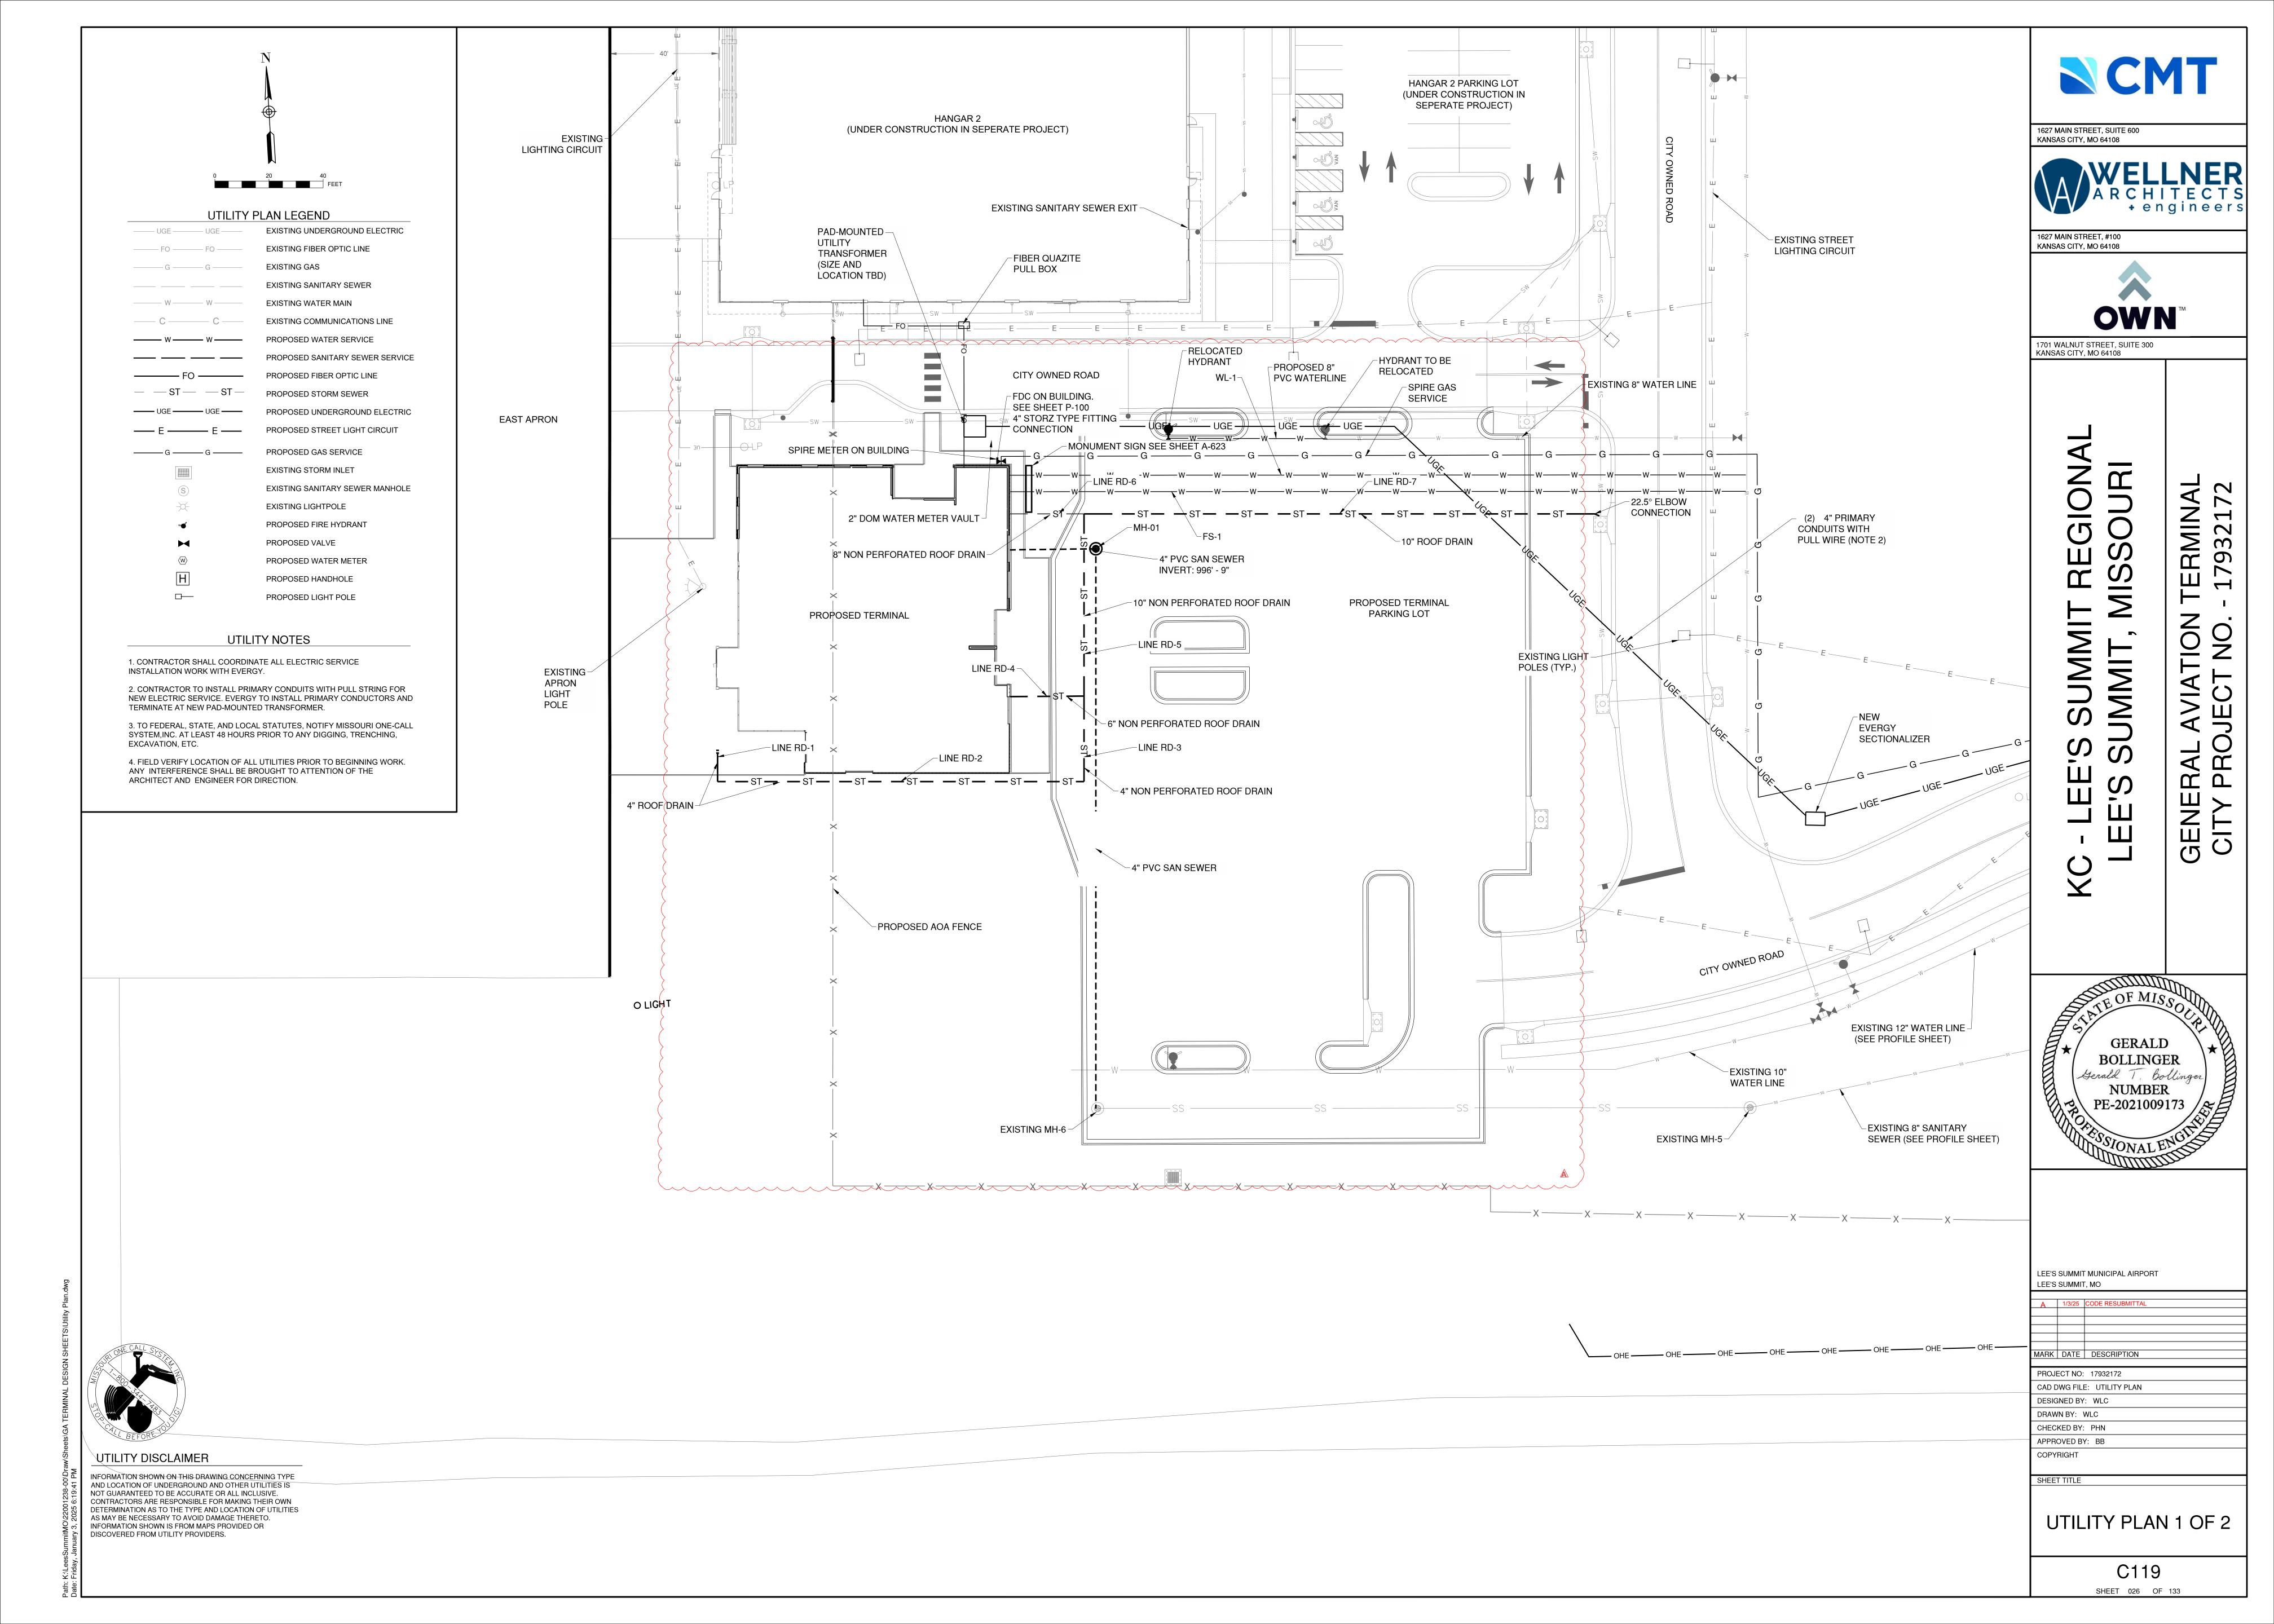

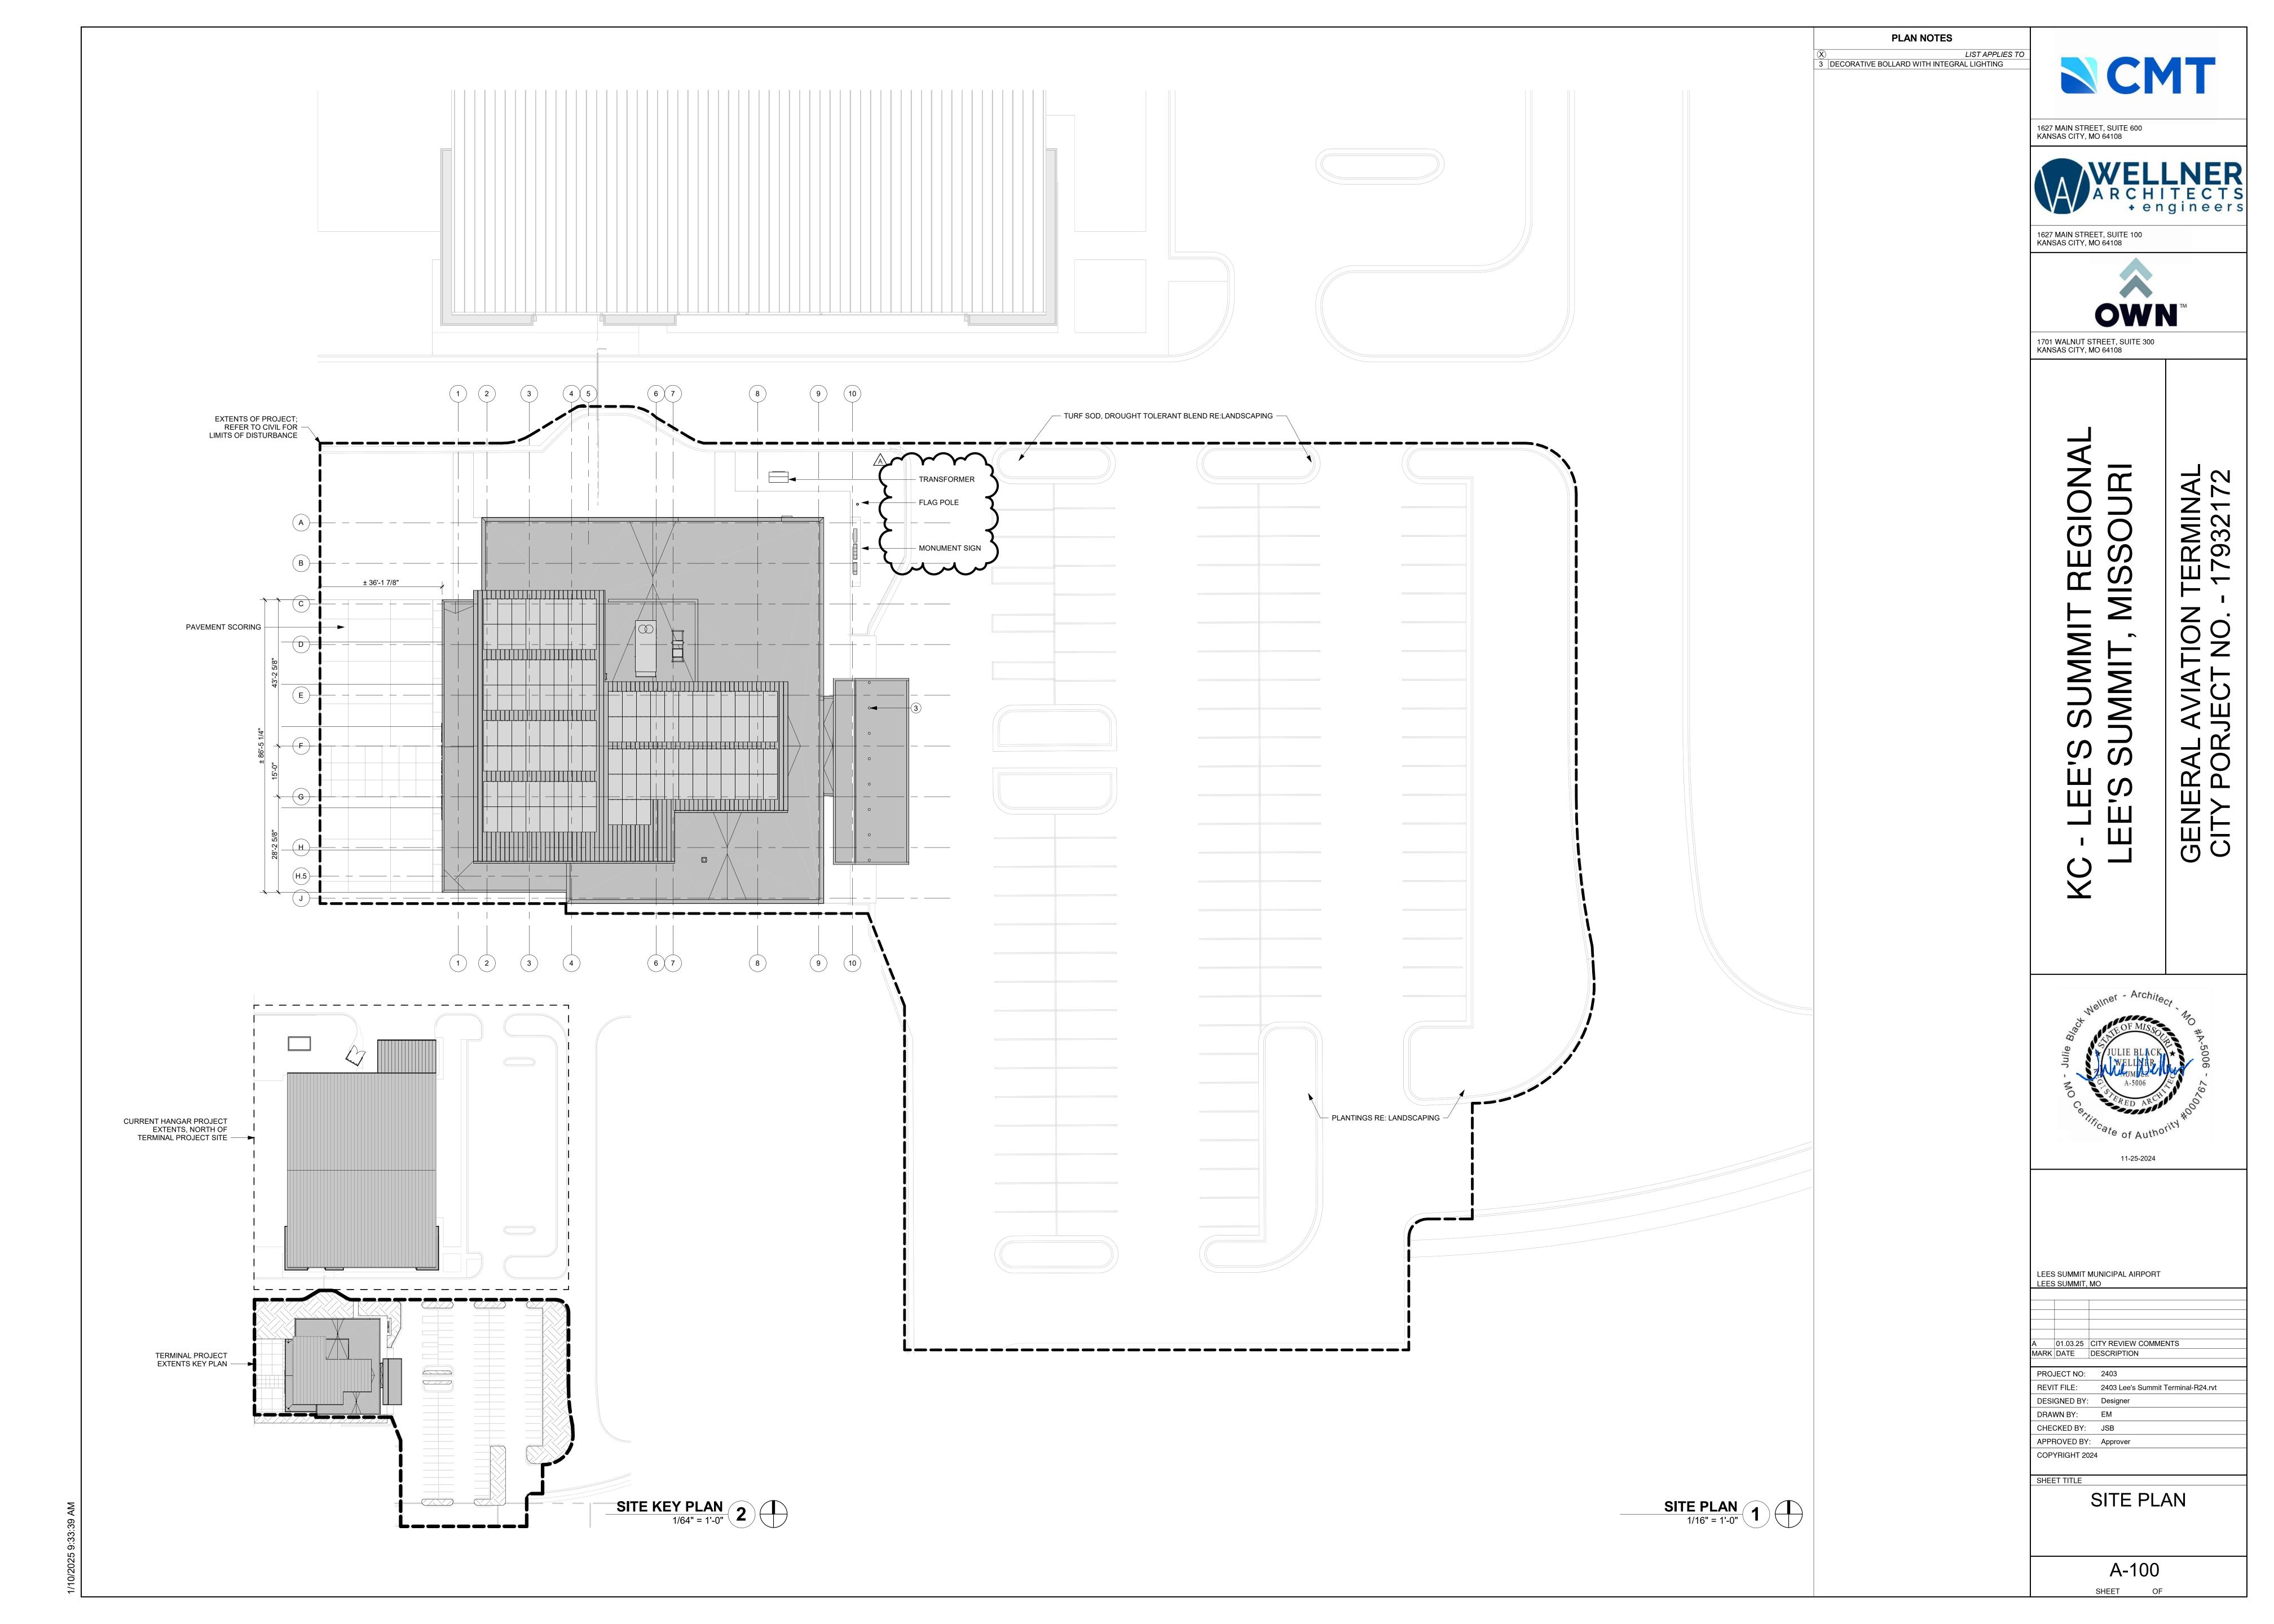

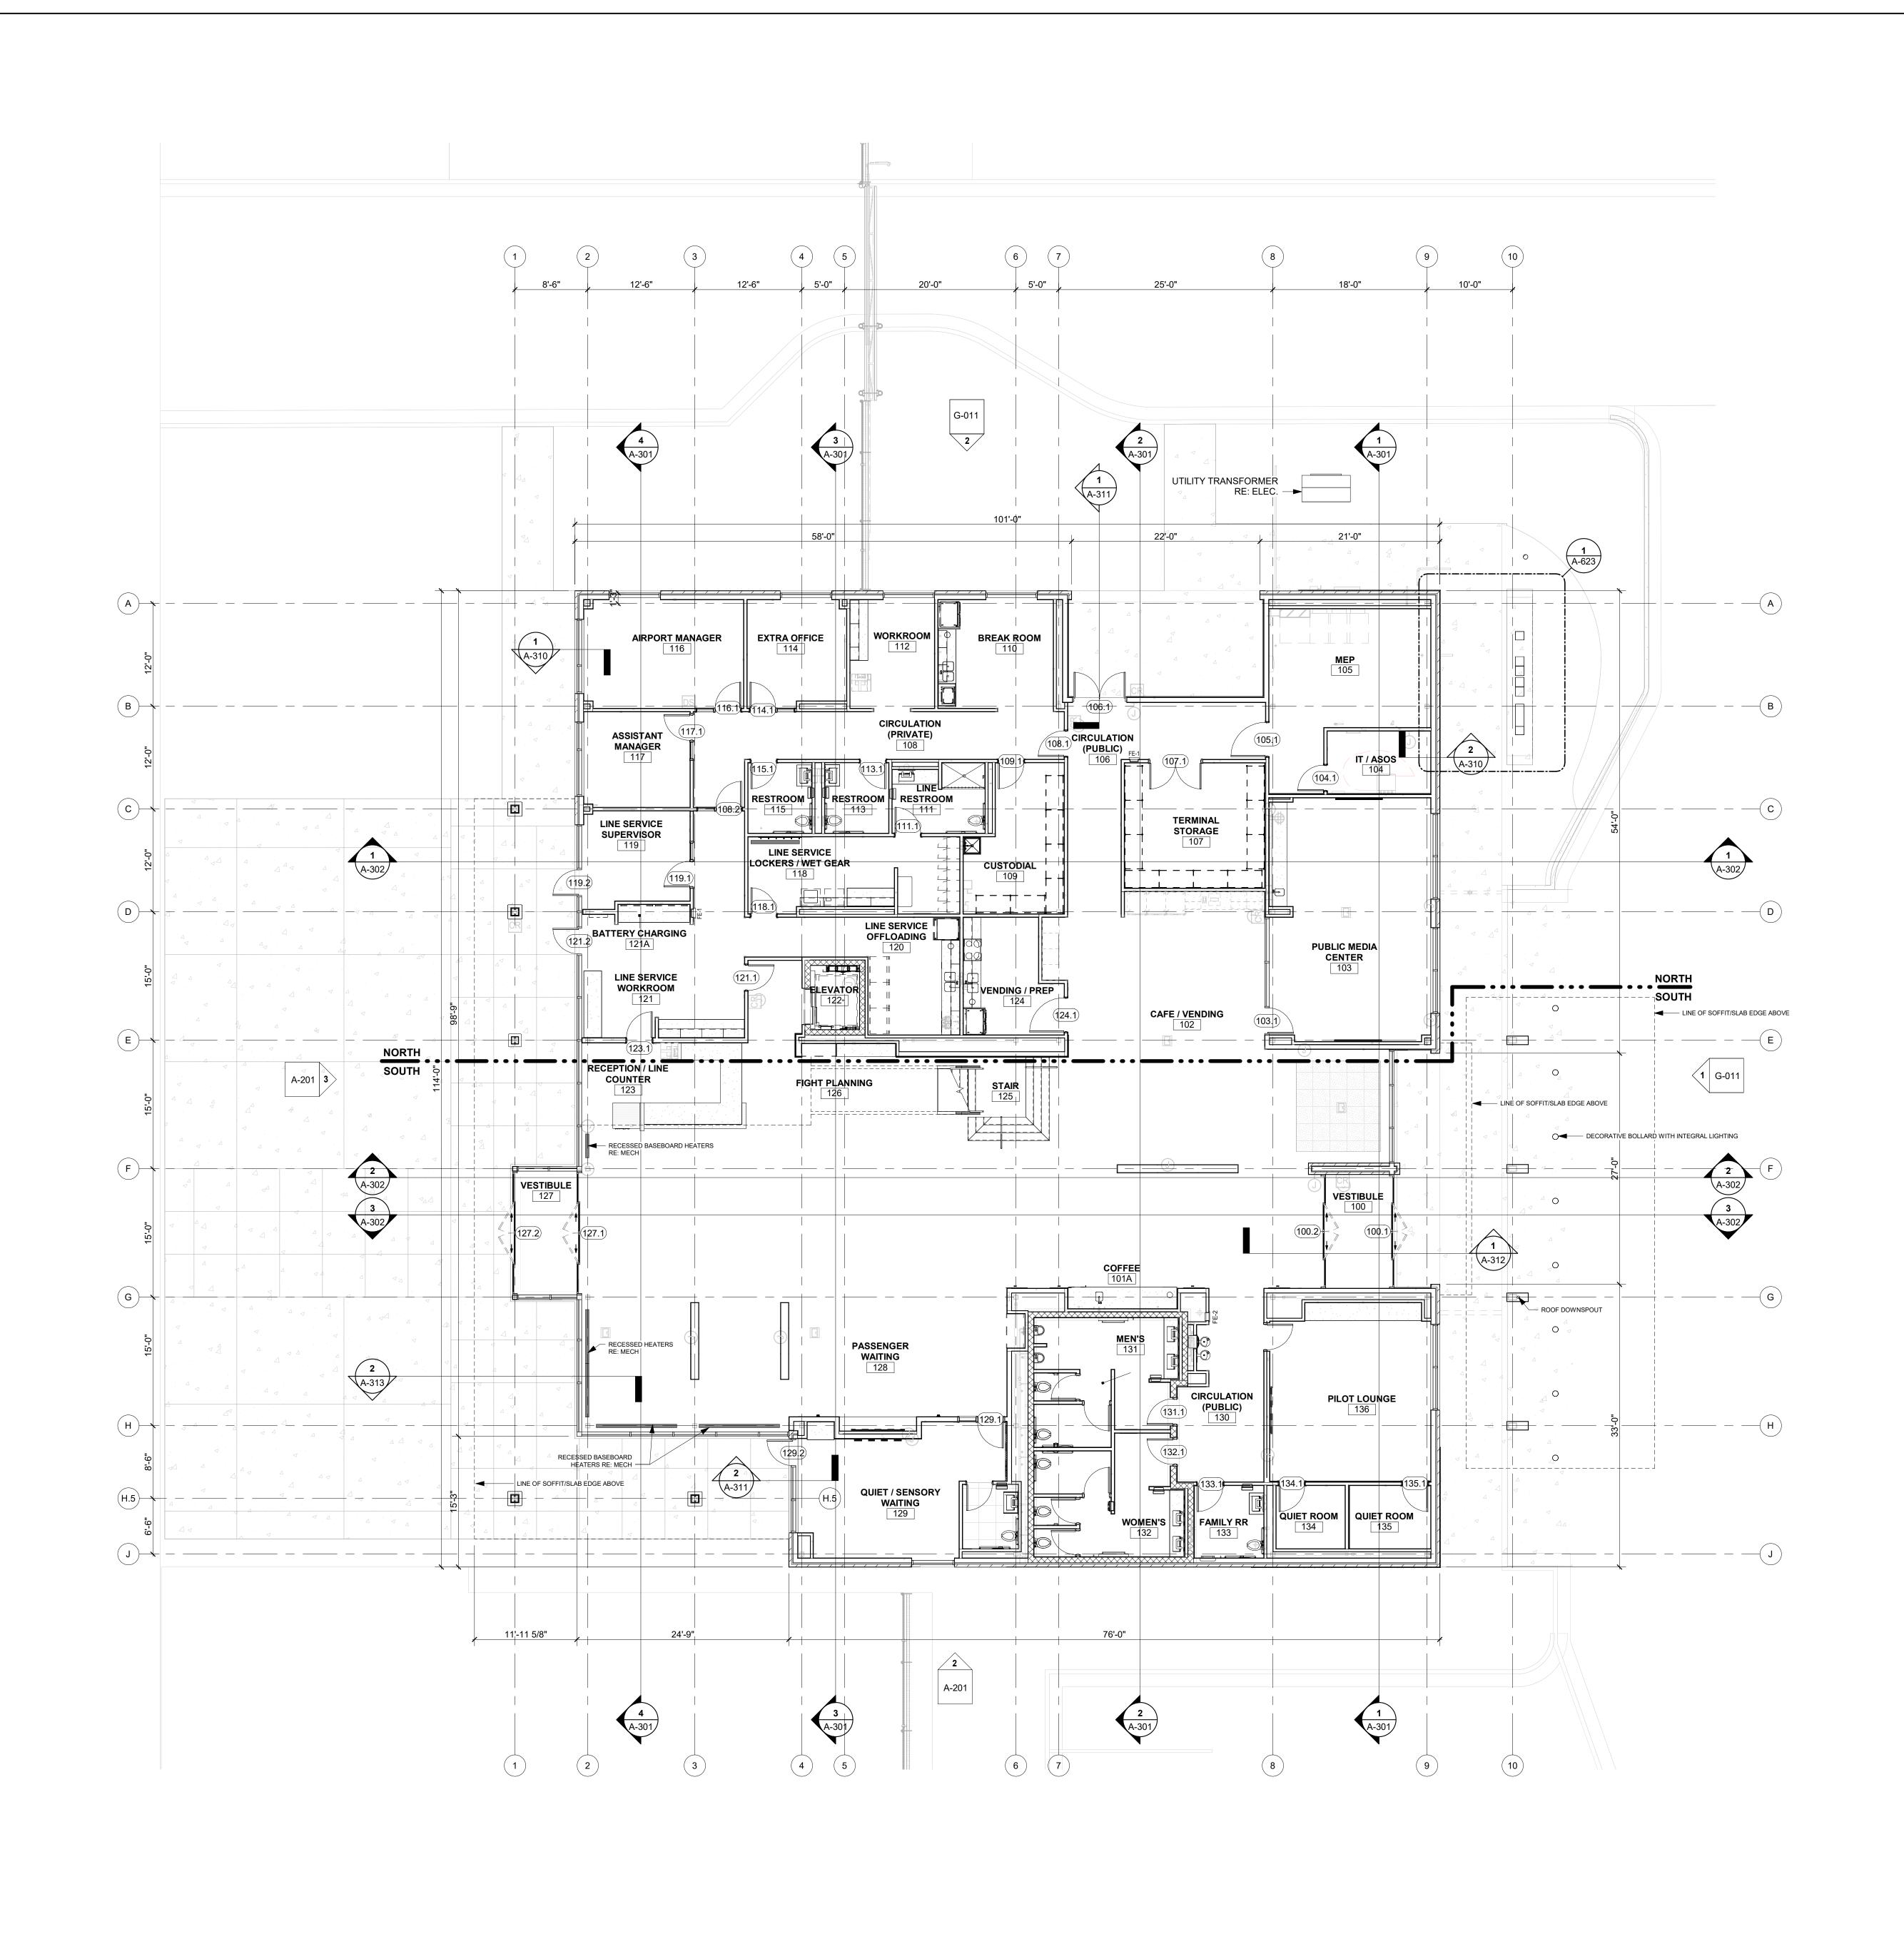



TERMINAL - 17932172

CMT

1627 MAIN STREET, SUITE 600 KANSAS CITY, MO 64108

11-25-2024

LEES SUMMIT MUNICIPAL AIRPORT LEES SUMMIT, MO

MARK DATE DESCRIPTION PROJECT NO: 2403 REVIT FILE: 2403 Lee's Summit Terminal-R24.rvt


DESIGNED BY: Designer DRAWN BY: EM

CHECKED BY: JSB APPROVED BY: Approver COPYRIGHT 2024

1ST FLOOR PLAN
1/8" = 1'-0"
1

SHEET TITLE 1ST FLOOR PLAN

> A-101 SHEET OF

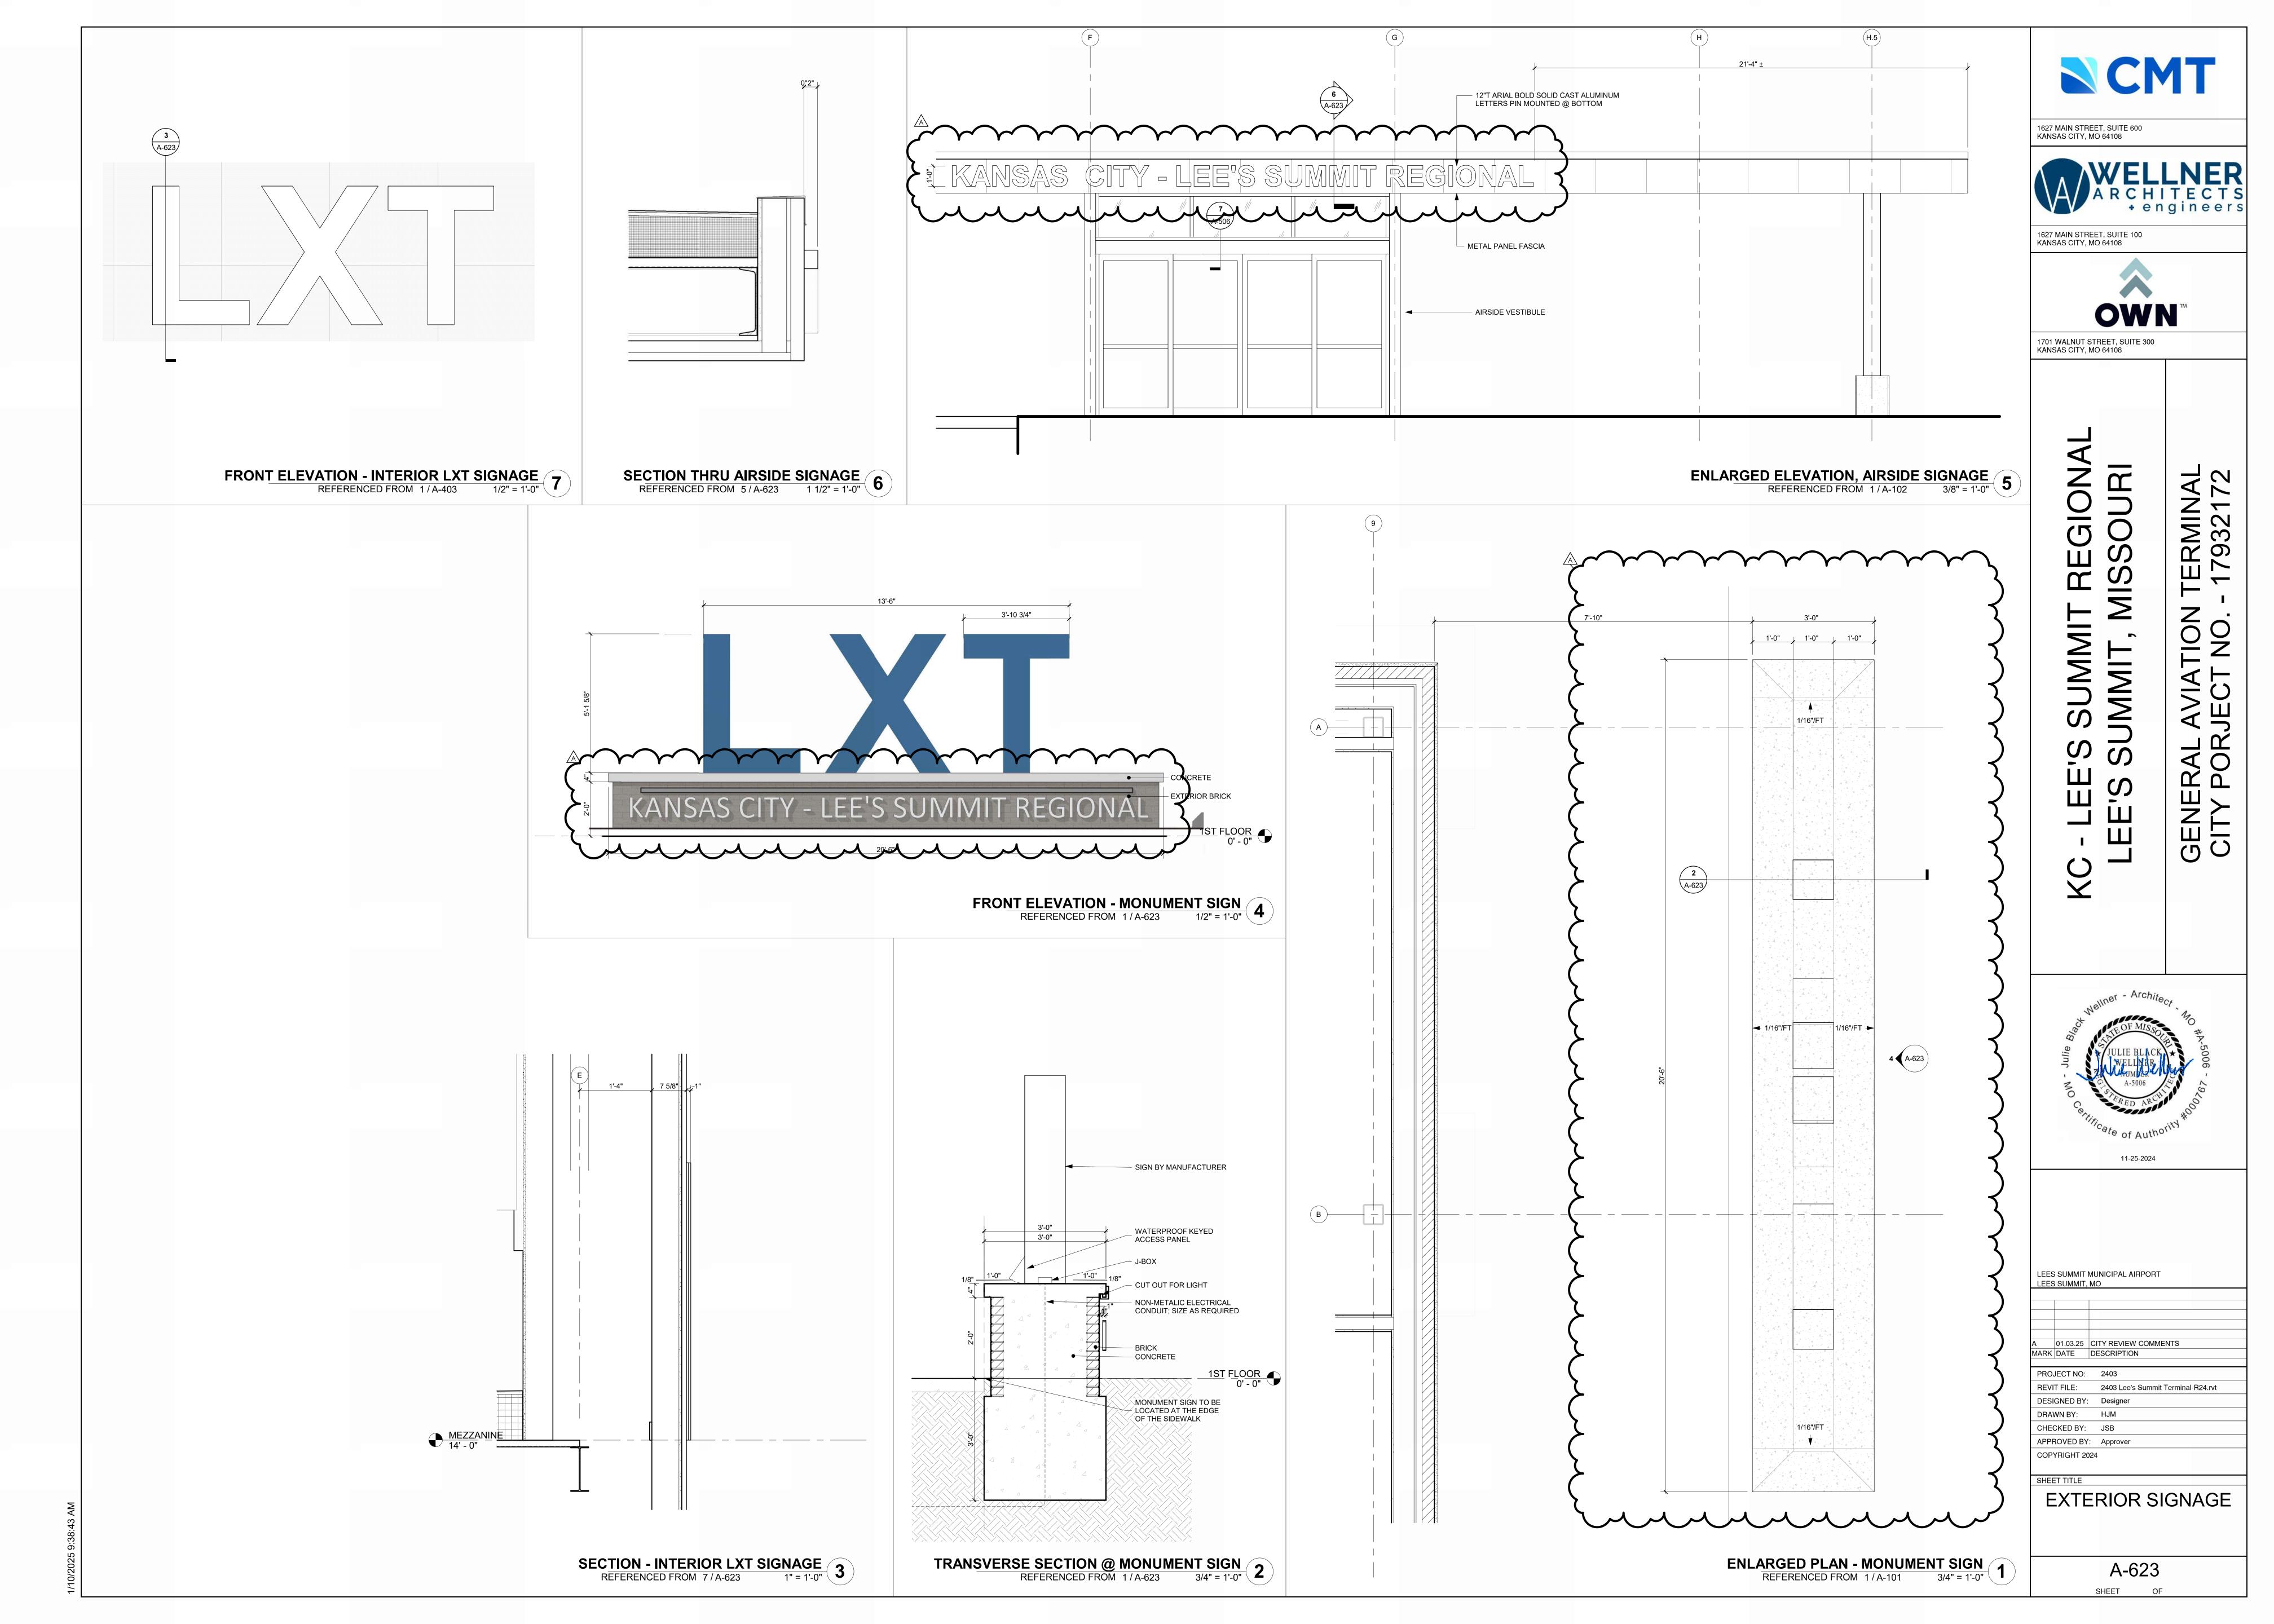












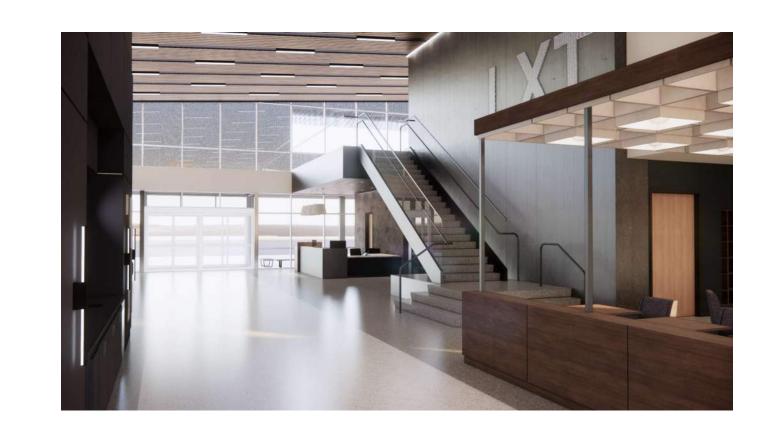

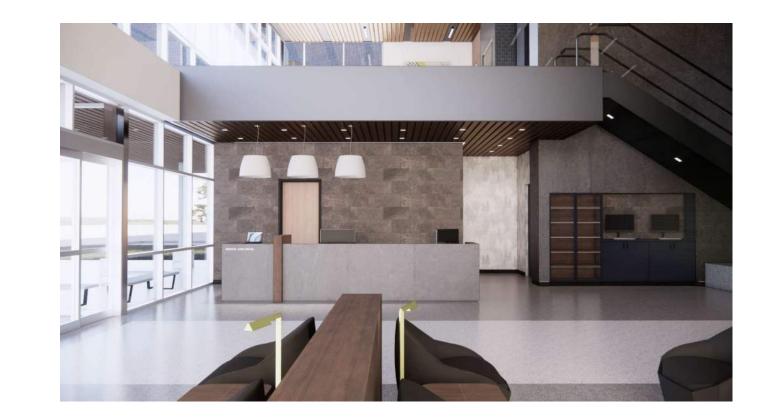






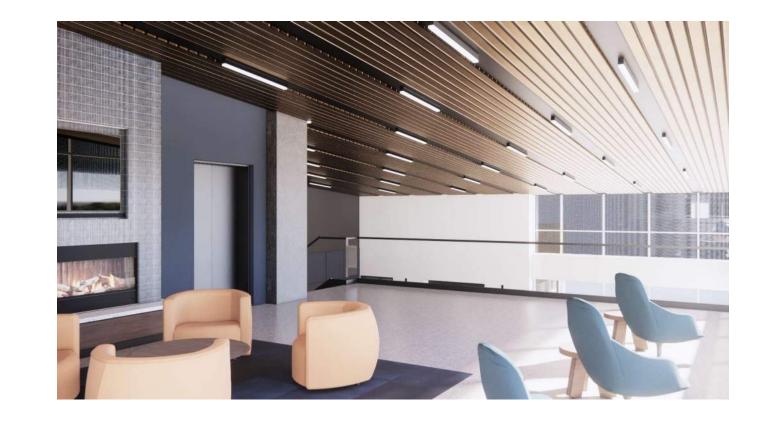





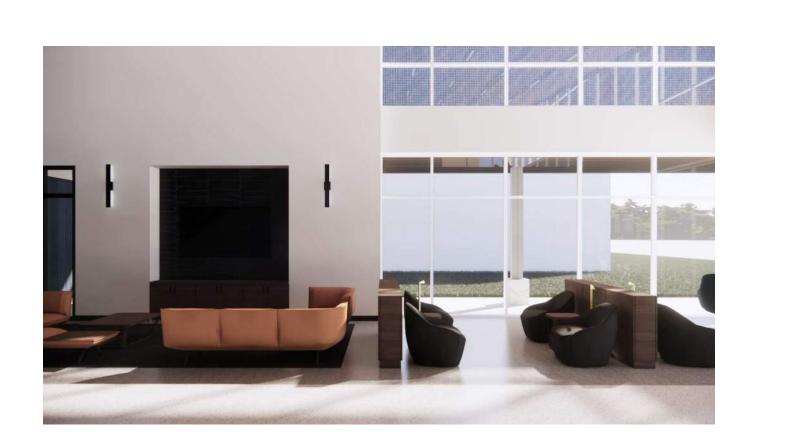




1627 MAIN STREET, SUITE 100 KANSAS CITY, MO 64108



1701 WALNUT STREET, SUITE 300 KANSAS CITY, MO 64108

TERMINAL - 17932172

GENERAL AVIATION CITY PORJECT NO.

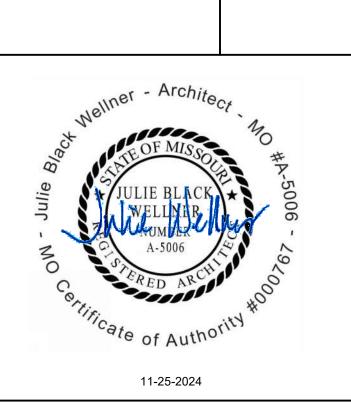

LEES SUMMIT MUNICIPAL AIRPORT LEES SUMMIT, MO

MARK DATE DESCRIPTION


PROJECT NO: 2403 REVIT FILE: 2403 Lee's Summit Terminal-R24.rvt DESIGNED BY: Designer DRAWN BY: EM

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SHEET TITLE 3D VIEWS

A-901

SHEET OF

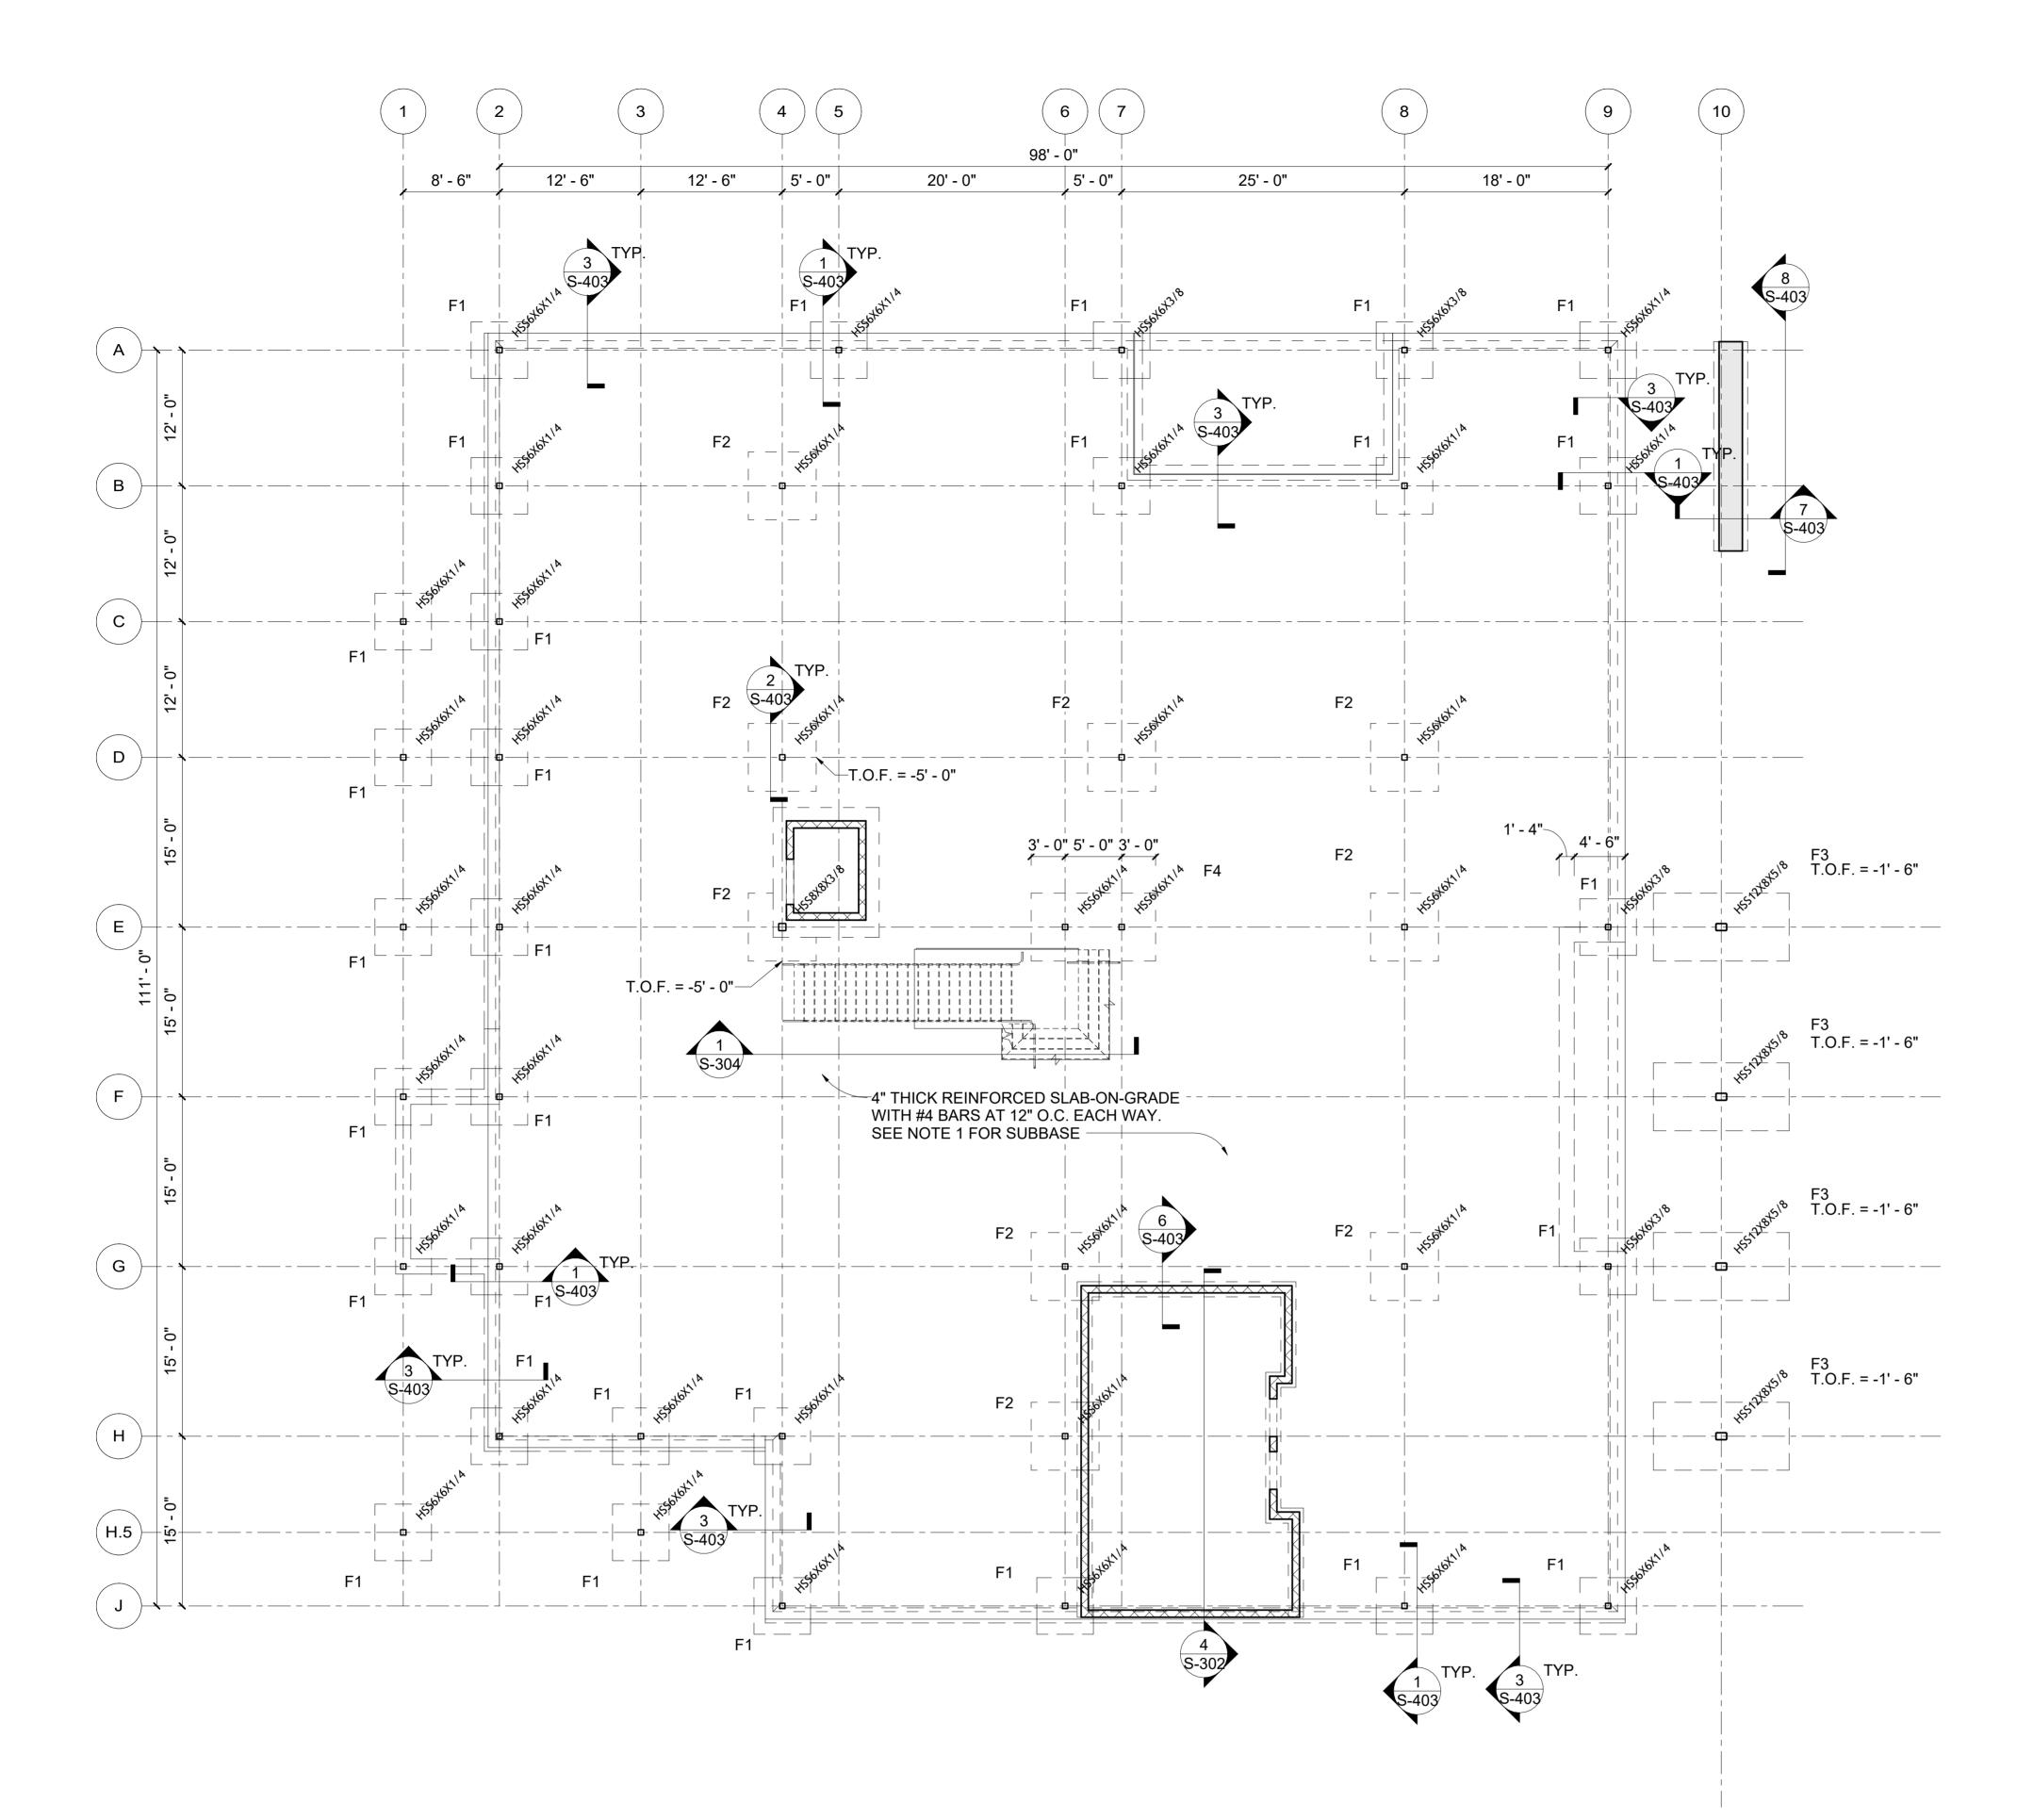

Foundation Plan		

SPREAD FOOTING								
			DIMENSI	ONS	RE	INF.		
ID	QTY.	WIDTH	LENGTH	THICKNESS	TOP	BOT	COMMENTS	
F1	30	5' - 0"	5' - 0"	2' - 6"	~	#5 @ 12" O.C. E.W.		
F2	9	6' - 0"	6' - 0"	1' - 4"	~	#5 @ 10" O.C. E.W.		
F3	4	6' - 0"	12' - 0"	2' - 6"	5 - #8 LONG. 10 - #8 TRANS.	5 - #8 LONG. 10 - #8 TRANS.		
F4	1	11' - 0"	6' - 0"	1' - 4"	~	#5 @ 10" O.C. E.W.		

- 1. SLAB ON GRADE TO BE PLACED OVER 15-MIL VAPOR BARRIER OVER 4" CLEAN ROCK, OVER 12" CRUSHED LIMESTONE SCREENINGS PER GEOTECH
- 2. TOP OF FOOTING = -1' 3" (UNLESS NOTED OTHERWISE)



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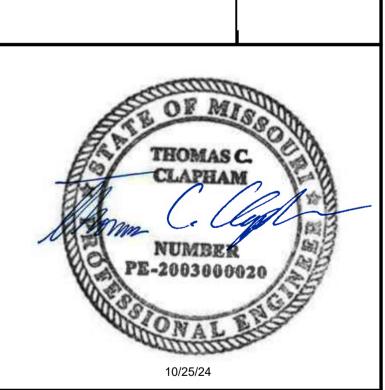


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TERMINAL - 17932172



LEES SUMMIT MUNICIPAL AIRPORT AUTHORITY LEES SUMMIT, MO

MARK	DATE	DESCRIPTION	
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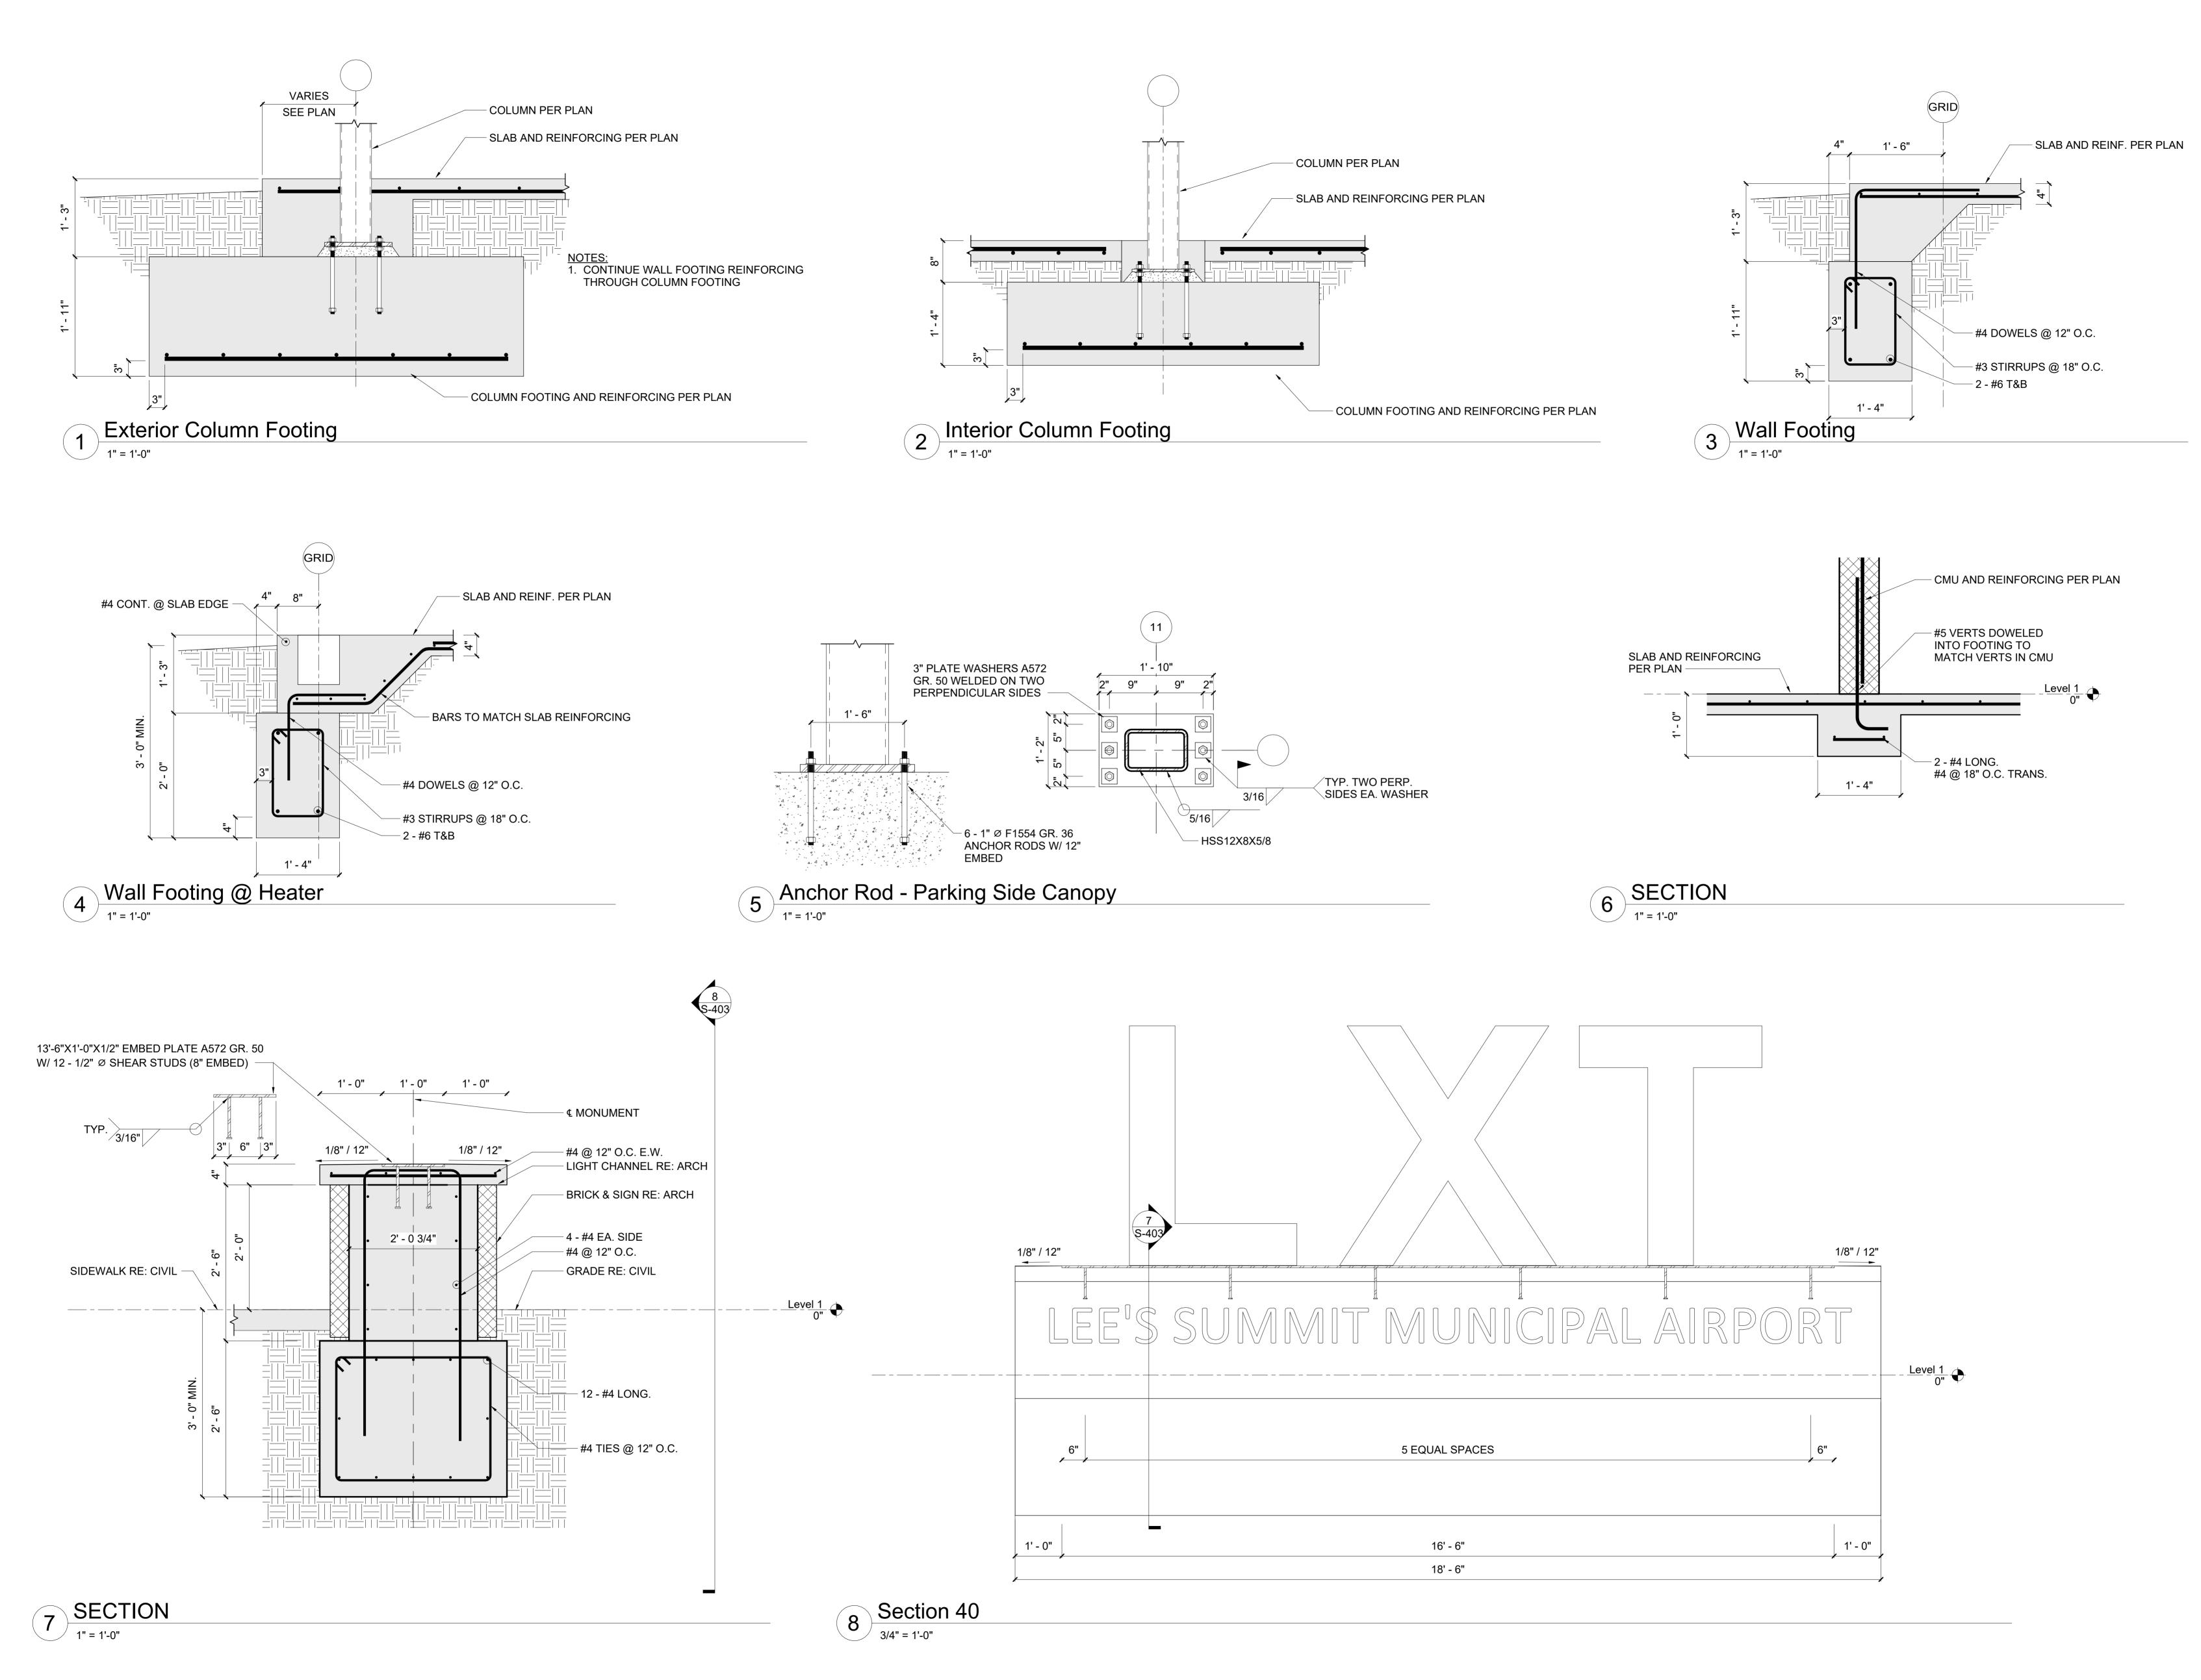
PROJECT NO: 24KC50013 CAD DWG FILE: Lee's Summit - Hangar 2.rvt DESIGNED BY: JDH & BLL

DRAWN BY: JDH CHECKED BY: BLL

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FOUNDATION PLAN

S-101





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TERMINAL - 17932172

GENERAL AVIATION CITY PORJECT NO.

1701 WALNUT STREET, SUITE 300 KANSAS CITY, MO 64108

LEES SUMMIT MUNICIPAL AIRPORT AUTHORITY LEES SUMMIT, MO


MARK DATE DESCRIPTION PROJECT NO: 24KC50013

CAD DWG FILE: Lee's Summit - Hangar 2.rvt DESIGNED BY: JDH & BLL DRAWN BY: JDH CHECKED BY: BLL

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FOUNDATION DETAILS

S-403

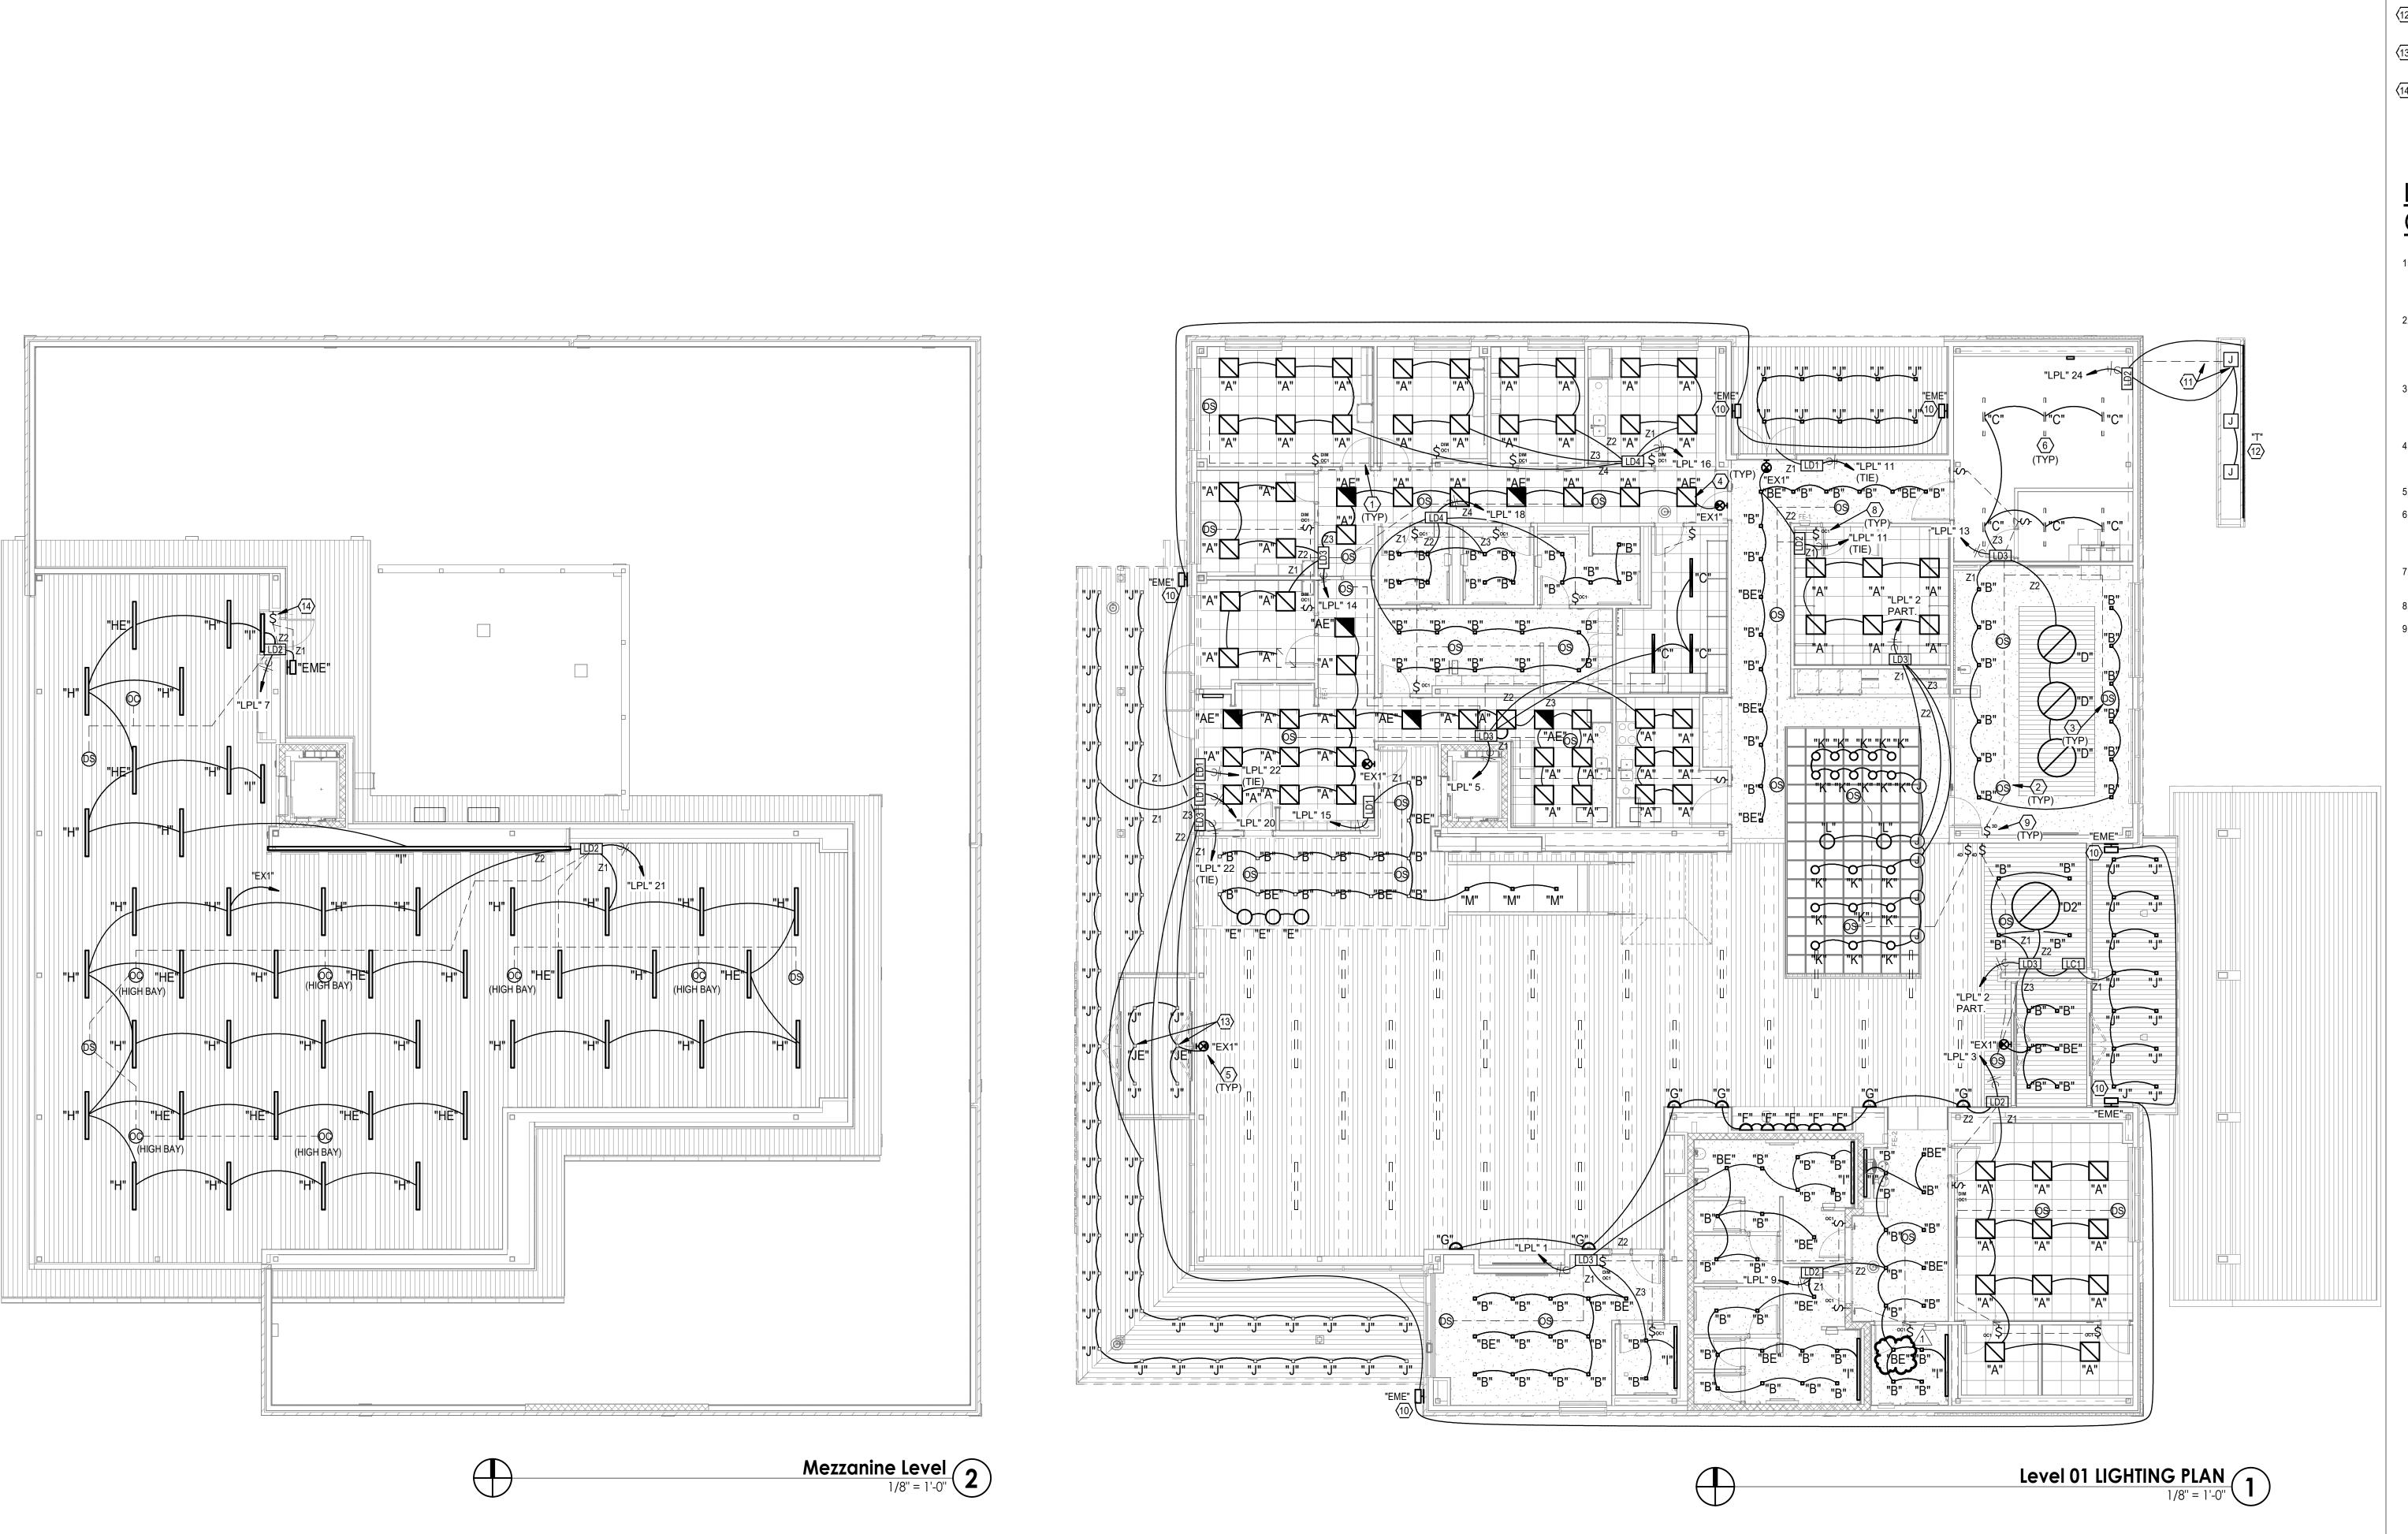

<u>LIGHTING</u> **PLAN NOTES**

1 ROUTE CAT-6 CABLING FOR ALL CONTROL DEVICES TO CONTROLLER.

DUAL TECHNOLOGY (PIR/US) LOW VOLTAGE CEILING OCCUPANCY SENSOR FURNISEHED AS PART OF DIGITAL LIGHTING CONTROL SYSTEM. ROUTE COMMUNICATION CABLING TO CONTROLLER.

TYPICAL DAYLIGHT HARVESTING SENSOR MOUNTED IN CEILING WITHIN 60" OF WINDOW.

FIXTURES WITHIN DRYWALL CEILING LID TO BE FURNISHED WITH PLASTER FRAM (TYP, RE: ARCH REFLECTED CEILING

5 INCLUDE 'HOT' UNSWITCHED CONDUCTOR WITH CIRCUITS THAT POWER EMERGENCY BATTERY PACK.

6 SUSPEND LED STRIP FIXTURE WITH CHAINS AT 8'-0" AFF. DIGITAL LIGHTING CONTROLLER (1-4 CIRCUIT) MOUNTED ABOVE CEILING ON WALL 12" ABOVE GRID (LD FOR

DIMMING, LC FOR GROUP CONTROL).

TYPICAL DUAL TECHNOLOGY (PIR/US) WALL SWITCH OCCUPANCY SENSOR WITH OVERRIDE OFF AND PUSH TO DIM FURNISHED AS PART OF DIGITAL LIGHTING CONTROL SYSTEM. ROUTE COMMUNICATION CABLING TO CONTROLLER.

TYPICAL MULTI-BUTTON DIGITAL SWITCH SENSOR FURNISHED AS PART OF DIGITAL LIGHTING CONTROL SYSTEM. ROUTE COMMUNICATION CABLING CONTROLLER. PROGRAM PER SEQUENCES FOR DAYLIHGTING, PUSH TO

MOUNT EXTERIOR FIXTURE AT 108" AFF PROVIDE SURFACE MOUNTING PLATE AND CONDUIT ENTRY. EXTERIOR EMERGENCY FIXTURES SHALL COME WITH BUILT-IN

PROVIDE 2#12, #12G., 3/4" UG CONDUIT FROM PANELBOARD SERVING LOAD TO JUNCTION BOX FOR MONUMENT SIGN POWER. FINAL CONNECTION BY MONUMENT SIGN VENDOR.

LED STRIP LIGHTING ON FRONT OF MONUMENT SIGN. RE: ARCH DRAWINGS FOR ADDITIONAL DETAILS.

> PROVIDE "JE" TYPE LIGHT FIXTURE WITH SURE-LITES EBPLEDL EMERGENCY BATTERY PACK RE: DETAIL 6/E-400.

MANUAL OVERRIDE SWITCH FOR EXTERIOR MEZZANINE (14) "EME" LIGHT FIXTURE. SWITCH TO ALLOW FIXTURE TO REMAIN OFF IN NORMAL OPERATION AND TURN ON VIA SWITCH OR EMERGENCY POWER.

- AND NFPA AS ADOPTED BY THE AUTHORITY HAVING JURISDICTION.
- 2. COORDINATE CLOSELY WITH ALL OTHER TRADES TO EXPEDITE CONSTRUCTION AND AVOID INTERFERENCES AND CONFLICTS BEFORE ANY PIPING, DUCTWORK,
 CONDUIT, ECT. IS INSTALLED, IT SHALL BE COORDINATED
- ACCESSORIES, AND MATERIAL FURNISHED BY THEM FOR A PERIOD OF ONE YEAR FROM FINAL ACCEPTANCE AGAINST ALL DEFECTORS.
- ARCHITECTURAL PLANS.
- 5. ROUTE ALL CONDUIT TIGHT TO STRUCTURE.
- 6. LIGHT FIXTURES DESIGNATED WITH THE LETTER "E" (I.E "DE", "BE", ETC.) SHALL BE CONNECTED TO CIRCUIT SHOWN THAT SHALL AUTOMATICALLY SIWTCH TO EMERGENCY POWER IN THE EVEN OF A NORMAL POWER LOSS.
- 8. REFER TO SHEET E-400 FOR DIMMING SWITCH BANKS.



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1. ALL ELECTRICAL WORK SHALL BE IN ACCORDANCE WITH


THE LOCAL VERSION OF THE NATIONAL ELECTRIC CODE

CAREFULLY BETWEEN ALL TRADES. 3. CONTRACTOR SHALL GUARANTEE ALL EQUIPMENT,

4. VERIFY IN FIELD, THE LOCATION OF ALL STRUCTURAL MEMBERS. CEILINGS ARE SHOWN SCHEMATICALLY FROM

. PROVIDE ALL LED DIMMABLE FIXTURES WITH 0-10V DIMMABLE DRIVERS.

9. EXIT LIGHTS SHALL BE CIRCUITED TO UNSWITCHED HOT, TYPICAL ALL EXITS THROUGHOUT.

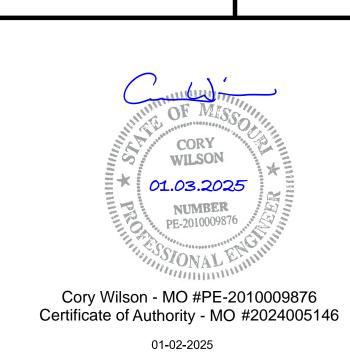

LEES SUMMIT MUNICIPAL AIRPORT LEES SUMMIT. MO

01.03.25 CITY REVIEW COMMENTS

PROJECT NO: 2403 CAD DWG FILE: Lee's Summit - Hangar 2.rvt DESIGNED BY: CMW

DRAWN BY: MR CHECKED BY: WAI APPROVED BY: APPROVER COPYRIGHT 2023

LIGHTING PLANS

E-100