

# FINAL DEVELOPMENT PLAN

# LEE'S SUMMIT FLEX SPACE 60 SE THOMPSON DR.

#### PROJECT TEAM

#### OWNER: CAPITAL BUILDERS 1507 NE WALL ST. LEE'S SUMMIT. MO. 64086 CONTACT: MATT HENDRICKSON

EMAIL: MATT@CAPITALBUILDERSKC.COM CIVIL ENGINEER: KIMLEY-HORN AND ASSOCIATES, INC.

805 PENNSYLVANIA AVE. SUITE 150. KANSAS CITY, MO 64105 CONTACT: PATRICK JOYCE, P.E.

TEL: (785) 550-8994 EMAIL: PATRICK.JOYCE@KIMLEY-HORN.COM

ARCHITECT SIXTWENTYONE 1705 SUMMIT ST. KANSAS CITY, MO 64108 CONTACT: JACOB LITTRELL, RA, LEED AP BD+C

TEL: (816) 694-1369 EMAIL: JACOB@SIXTWENTYONE.COM

LANDSCAPE: LANDWORKS STUDIO 102 S CHERRY ST.

OLATHE, KS 66061 CONTACT: ERICA FLAD, PLA, LEED GA TEL: (913) 780-6707 EMAIL: ERICA@LANDWORKSSTUDIO.COM

#### UTILITY AND GOVERNING AGENCY CONTACTS

#### STORMWATER: SANITARY & WATER:

CITY OF LEE'S SUMMIT 1200 SE HAMBLEN RD. LEE'S SUMMIT, MO 64081 TEL: (816) 969-1900

**EVERGY**:

DOUG DAVIN

1300 SE HAMBLEN RD.

TEL: (816) 347-4320

LEE'S SUMMIT, MO 64081

STREETS: CITY OF LEE'S SUMMIT **RONALD GIPFERT** MICHAEL PARK 500 E 8TH ST. 220 SE GREEN ST. KANSAS CITY, MO 64106 LEE'S SUMMIT, MO 64063 TEL: (816) 275-1550 TEL: (8160 969-1800

MISSOURI GAS ENERGY:

RICHARD FROCK 3025 SW CLOVER DR. LEE'S SUMMIT, MO 64082 TEL: (816) 472-3489

CITY OF LEE'S SUMMIT

LEE'S SUMMIT, MISSOURI 64063

PUBLIC WORKS

220 SE GREEN ST.

TEL: (816) 969-1800

CITY OF LEE'S SUMMIT, JACKSON COUNTY, MISSOURI NW  $\frac{1}{4}$ , SECTION S17, TOWNSHIP 47N, RANGE 31W

#### **GENERAL NOTES:**

- 1. THE CONSTRUCTION COVERED BY THESE PLANS SHALL CONFORM TO ALL APPLICABLE STANDARDS AND SPECIFICATIONS OF THE PUBLIC WORKS DEPARTMENT OF THE CITY OF LEE'S SUMMIT, MISSOURI, IN ALL USAGE AND ALL SUPPLEMENTS THERE TO.
- 2. CONTRACTOR IS RESPONSIBLE FOR ALL PERMITS, BONDS, AND INSURANCE REQUIRED BY THE CITY

- 5. THE UTILITY LOCATIONS SHOWN ON THESE PLANS ARE TAKEN FROM UTILITY COMPANY RECORDS AND ARE APPROXIMATE ONLY. THEY DO NOT CONSTITUTE ACTUAL FIELD
- 7. ALL EXCESS MATERIAL SHALL BE REMOVED LEGALLY FROM SITE AND DISPOSED OF OFF SITE
- 8. TRAFFIC CONTROL AND MAINTENANCE OF TRAFFIC DURING CONSTRUCTION SHALL BE THE RESPONSIBILITY OF THE CONTRACTOR AND SHALL BE IN ACCORDANCE WITH THE
- CONTRACTOR'S EXPENSE.
- 10. ANY EXISTING OR NEW STORM SEWER INLETS IN USE DURING DEMOLITION, GRADING OR CONSTRUCTION SHALL HAVE INLET PROTECTION AS SPECIFIED

### HISTORIC INFORMATION

THIS STRUCTURE IS NOT LISTED IN THE NATIONAL REGISTER OF HISTORIC PLACES.

THIS SITE IS NOT LOCATED IN A LOCAL HISTORIC DISTRICT PER THE MISSOURI DEPARTMENT OF NATURAL RESOURCES HISTORIC DISTRICTS AND SITES DATABASE, ACCESSED JUNE 27, 2023.

#### FEMA INFORMATION

THIS SITE IS LOCATED WITHIN ZONE X PER FEMA FIRM MAPS 29095C0438G: EFFECTIVE DATE JANUARY 20, 2017, NO LETTERS OF MAP AMENDMENT OR REVISION ARE BEING PROPOSED.

#### LEGAL DESCRIPTION

LOT 3A, DECKER STREET MINOR PLAT, LOTS 2A AND 3A, A SUBDIVISION IN LEE'S SUMMIT, JACKSON COUNTY, MISSOURI, ACCORDING TO THE PLAT RECORDED AUGUST 6, 2021.

#### PROJECT SPECIFICATIONS

THE SPECIFICATIONS FOR THIS PROJECT SHALL BE THE FOLLOWING: 1. THE CITY OF LEE'S SUMMIT, MISSOURI KANSAS CITY METRO APWA

THE STANDARD SPECIFICATIONS THROUGH AND INCLUDING THE LATEST AMENDMENTS SHALL BE PART OF THESE PROJECT DRAWINGS AND SPECIFICATION AND ARE INCORPORATED HEREIN BY REFERENCE. THE MORE STRINGENT OF THESE STANDARD SPECIFICATIONS AND THOSE PREPARED BY THE ENGINEERING PREPARING THESE PLANS SHALL GOVERN.

### OIL AND GAS WELL NOTES

NO ABANDONED OIL OR GAS WELLS HAVE BEEN IDENTIFIED WITHIN THE PROPERTY LIMITS OF THE PROPOSED CONSTRUCITON ACTIVITIES, PER THE MISSOURI DEPARTMENT OF NATURAL RESOURCES (MDNR) PERMITTED OIL AND GAS DATABASE, ACCESSED JUNE 27, 2023.

#### FIRE CODE

ALL ISSUES OERTAINING TO LIFE, SAFETY, AND PROPERTY PROTECTION FROM THE HAZARDS OF FIRE, EXPLOSION OR DANGEROUS CONDITIONS IN NEW AND EXISTING BUILDINGS, STRUCTURES AND PREMISES, AND TO THE SAFETY TO FIRE FIGHTERS AND EMERGENCY RESPONDERS DURING EMERGENCY OPERATIONS, SHALL BE IN ACCORDANCE WITH THE 2018 INTERNATIONAL FIRE CODE.

### APPROXIMATE TOTAL ACREAGE: 2.13 AC LIMITS OF DISTURBANCE: 1.81 AC

WATERSHED: BIG CREEK



**LOCATION MAP** 



TY	TYPICAL LEGEND				
	PROPOSED STANDARD DUTY ASPHALT PAVEMENT				
A 4. A 4. A	PROPOSED HEAVY DUTY CONCRETE PAVEMENT				
	PROPOSED BUILDING				
	EXISTING PUBLIC ROADWAY				
	EXISTING 60' STREAM BUFFER				
	PROPERTY LINE				
	PROPOSED BUILDING OUTLINE				
	EASEMENT LINE				
	SETBACK LINE				
	STANDARD CURB & GUTTER				
SAN	EXISTING SANITARY SEWER				
w	EXISTING WATER LINE				
FO	EXISTING FIBER OPTIC				
——— G ———	EXISTING GAS				
—— Р ——	EXISTING POWER				
— т —	EXISTING TELECOMMUNICATIONS				
w	PROPOSED WATER LINE				
UE	PROPOSED UNDERGROUND ELECTRIC				
ss	PROPOSED SANITARY SEWER				

SHEET INDEX				
Sheet Number	Sheet Title			
C001	COVER SHEET			
C002	EXISTING CONDITIONS			
C003	SITE PLAN			
C004	GRADING PLAN			
C005	ADA RAMPS			
C006	UTILITY & STORMWATER PLAN			
C007	STORMWATER PLAN & PROFILE			
C008	STORMWATER PLAN & PROFILE			
C009A	CONTECH HDS DETAILS			
C009B	DETAILS			
C010	DETAILS			
C011	DETAILS			
C012	DETAILS			
L001	LANDSCAPE PLAN			
L002	LANDSCAPE DETAILS			
A101	FLOOR PLANS			
A201	ELEVATIONS - BUILDING A			
A202	ELEVATIONS - BUILDING B			
A203	RENDERINGS			
A204	TRASH ENCLOSURE PLAN & DETAILS			
M101	MECHANICAL FLOOR PLANS			
E001	SITE PHOTOMETRICS			
F001	FIRE SUPPRESSION			
F101	FIRE SUPPRESSION FLOOR PLANS			
F500	FIRE SUPPRESSION DETAILS			


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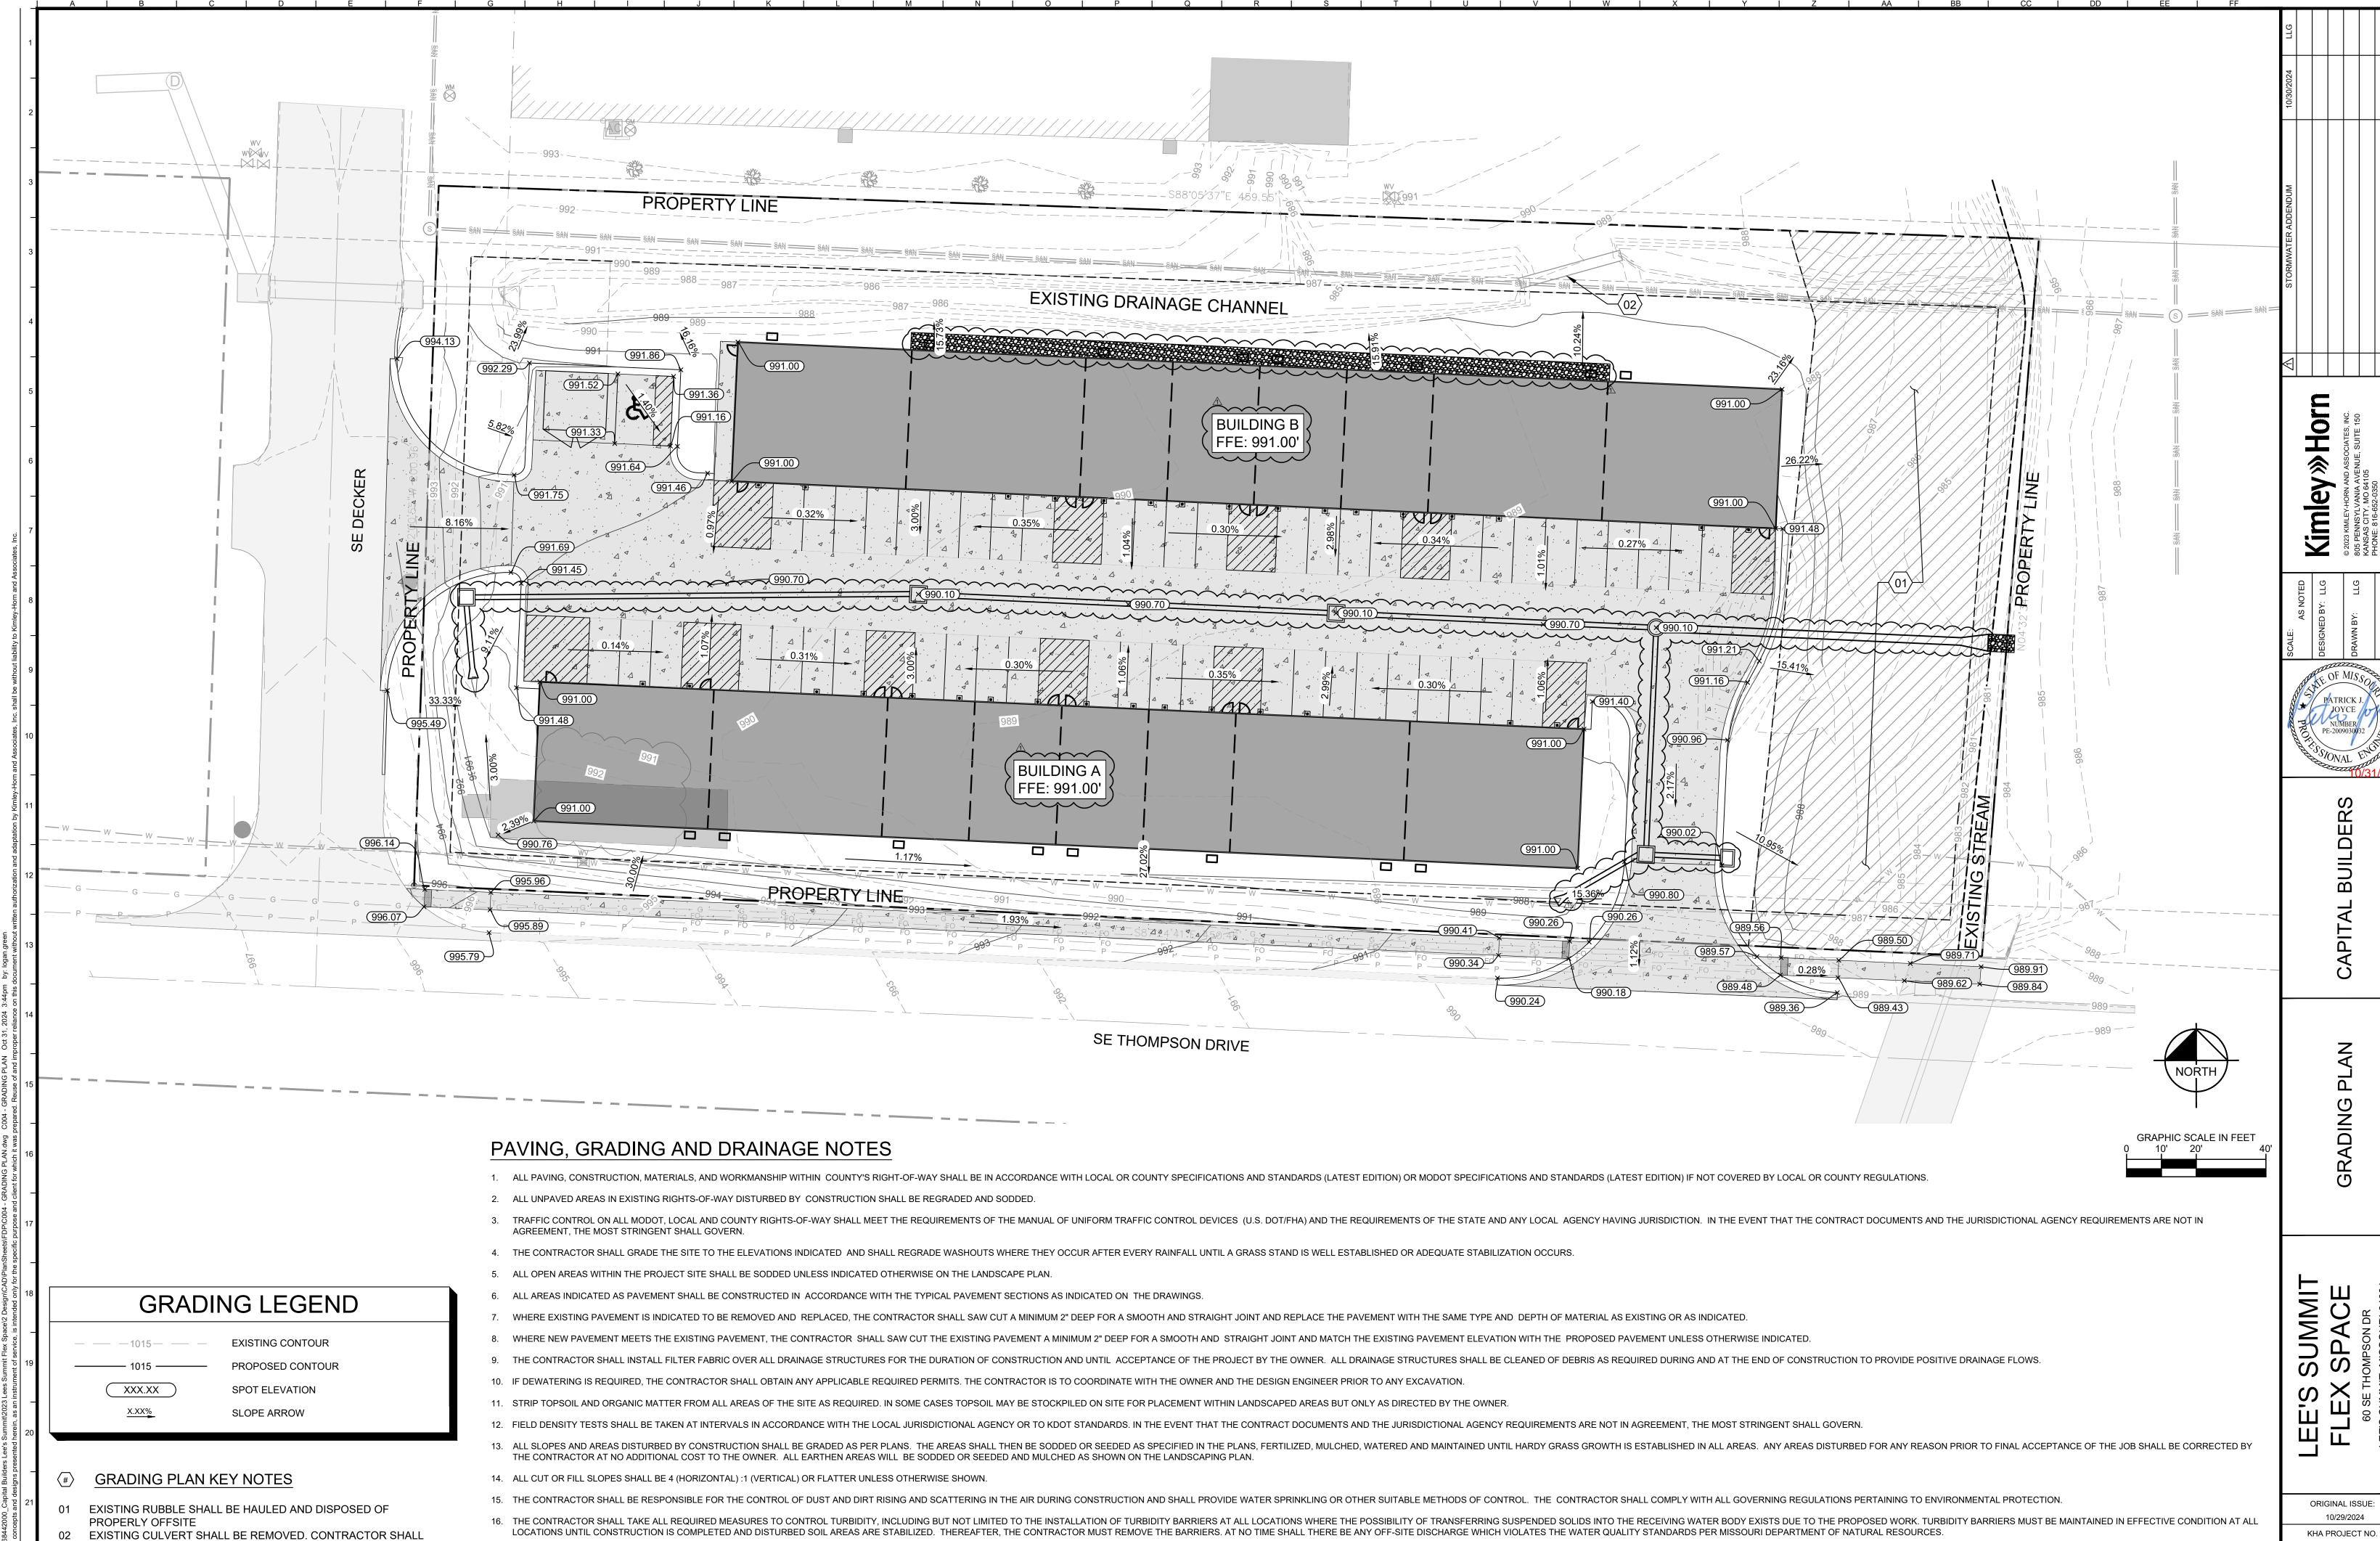
ORIGINAL ISSUE: 10/29/2024 KHA PROJECT NO. 268442000

C001

SHEET NUMBER





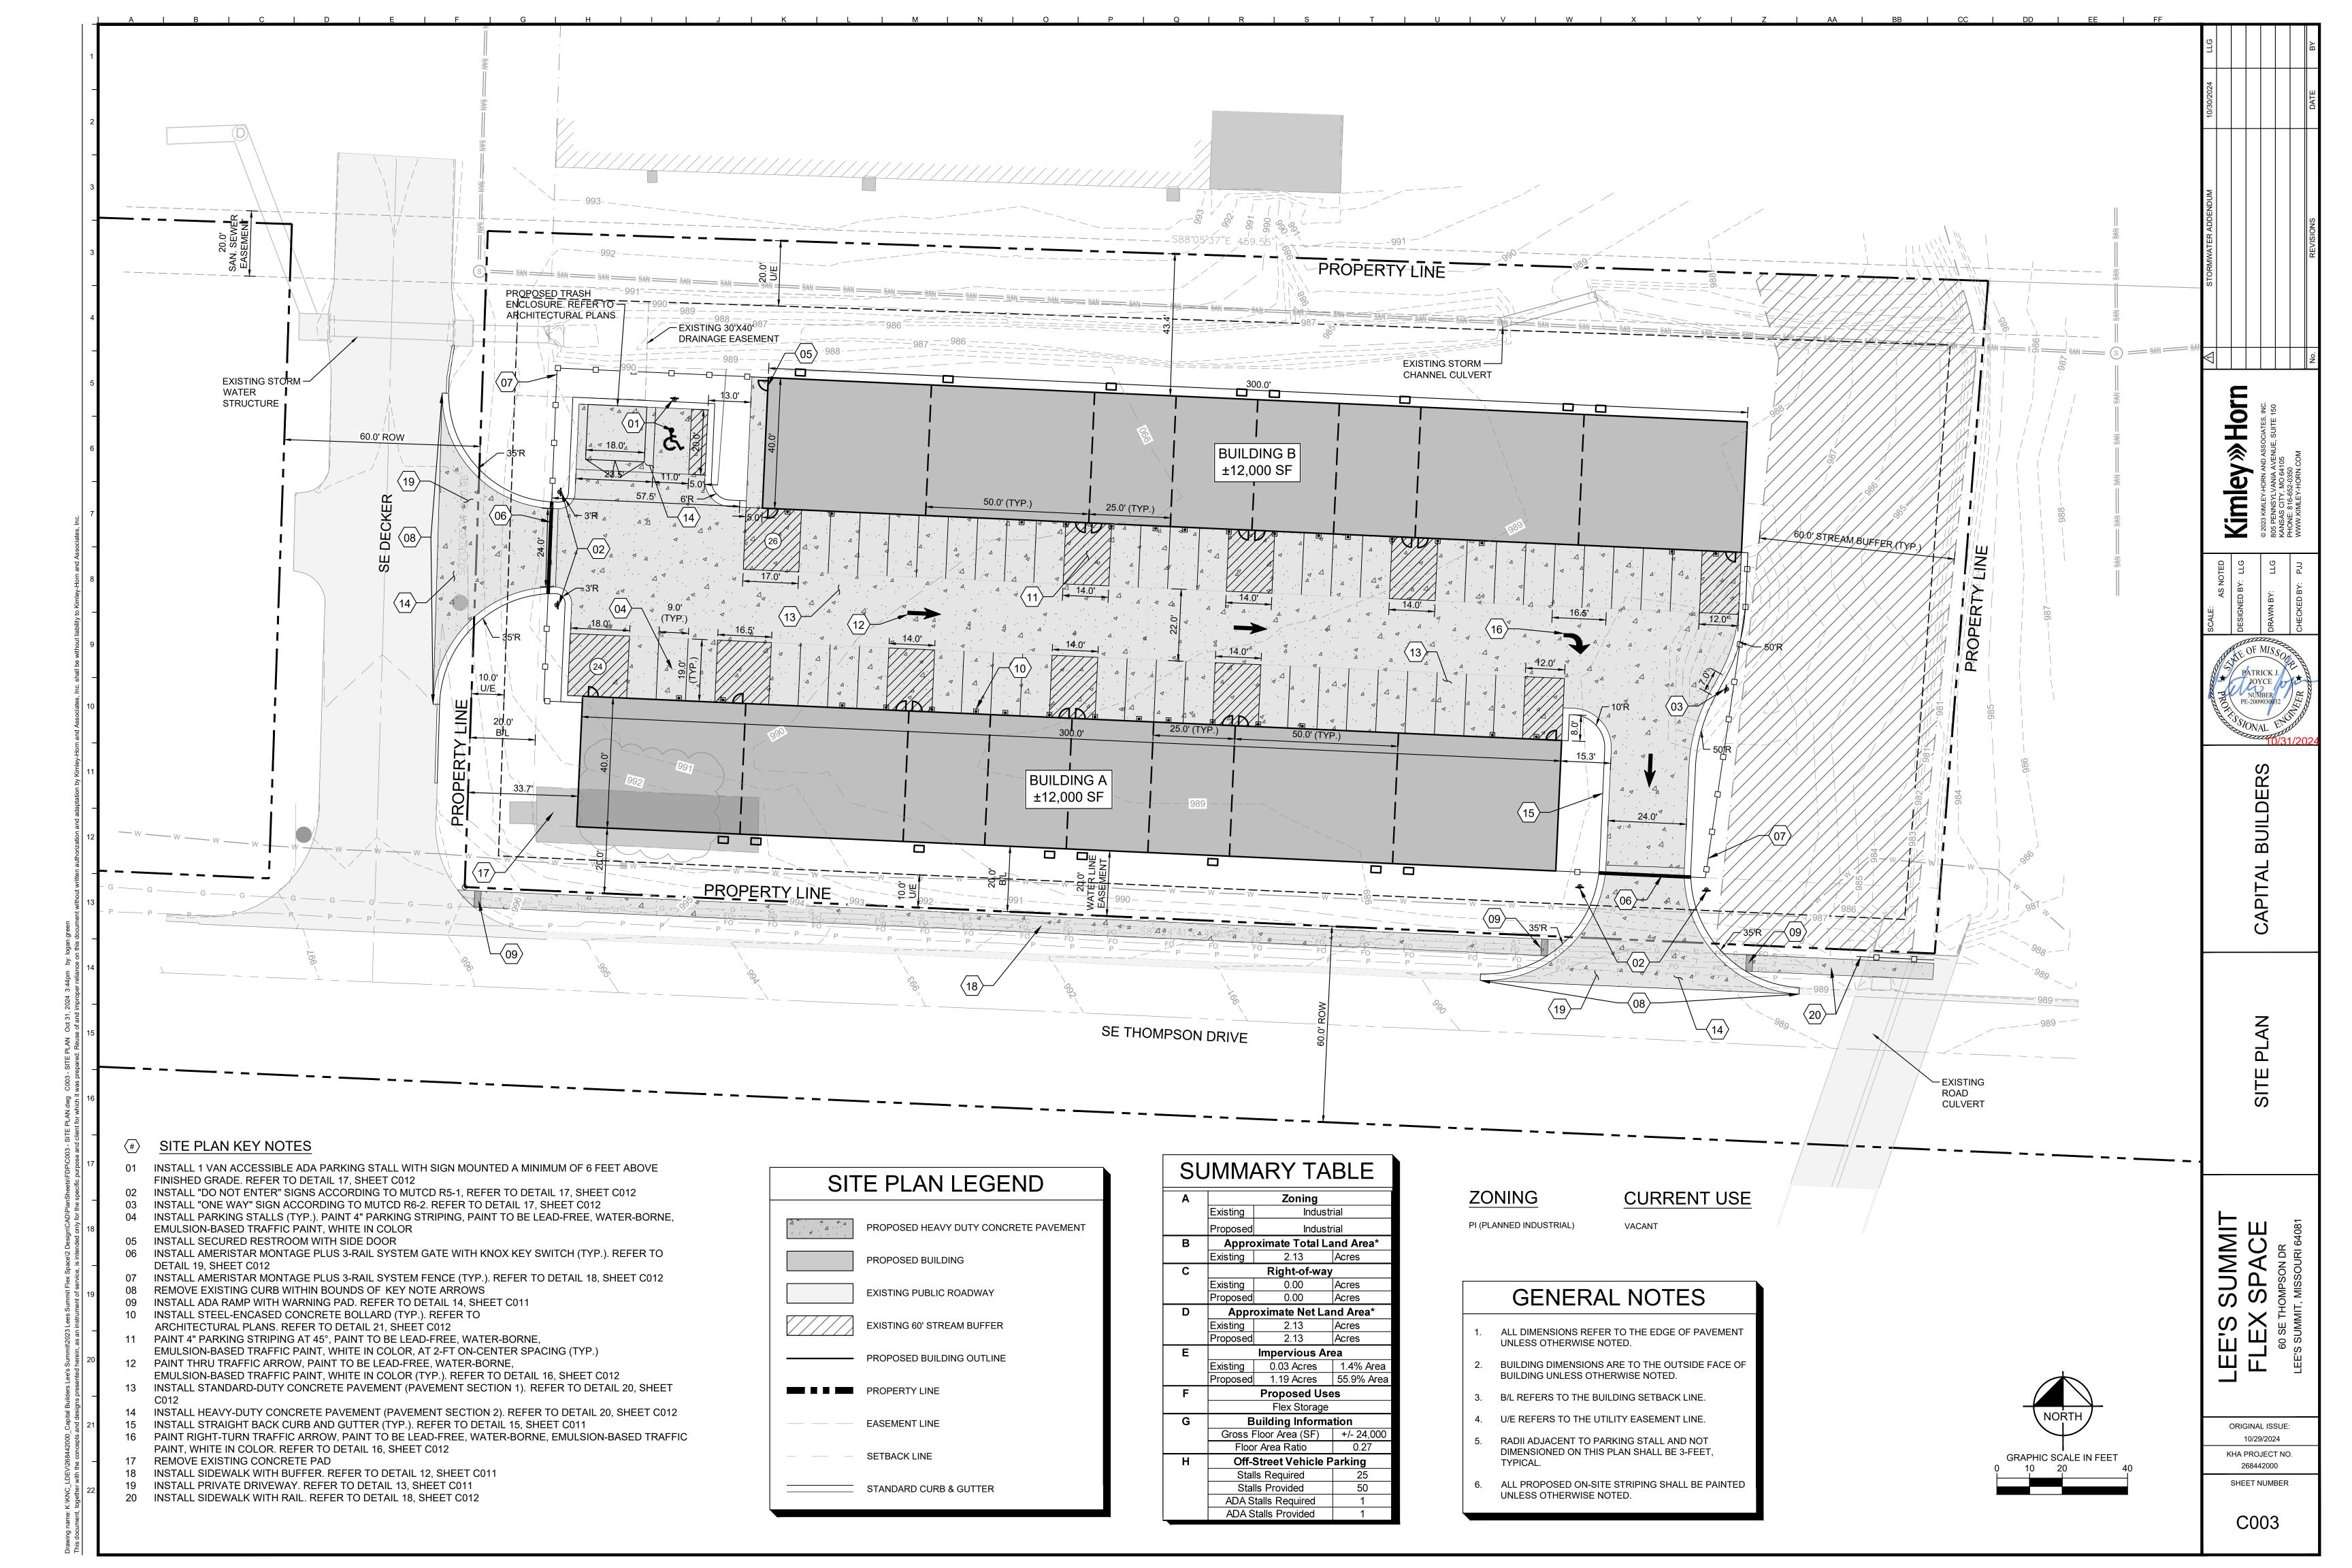

17. SOD, WHERE CALLED FOR, MUST BE INSTALLED AND MAINTAINED ON EXPOSED SLOPES WITHIN 48 HOURS OF COMPLETING FINAL GRADING, AND AT ANY OTHER TIME AS NECESSARY, TO PREVENT EROSION, SEDIMENTATION OR TURBID DISCHARGES.

20. THE CONTRACTOR SHALL INSTALL ALL UNDERGROUND STORM WATER PIPING PER MANUFACTURER'S RECOMMENDATIONS.

18. THE CONTRACTOR MUST REVIEW AND MAINTAIN A COPY OF THE ENVIRONMENTAL RESOURCE PERMIT COMPLETE WITH ALL CONDITIONS, ATTACHMENTS, EXHIBITS, AND PERMIT MUST BE AVAILABLE FOR REVIEW UPON REQUEST BY WATER MANAGEMENT DISTRICT REPRESENTATIVES.

19. THE CONTRACTOR SHALL ENSURE THAT ISLAND PLANTING AREAS AND OTHER PLANTING AREAS ARE NOT COMPACTED AND DO NOT CONTAIN ROAD BASE MATERIALS. THE CONTRACTOR SHALL ENSURE THAT ISLAND PLANTING AREAS AND OTHER PLANTING AREAS ARE NOT COMPACTED AND DO NOT CONTAIN ROAD BASE MATERIALS. THE CONTRACTOR SHALL ENSURE THAT ISLAND PLANTING AREAS AND OTHER PLANTING AREAS ARE NOT COMPACTED AND PROPERLY DISPOSED OF IN A LEGAL MANNER.

REGRADE TO MAINTAIN EXISTING DRAINAGE PATTERNS

LIMITS OF DISTURBANCE: 1.81 AC

SHEET NUMBER

C004

268442000

### ADA RAMP 1 ADA RAMP 2 **Kimley** » Horn ADA WARNING PAD 990.41 996.14 990.26 ADA WARNING PAD 995.96 1.91% 995.97 1,49% 0.75% 0.97% 1.90% 990.26 SIDEWALK TRANSITION ZONE -SIDEWALK TRANSITION ZONE 990.34 990.18 996.07 995.89 ADA RAMP -ADA RAMP ADA RAMP 3 -ADA WARNING PAD 989.50 989.57 **GRADING LEGEND** 0.30% 1.00% SPOT ELEVATION XXX.XX TRANSITION ZONE SLOPE ARROW 989.43 989.48 -SIDEWALK KHA PROJECT NO.

ADA RAMP

**GRADING PLAN KEY NOTES** 

01 INSTALL ADA SIDEWALK RAMP WITH WARNING PAD. REFER TO DETAIL 14, SHEET C011


02 INSTALL SIDEWALK WITH BUFFER. REFER TO DETAIL 12, SHEET C011


ORIGINAL ISSUE:


10/29/2024


268442000 SHEET NUMBER

C005

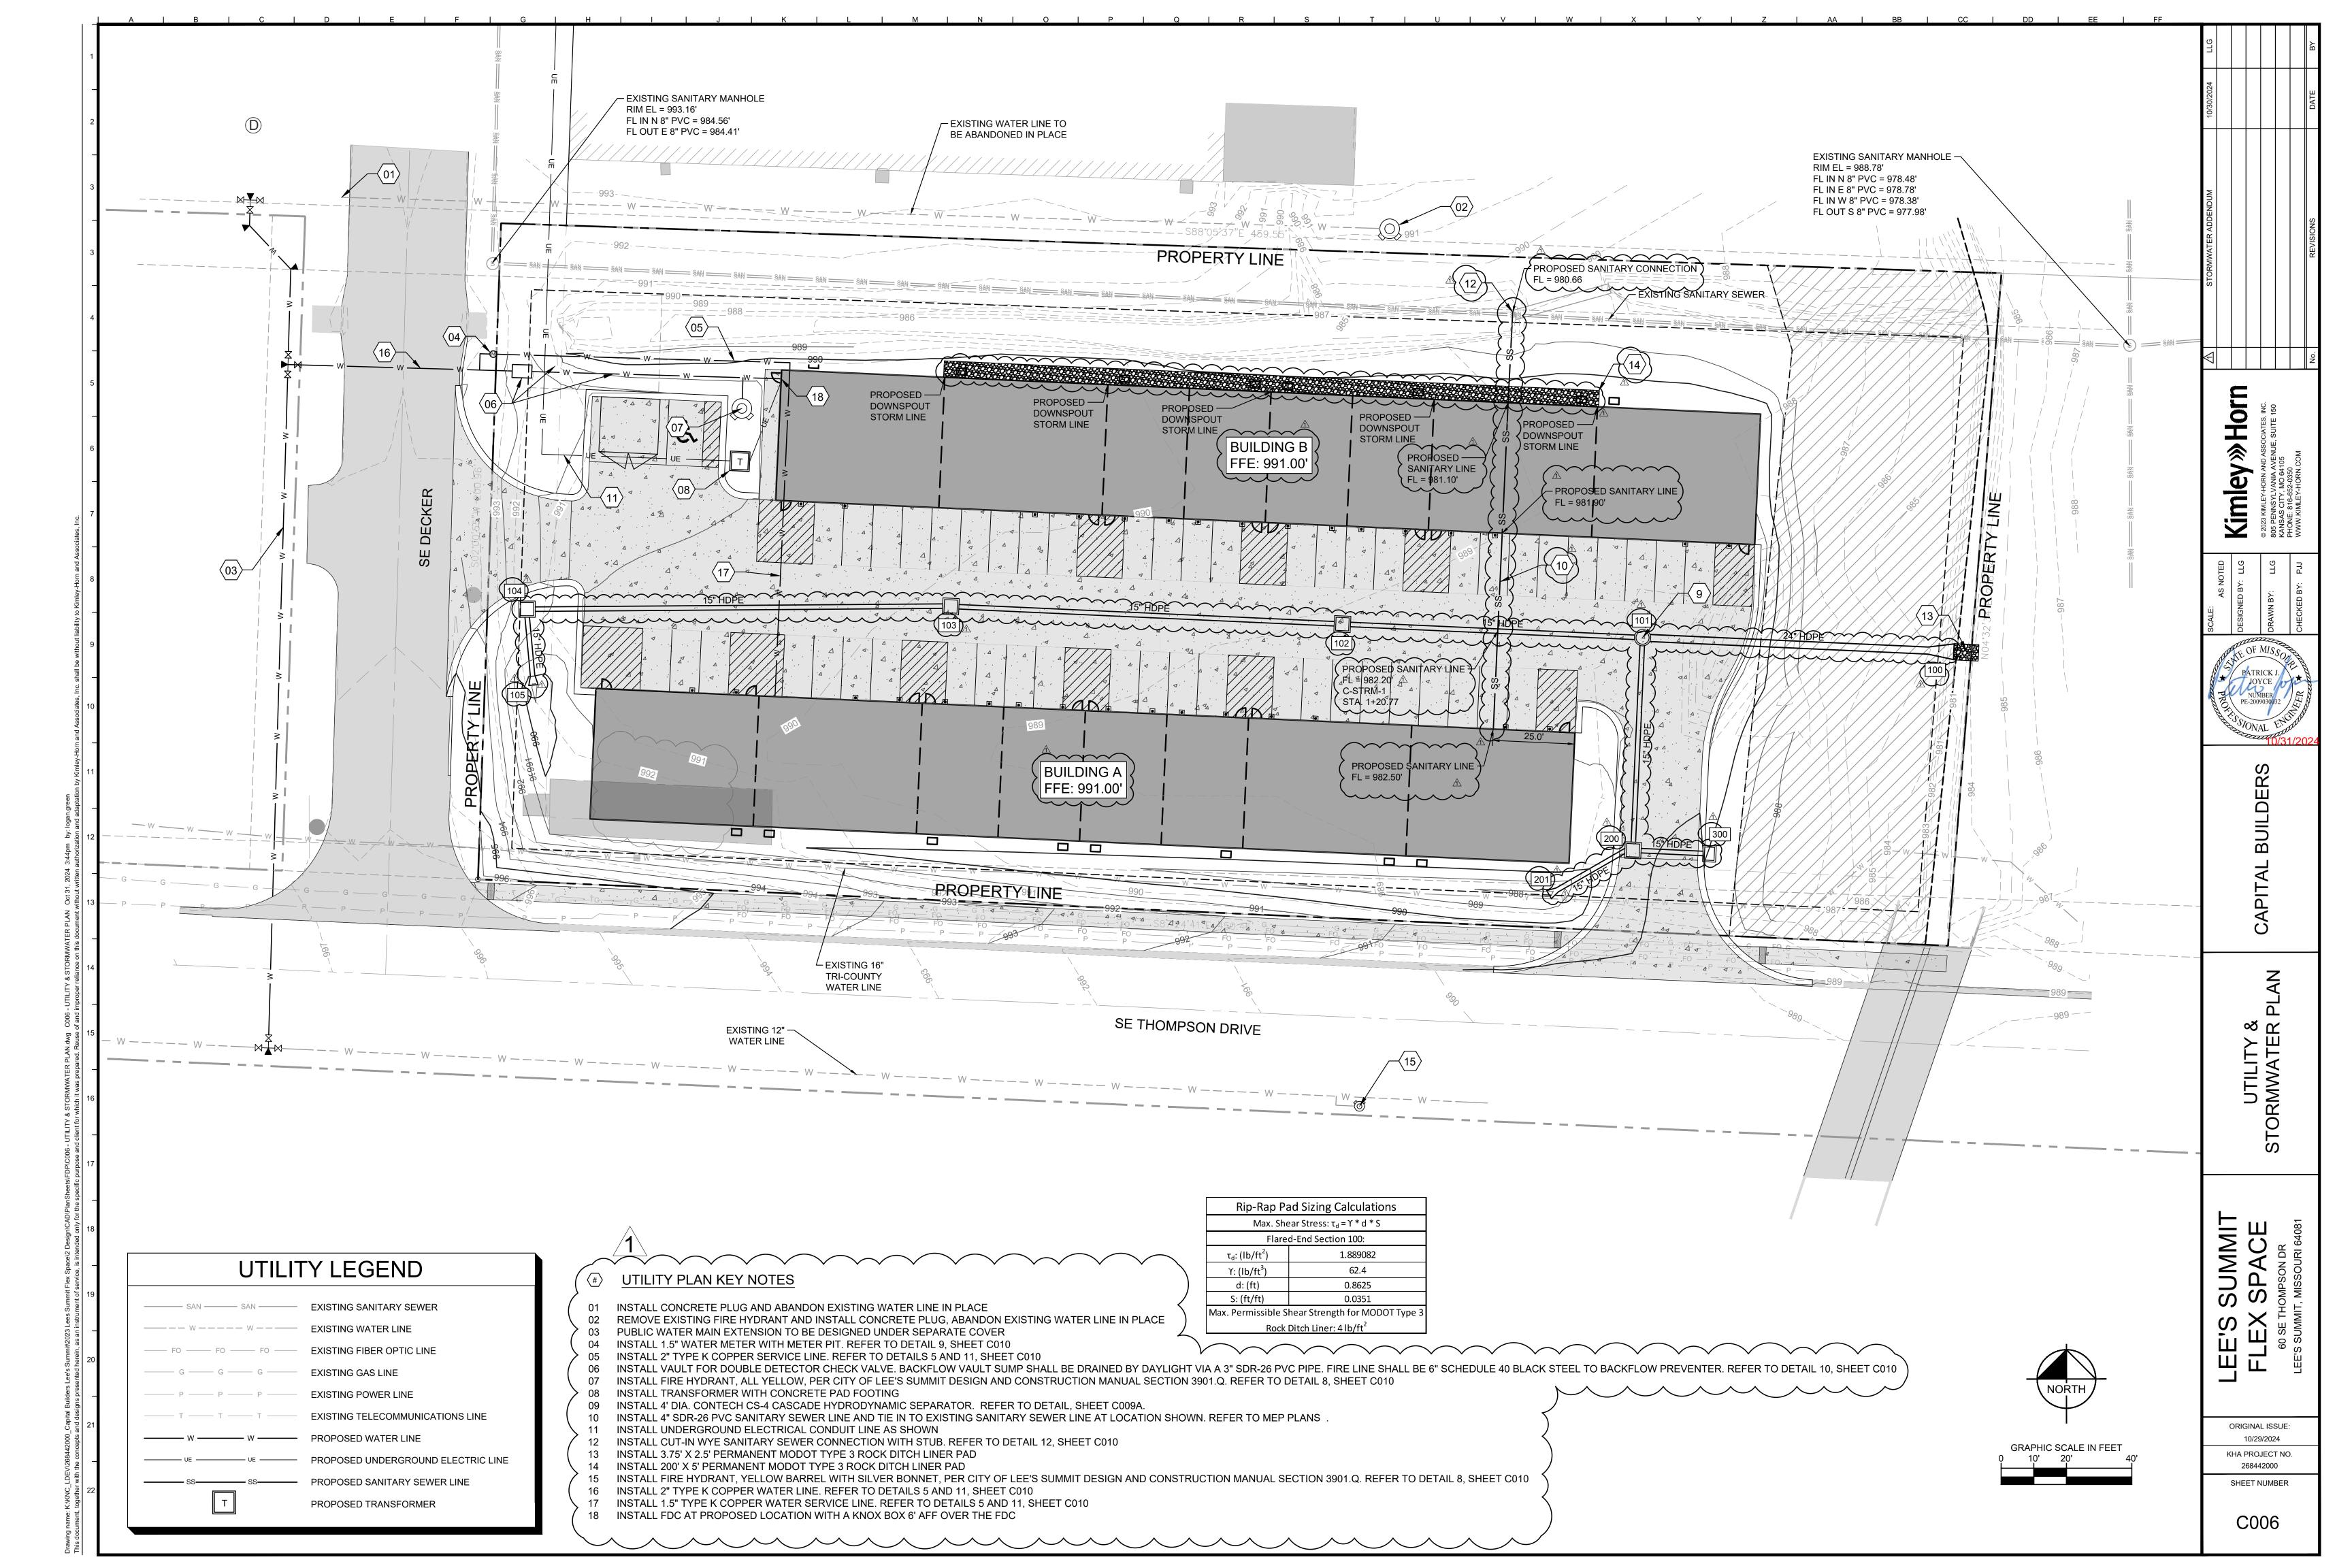

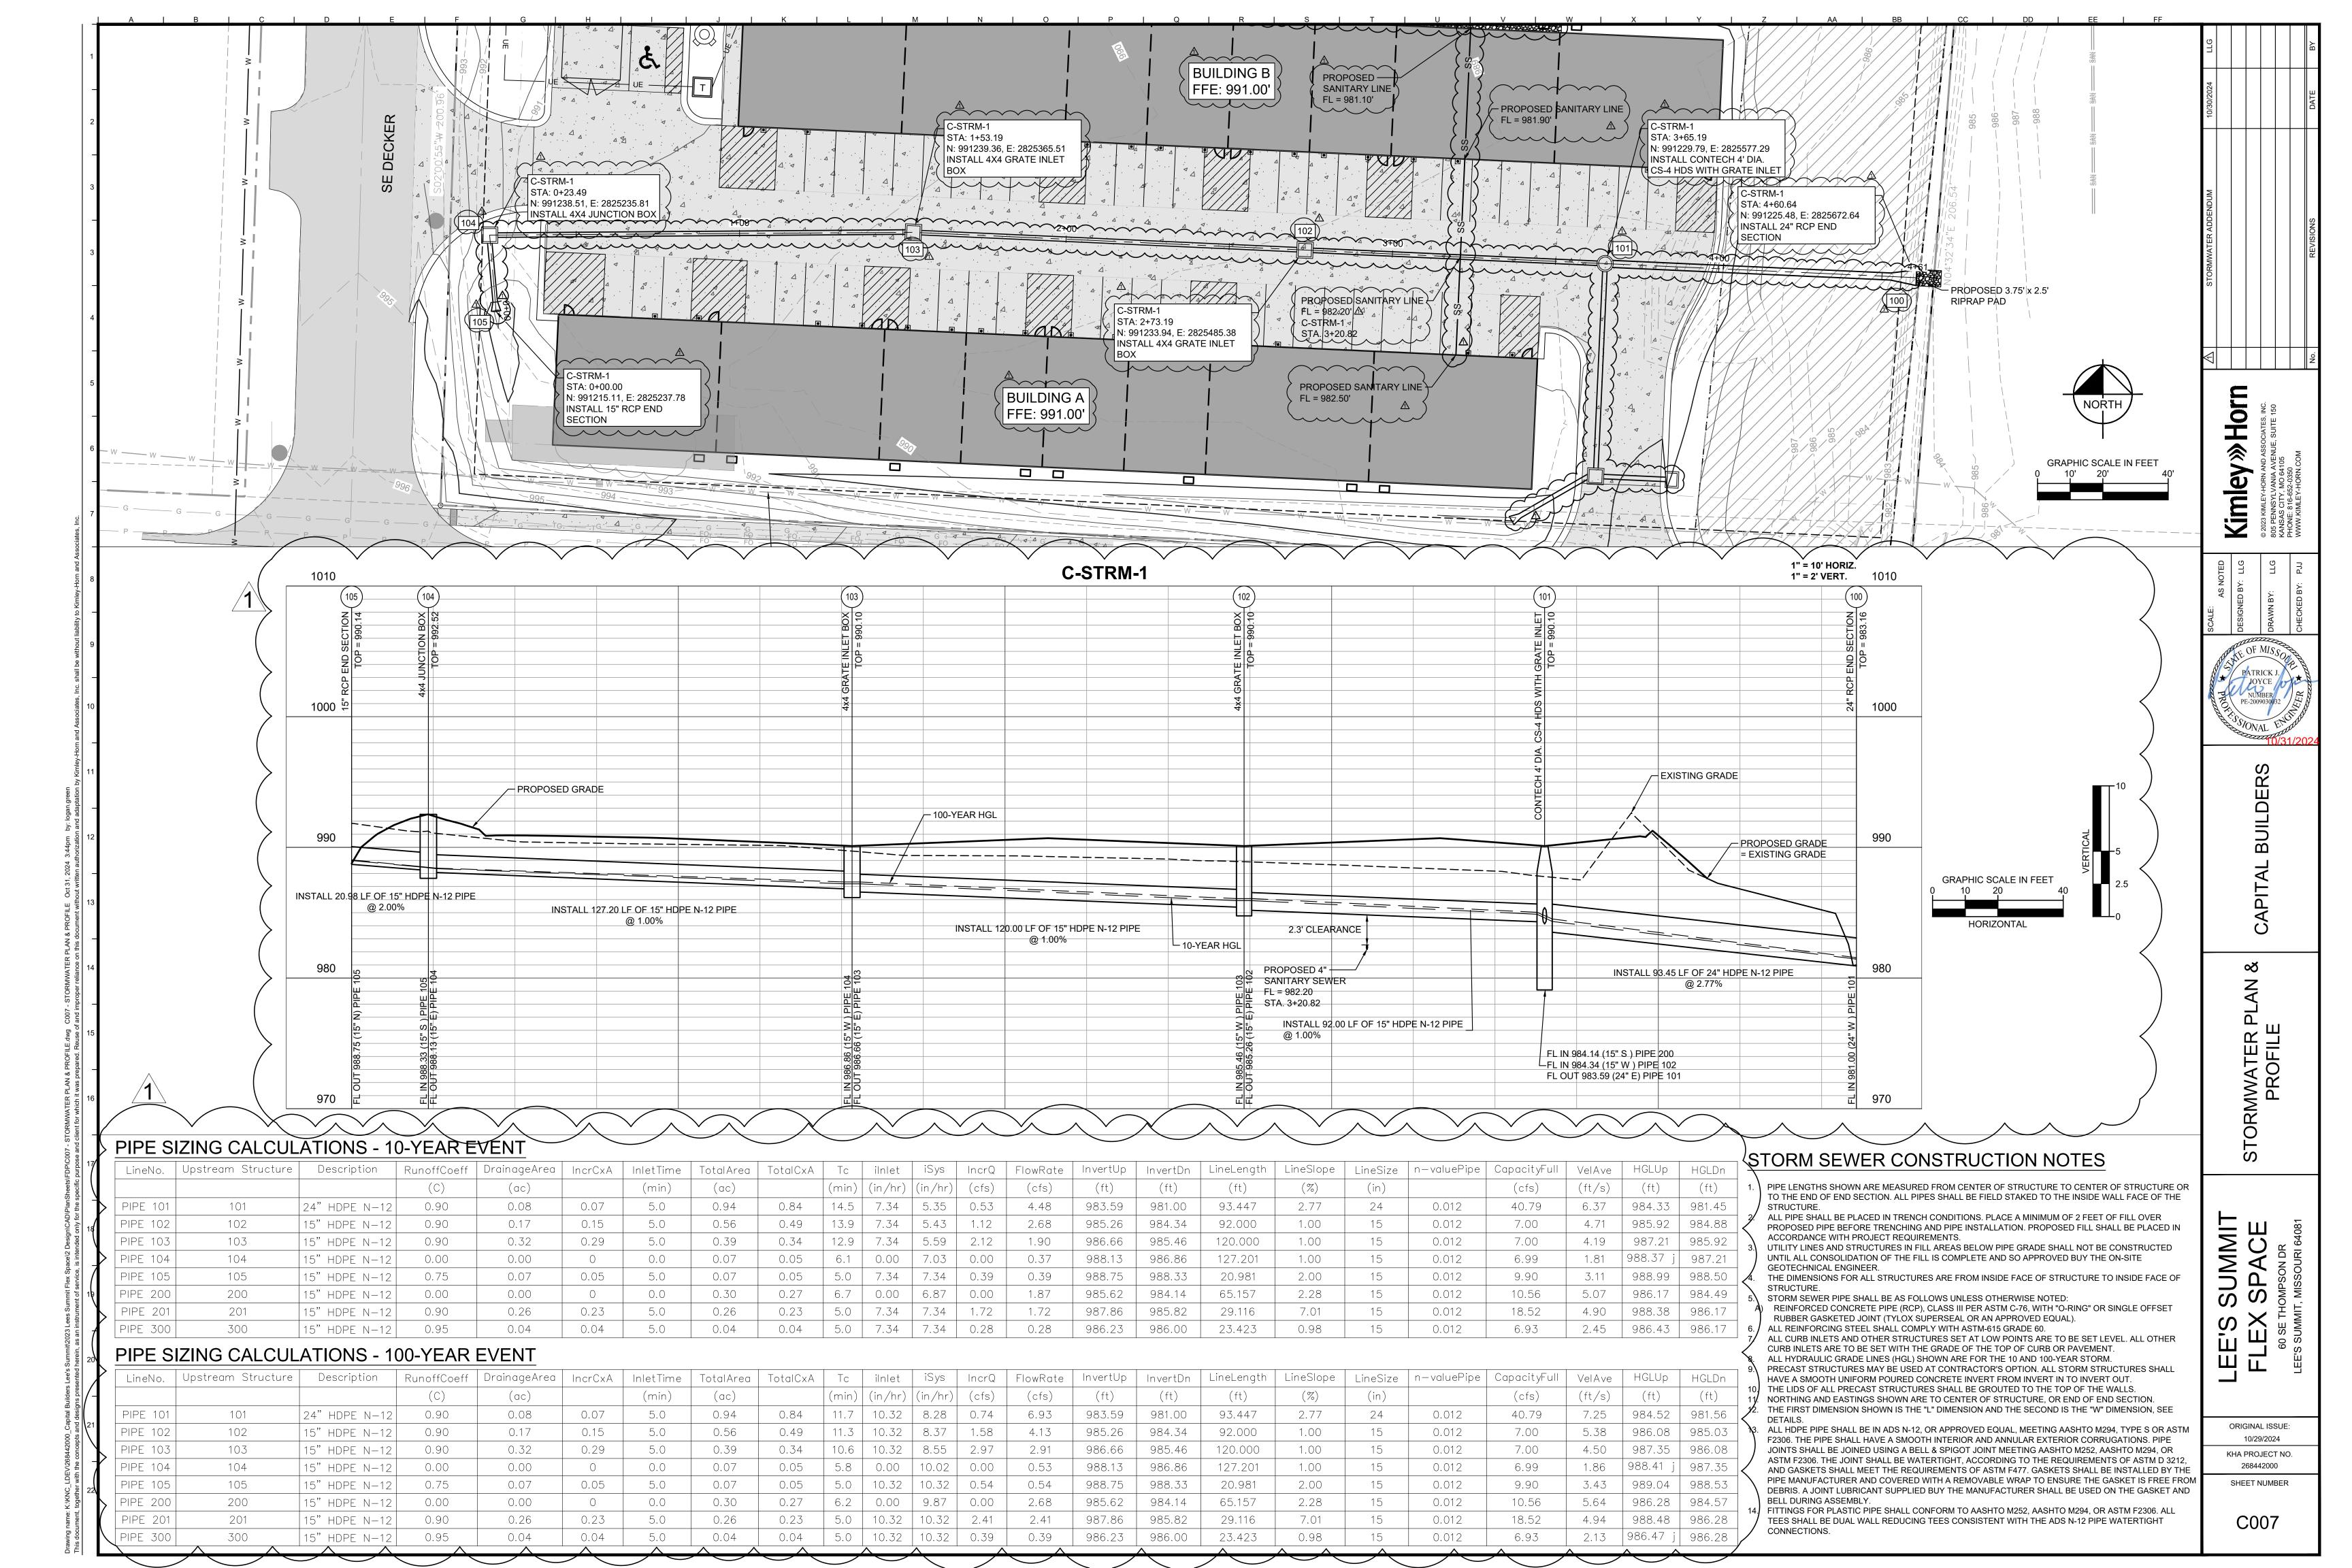

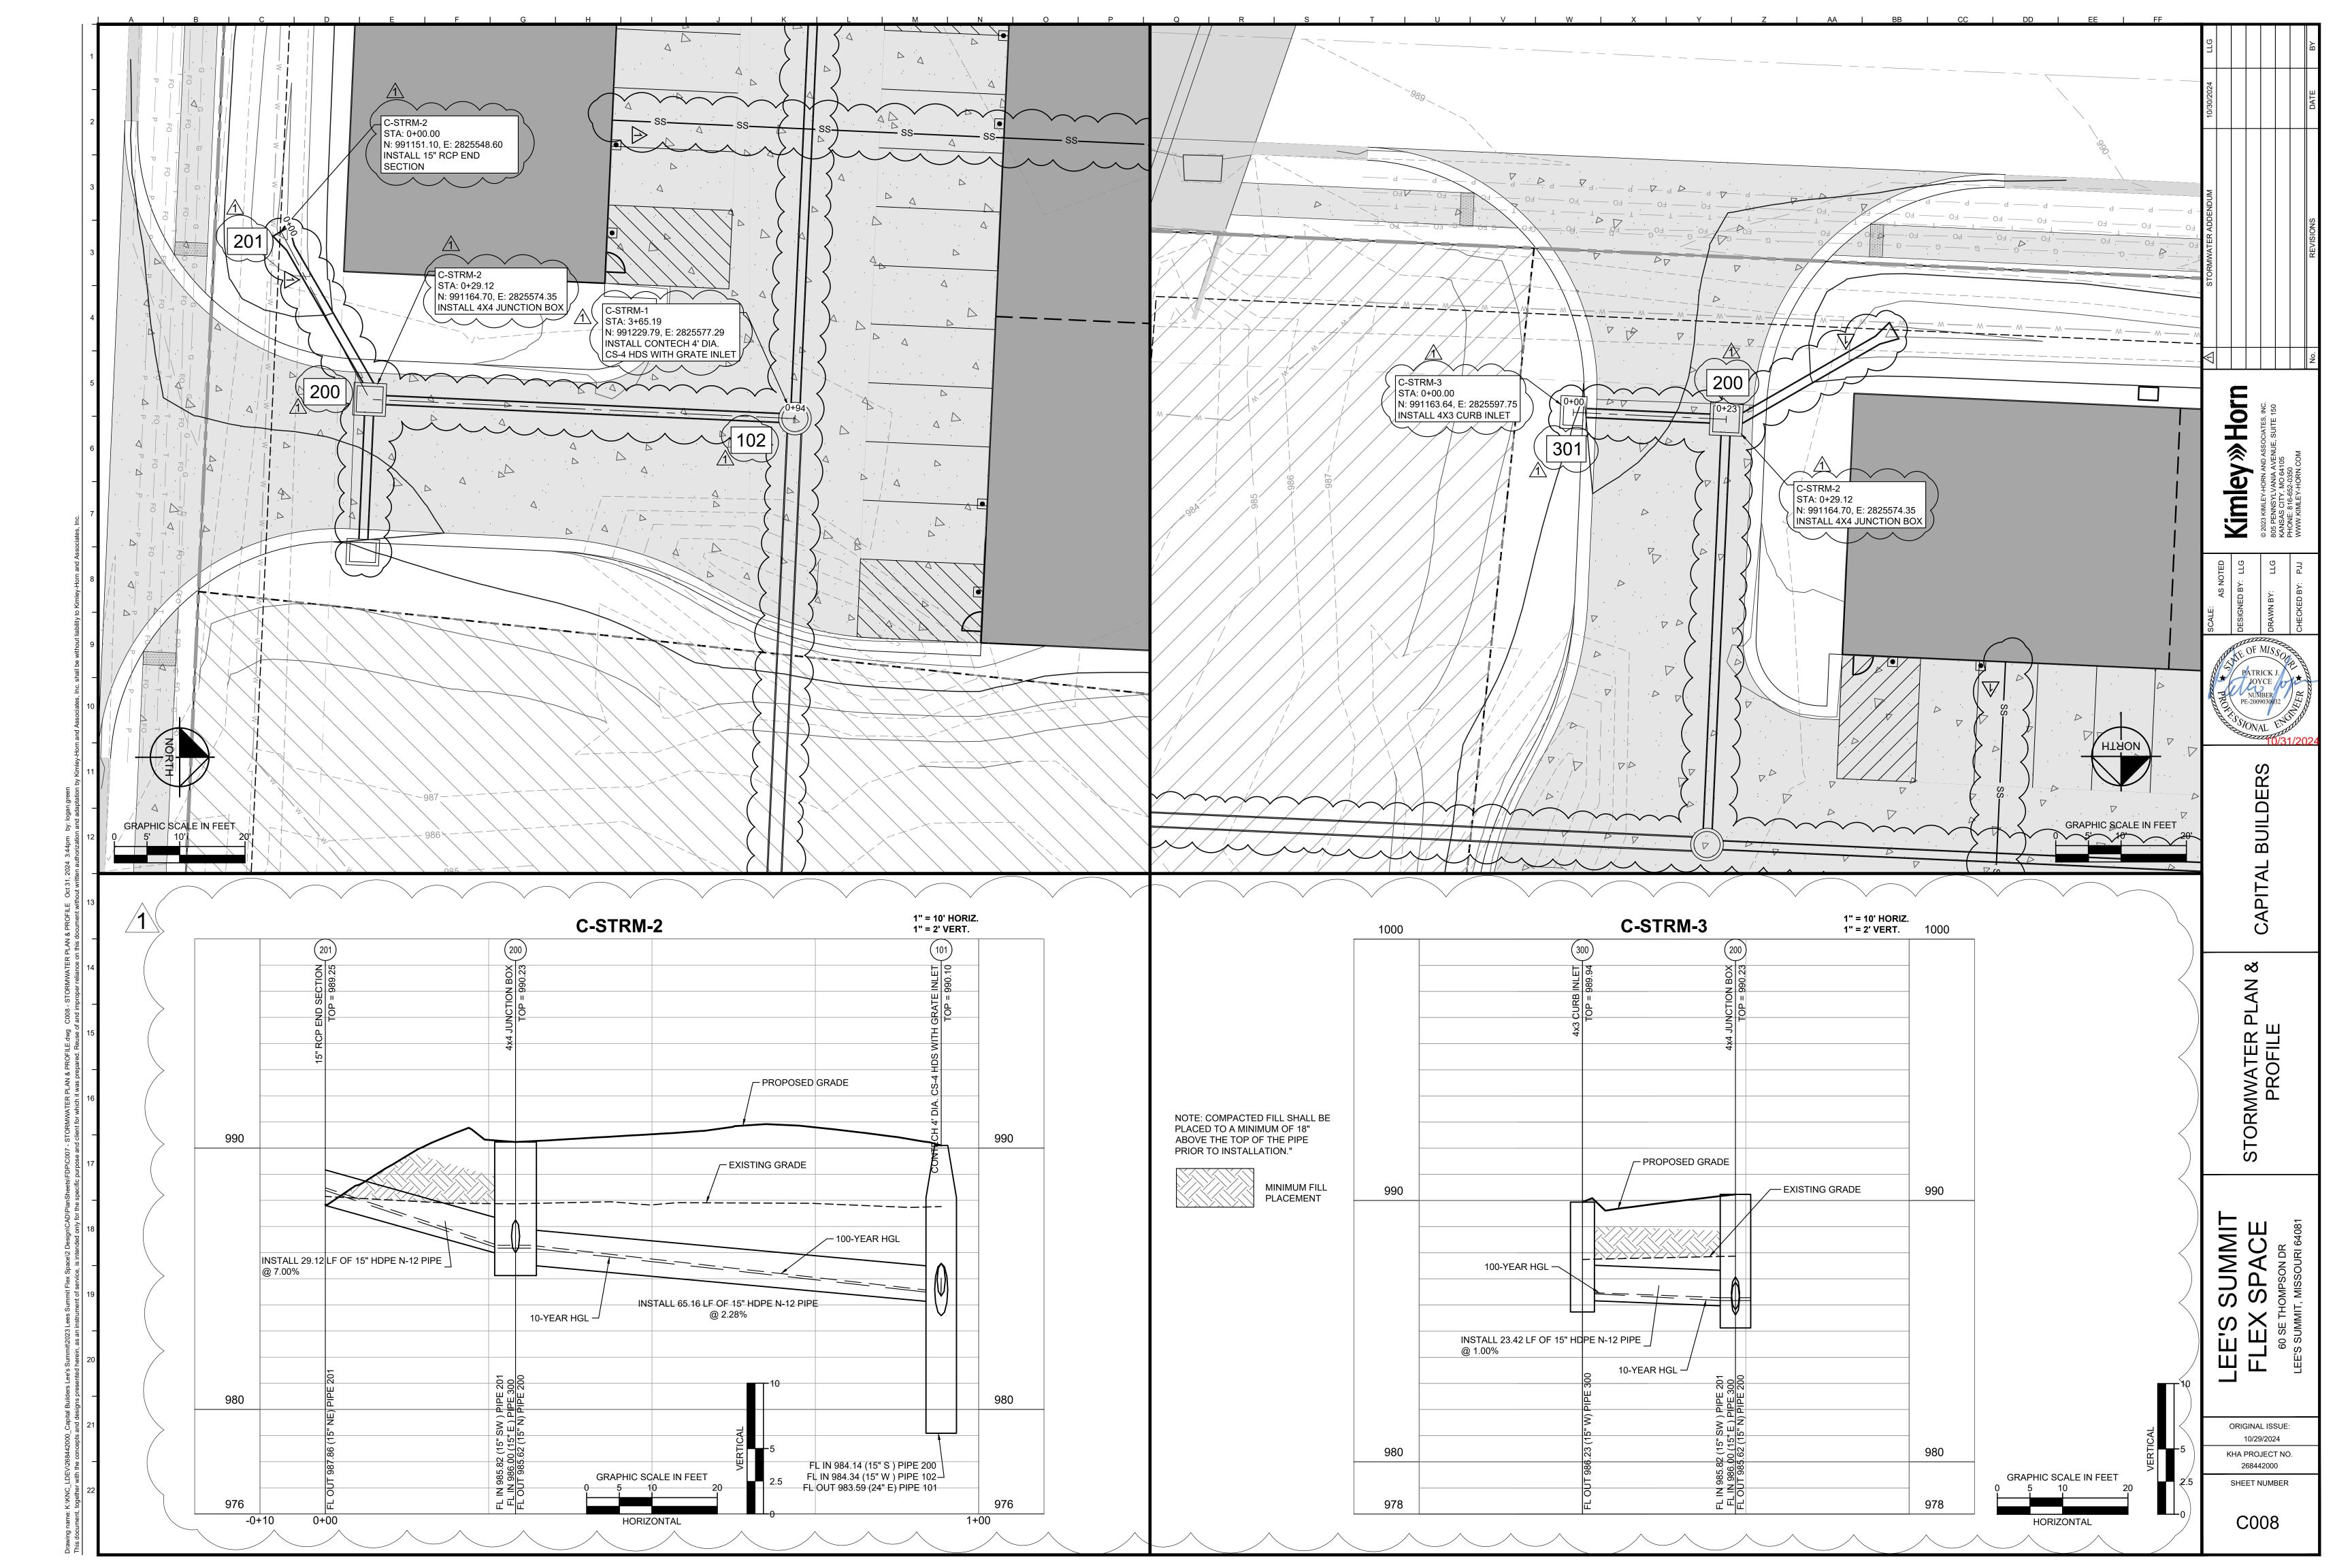

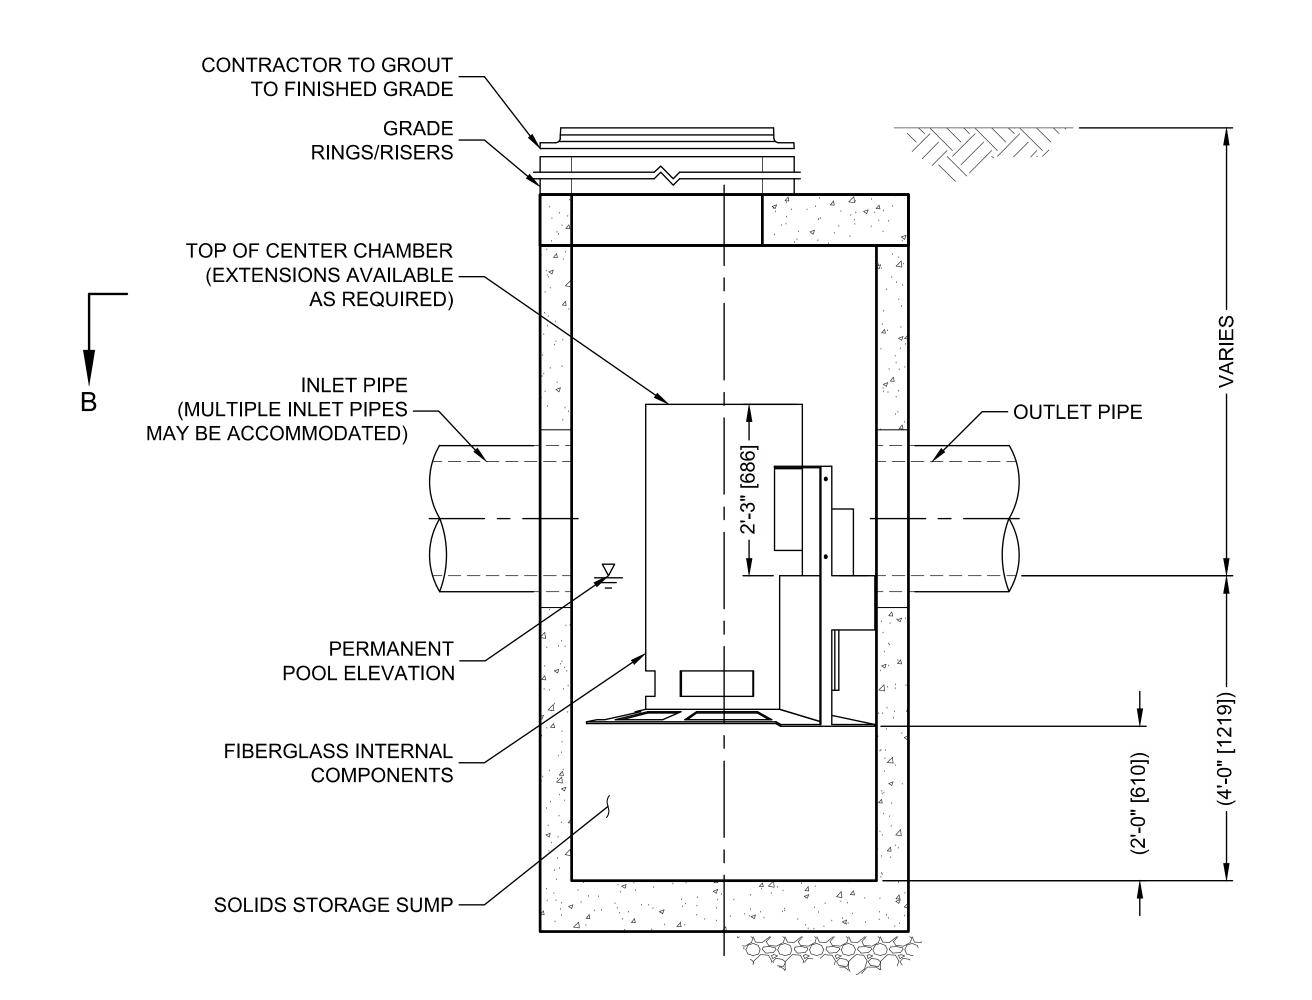

ELEVATION A-A
NOT TO SCALE

CASCADE separator™

#### CS-4 DESIGN NOTES

THE STANDARD CS-4 CONFIGURATION IS SHOWN. ALTERNATE CONFIGURATIONS ARE AVAILABLE AND ARE LISTED BELOW. SOME CONFIGURATIONS MAY BE COMBINED TO SUIT SITE REQUIREMENTS.


#### CONFIGURATION DESCRIPTION

GRATED INLET ONLY (NO INLET PIPE)

GRATED INLET WITH INLET PIPE OR PIPES

CURB INLET ONLY (NO INLET PIPE)

CURB INLET WITH INLET PIPE OR PIPES

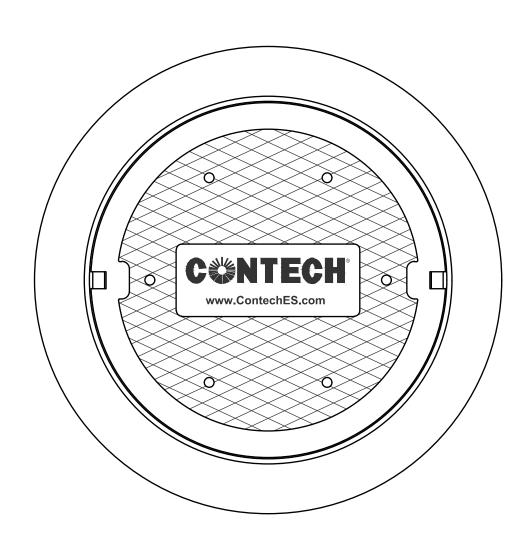

## FRAME AND COVER (DIAMETER VARIES) NOT TO SCALE

## SITE SPECIFIC DATA REQUIREMENTS

STRUCTURE ID	101
WATER QUALITY FLOW RATE (CFS OR L/s)	1.5
PEAK FLOW RATE (CFS OR L/s)	17
RETURN PERIOD OF PEAK FLOW (YRS)	100

PIPE DATA:	I.E.	MATERIAL	DIAMETER
INLET PIPE 1	984.14	HDPE	15"
INLET PIPE 2	984.34	HDPE	15"
OUTLET PIPE	983.59	HDPE	24"

RIM ELEVATION		990.10
ANTI-FLOTATION BALLAST	WIDTH	HEIGHT
	*	*
		i

#### NOTES/SPECIAL REQUIREMENTS:

CONTECH CS-4 HDS SHALL BE INSTALLED WITH CLAY AND BAILEY NO. 2153 FRAME AND NO. 2152 GRATE INLET OR APPROVED EQUAL

\* PER ENGINEER OF RECORD



#### **GENERAL NOTES**

- 1. CONTECH TO PROVIDE ALL MATERIALS UNLESS NOTED OTHERWISE.
- 2. FOR SITE SPECIFIC DRAWINGS WITH DETAILED STRUCTURE DIMENSIONS AND WEIGHT, PLEASE CONTACT YOUR CONTECH ENGINEERED SOLUTIONS LLC REPRESENTATIVE. www.ContechES.com
- 3. CASCADE SEPARATOR WATER QUALITY STRUCTURE SHALL BE IN ACCORDANCE WITH ALL DESIGN DATA AND INFORMATION CONTAINED IN THIS DRAWING. CONTRACTOR TO CONFIRM STRUCTURE MEETS REQUIREMENTS OF PROJECT.
- 4. CASCADE SEPARATOR STRUCTURE SHALL MEET AASHTO HS20 LOAD RATING, ASSUMING EARTH COVER OF 0' 2', AND GROUNDWATER ELEVATION AT, OR BELOW, THE OUTLET PIPE INVERT ELEVATION. ENGINEER OF RECORD TO CONFIRM ACTUAL GROUNDWATER ELEVATION. CASTINGS SHALL MEET AASHTO M306 AND BE CAST WITH THE CONTECH LOGO..
- 5. CASCADE SEPARATOR STRUCTURE SHALL BE PRECAST CONCRETE CONFORMING TO ASTM C-478 AND AASHTO LOAD FACTOR DESIGN METHOD.


#### **INSTALLATION NOTES**

- A. ANY SUB-BASE, BACKFILL DEPTH, AND/OR ANTI-FLOTATION PROVISIONS ARE SITE-SPECIFIC DESIGN CONSIDERATIONS AND SHALL BE SPECIFIED BY ENGINEER OF RECORD.
- B. CONTRACTOR TO PROVIDE EQUIPMENT WITH SUFFICIENT LIFTING AND REACH CAPACITY TO LIFT AND SET THE CASCADE SEPARATOR MANHOLE STRUCTURE.
- C. CONTRACTOR TO INSTALL JOINT SEALANT BETWEEN ALL STRUCTURE SECTIONS AND ASSEMBLE STRUCTURE.
- D. CONTRACTOR TO PROVIDE, INSTALL, AND GROUT INLET AND OUTLET PIPE(S). MATCH PIPE INVERTS WITH ELEVATIONS SHOWN. ALL PIPE CENTERLINES TO MATCH PIPE OPENING CENTERLINES.
- E. CONTRACTOR TO TAKE APPROPRIATE MEASURES TO ASSURE UNIT IS WATER TIGHT, HOLDING WATER TO FLOWLINE INVERT MINIMUM. IT IS SUGGESTED THAT ALL JOINTS BELOW PIPE INVERTS ARE GROUTED.




800-338-1122 513-645-7000 513-645-7993 FAX

CS-4
CASCADE SEPARATOR
STANDARD DETAIL

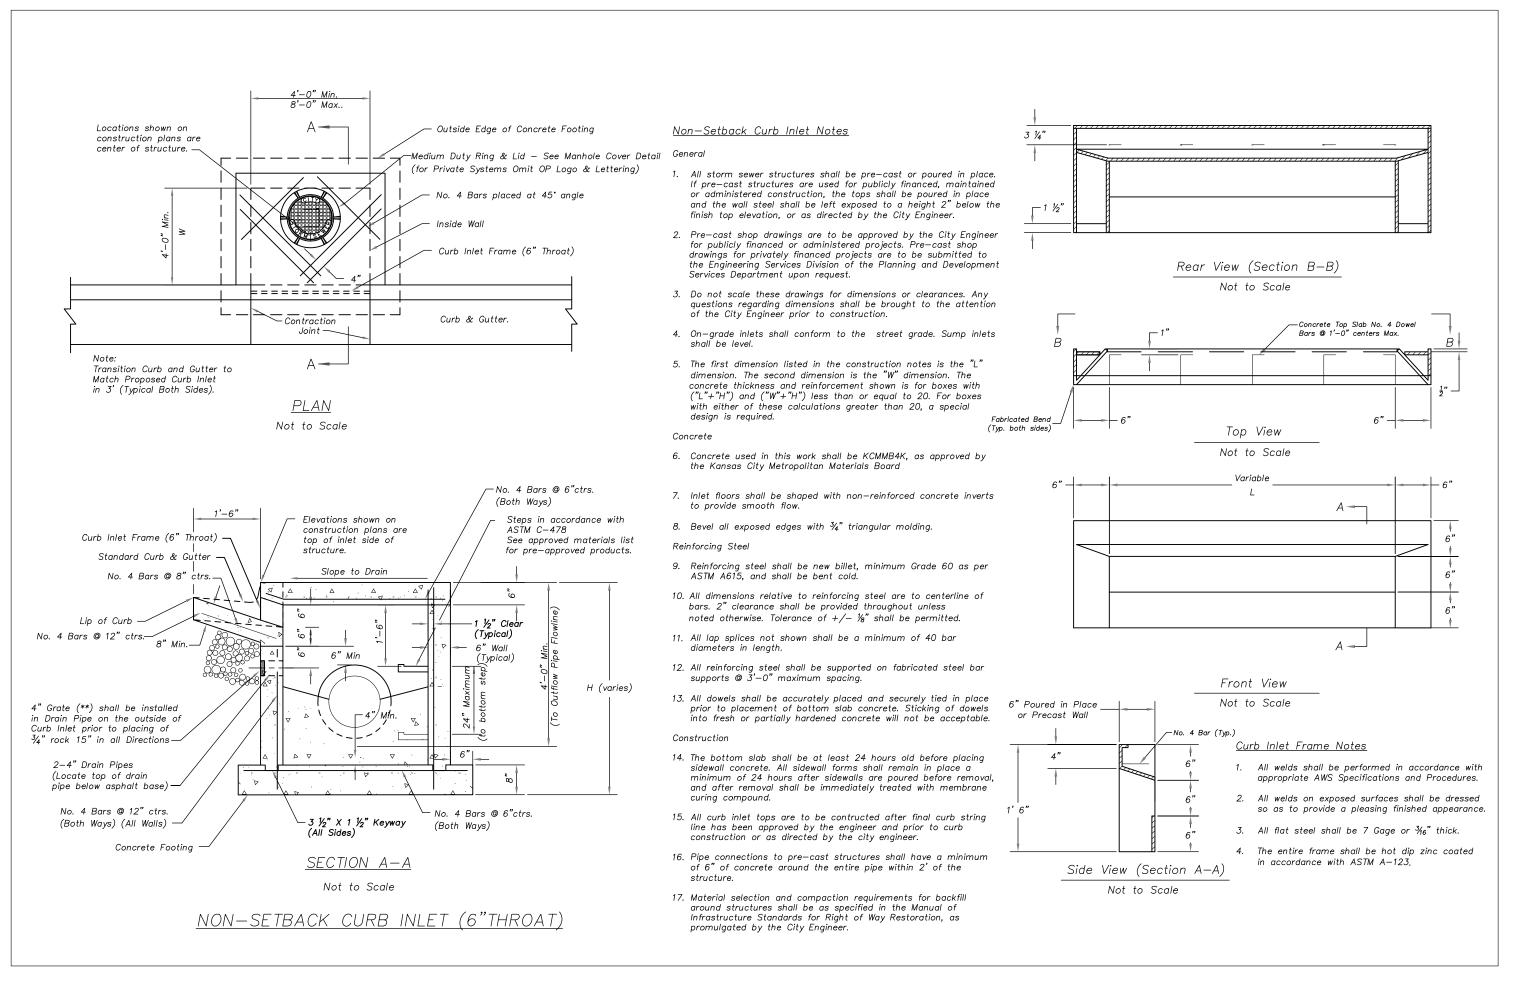

## 2 NON-SETBACK CURB INLET DETAIL SCALE: NOT TO SCALE

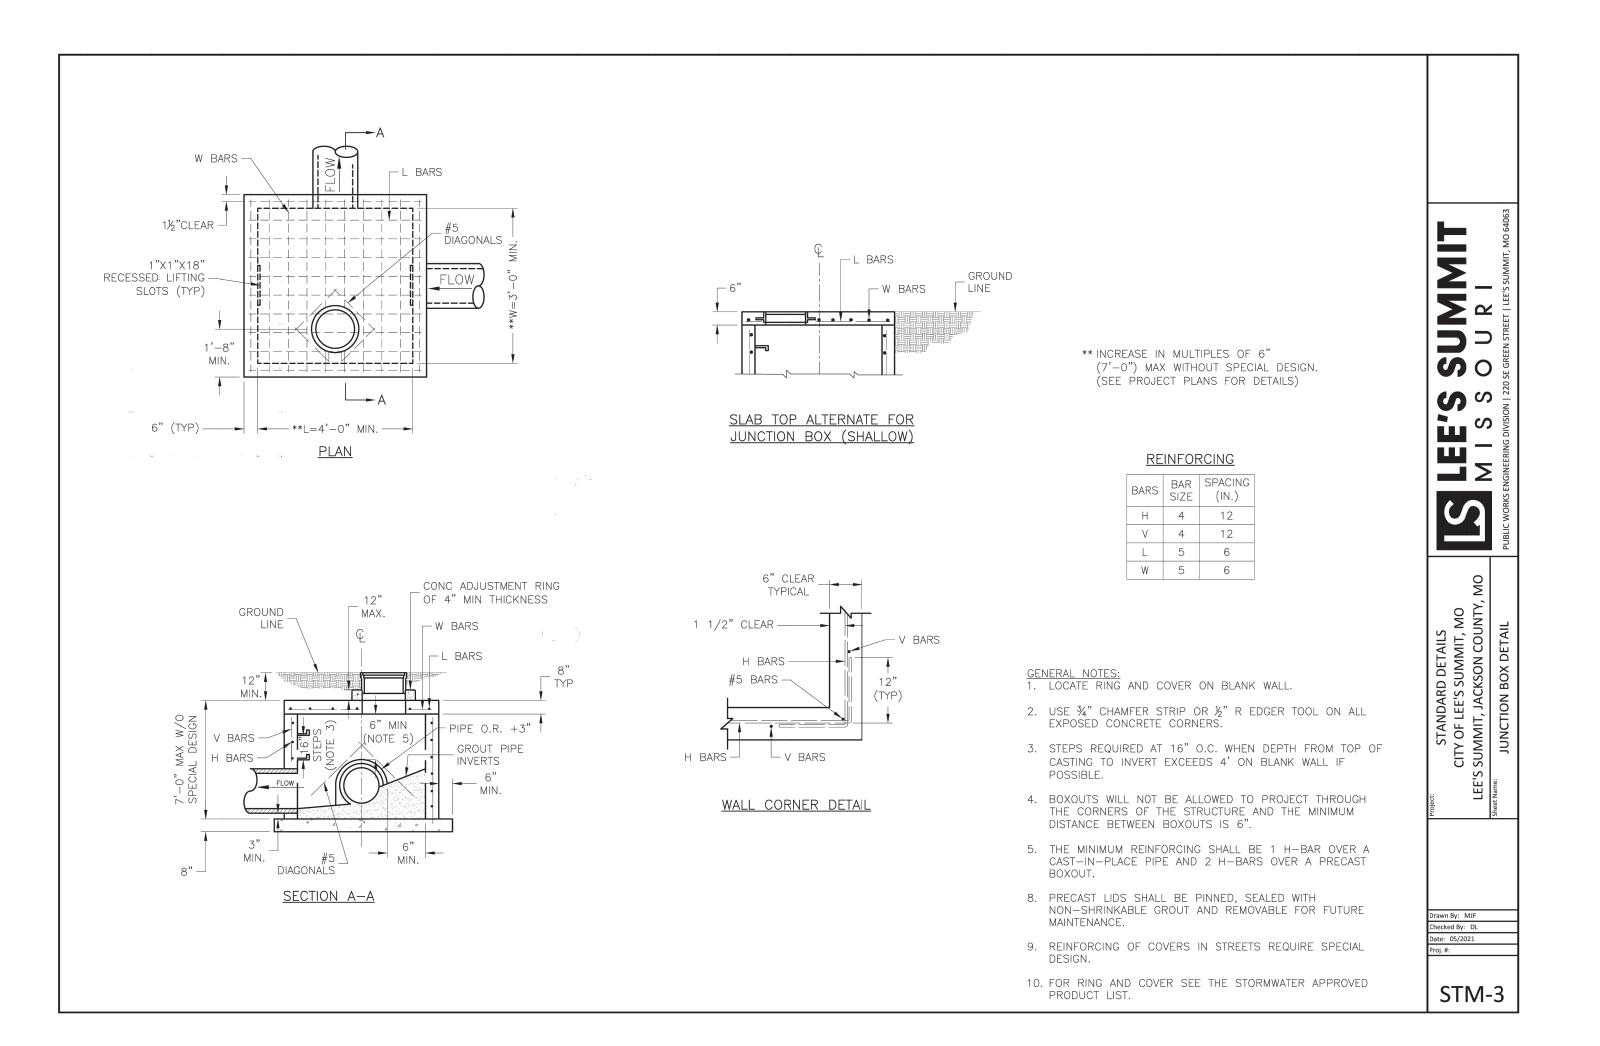



AS NOTED

VED BY: LLG

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805 PENNSYLVANIA AVENUE, SUITE 150
KANSAS CITY, MO 64105
PHONE: 816-852-0350

AS NOT SEND BY:

LOS MISSON DESIGNED BY:

DESIGNED BY:

DESIGNED BY:

DESIGNED BY:

DESIGNED BY:

AS NOT SEND BY:

DESIGNED BY:

APITAL BUILDERS


DETAILS


FLEX SPACE
60 SE THOMPSON DR


ORIGINAL ISSUE: 10/29/2024 KHA PROJECT NO. 268442000

SHEET NUMBER


C009B

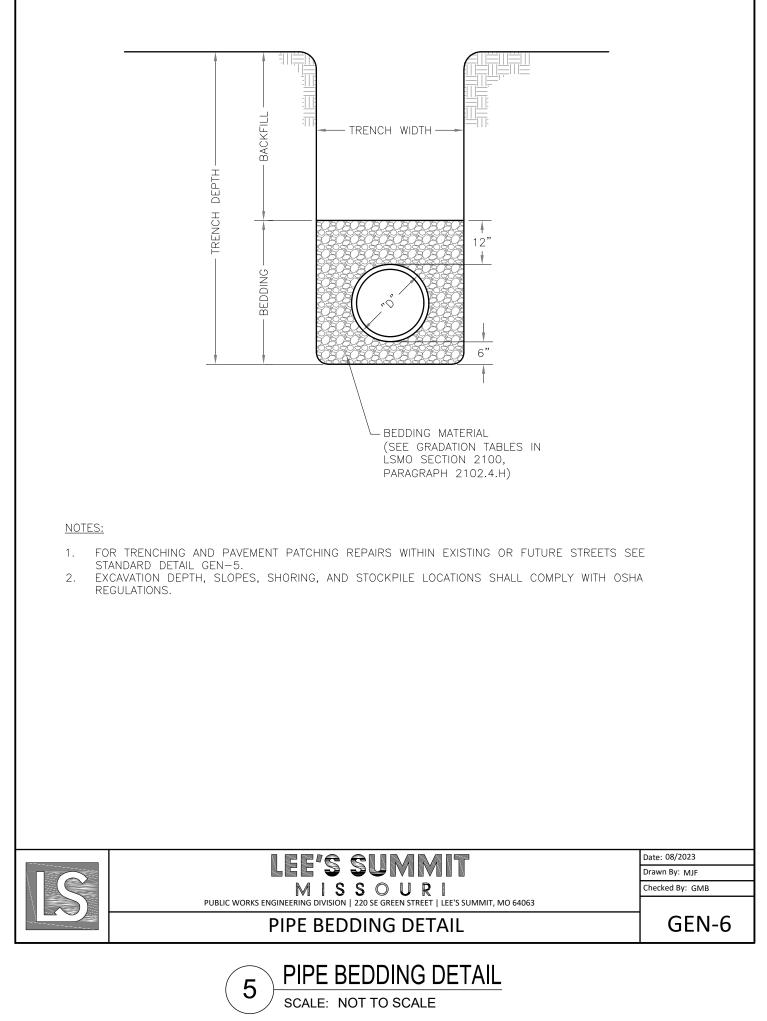

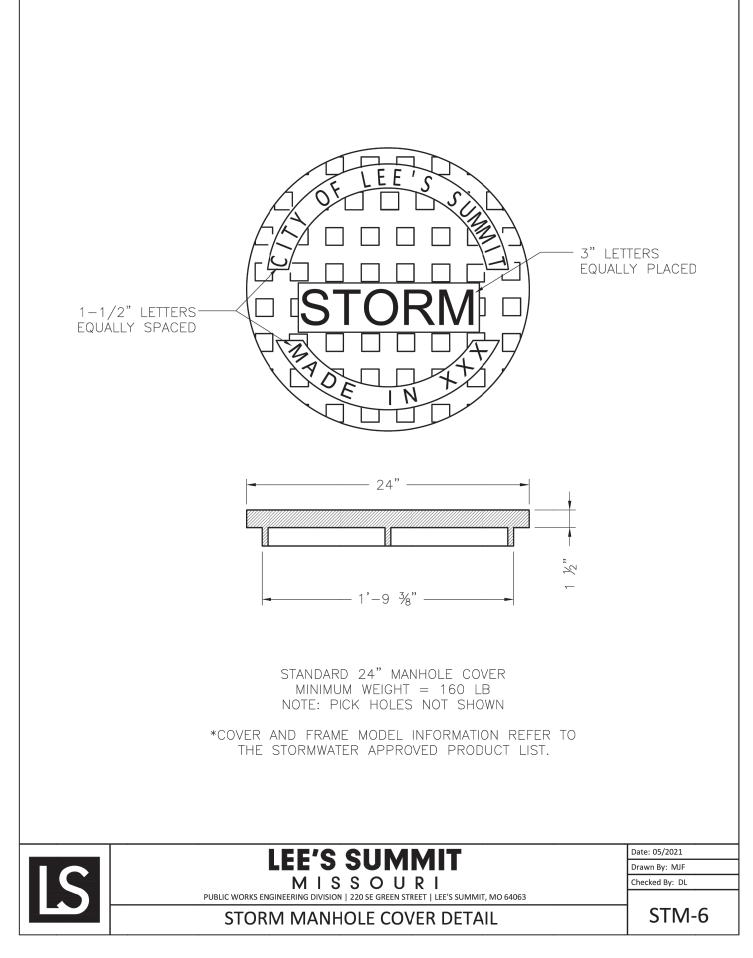

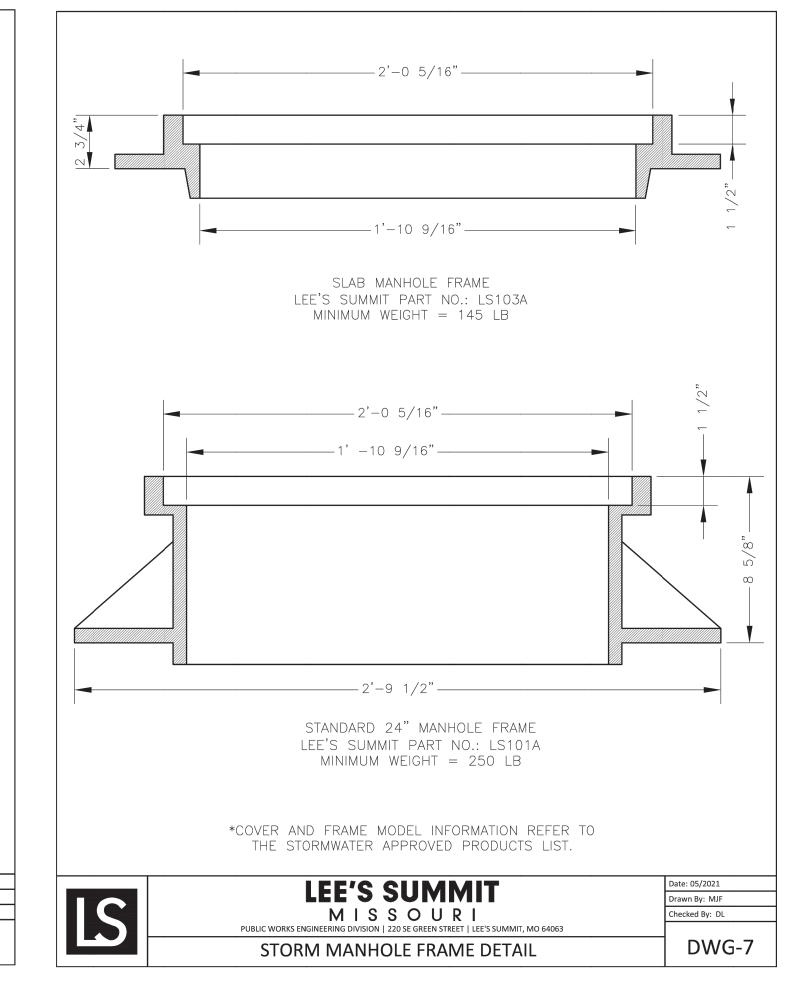

STORM MANHOLE COVER DETAIL STORM MANHOLE FRAME DETAIL SCALE: NOT TO SCALE SCALE: NOT TO SCALE

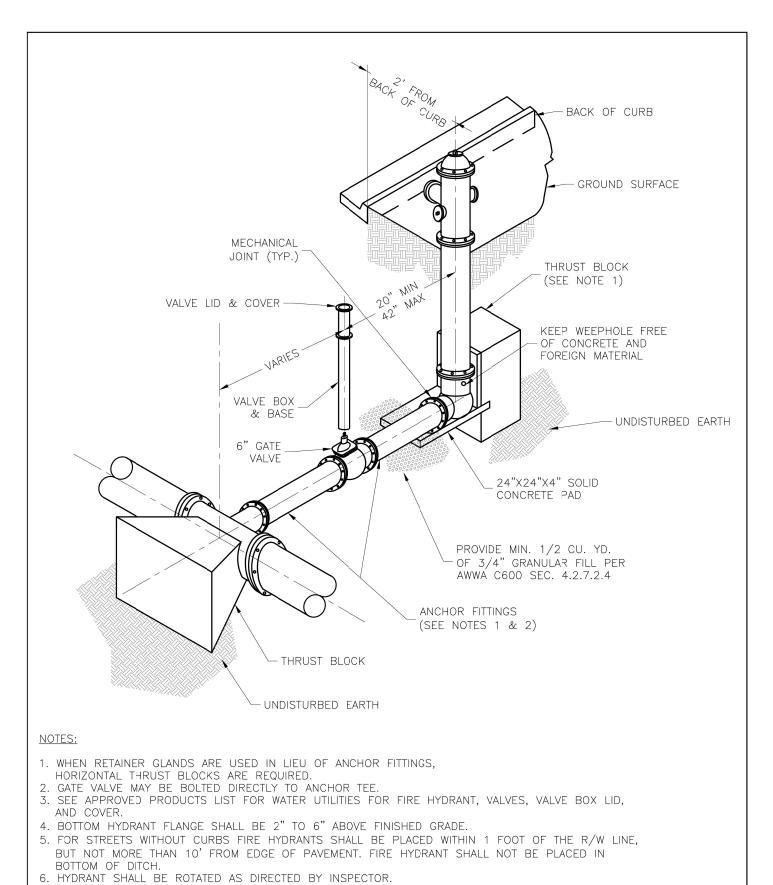

**LEE'S SUMMIT** 

**HYDRANT - STRAIGHT SET** 

\ HYDRANT - STRAIGHT SET DETAIL


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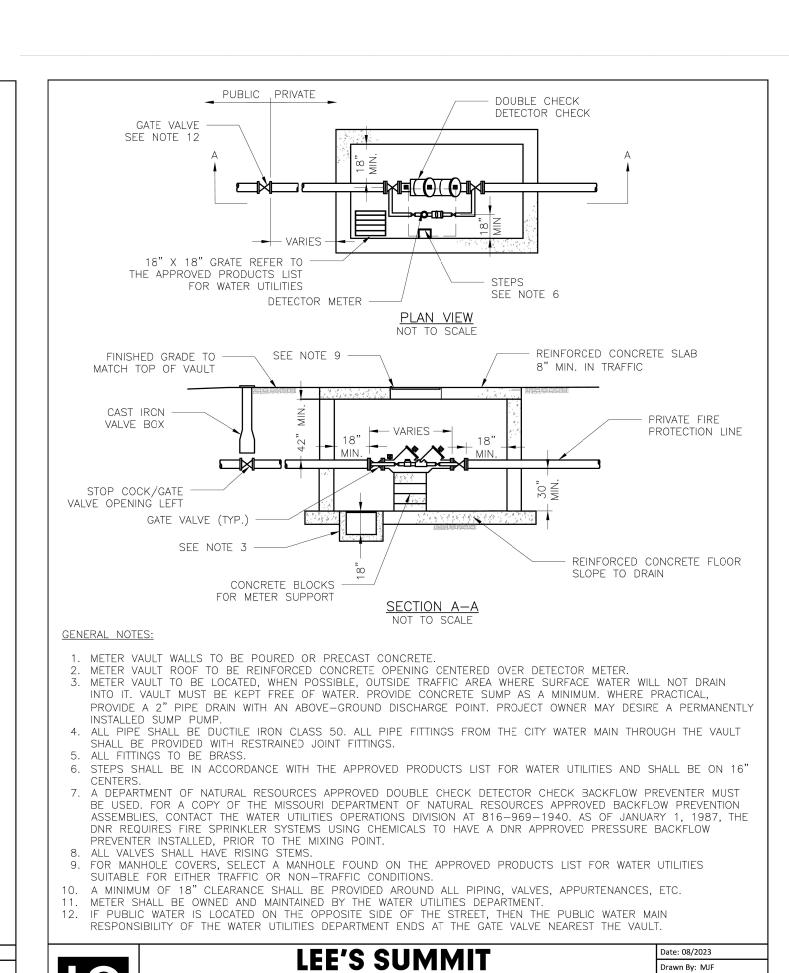
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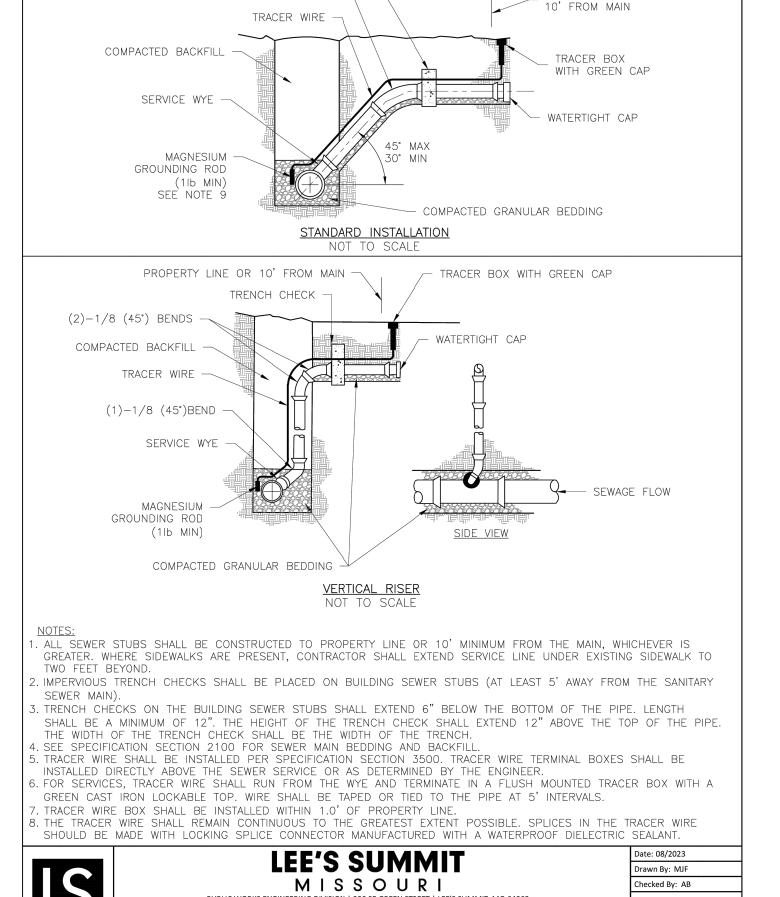
FLARED END SECTION WITH TOE WALL DETAIL

SCALE: NOT TO SCALE



WAT-13




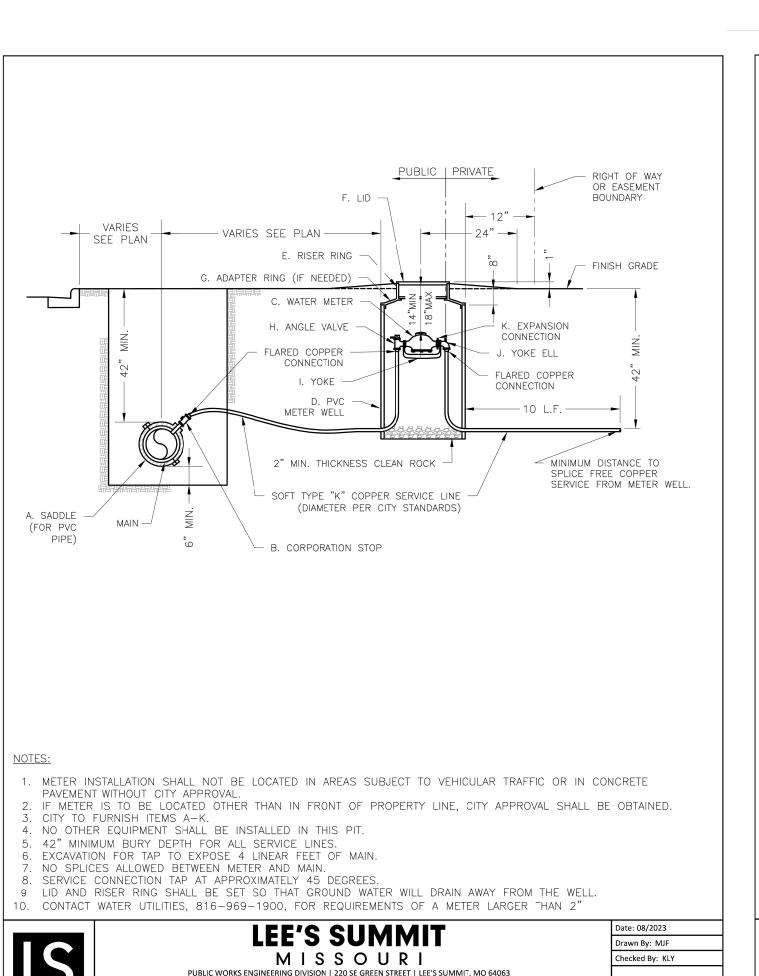

TRENCH CHECK

PROPERTY LINE OR

1-1/8 (45°) BEND -

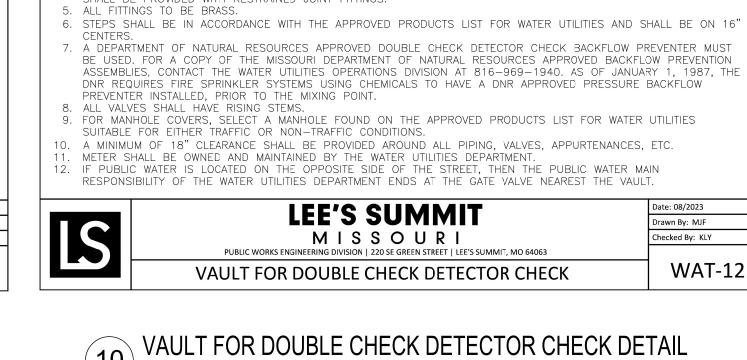





SERVICE CONNECTION WITH METER WELL

VAULT FOR DOUBLE CHECK DETECTOR CHECK DETAIL SCALE: NOT TO SCALE

SCALE: NOT TO SCALE

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KHA PROJECT NO.


268442000 SHEET NUMBER

Horn


Kimley


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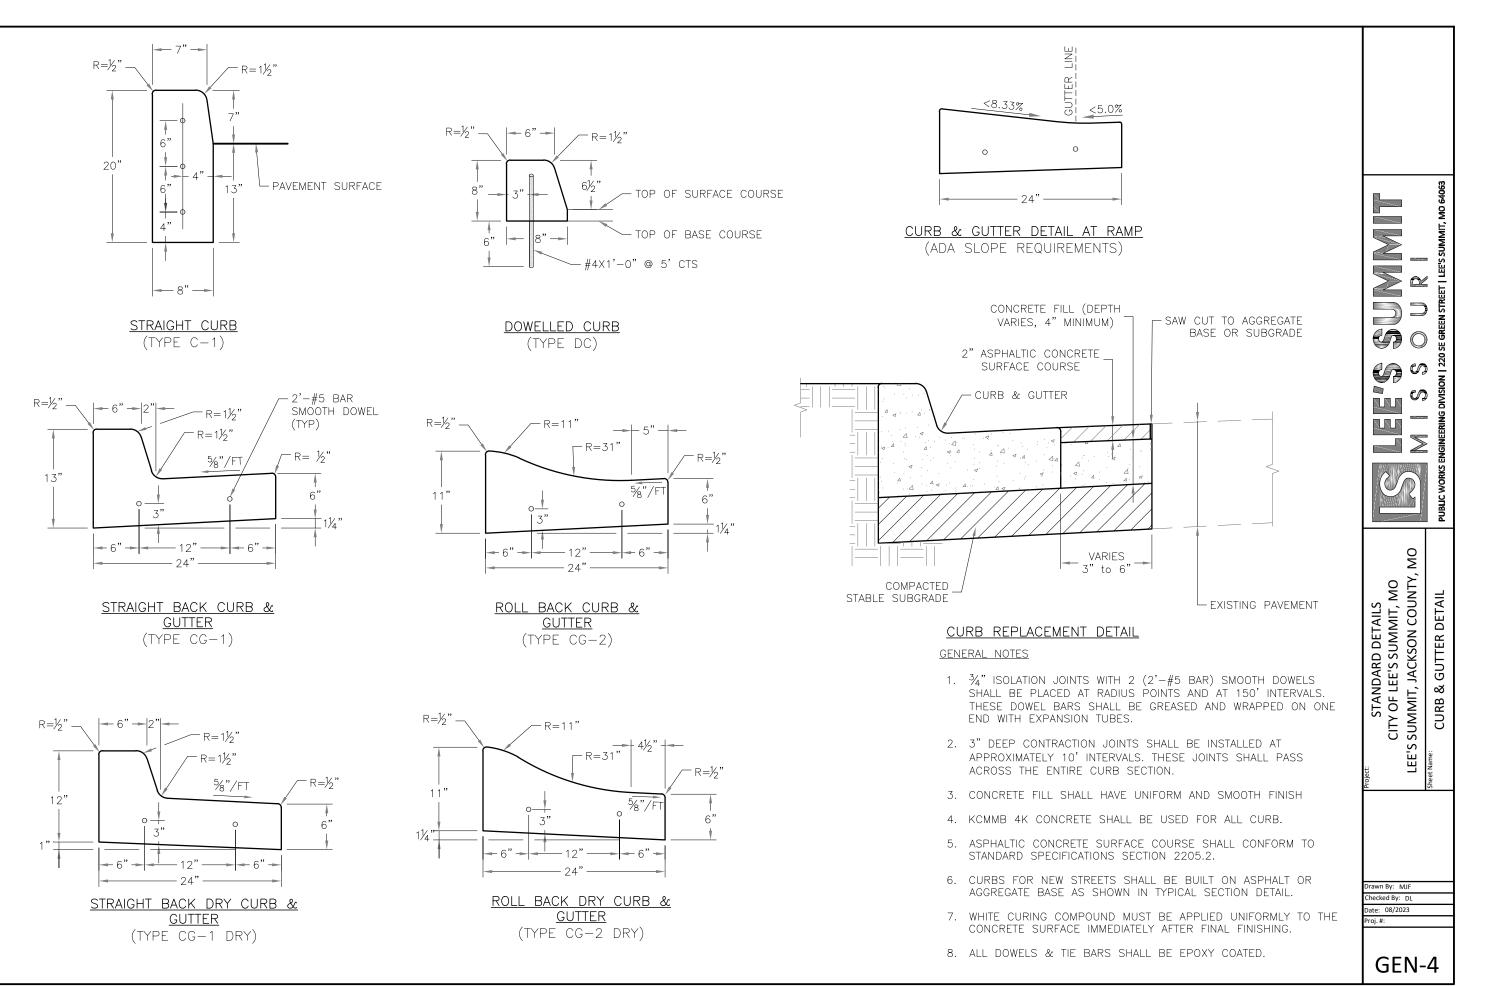
C010



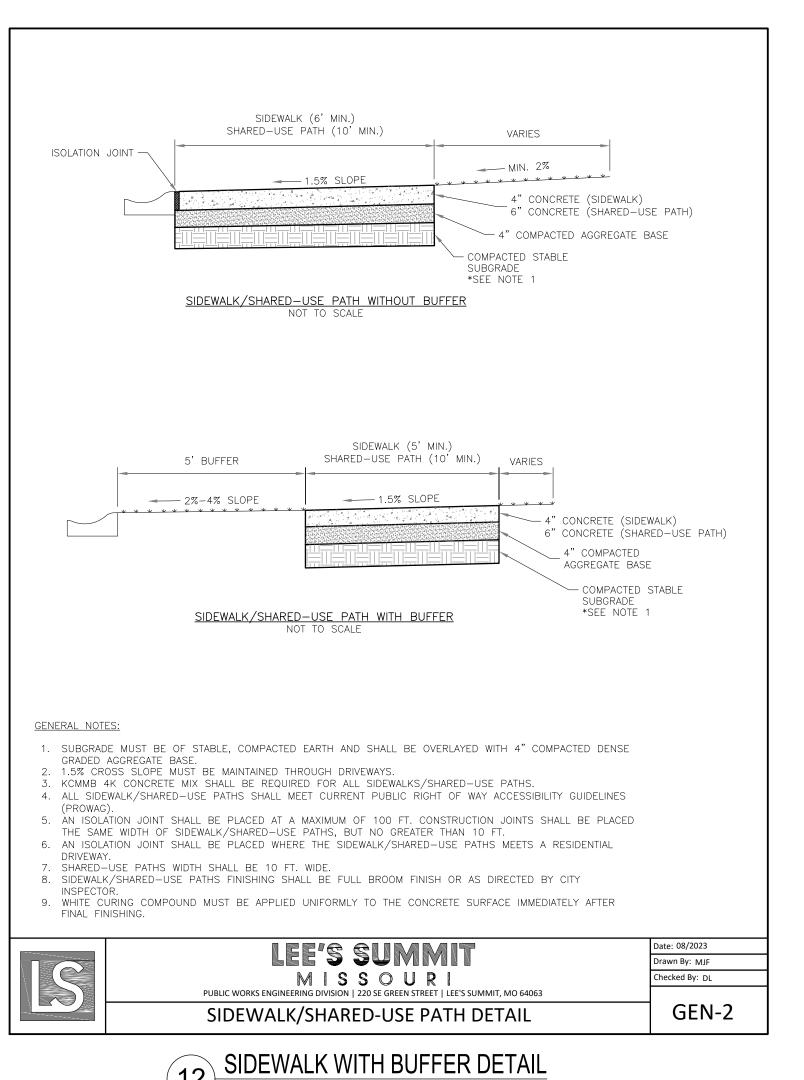



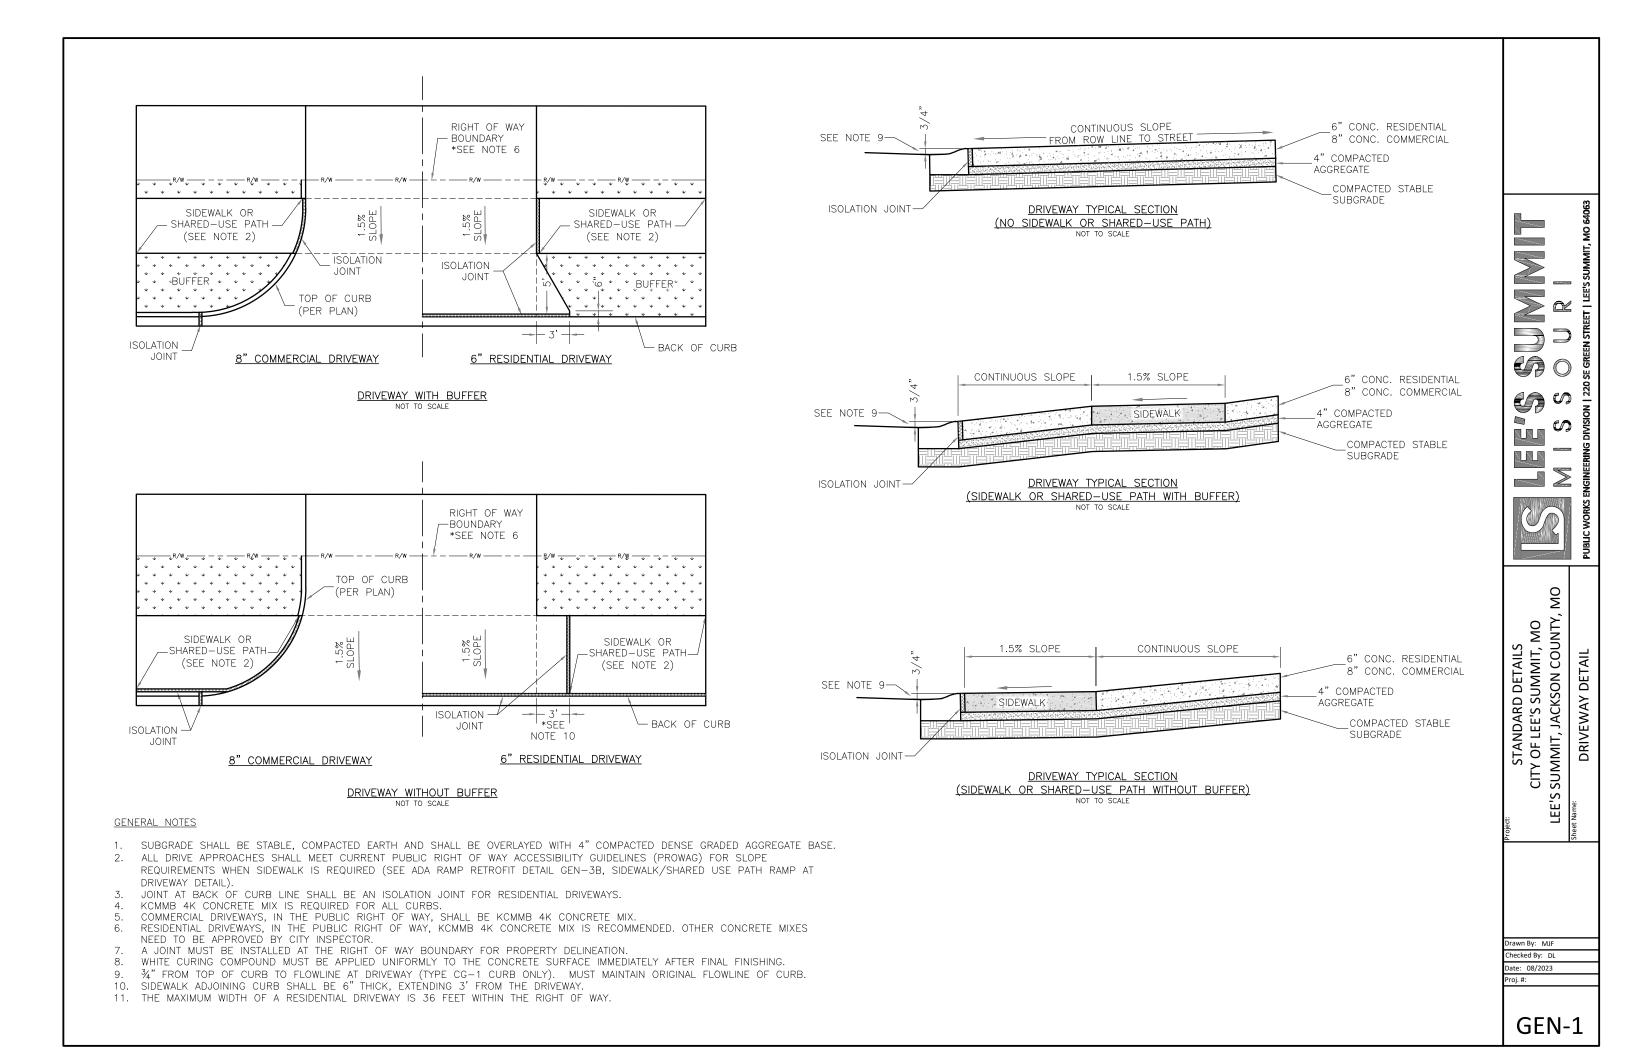

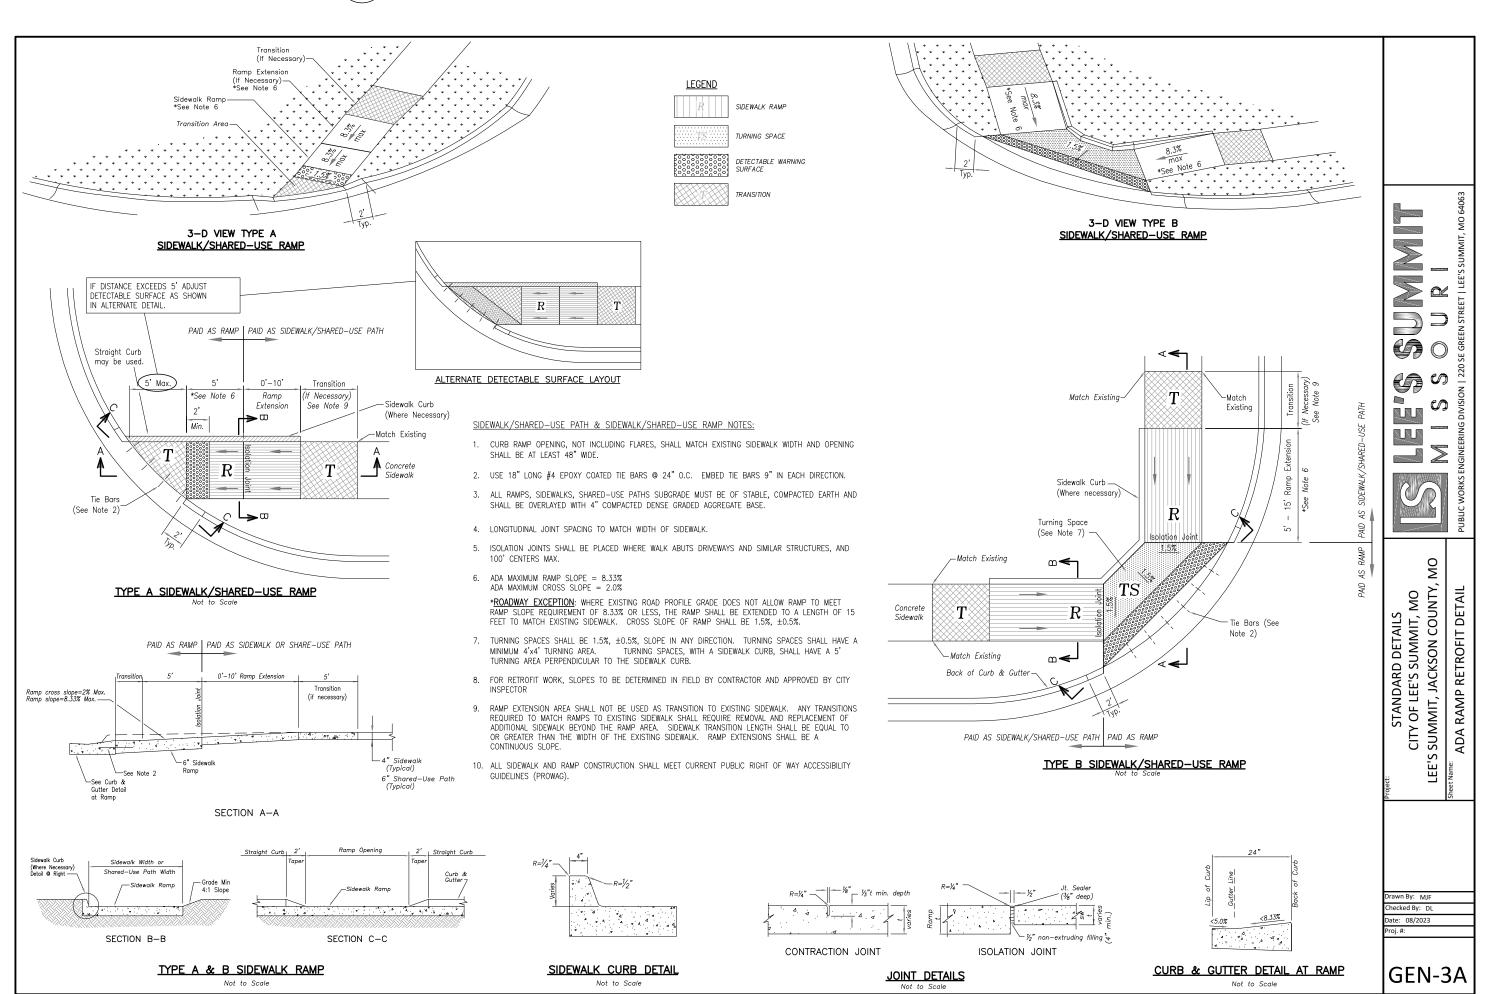



STRAIGHT BACK CURB AND GUTTER DETAIL SCALE: NOT TO SCALE

ORIGINAL ISSUE: 10/29/2024 KHA PROJECT NO. 268442000 SHEET NUMBER


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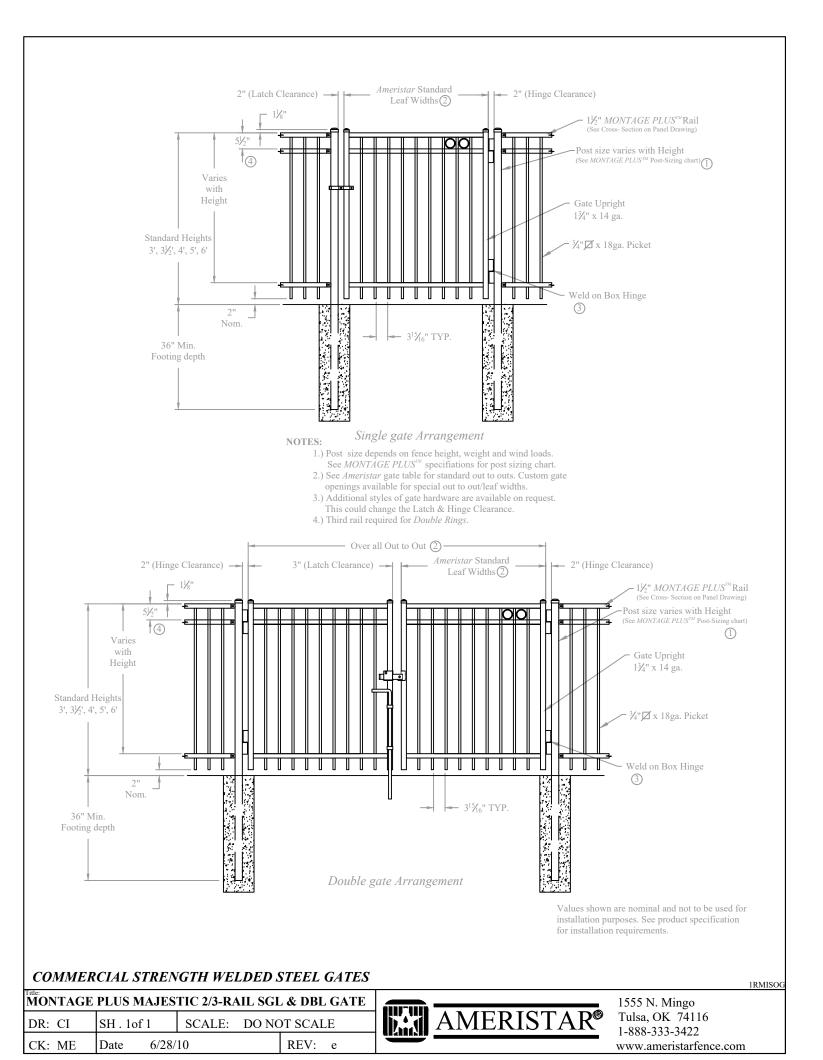
TYPE A SIDEWALK ADA RAMP RETROFIT DETAIL SCALE: NOT TO SCALE



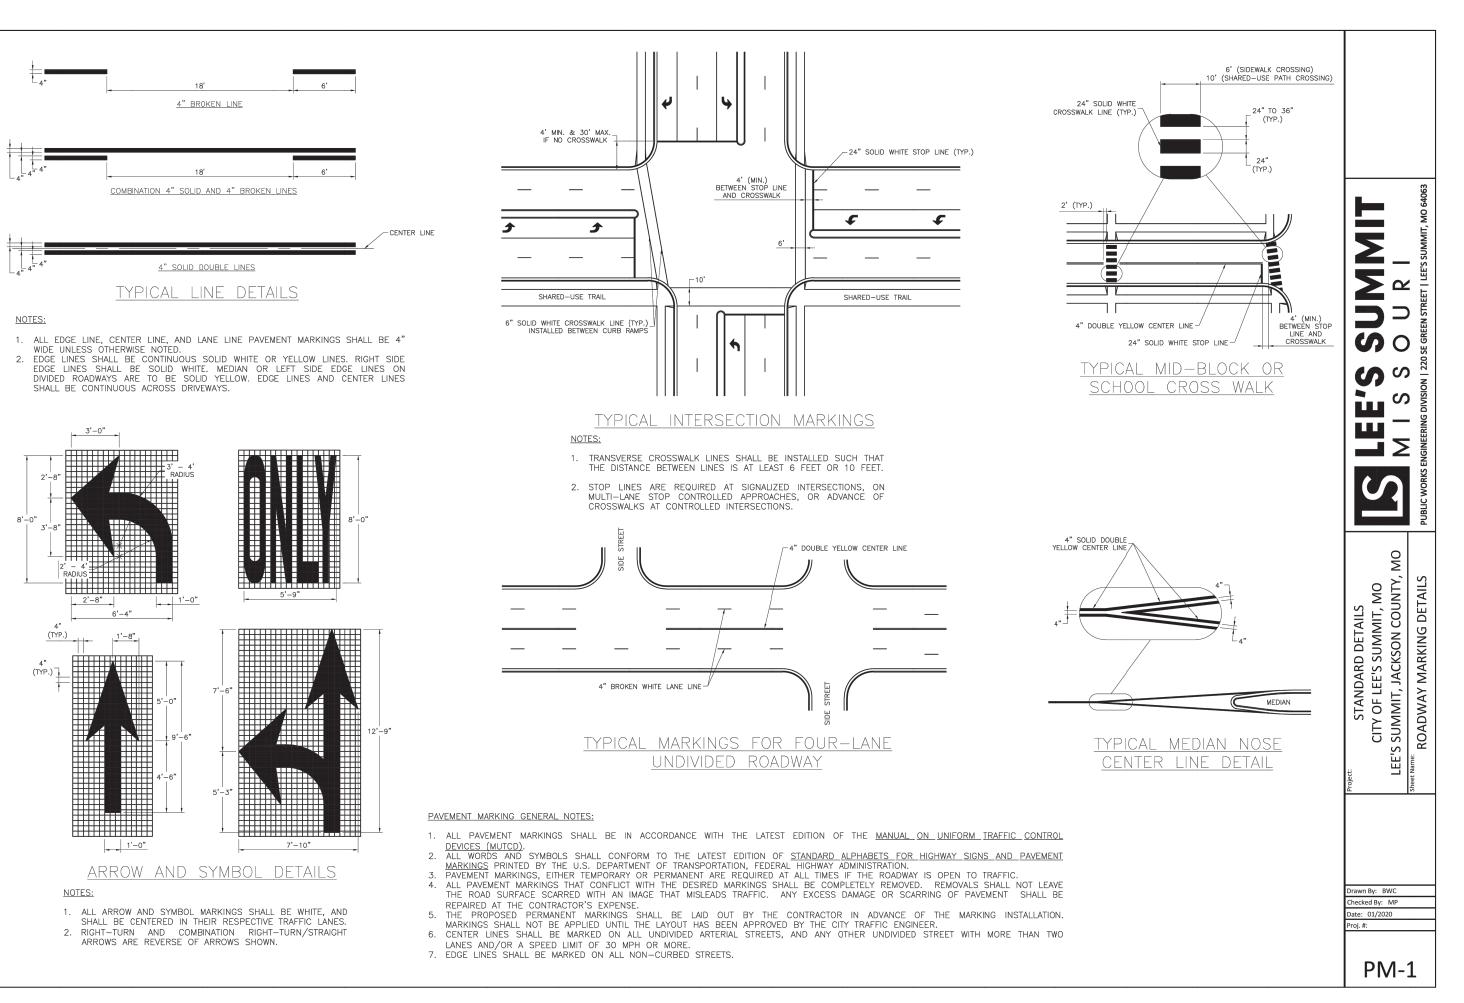

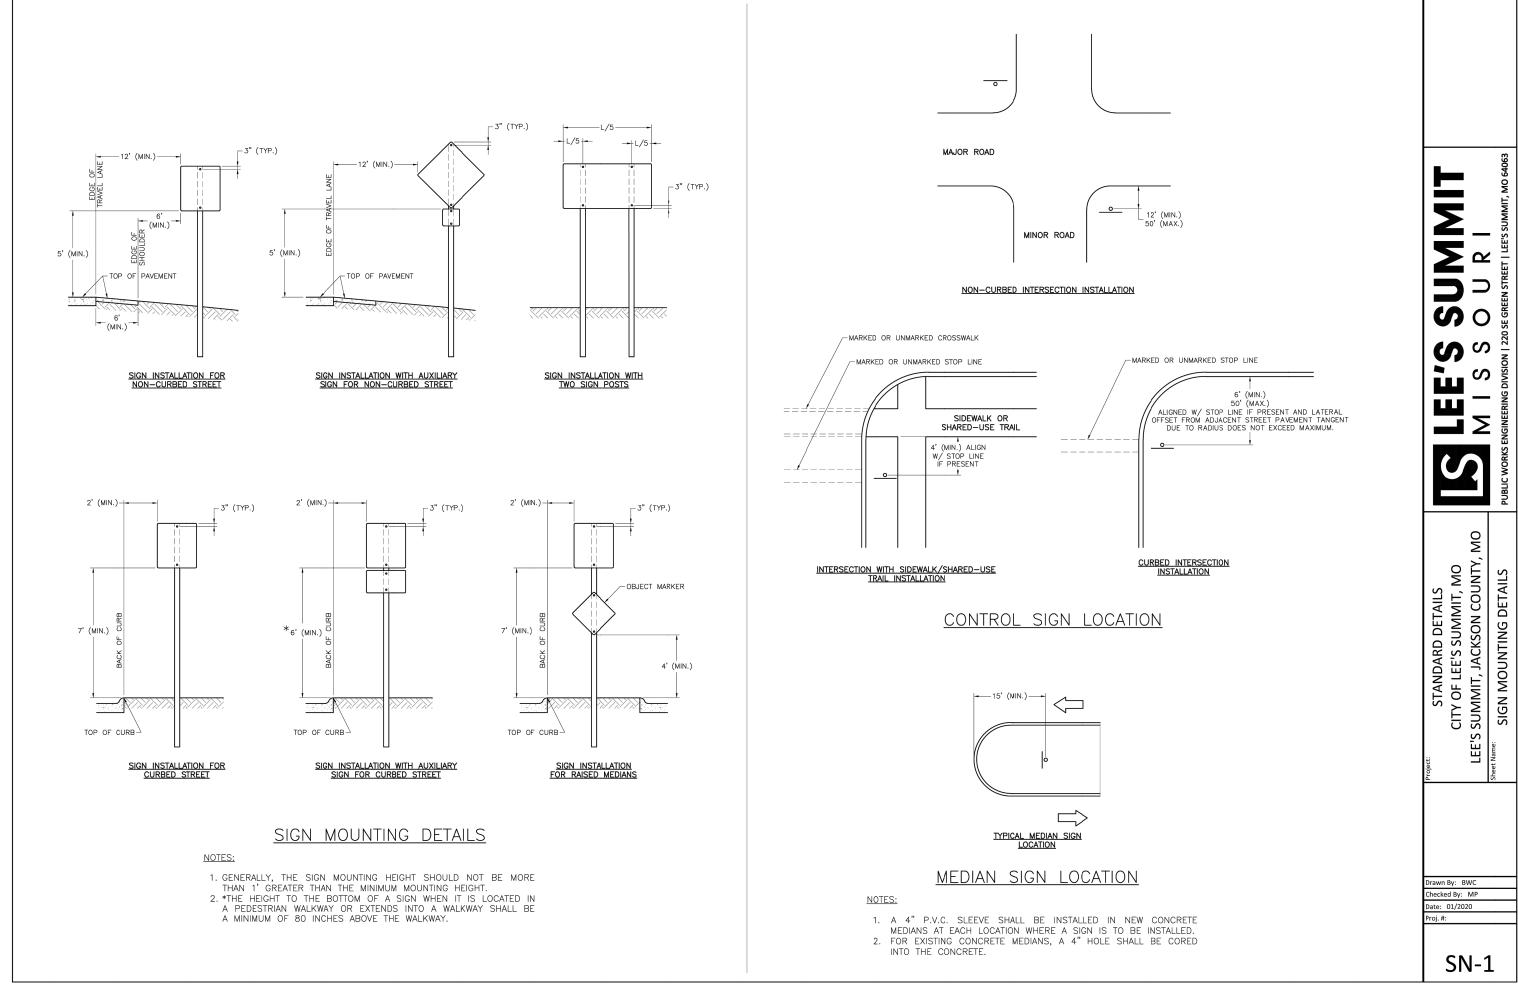
#### PAVEMENT MARKING ARROW AND SYMBOL DETAILS SCALE: NOT TO SCALE



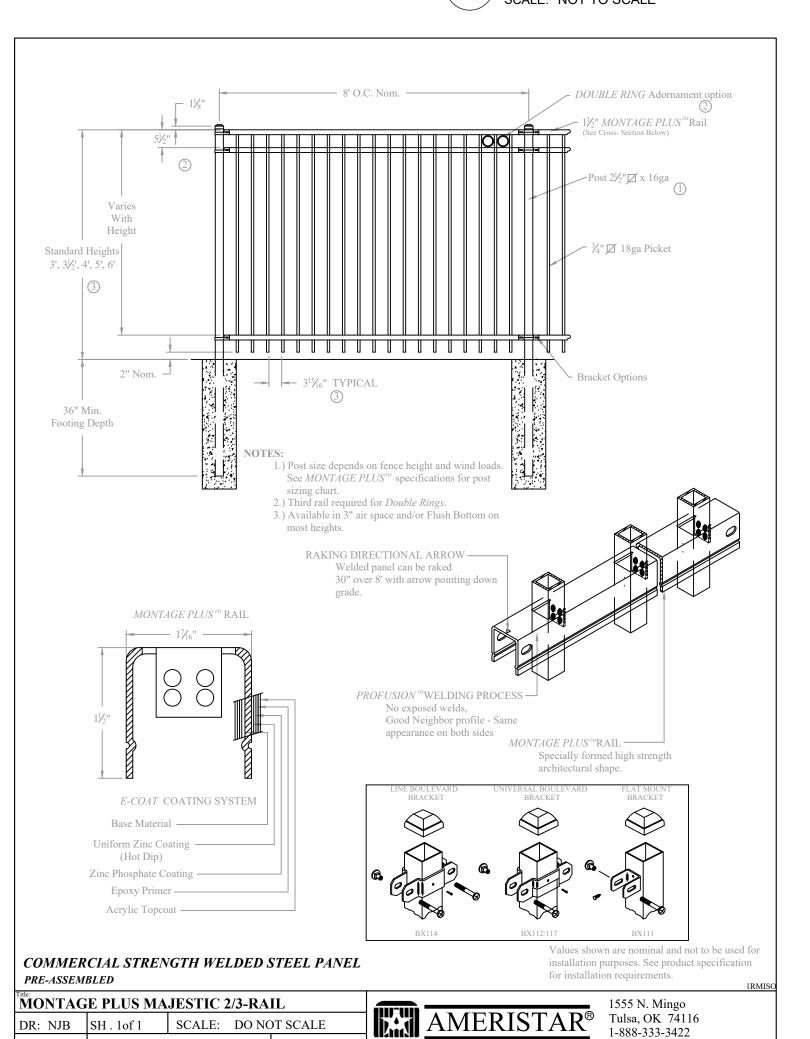




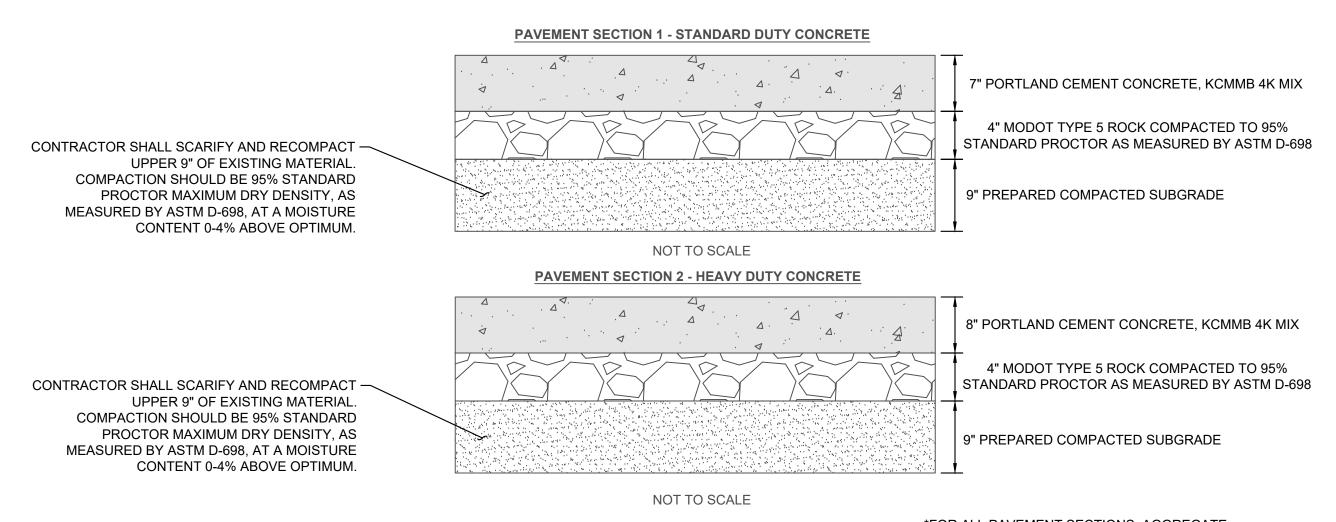



\*FOR ALL PAVEMENT SECTIONS: AGGREGATE BASE AND COMPACTION OF NATIVE SUBGRADE SHALL EXTEND A MINIMUM OF ONE (1) FOOT BEYOND THE BACK OF CURB

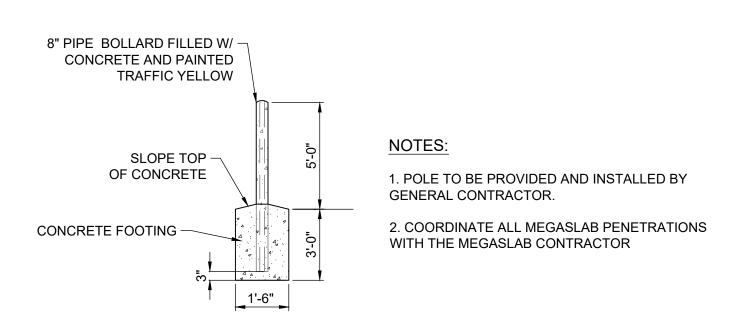

STEEL-ENCASED CONCRETE BOLLARD DETAIL

SCALE: NOT TO SCALE

AMERISTAR FENCE DETAIL

www.ameristarfence.com

REV: e

DR: NJB SH . 1 of 1 SCALE: DO NOT SCALE

AMERISTAR GATE DETAIL

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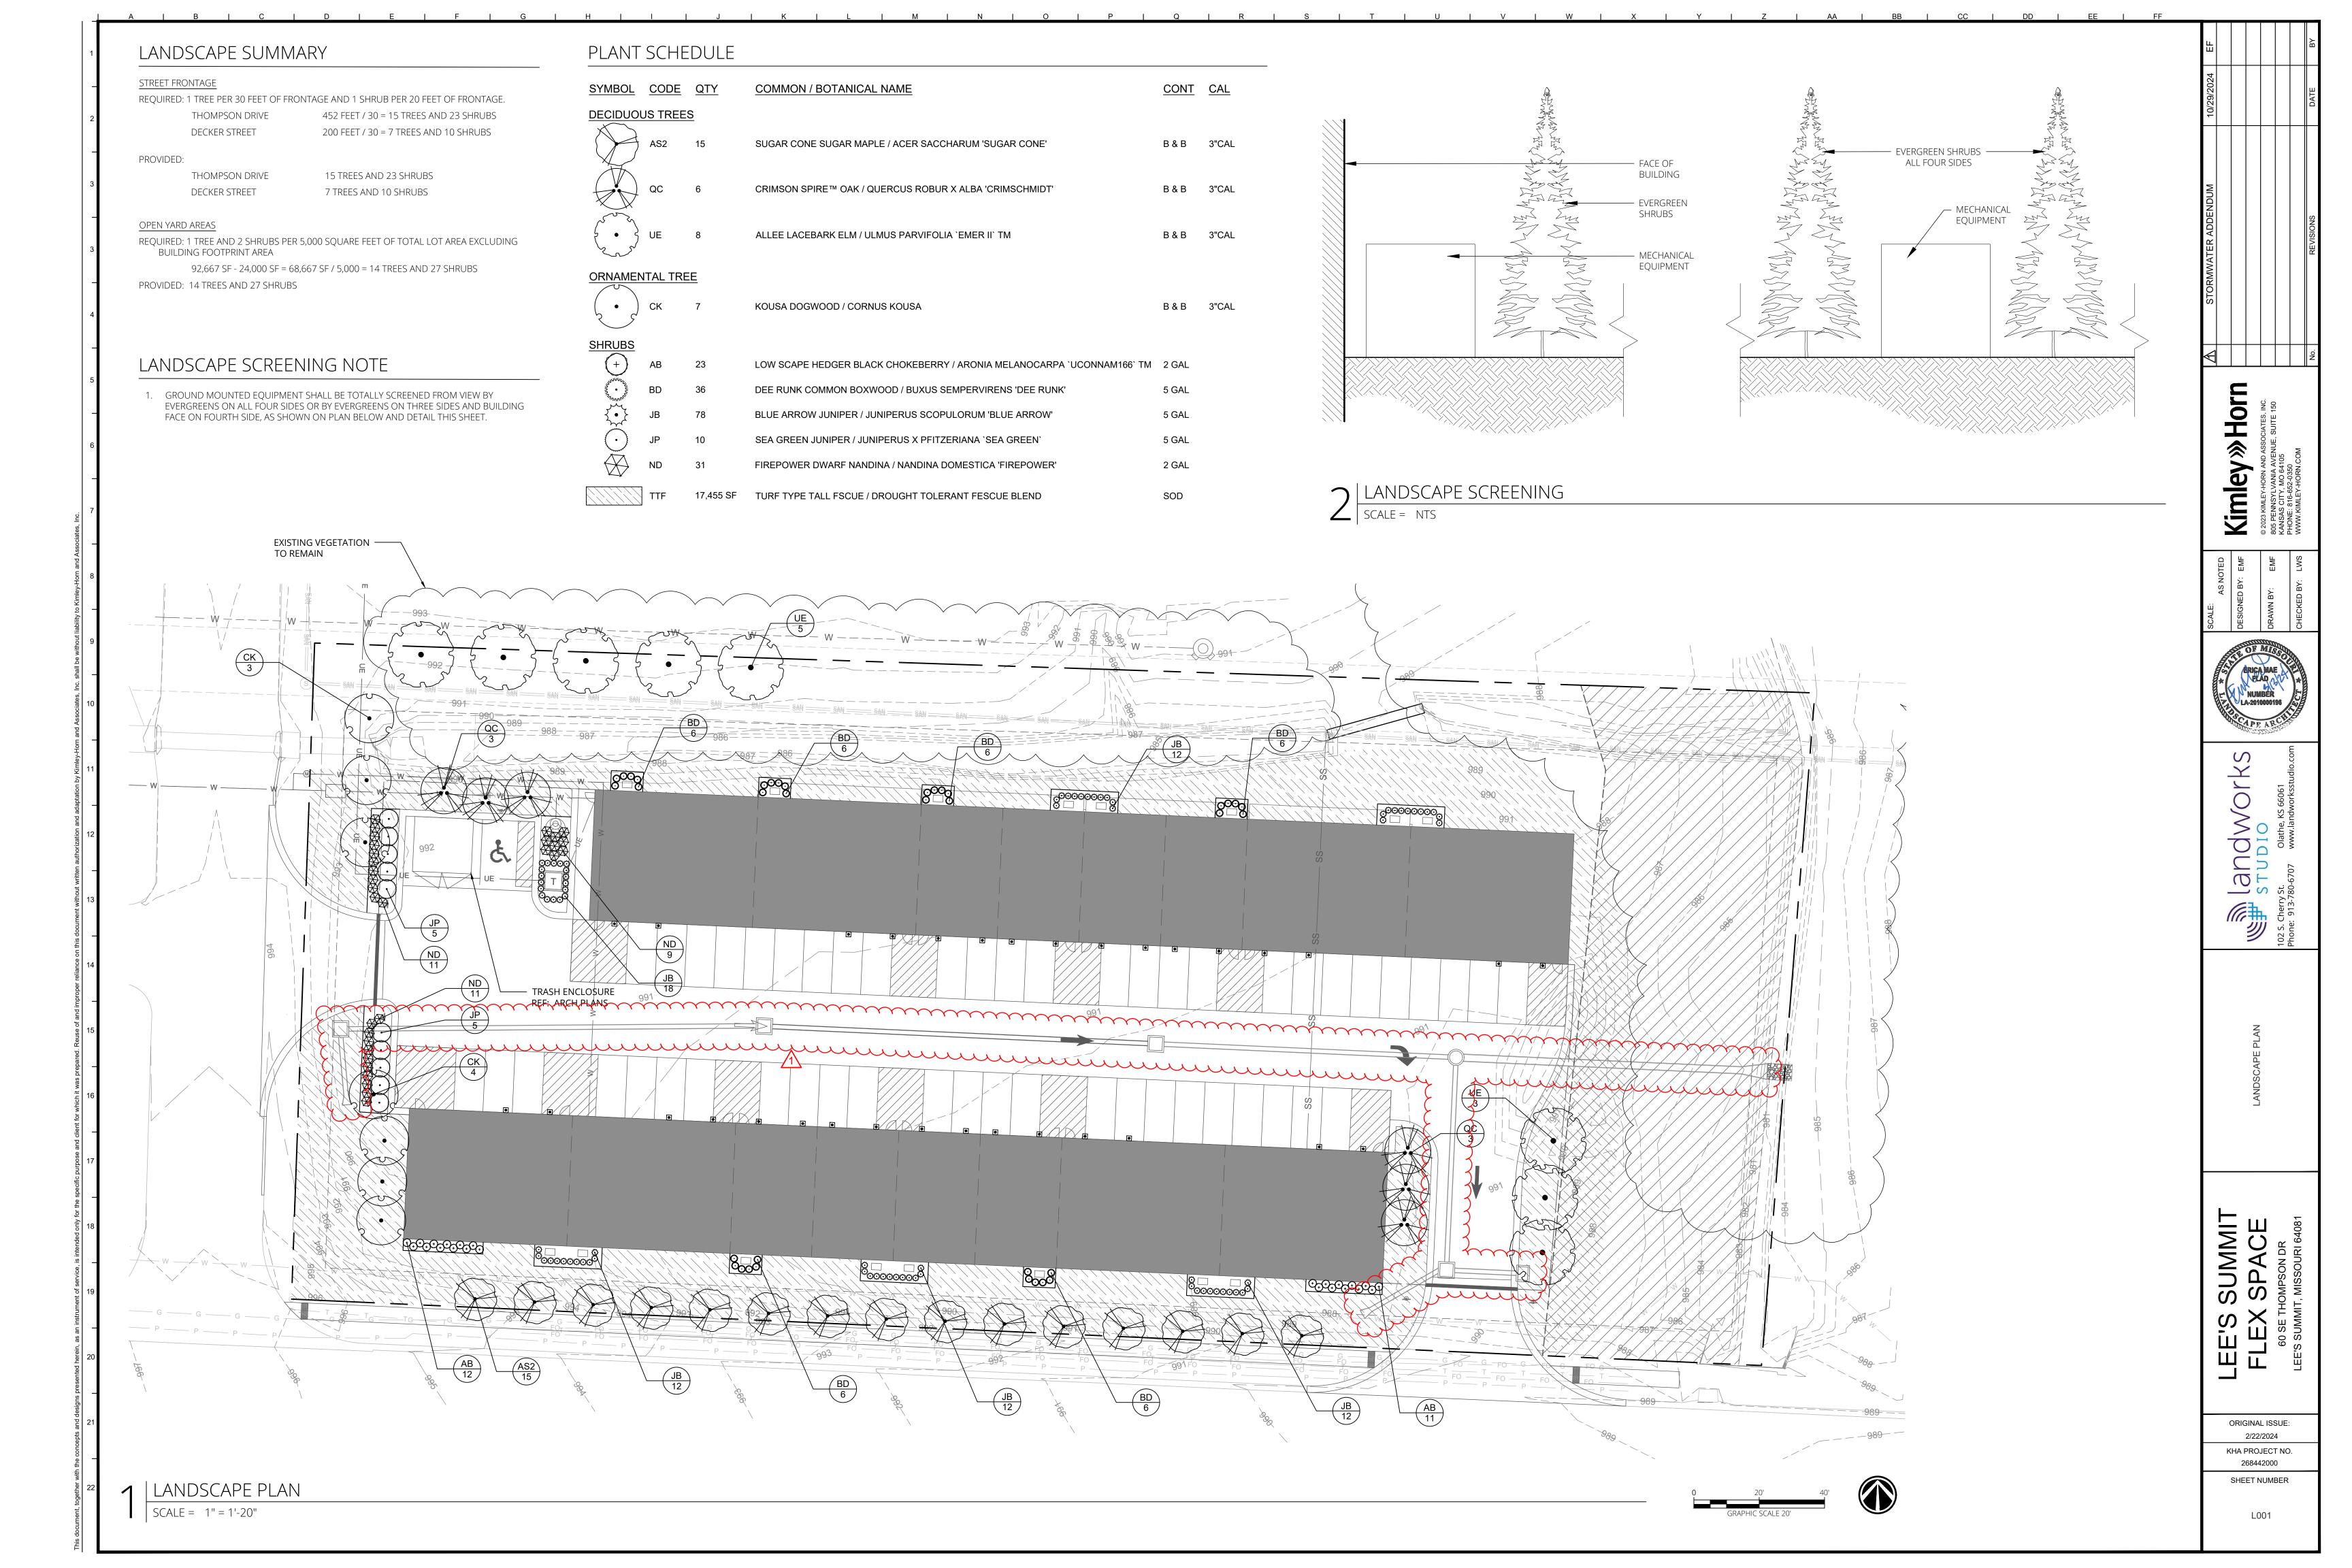
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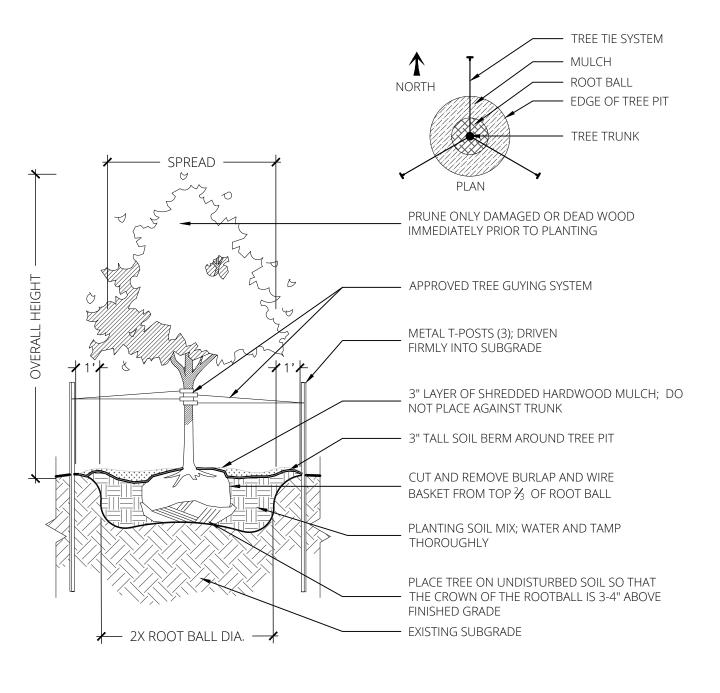
ORIGINAL ISSUE:

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SHEET NUMBER

C012





PLACE SHRUB IN UPRIGHT POSITION

3" LAYER OF SHREDDED HARDWOOD MULCH; DO NOT PLACE AGAINST STEMS
NON-WOVEN GEOTEXTILE FILTER FABRIC

3" TALL SOIL BERM AROUND SHRUB PIT

REMOVE CONTAINER COMPLETELY AND PLACE SHRUB IN UPRIGHT POSITION PLANTING SOIL MIX; WATER AND TAMP THOROUGHLY


UNDISTURBED SOIL


24" LARGER THAN CONTAINER

1 | DECIDOUS TREE PLANTING

SCALE = 1/4" = 1'-0"

2 SHRUB PLANTING

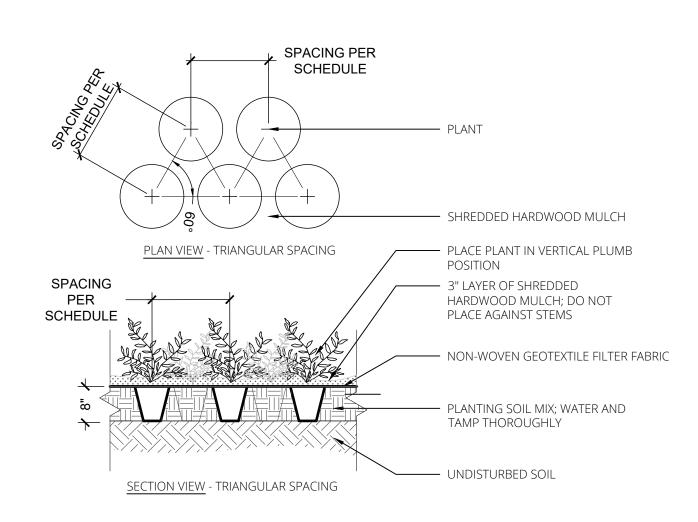

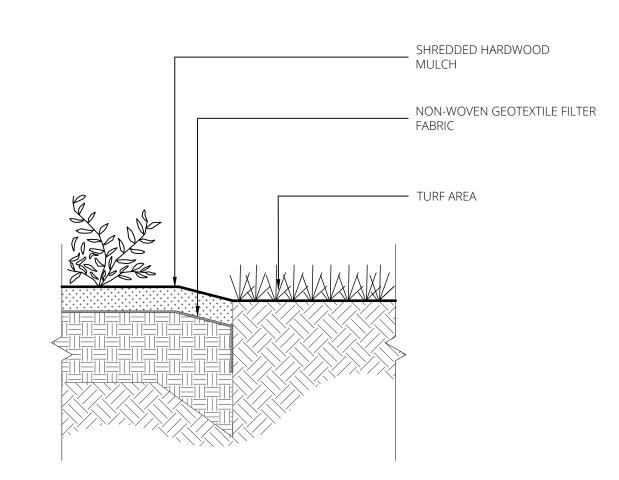

3 PERENNIAL PLANTING

SCALE = 1/2" = 1'-0"

CULTIVATED EDGE

#### **PLANTING NOTES**

#### GENER

1. CONTRACTOR SHALL LOCATE ALL UTILITIES BEFORE COMMENCING WORK. NOTIFY THE KANSAS ONE CALL SYSTEM AT 800-344-7233, OR 811. CONTRACTOR SHALL BE RESPONSIBLE FOR THE REPAIR OF ANY DAMAGE TO UTILITIES RESULTING FROM LANDSCAPE OPERATIONS. ANY UTILITIES SHOWN ON PLAN ARE FOR REFERENCE ONLY AND MAY OR MAY NOT DEPICT THE ACTUAL LOCATION OF SERVICES.

2. NO MATERIAL SUBSTITUTIONS SHALL BE MADE WITHOUT LANDSCAPE ARCHITECT'S APPROVAL. ALTERNATE MATERIALS OF SIMILAR SIZE AND CHARACTER MAY BE CONSIDERED IF SPECIFIED PLANT MATERIALS CANNOT BE OBTAINED. LANDSCAPE ARCHITECT RESERVES THE RIGHT TO REVISE PLANT LIST AS DEEMED NECESSARY.

3. QUANTITIES OF MATERIALS SHOWN ON THE PLANTING PLAN TAKE PRECEDENCE OVER QUANTITIES SHOWN ON THE PLANT MATERIAL SCHEDULE. CONTRACTOR SHALL BE RESPONSIBLE FOR VERIFYING ALL QUANTITIES ON THE PLANTING PLAN PRIOR TO BIDDING.

4. REPORT ANY DISCREPANCIES IN THE PLANTING PLAN TO THE LANDSCAPE ARCHITECT,

PRIOR TO PURCHASING MATERIALS OR STARTING CONSTRUCTION.

5. ALL DISTURBED AREAS NOT COVERED BY BUILDING, PAVEMENT, OR PLANTING BED SHALL BE BROUGHT TO FINISH GRADE AND PLANTED IN TURF-TYPE TALL FESCUE OR OTHER.

#### DI ANTING PREPARATION

6. CONTRACTOR SHALL PROVIDE OWNER'S REPRESENTATIVE WITH SOIL TEST ANALYSIS REPORTS FOR EACH SAMPLE OF EXISTING SOIL, TOPSOIL, COMPOST, AND PLANTING SOIL MIX PRIOR TO PLANTING PREPARATION. ANALYSES SHALL INCLUDE, BUT NOT BE LIMITED TO, THE FOLLOWING PARAMETERS: PARTICLE SIZE ANALYSIS (% DRY WEIGHT), USDA SOIL TEXTURE, pH AND BUFFER pH, ORGANIC CONTENT (% DRY WEIGHT), MOISTURE CONTENT (% WET WEIGHT), PHYSICAL CONTAMINANTS (% DRY WEIGHT), AND NUTRIENT LEVELS (NITROGEN, PHOSPHORUS POTASSIUM).

7. ALL PLANTING BEDS SHALL BE AMENDED WITH A PLANTING SOIL MIX CONSISTING OF EXISTING SOIL, TOPSOIL, AND COMPOST TO MAKE A NEW SOIL THAT MEETS THE PROJECT GOALS FOR THE INDICATED PLANTING AREAS. REFER TO SPECIFICATION SECTION 32 91 13 - SOIL PREPARATION.

8. PLANT PIT BACKFILL FOR TREES AND SHRUBS SHALL BE PLANTING SOIL MIX, AS DESCRIBED IN ABOVE NOTE.

9. MOUND ALL PLANTING BEDS NOT ADJACENT TO BUILDINGS. PROVIDE POSITIVE DRAINAGE AROUND ALL PLANTING BEDS.

#### PLANTING MATERIALS

10. ALL PLANT MATERIAL SHALL BE WELL-FORMED AND DEVELOPED IN GOOD CONDITION, HEALTHY AND DISEASE-FREE, AND BE TYPICAL OF THE SPECIES. PLANTS SHALL COMPLY WITH ACCEPTABLE STANDARDS AS SET FORTH IN THE AMERICAN HORT "AMERICAN STANDARD OF NURSERY STOCK."

11. ALL PLANT MATERIALS SHALL BE PROTECTED FROM THE DRYING ACTION OF THE SUN AND WIND AFTER BEING DUG, WHILE BEING TRANSPORTED, AND WHILE AWAITING PLANTING. BALLS OF PLANTS WHICH CANNOT BE PLANTED IMMEDIATELY SHALL BE PROTECTED FROM DRYING ACTION BY COVERING THEM WITH MOIST MULCH. PERIODICALLY, APPLY WATER TO MULCH-COVERED BALLS TO KEEP MOIST. IF PLANTING SHOULD OCCUR DURING GROWING SEASON, APPLY ANTI-DESSICANT TO LEAVES BEFORE TRANSPORT TO REDUCE LIKELIHOOD OF WINDBURN. REAPPLY ANTI-DESSICANT AFTER PLANTING TO REDUCE TRANSPIRATION.

12. PLANTS DESIGNATED AS CONTAINER GROWN SHALL HAVE BEEN GROWN IN POTS, CANS OR BOXES FOR A MINIMUM OF SIX MONTHS AND A MAXIMUM OF TWO YEARS. THESE PLANTS SHALL BE REMOVED FROM CONTAINERS BEFORE PLANTING. PLANTS THAT APPEAR ROOT-BOUND SHALL BE REJECTED.

13. ALL PLANT LOCATIONS ARE APPROXIMATE, ADJUST AS NECESSARY TO AVOID CONFLICTS. THE FOLLOWING APPLIES FOR GENERAL PLANT LOCATIONS:

a. CREEPING GROUNDCOVER SHALL BE LOCATED A MINIMUM OF 6 INCHES FROM EDGE OF PAVEMENT.

b. ALL SHRUBS SHALL BE LOCATED A MINIMUM OF 2 FEET FROM EDGE OF PAVEMENT AND 4 FEET FROM BUILDINGS.

c. ALL TREES SHALL BE LOCATED A MINIMUM OF 2.5 FEET FROM EDGE OF PAVEMENT.

d. EQUALLY SPACE ALL PLANTS OF THE SAME SPECIES FOR BEST VIEWING.

#### PLANTING SOIL MIX

15. A MIX OF EXISTING SOIL, TOPSOIL, AND COMPOST TO MAKE A NEW SOIL THAT MEETS THE PROJECT GOALS FOR THE INDICATED PLANTING AREAS. THESE WILL BE MIXED ON-SITE, AND WILL CONSIST OF THE MIX COMPONENTS AND IN THE PROPORTIONS AS INDICATED:

A MIX OF EXISTING SOIL, TOPSOIL, AND COMPOST IN THE FOLLOWING RATIO:

MIX COMPONENT % BY MOIST VOLUME

EXISTING SOIL 65-70%

TOPSOIL (UNSCREENED) 25-30%

COMPOST

a. FINAL TESTED ORGANIC MATTER BETWEEN 2.75 AND 4% (BY DRY WEIGHT).

b. MIX THE TOPSOIL AND COMPOST TOGETHER FIRST AND THEN ADD TO THE EXISTING SOIL. MIX WITH A LOADER BUCKET TO LOOSELY INCORPORATE THE TOPSOIL/COMPOST MIX INTO THE EXISTING SOIL.

c. AT THE TIME OF FINAL GRADING, ADD LIME OR OTHER INORGANIC AMENDMENTS, ONLY IF REQUIRED, AT RATES RECOMMENDED BY THE TESTING RESULTS FOR THE PLANTS TO BE GROWN.

d. PROVIDE A TWO-GALLON SAMPLE WITH TESTING DATA THAT INCLUDES RECOMMENDATIONS FOR CHEMICAL ADDITIVES FOR THE TYPES OF PLANTS TO BE GROWN. SAMPLES AND TESTING DATA SHALL BE SUBMITTED AT THE SAME TIME.

16. COMPOST: BLENDED AND GROUND LEAF, WOOD AND OTHER PLANT-BASED MATERIAL, COMPOSTED FOR A MINIMUM OF 9 MONTHS AND AT TEMPERATURES ENOUGH TO BREAK DOWN ALL WOODY FIBERS, SEEDS AND LEAF STRUCTURES, FREE OF TOXIC MATERIAL AT LEVELS THAT ARE HARMFUL TO PLANTS OR HUMANS. SOURCE MATERIAL SHALL BE YARD WASTE TRIMMINGS BLENDED WITH OTHER PLANT OR MANURE-BASED MATERIAL DESIGNED TO PRODUCE COMPOST HIGH IN FUNGAL MATERIAL. COMPOST SHALL BE COMMERCIALLY PREPARED COMPOST AND MEET US COMPOST COUNCIL STA/TMECC CRITERIA OR AS MODIFIED IN THIS SECTION FOR "COMPOST AS A LANDSCAPE BACKFILL MIX COMPONENT".

a. COMPOST SHALL COMPLY WITH THE FOLLOWING PARAMETERS:

a.a. PH: 5.5 - 8.0.

a.b. SOIL SALT (ELECTRICAL CONDUCTIVITY): MAXIMUM 5 DS/M (MMHOS/CM).

a.c. MOISTURE CONTENT %, WET WEIGHT BASIS: 30 - 60.

a.d. PARTICLE SIZE, DRY WEIGHT BASIS: 98% PASS THROUGH 3/4 INCH SCREEN OR SMEAR.

a.e. STABILITY CARBON DIOXIDE EVOLUTION RATE: MG CO<sub>2</sub>-C/ G OM/ DAY < 2.

a.f. SOLVITA MATURITY TEST: >6.

a.g. PHYSICAL CONTAMINANTS (INERTS), %, DRY WEIGHT BASIS: <1%.

a.h. CHEMICAL CONTAMINANTS, MG/KG (PPM): MEET OR EXCEED US EPA CLASS A STANDARD, 40CFR § 503.13, TABLES 1 AND 3 LEVELS.

a.i. BIOLOGICAL CONTAMINANTS SELECT PATHOGENS FECAL COLIFORM BACTERIA, OR SALMONELLA, MEET OR EXCEED US EPA CLASS A STANDARD, 40 CFR § 503.32(A) LEVEL REQUIREMENTS.

17. PROVIDE A ONE QUART SAMPLE WITH MANUFACTURER'S LITERATURE AND MATERIAL CERTIFICATION THAT THE PRODUCT MEETS THE REQUIREMENTS.

18. INORGANIC SOIL AMENDMENTS

a. LIME: ASTM C 602, AGRICULTURAL LIMING MATERIAL CONTAINING A MINIMUM OF 80 PERCENT CALCIUM CARBONATE EQUIVALENT AND AS FOLLOWS:

a.a. CLASS: T, WITH A MINIMUM OF 99 PERCENT PASSING THROUGH A NO. 8 SIEVE

AND A MINIMUM OF 75 PERCENT PASING THROUGH A NO. 60 SIEVE. a.b. FORM: PROVIDE LIME IN FORM OF GROUND DOLOMITIC LIMESTONE.

19. SOIL TESTING FOR TOPSOIL, EXISTING SOIL, COMPOST, PLANTING MIXES

a. SUBMIT SOIL TEST ANALYSIS REPORT FOR EACH SAMPLE OF TOPSOIL, EXISTING SOIL, COMPOST AND PLANTING SOIL FROM AN APPROVED SOIL-TESTING LABORATORY, AS FOLLOWS: SUBMIT TOPSOIL, EXISTING SOIL, AND COMPOST FOR TESTING AT LEAST 8 WEEKS BEFORE SCHEDULED INSTALLATION OF PLANTING SOIL MIXES. SUBMIT PLANTING SOIL MIX TEST NO MORE THAN 2 WEEKS AFTER THE APPROVAL OF THE TOPSOIL, EXISTING SOIL, AND COMPOST. DO NOT SUBMIT PLANTING SOIL MIXES TO THE TESTING LABORATORY FOR TESTING UNTIL ALL TOPSOIL, EXISTING SOIL, AND COMPOST RESULTS HAVE BEEN APPROVED. IF TESTS FAIL TO MEET THE SPECIFICATIONS, OBTAIN OTHER SOURCES OF MATERIAL, RETEST AND RESUBMIT UNTIL ACCEPTED BY THE OWNER'S REPRESENTATIVE. ALL SOIL TESTING WILL BE AT THE EXPENSE OF THE CONTRACTOR.

20. FOR EACH TOPSOIL, EXISTING SOIL, AND PLANTING SOIL MIX SAMPLE, SUBMIT THE FOLLOWING ANALYSES:

a. PARTICLE SIZE ANALYSIS (% DRY WEIGHT)

b. USDA SOIL TEXTURE

c. PH AND BUFFER PH.

d. PERCENT ORGANIC CONTENT BY OVEN DRIED WEIGHT.

e. NUTRIENT LEVELS BY PARTS PER MILLION INCLUDING: PHOSPHORUS, POTASSIUM, MAGNESIUM, MANGANESE, IRON, ZINC AND CALCIUM. NUTRIENT TEST SHALL INCLUDE THE TESTING LABORATORY RECOMMENDATIONS FOR SUPPLEMENTAL ADDITIONS TO THE SOIL FOR OPTIMUM GROWTH OF THE PLANTINGS SPECIFIED.

f. SOLUBLE SALT BY ELECTRICAL CONDUCTIVITY OF A 1:2 SOIL WATER SAMPLE MEASURED IN MILLIOHM PER CM.

g. CATION EXCHANGE CAPACITY (CEC).

21. FOR EACH COMPOST PRODUCT, SUBMIT THE FOLLOWING ANALYSES:

a. PH

b. SALT CONCENTRATION (ELECTRICAL CONDUCTIVITY)

c. MOISTURE CONTENT %, WET WEIGHT BASIS

d. PARTICLE SIZE % PASSING A SELECTED MESH SIZE, DRY WEIGHT BASIS

e. STABILITY CARBON DIOXIDE EVOLUTION RATE MG CO2-C PER G OM PER DAY

f. PHYSICAL CONTAMINANTS (INERTS) %, DRY WEIGHT BASIS

g. US EPA CLASS A STANDARD, 40CFR § 503.13, TABLES 1 AND 3 LEVELS CHEMICAL CONTAMINANTS MG/KG (PPM)

22. IT IS THE RESPONSIBILITY OF THE CONTRACTOR TO BE AWARE OF ALL SURFACE AND SUBSURFACE CONDITIONS, AND TO NOTIFY THE OWNER'S REPRESENTATIVE, IN WRITING, OF ANY CIRCUMSTANCES THAT WOULD NEGATIVELY IMPACT THE HEALTH OF PLANTINGS. DO NOT PROCEED WITH WORK UNTIL UNSATISFACTORY CONDITIONS HAVE BEEN CORRECTED.

23. SHOULD SUBSURFACE DRAINAGE OR SOIL CONDITIONS BE ENCOUNTERED WHICH WOULD BE DETRIMENTAL TO GROWTH OR SURVIVAL OF PLANT MATERIAL, THE CONTRACTOR SHALL NOTIFY THE OWNER'S REPRESENTATIVE IN WRITING, STATING THE CONDITIONS AND SUBMIT A PROPOSAL COVERING COST OF CORRECTIONS. IF THE CONTRACTOR FAILS TO NOTIFY THE OWNER'S REPRESENTATIVE OF SUCH CONDITIONS, THEY SHALL REMAIN RESPONSIBLE FOR PLANT MATERIAL UNDER THE WARRANTEE CLAUSE OF THE SPECIFICATIONS.

24. DELIVERY, STORAGE, AND HANDLING

a. WEATHER: DO NOT MIX, DELIVER, PLACE OR GRADE SOILS WHEN FROZEN OR WITH MOISTURE ABOVE FIELD CAPACITY.

b. PROTECT SOIL AND SOIL STOCKPILES, INCLUDING THE STOCKPILES AT THE SOIL BLENDER'S YARD, FROM WIND, RAIN AND WASHING THAT CAN ERODE SOIL OR SEPARATE FINES AND COARSE MATERIAL, AND CONTAMINATION BY CHEMICALS, DUST AND DEBRIS THAT MAY BE DETRIMENTAL TO PLANTS OR SOIL DRAINAGE. COVER STOCKPILES WITH PLASTIC SHEETING OR FABRIC AT THE END OF EACH WORKDAY.

c. ALL MANUFACTURED PACKAGED PRODUCTS AND MATERIAL SHALL BE DELIVERED TO THE SITE IN UNOPENED CONTAINERS AND STORED IN A DRY ENCLOSED SPACE SUITABLE FOR THE MATERIAL AND MEETING ALL ENVIRONMENTAL REGULATIONS. BIOLOGICAL ADDITIVES SHALL BE PROTECTED FROM EXTREME COLD AND HEAT. ALL PRODUCTS SHALL BE FRESHLY MANUFACTURED AND DATED FOR THE YEAR IN WHICH THE PRODUCTS ARE

d. DELIVER ALL CHEMICAL AMENDMENTS IN ORIGINAL, UNOPENED CONTAINERS WITH ORIGINAL LABELS INTACT AND LEGIBLE, WHICH STATE THE GUARANTEED CHEMICAL ANALYSIS. STORE ALL CHEMICALS IN A WEATHER PROTECTED ENCLOSURE.

#### RELATED ITEMS

25. EDGING: ALL PLANT BEDS AND TURF AREAS MUST BE SEPARATED WITH A CULTIVATED EDGE, AS SHOWN IN THE DETAIL ON THIS SHEET.

26. MULCH: APPLY A 3" LAYER OF SHREDDED HARDWOOD BARK MULCH IN PLANTING BEDS AND AROUND TREES. MULCH SHALL CONSIST OF PURE WOOD, BROWN IN COLOR AND BE FREE OF ALL FOREIGN SUBSTANCES. PROVIDE AND INSTALL PRE-EMERGENT HERBICIDE PRIOR TO MULCH INSTALLATION PER MANUFACTURERS INSTRUCTIONS.

27. TREE TIES: CONTRACTOR SHALL USE AN APPROVED TREE TIE SYSTEM. TREE GUYING TO BE FLAT WOVEN POLYPROPYLENE MATERIAL, 3/4-INCH-WIDE, WITH A TENSILE STRENGTH OF 900 LBS. HOSE AND WIRE WILL NOT BE ACCEPTED. SUBJECT TO COMPLIANCE WITH THESE REQUIREMENTS, PROVIDE ONE OF THE FOLLOWING PRODUCTS, OR APPROVED EQUAL:

"ARBORTIE GREEN" MANUFACTURED BY DEEP ROOT PARTNERS, LP

"LEONARD TREE TIE WEBBING GREEN" MANUFACTURED BY A.M. LEONARD, INC.

MAINTENANCE AND CLEAN-UP

28. THE CONTRACTOR SHALL PROVIDE ALL WATER, WATERING DEVICES AND LABOR NEEDED TO IRRIGATE PLANT MATERIALS UNTIL PROVISIONAL ACCEPTANCE OF THE PROJECT. THE CONTRACTOR SHALL SUPPLY ENOUGH WATER TO MAINTAIN THE PLANT'S HEALTHY CONDITION.

29. REMOVE ALL RUBBISH, EQUIPMENT, AND MATERIAL AND LEAVE THE AREA IN A NEAT, CLEAN CONDITION EACH DAY. MAINTAIN PAVED AREAS UTILIZED FOR HAULING EQUIPMENT AND MATERIALS BY OTHER TRADES IN A CLEAN AND UNOBSTRUCTED CONDITION AT ALL TIMES. REMOVE SOIL OR DIRT THAT ACCUMULATES DUE TO PLANTING OPERATIONS EACH DAY.

INSPECTION, WARRANTIES AND GUARANTEE

30. AT THE COMPLETION OF PLANTING OPERATIONS, ALL PLANTS SHALL BE INSPECTED BY A LICENSED LANDSCAPE ARCHITECT TO VERIFY THAT ALL LANDSCAPING HAS BEEN INSTALLED IN ACCORDANCE WITH THE APPROVED PLANTING PLAN AND IS IN A HEALTHY CONDITION. CONTRACTOR SHALL REPLACE IMMEDIATELY ANY PLANTS NOT IN HEALTHY AND VIGOROUS CONDITION AT THAT TIME AT NO EXPENSE TO THE OWNER. ONCE IT CAN BE VERIFIED THAT ALL PLANTINGS CONFORM TO THE APPROVED PLAN AND ARE FOUND TO BE HEALTHY, THE LANDSCAPE ARCHITECT SHALL PREPARE AN AFFIDAVIT TESTIFYING TO THESE FACTS AND THE OWNER SHALL SUBMIT IT TO CITY STAFF.

31. OWNER'S REPRESENTATIVE RESERVES THE RIGHT TO REJECT AT ANY TIME OR PLACE PRIOR TO FINAL ACCEPTANCE OF WORK, ANY AND ALL PLANTS WHICH, IN THEIR OPINION, FAIL TO MEET THESE SPECIFICATION REQUIREMENTS.

32. CONTRACTOR SHALL GUARANTEE TREES, SHRUBS, PERENNIALS AND TURF FOR ONE CALENDAR YEAR FOLLOWING PROVISIONAL ACCEPTANCE OF THE OVERALL PROJECT. DURING THE GUARANTEE PERIOD, PLANTS THAT DIE DUE TO NATURAL CAUSES OR THAT ARE UNHEALTHY OR UNSIGHTLY IN CONDITION, SHALL BE REPLACED BY THE CONTRACTOR. PLANTS USED FOR THE REPLACEMENT SHALL BE OF THE SAME VARIETY AND SIZE AS ORIGINALLY SPECIFIED IN THE PLANT SCHEDULE. REPLACEMENTS SHALL BE MADE WITHIN ONE WEEK OF REQUEST PENDING FAVORABLE SEASONAL PLANTING CONDITIONS. GUARANTEE WILL NOT BE ENFORCED SHOULD THE PLANT MATERIAL DIE DUE TO VANDALISM, OVER OR UNDER WATERING BY THE OWNER, IMPROPER MAINTENANCE PROCEDURES CARRIED OUT BY THE OWNER INVOLVING LAWN MOWER DAMAGE, OVER FERTILIZATION, ACTS NOT RELATED TO CONTRACTUAL RESPONSIBILITIES OF CONTRACTOR OR SIMILAR CIRCUMSTANCES BEYOND THE CONTROL OF THE CONTRACTOR.

REVISIONS DA

(\$\text{Im} \text{ev}\$) Horn

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