

VERIZON PROJECT NUMBER: 16968208

VERIZON SITE NAME:

SITE TYPE:

TOWER OWNER:

CARRIER/APPLICANT:

ELECTRIC PROVIDER:

TELCO PROVIDER:

A&E FIRM:

CROWN CASTLE

CONTACTS:

USA INC. DISTRIC

TOWER HEIGHT:

KCYC LEES SUMMIT DT MONOPOLE 180'-0"

BUSINESS UNIT #: 877803

207 SE DOUGLAS SITE ADDRESS: LEE'S SUMMIT, MO 64063

COUNTY:

DATE

DATE

MO - CITY OF LEE'S SUMMIT 2015 **JURISDICTION:**

JACKSON

LOCATION MAP

IURISDICTIONAL APPROVAL:

BEDMINSTER, NJ 07921






IRVING, TEXAS 75038

VERIZON SITE NUMBER: **16968208**

BU #: **877803** KCYC LEES SUMMIT DT 207 SE DOUGLAS LEE'S SUMMIT, MO 64063 EXISTING 180'-0" MONOPOLE

1				
		ISSU	ED FOR:	·,
REV	DATE	DRWN	DESCRIPTION	DES./QA
1	06/21/2023	RC	FINAL	EAN
2	07/27/2023	RC	FINAL	AMT
3	09/18/2023	TFL	FINAL	AMT
4	10/17/2023	RC	FINAL	АМТ
5	01/09/2024	TFL	FINAL	АМТ
6	01/23/2024	RC	FINAL	АМТ
7	03/29/2024	RC	FINAL	АМТ
8	04/05/2024	RC	FINAL	АМТ
9	04/19/2024	RC	FINAL	АМТ
10	07/25/2024	RC	FINAL	АМТ
11	08/14/2024	RC	FINAL	АМТ
12	09/19/2024	RC	FINAL	AMT

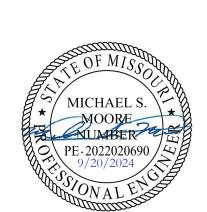

IT IS A VIOLATION OF LAW FOR ANY PERSON, JNLESS THEY ARE ACTING UNDER THE DIRECTION OF A LICENSED PROFESSIONAL ENGINEER, TO ALTER THIS DOCUMENT.

VERIZON INITIAL BUILD

VERIZON SIGNATURE BLOCK

CROWN CASTLE USA INC. SIGNATURE BLOCK

APPROVAL

RADIO

TELCO

MICROWAVE

EQUIPMENT

APPROVAI

SITE ACQUISITION

CONSTRUCTION

PROJECT MANAGER

UTILITY MANAGER

LANDLORD

SITE ACQUISITION

CONSTRUCTION

APPROVALS

SIGNATURE

SIGNATURE

SITE INFORMATION CROWN CASTLE USA INC. KCYC LEES SUMMIT DT SITE NAME: SITE ADDRESS: 207 SE DOUGLAS LEE'S SUMMIT, MO 64063 COUNTY: JACKSON 61-340-20-06-00-0-00-000 MAP/PARCEL #: AREA OF CONSTRUCTION: **EXISTING** LATITUDE: 38.913842 / 38° 54' 49.83" N LONGITUDE: -94.376328 / -94° 22' 34.78" W LAT/LONG TYPE: NAD83 GROUND ELEVATION: 1006.96' **CURRENT ZONING: JURISDICTION:** MO - CITY OF LEE'S SUMMIT 2015 OCCUPANCY CLASSIFICATION: U TYPE OF CONSTRUCTION: A.D.A. COMPLIANCE: FACILITY IS UNMANNED AND NOT FOR **HUMAN HABITATION** CITY OF LEES SUMMIT PROPERTY OWNER: PO BOX 1600 LEES SUMMIT, MO 64063-7600

CROWN CASTLE

2000 CORPORATE DRIVE

CANONSBURG, PA 15317

180 WASHINGTON VALLEY ROAD

VERIZON WIRELESS

BEDMINSTER, NJ 07921

EVERGY

AT&T

PROJECT TEAM

1200 MACARTHUR BLVD, SUITE 200

EVE ZWEIG - PROJECT MANAGER

jonathan.macconkey@crowncastle.com"V

JONATHAN MACCONKEY - CONSTRUCTION MANAGER

TRYLON

1825 W. WALNUT HILL

IRVING, TEXAS 75038

eve.zweig@crowncastle.com

MAHWAH, NJ 07430

LANE, SUITE 120

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C-2	OVERALL SITE PLAN
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ATTACHED	TOWER SURVEY & AS-BUILT SURVEY

DRAWING INDEX

SHEET DESCRIPTION

SHEET#

ALL DRAWINGS CONTAINED HEREIN ARE FORMATTED FOR
22X34. CONTRACTOR SHALL VERIFY ALL PLANS AND EXISTING
DIMENSIONS AND CONDITIONS ON THE JOB SITE AND SHALL
IMMEDIATELY NOTIFY THE ENGINEER IN WRITING OF ANY
DISCREPANCIES BEFORE PROCEEDING WITH THE WORK OR
BE RESPONSIBLE FOR SAME.

PROJECT DESCRIPTION

THE PURPOSE OF THIS PROJECT IS TO ENHANCE BROADBAND CONNECTIVITY AND CAPACITY TO THE EXISTING ELIGIBLE WIRELESS FACILITY.

- OWER SCOPE OF WORK:
- INSTALL (9) ANTENNAS
- INSTALL (9) RRUS
- INSTALL (2) 6x12 HYBRID CABLES
- INSTALL (1) SITE PRO 1 RMQP-4126-HK PLATFORM MOUNT
- INSTALL (1) OVP

ROUND SCOPE OF WORK:

- INSTALL (3) SIDE BY SIDE MOUNTS
- INSTALL (1) 11'-0"x4'-0" EQUIPMENT PAD • INSTALL (1) EQUIPMENT PLINTH
- INSTALL (1) RF CABINET
- INSTALL (1) BATTERY CABINET • INSTALL (1) RACK MOUNTED OVP
- INSTALL (1) GPS ANTENNA
- INSTALL (1) EQUIPMENT H-FRAME
- INSTALL (1) ILC CABINET
- INSTALL (1) APPLETON PLUG ON NEW ILC CABINET • INSTALL (1) 200A METER SOCKET W/ DISCONNECT
- INSTALL (2) SERVICE LIGHTS

PRIOR TO ACCESSING/ENTERING THE SITE YOU MUST CONTACT THE CROWN NOC AT (800) 788-7011 & CROWN CONSTRUCTION MANAGER

CONTRACTOR PMI REQUIREMENTS

https://pmi.vzwsmart.com PMI ACCESSED AT SMART TOOL VENDOR PROJECT NUMBER

VzW LOCATION CODE (PSLC) 716127

*** PMI AND REQUIREMENTS ALSO EMBEDDED IN MOUNT ANALYSIS REPORT

MOUNT MODIFICATION REQUIRED

VzW APPROVED SMART KIT VENDORS

REFER TO MOUNT MODIFICATION DRAWINGS PAGE FOR VzW SMART KIT APPROVED VENDORS



DRIVING DIRECTIONS FROM VERIZON LOCAL OFFICE (180 WASHINGTON VALLEY ROAD, BEDMINSTER, NJ 07921): DEPART AND HEAD TOWARD WASHINGTON VALLEY RD / COUNTY HWY-620, TURN LEFT ONTO WASHINGTON VALLEY RD / COUNTY HWY-620, BEAR RIGHT TOWARD US-202 S / US-206 S / US HIGHWAY 202 206, TURN LEFT ONTO US-202 S / US-206 S / US HIGHWAY 202 206, KEEP LEFT TO STAY ON I-78 W, KEEP STRAIGHT TO GET ONTO I-81 S, KEEP LEFT, HEADING TOWARD PITTSBURGH, KEEP LEFT, HEADING TOWARD WHEELING, AT EXIT 5A, HEAD LEFT ON THE RAMP FOR I-470 WEST TOWARD COLUMBUS / OH, KEEP STRAIGHT TO GET ONTO I-70 W, KEEP RIGHT, HEADING TOWARD SAINT LOUIS, KEEP STRAIGHT, HEADING TOWARD KANSAS CITY, KEEP RIGHT, HEADING TOWARD KANSAS CITY, TURN RIGHT ONTO E LANGSFORD RD, TURN LEFT, ARRIVE AT 207 SE DOUGLAS, LEE'S SUMMIT, MO 64063

APPLICABLE CODES/REFERENCE **DOCUMENTS**

ALL WORK SHALL BE PERFORMED AND MATERIALS INSTALLED IN ACCORDANCE WITH THE CURRENT EDITIONS OF THE FOLLOWING CODES AS ADOPTED BY THE LOCAL GOVERNING AUTHORITIES. NOTHING IN THESE PLANS IS TO BE CONSTRUED TO PERMIT WORK NOT CONFORMING TO THESE CODES:

CODE TYPE CODE 2018 IBC BUILDING 2018 IMC **MECHANICAL** 2017 NEC ELECTRICAL

REFERENCE DOCUMENTS:

DATED: 01/04/2023 RFDS REVISION: N/A DATED: 12/22/2022

ORDER ID: 640178 REVISION: 1

> CALL MISSOURI ONE CALL CALL 3 WORKING DAYS BEFORE YOU DIG!

STRUCTURAL ANALYSIS: CROWN CASTLE

Cloud 9 Li

SHEET NUMBER:

CROWN CASTLE USA INC. SITE ACTIVITY REQUIREMENTS:

- 1. NOTICE TO PROCEED— NO WORK SHALL COMMENCE PRIOR TO CROWN CASTLE USA INC. WRITTEN NOTICE TO PROCEED (NTP) AND THE ISSUANCE OF A PURCHASE ORDER. PRIOR TO ACCESSING/ENTERING THE SITE YOU MUST CONTACT THE CROWN CASTLE USA INC. NOC AT 800-788-7011 & THE CROWN CASTLE USA INC. CONSTRUCTION MANAGER.
- 2. "LOOK UP" CROWN CASTLE USA INC. SAFETY CLIMB REQUIREMENT
- THE INTEGRITY OF THE SAFETY CLIMB AND ALL COMPONENTS OF THE CLIMBING FACILITY SHALL BE CONSIDERED DURING ALL STAGES OF DESIGN, INSTALLATION, AND INSPECTION. TOWER MODIFICATION, MOUNT REINFORCEMENTS, AND/OR EQUIPMENT INSTALLATIONS SHALL NOT COMPROMISE THE INTEGRITY OR FUNCTIONAL USE OF THE SAFETY CLIMB OR ANY COMPONENTS OF THE CLIMBING FACILITY ON THE STRUCTURE. THIS SHALL INCLUDE, BUT NOT BE LIMITED TO: PINCHING OF THE WIRE ROPE, BENDING OF THE WIRE ROPE FROM ITS SUPPORTS, DIRECT CONTACT OR CLOSE PROXIMITY TO THE WIRE ROPE WHICH MAY CAUSE FRICTIONAL WEAR, IMPACT TO THE ANCHORAGE POINTS IN ANY WAY, OR TO IMPEDE/BLOCK ITS INTENDED USE. ANY COMPROMISED SAFETY CLIMB, INCLUDING EXISTING CONDITIONS MUST BE TAGGED OUT AND REPORTED TO YOUR CROWN CASTLE USA INC. POC OR CALL THE NOC TO GENERATE A SAFETY CLIMB MAINTENANCE AND CONTRACTOR NOTICE TICKET.
- PRIOR TO THE START OF CONSTRUCTION, ALL REQUIRED JURISDICTIONAL PERMITS SHALL BE OBTAINED. THIS INCLUDES, BUT IS NOT LIMITED TO, BUILDING, ELECTRICAL, MECHANICAL, FIRE, FLOOD ZONE, ENVIRONMENTAL, AND ZONING. AFTER ONSITE ACTIVITIES AND CONSTRUCTION ARE COMPLETED, ALL REQUIRED PERMITS SHALL BE SATISFIED AND CLOSED OUT ACCORDING TO LOCAL JURISDICTIONAL REQUIREMENTS
- ALL CONSTRUCTION MEANS AND METHODS; INCLUDING BUT NOT LIMITED TO, ERECTION PLANS, RIGGING PLANS, CLIMBING PLANS, AND RESCUE PLANS SHALL BE THE RESPONSIBILITY OF THE GENERAL CONTRACTOR RESPONSIBLE FOR THE EXECUTION OF THE WORK CONTAINED HEREIN, AND SHALL MEET ANSI/ASSE A10.48 (LATEST EDITION); FEDERAL, STATE, AND LOCAL REGULATIONS; AND ANY APPLICABLE INDUSTRY CONSENSUS STANDARDS RELATED TO THE CONSTRUCTION ACTIVITIES BEING PERFORMED. ALL RIGGING PLANS SHALL ADHERE TO ANSI/ASSE A10.48 (LATEST EDITION) AND CROWN CASTLE USA INC. STANDARD CED-STD-10253, INCLUDING THE REQUIRED INVOLVEMENT OF A QUALIFIED ENGINEER FOR CLASS IV CONSTRUCTION, TO CERTIFY THE SUPPORTING STRUCTURE(S) IN ACCORDANCE WITH ANSI/TIA-322 (LATEST EDITION)
- 5. ALL SITE WORK TO COMPLY WITH QAS-STD-10068 "INSTALLATION STANDARDS FOR CONSTRUCTION ACTIVITIES ON CROWN CASTLE USA INC. TOWER SITE," CED-STD-10294 "STANDARD FOR INSTALLATION OF MOUNTS AND APPURTENANCES," AND LATEST VERSION OF ANSI/TIA-1019-A-2012 "STANDARD FOR INSTALLATION, ALTERATION, AND MAINTENANCE OF ANTENNA SUPPORTING STRUCTURES AND ANTENNAS.
- IF THE SPECIFIED EQUIPMENT CAN NOT BE INSTALLED AS SHOWN ON THESE DRAWINGS, THE CONTRACTOR SHALL PROPOSE AN ALTERNATIVE INSTALLATION FOR APPROVAL BY CROWN CASTLE USA INC. PRIOR TO PROCEEDING WITH ANY SUCH CHANGE OF INSTALLATION.
- ALL MATERIALS FURNISHED AND INSTALLED SHALL BE IN STRICT ACCORDANCE WITH ALL APPLICABLE CODES, REGULATIONS AND ORDINANCES. CONTRACTOR SHALL ISSUE ALL APPROPRIATE NOTICES AND COMPLY WITH ALL LAWS, ORDINANCES, RULES, REGULATIONS AND LAWFUL ORDERS OF ANY PUBLIC AUTHORITY REGARDING THE PERFORMANCE OF THE WORK. ALL WORK CARRIED OUT SHALL COMPLY WITH ALL APPLICABLE MUNICIPAL AND UTILITY COMPANY SPECIFICATIONS AND LOCAL JURISDICTIONAL CODES, ORDINANCES AND APPLICABLE REGULATIONS.
- THE CONTRACTOR SHALL INSTALL ALL EQUIPMENT AND MATERIALS IN ACCORDANCE WITH MANUFACTURER'S RECOMMENDATIONS UNLESS SPECIFICALLY STATED OTHERWISE.
- THE CONTRACTOR SHALL CONTACT UTILITY LOCATING SERVICES PRIOR TO THE START OF CONSTRUCTION.
- 10. ALL EXISTING ACTIVE SEWER, WATER, GAS, ELECTRIC AND OTHER UTILITIES WHERE ENCOUNTERED IN THE WORK, SHALL BE PROTECTED AT ALL TIMES AND WHERE REQUIRED FOR THE PROPER EXECUTION OF THE WORK, SHALL BE RELOCATED AS DIRECTED BY CONTRACTOR. EXTREME CAUTION SHOULD BE USED BY THE CONTRACTOR WHEN EXCAVATING OR DRILLING PIERS AROUND OR NEAR UTILITIES. CONTRACTOR SHALL PROVIDE SAFETY TRAINING FOR THE WORKING CREW. THIS WILL INCLUDE BUT NOT BE LIMITED TO A) FALL PROTECTION B) CONFINED SPACE C) ELECTRICAL SAFETY D) TRENCHING AND EXCAVATION E) CONSTRUCTION SAFETY PROCEDURES.
- 11. ALL SITE WORK SHALL BE AS INDICATED ON THE STAMPED CONSTRUCTION DRAWINGS AND PROJECT SPECIFICATIONS, LATEST APPROVED REVISION.
- 12. CONTRACTOR SHALL KEEP THE SITE FREE FROM ACCUMULATING WASTE MATERIAL, DEBRIS, AND TRASH AT THE COMPLETION OF THE WORK. IF NECESSARY, RUBBISH, STUMPS, DEBRIS, STICKS, STONES AND OTHER REFUSE SHALL BE REMOVED FROM THE SITE AND DISPOSED OF LEGALLY.
- 13. ALL EXISTING INACTIVE SEWER, WATER, GAS, ELECTRIC AND OTHER UTILITIES, WHICH INTERFERE WITH THE EXECUTION OF THE WORK, SHALL BE REMOVED AND/OR CAPPED, PLUGGED OR OTHERWISE DISCONTINUED AT POINTS WHICH WILL NOT INTERFERE WITH THE EXECUTION OF THE WORK, SUBJECT TO THE APPROVAL OF CONTRACTOR, TOWER OWNER, CROWN CASTLE USA INC., AND/OR LOCAL UTILITIES
- 14. THE CONTRACTOR SHALL PROVIDE SITE SIGNAGE IN ACCORDANCE WITH THE TECHNICAL SPECIFICATION FOR SITE SIGNAGE REQUIRED BY LOCAL JURISDICTION AND SIGNAGE REQUIRED ON INDIVIDUAL PIECES OF EQUIPMENT, ROOMS, AND SHELTERS.
- 15. THE SITE SHALL BE GRADED TO CAUSE SURFACE WATER TO FLOW AWAY FROM THE CARRIER'S EQUIPMENT AND TOWER AREAS.
- 16. THE SUB GRADE SHALL BE COMPACTED AND BROUGHT TO A SMOOTH UNIFORM GRADE PRIOR TO FINISHED URFACE APPLICATION.
- 17. THE AREAS OF THE OWNERS PROPERTY DISTURBED BY THE WORK AND NOT COVERED BY THE TOWER, EQUIPMENT OR DRIVEWAY, SHALL BE GRADED TO A UNIFORM SLOPE, AND STABILIZED TO PREVENT EROSION AS SPECIFIED ON THE CONSTRUCTION DRAWINGS AND/OR PROJECT SPECIFICATIONS.
- 18. CONTRACTOR SHALL MINIMIZE DISTURBANCE TO EXISTING SITE DURING CONSTRUCTION. EROSION CONTROL MEASURES, IF REQUIRED DURING CONSTRUCTION, SHALL BE IN CONFORMANCE WITH THE LOCAL GUIDELINES FOR EROSION AND SEDIMENT CONTROL.
- 19. THE CONTRACTOR SHALL PROTECT EXISTING IMPROVEMENTS, PAVEMENTS, CURBS, LANDSCAPING AND STRUCTURES. ANY DAMAGED PART SHALL BE REPAIRED AT CONTRACTOR'S EXPENSE TO THE SATISFACTION
- 20. CONTRACTOR SHALL LEGALLY AND PROPERLY DISPOSE OF ALL SCRAP MATERIALS SUCH AS COAXIAL CABLES AND OTHER ITEMS REMOVED FROM THE EXISTING FACILITY. ANTENNAS REMOVED SHALL BE RETURNED TO THE OWNER'S DESIGNATED LOCATION.
- 21. CONTRACTOR SHALL LEAVE PREMISES IN CLEAN CONDITION. TRASH AND DEBRIS SHOULD BE REMOVED FROM SITE ON A DAILY BASIS.
- 22. NO FILL OR EMBANKMENT MATERIAL SHALL BE PLACED ON FROZEN GROUND. FROZEN MATERIALS, SNOW OR ICE SHALL NOT BE PLACED IN ANY FILL OR EMBANKMENT.

GENERAL NOTES:

- FOR THE PURPOSE OF CONSTRUCTION DRAWING, THE FOLLOWING DEFINITIONS SHALL APPLY: GENERAL CONTRACTOR RESPONSIBLE FOR CONSTRUCTION CONTRACTOR:
- CARRIER: VERIZON TOWER OWNER: CROWN CASTLE USA INC.
- 2. THESE DRAWINGS HAVE BEEN PREPARED USING STANDARDS OF PROFESSIONAL CARE AND COMPLETENESS NORMALLY EXERCISED UNDER SIMILAR CIRCUMSTANCES BY REPUTABLE ENGINEERS IN THIS OR SIMILAR LOCALITIES. IT IS ASSUMED THAT THE WORK DEPICTED WILL BE PERFORMED BY AN EXPERIENCED CONTRACTOR AND/OR WORKPEOPLE WHO HAVE A WORKING KNOWLEDGE OF THE APPLICABLE CODE STANDARDS AND REQUIREMENTS AND OF INDUSTRY ACCEPTED STANDARD GOOD PRACTICE. AS NOT EVERY CONDITION OR ELEMENT IS (OR CAN BE) EXPLICITLY SHOWN ON THESE DRAWINGS, THE CONTRACTOR SHALL USE INDUSTRY ACCEPTED STANDARD GOOD PRACTICE FOR MISCELLANEOUS WORK NOT EXPLICITLY SHOWN.
- THESE DRAWINGS REPRESENT THE FINISHED STRUCTURE. THEY DO NOT INDICATE THE MEANS OR METHODS OF CONSTRUCTION. THE CONTRACTOR SHALL BE SOLELY RESPONSIBLE FOR THE CONSTRUCTION MEANS, METHODS TECHNIQUES, SEQUENCES, AND PROCEDURES. THE CONTRACTOR SHALL PROVIDE ALL MEASURES NECESSARY FOR PROTECTION OF LIFE AND PROPERTY DURING CONSTRUCTION. SUCH MEASURES SHALL INCLUDE, BUT NOT BE LIMITED TO, BRACING, FORMWORK, SHORING, ETC. SITE VISITS BY THE ENGINEER OR HIS REPRESENTATIVE WILL NOT INCLUDE INSPECTION OF THESE ITEMS AND IS FOR STRUCTURAL OBSERVATION OF THE FINISHED STRUCTURE ONLY.
- NOTES AND DETAILS IN THE CONSTRUCTION DRAWINGS SHALL TAKE PRECEDENCE OVER GENERAL NOTES AND TYPICAL DETAILS. WHERE NO DETAILS ARE SHOWN, CONSTRUCTION SHALL CONFORM TO SIMILAR WORK ON THE PROJECT, AND/OR AS PROVIDED FOR IN THE CONTRACT DOCUMENTS. WHERE DISCREPANCIES OCCUR BETWEEN PLANS, DETAILS, GENERAL NOTES, AND SPECIFICATIONS, THE GREATER, MORE STRICT REQUIREMENTS, SHALL GOVERN. IF FURTHER CLARIFICATION IS REQUIRED CONTACT THE ENGINEER OF RECORD.
- SUBSTANTIAL EFFORT HAS BEEN MADE TO PROVIDE ACCURATE DIMENSIONS AND MEASUREMENTS ON THE DRAWINGS TO ASSIST IN THE FABRICATION AND/OR PLACEMENT OF CONSTRUCTION ELEMENTS BUT IT IS THE SOLE RESPONSIBILITY OF THE CONTRACTOR TO FIELD VERIFY THE DIMENSIONS, MEASUREMENTS, AND/OR CLEARANCES SHOWN IN THE CONSTRUCTION DRAWINGS PRIOR TO FABRICATION OR CUTTING OF ANY NEW OR EXISTING CONSTRUCTION ELEMENTS. IF IT IS DETERMINED THAT THERE ARE DISCREPANCIES AND/OR CONFLICTS WITH THE CONSTRUCTION DRAWINGS THE ENGINEER OF RECORD IS TO BE NOTIFIED AS SOON AS POSSIBLE.
- PRIOR TO THE SUBMISSION OF BIDS, THE BIDDING CONTRACTOR SHALL VISIT THE CELL SITE TO FAMILIARIZE WITH THE EXISTING CONDITIONS AND TO CONFIRM THAT THE WORK CAN BE ACCOMPLISHED AS SHOWN ON THE CONSTRUCTION DRAWINGS. ANY DISCREPANCY FOUND SHALL BE BROUGHT TO THE ATTENTION OF CROWN CASTLE
- 7. ALL MATERIALS FURNISHED AND INSTALLED SHALL BE IN STRICT ACCORDANCE WITH ALL APPLICABLE CODES, REGULATIONS AND ORDINANCES. CONTRACTOR SHALL ISSUE ALL APPROPRIATE NOTICES AND COMPLY WITH ALL LAWS, ORDINANCES, RULES, REGULATIONS AND LAWFUL ORDERS OF ANY PUBLIC AUTHORITY REGARDING THE PERFORMANCE OF THE WORK. ALL WORK CARRIED OUT SHALL COMPLY WITH ALL APPLICABLE MUNICIPAL AND UTILITY COMPANY SPECIFICATIONS AND LOCAL JURISDICTIONAL CODES, ORDINANCES AND APPLICABLE REGULATIONS.
- UNLESS NOTED OTHERWISE, THE WORK SHALL INCLUDE FURNISHING MATERIALS, EQUIPMENT, APPURTENANCES AND LABOR NECESSARY TO COMPLETE ALL INSTALLATIONS AS INDICATED ON THE DRAWINGS.
- 9. THE CONTRACTOR SHALL INSTALL ALL EQUIPMENT AND MATERIALS IN ACCORDANCE WITH MANUFACTURER'S RECOMMENDATIONS UNLESS SPECIFICALLY STATED OTHERWISE.
- 10. IF THE SPECIFIED EQUIPMENT CAN NOT BE INSTALLED AS SHOWN ON THESE DRAWINGS, THE CONTRACTOR SHALL PROPOSE AN ALTERNATIVE INSTALLATION FOR APPROVAL BY THE CARRIER AND CROWN CASTLE PRIOR TO PROCEEDING
- WITH ANY SUCH CHANGE OF INSTALLATION. 11. CONTRACTOR IS TO PERFORM A SITE INVESTIGATION AND IS TO DETERMINE THE BEST ROUTING OF ALL CONDUITS FOR POWER, AND TELCO AND FOR GROUNDING CABLES AS SHOWN IN THE POWER, TELCO, AND GROUNDING PLAN
- DRAWINGS 12. THE CONTRACTOR SHALL PROTECT EXISTING IMPROVEMENTS, PAVEMENTS, CURBS, LANDSCAPING AND STRUCTURES. ANY DAMAGED PART SHALL BE REPAIRED AT CONTRACTOR'S EXPENSE TO THE SATISFACTION OF CROWN CASTLE USA INC. 13. CONTRACTOR SHALL LEGALLY AND PROPERLY DISPOSE OF ALL SCRAP MATERIALS SUCH AS COAXIAL CABLES AND
- OTHER ITEMS REMOVED FROM THE EXISTING FACILITY. ANTENNAS REMOVED SHALL BE RETURNED TO THE OWNER'S DESIGNATED LOCATION. 14. CONTRACTOR SHALL LEAVE PREMISES IN CLEAN CONDITION. TRASH AND DEBRIS SHOULD BE REMOVED FROM SITE ON

CONCRETE, FOUNDATIONS, AND REINFORCING STEEL:

- ALL CONCRETE WORK SHALL BE IN ACCORDANCE WITH THE ACI 301, ACI 318, ACI 336, ASTM A184, ASTM A185 AND THE DESIGN AND CONSTRUCTION SPECIFICATION FOR CAST-IN-PLACE CONCRETE. 2. UNLESS NOTED OTHERWISE, SOIL BEARING PRESSURE USED FOR DESIGN OF SLABS AND FOUNDATIONS IS ASSUMED
- TO BE 1000 psf 3. ALL CONCRETE SHALL HAVE A MINIMUM COMPRESSIVE STRENGTH (f'c) OF 3000 psi AT 28 DAYS, UNLESS NOTED OTHERWISE. NO MORE THAN 90 MINUTES SHALL ELAPSE FROM BATCH TIME TO TIME OF PLACEMENT UNLESS APPROVED BY THE ENGINEER OF RECORD. TEMPERATURE OF CONCRETE SHALL NOT EXCEED 90°f AT TIME OF PLACEMENT
- CONCRETE EXPOSED TO FREEZE—THAW CYCLES SHALL CONTAIN AIR ENTRAINING ADMIXTURES. AMOUNT OF AIR ENTRAINMENT TO BE BASED ON SIZE OF AGGREGATE AND F3 CLASS EXPOSURE (VERY SEVERE). CEMENT USED TO BE TYPE II PORTLAND CEMENT WITH A MAXIMUM WATER-TO-CEMENT RATIO (W/C) OF 0.45.
- ALL STEEL REINFORCING SHALL CONFORM TO ASTM A615. ALL WELDED WIRE FABRIC (WWF) SHALL CONFORM TO ASTM A185. ALL SPLICES SHALL BE CLASS "B" TENSION SPLICES, UNLESS NOTED OTHERWISE. ALL HOOKS SHALL BE STANDARD 90 DEGREE HOOKS, UNLESS NOTED OTHERWISE. YIELD STRENGTH (Fy) OF STANDARD DEFORMED BARS ARE AS FOLLOWS:
- #4 BARS AND SMALLER.. #5 BARS AND LARGER.. .60 ksi THE FOLLOWING MINIMUM CONCRETE COVER SHALL BE PROVIDED FOR REINFORCING STEEL UNLESS SHOWN OTHERWISE ON DRAWINGS:
- CONCRETE CAST AGAINST AND PERMANENTLY EXPOSED TO EARTH... CONCRETE EXPOSED TO EARTH OR WEATHER: #6 BARS AND LARGER... #5 BARS AND SMALLER ...
- CONCRETE NOT EXPOSED TO EARTH OR WEATHER: SLAB AND WALLS... BEAMS AND COLUMNS1-1/2"
- 7. A TOOLED EDGE OR A 3/4" CHAMFER SHALL BE PROVIDED AT ALL EXPOSED EDGES OF CONCRETE, UNLESS NOTED OTHERWISE, IN ACCORDANCE WITH ACI 301 SECTION 4.2.4.

GREENFIELD GROUNDING NOTES:

- ALL GROUND ELECTRODE SYSTEMS (INCLUDING TELECOMMUNICATION, RADIO, LIGHTNING PROTECTION AND AC POWER GES'S) SHALL BE BONDED TOGETHER AT OR BELOW GRADE, BY TWO OR MORE COPPER BONDING CONDUCTORS IN ACCORDANCE WITH THE NEC.
- THE CONTRACTOR SHALL PERFORM IEEE FALL—OF—POTENTAL RESISTANCE TO EARTH TESTING (PER IEEE 1100 AND 81) FOR GROUND ELECTRODE SYSTEMS, THE CONTRACTOR SHALL FURNISH AND INSTALL SUPPLEMENTAL GROUND ELECTRODES AS NEEDED TO ACHIEVE A TEST RESULT OF 5 OHMS OR LESS.
- THE CONTRACTOR IS RESPONSIBLE FOR PROPERLY SEQUENCING GROUNDING AND UNDERGROUND CONDUIT INSTALLATION AS TO PREVENT ANY LOSS OF CONTINUITY IN THE GROUNDING SYSTEM OR DAMAGE TO THE CONDUIT AND PROVIDE
- 4. METAL CONDUIT AND TRAY SHALL BE GROUNDED AND MADE ELECTRICALLY CONTINUOUS WITH LISTED BONDING FITTINGS OR BY BONDING ACROSS THE DISCONTINUITY WITH #6 COPPER WIRE UL APPROVED GROUNDING TYPE CONDUIT
- METAL RACEWAY SHALL NOT BE USED AS THE NEC REQUIRED EQUIPMENT GROUND CONDUCTOR. STRANDED COPPER CONDUCTORS WITH GREEN INSULATION, SIZED IN ACCORDANCE WITH THE NEC, SHALL BE FURNISHED AND INSTALLED
- EACH CABINET FRAME SHALL BE DIRECTLY CONNECTED TO THE MASTER GROUND BAR WITH GREEN INSULATED SUPPLEMENTAL EQUIPMENT GROUND WIRES, #6 STRANDED COPPER OR LARGER FOR INDOOR BTS; #2 BARE SOLID TINNED
- ALUMINUM CONDUCTOR OR COPPER CLAD STEEL CONDUCTOR SHALL NOT BE USED FOR GROUNDING CONNECTIONS.
- 11. EXOTHERMIC WELDS SHALL BE USED FOR ALL GROUNDING CONNECTIONS BELOW GRADE.
- 12. ALL GROUND CONNECTIONS ABOVE GRADE (INTERIOR AND EXTERIOR) SHALL BE FORMED USING HIGH PRESS CRIMPS.
- 13. COMPRESSION GROUND CONNECTIONS MAY BE REPLACED BY EXOTHERMIC WELD CONNECTIONS.
- 14. ICE BRIDGE BONDING CONDUCTORS SHALL BE EXOTHERMICALLY BONDED OR BOLTED TO THE BRIDGE AND THE TOWER GROUND BAR.
- 15. APPROVED ANTIOXIDANT COATINGS (i.e. CONDUCTIVE GEL OR PASTE) SHALL BE USED ON ALL COMPRESSION AND BOLTED GROUND CONNECTIONS.
- 17. MISCELLANEOUS ELECTRICAL AND NON-ELECTRICAL METAL BOXES, FRAMES AND SUPPORTS SHALL BE BONDED TO THE GROUND RING, IN ACCORDANCE WITH THE NEC.
- 18. BOND ALL METALLIC OBJECTS WITHIN 6 ft OF MAIN GROUND RING WITH (1) #2 BARE SOLID TINNED COPPER GROUND CONDUCTOR.
- 19. GROUND CONDUCTORS USED FOR THE FACILITY GROUNDING AND LIGHTNING PROTECTION SYSTEMS SHALL NOT BE ROUTED THROUGH METALLIC OBJECTS THAT FORM A RING AROUND THE CONDUCTOR, SUCH AS METALLIC CONDUITS, METAL SUPPORT CLIPS OR SLEEVES THROUGH WALLS OR FLOORS. WHEN IT IS REQUIRED TO BE HOUSED IN CONDUIT TO MEET CODE REQUIREMENTS OR LOCAL CONDITIONS, NON-METALLIC MATERIAL SUCH AS PVC CONDUIT SHALL BE
- 20. ALL GROUNDS THAT TRANSITION FROM BELOW GRADE TO ABOVE GRADE MUST BE #2 BARE SOLID TINNED COPPER IN 3/4" NON-METALLIC, FLEXIBLE CONDUIT FROM 24" BELOW GRADE TO WITHIN 3" TO 6" OF CAD-WELD TERMINATION POINT. THE EXPOSED END OF THE CONDUIT MUST BE SEALED WITH SILICONE CAULK. (ADD TRANSITIONING GROUND STANDARD DETAIL AS WELL).
- 21. BUILDINGS WHERE THE MAIN GROUNDING CONDUCTORS ARE REQUIRED TO BE ROUTED TO GRADE, THE CONTRACTOR SHALL ROUTE TWO GROUNDING CONDUCTORS FROM THE ROOFTOP, TOWERS, AND WATER TOWERS GROUNDING RING, TO THE EXISTING GROUNDING SYSTEM, THE GROUNDING CONDUCTORS SHALL NOT BE SMALLER THAN 2/0 COPPER. ROOFTOP GROUNDING RING SHALL BE BONDED TO THE EXISTING GROUNDING SYSTEM, THE BUILDING STEEL COLUMNS, LIGHTNING PROTECTION SYSTEM, AND BUILDING MAIN WATER LINE (FERROUS OR NONFERROUS METAL PIPING ONLY).

ELECTRICAL INSTALLATION NOTES:

- ALL ELECTRICAL WORK SHALL BE PERFORMED IN ACCORDANCE WITH THE PROJECT SPECIFICATIONS, NEC AND ALL APPLICABLE
- FEDERAL, STATE, AND LOCAL CODES/ORDINANCES. CONDUIT ROUTINGS ARE SCHEMATIC. CONTRACTOR SHALL INSTALL CONDUITS SO THAT ACCESS TO EQUIPMENT IS NOT BLOCKED
- AND TRIP HAZARDS ARE ELIMINATED.
- 3. WIRING, RACEWAY AND SUPPORT METHODS AND MATERIALS SHALL COMPLY WITH THE REQUIREMENTS OF THE NEC. 4. ALL CIRCUITS SHALL BE SEGREGATED AND MAINTAIN MINIMUM CABLE SEPARATION AS REQUIRED BY THE NEC.
- 4.1. ALL EQUIPMENT SHALL BEAR THE UNDERWRITERS LABORATORIES LABEL OF APPROVAL, AND SHALL CONFORM TO REQUIREMENT OF THE NATIONAL ELECTRICAL CODE.
 - ALL OVERCURRENT DEVICES SHALL HAVE AN INTERRUPTING CURRENT RATING THAT SHALL BE GREATER THAN THE SHORT CIRCUIT CURRENT TO WHICH THEY ARE SUBJECTED, 22,000 AIC MINIMUM. VERYIFY AVAILABLE SHORT CIRCUIT CURRENT DOES NOT EXCEED THE RATING OF ELECTRICAL EQUIPMENT IN ACCORDANCE WITH ARTICLE 110.24 NEC OR THE MOST CURRENT ADOPTED CODE PRE THE GOVERNING JURISDICTION.
- 5. EACH END OF EVERY POWER PHASE CONDUCTOR, GROUNDING CONDUCTOR, AND TELCO CONDUCTOR OR CABLE SHALL BE LABELED WITH COLOR-CODED INSULATION OR ELECTRICAL TAPE (3M BRAND, 1/2" PLASTIC ELECTRICAL TAPE WITH UV PROTECTION, OR EQUAL). THE IDENTIFICATION METHOD SHALL CONFORM WITH NEC AND OSHA.
- ALL ELECTRICAL COMPONENTS SHALL BE CLEARLY LABELED WITH LAMICOID TAGS SHOWING THEIR RATED VOLTAGE, PHASE CONFIGURATION, WIRE CONFIGURATION, POWER OR AMPACITY RATING AND BRANCH CIRCUIT ID NUMBERS (i.e. PANEL BOARD AND CIRCUIT ID'S).
- PANEL BOARDS (ID NUMBERS) SHALL BE CLEARLY LABELED WITH PLASTIC LABELS 8. ALL TIE WRAPS SHALL BE CUT FLUSH WITH APPROVED CUTTING TOOL TO REMOVE SHARP EDGES
- ALL POWER AND EQUIPMENT GROUND WIRING IN TUBING OR CONDUIT SHALL BE SINGLE COPPER CONDUCTOR (#14 OR LARGER) WITH TYPE THHW, THWN, THWN-2, XHHW, XHHW-2, THW, THW-2, RHW, OR RHW-2 INSULATION UNLESS OTHERWISE SPECIFIED.
- 10. SUPPLEMENTAL EQUIPMENT GROUND WIRING LOCATED INDOORS SHALL BE SINGLE COPPER CONDUCTOR (#6 OR LARGER) WITH
- TYPE THHW, THWN, THWN-2, XHHW, XHHW-2, THW, THW-2, RHW, OR RHW-2 INSULATION UNLESS OTHERWISE SPECIFIED. 11. POWER AND CONTROL WIRING IN FLEXIBLE CORD SHALL BE MULTI-CONDUCTOR, TYPE SOOW CORD (#14 OR LARGER) UNLESS
- OTHERWISE SPECIFIED. 12. POWER AND CONTROL WIRING FOR USE IN CABLE TRAY SHALL BE MULTI-CONDUCTOR, TYPE TO CABLE (#14 OR LARGER), WITH TYPE THHW, THWN, THWN-2, XHHW, XHHW-2, THW, THW-2, RHW, OR RHW-2 INSULATION UNLESS OTHERWISE SPECIFIED.
- 13. ALL POWER AND GROUNDING CONNECTIONS SHALL BE CRIMP-STYLE, COMPRESSION WIRE LUGS AND WIRE NUTS BY THOMAS AND BETTS (OR EQUAL). LUGS AND WIRE NUTS SHALL BE RATED FOR OPERATION NOT LESS THAN 75°C (90°C IF AVAILABLE).
- 14. RACEWAY AND CABLE TRAY SHALL BE LISTED OR LABELED FOR ELECTRICAL USE IN ACCORDANCE WITH NEMA, UL, ANSI/IEEE 15. ELECTRICAL METALLIC TUBING (EMT), INTERMEDIATE METAL CONDUIT (IMC), OR RIGID METAL CONDUIT (RMC) SHALL BE USED FOR
- EXPOSED INDOOR LOCATIONS.
- 16. ELECTRICAL METALLIC TUBING (EMT) OR METAL—CLAD CABLE (MC) SHALL BE USED FOR CONCEALED INDOOR LOCATIONS. 17. SCHEDULE 40 PVC UNDERGROUND ON STRAIGHTS AND SCHEDULE 80 PVC FOR ALL ELBOWS/90s AND ALL APPROVED ABOVE
- GRADE PVC CONDUIT 18. LIQUID-TIGHT FLEXIBLE METALLIC CONDUIT (LIQUID-TITE FLEX) SHALL BE USED INDOORS AND OUTDOORS, WHERE VIBRATION
- OCCURS OR FLEXIBILITY IS NEEDED. 19. CONDUIT AND TUBING FITTINGS SHALL BE THREADED OR COMPRESSION-TYPE AND APPROVED FOR THE LOCATION USED. SET
- SCREW FITTINGS ARE NOT ACCEPTABLE. 20. CABINETS, BOXES AND WIRE WAYS SHALL BE LABELED FOR ELECTRICAL USE IN ACCORDANCE WITH NEMA, UL, ANSI/IEEE AND
- 21. WIREWAYS SHALL BE METAL WITH AN ENAMEL FINISH AND INCLUDE A HINGED COVER, DESIGNED TO SWING OPEN DOWNWARDS
- (WIREMOLD SPECMATE WIREWAY). 22. SLOTTED WIRING DUCT SHALL BE PVC AND INCLUDE COVER (PANDUIT TYPE E OR EQUAL).
- 23. CONDUITS SHALL BE FASTENED SECURELY IN PLACE WITH APPROVED NON-PERFORATED STRAPS AND HANGERS. EXPLOSIVE
- DEVICES (i.e. POWDER-ACTUATED) FOR ATTACHING HANGERS TO STRUCTURE WILL NOT BE PERMITTED. CLOSELY FOLLOW THE LINES OF THE STRUCTURE, MAINTAIN CLOSE PROXIMITY TO THE STRUCTURE AND KEEP CONDUITS IN TIGHT ENVELOPES. CHANGES IN DIRECTION TO ROUTE AROUND OBSTACLES SHALL BE MADE WITH CONDUIT OUTLET BODIES. CONDUIT SHALL BE INSTALLED IN A NEAT AND WORKMANLIKE MANNER. PARALLEL AND PERPENDICULAR TO STRUCTURE WALL AND CEILING LINES. ALL CONDUIT SHALL BE FISHED TO CLEAR OBSTRUCTIONS. ENDS OF CONDUITS SHALL BE TEMPORARILY CAPPED FLUSH TO FINISH GRADE TO PREVENT CONCRETE, PLASTER OR DIRT FROM ENTERING. CONDUITS SHALL BE RIGIDLY CLAMPED TO BOXES BY GALVANIZED
- MALLEABLE IRON BUSHING ON INSIDE AND GALVANIZED MALLEABLE IRON LOCKNUT ON OUTSIDE AND INSIDE 24. EQUIPMENT CABINETS, TERMINAL BOXES, JUNCTION BOXES AND PULL BOXES SHALL BE GALVANIZED OR EPOXY-COATED SHEET STEEL. SHALL MEET OR EXCEED UL 50 AND BE RATED NEMA 1 (OR BETTER) FOR INTERIOR LOCATIONS AND NEMA 3R (OR BETTER) FOR EXTERIOR LOCATIONS.
- 25. METAL RECEPTACLE, SWITCH AND DEVICE BOXES SHALL BE GALVANIZED, EPOXY—COATED OR NON—CORRODING; SHALL MEET OR EXCEED UL 514A AND NEMA OS 1 AND BE RATED NEMA 1 (OR BETTER) FOR INTERIOR LOCATIONS AND WEATHER PROTECTED (WP OR BETTER) FOR EXTERIOR LOCATIONS.
- 26. NONMETALLIC RECEPTACLE, SWITCH AND DEVICE BOXES SHALL MEET OR EXCEED NEMA OS 2 (NEWEST REVISION) AND BE RATED NEMA 1 (OR BETTER) FOR INTERIOR LOCATIONS AND WEATHER PROTECTED (WP OR BETTER) FOR EXTERIOR LOCATIONS.
- 27. THE CONTRACTOR SHALL NOTIFY AND OBTAIN NECESSARY AUTHORIZATION FROM THE CARRIER AND/OR CROWN CASTLE USA INC BEFORE COMMENCING WORK ON THE AC POWER DISTRIBUTION PANELS. 28. THE CONTRACTOR SHALL PROVIDE NECESSARY TAGGING ON THE BREAKERS, CABLES AND DISTRIBUTION PANELS IN ACCORDANCE
- WITH THE APPLICABLE CODES AND STANDARDS TO SAFEGUARD LIFE AND PROPERTY. 29. INSTALL LAMICOID LABEL ON THE METER CENTER TO SHOW "VERIZON".
- 30. ALL EMPTY/SPARE CONDUITS THAT ARE INSTALLED ARE TO HAVE A METERED MULE TAPE PULL CORD INSTALLED.

CONDUCTOR COLOR CODE						
SYSTEM	CONDUCTOR	COLOR				
	A PHASE	BLACK				
120/240V, 1Ø	B PHASE	RED				
120/2400, 10	NEUTRAL	WHITE				
	GROUND	GREEN				
	A PHASE	BLACK				
	B PHASE	RED				
120/208V, 3Ø	C PHASE	BLUE				
	NEUTRAL	WHITE				
	GROUND	GREEN				
	A PHASE	BROWN				
	B PHASE	ORANGE OR PURPLE				
277/480V, 3Ø	C PHASE	YELLOW				
	NEUTRAL	GREY				
	GROUND	GREEN				
DC VOLTAGE	POS (+)	RED**				
DO VOLTAGE	NEG (-)	BLACK**				

* SEE NEC 210.5(C)(1) AND (2) ** POLARITY MARKED AT TERMINATION

FACILITY INTERFACE FRAME

LONG TERM EVOLUTION

NATIONAL ELECTRIC CODE

MASTER GROUND BAR

RADIO BASE STATION

REMOTE RADIO HEAD

SMART INTEGRATED DEVICE

TOWER MOUNTED AMPLIFIER

UNIVERSAL MOBILE TELECOMMUNICATIONS SYSTEM

REMOTE RADIO UNIT

REMOTE ELECTRIC TILT

RADIO FREQUENCY DATA SHEET

GLOBAL POSITIONING SYSTEM

GLOBAL SYSTEM FOR MOBILE

ABBREVIATIONS:

GEN

GPS

GSM

MGB

MW

NEC

QTY

RBS

RET

RFDS

RRU

SIAD

TMA

TYP

UMTS

W.P.

RECT

ANTENNA EXISTING

GENERATOR

MICROWAVE

PROPOSED

QUANTITY

RECTIFIER

TYPICAL

WORK POINT

POWER PLANT

APWA UNIFORM COLOR CODE:

PROPOSED EXCAVATION EMPORARY SURVEY MARKINGS LECTRIC POWER LINES, CABLES, CONDUIT, AND LIGHTING CABLES GAS, OIL, STEAM, PETROLEUM, OR GASEOUS MATERIALS

COMMUNICATION, ALARM OR SIGNAL LINES, CABLES, OR CONDUIT AND TRAFFIC LOOPS POTABLE WATER ECLAIMED WATER, IRRIGATION, AND

SEWERS AND DRAIN LINES

SLURRY LINES

JURISDICTIONAL APPROVAL:



MAHWAH, NJ 07430

BEDMINSTER, NJ 07921



IRVING, TEXAS 75038

1825 W. WALNUT HILL LANE, SUITE 120

/ERIZON SITE NUMBER: **16968208**

BU #: **877803** KCYC LEES SUMMIT DT 207 SE DOUGLAS LEE'S SUMMIT, MO 64063 EXISTING 180'-0" MONOPOLE

		ISSUI	ED FOR:	
REV	DATE	DRWN	DESCRIPTION	DES./Q
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11	08/14/2024	RC	FINAL	AMT
12	09/19/2024	RC	FINAL	AMT



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SHEET NUMBER:

REVISION:

A DAILY BASIS.

- CLAMPS
- WITH THE POWER CIRCUITS TO BTS EQUIPMENT.
- COPPER FOR OUTDOOR BTS. CONNECTIONS TO THE GROUND BUS SHALL NOT BE DOUBLED UP OR STACKED BACK TO BACK CONNECTIONS ON OPPOSITE SIDE OF THE GROUND BUS ARE PERMITTED.
- ALL EXTERIOR GROUND CONDUCTORS BETWEEN EQUIPMENT/GROUND BARS AND THE GROUND RING SHALL BE #2 SOLID TINNED COPPER UNLESS OTHERWISE INDICATED. USE OF 90° BENDS IN THE PROTECTION GROUNDING CONDUCTORS SHALL BE AVOIDED WHEN 45° BENDS CAN BE ADEQUATELY SUPPORTED.
- 16. ALL EXTERIOR GROUND CONNECTIONS SHALL BE COATED WITH A CORROSION RESISTANT MATERIAL
- USED. WHERE USE OF METAL CONDUIT IS UNAVOIDABLE (i.e., NONMETALLIC CONDUIT PROHIBITED BY LOCAL CODE) THE GROUND CONDUCTOR SHALL BE BONDED TO EACH END OF THE METAL CONDUIT.



JOB SUMMARY

Service Completed Date: 09/07/2023

Customer: GEOLINE SURVEYING INC Phone Number:

Billing Address City State Zip
13430 NW 104TH TERRACE ALACHUA FL 32615

Job Details

 Jobsite Location
 City
 State
 Zip

 undefined undefined
 Lee's Summit
 Missouri

Work Order Number 588762-92726 Customer Service Phone Num

Job Num PO Num 877

questions regarding the results of this scanning, please contact the lead GPRS technician on this project.

Project Manager: Jordan Liberty Email: Jordan.Liberty@gprsinc.com

Thank you for using GPRS on your project. We appreciate the opportunity to work with you. If you have

EQUIPMENT USED

The following equipment was used on this project:

- Underground GPR Antenna: This GPR Antenna uses frequencies ranging from 250 MHz to 450 MHz and is
 mounted in a stroller frame that rolls over the surface. Data is displayed on a screen and marked in the field in realtime. The surface needs to be reasonably smooth and unobstructed to obtain readable scans. Obstructions such as
 curbs, landscaping, and vegetation will limit the efficacy of GPR. The total effective scan depth can be as much as 8'
 or more with this antenna but can vary widely depending on the soil conditions and composition. Some soil types,
 such as clay, may limit maximum depths to 3' or less. As depth increases, targets must be larger to be detected, and
 non-metallic targets can be challenging to locate. The depths provided should always be treated as estimates as their
 accuracy can be affected by multiple factors. For more information, please visit: Link
- EM Pipe Locator: Electromagnetic Pipe and Cable Locator. Detects electromagnetic fields. Used to actively trace
 conductive pipes and tracer wires, or passively detect power and radio signals traveling along conductive pipes and
 utilities. For more information, please visit: <u>Link</u>
- GPS: This handheld unit offers accuracy down to 4 inches; however, the accuracy achieved will depend on the
 satellite environment at the time of collection and is not considered survey-grade. Features can be collected as
 points, lines, or areas and then exported as a KML/KMZ or overlaid on a CAD drawing. For more information, please
 visit: Link

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JOB SUMMARY

WORK PERFORMED

GPRS performed the following work on this project:

UNDERGROUND UTILITY

- The total area scanned was approximately 15000 square feet.
- The effective depth of GPR will vary throughout a site depending on a variety of factors such as surface type, surface conditions, soil type, and moisture content. At this site, the maximum effective GPR depth was approximately 2 feet.

RESULTS AND NOTES

Details on Unlocatable Utilities	On the north side of the generator there is a t in the gas line where the gas goes under ground and that line is unlocatable. There are 2 comm lines that come off the east pole and enter the complex and then stop locating. There was a sprint box in there and a man came out and talked to me said that soeing had come and cut out a bunch of their wires.						
Client's Scope of Work	Locate utilties from cell tower to end point in right of ways.						
Additional Notes	Located gas, communication and electric. Please stay 2 feet off of marks.						
Located Utilities:	Electric, Communication, Natural Gas Unlocatable Utility Types: Communication Gas						
Marking Medium:	Spray Paint, Flags	Client performed 811	No				
Client Provided Drawings:	No	Location Request:					
	1.72	Findings Walkthrough done with client:	No : Client not on site				

<u>GPRS</u>

JOB SUMMARY

Page 1 of 5



CONTACT / SIGNATURE INFORMATION
TERMS & CONDITIONS

http://www.gprsinc.com/termsandconditions.html SIGNATURE

CONTACT NAM

CONTACT NAME ZACK WALL

386-418-0500

Page 4 of 5

Page 2 of 5



Page 5 of 5

JURISDICTIONAL APPROVAL:







1825 W. WALNUT HILL LANE, SUITE 120 IRVING, TEXAS 75038

VERIZON SITE NUMBER: 16968208

BU #: **877803 KCYC LEES SUMMIT DT**207 SE DOUGLAS
LEE'S SUMMIT, MO 64063
EXISTING 180'-0" MONOPOLE

3444							
	ISSUED FOR:						
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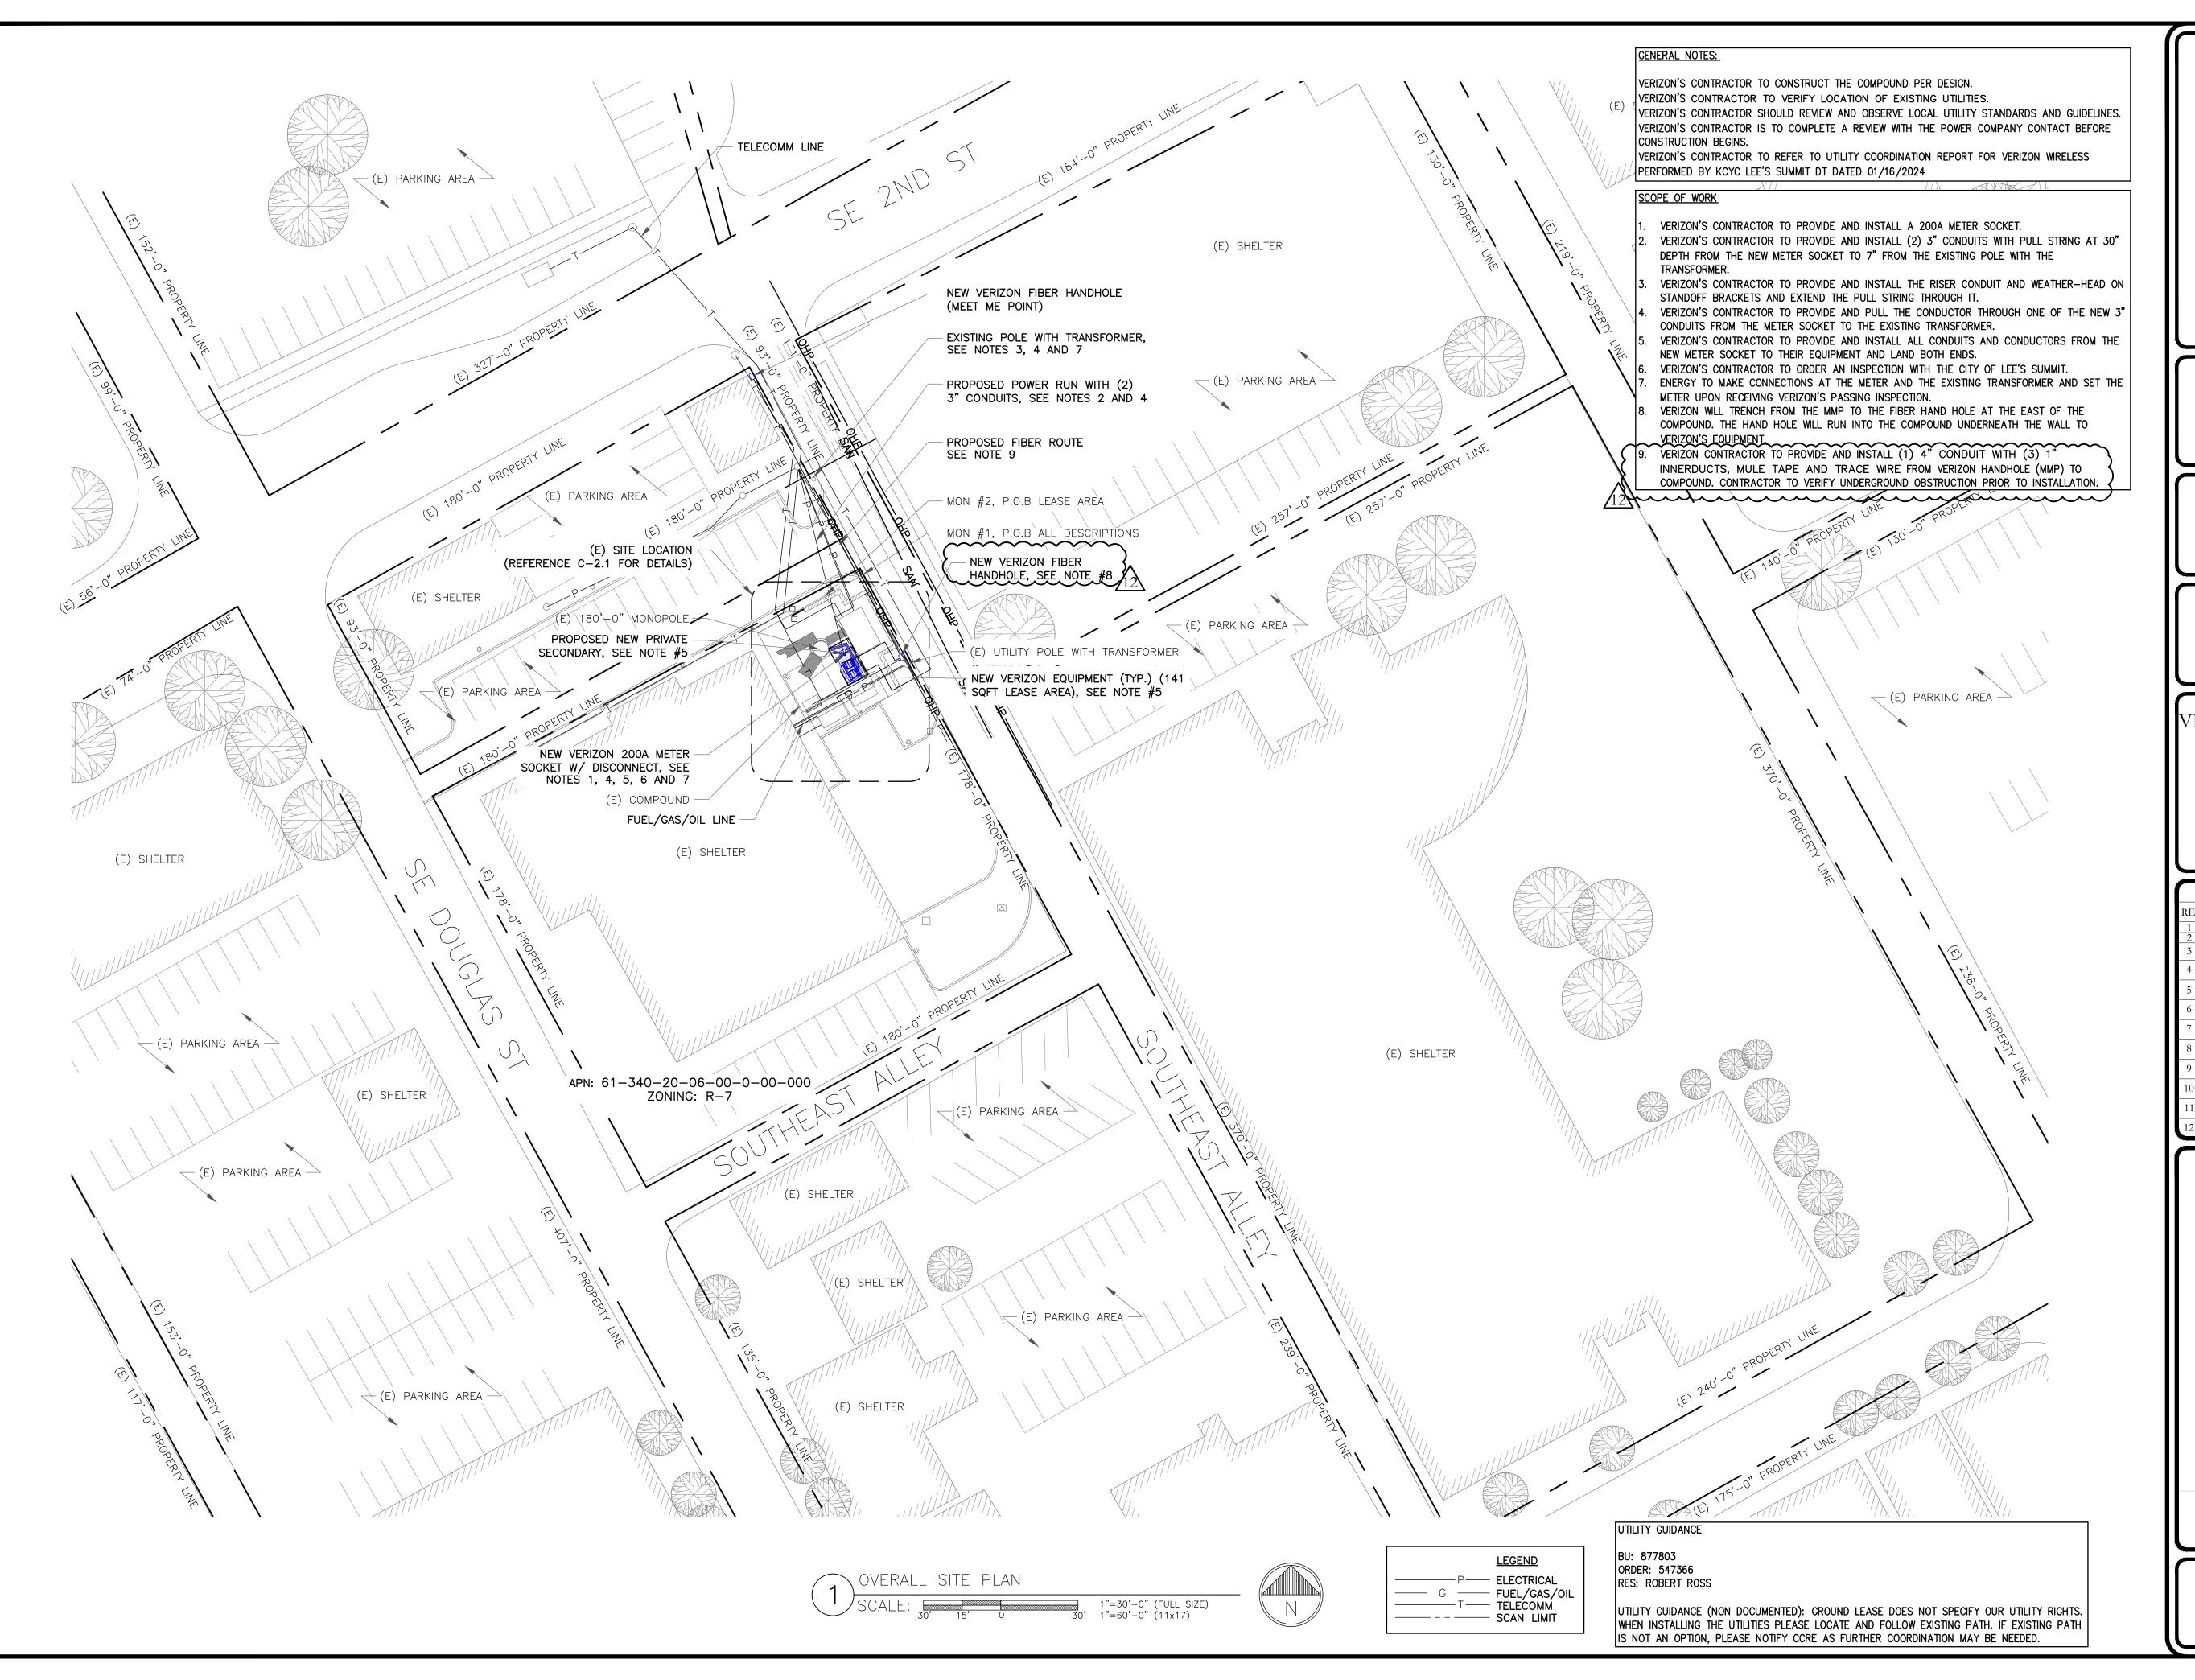


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SHEET NUMBER:

C-1

12







BEDMINSTER, NJ 07921

1200 MACARTHUR BLVD, SUITE 200 MAHWAH, NJ 07430



1825 W. WALNUT HILL LANE, SUITE 120 IRVING, TEXAS 75038

VERIZON SITE NUMBER: **16968208**

BU #: 877803

KCYC LEES SUMMIT DT

207 SE DOUGLAS

LEE'S SUMMIT, MO 64063

EXISTING 180'-0" MONOPOLE

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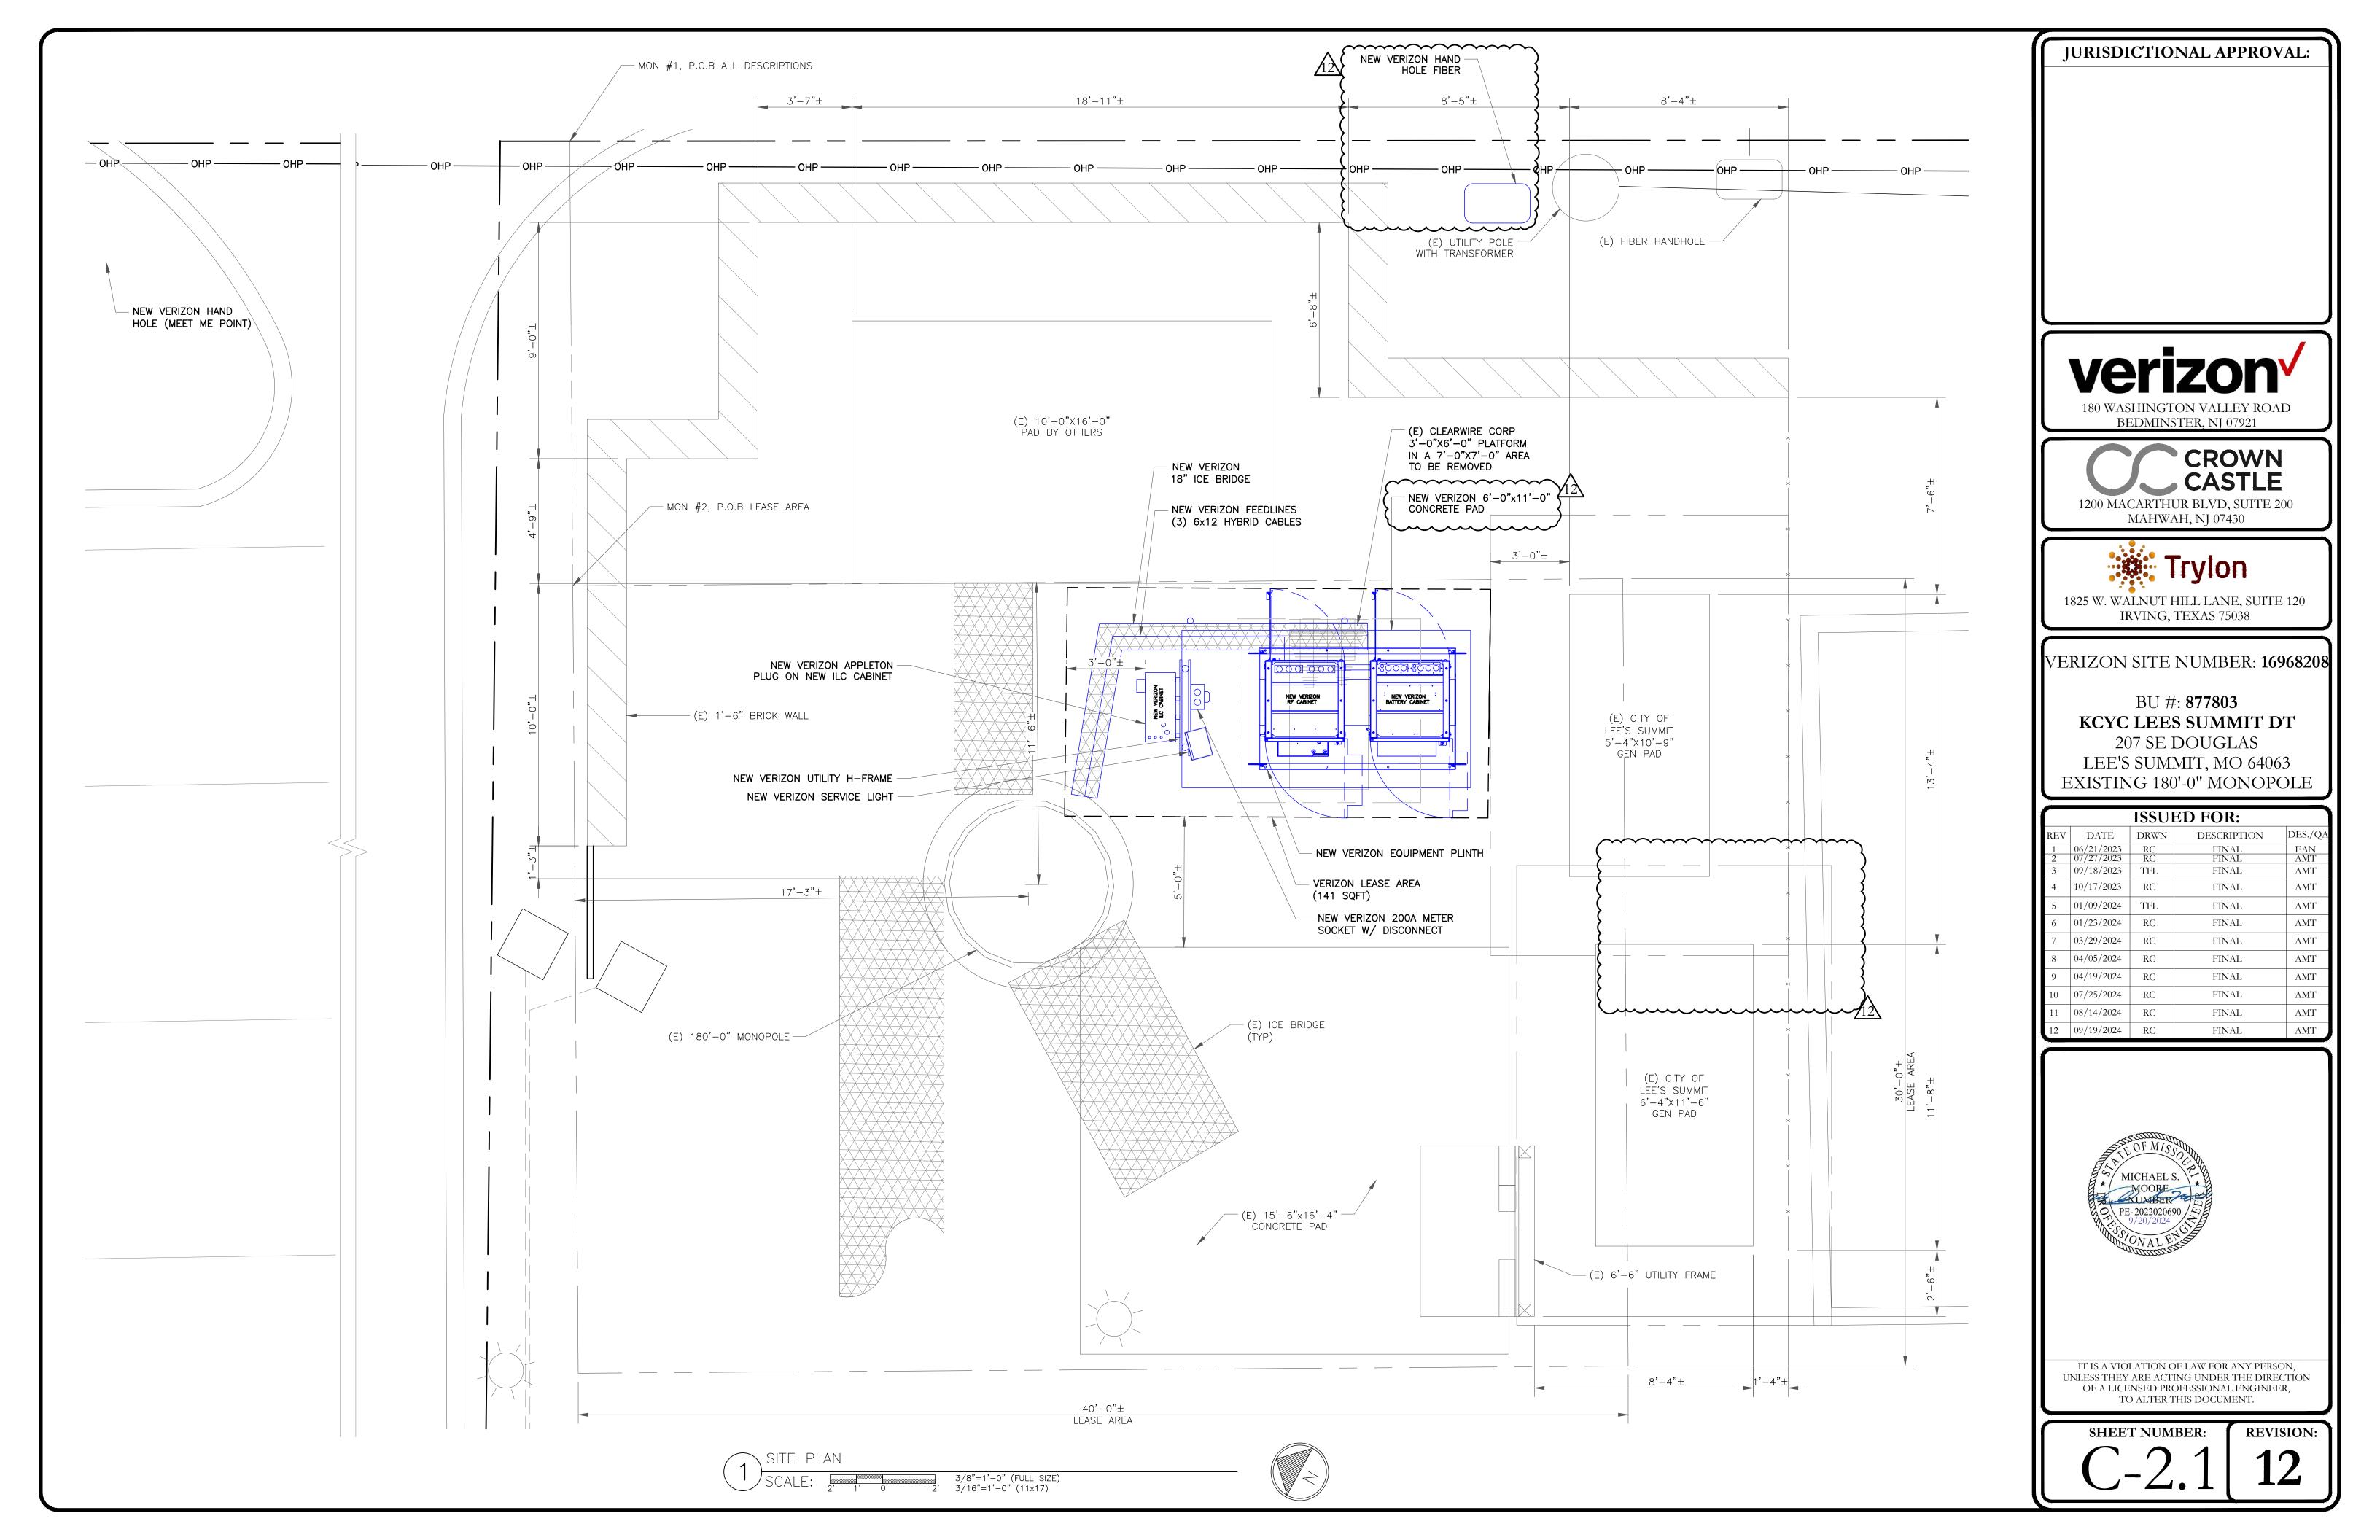



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SHEET NUMBER:

REVISION:

C-2





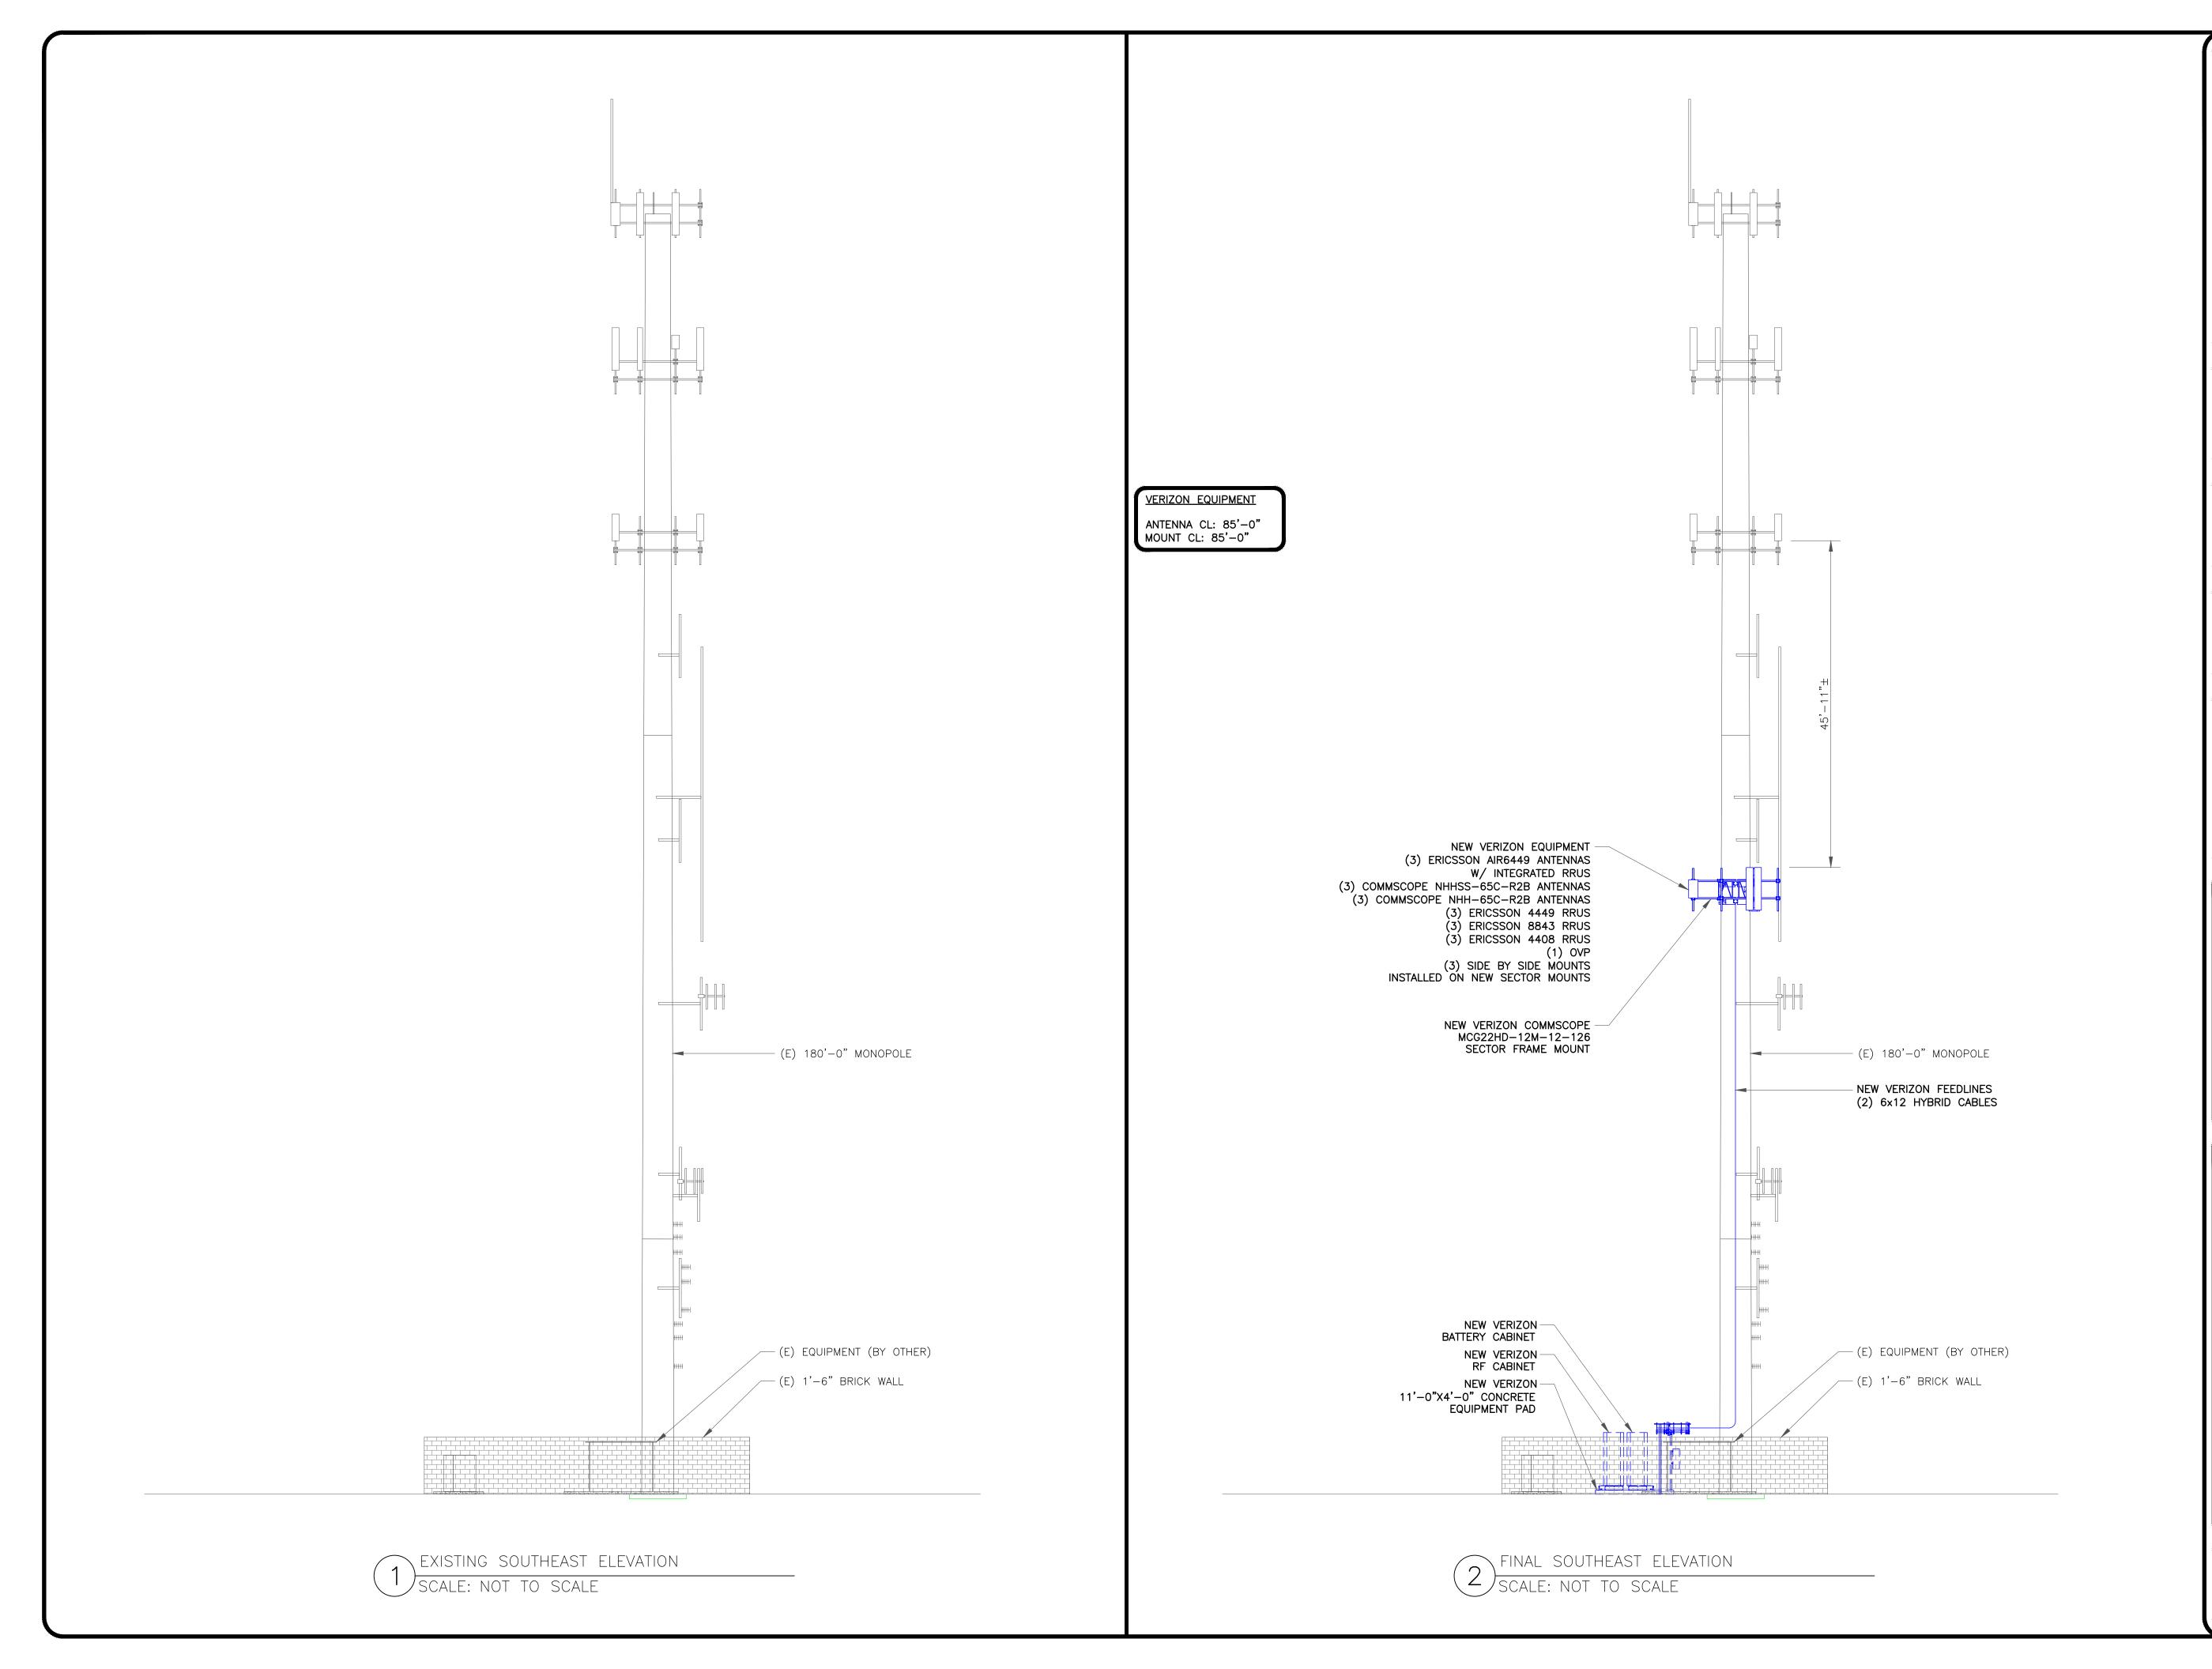

CROWN

1200 MACARTHUR BLVD, SUITE 200 MAHWAH, NJ 07430



1825 W. WALNUT HILL LANE, SUITE 120 IRVING, TEXAS 75038

VERIZON SITE NUMBER: 16968208

BU #: **877803 KCYC LEES SUMMIT DT**207 SE DOUGLAS
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C-3


12

						ANTENNA SCHEDULE				
SECTOR	POS.	TECHNOLOGY	RAD CENTER	AZIMUTH	ANTENNA MANUFACTURER	ANTENNA MODEL	MECH. TILT	ELECT. TILT	TOWER MOUNTED EQUIPMENT	FEEDLINE TYPE
ALPHA	A1	-	_	_	-	-	_	-	_	_
ALPHA	A2	I	85'-0"	0.	JMA WIRELESS	NHHSS-65C-R2B NHH-65C-R2B	-	-	(1) ERICSSON — RADIO 4449 (1) ERICSSON — RADIO 4408 (1) ERICSSON — RRUS 8843	HYBRID
ALPHA	А3	-	_	_	-	-	_	_	-	_
ALPHA	A4	_	85'-0"	0.	ERICSSON	AIR6449	_	-	(1) INTEGRATED RRU	-
										•
BETA	B1	_	_	_	-	-	_	-	_	_
BETA	B2	_	85'-0"	120°	JMA WIRELESS	NHHSS-65C-R2B NHH-65C-R2B	-	-	(1) ERICSSON — RADIO 4449 (1) ERICSSON — RADIO 4408 (1) ERICSSON — RRUS 8843 (1) OVP	HYBRID
BETA	В3	_			_	-	_	-	· /	-
BETA	B4	-	85'-0"	120°	ERICSSON	AIR6449	-	_	(1) INTEGRATED RRU	-
			•							
GAMMA	C1	_	_	_	-	_	_	_		-
GAMMA	C2	-	85'-0"	240°	JMA WIRELESS	NHHSS-65C-R2B NHH-65C-R2B	-	-	(1) ERICSSON — RADIO 4449 (1) ERICSSON — RADIO 4408 (1) ERICSSON — RRUS 8843	HYBRID (SHARED)
GAMMA	C3	_	_	-	-	-	_	_	_	-
GAMMA	C4	_	85'-0"	240°	ERICSSON	AIR6449	_	_	(1) INTEGRATED RRU	-

FIN	2				
NEW	HYBRID	6x12	2		
STATUS	SIZE	QUANTITY			
CABLE SCHEDULE					

ANTENNA AND CABLE SCHEDULE

SCALE: NOT TO SCALE

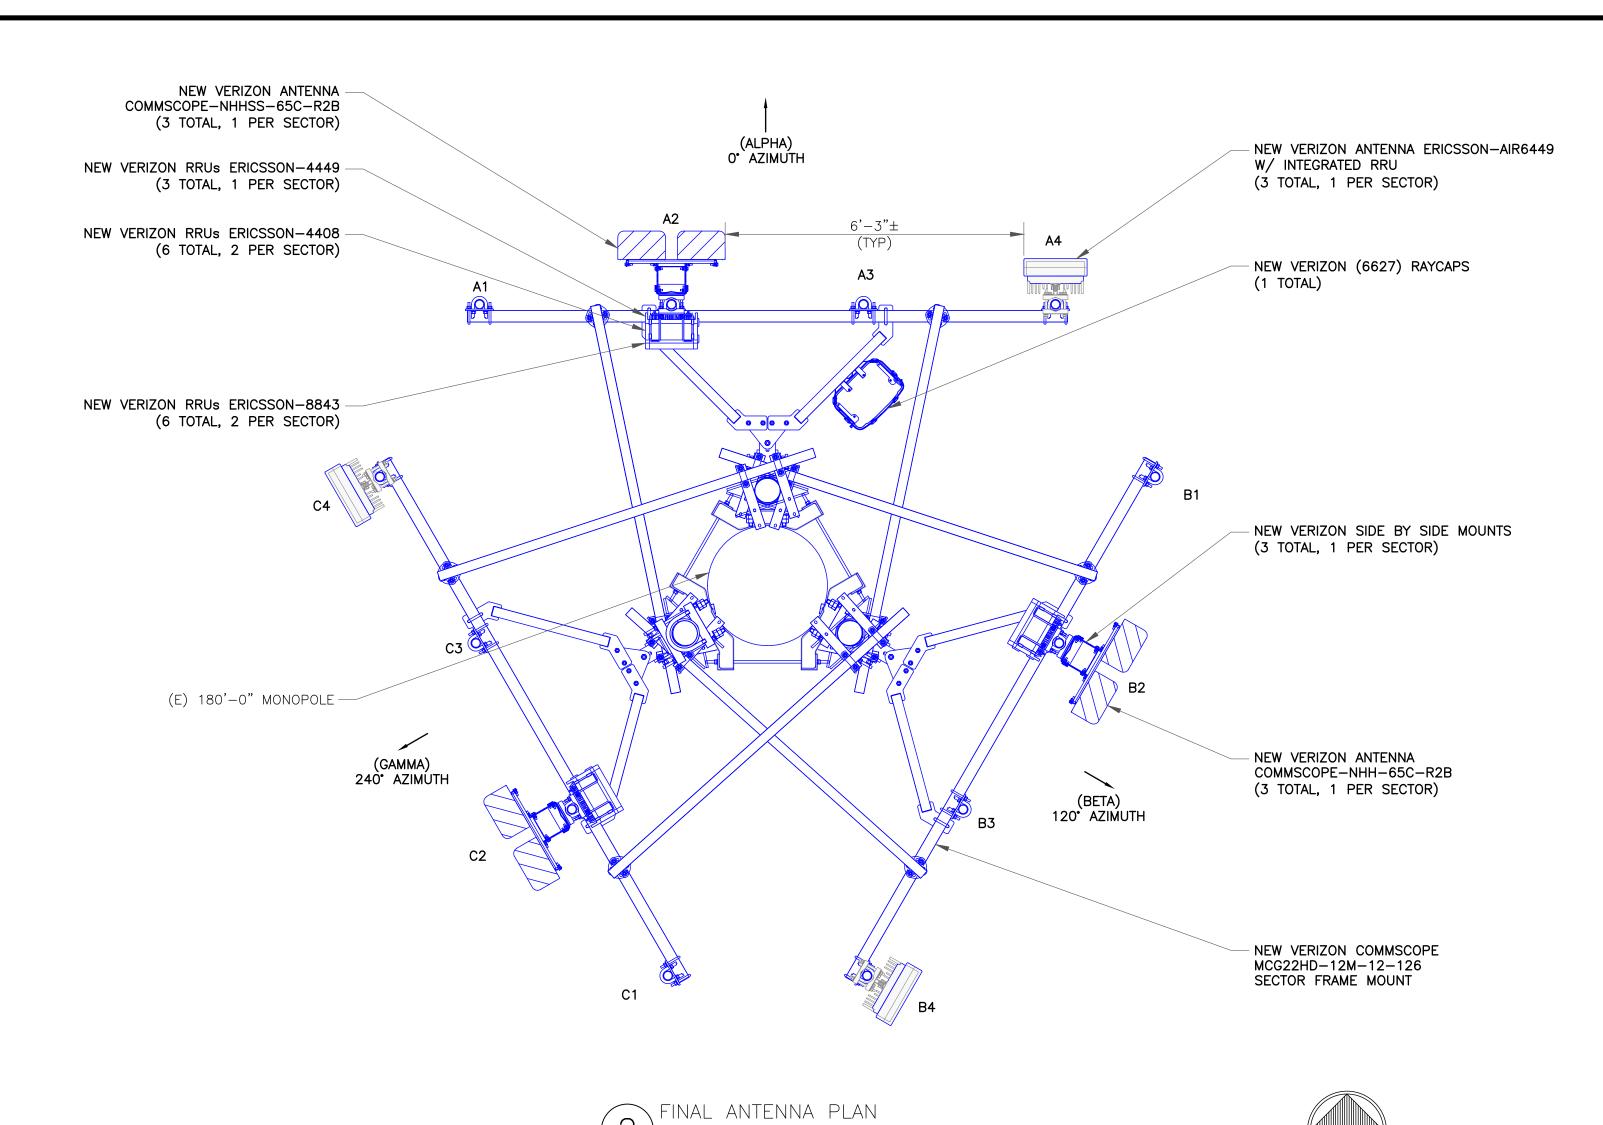

SCALE: NOT TO SCALE



JURISDICTIONAL APPROVAL:



IRVING, TEXAS 75038

VERIZON SITE NUMBER: **16968208**


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LEE'S SUMMIT, MO 64063
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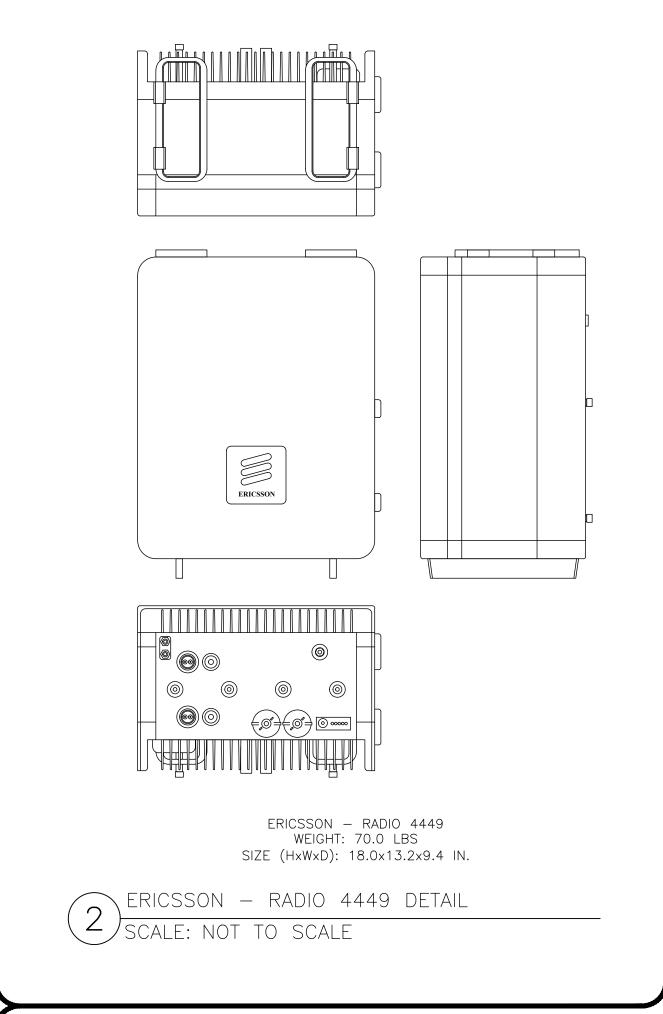
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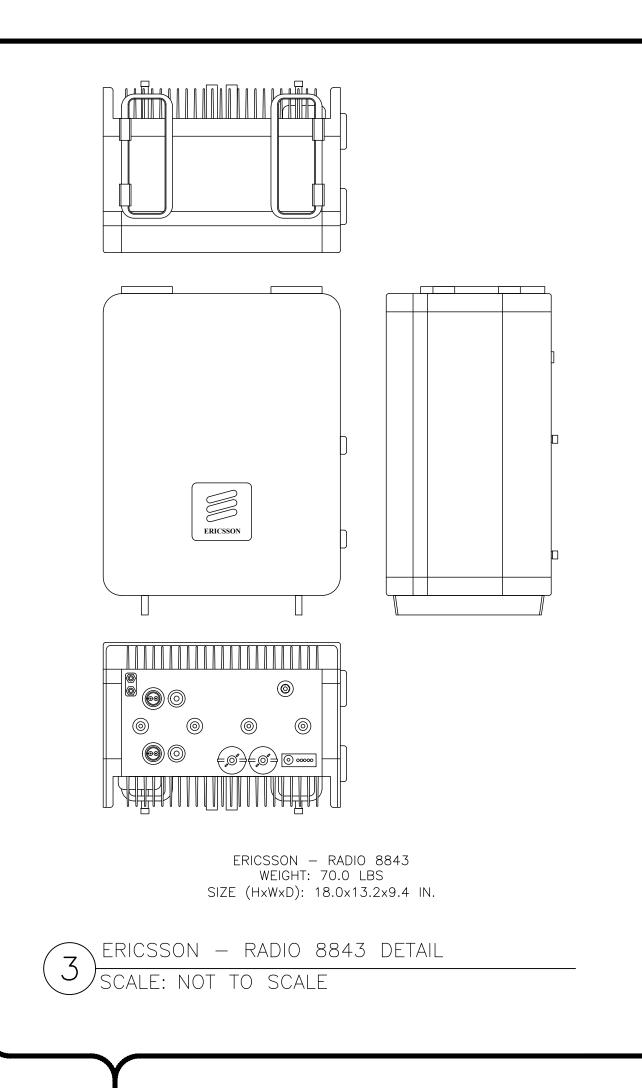
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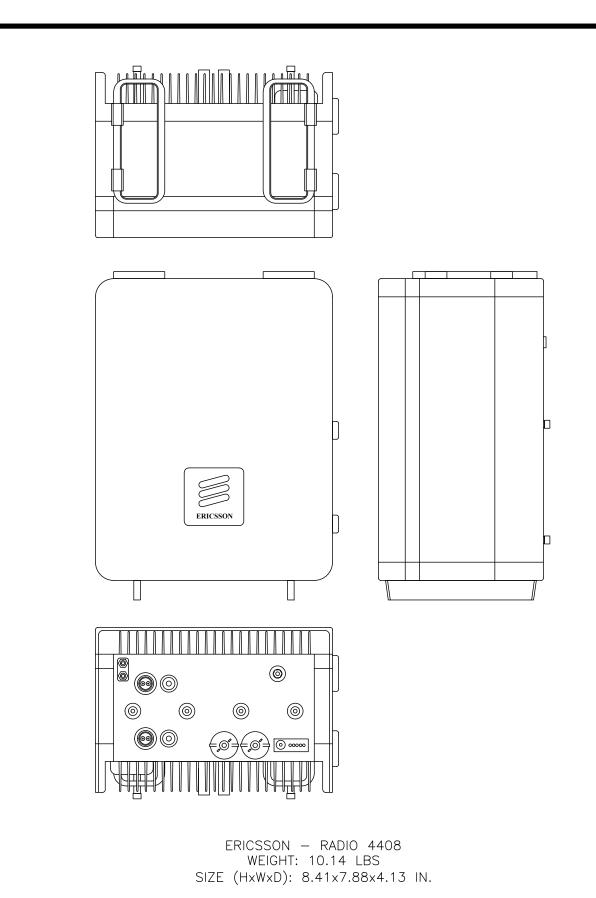


PANEL ANTENNA (NHH-65C-R2B)

DIMENSIONS, HxWxD: 96.00"x11.90"x7.10"





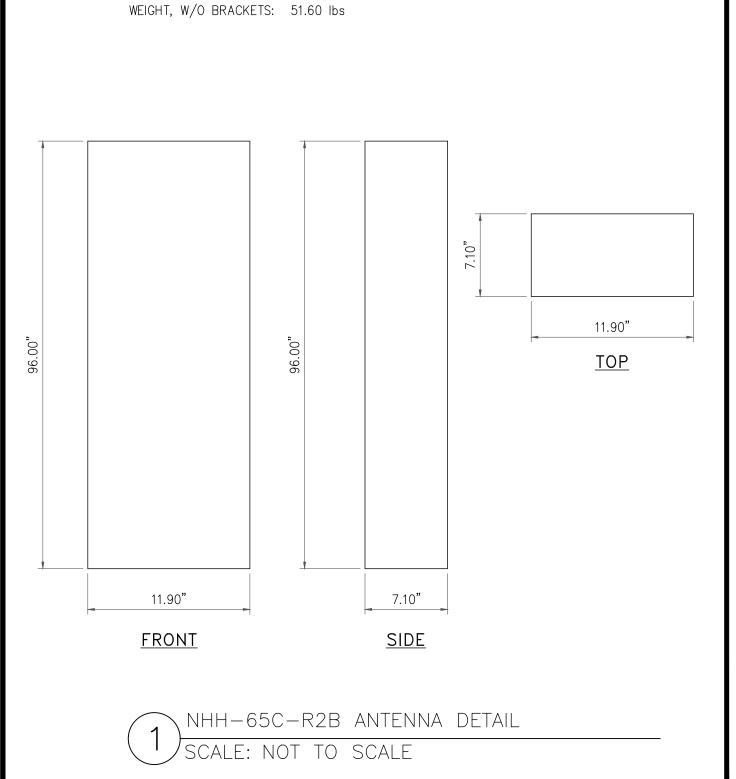

ERICSSON - RADIO 4408 DETAIL

SCALE: NOT TO SCALE



JURISDICTIONAL APPROVAL:



1825 W. WALNUT HILL LANE, SUITE 120 IRVING, TEXAS 75038

VERIZON SITE NUMBER: 16968208

BU #: **877803** KCYC LEES SUMMIT DT 207 SE DOUGLAS LEE'S SUMMIT, MO 64063 EXISTING 180'-0" MONOPOLE


		ISSUI	ED FOR:	
REV	DATE	DRWN	DESCRIPTION	DES./QA
1 2	06/21/2023 07/27/2023	RC RC	FINAL FINAL	EAN AMT
3	09/18/2023	TFL	FINAL	AMT
4	10/17/2023	RC	FINAL	AMT
5	01/09/2024	TFL	FINAL	AMT
6	01/23/2024	RC	FINAL	AMT
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9	04/19/2024	RC	FINAL	AMT
10	07/25/2024	RC	FINAL	AMT
11	08/14/2024	RC	FINAL	AMT
12	09/19/2024	RC	FINAL	AMT




IT IS A VIOLATION OF LAW FOR ANY PERSON, UNLESS THEY ARE ACTING UNDER THE DIRECTION OF A LICENSED PROFESSIONAL ENGINEER, TO ALTER THIS DOCUMENT.

SHEET NUMBER:


REVISION:

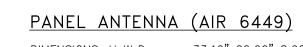

DIMENSIONS, HxWxD: 33.10"x20.60"x8.60" WEIGHT, W/O BRACKETS: 104.0 lbs

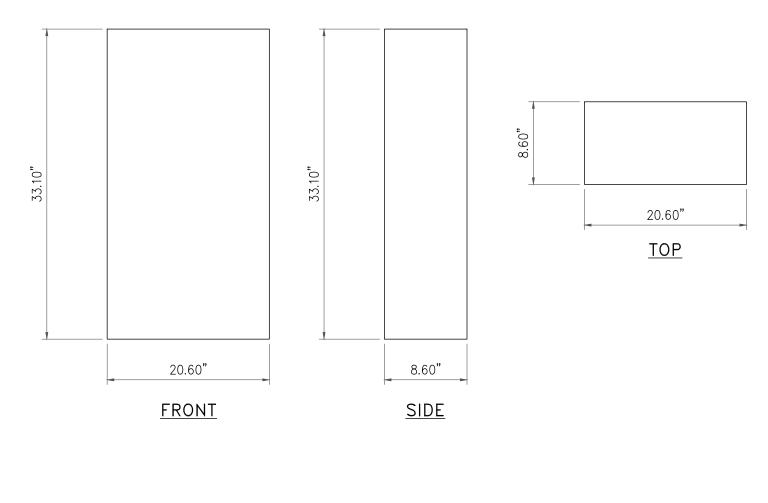


AIR 6449 ANTENNA DETAIL SCALE: NOT TO SCALE

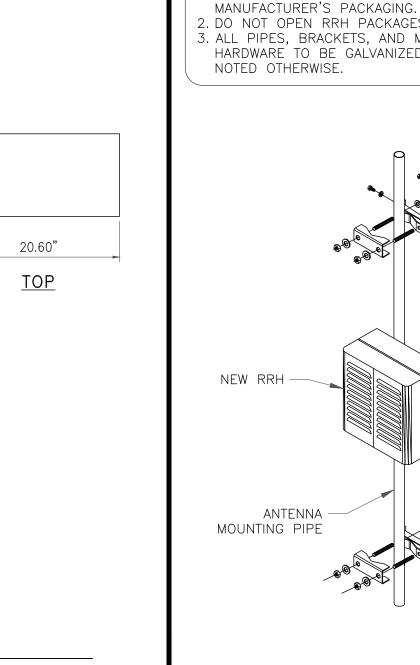


INSTALLER NOTES:

. COMPLY WITH MANUFACTURERS

INSTRUCTIONS TO ENSURE THAT ALL RRHs RECEIVE ELECTRICAL POWER WITHIN 24 HOURS OF BEING REMOVED FROM THE

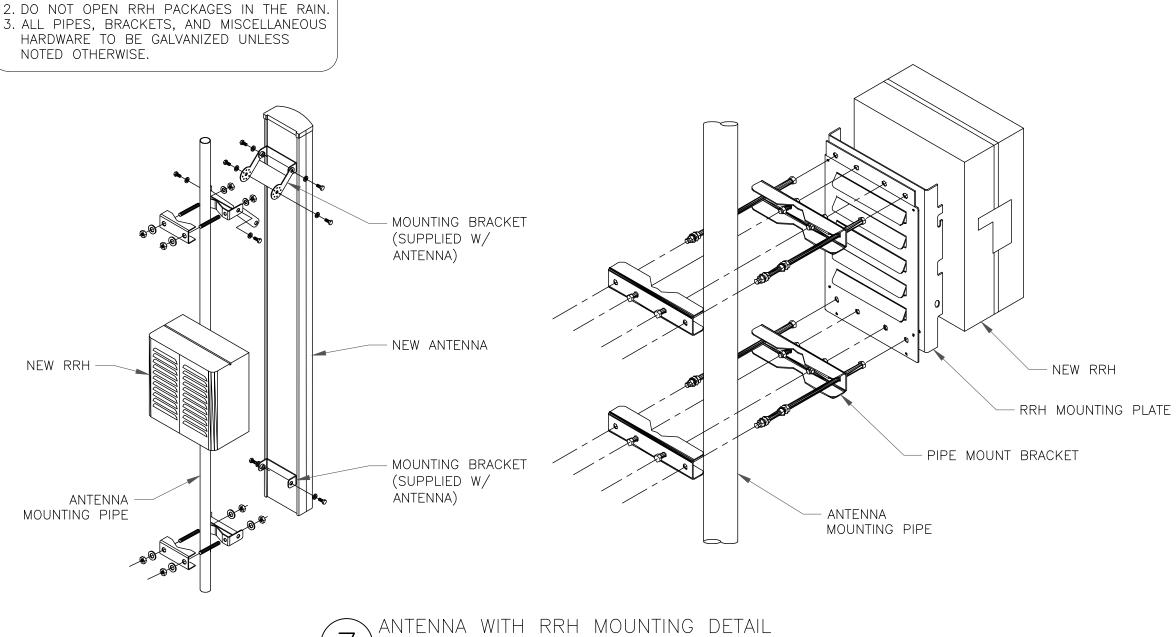

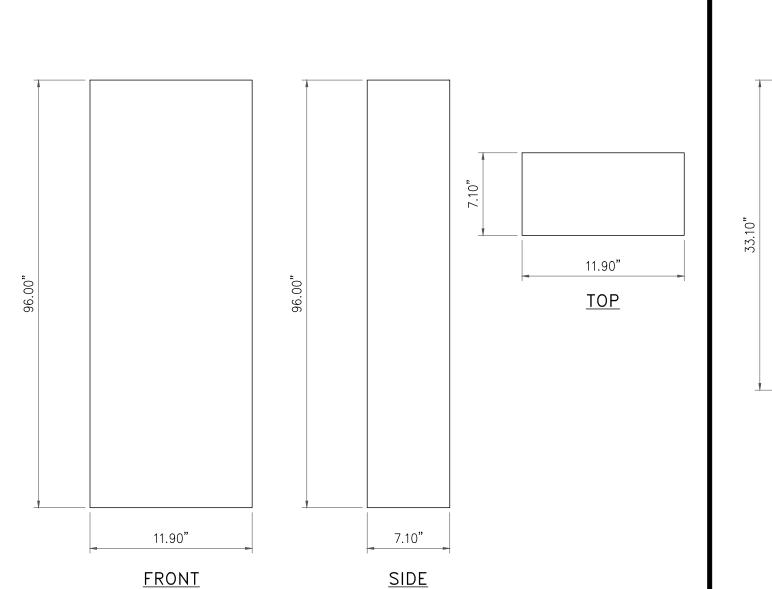


NHHSS-65C-R2B ANTENNA DETAIL

SCALE: NOT TO SCALE

PANEL ANTENNA (NHHSS-65C-R2B)

DIMENSIONS, HxWxD: 96.00"x11.90"x7.10"

WEIGHT, W/O BRACKETS: 69.70 lbs

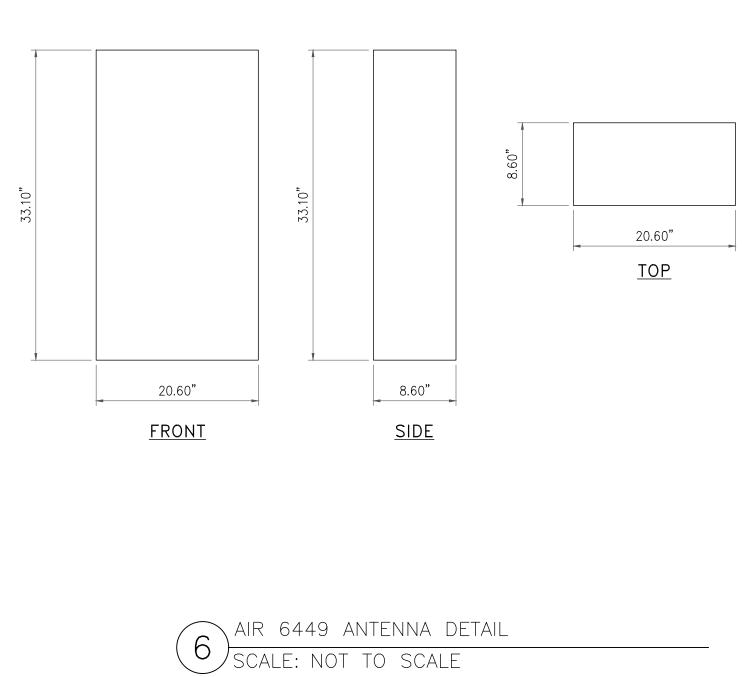

SCALE: NOT TO SCALE

MCG22HD-12M-12-126



G22HD High Capacity 3-Sector Monopole Frame with 2 7/8in OD x 12.5ft face. Includes twelve 2 3/8in OD x 126in antenna pipes

Product Classification

Product Type High capacity monopole sector frame

Product Series G

General Specifications

Mounting Monopole, 381–1270 mm (15–50 in) OD

Pipe, quantity 12
Sectors, quantity 3

Dimensions

Height 3,200.4 mm | 126 in 3.81 m | 12.5 ft **Face Width** 3,810 mm | 150 in 3,200.4 mm | 126 in Face Support Pipe Diameter 73.025 mm | 2.875 in 1270 mm | 50 in Mounting Diameter, maximum 381 mm | 15 in Mounting Diameter, minimum Pipe Outer Diameter 60.325 mm | 2.375 in Stand-off Distance 1,041.4 mm | 41 in

Material Specifications

Material Type Hot dip galvanized steel

Mechanical Specifications

Wind Rating For Specifications, please contact steelproducts@commscope.com or call 800-255-1479

Wind Rating Test Method TIA/EIA-222

MCG22HD-12M-12-126

Environmental Specifications

Man Rating 500 lb vertical man load at 15 mph (BWS)

Packaging and Weights

Included Pipe mounts | Plain end pipes (12) | Ring mounts (2) | Sector frames (3) | Stiff arm

Packaging quantity

* Footnotes

Wind Rating BWS—Base Wind Speed; FBC—Florida Building Code

Man Rating BWS—Base Wind Speed

verizon values po a p

BEDMINSTER, NJ 07921

JURISDICTIONAL APPROVAL:



1200 MACARTHUR BLVD, SUITE 200 MAHWAH, NJ 07430



1825 W. WALNUT HILL LANE, SUITE 120 IRVING, TEXAS 75038

VERIZON SITE NUMBER: 16968208

BU #: **877803 KCYC LEES SUMMIT DT**207 SE DOUGLAS
LEE'S SUMMIT, MO 64063
EXISTING 180'-0" MONOPOLE

ISSUED FOR:				
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11	08/14/2024	RC	FINAL	AMT
12	09/19/2024	RC	FINAL	AMT



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SHEET NUMBER:

ER: REVISION: 12

Page 1 of 2

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Page 2 of 2

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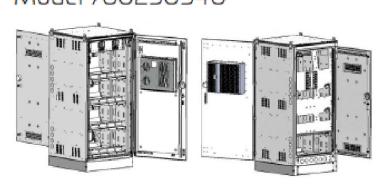
ANTENNA MOUNT DETAIL

SCALE: NOT TO SCALE

Verizon Wireless Ordering Guide

CMC74-36B VRLA Battery Cabinet for 6-Strings, HVAC Door with Heater

Model 760250540



Front View Rear View

CMC Cabinet Ordering Information

PeopleSoft Part #	Description
760250540	CMC74-36B, VRLA Battery Cabinet, 6-String, 1 kW HVAC with 500 W Heater, DC

Field Replacement Units and Aftermarket Kits

PeopleSoft Part #	Description		
Field Replacement Units (FRUs)			
760250922	Handle, Front Door		
760250925	1 kW HVAC with 500 W Heater, DC		
760250928	Circuit Breaker, Battery String, 250 A		
760250958	Front Door Assembly, with 1 kW HVAC with 500 W Heater, DC		
760253587	Rear Door Assembly, CMC74-36B		
760250961	Solar Shield, Side		
760250927	Solar Shield, Top		
Aftermarket Kits (AMKs)			
760246443	Interconnect, 3PR, 4/0, 2", CMC74-36B		
760250933	6" High Plinth, Cabinet Mounting		
Additional AMKs can be found on pages 13-14.			

NOTE: The CommScope Part # and Verizon Wireless PeopleSoft #'s are the same.

COMMSCOPE SIDE BY SIDE MOUNTING KIT (OR APPROVED EQUAL): 639845-1 BSAMNT-SBS-2-2

DIMENSIONS HxW (mm): 5.20"(132) x 29.37"(746)

MOUNTING:

ALLOWS MOUNTING EITHER (2) 350mm OR (2)

457mm WIDE ANTENNAS WITH 2 MOUNT POINTS SIDE BY SIDE

POLE DIAMETER: 60 - 115mm

SCALE: NOT TO SCALE

CYLINDRICAL PIPE INSTALLATIONS 2.4"-4.5"(60-115mm)

PIPE DIAMETER FOR HEAVY DUTY APPLICATIONS

Cabinet Features

Dimensions

Overall 74" H x 43.7" D x 36" W (standard height, depth with air conditioner)

- With Optional 6" Plinth 80" H x 43.7" D x 36" W (depth with air conditioner)
- Footprint 37" D x 36" W

(depth without air conditioner)

Weight: 1060 lbs. (481 kg) – for 6-String Cabinet Weight: as Shipped: 1237 lbs. (561 kg) Note: Cabinet Weights are without Plinth (112.4 lbs. [51 kg])

- Battery Compartment
- 1 kW HVAC with 500 W Heater, DC*
- 4 Battery Shelves, 6-String Capacity of 24 HT200 Ah VRLA Batteries Master Circuit Breaker String Panel with 6 each 250-amp String Circuit Breaker Switches
- Battery Cabling and the 250A Circuit Breakers Included
- CommScope Battery Bus Bar Assembly Connection Point for Battery Cabling to the Power Cabinet
- Maximum Cable Size of 4.0 AWG from Battery to Power Cabinet
- Cabinet Light
- Hinged Rear Access Door with Upper and Lower Vents Knockouts on Left and Right Sides, Rear
- Top and Side Solar Shields
- Side Shield Fits Left and Right Sides, Pending Cabinet Site Orientation (one cabinet side shield only)
- Integrated Puck Lock System Intrusion Prevention, Front and Rear Doors - Cabinet can use both Electronic and Standard Keyed Puck Locks

Telcordia GR-487 Compliant

Safety Agency Listed


* Hardened Equipment to -40° C to +65° C

BATTERY CABINET DETAIL SCALE: NOT TO SCALE

Verizon Wireless Ordering Guide

CMC74-36E Equipment and Power Cabinet with 4 kW Air Conditioner

Model 760250058

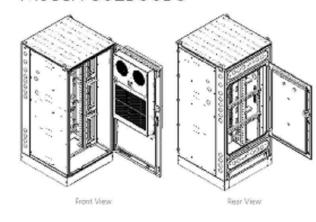

CMC Cabinet Ordering Information

PeopleSoft Part#	Description
760250058	CMC74-36E, Equipment Cabinet, 4 KW Air Conditioner, DC

Field Replacement Units and Aftermarket Kits

PeopleSoft Part#	Description	
Field Replacement	Units (FRUs)	
760250972	Front Door Assembly, 4kW Air Conditioner, CMC74-36E	
760250922	Handle, Front Door	
760250960	Rear Door Assembly	
760250935	4 kW Air Conditioner, DC	
760250926	Interchangeable Conduit Panel, Rear	
760250927	Solar Shield, Top	
Aftermarket Kits (AMKs)	
760246443	Interconnect, 3PR, 4/0, 2*, CMC74-B	
760250933	6 High Plinth, Cabinet Mounting	
Additional AMKs ca	n be found on pages 13-14.	

NOTE: The CommScope Part # and Verizon Wireless PeopleSoft #'s are the same.

RF CABINET DETAIL

SCALE: NOT TO SCALE

BEFORE MOUNTING LUGS TO ANY EXTERIOR EQUIPMENT, SURFACE PAINT IS TO BE STRIPPED AND DEOX IS TO BE APPLIED TO THE SURFACE

> #2 AWG SOLID TINNED BARE COPPER WIRE CONDUCTOR WITH COMPRESSION LUGS, (1/4" LUGS = BURNDY #YA3C-2TC14E2, 3/8" LUGS = BURNDY #YA3C-2TC38), ALL LUGS ARE TO BE MOUNTED WITH (2) 1/4" DIA. OR 3/8" DIA. BOLTS, NUTS, AND LOCK WASHERS, SÉCURED TO EXTERIOR-MOUNTED DEVICE -

1/2" DIA. PVC CONDUIT WITH (1) "C" CLAMP FOR GROUND WIRE, EXTEND PVC PIPE 12" BELOW GRADE —


CAD WELD CONNECTION ----

GROUNDING TRENCH -

(E) EXTERNAL ĠŔOUND RING

Cabinet Features

Dimensions

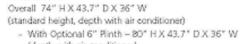



4 kW Air Conditioner, DC*

Equipment Compartment

- Adjustable Equipment Rack System, Up to 49 RU - Up to 40 RU of 23" EIA Horizontal Rack Space
- Up to 9 RU of 19" EIA Vertical Rack Space OVP Vertical Side Mounting Options
- Allows more Horizontal Rack Space for Equipment
- Cabinet Light
- 4-Position GFCI Outlet Hinged Rear Access Door
- Two Interchangeable Rear Port Panels - Cabinet Ships with One Conduit Knockout Panel and One Blank
- Knockouts on Left and Right Sides, Rear
- Solar Shield, Top. Integrated Puck Lock System Intrusion Prevention,
- Front and Rear Doors Cabinet can use both Electronic and Standard Keyed Puck Locks

Telcordia GR-487 Compliant Safety Agency Listed


GENERATOR


GENERATOR SLAB ---


2'-0" TO 3'-0"


* Hardened Equipment to -40° C to +65° C



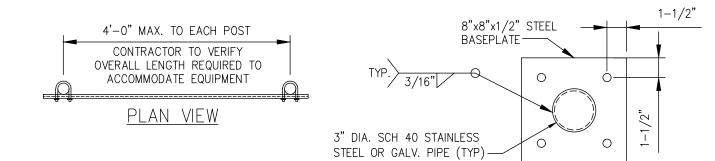

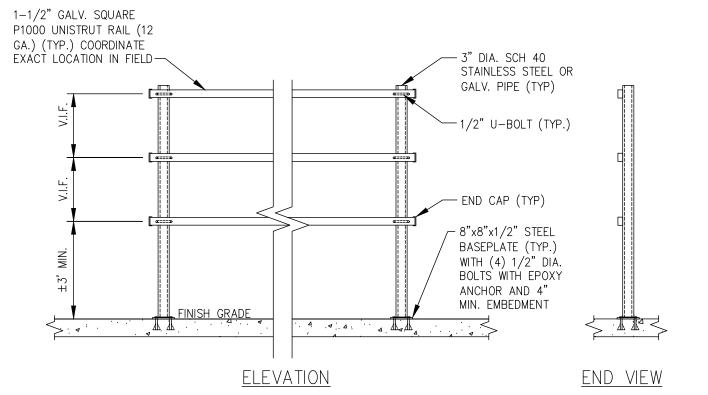

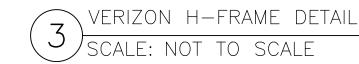

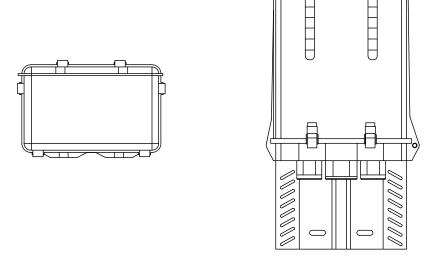

RAYCAP - RCMDC-3315-PF-48 WEIGHT (WITHOUT MOUNTING HARDWARE): 32.0 LBS SIZE (HxWxD): 25.66x15.73x10.26 IN.

RATED WIND VELOCITY: 150 MPH (SUSTAINED) OPERATING TEMPERATURE: -40° C TO +80° C NOMINAL OPERATING DC VOLTAGE: 48 VDC

RAYCAP - RCMDC - 3315 - PF - 48



JURISDICTIONAL APPROVAL:





1825 W. WALNUT HILL LANE, SUITE 120 IRVING, TEXAS 75038

VERIZON SITE NUMBER: 16968208

BU #: **877803** KCYC LEES SUMMIT DT 207 SE DOUGLAS LEE'S SUMMIT, MO 64063 EXISTING 180'-0" MONOPOLE

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8	04/05/2024	RC	FINAL	AMT
9	04/19/2024	RC	FINAL	AMT
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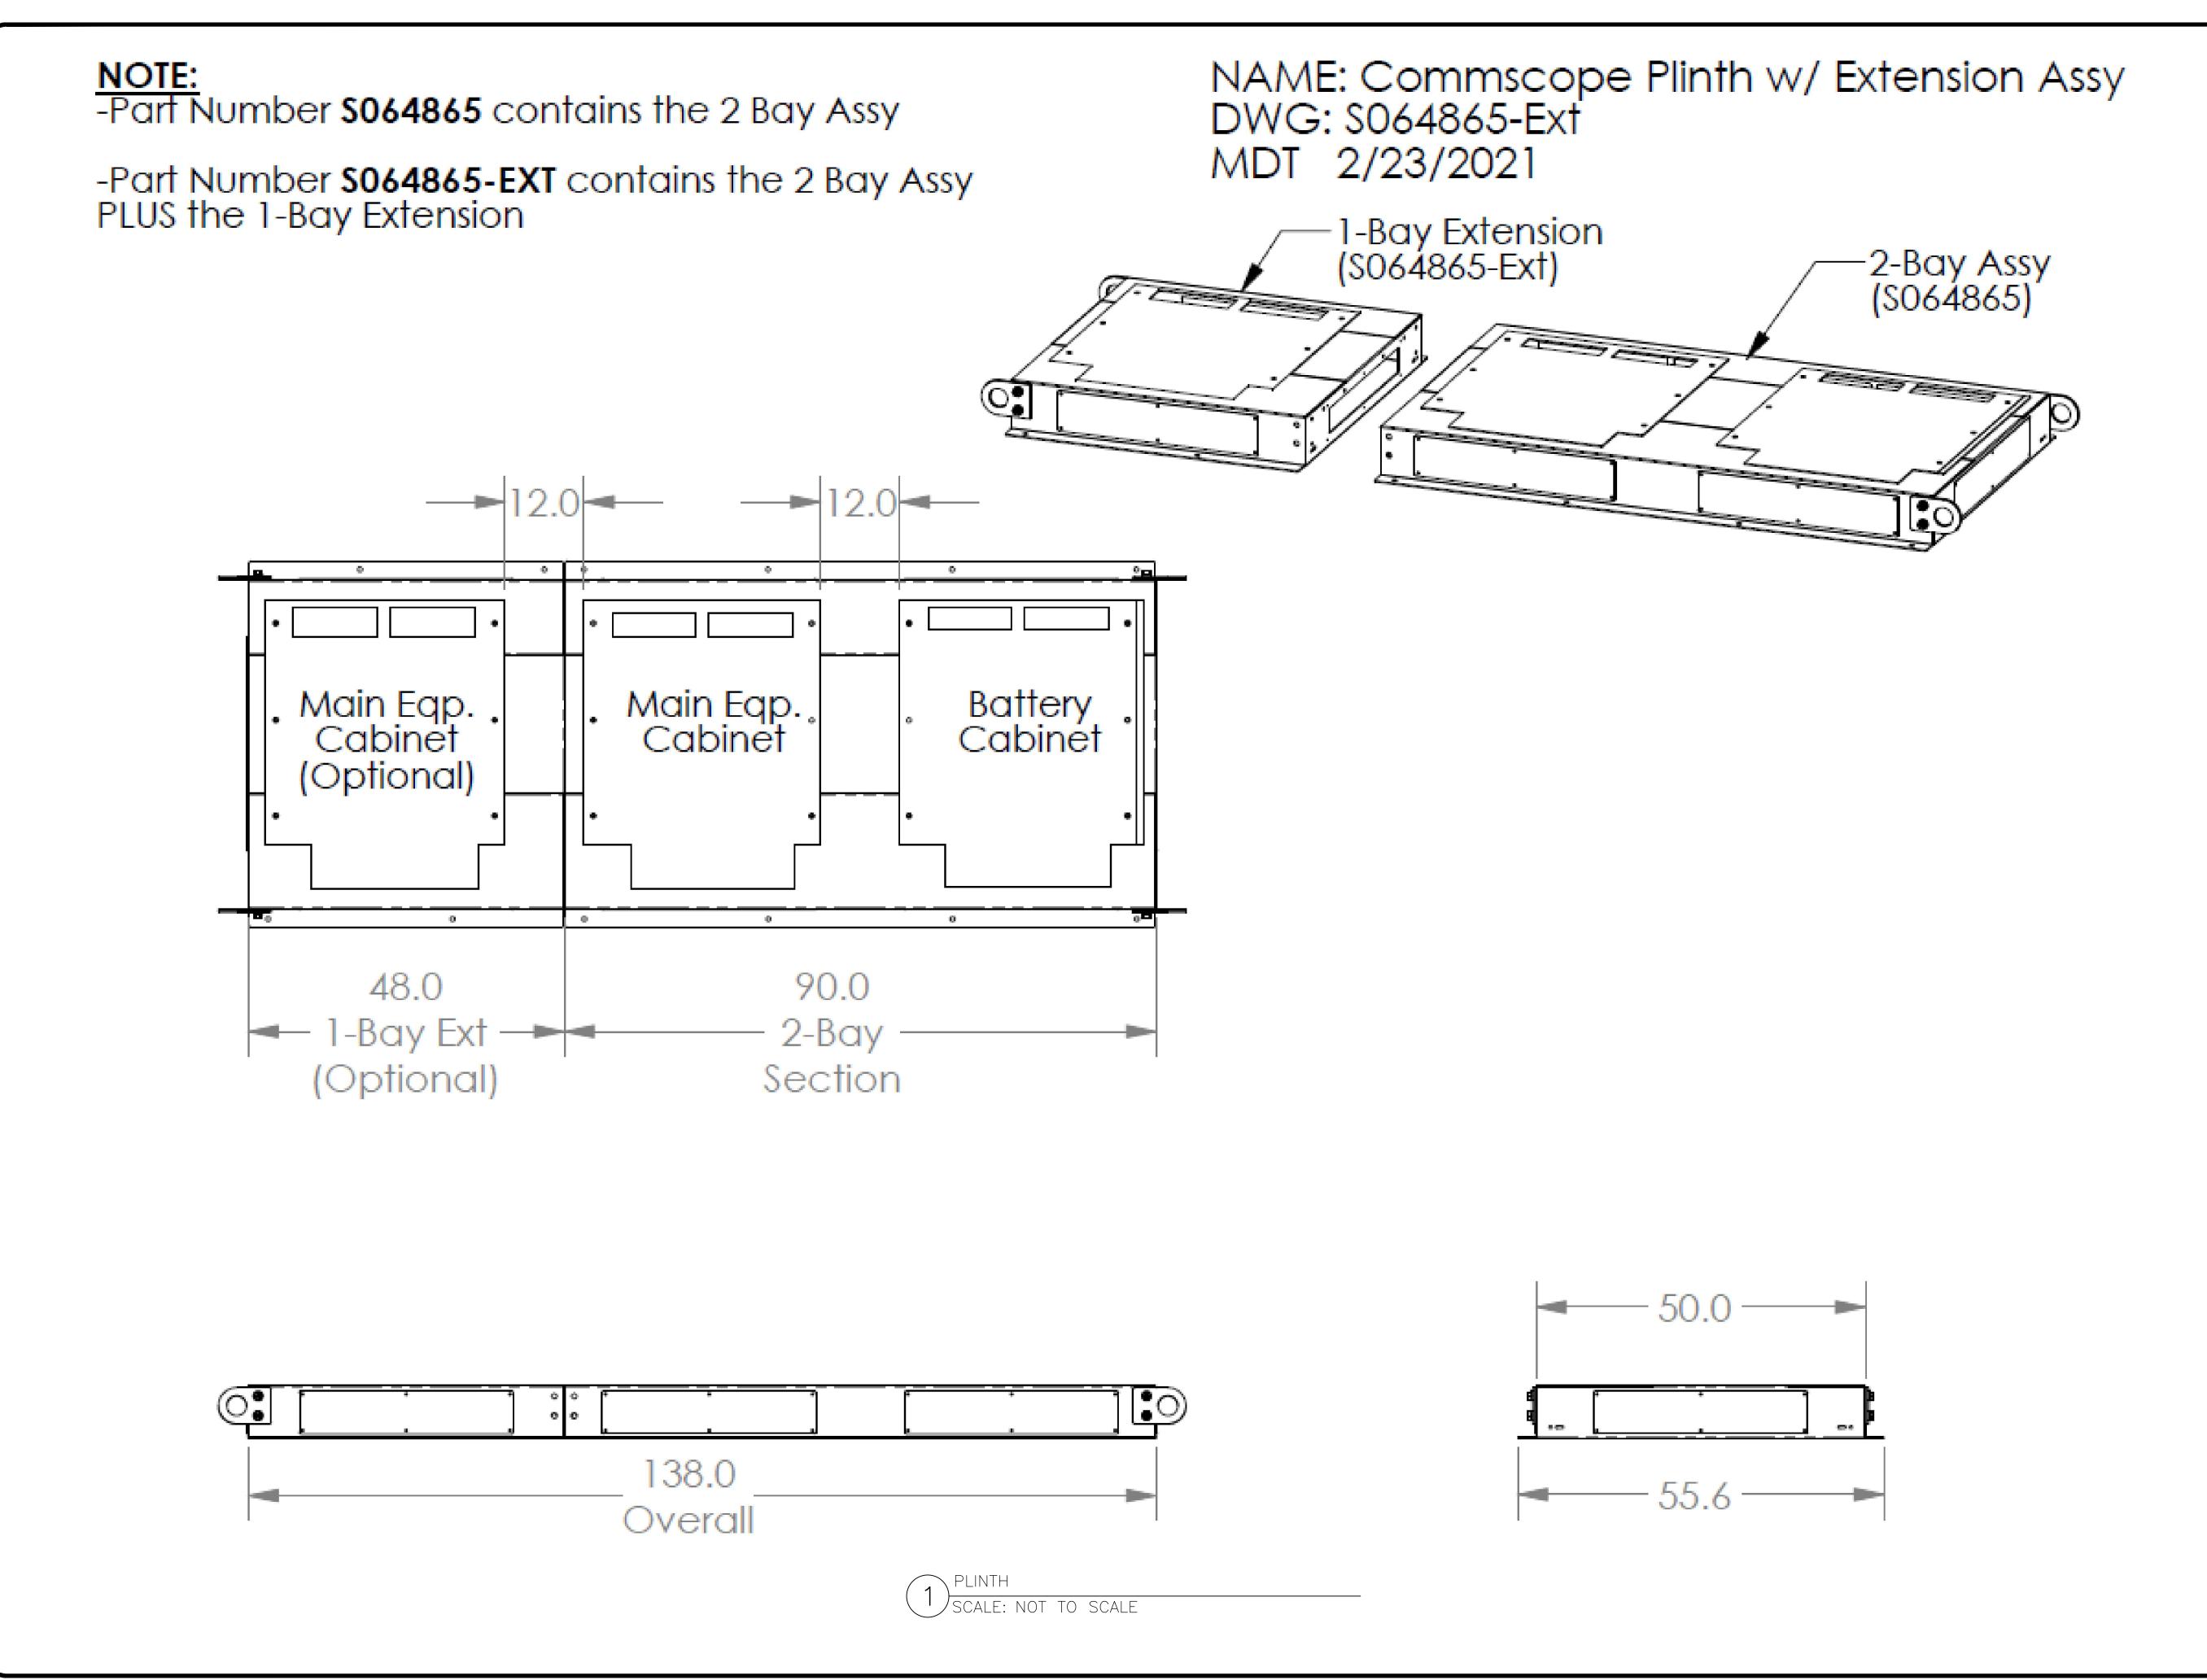
GENERATOR GROUNDING DETAIL (TYPICAL) SCALE: NOT TO SCALE CALE: NOT TO SCALE

CONNECTION

- NEW GROUND

ROD COPPER CLAD 5/8" DIA.

x 8' LONG





BEDMINSTER, NJ 07921





25 W. WALNUT HILL LANE, SUITE 120 IRVING, TEXAS 75038

VERIZON SITE NUMBER: 16968208

BU #: **877803 KCYC LEES SUMMIT DT**207 SE DOUGLAS
LEE'S SUMMIT, MO 64063
EXISTING 180'-0" MONOPOLE


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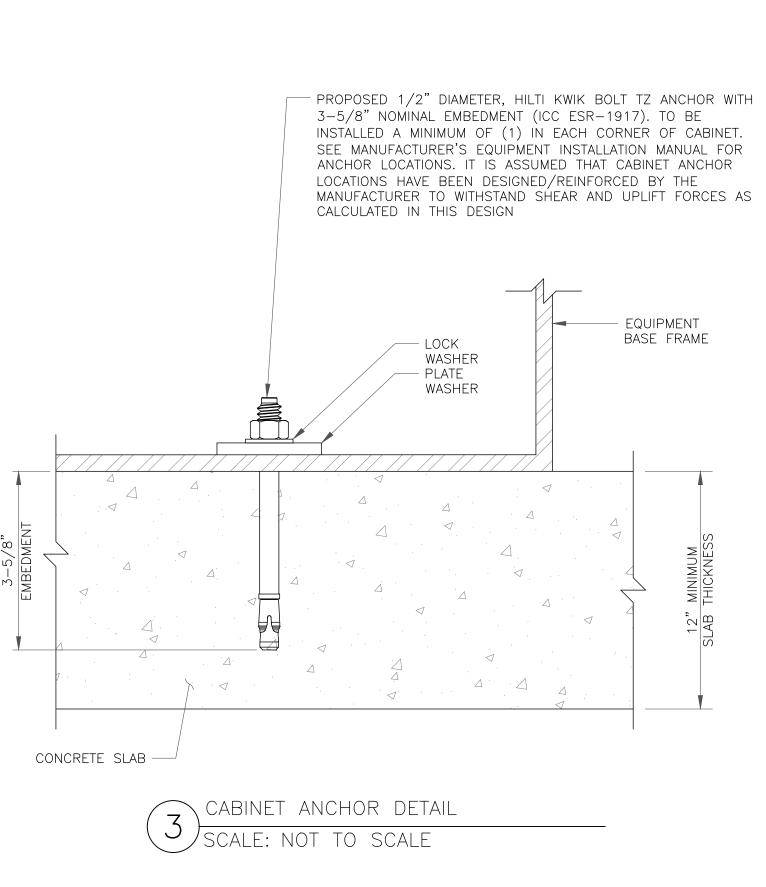
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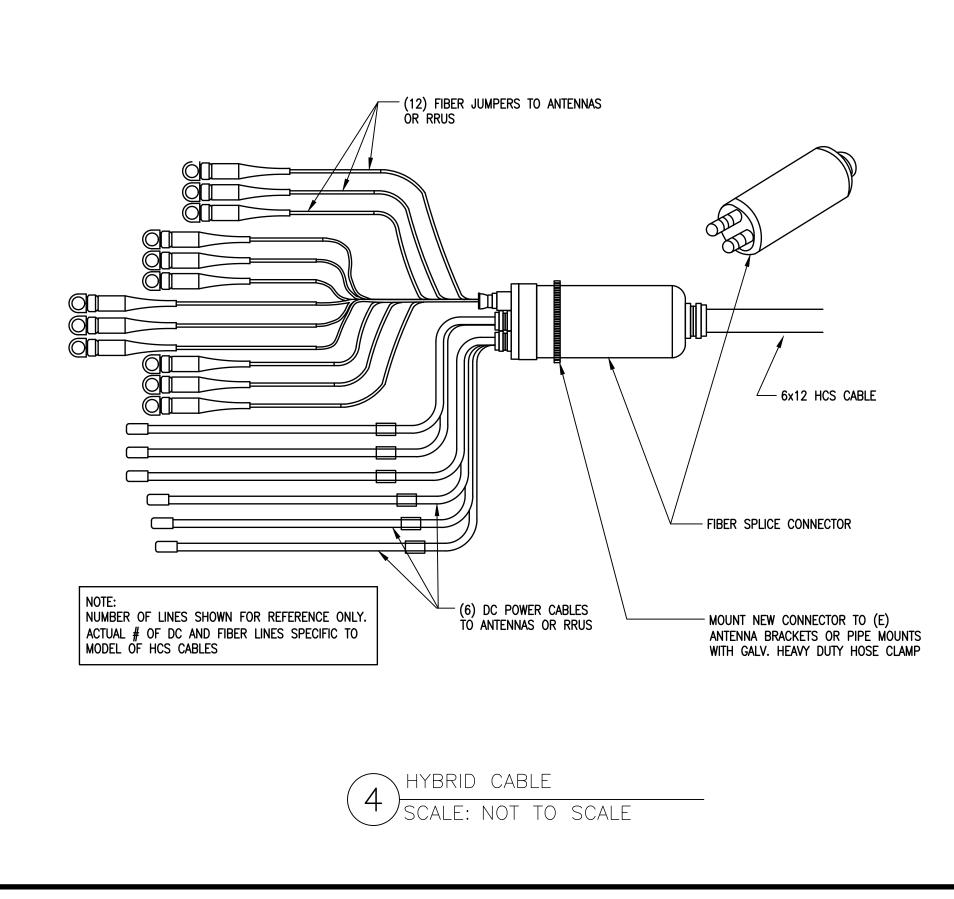
SHEET NUMBER:

12



NOT USED
SCALE: NOT TO SCALE



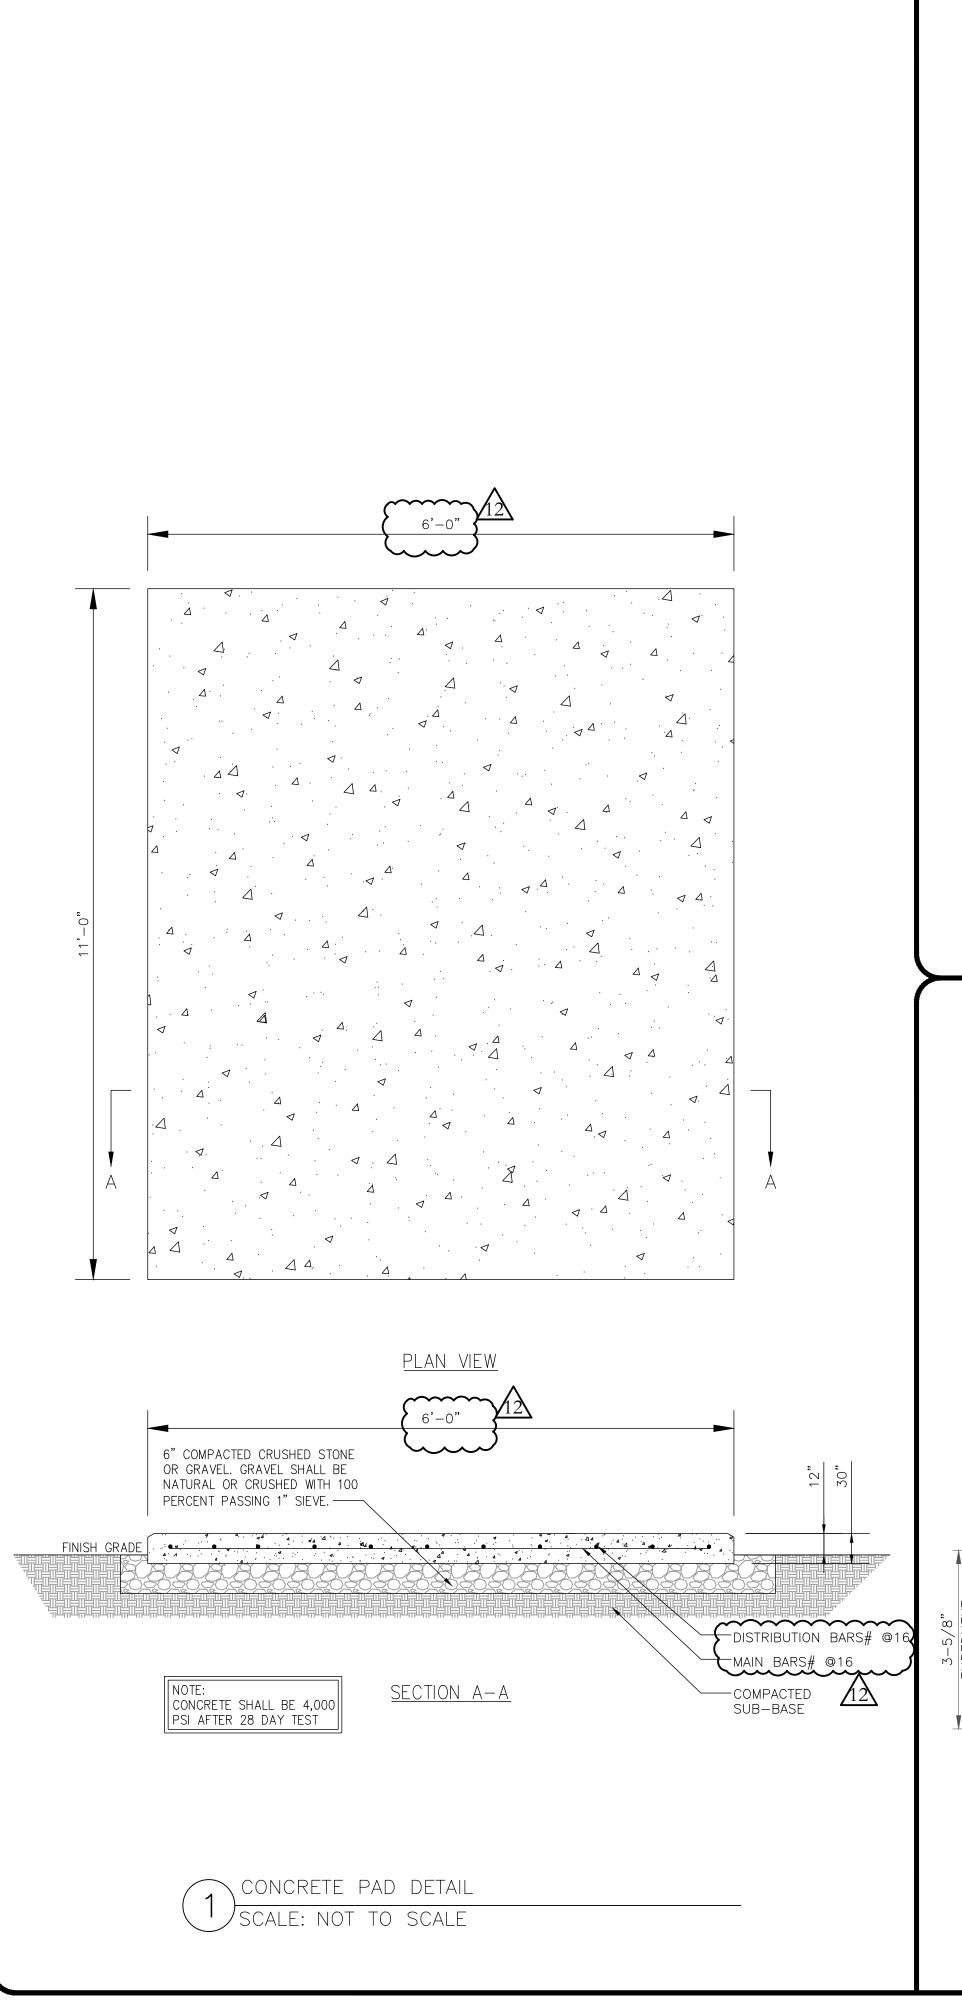

JURISDICTIONAL APPROVAL:



CROWN **CASTLE**

BEDMINSTER, NJ 07921

MAHWAH, NJ 07430




1825 W. WALNUT HILL LANE, SUITE 120 IRVING, TEXAS 75038

VERIZON SITE NUMBER: **16968208**


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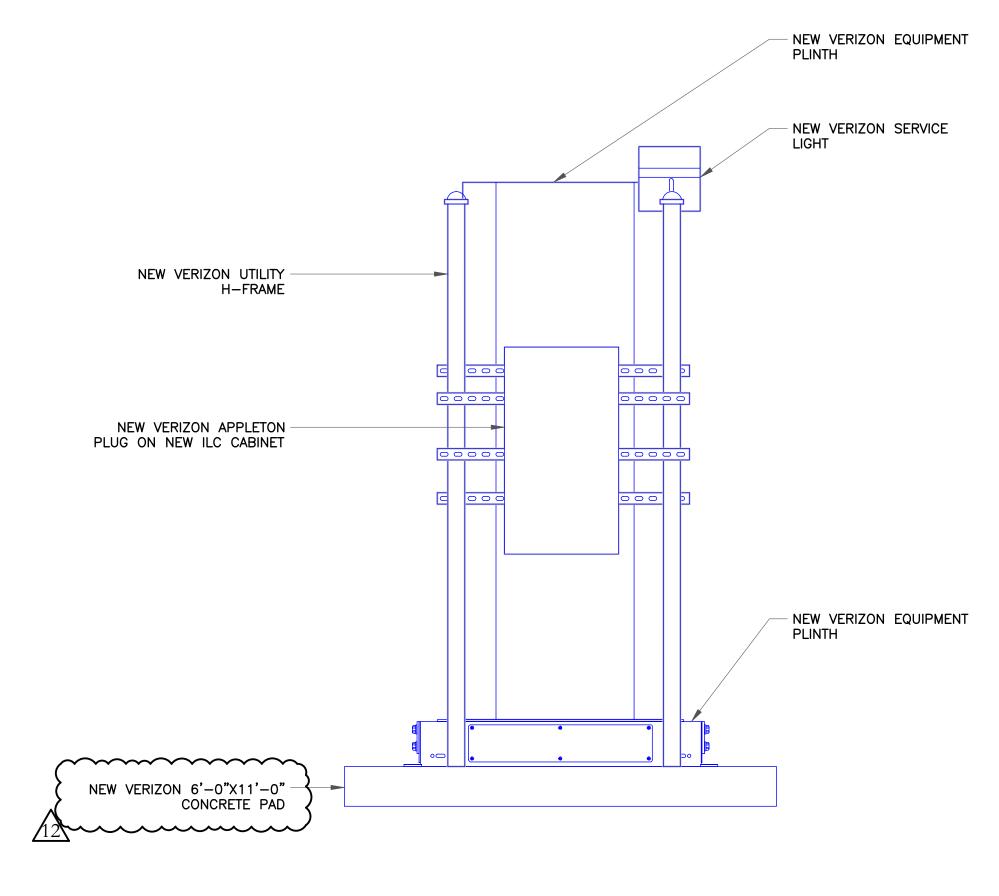
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	ISSUED FOR:				
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SHEET NUMBER:



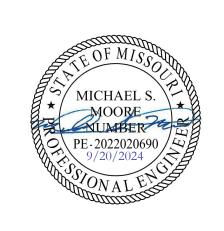



CROWN CASTLE
1200 MACARTHUR BLVD, SUITE 200

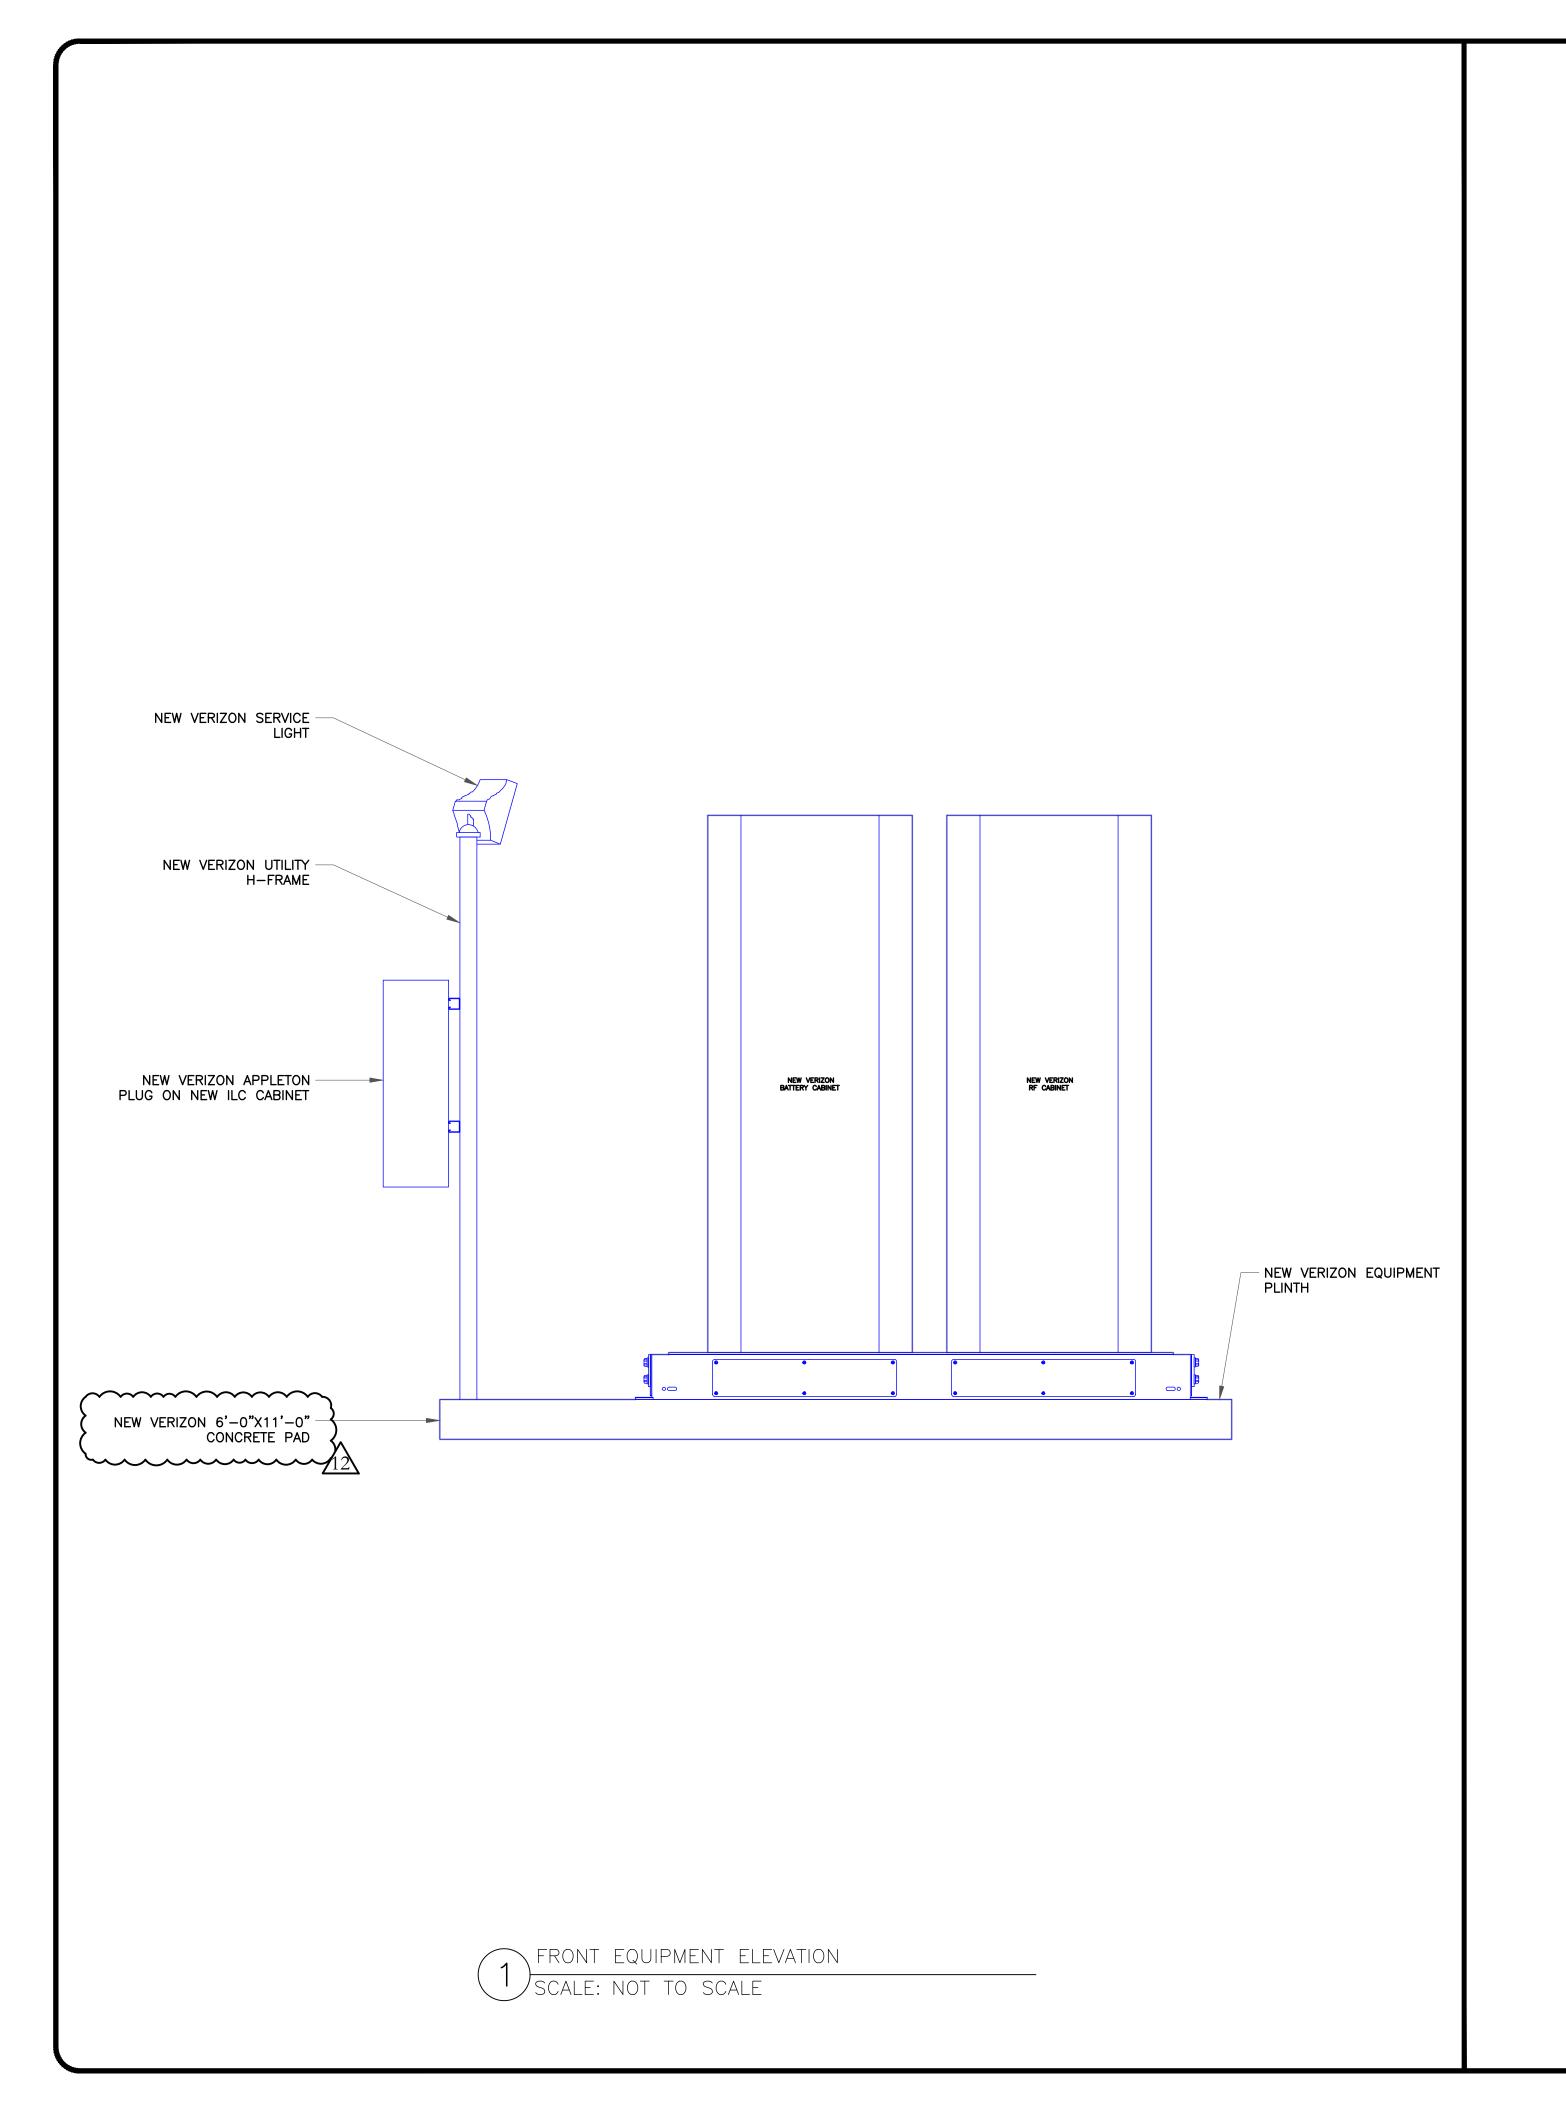BEDMINSTER, NJ 07921

Trylon

MAHWAH, NJ 07430

1825 W. WALNUT HILL LANE, SUITE 120 IRVING, TEXAS 75038

VERIZON SITE NUMBER: 16968208

BU #: **877803 KCYC LEES SUMMIT DT**207 SE DOUGLAS
LEE'S SUMMIT, MO 64063
EXISTING 180'-0" MONOPOLE

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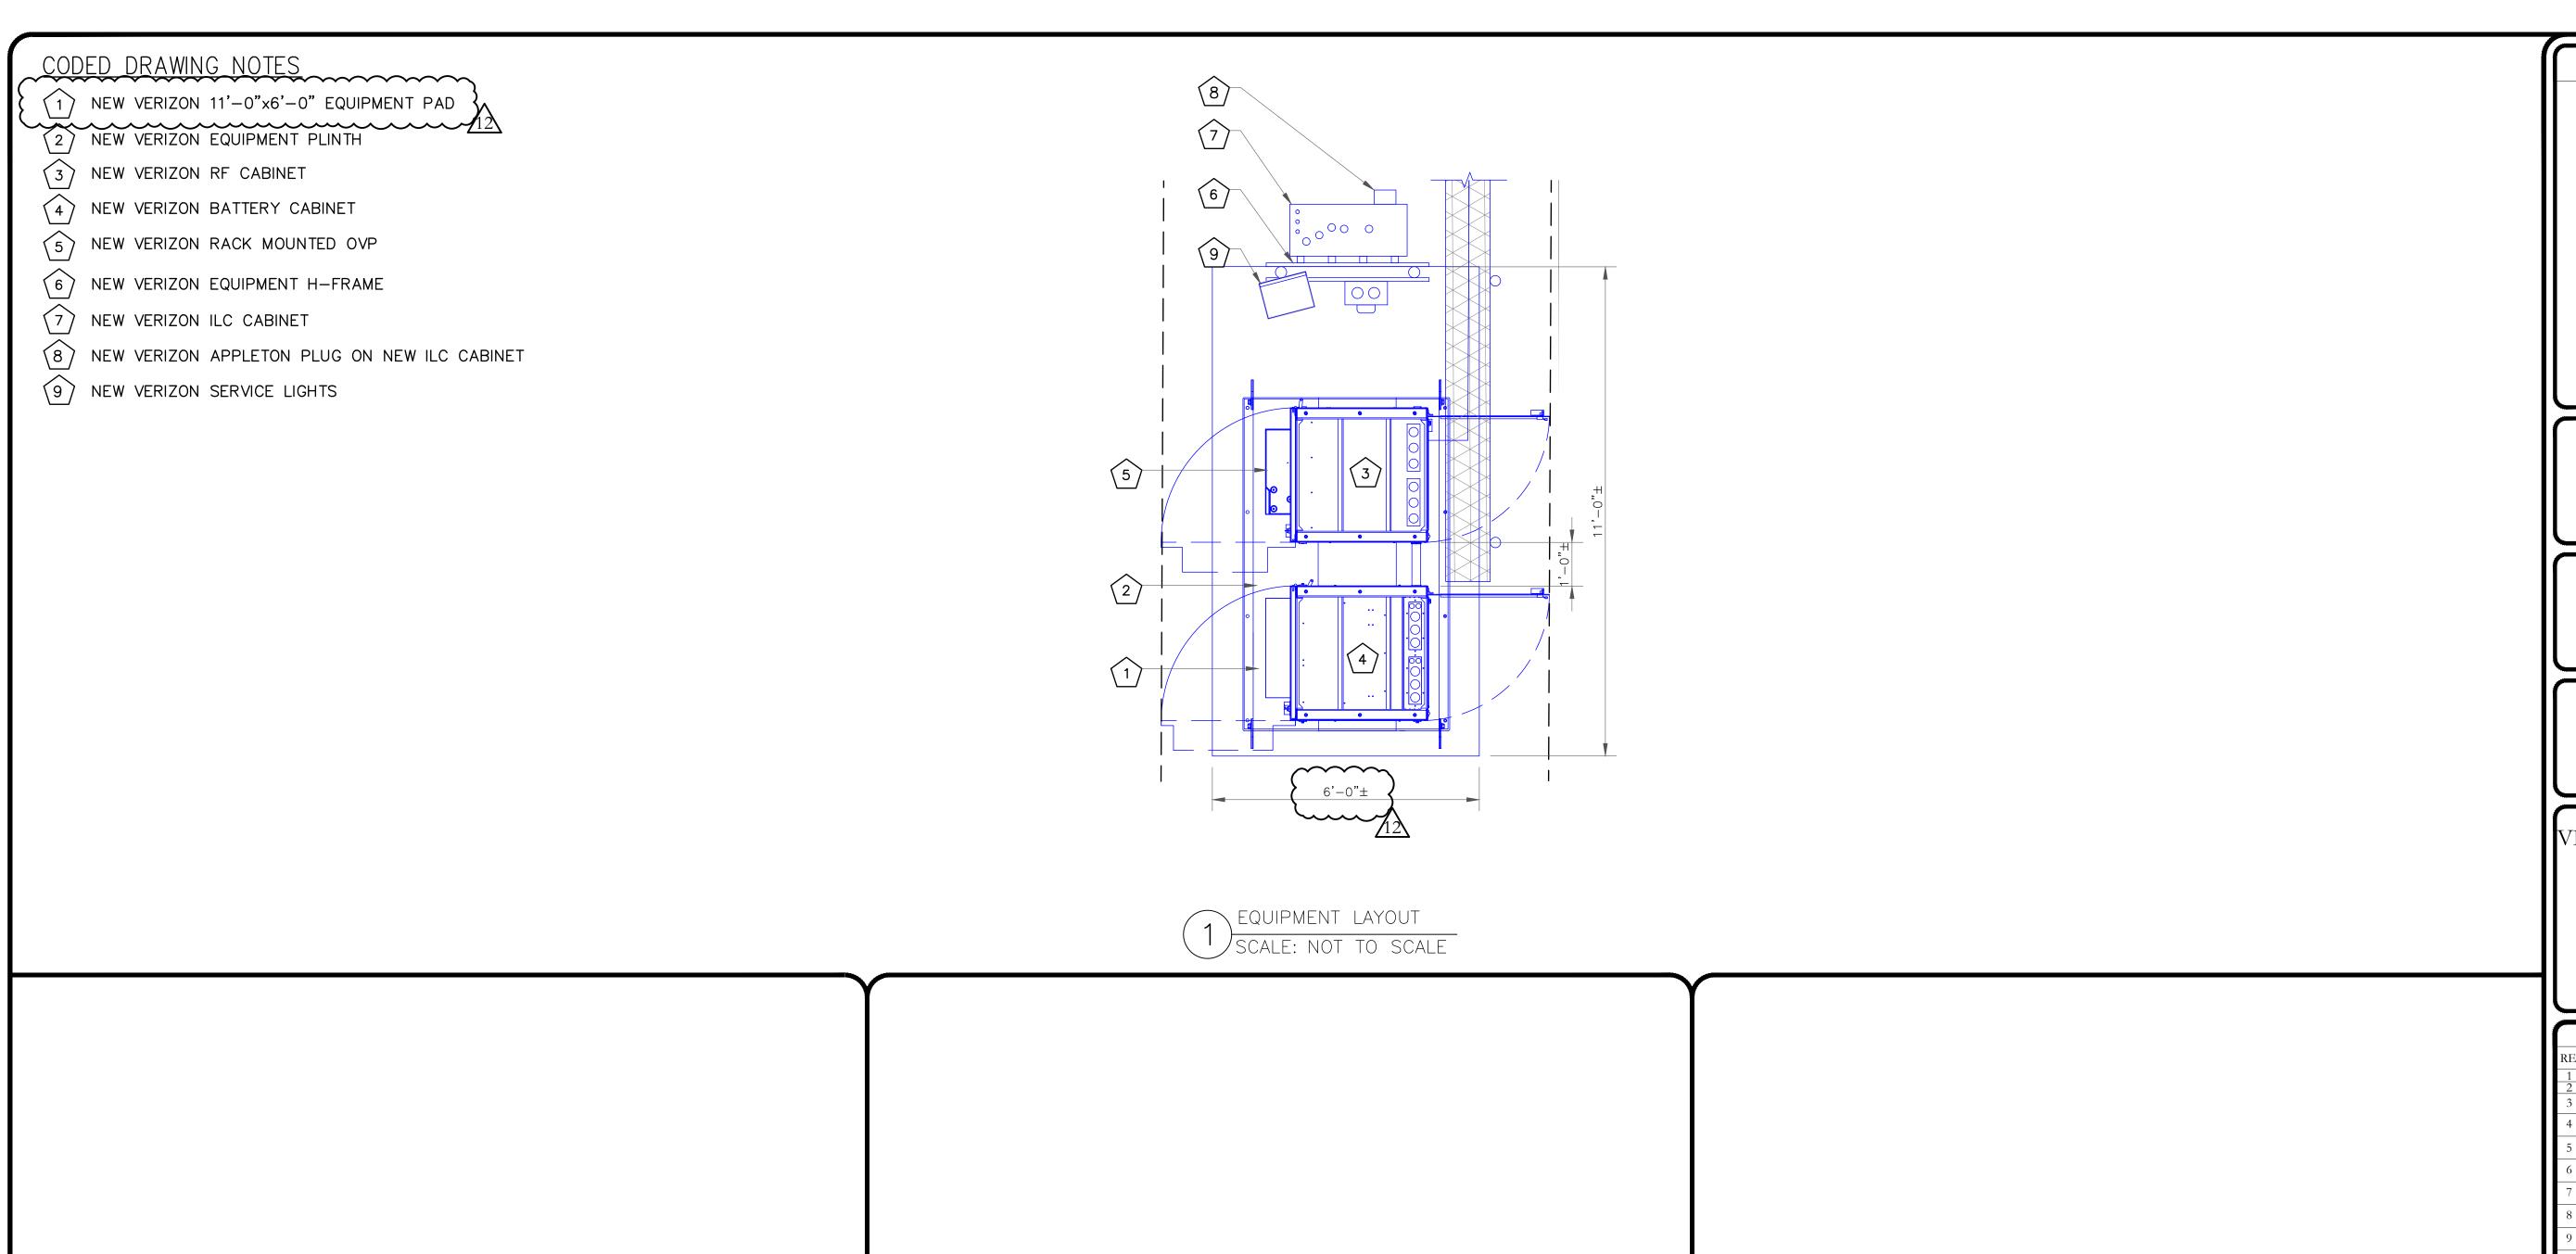


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SHEET NUMBER:

REVISION: 12

SIDE EQUIPMENT ELEVATION
SCALE: NOT TO SCALE









1200 MACARTHUR BLVD, SUITE 200 MAHWAH, NJ 07430



1825 W. WALNUT HILL LANE, SUITE 120 IRVING, TEXAS 75038

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REVISION:

NOT USED

SCALE: NOT TO SCALE

NOT USED

SCALE: NOT TO SCALE


SCALE: NOT TO SCALE

GENERAL ELECTRICAL NOTES:

- 1. ALL ELECTRICAL WORK SHALL BE IN ACCORDANCE WITH THE LATEST VERSION OF THE NATIONAL ELECTRICAL CODE AND ALL LOCAL AND STATE CODES, LAWS, AND ORDINANCES.
- 2. ALL UNDERGROUND CONDUIT SHALL BE PVC SCHEDULE 40 UNLESS OTHERWISE INDICATED. SUPPLY UTILITY MARKING TAPE BURIED 12" BELOW GRADE ALONG ENTIRE LENGTH OF UNDERGROUND CONDUITS.
- 3. ALL CONDUCTORS SHALL BE COPPER WITH THHN/THWN INSULATION. CONTROL CONDUCTORS SHALL BE STRANDED, POWER & LIGHTING CONDUCTORS SHALL BE SOLID FOR #10 & #12 CONDUCTORS AND STRANDED FOR ALL OTHER SIZES.
- 4. ELECTRICAL DRAWINGS ARE IN PART DIAGRAMMATIC. COORDINATE ELECTRICAL WORK WITH SITE CONDITIONS.
- 5. LOCATE ALL UNDERGROUND UTILITIES BEFORE TRENCHING. IF CONFLICTS ARISE, CONTACT UTILITY COMPANY AND ENGINEER IMMEDIATELY.
- 6. ALL EXPOSED CONDUITS SHALL HAVE WEATHERPROOF CAPS, NOT DUCT TAPE.
- 7. PROVIDE 200 LB TEST PULL WIRES IN EACH TELEPHONE AND POWER CONDUIT.
- 8. PULL BOXES SHALL BE INSTALLED AS NEEDED PER NEC UTILITY REQUIREMENTS.

CODED DRAWING NOTES:

- 1) EXISTING UTILITY POLE
- 2) NEW VERIZON FIBER HANDHOLE COVER SHALL BE STAMPED VERIZON
- 3 NEW VERIZON 200A METER SOCKET W/ DISCONNECT
- (4) NEW VERIZON CABINETS ON A NEW 11'-0"x4'-0" EQUIPMENT PAD
- NEW VERIZON ILC CABINET ON NEW EQUIPMENT H-FRAME
- 6 EOR POWER (1) 2" SCH. 40 PVC CONDUIT FOR POWER FROM EXISTING UTILITY POLE TO NEW VERIZON 200A METER SOCKET W/ DISCONNECT
- (1) 2" SCH. 40 PVC CONDUIT FROM NEW VERIZON 200A METER SOCKET W/DISCONNECT TO NEW ILC CABINET
- EOR TELCO (1) 4" SCH 40 PVC CONDUIT WITH (3) 1" INNERDUCTS, MULE TAPE AND TRACE WIRE FOR FIBER BETWEEN THE (2) NEW FIBER HANDHOLES (PENDING COORDINATION WITH LOCAL UTILITY COMPANY)
- EOR TELCO (1) 2" SCH 40 PVC CONDUIT WITH MULE TAPE FOR FIBER FROM THE NEW FIBER HANDHOLE TO THE EQUIPMENT

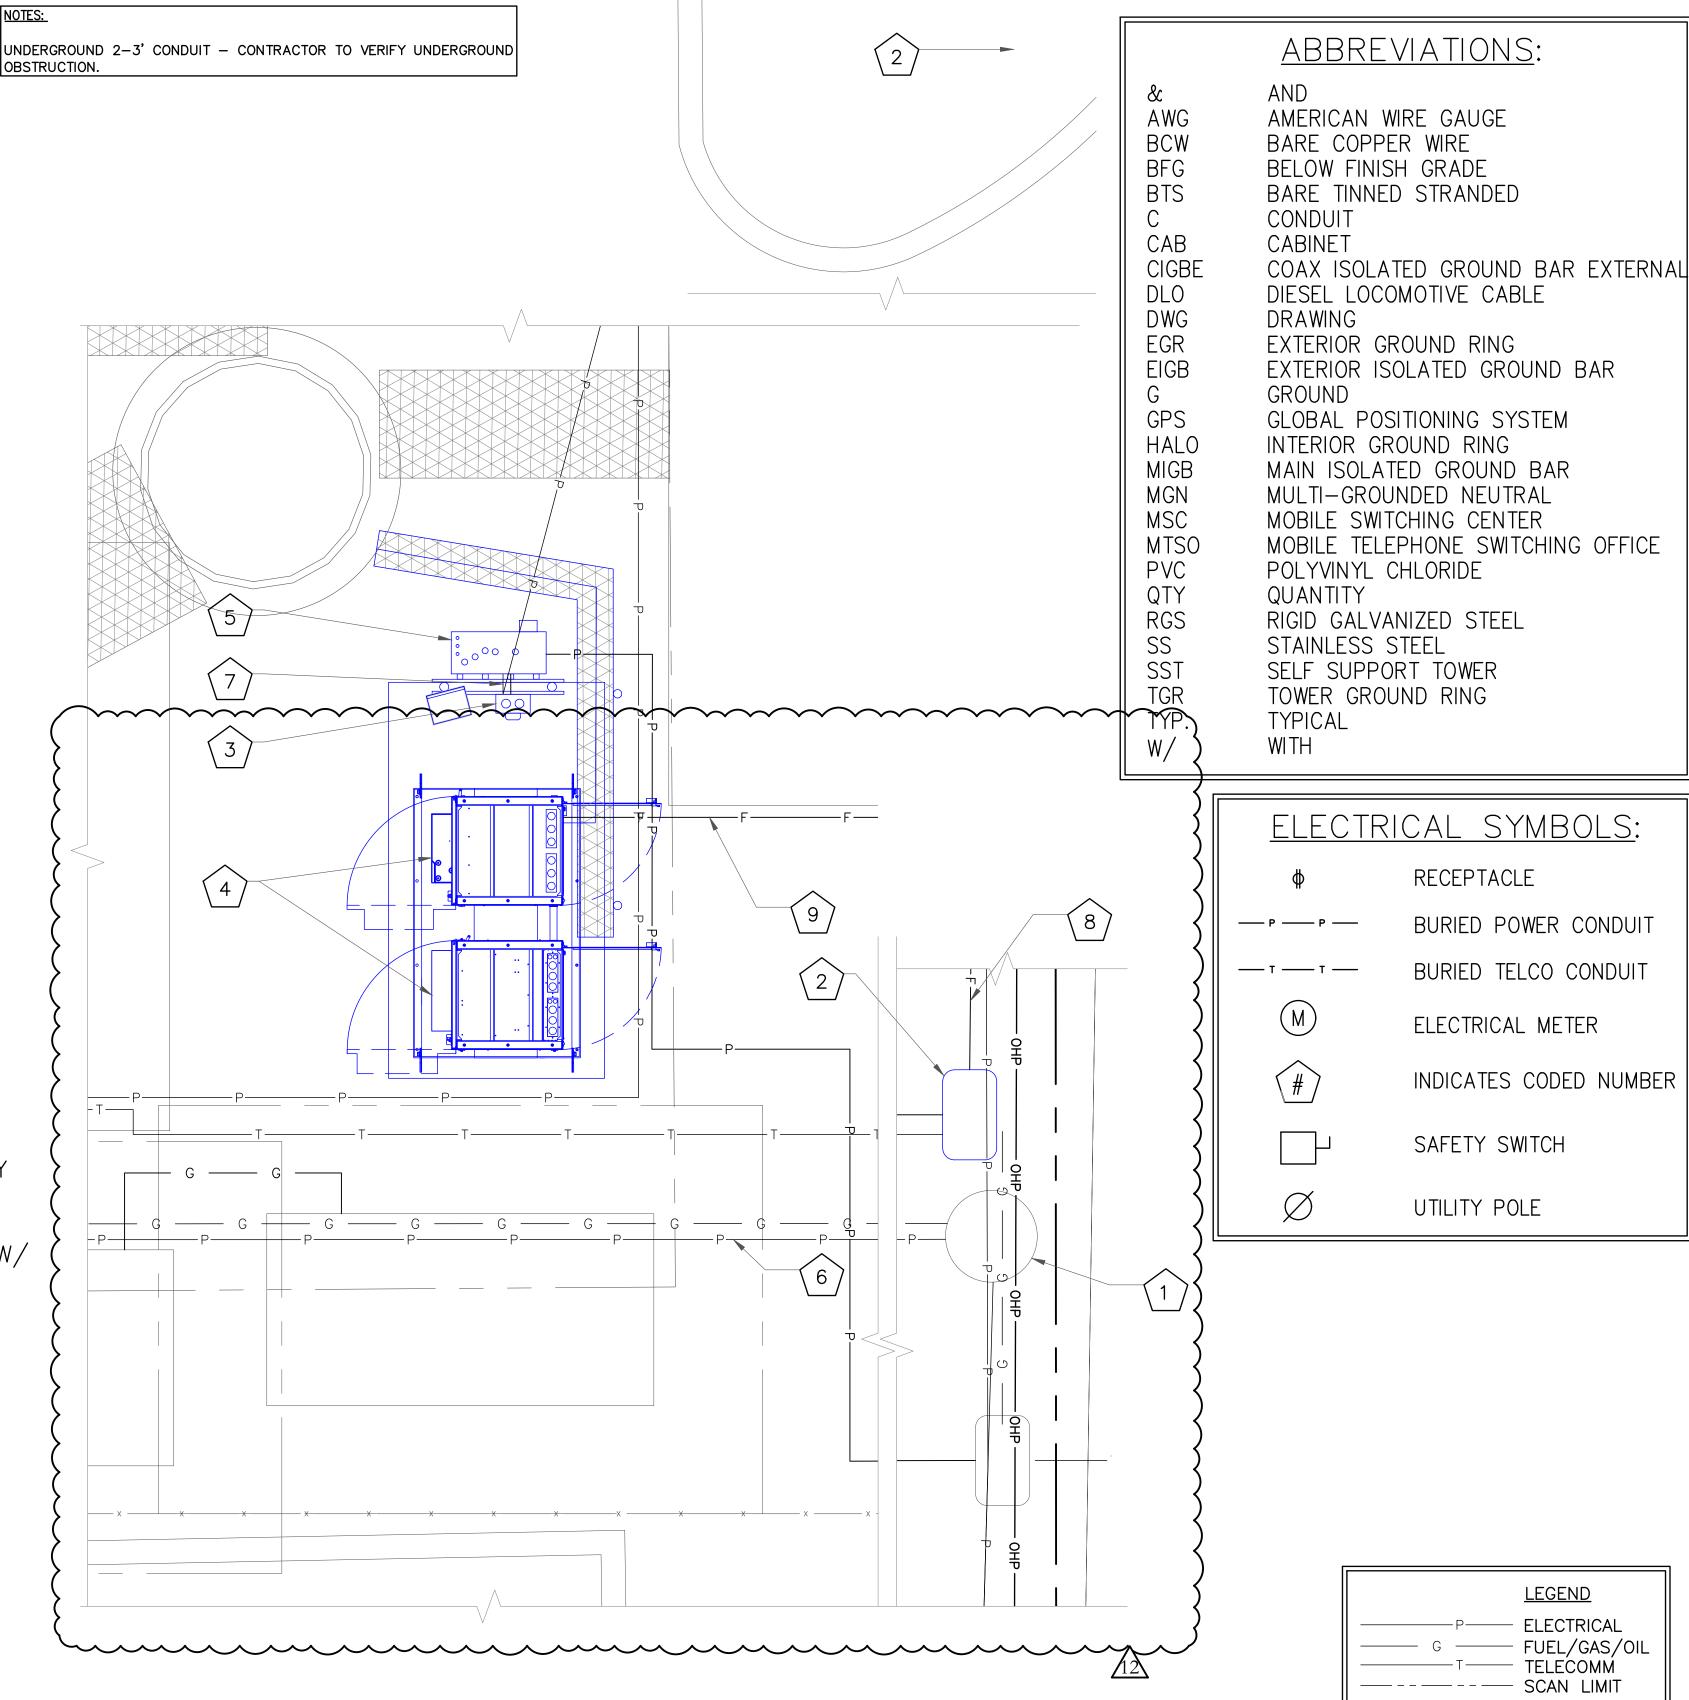

<u>NOT</u>E: ICE BRIDGE NOT SHOWN FOR CLARITY.

| NOTE: | CONTRACTOR TO LOCATE ALL UNDERGROUND UTILITIES PRIOR | TO CONSTRUCTION. COORDINATE LOCATION OF ALL PROPOSED | DIGGING & UNDERGROUND UTILITIES PRIOR TO CONSTRUCTION.

OVERALL CONDUIT LAYOUT

SCALE: NOT TO SCALE

UTILITY GUIDANCE

BU: 877803 ORDER: 547366 RES: ROBERT ROSS

UTILITY GUIDANCE (NON DOCUMENTED): GROUND LEASE DOES NOT SPECIFY OUR UTILITY RIGHTS. WHEN INSTALLING THE UTILITIES PLEASE LOCATE AND FOLLOW EXISTING PATH. IF EXISTING PATH IS NOT AN OPTION, PLEASE NOTIFY CCRE AS FURTHER COORDINATION MAY BE NEEDED.

Verizon√

IURISDICTIONAL APPROVAL:

CROWN

BEDMINSTER, NJ 07921

1200 MACARTHUR BLVD, SUITE 200 MAHWAH, NJ 07430



1825 W. WALNUT HILL LANE, SUITE 120 IRVING, TEXAS 75038

VERIZON SITE NUMBER: **16968208**

BU #: **877803 KCYC LEES SUMMIT DT**207 SE DOUGLAS
LEE'S SUMMIT, MO 64063
EXISTING 180'-0" MONOPOLE

	ISSUED FOR:				
REV	DATE	DRWN	DESCRIPTION	DES./QA	
1	06/21/2023	RC	FINAL	EAN	
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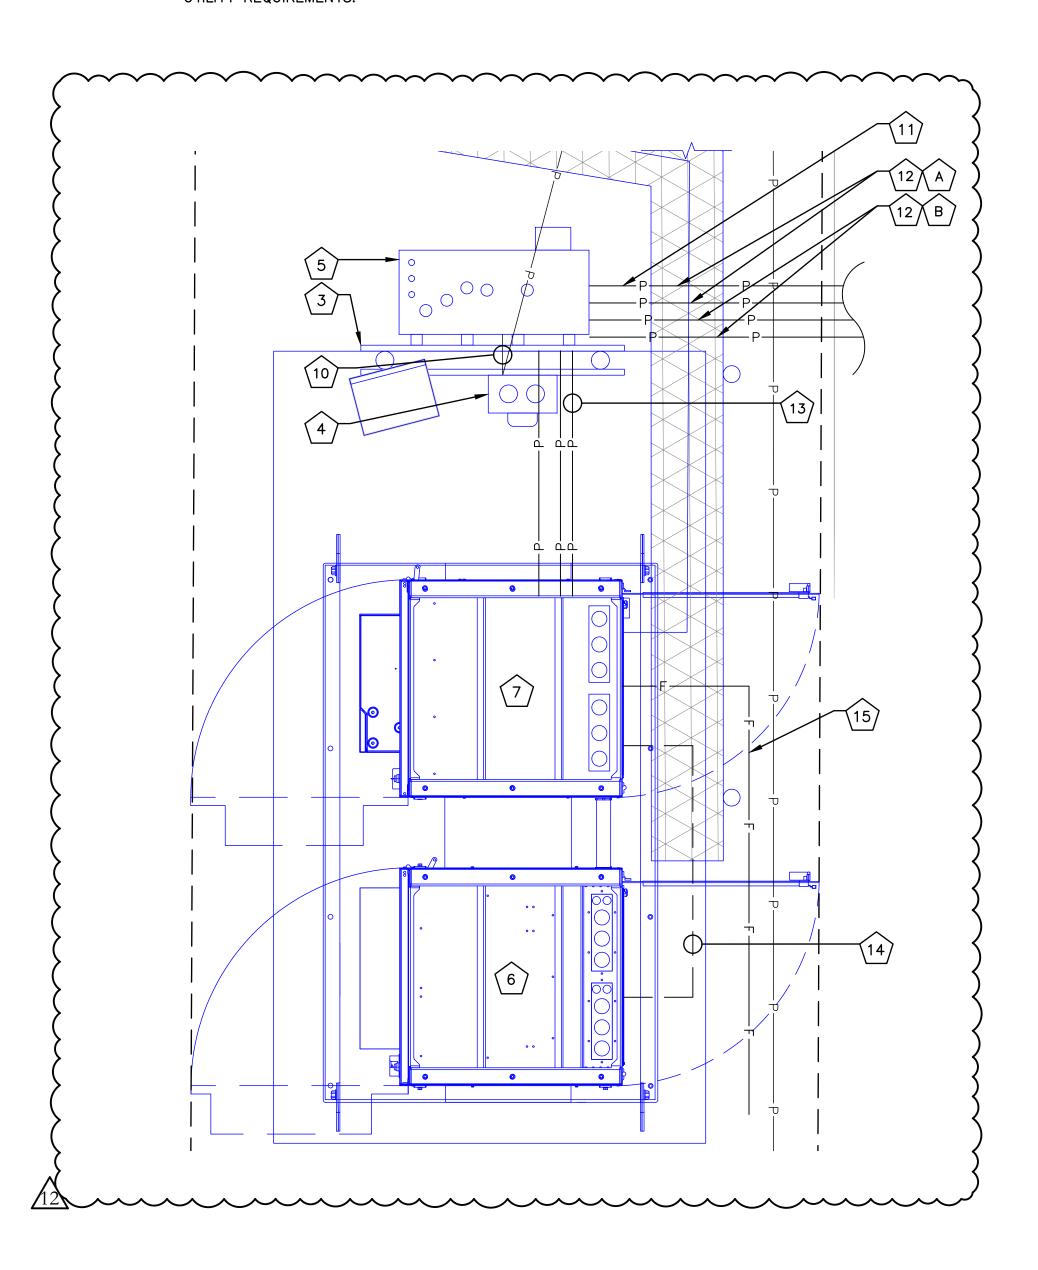
12

CODED DRAWING NOTES:

- EXISTING UTILITY POLE W/ POLE MOUNTED TRANSFORMER (NOT SHOWN)
- NEW VERIZON FIBER HANDHOLE (MEET ME POINT) (LOCATION TBD) (NOT SHOWN)
- NEW UTILITY H-FRAME
- NEW VERIZON 200A METER SOCKET W/ DISCONNECT IN EMPTY METER SLOT C ON EXISTING METERBANK
- NEW VERIZON ILC CABINET W/ INTEGRATED ATS
- NEW VERIZON BATTERY CABINET
- NEW VERIZON RF CABINET
- NEW VERIZON BACKUP GENERATOR (PENDING COORDINATION WITH LOCAL UTILITY COMPANY)
- <u>FOR POWER</u> (1) 2" SCH. 40 PVC CONDUIT FROM EXISTING UTILITY POLE (NOT SHOWN) TO NEW VERIZON METER/DISCONNECT SWITCH (NOT SHOWN) (PENDING COORDINATION WITH LOCAL
- (1) 2" SCH. 40 PVC CONDUIT FROM NEW ELECTRIC METER/DISCONNECT SWITCH TO NEW ILC CABINET W/ INTEGRATED ATS
- (1) 3/4" SCH. 40 PVC CONDUIT FOR ALARMS FROM NEW ILC CABINET W/ INTEGRATED ATS TO NEW VERIZON BACKUP GENERATOR (CONTRACTOR TO SUPPLY SIZE/QTY CONDUCTORS PER MANUFACTURER SPECIFICATIONS)
- (1) 2" SCH. 40 PVC CONDUIT FOR POWER FROM NEW ILC CABINET W/ INTEGRATED ATS TO (12) NEW TO PROPOSED VERIZON BACKUP GENERATOR (CONTRACTOR TO SUPPLY SIZE/1TY CONDUCTORS PER MANUFACTURER SPECIFICATIONS)
- (1) 2" GRC OR LIQUIDTIGHT CONDUIT FROM NEW VERIZON ILC CABINET W/ INTEGRATED ATS TO NEW VERIZON POWER RF CABINET (CONTRACTOR TO SUPPLY SIZE/QTY CONDUCTORS PER MANUFACTURER SPECIFICATIONS)
- (1) 2" GRC OR LIQUIDTIGHT CONDUIT FROM NEW VERIZON RF CABINET TO NEW VERIZON
- EOR TELCO (1) 2" PVC CONDUIT FROM NEW FIBER HANDHOLE TO NEW VERIZON RF (15) CABINET (PENDING COORDINATION WITH LOCAL UTILITY COMPANY)

GENERAL ELECTRICAL NOTES:

- 1. ALL ELECTRICAL WORK SHALL BE IN ACCORDANCE WITH THE LATEST VERSION OF THE NATIONAL ELECTRICAL CODE AND ALL LOCAL AND STATE CODES, LAWS, AND ORDINANCES.
- 2. ALL UNDERGROUND CONDUIT SHALL BE PVC SCHEDULE 40 UNLESS OTHERWISE INDICATED. SUPPLY UTILITY MARKING TAPE BURIED 12" BELOW GRADE ALONG ENTIRE LENGTH OF UNDERGROUND CONDUITS.
- 3. ALL CONDUCTORS SHALL BE COPPER WITH THHN/THWN INSULATION. CONTROL CONDUCTORS SHALL BE STRANDED, POWER & LIGHTING CONDUCTORS SHALL BE SOLID FOR #10 & #12 CONDUCTORS AND STRANDED FOR ALL OTHER SIZES.
- 4. ELECTRICAL DRAWINGS ARE IN PART DIAGRAMMATIC. COORDINATE ELECTRICAL WORK WITH SITE CONDITIONS.
- 5. LOCATE ALL UNDERGROUND UTILITIES BEFORE TRENCHING. IF CONFLICTS ARISE, CONTACT UTILITY COMPANY AND ENGINEER IMMEDIATELY.
- 6. ALL EXPOSED CONDUITS SHALL HAVE WEATHERPROOF CAPS, NOT DUCT TAPE.
- 7. PROVIDE 200 LB TEST PULL WIRES IN EACH TELEPHONE AND POWER CONDUIT.
- 8. PULL BOXES SHALL BE INSTALLED AS NEEDED PER NEC UTILITY REQUIREMENTS.



CONDUIT **CABINET** CIGBE COAX ISOLATED GROUND BAR EXTERNAL DIESEL LOCOMOTIVE CABLE DRAWING EXTERIOR GROUND RING EXTERIOR ISOLATED GROUND BAR GLOBAL POSITIONING SYSTEM INTERIOR GROUND RING MAIN ISOLATED GROUND BAR MULTI-GROUNDED NEUTRAL MOBILE SWITCHING CENTER MTS0 MOBILE TELEPHONE SWITCHING OFFICE POLYVINYL CHLORIDE QUANTITY RIGID GALVANIZED STEEL STAINLESS STEEL SELF SUPPORT TOWER TOWER GROUND RING TYPICAL WITH

ABBREVIATIONS:

AMERICAN WIRE GAUGE

BARE TINNED STRANDED

BARE COPPER WIRE BELOW FINISH GRADE

BCW

BTS

CAB

DWG

EGR

EIGB

HALO

MIGB MGN

MSC

QTY

RGS

SS

SST

TYP.

W/

	ELECTR	ICAL SYMBOLS:
	ф	RECEPTACLE
_	P —— P ——	BURIED POWER CONDUIT
_	т — т —	BURIED TELCO CONDUIT
	M	ELECTRICAL METER
	#	INDICATES CODED NUMBER
		SAFETY SWITCH
	Ø	UTILITY POLE

GENERATOR CONDUITS:

- A. (1) 2" CONDUIT (AC POWER) ILC TO GENERATOR B. (1) 1" CONDUIT WITH 2 #12 AC CIRCUITS (CHARGER
- AND HEATER) ILC TO GENERATOR C. (1) 1" CONDUIT WITH 1 #14 DC CIRCUIT (START/STOP)
- ILC TO GENERATOR D. (1) 1" CONDUIT WITH 2 CAT5'S (1 TO THE TRANSFER SWITCH AND 1 TO THE GENERATOR) ILC TO GENERATOR

EQUIPMENT CABINET:

- E. (1) 2" CONDUIT (AC POWER) ILC TO EQUIPMENT CABINET/PLINTH
- F. (1) 2"CONDUIT (ALARMS) ILC TO EQUIPMENT CABINET/PLINTH
- G. (1) 2" CONDUIT (FUTURE) ILC TO EQUIPMENT
- CABINET/PLINTH H. (1) 3" CONDUIT (OR PER JURISDICTION) (MAIN POWER) METER TO ILC

180 WASHINGTON VALLEY ROAD BEDMINSTER, NJ 07921

JURISDICTIONAL APPROVAL:





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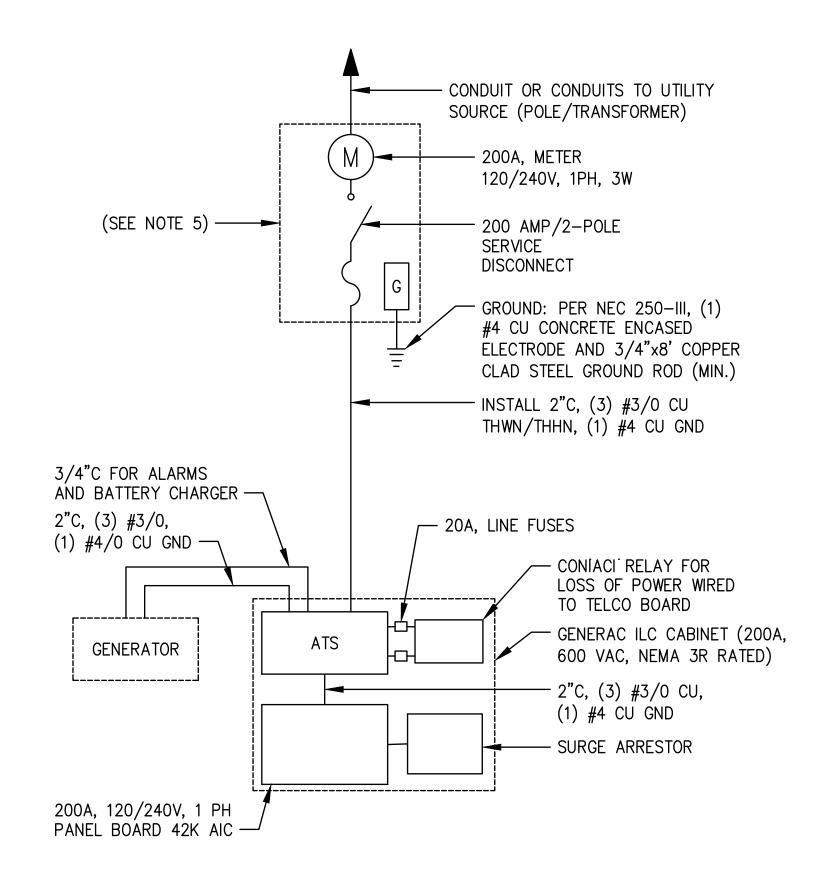
REVISION:

ICE BRIDGE NOT SHOWN FOR CLARITY.

CONTRACTOR TO LOCATE ALL UNDERGROUND UTILITIES PRIOR TO CONSTRUCTION. COORDINATE LOCATION OF ALL PROPOSED DIGGING & UNDERGROUND UTILITIES PRIOR TO CONSTRUCTION.


POWER NOTES:


- (1) ALL SERVICE EQUIPMENT SHALL USE EUSERC/POWER COMPANY REQUIREMENTS AND BE REVIEWED & APPROVED BY POWER COMPANY PRIOR TO CONSTRUCTION.
- (2) ALL CONDUITS MUST BE COPPER UNLESS OTHERWISE SPECIFIED.
- (3) CONTRACTOR SHALL COORDINATE WITH UTILITY COMPANY FOR FINAL AND EXACT WORK/MATERIALS REQUIREMENTS & CONSTRUCT TO UTILITY ENGINEERING PLANS & SPECIFICATIONS ONLY.
- (4) CONTRACTOR SHALL FURNISH AND INSTALL CONDUITS, PULL WIRES, CABLE PULL BOXES, CONCRETE ENCASEMENT OF CONDUITS, TRANSFORMER PAD, BARRIERS, POLE RISER TRENCHING, BACK FILL, PAY ALL UTILITY FEES, & INCLUDE REQUIREMENTS IN SCOPE
- (5) COMMERCIAL ELECTRICAL SERVICE COMBINATION METER AND MAIN DISCONNECT, 200A 120/240V, 1-PHASE, 3-WIRE, RING-TYPE, WITH TEST-PASS FACILITIES, 10K AIC, NEMA 3R ENCLOSURE
- (6) THE DESIGN CRITERIA USED FOR THIS PROJECT WAS THE 2014 NEC



NOT USED

SCALE: NOT TO SCALE

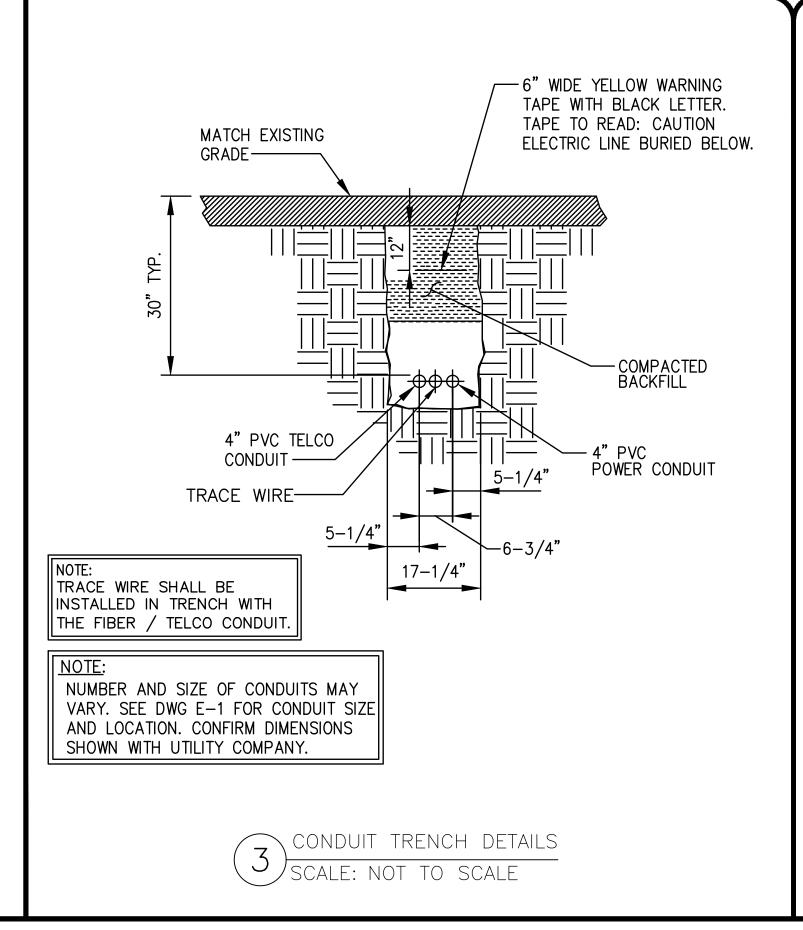

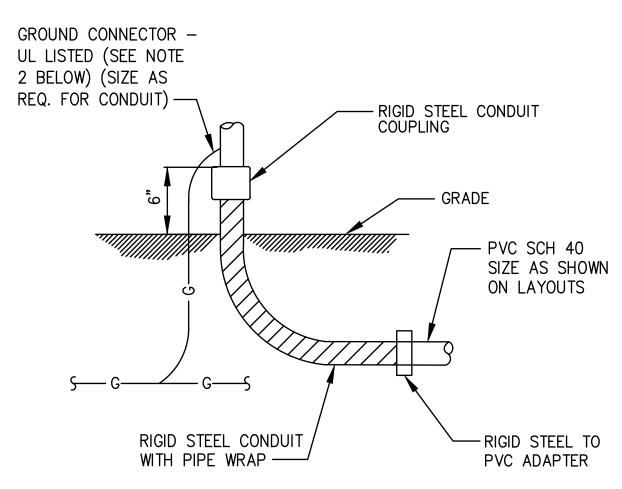

NOTES 1. AL

ALL CONDUIT ABOVE GRADE MUST BE RIGID STEEL OR LIQUIDTIGHT
 ALL NEW STRUCTURAL STEEL SHALL BE HOT DIP GALVANIZED IN
ACCORDANCE WITH ASTM A123 G90 AFTER FABRICATION.
 FIELD ABRASIONS SHALL BE TOUCH UP PAINTED WITH ZINC RICH
GALVANIZING REPAIR PAINT IN ACCORDANCE WITH ASTM A780.
 ALL EXPOSED ENDS OF CONDUITS SHALL HAVE WEATHER
PROOF CAPS. DO NOT USE DUCT TAPE.
 PROVIDE 200LB. TEST PULL WIRES IN EACH TELEPHONE AND
POWER CONDUIT. STUB CONDUITS INTO ENCLOSURE AND LABEL.

4 UNDERGROUND CONDUIT STUB-UP SCALE: NOT TO SCALE










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1) ELECTRICAL ONE LINE DIAGRAM (TYPICAL)
SCALE: NOT TO SCALE

CODED DRAWING NOTES:

- PROPOSED VERIZON BURIED EQUIPMENT GROUND RING (#2 SOLID TINNED BCW)
- PROPOSED EQUIPMENT GROUND BAR NEAR PROPOSED VERIZON EQUIPMENT (TYP. OF (2))
- PROPOSED VERIZON POWER DISTRIBUTION CABINET TO BE GROUNDED PER MANUFACTURER'S SPECIFICATIONS
- PROPOSED VERIZON BBU CABINET TO BE GROUNDED PER MANUFACTURER'S SPECIFICATIONS
- PROPOSED VERIZON ILC CABINET W/ INTEGRATED ATS TO BE GROUNDED PER MANUFACTURER'S SPECIFICATIONS
- PROPOSED EQUIPMENT H-FRAME TO BE GROUNDED PER MANUFACTURER'S SPECIFICATIONS
- EXISTING TOWER GROUND RING (NOT SHOWN)
- BOND PROPOSED EQUIPMENT GROUND BAR TO NEW VERIZON BURIED EQUIPMENT GROUND RING WITH #2 SOLID TINNED BCW. (TYP. OF (2) PLACES PER GROUND BAR)
- BOND PROPOSED ICE BRIDGE TO NEW VERIZON BURIED EQUIPMENT GROUND RING WITH #2 SOLID TINNED BCW. (TYP.)
- PROPOSED VERIZON TOWER BASE CIGBE (TYP. OF (1)) (NOT SHOWN)
- BOND PROPOSED VERIZON TOWER BASE CIGBE (NOT SHOWN) TO PROPOSED EQUIPMENT GROUND BAR WITH #2 SOLID TINNED BCW. (CONTRACTOR TO VERIFY)
- BOND PROPOSED VERIZON TOWER TOP CIGBE (NOT SHOWN) TO PROPOSED TOWER BASE CIGBE (NOT SHOWN) WITH #2 SOLID TINNED BCW. (CONTRACTOR TO VERIFY)
- BOND PROPOSED VERIZON BURIED EQUIPMENT GROUND RING TO EXISTING COMPOUND GROUNDING SYSTEM WITH #2 SOLID TINNED BCW. (TYP. OF (2) PLACES) (CONTRACTOR TO VERIFY)
- BOND TOWER BASE CIGBE (NOT SHOWN) TO EXISTING TOWER GROUND RING (NOT SHOWN) WITH #2 SOLID TINNED BCW. (CONTRACTOR TO VERIFY)
- PROPOSED BACKUP GENERATOR TO BE GROUNDED PER MANUFACTURER'S SPECIFICATIONS

GROUNDING SYMBOLS:

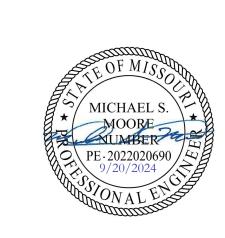GROUND ROD

ACCESS WELL


GROUND ROD WITH ACCESS

INDICATES CODED NOTE

COMPRESSION TYPE CONNECTION

#2/0 BTS COPPER CONDUCTOR


EXOTHERMIC WELD TYPE CONNECTION

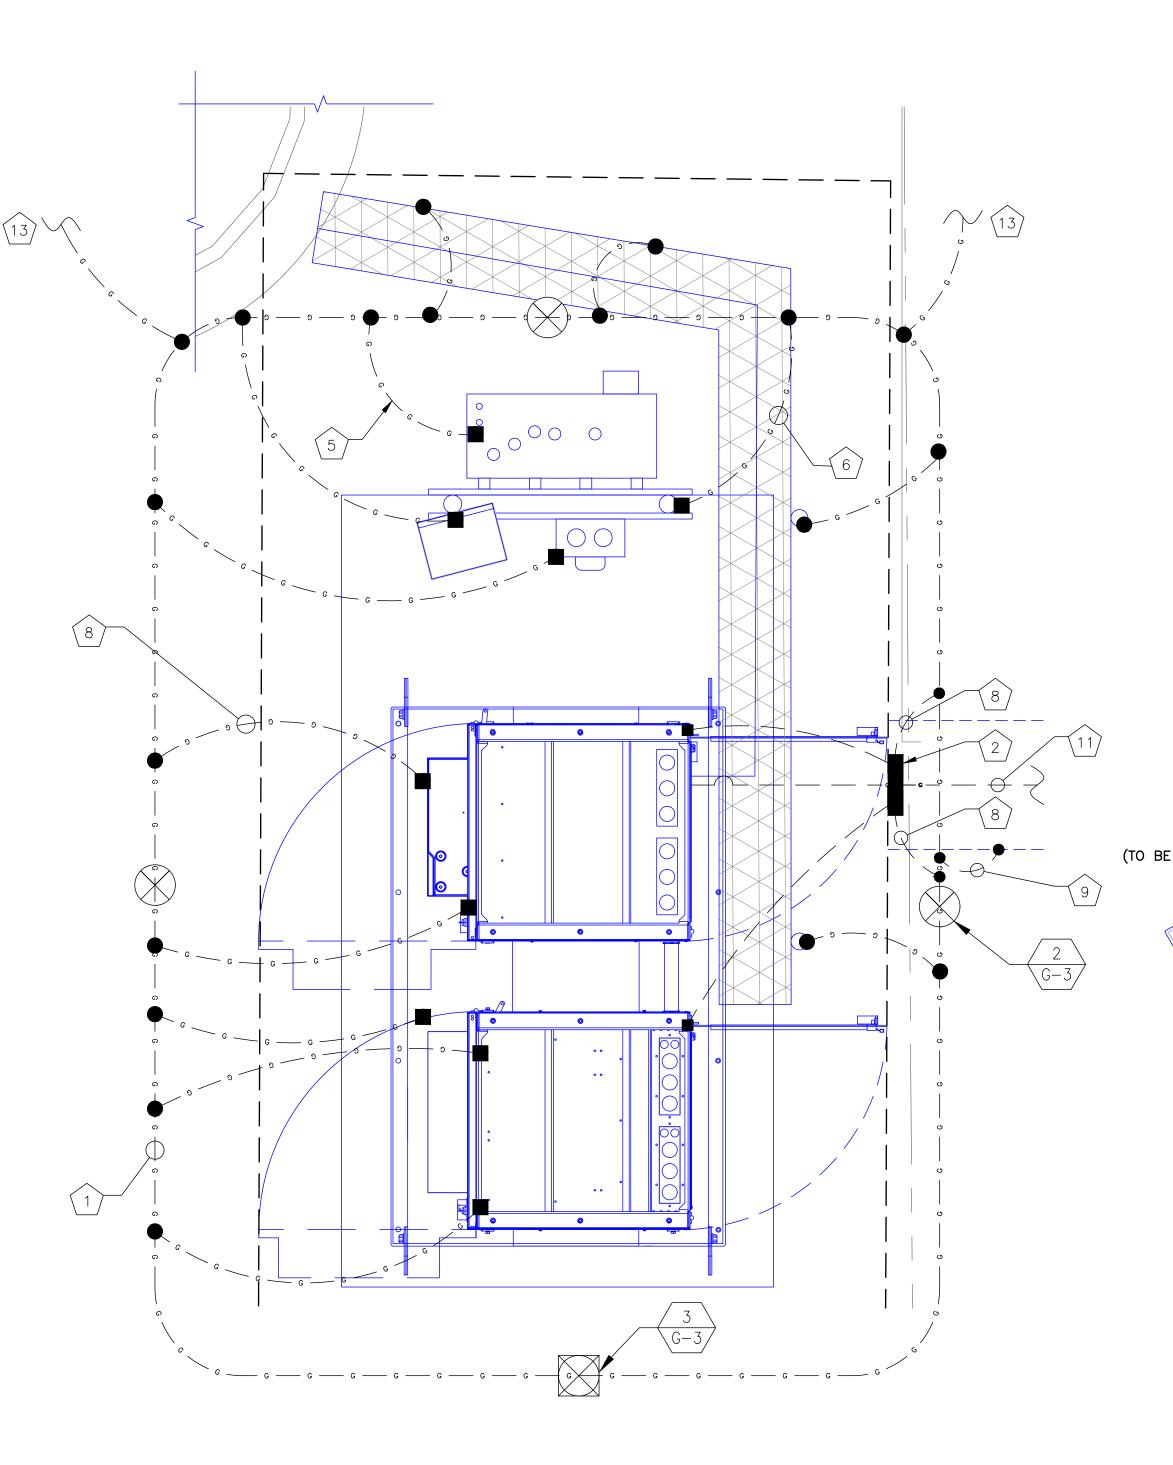

GENERAL GROUNDING NOTES:

- 1. TO ENSURE PROPER BONDING, ALL CONNECTIONS SHALL BE AS FOLLOWS:
- #2 BARE TINNED SOLID COPPER CONDUCTOR: EXOTHERMIC WELD TO RODS OR GROUND RING - LUGS AND BUS BAR (UNLESS NOTED OTHERWISE): SANDED CLEAN, COATED WITH OXIDE INHIBITOR AND BOLTED FOR MAXIMUM SURFACE CONTACT. ALL LUGS SHALL BE COPPER (NO ALUMINUM SHALL BE PERMITTED). PROVIDE LOCK WASHERS FOR ALL MECHANICAL CONNECTIONS FOR GROUND CONDUCTORS. USE STAINLESS STEEL HARDWARE THROUGHOUT.
- 2. ALL GROUNDING CABLE IN CONCRETE OR THROUGH WALLS SHALL BE IN 3/4" PVC CONDUIT. SEAL AROUND CONDUIT THROUGH WALLS. NO METALLIC CONDUIT SHALL BE USED FOR GROUNDING CONDUCTORS.
- 3. OWNER'S REPRESENTATIVE WILL INSPECT EXOTHERMIC WELD AND CONDUCT MEGGER TEST PRIOR TO BURIAL. MAXIMUM 5 OHMS RESISTANCE IS REQUIRED.
- 4. CONTRACTOR TO INSTALL GROUNDING IN CLOSE PROXIMITY TO EQUIPMENT PLATFORM OR PAD.
- 5. MAKE ALL GROUND CONNECTIONS AS SHORT AND DIRECT AS POSSIBLE. AVOID SHARP BENDS. ALL BENDS SHALL BE A MINIMUM 8" RADIUS AND NO GREATER THAN 90 DEGREES.
- 6. ALL CADWELDS TO BURIED GROUND RING SHALL BE THE PARALLEL TYPE, EXCEPT FOR THE GROUND RODS WHICH SHALL BE THE TEE TYPE.
- 7. BOND SERVICE CONDUITS TO GROUND RING AS THEY CROSS. DO NOT EXOTHERMICALLY WELD TO
- 8. THE CONTRACTOR SHALL NOTIFY THE CONSTRUCTION MANAGER WHEN THE GROUNDING SYSTEM IS COMPLETE. THE CONSTRUCTION MANAGER SHALL INSPECT THE GROUNDING SYSTEM PRIOR TO BACKFILLING.
- 9. THE MINIMUM SPACING BETWEEN GROUND RODS SHALL BE 10'-0" (MAX. 15'-0").
- 10. BOND CIGBE TO EXTERNAL GROUND RING WITH 2 RUNS OF #2 BARE, TINNED, SOLID COPPER CONDUCTOR IN PVC. CONNECT BAR END WITH 2 HOLE LUG, AND "CADWELD" THE OTHER END TO THE EXTERNAL GROUND ROD.
- 11. THE PREFERRED LOCATION FOR COAX GROUNDING IS AT THE BASE OF THE TOWER PRIOR TO THE COAX BEND.
- 12. BONDING OF THE GROUNDED CONDUCTOR (NEUTRAL) AND THE GROUNDING CONDUCTOR SHALL BE AT THE SERVICE DISCONNECTING MEANS. BONDING JUMPER SHALL BE INSTALLED PER N.E.C. ARTICLE 250-30.

CONTRACTOR TO GROUND PROPOSED ICE BRIDGE TO CROWN CASTLE SPECIFICATIONS

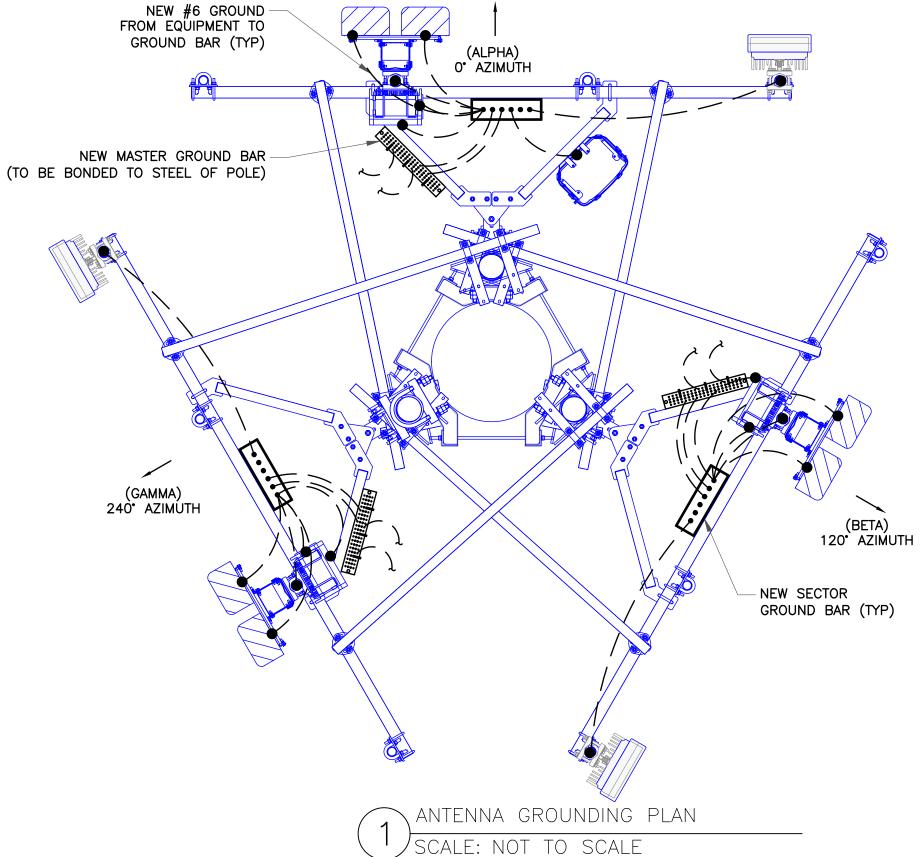

JURISDICTIONAL APPROVAL:



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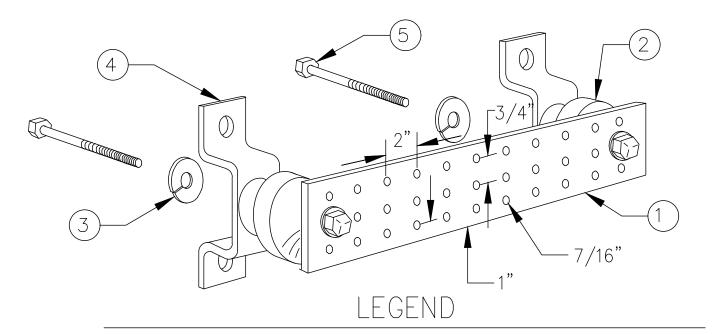


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TYPICAL GROUNDING PLAN SCALE: NOT TO SCALE




- 1. TINNED COPPER GROUND BAR, 1/4"x4"x20", NEWTON INSTRUMENT CO., HARGER
- TGBI14420M, OR EQUIVALENT. HOLE CENTERS TO MATCH
- 2. NEMA DOUBLE LUG CONFIGURATION.
- 3. INSULATORS, NEWTON INSTRUMENT CO. CAT. NO. 3061-4 OR HARGER EQUIVALENT.
- 4. 5/8" LOCKWASHERS, NEWTON INSTRUMENT CO. CAT. NO. 3015-8 OR EQUIVALENT.
- 5. WALL MOUNTING BRACKET, NEWTON INSTRUMENT CO. CAT. NO. A-6056 OR HARGER EQUIVALENT.
- 6. 5/8-11"x1" H.H.C.S. BOLTS, NEWTON INSTRUMENT CO. CAT. NO. 3012-1 OR HARGER EQUIVALENT.


NOIES:

1. ALL MOUNTING HARDWARE CAN ALSO BE USED ON 6", 12", 18", ETC. GROUND BARS. 2. ENTIRE ESSEMBLY AVAILABLE FROM NEWTON INSTRUMENT CO. CAT. NO. 2106060010 OF AS HARGER TGBI14420M.



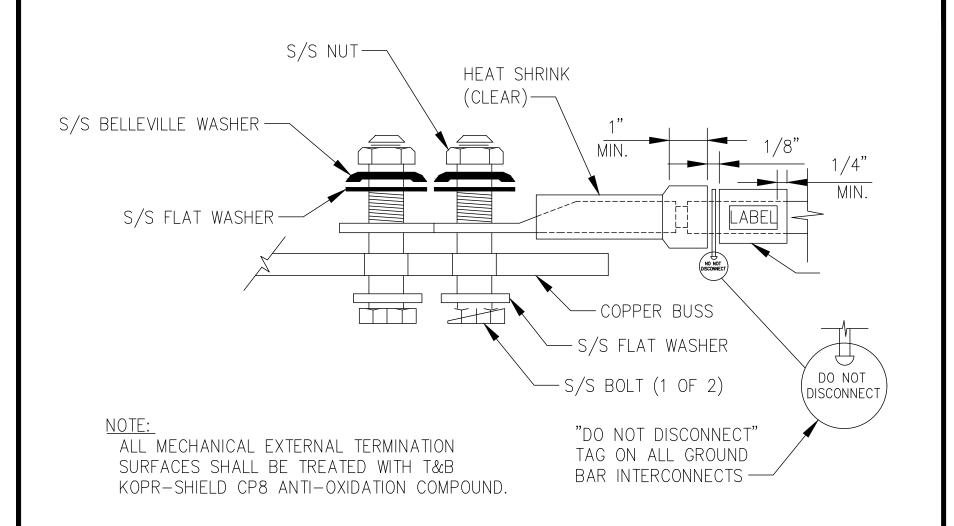



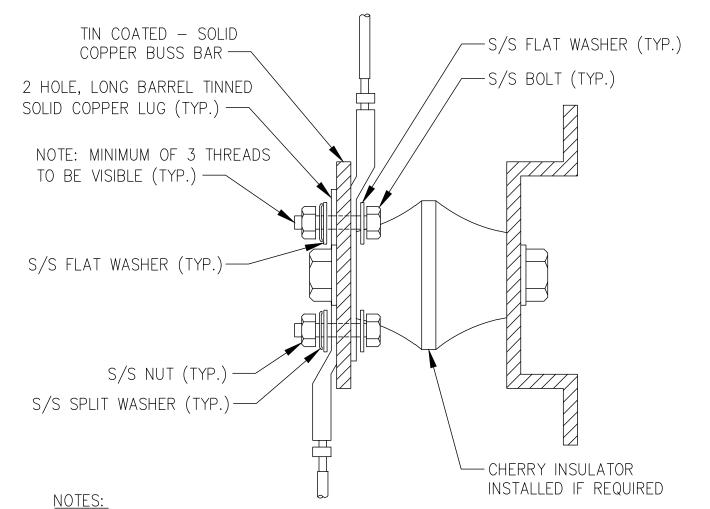

1. ALL HARDWARE 18-8 STAINLESS STEEL INCLUDING SPLIT WASHERS. 2. COAT WIRE END WITH ANTI-OXIDATION COMPOUND PRIOR TO INSERTION INTO LUG BARREL AND CRIMPING. 3. APPLY ANTI-OXIDATION COMPOUND BETWEEN ALL LUGS AND BUSS BARS



PRIOR TO MATING AND BOLTING.



180 WASHINGTON VALLEY ROAD BEDMINSTER, NJ 07921

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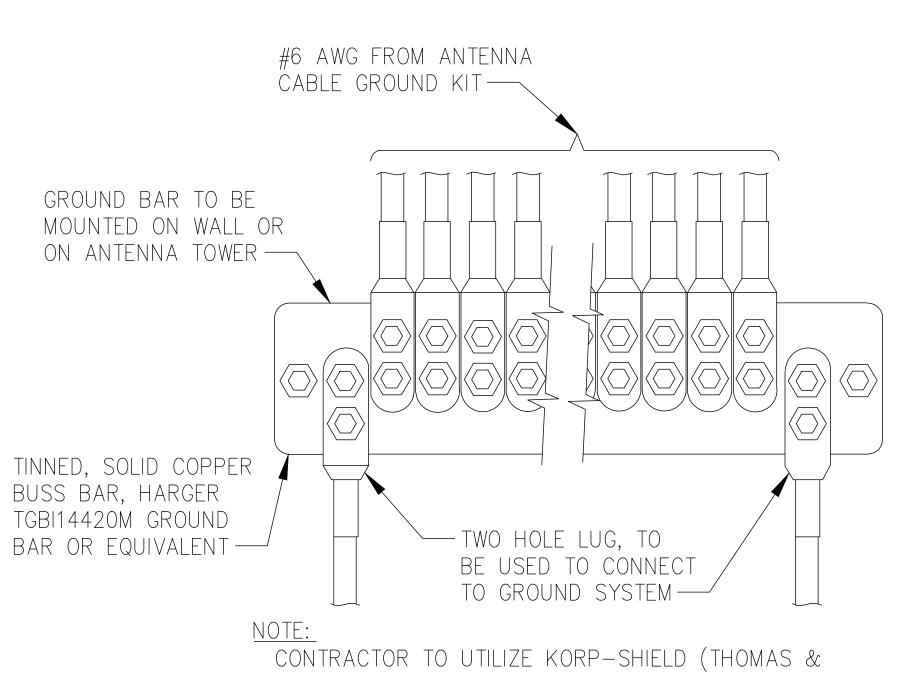
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BETTS) OR EQUIVALENT ON ALL LUG CONNECTIONS

TYPCAL ANTENNA GROUND BAR SCALE: NOT TO SCALE

TYPICAL CABLE GROUND KIT CONNECTION SCALE: NOT TO SCALE


-JUMPER REQUIRED ONLY WHEN 7/8"ø AND LARGER (TYP.) WEATHERPROOFING KIT (USE SITEPRO1 OR APPROVED EQUAL) - STANDARD GROUND KIT (USE SITEPRO1 OR APPROVED EQUAL) ANTENNA CABLE (TYP.) NOTE: DO NOT INSTALL CABLE GROUND KIT AT A BEND ALWAYS DIRECT GROUND WIRE DOWN TO CIGBE #6 AWG-GROUND BAR (CONTRACTOR SUPPLIED) #2/0 AWG GREEN INSULATED TO GROUND BAR AS APPROPRIATE ELEVATION VIEW

TYPICAL CONNECTION OF GROUND WIRES TO GROUNDING BARS@ANTENNA SCALE: NOT TO SCALE

12" APPROX. EQUIPMENT — 2 1/2" Ø MAX.— ANTENNA CABLE ---- CABLE GROUND KIT CABLEWAVE WEATHERPROOFING KIT — - #2 AWG STRANDED COPPER GROUND WIRE (GROUNDED TO GROUND BAR)
(STANDARD CABLEWAVE GROUNDING KIT)

TO ANTENNA CABLE


DO NOT INSTALL CABLE GROUND KIT AT A BEND AND ALWAYS DIRECT GROUND WIRE DOWN TO GROUND BAR.

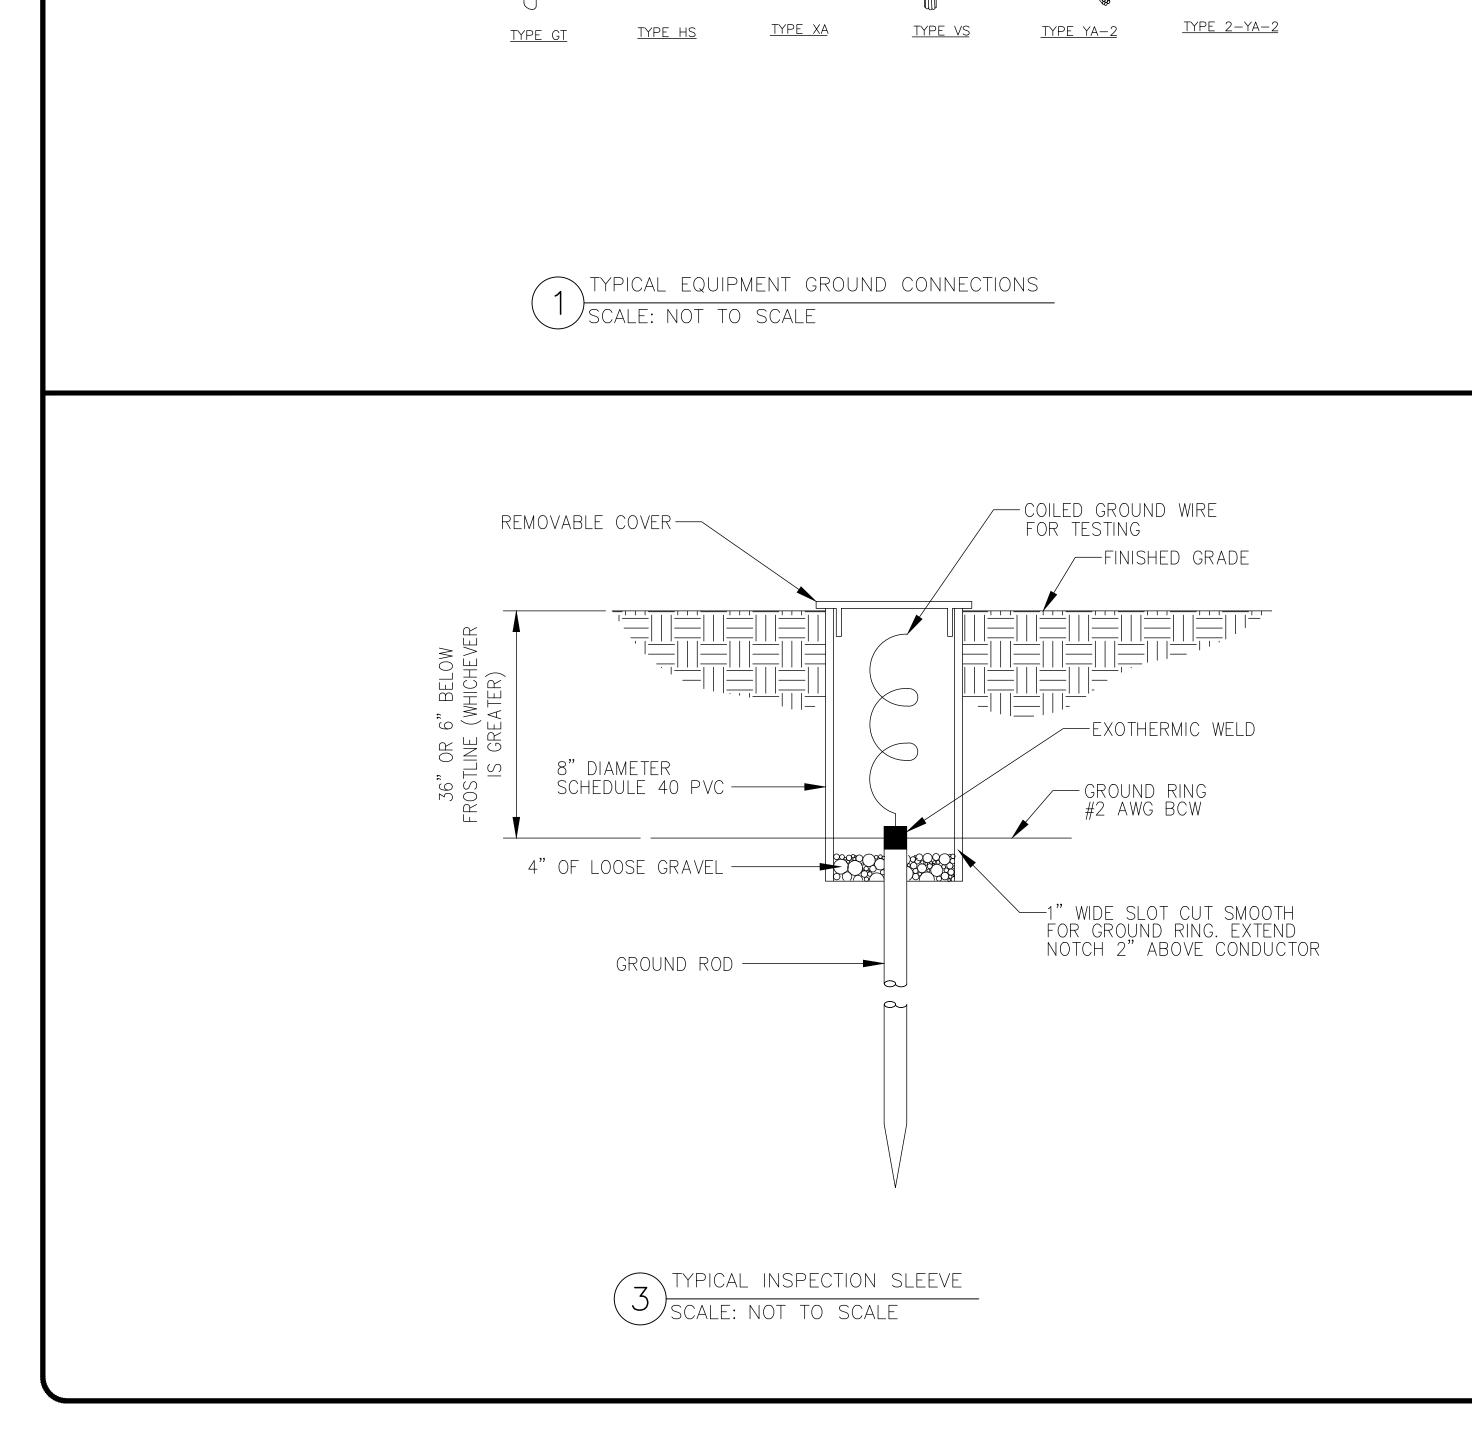

TYPE SS

NOTE: ERICO CADWELD "MOLD TYPES" SHOWN HERE ARE EXAMPLES. CONSULT WITH PROJECT MANAGER FOR SPECIFIC MOLDS TO BE USED FOR THIS PROJECT

TYPE PT

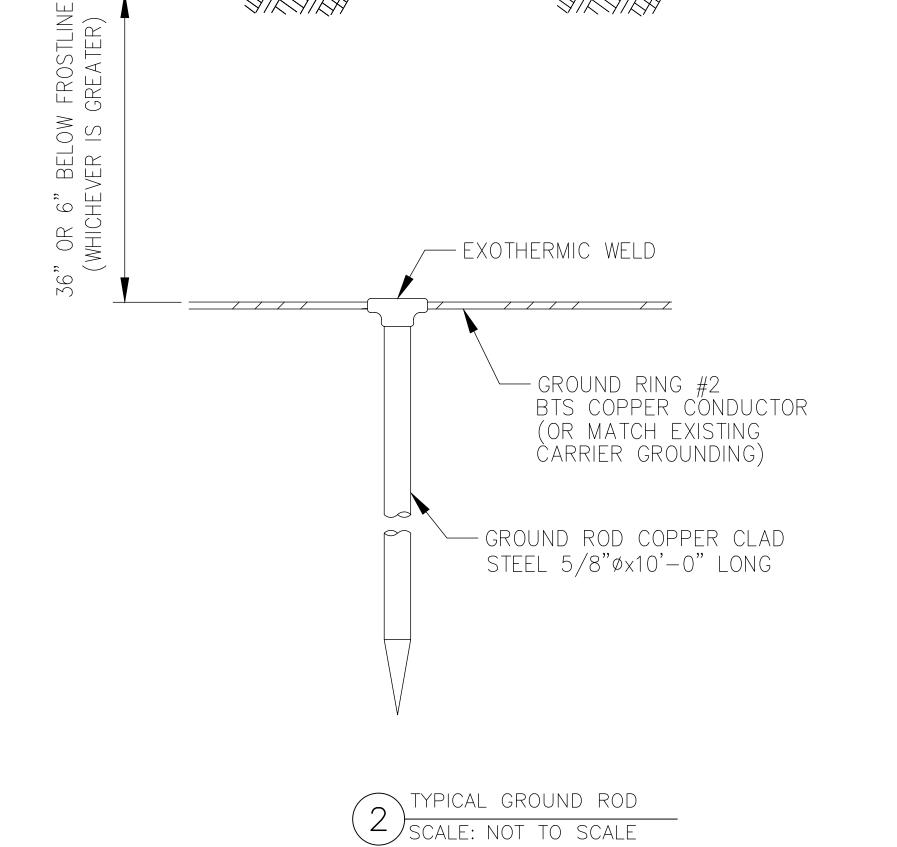

SCALE: NOT TO SCALE

GRADE

7/2/2/

7/2/2/



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SHEET NUMBER:

REVISION:

EXISTING 180'-0" MONOPOLE 11 08/14/2024 RC AMT 09/19/2024 RC FINAL AMT

PROPERTY DESCRIPTION: LEASE AREA (AS PROVIDED) All that part of Lot 8, Block 17, W.B. Howards Addition, a subdivision in the city of Lee's Summit, Jackson County, Missouri described as follows: Commencing at the most Northerly corner of said Lot 8, thence South 45° East along the most Northeasterly line of said Lot 8, a distance of 4.59 feet, thence South 44° 41' 08" West parallel to the most Northwesterly line of said Lot 8, a distance of 30.00 feet to the point of beginning, thence continuing South 44° 41' 08" West, a distance of 30.00 feet, thence South 45° East a distance of 40.00 feet, thence North 44°41' 08" East, a distance of 30.00 feet, thence North 45° West, a distance of 40.00 feet to the point of beginning. City of Lee's Summit APN: 61-340-20-06-00-0-000 Deed: N/A Given under my hand and seal ______ JEFFREY B. LOVELACE MO-LS2580

NOTE: LEE'S SUMMIT FIRE STATION

BUN: 877803

LEE'S SUMMIT FIRE STATION BUN: 877803

PROPERTY DESCRIPTION: NON-EXCLUSIVE ACCESS & UTILITY EASEMENT (AS SURVEYED)

A 20 foot wide Access and Utility Easement being situated in Lots 7 and 8, Block 17, WILLIAM B. HOWARD'S FIRST ADDITION TO THE CITY OF LEE'S SUMMIT, Jackson County, Missouri, lying 10.00 feet on each side of following described centerline:

COMMENCING at the most Northerly corner of said Lot 8; thence along the Northeasterly line of said Lot 8, South 28°44'45" East, a distance of 4.59 feet; thence departing said Northeasterly line, South 60°48'47" West, a distance of 47.24 feet; thence North 29°11'13" West, a distance of 10.00 feet to the POINT OF BEGINNING; thence North 60°48'47" East, a distance of 20.00 feet; thence North 29°11'13" West, a distance of 4.59 feet; thence North 60°48'47" East, a distance of 27.35 feet to the Southwesterly line of an existing Public Alley in said Block 17 and the POINT OF TERMINATION. Containing 1,039 square feet or 0.02 acres more or less.

APŃ: Deed:	61-340-20-06-00-0-00-000 N/A
Given	under my hand and seal
JEFFRE MO-LS	EY B. LOVELACE S2580