



ATC SITE NAME: LEES SUMMIT ATC SITE NUMBER: 306030

WISPER ISP SITE NAME: JCKSMOAJ

SITE ADDRESS: 111 SW HOOK ROAD

LEES SUMMIT, MO 64082



LOCATION MAP

WISPER ISP COLLOCATION PLAN

| COMPLIANCE CODE | PROJECT SUMMARY | | PROJECT DESCRIPTION | | SHEET INDEX | | | |
|--|--|--|---|---|-----------------------------------|-------------------|----------|----------|
| ALL WORK SHALL BE PERFORMED AND MATERIALS INSTALLED IN ACCORDANCE WITH THE CURRENT EDITIONS OF THE | <u>SITE ADDRESS:</u> 111 SW HOOK ROAD LEES SUMMIT, MO 64082 COUNTY: JACKSON | | THE PROPOSED PROJECT INCLUDES PLACING A NEW EQUIPMENT CABINET ON A NEW CONCRETE PAD | SHEET NO: | DESCRIPTION: | REV: | DATE: | BY: |
| FOLLOWING CODES AS ADOPTED BY THE LOCAL GOVERNMENT AUTHORITIES. NOTHING IN THESE PLANS IS | | | WITHIN THE EXISTING COMPOUND, AND INSTALLING | G-001 | TITLE SHEET | 0 | 07/01/24 | VAR |
| TO BE CONSTRUED TO PERMIT WORK NOT CONFORMING TO THESE CODES. | | | NEW EQUIPMENT ON AN EXISTING TOWER. | G-002 | GENERAL NOTES | 0 | 07/01/24 | VAR |
| INTERNATIONAL BUILDING CODE (IBC) | GEOGRAPHIC CO | OORDINATES: | | C-101 | DETAILED SITE PLAN | 0 | 07/01/24 | VAR |
| NATIONAL ELECTRIC CODE (NEC) LOCAL BUILDING CODE | LATITUDE: 38 | | | C-201 | TOWER ELEVATION | 0 | 07/01/24 | VAR |
| 4. CITY/COUNTY ORDINANCES | LONGITUDE: -94.37692264 GROUND ELEVATION: 1001' AMSL | | | C-401 | ANTENNA INFORMATION & SCHEDULE | 0 | 07/01/24 | VAR |
| | | | PROJECT NOTES | C-501 | CONSTRUCTION DETAILS | 0 | 07/01/24 | VAR |
| | | | THE FACILITY IS UNMANNED. | C-502 | CONSTRUCTION DETAILS | 0 | 07/01/24 | VAR |
| | | | A TECHNICIAN WILL VISIT THE SITE APPROXIMATELY ONCE A MONTH FOR ROUTINE INSPECTION AND MAINTENANCE. | C-503 | CONSTRUCTION DETAILS | 0 | 07/01/24 | VAR |
| | | | 3. THE PROJECT WILL NOT RESULT IN ANY SIGNIFICANT LAND DISTURBANCE OR EFFECT OF STORM WATER DRAINAGE. 4. NO SANITARY SEWER, POTABLE WATER OR TRASH DISPOSAL IS REQUIRED. | E-101 | GROUNDING LAYOUT | 0 | 07/01/24 | VAR |
| | PROJEC ⁻ | APPLICANT: | | E-501 | PANEL SCHEDULE & ONE-LINE DIAGRAM | 0 | 07/01/24 | VAR |
| | TOWER OWNER: | | ER: APPLICANT: | 5. HANDICAP ACCESS IS NOT REQUIRED. 6. THE PROJECT DEPICTED IN THESE PLANS QUALIFIES AS | E-502 | GROUNDING DETAILS | 0 | 07/01/24 |
| | AMERICAN TOWER | WISPER ISP INC | AN ELIGIBLE FACILITIES REQUEST ENTITLED TO EXPEDITED REVIEW UNDER 47 U.S.C. § 1455(A) AS A | E-503 | GROUNDING DETAILS | 0 | 07/01/24 | VAR |
| | 10 PRESIDENTIAL WAY WOBURN, MA 01801 | 9711 FUESSER ROAD MASCOUTAH, IL 62258 | MODIFICATION OF AN EXISTING WIRELESS TOWER THAT INVOLVES THE COLLOCATION, REMOVAL, AND/OR | | | | | |
| | ENGINEER: | | REPLACEMENT OF TRANSMISSION EQUIPMENT THAT IS NOT A SUBSTANTIAL CHANGE UNDER CFR § 1.61000 (B)(7). | | | | | |
| | ATC TOWER SERVICES, LLC | | DDO IFOT LOOATION DIDECTIONS | | | | | |
| UTILITY COMPANIES | 3500 REGENCY PKWY STE 100 CARY, NC 27518 | | PROJECT LOCATION DIRECTIONS | | | | | |
| POWER COMPANY: KANSAS CITY POWER & LIGHT PHONE: (888) 471-5275 | PROPERTY OWNER: UMB BANK NA | | FROM DOWNTOWN KANSAS CITY, MO TAKE RAMP (EAST) ONTO I-70 | | | | | |
| TELEPHONE COMPANY: AT&T PHONE: (888) 544-8847 | 111 SW HOOK ROAD LEES SUMMIT, MO 64082 | | [US-40] FOR 5.9 MILES, AT EXIT 8A, TAKE RAMP (RIGHT) ONTO I-435 FOR 2.9 MILES, AT EXIT 66, TAKE RAMP (LEFT) ONTO SR-350 [BLUE PKY] FOR 8.3 MILES, ROAD NAME CHANGES TO US-50 [SR-350] FOR | | | | | |
| Know what's below. Call before you dig. | | | 2.7 MILES, TAKE RAMP (LEFT) ONTO SR-291 FOR 2.7 MILES, TURN RIGHT (WEST) ONTO SW HOOK RD, THEN IMMEDIATELY TURN LEFT (SOUTH-EAST) ONTO OUTER ROAD FOR 0.2 MILES, TURN RIGHT (WEST) ONTO ACCESS ROAD WITH GATE | | | | | |



ATC TOWER SERVICES LLC

3500 REGENCY PARKWAY SUITE 100 CARY, NC 27518 PHONE: (919) 468-0112 2015011232

THE USE AND PUBLICATION OF THESE DRAWINGS SHALL BE RESTRICTED TO THE ORIGINAL SITE FOR WHICH THEY ARE PREPARED. ANY USE OR DISCLOSURE OTHER THAN THAT WHICH RELATES TO AMERICAN TOWER OR THE SPECIFIED CARRIER IS STRICTLY PROHIBITED. NEITHER THE ARCHITECT NOR THE ENGINEER WILL BE PROVIDING ON-SITE CONSTRUCTION REVIEW OF THIS PROJECT. CONTRACTORS) MUST VERIFY ALL DIMENSIONS AND ADVISE AMERICAN TOWER OR THE SPECIFIED CARRIER OF ANY DISCREPANCIES. ANY PRIOR ISSUANCE OF THIS DRAWING IS SUPERSEDED BY THE LATEST VERSION.

| REV. | DESCRIPTION | BY | DATE |
|---------------------|------------------|---------------|----------|
| ▲. | FOR CONSTRUCTION | <u>VAR</u> | 07/01/24 |
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WISPER ISP SITE NAME:

JCKSMOAJ

SITE ADDRESS: 111 SW HOOK ROAD LEES SUMMIT. MO 64082

SEAL





ATC JOB NO: 14536934_D2
CUSTOMER ID: JCKSMOAJ
CUSTOMER #: JCKSMOAJ

TITLE SHEET

SHEET NUMBER:

G-001

0

GENERAL CONSTRUCTION NOTES:

- OWNER FURNISHED MATERIALS, WISPER ISP, LLC "THE COMPANY" WILL PROVIDE AND 22. THE CONTRACTOR WILL INSTALL
 - A. BTS EQUIPMENT FRAME (PLATFORM) AND ICEBRIDGE SHELTER (GROUND
 - BUILD/CO-LOCATE ONLY) AC/TELCO INTERFACE BOX (PPC)
 - C. ICE BRIDGE (CABLE TRAY WITH COVER) (GROUND BUILD/CO-LOCATE ONLY, GC TO FURNISH AND INSTALL FOR ROOFTOP INSTALLATION)
 - D. TOWERS, MONOPOLES
 - TOWER LIGHTING
 - GENERATORS & LIQUID PROPANE TANK
 - G. ANTENNA STANDARD BRACKETS, FRAMES AND PIPES FOR MOUNTING
 - ANTENNAS (INSTALLED BY OTHERS)
 - TRANSMISSION LINE
 - TRANSMISSION LINE JUMPERS
 - TRANSMISSION LINE CONNECTORS WITH WEATHERPROOFING KITS
 - TRANSMISSION LINE GROUND KITS
 - HANGERS
 - HOISTING GRIPS
 - O. BTS EQUIPMENT
- THE CONTRACTOR IS RESPONSIBLE TO PROVIDE ALL OTHER MATERIALS FOR THE COMPLETE INSTALLATION OF THE SITE INCLUDING, BUT NOT LIMITED TO, SUCH MATERIALS AS FENCING, STRUCTURAL STEEL SUPPORTING SUB-FRAME FOR PLATFORM ROOFING LABOR AND MATERIALS GROUNDING RINGS GROUNDING WIRES COPPER-CLAD OR XIT CHEMICAL GROUND ROD(S), BUSS BARS, TRANSFORMERS AND DISCONNECT SWITCHES WHERE APPLICABLE, TEMPORARY ELECTRICAL POWER CONDUIT LANDSCAPING COMPOUND STONE, CRANES, CORE DRILLING, SI FEPERS AND RUBBER MATTING, REBAR, CONCRETE CAISSONS, PADS AND/OR AUGER MOUNTS, MISCELLANEOUS FASTENERS, CABLE TRAYS, NON-STANDARD ANTENNA FRAMES AND ALL OTHER MATERIAL AND LABOR REQUIRED TO COMPLETE THE JOB ACCORDING TO THE DRAWINGS AND SPECIFICATIONS. IT IS THE POSITION OF WISPER ISP, LLC TO APPLY FOR PERMITTING AND CONTRACTOR RESPONSIBLE FOR PICKUP AND PAYMENT OF
- ALL WORK SHALL CONFORM TO ALL CURRENT APPLICABLE FEDERAL, STATE, AND LOCAL CODES, INCLUDING ANSI/EIA/TIA-222, AND COMPLY WITH ATC CONSTRUCTION
- CONTRACTOR SHALL CONTACT LOCAL 811 FOR IDENTIFICATION OF UNDERGROUND UTILITIES PRIOR TO START OF CONSTRUCTION.
- CONTRACTOR SHALL BE RESPONSIBLE FOR COORDINATING ALL REQUIRED INSPECTIONS.
- ALL DIMENSIONS TO, OF, AND ON EXISTING BUILDINGS, DRAINAGE STRUCTURES, AND SITE IMPROVEMENTS SHALL BE VERIFIED IN FIELD BY CONTRACTOR WITH ALL DISCREPANCIES REPORTED TO THE ENGINEER.
- DO NOT CHANGE SIZE OR SPACING OF STRUCTURAL ELEMENTS
- DETAILS SHOWN ARE TYPICAL: SIMILAR DETAILS APPLY TO SIMILAR CONDITIONS UNLESS
- THESE DRAWINGS DO NOT INCLUDE NECESSARY COMPONENTS FOR CONSTRUCTION SAFETY WHICH SHALL BE THE SOLE RESPONSIBILITY OF THE CONTRACTOR.
- CONTRACTOR SHALL BRACE STRUCTURES UNTIL ALL STRUCTURAL ELEMENTS NEEDED FOR STABILITY ARE INSTALLED. THESE ELEMENTS ARE AS FOLLOWS: LATERAL BRACING,
- CONTRACTOR SHALL DETERMINE EXACT LOCATION OF EXISTING UTILITIES, GROUNDS DRAINS, DRAIN PIPES, VENTS, ETC, BEFORE COMMENCING WORK
- INCORRECTLY FABRICATED, DAMAGED, OR OTHERWISE MISFITTING OR NONCONFORMING MATERIALS OR CONDITIONS SHALL BE REPORTED TO THE WISPER ISP, LLC REP PRIOR TO REMEDIAL OR CORRECTIVE ACTION, ANY SUCH REMEDIAL ACTION SHALL REQUIRE WRITTEN APPROVAL BY THE WISPER ISP, LLC REP PRIOR TO
- EACH CONTRACTOR SHALL COOPERATE WITH THE WISPER ISP, LLC REP, AND COORDINATE HIS WORK WITH THE WORK OF OTHERS.
- CONTRACTOR SHALL REPAIR ANY DAMAGE CAUSED BY CONSTRUCTION OF THIS PROJECT TO MATCH EXISTING PRE-CONSTRUCTION CONDITIONS TO THE SATISFACTION OF THE WISPER ISP. LLC. CONSTRUCTION MANAGER
- ALL CARLE/CONDUIT ENTRY/EXIT PORTS SHALL BE WEATHERPROOFED DURING INSTALLATION USING A SILICONE SEALANT
- WHERE EXISTING CONDITIONS DO NOT MATCH THOSE SHOWN IN THIS PLAN SET CONTRACTOR SHALL NOTIFY THE WISPER ISP, LLC REP AND ENGINEER OF RECORD **IMMEDIATELY**
- CONTRACTOR SHALL ENSURE ALL SUBCONTRACTORS ARE PROVIDED WITH A COMPLETE AND CURRENT SET OF DRAWINGS AND SPECIFICATIONS FOR THIS PROJECT.
- CONTRACTOR SHALL REMOVE ALL RUBBISH AND DEBRIS FROM THE SITE AT THE END OF
- CONTRACTOR SHALL COORDINATE WORK SCHEDULE WITH AMERICAN TOWER CORPORATION (ATC) AND TAKE PRECAUTIONS TO MINIMIZE IMPACT AND DISRUPTION OF

OTHER OCCUPANTS OF THE FACILITY.

- CONTRACTOR SHALL FURNISH WISPER ISP, LLC, AND AMERICAN TOWER CORPORATION (ATC) WITH A PDF MARKED UP AS-BUILT SET OF DRAWINGS UPON COMPLETION OF
- PRIOR TO SUBMISSION OF BID, CONTRACTOR SHALL COORDINATE WITH WISPER ISP, LLC REP TO DETERMINE WHAT, IF ANY, ITEMS WILL BE PROVIDED. ALL ITEMS NOT PROVIDED SHALL BE PROVIDED AND INSTALLED BY THE CONTRACTOR. CONTRACTOR WILL INSTALL

ALL ITEMS PROVIDED.

- PRIOR TO SUBMISSION OF BID CONTRACTOR SHALL COORDINATE WITH WISPER ISP. LLC REP TO DETERMINE IF ANY PERMITS WILL BE OBTAINED BY CONTRACTOR. ALL
 REQUIRED PERMITS NOT OBTAINED BY WISPER ISP, LLC MUST BE OBTAINED, AND PAID FOR, BY THE CONTRACTOR
- 23. CONTRACTOR SHALL INSTALL ALL SITE SIGNAGE IN ACCORDANCE WITH WISPER ISP, LLC 6. SPECIFICATIONS AND REQUIREMENTS.
- CONTRACTOR SHALL SUBMIT ALL SHOP DRAWINGS TO WISPER ISP, LLC FOR REVIEW AND APPROVAL PRIOR TO FABRICATION.
- 25. ALL EQUIPMENT SHALL BE INSTALLED ACCORDING TO MANUFACTURER'S SPECIFICATIONS AND LOCATED ACCORDING TO WISPER ISP, LLC SPECIFICATIONS, AND AS SHOWN IN THESE PLANS.
- THE CONTRACTOR SHALL SUPERVISE AND DIRECT THE PROJECT DESCRIBED HEREIN. THE CONTRACTOR SHALL BE SOLELY RESPONSIBLE FOR ALL THE CONSTRUCTION MEANS, METHODS, TECHNIQUES, SEQUENCES AND PROCEDURES AND FOR COORDINATING ALL PORTIONS OF THE WORK UNDER THE CONTRACT.
- 27 CONTRACTOR SHALL NOTIFY WISPER ISPULIC REP A MINIMUM OF 48 HOURS IN ADVANCE OF POURING CONCRETE OR BACKFILLING ANY UNDERGROUND UTILITIES, FOUNDATIONS OR SEALING ANY WALL, FLOOR OR ROOF PENETRATIONS FOR ENGINEERING REVIEW AND APPROVAL
- WHEN THE PROJECT SCOPE REQUIRES THE USE OF THE SAFETY CLIMB, THE GENERAL CONTRACTOR SHALL ENSURE THE SAFETY CLIMB IS FREE OF OBSTRUCTIONS, NOT RUBBING ON OR TRAPPED BY ANY INSTALLED CUSTOMER EQUIPMENT. IS VISUALLY TAUT, MEETS MANUFACTURER INSTALLATION SPECIFICATIONS, AND IS FIRMLY SECURED AT ALL CABLE GUIDE LOCATIONS UPON PROJECT COMPLETION.
- COMPLETION OF PROJECT SHALL NOT OBSTRUCT, TRAP, LOOSEN, OR OTHERWISE CAUSE FAILURE TO MEET MANUFACTURER INSTALLATION REQUIREMENTS FOR THE
- CONTRACTOR SHALL BE RESPONSIBLE FOR SITE SAFETY INCLUDING COMPLIANCE WITH ALL APPLICABLE OSHA STANDARDS AND RECOMMENDATIONS AND SHALL PROVIDE ALL NECESSARY SAFETY DEVICES INCLUDING PPE AND PPM AND CONSTRUCTION DEVICES SUCH AS WELDING AND FIRE PREVENTION, TEMPORARY SHORING, SCAFFOLDING, TRENCH BOXES/SLOPING, BARRIERS, ETC.
- THE CONTRACTOR SHALL PROTECT AT HIS OWN EXPENSE. ALL EXISTING FACILITIES AND SUCH OF HIS NEW WORK LIABLE TO INJURY DURING THE CONSTRUCTION PERIOD. ANY DAMAGE CAUSED BY NEGLECT ON THE PART OF THIS CONTRACTOR OR HIS REPRESENTATIVES, OR BY THE ELEMENTS DUE TO NEGLECT ON THE PART OF THIS CONTRACTOR OR HIS REPRESENTATIVES, EITHER TO THE EXISTING WORK, OR TO HIS WORK OR THE WORK OF ANY OTHER CONTRACTOR, SHALL BE REPAIRED AT HIS EXPENSE TO THE OWNER'S SATISFACTION
- ALL WORK SHALL BE INSTALLED IN A FIRST CLASS, NEAT AND WORKMANLIKE MANNER BY MECHANICS SKILLED IN THE TRADE INVOLVED. THE QUALITY OF WORKMANSHIP SHALL BE SUBJECT TO THE APPROVAL OF THE WISPER ISP, LLC REP. ANY WORK FOUND BY THE WISPER ISP, LLC REP TO BE OF INFERIOR QUALITY AND/OR WORKMANSHIP SHALL BE REPLACED AND/OR REWORKED AT CONTRACTOR EXPENSE UNTIL APPROVAL
- 33. IN ORDER TO ESTABLISH STANDARDS OF QUALITY AND PERFORMANCE, ALL TYPES OF MATERIALS LISTED HEREINAFTER BY MANUFACTURER'S NAMES AND/OR
 MANUFACTURER'S CATALOG NUMBER SHALL BE PROVIDED BY THESE MANUFACTURERS AS SPECIFIED
- WISPER ISP, LLC FURNISHED EQUIPMENT SHALL BE PICKED-UP AT THE WISPER ISP, LLC WAREHOUSE, NO LATER THAN 48HR AFTER BEING NOTIFIED INSURED, STORED, UNCRATE, PROTECTED AND INSTALLED BY THE CONTRACTOR WITH ALL APPURTENANCES REQUIRED TO PLACE THE EQUIPMENT IN OPERATION, READY FOR USE. THE CONTRACTOR SHALL BE RESPONSIBLE FOR THE EQUIPMENT AFTER PICKING IT
- WISPER ISP, LLC OR HIS ARCHITECT/ENGINEER RESERVES THE RIGHT TO REJECT ANY EQUIPMENT OR MATERIALS WHICH, IN HIS OWN OPINION ARE NOT IN COMPLIANCE WITH THE CONTRACT DOCUMENTS, EITHER BEFORE OR AFTER INSTALLATION AND THE FOLIPMENT SHALL BE REPLACED WITH FOLIPMENT CONFORMING TO THE REQUIREMENTS OF THE CONTRACT DOCUMENTS BY THE CONTRACTOR AT NO COST TO WISPER ISP, LLC OR THEIR ARCHITECT/ENGINEER.

STRUCTURAL STEEL NOTES:

- STRUCTURAL STEEL SHALL CONFORM TO THE LATEST EDITION OF THE AISC SPECIFICATION FOR THE DESIGN, FABRICATION AND ERECTION OF STRUCTURAL STEEL
- STRUCTURAL STEEL ROLLED SHAPES, PLATES AND BARS SHALL CONFORM TO THE
 - A. ASTM A-572, GRADE 50 ALL W SHAPES, UNLESS NOTED OR A992 OTHERWISE
 - B. ASTM A-36 ALL OTHER ROLLED SHAPES, PLATES AND BARS UNLESS NOTED
 - C. ASTM A-500, GRADE B HSS SECTION (SQUARE, RECTANGULAR, AND ROUND)
 - D. ASTM A-325, TYPE SC OR N ALL BOLTS FOR CONNECTING STRUCTURAL
 - E. ASTM F-1554 07 ALL ANCHOR BOLTS, UNLESS NOTED OTHERWISE
- ALL EXPOSED STRUCTURAL STEEL MEMBERS SHALL BE HOT-DIPPED GALVANIZED AFTER FABRICATION PER ASTM A123. EXPOSED STEEL HARDWARE AND ANCHOR BOLTS SHALL BE GALVANIZED PER ASTM A153 OR B695
- ALL FIELD CUT SURFACES, FIELD DRILLED HOLES AND GROUND SURFACES WHERE

EXISTING PAINT OR GALVANIZATION REMOVAL WAS REQUIRED SHALL BE REPAIRED WITH 4. (2) BRUSHED COATS OF ZRC GALVILITE COLD GALVANIZING COMPOUND PER ASTM A780

- DO NOT DRILL HOLES THROUGH STRUCTURAL STEEL MEMBERS EXCEPT AS SHOWN AND DETAILED ON STRUCTURAL DRAWINGS.
- CONNECTIONS:
 - A. ALL WELDING TO BE PERFORMED BY AWS CERTIFIED WELDERS AND CONDUCTED IN ACCORDANCE WITH THE LATEST EDITION OF THE AWS WELDING CODE D1.1.
 - B. ALL WELDS SHALL BE INSPECTED VISUALLY, 25% OF WELDS SHALL BE ACCEPTANCE CRITERIA OF AWS D1.1. REPAIR ALL WELDS AS NECESSARY
 - C. INSPECTION SHALL BE PERFORMED BY AN AWS CERTIFIED WELD INSPECTOR.
 - D. IT IS THE CONTRACTORS RESPONSIBILITY TO PROVIDE BURNING/WELDING PERMITS AS REQUIRED BY LOCAL GOVERNING AUTHORITY AND IF REQUIRED SHALL HAVE FIRE DEPARTMENT DETAIL FOR ANY WELDING ACTIVITY.
 - E. ALL ELECTRODES TO BE LOW HYDROGEN, MATCHING FILLER METAL, PER AWS
 - MINIMUM WELD SIZE TO BE 0.1875 INCH FILLET WELDS, UNLESS NOTED
 - G. PRIOR TO FIELD WELDING GALVANIZING MATERIAL, CONTRACTOR SHALL GRIND OFF GALVANIZING % BEYOND ALL FIELD WELD SURFACES. AFTER WELD AND WELD INSPECTION IS COMPLETE, REPAIR ALL GROUND AND WELDED SURFACES 10. WITH ZRC GALVILITE COLD GALVANIZING COMPOUND PER ASTM A780 AND MANUFACTURERS RECOMMENDATIONS.
 - THE CONTRACTOR SHALL PROVIDE ADEQUATE SHORING AND/OR BRACING WHERE REQUIRED DURING CONSTRUCTION UNTIL ALL CONNECTIONS ARE
 - ANY FIELD CHANGES OR SUBSTITUTIONS SHALL HAVE PRIOR APPROVAL FROM THE ENGINEER, AND WISPER ISP, LLC PROJECT MANAGER IN WRITING

SPECIAL CONSTRUCTION ANTENNA INSTALLATION NOTES:

- - ANTENNA AND COAXIAL CABLES ARE FURNISHED BY WISPER ISP. LLC UNDER A SEPARATE CONTRACT. THE CONTRACTOR SHALL ASSIST ANTENNA INSTALLATION CONTRACTOR IN TERMS OF COORDINATION AND SITE ACCESS. ERECTION SUBCONTRACTOR SHALL BE RESPONSIBLE FOR THE PROTECTION OF
 - B. INSTALL ANTENNAS AS INDICATED ON DRAWINGS AND WISPER ISP, LLC
 - C. INSTALL GALVANIZED STEEL ANTENNA MOUNTS AS INDICATED ON DRAWINGS.
 - D. INSTALL FURNISHED GALVANIZED STEEL OR ALUMINUM WAVEGUIDE AND PROVIDE PRINTOUT OF THAT TEST.
 - E. CONTRACTOR SHALL PROVIDE FOUR (4) SETS OF SWEEP TESTS USING ANRITZU-PACKARD 8713B RF SCALAR NETWORK ANALYZER. SUBMIT FREQUENCY DOMAIN REFLECTOMETER(FDR) TESTS RESULTS TO THE PROJECT MANAGER. SWEEP TESTS SHALL BE AS PER ATTACHED RFS "MINIMUM FIELD TESTING RECOMMENDED FOR ANTENNA AND HELIAX COAXIAL CABLE SYSTEMS" DATED 10/5/93 TESTING SHALL BE PERFORMED BY AN INDEPENDENT TESTING SERVICE AND BE BOUND AND SUBMITTED WITHIN ONE WEEK OF WORK COMPLETION.
 - F. INSTALL COAXIAL CABLES AND TERMINATING BETWEEN ANTENNAS AND EQUIPMENT PER MANUFACTURER'S RECOMMENDATIONS. WEATHERPROOF ALL CONNECTIONS RETWEEN THE ANTENNA AND FOLIPMENT PER MANUFACTURER'S REQUIREMENTS. TERMINATE ALL COAXIAL CABLE THREE (3) FEET IN EXCESS OF ENTRY PORT LOCATION UNLESS OTHERWISE STATED.
 - G. ANTENNA AND COAXIAL CABLE GROUNDING:
- ALL EXTERIOR #6 GREEN GROUND WIRE "DAISY CHAIN" CONNECTIONS ARE TO BE VEATHER SEALED WITH RFS CONNECTORS/SPLICE WEATHERPROOFING KIT #221213 OR
- ALL COAXIAL CABLE GROUNDING KITS ARE TO BE INSTALLED ON STRAIGHT RUNS OF COAXIAL CABLE (NOT WITHIN BENDS)

CONCRETE AND REINFORCING STEEL NOTES:

- LATEST EDITIONS OF ALL APPLICABLE CODES INCLUDING: ACI 301 "SPECIFICATIONS FOR STRUCTURAL CONCRETE FOR BUILDINGS", ACI 117 "SPECIFICATIONS FOR TOLERANCES FOR CONCRETE CONSTRUCTION AND MATERIALS", AND ACI 318 "BUILDING CODE REQUIREMENTS FOR REINFORCED CONCRETE "
- MIX DESIGN SHALL BE APPROVED BY WISPER ISP, LLC REP PRIOR TO PLACING
- CONCRETE SHALL BE NORMAL WEIGHT, 6 % AIR ENTRAINED (+/- 1.5%) WITH A SLUMF RANGE OF 3-6" AND HAVE A MINIMUM 28-DAY COMPRESSIVE STRENGTH OF 4500 PSI

THE FOLLOWING MATERIALS SHALL BE USED:

PORTLAND CEMENT: ASTM C150, TYPE 2

REINFORCEMENT: ASTM A185, PLAIN STEEL WELDED WIRE FABRIC

REINFORCEMENT BARS ASTM A615, GRADE 60, DEFORMED

NORMAL WEIGHT AGGREGATE: ASTM C33

WATER: ASTM C 94/C 94M WELDED WIRE FABRIC: ASTM A185

ADMIXTURES: -WATER-REDUCING AGENT: ASTM C 494/C 494M, TYPE A

-AIR-ENTERING AGENT: ASTM C 260/C 260M -SUPERPLASTICIZER: ASTM C494. TYPE F OR TYPE G -RETARDING: ASTM C 494/C 494M, TYPE B

- MINIMUM CONCRETE COVER FOR REINFORCING STEEL SHALL BE NO LESS THAN 3".
- A 3/4" CHAMFER SHALL BE PROVIDED AT ALL EXPOSED EDGES OF CONCRETE IN ACCORDANCE WITH ACI 301 SECTION 4.2.4, UNLESS NOTED OTHERV
- INSTALLATION OF CONCRETE EXPANSION/WEDGE ANCHOR SHALL BE PER MANUFACTURER'S WRITTEN RECOMMENDED PROCEDURE. THE ANCHOR BOLT, DOWEL OR ROD SHALL CONFORM TO MANUFACTURER'S RECOMMENDATION FOR EMBEDMEN
 DEPTH OR AS SHOWN ON THE DRAWINGS. NO REBAR SHALL BE CUT WITHOUT PRIOR APPROVAL FROM AN ATC ENGINEER WHEN DRILLING HOLES IN CONCRETE
- ADMIXTURES SHALL CONFORM TO THE APPROPRIATE ASTM STANDARD AS REFERENCED
- DO NOT WELD OR TACK WELD REINFORCING STEEL.
- ALL DOWELS, ANCHOR BOLTS, EMBEDDED STEEL, ELECTRICAL CONDUITS, PIPE SLEEVES, GROUNDS AND ALL OTHER EMBEDDED ITEMS AND FORMED DETAILS SHALL BE IN PLACE BEFORE START OF CONCRETE PLACEMENT.
- REINFORCEMENT SHALL BE COLD BENT WHENEVER BENDING IS REQUIRED.
- 12. DO NOT PLACE CONCRETE IN WATER, ICE, OR ON FROZEN GROUND.
- FOR COLD-WEATHER (ACI 306) AND HOT-WEATHER (ACI 301M) CONCRETE PLACEMENT. CONFORM TO APPLICABLE ACI CODES AND RECOMMENDATIONS. IN EITHER CASE. MATERIALS CONTAINING CHLORIDE, CALCIUM, SALTS, ETC. SHALL NOT BE USED. PROTECT FRESH CONCRETE FROM WEATHER FOR 7 DAYS, MINIMUM
- 14. ALL CONCRETE SHALL HAVE A "SMOOTH FORM FINISH."
- SPLICING OF REINFORCEMENT IS PERMITTED ONLY AT LOCATIONS SHOWN IN THE CONTRACT DRAWINGS OR AS ACCEPTED BY THE ENGINEER. UNLESS OTHER SHOWN OR NOTED REINFORCING STEEL SHALL BE SPLICED TO DEVELOP ITS FULL TENSILE CAPACITY (CLASS A) IN ACCORDANCE WITH ACI 318
- DETAILING OF REINFORCING STEEL SHALL CONFORM TO "ACI MANUAL OF STANDARD PRACTICE FOR DETAILING REINFORCED CONCRETE STRUCTURES" (ACI 315)
- ALL SLAB CONSTRUCTION SHALL BE CAST MONOLITHICALLY WITHOUT HORIZONTAL CONSTRUCTION JOINTS, UNLESS SHOWN IN THE CONTRACT DRAWINGS
- LOCATION OF ALL CONSTRUCTION JOINTS ARE SUBJECT TO THE REQUIREMENTS OF THE CONTRACT DOCUMENTS, CONFORMANCE WITH ACI 318, AND ACCEPTANCE OF THE ENGINEER, DRAWINGS SHOWING LOCATION OF DETAILS OF THE PROPOSED CONSTRUCTION JOINTS SHALL BE SUBMITTED WITH REINFORCING STEEL PLACEMENT
- SPLICES OF WWF, AT ALL SPLICED EDGES, SHALL BE SUCH THAT THE OVERLAP MEASURED BETWEEN OUTERMOST CROSS WIRES OF EACH FABRIC SHEET IS NOT LESS THAN THE SPACING OF THE CROSS WIRE PLUS 2 INCHES, NOR LESS THAN 6".
- BAR SUPPORTS SHALL BE ALL-GALVANIZED METAL WITH PLASTIC TIPS.
- ALL REINFORCEMENT SHALL BE SECURELY TIED IN PLACE TO PREVENT DISPLACEMENT BY CONSTRUCTION TRAFFIC OR CONCRETE. TIE WIRE SHALL BE OF SUFFICIENT STRENGTH FOR INTENDED PURPOSE, BUT NOT LESS THAN NO. 18 GAUGE.
- SLAB ON GROUND: COMPACT STRUCTURAL FILL TO 95% DENSITY AND THEN PLACE 6" GRAVEL BENEATH SLAB.

ELECTRICAL NOTES:

- ELECTRICAL WORK SHALL BE PERFORMED BY ELECTRICAL CONTRACTOR. ELECTRICAL CONTRACTOR SHALL ENSURE THAT ALL WORK COMPLIES WITH ALL APPLICABLE LOCAL AND STATE CODES AND NATIONAL ELECTRICAL CODE.
- ALL SUGGESTED ELECTRICAL ELEMENTS (SUCH AS BREAKER SIZES, WIRE SIZES, CONDUITS SIZES) ARE FOR ZONING PURPOSES ONLY. IT IS THE RESPONSIBILITY TO OF THE ELECTRICAL CONTRACTOR TO CONFIRM COMPLIANCE WITH LOCAL ELECTRICAL CODES AND PASS ALL APPLICABLE AND NECESSARY INSPECTIONS. IN SOME EVENTS, IT MAY BE NECESSARY TO PERFORM AN ELECTRICAL LOAD STUDY TO VERIFY THE CAPACITY OF THE EXISTING SERVICE. THIS IS NOT THE RESPONSIBILITY OF ATC. IT IS THE RESPONSIBILITY OF THE ELECTRICAL CONTRACTOR.
- CONTRACTOR SHALL FIELD LOCATE ALL BELOW GRADE GROUNDING CABLES AND UTILITY LINES PRIOR TO CONSTRUCTION. CONTRACTOR IS RESPONSIBLE FOR RELOCATION OF ALL UTILITIES AND GROUNDING LINES THAT MAY BECOME DISTURBED OR CONFLICTING IN THE COURSE OF CONSTRUCTION.

ALL DISCREPANCIES FROM WHAT IS SHOWN ON THESE CONSTRUCTION DRAWINGS SHALL BE COMMUNICATED TO ATC ENGINEERING IMMEDIATELY FOR CORRECTION OR RE-DESIGN. FAILURE TO COMMUNICATE DIRECTLY WITH ATC ENGINEERING OR ANY CHANGES FROM THE DESIGN CONDUCTED WITHOUT PRIOR APPROVAL FROM ATC ENGINEERING SHALL BE THE SOLE RESPONSIBILITY OF THE GENERAL CONTRACTOR.



ATC TOWER SERVICES LLC 3500 REGENCY PARKWAY SUITE 100 **CARY. NC 27518** PHONE: (919) 468-0112 2015011232

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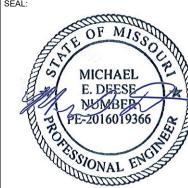
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ATC SITE NUMBER: 306030

ATC SITE NAME: **LEES SUMMIT**

WISPER ISP SITE NAME: **JCKSMOAJ**

SITE ADDRESS 111 SW HOOK ROAD LEES SUMMIT. MO 64082



Digitally Signed: 2024-07-01



ATC JOB NO: 14536934 D2 CUSTOMER ID: LICKSMOAJ CUSTOMER #: | JCKSMOAJ

GENERAL NOTES

SHEET NUMBER:

G-002

SITE PLAN NOTES:


- THIS SITE PLAN REPRESENTS THE BEST PRESENT KNOWLEDGE AVAILABLE TO THE ENGINEER AT THE TIME OF THIS DESIGN. THE CONTRACTOR SHALL VISIT THE SITE PRIOR TO CONSTRUCTION AND VERIFY ALL EXISTING CONDITIONS RELATED TO THE SCOPE OF WORK FOR THIS PROJECT.
- ICE BRIDGE, CABLE LADDER, COAX PORT, AND COAX CABLE ARE SHOWN FOR REFERENCE ONLY. CONTRACTOR SHALL CONFIRM THE EXACT LOCATION OF ALL PROPOSED AND EXISTING **EQUIPMENT AND STRUCTURES DEPICTED ON** THIS PLAN. BEFORE UTILIZING EXISTING CABLE SUPPORTS, COAX PORTS, INSTALLING NEW PORTS OR ANY OTHER EQUIPMENT, CONTRACTOR SHALL VERIFY ALL ASPECTS OF THE COMPONENTS MEET THE ATC SPECIFICATIONS
- IT IS THE RESPONSIBILITY OF THE CONTRACTOR TO COORDINATE WITH THE WISPER ISP, LLC REPRESENTATIVE AND LOCAL UTILITY COMPANY FOR THE INSTALLATION OF CONDUITS, CONDUCTORS, BREAKERS, DISCONNECTS, OR ANY OTHER EQUIPMENT REQUIRED FOR ELECTRICAL SERVICE. ALL ELECTRICAL WORK SHALL BE PERFORMED IN ACCORDANCE WITH LATEST EDITION OF THE STATE AND NATIONAL CODES, ORDINANCES AND REGULATIONS APPLICABLE TO THIS PROJECT

LEGEND

GROUNDING TEST WELL AUTOMATIC TRANSFER SWITCH ATS BOLLARD CELL SITE CABINET CSC DISCONNECT ELECTRICAL FIBER GEN **GENERATOR** GENERATOR RECEPTACLE HH, V HAND HOLE, VAULT ICE BRIDGE KENTROX BOX LIGHTING CONTROL LC METER ΡВ PULL BOX POWER POLE TELCO TRN TRANSFORMER CHAINLINK FENCE

PROPOSED CABLE NOTES:

- ESTIMATED LENGTH OF PROPOSED CABLE IS <u>323</u>'. ESTIMATED LENGTH OF CABLE WAS PROVIDED BY CUSTOMER OR CALCULATED BY ADDING THE RAD CENTER AND THE DISTANCE FROM THE SHELTER ENTRY PLATE TO THE TOWER (ALONG THE ICE BRIDGE) AND A SAFETY FACTOR MEASUREMENT OF 15% (OF THE TWO PREVIOUS VALUES), CDS DEFER TO GREATEST CABLE LENGTH.
- ROUTE PROPOSED CABLES ALONG SAME PATH AS EXISTING CABLES AND IN ACCORDANCE WITH STRUCTURAL ANALYSIS. WHERE POSSIBLE UTILIZE EXISTING CABLE SUPPORT STRUCTURES AS PROVIDED FOR CARRIER TO ADEQUATELY SECURE CABLES, USING EITHER APPROPRIATELY SIZED STAINLESS STEEL SNAP-INS OR MOUNTING HARDWARE AND BRACKETS AS SPECIFIED BY CABLE MANUFACTURER. OTHERWISE, ATTACH CABLES TO HORIZONTAL OR DIAGONAL TOWER MEMBERS USING PROPOSED STAINLESS STEEL ADAPTERS (DO NOT ATTACH TO TOWER LEG)

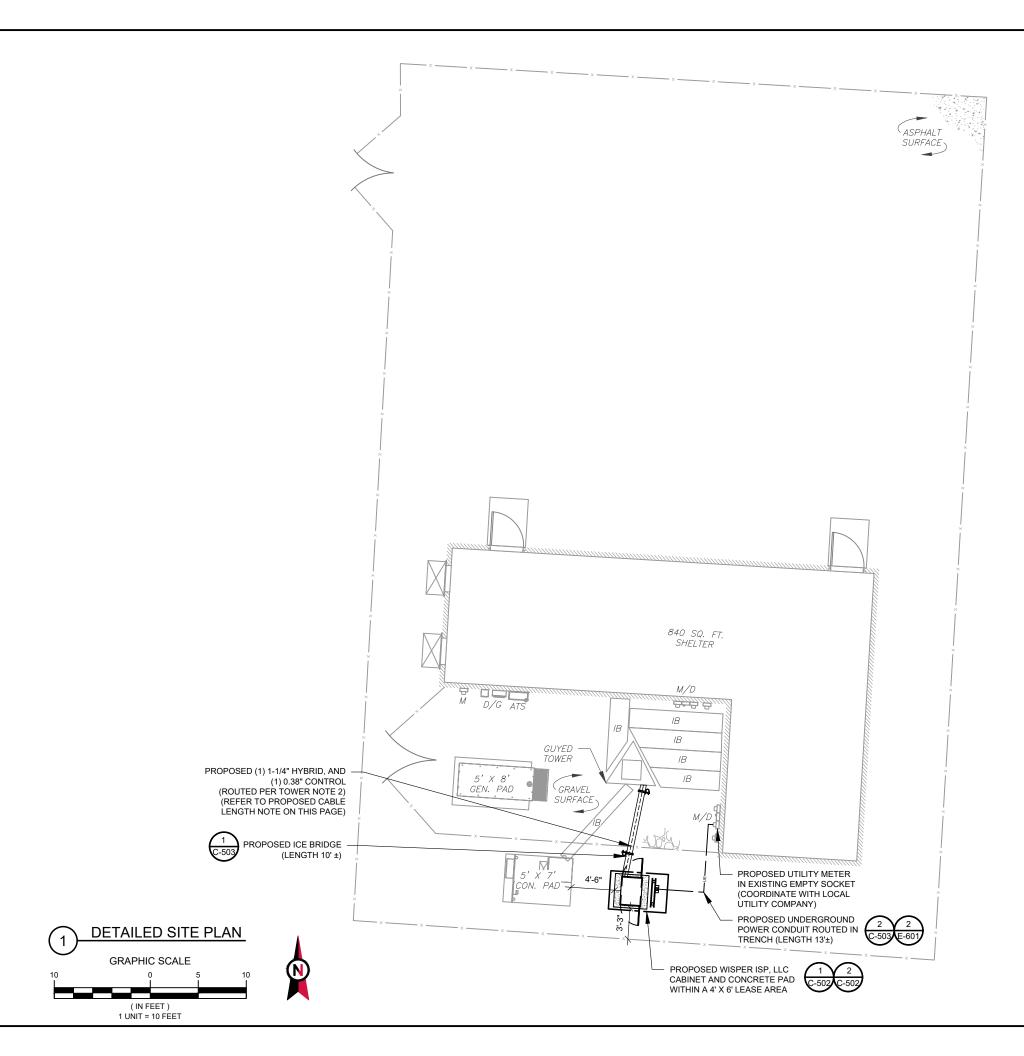



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ATC SITE NUMBER: 306030

ATC SITE NAME: LEES SUMMIT

WISPER ISP SITE NAME:

JCKSMOAJ

SITE ADDRESS: 111 SW HOOK ROAD LEES SUMMIT. MO 64082



Digitally Signed: 2024-07-01




ATC JOB NO: CUSTOMER ID: JCKSMOAJ

CUSTOMER #: JCKSMOAJ

DETAILED SITE PLAN

SHEET NUMBER:

C-101

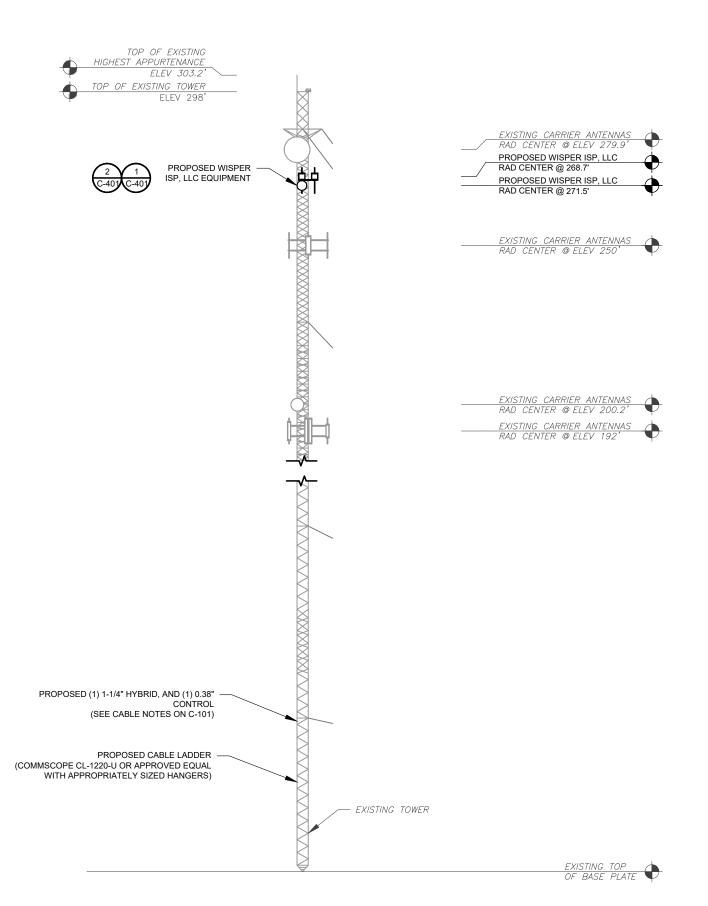



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IT IS THE CONTRACTOR'S RESPONSIBILITY TO CONFIRM WITH THE PROJECT MANAGER THAT THEY HAVE THE MOST RECENT VERSION OF THE

STRUCTURAL ANALYSIS BEFORE COMMENCING

PAINTED/SOCKED TO MATCH EXISTING EQUIPMENT IN ACCORDANCE WITH FAA, JURISDICTION, AND/OR

PROVIDED FOR CARRIER TO ADEQUATELY SECURE

3. ROUTE PROPOSED CABLES ALONG SAME PATH AS EXISTING CABLES AND IN ACCORDANCE WITH STRUCTURAL ANALYSIS. WHERE POSSIBLE UTILIZE

EXISTING CABLE SUPPORT STRUCTURES AS

CABLES, USING EITHER APPROPRIATELY SIZED STAINLESS STEEL SNAP-INS OR MOUNTING HARDWARE AND BRACKETS AS SPECIFIED BY CABLE MANUFACTURER. OTHERWISE, ATTACH

CABLES TO HORIZONTAL OR DIAGONAL TOWER

MEMBERS USING PROPOSED STAINLESS STEEL

ANALYSIS. ELEVATIONS DO NOT REFLECT TRUE

TOWER ELEVATION DEPICTION MAY NOT REFLECT ALL EQUIPMENT INCLUDED IN STRUCTURAL

ANALYSIS. REFER TO STRUCTURAL ANALYSIS FOR

ADAPTERS (DO NOT ATTACH TO TOWER LEG). TOWER ELEVATIONS ARE MEASURED FROM TOP OF BASE PLATE TO MATCH STRUCTURAL

WORK. EXISTING AND PROPOSED TOWER APPURTENANCES, MOUNTS, AND ANTENNAS ARE SHOWN BASED ON THE STRUCTURAL ANALYSIS. 2. WHERE APPLICABLE, ALL NEW ANTENNAS, EQUIPMENT, MOUNTS, CABLING, ETC. SHALL BE

OTHER LOCAL REQUIREMENTS.

ABOVE GROUND LEVEL (A.G.L.)

FULL TOWER LOADING.



Digitally Signed: 2024-07-01

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ATC JOB NO: 14536934_D2 CUSTOMER ID: JCKSMOAJ

CUSTOMER #: JCKSMOAJ


TOWER ELEVATION

SHEET NUMBER:

C-201


REVISION:

TOWER ELEVATION

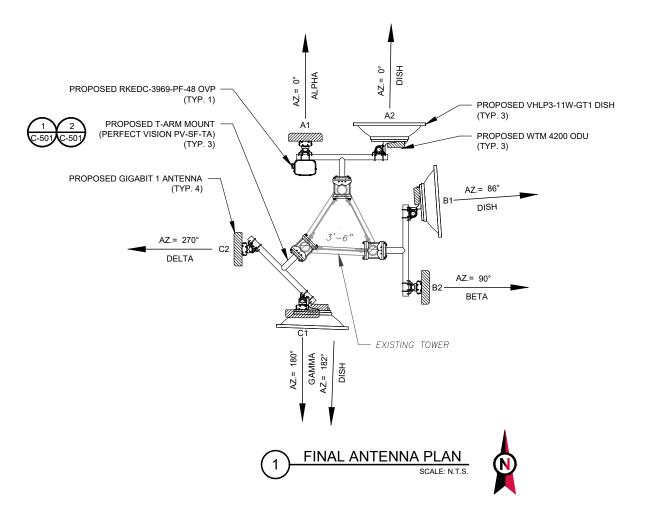

| | FINAL ANTENNA/ COAX SCHEDULE | | | | | | |
|--------|------------------------------|----------------------------|--------------|------------------|--------------|------------------------------------|------------------------------|
| SECTOR | ANT. | MODEL# | MOUNT HEIGHT | RAD CENTER | AZIMUTH | ADDITIONAL TOWER MOUNTED EQUIPMENT | CABLE DESCRIPTION |
| ALPHA | A1 | GIGABIT 1 | | 271.5' | 0° | - | |
| ALPHA | A2 | VHLP3-11W-GT1 | | 271.5' | 0° | WTM 4200 | |
| BETA | B1 | VHLP3-11W-GT1 | | 271.5' | 86° | WTM 4200 | (1) 1-1/4" HYBRID, AND |
| BETA | B2 | GIGABIT 1 | 270' | 271.5' | 90° | - | (1) 0.38" CONTROL (323'±) |
| GAMMA | C1 | GIGABIT 1 VHLP3-11W-GT1 | | 271.5' 268.7' | 180° 182° | WTM 4200 | |
| GAMMA | C2 | GIGABIT 1 | | 271.5' | 270° | - | |

- 1. CONFIRM WITH CARRIER REP FOR APPLICABLE UPDATES/REVISIONS AND MOST RECENT RFDS.
- 2. ALL PROPOSED EQUIPMENT INCLUDING ANTENNAS, COAX, ETC. SHALL BE MOUNTED IN ACCORDANCE WITH THE TOWER STRUCTURAL ANALYSIS ON FILE WITH THE ATC CM.
- 3. SPACING OF PROPOSED EQUIPMENT SHALL BE CONFIRMED FOR TOWER CONFLICTS AND PROPOSED MOUNTS SHALL NOT IMPEDE TOWER CLIMBING PEGS.
- 4. INSTALL (1) RKEDC-3969-PF-48 OVP.

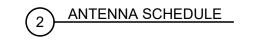



ATC TOWER SERVICES LLC

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ATC SITE NUMBER: 306030

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JCKSMOAJ

SITE ADDRESS: 111 SW HOOK ROAD LEES SUMMIT, MO 64082

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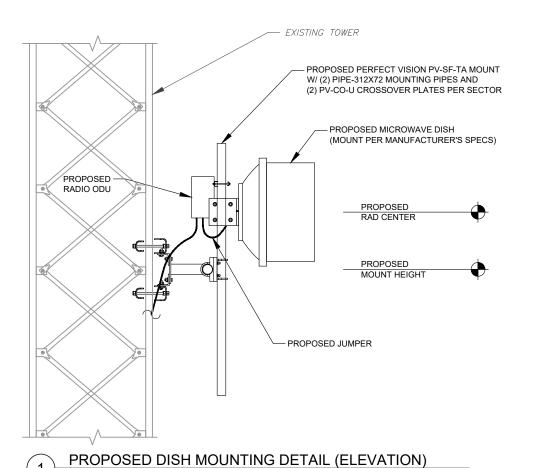
ATC JOB NO: 14536934_D2
CUSTOMER ID: JCKSMOAJ
CUSTOMER #: JCKSMOAJ

ANTENNA INFORMATION & SCHEDULE

SHEET NUMBER:


C-401

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EXISTING TOWER - PROPOSED PERFECT VISION PV-SF-TA MOUNT W/ (2) PIPE-312X72 MOUNTING PIPES AND (2) PV-CO-U CROSSOVER PLATES PER SECTOR - PROPOSED ANTENNA (MOUNT PER MANUFACTURER'S SPECS) PROPOSED RAD CENTER PROPOSED MOUNT HEIGHT PROPOSED JUMPER

PROPOSED ANTENNA MOUNTING DETAIL (ELEVATION)



PROPOSED ANTENNA/DISH MOUNTING DETAIL (ELEVATION)

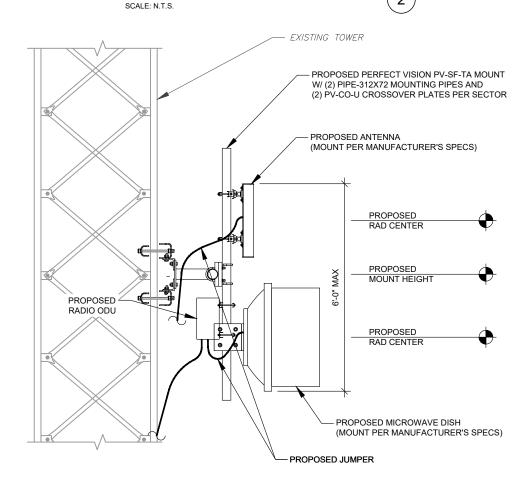

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ATC JOB NO: CUSTOMER ID: JCKSMOAJ


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CUSTOMER #: JCKSMOAJ

CONSTRUCTION DETAILS

C-501


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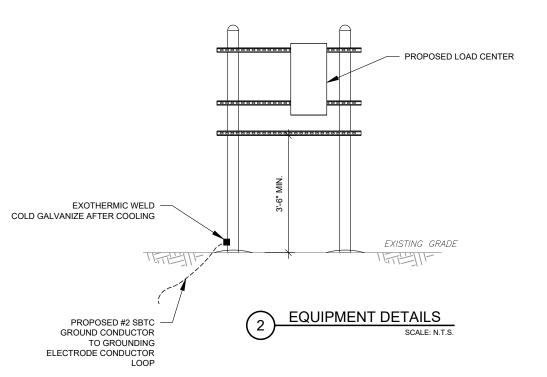


H-FRAME NOTES:

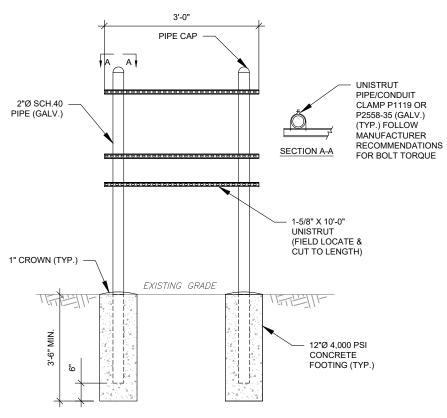- IF IT IS NECESSARY TO EXTEND THE H-FRAME, AN ADDITIONAL POST WILL ALWAYS BE REQUIRED.
- PROPOSED UNISTRUTS TO BE FIELD CUT AND SHOULD NOT EXTEND MORE THAN 6 INCHES BEYOND THE LAST POST.
- SPRAY ENDS OF UNISTRUT WITH COLD GALVANIZING SPRAY PAINT, ALLOW TO DRY, THEN COVER WITH RUBBER PROTECTIVE CAPS FOR SAFETY.
- UNISTRUT TO BE CUT FLUSH WITH NO SHARP OR JAGGED EDGES.
- ALL PROPOSED HARDWARE TO BE MOUNTED PER MANUFACTURERS SPECS.





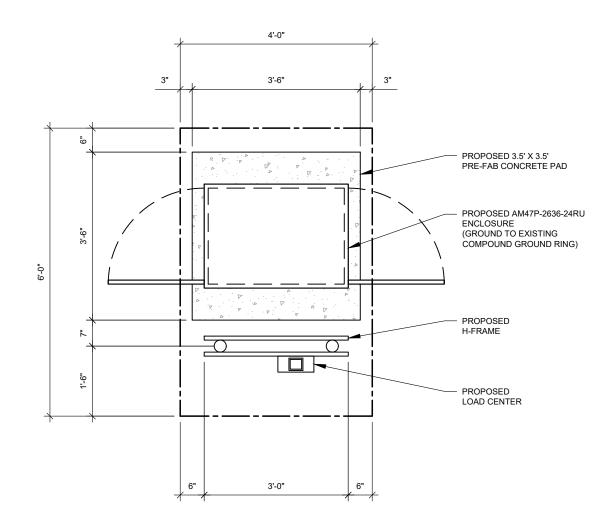



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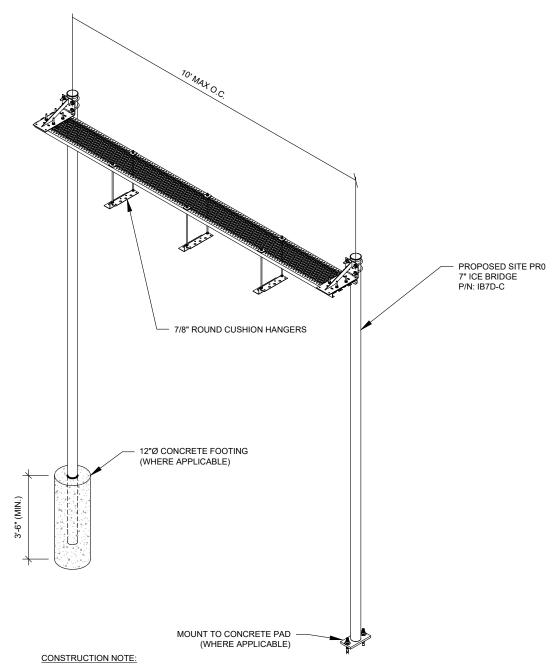
ATC JOB NO: 14536934_D2 CUSTOMER ID: JCKSMOAJ

CUSTOMER #: JCKSMOAJ **CONSTRUCTION**

DETAILS


SHEET NUMBER:

C-502




1. INSTALL ICE BRIDGE TO ALLOW 7 FEET CLEARANCE ABOVE GRADE TO LOWEST APPURTENANCE.

(1) WAVEGUIDE BRIDGE KIT SCALE: N.T.S.

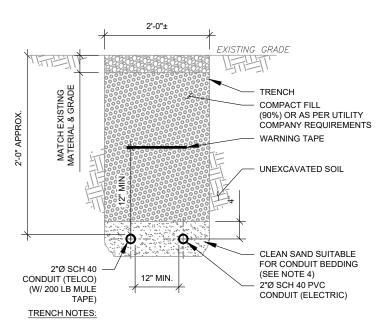

- IF FREE OF ORGANIC OR OTHER DELETERIOUS MATERIAL, EXCAVATED MATERIAL MAY BE USED FOR BACKFILL.
- IF NOT, PROVIDE CLEAN, COMPACTIBLE MATERIAL. COMPACT IN 8" LIFTS. REMOVE ANY LARGE ROCKS PRIOR TO BACKFILLING. CONTRACTOR TO VERIFY LOCATION OF EXISTING U/G UTILITIES PRIOR TO DIGGING.
- 3. IF CURRENT AS-BUILT DRAWINGS ARE NOT AVAILABLE CONTRACTOR SHALL HAND DIG U/G TRENCHING.
- 4. CONCRETE ENCASE CONDUIT WHEN TRENCHING UNDER SITE ACCESS ROAD.

2 TELCO AND POWER CONDUIT JOINT TRENCH SCALE: N.T.S.

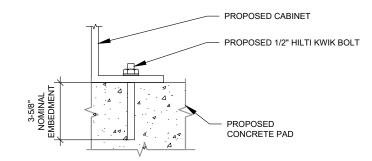

NOTE:

INSTALL HILTI KWIK BOLT ANCHORS STRICTLY PER INSTALLATION INSTRUCTIONS INCLUDED WITH PRODUCT OR FOUND ONLINE AT WWW.US.HILTI.COM. PROPER INSTALLATION IS CRITICAL FOR FULL PERFORMANCE.

CABINET ATTACHMENT DETAIL
SCALE: N.T.S.



ATC TOWER SERVICES LLC

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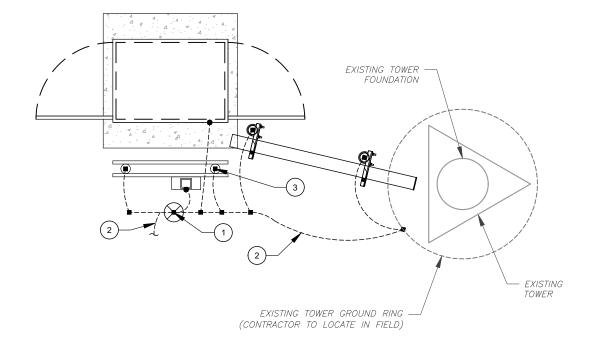
ATC JOB NO: 14536934_D2
CUSTOMER ID: JCKSMOAJ


CONSTRUCTION

DETAILS

SHEET NUMBER:

C-503



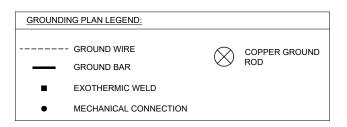

GROUNDING KEYED NOTES:

- (1) 5/8Ø" X 10 FT GROUND ROD.
- GROUNDING CONDUCTOR BETWEEN EXISTING GROUND RING AND CABINET GROUNDING LUG. EXOTHERMIC WELD TO EXISTING GROUND RING AND ATTACH TO CABINET WITH A MECHANICAL CONNECTION.
- #2 AWG SBTC BOND FROM ICE BRIDGE AND H-FRAME POSTS TO GROUNDING (TYP. EVERY POST).





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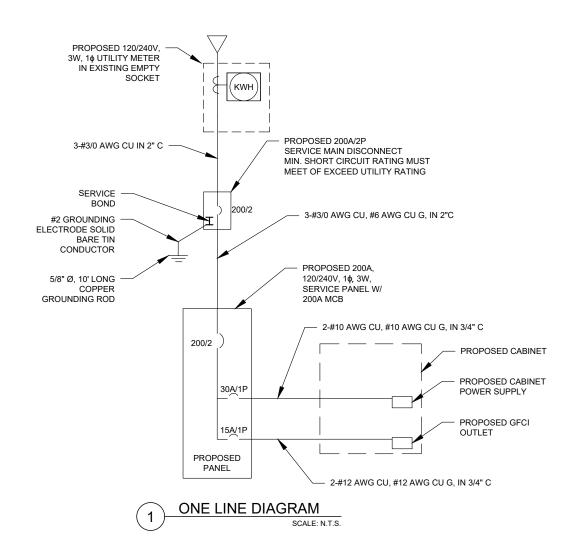
ATC JOB NO: 14536934_D2
CUSTOMER ID: JCKSMOAJ
CUSTOMER #: JCKSMOAJ

GROUNDING LAYOUT

SHEET NUMBER:

E-101

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1. ALL CONDUCTORS SHALL BE TYPE THWN AND RATED IN ACCORDANCE WITH NEC 110-14(C)

2. ALL UNDERGROUND CONDUITS SHALL BE PVC SCH40. ALL ABOVE GROUND CONDUITS SHALL BE RIGID METAL CONDUIT (RMC). TRANSITION FROM PVC SCH 40 TO RMC SHALL BE MADE UNDERGROUND WITH LISTED FITTINGS FOR THE APPLICATION.

- 3. ALL CIRCUIT BREAKERS, FUSES AND ELECTRICAL EQUIPMENT SHALL HAVE AN INTERRUPTING RATING NOT LESS THAN THE MAXIMUM INTERRUPTING CURRENT TO WHICH THEY MAY BE SUBJECTED.
- 4.THE ENTIRE ELECTRICAL INSTALLATION SHALL BE GROUNDED IN ACCORDANCE WITH THE NATIONAL ELECTRICAL CODE (NEC); ARTICLES 250, 280, AND THE UTILITY COMPANY STANDARDS.

| | T | W//0050 /00 | TYPE: | | LIGHTING | | | | _ | SYSTE | | (1.5) | 120/ | 240V, 19 | | CKT | _ | LOCATION: | WISPER ISP LEASE EC | UIPMEN | IT AREA |
|---------|---------|----------------------------|-----------|---------|----------|---------|----------|------|-------|---------|----------|-------|--------|----------|---------|-------|------|--------------|----------------------|--------|---------|
| DESIGNA | TION: _ | WISPER ISP | MOUNTING: | | | URFACI | | | _ | | REAKER | ` ' | | 20 | | | _ | | | | |
| İ | | | ENCLOSURE | | N | NEMA 3F | ₹ | | _ | MAIN B | US RATI | ۱G: | | 20 | 0A | | _ | PANEL NOTES: | PROPOSE | ED | |
| | | | | | | | | | - | MIN. A. | .C. RATI | NG: | | N. | /A | | - | | | | |
| CONNE | CTED | | | FE | EDER OF | R BRAN | CH CIRCL | JIT | | | | FE | EDER C | R BRAN | ICH CIR | CUIT | | | | CONN | IECTED |
| LOAD (| kVA) | BRIEF DESCRIPTION | BF | EAKER | | CIRCUI | Γ | POLE | CIRC. | | CIRC. | POLE | | CIRCUIT | | BRE. | AKER | BRIEF | DESCRIPTION | LOAD |) (kVA) |
| A | в | | AMF | S POLES | WIRE | GND | COND. | NO. | NOTES | | NOTES | NO. | COND. | GND | WIRE | POLES | AMPS | | | Α | В |
| 1.44 | | GFCI | 15 | 1 | 2-#12 | #12 | 3/4" | 1 | 1 | | | 2 | | | | | | | | 0.00 | |
| | 2.88 | CABINET | 30 | 1 | 2-#10 | #10 | 1/2" | 3 | 1 | | | 4 | | | | | | | | | 0.00 |
| 0.00 | | | | | | | | 5 | | | | 6 | | | | | | | | 0.00 | |
| | 0.00 | | | | | | | 7 | | | | 8 | | | | | | | | | 0.00 |
| 1.4 | 2.9 | | | | | | | | Α | В | TOT | AL | | | | | | | | 0.0 | 0.0 |
| | | | | | | | | | 1.4 | 2.9 | 4. | 3 | CONNE | CTED LC | DAD (kV | 4) | | | | | |
| | | | | | | | | | 1.4 | 2.9 | 4. | 3 | DEMAN | D LOAD | (kVA) | | | DI | ERATING FACTOR (80%) | | |
| - | CIRCUIT | <u>NOTES</u> ED CIRCUIT | | | | | | | | | | | | | | | | | DEMANDLOAD SIZING: | 23 | AMPS |

ELECTRICAL PANEL SCHEDULE



ATC TOWER SERVICES LLC

3500 REGENCY PARKWAY SUITE 100 **CARY, NC 27518** PHONE: (919) 468-0112 2015011232

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| | REV. | DESCRIPTION | BY | DATE |
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ATC SITE NUMBER: 306030

ATC SITE NAME: LEES SUMMIT

WISPER ISP SITE NAME:

JCKSMOAJ

SITE ADDRESS: 111 SW HOOK ROAD LEES SUMMIT, MO 64082



Digitally Signed: 2024-07-01




ATC JOB NO: 14536934_D2 CUSTOMER #: JCKSMOAJ

CUSTOMER ID: JCKSMOAJ

PANEL SCHEDULE & ONE-LINE DIAGRAM


SHEET NUMBER:

E-501

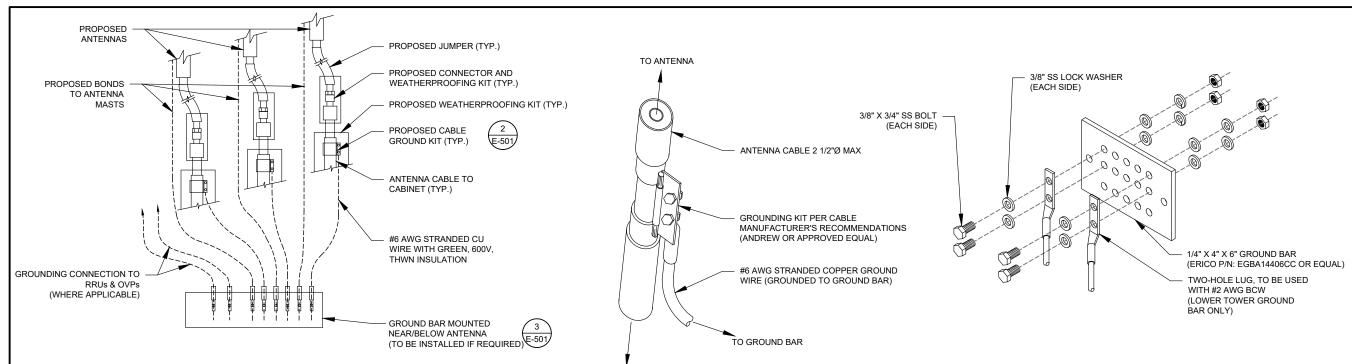

- 1. THIS DETAIL IS INTENDED TO SHOW THE GENERAL GROUNDING REQUIREMENTS. SLIGHT ADJUSTMENTS MAY BE REQUIRED BASED ON EXISTING SITE CONDITIONS. THE CONTRACTOR SHALL MAKE FIELD ADJUSTMENTS AS NEEDED AND INFORM THE CONSTRUCTION MANAGER OF ANY CONFLICTS.
- 2. SITE GROUNDING SHALL COMPLY WITH VERIZONGROUNDING STANDARDS, LATEST EDITION, AND COMPLY WITH VERIZONGROUNDING CHECKLIST, LATEST VERSION. WHEN NATIONAL AND LOCAL GROUNDING CODES ARE MORE STRINGENT THEY SHALL GOVERN.

TYPICAL ANTENNA GROUNDING DIAGRAM

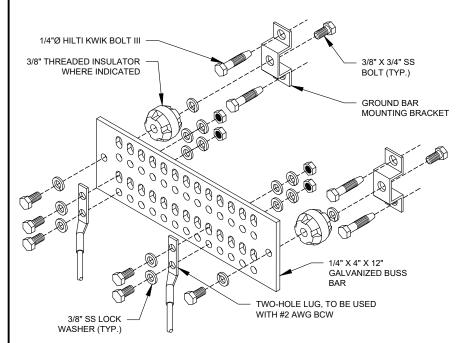

GROUND BAR NOTES

- GROUND KITS COME WITH ALL HARDWARE, NUTS, BOLTS, WASHERS, ETC. EXCEPT THE STRUCTURAL MOUNTING MEMBER(S).
- 2. GROUND BAR SHALL BE BOLTED TO STRUCTURAL MEMBER OR ANCHORED TO CONCRETE SLAB W/ HILTI KWIK BOLT III.

TO EQUIPMENT


- <u>GROUND KIT NOTES:</u>


 1. DO NOT INSTALL CABLE GROUND KIT AT A BEND AND ALWAYS DIRECT GROUND WIRE DOWN TO GROUND BAR.
- 2. CONTRACTOR SHALL PROVIDE WEATHERPROOFING KIT (ANDREW PART NUMBER 221213) AND INSTALL/TAPE PER MANUFACTURER'S SPECIFICATIONS

CABLE GROUND KIT CONNECTION DETAIL

NOTES:

- SEPARATION DIMENSION TO BE VERIFIED WITH LOCAL UTILITY COMPANY
- 2. COORDINATE UTILITY, LOCATE BEFORE DIGGING.
- CONDUIT TRENCHING DEPTHS AT 36" OR 6" BELOW FROST LINE, WHICHEVER IS GREATER.
- ALL RING AND RADIAL DEPTHS AT 30" OR 6" BELOW FROST LINE, WHICHEVER IS GREATER.

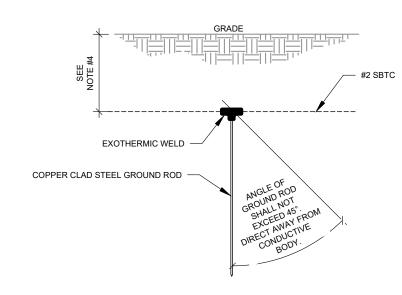

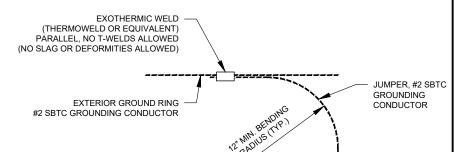

GROUND ROD DETAIL

TIE CONNECTION DETAIL

GROUND BAR NOTES:

- GROUND BAR KITS COME WITH ALL HARDWARE, NUTS, BOLTS, WASHERS, ETC. EXCEPT THE STRUCTURAL MOUNTING MEMBER(S).
- 2 GROUND BAR TO BE BONDED DIRECTLY TO TOWER





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14536934_D2 ATC JOB NO: CUSTOMER ID: JCKSMOAJ CUSTOMER #: JCKSMOAJ


GROUNDING DETAILS


SHEET NUMBER:

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REVISION

MAIN GROUND BAR DETAIL



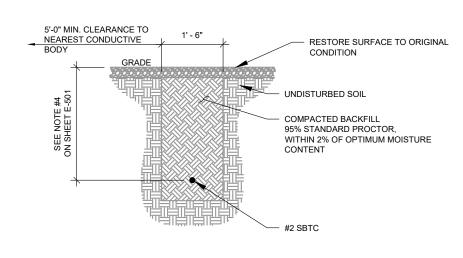

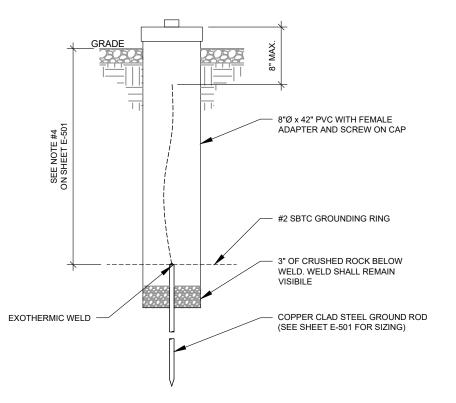1 GROUND CONNECTION TRENCH DETAIL (STD.)
SCALE: N.T.S

2 TEST WELL DETAIL SCALE: N.T.S.



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SEAL:



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ATC JOB NO: 14536934_D2
CUSTOMER ID: JCKSMOAJ
CUSTOMER #: JCKSMOAJ

GROUNDING DETAILS

SHEET NUMBER:

E-503

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