

1000 W Nifong Blvd., Bldg. 1 Columbia, Missouri 65203 (573) 447-0292

June 14, 2024

City of Lee's Summit Development Services 220 SE Green Street Lee's Summit, MO 64063

Re: Home2 Suites By Hilton - PL2024097 Response Letter

City reviewers,

This letter is in response to the Commercial Final Development Plan Applicant's Letter dated May 17, 2024. The engineering plans have been revised to address the comments. The original comments are below and follow the order as shown in the review comments. Our responses are in bold, and follow each individual comment.

Planning Review

1. MECHANICAL SCREENING. Dash in the RTUs on the architectural building elevations (Sheets A-202 and A-203) to verify compliance with the requirement that all RTUs are fully screened from view on all sides by the use of parapet walls of a height at least equal to the units being screened. Take into account the added height from the curbs on which the RTUs will sit.

Addressed in separate letter from Rosemann and Associates. FDP plan set includes street perspectives for mechanical screening. See attached at end of this response.

2. TRASH ENCLOSURE. Provide a detail of the proposed trash enclosure. Each trash enclosure shall be constructed of masonry walls or steel architecturally designed walls with either a solid steel opaque gate painted to be compatible with the color of the masonry or steel walls and building it is to serve or a steel framed semi-opaque gate with a screen mesh material approved by the Director that provides an appropriate visual barrier.

Trash enclosure is included with this plan set.

3. FAA FORM 7460. Due to the proximity of the proposed development to the airport, an FAA Form 7460 shall be completed and submitted to the FAA, and comments received back prior to the release of a building permit.

The FAA permit is currently being reviewed.

Engineering Review

1. Submit the proposed private waterline easement and public sanitary easement documents for review and approval. Please note that these easements must be in place prior to issuance of any permit.

It's our understanding that our client's attorney and the City's attorney are working together to determine the best way to cover utilities, by easements or other methods.

2. Show proposed private waterline easement and all the water main connection locations and type, including valves and restraints. The fire line will be connected with a tee and a valve provided at the BFPD. The BFPD must be located outside of the easement (LS 6901 I. Fire Lines). Grade the vault area to drain and provide a note indicating how the vault sump will drain.

It's our understanding that our client's attorney and the City's attorney are working together to determine the best way to cover utilities, by easements or other methods. Fire line is shown connecting at BFPD with valve. BFPD has been shown outside of the easement, there is also a profile showing how the vault sump drains.

3. Show size and location of water service lines and water meters (LS 6901 L. Water Meters). The water meter shall be located outside of the easement shown. The building service line and the irrigation line will each have their own connection to the water main by corporation stop with separate meters. Please note that the City Development Services inspectors do not use the MEP plans to inspect, please add requested information to the civil plans.

Additional information for water meters is now included. It is understood that city inspectors do not use MEP plans, the label still calls out to verify with MEP plans in case of any conflict.

4. Add the City sanitary sewer manhole naming as follows: Existing MH A1 is 16-107 and Existing MH A2 is 16-108.

Sanitary sewer manhole names revised accordingly.

- 5. Show in the pavement sections and add the following notes to the plans regarding all paving (public and private) must be per Section 2200 of the City Design and Construction Manual.
 - All asphalt materials shall conform to the KCMMB ASPHALT MATERIAL SPECIFICATION, current edition.

- All concrete materials for paving curb and gutter, sidewalks, paths, commercial driveways and other pavements in the right of way shall conform to the KCMMB specifications.

The concrete note has been added to all pavement sections. Asphalt note is not applicable for these plans because there is no asphalt.

6. Please add a note to the plans stating: "The contractor shall contact the City's Development Services Engineering Inspection to schedule a pre-construction meeting with a Field Engineering Inspector prior to any land disturbance work at (816) 969-1200."

Note has been added to cover sheet under "General Notes"

7. Provide a complete plan for the ADA-accessible ramps. Ensure that all elevation callouts, running slope callouts, and cross-slope points for construction of ADA-accessible ramps and sidewalk are shown. Also, include details of the sidewalk through the new driveways. Site specific information is required on these ADA plans and generic information will not be sufficient. Specific elevations, slopes, etc. for each location is needed. Also, include all ADA facilities for access to the building. More project specific detail must be provided to review and build the ADA facilities. Add the exact geometric information including dimensions to these plans.

Sidewalk through new driveway now has slope labels. Additional dimensions for ramp length and with have been added to all ADA facilities.

Fire Review

All issues pertaining to life safety and property protection from the hazards of fire, explosion or dangerous conditions in new and existing buildings, structures and premises, and to the safety to fire fighters and emergency responders during emergency operations, shall be in accordance with the 2018 International Fire Code.

Understood.

Traffic Review

1. The current radii do not meet the City's design criteria for Commercial/Industrial Collector or Local roads. If you are not able to adjust the radii due to storm or other public site restrictions an exception may be allowed, otherwise site approval will not be given to the current design.

Please see attached revised exhibits. A 15' radius will still allow a firetruck to enter and exit these locations without bumping into the proposed curb. The red line shows the wheel paths of each movement shown.

In addition, and as we discussed and mentioned previously, these will function the same as the existing approved entrances on the same private drive that was approved on the plans named "Private Site Development Plans for The Village at Discovery Park Zone 1" and dated 10/18/2023. Exhibit "Approved Drive Entrance Lot 10 & 11 – Right In" illustrates the movement into the shared driveway for lots 10 & 11.

These entrances also function similar to the approved fire access plan of the approved PDP plan. Attached is the revised PDP plan.

Building Codes Review

1. Inadequate information to complete reviews. Specify all utility connections, locations, sizes, materials, meter, interceptor, cleanouts, slopes, etc. (do not treat this as an all-inclusive list). Also, coordinate with MEP design team -plans don't match.

While design-build is an acceptable process, the designs must be complete prior to submittal. 5/15/24 - Only partially addressed and still not coordinated with MEP. As stated earlier, design-build is an acceptable process, but the designs must be completed prior to submittal.

Per phone discussion, the comment regarding plans not matching has been resolved. Additionally, meters, cleanouts, materials, slopes. etc. have been added to the plans where it is applicable.

Please review attached submittal and if there is any additional information needed you may contact by email at ndixon@crockettengineering.com or at 573-447-0292.

Sincerely,

Crockett Engineering Consultants, LLC

Welm Differ

Nolan Dixon, EIT

May 17, 2024

Hector Soto Jr.
City of Lee's Summit Senior Planner
220 SE Green Street
Lee's Summit, MO 64063
(816)-696-1600
Hector.Soto@cityofls.net



ARCHITECTURE
INTERIOR DESIGN
ENGINEERING
PLANNING

Project Name: Home2 Suites

Project Address: 251 NE Alura Way, Lee's Summit, MO 64086

Plan Number: PL2024097

This letter is in response to the Commercial Final Development Plan Applicant's Letter architectural comments dated April 24, 2024. The plans have been revised to address the referenced comments. Our responses are below, **IN BOLD**, and follow the order as shown in the review comments.

Planning Review

4. MECHANICAL SCREENING. Dash in the RTUs on the architectural building elevations (Sheets A-202 and A-203) to verify compliance with the requirement that all RTUs are fully screened from view on all sides by the use of parapet walls of a height at least equal to the units being screened. Take into account the added height from the curbs on which the RTUs will sit.

Per discussions with Hector Soto on Friday May 10, parapets do not necessarily have to match the height of the rooftop mechanical equipment if it can be demonstrated through the use of sight line studies that the roof mounted mechanical equipment is not visible from the public right-of-way, most importantly the equipment is to be screened from view when along Colbern and Douglas.

Per the exhibit on sheet A-204, all roof mounted mechanical equipment on the 4-story roof is screened from view without the need of parapet revision.

The mechanical equipment on the west side of the building on the 1-sotry roof is naturally screened from Colbern and Douglas given the building geometry, however, curb mounted mechanical screening is being proposed to screen that equipment from Alura Way and the adjacent hotel unit windows.

7. TRASH ENCLOSURE. Provide a detail of the proposed trash enclosure. Each trash enclosure shall be constructed of masonry walls or steel architecturally designed walls with either a solid steel opaque gate painted to be compatible with the color of the masonry or steel walls and building it is to serve or a steel framed semi-opaque gate with a screen mesh material approved by the Director that provides an appropriate visual barrier.

See trash enclosure details on sheet AS-102.

Should you have any questions, please do not hesitate to call.

Sincerely yours,

The Village at Discovery Park, Lot 2 Home2 Suites by Hilton FDP Round 1, Architectural Response – May 17, 2024 Page | **2**



ROSEMANN & ASSOCIATES, P.C.

816.472.1448. A.J. Dolph

OSemanr & ASSOC

HOME2 SUITES BY HILTON


SHEET TITLE FDP PERSPECTIVES

PROJECT NUMBER: 22023

SHEET NUMBER:

A-204

LEE'S SUMMIT

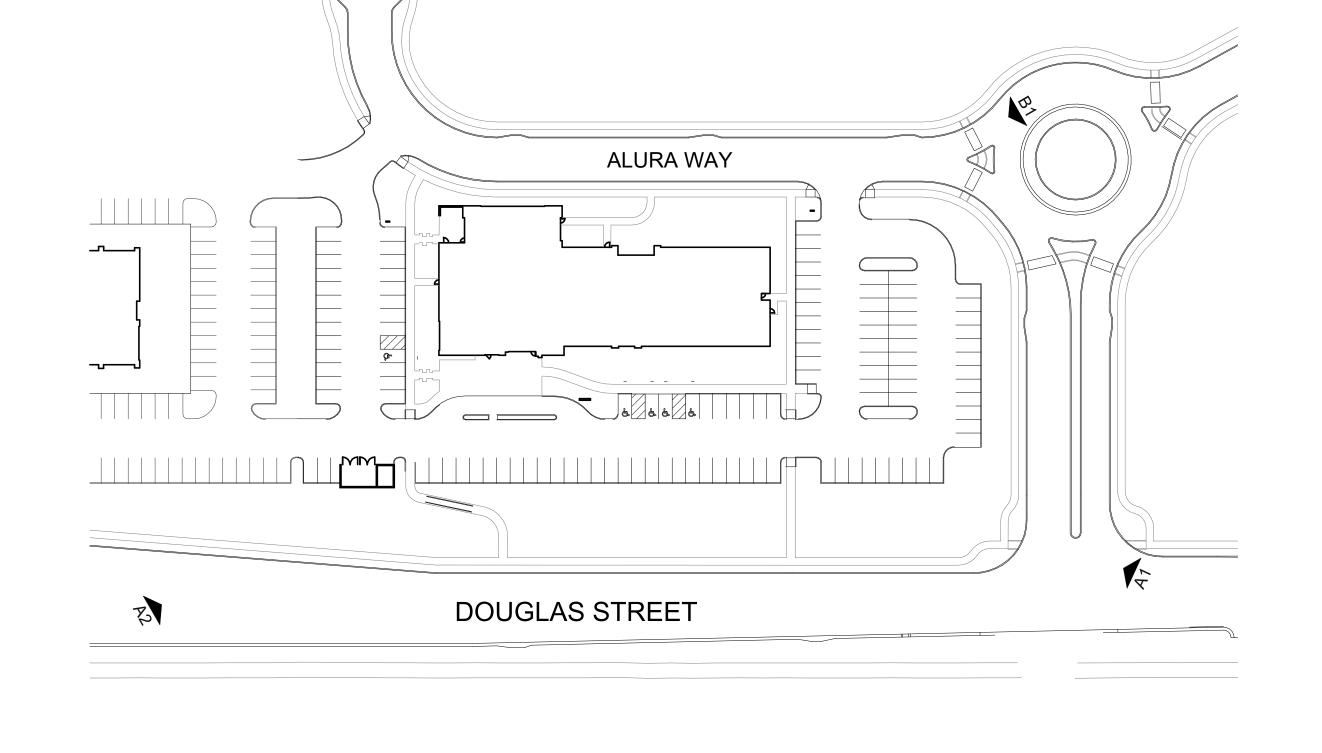

SOUTHEAST PERSPECTIVE

The state of the s



NORTHWEST PERSPECTIVE

B2 SITE DIAGRAM

1/64" = 1'-0"

SOUTHWEST PERSPECTIVE


04/17/2024 - CITY SUBMISSION

REVISIONS:

PRINTS ISSUED


2"x4"x3/16" TUBE STEEL FRAME - PAINT 1/2"x4" STEEL HINGE - WELD TO STEEL FRAME - PAINT 6" CONC. FILLED **BOLLARD - PAINT** 24 GAUGE "V" GROOVE METAL PANEL, PAINT TO MATCH ADJ. FINISH

TRASH GATE CROSS SECTION

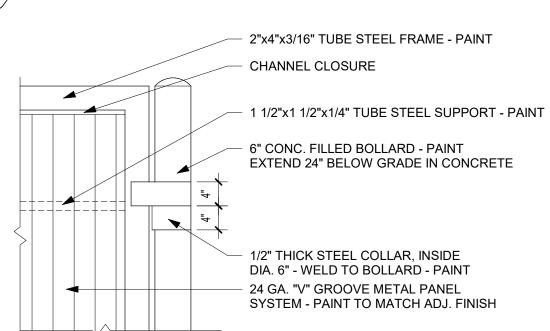


PRECAST


TRASH GATE DETAIL

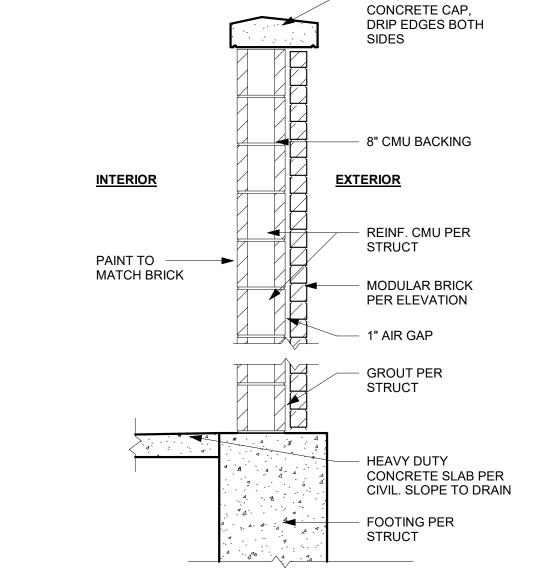


A2 SITE - ENCLOSURE - CMU - WALL SECTION

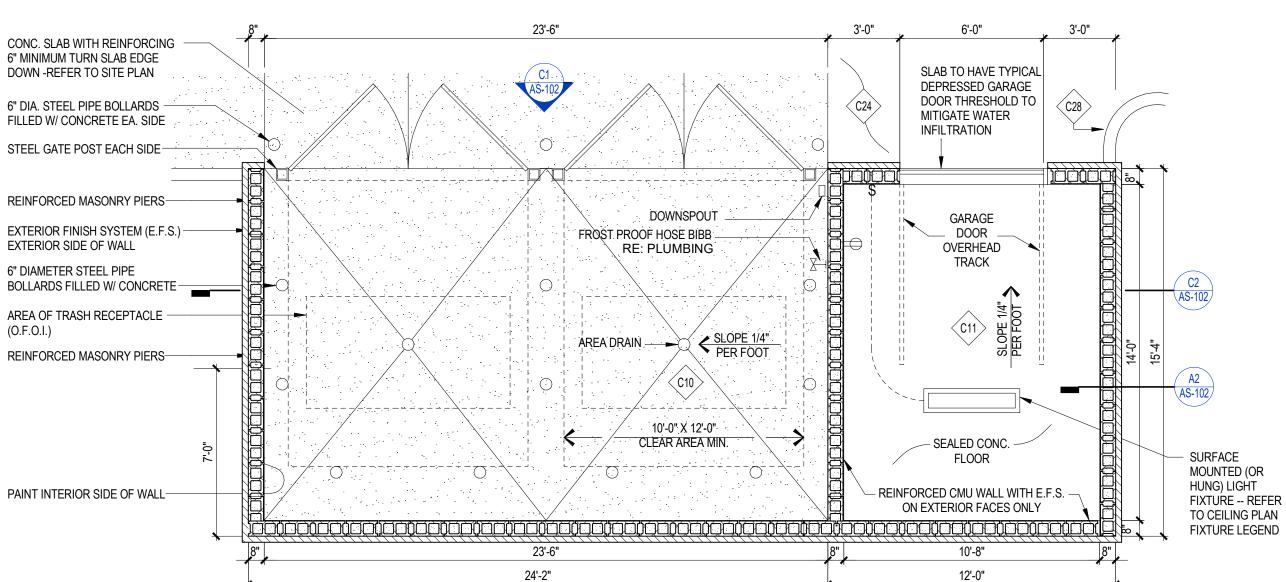


36'-2"

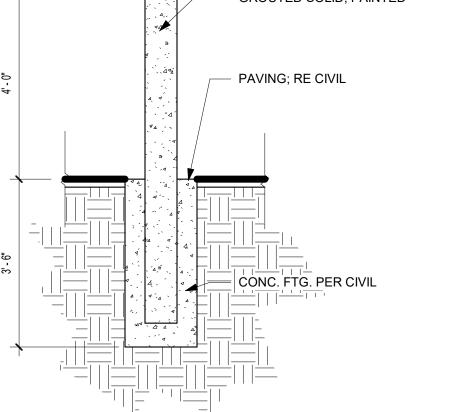

SITE - BOLLARD - STEEL

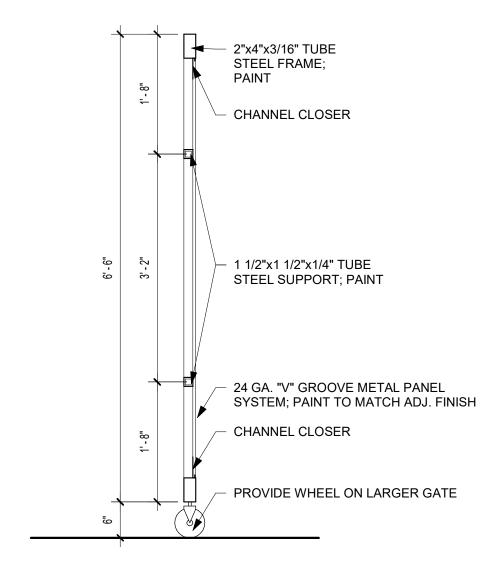

TRASH GATE SECTION

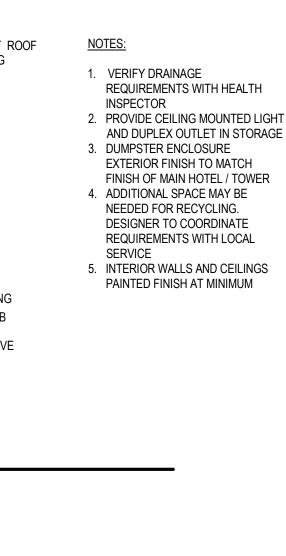

TIE SUPPORT CONCRETE STEM

TRELLIS - DETAIL

TYPICAL SPACING

4x4 CONTINUOUS STEEL ANGLE

WELDED TAB WITH THROUGH BOLT

- 2x4 HORIZONTAL THERMALLY

MODIFIED WOOD OR ACELYTATED

(BEYOND)

WOOD SLAT

- TUBE STEEL BEAM

TUBE STEEL COLUMN

MODIFIED WOOD OR

WELDED TAB WITH THROUGH BOLT - WASHER

ON OPPOSITE SIDE

- 2x7 CONTINUOUS STEEL BEAM

FIXTURE

CONTINUOUS WELDED

PLATE TO SHIELD LIGHT

CONTINUOUS LED

STRIP LIGHT;

NOTCH WOOD

SLATS TO PASS THROUGH

4X4 CONTINUOUS

STEEL ANGLE

- 2X2 WELDED TAB

2X4 VERTICAL

WOOD SLAT

THRU-BOLT

CONTINUOUS

STEEL PLATE

- CONCRETE CURB

STEEL BASEPLATE

ON CONTINOUS

CONCRETE

FOOTING

THERMALY MODIFIED

WELDED TAB WITH

WOOD OR ACELYTATED

WITH THRU-BOLT

- CONTINUOUS

STEEL PLATE (BEYOND)

TRELLIS - SLAT CONNECTIONS

WELDED TAB

WITH THRU-BOLT

2x4 HORIZONTAL

MODIFIED WOOD

OR ACELYTATED

THERMALLY

WOOD SLAT

ALL EXPOSED STEEL

TO BE PAINTED WITH HIGH PERFORMANCE


COATING AT TRELLIS

L SHAPED -


STEEL MEMBER

2x4 VERTICAL THERMALLY


ACELYTATED WOOD SLAT

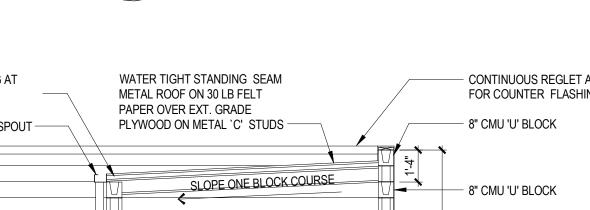

BRICK MASONRY WALL SECTION

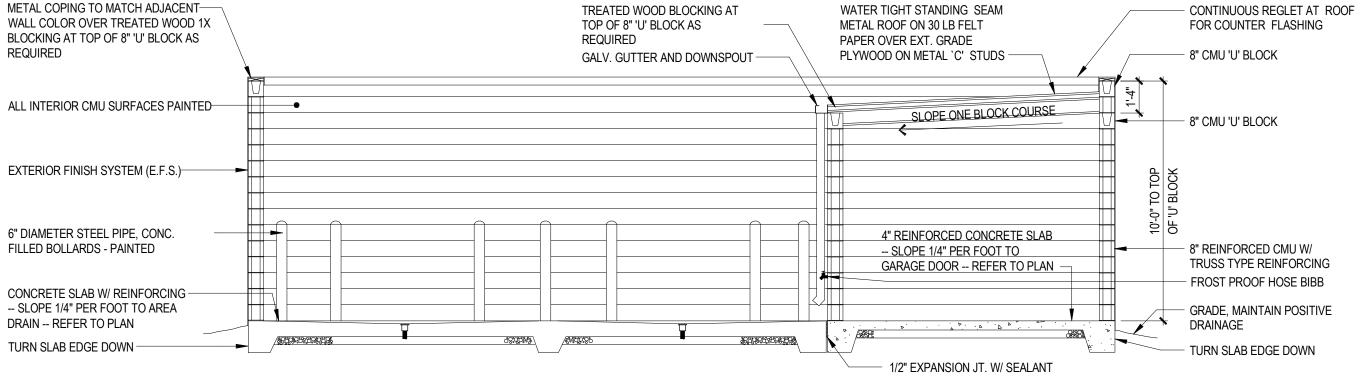

STORAGE & TRASH ENLOSURE SECTION

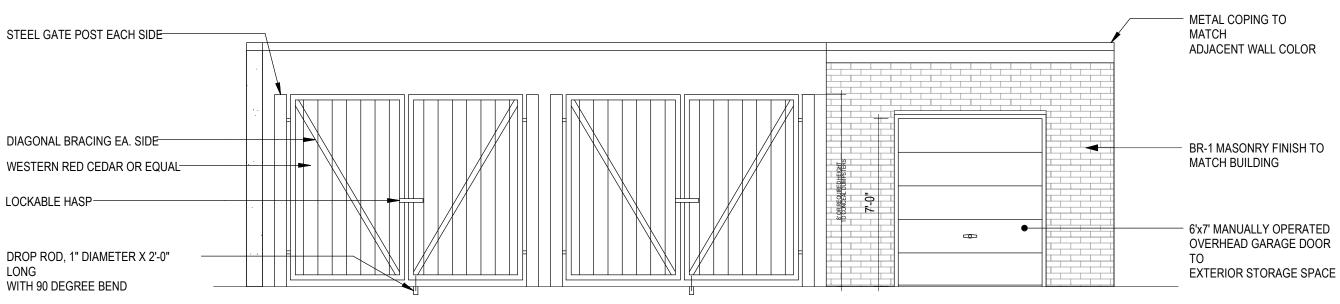

STORAGE & TRASH ENLOSURE ELEVATION

STORAGE & TRASH ENLOSURE PLAN

HOME2

 \Box

SHEET TITLE ARCHITECTURAL SITE AMENITIES

DAVID EUGEN

PROJECT NUMBER: 22023

SHEET NUMBER:

FINISH OF MAIN HOTEL / TOWER DESIGNER TO COORDINATE REQUIREMENTS WITH LOCAL

CONC. SLAB WITH REINFORCING 6" MINIMUM TURN SLAB EDGE DOWN -REFER TO SITE PLAN

4. ADDITIONAL SPACE MAY BE 5. INTERIOR WALLS AND CEILINGS PAINTED FINISH AT MINIMUM

(O.F.O.I.)

6" DIA. STEEL PIPE BOLLARDS -

CONCRETE SLAB ON GRADE TRELLIS AND HALF HEIGHT BRICK WALL FOOTING

TIE VERTICAL IN CORES REINFORCING IN GROUT FOOTING HORIZONTAL BRICK

BRICKS FILLED WITH GROUT -

WITH VERTICAL REINFORCING AND SOLID FILLED GROUT


PRE CAST CONCRETE - STRUCTURAL BRICK


CAVITY BETWEEN


TRELLIS TUBE STEEL COLUMN BEYOND


RE: CIVIL & STRUCT DWG FOR ADDITIONAL DETAIL

8" ROUND STL PIPE BOLLARD, GROUTED SOLID; PAINTED

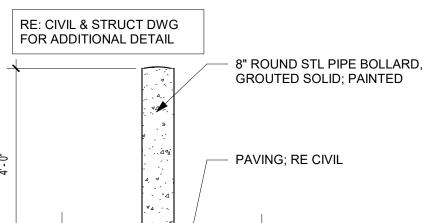


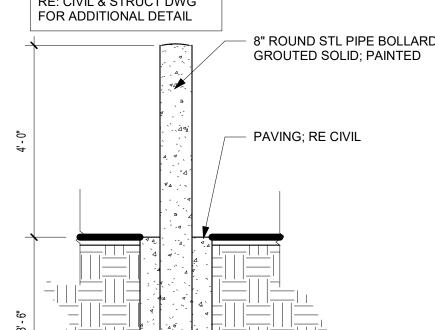


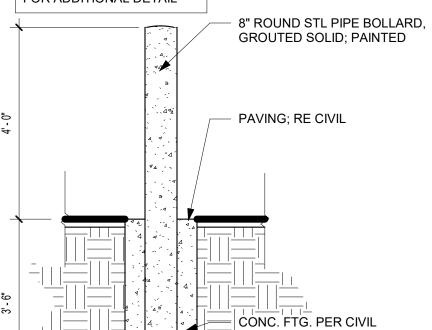


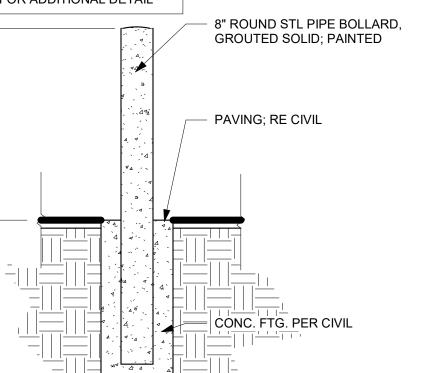





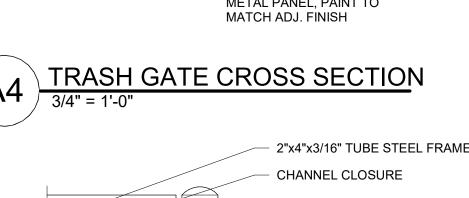

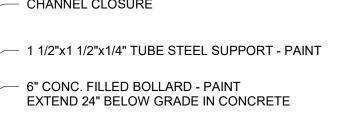


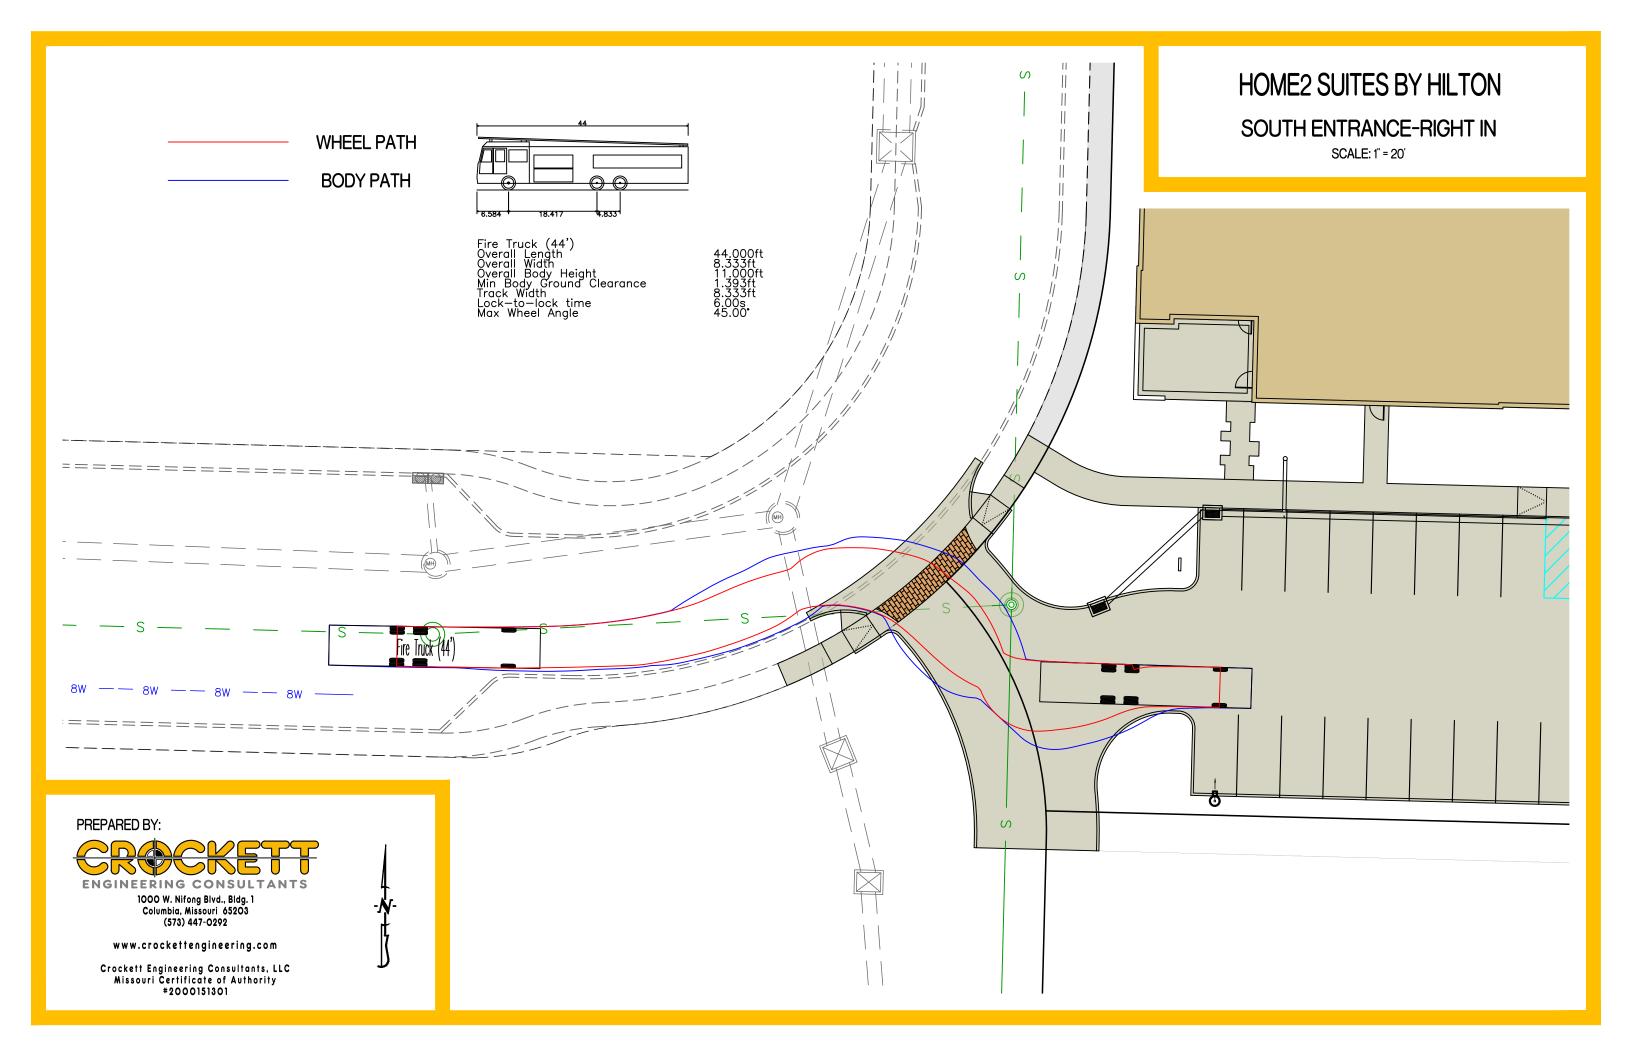

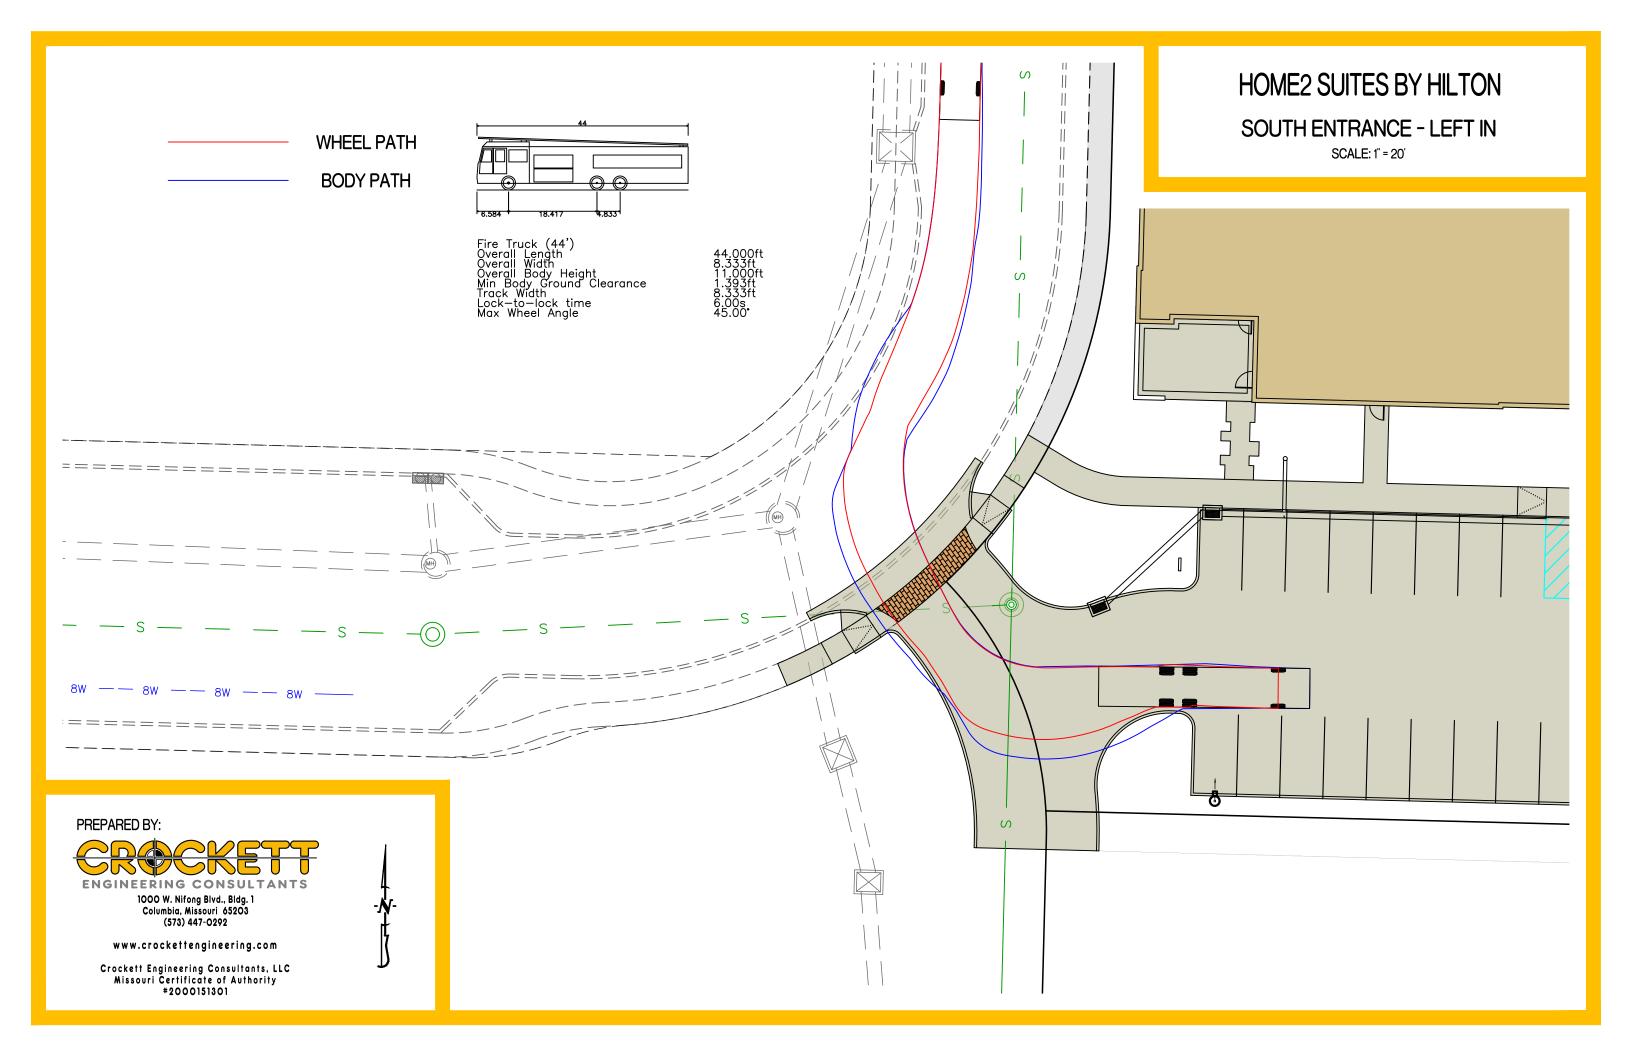

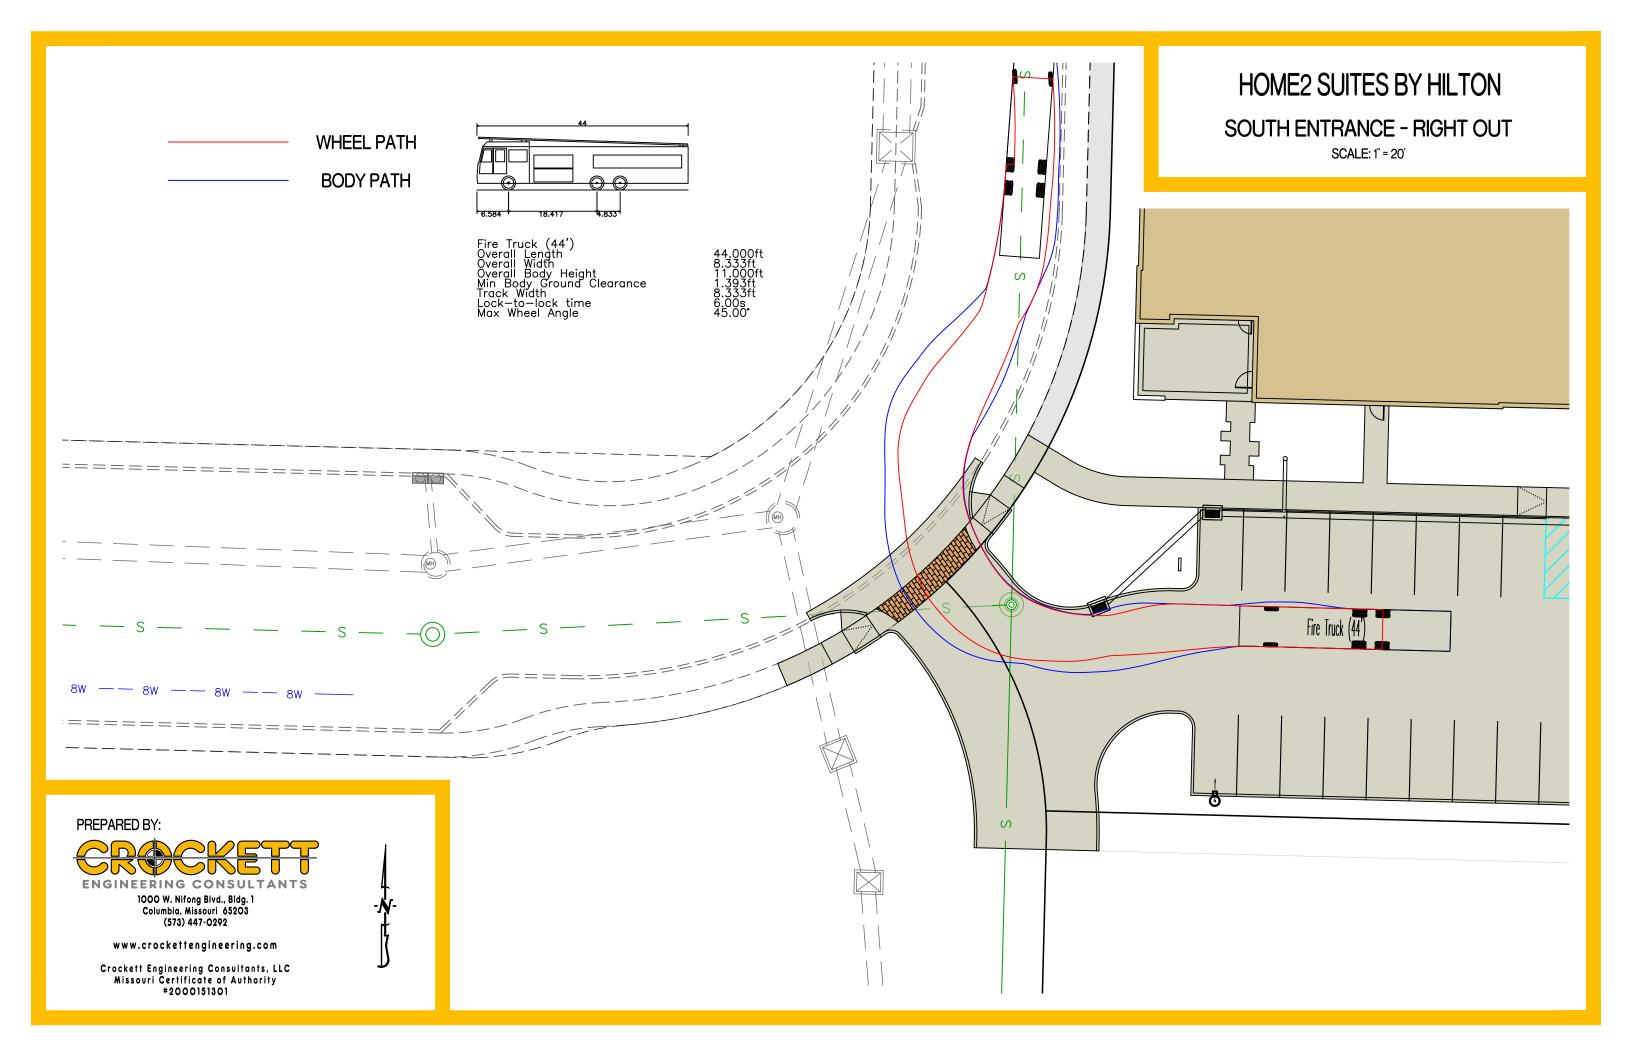

WHEEL PATH
BODY PATH

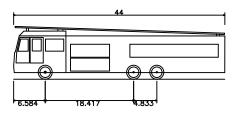

Fire Truck (44')
Overall Length
Overall Width
Overall Body Height
Min Body Ground Clearance
Track Width
Lock—to—lock time
Max Wheel Angle



PREPARED BY:




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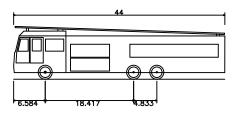
www.crockettengineering.com

Crockett Engineering Consultants, LLC Missouri Certificate of Authority #2000151301



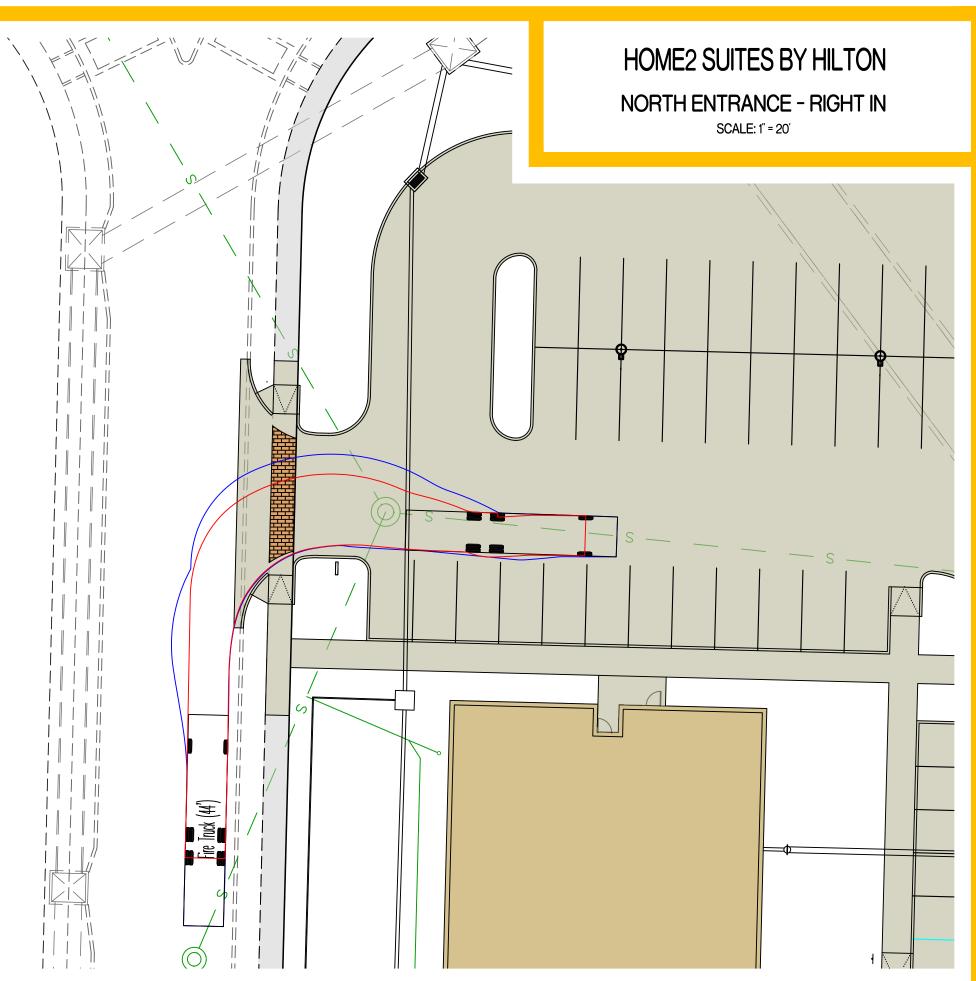

WHEEL PATH
BODY PATH



Fire Truck (44')
Overall Length
Overall Width
Overall Body Height
Min Body Ground Clearance
Track Width
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Max Wheel Angle



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