GENERAL NOTES:

1. MOUNT T-STATS AT 4'-0" A.F.F. UNLESS OTHERWISE INDICATED. T-STAT IS SUPPLIED AND WIRED BY THE MECHANICAL CONTRACTOR. 2. FIELD VERIFY ARCHITECTURAL AND STRUCTURAL BUILDINC CONDITIONS PRIOR TO DUCT AND EQUIPMENT FABRICATION. COORDINATE FOR CORRECT INSTALLATION.

3. PERFORM ALL WORK IN ACCORDANCE WITH CODES AND AUTHORITIES HAVING JURISDICTION. PROVIDE ALL PERMITS, INSPECTIONS, LICENSES AND FEES.

4. ALL DUCT SIZES SHOWN ON THE DRAWINGS ARE NET INSIDE CLEAR DIMENSIONS.


5. PROVIDE A LOCKINC QUADRANT VOLUME DAMPER AT THE TAP OF EACH RUN-OUT TO DIFFUSERS & CRILLES, FOR BALANCING PURPOSES NO EXCEPTIONS!

6. ALL DUCTWORK CONSTRUCTION AND INSTALLATION SHALL CONFORM TO SMACNA AND ASHRAE RECOMMENDATIONS. 7. ALL SUPPLY AIR AND OUTSIDE AIR DUCTWORK SHALL BE EXTERNALLY INSULATED, UNLESS OTHERWISE INDICATED. 8. CONTRACTOR SHALL LIMIT THE AMOUNT OF FLEXIBLE DUCTWORK TO 6 FEET NO EXCEPTIONS! 9. ALL DUCT RUNOUTS TO DIFFUSERS SHALL BE THE SAME SIZE AS THE SCHEDULED NECK SIZE UNLESS OTHERWISE INDICATED.

10. COORDINATE ALL CEILING DIFFUSER/GRILLE LOCATIONS WITH LIGHTS, SPRINKLER HEADS AND OTHER CEILING DEVICES. 11. RECTANGULAR DUCTWORK IN LIEU OF ROUND IS ACCEPTABLE. CONVERSION FROM RECTANCULAR TO ROUND (OR VICE VERSA) SHALL CONFORM TO SMACNA CUIDELINES.

12. CONTRACTOR SHALL SEAL ALL ROOF PENETRATIONS AIR & WATER TIGHT.


13. IN ACCORDANCE \VITH THE 2015 1. E.C.C, ALL SUPPLY DUCTWORK SHALL BE PROVIDED WITH DUCT WRAP OR DUCT LINER \VITH A MINIMUM INSU LATINS VALUE OF R —8. ALL RETURN DUCTWORK SHALL BE PROVIDED WITH DUCT WRAP OR DUCT LINER WITH A MINIMUM INSULATING VALUE OF R—6.

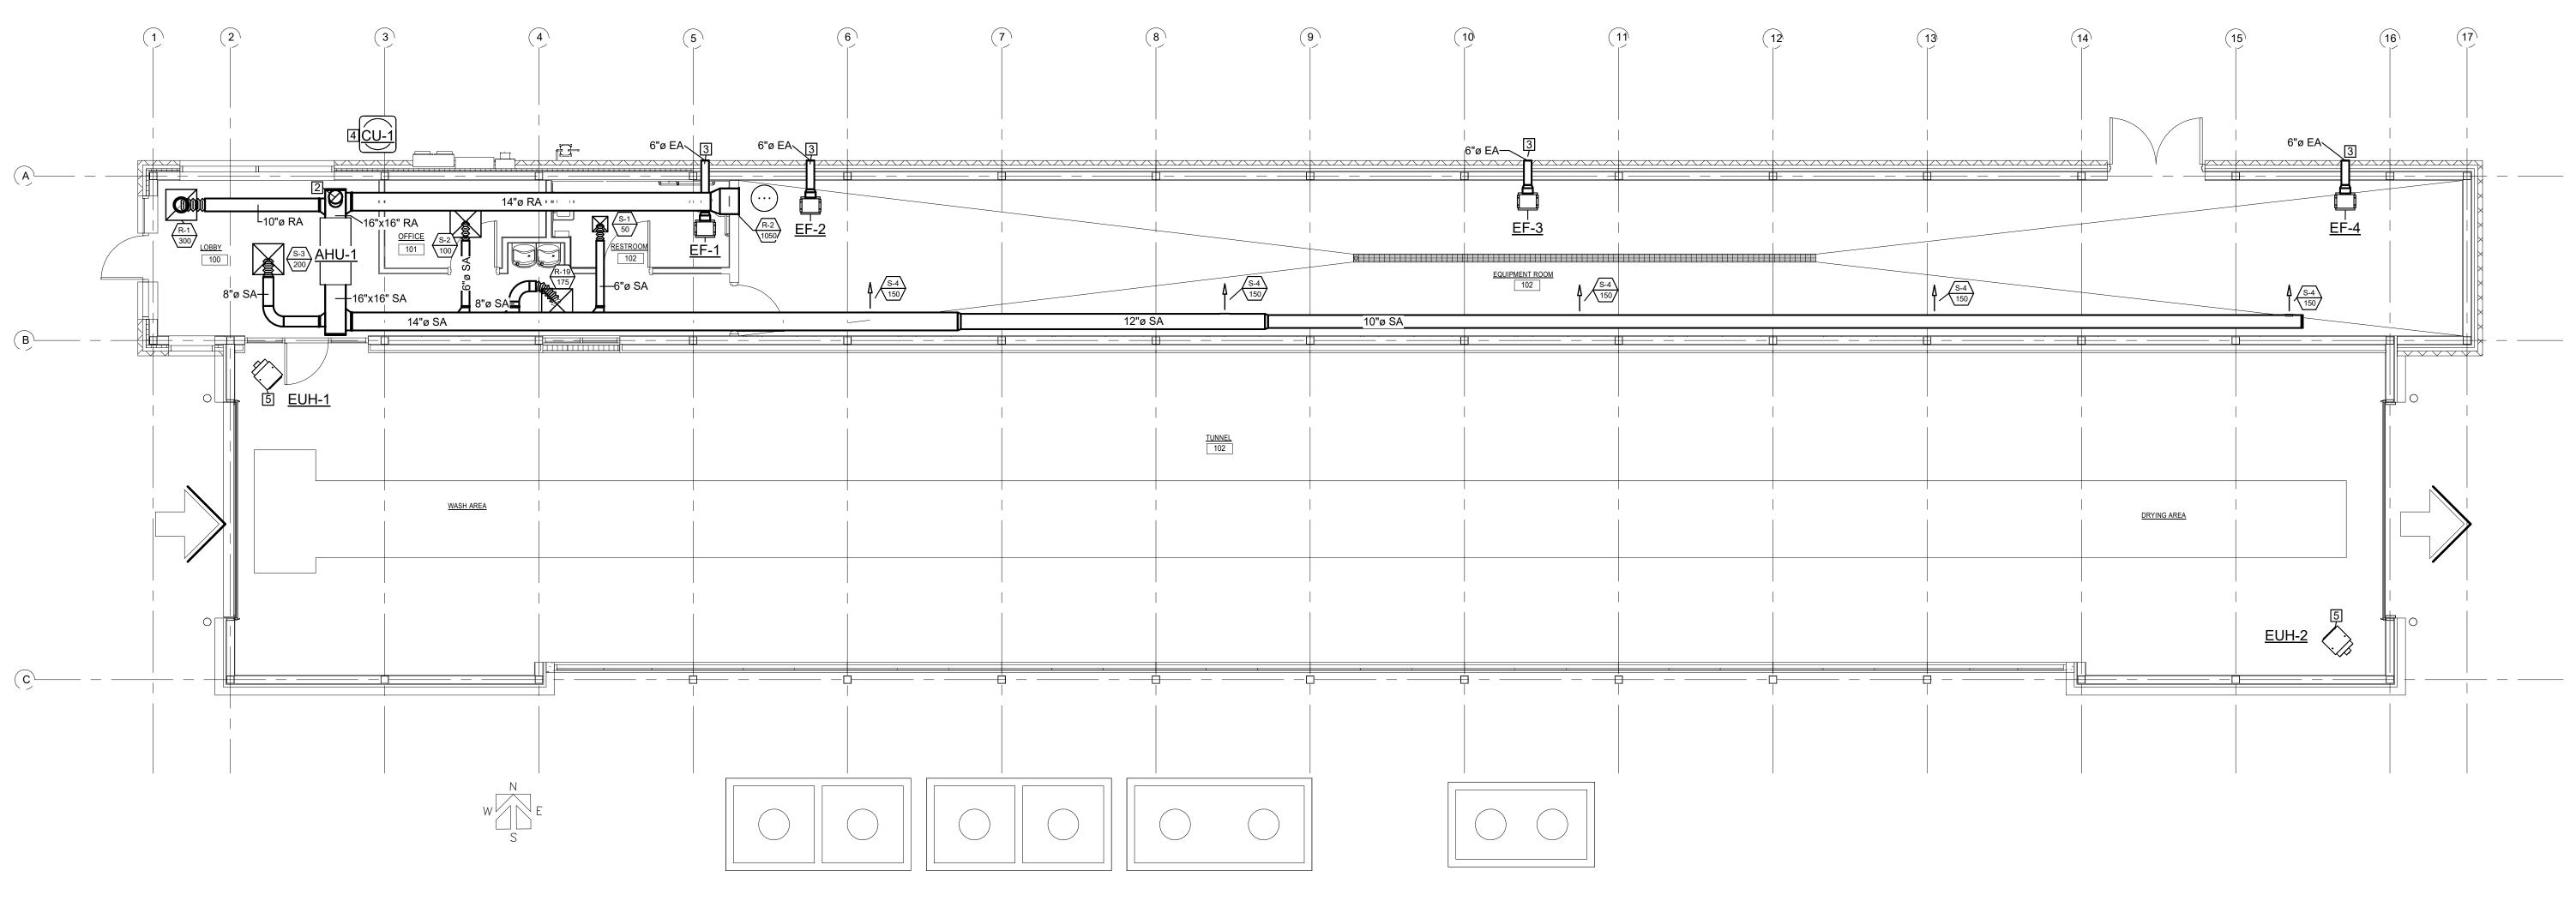

KEYED NOTES:

- 1. SPLIT SYSTEM A/C UNIT SUSPENDED FROM STRUCTURE ABOVE UNIT WITH VIBRATION ISOLATING HANGERS. EXTEND REFRIGERANT PIPING FROM INDOOR UNIT TO OUTDOOR UNIT AS RECOMMENDED BY THE UNIT MANUFACTURER. SEE DETAIL FOR ADDITIONAL INSTALLATION INFORMATION AND SCHEDULE FOR CAPACITY. ROUTE 3/4" INSULATED CONDENSATE DRAIN LINE FROM UNIT TO HUB DRAIN ADJACENT TO UTILITY SINK. SEE PLUMBING DRAWINGS FOR HUB DRAIN LOCATION.
- 2. 10" DIAMETER OUTSIDE AIR DUCT FROM RETURN AIR DUCT PLENUM UP THRU ROOF AND TERMINATED WITH LOW— PROFILE ROOF CAP. ROOF CAP SHALL BE SIMILAR TO GREENHECK MODEL GRSF—10 OR EQUAL. COORDINATE WITH ROOFING CONTRACTOR TO ENSURE ROOF PENETRATION IS AIR/WATER TIGHT.
- 3. CEILING-MOUNTED, EXHAUST FAN SUSPENDED FROM STRUCTURE ABOVE FAN WITH VIBRATION ISOLATING HANGERS. EXTEND EXHAUST DUCT OUT THRU EXTERIOR WALL AS SHOWN AND TERMINATE WITH GREENHECK MODEL WC—10x3 OR EQUAL HOODED WALL CAP.
- 4. AIR— COOLED CONDENSING UNIT MOUNTED 4" CONCRETE HOUSEKEEP INT PAD. INSTALL UNIT, INCLUDING OPERATING CLEARANCES, AS RECOMMENDED BY UNIT MANUFACTURER. SEE DETAIL FOR ADDITIONAL INFORMATION AND SCHEDULE FOR CAPACITY.
- 5. ELECTRIC UNIT HEATER INSTALLED AT 9'-0" AFF TO HEATER BOTTOM. PROVIDE WALL-MOUNTED THERMOSTAT SET TO ENERGIZE HEATER AT 45 DEG. F. SEE DETAIL FOR ADDITIONAL INFORMATION AND SCHEDULE FOR CAPACITY.

1 <u>M1.1 - HVAC FLOOR PLAN</u> 3/16" = 1'-0"

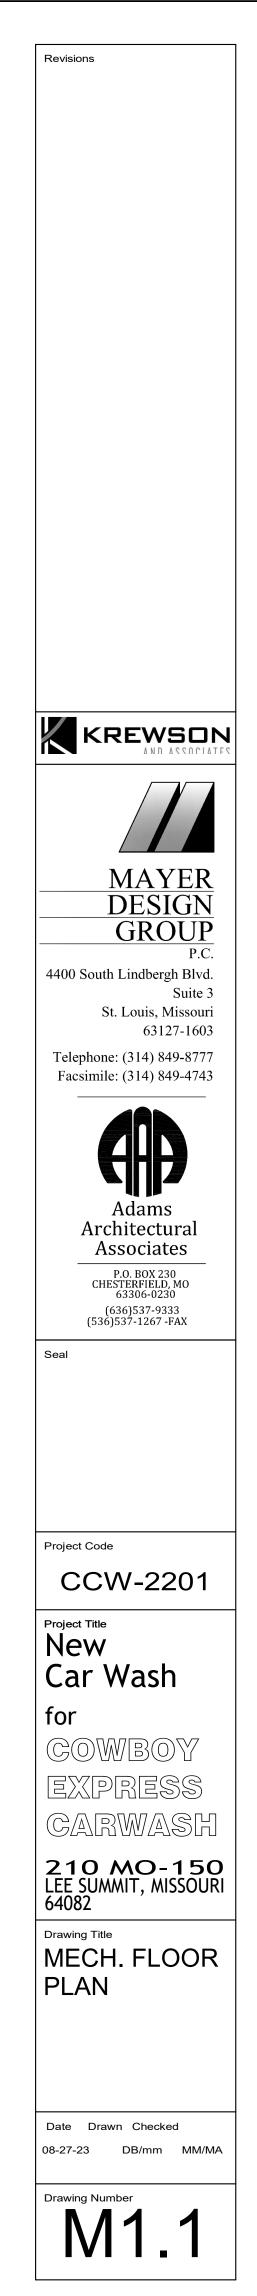

			SPI	LIT SY	STEM U	NIT S	CHEDU	LE					
PLAN	MANUF.	MODEL	SERVING	CLG	HEATER	CFM	AMB	REF	ELEC	TRICA	L	WEIGHT	DEMADUS
MARK	MANOF.	WODEL	SERVING	MBH	КW	CFIVI	TEMP °F	NEF	VOLTS/PH	MCA	MOCP	LBS	REMARKS 1, 2 1, 3, 4, 5
AHU-1	TRANE	TEM4A0C48S41SB	OFFICE	33.2	14.4	1575	95	R-410A	208/1	94	100	30	1, 2
CU-1	TRANE	4TTA4048A3000A	OFFICE	33.2	-	-	95	R-410A	208/3	18	30	85	1, 3, 4, 5

1. FURNISHED BY MECHANICAL CONTRACTOR.

2. FURNISHED WITH MANUFACTURER'S INTEGRAL PULL DISCONNECT.

3. DISCONNECT SWITCH BY ELECTRICAL CONTRACTOR. 4. FURNISHED WITH 7-DAY PROGRAMMABLE THERMOSTAT

5. PROVIDE UNIT WITH CRANKCASE HEATER, FILTER DRYER, SIGHT GLASS, AND SERVICE VALVES.

		ELECT	RIC UNIT H	IEATER SCH	EDULE			
PLAN	MANUF.	MODEL	ТҮРЕ	LOCATION		HEATER	R	REMARKS
MARK	WANUF.	WIODEL	ITPE	LOCATION	KW	STAGES	VOLT/PH	REIVIARKS
EUH-1	MODINE	HER150B 3101	HORIZONTAL	WASH AREA	15	1	480/3	1, 2, 3, 4
EUH-2	MODINE	HER150B 3101	HORIZONTAL	DRYING AREA	15	1	480/3	1, 2, 3, 4

1. PROVIDED BY MECHANICAL SUB CONTRACTOR.

2. FURNISHED WITH DISCONNECT SWITCH.

3. FURNISHED WITH REMOTELY MOUNTED THERMOSTAT SET TO 45F.

4. MOUNT 10'-0" FROM FLOOR TO BOTTOM OF UNIT.

				AIR	DEVICE S	SCHEDUL	E			
PLAN MARK	MANUF.	MODEL	MODULE	NECK	MAX NC	PATTERN	MATERIAL	FINISH	MOUNT	REMARKS
S-1	TITUS	TMS	12"X12"	6" Ø	30	4-WAY	STEEL	WHITE	CEILING	1
S-2	TITUS	TMS	24"x24"	6" Ø	30	4-WAY	STEEL	WHITE	CEILING	1
S-3	TITUS	TMS	24"x24"	8" Ø	30	4-WAY	STEEL	WHITE	CEILING	1
S-4	TITUS	301RL	12"X6"	-	30	-	ALUMINUM	WHITE	DUCT	1
R-1	TITUS	PAR	24"x24"	12" Ø	30	PERF	STEEL	WHITE	LAY-IN	1
R-2	TITUS	301RL	20"X20"	-	30	-	ALUMINUM	WHITE	SIDEWALL	1, 2

1. PROVIDED BY MECHANICAL SUBCONTRACTOR.

2. DO NOT SUPPLY WITH OPPOSED BLADE DAMPER.

				FAI	N SCHEI	DULE				
PLAN	AN MANUF. MODEL		SERVICE	CFM TSP IWC		MOTOR		LBS	MOUNT	REMARKS
MARK	MANOF.	MODEL	SERVICE	CFIVI	ISP IVC	HP	VOLT/PH	LDS	MOONT	REIVIARKS
EF-1	GREENHECK	SP-A125	RESTROOM 102	75	0.25	FR	115/1	30	CEILING MOUNTED	1, 2, 3
EF-2	GREENHECK	SP-A125	EQUIPMENT ROOM 103	75	0.25	FR	115/1	30	CEILING MOUNTED	1, 2
EF-3	GREENHECK	SP-A125	EQUIPMENT ROOM 103	75	0.25	FR	115/1	30	CEILING MOUNTED	1, 2
EF-4	GREENHECK	SP-A125	EQUIPMENT ROOM 103	75	0.25	FR	115/1	30	CEILING MOUNTED	1, 2


1. PROVIDED BY MECHANICAL SUBCONTRACTOR.

2. FURNISHED WITH DISCONNECT, GRAVITY DAMPER, AND WALL TERMINATION KIT.


3. EC TO TIE INTO LIGHT SWITCH.


		VE	NTILATION	SCHEDUL	E		
ROOM NUMBER	ROOM NAME	AREA SF	MAXIMUM OCCUPANTS	REQUIRED OA (CFM/PERS)	REQUIRED OA (CFM/SF)	REQUIRED EA (CFM)	FINAL OA REQUIRED
100	LOBBY	235	3	5	0.06	-	
101	OFFICE	55	1	5	0.06	-	225
102	RESTROOM	60	-	-	-	75	225
103	EQUIPMENT	725	_	-	0.15	150	

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K	
	MAYER
	DESIGN GROUP P.C.
	0 South Lindbergh Blvd. Suite 3 St. Louis, Missouri 63127-1603
	elephone: (314) 849-8777 acsimile: (314) 849-4743
	HP Adams
	Architectural Associates P.O. BOX 230 CHESTERFIELD, MO 63306-0230
Seal	(636)537-9333 (536)537-1267 -FAX
Proje	ect Code
Proj	CCW-2201
	ew ar Wash r
C	OWBOY XPRESS
C	ARWASH
Drav	10 MO-150 E SUMMIT, MISSOURI 082 ving Title CHEDULES
	e Drawn Checked
08-2	e Drawn Cnecked 7-23 DB/mm MM/MA wing Number
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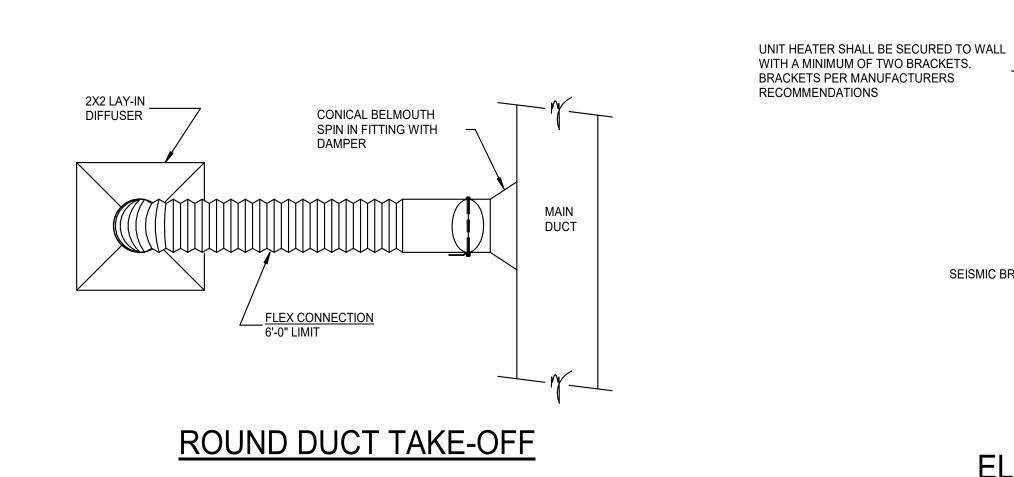


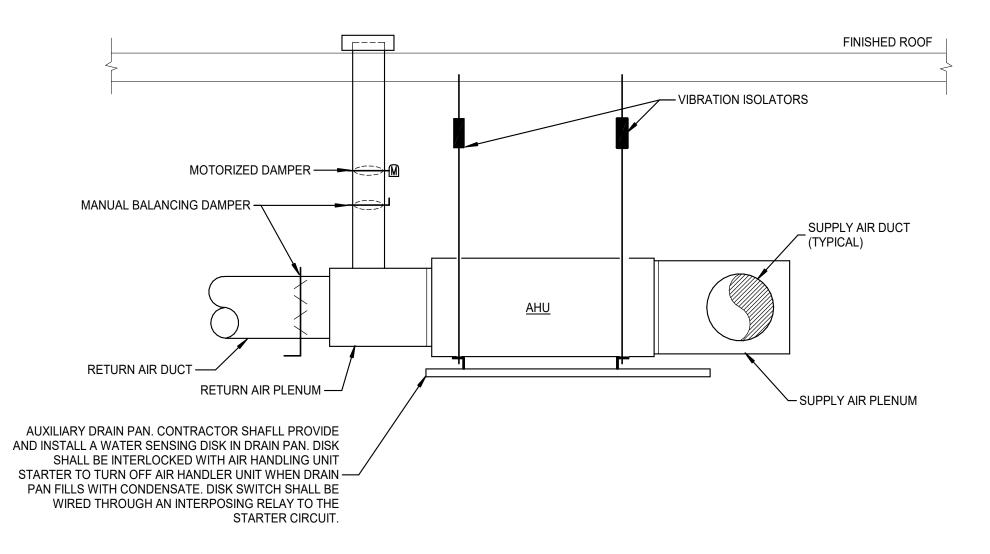HORIZONTAL AHU SUSPENDED ABOVE CEILING




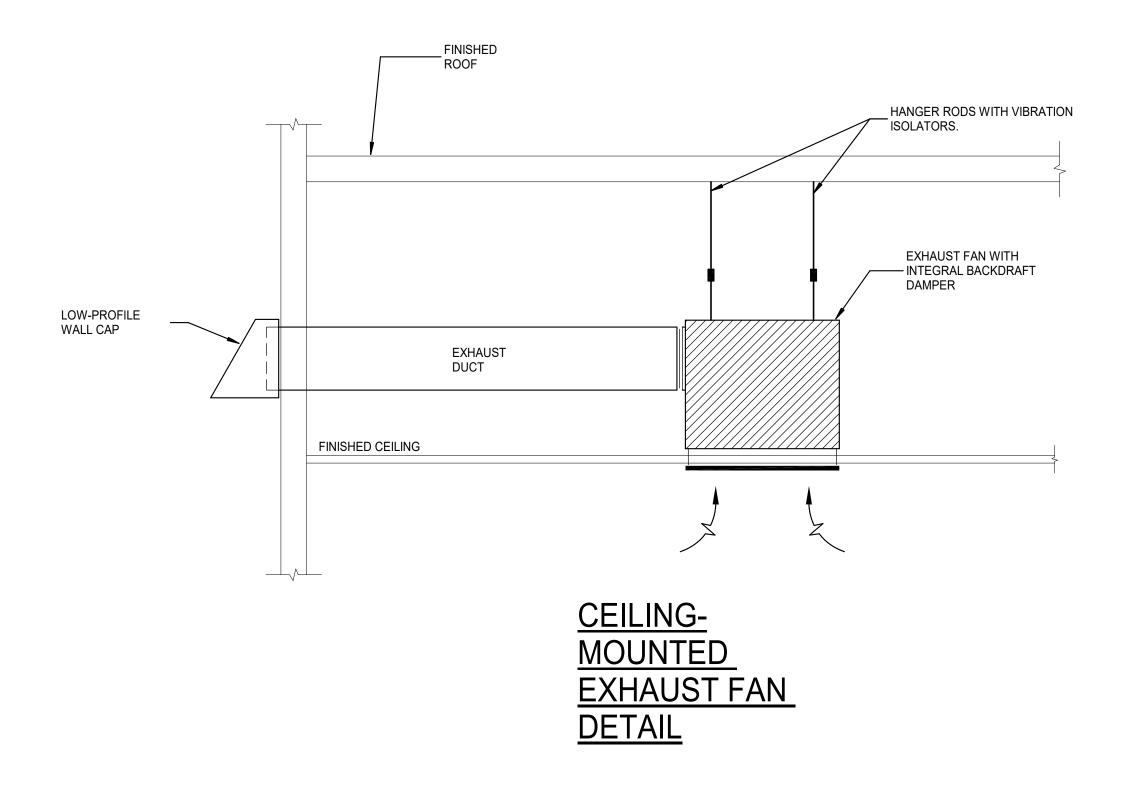

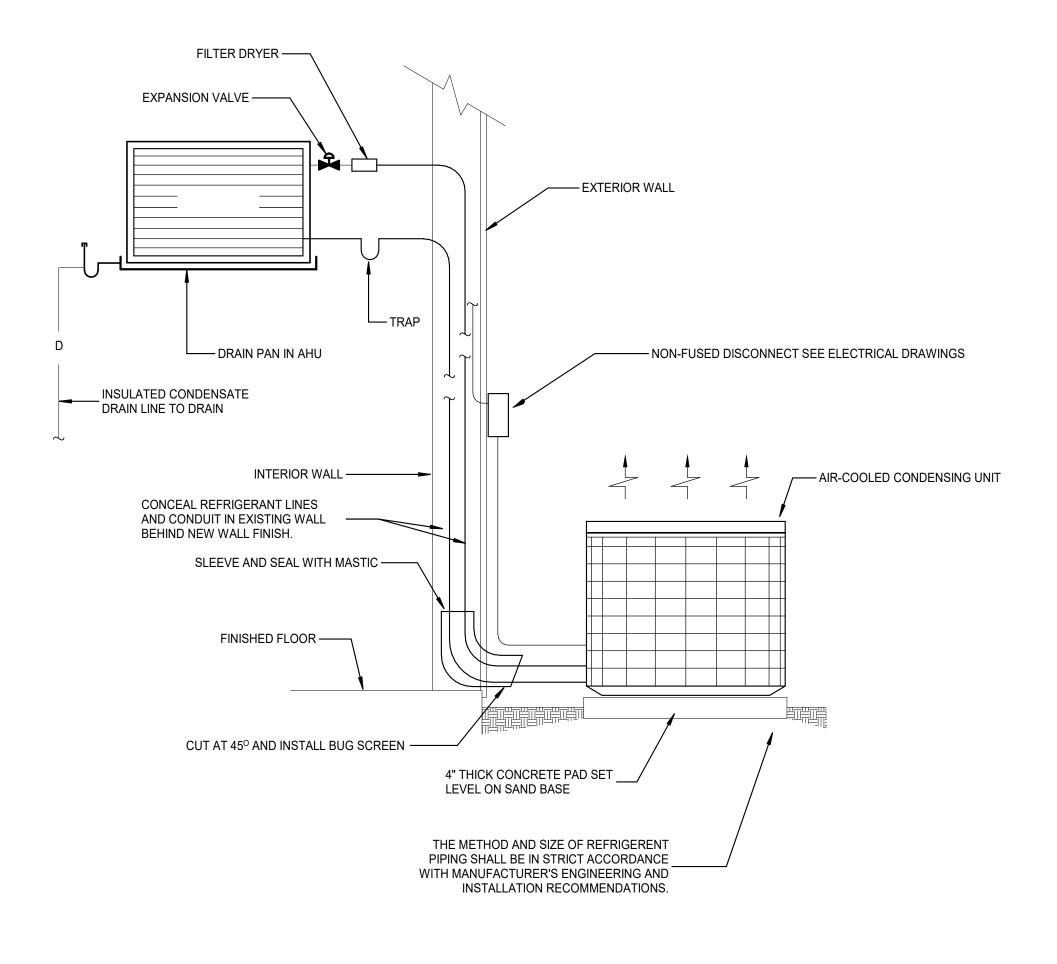
SPLIT SYSTEM AHU DETAILS



ELECTRICAL UNIT HEATER DETAIL

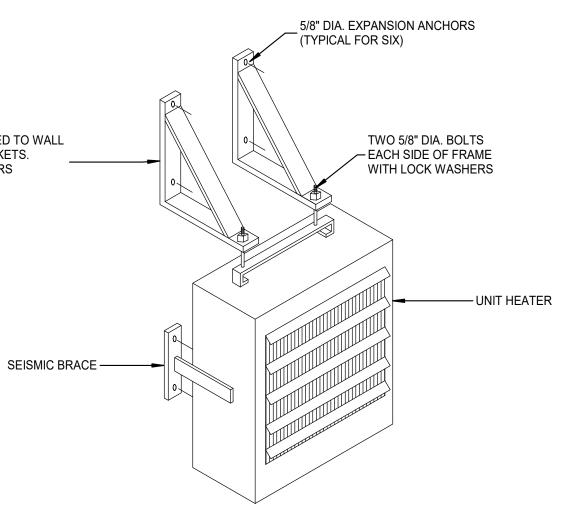


COOLING TRAP DETAIL

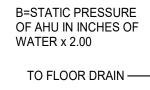

BLOWTHRU UNITS A=2 INCHES MINIMUM

A=2 INCHES MINIMUM B=STATIC PRESSURE OF AHU IN INCHES OF WATER x 1.25


DRAWTHRU UNITS

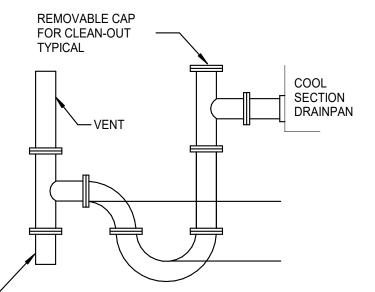

MAYER DESIGN GROUP P.C 4400 South Lindbergh Blvd. Suite 3 St. Louis, Missouri 63127-1603 Telephone: (314) 849-8777 Facsimile: (314) 849-4743 **AHD** Adams Architectural Associates P.O. BOX 230 CHESTERFIELD, MO 63306-0230 (636)537-9333 (536)537-1267 -FAX Seal Project Code CCW-2201 New Car Wash for COWBOY EXPRESS CARWASH **210 MO-150** LEE SUMMIT, MISSOURI 64082 Drawing Title HVAC DETAILS Date Drawn Checked 08-27-23 DB/mm MM/MA Drawing Number

M3.1

Revisions

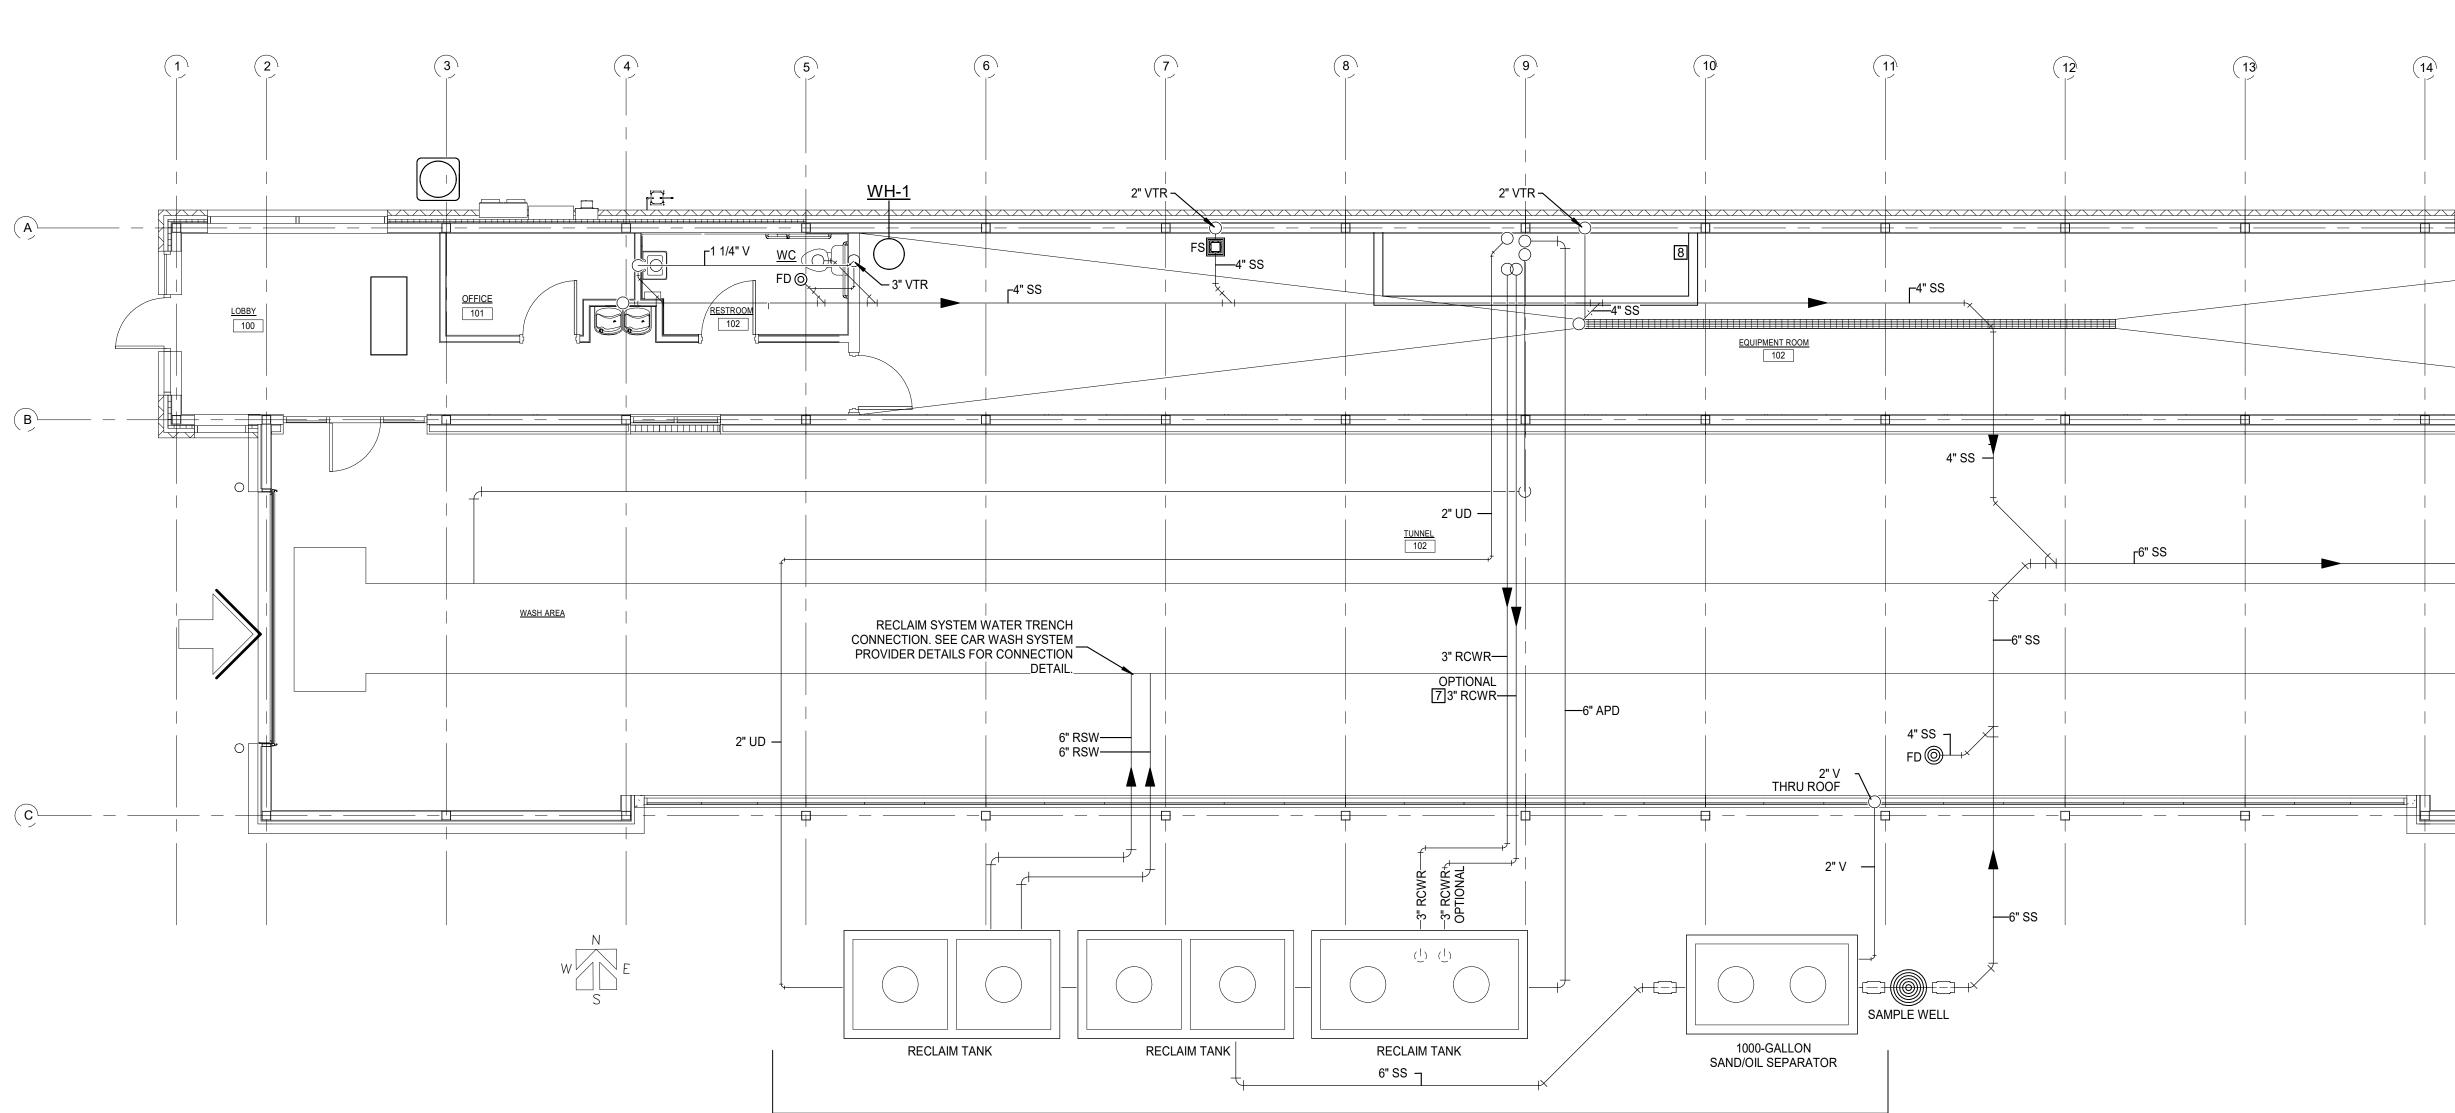

SANITARY PLUMBING FLOOR PLAN

RECLAIM SYSTEM PROVIDED BY CAR WASH SYSTEM PROVIDER VERIFY TANK QTY., LAYOUT, & PIPING CONNECTIONS WITH CAR WASH SYSTEM PROVIDER

OF THE BUILDING. 8. CONTRACTOR SHALL COORDINATE ALL PLUMBING VENTS THRU ROOF TO ENSURE THAT PLUMBING VENTS TERMINATE AT LEAST 10'-0" FROM ALL A/C UNIT OUTSIDE AIR INTAKES. PRIOR TO STARTING WORK. 10. CONTRACTOR SHALL ENSURE THAT THE HOT WATER TEMPERATURE DELIVERED LAVATORY AND UTILITY SINK IS NO

1. INSTALL ALL PLUMBING IN ACCORDANCE WITH CITY ORDINANCE

INSULATE ALL PIPING SUBJECT TO FREEZING AND SUBJECT TO

5. PROVIDE TRAP PRIMERS ON FLOOR DRAINS AND FLOOR SINKS.

7. ALL VENTS THRU ROOF TO BE A MINIMUM OF 24" FROM THE EDGE

6. PROVIDE ADA PIPING COVERS ON WATER SUPPLY AND DRAIN

BELOW SLAB/GRADE: TYPE K SOFT DRAWN COPPER

ABOVE SLAB/GRADE: TYPE L HARD DRAWN COPPER.

FORMING CONDENSATION TO A MINIMUM VALUE R-3.

3. SANITARY SEWER AND VENT PIPING - PVC SCHEDULE 40.

4. PROVIDE A VACUUM BREAKER AT ALL HOSE BIBBS.

PIPING UNDER EXPOSED LAVATORIES.

GENERAL NOTES

AND PAY FOR FEES REQUIRED.

2. WATER PIPING:

SCHEDULES.


- 9. CONTRACTOR SHALL FIELD VERIFY ALL EXISTING CONDITIONS
- GREATER THAN 110 DEG.F BY PROVIDING ASSE 1070 LISTED


- TEMPERATURE LIMITING DEVICES AT EACH PLUMBING FIXTURE

- RECEIVING HOT WATER.
- DETAILED FRESH WATER, RECLAIM WATER AND SANITARY SEWER
- 11. REFER TO CAR WASH EQUIPMENT PROVIDER'S DRAWINGS FOR PIPING CONNECTIONS TO CAR WASH AND OTHER EQUIPMENT.

- 12. SEE CAR WASH EQUIPMENT PROVIDER DETAILS FOR PIPE

- **KEYED NOTES**
- 1. REFER TO SITE UTILITIES PLAN FOR CONTINUATION OF DOMESTIC COLD WATER & SANITARY SEWER CONNECTIONS. FIELD VEIFY EXACT LOCATION AND ALL EXISTING CONDITIONS PRIOR TO
- STARTING ANY WORK. 2. PROVIDE BUILDING SHUT-OFF VALVE (TEE HEAD VALVE), BELOW
- GRADE IN VALVE BOX. 3. RPZ-TYPE BACKFLOW PREVENTER MOUNTED ON WALL AT 48" AFF.
- BACKFLOW PREVENTER SHALL BE EQUAL TO WATTS REGULATOR
- SERIES LF909 WITH AIR GAP PIPED TO ADJACENT FLOOR DRAIN. 4. APPROXIMATE LOCATION OF 1 1/2" DOMESTIC COLD WATER LINE DOWN TO SERVICE CAR WASH EQUIPMENT. FIELD VERIFY EXACT LOCATION ON-SITE WITH CAR WASH SYSTEM PROVIDER. PROVIDE
- RPZ BACKFLOW PREVENTER PRIOR TO CONNECTION TO EQUIPMENT. 5. SEE MANUFACTURERS INSTALLATION DOCUMENTATION FOR RECLAIM WATER SYSTEM TANK CONNECTION DETAILS. VERIFY
- UNDERGROUND PIPING ROUTING, DEPTH, AND CONNECTIONS PRIOR TO INSTALLATION.
- 6. ELECTRIC WATER HEATER WH ON PLATFORM. SEE DETAIL FOR ADDITIONAL INFORMATION AND SCHEDULE FOR CAPACITY.
- 7. A SECOND 3" RECLAIM WATER SYSTEM SUCTION LINE IS OPTIONAL. CONFIRM WITH EQUIPMENT SUPPLIER IF THE OPTIONAL RECLAIM WATER SYSTEM SUCTION LINE IS REQUIRED.
- 8. SECONDARY CONTAINMENT AROUND RECLAIM WATER SYSTEM EQUIPMENT. INSTALL RPZ MIN. 6" ABOVE THE FLOOD RIM OF THE CONTAINMENT. ROUTE RPZ DRAIN OUTSIDE CONTAINMENT TO NEAR DRAIN.

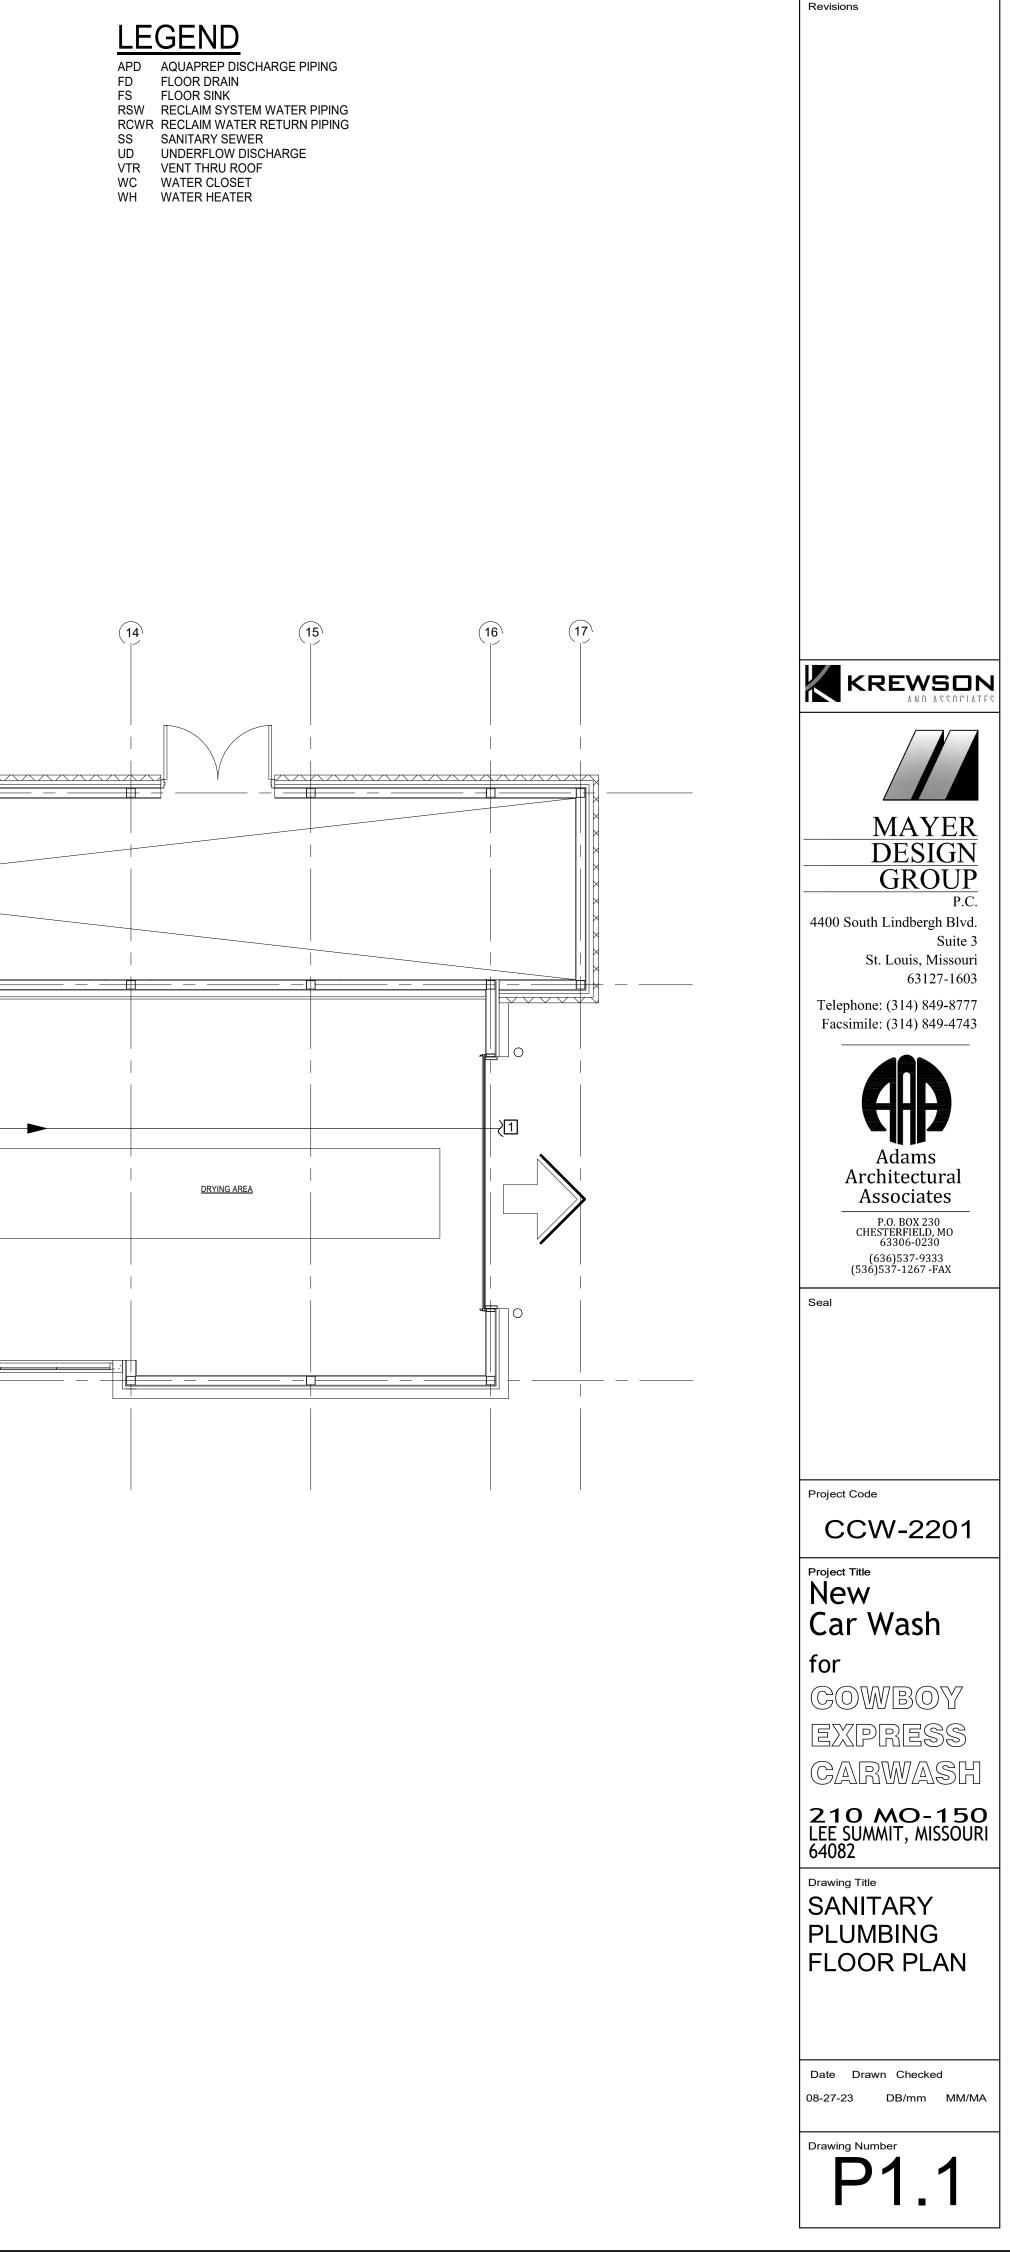

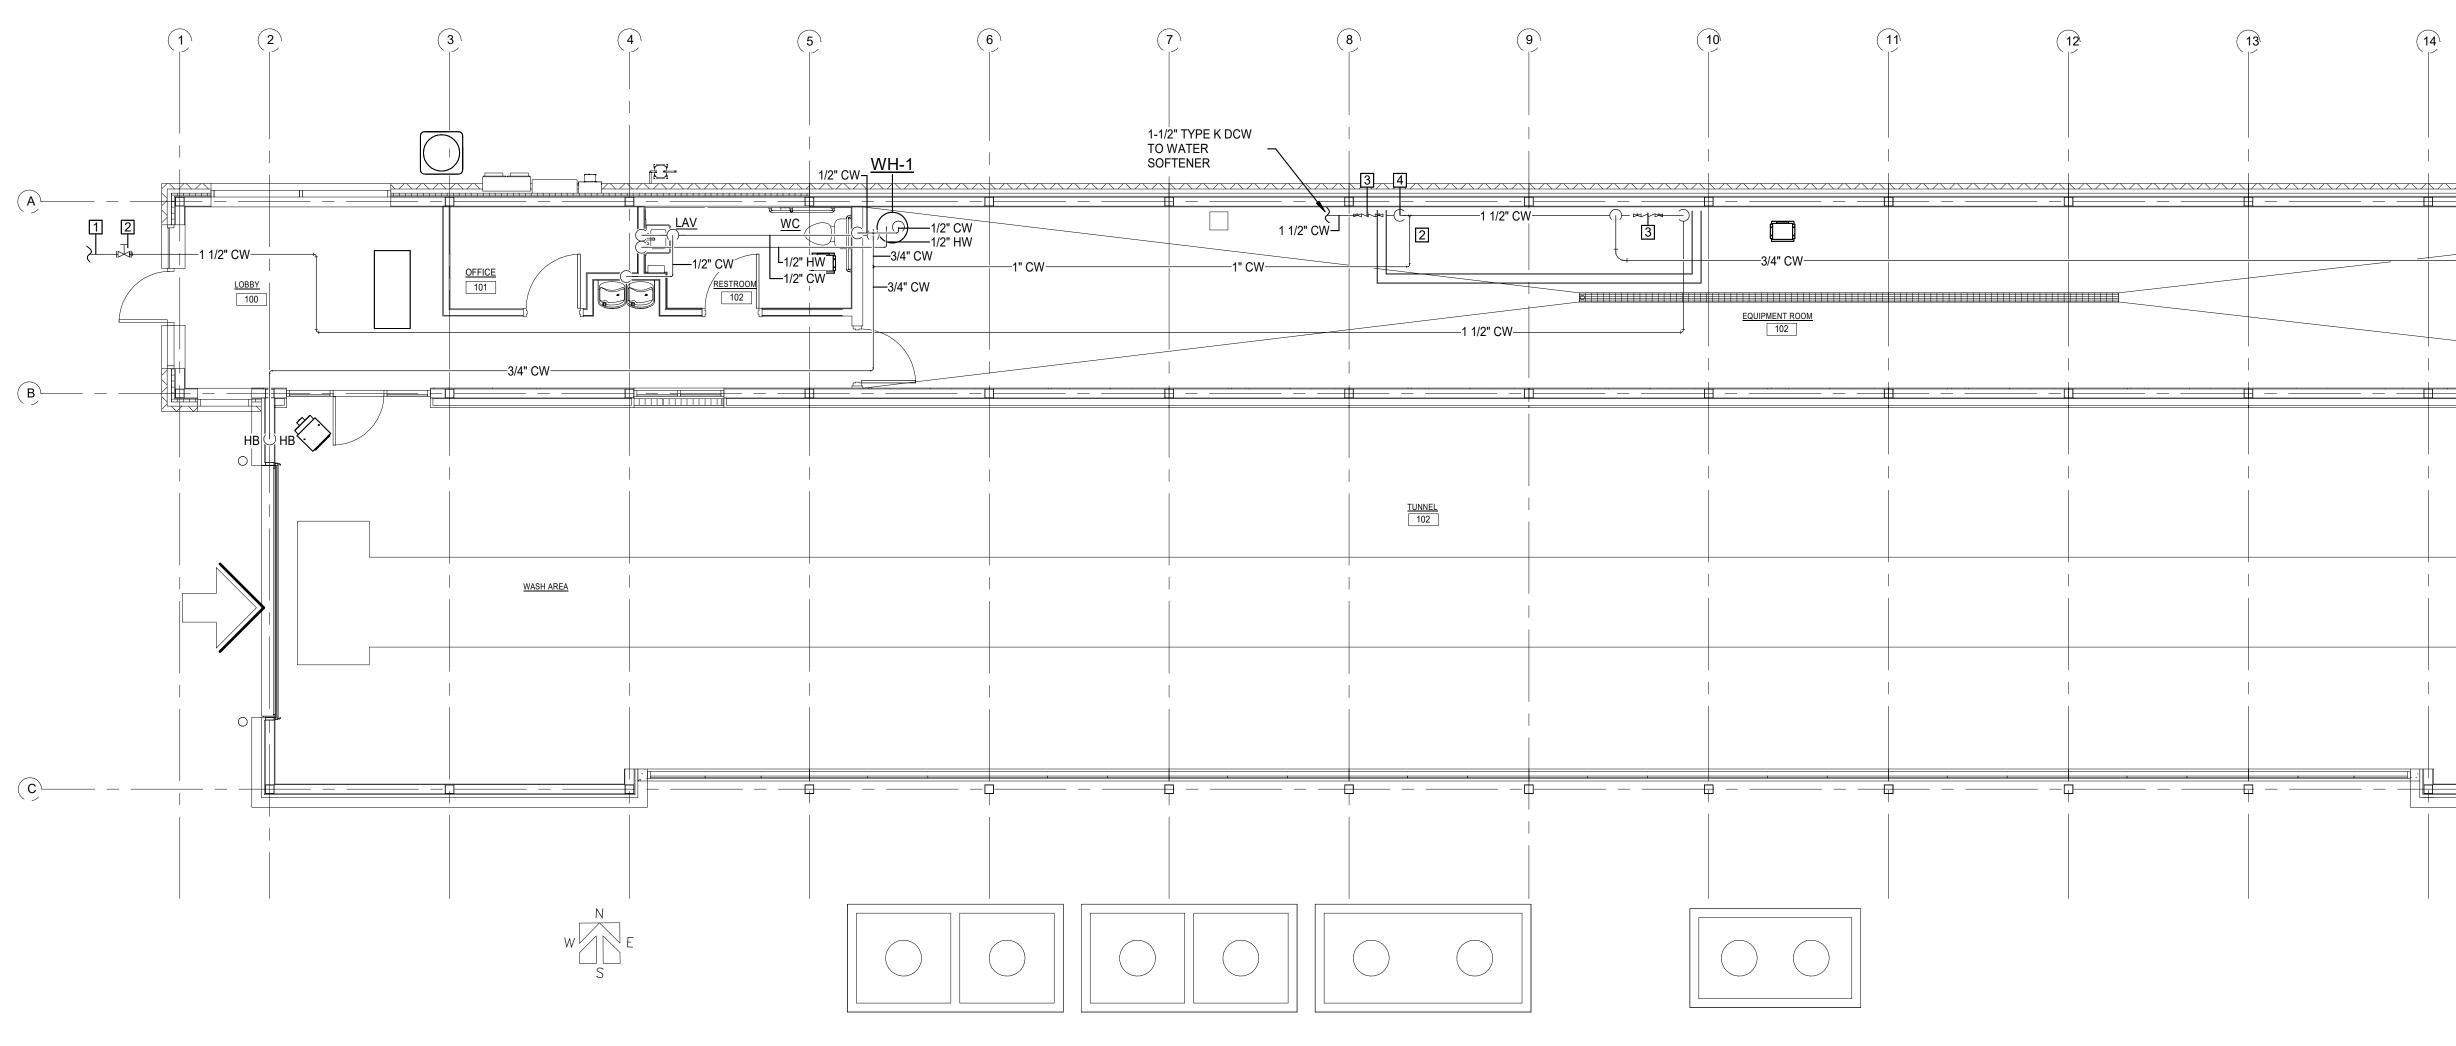


GENERAL NOTES

- 1. INSTALL ALL PLUMBING IN ACCORDANCE WITH CITY ORDINANCE AND PAY FOR FEES REQUIRED. 2. WATER PIPING:
- BELOW SLAB/GRADE: TYPE K SOFT DRAWN COPPER ABOVE SLAB/GRADE: TYPE L HARD DRAWN COPPER. INSULATE ALL PIPING SUBJECT TO FREEZING AND SUBJECT TO FORMING CONDENSATION TO A MINIMUM VALUE R-3. 3. SANITARY SEWER AND VENT PIPING - PVC SCHEDULE 40.
- 4. PROVIDE A VACUUM BREAKER AT ALL HOSE BIBBS. 5. PROVIDE TRAP PRIMERS ON FLOOR DRAINS AND FLOOR SINKS.
- 6. PROVIDE ADA PIPING COVERS ON WATER SUPPLY AND DRAIN PIPING UNDER EXPOSED LAVATORIES.
- 7. ALL VENTS THRU ROOF TO BE A MINIMUM OF 24" FROM THE EDGE OF THE BUILDING.
- 8. CONTRACTOR SHALL COORDINATE ALL PLUMBING VENTS THRU ROOF TO ENSURE THAT PLUMBING VENTS TERMINATE AT LEAST OF 10'-0" FROM ALL A/C UNIT OUTSIDE OF AIR INTAKES. 9. CONTRACTOR SHALL FIELD VERIFY ALL EXISTING CONDITIONS
- PRIOR TO STARTING WORK. 10. CONTRACTOR SHALL ENSURE THAT THE HOT WATER TEMPERATURE DELIVERED LAVATORY AND UTILITY SINK IS NO GREATER THAN 110DEG.F BY PROVIDING ASSE 1070 LISTED TEMPERATURE LIMITING DEVICES AT EACH PLUMBING FIXTURE
- RECEIVING HOT WATER. 11. REFER TO CAR WASH EQUIPMENT PROVIDER'S DRAWINGS FOR DETAILED FRESH WATER, RECLAIM WATER AND SANITARY SEWER PIPING CONNECTIONS TO CAR WASH AND OTHER EQUIPMENT.

KEYED NOTES

- 1. REFER TO SITE UTILITIES PLAN FOR CONTINUATION OF DOMESTIC COLD WATER & SANITARY SEWER CONNECTIONS. FIELD VEIFY EXACT LOCATION AND ALL EXISTING CONDITIONS PRIOR TO
- STARTING ANY WORK. 2. PROVIDE BUILDING SHUT-OFF VALVE (TEE HEAD VALVE), BELOW GRADE IN VALVE BOX.
- 3. RPZ-TYPE BACKFLOW PREVENTER MOUNTED ON WALL AT 48" AFF. BACKFLOW PREVENTER SHALL BE EQUAL TO WATTS REGULATOR
- SERIES LF909 WITH AIR GAP PIPED TO ADJACENT FLOOR DRAIN. 4. APPROXIMATE LOCATION OF 1 1/2" DOMESTIC COLD WATER LINE DOWN TO SERVICE CAR WASH EQUIPMENT. FIELD VERIFY EXACT LOCATION ON-SITE WITH CAR WASH SYSTEM PROVIDER. PROVIDE RPZ BACKFLOW PREVENTER PRIOR TO CONNECTION TO
- EQUIPMENT. 5. SEE MANUFACTURERS INSTALLATION DOCUMENTATION FOR RECLAIM WATER SYSTEM TANK CONNECTION DETAILS. VERIFY UNDERGROUND PIPING ROUTING, DEPTH, AND CONNECTIONS
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- 7. A SECOND 3" RECLAIM WATER SYSTEM SUCTION LINE IS OPTIONAL. CONFIRM WITH EQUIPMENT SUPPLIER IF THE OPTIONAL RECLAIM WATER SYSTEM SUCTION LINE IS REQUIRED.
- 8. SECONDARY CONTAINMENT AROUND RECLAIM WATER SYSTEM EQUIPMENT. INSTALL RPZ MIN. 6" ABOVE THE FLOOD RIM OF THE CONTAINMENT. ROUTE RPZ DRAIN OUTSIDE CONTAINMENT TO
- NEAR DRAIN. 9. ELECTRIC HEAT TRACE WATER LINE TO PREVENT FREEZING.

1 P1.2 - DOMESTIC WATER PLUMBING FLOOR PLAN 3/16" = 1'-0"

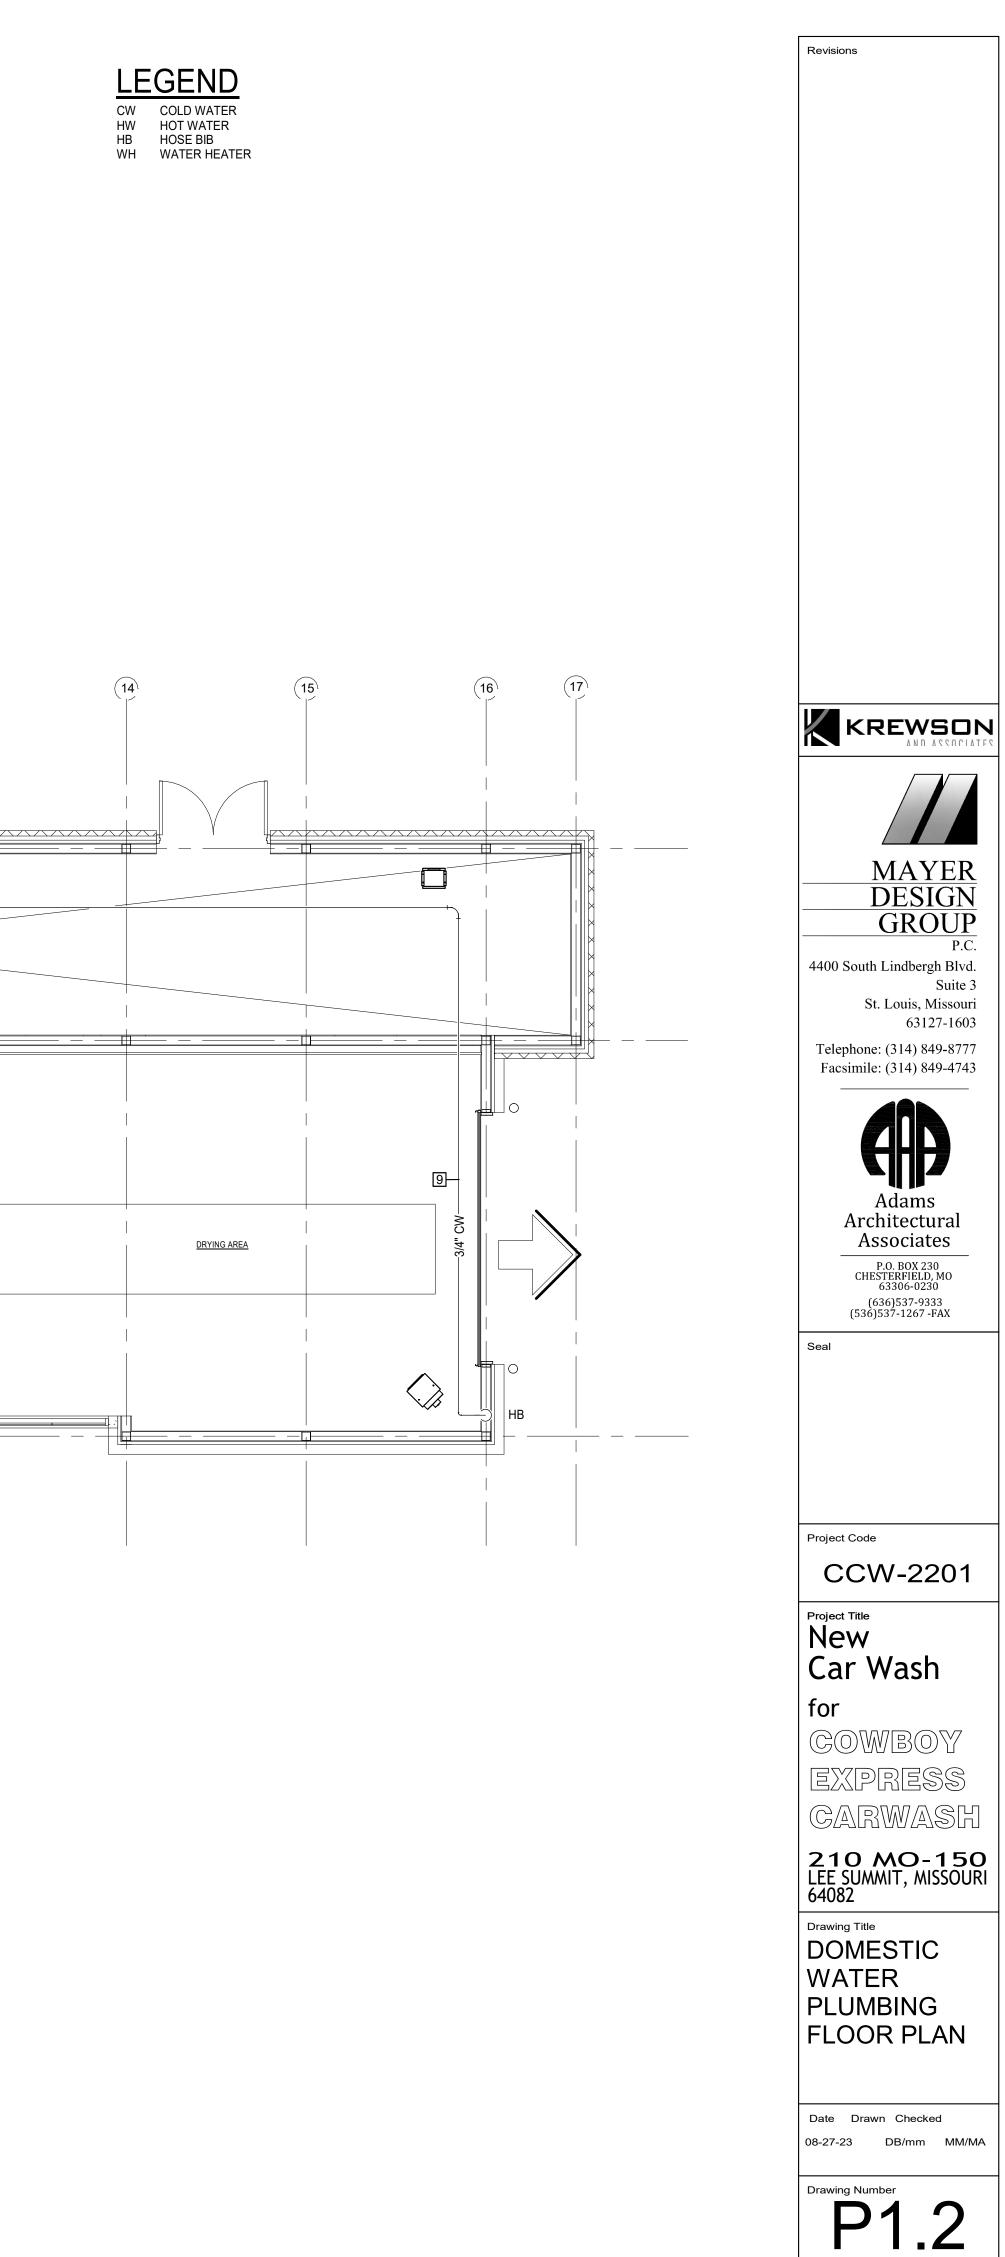

			PL	UMBING	FIXTURE SCHEDULE
PLAN		ROUGH-	IN SIZES	_	
MARK	cw	нw	w	v	DESCRIPTION
					TANK-TYPE WATER CLOSET, FLOOR-MOUNTED, WHITE VITREOUS CHINA, BOTTOM OUTLET, 1.6 GPF, WHITE OPEN-FRONT SEAT. KOHLER MODEL K-
					3493-RA, 17-1/8" HIGH WITH K-4650 SEAT AND MANUAL LEVER PROVIDED
WC	1/2"	-	4"	3"	WITH FIXTURE OR EQUAL.
					LAVATORY, WALL-MOUNTED, 20"x18" WALL-MOUNTED/CONCEALED ARM CARRIER ARM, P-TRAP AND WALL ESCUTCHEON, ENAMELED CAST IRON, SINGLE HOLE WITH SENSOR FAUCET ADA/TAS COMPLIANT INSTALLATION.
					LAVATORY: KOHLER MODEL K-2084-0 OR APPROVED EQUAL. SENSOR
LAV	1/2"	1/2"	2"	1-1/4"	FAUCET: ZURN MODEL Z6913-F-CWB-MJ-TMV OR APPROVED EQUAL.
					WORK SINK, FLOOR- & WALL-MOUNTED, STAINLESS STEEL WITH FOOT-
					OPERATED FAUCET. SINGLE FAUCET HOLE. CAST IRON COMBINATION P-
					TRAP/ADJUSTABLE FLOOR SUPPORT. CONSULT ARCHITECT FOR
					MOUNTING HEIGHTS AND PLACEMENT. ELKAY ESS-2520C WITH LK-395
					FAUCET AND LK-399 FLOOR-MOUNTED DOUBLE PEDAL VALVE OR
USK	1/2"	1/2"	3"	1-1/2"	APPROVED EQUAL.
					HOSE HYDRANT, FREEZE-PROOF, WITH CONTROL KEY AND INTEGRAL
					VACUUM BREAKER & UNION ELBOW. JOSAMN 71050 OR APPROVED
HB	3/4"	-	-	-	EQUAL.
					FLOOR DRAIN WITH DEEP SEAL P-TRAP AND 1/2" PRIMER TAP. JOSAM
FD	1/2"	-	3"	1-1/2"	30003-5A-50 FLOOR DRAIN AND STRAINER OR EQUAL.
					PVC FLOOR SINK, 9" SQUARE BODY, 6" DEEP WITH DOME BOTTOM
FS	1/2"	-	3"	1-1/2"	STRAINER, 1/2" GRATE AND 3" HUB OUTLET WITH 1/2" TRAP PRIMER TAP.
TP-1	1/2"	-	-	-	TRAP SEAL PRIMER VALVE. JOSAM 88250 OR EQUAL.
					KITCHEN SINK, DOUBLE COMPARTMENT, 18 GA. STAINLESS STEEL, SINGLE CONTROL FAUCET WITH HAND SPRAY AND 1/2 HP ELECTRIC DISPOSAL, 10"
KSK	1/2"	1/2"	2"	1-1/2"	DEEP. FINAL FIXTURE SELECTION BY OWNER/CONTRACTOR

1. PROVIDED BY MECHANICAL SUBCONTRACTOR.

2. DO NOT SUPPLY WITH OPPOSED BLADE DAMPER.

WATER HEATER SCHEDULE					
WH					
EQUIPMENT ROOM					
30					
65					
132					
21.64					
2					
208/1					
25					
AO SMITH					
DEN-30					
1					

<u>REMARKS</u> 1. SET THE LEAVING WATER TEMPERATURE FOR THIS WATER HEATER TO 130°F.


	evisions
	KREWSON
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4	GROUP P.C. 400 South Lindbergh Blvd.
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	Architectural Associates P.O. BOX 230
	CHESTERFIELD, MO 63306-0230 (636)537-9333 (536)537-1267 -FAX
s	eal
Р	
	CCW-2201
_	New Car Wash
	or Gowboy
	EXPRESS
-	CARWASH 210 MO-150
L 6	EE SUMMIT, MISSOURI 4082
F	rawing Title PLUMBING SCHEDULES
Ċ	
	Date Drawn Checked 3-27-23 DB/mm MM/MA
D	
	P2.1



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EXPANSION TANK

- PER MANUFACTURER;S

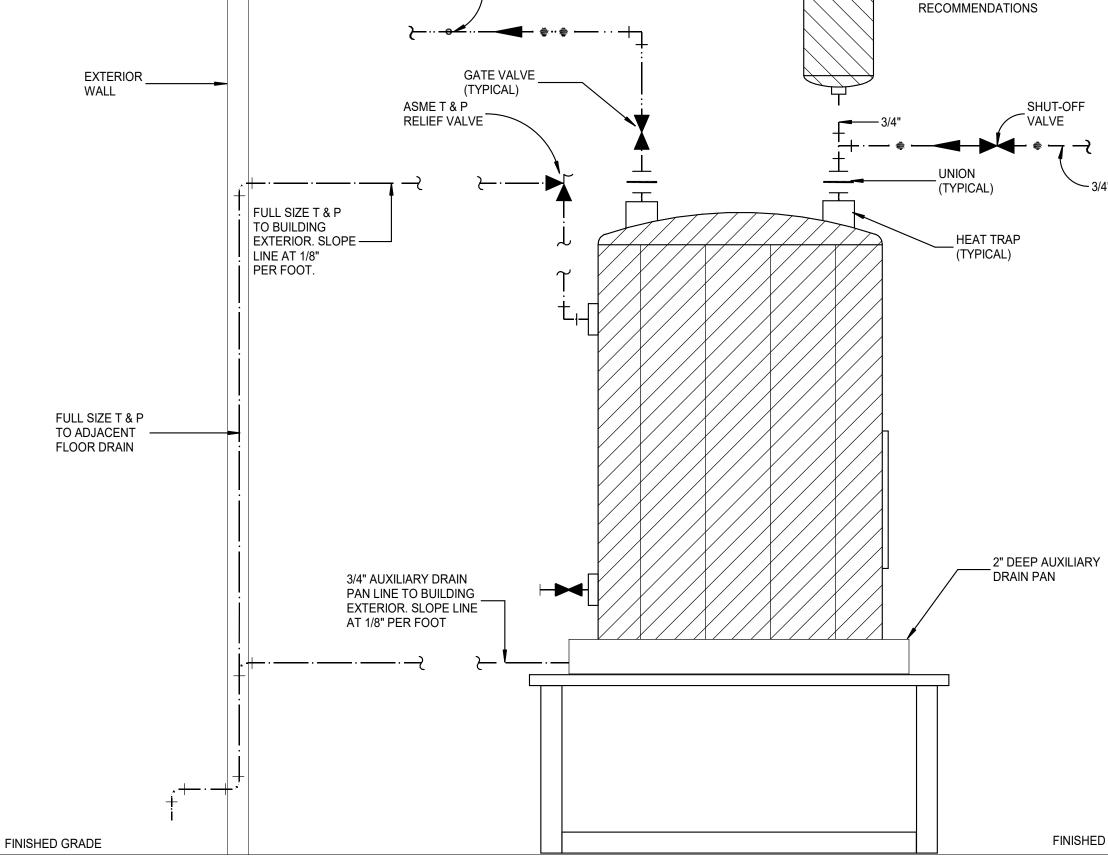

FLOW

CLEANOUT STACKS —

3/4" HW —

_CLEAN OUT PLUG (TYP)


- CONCRETE SLAB


DUAL GRADE CLEANOUT DETAIL







— 3/4" CW

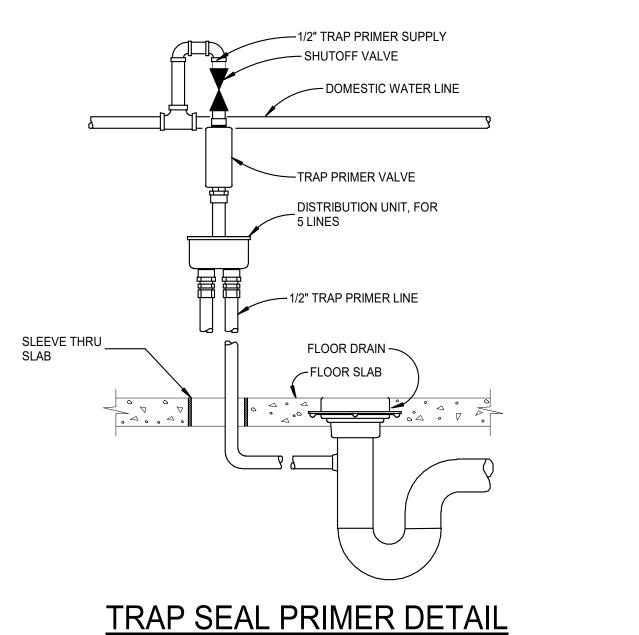


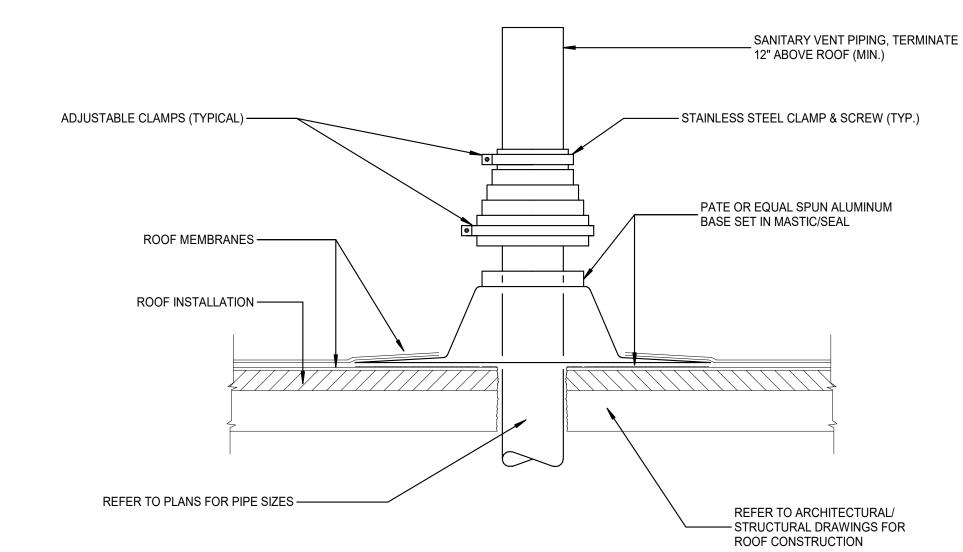




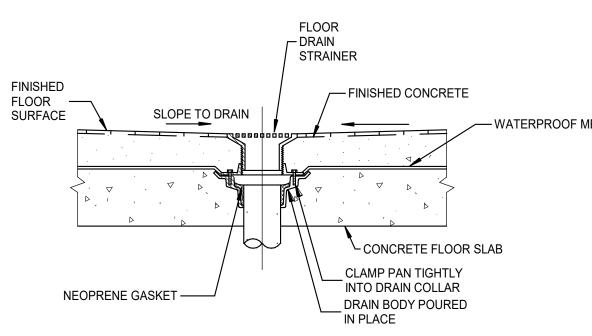

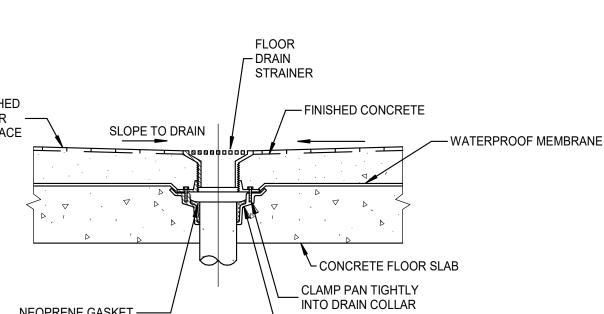

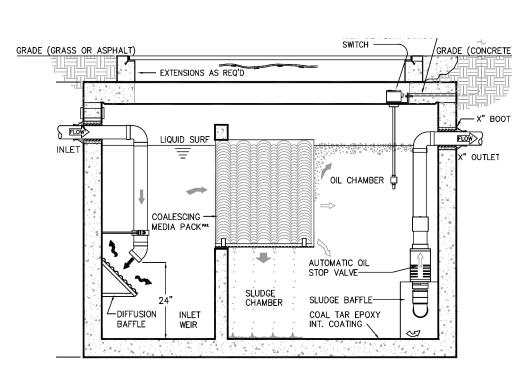


<u>SAND / OIL SEPARATOR</u>

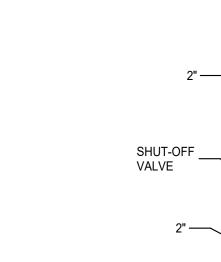

PLUMBING VENT THROUGH ROOF

WALL CLEANOUT-FINISHED ROOMS

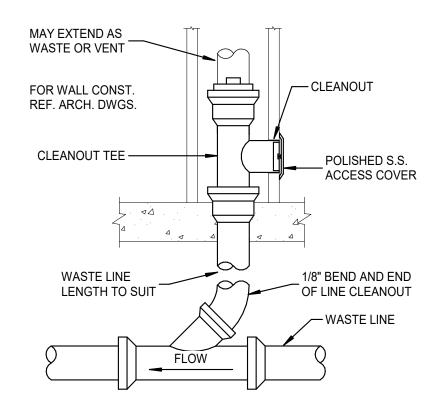

RPZ BACKFLOW PREVENTER DETAIL

