

RELEASED FOR CONSTRUCTION **As Noted on Plan Review**

Lee's Summit, Missouri

IURISDICTIONAL APPROVAL:

Cloud 9 L

LeaderOne Financia

Red Racks T

SE 3rd St

NO SCALE

BEDMINSTER, NJ 07921






IRVING, TEXAS 75038

VERIZON SITE NUMBER: 716127

BU #: **877803** KCYC LEES SUMMIT DT 207 SE DOUGLAS LEE'S SUMMIT, MO 64063 EXISTING 180'-0" MONOPOLE

ISSUED FOR:						
REV	DATE	DRWN	DESCRIPTION	DES./QA		
A	02/14/2023	RC	PRELIMINARY	AMT		
В	02/17/2023	RC	PRELIMINARY	АМТ		
0	03/17/2023	RC	FINAL	EAN		
1	06/21/2023	RC	FINAL	EAN		
2	07/27/2023	RC	FINAL	AMT		

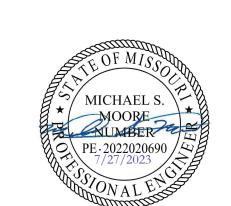

IT IS A VIOLATION OF LAW FOR ANY PERSON, JNLESS THEY ARE ACTING UNDER THE DIRECTION OF A LICENSED PROFESSIONAL ENGINEER, TO ALTER THIS DOCUMENT.

SHEET NUMBER:

REVISION:

VERIZON SITE NUMBER: 716127

VERIZON SITE NAME:

SITE TYPE:

CARRIER/APPLICANT:

ELECTRIC PROVIDER:

TELCO PROVIDER:

A&E FIRM:

CROWN CASTLE

CONTACTS:

USA INC. DISTRIC

TOWER HEIGHT:

KCYC LEES SUMMIT DT MONOPOLE

180'-0''

BUSINESS UNIT #: 877803

207 SE DOUGLAS SITE ADDRESS: LEE'S SUMMIT, MO 64063

JACKSON COUNTY:

FBC Lee's Summit

Lee's Summit

JURISDICTION: MO - CITY OF LEE'S SUMMIT 2015

LOCATION MAP

Third Street Social

VERIZON INITIAL BUILD

VERIZON SIGNATURE BLOCK

SITE ACQUISITION

CONSTRUCTION

RADIO

TELCO

MICROWAVE

EQUIPMENT

WO ADMINISTRATO

SITE ACQUISITION

CONSTRUCTION

PROJECT MANAGER

UTILITY MANAGER

LANDLORD

CROWN CASTLE USA INC. SIGNATURE BLOCK

APPROVALS

SIGNATURE

SIGNATURE

DATE

DATE

SITE INFORMATION					
CROWN CASTLE USA INC. SITE NAME:	KCYC LEES SUMMIT DT				
SITE ADDRESS:	207 SE DOUGLAS LEE'S SUMMIT, MO 64063				
COUNTY:	JACKSON				
MAP/PARCEL #:	61-340-20-06-00-0-00-000				
AREA OF CONSTRUCTION:	EXISTING				
LATITUDE:	38.913842 / 38° 54' 49.83" N				
LONGITUDE:	-94.376328 / -94° 22' 34.78" W				
LAT/LONG TYPE:	NAD83				
GROUND ELEVATION:	1006.96'				
CURRENT ZONING:	R-7				
JURISDICTION:	MO - CITY OF LEE'S SUMMIT 2015				
OCCUPANCY CLASSIFICATION:	U				
TYPE OF CONSTRUCTION:	IIB				
A.D.A. COMPLIANCE:	FACILITY IS UNMANNED AND NOT FOR HUMAN HABITATION				
PROPERTY OWNER:	CITY OF LEES SUMMIT				
	PO BOX 1600 LEES SUMMIT, MO 64063-7600				
TOWER OWNER:	CROWN CASTLE 2000 CORPORATE DRIVE CANONSBURG, PA 15317				

VERIZON WIRELESS

BEDMINSTER, NJ 07921

EVERGY

AT&T

PROJECT TEAM

1200 MACARTHUR BLVD, SUITE 200

EVE ZWEIG - PROJECT MANAGER

jonathan.macconkey@crowncastle.com"V

JONATHAN MACCONKEY - CONSTRUCTION MANAGER

TRYLON

1825 W. WALNUT HILL

IRVING, TEXAS 75038

eve.zweig@crowncastle.com

MAHWAH, NJ 07430

LANE, SUITE 120

180 WASHINGTON VALLEY ROAD

	SHEET #	SHEET DESCRIPTION
	T-1	TITLE SHEET
ı	T-2	GENERAL NOTES
	C-1.1	OVERALL SITE PLAN
	C-1.2	SITE PLAN
	C-2	SOUTHEAST EXISTING & NEW ELEVATION
l	C-3	ANTENNA PLANS & CABLE SCHEDULE
	C-4	EQUIPMENT & MOUNTING SPECIFICATIONS
	C-5	ANTENNA MOUNT SPECIFICATIONS
	C-6 - C-8	EQUIPMENT SPECIFICATIONS
	C-9	EQUIPMENT ELEVATION VIEWS
	C-10	EQUIPMENT LAYOUT & DETAILS
	E-1	OVERALL CONDUIT LAYOUT
	E-2	EQUIPMENT CONDUIT LAYOUT
	E-3	ELECTRICAL DETAILS
	G-1	GROUNDING PLAN
	G-2	GROUNDING DETAILS
	G-3	GROUNDING DETAILS

DRAWING INDEX

ALL DRAW	INGS CONTAINED HEREIN ARE FORMATTED FOR
22X34. CONT	RACTOR SHALL VERIFY ALL PLANS AND EXISTING
DIMENSION	IS AND CONDITIONS ON THE JOB SITE AND SHALL
IMMEDIAT	ELY NOTIFY THE ENGINEER IN WRITING OF ANY
DISCREPAN	ICIES BEFORE PROCEEDING WITH THE WORK OR
	BE RESPONSIBLE FOR SAME.

PROJECT DESCRIPTION

THE PURPOSE OF THIS PROIECT IS TO ENHANCE BROADBAND CONNECTIVITY AND CAPACITY TO THE EXISTING ELIGIBLE WIRELESS FACILITY.

OWER SCOPE OF WORK: • INSTALL (9) ANTENNAS

- INSTALL (9) RRUS
- INSTALL (2) 6x12 HYBRID CABLES
- INSTALL (1) SITE PRO 1 RMQP-4126-HK PLATFORM MOUNT
- INSTALL (1) OVP • INSTALL (3) DUAL MOUNTS
- ROUND SCOPE OF WORK:
- INSTALL (1) 11'-0"x4'-0" EQUIPMENT PAD
- INSTALL (1) EQUIPMENT PLINTH • INSTALL (1) RF CABINET
- INSTALL (1) BATTERY CABINET • INSTALL (1) RACK MOUNTED OVP
- INSTALL (1) GPS ANTENNA
- INSTALL (1) EQUIPMENT H-FRAME
- INSTALL (1) ILC CABINET
- INSTALL (1) APPLETON PLUG ON NEW ILC CABINET • INSTALL (1) 200A METER SOCKET W/ DISCONNECT
- INSTALL (2) SERVICE LIGHTS

PRIOR TO ACCESSING/ENTERING THE SITE YOU MUST CONTACT THE CROWN NOC AT (800) 788-7011 & CROWN CONSTRUCTION MANAGER

CONTRACTOR PMI REQUIREMENTS

https://pmi.vzwsmart.com PMI ACCESSED AT SMART TOOL VENDOR PROJECT NUMBER

VzW LOCATION CODE (PSLC) 716127

*** PMI AND REQUIREMENTS ALSO EMBEDDED IN MOUNT ANALYSIS REPORT

MOUNT MODIFICATION REQUIRED

VzW APPROVED SMART KIT VENDORS

REFER TO MOUNT MODIFICATION DRAWINGS PAGE FOR VzW SMART KIT APPROVED VENDORS

APPLICABLE CODES/REFERENCE **DOCUMENTS** ALL WORK SHALL BE PERFORMED AND MATERIALS INSTALLED IN ACCORDANCE WITH

LANGSFORD RD, TURN LEFT, ARRIVE AT 207 SE DOUGLAS, LEE'S SUMMIT, MO 64063

DRIVING DIRECTIONS FROM VERIZON LOCAL OFFICE (180 WASHINGTON VALLEY ROAD,

BEDMINSTER, NJ 07921): DEPART AND HEAD TOWARD WASHINGTON VALLEY RD / COUNTY HWY-620, TURN LEFT ONTO WASHINGTON VALLEY RD / COUNTY HWY-620, BEAR RIGHT

TOWARD US-202 S / US-206 S / US HIGHWAY 202 206, TURN LEFT ONTO US-202 S / US-206 S / US HIGHWAY 202 206, KEEP LEFT TO STAY ON I-78 W, KEEP STRAIGHT TO GET ONTO I-81 S, KEEP

LEFT, HEADING TOWARD PITTSBURGH, KEEP LEFT, HEADING TOWARD WHEELING, AT EXIT

5A, HEAD LEFT ON THE RAMP FOR I-470 WEST TOWARD COLUMBUS / OH, KEEP STRAIGHT TO

GET ONTO I-70 W, KEEP RIGHT, HEADING TOWARD SAINT LOUIS, KEEP STRAIGHT, HEADING

TOWARD KANSAS CITY, KEEP RIGHT, HEADING TOWARD KANSAS CITY, TURN RIGHT ONTO E

THE CURRENT EDITIONS OF THE FOLLOWING CODES AS ADOPTED BY THE LOCAL GOVERNING AUTHORITIES. NOTHING IN THESE PLANS IS TO BE CONSTRUED TO PERMIT WORK NOT CONFORMING TO THESE CODES:

2018 IBC BUILDING 2018 IMC MECHANICAL ELECTRICAL 2017 NEC

REFERENCE DOCUMENTS:

STRUCTURAL ANALYSIS: CROWN CASTLE DATED: 01/04/2023

> DATED: 12/22/2022 ORDER ID: 640178 REVISION: 1

> > BEFORE YOU DIG!

CODE TYPE CODE

RFDS REVISION: N/A

CALL MISSOURI ONE CALL CALL 3 WORKING DAYS



CROWN CASTLE USA INC. SITE ACTIVITY REQUIREMENTS:

- 1. NOTICE TO PROCEED— NO WORK SHALL COMMENCE PRIOR TO CROWN CASTLE USA INC. WRITTEN NOTICE TO PROCEED (NTP) AND THE ISSUANCE OF A PURCHASE ORDER. PRIOR TO ACCESSING/ENTERING THE SITE YOU MUST CONTACT THE CROWN CASTLE USA INC. NOC AT 800-788-7011 & THE CROWN CASTLE USA INC. CONSTRUCTION MANAGER.
- 2. "LOOK UP" CROWN CASTLE USA INC. SAFETY CLIMB REQUIREMENT
 - THE INTEGRITY OF THE SAFETY CLIMB AND ALL COMPONENTS OF THE CLIMBING FACILITY SHALL BE CONSIDERED DURING ALL STAGES OF DESIGN, INSTALLATION, AND INSPECTION. TOWER MODIFICATION, MOUNT REINFORCEMENTS, AND/OR EQUIPMENT INSTALLATIONS SHALL NOT COMPROMISE THE INTEGRITY OR FUNCTIONAL USE OF THE SAFETY CLIMB OR ANY COMPONENTS OF THE CLIMBING FACILITY ON THE STRUCTURE. THIS SHALL INCLUDE, BUT NOT BE LIMITED TO: PINCHING OF THE WIRE ROPE, BENDING OF THE WIRE ROPE FROM ITS SUPPORTS, DIRECT CONTACT OR CLOSE PROXIMITY TO THE WIRE ROPE WHICH MAY CAUSE FRICTIONAL WEAR, IMPACT TO THE ANCHORAGE POINTS IN ANY WAY, OR TO IMPEDE/BLOCK ITS INTENDED USE. ANY COMPROMISED SAFETY CLIMB, INCLUDING EXISTING CONDITIONS MUST BE TAGGED OUT AND REPORTED TO YOUR CROWN CASTLE USA INC. POC OR CALL THE NOC TO GENERATE A SAFETY CLIMB MAINTENANCE AND CONTRACTOR NOTICE TICKET.
- PRIOR TO THE START OF CONSTRUCTION, ALL REQUIRED JURISDICTIONAL PERMITS SHALL BE OBTAINED. THIS INCLUDES, BUT IS NOT LIMITED TO, BUILDING, ELECTRICAL, MECHANICAL, FIRE, FLOOD ZONE, ENVIRONMENTAL, AND ZONING. AFTER ONSITE ACTIVITIES AND CONSTRUCTION ARE COMPLETED, ALL REQUIRED PERMITS SHALL BE SATISFIED AND CLOSED OUT ACCORDING TO LOCAL JURISDICTIONAL REQUIREMENTS
- ALL CONSTRUCTION MEANS AND METHODS; INCLUDING BUT NOT LIMITED TO, ERECTION PLANS, RIGGING PLANS, CLIMBING PLANS, AND RESCUE PLANS SHALL BE THE RESPONSIBILITY OF THE GENERAL CONTRACTOR RESPONSIBLE FOR THE EXECUTION OF THE WORK CONTAINED HEREIN, AND SHALL MEET ANSI/ASSE A10.48 (LATEST EDITION); FEDERAL, STATE, AND LOCAL REGULATIONS; AND ANY APPLICABLE INDUSTRY CONSENSUS STANDARDS RELATED TO THE CONSTRUCTION ACTIVITIES BEING PERFORMED. ALL RIGGING PLANS SHALL ADHERE TO ANSI/ASSE A10.48 (LATEST EDITION) AND CROWN CASTLE USA INC. STANDARD CED-STD-10253, INCLUDING THE REQUIRED INVOLVEMENT OF A QUALIFIED ENGINEER FOR CLASS IV CONSTRUCTION, TO CERTIFY THE SUPPORTING STRUCTURE(S) IN ACCORDANCE WITH ANSI/TIA-322 (LATEST EDITION)
- 5. ALL SITE WORK TO COMPLY WITH QAS-STD-10068 "INSTALLATION STANDARDS FOR CONSTRUCTION ACTIVITIES ON CROWN CASTLE USA INC. TOWER SITE," CED-STD-10294 "STANDARD FOR INSTALLATION OF MOUNTS AND APPURTENANCES," AND LATEST VERSION OF ANSI/TIA-1019-A-2012 "STANDARD FOR INSTALLATION, ALTERATION, AND MAINTENANCE OF ANTENNA SUPPORTING STRUCTURES AND ANTENNAS.
- IF THE SPECIFIED EQUIPMENT CAN NOT BE INSTALLED AS SHOWN ON THESE DRAWINGS. THE CONTRACTOR SHALL PROPOSE AN ALTERNATIVE INSTALLATION FOR APPROVAL BY CROWN CASTLE USA INC. PRIOR TO PROCEEDING WITH ANY SUCH CHANGE OF INSTALLATION.
- ALL MATERIALS FURNISHED AND INSTALLED SHALL BE IN STRICT ACCORDANCE WITH ALL APPLICABLE CODES, REGULATIONS AND ORDINANCES. CONTRACTOR SHALL ISSUE ALL APPROPRIATE NOTICES AND COMPLY WITH ALL LAWS, ORDINANCES, RULES, REGULATIONS AND LAWFUL ORDERS OF ANY PUBLIC AUTHORITY REGARDING THE PERFORMANCE OF THE WORK. ALL WORK CARRIED OUT SHALL COMPLY WITH ALL APPLICABLE MUNICIPAL AND UTILITY COMPANY SPECIFICATIONS AND LOCAL JURISDICTIONAL CODES, ORDINANCES AND APPLICABLE REGULATIONS.
- THE CONTRACTOR SHALL INSTALL ALL EQUIPMENT AND MATERIALS IN ACCORDANCE WITH MANUFACTURER'S RECOMMENDATIONS UNLESS SPECIFICALLY STATED OTHERWISE.
- THE CONTRACTOR SHALL CONTACT UTILITY LOCATING SERVICES PRIOR TO THE START OF CONSTRUCTION.
- 10. ALL EXISTING ACTIVE SEWER, WATER, GAS, ELECTRIC AND OTHER UTILITIES WHERE ENCOUNTERED IN THE WORK, SHALL BE PROTECTED AT ALL TIMES AND WHERE REQUIRED FOR THE PROPER EXECUTION OF THE WORK, SHALL BE RELOCATED AS DIRECTED BY CONTRACTOR. EXTREME CAUTION SHOULD BE USED BY THE CONTRACTOR WHEN EXCAVATING OR DRILLING PIERS AROUND OR NEAR UTILITIES. CONTRACTOR SHALL PROVIDE SAFETY TRAINING FOR THE WORKING CREW. THIS WILL INCLUDE BUT NOT BE LIMITED TO A) FALL PROTECTION B) CONFINED SPACE C) ELECTRICAL SAFETY D) TRENCHING AND EXCAVATION E) CONSTRUCTION SAFETY PROCEDURES.
- 11. ALL SITE WORK SHALL BE AS INDICATED ON THE STAMPED CONSTRUCTION DRAWINGS AND PROJECT SPECIFICATIONS, LATEST APPROVED REVISION.
- 12. CONTRACTOR SHALL KEEP THE SITE FREE FROM ACCUMULATING WASTE MATERIAL, DEBRIS, AND TRASH AT THE COMPLETION OF THE WORK. IF NECESSARY, RUBBISH, STUMPS, DEBRIS, STICKS, STONES AND OTHER REFUSE SHALL BE REMOVED FROM THE SITE AND DISPOSED OF LEGALLY.
- 13. ALL EXISTING INACTIVE SEWER, WATER, GAS, ELECTRIC AND OTHER UTILITIES, WHICH INTERFERE WITH THE EXECUTION OF THE WORK, SHALL BE REMOVED AND/OR CAPPED, PLUGGED OR OTHERWISE DISCONTINUED AT POINTS WHICH WILL NOT INTERFERE WITH THE EXECUTION OF THE WORK, SUBJECT TO THE APPROVAL OF CONTRACTOR, TOWER OWNER, CROWN CASTLE USA INC., AND/OR LOCAL UTILITIES
- 14. THE CONTRACTOR SHALL PROVIDE SITE SIGNAGE IN ACCORDANCE WITH THE TECHNICAL SPECIFICATION FOR SITE SIGNAGE REQUIRED BY LOCAL JURISDICTION AND SIGNAGE REQUIRED ON INDIVIDUAL PIECES OF EQUIPMENT, ROOMS, AND SHELTERS.
- 15. THE SITE SHALL BE GRADED TO CAUSE SURFACE WATER TO FLOW AWAY FROM THE CARRIER'S EQUIPMENT AND TOWER AREAS.
- 16. THE SUB GRADE SHALL BE COMPACTED AND BROUGHT TO A SMOOTH UNIFORM GRADE PRIOR TO FINISHED URFACE APPLICATION.
- 17. THE AREAS OF THE OWNERS PROPERTY DISTURBED BY THE WORK AND NOT COVERED BY THE TOWER, EQUIPMENT OR DRIVEWAY, SHALL BE GRADED TO A UNIFORM SLOPE, AND STABILIZED TO PREVENT EROSION AS SPECIFIED ON THE CONSTRUCTION DRAWINGS AND/OR PROJECT SPECIFICATIONS.
- 18. CONTRACTOR SHALL MINIMIZE DISTURBANCE TO EXISTING SITE DURING CONSTRUCTION. EROSION CONTROL MEASURES, IF REQUIRED DURING CONSTRUCTION, SHALL BE IN CONFORMANCE WITH THE LOCAL GUIDELINES FOR EROSION AND SEDIMENT CONTROL.
- 19. THE CONTRACTOR SHALL PROTECT EXISTING IMPROVEMENTS, PAVEMENTS, CURBS, LANDSCAPING AND STRUCTURES. ANY DAMAGED PART SHALL BE REPAIRED AT CONTRACTOR'S EXPENSE TO THE SATISFACTION
- 20. CONTRACTOR SHALL LEGALLY AND PROPERLY DISPOSE OF ALL SCRAP MATERIALS SUCH AS COAXIAL CABLES AND OTHER ITEMS REMOVED FROM THE EXISTING FACILITY. ANTENNAS REMOVED SHALL BE RETURNED TO THE OWNER'S DESIGNATED LOCATION.
- 21. CONTRACTOR SHALL LEAVE PREMISES IN CLEAN CONDITION. TRASH AND DEBRIS SHOULD BE REMOVED FROM SITE ON A DAILY BASIS.
- 22. NO FILL OR EMBANKMENT MATERIAL SHALL BE PLACED ON FROZEN GROUND. FROZEN MATERIALS, SNOW OR ICE SHALL NOT BE PLACED IN ANY FILL OR EMBANKMENT.

GENERAL NOTES:

- FOR THE PURPOSE OF CONSTRUCTION DRAWING, THE FOLLOWING DEFINITIONS SHALL APPLY: GENERAL CONTRACTOR RESPONSIBLE FOR CONSTRUCTION CONTRACTOR:
- CARRIER: VERIZON TOWER OWNER: CROWN CASTLE USA INC.
- 2. THESE DRAWINGS HAVE BEEN PREPARED USING STANDARDS OF PROFESSIONAL CARE AND COMPLETENESS NORMALLY EXERCISED UNDER SIMILAR CIRCUMSTANCES BY REPUTABLE ENGINEERS IN THIS OR SIMILAR LOCALITIES. IT IS ASSUMED THAT THE WORK DEPICTED WILL BE PERFORMED BY AN EXPERIENCED CONTRACTOR AND/OR WORKPEOPLE WHO HAVE A WORKING KNOWLEDGE OF THE APPLICABLE CODE STANDARDS AND REQUIREMENTS AND OF INDUSTRY ACCEPTED STANDARD GOOD PRACTICE. AS NOT EVERY CONDITION OR ELEMENT IS (OR CAN BE) EXPLICITLY SHOWN ON THESE DRAWINGS, THE CONTRACTOR SHALL USE INDUSTRY ACCEPTED STANDARD GOOD PRACTICE FOR MISCELLANEOUS WORK NOT EXPLICITLY SHOWN.
- THESE DRAWINGS REPRESENT THE FINISHED STRUCTURE. THEY DO NOT INDICATE THE MEANS OR METHODS OF CONSTRUCTION. THE CONTRACTOR SHALL BE SOLELY RESPONSIBLE FOR THE CONSTRUCTION MEANS, METHODS TECHNIQUES, SEQUENCES, AND PROCEDURES. THE CONTRACTOR SHALL PROVIDE ALL MEASURES NECESSARY FOR PROTECTION OF LIFE AND PROPERTY DURING CONSTRUCTION. SUCH MEASURES SHALL INCLUDE, BUT NOT BE LIMITED TO, BRACING, FORMWORK, SHORING, ETC. SITE VISITS BY THE ENGINEER OR HIS REPRESENTATIVE WILL NOT INCLUDE INSPECTION OF THESE ITEMS AND IS FOR STRUCTURAL OBSERVATION OF THE FINISHED STRUCTURE ONLY.
- NOTES AND DETAILS IN THE CONSTRUCTION DRAWINGS SHALL TAKE PRECEDENCE OVER GENERAL NOTES AND TYPICAL DETAILS. WHERE NO DETAILS ARE SHOWN, CONSTRUCTION SHALL CONFORM TO SIMILAR WORK ON THE PROJECT, AND/OR AS PROVIDED FOR IN THE CONTRACT DOCUMENTS. WHERE DISCREPANCIES OCCUR BETWEEN PLANS, DETAILS, GENERAL NOTES, AND SPECIFICATIONS, THE GREATER, MORE STRICT REQUIREMENTS, SHALL GOVERN. IF FURTHER CLARIFICATION IS REQUIRED CONTACT THE ENGINEER OF RECORD.
- SUBSTANTIAL EFFORT HAS BEEN MADE TO PROVIDE ACCURATE DIMENSIONS AND MEASUREMENTS ON THE DRAWINGS TO ASSIST IN THE FABRICATION AND/OR PLACEMENT OF CONSTRUCTION ELEMENTS BUT IT IS THE SOLE RESPONSIBILITY OF THE CONTRACTOR TO FIELD VERIFY THE DIMENSIONS, MEASUREMENTS, AND/OR CLEARANCES SHOWN IN THE CONSTRUCTION DRAWINGS PRIOR TO FABRICATION OR CUTTING OF ANY NEW OR EXISTING CONSTRUCTION ELEMENTS. IF IT IS DETERMINED THAT THERE ARE DISCREPANCIES AND/OR CONFLICTS WITH THE CONSTRUCTION DRAWINGS THE ENGINEER OF RECORD IS TO BE NOTIFIED AS SOON AS POSSIBLE.
- PRIOR TO THE SUBMISSION OF BIDS, THE BIDDING CONTRACTOR SHALL VISIT THE CELL SITE TO FAMILIARIZE WITH THE EXISTING CONDITIONS AND TO CONFIRM THAT THE WORK CAN BE ACCOMPLISHED AS SHOWN ON THE CONSTRUCTION DRAWINGS. ANY DISCREPANCY FOUND SHALL BE BROUGHT TO THE ATTENTION OF CROWN CASTLE
- 7. ALL MATERIALS FURNISHED AND INSTALLED SHALL BE IN STRICT ACCORDANCE WITH ALL APPLICABLE CODES, REGULATIONS AND ORDINANCES. CONTRACTOR SHALL ISSUE ALL APPROPRIATE NOTICES AND COMPLY WITH ALL LAWS, ORDINANCES, RULES, REGULATIONS AND LAWFUL ORDERS OF ANY PUBLIC AUTHORITY REGARDING THE PERFORMANCE OF THE WORK. ALL WORK CARRIED OUT SHALL COMPLY WITH ALL APPLICABLE MUNICIPAL AND UTILITY COMPANY SPECIFICATIONS AND LOCAL JURISDICTIONAL CODES, ORDINANCES AND APPLICABLE REGULATIONS.
- UNLESS NOTED OTHERWISE, THE WORK SHALL INCLUDE FURNISHING MATERIALS, EQUIPMENT, APPURTENANCES AND LABOR NECESSARY TO COMPLETE ALL INSTALLATIONS AS INDICATED ON THE DRAWINGS.
- 9. THE CONTRACTOR SHALL INSTALL ALL EQUIPMENT AND MATERIALS IN ACCORDANCE WITH MANUFACTURER'S RECOMMENDATIONS UNLESS SPECIFICALLY STATED OTHERWISE.
- 10. IF THE SPECIFIED EQUIPMENT CAN NOT BE INSTALLED AS SHOWN ON THESE DRAWINGS, THE CONTRACTOR SHALL PROPOSE AN ALTERNATIVE INSTALLATION FOR APPROVAL BY THE CARRIER AND CROWN CASTLE PRIOR TO PROCEEDING
- WITH ANY SUCH CHANGE OF INSTALLATION. 11. CONTRACTOR IS TO PERFORM A SITE INVESTIGATION AND IS TO DETERMINE THE BEST ROUTING OF ALL CONDUITS FOR POWER, AND TELCO AND FOR GROUNDING CABLES AS SHOWN IN THE POWER, TELCO, AND GROUNDING PLAN
- DRAWINGS 12. THE CONTRACTOR SHALL PROTECT EXISTING IMPROVEMENTS, PAVEMENTS, CURBS, LANDSCAPING AND STRUCTURES. ANY DAMAGED PART SHALL BE REPAIRED AT CONTRACTOR'S EXPENSE TO THE SATISFACTION OF CROWN CASTLE USA INC.
- 13. CONTRACTOR SHALL LEGALLY AND PROPERLY DISPOSE OF ALL SCRAP MATERIALS SUCH AS COAXIAL CABLES AND OTHER ITEMS REMOVED FROM THE EXISTING FACILITY. ANTENNAS REMOVED SHALL BE RETURNED TO THE OWNER'S DESIGNATED LOCATION.
- 14. CONTRACTOR SHALL LEAVE PREMISES IN CLEAN CONDITION. TRASH AND DEBRIS SHOULD BE REMOVED FROM SITE ON A DAILY BASIS.

CONCRETE, FOUNDATIONS, AND REINFORCING STEEL:

- ALL CONCRETE WORK SHALL BE IN ACCORDANCE WITH THE ACI 301, ACI 318, ACI 336, ASTM A184, ASTM A185 AND THE DESIGN AND CONSTRUCTION SPECIFICATION FOR CAST-IN-PLACE CONCRETE. 2. UNLESS NOTED OTHERWISE, SOIL BEARING PRESSURE USED FOR DESIGN OF SLABS AND FOUNDATIONS IS ASSUMED
- TO BE 1000 psf 3. ALL CONCRETE SHALL HAVE A MINIMUM COMPRESSIVE STRENGTH (f'c) OF 3000 psi AT 28 DAYS, UNLESS NOTED OTHERWISE. NO MORE THAN 90 MINUTES SHALL ELAPSE FROM BATCH TIME TO TIME OF PLACEMENT UNLESS APPROVED BY THE ENGINEER OF RECORD. TEMPERATURE OF CONCRETE SHALL NOT EXCEED 90°f AT TIME OF
- PLACEMENT CONCRETE EXPOSED TO FREEZE—THAW CYCLES SHALL CONTAIN AIR ENTRAINING ADMIXTURES. AMOUNT OF AIR ENTRAINMENT TO BE BASED ON SIZE OF AGGREGATE AND F3 CLASS EXPOSURE (VERY SEVERE). CEMENT USED TO BE
- TYPE II PORTLAND CEMENT WITH A MAXIMUM WATER-TO-CEMENT RATIO (W/C) OF 0.45. ALL STEEL REINFORCING SHALL CONFORM TO ASTM A615. ALL WELDED WIRE FABRIC (WWF) SHALL CONFORM TO ASTM A185. ALL SPLICES SHALL BE CLASS "B" TENSION SPLICES, UNLESS NOTED OTHERWISE. ALL HOOKS SHALL BE STANDARD 90 DEGREE HOOKS, UNLESS NOTED OTHERWISE. YIELD STRENGTH (Fy) OF STANDARD DEFORMED BARS ARE
- AS FOLLOWS: #4 BARS AND SMALLER.. 40 ksi #5 BARS AND LARGER.. .60 ksi THE FOLLOWING MINIMUM CONCRETE COVER SHALL BE PROVIDED FOR REINFORCING STEEL UNLESS SHOWN OTHERWISE
- CONCRETE CAST AGAINST AND PERMANENTLY EXPOSED TO EARTH ... CONCRETE EXPOSED TO EARTH OR WEATHER: #6 BARS AND LARGER... #5 BARS AND SMALLER ...
- CONCRETE NOT EXPOSED TO EARTH OR WEATHER: SLAB AND WALLS...
- BEAMS AND COLUMNS .. .1-1/2" 7. A TOOLED EDGE OR A 3/4" CHAMFER SHALL BE PROVIDED AT ALL EXPOSED EDGES OF CONCRETE, UNLESS NOTED OTHERWISE, IN ACCORDANCE WITH ACI 301 SECTION 4.2.4.

GREENFIELD GROUNDING NOTES:

- ALL GROUND ELECTRODE SYSTEMS (INCLUDING TELECOMMUNICATION, RADIO, LIGHTNING PROTECTION AND AC POWER GES'S) SHALL BE BONDED TOGETHER AT OR BELOW GRADE, BY TWO OR MORE COPPER BONDING CONDUCTORS IN ACCORDANCE WITH THE NEC.
- THE CONTRACTOR SHALL PERFORM IEEE FALL—OF—POTENTAL RESISTANCE TO EARTH TESTING (PER IEEE 1100 AND 81) FOR GROUND ELECTRODE SYSTEMS, THE CONTRACTOR SHALL FURNISH AND INSTALL SUPPLEMENTAL GROUND ELECTRODES AS NEEDED TO ACHIEVE A TEST RESULT OF 5 OHMS OR LESS.

ON DRAWINGS:

- THE CONTRACTOR IS RESPONSIBLE FOR PROPERLY SEQUENCING GROUNDING AND UNDERGROUND CONDUIT INSTALLATION AS TO PREVENT ANY LOSS OF CONTINUITY IN THE GROUNDING SYSTEM OR DAMAGE TO THE CONDUIT AND PROVIDE
- 4. METAL CONDUIT AND TRAY SHALL BE GROUNDED AND MADE ELECTRICALLY CONTINUOUS WITH LISTED BONDING FITTINGS OR BY BONDING ACROSS THE DISCONTINUITY WITH #6 COPPER WIRE UL APPROVED GROUNDING TYPE CONDUIT CLAMPS
- METAL RACEWAY SHALL NOT BE USED AS THE NEC REQUIRED EQUIPMENT GROUND CONDUCTOR. STRANDED COPPER CONDUCTORS WITH GREEN INSULATION, SIZED IN ACCORDANCE WITH THE NEC, SHALL BE FURNISHED AND INSTALLED WITH THE POWER CIRCUITS TO BTS EQUIPMENT.
- EACH CABINET FRAME SHALL BE DIRECTLY CONNECTED TO THE MASTER GROUND BAR WITH GREEN INSULATED SUPPLEMENTAL EQUIPMENT GROUND WIRES, #6 STRANDED COPPER OR LARGER FOR INDOOR BTS; #2 BARE SOLID TINNED COPPER FOR OUTDOOR BTS.
- CONNECTIONS TO THE GROUND BUS SHALL NOT BE DOUBLED UP OR STACKED BACK TO BACK CONNECTIONS ON OPPOSITE SIDE OF THE GROUND BUS ARE PERMITTED.
- ALL EXTERIOR GROUND CONDUCTORS BETWEEN EQUIPMENT/GROUND BARS AND THE GROUND RING SHALL BE #2 SOLID TINNED COPPER UNLESS OTHERWISE INDICATED. ALUMINUM CONDUCTOR OR COPPER CLAD STEEL CONDUCTOR SHALL NOT BE USED FOR GROUNDING CONNECTIONS.
- 10. USE OF 90° BENDS IN THE PROTECTION GROUNDING CONDUCTORS SHALL BE AVOIDED WHEN 45° BENDS CAN BE ADEQUATELY SUPPORTED. 11. EXOTHERMIC WELDS SHALL BE USED FOR ALL GROUNDING CONNECTIONS BELOW GRADE.
- 12. ALL GROUND CONNECTIONS ABOVE GRADE (INTERIOR AND EXTERIOR) SHALL BE FORMED USING HIGH PRESS CRIMPS. 13. COMPRESSION GROUND CONNECTIONS MAY BE REPLACED BY EXOTHERMIC WELD CONNECTIONS.
- 14. ICE BRIDGE BONDING CONDUCTORS SHALL BE EXOTHERMICALLY BONDED OR BOLTED TO THE BRIDGE AND THE TOWER GROUND BAR.
- 15. APPROVED ANTIOXIDANT COATINGS (i.e. CONDUCTIVE GEL OR PASTE) SHALL BE USED ON ALL COMPRESSION AND BOLTED GROUND CONNECTIONS. 16. ALL EXTERIOR GROUND CONNECTIONS SHALL BE COATED WITH A CORROSION RESISTANT MATERIAL.
- 17. MISCELLANEOUS ELECTRICAL AND NON-ELECTRICAL METAL BOXES, FRAMES AND SUPPORTS SHALL BE BONDED TO THE GROUND RING, IN ACCORDANCE WITH THE NEC.
- 18. BOND ALL METALLIC OBJECTS WITHIN 6 ft OF MAIN GROUND RING WITH (1) #2 BARE SOLID TINNED COPPER GROUND CONDUCTOR.
- 19. GROUND CONDUCTORS USED FOR THE FACILITY GROUNDING AND LIGHTNING PROTECTION SYSTEMS SHALL NOT BE ROUTED THROUGH METALLIC OBJECTS THAT FORM A RING AROUND THE CONDUCTOR, SUCH AS METALLIC CONDUITS, METAL SUPPORT CLIPS OR SLEEVES THROUGH WALLS OR FLOORS. WHEN IT IS REQUIRED TO BE HOUSED IN CONDUIT TO MEET CODE REQUIREMENTS OR LOCAL CONDITIONS, NON-METALLIC MATERIAL SUCH AS PVC CONDUIT SHALL BE USED. WHERE USE OF METAL CONDUIT IS UNAVOIDABLE (i.e., NONMETALLIC CONDUIT PROHIBITED BY LOCAL CODE) THE GROUND CONDUCTOR SHALL BE BONDED TO EACH END OF THE METAL CONDUIT.
- 20. ALL GROUNDS THAT TRANSITION FROM BELOW GRADE TO ABOVE GRADE MUST BE #2 BARE SOLID TINNED COPPER IN 3/4" NON-METALLIC, FLEXIBLE CONDUIT FROM 24" BELOW GRADE TO WITHIN 3" TO 6" OF CAD-WELD TERMINATION POINT. THE EXPOSED END OF THE CONDUIT MUST BE SEALED WITH SILICONE CAULK. (ADD TRANSITIONING GROUND STANDARD DETAIL AS WELL).
- 21. BUILDINGS WHERE THE MAIN GROUNDING CONDUCTORS ARE REQUIRED TO BE ROUTED TO GRADE, THE CONTRACTOR SHALL ROUTE TWO GROUNDING CONDUCTORS FROM THE ROOFTOP, TOWERS, AND WATER TOWERS GROUNDING RING, TO THE EXISTING GROUNDING SYSTEM, THE GROUNDING CONDUCTORS SHALL NOT BE SMALLER THAN 2/0 COPPER. ROOFTOP GROUNDING RING SHALL BE BONDED TO THE EXISTING GROUNDING SYSTEM, THE BUILDING STEEL COLUMNS, LIGHTNING PROTECTION SYSTEM, AND BUILDING MAIN WATER LINE (FERROUS OR NONFERROUS METAL PIPING ONLY).

ELECTRICAL INSTALLATION NOTES:

- ALL ELECTRICAL WORK SHALL BE PERFORMED IN ACCORDANCE WITH THE PROJECT SPECIFICATIONS, NEC AND ALL APPLICABLE
- FEDERAL, STATE, AND LOCAL CODES/ORDINANCES. CONDUIT ROUTINGS ARE SCHEMATIC. CONTRACTOR SHALL INSTALL CONDUITS SO THAT ACCESS TO EQUIPMENT IS NOT BLOCKED
- AND TRIP HAZARDS ARE ELIMINATED.
- 3. WIRING, RACEWAY AND SUPPORT METHODS AND MATERIALS SHALL COMPLY WITH THE REQUIREMENTS OF THE NEC. 4. ALL CIRCUITS SHALL BE SEGREGATED AND MAINTAIN MINIMUM CABLE SEPARATION AS REQUIRED BY THE NEC.
- 4.1. ALL EQUIPMENT SHALL BEAR THE UNDERWRITERS LABORATORIES LABEL OF APPROVAL, AND SHALL CONFORM TO REQUIREMENT OF THE NATIONAL ELECTRICAL CODE.
- ALL OVERCURRENT DEVICES SHALL HAVE AN INTERRUPTING CURRENT RATING THAT SHALL BE GREATER THAN THE SHORT CIRCUIT CURRENT TO WHICH THEY ARE SUBJECTED, 22,000 AIC MINIMUM. VERYIFY AVAILABLE SHORT CIRCUIT CURRENT DOES NOT EXCEED THE RATING OF ELECTRICAL EQUIPMENT IN ACCORDANCE WITH ARTICLE 110.24 NEC OR THE MOST CURRENT ADOPTED CODE PRE THE GOVERNING JURISDICTION.
- 5. EACH END OF EVERY POWER PHASE CONDUCTOR, GROUNDING CONDUCTOR, AND TELCO CONDUCTOR OR CABLE SHALL BE LABELED WITH COLOR-CODED INSULATION OR ELECTRICAL TAPE (3M BRAND, 1/2" PLASTIC ELECTRICAL TAPE WITH UV PROTECTION, OR EQUAL). THE IDENTIFICATION METHOD SHALL CONFORM WITH NEC AND OSHA.
- ALL ELECTRICAL COMPONENTS SHALL BE CLEARLY LABELED WITH LAMICOID TAGS SHOWING THEIR RATED VOLTAGE, PHASE CONFIGURATION, WIRE CONFIGURATION, POWER OR AMPACITY RATING AND BRANCH CIRCUIT ID NUMBERS (i.e. PANEL BOARD AND CIRCUIT ID'S).
- PANEL BOARDS (ID NUMBERS) SHALL BE CLEARLY LABELED WITH PLASTIC LABELS
- 8. ALL TIE WRAPS SHALL BE CUT FLUSH WITH APPROVED CUTTING TOOL TO REMOVE SHARP EDGES ALL POWER AND EQUIPMENT GROUND WIRING IN TUBING OR CONDUIT SHALL BE SINGLE COPPER CONDUCTOR (#14 OR LARGER)
- WITH TYPE THHW, THWN, THWN-2, XHHW, XHHW-2, THW, THW-2, RHW, OR RHW-2 INSULATION UNLESS OTHERWISE SPECIFIED. 10. SUPPLEMENTAL EQUIPMENT GROUND WIRING LOCATED INDOORS SHALL BE SINGLE COPPER CONDUCTOR (#6 OR LARGER) WITH
- TYPE THHW, THWN, THWN-2, XHHW, XHHW-2, THW, THW-2, RHW, OR RHW-2 INSULATION UNLESS OTHERWISE SPECIFIED. 11. POWER AND CONTROL WIRING IN FLEXIBLE CORD SHALL BE MULTI-CONDUCTOR, TYPE SOOW CORD (#14 OR LARGER) UNLESS
- OTHERWISE SPECIFIED. 12. POWER AND CONTROL WIRING FOR USE IN CABLE TRAY SHALL BE MULTI-CONDUCTOR, TYPE TO CABLE (#14 OR LARGER), WITH
- TYPE THHW, THWN, THWN-2, XHHW, XHHW-2, THW, THW-2, RHW, OR RHW-2 INSULATION UNLESS OTHERWISE SPECIFIED. 13. ALL POWER AND GROUNDING CONNECTIONS SHALL BE CRIMP-STYLE, COMPRESSION WIRE LUGS AND WIRE NUTS BY THOMAS AND
- BETTS (OR EQUAL). LUGS AND WIRE NUTS SHALL BE RATED FOR OPERATION NOT LESS THAN 75°C (90°C IF AVAILABLE). 14. RACEWAY AND CABLE TRAY SHALL BE LISTED OR LABELED FOR ELECTRICAL USE IN ACCORDANCE WITH NEMA, UL, ANSI/IEEE
- 15. ELECTRICAL METALLIC TUBING (EMT), INTERMEDIATE METAL CONDUIT (IMC), OR RIGID METAL CONDUIT (RMC) SHALL BE USED FOR
- EXPOSED INDOOR LOCATIONS 16. ELECTRICAL METALLIC TUBING (EMT) OR METAL—CLAD CABLE (MC) SHALL BE USED FOR CONCEALED INDOOR LOCATIONS.
- 17. SCHEDULE 40 PVC UNDERGROUND ON STRAIGHTS AND SCHEDULE 80 PVC FOR ALL ELBOWS/90s AND ALL APPROVED ABOVE GRADE PVC CONDUIT
- 18. LIQUID-TIGHT FLEXIBLE METALLIC CONDUIT (LIQUID-TITE FLEX) SHALL BE USED INDOORS AND OUTDOORS, WHERE VIBRATION OCCURS OR FLEXIBILITY IS NEEDED.
- 19. CONDUIT AND TUBING FITTINGS SHALL BE THREADED OR COMPRESSION-TYPE AND APPROVED FOR THE LOCATION USED. SET
- SCREW FITTINGS ARE NOT ACCEPTABLE. 20. CABINETS, BOXES AND WIRE WAYS SHALL BE LABELED FOR ELECTRICAL USE IN ACCORDANCE WITH NEMA, UL, ANSI/IEEE AND
- 21. WIREWAYS SHALL BE METAL WITH AN ENAMEL FINISH AND INCLUDE A HINGED COVER, DESIGNED TO SWING OPEN DOWNWARDS
- (WIREMOLD SPECMATE WIREWAY). 22. SLOTTED WIRING DUCT SHALL BE PVC AND INCLUDE COVER (PANDUIT TYPE E OR EQUAL).
- 23. CONDUITS SHALL BE FASTENED SECURELY IN PLACE WITH APPROVED NON-PERFORATED STRAPS AND HANGERS. EXPLOSIVE
- DEVICES (i.e. POWDER-ACTUATED) FOR ATTACHING HANGERS TO STRUCTURE WILL NOT BE PERMITTED. CLOSELY FOLLOW THE LINES OF THE STRUCTURE, MAINTAIN CLOSE PROXIMITY TO THE STRUCTURE AND KEEP CONDUITS IN TIGHT ENVELOPES. CHANGES IN DIRECTION TO ROUTE AROUND OBSTACLES SHALL BE MADE WITH CONDUIT OUTLET BODIES. CONDUIT SHALL BE INSTALLED IN A NEAT AND WORKMANLIKE MANNER. PARALLEL AND PERPENDICULAR TO STRUCTURE WALL AND CEILING LINES. ALL CONDUIT SHALL BE FISHED TO CLEAR OBSTRUCTIONS. ENDS OF CONDUITS SHALL BE TEMPORARILY CAPPED FLUSH TO FINISH GRADE TO PREVENT CONCRETE, PLASTER OR DIRT FROM ENTERING. CONDUITS SHALL BE RIGIDLY CLAMPED TO BOXES BY GALVANIZED
- MALLEABLE IRON BUSHING ON INSIDE AND GALVANIZED MALLEABLE IRON LOCKNUT ON OUTSIDE AND INSIDE 24. EQUIPMENT CABINETS, TERMINAL BOXES, JUNCTION BOXES AND PULL BOXES SHALL BE GALVANIZED OR EPOXY-COATED SHEET STEEL. SHALL MEET OR EXCEED UL 50 AND BE RATED NEMA 1 (OR BETTER) FOR INTERIOR LOCATIONS AND NEMA 3R (OR
- BETTER) FOR EXTERIOR LOCATIONS. 25. METAL RECEPTACLE, SWITCH AND DEVICE BOXES SHALL BE GALVANIZED, EPOXY—COATED OR NON—CORRODING; SHALL MEET OR EXCEED UL 514A AND NEMA OS 1 AND BE RATED NEMA 1 (OR BETTER) FOR INTERIOR LOCATIONS AND WEATHER PROTECTED (WP OR BETTER) FOR EXTERIOR LOCATIONS.
- 26. NONMETALLIC RECEPTACLE, SWITCH AND DEVICE BOXES SHALL MEET OR EXCEED NEMA OS 2 (NEWEST REVISION) AND BE RATED NEMA 1 (OR BETTER) FOR INTERIOR LOCATIONS AND WEATHER PROTECTED (WP OR BETTER) FOR EXTERIOR LOCATIONS.
- 27. THE CONTRACTOR SHALL NOTIFY AND OBTAIN NECESSARY AUTHORIZATION FROM THE CARRIER AND/OR CROWN CASTLE USA INC. BEFORE COMMENCING WORK ON THE AC POWER DISTRIBUTION PANELS.
- 28. THE CONTRACTOR SHALL PROVIDE NECESSARY TAGGING ON THE BREAKERS, CABLES AND DISTRIBUTION PANELS IN ACCORDANCE WITH THE APPLICABLE CODES AND STANDARDS TO SAFEGUARD LIFE AND PROPERTY. 29. INSTALL LAMICOID LABEL ON THE METER CENTER TO SHOW "VERIZON".
- 30. ALL EMPTY/SPARE CONDUITS THAT ARE INSTALLED ARE TO HAVE A METERED MULE TAPE PULL CORD INSTALLED.

CONDUCTOR COLOR CODE						
SYSTEM	CONDUCTOR	COLOR				
	A PHASE	BLACK				
 120/240V, 1Ø	B PHASE	RED				
120/2400, 10	NEUTRAL	WHITE				
	GROUND	GREEN				
	A PHASE	BLACK				
	B PHASE	RED				
120/208V, 3Ø	C PHASE	BLUE				
	NEUTRAL	WHITE				
	GROUND	GREEN				
	A PHASE	BROWN				
	B PHASE	ORANGE OR PURPLE				
277/480V, 3Ø	C PHASE	YELLOW				
	NEUTRAL	GREY				
	GROUND	GREEN				

* SEE NEC 210.5(C)(1) AND (2)

** POLARITY MARKED AT TERMINATION

POS (+)

NEG(-)

RED**

BLACK**

ABBREVIATIONS:

DC VOLTAGE

- ANTENNA EXISTING FACILITY INTERFACE FRAME
- GEN GENERATOR GPS GLOBAL POSITIONING SYSTEM GSM GLOBAL SYSTEM FOR MOBILE
- LTE LONG TERM EVOLUTION MGB MASTER GROUND BAR MW MICROWAVE
- NATIONAL ELECTRIC CODE NEC PROPOSED POWER PLANT
- QTY QUANTITY RECT RECTIFIER RADIO BASE STATION RBS RET REMOTE ELECTRIC TILT
- RFDS RADIO FREQUENCY DATA SHEET REMOTE RADIO HEAD RRU
- REMOTE RADIO UNIT SIAD SMART INTEGRATED DEVICE TMA TOWER MOUNTED AMPLIFIER
- TYP TYPICAL UMTS UNIVERSAL MOBILE TELECOMMUNICATIONS SYSTEM W.P. WORK POINT

APWA UNIFORM COLOR CODE:

PROPOSED EXCAVATION EMPORARY SURVEY MARKINGS

LECTRIC POWER LINES. CABLES. CONDUIT, AND LIGHTING CABLES GAS, OIL, STEAM, PETROLEUM, OR

GASEOUS MATERIALS COMMUNICATION, ALARM OR SIGNAL LINES, CABLES, OR CONDUIT AND TRAFFIC LOOPS

POTABLE WATER ECLAIMED WATER, IRRIGATION, AND SLURRY LINES

SEWERS AND DRAIN LINES

RELEASED FOR CONSTRUCTION

Development Services Department Lee's Summit, Missouri 11/10/2023

As Noted on Plan Review

JURISDICTIONAL APPROVAL:



BEDMINSTER, NJ 07921



MAHWAH, NJ 07430



VERIZON SITE NUMBER: 716127

1825 W. WALNUT HILL LANE, SUITE 120

IRVING, TEXAS 75038


BU #: **877803** KCYC LEES SUMMIT DT 207 SE DOUGLAS LEE'S SUMMIT, MO 64063 EXISTING 180'-0" MONOPOLE

\bigcap	ISSUED FOR:						
REV	DATE	DRWN	DESCRIPTION	DES./Q			
Α	02/14/2023	RC	PRELIMINARY	AMT			
В	02/17/2023	RC	PRELIMINARY	AMT			
0	03/17/2023	RC	FINAL	EAN			
1	06/21/2023	RC	FINAL	EAN			
2	07/27/2023	RC	FINAL	АМТ			



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SHEET NUMBER:



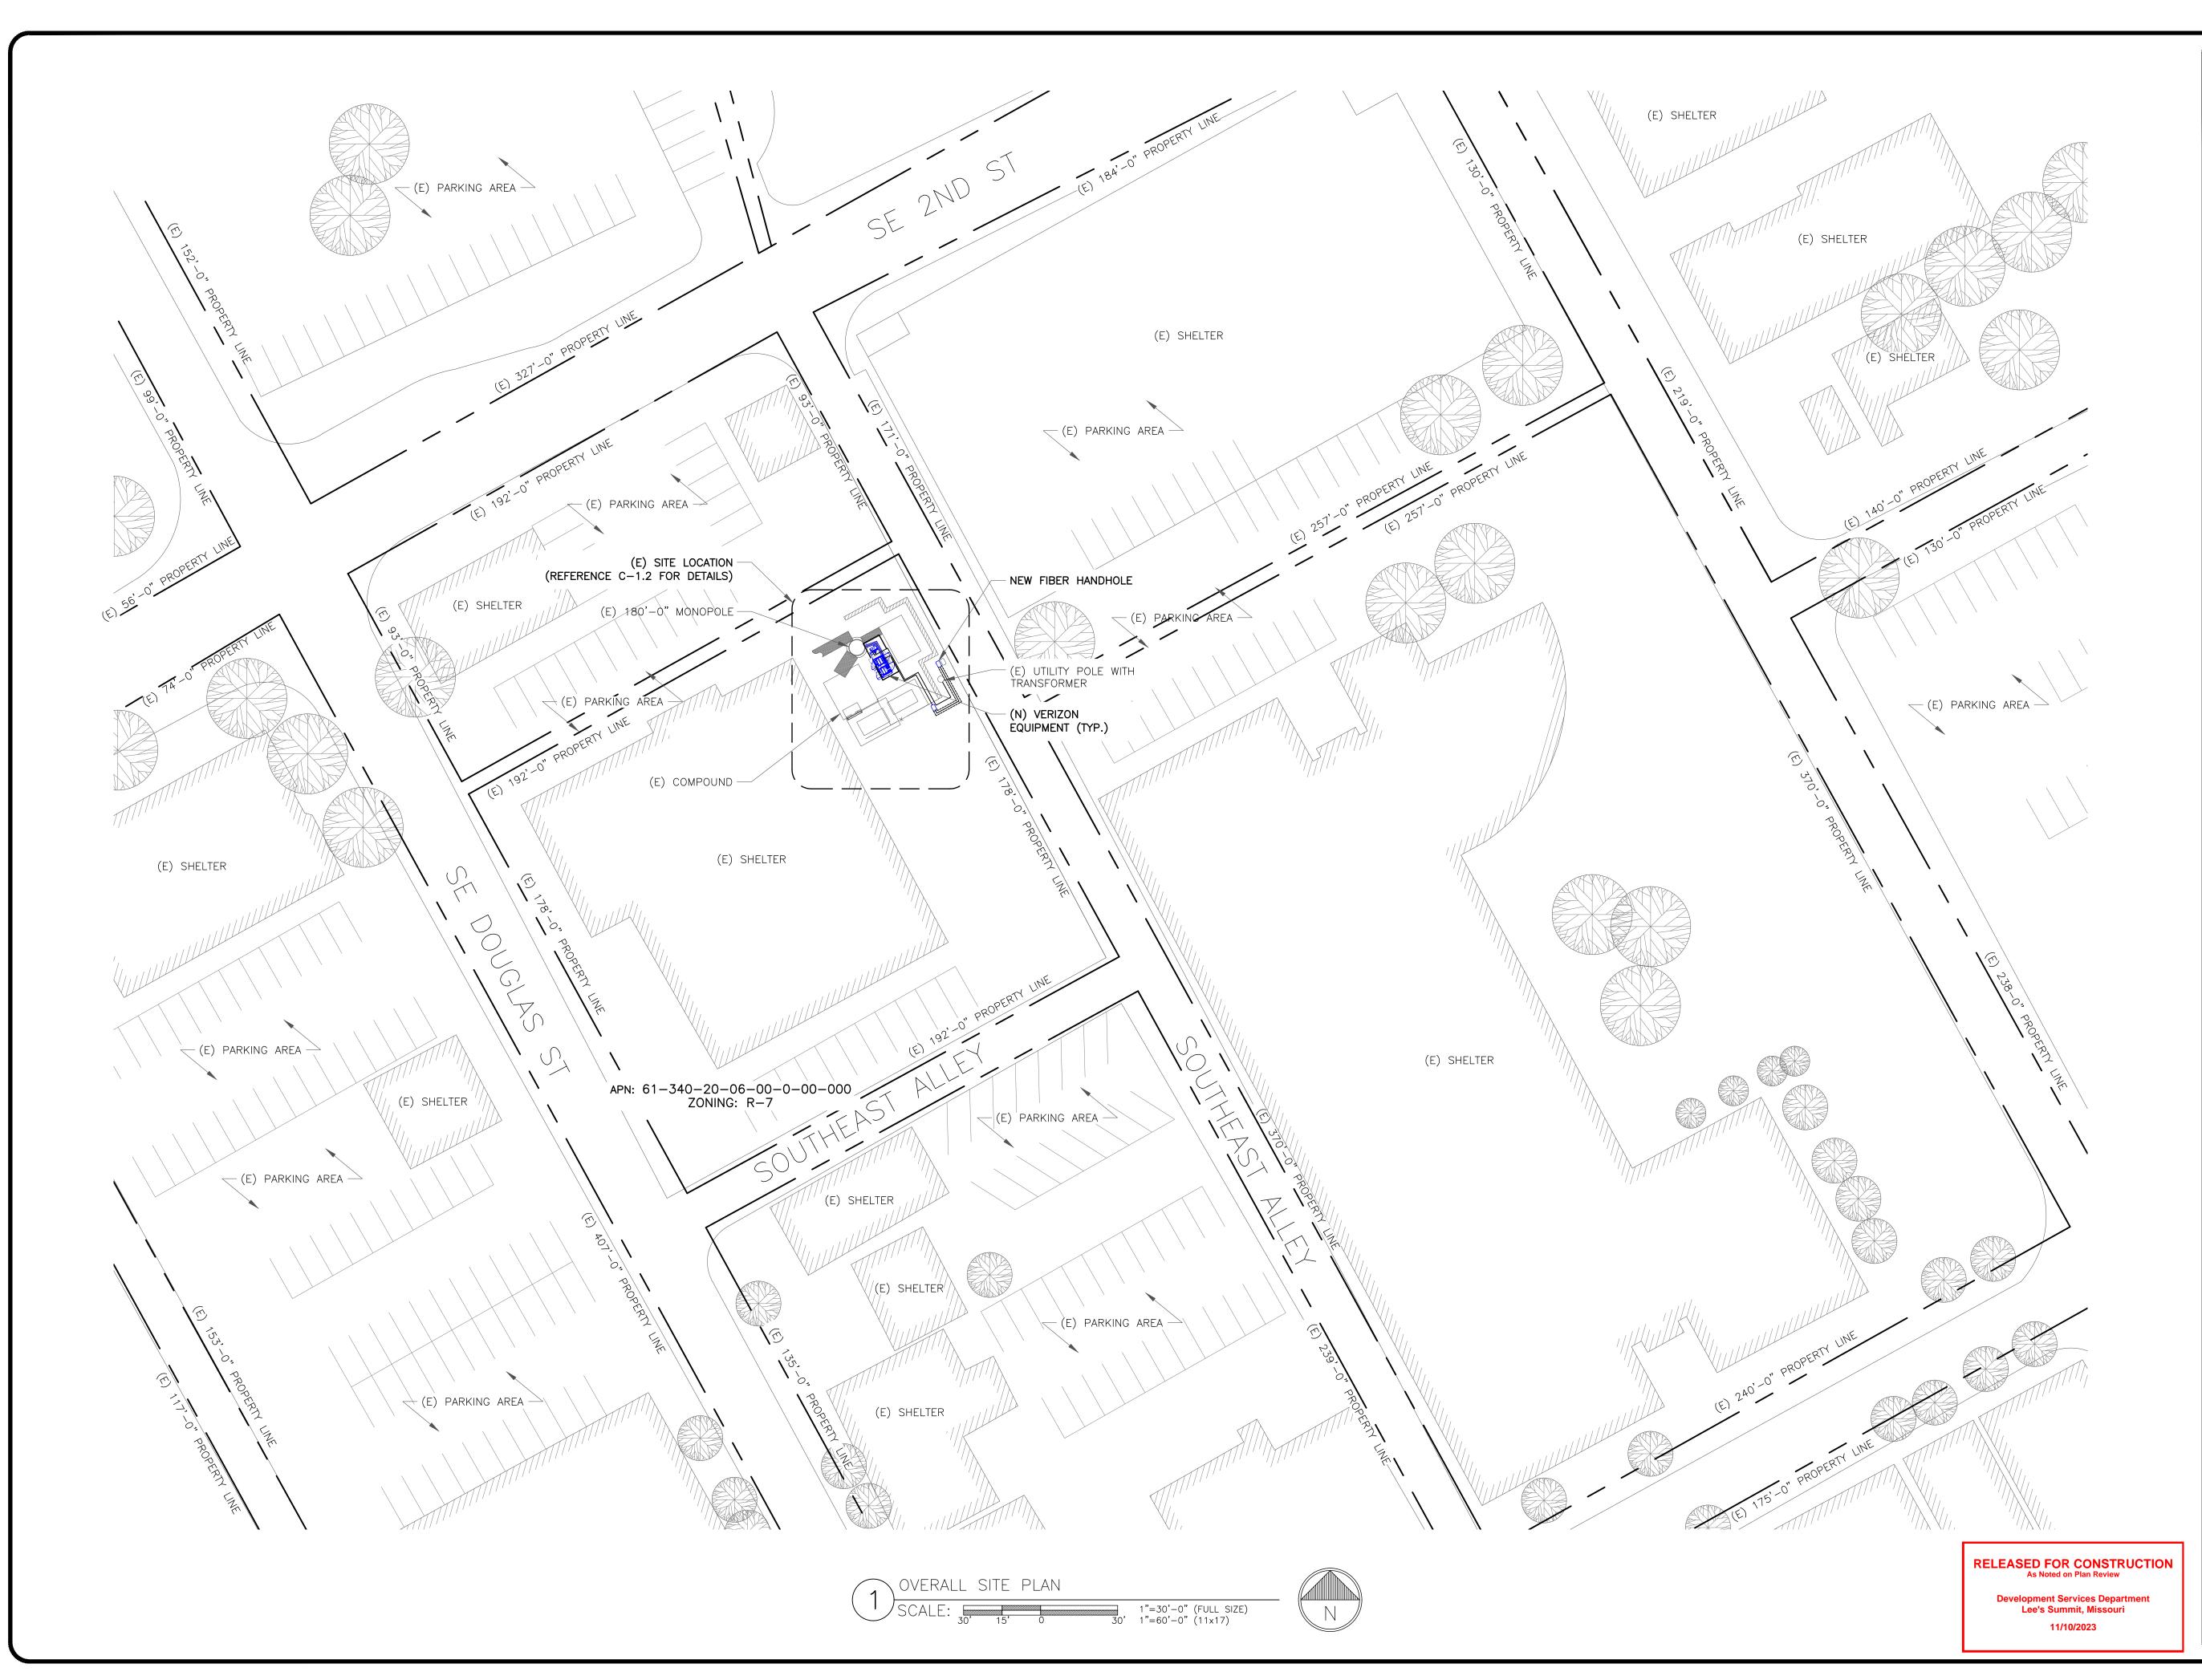



MAHWAH, NJ 07430



IRVING, TEXAS 75038

VERIZON SITE NUMBER: 716127


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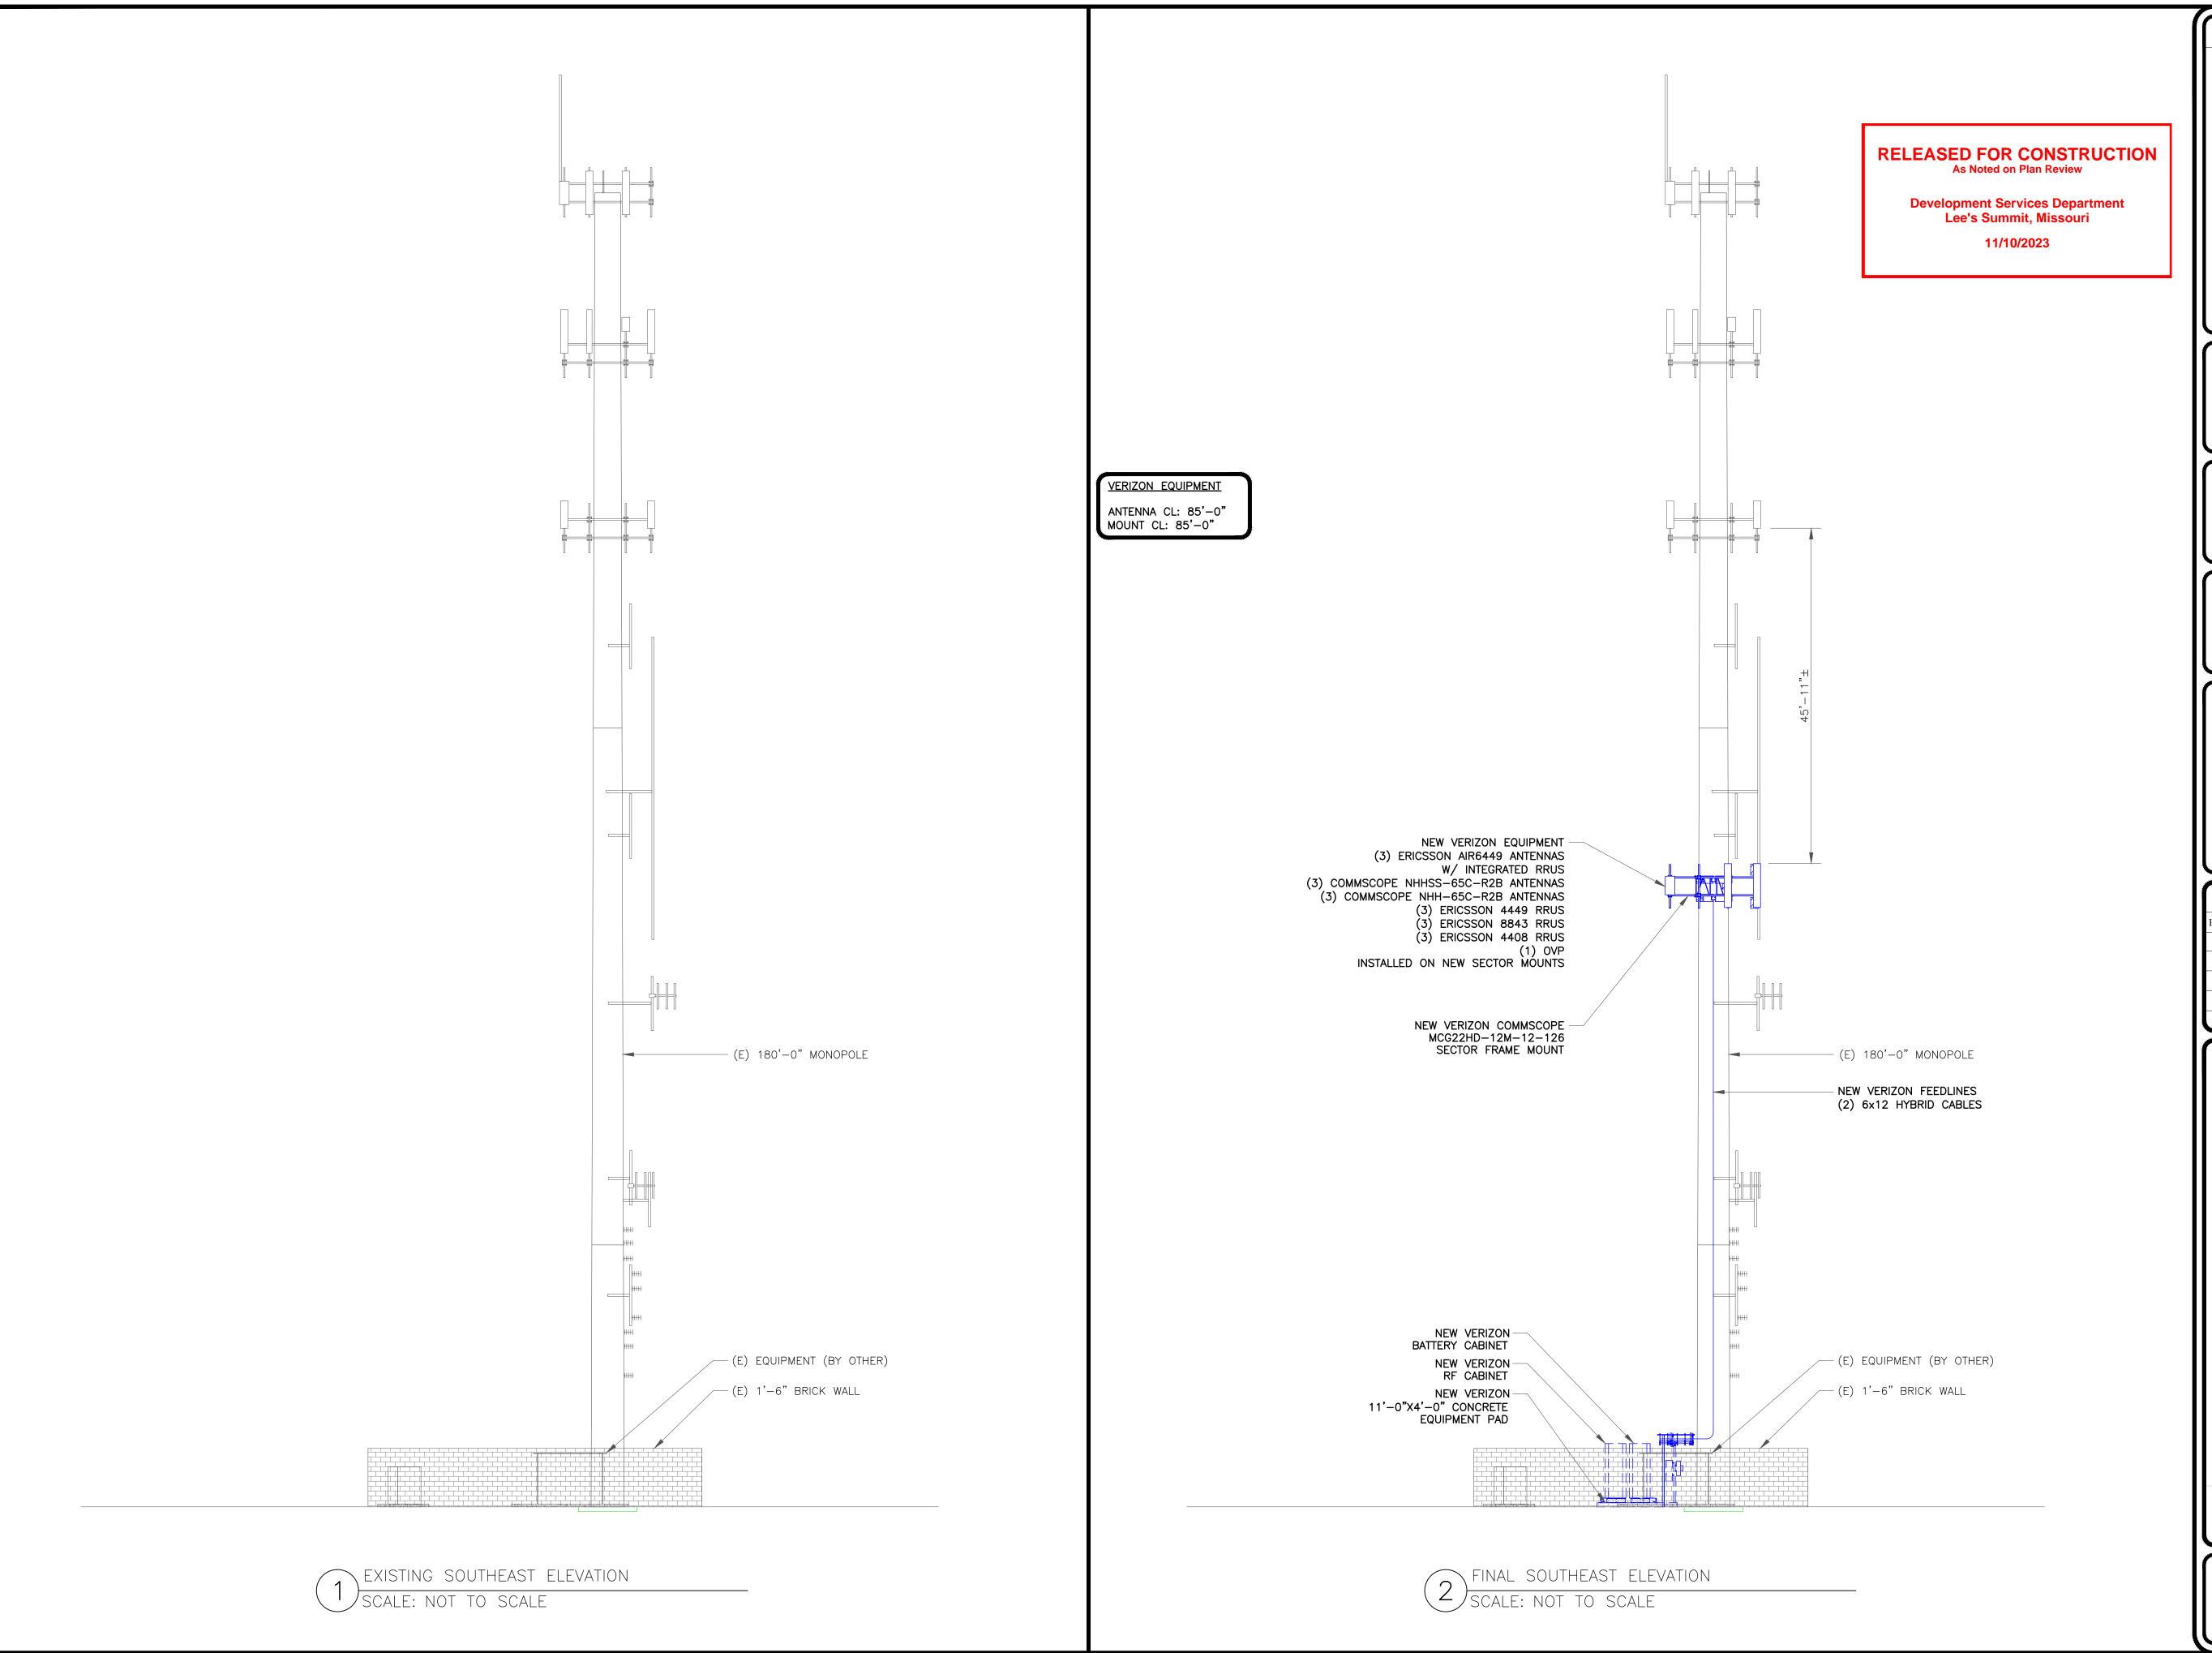
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SHEET NUMBER:





Verizon

180 WASHINGTON VALLEY ROAD

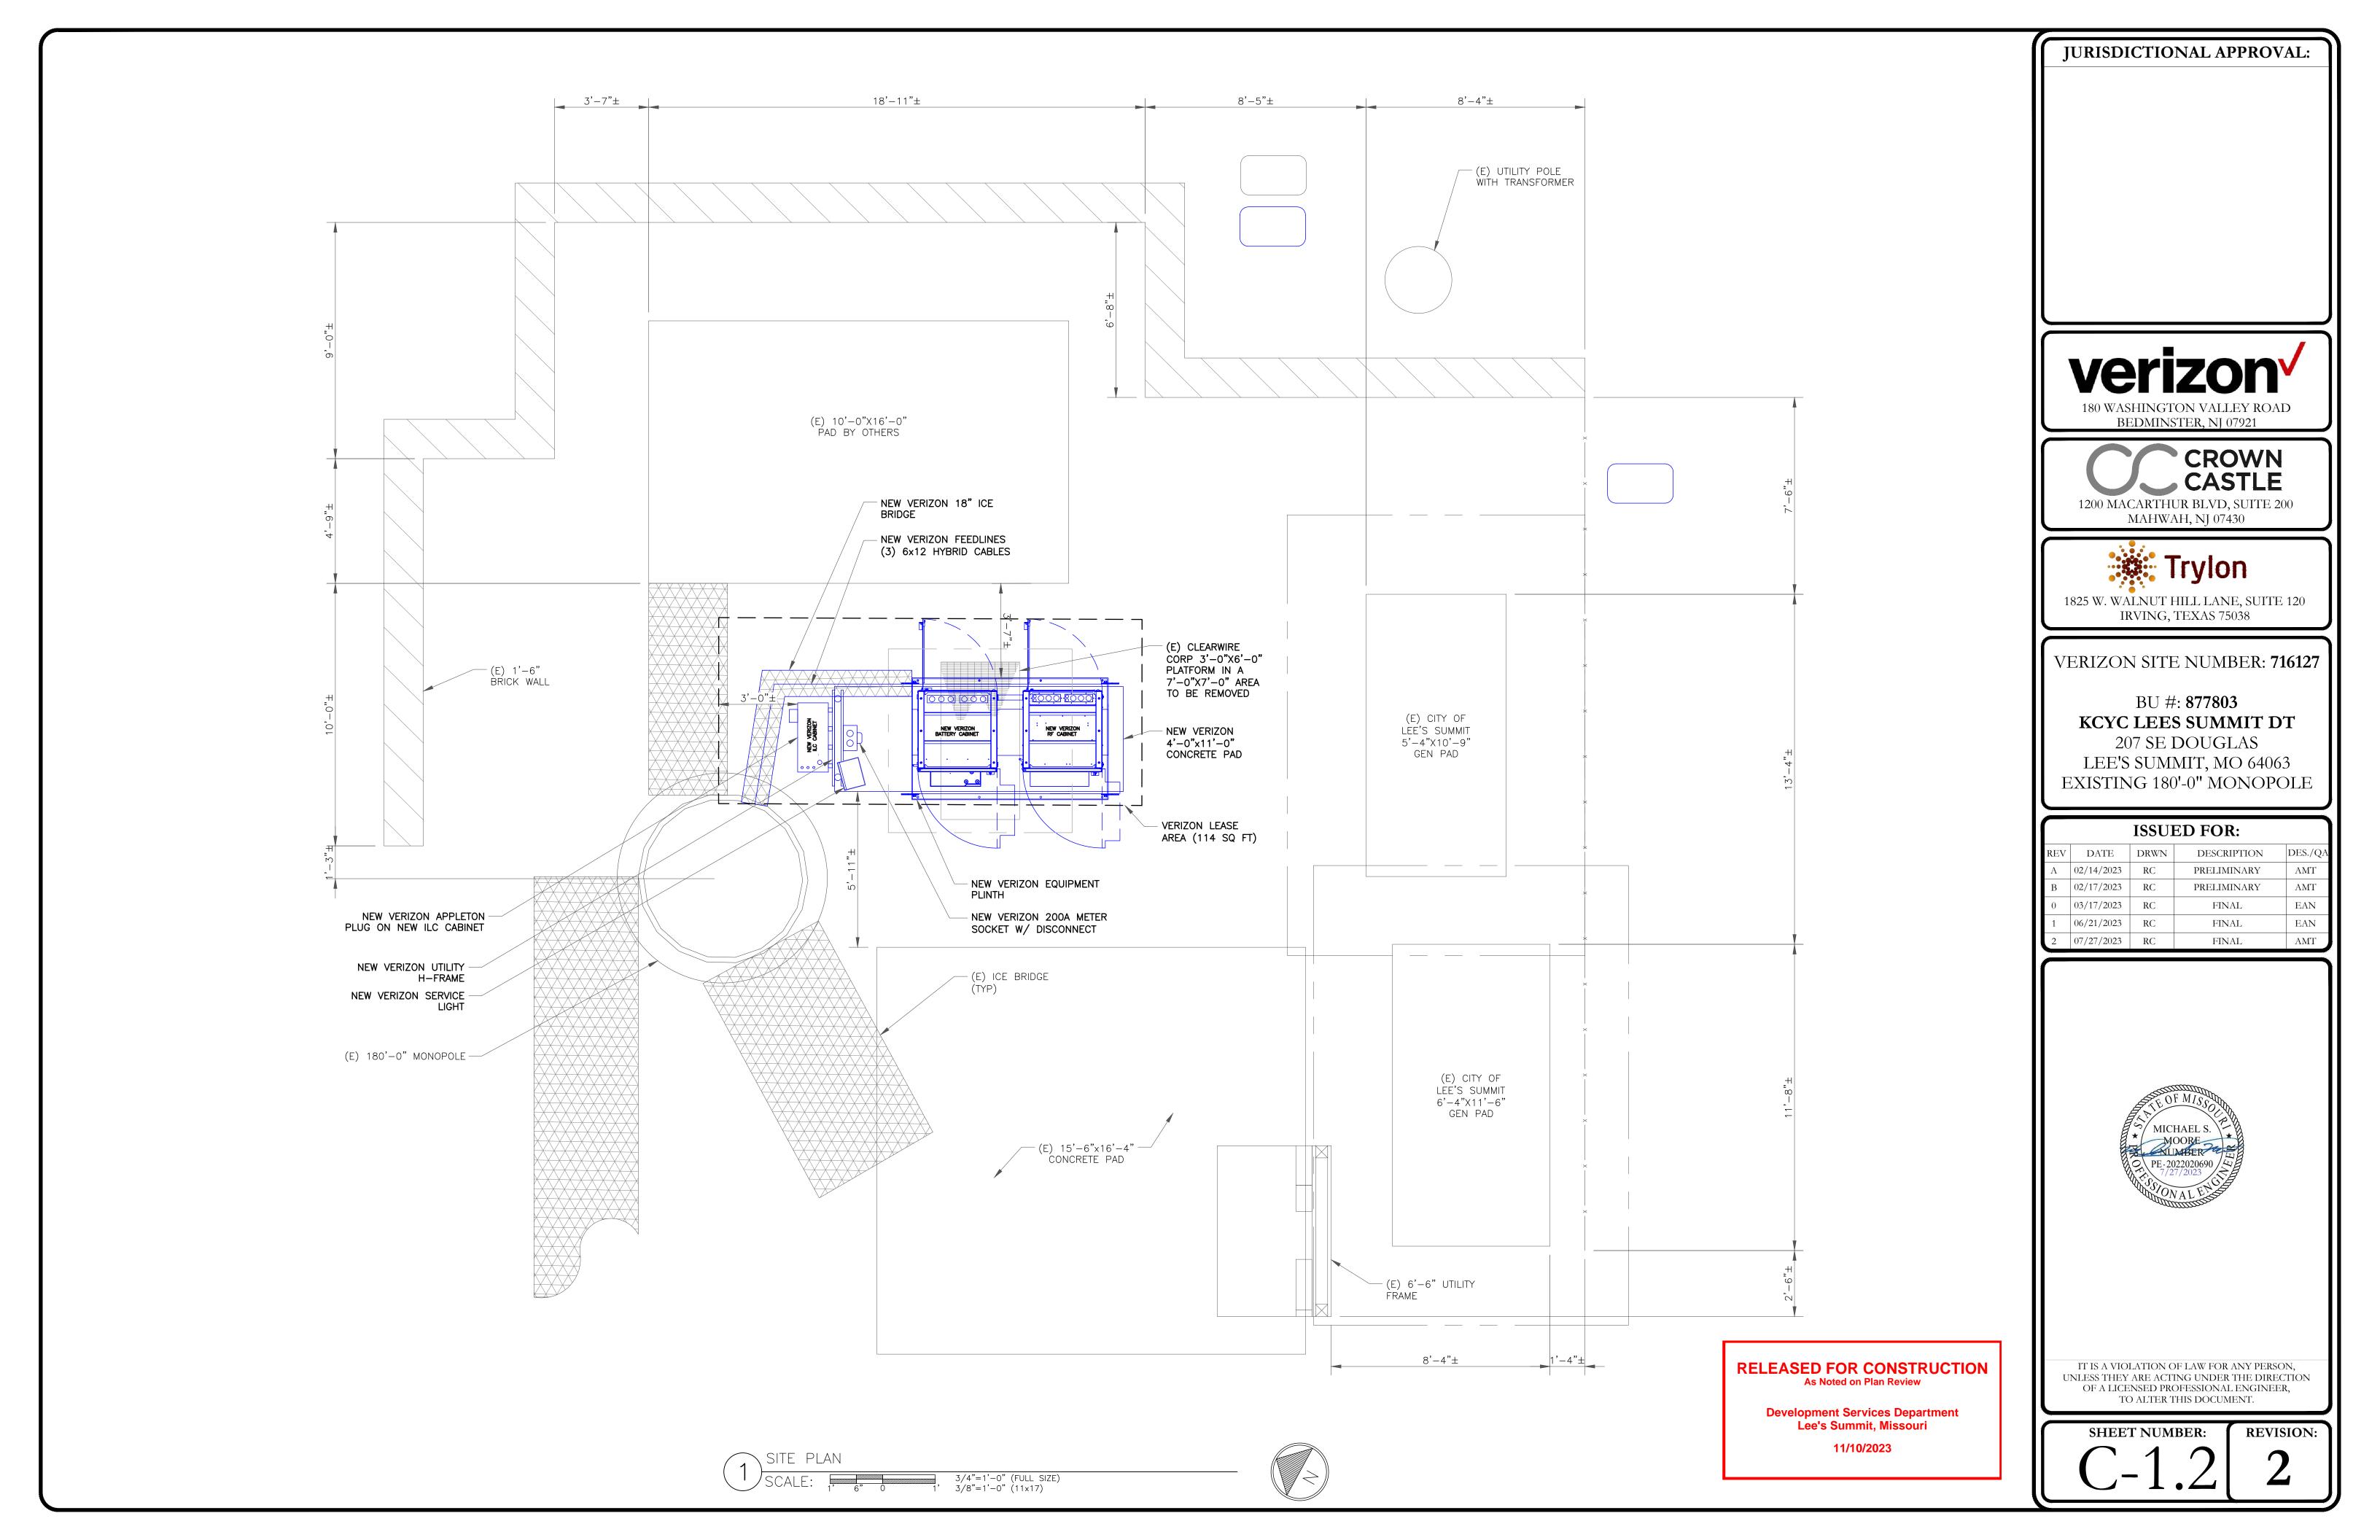BEDMINSTER, NJ 07921



1200 MACARTHUR BLVD, SUITE 200 MAHWAH, NJ 07430



1825 W. WALNUT HILL LANE, SUITE 120 IRVING, TEXAS 75038

VERIZON SITE NUMBER: 716127

BU #: **877803 KCYC LEES SUMMIT DT**207 SE DOUGLAS
LEE'S SUMMIT, MO 64063
EXISTING 180'-0" MONOPOLE

	ISSUED FOR:						
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SHEET NUMBER:

C-2

						ANTENNA SCHEDULE				
SECTOR	POS.	TECHNOLOGY	RAD CENTER	AZIMUTH	ANTENNA MANUFACTURER	ANTENNA MODEL	MECH. TILT	ELECT. TILT	TOWER MOUNTED EQUIPMENT	FEEDLINE TYPE
ALPHA	A1	_	85'-0"	0.	JMA WIRELESS	NHHSS-65C-R2B	_	-	(1) ERICSSON — RADIO 4449 (1) ERICSSON — RADIO 4408	HYBRID
ALPHA	A2	_	85'-0"	0.	JMA WIRELESS	NHH-65C-R2B	_	_	(1) ERICSSON - RRUS 8843	-
ALPHA	A3	_	85'-0"	0.	-	-	_	_	-	-
ALPHA	A4	_	85'-0"	0.	ERICSSON	AIR6449	_	_	(1) INTEGRATED RRU	-
BETA	B1	-	85'-0"	120°	JMA WIRELESS	NHHSS-65C-R2B	_	-	(1) ERICSSON — RADIO 4449 (1) ERICSSON — RADIO 4408	HYBRID
BETA	B2	-	85'-0"	120°	JMA WIRELESS	NHH-65C-R2B	-	-	(1) ERICSSON - RRUS 8843	-
BETA	В3	-	85'-0"	120°	-	-	-	-	(1) OVP	-
BETA	B4	-	85'-0"	120°	ERICSSON	AIR6449	_	_	(1) INTEGRATED RRU	-
				-						
GAMMA	C1	-	85'-0"	240°	JMA WIRELESS	NHHSS-65C-R2B	_	-	(1) ERICSSON — RADIO 4449 (1) ERICSSON — RADIO 4408	HYBRID (SHARED)
GAMMA	C2	-	85'-0"	240°	JMA WIRELESS	NHH-65C-R2B	-	-	(1) ERICSSON - RRUS 8843	-
GAMMA	С3	-	85'-0"	240°	-	-	_	-	-	-
GAMMA	C4	_	85'-0"	240°	ERICSSON	AIR6449	_	_	(1) INTEGRATED RRU	-

NEW	HYBRID IAL CABLE QUANT	6x12	2
STATUS	CABLE TYPE	SIZE	QUANTITY
	CABLE SC	HEDULE	







1825 W. WALNUT HILL LANE, SUITE 120 IRVING, TEXAS 75038

VERIZON SITE NUMBER: 716127

BU #: **877803 KCYC LEES SUMMIT DT**207 SE DOUGLAS
LEE'S SUMMIT, MO 64063
EXISTING 180'-0" MONOPOLE


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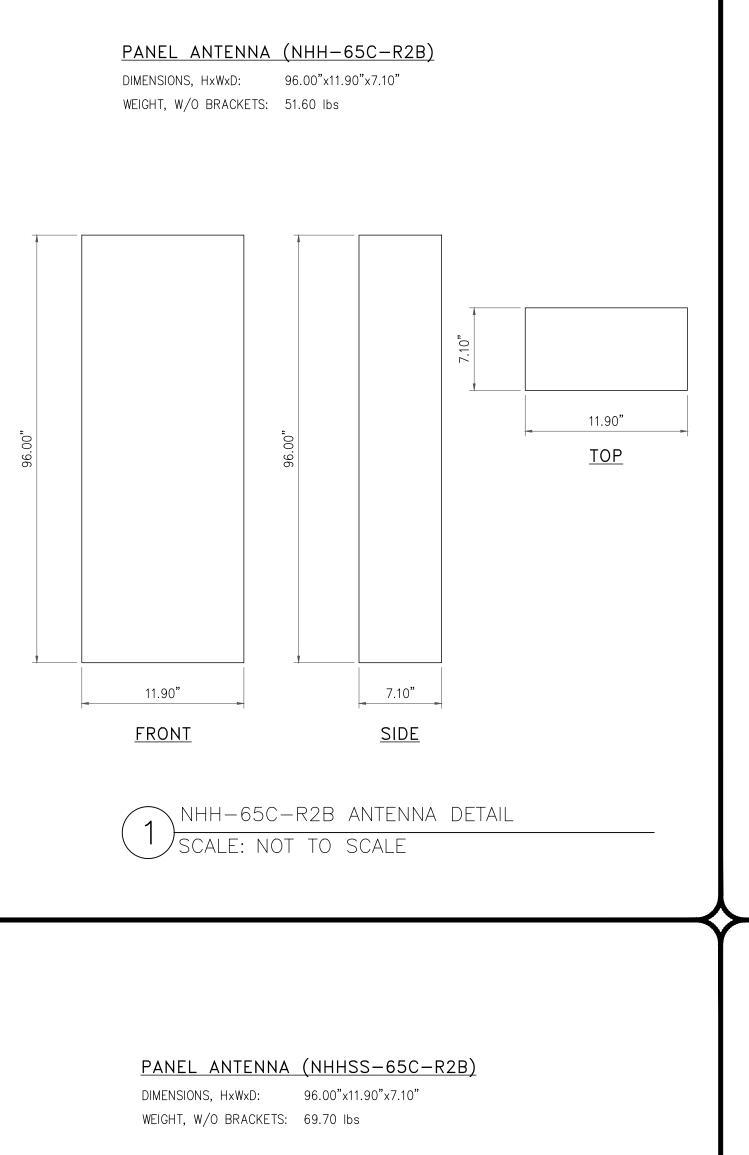



ANTENNA AND CABLE SCHEDULE


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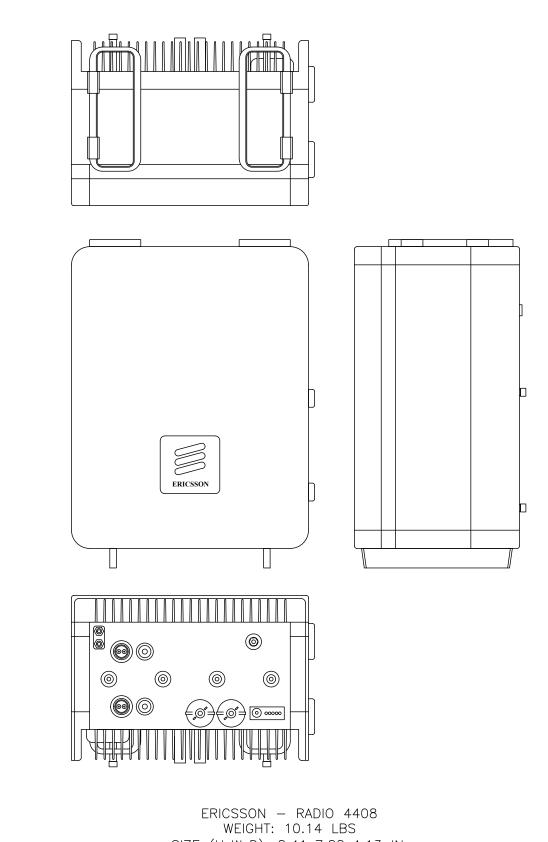
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As Noted on Plan Review

Development Services Department Lee's Summit, Missouri 11/10/2023



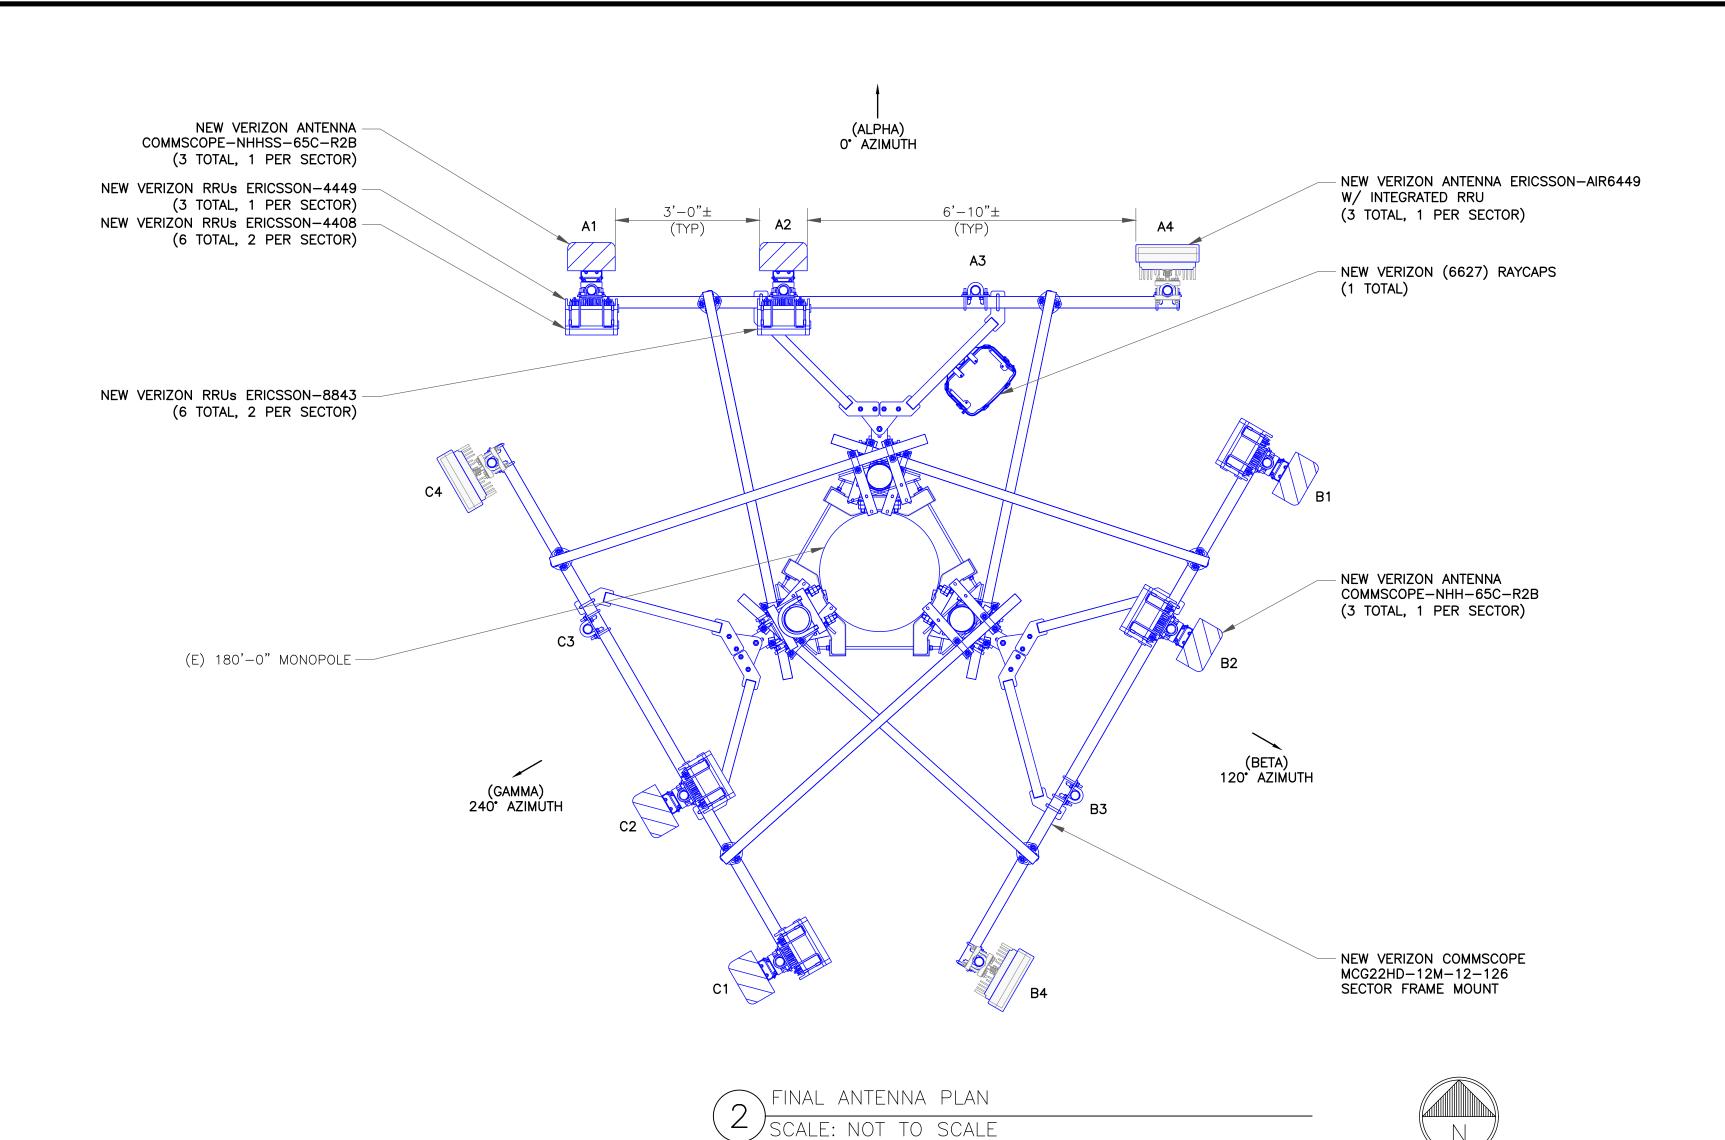

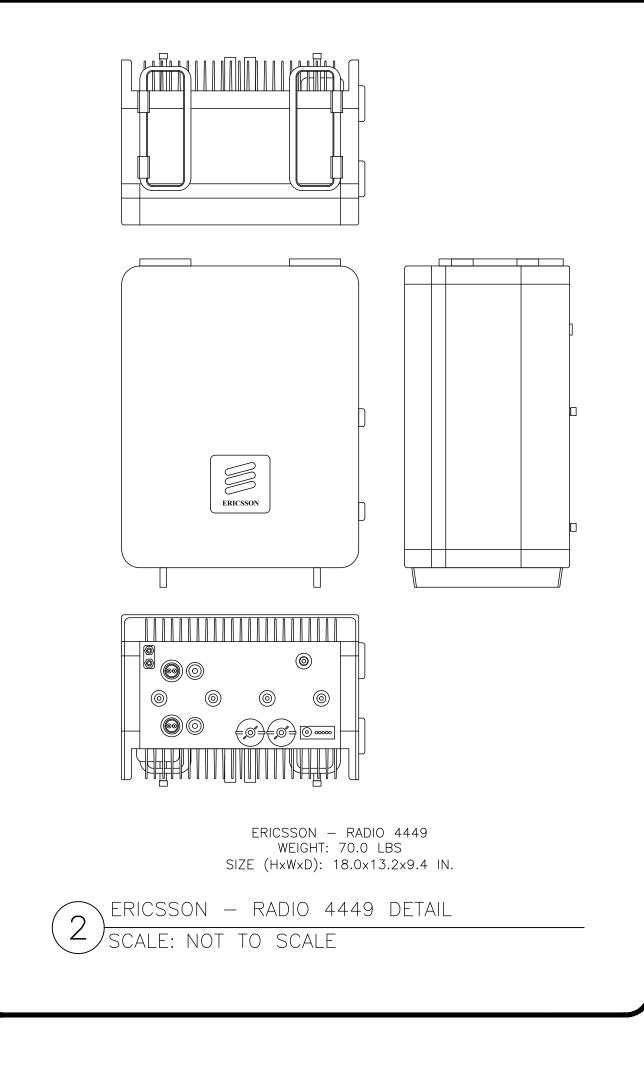

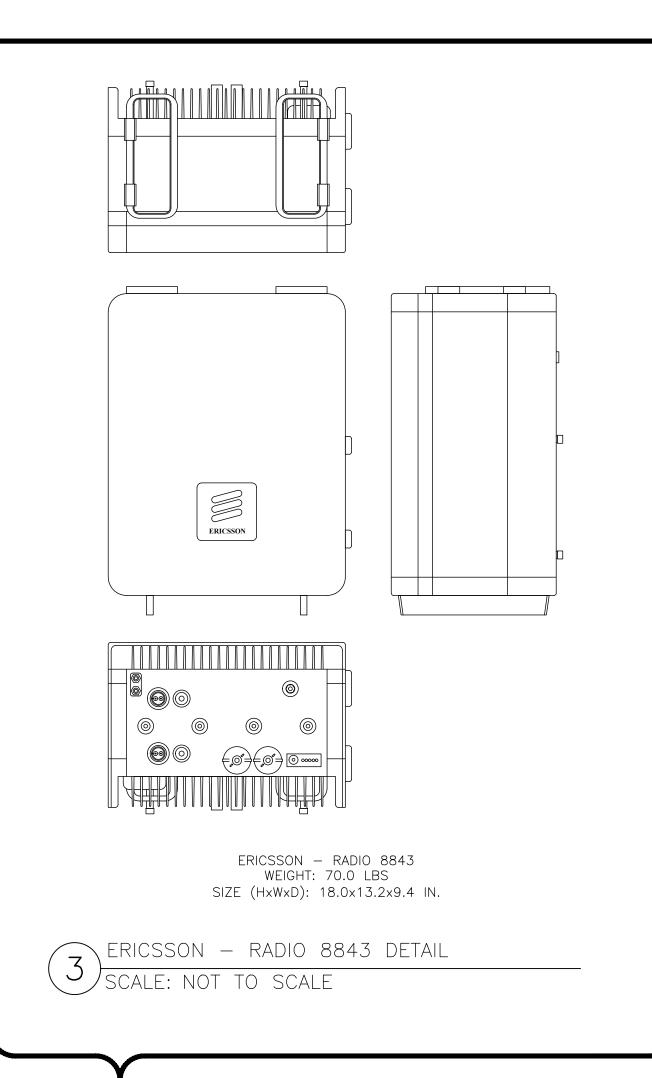

ERICSSON - RADIO 4408 DETAIL

SCALE: NOT TO SCALE

IRVING, TEXAS 75038 SIZE (HxWxD): 8.41x7.88x4.13 IN. VERIZON SITE NUMBER: 716127

> BU #: **877803** KCYC LEES SUMMIT DT 207 SE DOUGLAS LEE'S SUMMIT, MO 64063 EXISTING 180'-0" MONOPOLE

> > FINAL

FINAL

EAN

AMT

JURISDICTIONAL APPROVAL:

verizon

180 WASHINGTON VALLEY ROAD

BEDMINSTER, NJ 07921

1200 MACARTHUR BLVD, SUITE 200 MAHWAH, NJ 07430

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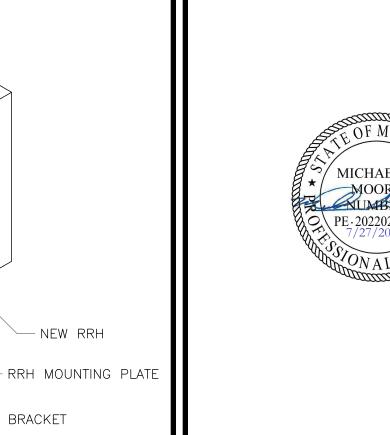
1825 W. WALNUT HILL LANE, SUITE 120

CROWN

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A 02/14/2023 RC PRELIMINARY AMT **Development Services Department** AMT 02/17/2023 RC PRELIMINARY AMT 03/17/2023 RC FINAL EAN

06/21/2023 RC

07/27/2023 RC




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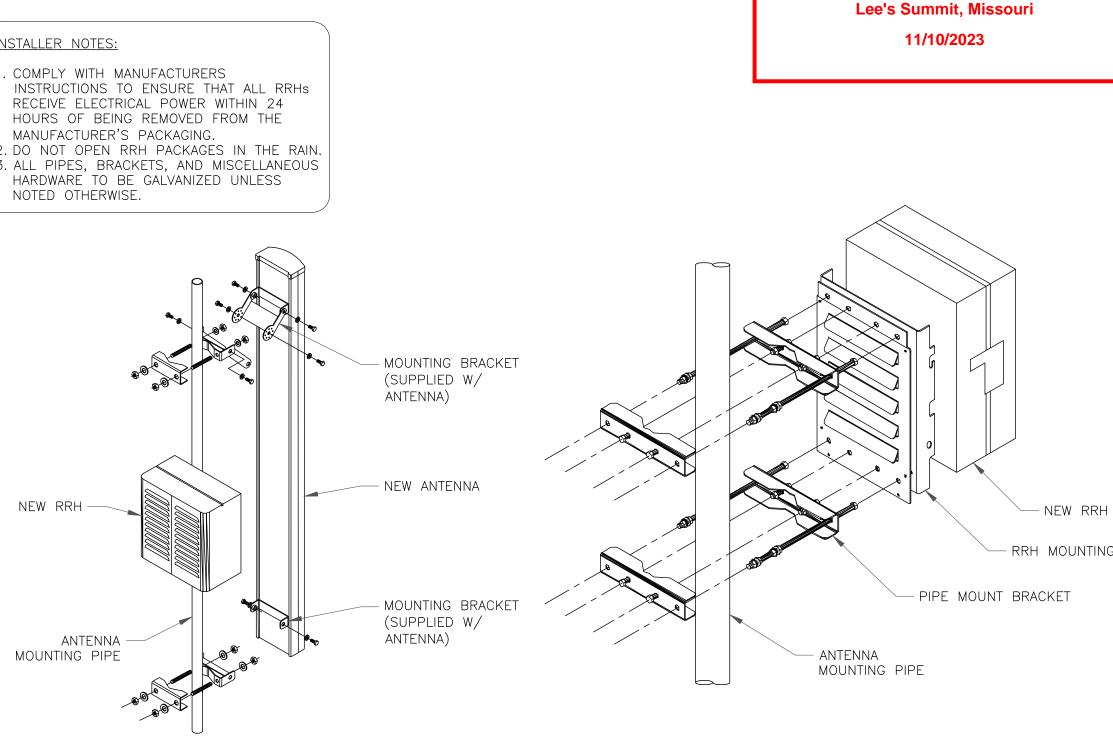
REVISION:



WEIGHT, W/O BRACKETS: 104.0 lbs



AIR 6449 ANTENNA DETAIL SCALE: NOT TO SCALE

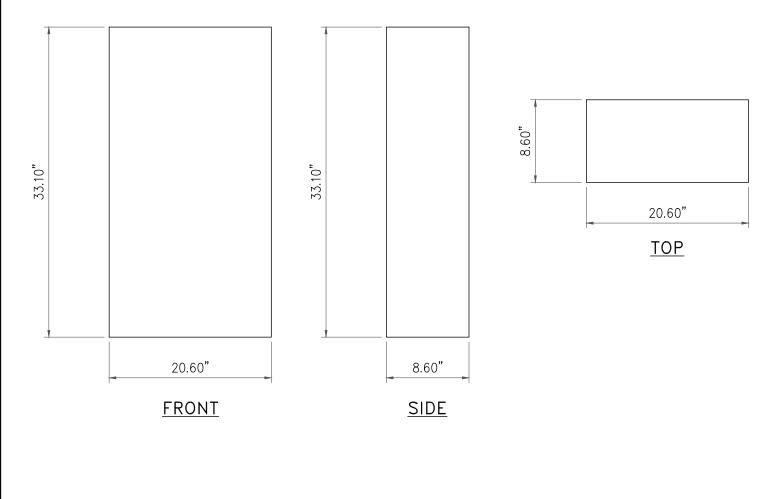

11.90" <u>TOP</u>

NHHSS-65C-R2B ANTENNA DETAIL SCALE: NOT TO SCALE

11.90"

<u>FRONT</u>

7.10"

<u>SIDE</u>

INSTALLER NOTES:

2. DO NOT OPEN RRH PACKAGES IN THE RAIN. 3. ALL PIPES, BRACKETS, AND MISCELLANEOUS HARDWARE TO BE GALVANIZED UNLESS

ANTENNA WITH RRH MOUNTING DETAIL SCALE: NOT TO SCALE

MCG22HD-12M-12-126



G22HD High Capacity 3-Sector Monopole Frame with 2 7/8in OD x 12.5ft face. Includes twelve 2 3/8in OD x 126in antenna pipes

Product Classification

Product Type High capacity monopole sector frame

Product Series G2

General Specifications

Mounting Monopole, 381–1270 mm (15–50 in) OD

Pipe, quantity 12
Sectors, quantity 3

Dimensions

3,200.4 mm | 126 in Height 3.81 m | 12.5 ft **Face Width** 3,810 mm | 150 in 3,200.4 mm | 126 in Face Support Pipe Diameter 73.025 mm | 2.875 in Mounting Diameter, maximum 1270 mm | 50 in 381 mm | 15 in Mounting Diameter, minimum 60.325 mm | 2.375 in Pipe Outer Diameter 1,041.4 mm | 41 in Stand-off Distance

Material Specifications

Material Type Hot dip galvanized steel

Mechanical Specifications

Wind Rating For Specifications, please contact steelproducts@commscope.com or call 800-255-1479

Wind Rating Test Method TIA/EIA-222

MCG22HD-12M-12-126

Environmental Specifications

Man Rating 500 lb vertical man load at 15 mph (BWS)

Packaging and Weights

Included Pipe mounts | Plain end pipes (12) | Ring mounts (2) | Sector frames (3) | Stiff arm

Packaging quantity

* Footnotes

Wind Rating BWS—Base Wind Speed; FBC—Florida Building Code

Man Rating BWS—Base Wind Speed

Verizon VALLEY ROAD

BEDMINSTER, NJ 07921

JURISDICTIONAL APPROVAL:






IRVING, TEXAS 75038

VERIZON SITE NUMBER: 716127

BU #: **877803 KCYC LEES SUMMIT DT**207 SE DOUGLAS
LEE'S SUMMIT, MO 64063
EXISTING 180'-0" MONOPOLE

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Page 2 of 2
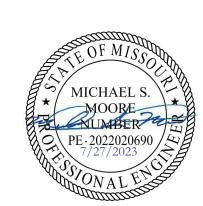
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NUMBER: REVISION: 2

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Development Services Department Lee's Summit, Missouri

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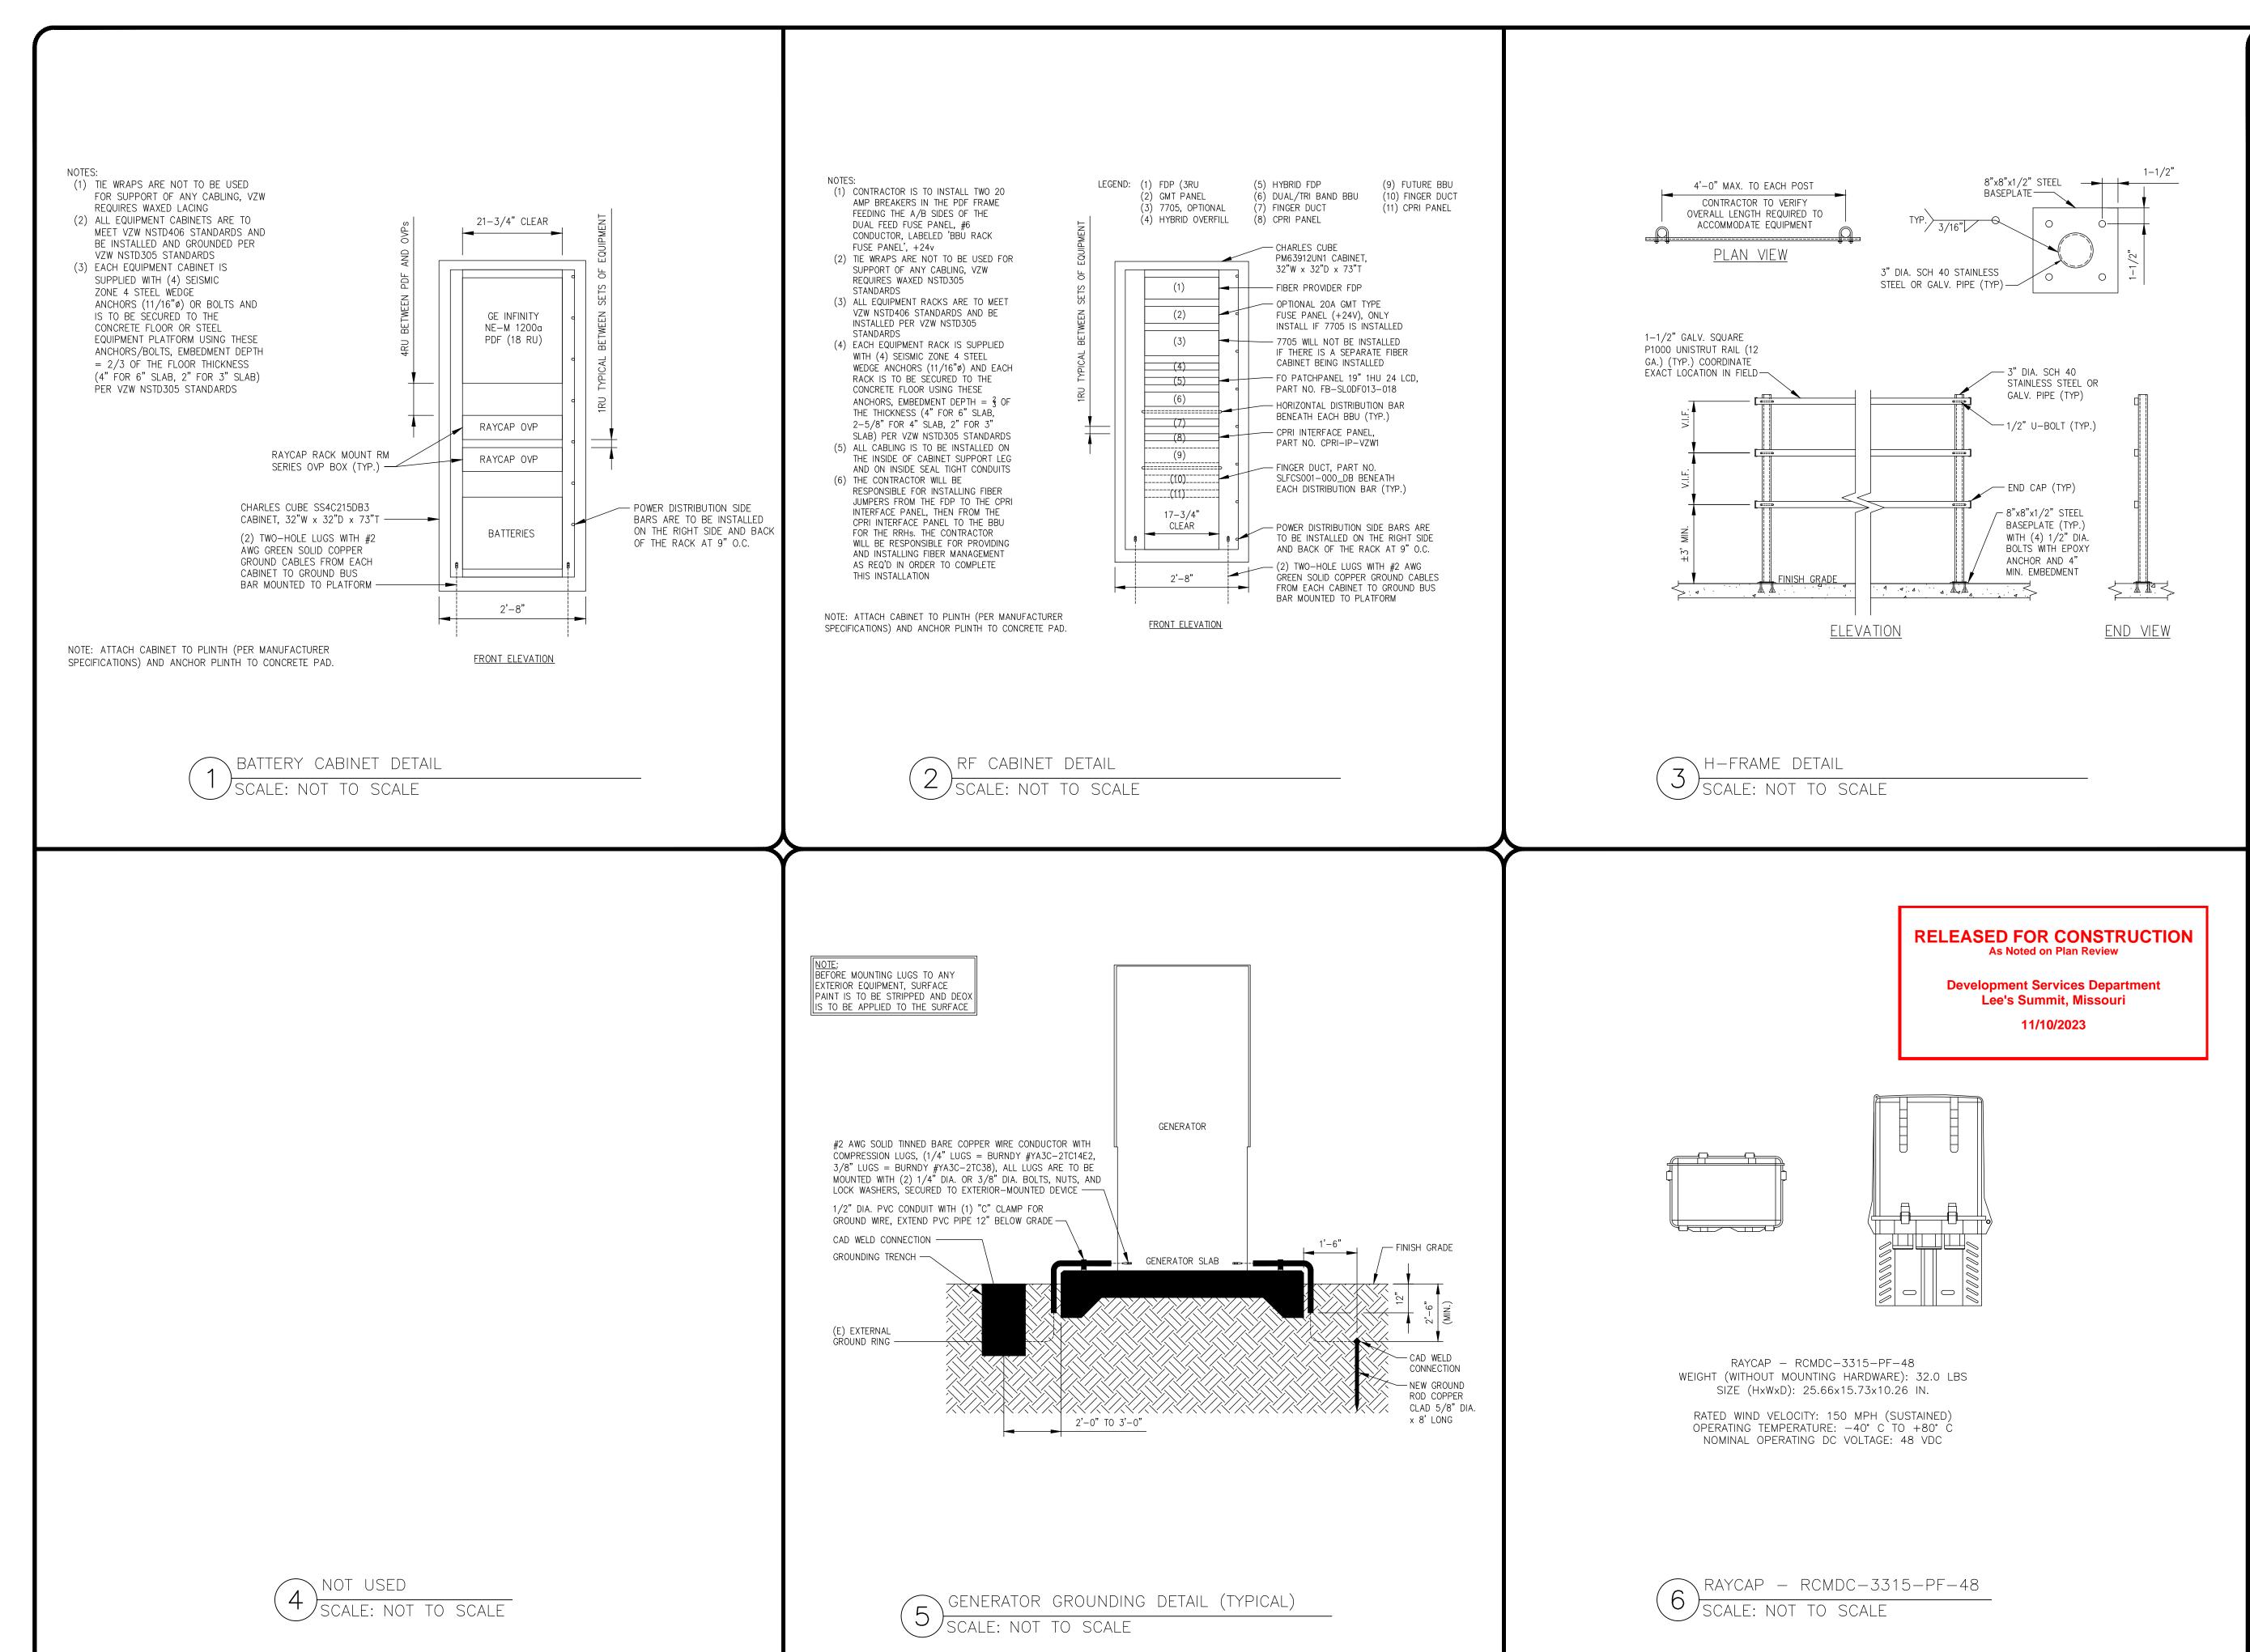
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ANTENNA MOUNT DETAIL

SCALE: NOT TO SCALE

Page 1 of 2









1825 W. WALNUT HILL LANE, SUITE 120 IRVING, TEXAS 75038

VERIZON SITE NUMBER: 716127


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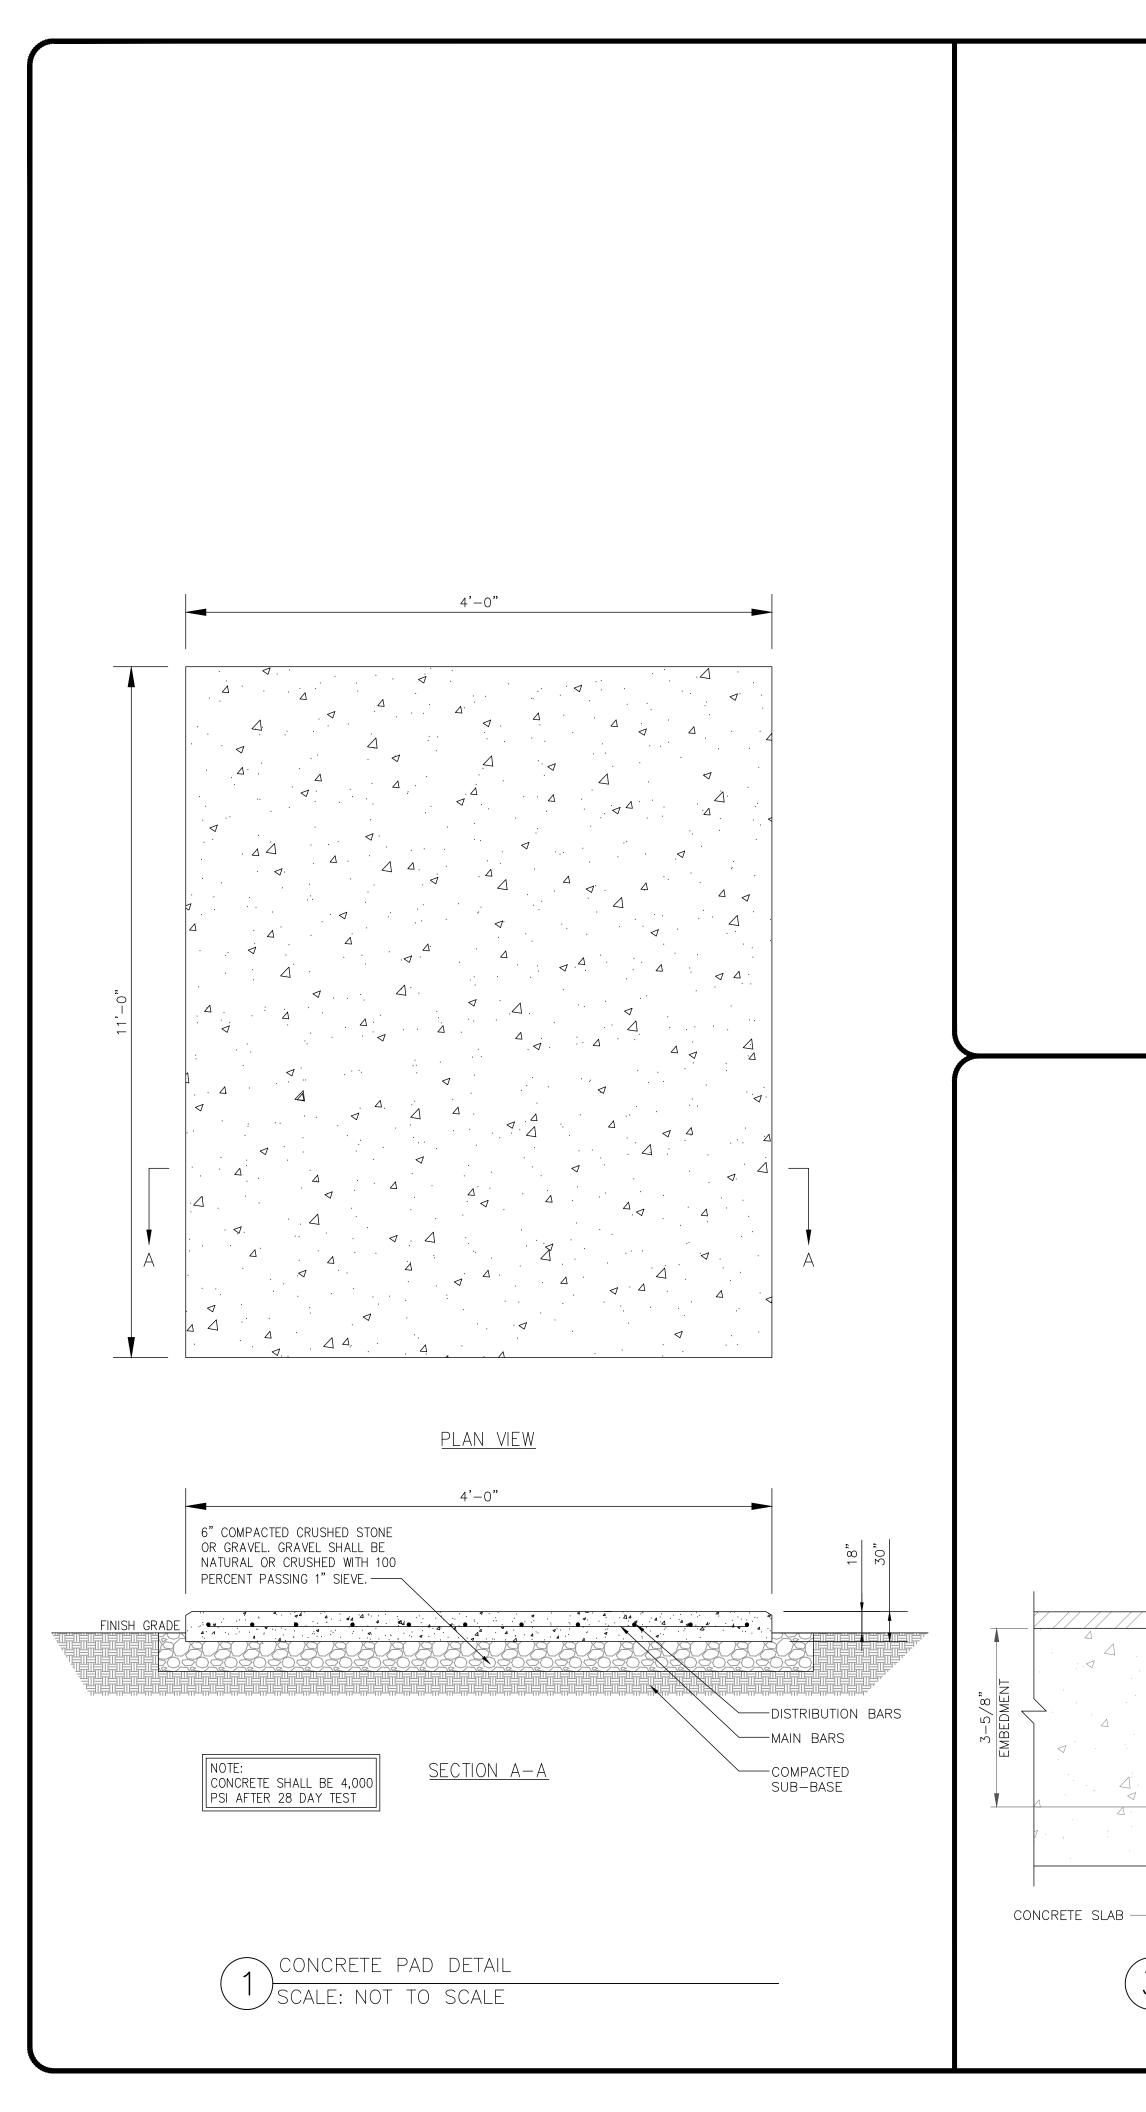
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l	06/21/2023	RC	FINAL	EAN			
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Development Services Department Lee's Summit, Missouri 11/10/2023

NOT USED
SCALE: NOT TO SCALE

PROPOSED 1/2" DIAMETER, HILTI KWIK BOLT TZ ANCHOR WITH

INSTALLED A MINIMUM OF (1) IN EACH CORNER OF CABINET. SEE MANUFACTURER'S EQUIPMENT INSTALLATION MANUAL FOR ANCHOR LOCATIONS. IT IS ASSUMED THAT CABINET ANCHOR

LOCATIONS HAVE BEEN DESIGNED/REINFORCED BY THE MANUFACTURER TO WITHSTAND SHEAR AND UPLIFT FORCES AS CALCULATED IN THIS DESIGN

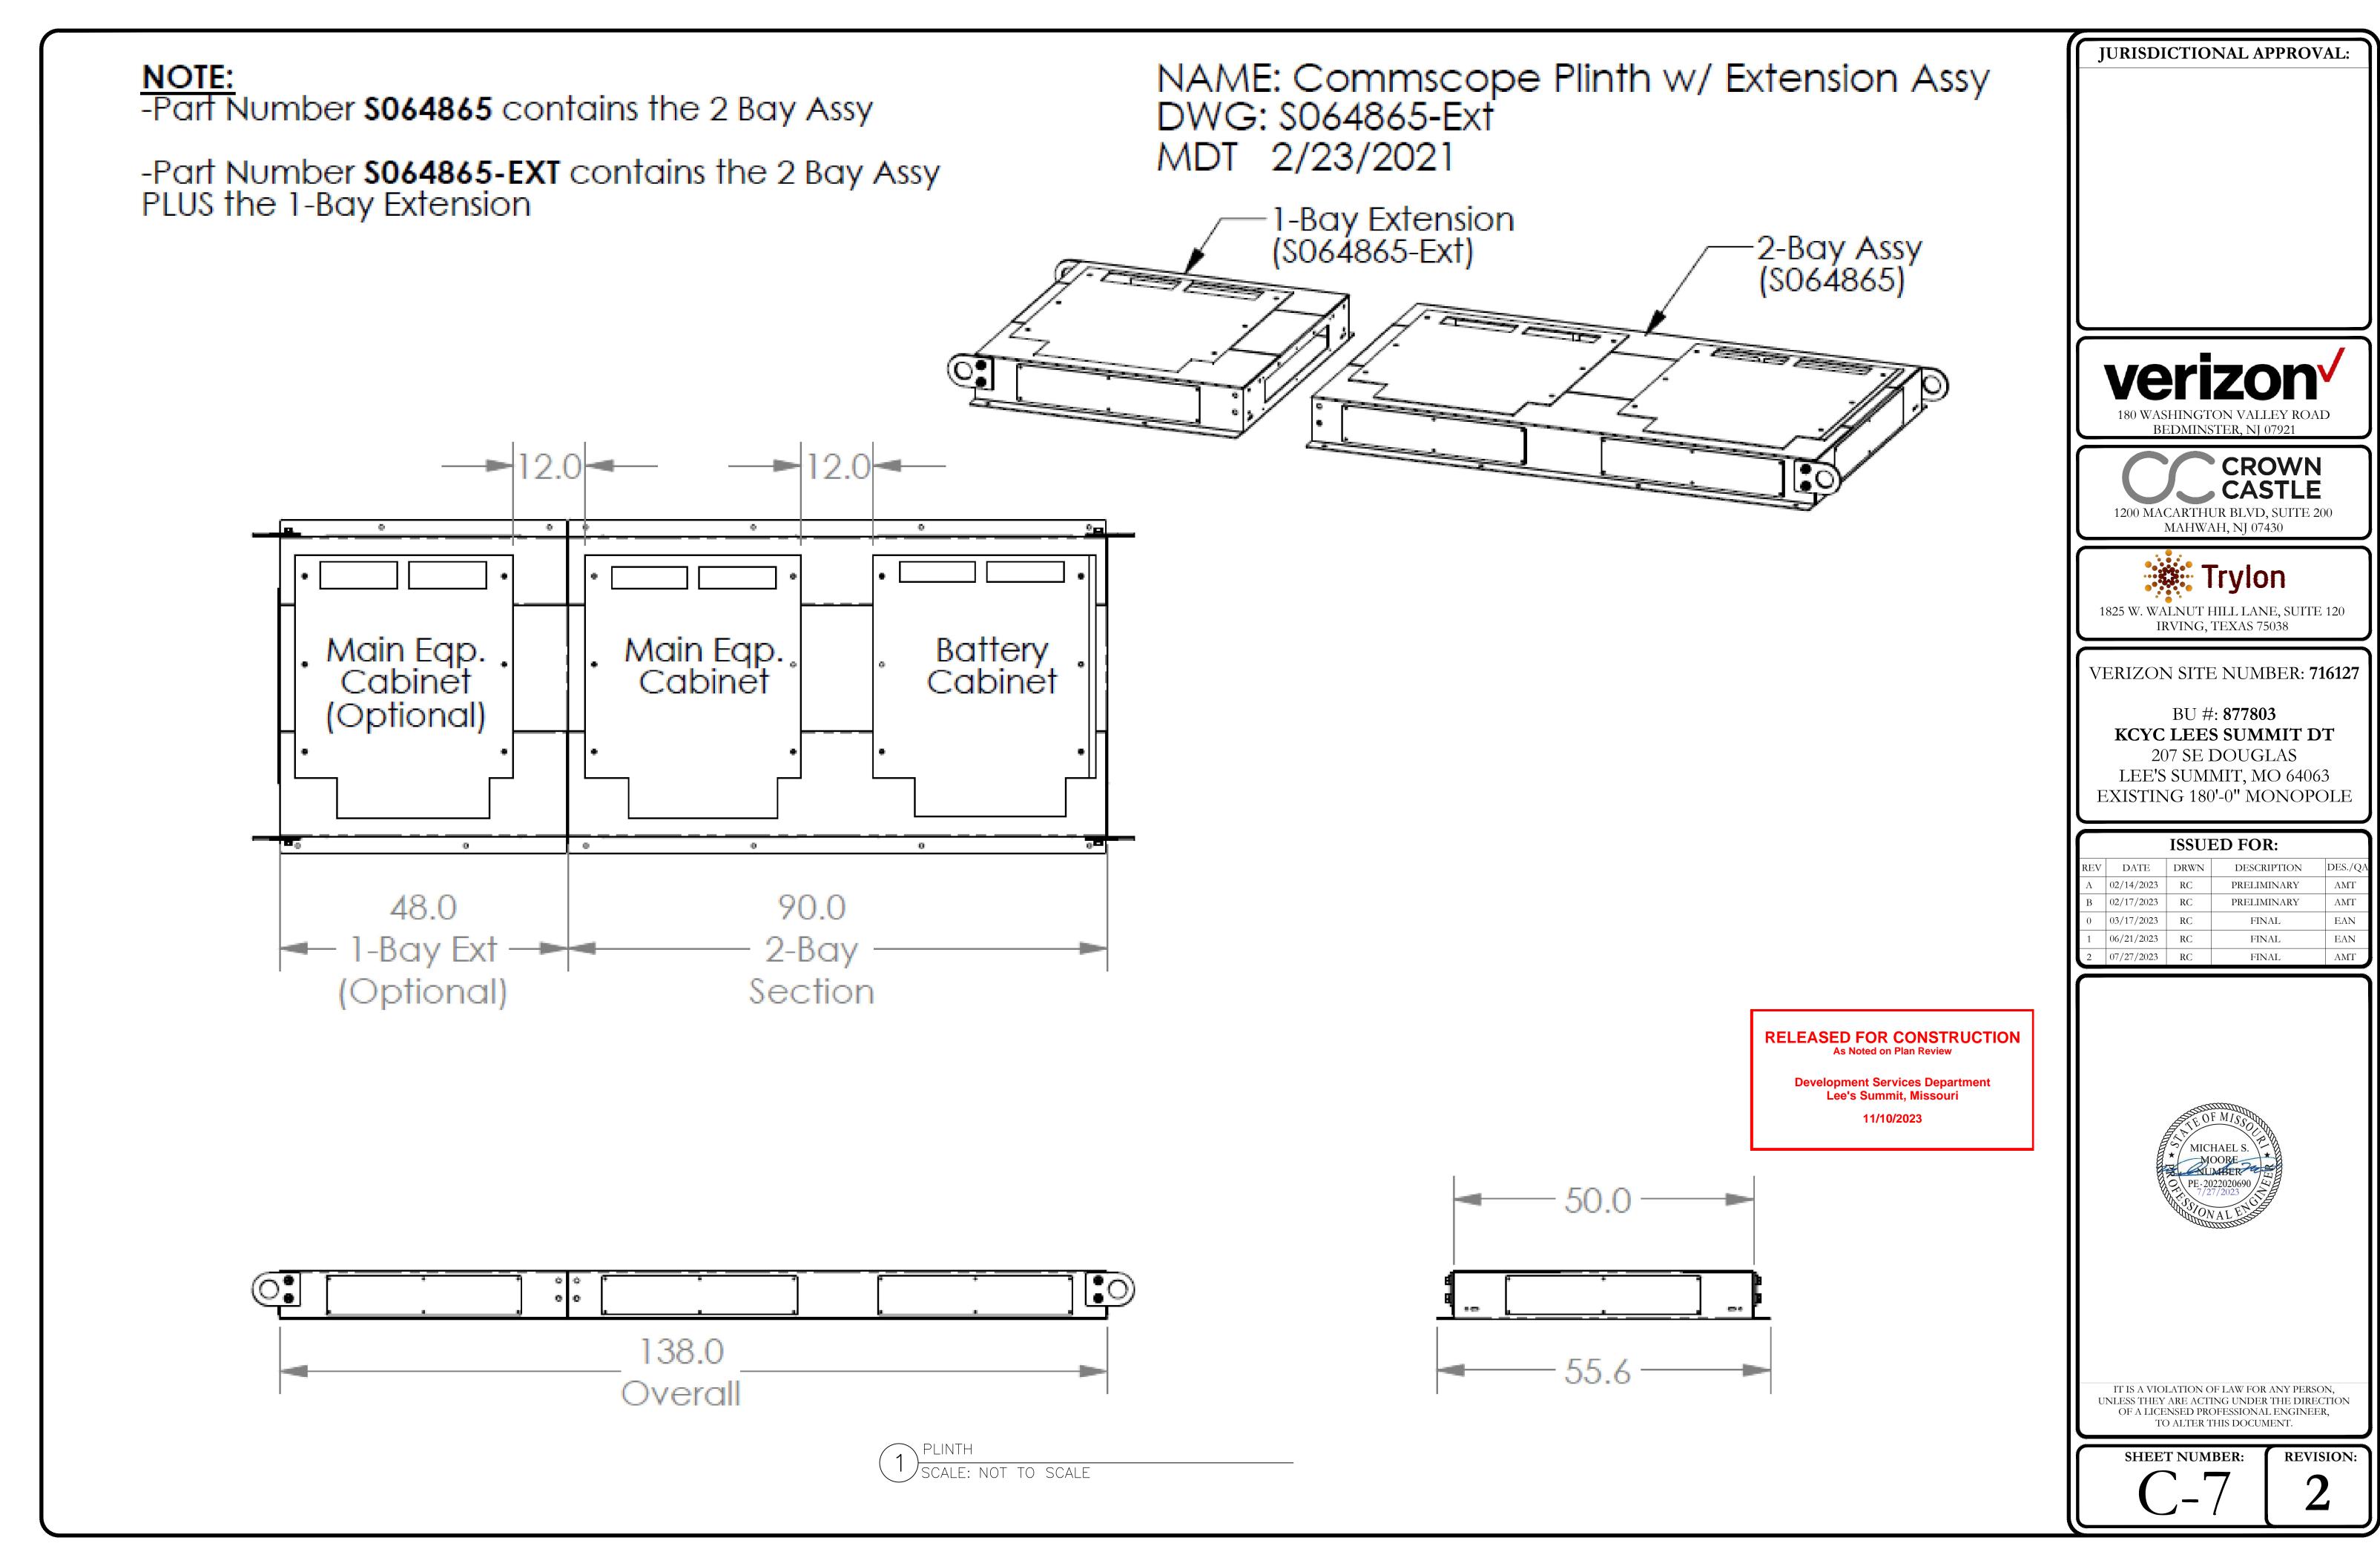EQUIPMENT

BASE FRAME


3-5/8" NOMINAL EMBEDMENT (ICC ESR-1917). TO BE

WASHER - PLATE

WASHER

CABINET ANCHOR DETAIL

SCALE: NOT TO SCALE

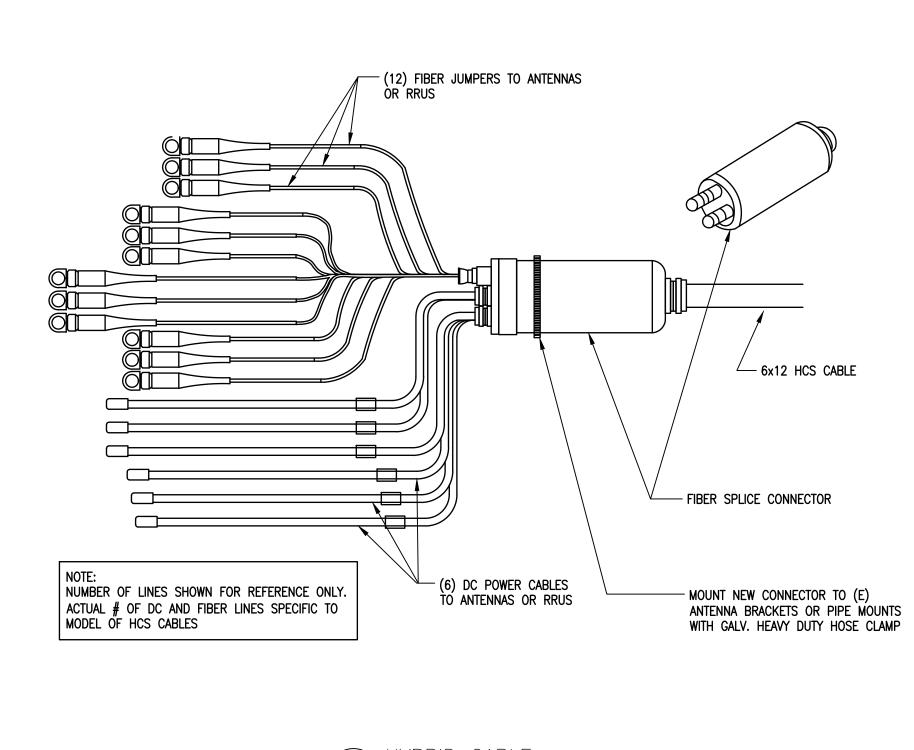

HYBRID CABLE

SCALE: NOT TO SCALE

JURISDICTIONAL APPROVAL:



BEDMINSTER, NJ 07921



0 MACARTHUR BLVD, SUITE MAHWAH, NJ 07430



IRVING, TEXAS 75038

VERIZON SITE NUMBER: 716127


BU #: **877803 KCYC LEES SUMMIT DT**207 SE DOUGLAS
LEE'S SUMMIT, MO 64063
EXISTING 180'-0" MONOPOLE


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SHEET NUMBER:





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SIDE EQUIPMENT ELEVATION
SCALE: NOT TO SCALE

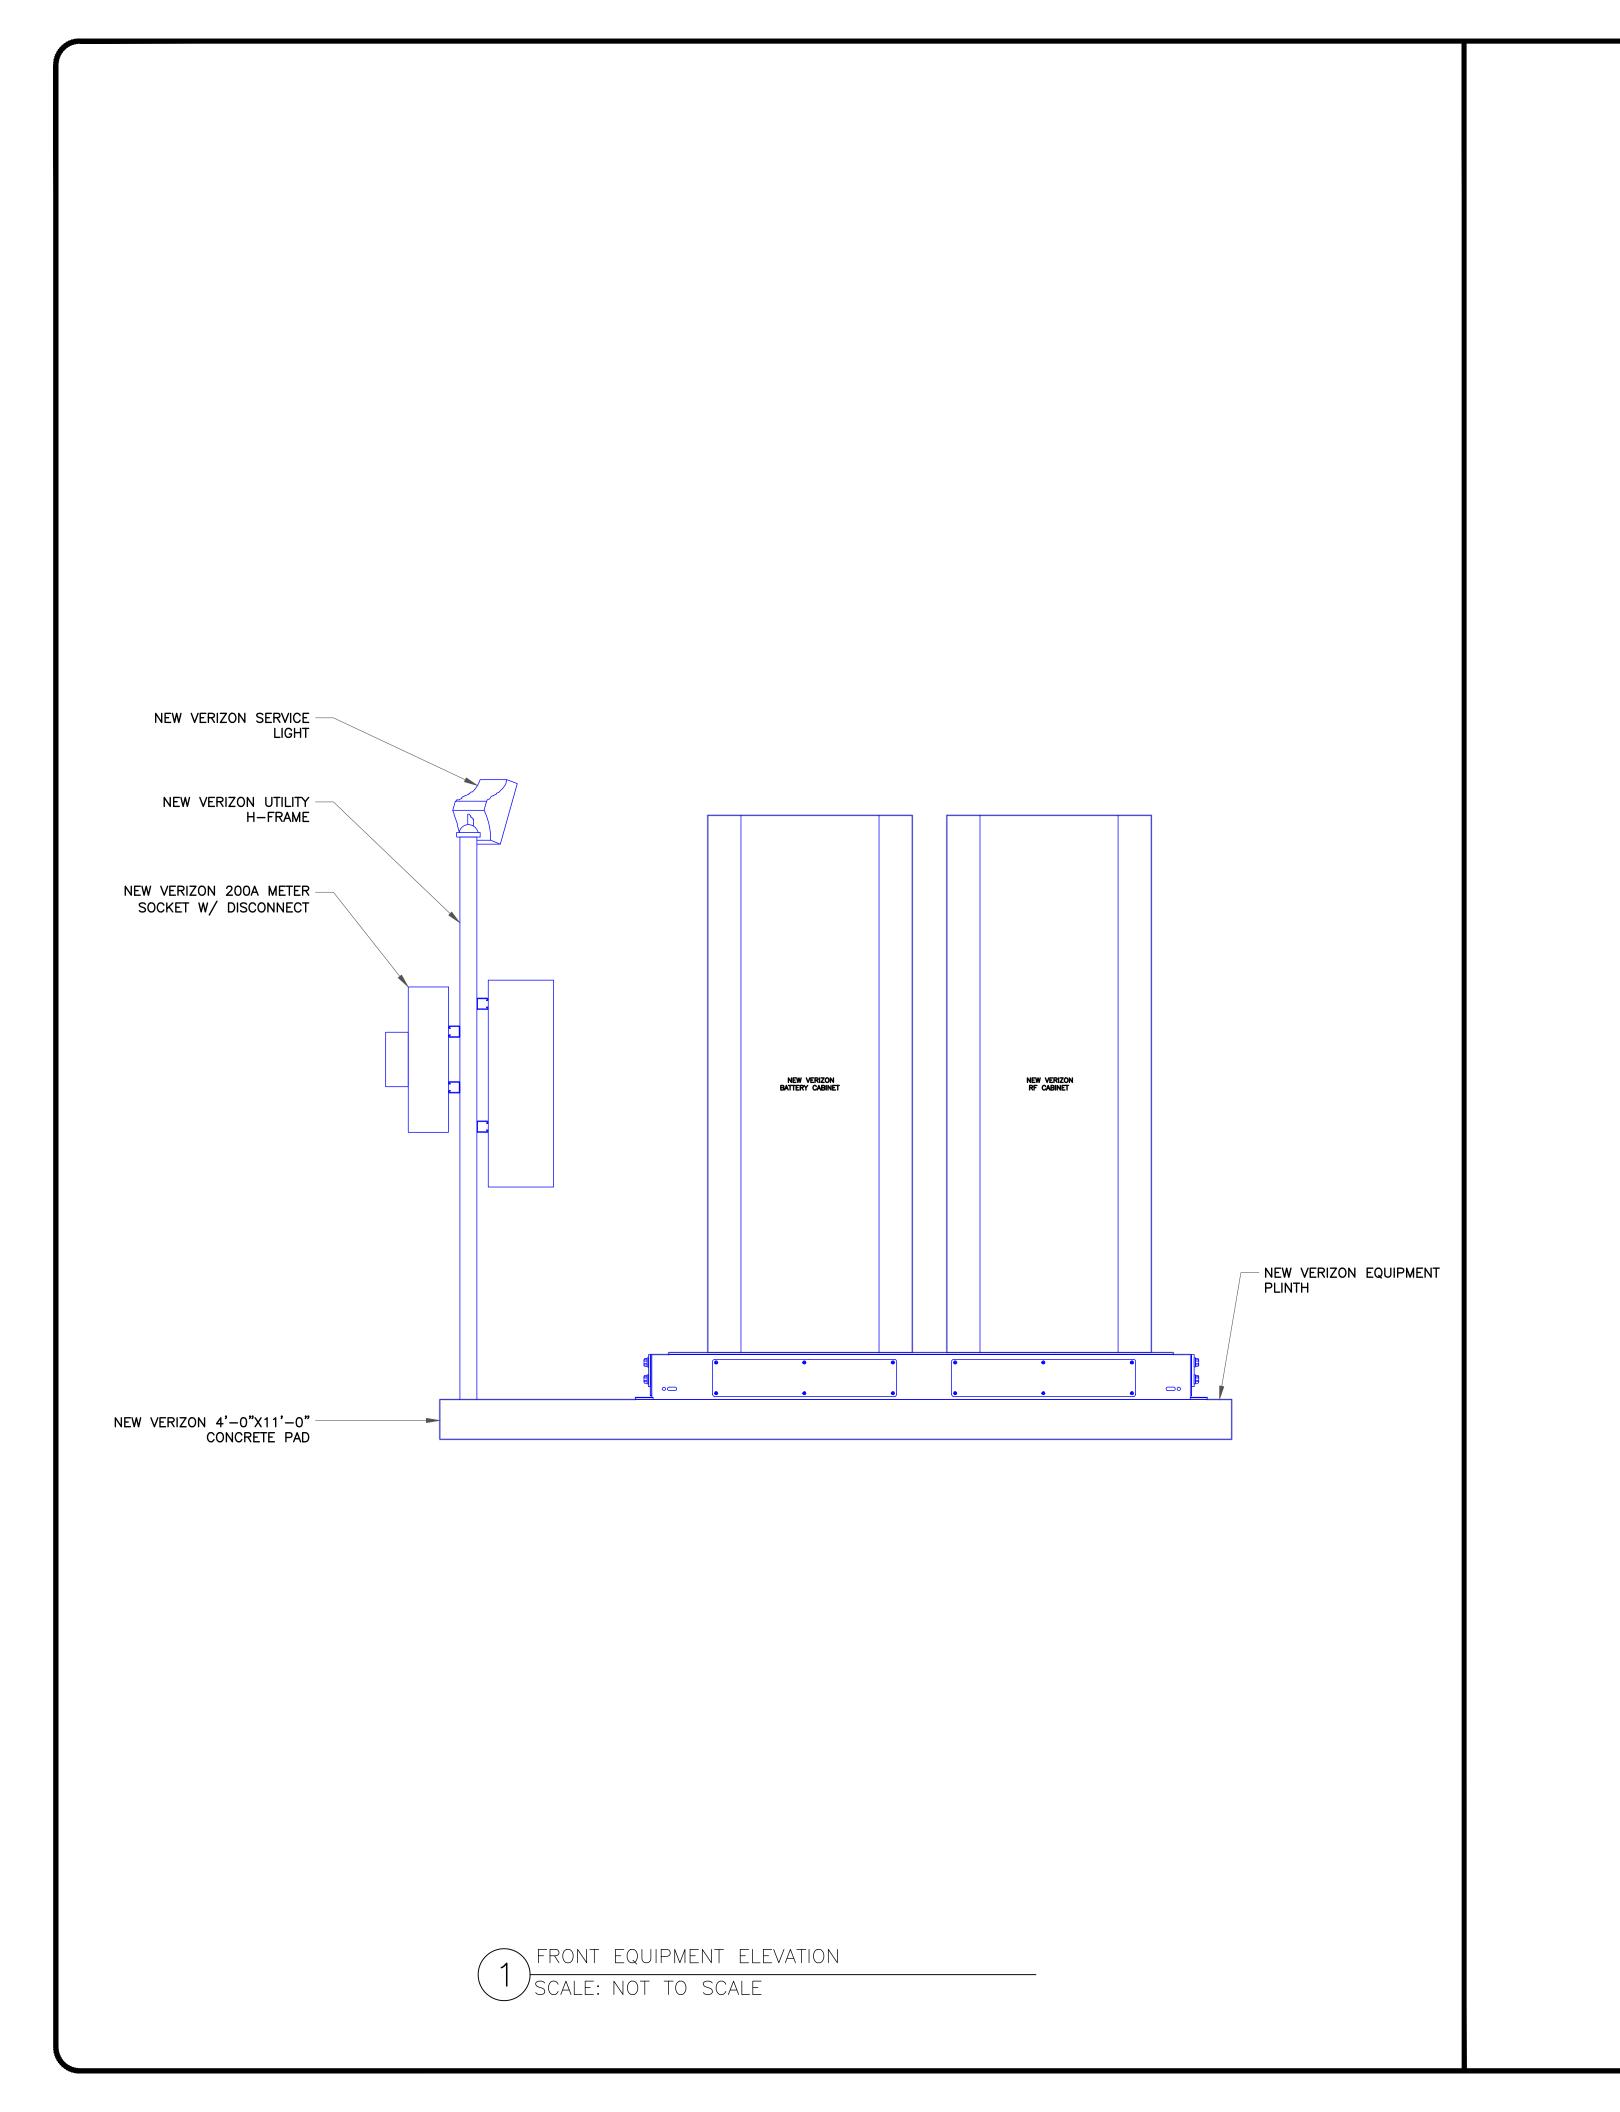JURISDICTIONAL APPROVAL:

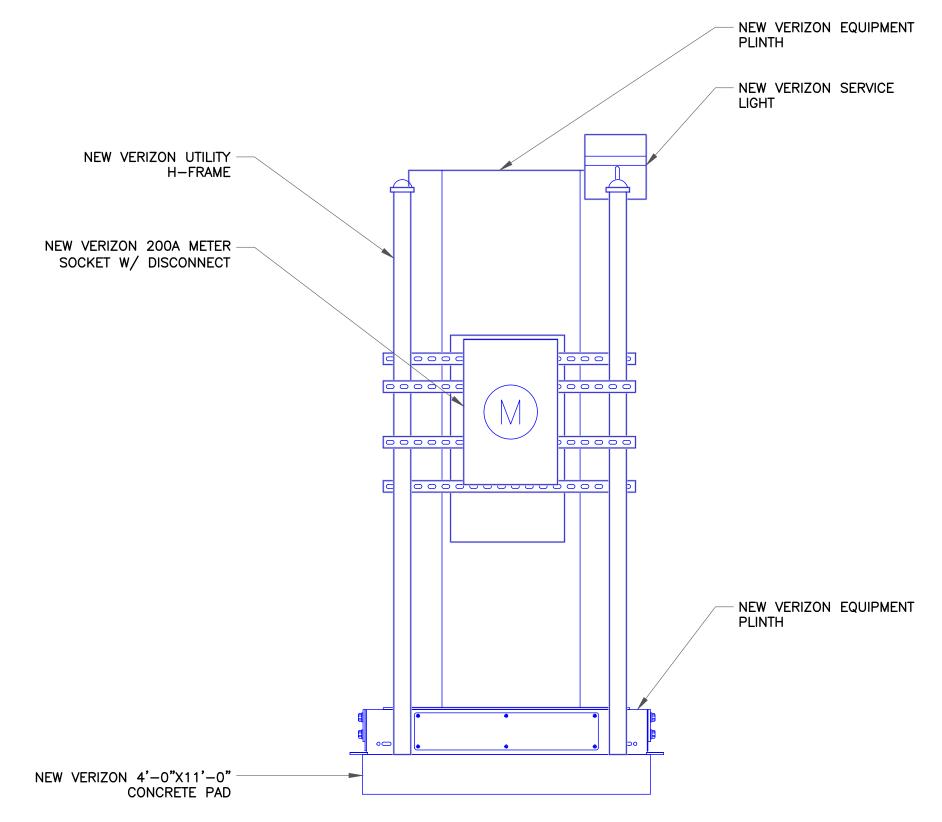





1825 W. WALNUT HILL LANE, SUITE 120 IRVING, TEXAS 75038

VERIZON SITE NUMBER: **716127**

BU #: **877803 KCYC LEES SUMMIT DT**207 SE DOUGLAS
LEE'S SUMMIT, MO 64063
EXISTING 180'-0" MONOPOLE


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SHEET NUMBER:

C-9




5 NEW VERIZON RACK MOUNTED OVP 6 NEW VERIZON EQUIPMENT H-FRAME

7 NEW VERIZON ILC CABINET

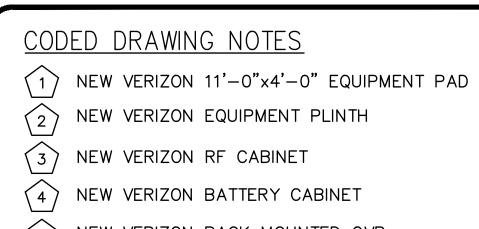8 NEW VERIZON APPLETON PLUG ON NEW ILC CABINET

9 NEW VERIZON 200A METER SOCKET W/ DISCONNECT


10) NEW VERIZON SERVICE LIGHTS

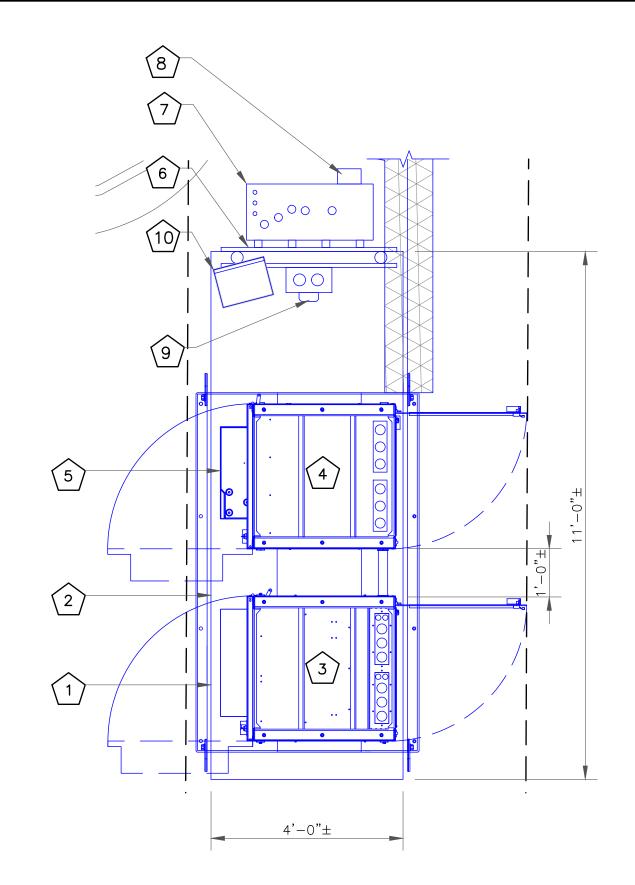

\ EQUIPMENT LAYOUT SCALE: NOT TO SCALE

ITEM# DESCRIPTION H-FRAME 1 UNISTRUT, 1-5/8"x1-5/8"x5', SLOTTED 2 PIPE CAP FOR 3.5" OD PIPE, HDG 3 U-BOLT KIT, 3.5" OD (1 U-BOLT) 4 END CAP, RED, 1-5/8" UNISTRUT UNISTRUT/SUPPORT RAIL 3.5" OD PIPE, 126" LONG 273 WEIGHT SEE PLAN NOTE: PIPE (5) SHALL NOT SEE PLAN EXCEED 6'-0" FINISH SLOPE TO DRAIN ---PROPOSED 3.5" DIA. SCH 40 PIPE GALVANIZED----PROPOSED 12" DIA. CONCRETE PIER (TYP) ---<u>FRONT</u> CONCRETE PIER H-FRAME CONCRETE SLAB INSTALLATION DETAIL

SCALE: NOT TO SCALE

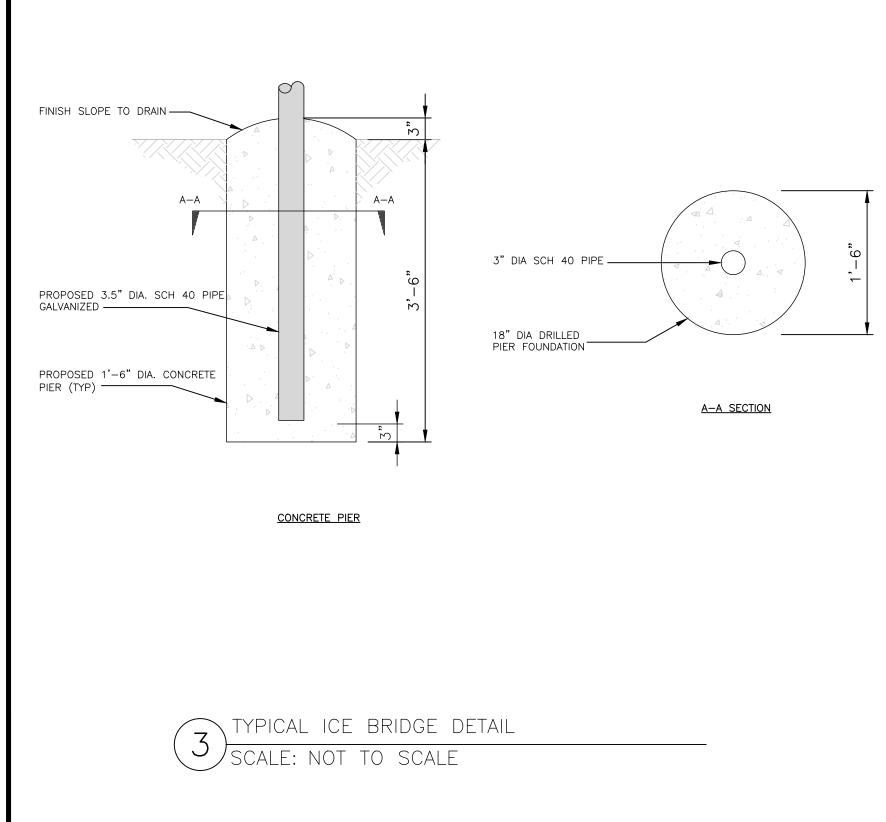

RELEASED FOR CONSTRUCTION As Noted on Plan Review **Development Services Department** Lee's Summit, Missouri 11/10/2023

NOT USED SCALE: NOT TO SCALE

JURISDICTIONAL APPROVAL:



BEDMINSTER, NJ 07921



MAHWAH, NJ 07430



IRVING, TEXAS 75038

VERIZON SITE NUMBER: **716127**

BU #: **877803** KCYC LEES SUMMIT DT 207 SE DOUGLAS LEE'S SUMMIT, MO 64063 EXISTING 180'-0" MONOPOLE

ISSUED FOR:					
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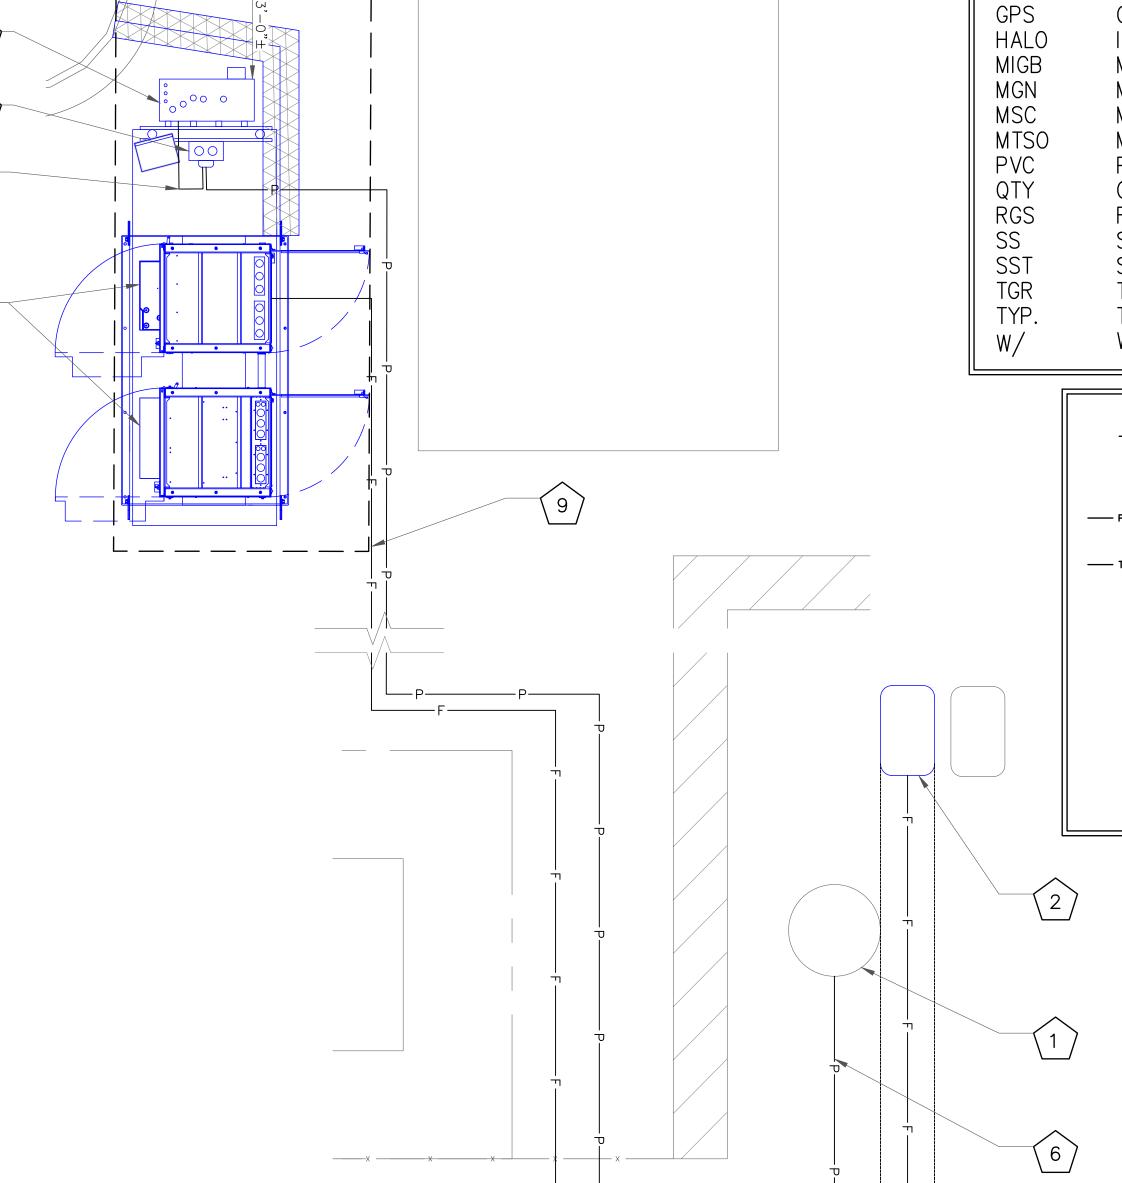
GENERAL ELECTRICAL NOTES:

- 1. ALL ELECTRICAL WORK SHALL BE IN ACCORDANCE WITH THE LATEST VERSION OF THE NATIONAL ELECTRICAL CODE AND ALL LOCAL AND STATE CODES, LAWS, AND ORDINANCES.
- 2. ALL UNDERGROUND CONDUIT SHALL BE PVC SCHEDULE 40 UNLESS OTHERWISE INDICATED. SUPPLY UTILITY MARKING TAPE BURIED 12" BELOW GRADE ALONG ENTIRE LENGTH OF UNDERGROUND CONDUITS.
- 3. ALL CONDUCTORS SHALL BE COPPER WITH THHN/THWN INSULATION. CONTROL CONDUCTORS SHALL BE STRANDED, POWER & LIGHTING CONDUCTORS SHALL BE SOLID FOR #10 & #12 CONDUCTORS AND STRANDED FOR ALL OTHER SIZES.
- 4. ELECTRICAL DRAWINGS ARE IN PART DIAGRAMMATIC. COORDINATE ELECTRICAL WORK WITH SITE CONDITIONS.
- 5. LOCATE ALL UNDERGROUND UTILITIES BEFORE TRENCHING. IF CONFLICTS ARISE, CONTACT UTILITY COMPANY AND ENGINEER IMMEDIATELY.
- 6. ALL EXPOSED CONDUITS SHALL HAVE WEATHERPROOF CAPS, NOT DUCT TAPE.
- 7. PROVIDE 200 LB TEST PULL WIRES IN EACH TELEPHONE AND POWER CONDUIT.
- 8. PULL BOXES SHALL BE INSTALLED AS NEEDED PER NEC UTILITY REQUIREMENTS.

CODED DRAWING NOTES:

- EXISTING UTILITY POLE
- NEW VERIZON FIBER HANDHOLE COVER SHALL BE STAMPED VERIZON
- NEW VERIZON 200A METER SOCKET W/ DISCONNECT
- NEW VERIZON CABINETS ON A NEW 11'-0"x4'-0" EQUIPMENT PAD
- NEW VERIZON ILC CABINET ON NEW EQUIPMENT H-FRAME
- EOR POWER (1) 2" SCH. 40 PVC CONDUIT FOR POWER FROM EXISTING UTILITY POLE TO NEW VERIZON 200A METER SOCKET W/ DISCONNECT
- (1) 4" SCH. 40 PVC CONDUIT FROM NEW VERIZON 200A METER SOCKET W/ DISCONNECT TO NEW ILC CABINET
- EOR TELCO (1) 4" SCH 40 PVC CONDUIT WITH (3) 1" INNERDUCTS, MULE TAPE AND TRACE WIRE FOR FIBER BETWEEN THE (2) NEW FIBER HANDHOLES (PENDING COORDINATION WITH LOCAL UTILITY COMPANY)
- EOR TELCO (1) 2" SCH 40 PVC CONDUIT WITH MULE TAPE FOR FIBER FROM THE NEW FIBER HANDHOLE TO THE EQUIPMENT CABINET.







AMERICAN WIRE GAUGE BARE COPPER WIRE BELOW FINISH GRADE BARE TINNED STRANDED CONDUIT

CAB CABINET

COAX ISOLATED GROUND BAR EXTERNAL

DIESEL LOCOMOTIVE CABLE DWG DRAWING

EXTERIOR GROUND RING

EXTERIOR ISOLATED GROUND BAR GROUND GLOBAL POSITIONING SYSTEM

INTERIOR GROUND RING MAIN ISOLATED GROUND BAR MULTI-GROUNDED NEUTRAL

MOBILE SWITCHING CENTER MOBILE TELEPHONE SWITCHING OFFICE POLYVINYL CHLORIDE

QUANTITY RIGID GALVANIZED STEEL

STAINLESS STEEL SELF SUPPORT TOWER TOWER GROUND RING

TYPICAL WITH

ELECTRICAL SYMBOLS:

RECEPTACLE BURIED POWER CONDUIT BURIED TELCO CONDUIT

(M)ELECTRICAL METER

INDICATES CODED NUMBER

UTILITY POLE

SAFETY SWITCH

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> **Development Services Department** Lee's Summit, Missouri 11/10/2023

JURISDICTIONAL APPROVAL:

BEDMINSTER, NJ 07921




MAHWAH, NJ 07430 Trylon

1825 W. WALNUT HILL LANE, SUITE 120 IRVING, TEXAS 75038

VERIZON SITE NUMBER: 716127

BU #: **877803** KCYC LEES SUMMIT DT 207 SE DOUGLAS LEE'S SUMMIT, MO 64063 EXISTING 180'-0" MONOPOLE

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SHEET NUMBER:

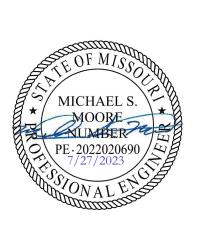REVISION:

CONTRACTOR TO LOCATE ALL UNDERGROUND UTILITIES PRIOR TO CONSTRUCTION. COORDINATE LOCATION OF ALL PROPOSED DIGGING & UNDERGROUND UTILITIES PRIOR TO CONSTRUCTION

OVERALL CONDUIT LAYOUT SCALE: NOT TO SCALE

CODED DRAWING NOTES:


- EXISTING UTILITY POLE
- NEW VERIZON FIBER HANDHOLE (MEET ME POINT)
- NEW VERIZON 200A METER SOCKET W/ DISCONNECT
- NEW VERIZON CABINETS ON A NEW 4'-0"x11'-0" EQUIPMENT PAD
- NEW VERIZON ILC CABINET ON NEW EQUIPMENT H-FRAME
- EOR POWER (1) 2" SCH. 40 PVC CONDUIT FOR POWER FROM EXISTING UTILITY POLE TO NEW VERIZON 200A METER SOCKET W/ DISCONNECT
- (1) 4" SCH. 40 PVC CONDUIT FROM NEW VERIZON 200A METER SOCKET W/DISCONNECT TO NEW ILC CABINET
- EOR TELCO (1) 4" GRC OR LIQUIDTIGHT CONDUIT FOR FIBER FROM NEW FIBER HANDHOLE TO NEW VERIZON BBU CABINET (PENDING COORDINATION WITH LOCAL UTILITY COMPANY)
- (9) FOR POWER (1) 2" SCH. 40 PVC CONDUIT FROM EXISTING UTILITY POLE (NOT SHOWN) TO PROPOSED VERIZON METER/DISCONNECT SWITCH (NOT SHOWN) (PENDING COORDINATION WITH LOCAL UTILITY COMPANY)
- (1) 4" SCH. 40 PVC CONDUIT FROM PROPOSED ELECTRIC METER/DISCONNECT SWITCH (NOT SHOWN) TO PROPOSED ILC CABINET
- (1) (1) 1" SCH. 40 PVC CONDUIT FOR ALARMS FROM PROPOSED VERIZON ILC CABINET TO PROPOSED VERIZON BACKUP GENERATOR (CONTRACTOR TO SUPPLY SIZE/QTY CONDUCTORS PER MANUFACTURER SPECIFICATIONS)
- (12) (1) 2" SCH. 40 PVC CONDUIT FOR POWER FROM PROPOSED VERIZON ILC CABINET TO PROPOSED VERIZON BACKUP GENERATOR (CONTRACTOR TO SUPPLY SIZE/1TY CONDUCTORS PER MANUFACTURER SPECIFICATIONS)
- (13) (1) 2" SCH 40 PVC CONDUIT FROM PROPOSED VERIZON ILC CABINET TO PROPOSED VERIZON POWER DISTRIBUTION CABINET (CONTRACTOR TO SUPPLY SIZE/QTY CONDUCTORS PER MANUFACTURER SPECIFICATIONS)
- (1) 2" GRC OR LIQUIDTIGHT CONDUIT FROM PROPOSED VERIZON POWER DISTRIBUTION CABINET TO PROPOSED VERIZON BBU CABINET
- FOR TELCO (1) 2" SCH 40 PVC CONDUIT WITH MULE TAPE FOR FIBER FROM THE NEW FIBER HANDHOLE TO THE EQUIPMENT CABINET.

NOTE: ICE BRIDGE NOT SHOWN FOR CLARITY.

CONTRACTOR TO LOCATE ALL UNDERGROUND UTILITIES PRIOR TO CONSTRUCTION. COORDINATE LOCATION OF ALL PROPOSED DIGGING & UNDERGROUND UTILITIES PRIOR TO CONSTRUCTION.

GENERAL ELECTRICAL NOTES:

- 1. ALL ELECTRICAL WORK SHALL BE IN ACCORDANCE WITH THE LATEST VERSION OF THE NATIONAL ELECTRICAL CODE AND ALL LOCAL AND STATE CODES, LAWS, AND ORDINANCES.
- 2. ALL UNDERGROUND CONDUIT SHALL BE PVC SCHEDULE 40 UNLESS OTHERWISE INDICATED. SUPPLY UTILITY MARKING TAPE BURIED 12" BELOW GRADE ALONG ENTIRE LENGTH OF UNDERGROUND CONDUITS.
- 3. ALL CONDUCTORS SHALL BE COPPER WITH THHN/THWN INSULATION. CONTROL CONDUCTORS SHALL BE STRANDED POWER & LIGHTING CONDUCTORS SHALL BE SOLID FOR #10 & #12 CONDUCTORS AND STRANDED FOR ALL OTHER SIZES.
- 4. ELECTRICAL DRAWINGS ARE IN PART DIAGRAMMATIC. COORDINATE ELECTRICAL WORK WITH SITE CONDITIONS.
- 5. LOCATE ALL UNDERGROUND UTILITIES BEFORE TRENCHING. IF CONFLICTS ARISE, CONTACT UTILITY COMPANY AND ENGINEER IMMEDIATELY.
- 6. ALL EXPOSED CONDUITS SHALL HAVE WEATHERPROOF CAPS, NOT DUCT TAPE.
- 7. PROVIDE 200 LB TEST PULL WIRES IN EACH TELEPHONE AND POWER CONDUIT.
- 8. PULL BOXES SHALL BE INSTALLED AS NEEDED PER NEC

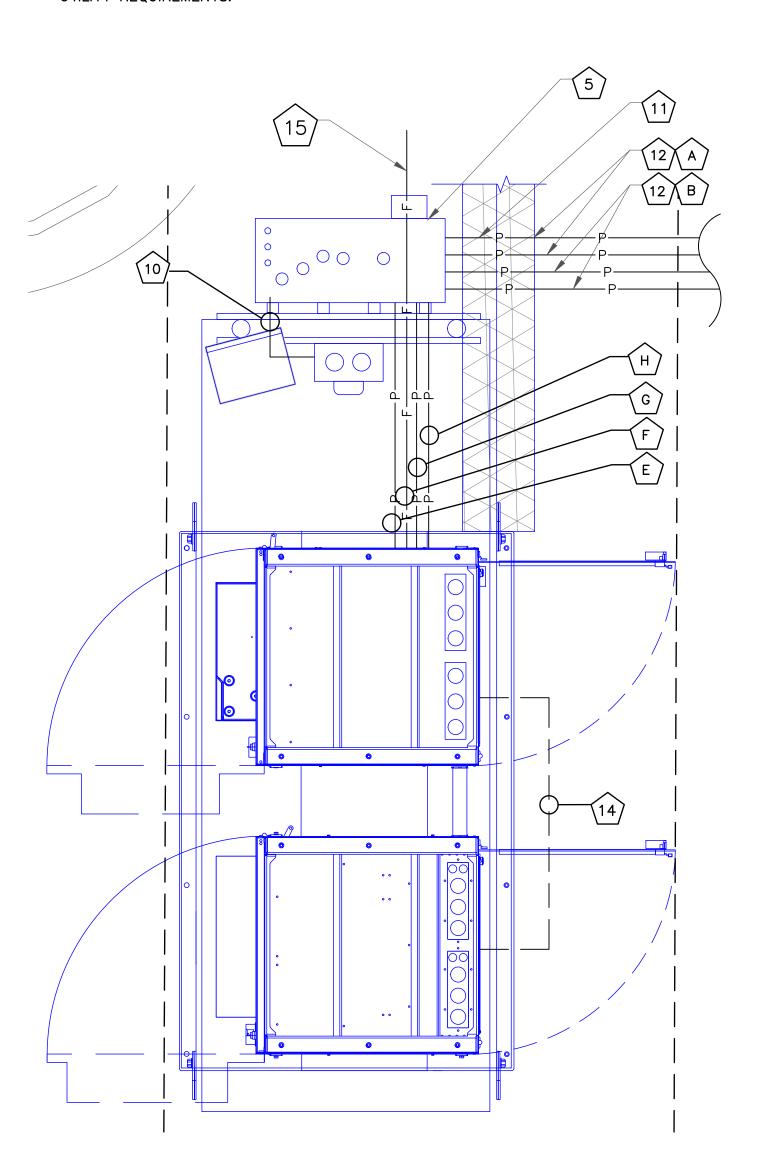

EQUIPMENT CONDUIT LAYOUT SCALE: NOT TO SCALE

ABBREVIATIONS:

AMERICAN WIRE GAUGE BARE COPPER WIRE BELOW FINISH GRADE BARE TINNED STRANDED CONDUIT COAX ISOLATED GROUND BAR EXTERNAL DIESEL LOCOMOTIVE CABLE EGR EXTERIOR GROUND RING EXTERIOR ISOLATED GROUND BAR GLOBAL POSITIONING SYSTEM INTERIOR GROUND RING MAIN ISOLATED GROUND BAR MULTI-GROUNDED NEUTRAL MOBILE TELEPHONE SWITCHING OFFICE POLYVINYL CHLORIDE QUANTITY RIGID GALVANIZED STEEL STAINLESS STEEL SELF SUPPORT TOWER TOWER GROUND RING

> **ELECTRICAL SYMBOLS:** RECEPTACLE BURIED POWER CONDUIT BURIED TELCO CONDUIT M ELECTRICAL METER INDICATES CODED NUMBER SAFETY SWITCH UTILITY POLE

GENERATOR CONDUITS:

- A. (1) 2" CONDUIT (AC POWER) ILC TO GENERATOR
- B. (1) 1" CONDUIT WITH 2 #12 AC CIRCUITS (CHARGER AND HEATER) ILC TO GENERATOR
- C. (1) 1" CONDUIT WITH 1 #14 DC CIRCUIT (START/STOP) ILC TO GENERATOR
- D. (1) 1" CONDUIT WITH 2 CAT5'S (1 TO THE TRANSFER SWITCH AND 1 TO THE GENERATOR) ILC TO GENERATOR

- E. (1) 2" CONDUIT (AC POWER) ILC TO EQUIPMENT CABINET/PLINTH
- F. (1) 2"CONDUIT (ALARMS) ILC TO EQUIPMENT
- CABINET/PLINTH G. (1) 2" CONDUIT (FUTURE) ILC TO EQUIPMENT
- CABINET/PLINTH
- H. (1) 3"CONDUIT (OR PER JURISDICTION) (MAIN POWER)

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> **Development Services Department** Lee's Summit, Missouri

11/10/2023

JURISDICTIONAL APPROVAL:







IRVING, TEXAS 75038

Trylon

VERIZON SITE NUMBER: 716127

BU #: **877803** KCYC LEES SUMMIT DT 207 SE DOUGLAS LEE'S SUMMIT, MO 64063 EXISTING 180'-0" MONOPOLE

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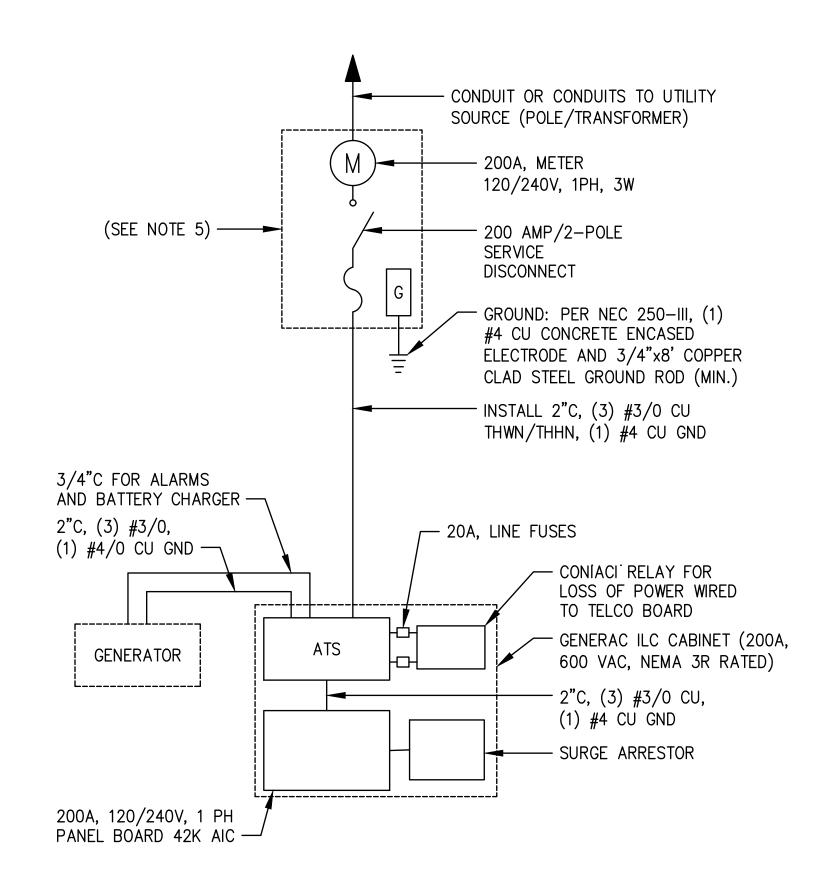



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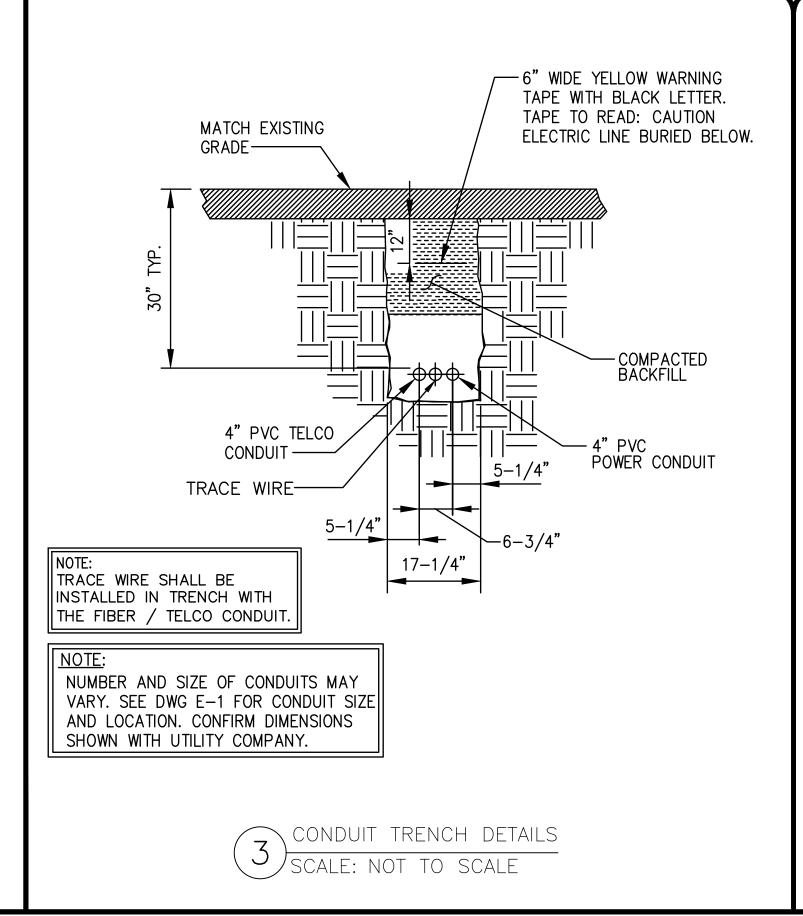
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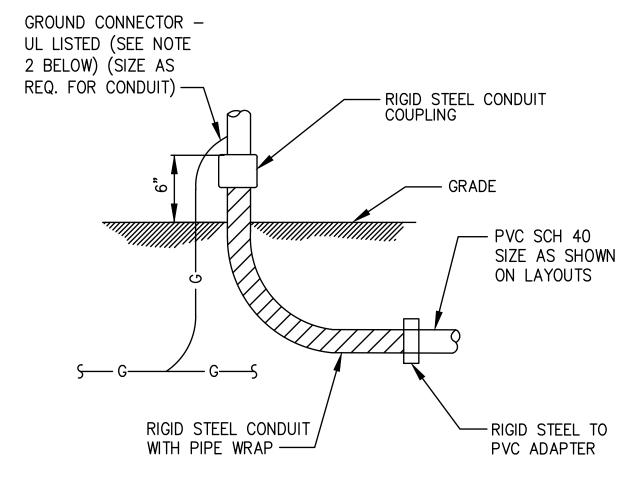
POWER NOTES:

- (1) ALL SERVICE EQUIPMENT SHALL USE EUSERC/POWER COMPANY REQUIREMENTS AND BE REVIEWED & APPROVED BY POWER COMPANY PRIOR TO CONSTRUCTION.
- (2) ALL CONDUITS MUST BE COPPER UNLESS OTHERWISE SPECIFIED.
- (3) CONTRACTOR SHALL COORDINATE WITH UTILITY COMPANY FOR FINAL AND EXACT WORK/MATERIALS REQUIREMENTS & CONSTRUCT TO UTILITY ENGINEERING PLANS & SPECIFICATIONS ONLY.
- (4) CONTRACTOR SHALL FURNISH AND INSTALL CONDUITS, PULL WIRES, CABLE PULL BOXES, CONCRETE ENCASEMENT OF CONDUITS, TRANSFORMER PAD, BARRIERS, POLE RISER TRENCHING, BACK FILL, PAY ALL UTILITY FEES, & INCLUDE REQUIREMENTS IN SCOPE
- (5) COMMERCIAL ELECTRICAL SERVICE COMBINATION METER AND MAIN DISCONNECT, 200A 120/240V, 1—PHASE, 3—WIRE, RING—TYPE, WITH TEST—PASS FACILITIES, 10K AIC, NEMA 3R ENCLOSURE
- (6) THE DESIGN CRITERIA USED FOR THIS PROJECT WAS THE 2014 NEC







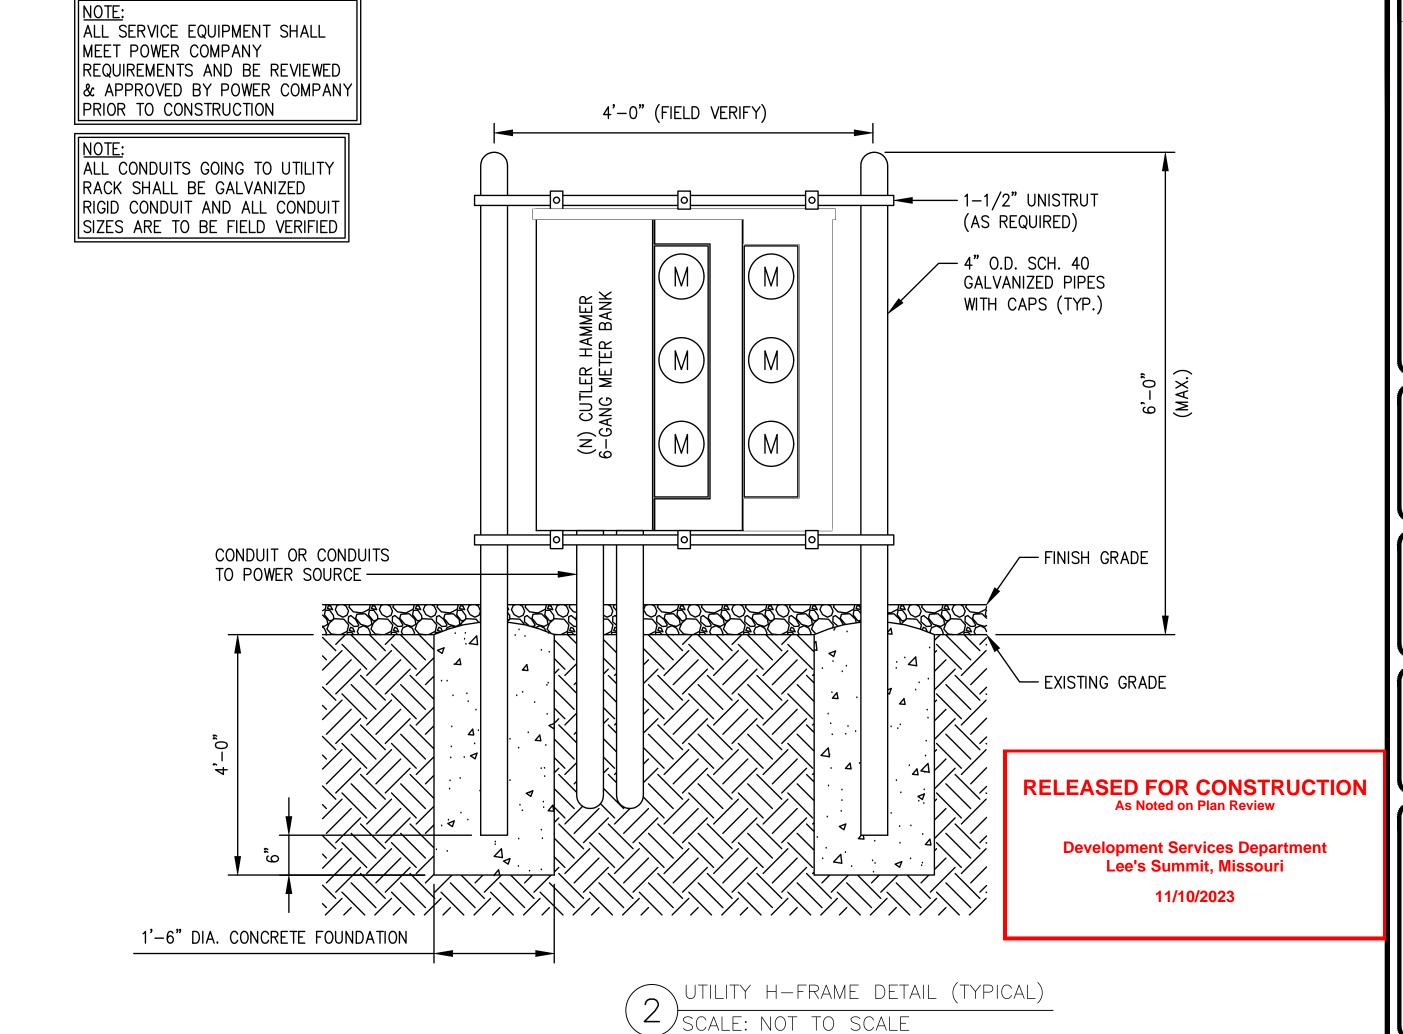

NOTES:

1. ALL CONDUIT ABOVE GRADE MUST BE RIGID STEEL OR LIQUIDTIGHT
2. ALL NEW STRUCTURAL STEEL SHALL BE HOT DIP GALVANIZED IN
ACCORDANCE WITH ASTM A123 G90 AFTER FABRICATION.
3. FIELD ABRASIONS SHALL BE TOUCH UP PAINTED WITH ZINC RICH
GALVANIZING REPAIR PAINT IN ACCORDANCE WITH ASTM A780.
4. ALL EXPOSED ENDS OF CONDUITS SHALL HAVE WEATHER
PROOF CAPS. DO NOT USE DUCT TAPE.
5. PROVIDE 200LB. TEST PULL WIRES IN EACH TELEPHONE AND
POWER CONDUIT. STUB CONDUITS INTO ENCLOSURE AND LABEL.

4 UNDERGROUND CONDUIT STUB-UP SCALE: NOT TO SCALE



JURISDICTIONAL APPROVAL:





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VERIZON SITE NUMBER: 716127

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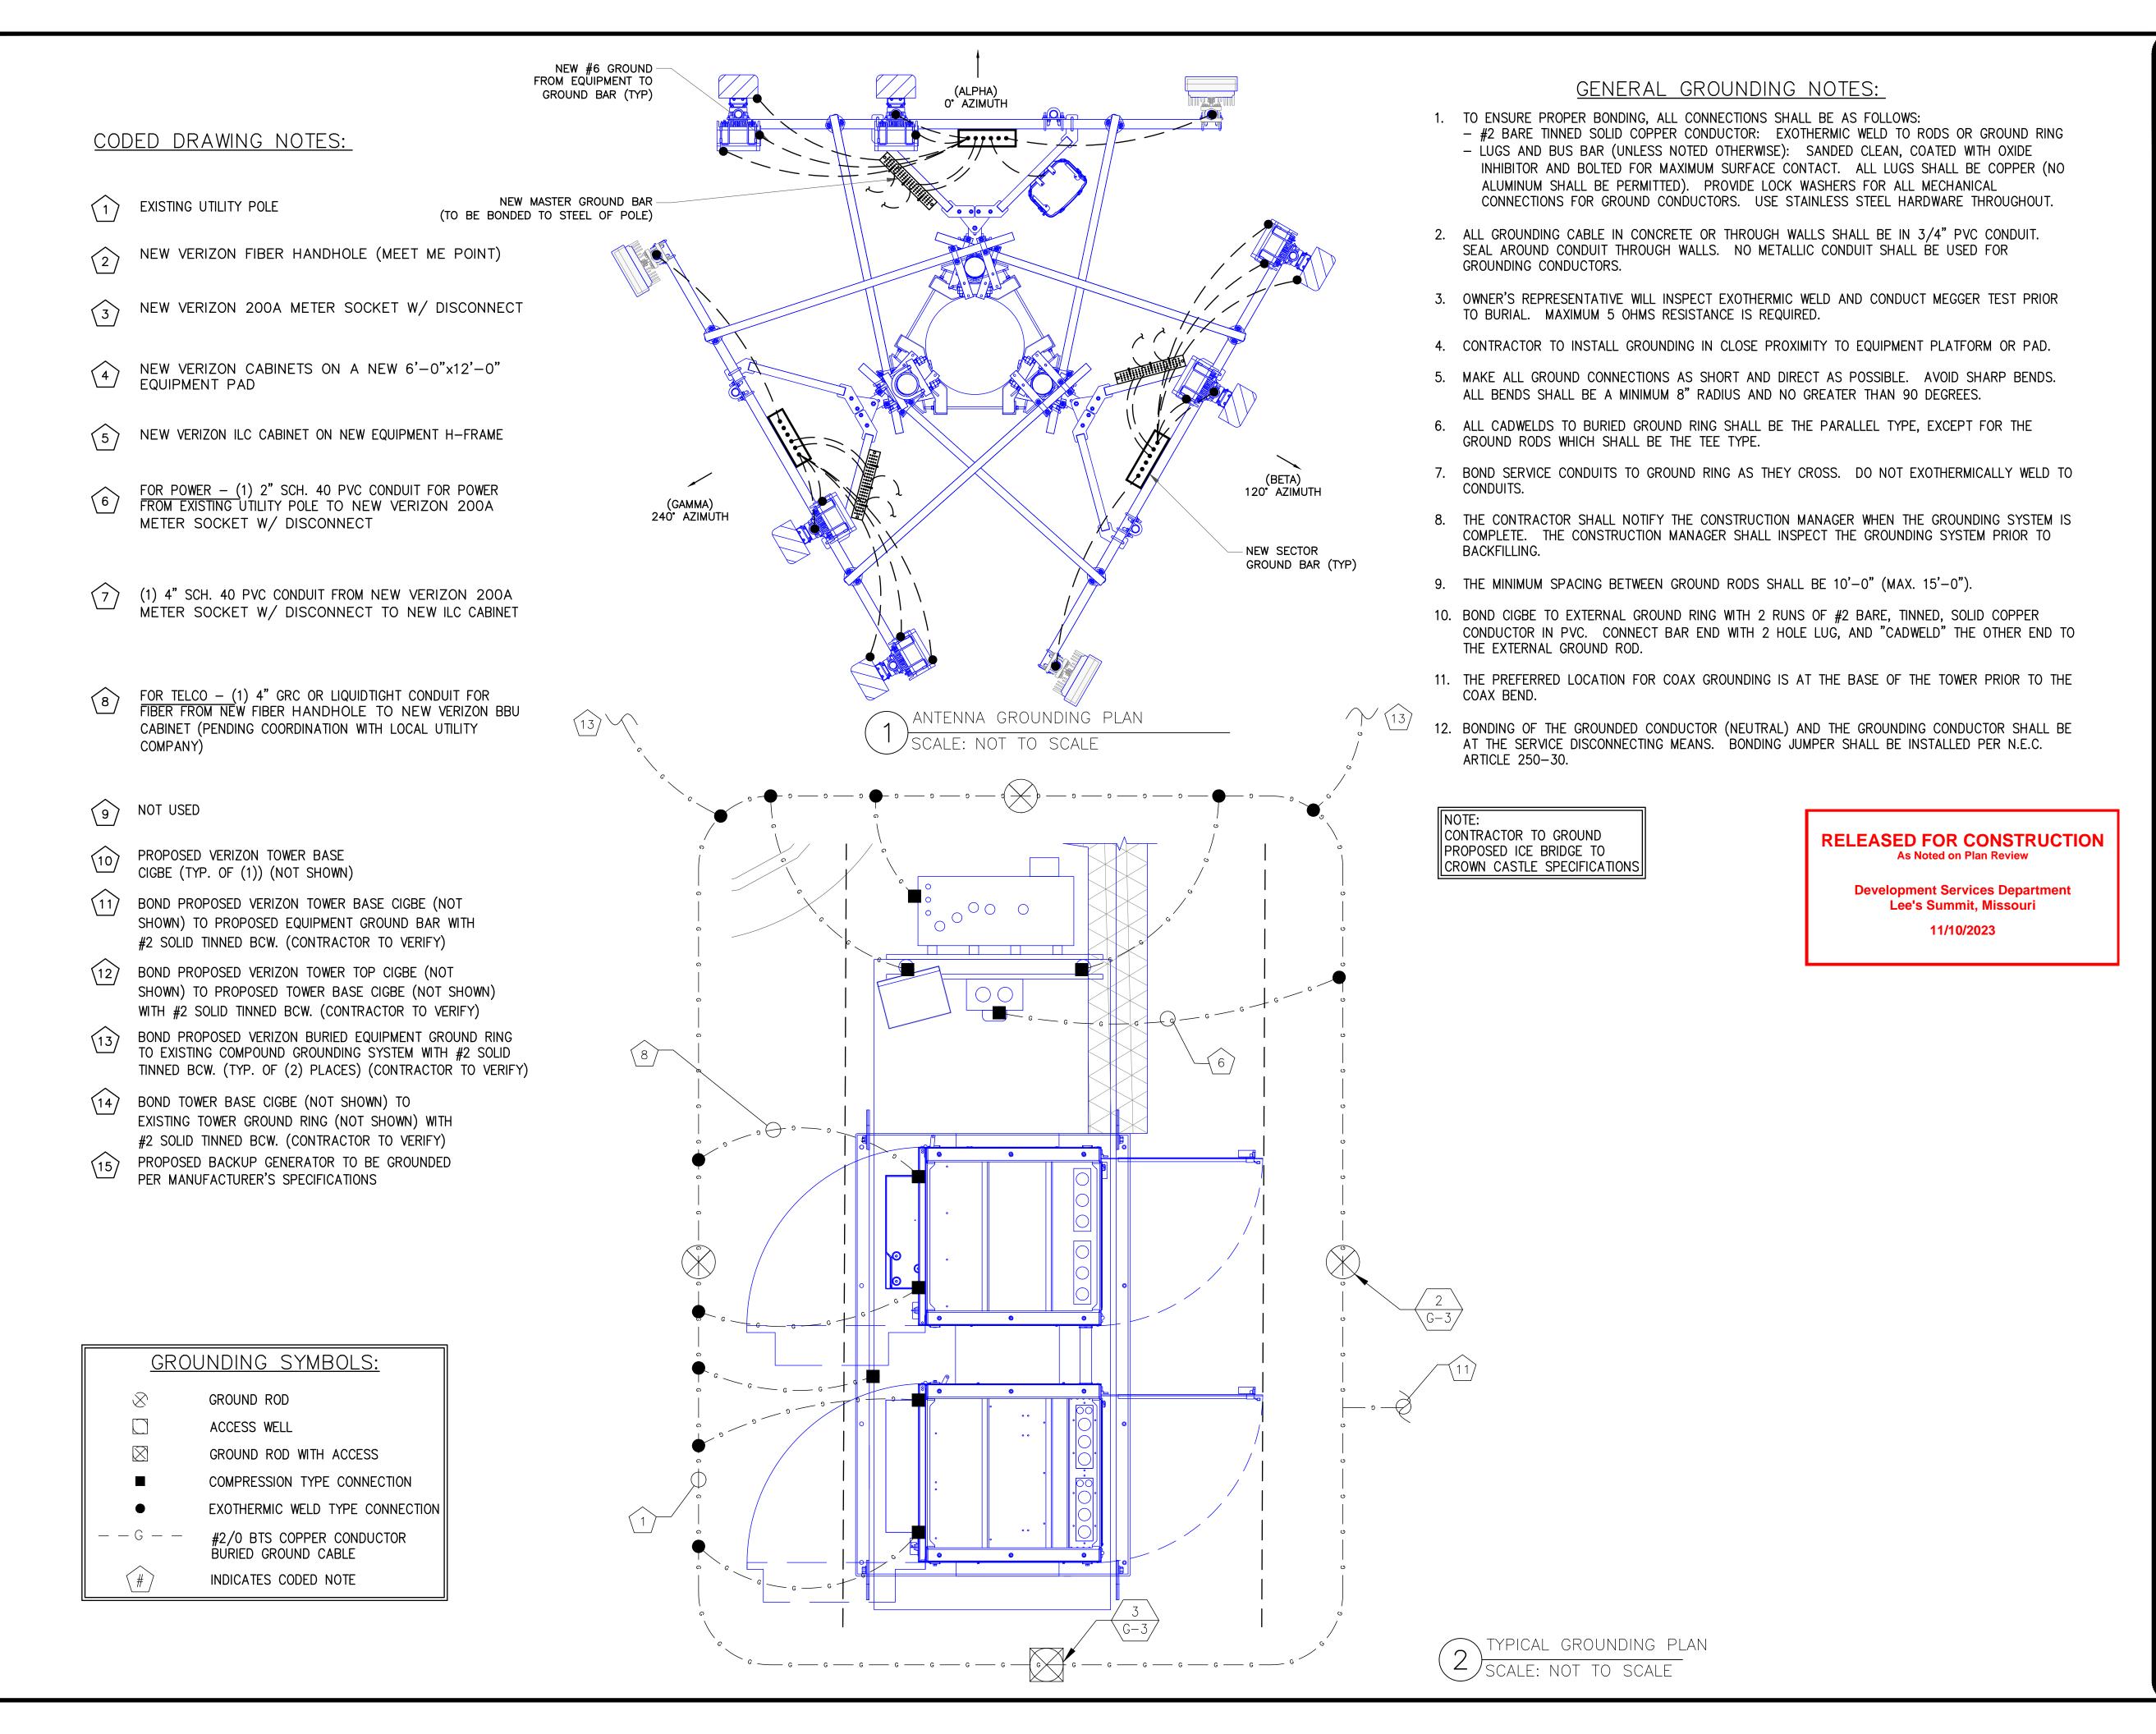


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SHEET NUMBER:

REVISION:

1 ELECTRICAL ONE LINE DIAGRAM (TYPICAL)
SCALE: NOT TO SCALE









MAHWAH, NJ 07430

1825 W. WALNUT HILL LANE, SUITE 120 IRVING, TEXAS 75038

VERIZON SITE NUMBER: 716127

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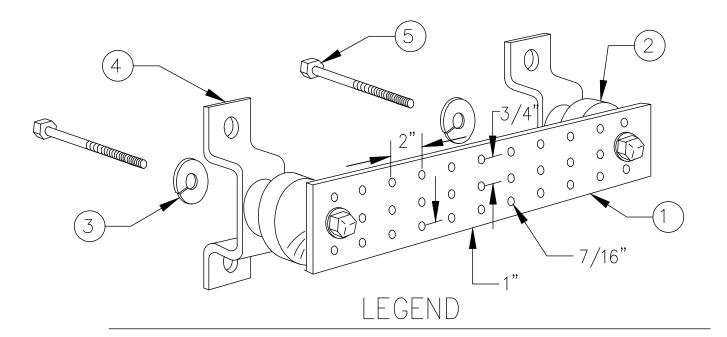


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G-1

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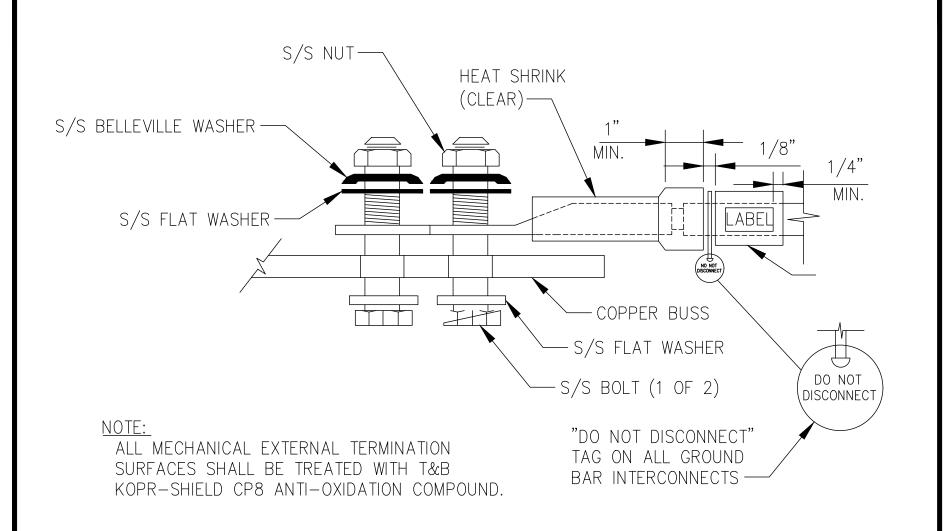


- 1. TINNED COPPER GROUND BAR, 1/4"x4"x20", NEWTON INSTRUMENT CO., HARGER
- TGBI14420M, OR EQUIVALENT. HOLE CENTERS TO MATCH
- 2. NEMA DOUBLE LUG CONFIGURATION.
- 3. INSULATORS, NEWTON INSTRUMENT CO. CAT. NO. 3061-4 OR HARGER EQUIVALENT.
- 4. 5/8" LOCKWASHERS, NEWTON INSTRUMENT CO. CAT. NO. 3015-8 OR EQUIVALENT.
- 5. WALL MOUNTING BRACKET, NEWTON INSTRUMENT CO. CAT. NO. A-6056 OR HARGER EQUIVALENT.
- 6. 5/8-11"x1" H.H.C.S. BOLTS, NEWTON INSTRUMENT CO. CAT. NO. 3012-1 OR HARGER EQUIVALENT.


NOIES:

1. ALL MOUNTING HARDWARE CAN ALSO BE USED ON 6", 12", 18", ETC. GROUND BARS. 2. ENTIRE ESSEMBLY AVAILABLE FROM NEWTON INSTRUMENT CO. CAT. NO. 2106060010 OF AS HARGER TGBI14420M.





TYPICAL EQUIPMENT GROUND CONNECTION (2) SCALE: NOT TO SCALE

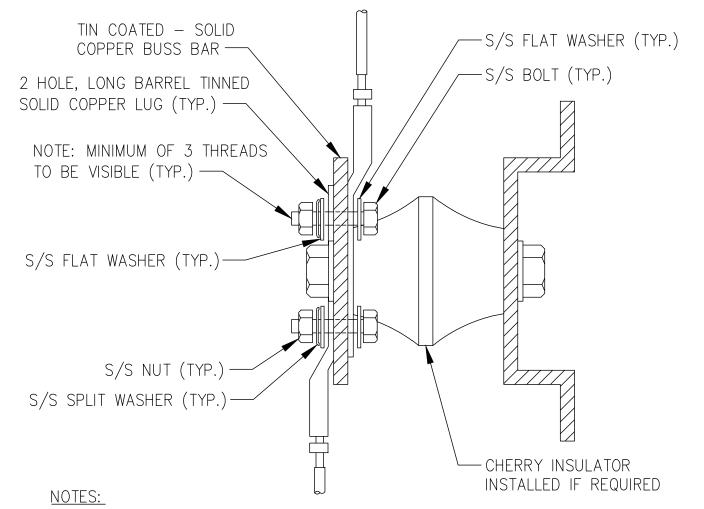


1. ALL HARDWARE 18-8 STAINLESS STEEL INCLUDING SPLIT WASHERS. 2. COAT WIRE END WITH ANTI-OXIDATION COMPOUND PRIOR TO INSERTION INTO LUG BARREL AND CRIMPING. 3. APPLY ANTI-OXIDATION COMPOUND BETWEEN ALL LUGS AND BUSS BARS

TYPICAL GROUND LUG (3) SCALE: NOT TO SCALE


PRIOR TO MATING AND BOLTING.



11/10/2023

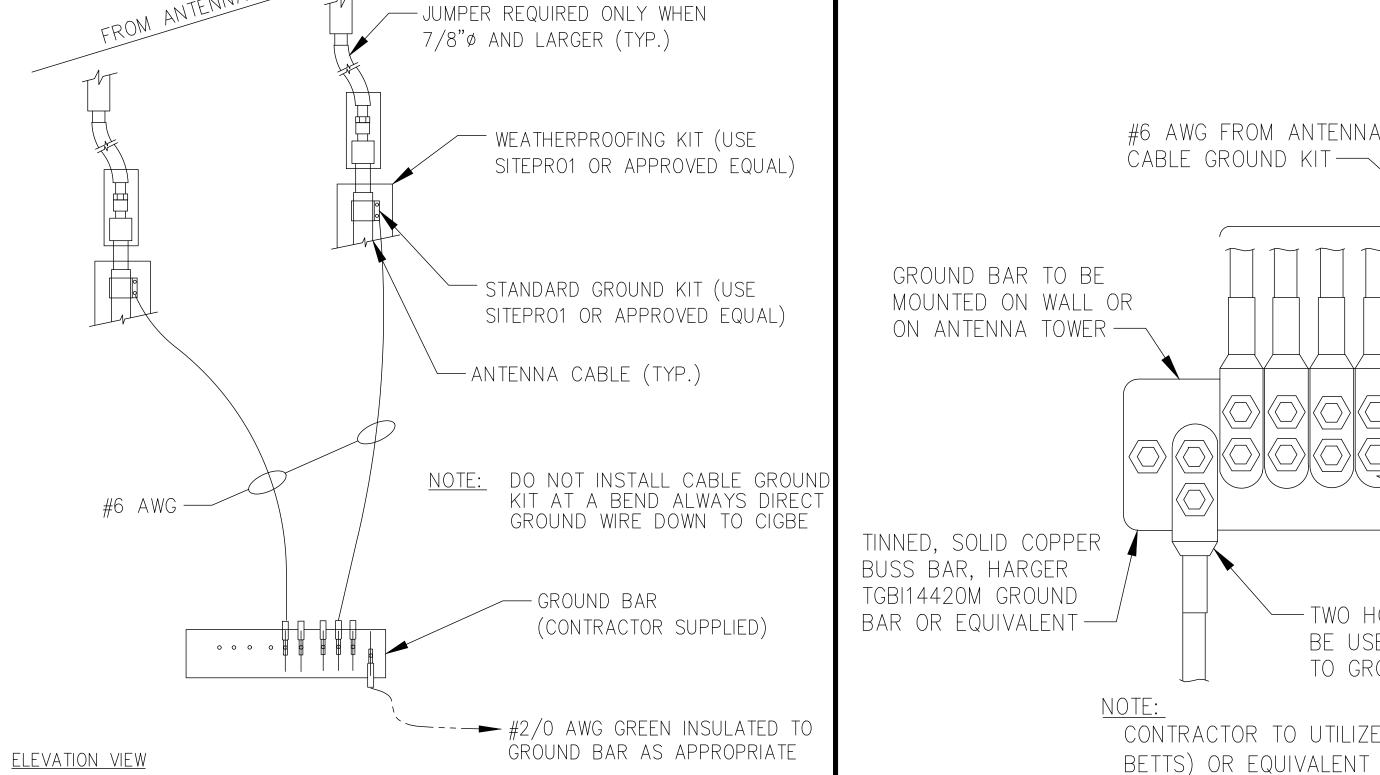


TYPICAL CONNECTION OF GROUND WIRES TO GROUNDING BARS@ANTENNA SCALE: NOT TO SCALE

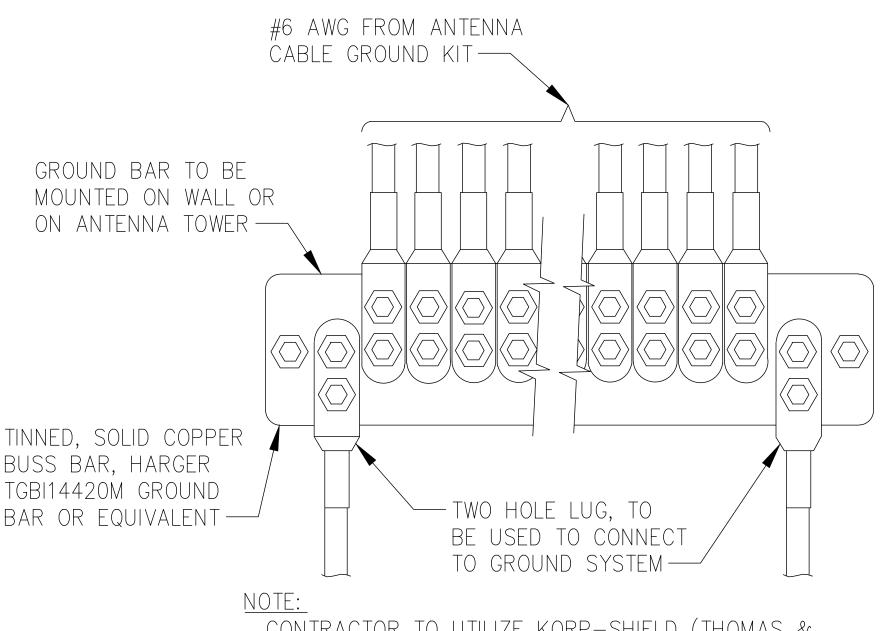

CONTRACTOR TO UTILIZE KORP-SHIELD (THOMAS & BETTS) OR EQUIVALENT ON ALL LUG CONNECTIONS

TYPCAL ANTENNA GROUND BAR SCALE: NOT TO SCALE

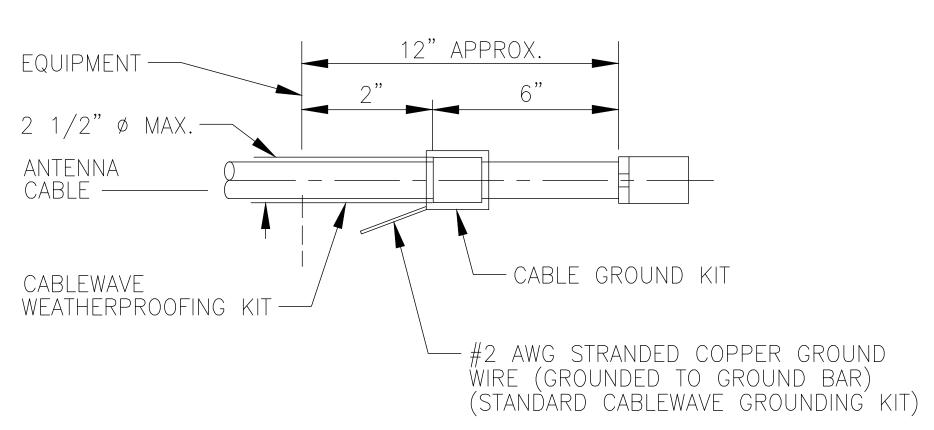

TO ANTENNA CABLE

DO NOT INSTALL CABLE GROUND KIT AT A BEND AND ALWAYS DIRECT GROUND WIRE DOWN TO GROUND BAR.

> TYPICAL CABLE GROUND KIT CONNECTION SCALE: NOT TO SCALE

Development Services Department Lee's Summit, Missouri

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A	02/14/2023	RC	PRELIMINARY	АМТ			
В	02/17/2023	RC	PRELIMINARY	АМТ			
0	03/17/2023	RC	FINAL	EAN			
1	06/21/2023	RC	FINAL	EAN			
2	07/27/2023	RC	FINAL	AMT			

JURISDICTIONAL APPROVAL:

180 WASHINGTON VALLEY ROAD

BEDMINSTER, NJ 07921

1200 MACARTHUR BLVD, SUITE 200 MAHWAH, NJ 07430

Trylon

1825 W. WALNUT HILL LANE, SUITE 120 IRVING, TEXAS 75038

VERIZON SITE NUMBER: 716127

BU #: **877803**

KCYC LEES SUMMIT DT

207 SE DOUGLAS

LEE'S SUMMIT, MO 64063

EXISTING 180'-0" MONOPOLE


CROWN

CASTLE




IT IS A VIOLATION OF LAW FOR ANY PERSON, UNLESS THEY ARE ACTING UNDER THE DIRECTION OF A LICENSED PROFESSIONAL ENGINEER, TO ALTER THIS DOCUMENT.

SHEET NUMBER:

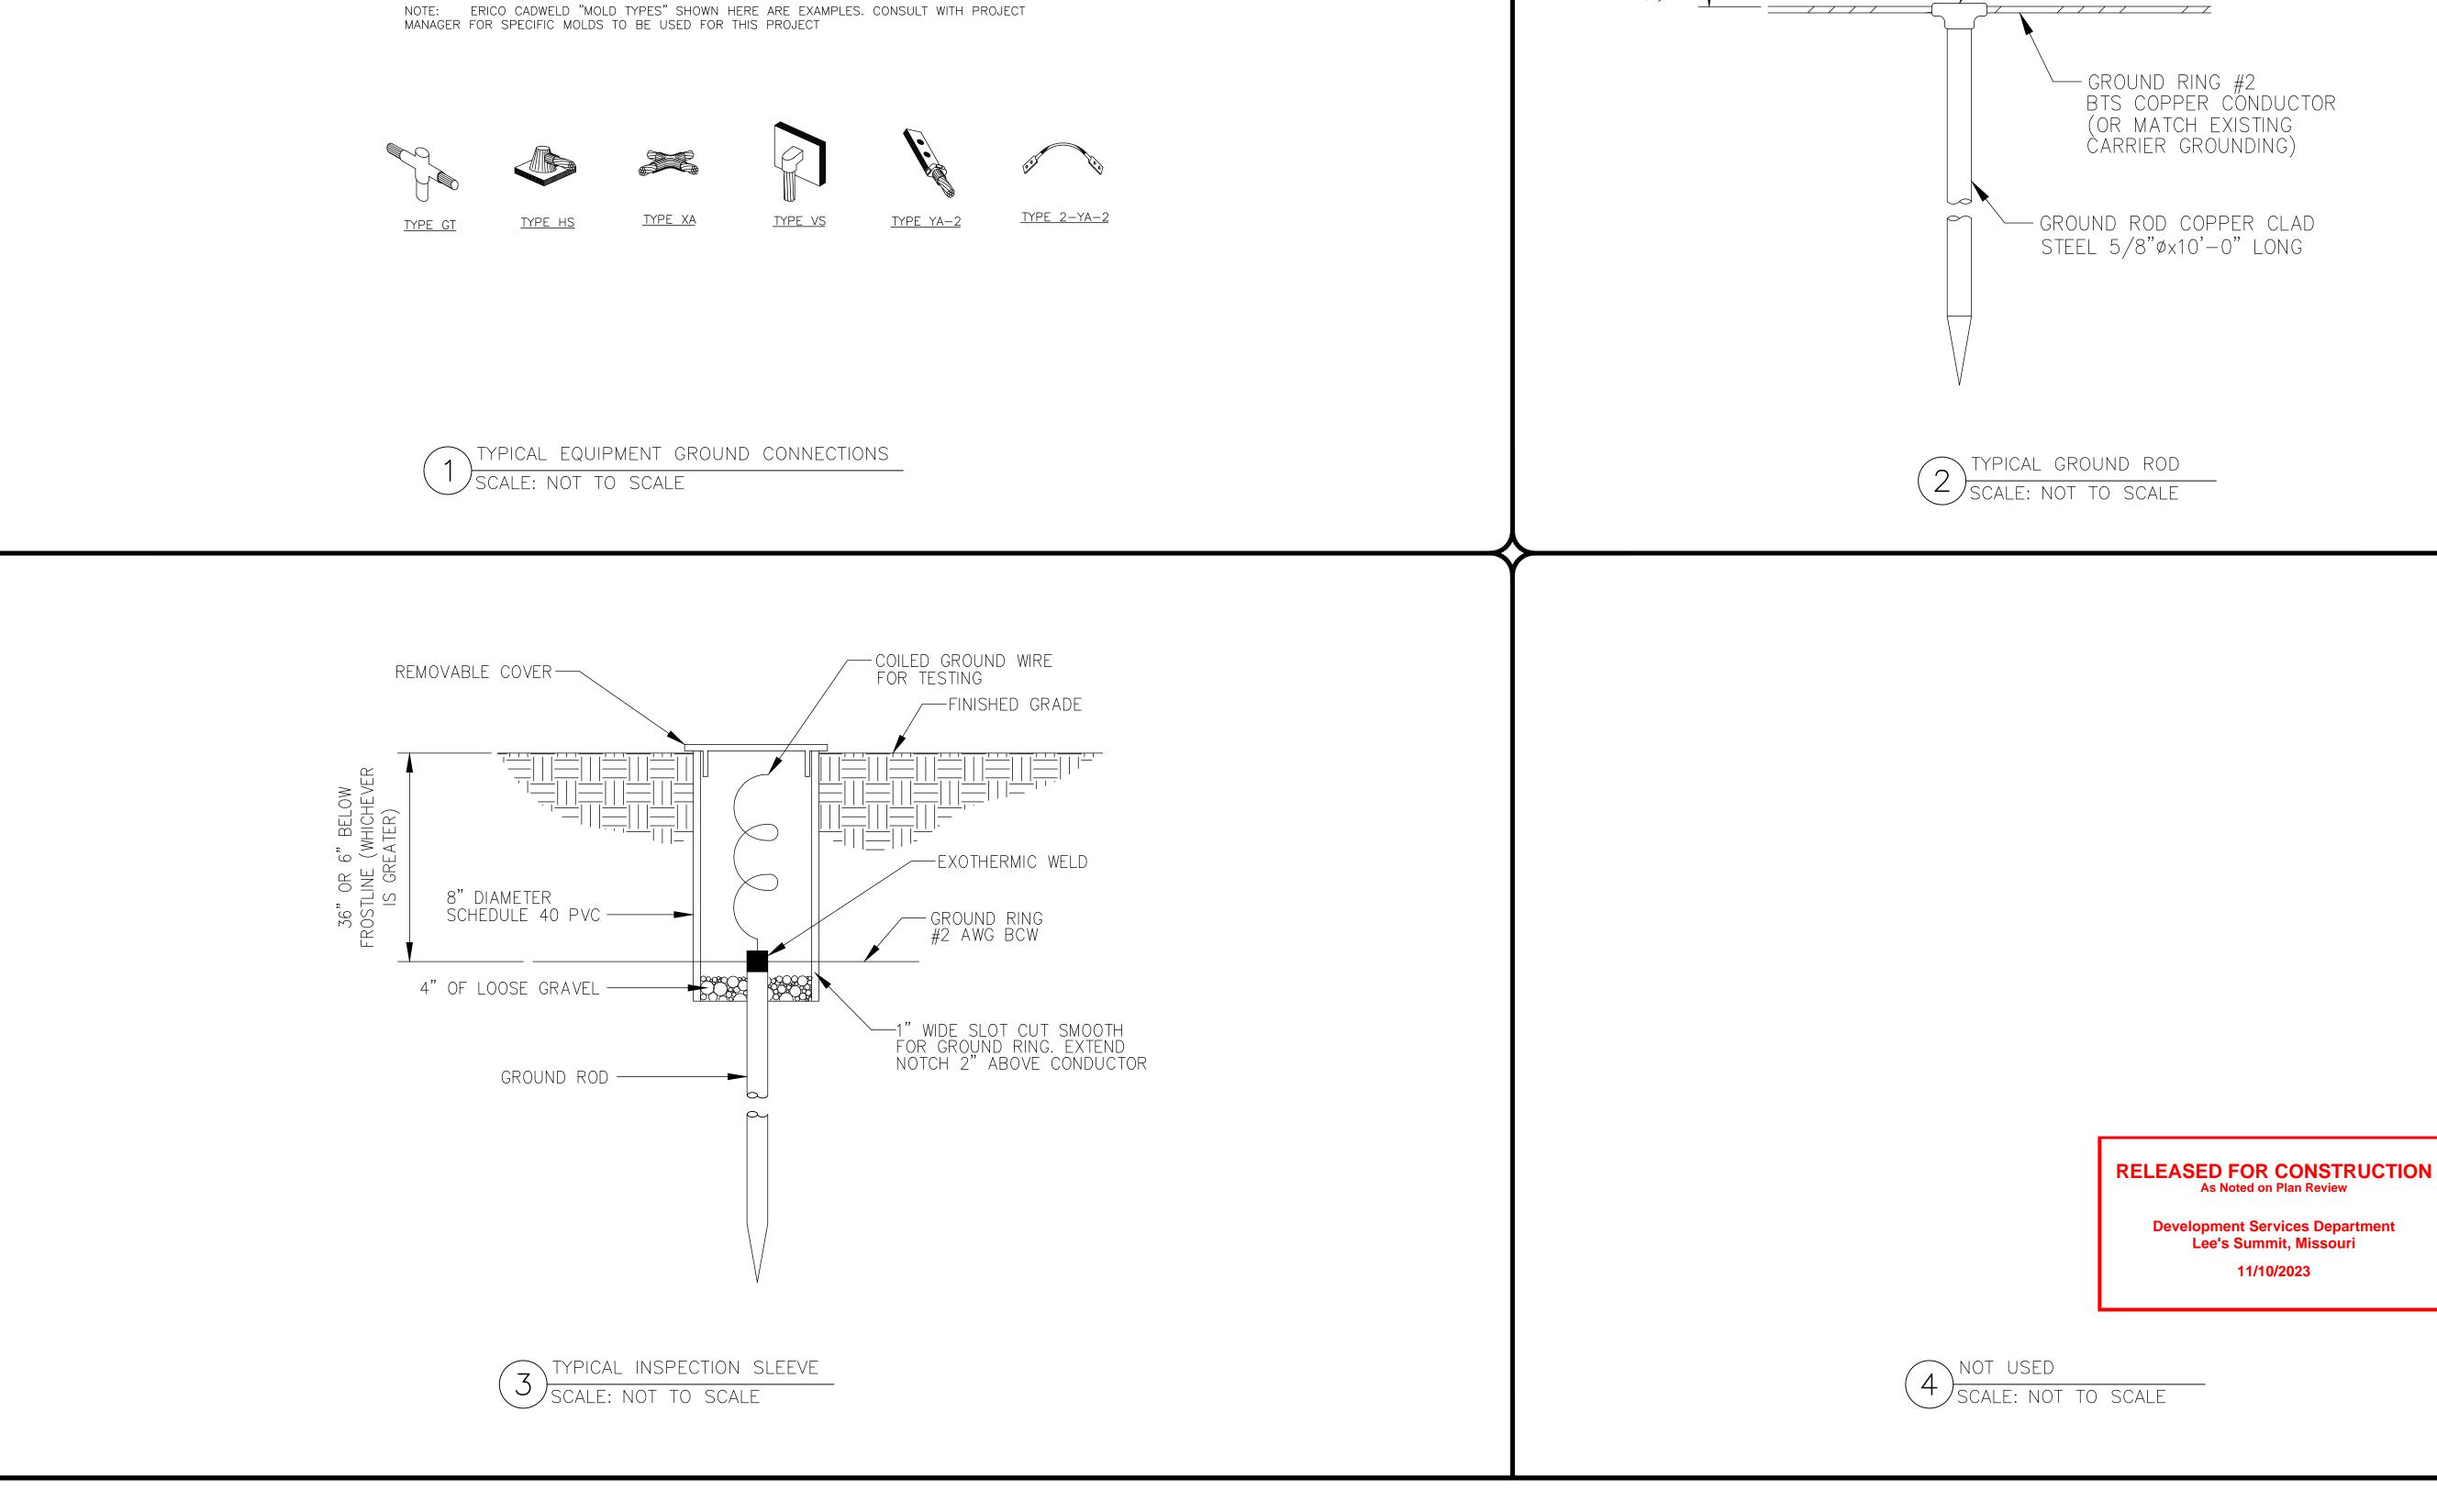

TYPE SS

TYPE PT

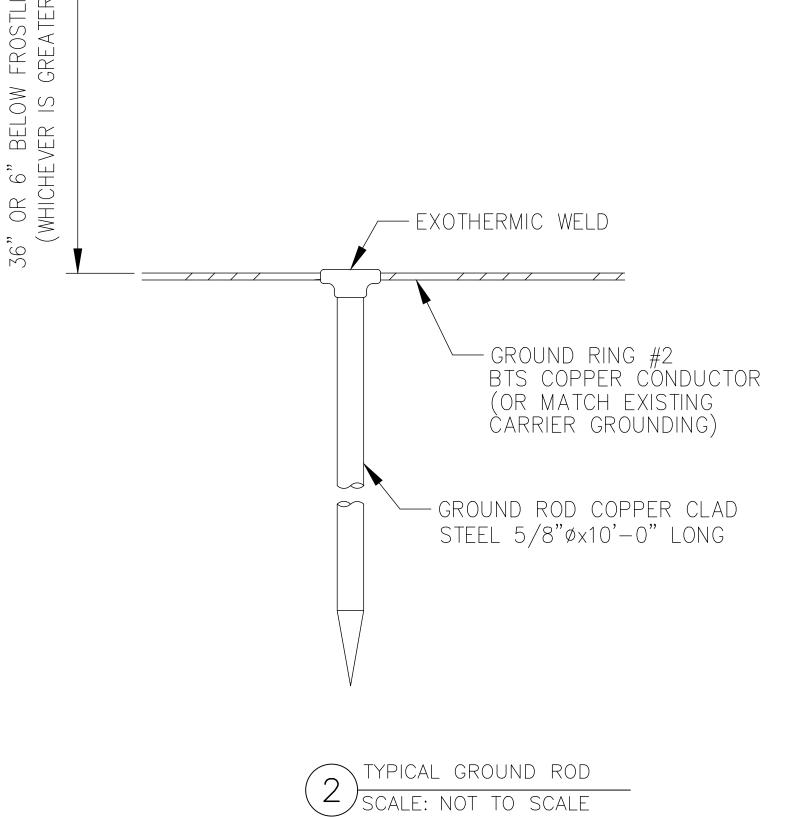

GRADE

Y/KY/K

7/2/2/



180 WASHINGTON VALLEY ROAD BEDMINSTER, NJ 07921

JURISDICTIONAL APPROVAL:


Trylon

1825 W. WALNUT HILL LANE, SUITE 120 IRVING, TEXAS 75038

VERIZON SITE NUMBER: 716127

BU #: **877803** KCYC LEES SUMMIT DT 207 SE DOUGLAS LEE'S SUMMIT, MO 64063 EXISTING 180'-0" MONOPOLE

	ISSUED FOR:						
REV	DATE	DRWN	DESCRIPTION	DES./QA			
A	02/14/2023	RC	PRELIMINARY	AMT			
В	02/17/2023	RC	PRELIMINARY	AMT			
0	03/17/2023	RC	FINAL	EAN			
1	06/21/2023	RC	FINAL	EAN			
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SHEET NUMBER:

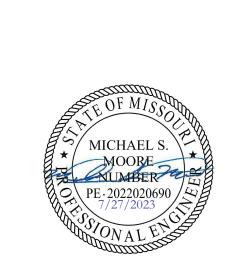REVISION:

11/10/2023