# LEE'S SUMMIT FIRE STATION NO. 4 5031 NORTHEAST LAKEWOOD WAY LEE'S SUMMIT, MISSOURI 64064

# FINAL DEVELOPMENT PLAN

# **CONSULTANT:**



9229 WARD PKWY KANSAS CITY, MISSOURI 64114 DERICK HOLMES derick.holmes@glmv.com T (816) 444-4200

# PARCEL INFORMATION:

ACREAGE: 1.1

ADDRESS: 5031 NORTHEAST LAKEWOOD WAY LEE'S SUMMIT, MO 64064

LEGAL DESCRIPTION ALL OF LOT 6-A, EXECUTIVE LAKES

CENTER LOTS 6-A AND 8-B, A SUBDIVISION IN THE SE 1/4 OF SECTION 5- T 48 N - R 31 W, LEE'S SUMMIT, JACKSON COUNTY, MISSOURI

FEMA FLOODPLAIN THE SUBJECT PROPERTY IS LOCATED IN ZONE X, AREAS DETERMINED TO BE

ZONE X, AREAS DETERMINED TO BE OUTSIDE THE 0.2% ANNUAL CHANCE FLOODPLAIN, AS SHOWN ON FLOOD INSURANCE RATE MAP (FIRM) 29095C0313G.

EFFECTIVE JANUARY 20, 2017.

OIL AND GAG WELLS

OIL AND GAS WELLS

NO EVIDENCE OF OIL OR GAS WELLS WERE FOUND ON LOT 6-A AND THE PORTION OF LOT 7 PROPOSED TO BE REPLATTED AS EVIDENCED BY THE FOLLOWING SOURCES

1. ATLAS/NSPS LAND SURVEY PERFORMED BY J&J SURVEYING LLC, DATED DECEMBER 7, 2021.

2. MISSOURI SPATIAL DATA INFORMATION SERVICE (FEBRUARY 20, 2022), MO 2018 STATE PERMITTED OIL AND GAS WELLS. RETRIEVED FROM


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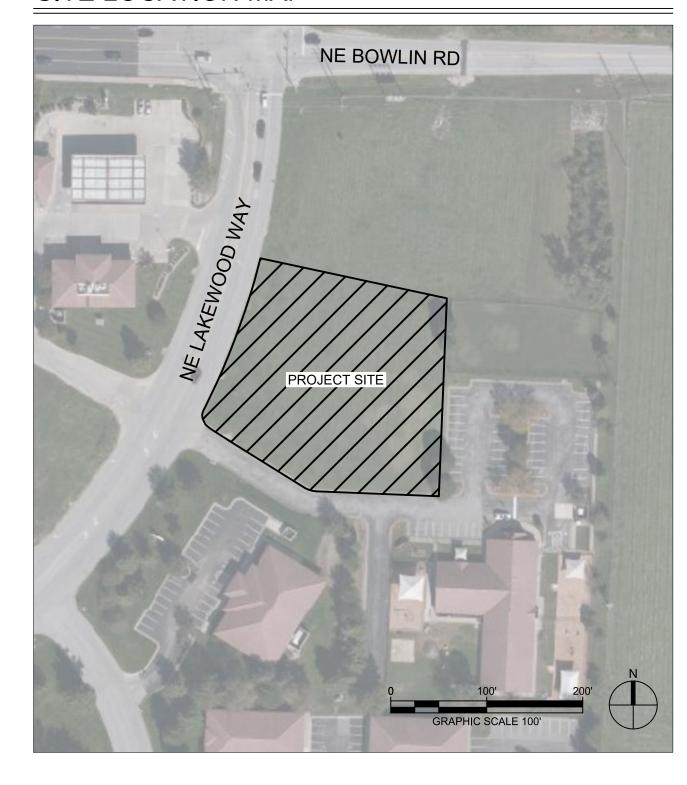
CP-2, PLANNED COMMUNITY COMMERCIAL

LAND USE SCHEDULE					
TOTAL FLOOR AREA	12,189 SF				
NUMBER OF DWELLING UNITS	8				
LAND AREA	1.17 ACRES				
REQUIRED PARKING	DIRECTED BY FIRE CHIEF				
PROPOSED PARKING	15 SPACES				
IMPERVIOUS COVERAGE	32,464 SF (.75 ACRES)				
FLOOR AREA RATIO (FAR)	0.24				
PERMITTED LAND USE	FIRE STATION - MUNICIPAL = CONDITIONAL				
DWELLING UNITS PER ACRE WITH COMMON AREA	6.84				
DWELLING UNITS PER ACRE WITHOUT COMMON AREA	6.84				


# VICINITY MAP




# SITE LOCATION MAP

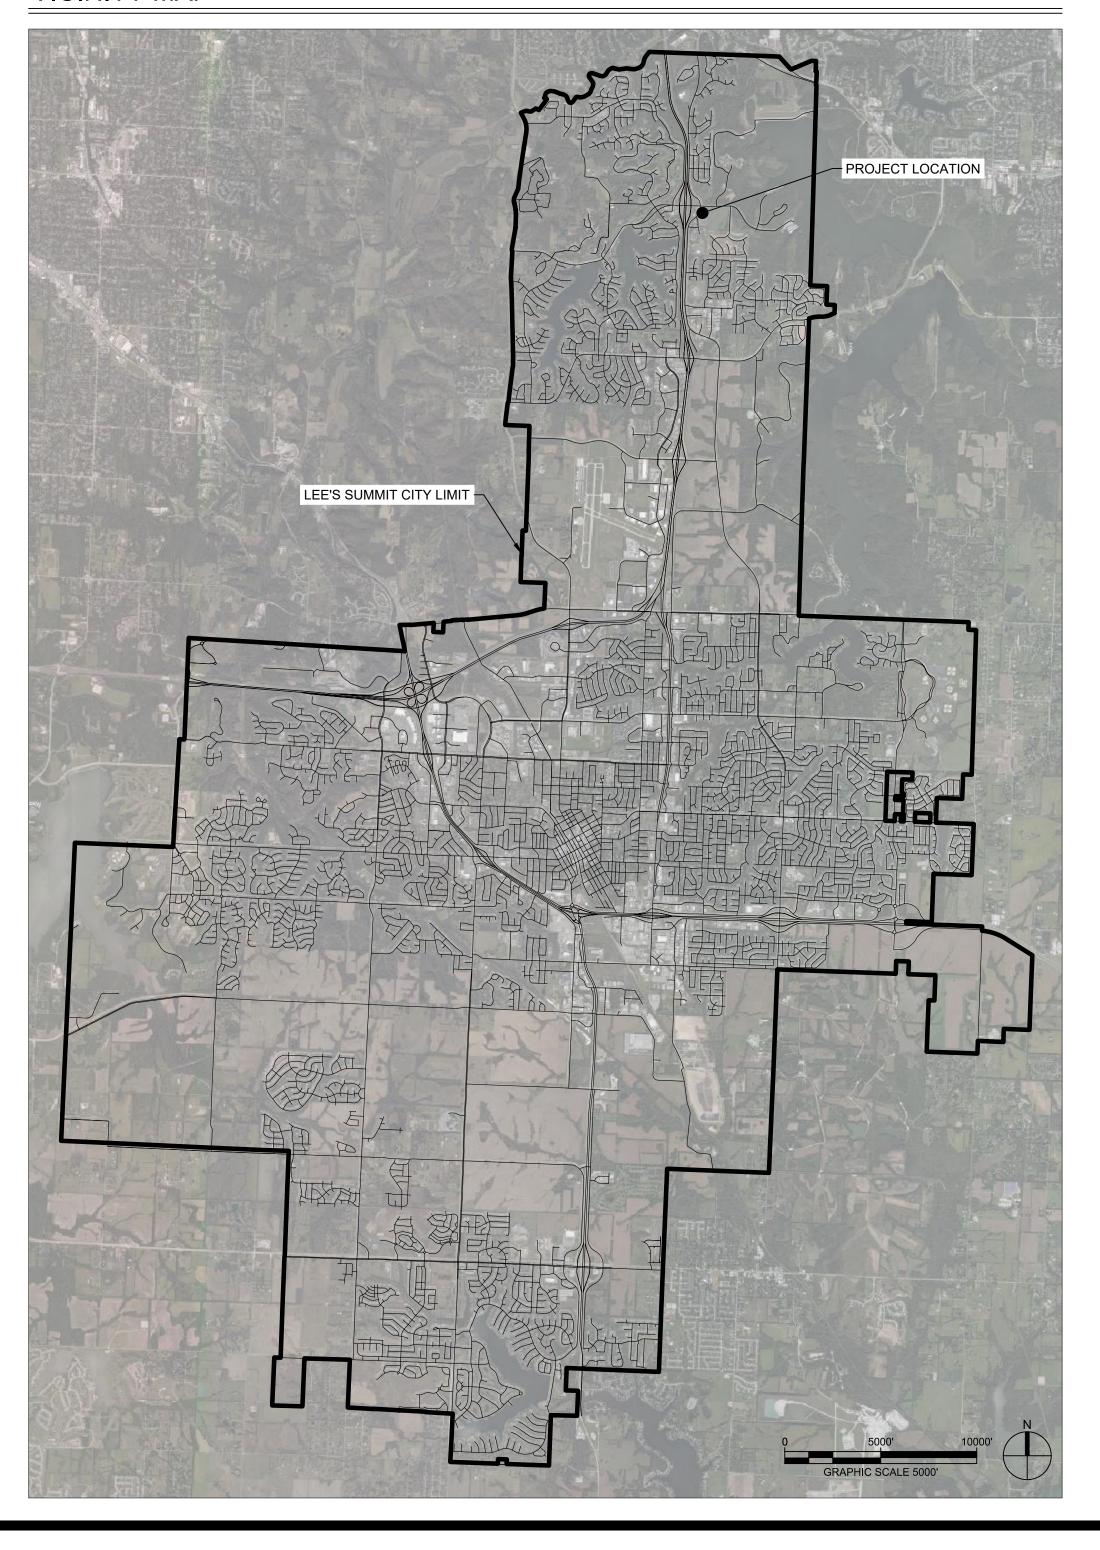

INDEX OF DRAWINGS					
SHEET NO.	SHEET NAME				
C-001	COVER SHEET				
GS001	ALTA/NSPS LAND TITLE SURVEY				
A-101	FIRST FLOOR PLAN				
A-102	SECOND FLOOR PLAN				
A-201	BUILDING ELEVATIONS				
A-202	BUILDING ELEVATIONS				
C-100	SITE PLAN				
C-101	LAYOUT PLAN				
C-102	DEMOLITION PLAN				
C-103	EROSION CONTROL PLAN				
C-104	GRADING & DRAINAGE PLAN				
C-105	UTILITY PLAN				
C-220	PUBLIC WATER PLAN & PROFILES				
C-231	PRIVATE STORMWATER PROFILES				
C-400	GRADING ENLARGEMENTS				
C-500	SITE DETAILS				
C-501	SITE DETAILS				
C-502 SITE DETAILS					
C-503	SITE DETAILS				
C-510	EROSION CONTROL DETAILS				
C-511	EROSION CONTROL DETAILS				
C-520	WATER DETAILS				
C-521	WATER DETAILS				
C-530	STORMWATER DETAILS				
C-531	STORMWATER DETAILS				
C-532	STORMWATER DETAILS				
C-540	SANITARY SEWER DETAILS				
ME001	MPE SITE PLAN				
ME002	SITE LIGHTING PHOTOMETRIC PLAN				
L-100	LANDSCAPE SCHEDULE				
L-101	LANDSCAPE PLAN				

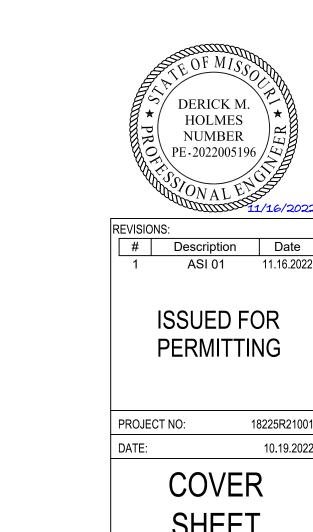

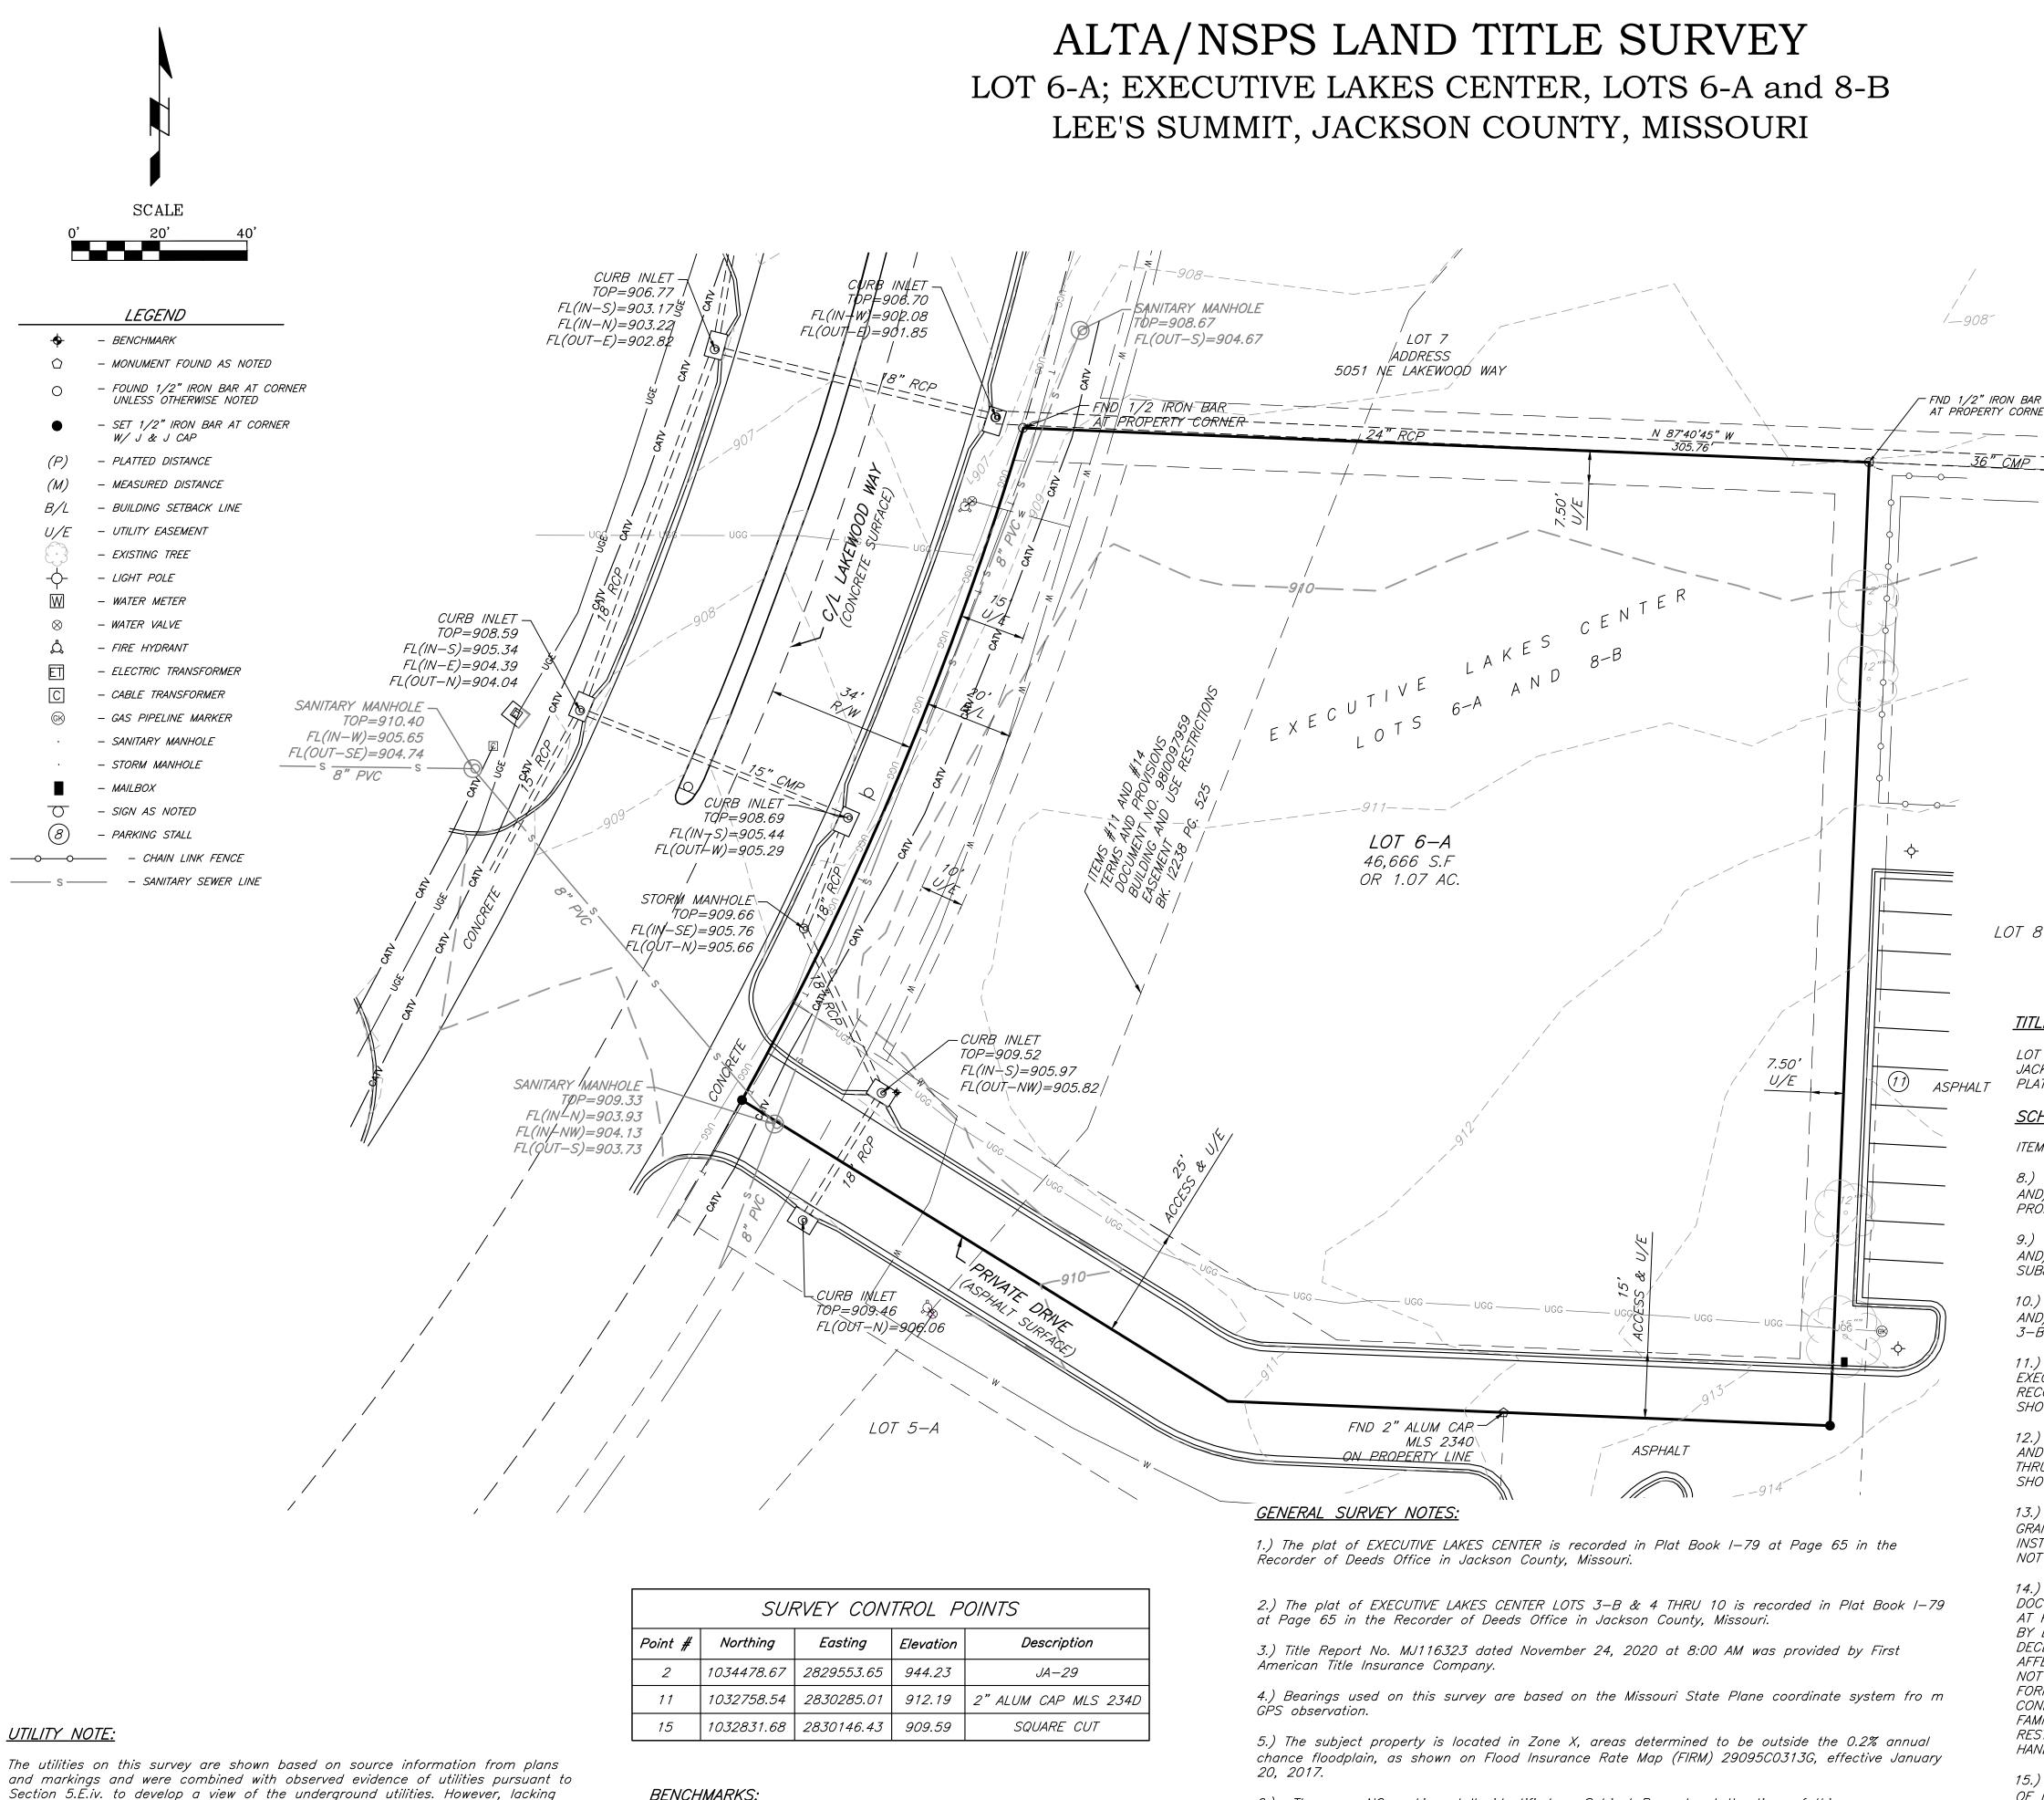

# PROJEC1 LOCATION SE 1/4 VICINITY MAP SEC. 5-48-31

9229 Ward Parkway Kansas City, Mo 64114

# <u>PROPERTY ADDRESS:</u>

5031 NE Lakewood Way Lee's Summit, Mo 64064

All of Lot 6-A, EXECUTIVE LAKES CENTER Lots 6-A and 8-B, a subdivision in the SE 1/4 of Section 5- T 48 N - R 31 W, Lee's Summit, Jackson County,

S 87°40'45" E

LOT 6A, EXECUTIVE LAKES CENTER LOTS 6A AND 8B, A SUBDIVISION IN LEE'S SUMMIT, JACKSON COUNTY, MISSOURI, ACCORDING TO THE RECORDED PLAT THEREOF; FILED IN PLAT BOOK 79 AT PAGE 65.

# SCHEDULE B - PART II NOTES:

ITEMS 1 - 7, AND 17 - 20 ARE NON SURVEY RELATED ITEMS.

8.) TERMS, PROVISIONS, EASEMENTS, SET-BACK LINES AND FEATURES ALL AS SHOWN AND/OR NOTED ON THE COMMISSIONER'S PLAT OF BOWLIN ESTATE. AFFECTS SUBJECT PROPERTY AND IS BLANKET IN NATURE

9.) TERMS, PROVISIONS, EASEMENTS, SET-BACK LINES AND FEATURES ALL AS SHOWN AND/OR NOTED ON THE RECORDED PLAT OF EXECUTIVE LAKES CENTER. AFFECTS SUBJECT PROPERTY, NO DOCUMENT PROVIDED.

10.) TERMS, PROVISIONS, EASEMENTS, SET-BACK LINES AND FEATURES ALL AS SHOWN AND/OR NOTED ON THE RECORDED PLAT OF EXECUTIVE LAKES CENTER LOTS 3-A & 3-B THRU 10. AFFECTS SUBJECT PROPERTY.

11.) TERMS AND PROVISIONS OF ORDINANCE NO. 4703 ACCEPTING FINAL PLAT OF EXECUTIVE LAKES CENTER, LOTS 3-B & 4 THRU 10 AS SHOWN BY INSTRUMENT RECORDED AS DOCUMENT NO. 9810097959. AFFECTS THE SUBJECT PROPERTY AND IS SHOWN HEREON. 12.) TERMS, PROVISIONS, EASEMENTS, SET-BACK LINES AND FEATURES ALL AS SHOWN

AND OR NOTED ON THE RECORDED PLAT OF EXECUTIVE LAKES CENTER LOTS 3-B & 4 THRU 10 AS AFFECTED BY ORDINANCE NO. 4925 VACATING AN UTILITY EASEMENT AS SHOWN AND DESCRIBED THEREIN. DOES NOT AFFECT THE SUBJECT PROPERTY.

13.) THE EFFECTS, IF ANY, OF THE TERMS AND PROVISIONS OF THE UTILITY EASEMENT GRANTED TO CITY OF LEE'S SUMMIT, A MUNICIPAL CORPORATION AS SHOWN BY INSTRUMENT RECORDED AS DOCUMENT NO. 97-14003 IN 12952 AT PAGE 1654. DOES NOT AFFECT THE SUBJECT PROPERTY.

14.) BUILDING AND USE RESTRICTIONS CREATED BY THE INSTRUMENT RECORDED AS DOCUMENT NO. 198126317 IN BOOK 13177 AT PAGE 329. AND 1103647 IN BOOK 12238 AT PAGE 525. AFFECTS THE SUBJECT PROPERTY AND IS SHOWN ON. AND AMENDED BY DOCUMENT NO. 98190271 IN BOOK 13310 AT PAGE 1665. AND AS AFFECTED BY DECLARATION OF ANNEXATION RECORDED AS DOCUMENT NO. 200010010475. DOES NOT AFFECT THE SUBJECT PROPERTY. AND AMENDED BY DOCUMENT NO. 2000126140. DOES NOT AFFECT THE SUBJECT PROPERTY. A VIOLATION OF WHICH WOULD NOT CAUSE A FORFEITURE OR REVERSION OF TITLE. NOTE, THIS EXCEPTION OMITS ANY COVENANT, CONDITION OR RESTRICTION BASED ON RACE, COLOR, RELIGION, SEX, HANDICAP, FAMILIAL STATUS OR NATIONAL ORIGIN, UNLESS AND ONLY TO THE EXTENT THAT RESTRICTION IS NOT IN VIOLATION OF STATE OR FEDERAL LAW OR RELATES TO A HANDICAP, BUT DOES NOT DISCRIMINATE AGAINST HANDICAPPED PEOPLE.

15.) TERMS AND PROVISIONS OF DEVELOPMENT AGREEMENT BY AND BETWEEN THE CITY OF LEE'S SUMMIT, MISSOURI AND LAKEWOOD DEVELOPMENT, L.P. AND FOUR BAR COMPANY, G.P. FILED JANUARY 13, 1999 AS DOCUMENT NO. 99/3356. AFFECTS THE SUBJECT PROPERTY AND IS BLANKET IN NATURE.

16.) TERMS AND PROVISIONS OF THE DEVELOPMENT AGREEMENT BY AND BETWEEN CITY OF LEE'S SUMMIT, MISSOURI, A MUNICIPAL CORPORATION AND LAKEWOOD DEVELOPMENT, L.P. AS SHOWN BY INSTRUMENT RECORDED AS DOCUMENT NO. 200010029662. DOES NOT AFFECT THE SUBJECT PROPERTY.

# **BENCHMARKS:**

excavation, the exact location of underground features cannot be accurately,

other similar utility locate requests from surveyors may be ignored or result in

an incomplete response, in which case the surveyor shall note on the plat or

utilities. Where additional or more detailed information is required, the client is

completely, and reliably depicted. In addition, in some jurisdictions, 811 or

map how this affected the surveyor's assessment of the location of the

advised that excavation and/or a private utility locate request may be

necessary.

STATION JA-29: Alum Disk Located about 5.5 miles North of Lee's Summit and between I-470 and the East outer Road of North Bound ramp #14

ELEVATION = 944.23

7.) Under Ground Utilities are shown as located by Missouri one call ticket No. 211930316 dated


9.) This Property is Zoned CP-2, Planned Community Commercial.

observed in the process of conducting the fieldwork

8.) There were no Wetland Delineations marked, at the time of survey.

10.) There was no evidence of Earth moving work, building construction, or building additions

6.) There are NO parking stalls identified on Subject Property at the time of this survey.

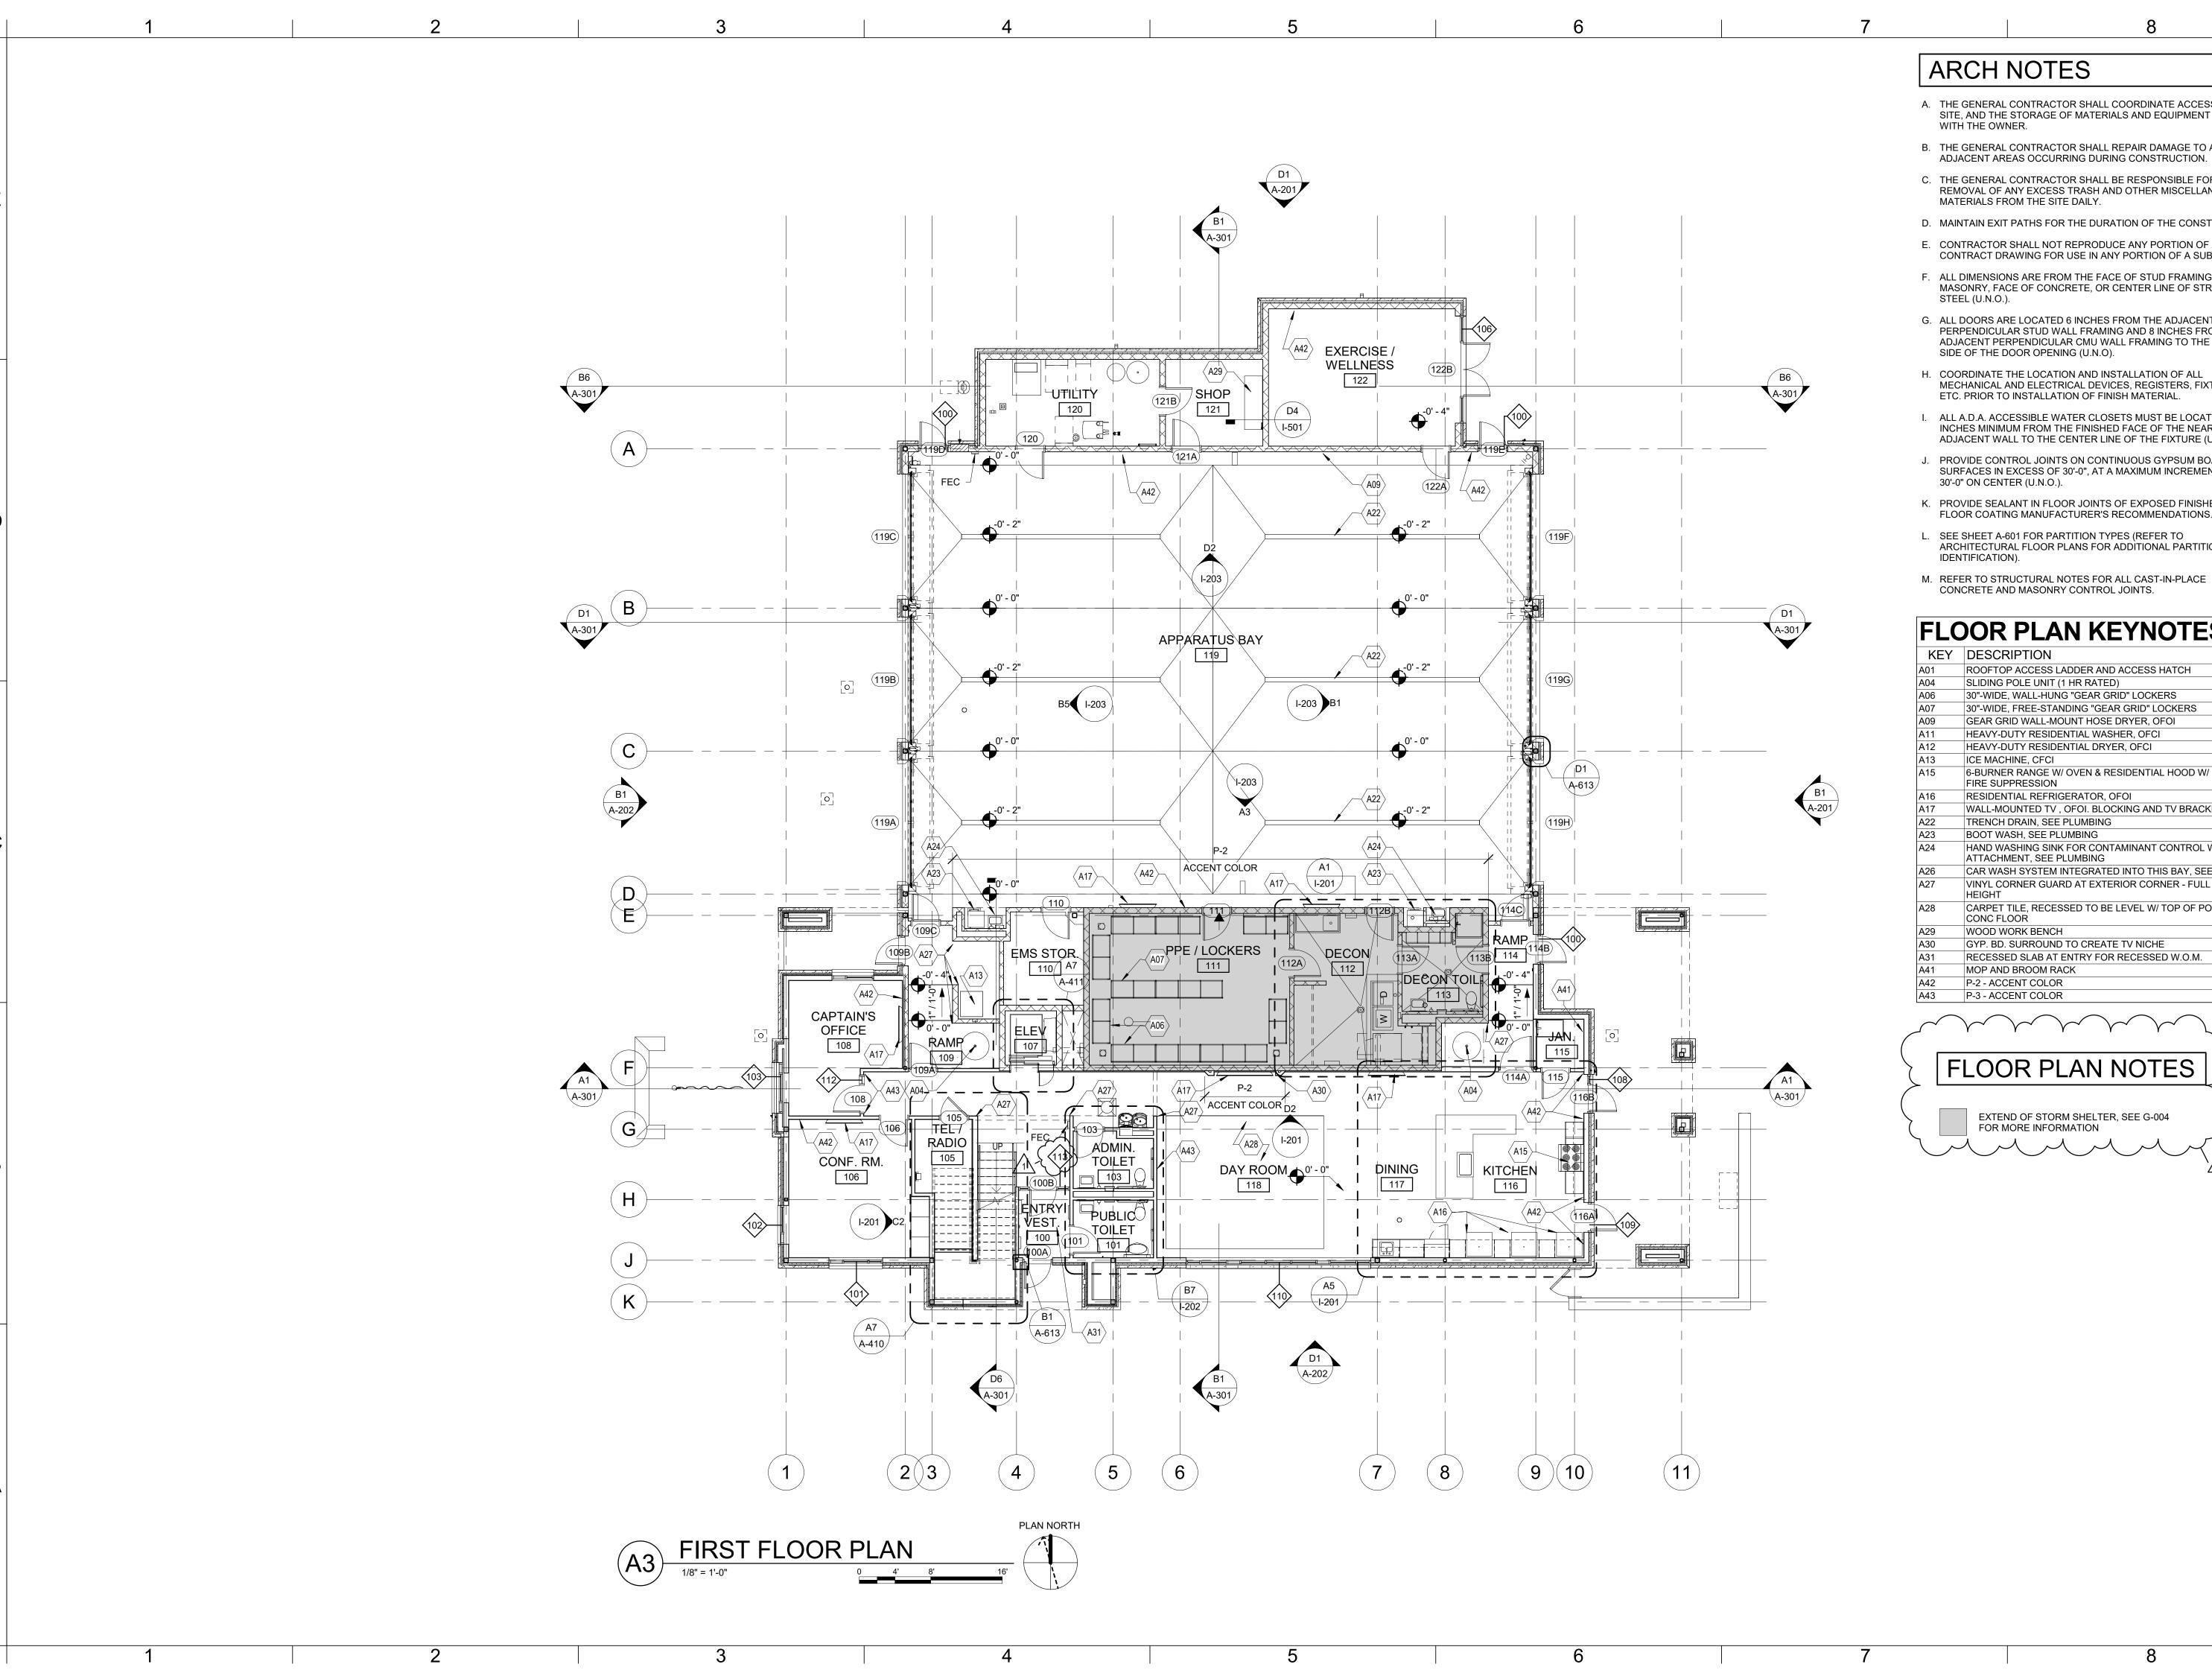

- A. THE GENERAL CONTRACTOR SHALL COORDINATE ACCESS TO THE SITE, AND THE STORAGE OF MATERIALS AND EQUIPMENT ON SITE
- B. THE GENERAL CONTRACTOR SHALL REPAIR DAMAGE TO ANY
- C. THE GENERAL CONTRACTOR SHALL BE RESPONSIBLE FOR THE REMOVAL OF ANY EXCESS TRASH AND OTHER MISCELLANEOUS
- D. MAINTAIN EXIT PATHS FOR THE DURATION OF THE CONSTRUCTION.
- E. CONTRACTOR SHALL NOT REPRODUCE ANY PORTION OF A CONTRACT DRAWING FOR USE IN ANY PORTION OF A SUBMITTAL.
- F. ALL DIMENSIONS ARE FROM THE FACE OF STUD FRAMING, FACE OF MASONRY, FACE OF CONCRETE, OR CENTER LINE OF STRUCTURAL
- G. ALL DOORS ARE LOCATED 6 INCHES FROM THE ADJACENT PERPENDICULAR STUD WALL FRAMING AND 8 INCHES FROM THE ADJACENT PERPENDICULAR CMU WALL FRAMING TO THE HINGE SIDE OF THE DOOR OPENING (U.N.O).
- H. COORDINATE THE LOCATION AND INSTALLATION OF ALL MECHANICAL AND ELECTRICAL DEVICES, REGISTERS, FIXTURES,
- I. ALL A.D.A. ACCESSIBLE WATER CLOSETS MUST BE LOCATED 18 INCHES MINIMUM FROM THE FINISHED FACE OF THE NEAREST ADJACENT WALL TO THE CENTER LINE OF THE FIXTURE (U.N.O.).
- J. PROVIDE CONTROL JOINTS ON CONTINUOUS GYPSUM BOARD SURFACES IN EXCESS OF 30'-0", AT A MAXIMUM INCREMENT OF
- K. PROVIDE SEALANT IN FLOOR JOINTS OF EXPOSED FINISHES PER FLOOR COATING MANUFACTURER'S RECOMMENDATIONS.
- L. SEE SHEET A-601 FOR PARTITION TYPES (REFER TO ARCHITECTURAL FLOOR PLANS FOR ADDITIONAL PARTITION
- M. REFER TO STRUCTURAL NOTES FOR ALL CAST-IN-PLACE CONCRETE AND MASONRY CONTROL JOINTS.

# FLOOR PLAN KEYNOTES

KEY	DESCRIPTION				
A01	ROOFTOP ACCESS LADDER AND ACCESS HATCH				
A04	SLIDING POLE UNIT (1 HR RATED)				
A06	30"-WIDE, WALL-HUNG "GEAR GRID" LOCKERS				
A07	30"-WIDE, FREE-STANDING "GEAR GRID" LOCKERS				
A09	GEAR GRID WALL-MOUNT HOSE DRYER, OFOI				
A11	HEAVY-DUTY RESIDENTIAL WASHER, OFCI				
A12	HEAVY-DUTY RESIDENTIAL DRYER, OFCI				
A13	ICE MACHINE, CFCI				
A15	6-BURNER RANGE W/ OVEN & RESIDENTIAL HOOD W/ INTEGRAL FIRE SUPPRESSION				
A16	RESIDENTIAL REFRIGERATOR, OFOI				
A17	WALL-MOUNTED TV , OFOI. BLOCKING AND TV BRACKET, CFCI				
A22	TRENCH DRAIN, SEE PLUMBING				
A23	BOOT WASH, SEE PLUMBING				
A24	HAND WASHING SINK FOR CONTAMINANT CONTROL W/ EYEWASHATTACHMENT, SEE PLUMBING				
A26	CAR WASH SYSTEM INTEGRATED INTO THIS BAY, SEE PLUMBING				
A27	VINYL CORNER GUARD AT EXTERIOR CORNER - FULL WALL HEIGHT				
A28	CARPET TILE, RECESSED TO BE LEVEL W/ TOP OF POLISHED CONC FLOOR				
A29	WOOD WORK BENCH				
A30	GYP. BD. SURROUND TO CREATE TV NICHE				
A31	RECESSED SLAB AT ENTRY FOR RECESSED W.O.M.				
A41	MOP AND BROOM RACK				
A42	P-2 - ACCENT COLOR				

# FLOOR PLAN NOTES

EXTEND OF STORM SHELTER, SEE G-004 FOR MORE INFORMATION



SUITE # 210

KANSAS CITY, MO 64114

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TEL: (816) 444-4200 FAX: (316) 265-5646 www.glmv.com

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CIVIL ENGINEER & LANDSCAPE ARCH. GLMV ARCHITECTURE, INC MISSOURI CIVIL COA #2018033898 MISSOURI LANDSCAPE COA #000008 9229 WARD PARKWAY, SUITE # 210

KANSAS CITY, MO 64114 TEL: (816) 444-4200 STRUCTURAL ENGINEER LEIGH + O'KANE

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SECURITY & IT ENGINEERS HENDERSON ENGINEERS MISSOURI COA #000556 1801 MAIN STREET, SUITE 300 KANSAS CITY, MO 64108 (816) 663-8700

FIRE STAT 5031 NORTHI LEE'S SUMMI


REVISIONS:

PAUL J. MICHELL - ARCHITECT MO# A-2009021701

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A43	P-3 - ACCENT COLOR

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9229 WARD PARKWAY

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CONSULTING ARCHITECT

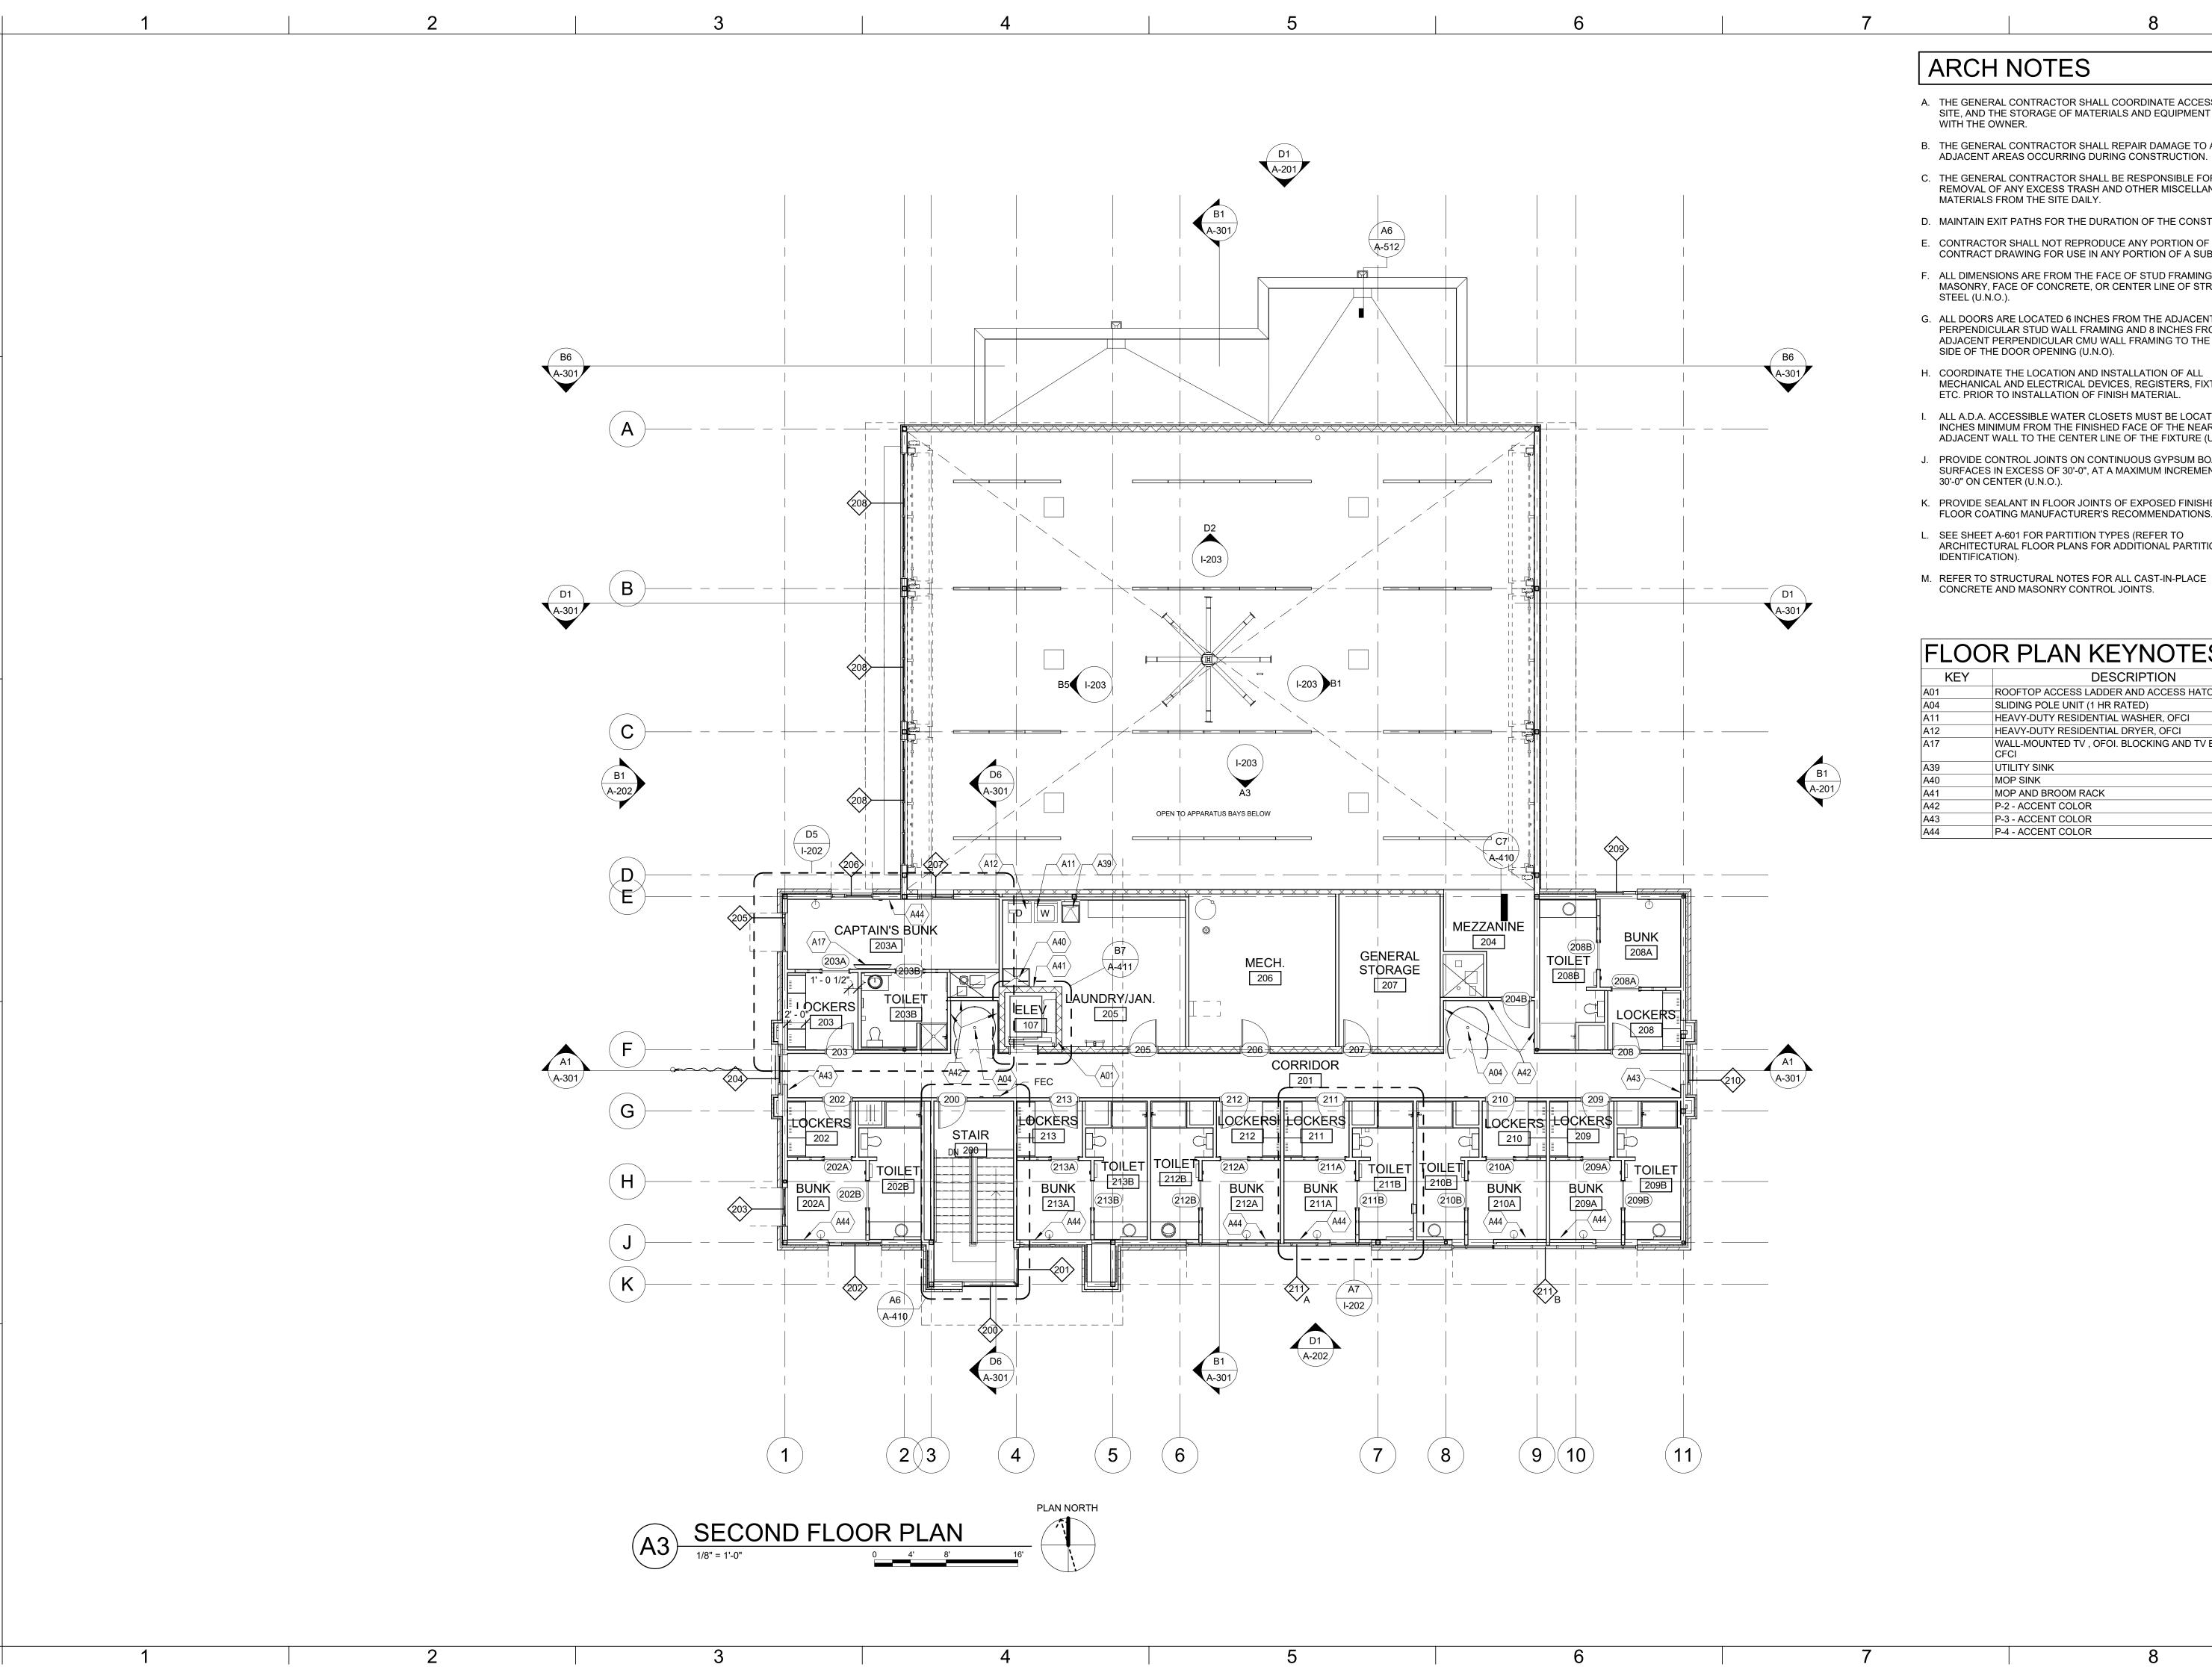FGMA ARCHITECTS

11250 ROGER BACON DRIVE, SUITE 16 RESTON, VIRGINIA 20190 TEL: (703) 956-5600

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FIRE STATION #4
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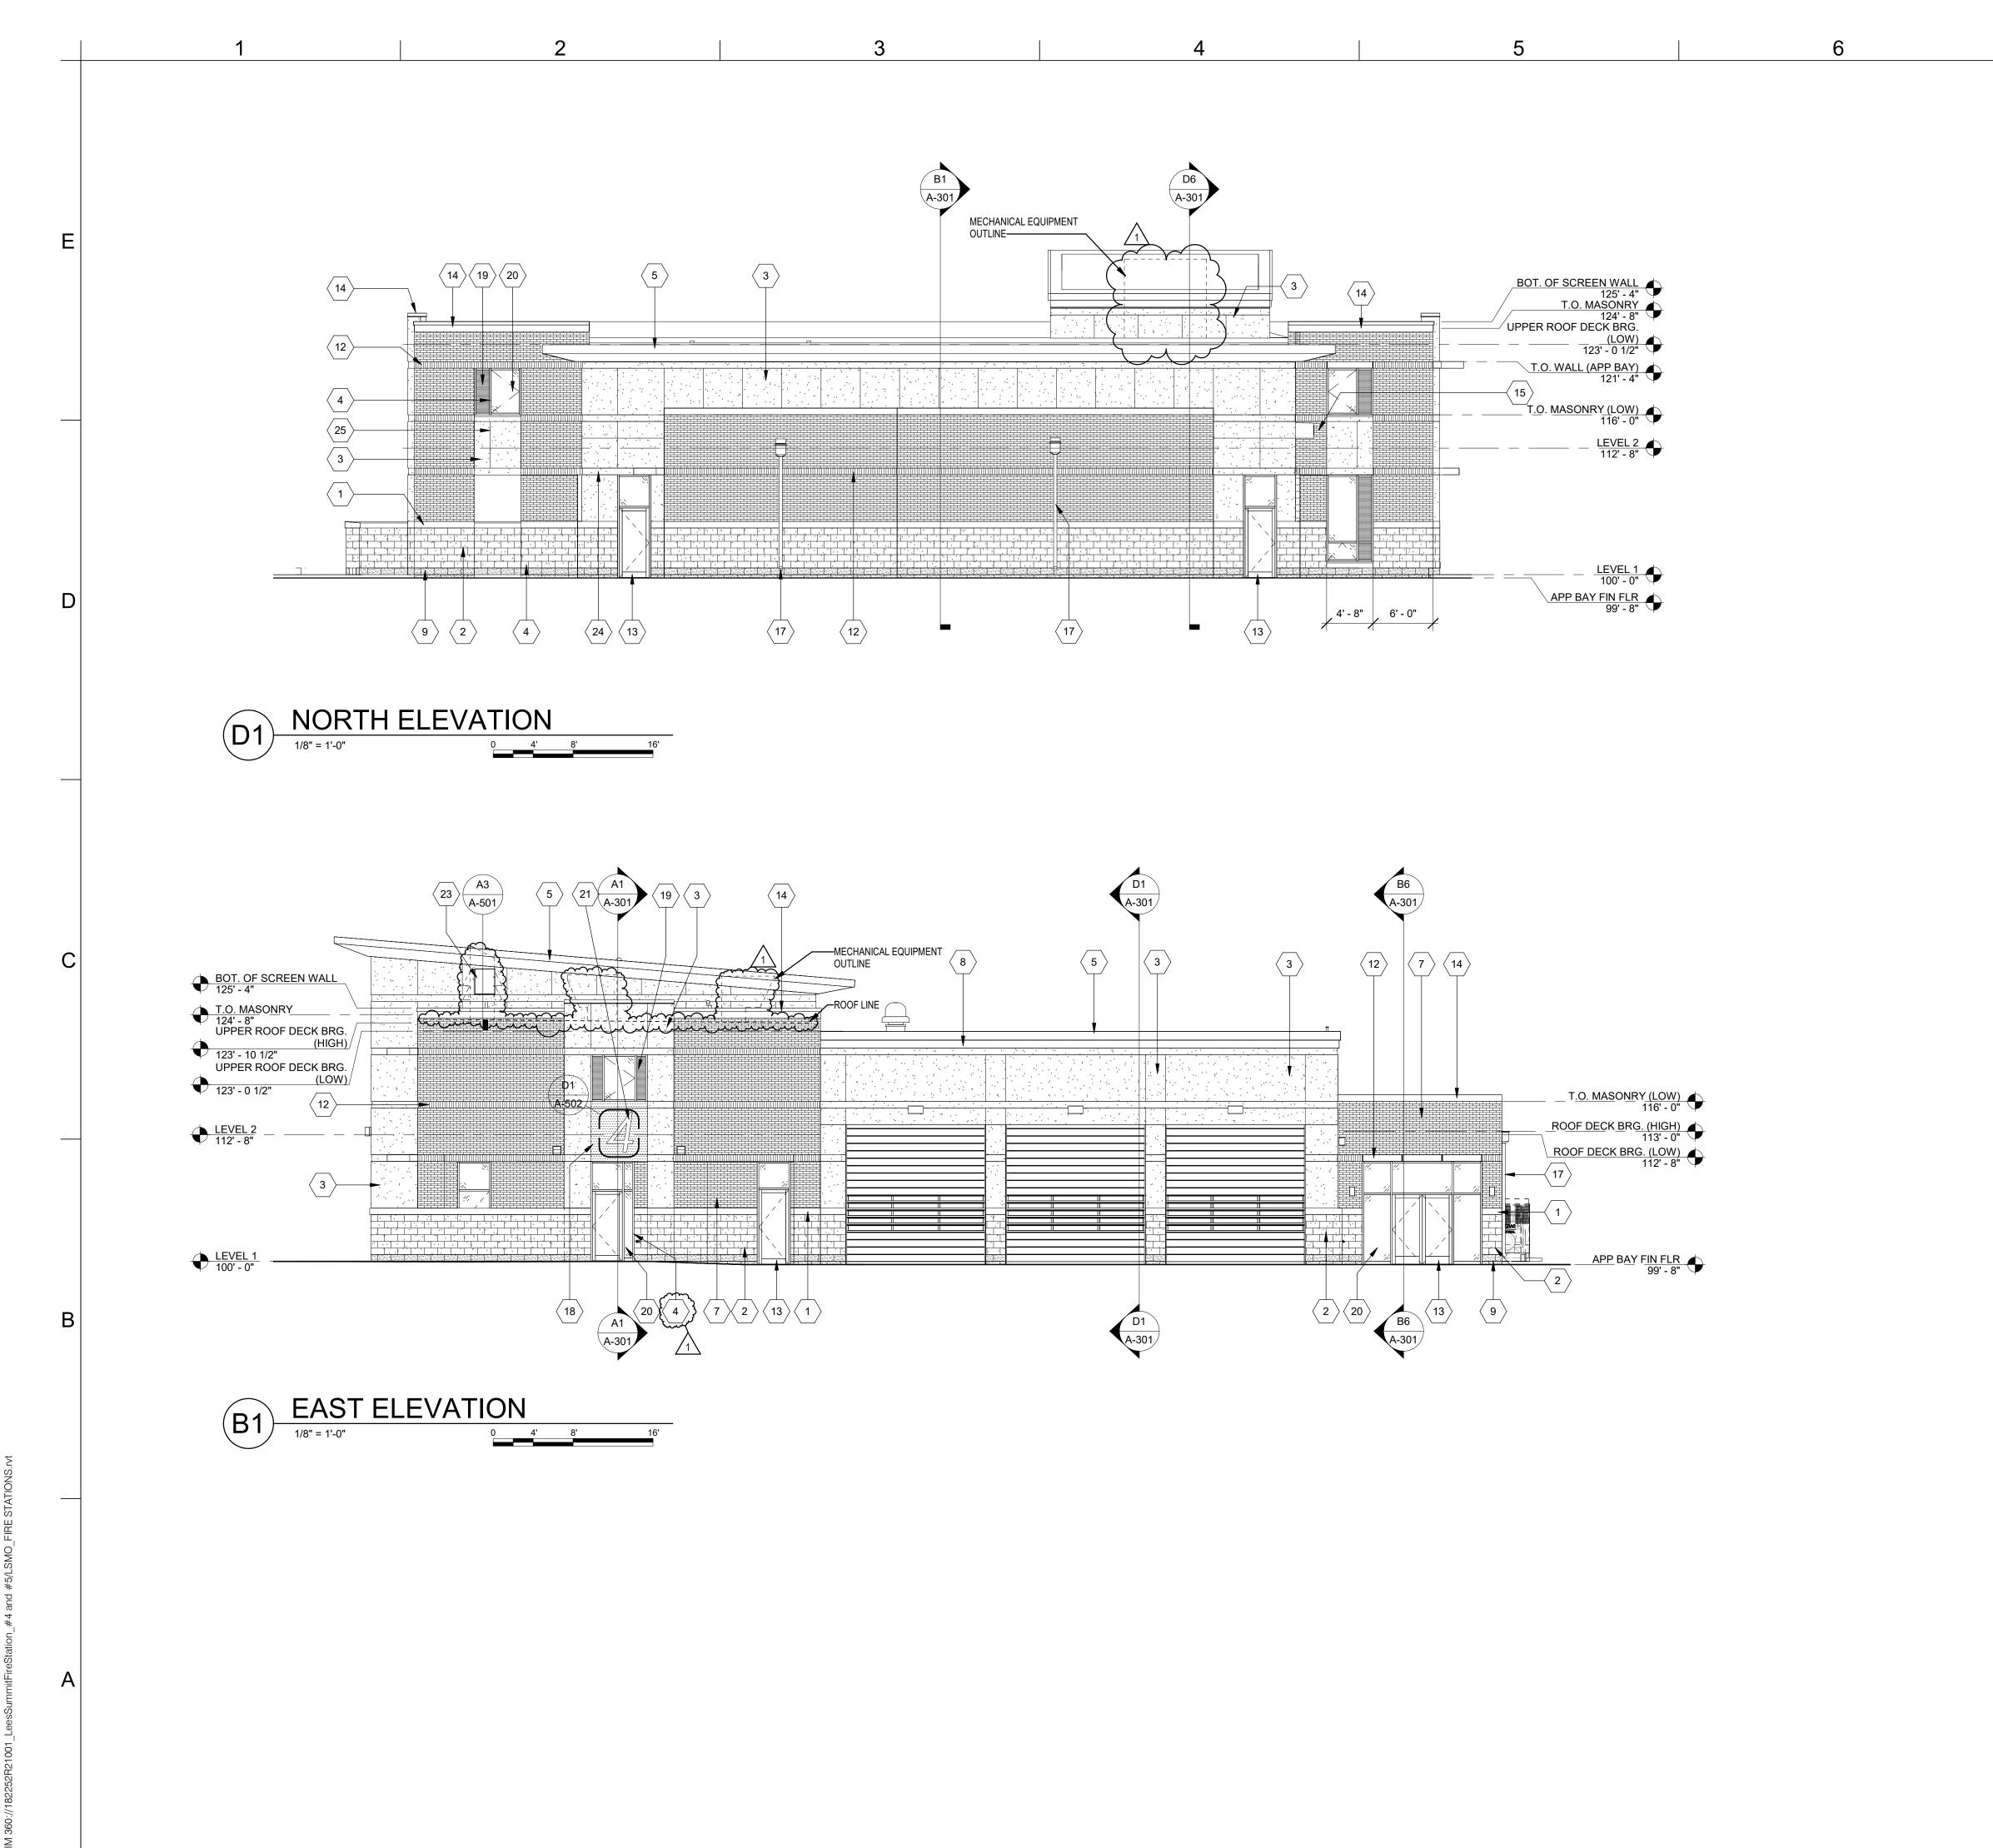
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2

**BUILDING ELEVATION...** 

KEY DESCRIPTION

1 CAST STONE MASONRY SILL
2 ANCHORED STONE MASONRY VENEER (TYPE 1)

2 ANCHORED STONE MASONRY VENEER (TYPE 1)
3 EIFS
4 PRE-FINISHED ALUMINUM-FRAMED STOREFRONT

5 PRE-FINISHED SHEET METAL FASCIA
6 PRE-FINISHED ALUMINUM-FRAMED STOREFRONT
7 4" MASONRY VENEER (COMMON BOND)
8 PRE-FINISHED SHEET METAL SOFFIT PANELS

8 PRE-FINISHED SHEET METAL SOFFIT PANELS
9 ANCHORED STONE MASONRY VENEER (TYPE 2)
12 4" MASONRY VENEER (SOLDIER)
13 PRE-FINISHED ALUMINUM-FRAMED ENTRANCE

14 PRE-FINISHED SHEET METAL PARAPET CAP
 15 PRE-FINISHED SHEET METAL CANOPY
 16 3/8" FIBER-CEMENT PANEL GAP (TYP.)
 17 PRE-FINISHED SHEET METAL CONDUCTOR HEAD & DOWNSPOUT

18 PRE-FINISHED METAL PLATE WALL PANELS
19 METAL-FACED INSULATED WINDOW PANEL
20 1" INSULATED GLASS UNIT

21 BACKLIT PIN-MOUNTED PRE-FINISHED METAL SIGNAGE
22 WALL HYDRANT (RE: PLMG)

22 WALL HYDRANT (RE: PLMG)
23 24"x30" METAL ACCESS DOOR

24 1/2" DEEP EIFS RECESS
 25 3/4" DEEP V-GROOVE EIFS REVEAL
 26 BACK-LIT STAINLESS STEEL POST-MOUNTED FIRE DEPARTMENT

27 1/2" METAL PANEL REVEAL

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9229 WARD PARKWAY
SUITE # 210
KANSAS CITY, MO 64114

TEL: (816) 444-4200
FAX: (316) 265-5646
www.glmv.com
GLMV ARCHITECTURE, INC.
MISSOURI STATE CERTIFICATE OF AUTHORITY
#000305

CONSULTING ARCHITECT
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11250 ROGER BACON DRIVE, SUITE 16
RESTON, VIRGINIA 20190

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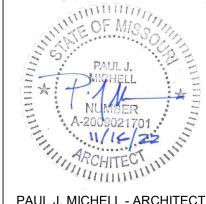
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HOSS & BROWN ENGINEERS
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15902 MIDLAND DRIVE
SHAWNEE, KS 66217
(913) 362.9090

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HENDERSON ENGINEERS
MISSOURI COA #000556
1801 MAIN STREET, SUITE 300
KANSAS CITY, MO 64108
(816) 663-8700

FIRE STATION #4
CITY OF LEE'S SUMMIT
5031 NORTHEAST LAKEWOOD WA'
LEE'S SUMMIT, MISSOURI 64064

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# Description Date
1 ASI 01 11/16/2022




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BUILDING ELEVATIONS

A-201



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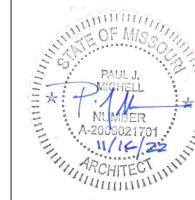
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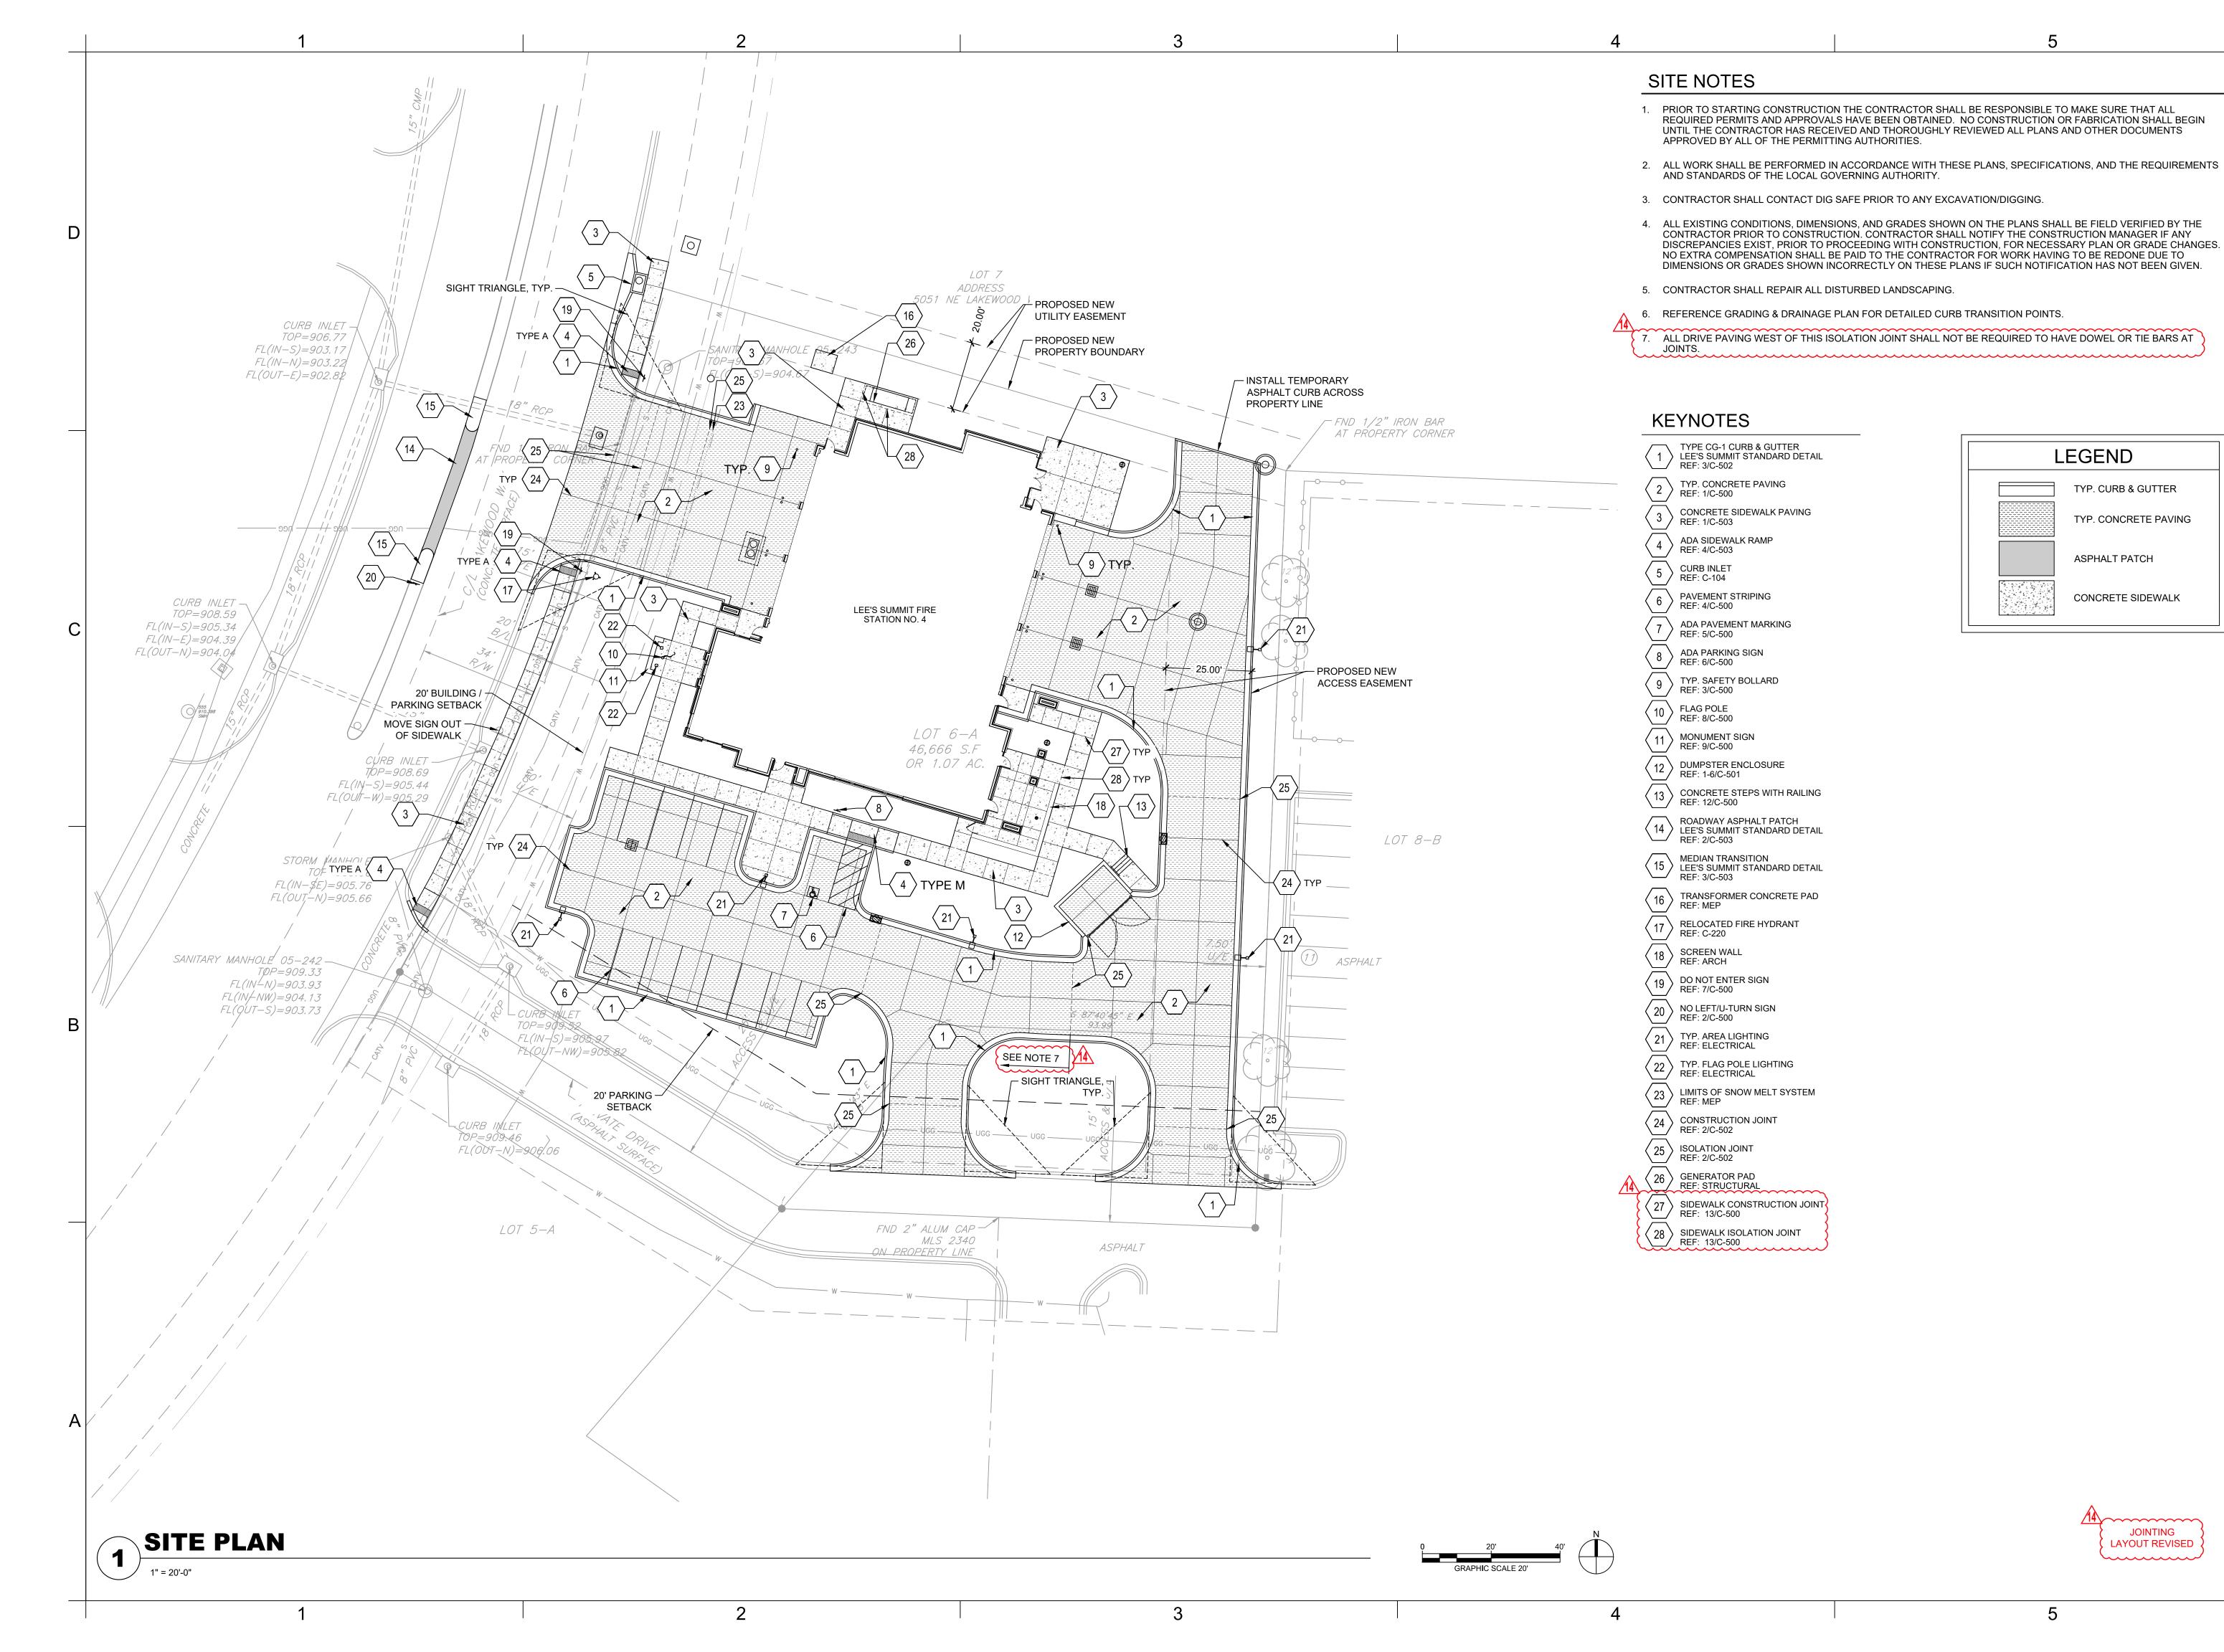
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BUILDING **ELEVATIONS** 

**A-202** 
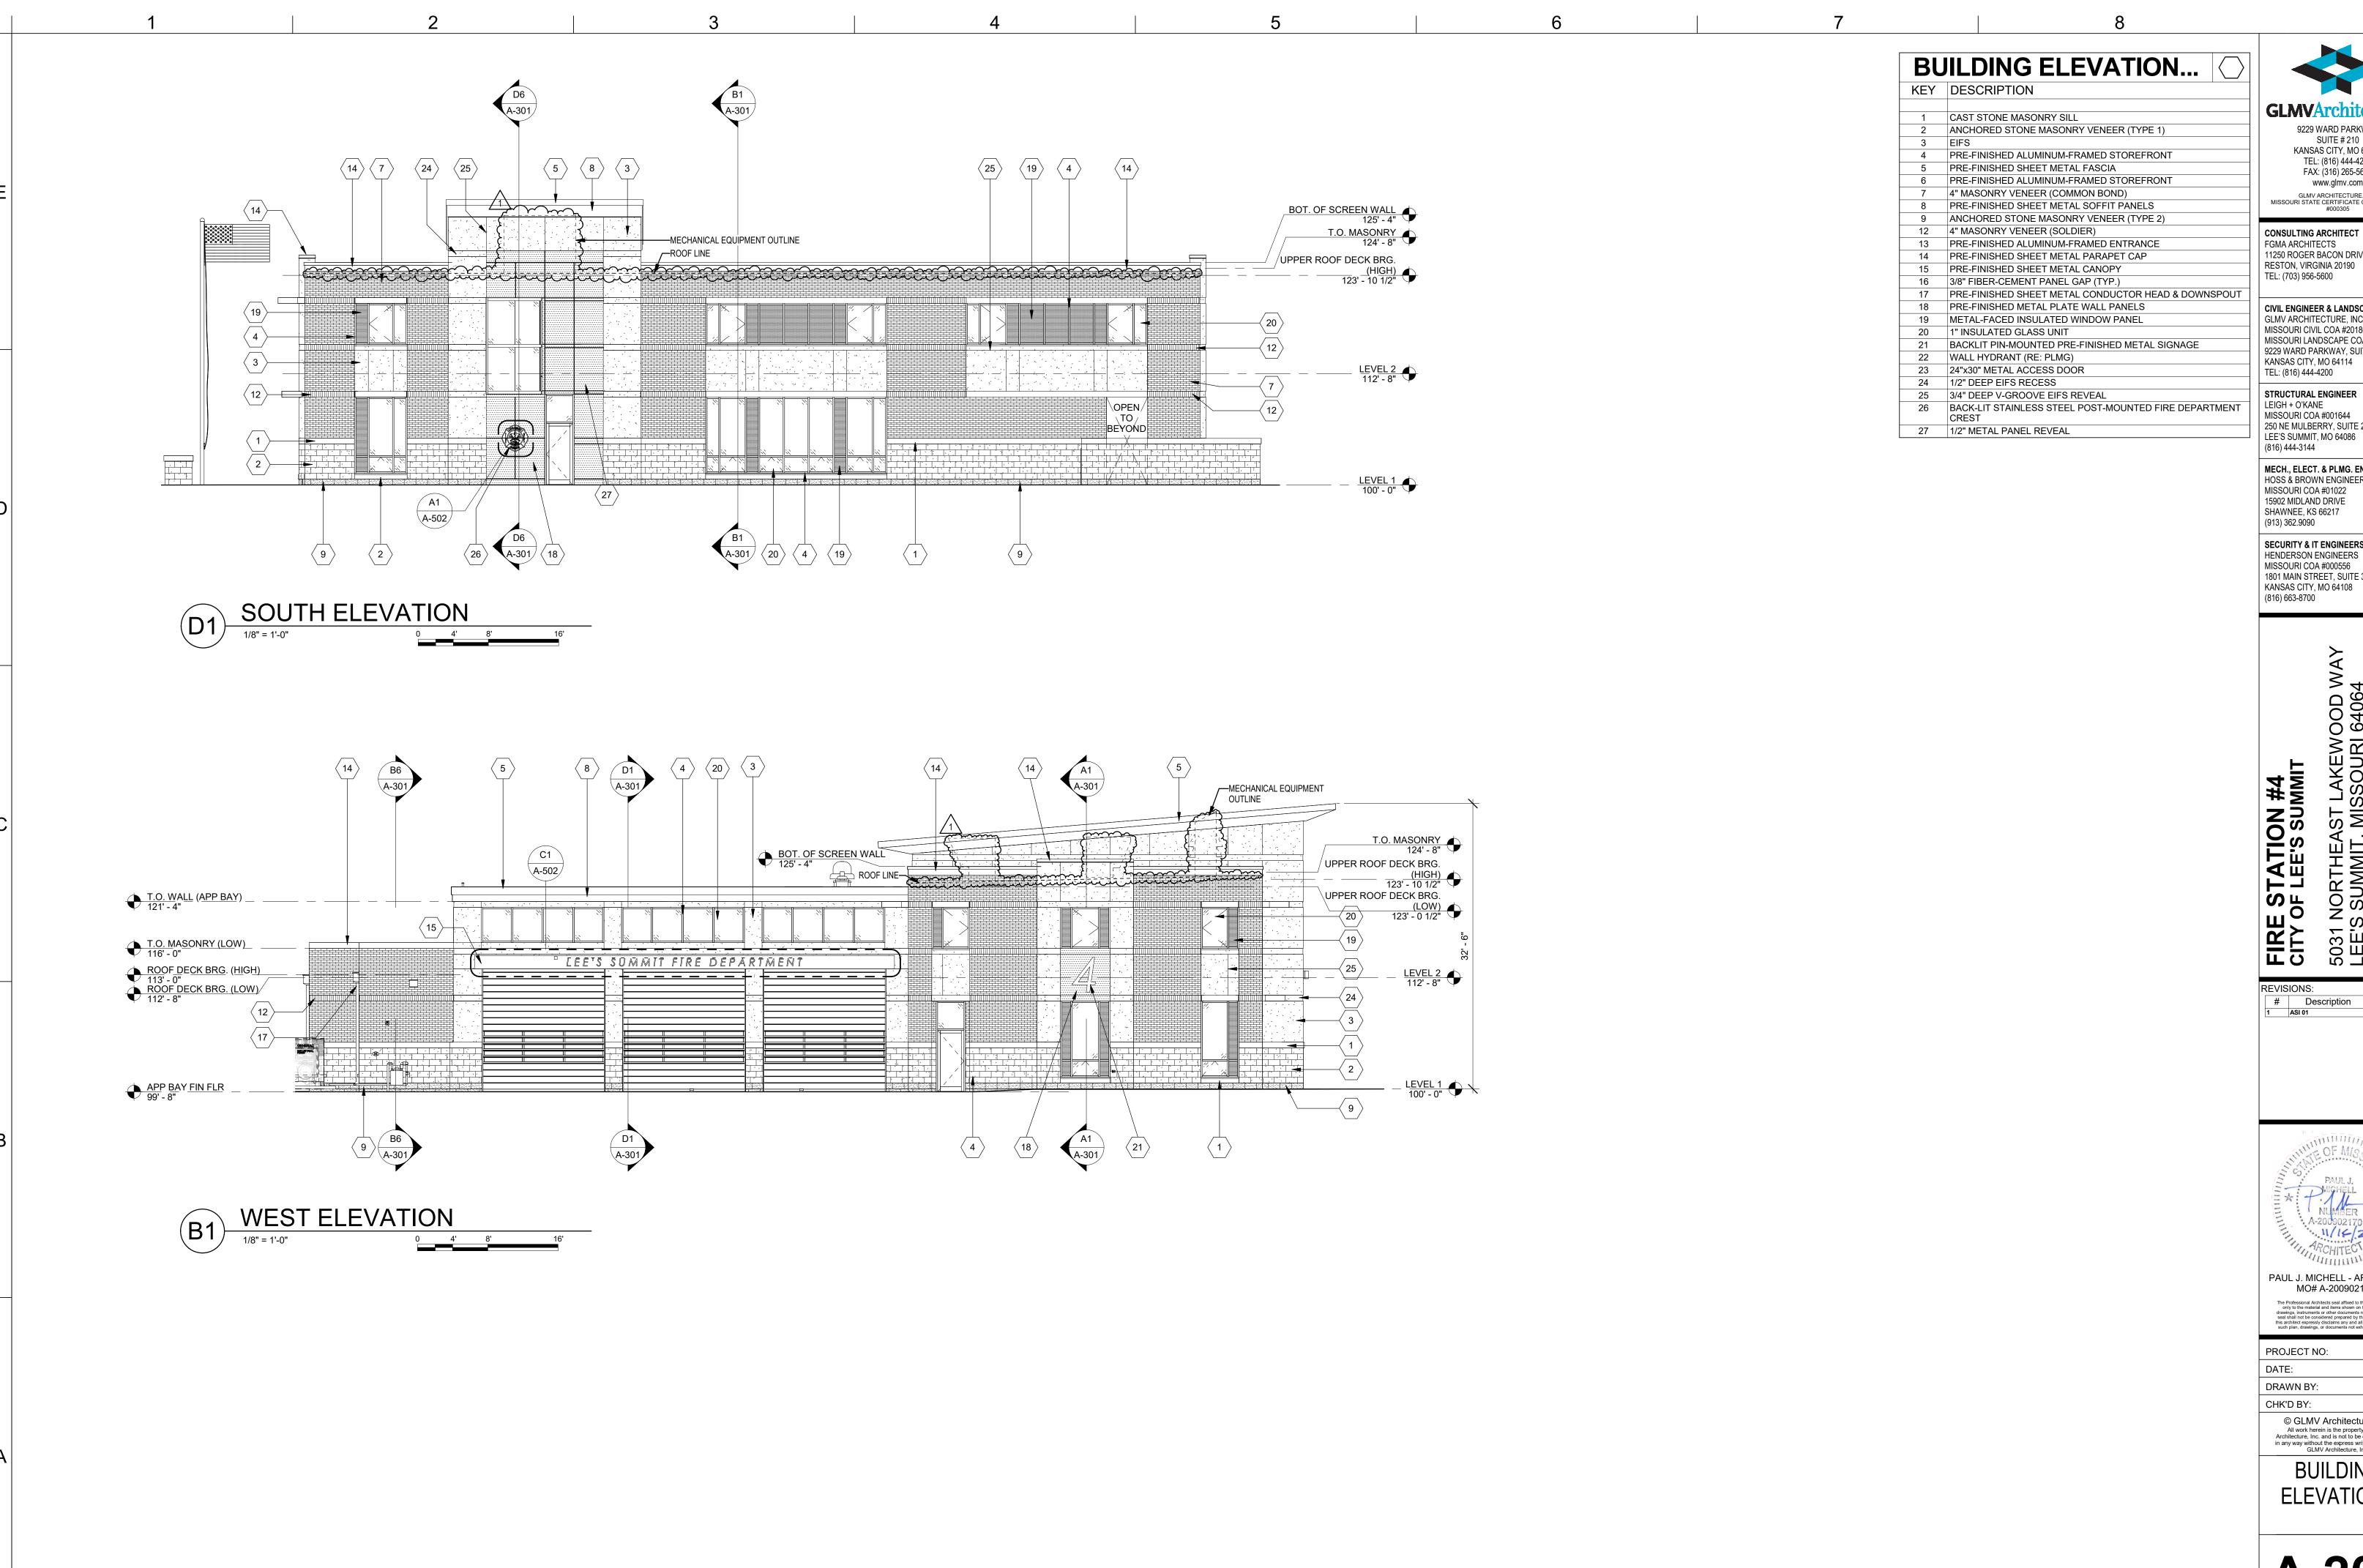
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(816) 663-8700 PHONE

FIRE STATIC CITY OF LEE'S SUN 5031 NORTHEAST LEE'S SUMMIT, M

REVISIONS: # Description Date 11.16.2022 ASI 01 ASI 07 04.25.2023 08.08.2023 ASI 11 ASI 14 10.13.2023

DERICK M. HOLMES NUMBER PE-2022005196 /5

DERICK HOLMES - CIVIL ENGINEER MO# PE-2022005196

PROJECT NO: 18225R21001 DATE: 10.19.2022 DRAWN BY: KDW CHK'D BY:


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SITE PLAN

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- 1. ALL CURB POINTS INDICATE BACK OF CURB UNLESS OTHERWISE NOTED.
- 2. SEE UTILITY PLAN FOR ALL UTILITY LOCATIONS AND LAYOUT.

POINT NO.	NORTHING	EASTING	DESCRIPTION
1	1032898.4666	2830193.3865	BLDG
2	1032930.4565	2830202.7537	BLDG
3	1032926.7096	2830215.5497	BLDG
4	1032983.5720	2830232.1999	BLDG
5	1032981.1366	2830240.5173	BLDG
6	1032991.0130	2830243.4111	BLDG
7	1032982.0298	2830274.0899	BLDG
8	1032987.5530	2830275.3924	BLDG
9	1032980.9960	2830297.7855	BLDG
10	1032965.6007	2830293.2776	BLDG
11	1032963.1653	2830301.5950	BLDG
12	1032915.5400	2830287.6496	BLDG
13	1032902.2241	2830283.7505	BLDG
14	1032900.6317	2830289.1889	BLDG
15	1032872.8005	2830281.0396	BLDG
16	1032887.6943	2830230.1753	BLDG
17	1032883.2157	2830228.8639	BLDG
18	1032891.1054	2830219.7122	BLDG
19	1032886.6268	2830218.4008	BLDG
20	1032889.3981	2830207.7504	BLDG
21	1032893.8767	2830209.0618	BLDG
100	1032774.0984	2830236.1407	CURB
101	1032774.0304	2830251.1687	CURB
102	1032798.6021	2830251.5850	CURB
102	1032798.0021	2830252.2480	CURB
104	1032807.1474	2830241.9193	CURB
105	1032822.9639	2830241.1359	CURB
106	1032819.9098	2830235.5527	CURB
107	1032807.9135	2830232.0400	CURB
108	1032828.4276	2830161.9817	CURB
109	1032840.4239	2830165.4943	CURB
110	1032846.0071	2830162.4403	CURB
111	1032848.6768	2830153.3231	CURB
112	1032872.6694	2830160.3485	CURB
113	1032872.2479	2830161.7880	CURB
114	1032878.4621	2830167.2546	CURB
115	1032889.4987	2830170.4863	CURB
116	1032876.5720	2830214.6326	CURB
117	1032862.6563	2830210.5579	CURB
118	1032857.0730	2830213.6120	CURB
119	1032855.1059	2830220.3299	CURB
120	1032858.1600	2830225.9131	CURB
121	1032872.0757	2830229.9879	CURB
122	1032866.4554	2830249.1819	CURB
123	1032852.5397	2830245.1072	CURB
124	1032846.9565	2830248.1613	CURB
125	1032838.3651	2830277.5021	CURB
126	1032834.9110	2830298.5431	CURB
127	1032834.5973	2830306.2742	CURB
128	1032836.9936	2830308.8735	CURB
129	1032853.6174	2830328.5631	CURB
130	1032856.0141	2830331.1625	CURB

LAYOUT TABLE						
POINT NO.	NORTHING	EASTING	DESCRIPTION			
131	1032881.0650	2830332.1775	CURB			
132	1032905.4284	2830315.0476	CURB			
133	1032910.9977	2830296.0450	CURB			
134	1032902.6403	2830293.5978	CURB			
135	1032958.5666	2830317.3002	CURB			
136	1032971.8943	2830335.8630	CURB			
137	1032984.9734	2830336.3938	CURB			
138	1032977.7330	2830361.1205	CURB			
139	1032783.9463	2830353.2567	CURB			
140	1032768.8692	2830367.1848	CURB			
141	1032771.0685	2830313.1866	CURB			
142	1032784.9680	2830328.2776	CURB			
143	1032794.1568	2830328.6505	CURB			
144	1032809.2328	2830314.7503	CURB			
145	1032809.9316	2830297.5294	CURB			
146	1032810.2684	2830292.2719	CURB			
147	1032796.3937	2830276.5175	CURB			
148	1032790.3937	2830276.1510	CURB			
149	1032777.0774	2830290.0301	CURB			
150	1032772.0204	2830149.9055	CURB			
		2830149.9055				
151	1032948.6137		CURB			
152	1032937.6942	2830204.8730	CURB			
153	1033015.1953	2830173.6316	CURB			
154	1032997.7133	2830183.6113	CURB			
155	1032989.2937	2830212.3637	CURB			
156	1032995.0518	2830214.0497	CURB			
157	1032942.7794	2830117.9391	CURB			
158	1032944.0963	2830114.3813	CURB			
159	1032997.1333	2830132.6419	CURB			
160	1032996.0459	2830136.2895	CURB			
161	1033038.4377	2830179.4824	CURB			
162	1033018.1107	2830174.3714	CURB			
163	1032850.7153	2830113.9461	CURB			
164	1032841.9942	2830119.4201	CURB			
200	1032851.7697	2830299.3356	PAVE			
201	1032866.2054	2830303.5626	PAVE			
202	1032871.9637	2830305.2487	PAVE			
203	1032907.1191	2830309.2908	PAVE			
204	1032868.0874	2830318.4867	PAVE			
205	1032978.4404	2830323.1196	PAVE			
206	1032985.4745	2830299.0969	PAVE			
207	1032986.5168	2830258.7664	PAVE			
208	1032996.4336	2830261.6702	PAVE			
209	1033002.6160	2830240.5567	PAVE			
210	1032988.5004	2830236.4235	PAVE			
211	1032900.3004	2830236.7179	PAVE			
211	1033003.7400	2830230.7179	PAVE			
		2830230.4799	WALL			
300	1032839.9703					
301	1032849.0374	2830301.1351	WALL			
302	1032862.3710	2830315.5962	WALL			
303	1032853.3039	2830323.9563	WALL			

LEGEND

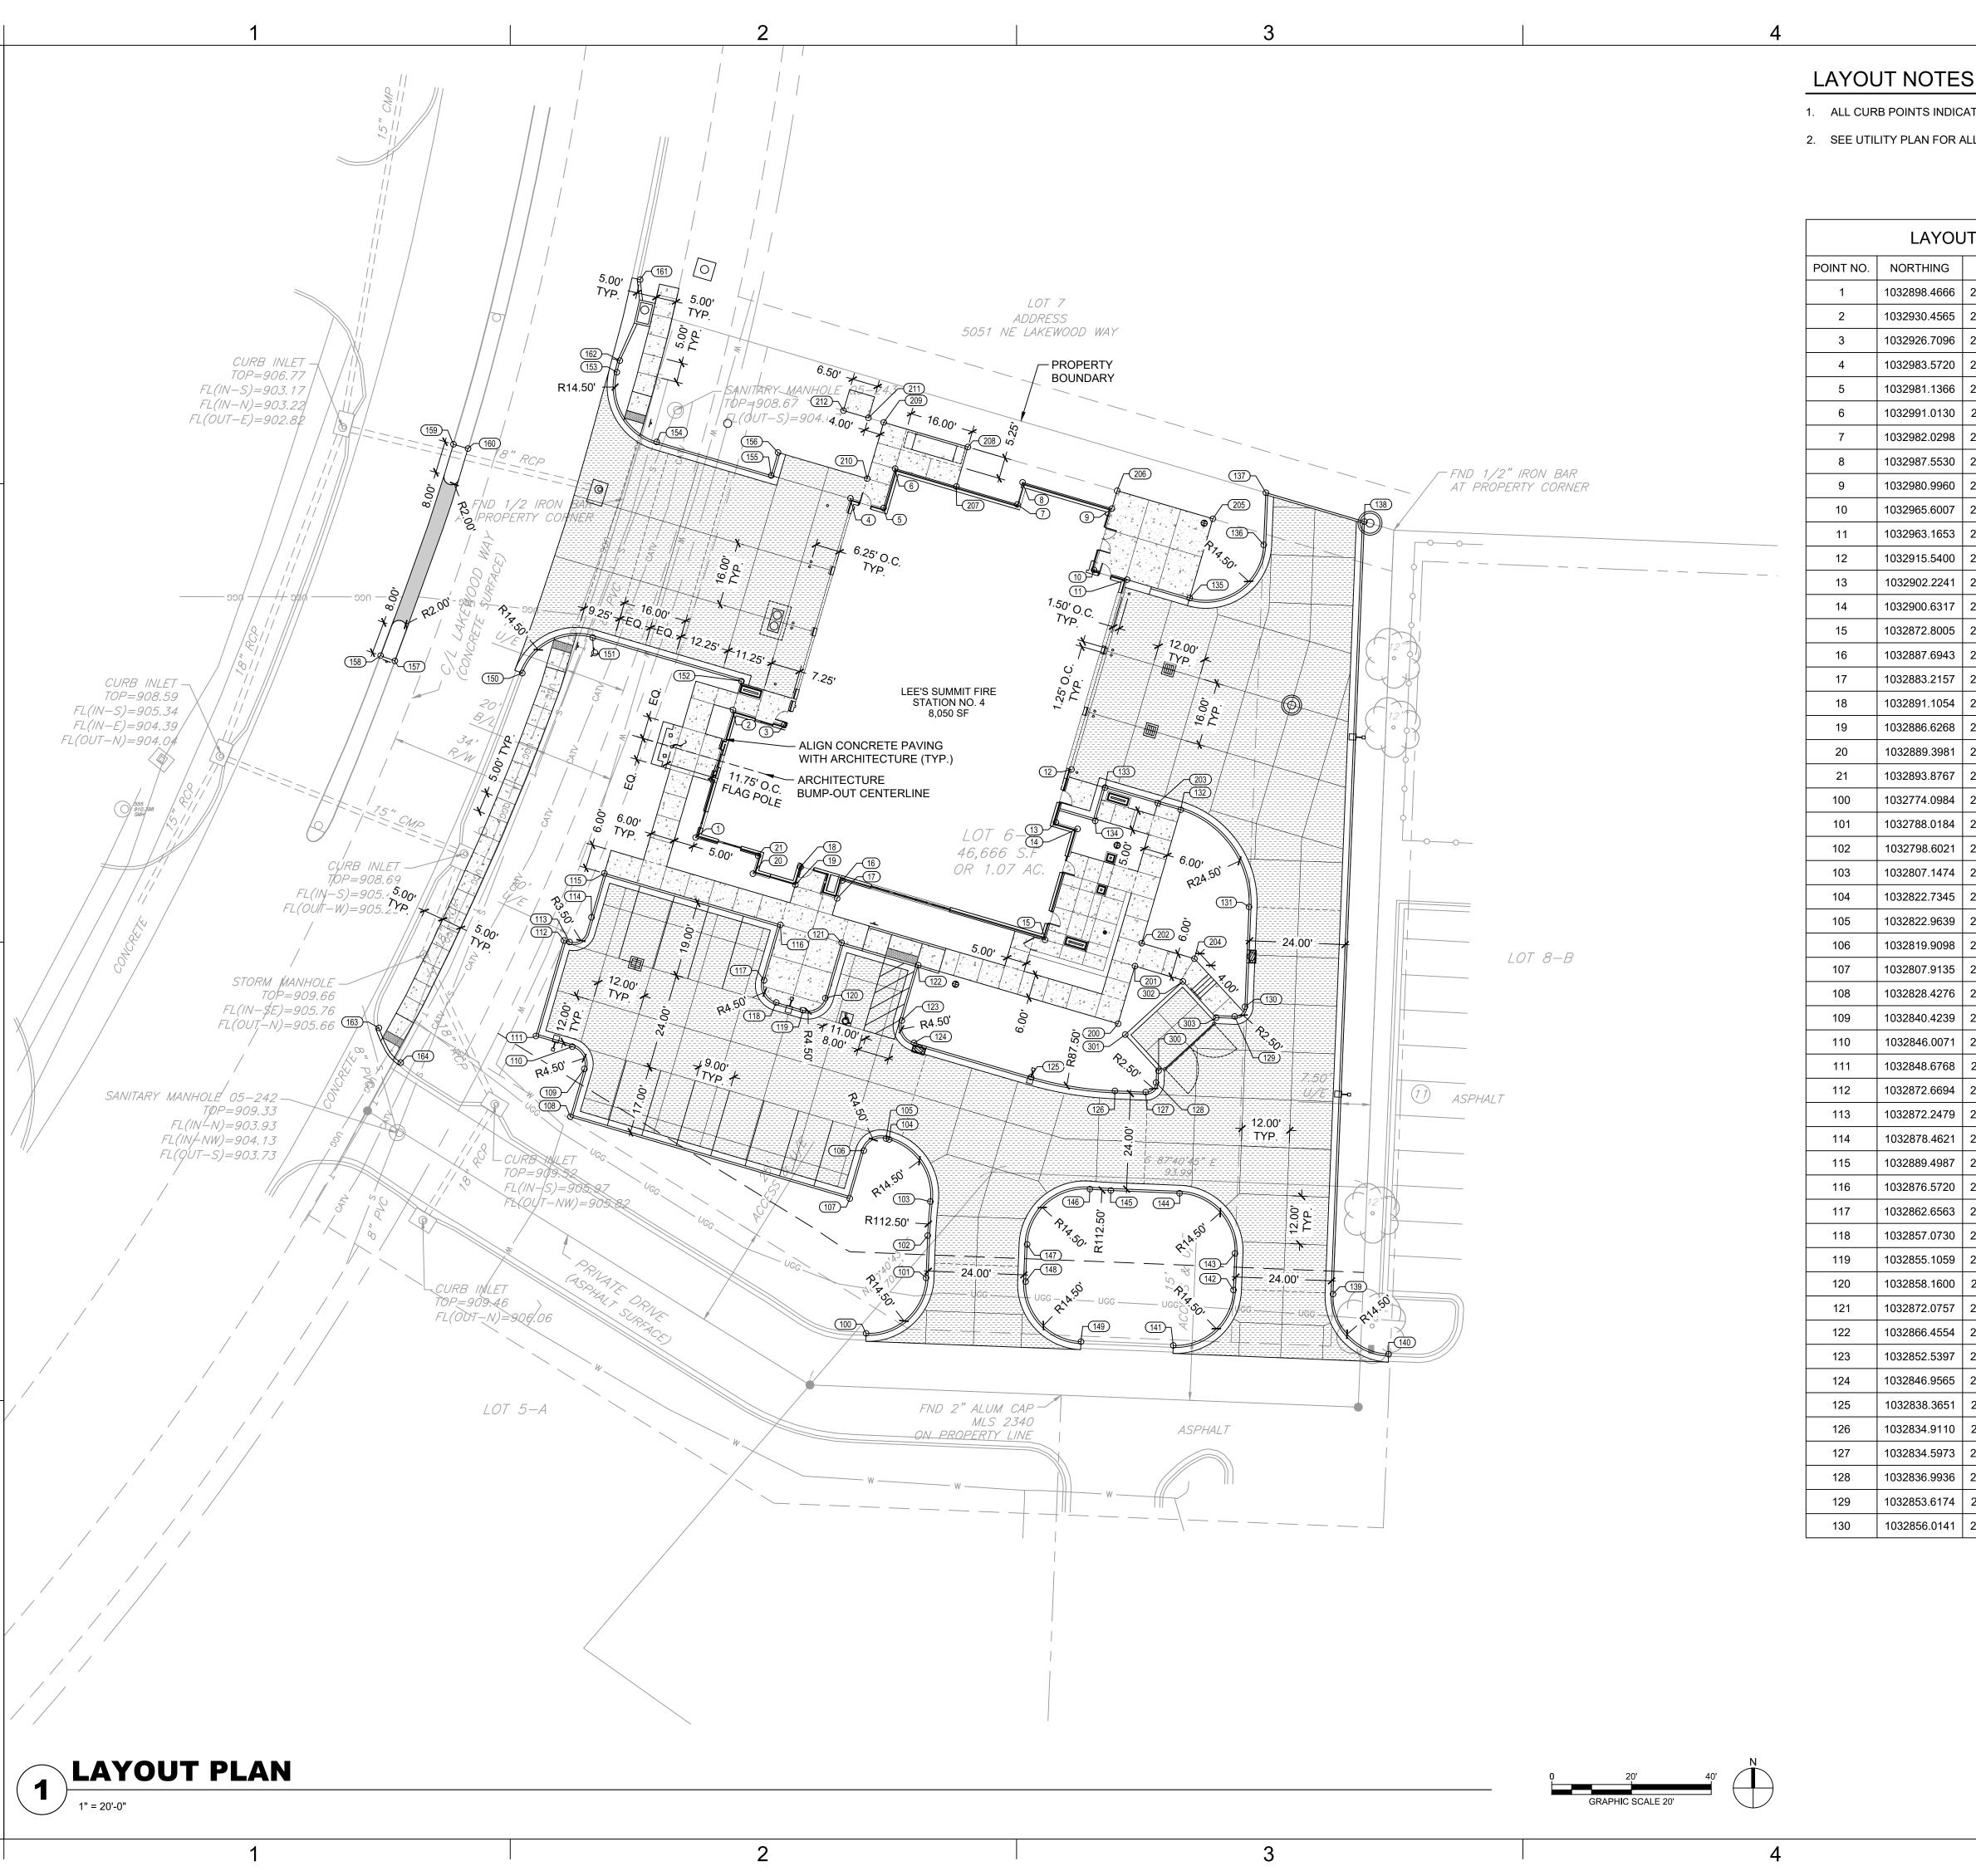TYP. CURB & GUTTER

ASPHALT PATCH

TYP. CONCRETE PAVING

CONCRETE SIDEWALK

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STRUCTURAL ENGINEER LEIGH + O'KANE MISSOURI COA #001644 250 NE MURBERRY, SUITE 201 LEE'S SUMMIT, MO, 64086

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15902 MIDLAND DRIVE

1801 MAIN STREET, SUITE 300 KANSAS CITY, MO 64108 (816) 663-8700 PHONE

5031 NORTHEAST LEE'S SUMMIT, M

FIRE STATION # REVISIONS: # Description Date
1 ASI 01 11.16.2022 ASI 07 04.25.2023 08.08.2023

ASI 11

DERICK M. HOLMES NUMBER

ASI 14 10.13.2023

DERICK HOLMES - CIVIL ENGINEER MO# PE-2022005196

PE 2022005196 /

PROJECT NO: 18225R21001 DATE: 10.19.2022 DRAWN BY: KDW CHK'D BY: DMH

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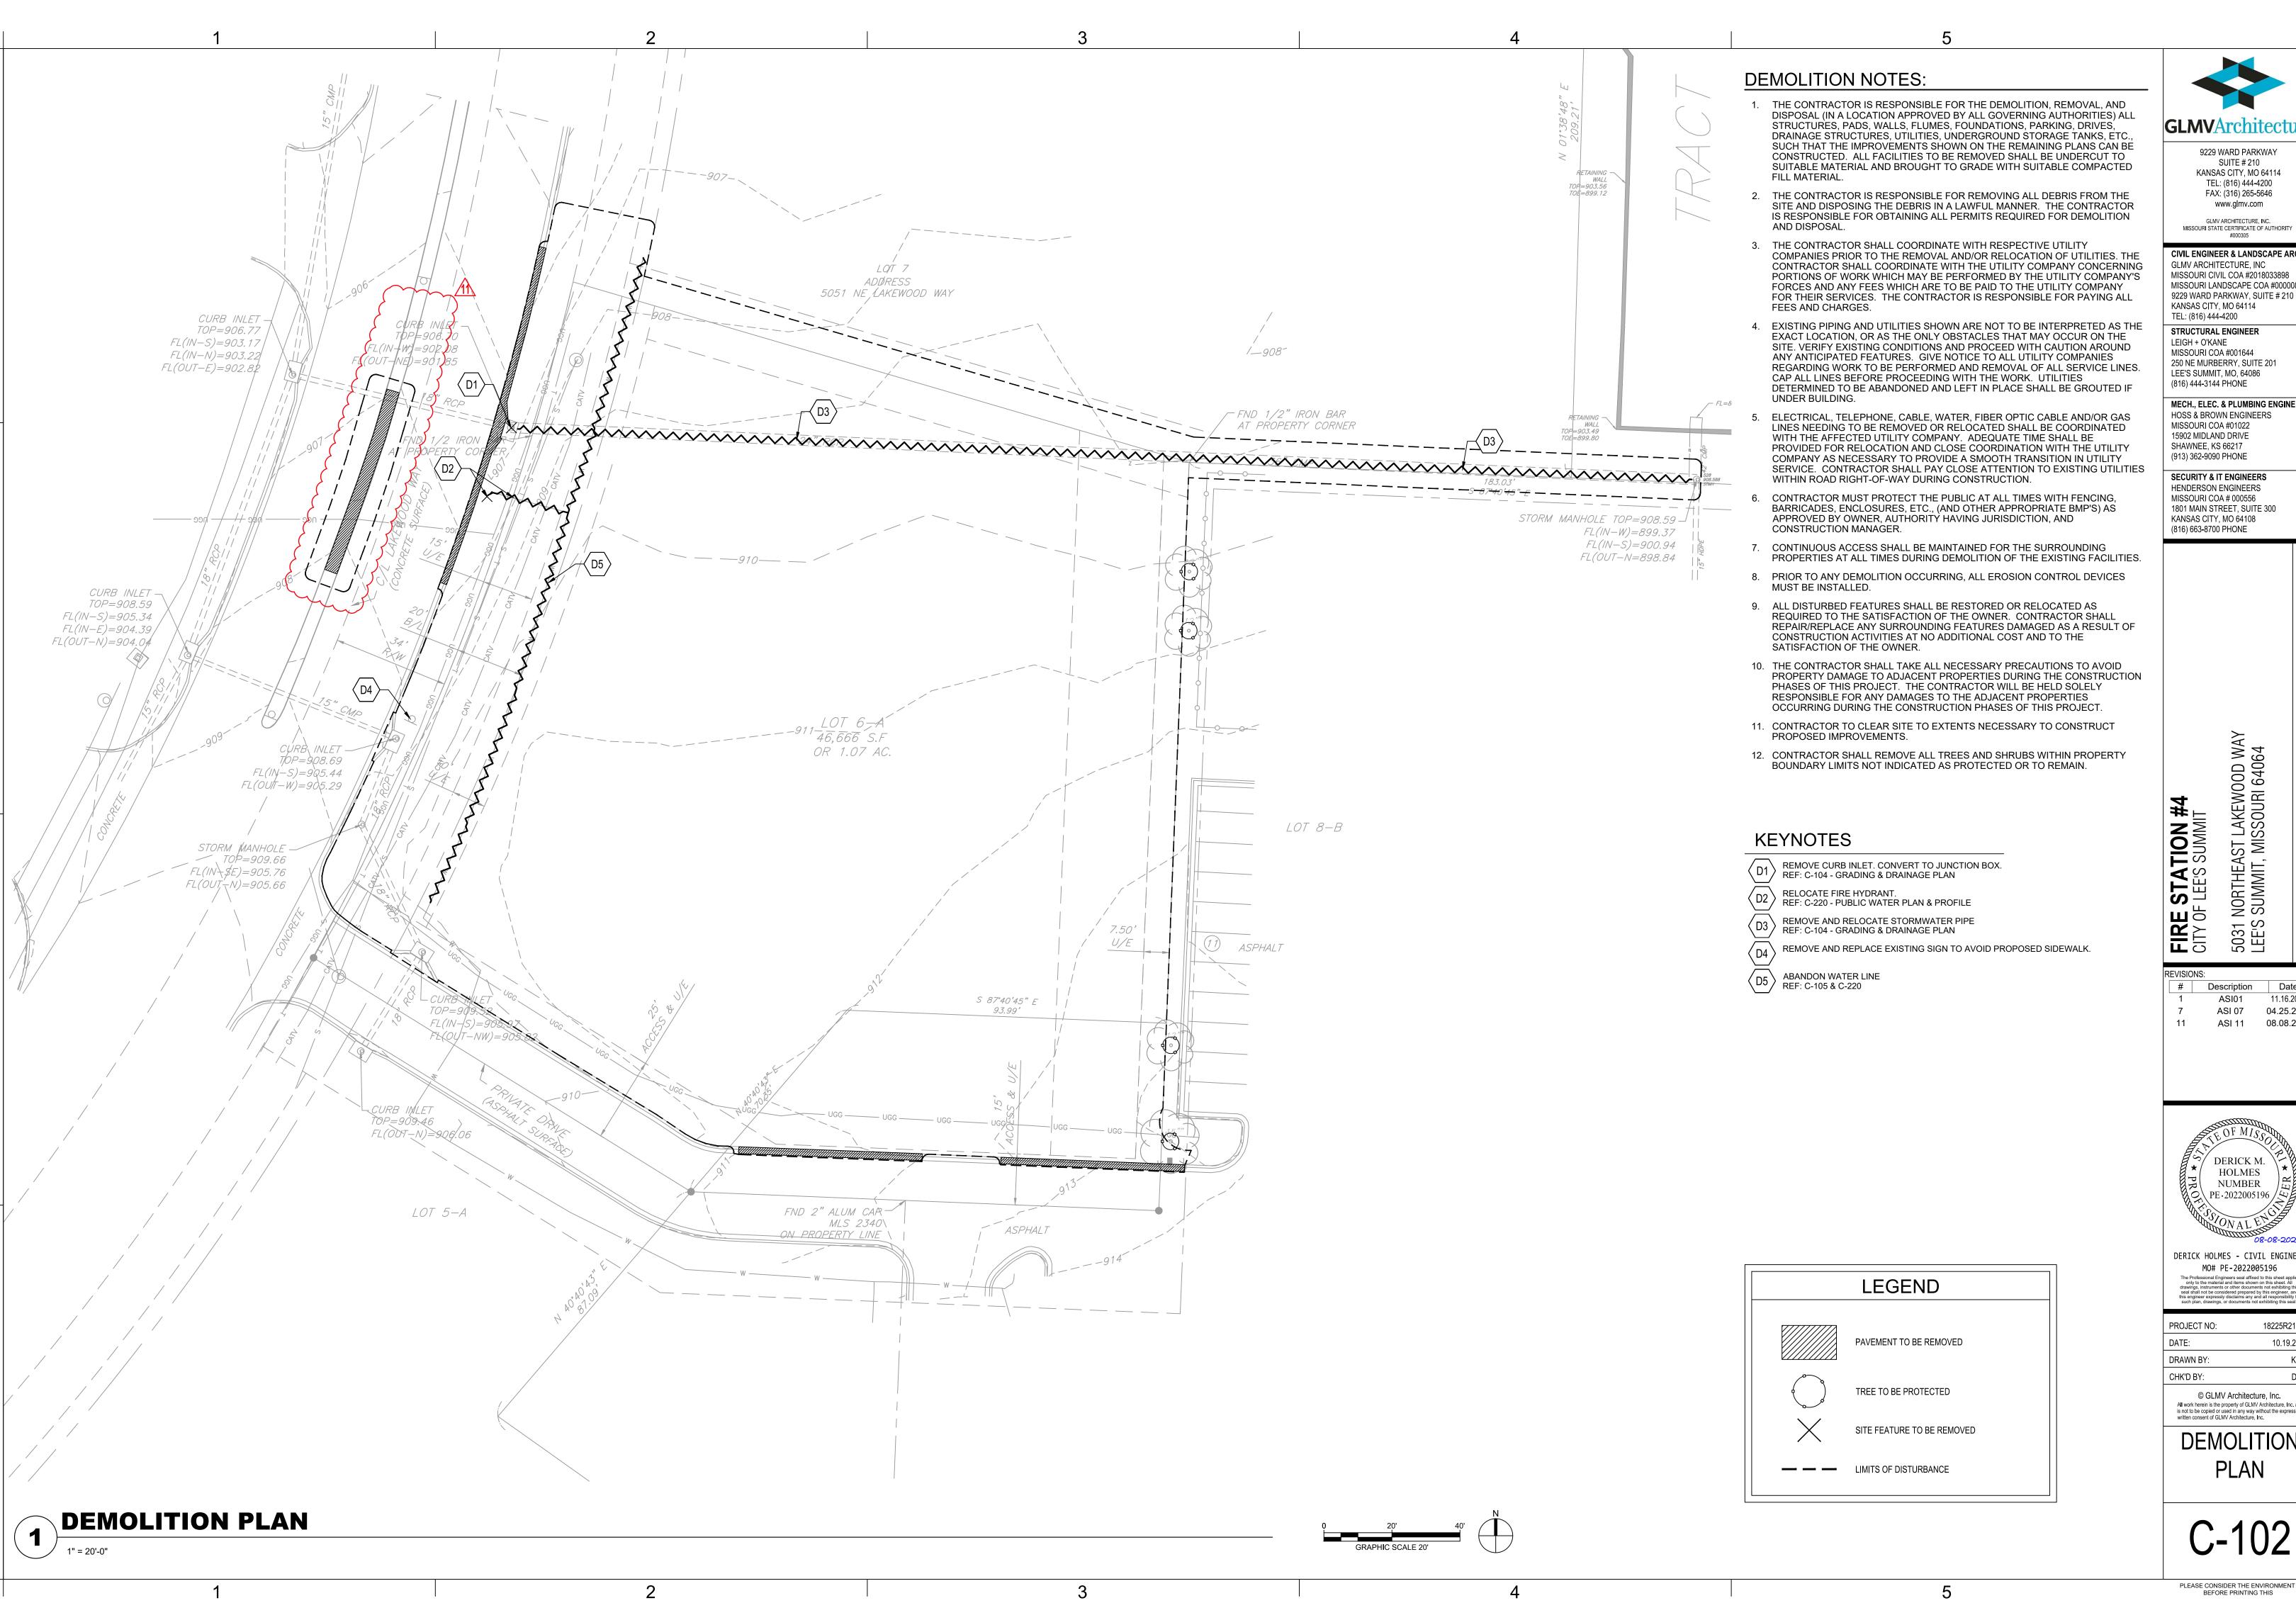
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LAYOUT PLAN

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250 NE MURBERRY, SUITE 201 LEE'S SUMMIT, MO, 64086 (816) 444-3144 PHONE

MECH., ELEC. & PLUMBING ENGINEERS HOSS & BROWN ENGINEERS MISSOURI COA #01022 15902 MIDLAND DRIVE

SHAWNEE, KS 66217 (913) 362-9090 PHONE SECURITY & IT ENGINEERS HENDERSON ENGINEERS

MISSOURI COA # 000556 1801 MAIN STREET, SUITE 300

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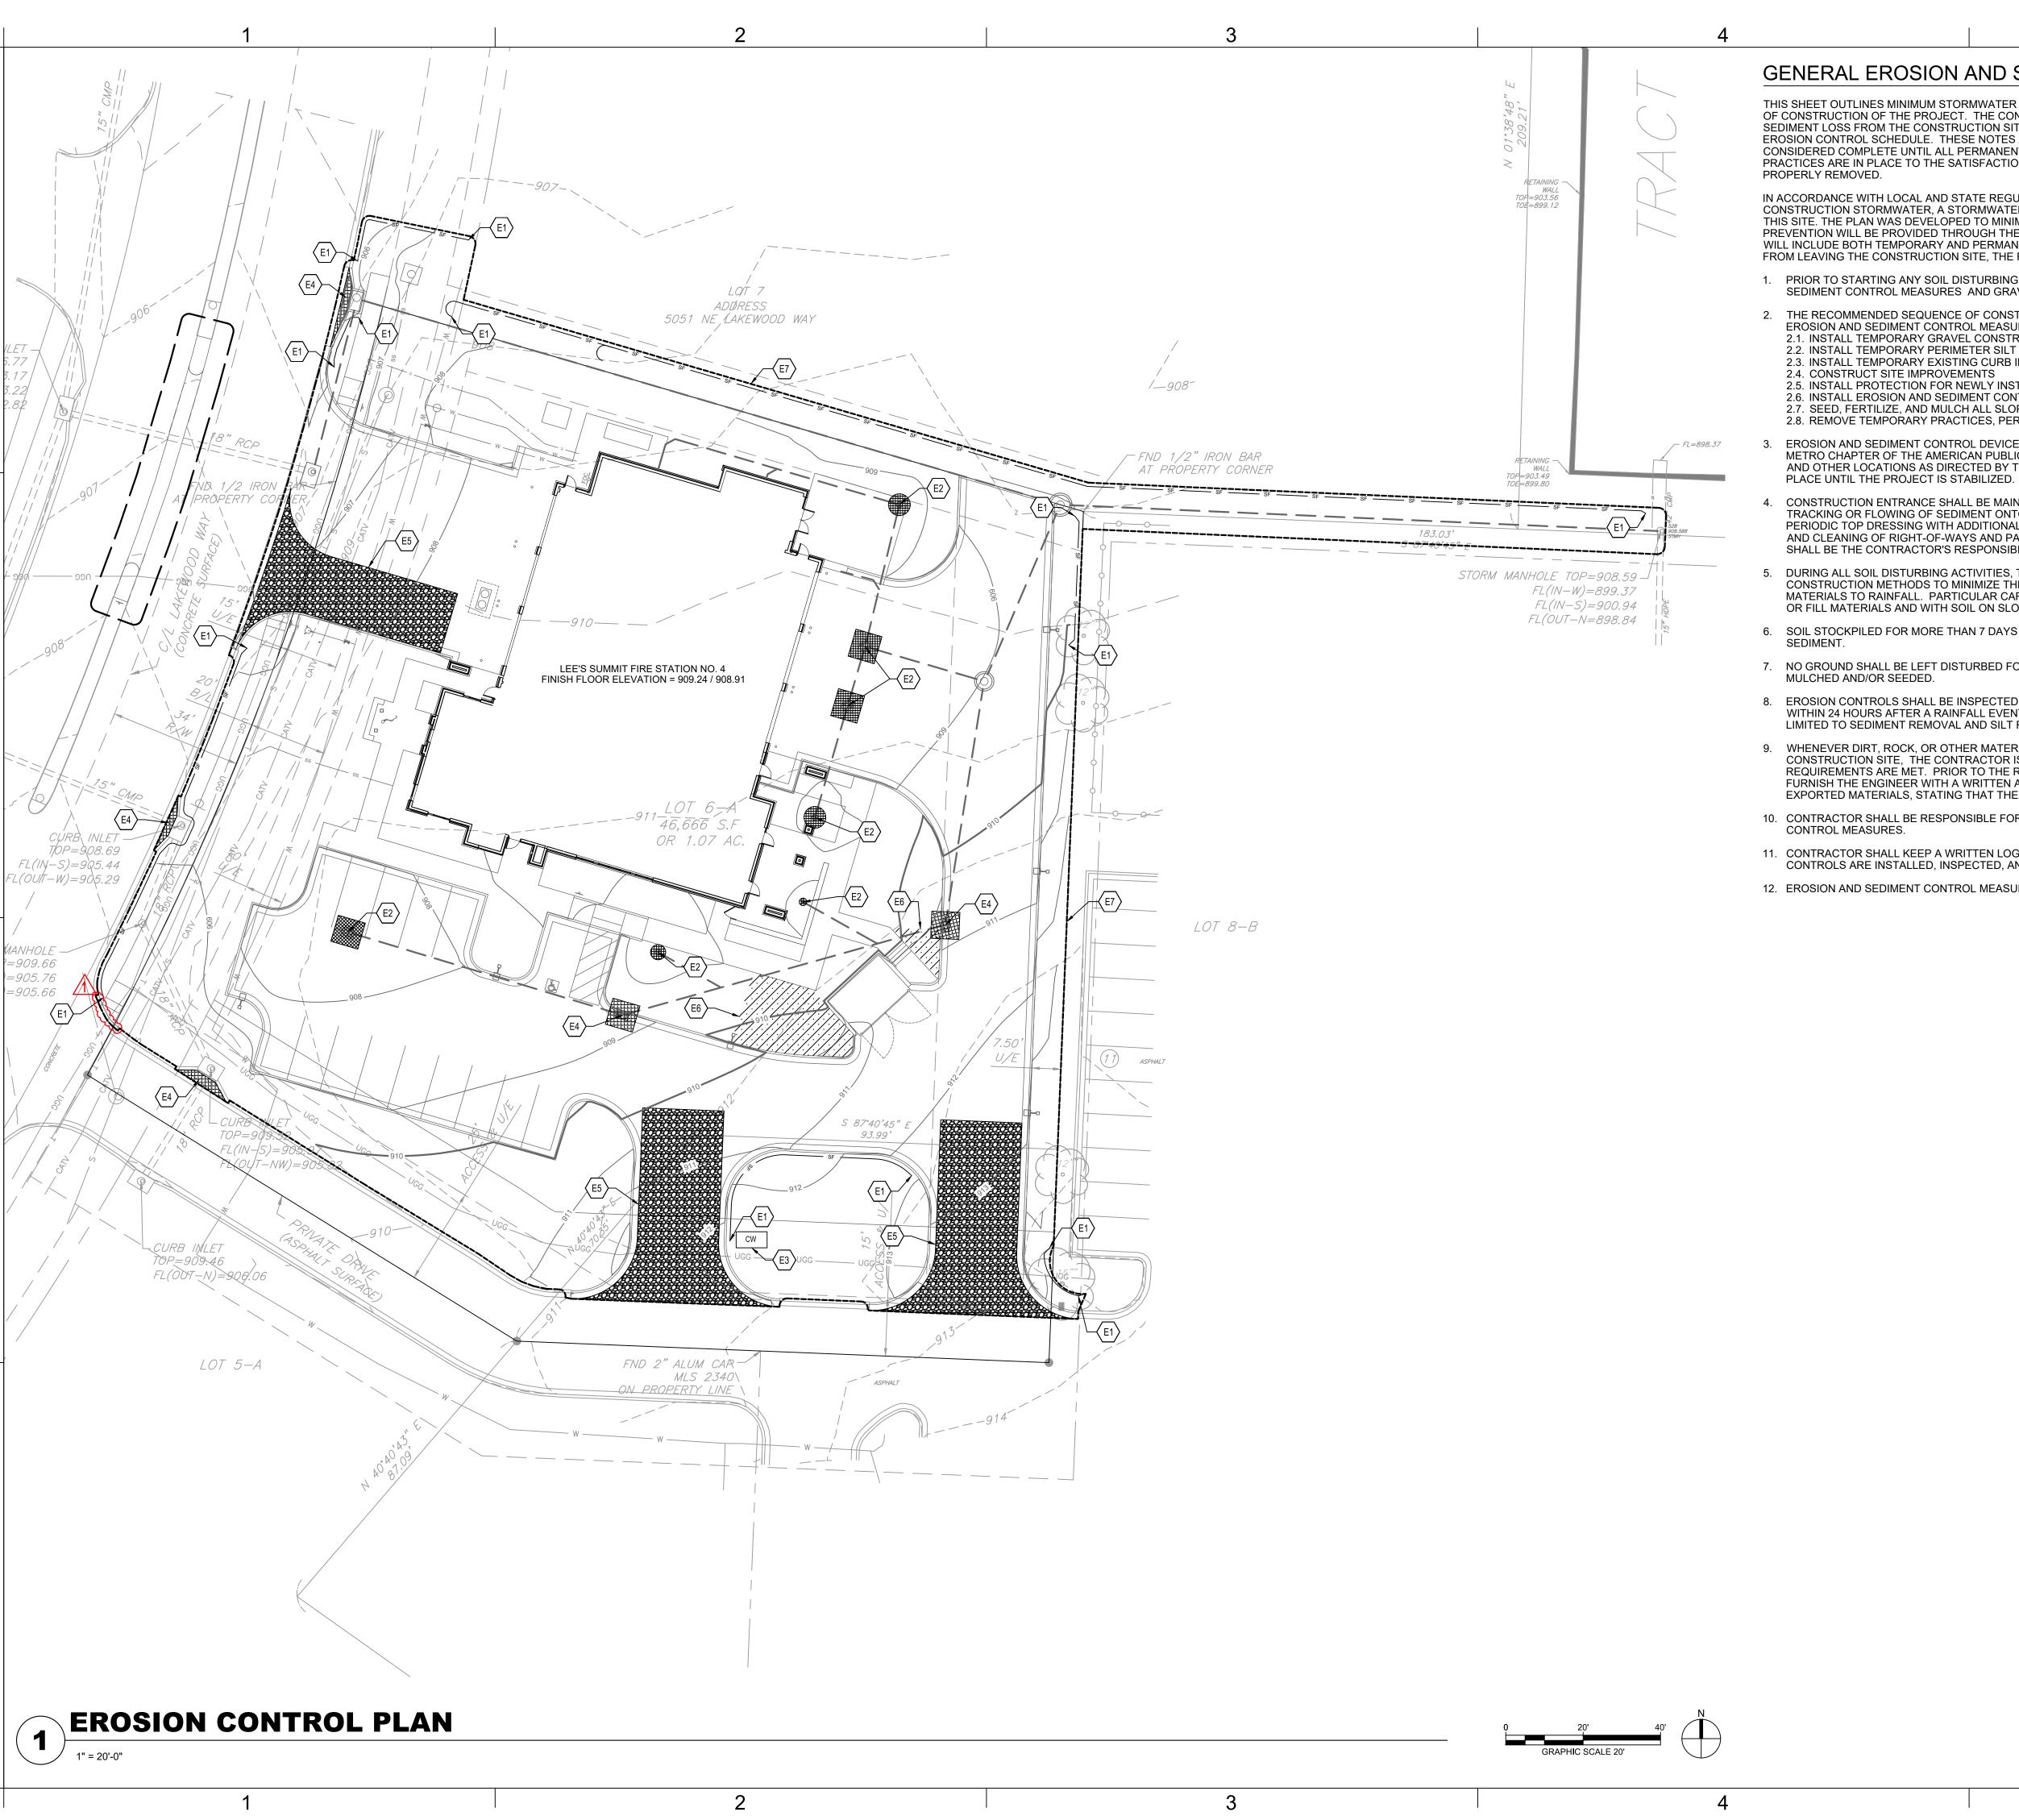
HOLMES NUMBER PE-2022005196

DERICK HOLMES - CIVIL ENGINEER MO# PE-2022005196

PROJECT NO: 18225R21001 DATE: 10.19.2022 DRAWN BY: KDW CHK'D BY:

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**DEMOLITION PLAN** 



# GENERAL EROSION AND SEDIMENT CONTROL NOTES:

THIS SHEET OUTLINES MINIMUM STORMWATER PRACTICES TO BE FOLLOWED BY THE CONTRACTOR DURING ALL PHASES OF CONSTRUCTION OF THE PROJECT. THE CONTRACTOR WILL BE RESPONSIBLE FOR PREVENTION OF SOIL OR SEDIMENT LOSS FROM THE CONSTRUCTION SITE. THE CONTRACTOR SHALL SUBMIT A SITE-SPECIFIC SEDIMENT AND EROSION CONTROL SCHEDULE. THESE NOTES ARE TO BE USED AS A GUIDELINE ONLY. THE PROJECT IS NOT CONSIDERED COMPLETE UNTIL ALL PERMANENT EROSION AND SEDIMENT CONTROLS AND STORMWATER MANAGEMENT PRACTICES ARE IN PLACE TO THE SATISFACTION OF THE OWNER AND ENGINEER. ALL TEMPORARY PRACTICES MUST BE PROPERLY REMOVED.

IN ACCORDANCE WITH LOCAL AND STATE REGULATIONS PURSUANT TO THE GENERAL NPDES PERMIT FOR CONSTRUCTION STORMWATER, A STORMWATER POLLUTION PREVENTION PLAN (SWPPP) HAS BEEN DEVELOPED FOR THIS SITE. THE PLAN WAS DEVELOPED TO MINIMIZE THE EFFECTS OF SOIL EROSION AND RESULTING SEDIMENT LOSS. PREVENTION WILL BE PROVIDED THROUGH THE USE OF PROPER CONSTRUCTION TECHNIQUES. THESE TECHNIQUES WILL INCLUDE BOTH TEMPORARY AND PERMANENT MANAGEMENT PRACTICES. TO PREVENT EROSION AND SEDIMENT FROM LEAVING THE CONSTRUCTION SITE, THE FOLLOWING STEPS SHALL BE TAKEN DURING CONSTRUCTION:

- 1. PRIOR TO STARTING ANY SOIL DISTURBING ACTIVITIES, THE CONTRACTOR SHALL INSTALL PERIMETER EROSION AND SEDIMENT CONTROL MEASURES AND GRAVEL CONSTRUCTION ENTRANCES.
- 2. THE RECOMMENDED SEQUENCE OF CONSTRUCTION ACTIVITIES AND OF THE INSTALLATION AND REMOVAL OF **EROSION AND SEDIMENT CONTROL MEASURES IS AS FOLLOWS:**
- 2.1. INSTALL TEMPORARY GRAVEL CONSTRUCTION ENTRANCES
- 2.2. INSTALL TEMPORARY PERIMETER SILT FENCE
- 2.3. INSTALL TEMPORARY EXISTING CURB INLET PROTECTION
- 2.5. INSTALL PROTECTION FOR NEWLY INSTALLED CURB INLETS, AREA INLETS, AND JUNCTION BOXES
- 2.6. INSTALL EROSION AND SEDIMENT CONTROL BLANKETS 2.7. SEED, FERTILIZE, AND MULCH ALL SLOPES AND DISTURBED AREAS
- 2.8. REMOVE TEMPORARY PRACTICES, PERIMETER CONTROLS, AND SITE CLEANUP.
- EROSION AND SEDIMENT CONTROL DEVICES SHALL BE CONSTRUCTED IN ACCORDANCE WITH THE KANSAS CITY METRO CHAPTER OF THE AMERICAN PUBLIC WORKS ASSOCIATION. INSTALL SILT FENCE AT INDICATED LOCATIONS AND OTHER LOCATIONS AS DIRECTED BY THE ENGINEER TO CONTROL SOIL EROSION. SILT FENCE SHALL BE KEPT IN
  - CONSTRUCTION ENTRANCE SHALL BE MAINTAINED BY THE CONTRACTOR IN A CONDITION THAT WILL PREVENT TRACKING OR FLOWING OF SEDIMENT ONTO PUBLIC RIGHT-OF-WAYS AND PAVED STREETS. THIS MAY INCLUDE PERIODIC TOP DRESSING WITH ADDITIONAL CRUSHED STONE AS CONDITIONS WARRANT. REPAIR OF ENTRANCE(S) AND CLEANING OF RIGHT-OF-WAYS AND PAVED STREETS THAT HAVE BEEN SOILED BY CONSTRUCTION ACTIVITIES SHALL BE THE CONTRACTOR'S RESPONSIBILITY.
- DURING ALL SOIL DISTURBING ACTIVITIES, THE CONTRACTOR SHALL TAKE APPROPRIATE STEPS USING ACCEPTED CONSTRUCTION METHODS TO MINIMIZE THE TIME OF EXPOSURE OF UNPROTECTED SOIL AND OTHER CONSTRUCTION MATERIALS TO RAINFALL. PARTICULAR CARE MUST BE EXERCISED WHEN DEALING WITH STOCKPILES OF TOPSOIL OR FILL MATERIALS AND WITH SOIL ON SLOPES.
- 6. SOIL STOCKPILED FOR MORE THAN 7 DAYS WILL HAVE SILT FENCE PLACED ON THE DOWNHILL SIDE TO TRAP
- 7. NO GROUND SHALL BE LEFT DISTURBED FOR MORE THAN 14 DAYS OF NON-ACTIVITY WITHOUT BEING TEMPORARILY MULCHED AND/OR SEEDED.
- 8. EROSION CONTROLS SHALL BE INSPECTED AND MAINTAINED BY THE CONTRACTOR NOT LESS THAN WEEKLY AND WITHIN 24 HOURS AFTER A RAINFALL EVENT OF 0.5 INCHES OR MORE. MAINTENANCE SHALL INCLUDE BUT NOT BE LIMITED TO SEDIMENT REMOVAL AND SILT FENCE REPAIR AND/OR REPLACEMENT.
- 9. WHENEVER DIRT, ROCK, OR OTHER MATERIALS ARE EXPORTED FOR PLACEMENT IN AREAS OFF THE PRIMARY CONSTRUCTION SITE. THE CONTRACTOR IS RESPONSIBLE FOR DETERMINING THAT ALL JURISDICTIONAL AUTHORITY REQUIREMENTS ARE MET. PRIOR TO THE REMOVAL OF ANY MATERIALS FROM THE SITE THE CONTRACTOR WILL FURNISH THE ENGINEER WITH A WRITTEN AGREEMENT, SIGNED BY EACH LANDOWNER WHO WILL RECEIVE EXPORTED MATERIALS, STATING THAT THE RECEIVING SITE WILL BE PROPERLY PERMITTED, WHEN REQUIRED.
- 10. CONTRACTOR SHALL BE RESPONSIBLE FOR ALL COSTS AND EXPENSES OF PROVIDING EROSION AND SEDIMENT
- 11. CONTRACTOR SHALL KEEP A WRITTEN LOG OF WHEN CONSTRUCTION ACTIVITIES BEGIN, EROSION AND SEDIMENT CONTROLS ARE INSTALLED, INSPECTED, AND REPAIRED. COPIES OF LOG SHALL BE FURNISHED TO THE ENGINEER.
- 12. EROSION AND SEDIMENT CONTROL MEASURES SHALL BE REMOVED UPON STABILIZATION OF DISTURBED AREAS.

# **EROSION CONTROL KEYNOTES**

E1 SILT FENCE REF: 3 / C-510

AREA INLET AND JUNCTION BOX PROTECTION REF: 1 / C-511

E3 CONCRETE WASHOUT REF: 1 / C-510


CURB INLET PROTECTION REF: 4 / C-510

E5 CONSTRUCTION ENTRANCE REF: 1 / C-510

 $\langle$  E7 angle LIMITS OF DISTURBANCE

---- SF ---- SILT FENCE

E6 TEMPORARY EROSION CONTROL BLANKET REF: 2 / C-510

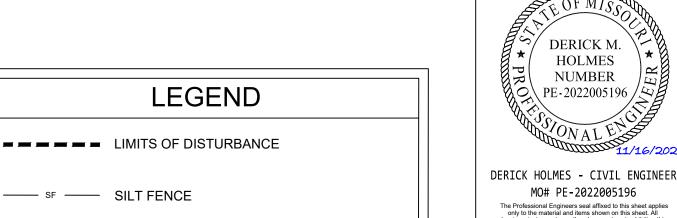

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9229 WARD PARKWAY

SUITE # 210 KANSAS CITY, MO 64114

TEL: (816) 444-4200

FAX: (316) 265-5646

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9229 WARD PARKWAY, SUITE # 210

GLMV ARCHITECTURE, INC MISSOURI CIVIL COA #2018033898

KANSAS CITY, MO 64114

STRUCTURAL ENGINEER

MISSOURI COA #001644

LEE'S SUMMIT, MO, 64086

HOSS & BROWN ENGINEERS

MISSOURI COA #01022

15902 MIDLAND DRIVE SHAWNEE, KS 66217

(913) 362-9090 PHONE

**SECURITY & IT ENGINEERS** 

HENDERSON ENGINEERS

MISSOURI COA # 000556 1801 MAIN STREET, SUITE 300

KANSAS CITY, MO 64108

(816) 663-8700 PHONE

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Description Date

11.16.2022

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250 NE MURBERRY, SUITE 201

MECH., ELEC. & PLUMBING ENGINEERS

TEL: (816) 444-4200

LEIGH + O'KANE

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**EROSION** CONTROL PLAN

AREA INLET PROTECTION


CONCRETE WASHOUT


CURB INLET PROTECTION

CONSTRUCTION ENTRANCE

TEMPORARY EROSION CONTROL BLANKET

PLEASE CONSIDER THE ENVIRONMENT

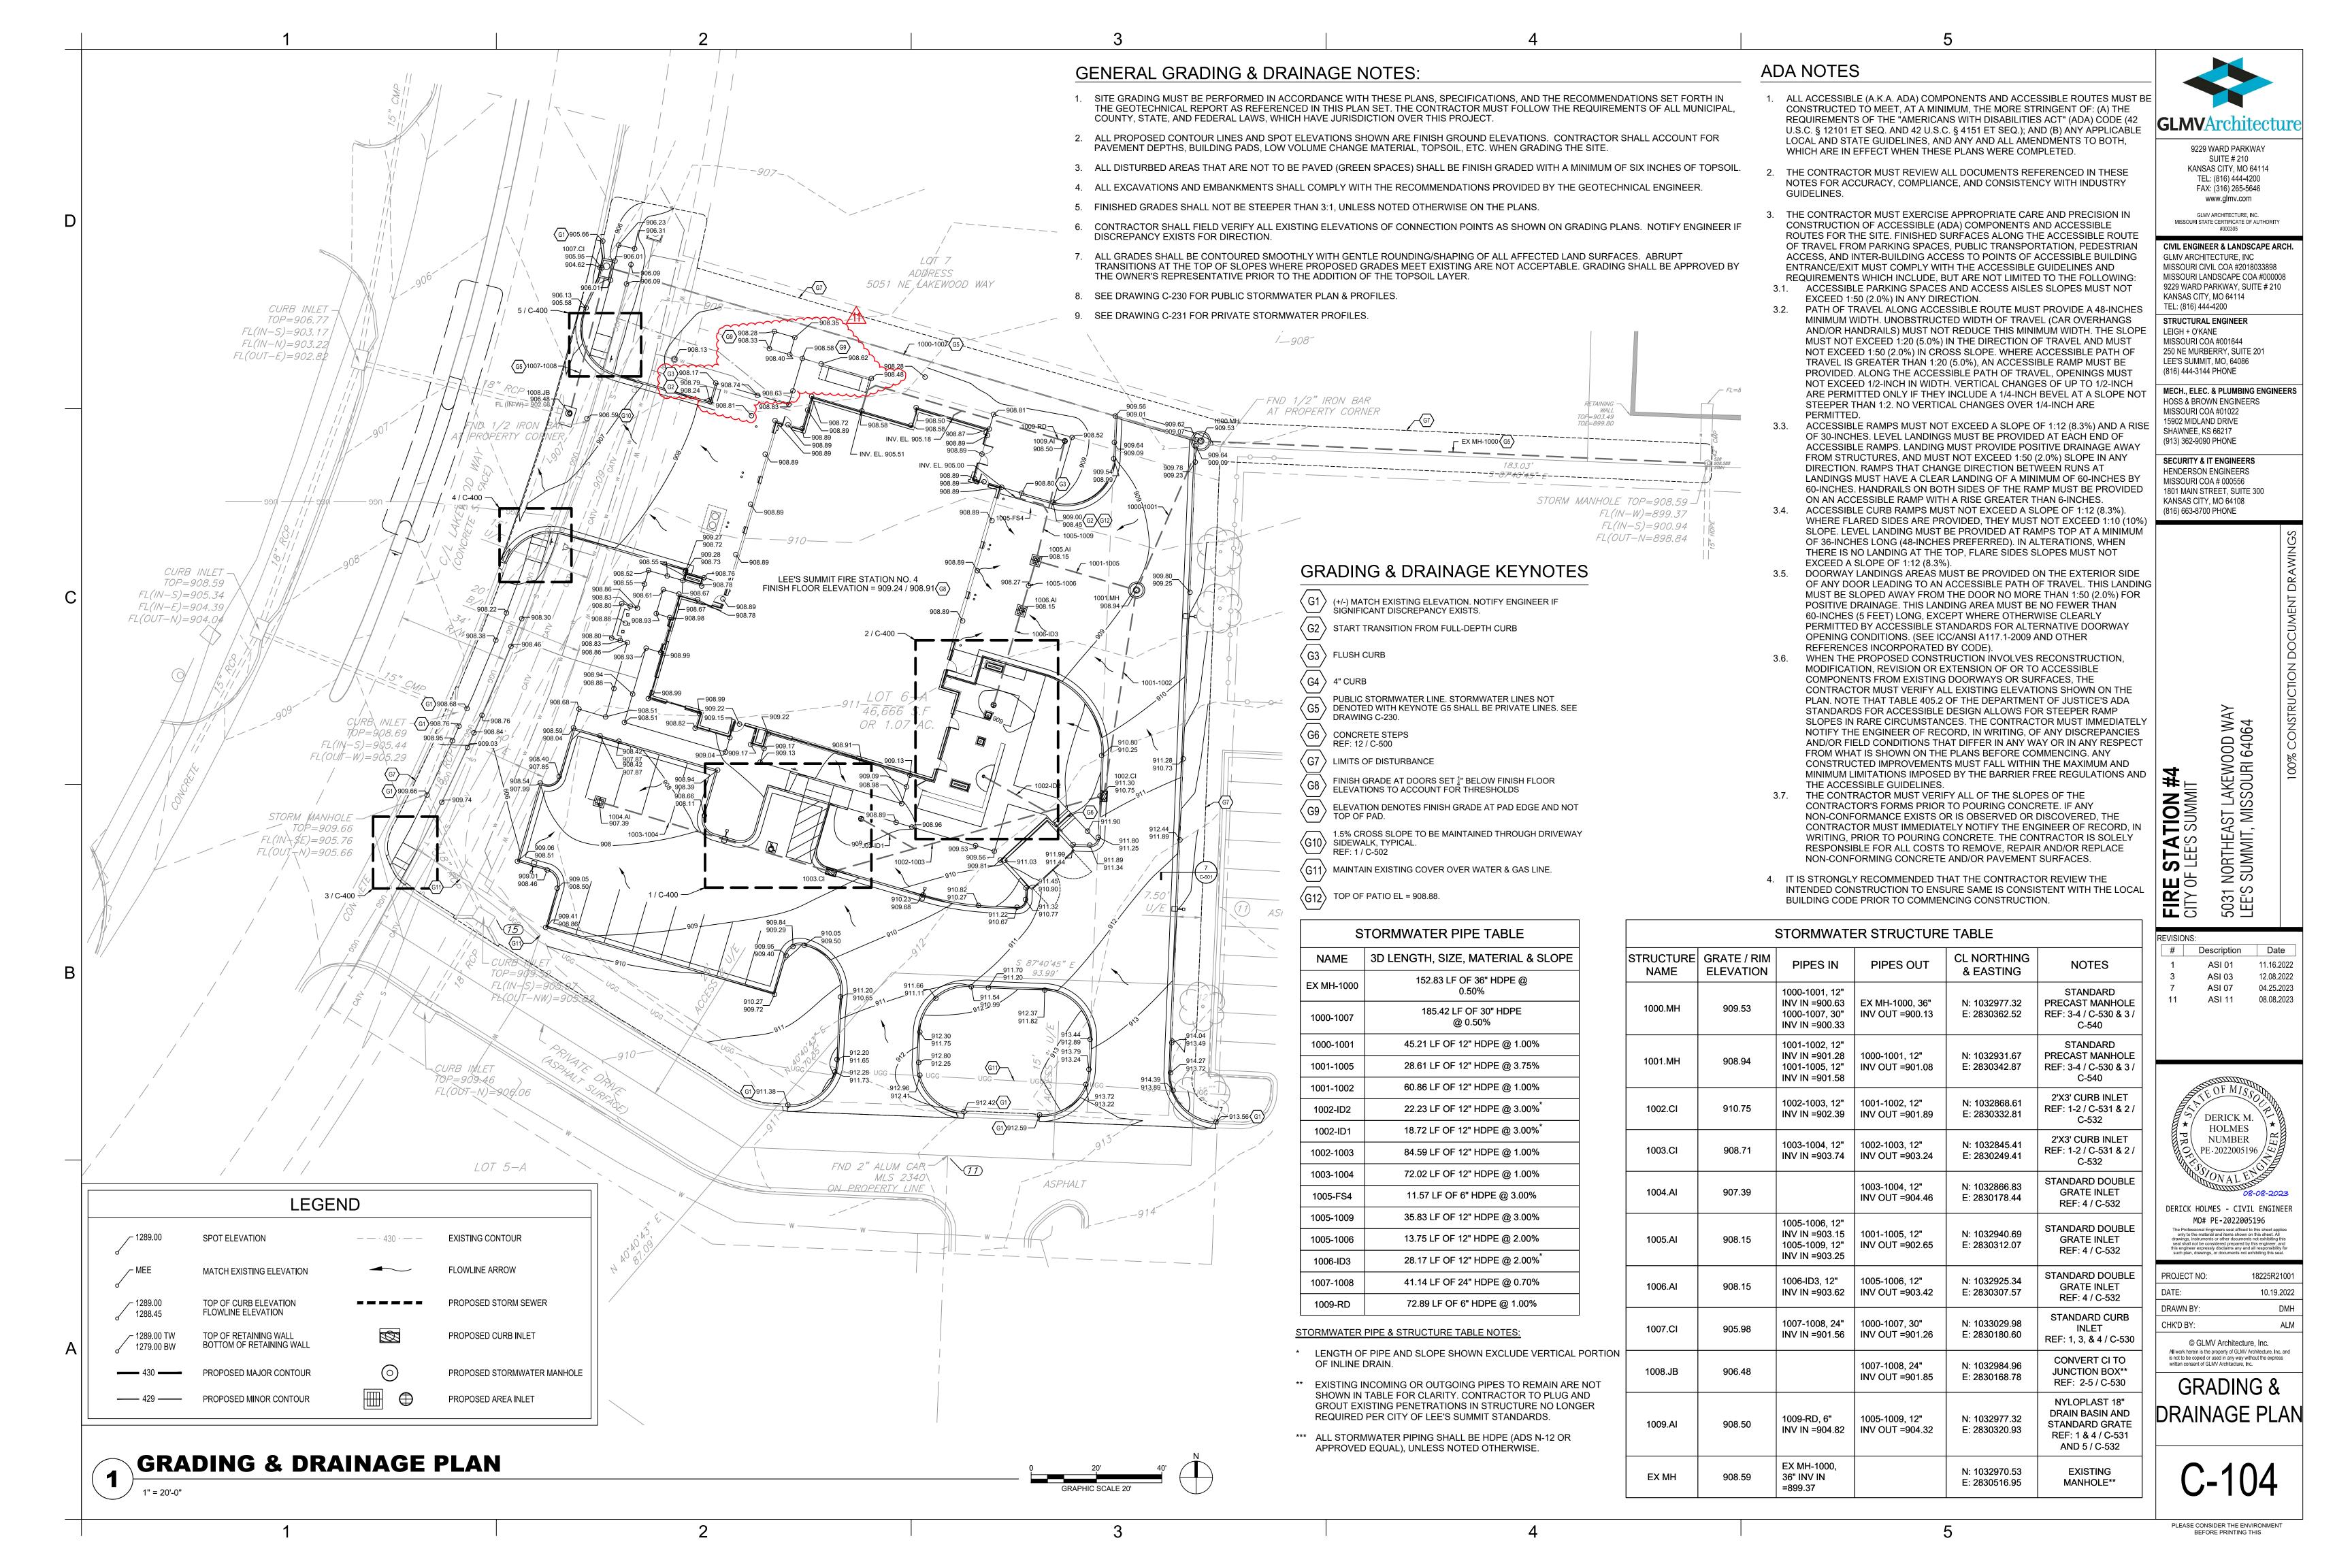

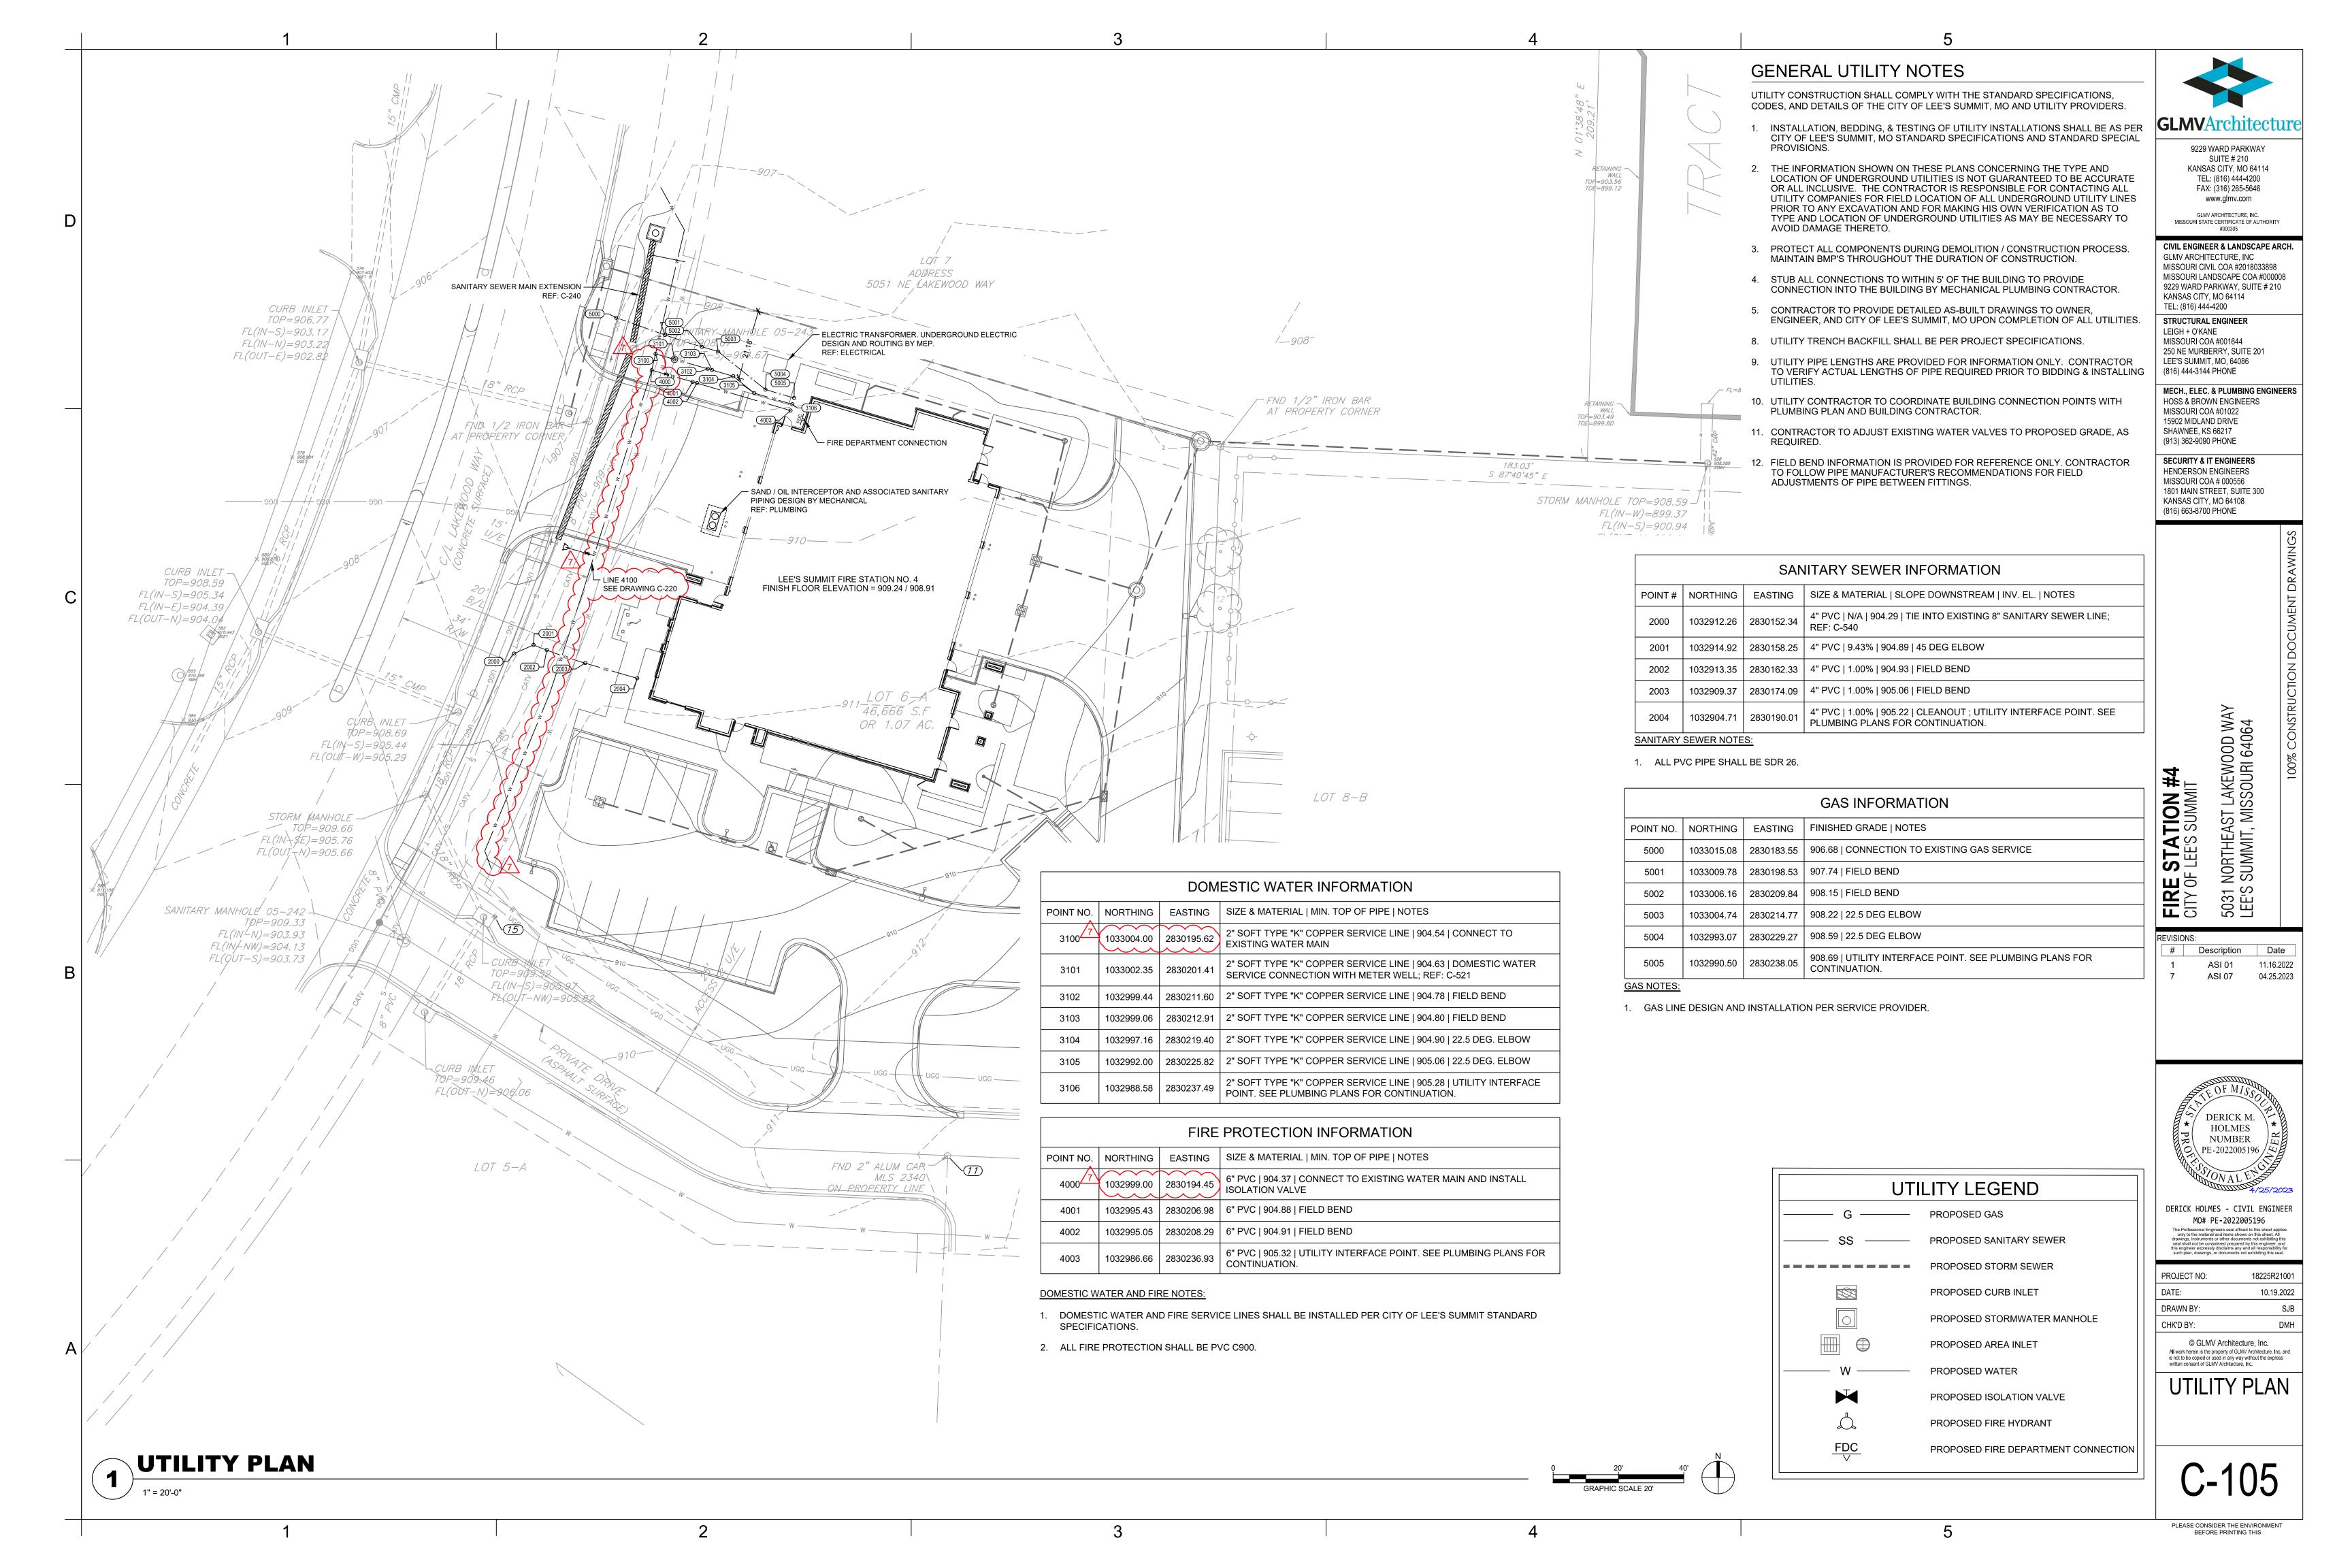

**GENERAL NOTES:** 1. SEE DRAWING C-105 FOR GENERAL NOTES APPLICABLE TO THIS DRAWING. /--STA. 0+70.46, PUBLIC WTR LINE 4100 STA. 0+59.46, PUBLIC WTR LINE 4100-0.7° DEFLECTION INSTALL FIRE HYDRANT ASSEMBLY - STRAIGHT SET N=1032931.75 LENGTH = 9.0' E=2830173.55 REF: 5 / C-520 N=1032942.25 E=2830176.82 -STA. 1+03.63, PUBLIC WTR LINE 4100 4.4° DEFLECTION N=1032900.20 LEE'S SUMMIT FIRE STATION NO. E=2830163.30 LINE 3100 + REF: C-105 LINE 4000 --STA. 1+61.98, PUBLIC WTR LINE 4100 REF: C-105 REF: C-105 INSTALL 45° BEND & CONNECT TO EXISTING PIPE N=1032846.16 E=2830145.43 STA. 0+00.00, PUBLIC WTR LINE 4100-CONNECT TO EXISTING PIPE (CONCRETE SURFACE) — C/L LAKEWOOD WAY N=1032999.03 -STA. 1+55.95, PUBLIC WTR LINE 4100 E=2830194.46 INSTALL 45° BEND N=1032851.83 E=2830143.37 **PUBLIC WATER LINE 4100 PLAN** SCALE: HORIZONTAL 1"=40' EXISTING GRADE 910.00 910.00 FINAL GRADE -900.00 8 " DIP @ 5.24% 52.32 LF 8 " PVC C900 @ 5.24% 8 " PVC C900 8 ' PV¢ C900 @ 2.66% @ -0.18%

> 908.63 907.76 909.13 909.44 907.54 909.68 908.60 910.21 910.21 909.03 910.31 909.03

**PUBLIC WATER LINE 4100 PROFILE** 

-0+40 -0+20 0+00 0+20 0+40 0+60 0+80 1+00 1+20 1+40 1+60 1+80

SCALE: HORIZONTAL 1"=40' SCALE: VERTICAL 1"=4'

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CIVIL ENGINEER & LANDSCAPE ARCH.

FAX: (316) 265-5646 www.glmv.com

GLMV ARCHITECTURE, INC
MISSOURI CIVIL COA #2018033898
MISSOURI LANDSCAPE COA #000008
9229 WARD PARKWAY, SUITE # 210
KANSAS CITY, MO 64114
TEL: (816) 444-4200

STRUCTURAL ENGINEER
LEIGH + O'KANE
MISSOURI COA #001644
250 NE MURBERRY, SUITE 201

250 NE MURBERRY, SUITE 201 LEE'S SUMMIT, MO, 64086 (816) 444-3144 PHONE

MECH., ELEC. & PLUMBING ENGINEERS

HOSS & BROWN ENGINEERS MISSOURI COA #01022 15902 MIDLAND DRIVE SHAWNEE, KS 66217

SECURITY & IT ENGINEERS
HENDERSON ENGINEERS
MISSOURI COA # 000556
1801 MAIN STREET, SUITE 300
KANSAS CITY, MO 64108
(816) 663-8700 PHONE

(913) 362-9090 PHONE

OCUMENT DRAWING

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FIRE STATION #
CITY OF LEE'S SUMMIT
5031 NORTHEAST LAKE
LEE'S SUMMIT, MISSOU

REVISIONS:
# Description

# Description Date

1 ASI 01 11.16.2022
7 ASI 07 04.25.2023



DERICK HOLMES - CIVIL ENGINEER

MO# PE-2022005196

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DRAWN BY:	HFL
CHK'D BY:	CDW

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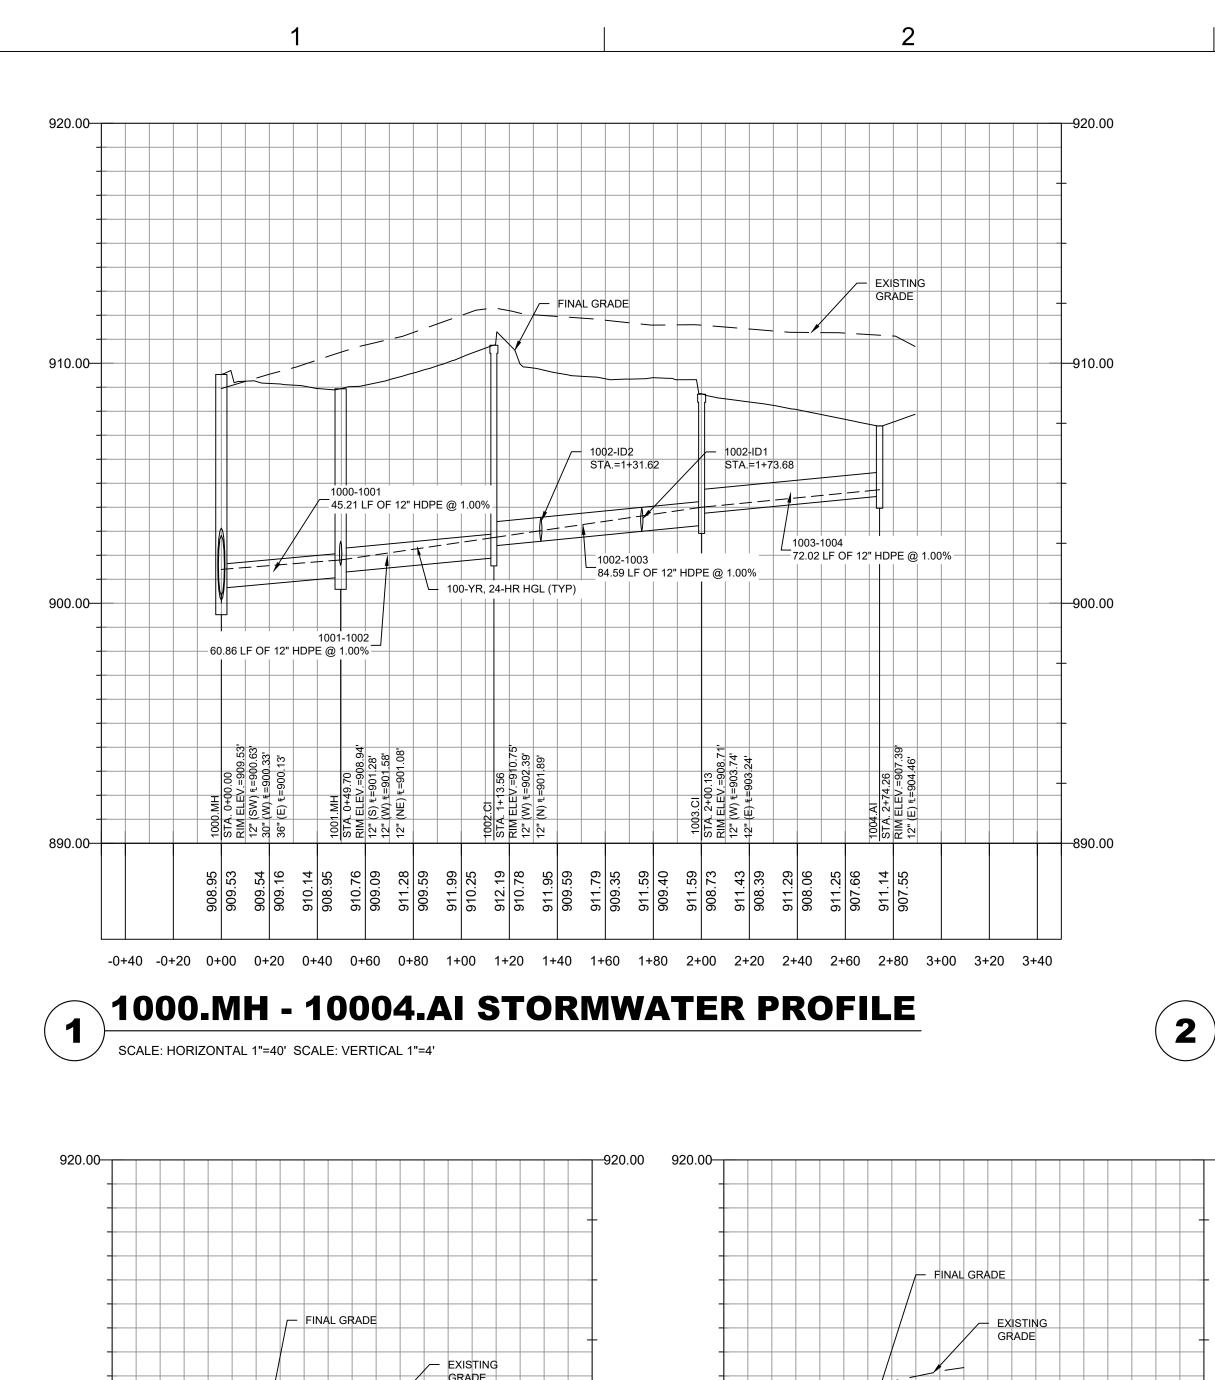
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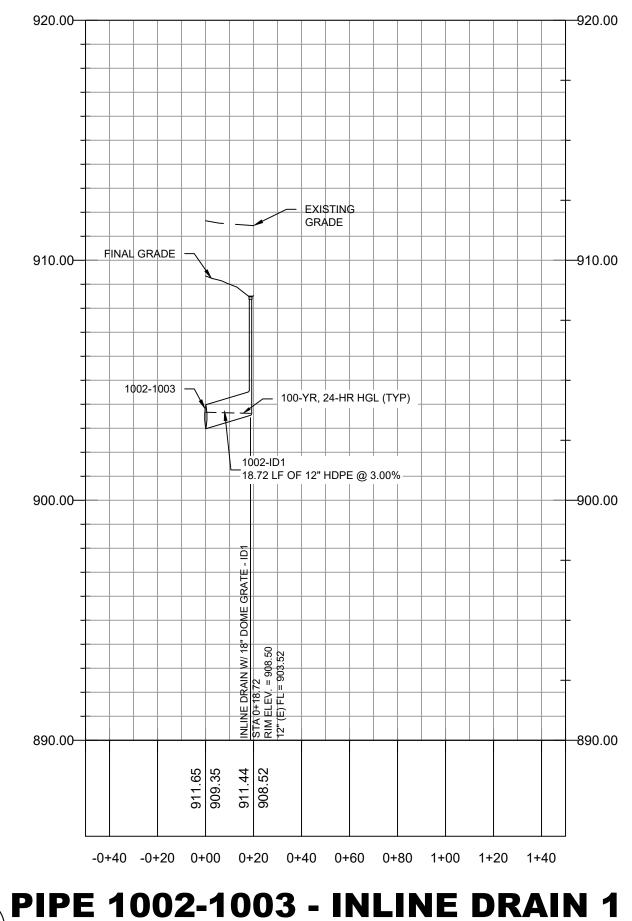
<del>--</del>900.00 900.00<del>--</del>

STA.=0+47.31

35.83 LF OF 12" HDPE @ 3.00%

1005-1006

13.75 LF OF 12" HDPE @ 2.00%



SCALE: HORIZONTAL 1"=40' SCALE: VERTICAL 1"=4'

FINAL GRADE EXISTING 910.00-22.23 LF OF 12" HDPE @ 3.00% 100-YR, 24-HR HGL (TYP) 1002-1003 -0+40 -0+20 0+00 0+20 0+40 0+60 0+80 1+00 1+20 1+40

**PIPE 1002-1003 - INLINE DRAIN 2** 

# **GENERAL NOTES:**

- 1. CONSTRUCTION OF STORMWATER IMPROVEMENTS SHALL BE AS PER CITY OF LEE'S SUMMIT, MO AND PROJECT SPECIFICATIONS.
- 2. THE INFORMATION SHOWN ON THESE PLANS CONCERNING THE TYPE AND LOCATION OF UNDERGROUND UTILITIES IS NOT GUARANTEED TO BE ACCURATE OR ALL INCLUSIVE. THE CONTRACTOR IS RESPONSIBLE FOR CONTACTING ALL UTILITY COMPANIES FOR FIELD LOCATION OF ALL UNDERGROUND UTILITY LINES PRIOR TO ANY EXCAVATION AND FOR MAKING HIS OWN VERIFICATION AS TO TYPE AND LOCATION OF UNDERGROUND UTILITIES AS MAY BE NECESSARY TO AVOID DAMAGE THERETO.
- PROTECT ALL COMPONENTS DURING DEMOLITION / CONSTRUCTION PROCESS. MAINTAIN BMP'S THROUGHOUT THE DURATION OF CONSTRUCTION.
- 4. CONTRACTOR TO PROVIDE DETAILED AS-BUILT DRAWINGS TO OWNER, ENGINEER, AND CITY OF LEE'S SUMMIT, MO UPON COMPLETION OF ALL IMPROVEMENTS.

9229 WARD PARKWAY SUITE # 210 KANSAS CITY, MO 64114 TEL: (816) 444-4200 FAX: (316) 265-5646 www.glmv.com

GLMV ARCHITECTURE, INC. MISSOURI STATE CERTIFICATE OF AUTHORITY

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TEL: (816) 444-4200 STRUCTURAL ENGINEER LEIGH + O'KANE MISSOURI COA #001644

250 NE MURBERRY, SUITE 201 LEE'S SUMMIT, MO, 64086 (816) 444-3144 PHONE

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SHAWNEE, KS 66217 (913) 362-9090 PHONE SECURITY & IT ENGINEERS HENDERSON ENGINEERS MISSOURI COA # 000556

1801 MAIN STREET, SUITE 300 KANSAS CITY, MO 64108 (816) 663-8700 PHONE

FIRE STATIC 5031 I LEE'S

REVISIONS:

ASI 03 12.08.2022 ASI 07 04.25.2023

DERICK M. HOLMES NUMBER PE-2022005196 / 🗢

DERICK HOLMES - CIVIL ENGINEER MO# PE-2022005196

PROJECT NO:	18225R21001
DATE:	10.19.2022
DRAWN BY:	HFL
CHK'D BY:	DMH


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**STORMWATER PROFILES** 

100-YR, 24-HR STORM EVENT PEAK TIME OF PEAK FLOW MAX FLOW FLOW OCCURRENCE VELOCITY OUTLET INVERT INLET INVERT MANNING'S TRAVEL DESIGN FLOW MAX FLOW | MAX FLOW DEPTH LENGTH SLOPE MAX FLOW / DESIGN DIAMETER TIME **ELEVATION ELEVATION** ROUGHNESS CAPACITY DEPTH PIPE NAME OWNSTREAM NODE TOTAL DEPTH NODE (FT) (%) LOSSES LOSSES FLOW RATIO (INCHES) (CFS) (FT) (FT/SEC) RATIO (FT) (FT) 0.012 0.50 0.50 1000-1001 1001.MH 1000.MH 45.21 901.08 900.63 1.00 0.50 0.80 0 12:05 4.89 0.15 3.85 1002.CI 60.86 901.89 901.28 1.00 0.012 0.50 0.90 0.24 3.86 0.35 0.35 1001-1002 1001.MH 901.58 3.75 0.012 0.90 0.08 0.23 1001-1005 1005.AI 1001.MH 28.61 902.65 0.50 6.34 7.46 0.12 0.23 1002-1003 1003.CI 1002.CI 84.59 903.24 902.39 1.00 0.012 0.70 0.17 3.91 0.35 0.35 1002-ID1 WYE 18.72 903.52 902.98 3.00 0.70 0.09 0.11 0.08 0.08 WYE 22.23 903.22 902.56 3.00 0.70 0.22 0.03 0.03 1004.AI 72.02 903.74 1.00 0.60 0.33 0.27 1005.AI 13.75 903.42 903.15 2.00 0.012 0.50 0.80 0.25 0.07 5.41 0.05 0.15 0.15 1005-1006 1006.AI 12 0 12:05 3.52 3.00 1005-1009 1005.AI 35.83 904.32 903.25 0.012 0.50 0.80 0.47 4.92 0.12 0.18 0.18 1009.AI 1006-ID3 28.17 903.62 2.00 0.012 0.50 2.50 0.08 0.08 ID3 1006.AI 904.18 0.50 0.08 0 12:05 0.19 5.44

SCALE: HORIZONTAL 1"=40' SCALE: VERTICAL 1"=4'



# 1001.MH - 1009.AI

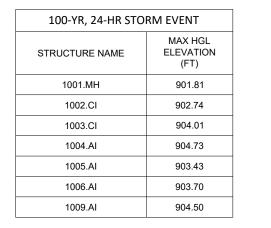SCALE: HORIZONTAL 1"=40' SCALE: VERTICAL 1"=4'

910.46 908.94 910.43 908.41 910.17

-0+40 -0+20 0+00 0+20 0+40 0+60 0+80 1+00 1+20 1+40

28.61 LF OF 12" HDPE @ 3.75%


**1005.AI - INLINE DRAIN 3** SCALE: HORIZONTAL 1"=40' SCALE: VERTICAL 1"=4'


-0+40 -0+20 0+00 0+20 0+40 0+60 0+80 1+00 1+20 1+40


28.17 LF OF 12" HDPE @ 2.00%


100-YR, 24-HR HGL (TYP)


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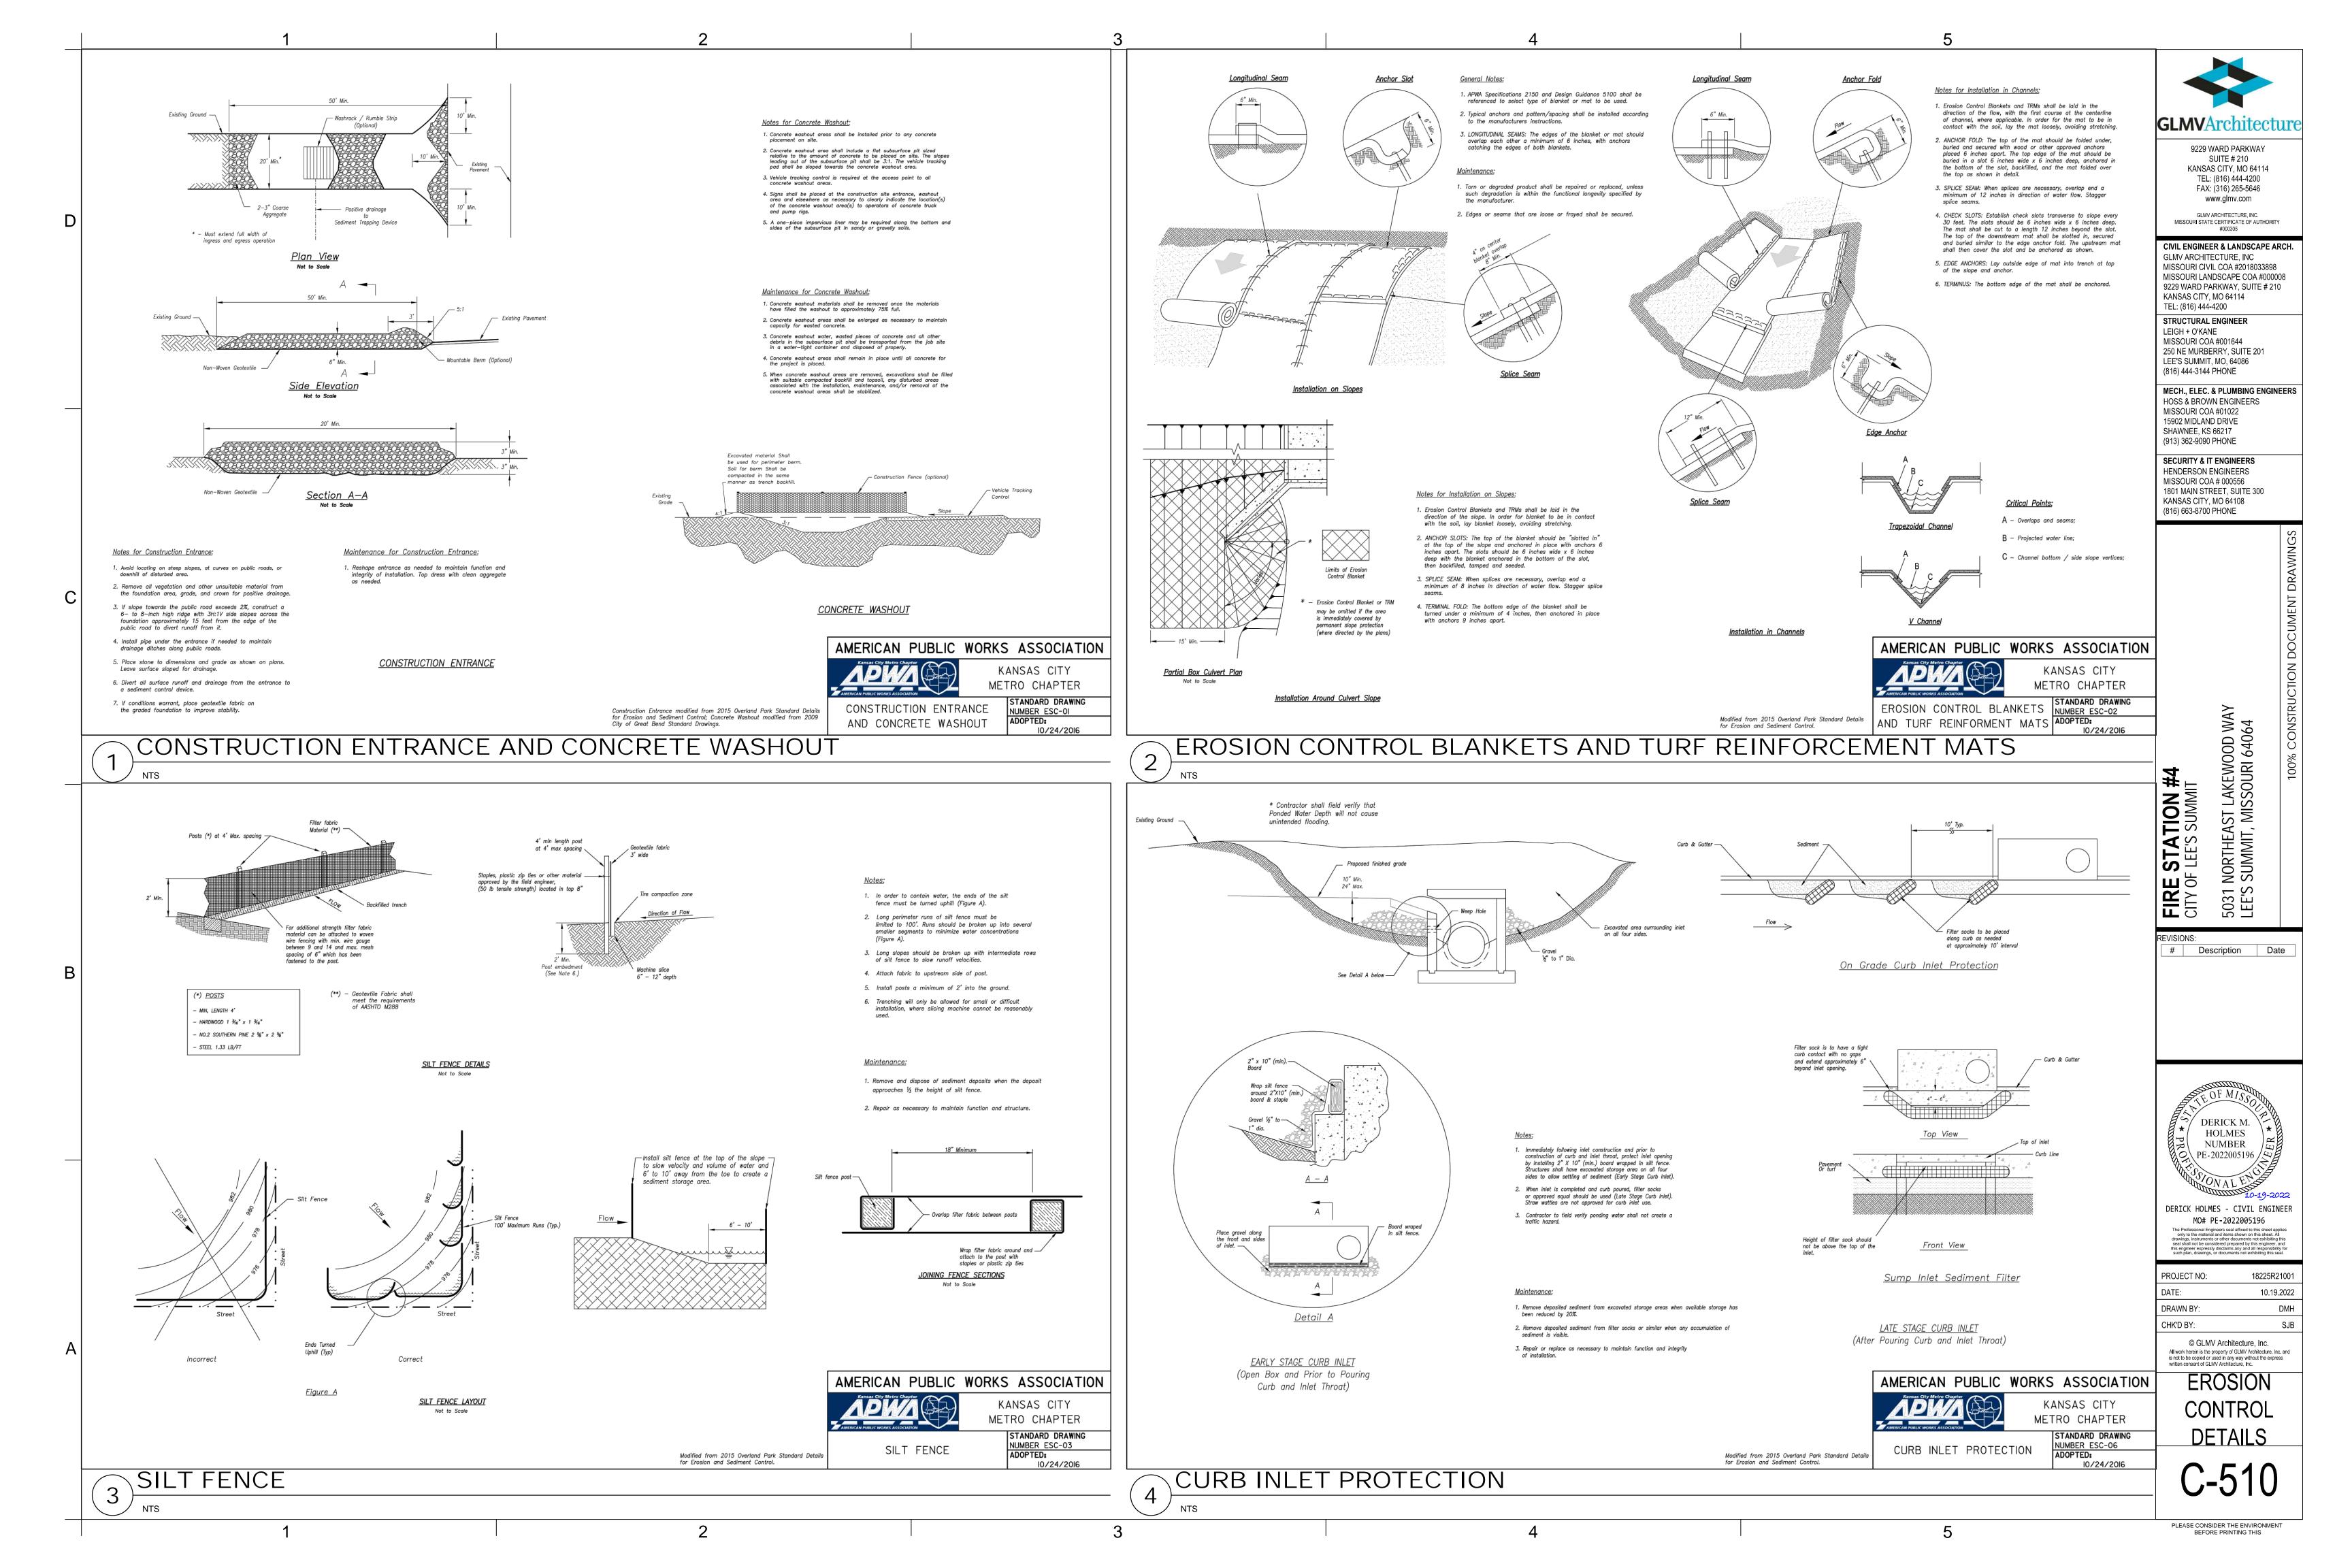


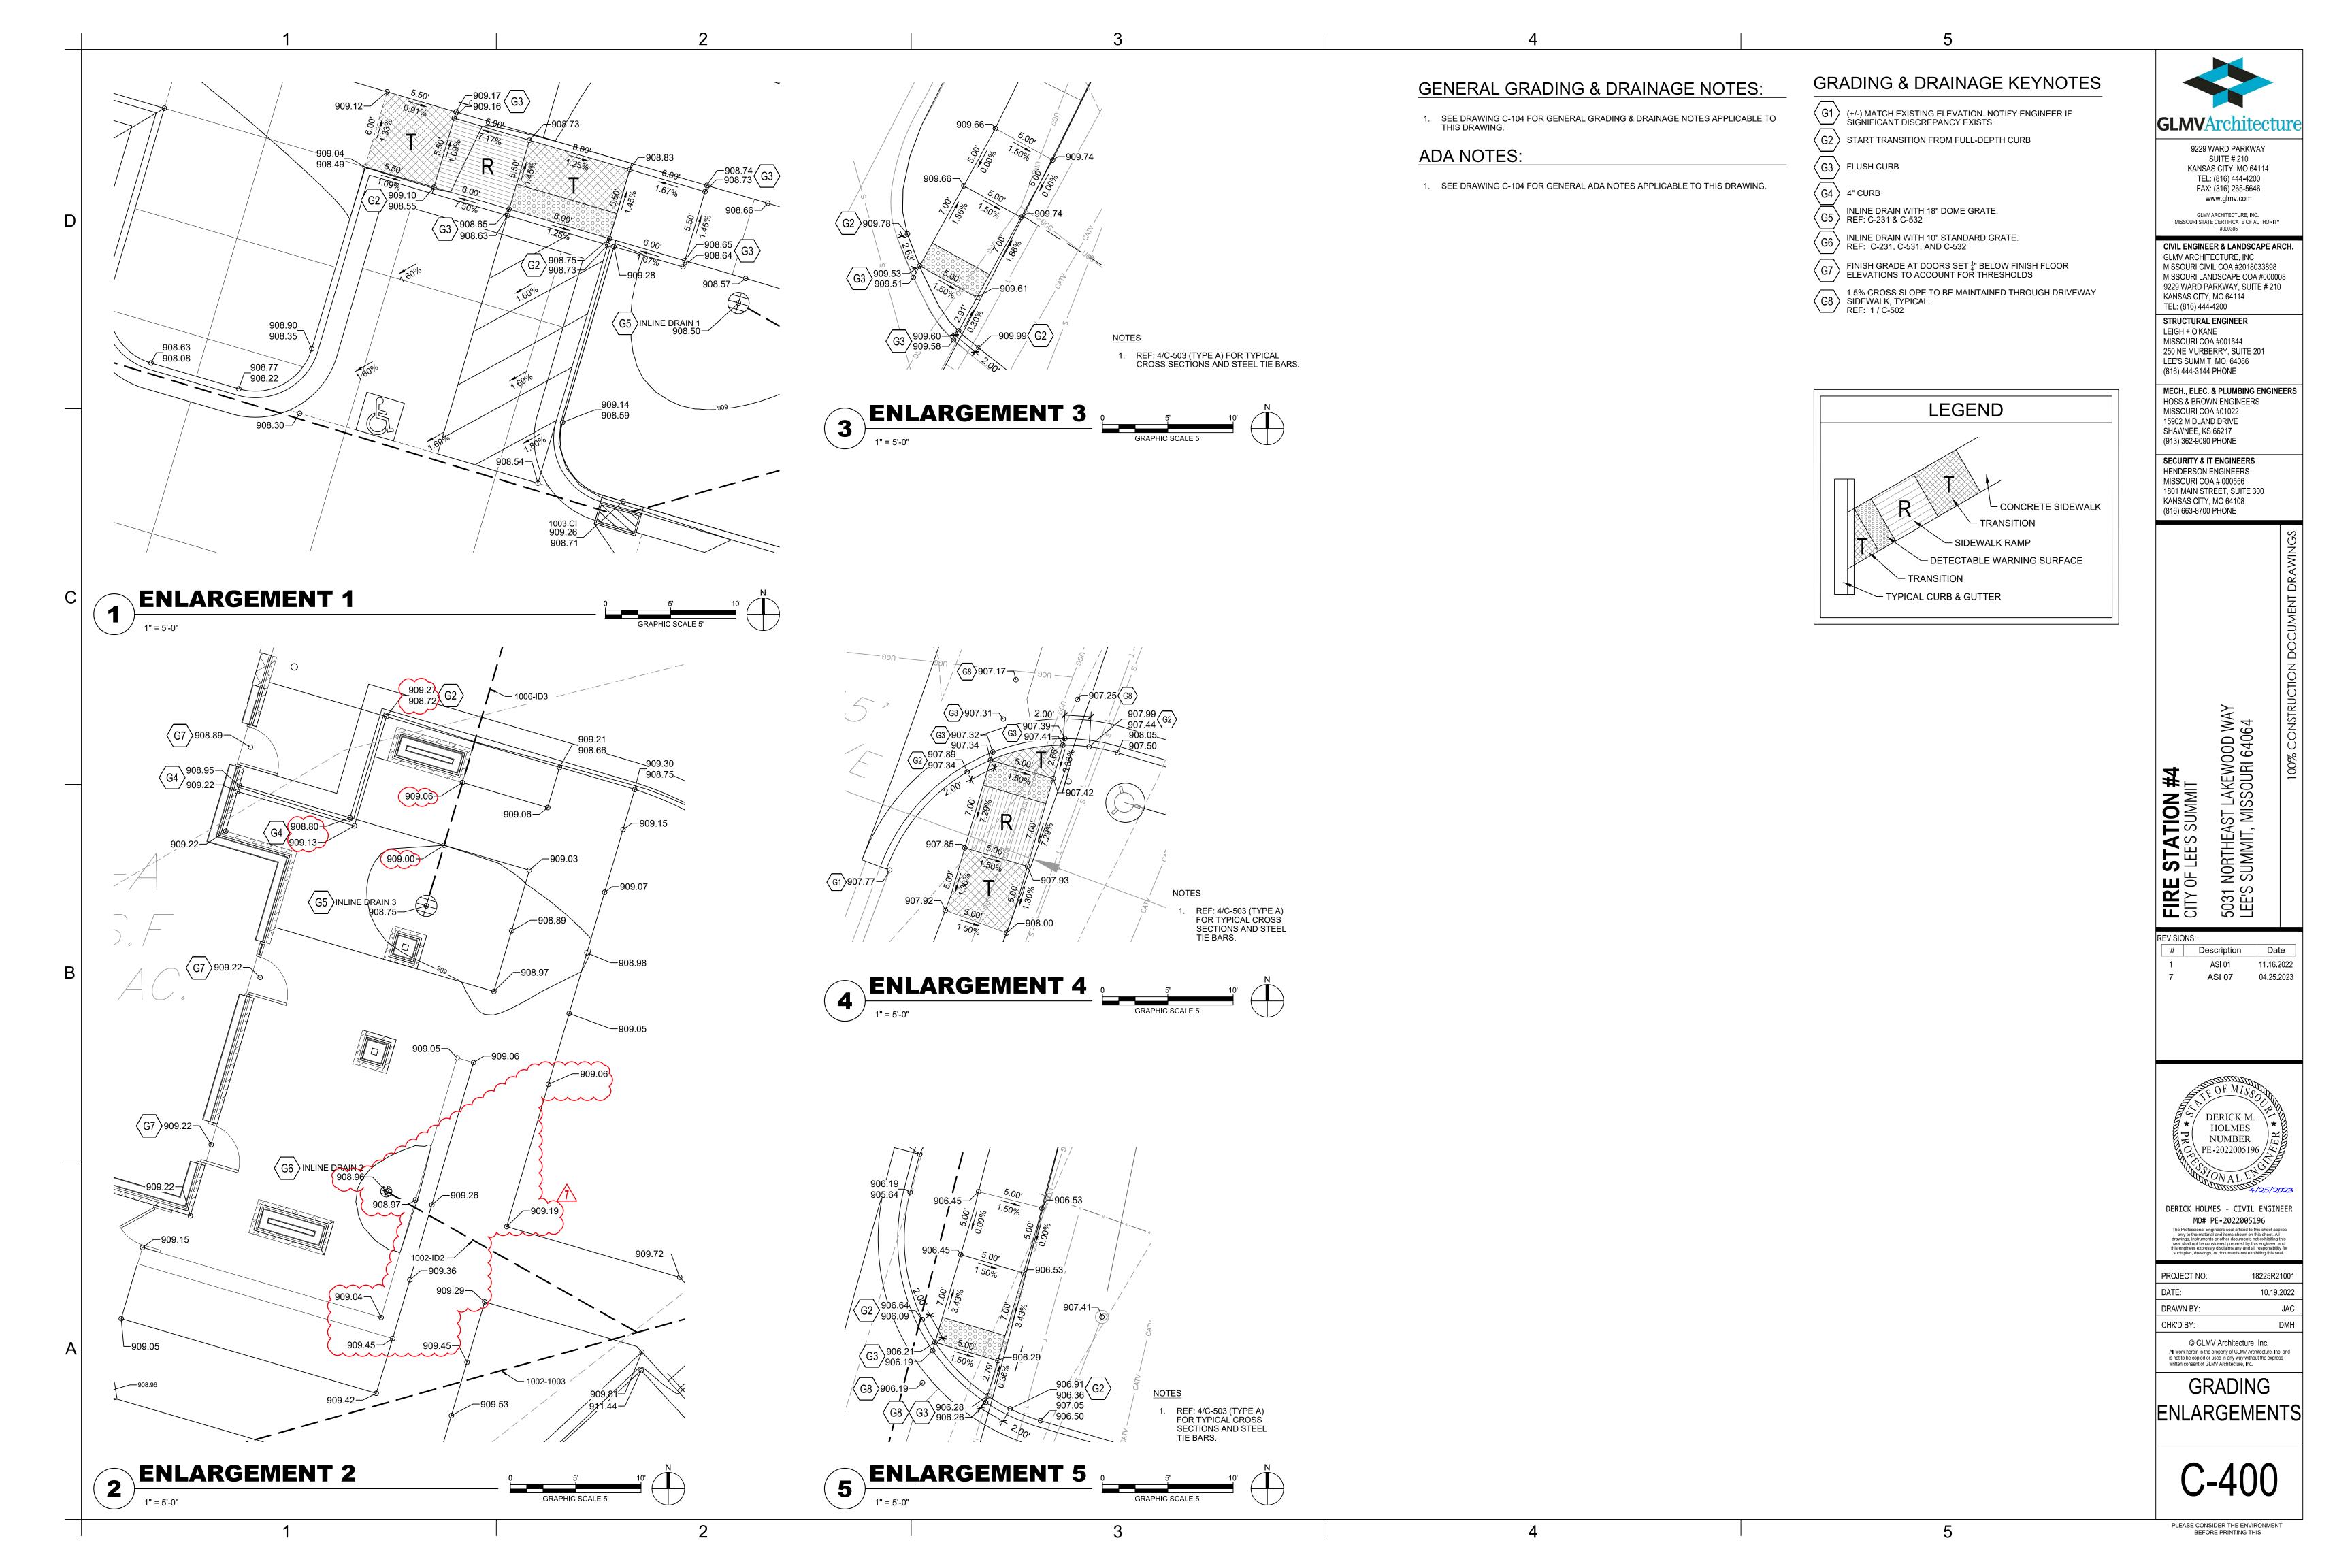


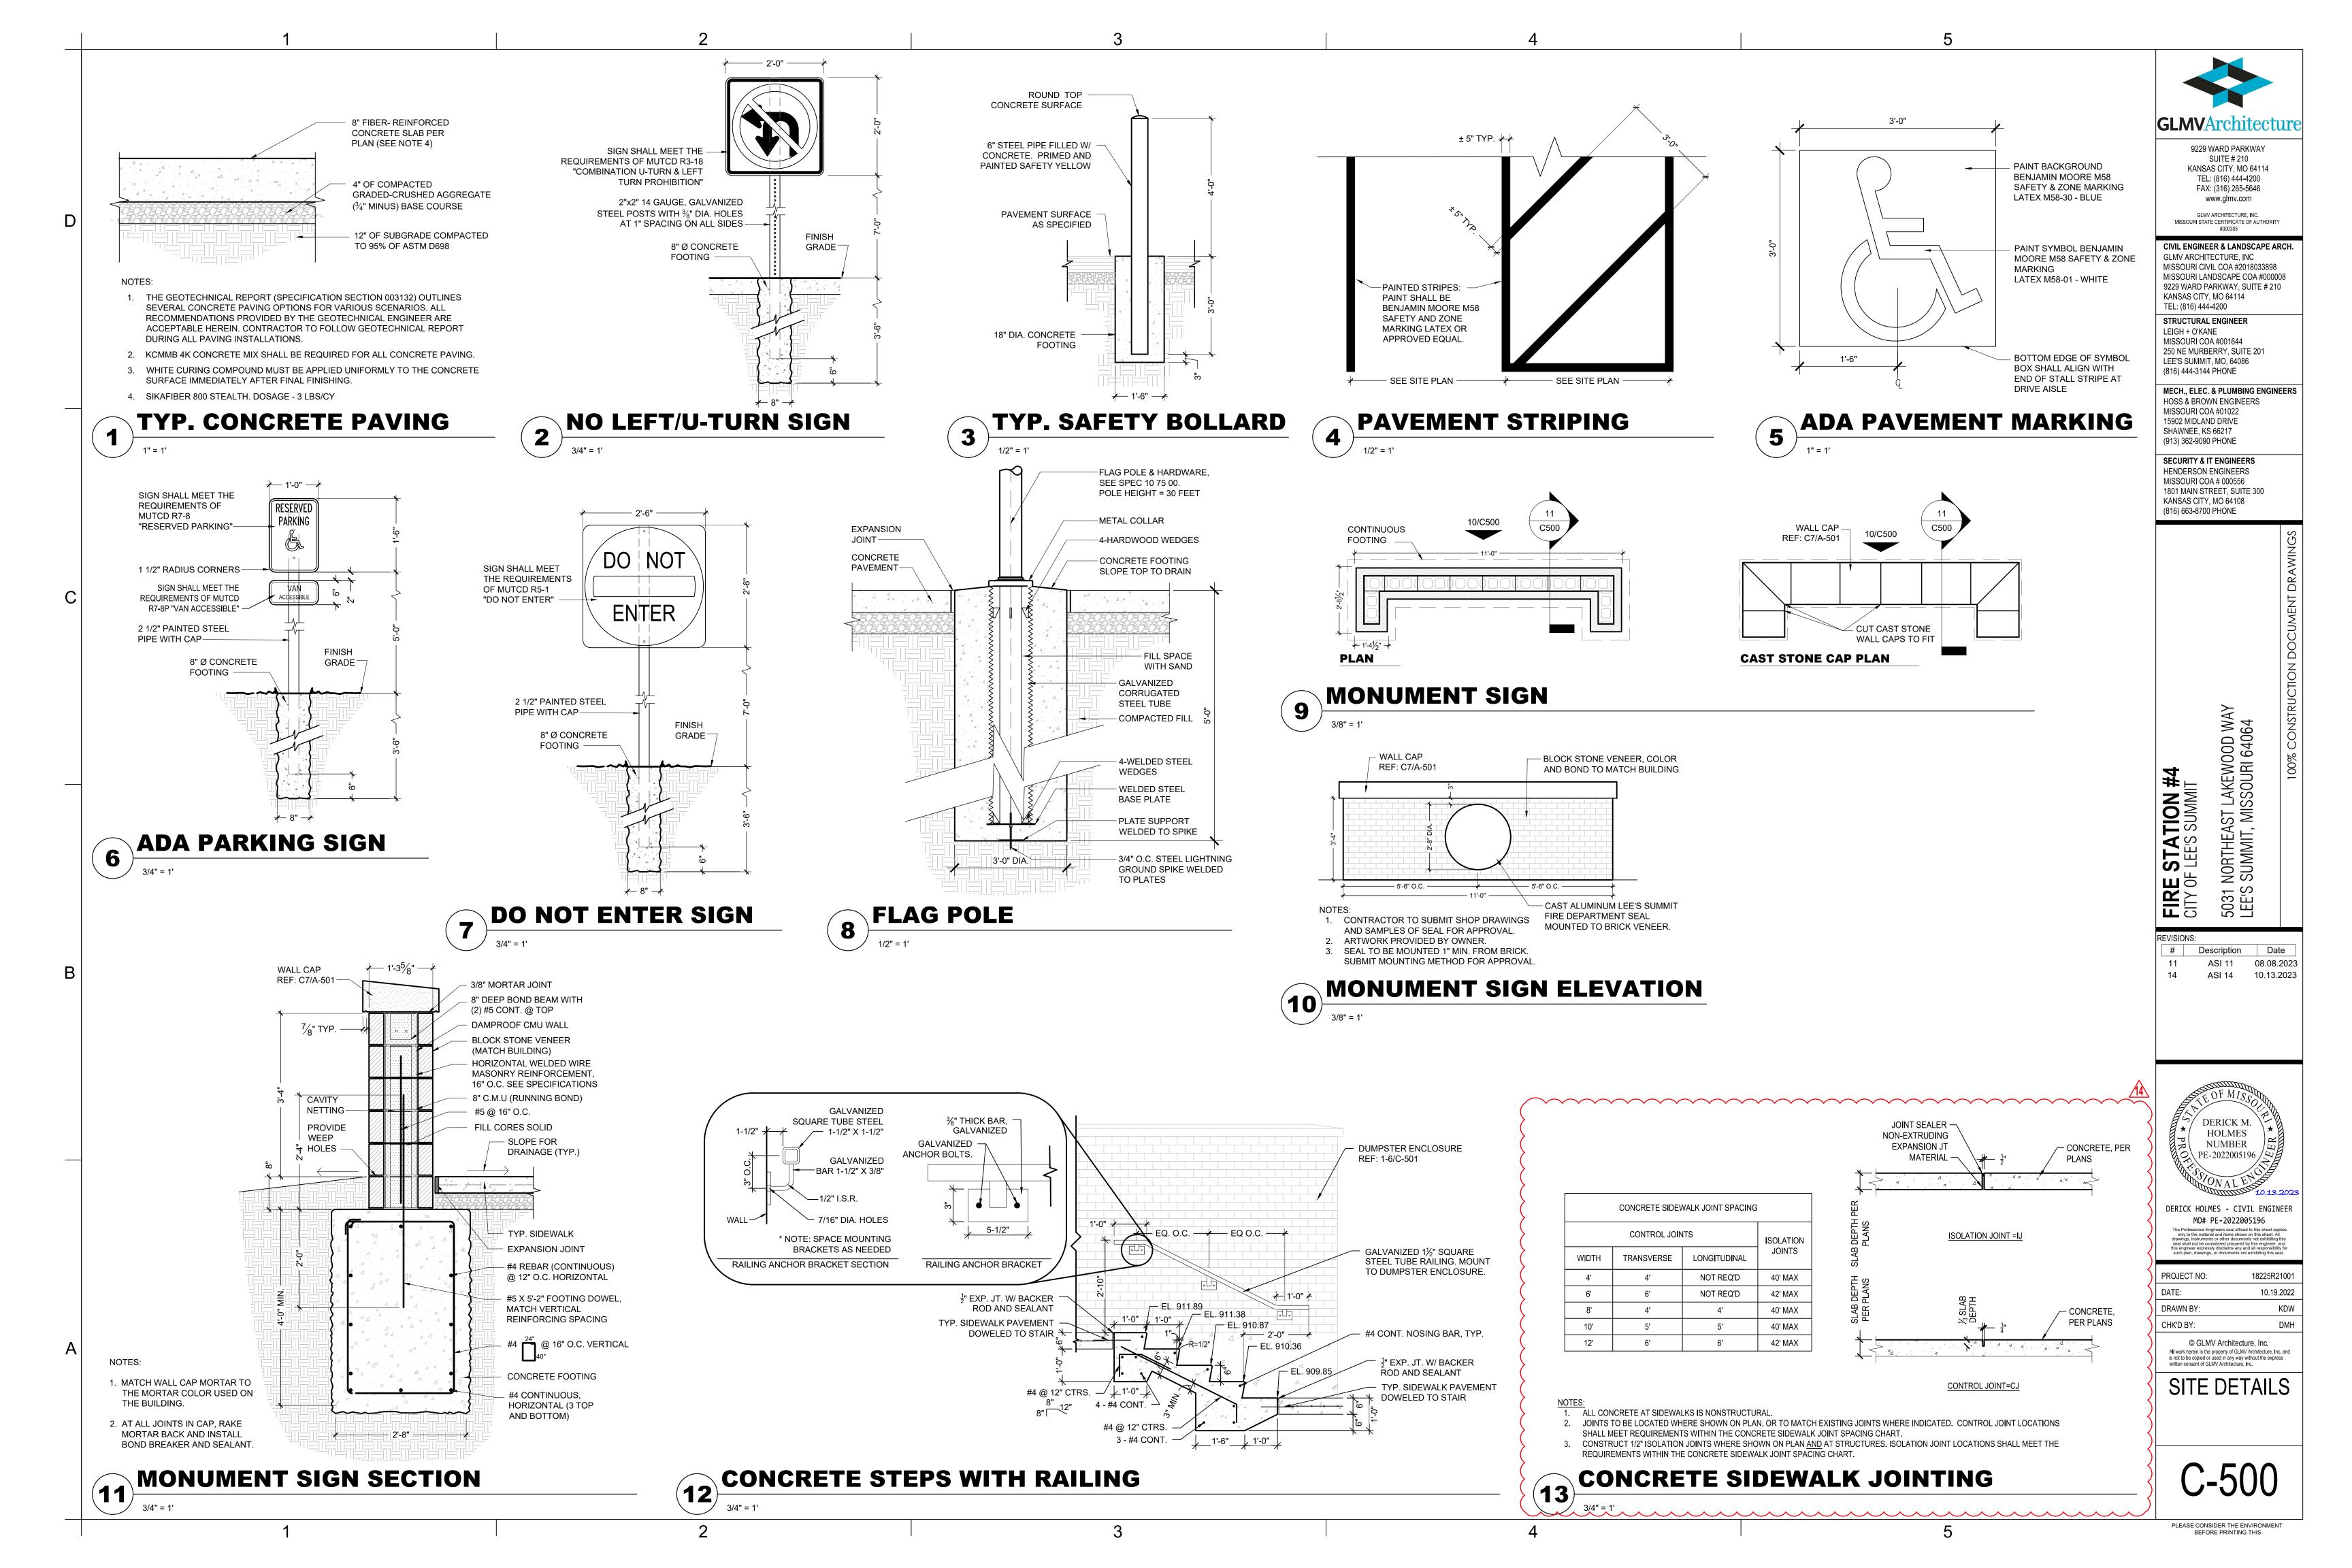

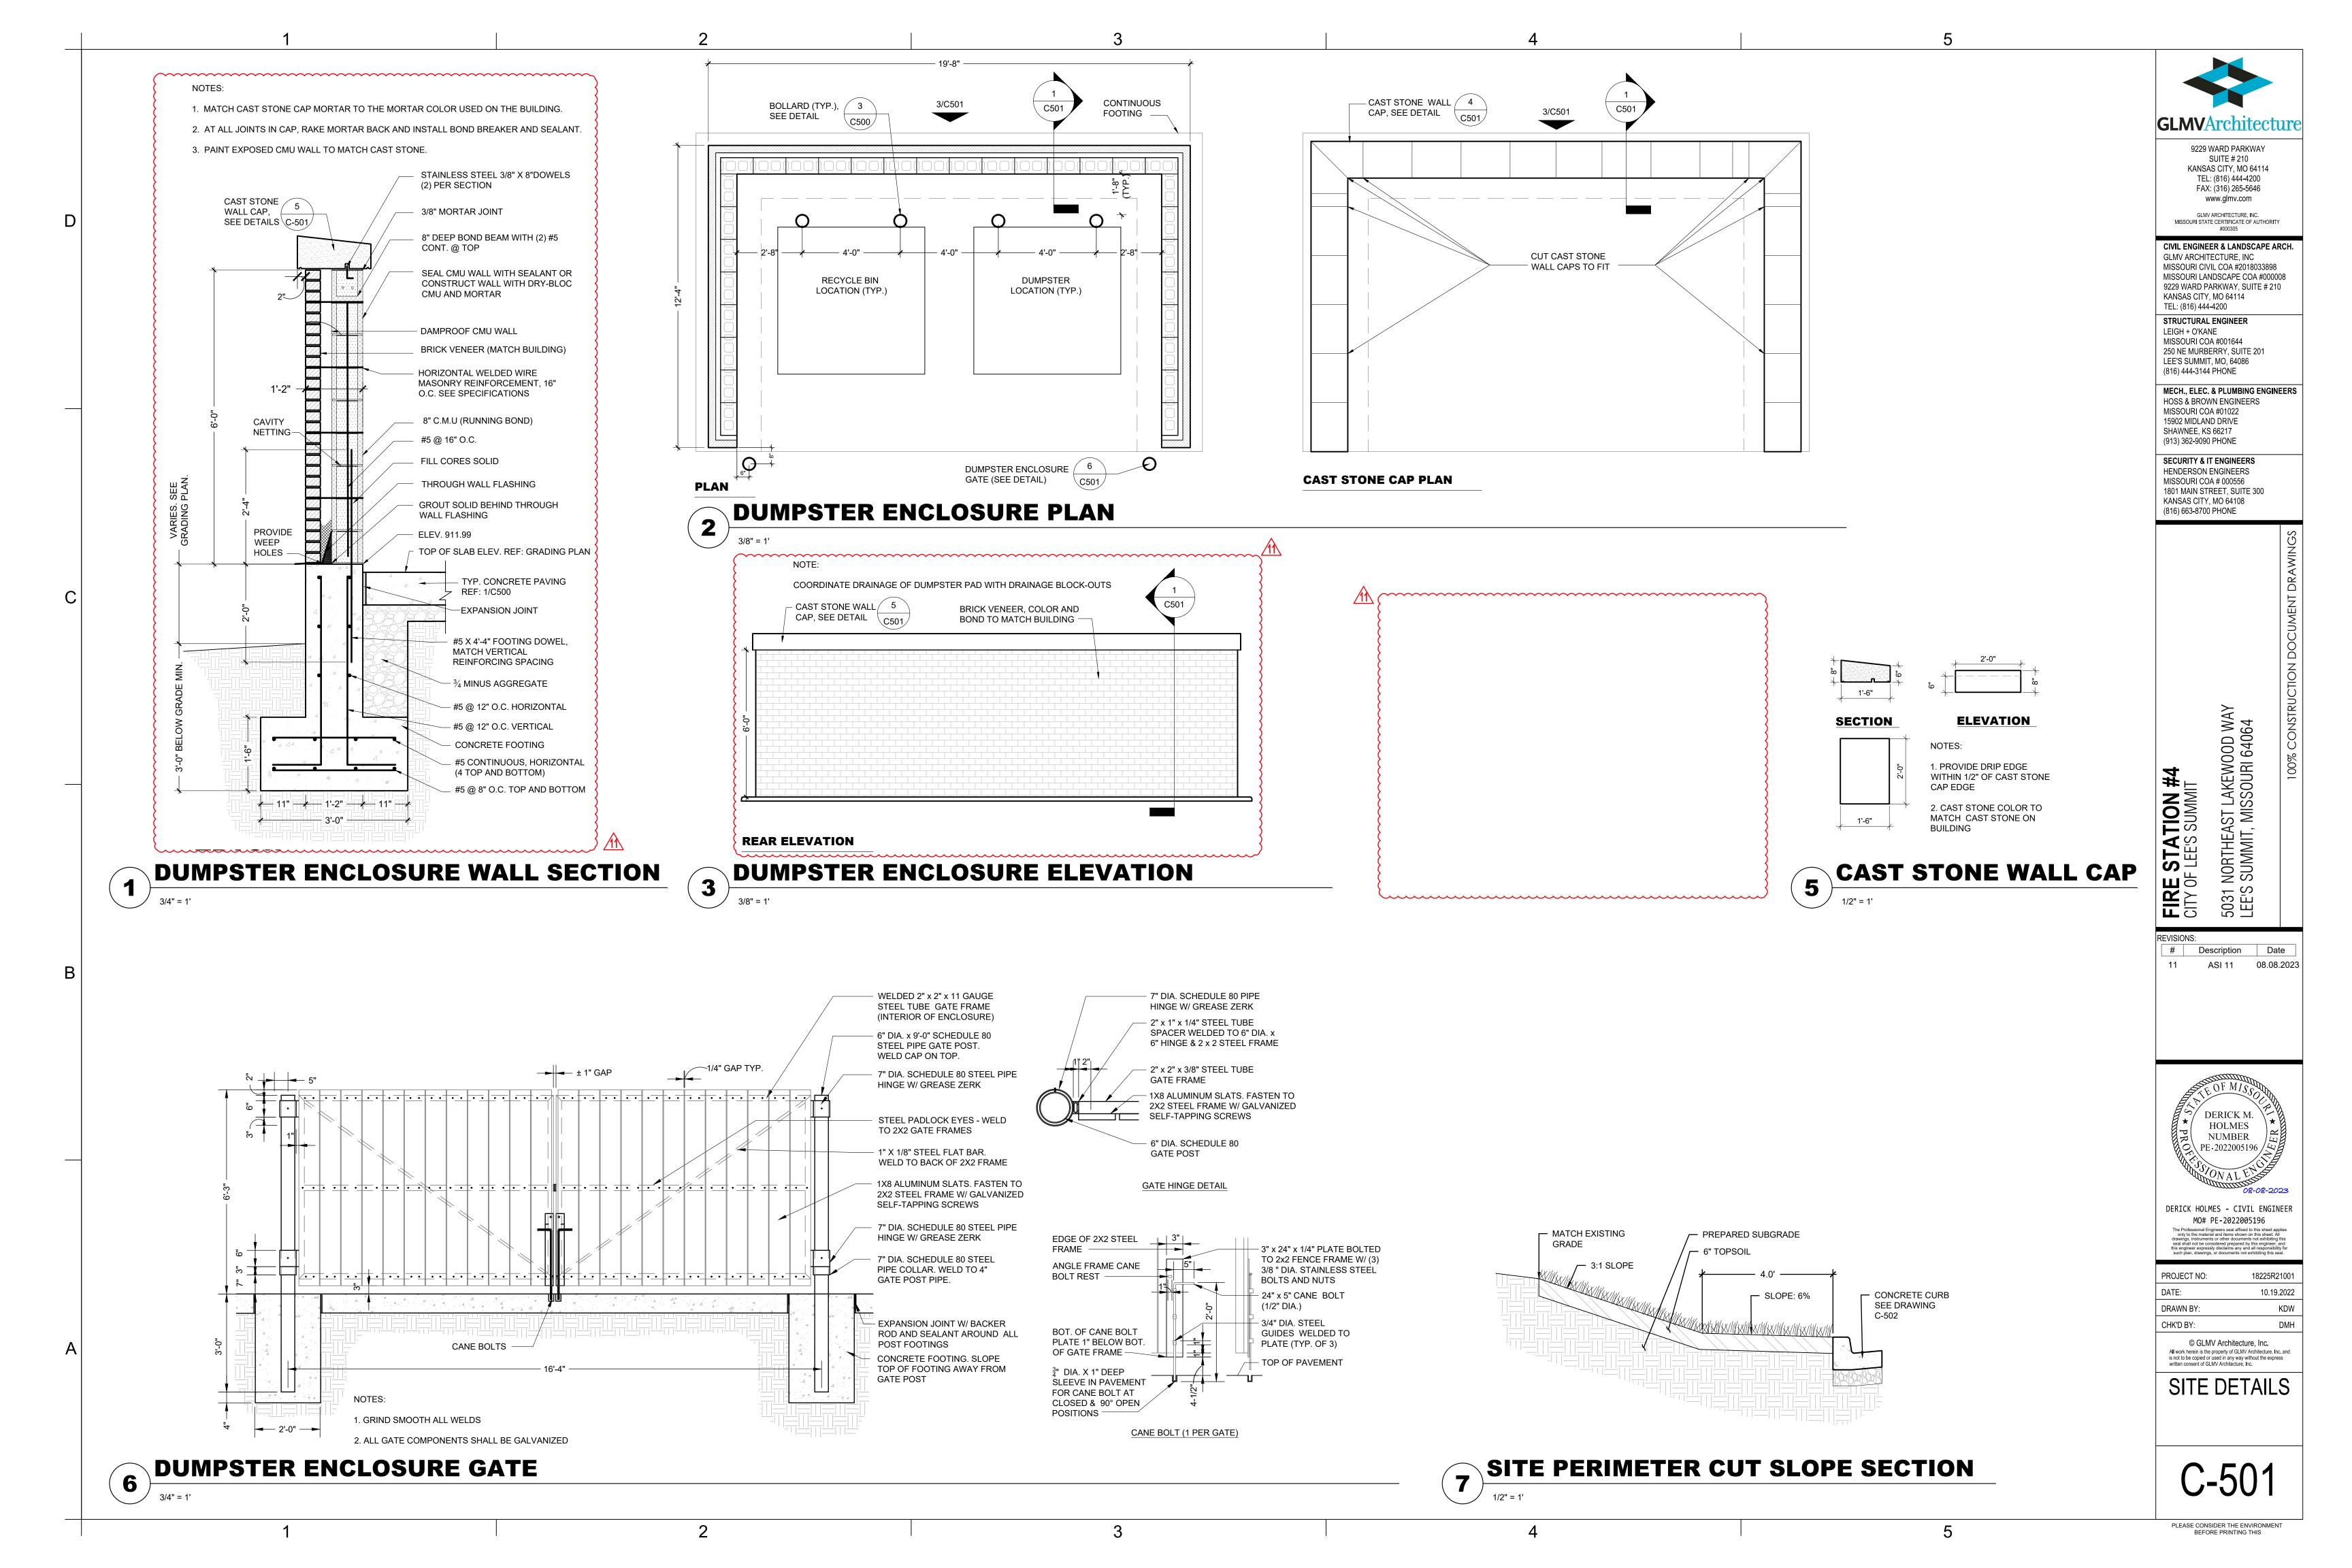

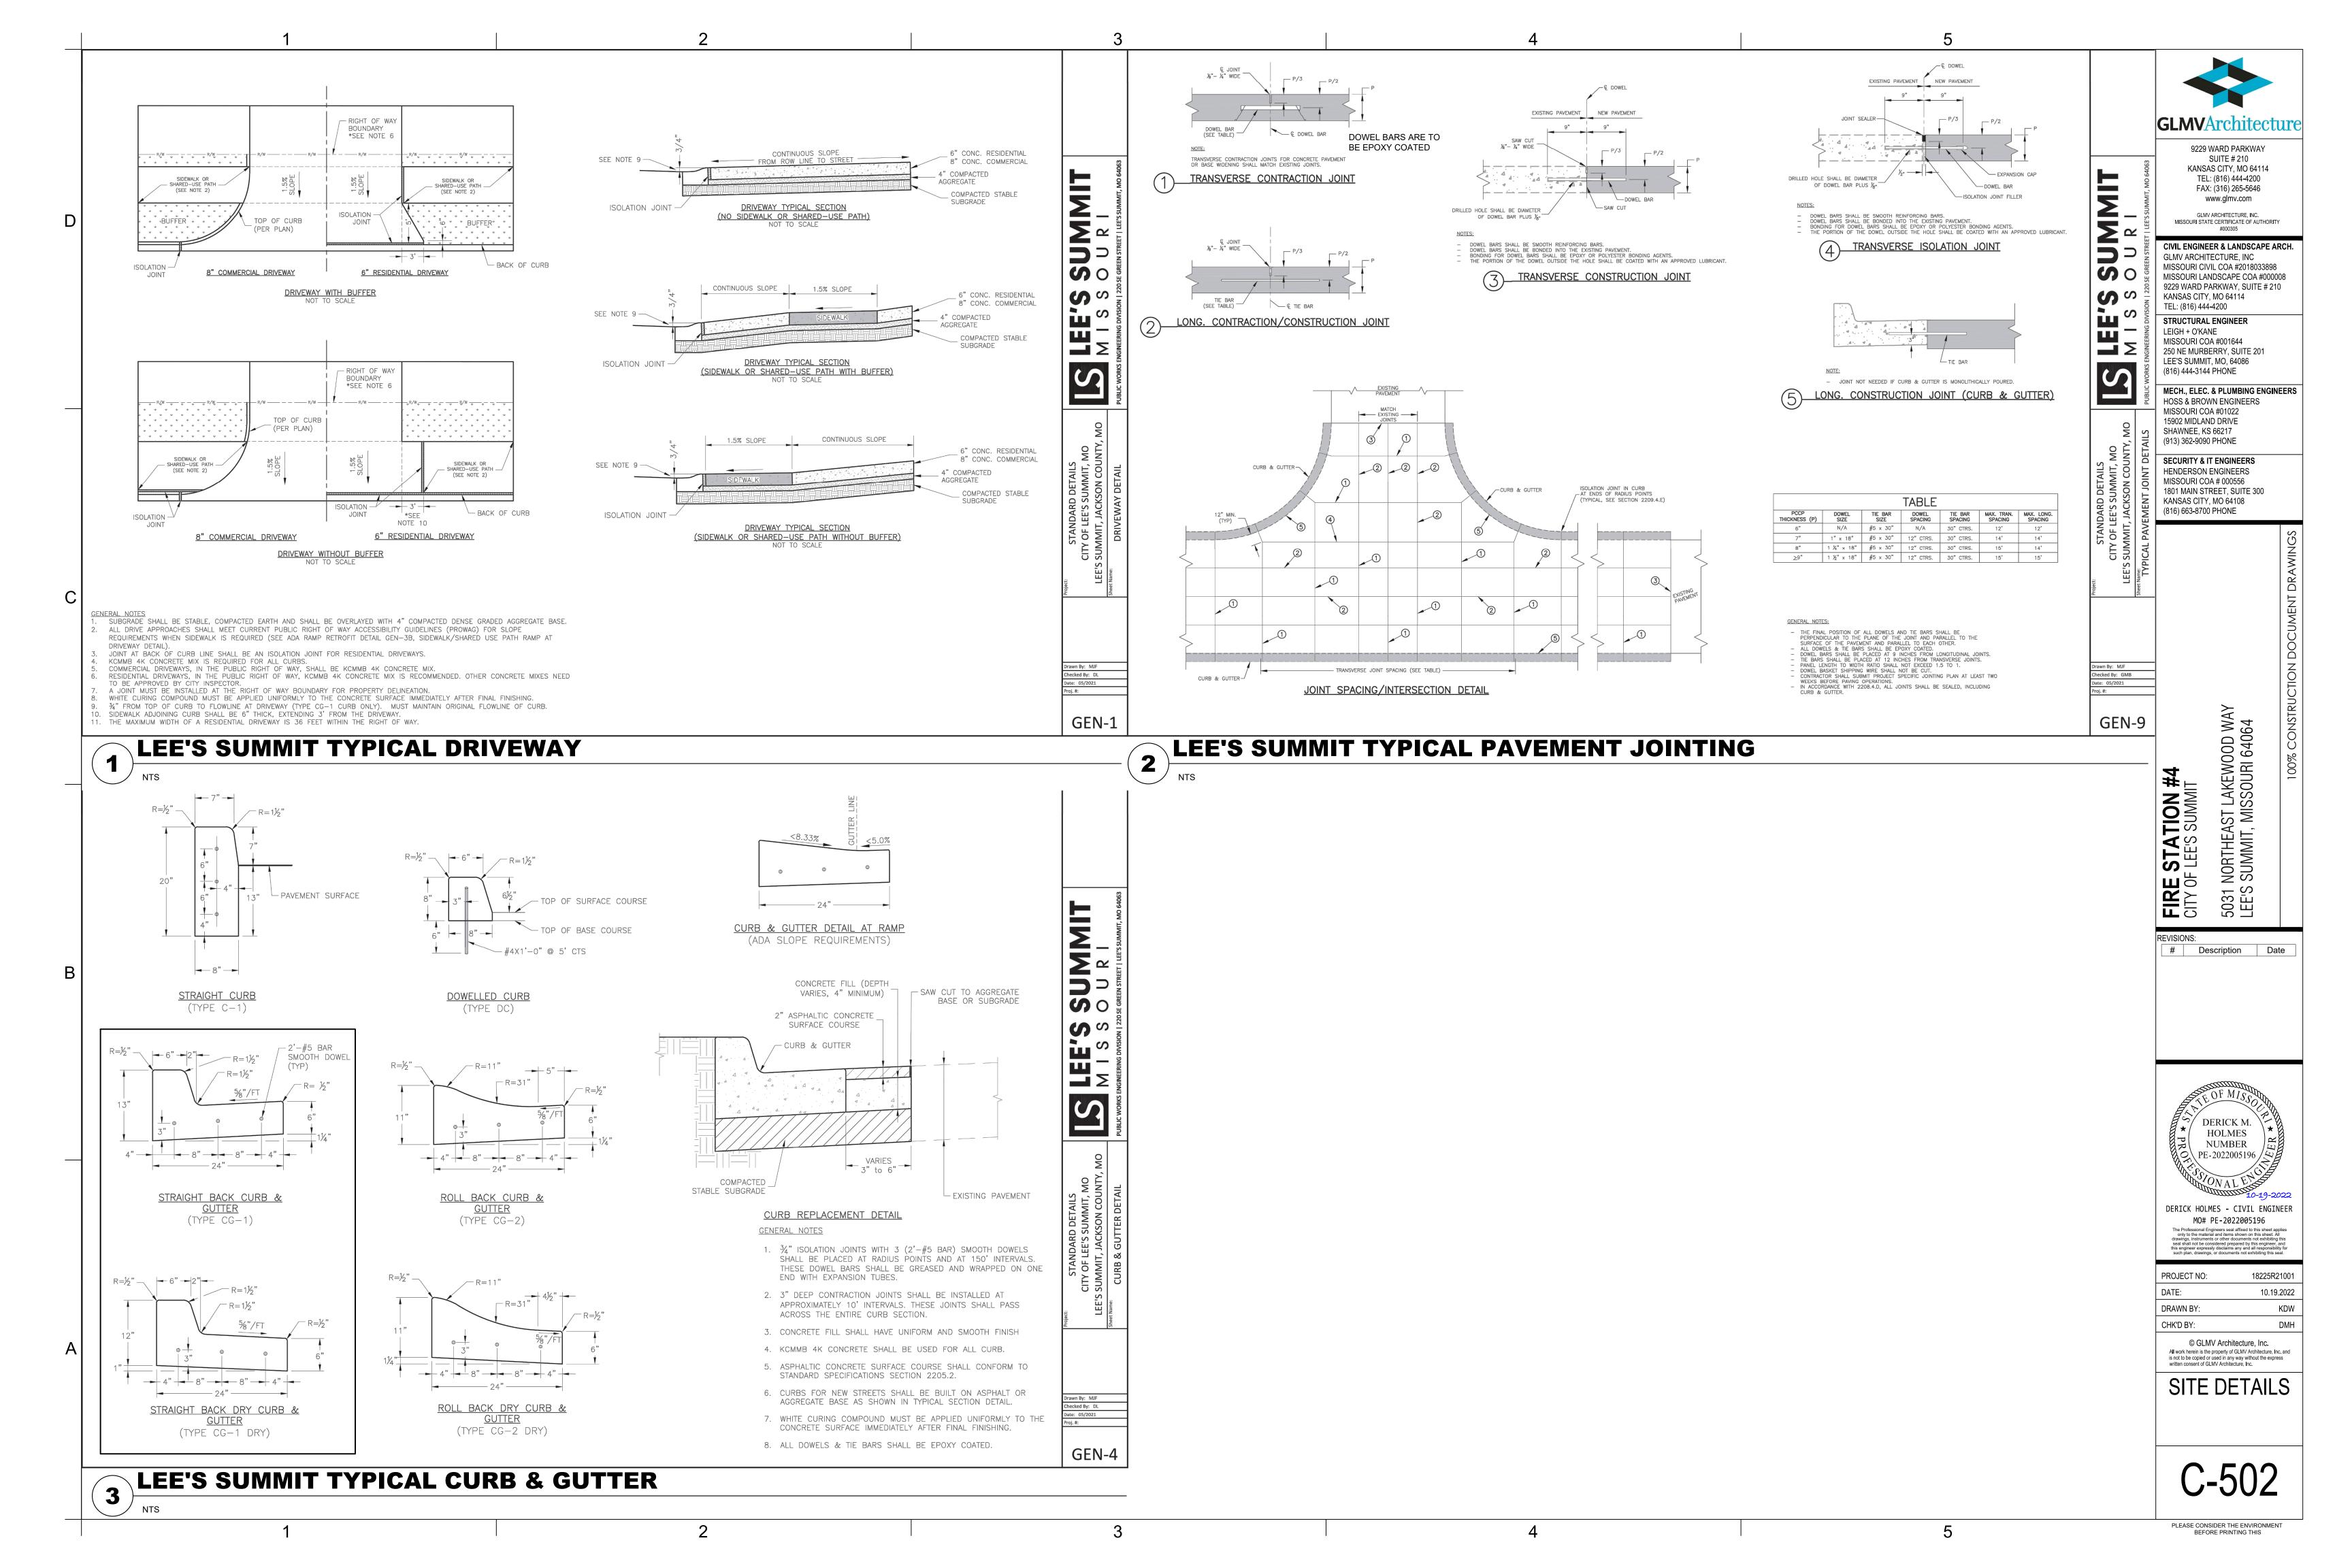

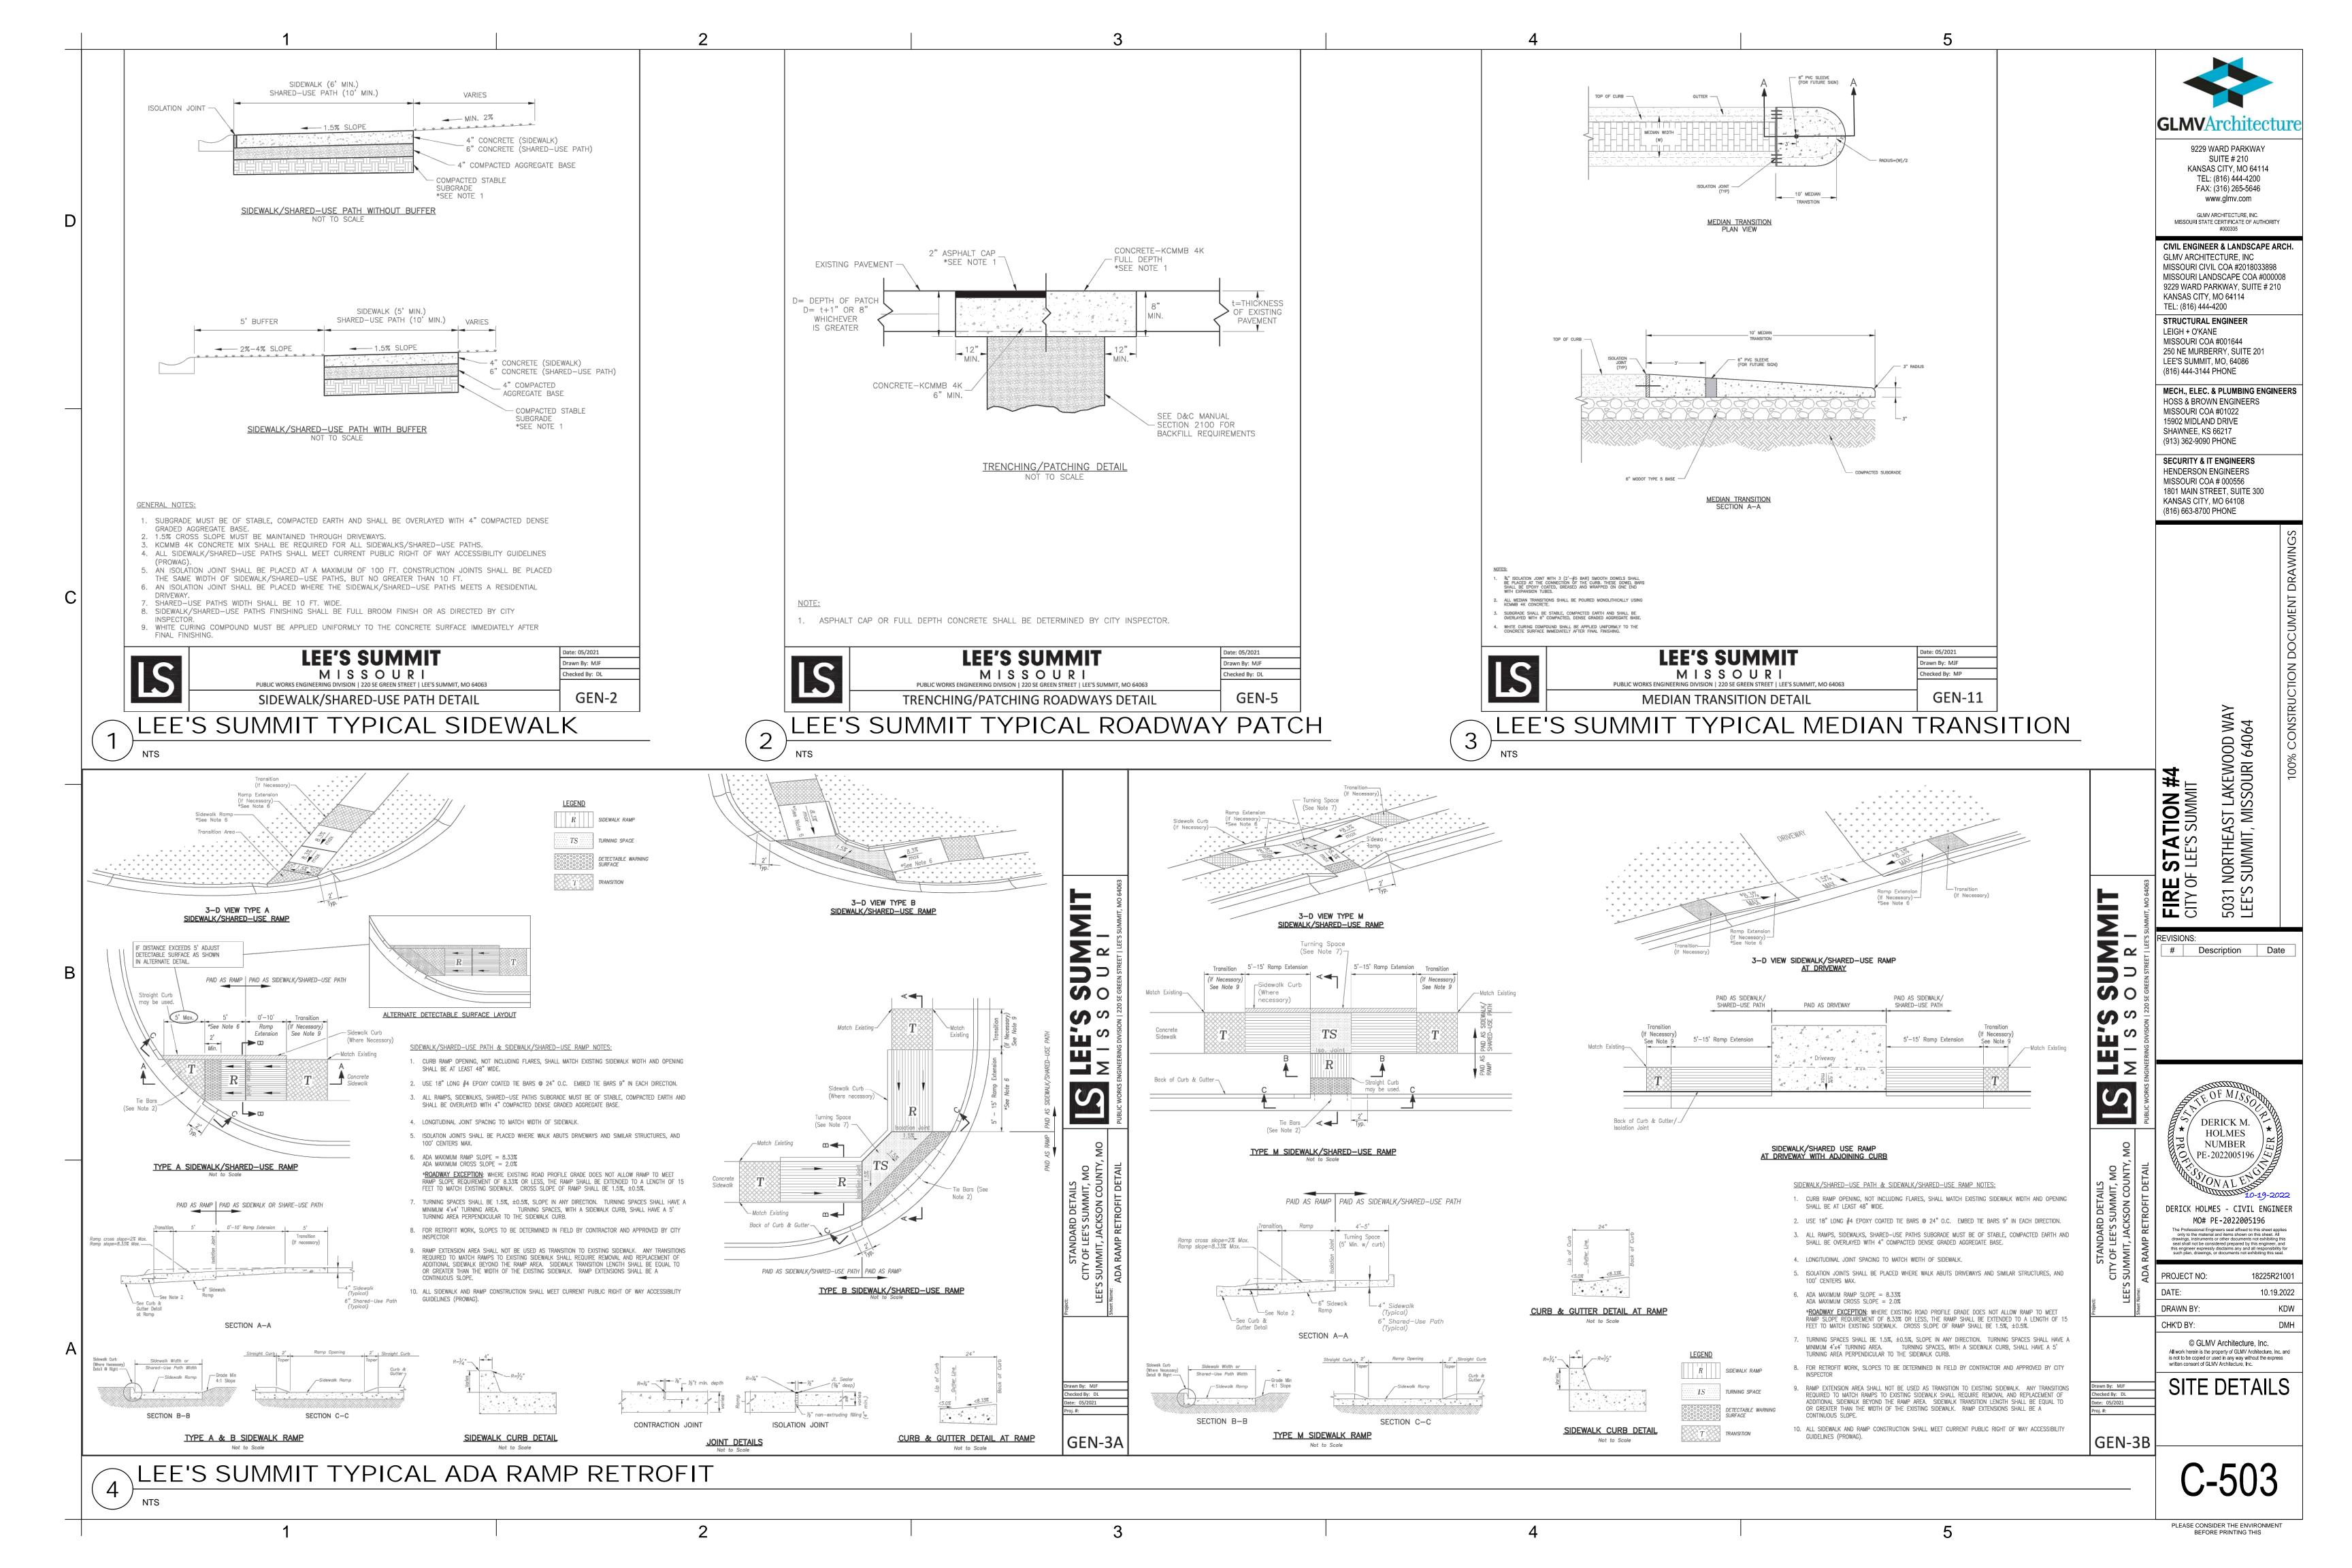

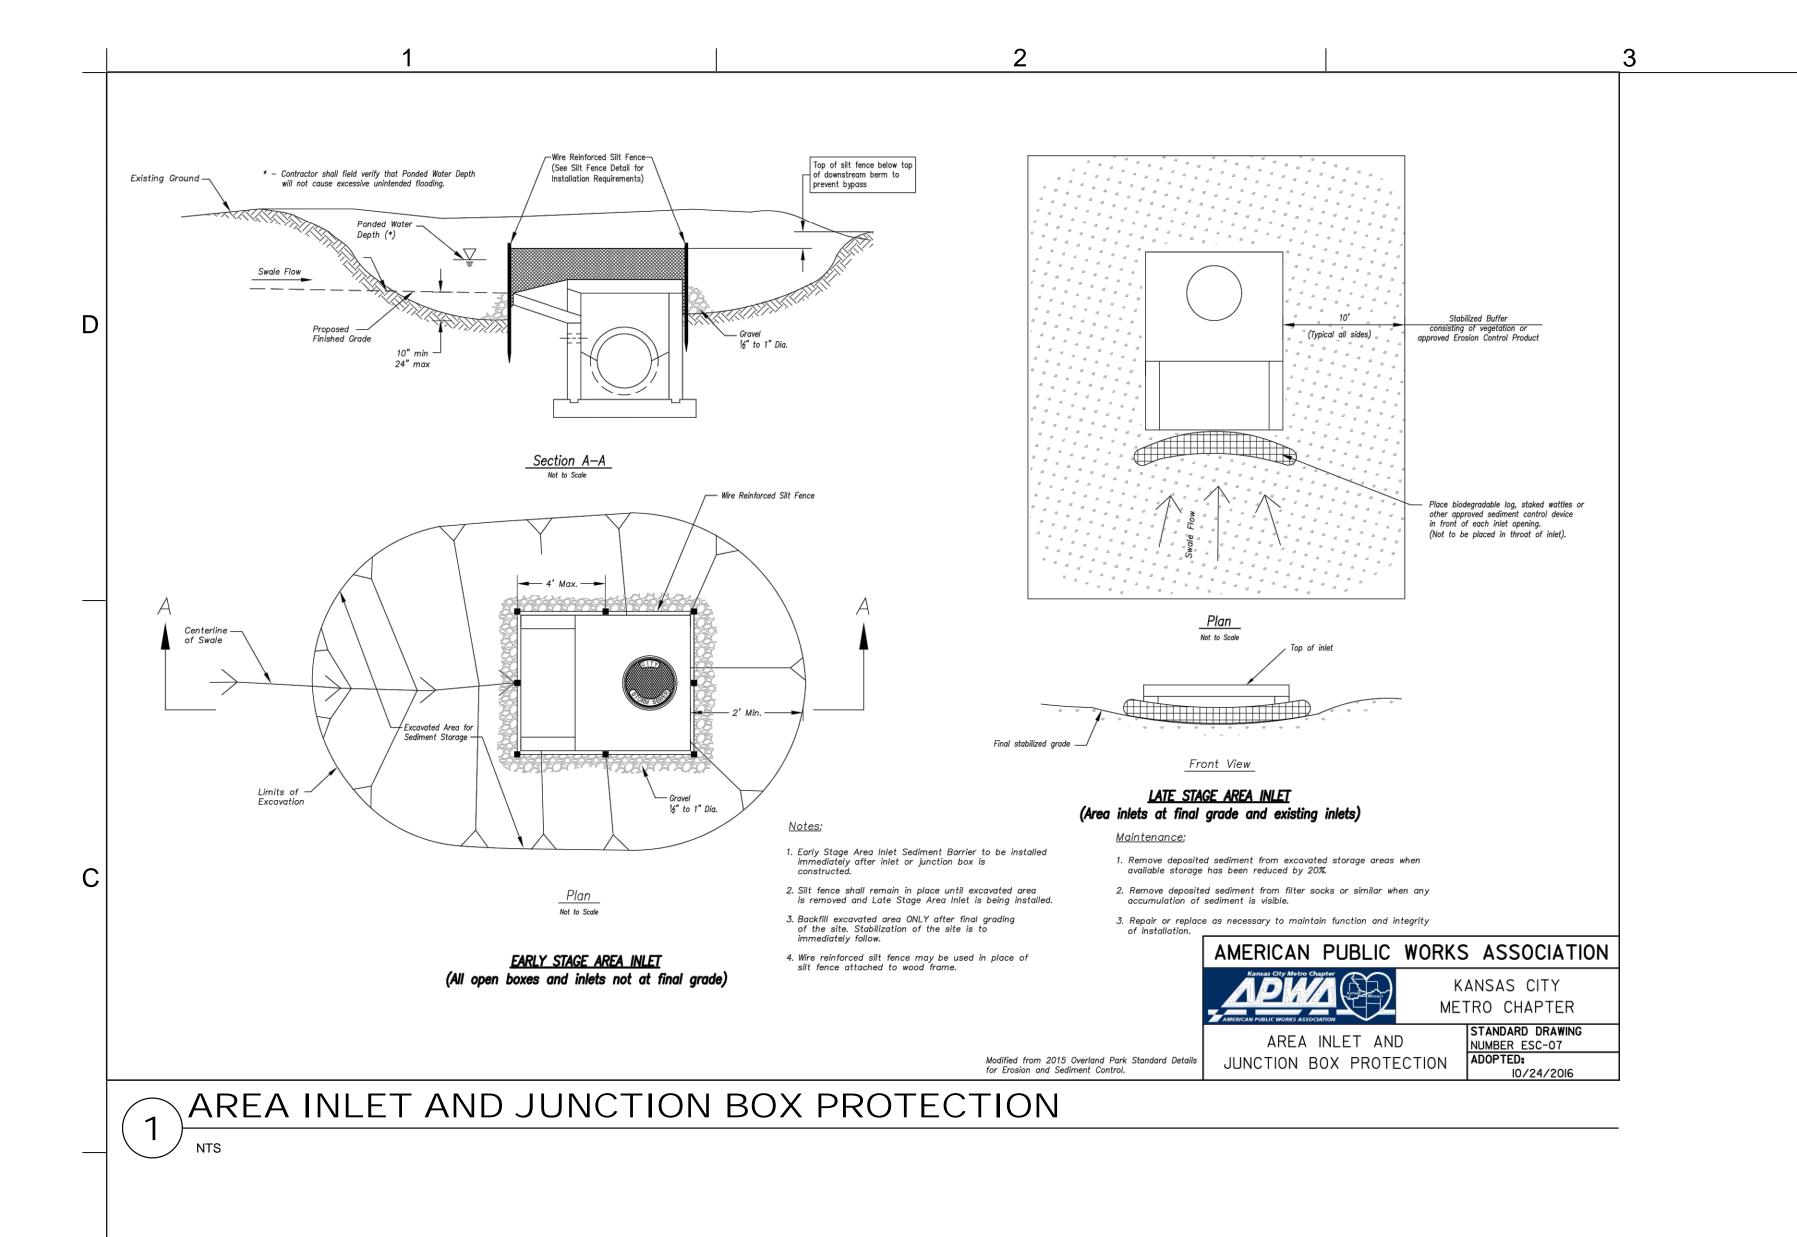

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GLMV ARCHITECTURE, INC
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MISSOURI LANDSCAPE COA #000008
9229 WARD PARKWAY, SUITE # 210
KANSAS CITY, MO 64114
TEL: (816) 444-4200

STRUCTURAL ENGINEER
LEIGH + O'KANE
MISSOURI COA #001644
250 NE MURBERRY, SUITE 201
LEE'S SUMMIT, MO, 64086

MISSOURI COA #01022

15902 MIDLAND DRIVE SHAWNEE, KS 66217

LEE'S SUMMIT, MO, 64086 (816) 444-3144 PHONE

MECH., ELEC. & PLUMBING ENGINEERS HOSS & BROWN ENGINEERS

(913) 362-9090 PHONE

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HENDERSON ENGINEERS
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1801 MAIN STREET, SUITE 300

KANSAS CITY, MO 64108

(816) 663-8700 PHONE

MENT DRAWINGS

રા 64064

FIRE STATION #4
CITY OF LEE'S SUMMIT
5031 NORTHEAST LAKEWO
LEE'S SUMMIT, MISSOURI

REVISIONS:
# Description Date

DERICK M.

HOLMES

NUMBER

PE-2022005196

DERICK HOLMES - CIVIL ENGINEER

MO# PE-2022005196

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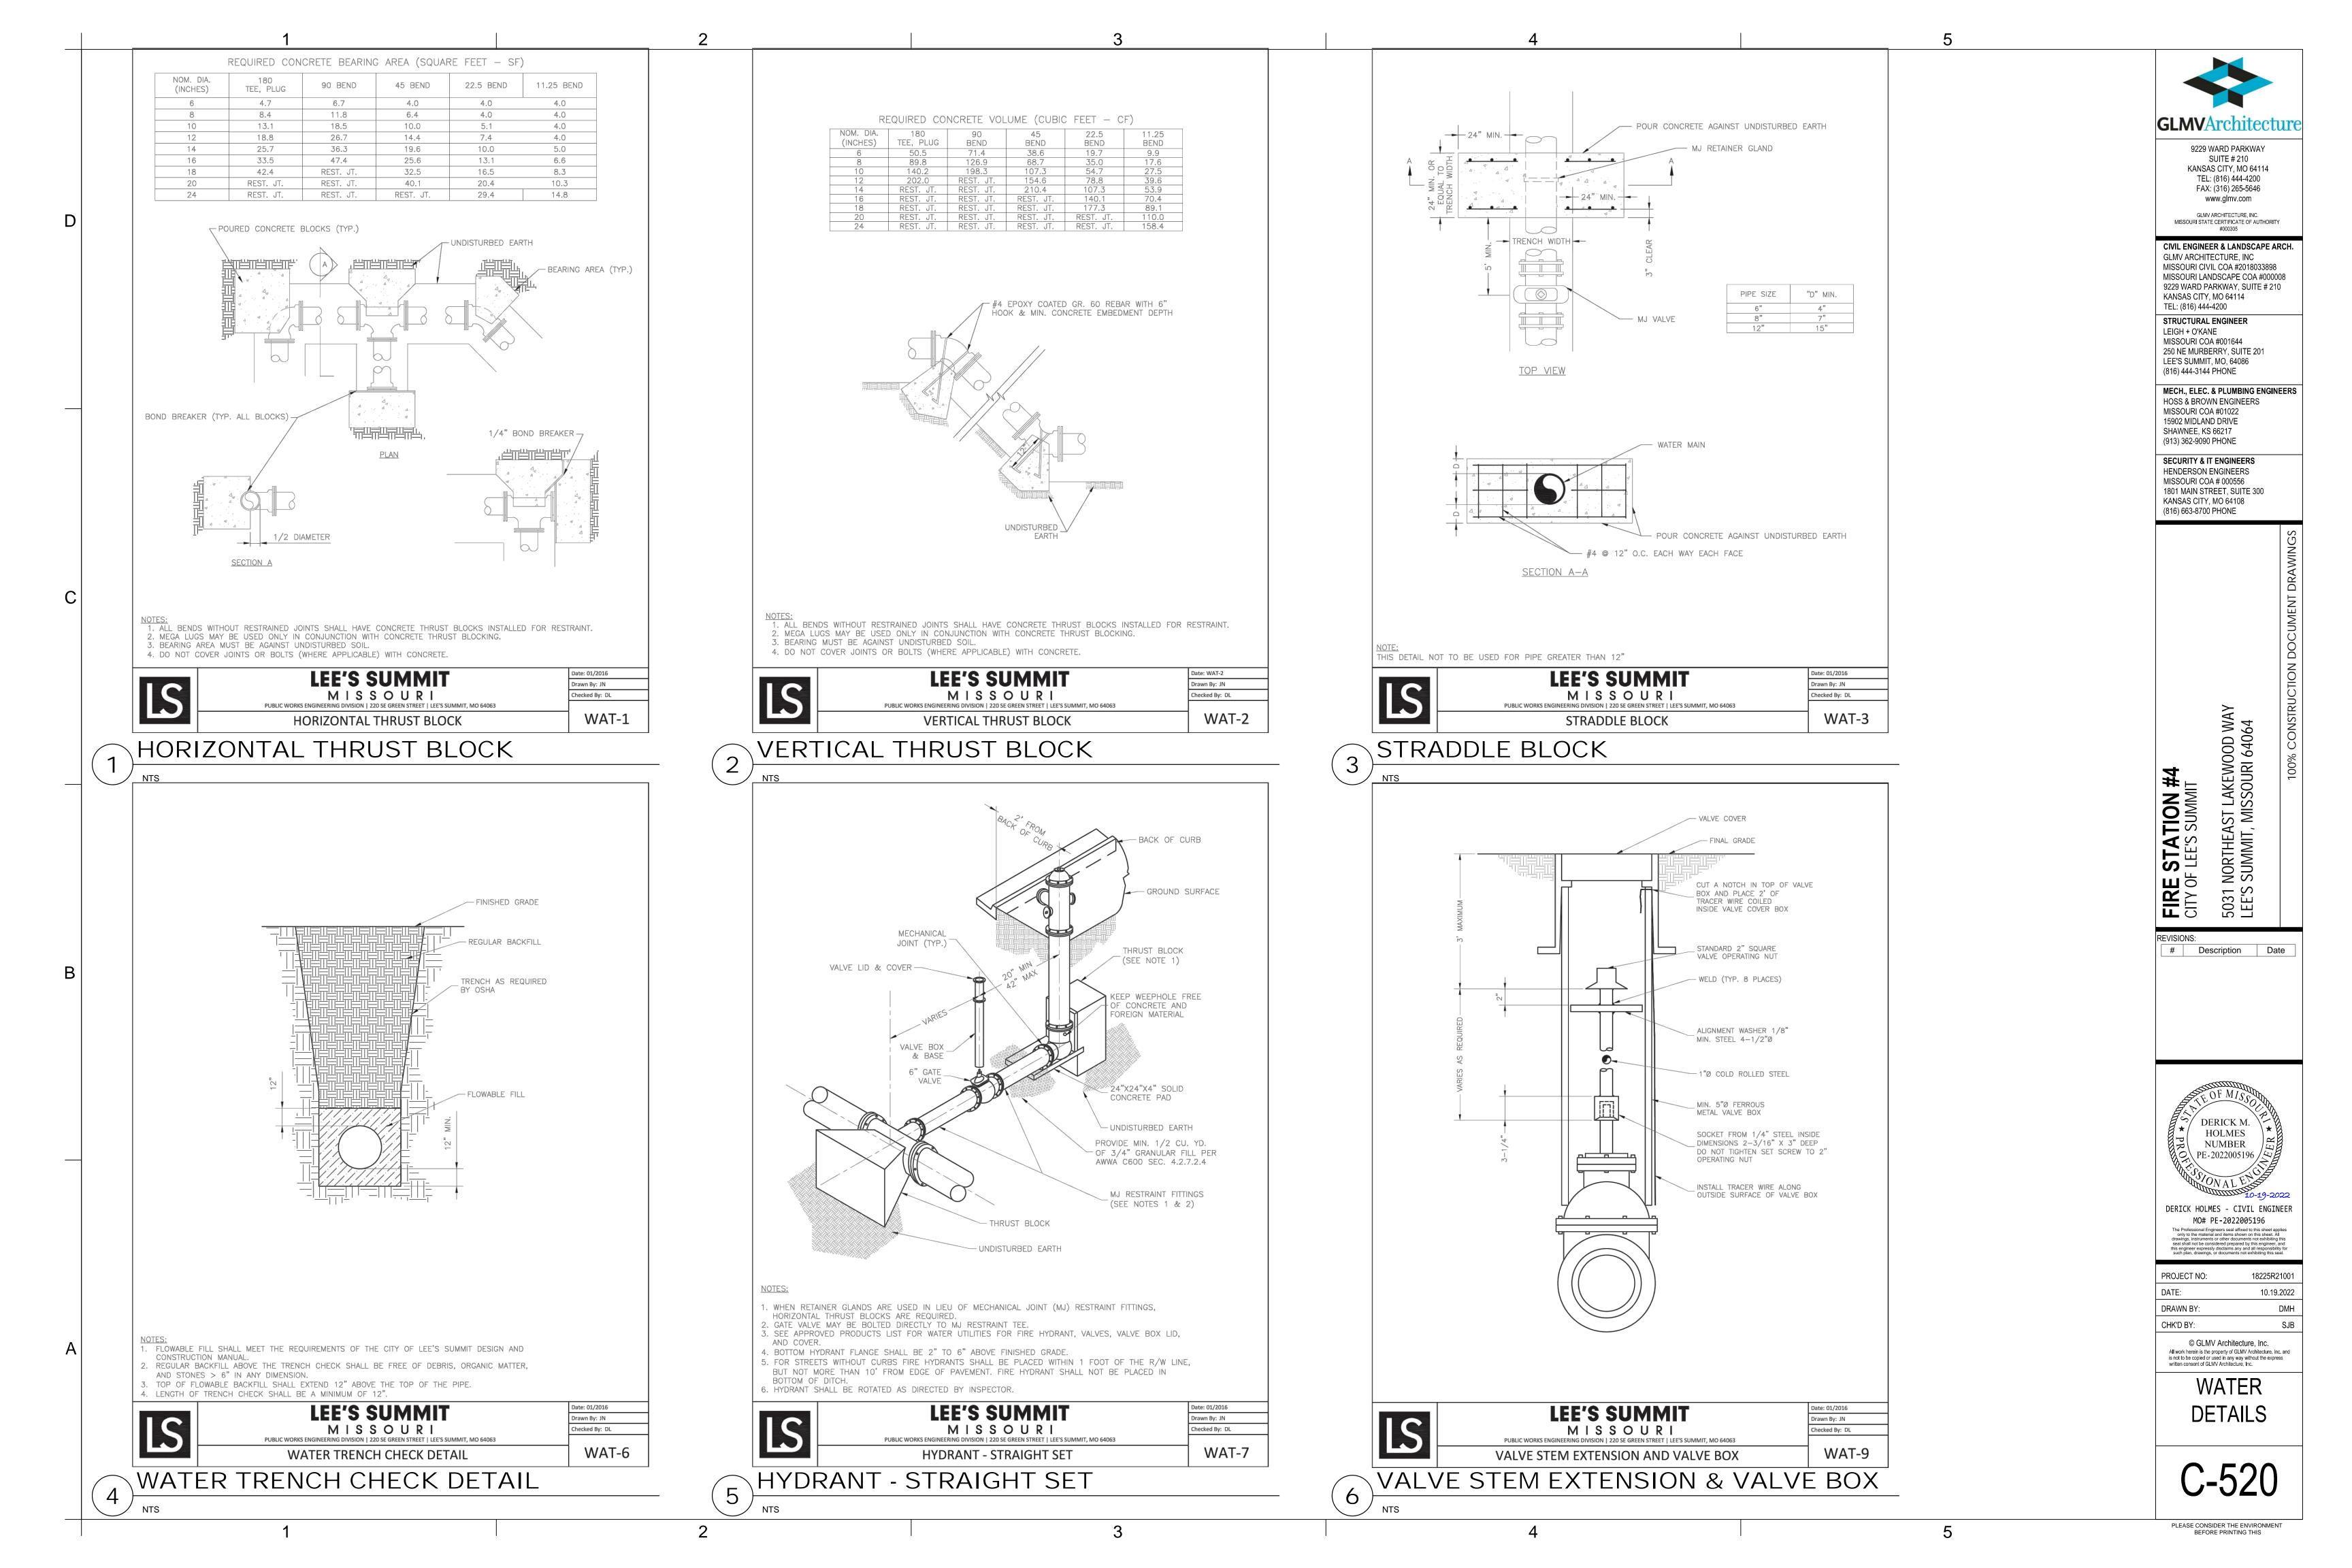
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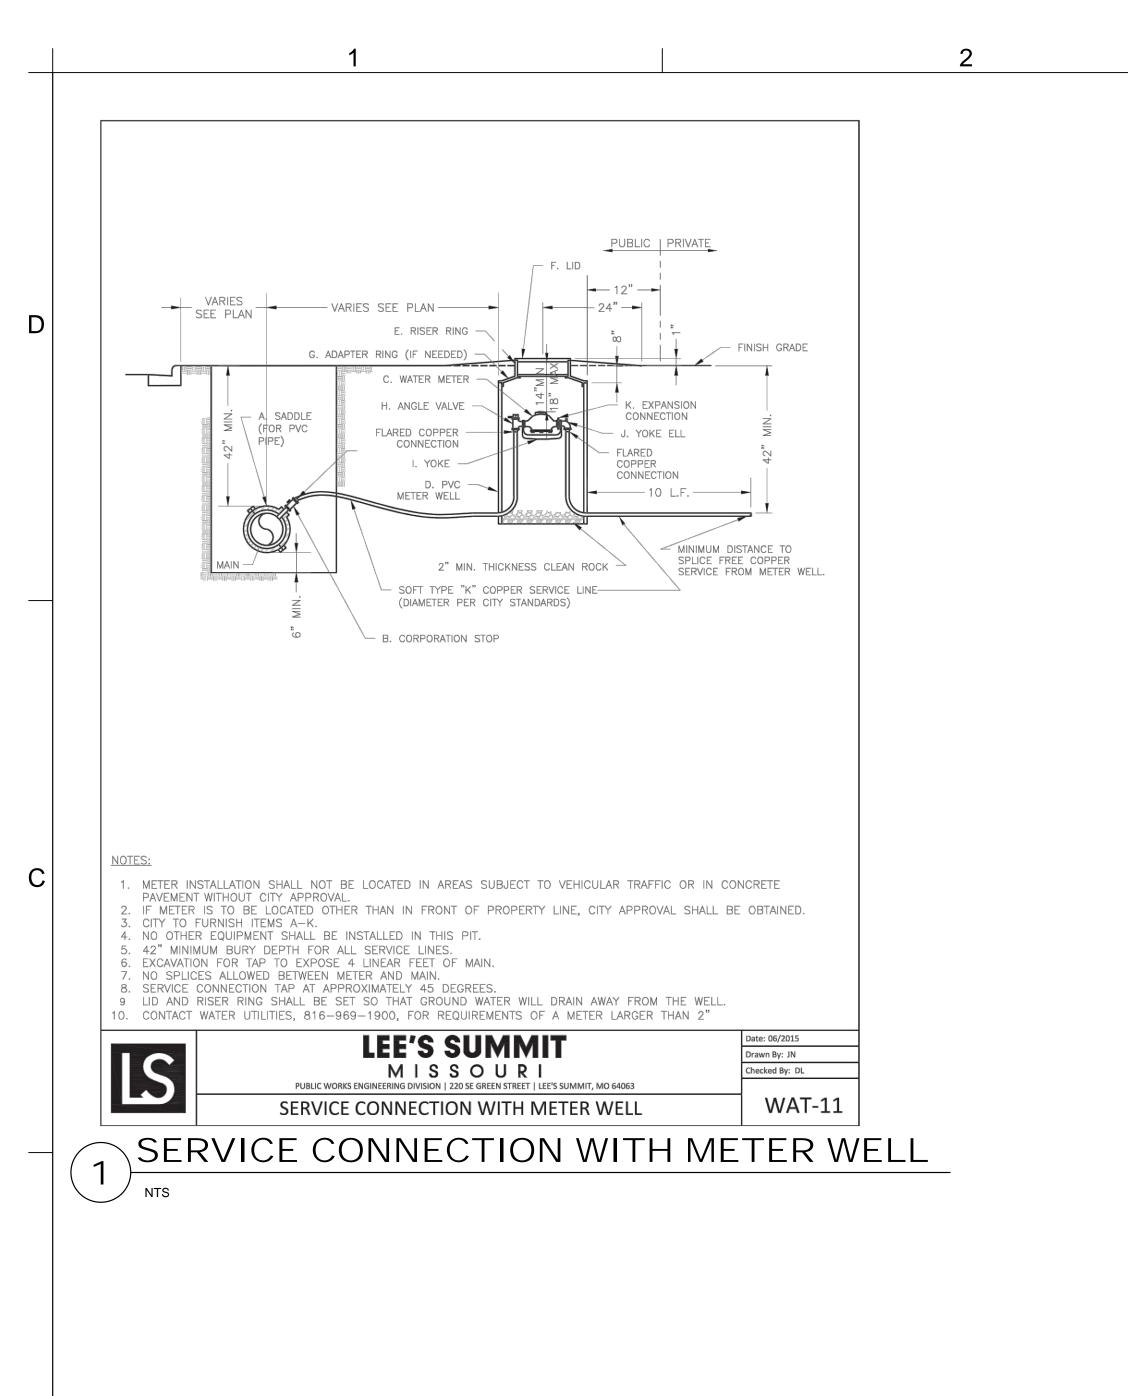
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GLMV ARCHITECTURE, INC
MISSOURI CIVIL COA #2018033898
MISSOURI LANDSCAPE COA #000008
9229 WARD PARKWAY, SUITE # 210
KANSAS CITY, MO 64114
TEL: (816) 444 4200

TEL: (816) 444-4200

STRUCTURAL ENGINEER

LEIGH + O'KANE

MISSOURI COA #001644

250 NE MURBERRY, SUITE 201

LEE'S SUMMIT, MO, 64086
(816) 444-3144 PHONE

MECH., ELEC. & PLUMBING ENGINEERS
HOSS & BROWN ENGINEERS

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(913) 362-9090 PHONE

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MISSOURI COA # 000556

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KANSAS CITY, MO 64108 (816) 663-8700 PHONE

ORAWINGS

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HOLMES
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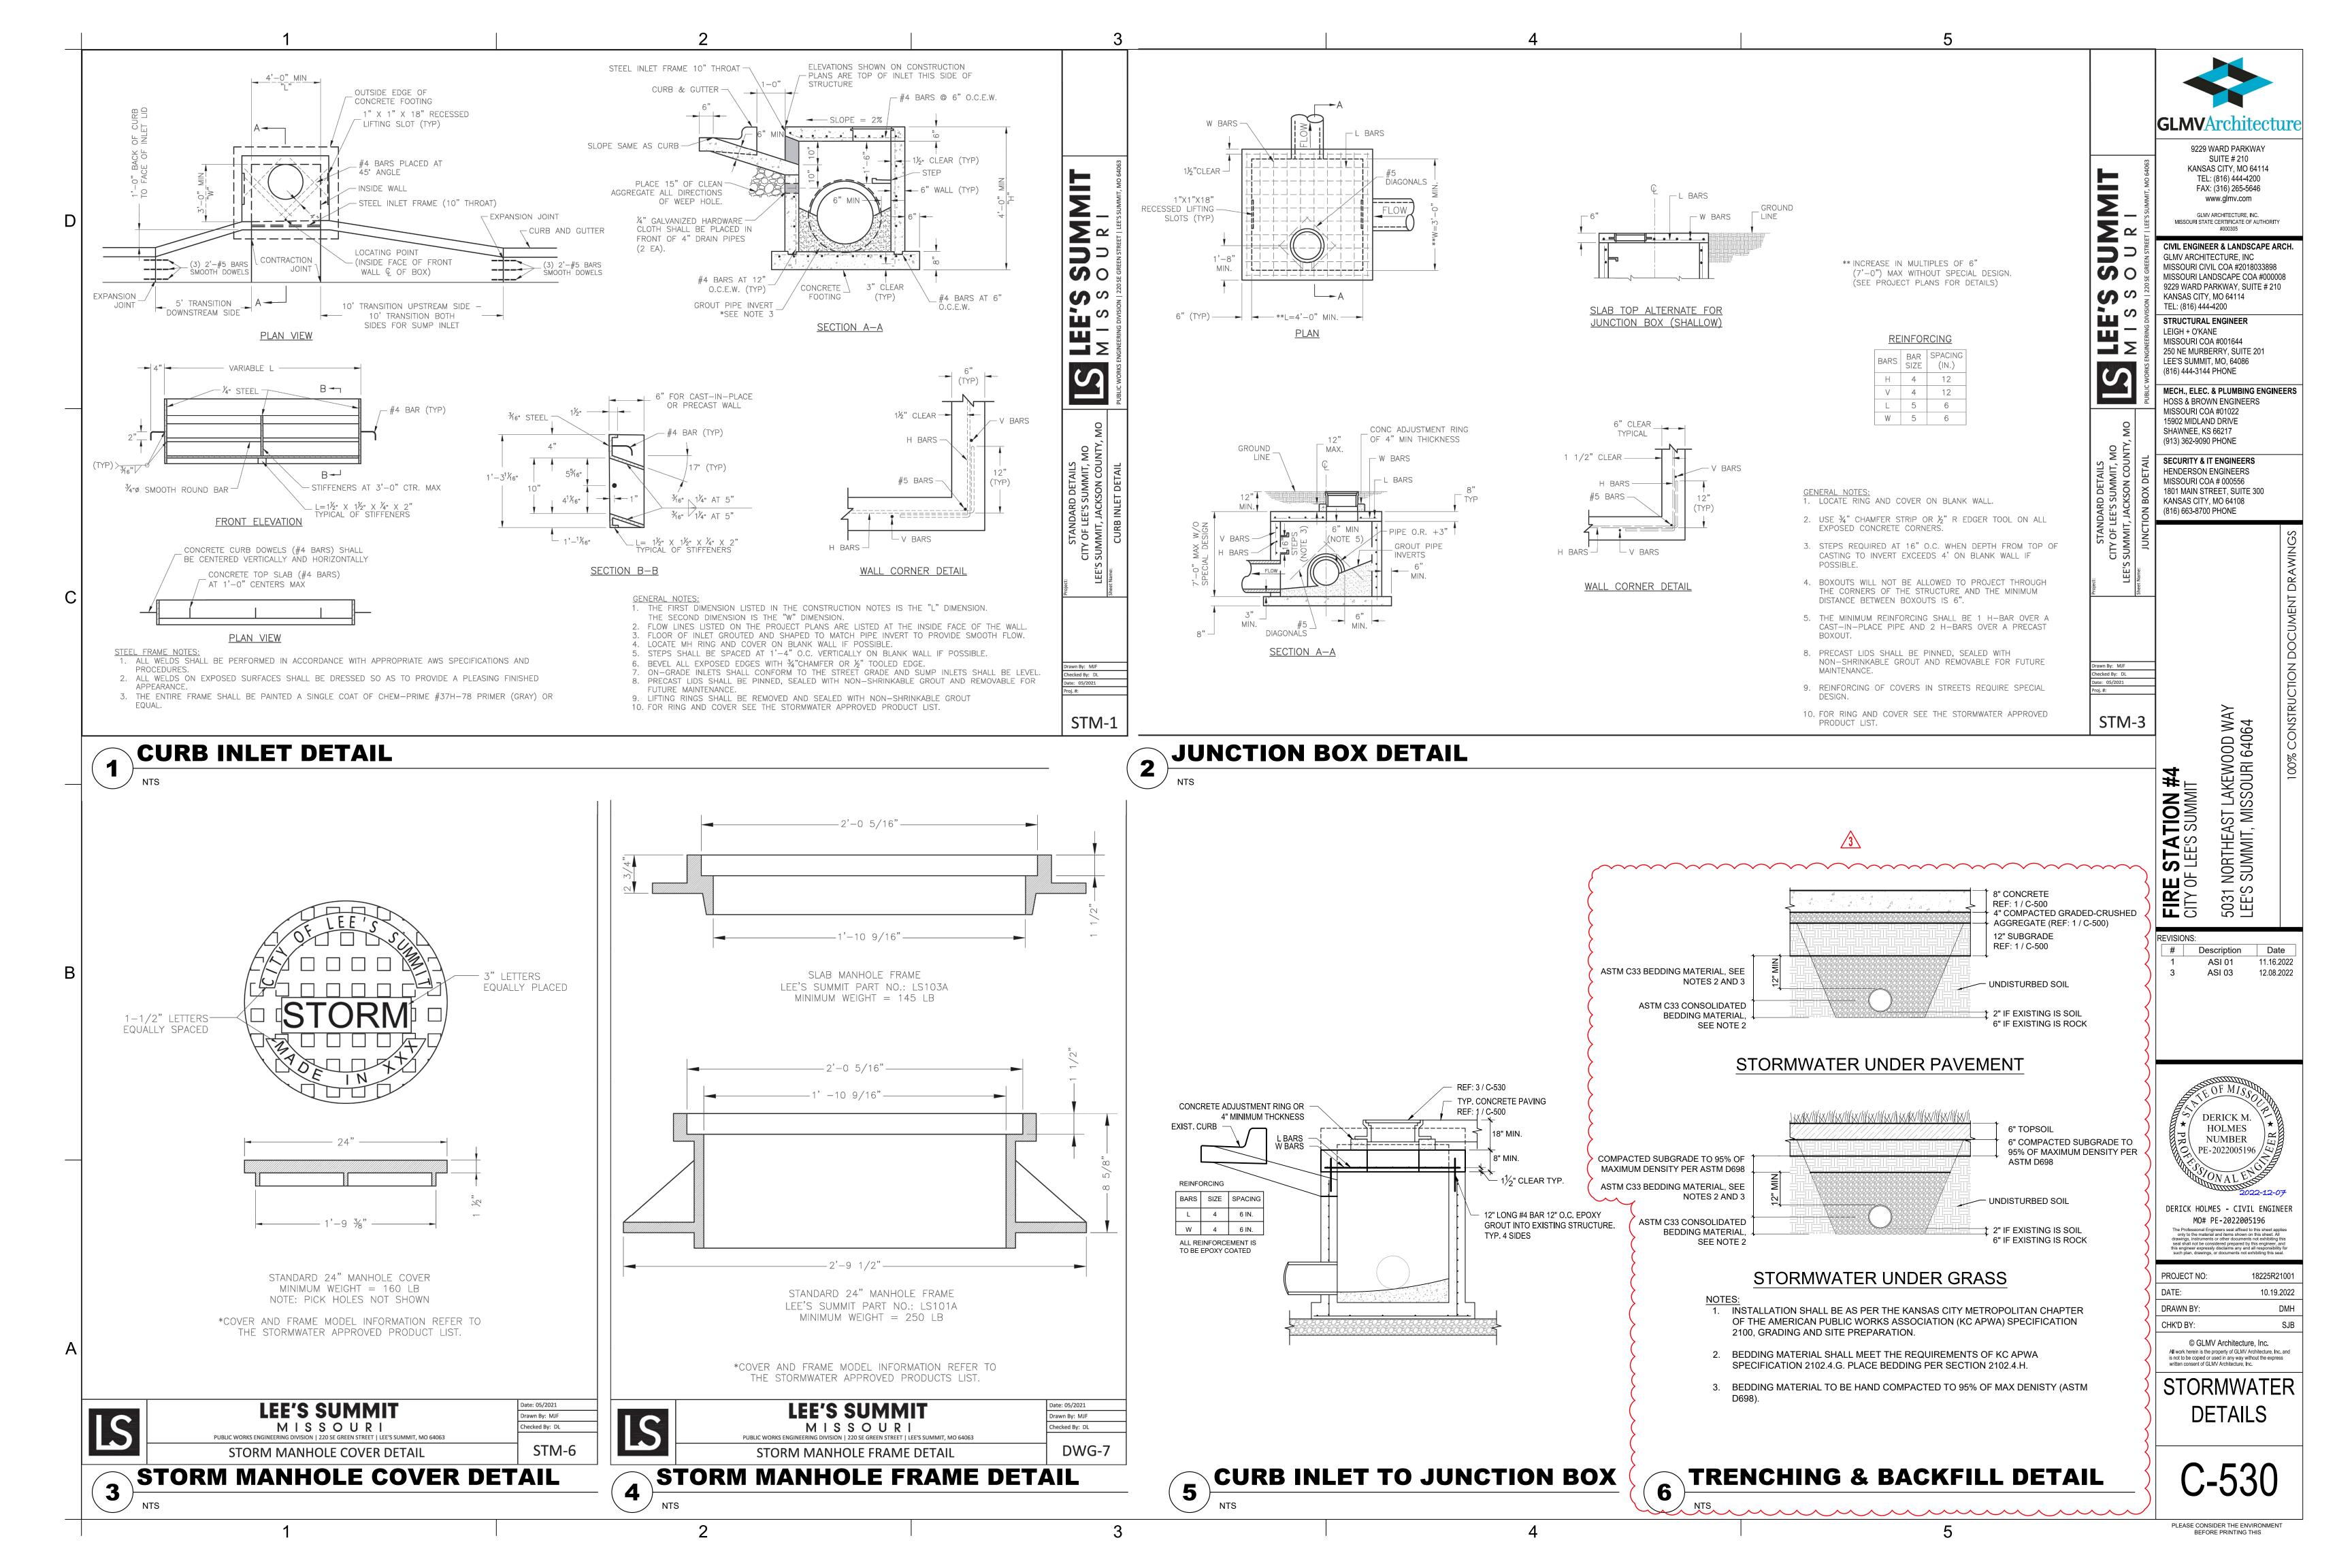
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WATER DETAILS

C-521

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# Section 2721

## **Engineered Surface Drainage Products**

PVC surface drainage inlets shall include the drain basin type as indicated on the contract drawing and referenced within the contract specifications. The ductile iron grates for each of these fittings are to be considered an integral part of the surface drainage inlet and shall be furnished by the same manufacturer. The surface drainage inlets shall be as manufactured by Nyloplast a division of Advanced Drainage Systems, Inc., or prior approved equal.

## **MATERIALS**

The drain basins required for this contract shall be manufactured from PVC pipe stock, utilizing a thermoforming process to reform the pipe stock to the specified configuration. The drainage pipe connection stubs shall be manufactured from PVC pipe stock and formed to provide a watertight connection with the specified pipe system. This joint tightness shall conform to ASTM D3212 for joints for drain and sewer plastic pipe using flexible elastomeric seals. The flexible elastomeric seals shall conform to ASTM F477. The pipe bell spigot shall be joined to the main body of the drain basin or catch basin. The raw material used to manufacture the pipe stock that is used to manufacture the main body and pipe stubs of the surface drainage inlets shall conform to ASTM D1784 cell class 12454.

The grates and frames furnished for all surface drainage inlets shall be ductile iron for structure sizes 8", 10", 12", 15", 18", 24", 30" and 36" and shall be made specifically for each basin so as to provide a round bottom flange that closely matches the diameter of the surface drainage inlet. Grates for drain basins shall be capable of supporting various wheel loads as specified by Nyloplast. 12" and 15" square grates will be hinged to the frame using pins. Ductile iron used in the manufacture of the castings shall conform to ASTM A536 grade 70-50-05. Grates and covers shall be provided painted black.

The specified PVC surface drainage inlet shall be installed using conventional flexible pipe backfill materials and procedures. The backfill material shall be crushed stone or other granular material meeting the requirements of class 1, class 2, or class 3 material as defined in ASTM D2321. Bedding and backfill for surface drainage inlets shall be well placed and compacted uniformly in accordance with ASTM D2321. The drain basin body will be cut at the time of the final grade. No brick, stone or concrete block will be required to set the grate to the final grade height. For load rated installations, a concrete slab shall be poured under and around the grate and frame. The concrete slab must be designed taking into consideration local soil conditions, traffic loading, and other applicable design factors. For other installation considerations such as migration of fines, ground water, and soft foundations refer to ASTM D2321 guidelines.

THIS PRINT DISCLOSES SUBJECT MATTER IN WHICH	DRAWN BY	CJA	MATERIAL					$\overline{}$	3130 VERONA AVE	
NYLOPLAST HAS PROPRIETARY RIGHTS. THE RECEIPT			l				1 (	(200)	BUFORD, GA 30518	
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TECHNICAL INFORMATION SHOWN HEREIN	REVISED B	Y NMH	PROJECT N	O./NAME			בעיב	Picci	www.nyloplast-us.co	ì
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DWG SIZE A SCALE 1:1 SHEET 1 OF 1 DWG NO. 7001-110-011 REV J

# 8 IN - 36 IN DRAIN BASIN SPECIFICATIONS

JUSTICE, 28 CFR PART 36.

1099CGSF APPROX. DRAIN AREA = 37.35 SQ IN APPROX. WEIGHT = 15.40 LBS DIMENSIONS ARE FOR REFERENCE ONLY 3130 VERONA AVE BUFORD, GA 30518 ACTUAL DIMENSIONS MAY VARY NYLOPLAST HAS PROPRIETARY RIGHTS. THE RECEIPT DIMENSIONS ARE IN INCHES PHN (770) 932-2443 OR POSSESSION OF THIS PRINT DOES NOT CONFER. GRATE HAS LIGHT DUTY RATING ANSFER, OR LICENSE THE USE OF THE DESIGN OR FAX (770) 932-2490 QUALITY: MATERIALS SHALL CONFORM TO ASTM A536 GRADE 70-50-05 TECHNICAL INFORMATION SHOWN HEREIN PAINT: CASTINGS ARE FURNISHED WITH A BLACK PAINT PRODUCTION OF THIS PRINT OR ANY INFORMATION NTAINED HEREIN, OR MANUFACTURE OF ANY SIZE OF OPENING MEETS REQUIREMENTS OF AMERICAN DISABILITY ACT AS STATED IN FEDERAL REGISTER PART III, DEPARTMENT OF

# 10" STANDARD GRATE ASSEMBLY - TYPE B

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7001-110-540

DWG SIZE A SCALE 1:5 SHEET 1 OF 1 DWG NO.

## OR POSSESSION OF THIS PRINT DOES NOT CONFER, DIMENSIONS ARE IN INCHES Nyloplast FAX (770) 932-2490 www.nyloplast-us.c ANSFER, OR LICENSE THE USE OF THE DESIGN OR GRATE MEETS H-20 LOAD RATING CHNICAL INFORMATION SHOWN HEREIN QUALITY: MATERIALS SHALL CONFORM TO ASTM A536 GRADE 70-50-05 ODLICTION OF THIS PRINT OR ANY INFORMATION PAINT: CASTINGS ARE FURNISHED WITH A BLACK PAINT ONTAINED HEREIN, OR MANUFACTURE OF ANY LOCKING DEVICE AVAILABLE UPON REQUEST SEE DRAWING NO. IS FORBIDDEN, EXCEPT BY SPECIFIC WRITTEN PERMISSION FROM NYLOPLAST. @22010 DWG SIZE A SCALE 1:10 SHEET 1 OF 1 DWG NO.

NYLOPLAST 24" DRAIN BASIN: 2824AG \_ \_X (1, 2) INTEGRATED DUCTILE IRON FRAME & GRATE TO MATCH BASIN O.D. 18" MIN WIDTH GUIDELINE 8" MIN THICKNESS GUIDELINE MINIMUM PIPE BURIAL DEPTH PER PIPE MANUFACTURER (3) VARIABLE INVERT HEIGHTS RECOMMENDATION AVAILABLE (ACCORDING TO TRAFFIC LOADS: CONCRETE SLAB DIMENSIONS ARE FOR (MIN. MANUFACTURING (5) ADAPTER ANGLES PLANS/TAKE OFF) GUIDELINE PURPOSES ONLY. ACTUAL CONCRETE SLAB MUST BE REQ. SAME AS MIN. SUMP) DESIGNED TAKING INTO CONSIDERATION LOCAL SOIL CONDITIONS, VARIABLE 0° - 360° TRAFFIC LOADING, & OTHER APPLICABLE DESIGN FACTORS. SEE DRAWING NO. 7001-110-111 FOR NON TRAFFIC INSTALLATION. (3) VARIABLE SUMP DEPTH ACCORDING TO PLANS (6" MIN. BASED ON MANUFACTURING REQ.) (4) VARIOUS TYPES OF INLET & OUTLET ADAPTERS AVAILABLE: 4" - 24" FOR CORRUGATED HDPE (ADS N-12/HANCOR DUAL WALL, ADS/HANCOR SINGLE WALL), N-12 HP, PVC SEWER (EX: SDR 35), PVC DWV (EX: SCH 40), PVC C900/C905, CORRUGATED & RIBBED PVC THE BACKFILL MATERIAL SHALL BE CRUSHED STONE OR OTHER GRANULAR MATERIAL MEETING THE REQUIREMENTS OF CLASS I. WATERTIGHT JOINT CLASS II, OR CLASS III MATERIAL AS DEFINED IN ASTM D2321. (CORRUGATED HDPE SHOWN) BEDDING & BACKFILL FOR SURFACE DRAINAGE INLETS SHALL BE PLACED & COMPACTED UNIFORMLY IN ACCORDANCE WITH ASTM D2321. - GRATES/SOLID COVER SHALL BE DUCTILE IRON PER ASTM A536 GRADE 70-50-05. HIS PRINT DISCLOSES SUBJECT MATTER IN WHICH - FRAMES SHALL BE DUCTILE IRON PER ASTM A536 GRADE 70-50-05. NYLOPLAST HAS PROPRIETARY RIGHTS. THE RECEIPT BUFORD, GA 30518 - DRAIN BASIN TO BE CUSTOM MANUFACTURED ACCORDING TO PLAN DETAILS. POSSESSION OF THIS PRINT DOES NOT CONFER. PHN (770) 932-2443 RISERS ARE NEEDED FOR BASINS OVER 84" DUE TO SHIPPING RESTRICTIONS. Nyloplast FAX (770) 932-2490 ANSFER, OR LICENSE THE USE OF THE DESIGN OR SEE DRAWING NO. 7001-110-065. TECHNICAL INFORMATION SHOWN HEREIN - DRAINAGE CONNECTION STUB JOINT TIGHTNESS SHALL CONFORM TO DDUCTION OF THIS PRINT OR ANY INFORMATION ASTM D3212 FOR CORRUGATED HDPE (ADS N-12/HANCOR DUAL WALL), N-12 HP NTAINED HEREIN, OR MANUFACTURE OF ANY 24 IN DRAIN BASIN QUICK SPEC INSTALLATION DETAIL

24" DRAIN BASIN QUICK SPEC INSTALLATION DETAIL

DWG SIZE A SCALE 1:40 SHEET 1 OF 1 DWG NO.

7001-110-192 REV E

PHN (770) 932-2443

18 IN STANDARD GRATE ASSEMBLY - TYPE C

RTICLE HEREFROM, FOR THE DISCLOSURE TO OTHERS

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- ADAPTERS CAN BE MOUNTED ON ANY ANGLE 0° TO 360°. TO DETERMINE MINIMUM

ANGLE BETWEEN ADAPTERS SEE DRAWING NO. 7001-110-012.

# APPROX, DRAIN AREA = 116.72 SQ IN APPROX. WEIGHT WITH FRAME = 68.50 LBS DIMENSIONS ARE FOR REFERENCE ONLY THIS PRINT DISCLOSES SUBJECT MATTER IN WHICH ACTUAL DIMENSIONS MAY VARY BUFORD, GA 30518 NYLOPLAST HAS PROPRIETARY RIGHTS. THE RECEIPT

# 18" STANDARD GRATE ASSEMBLY-TYPE C

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REVISIONS: # Description

HOLMES NUMBER


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**STORMWATER DETAILS** 

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(816) 444-3144 PHONE MECH., ELEC. & PLUMBING ENGINEERS HOSS & BROWN ENGINEERS MISSOURI COA #01022

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# Description Date ASI 01


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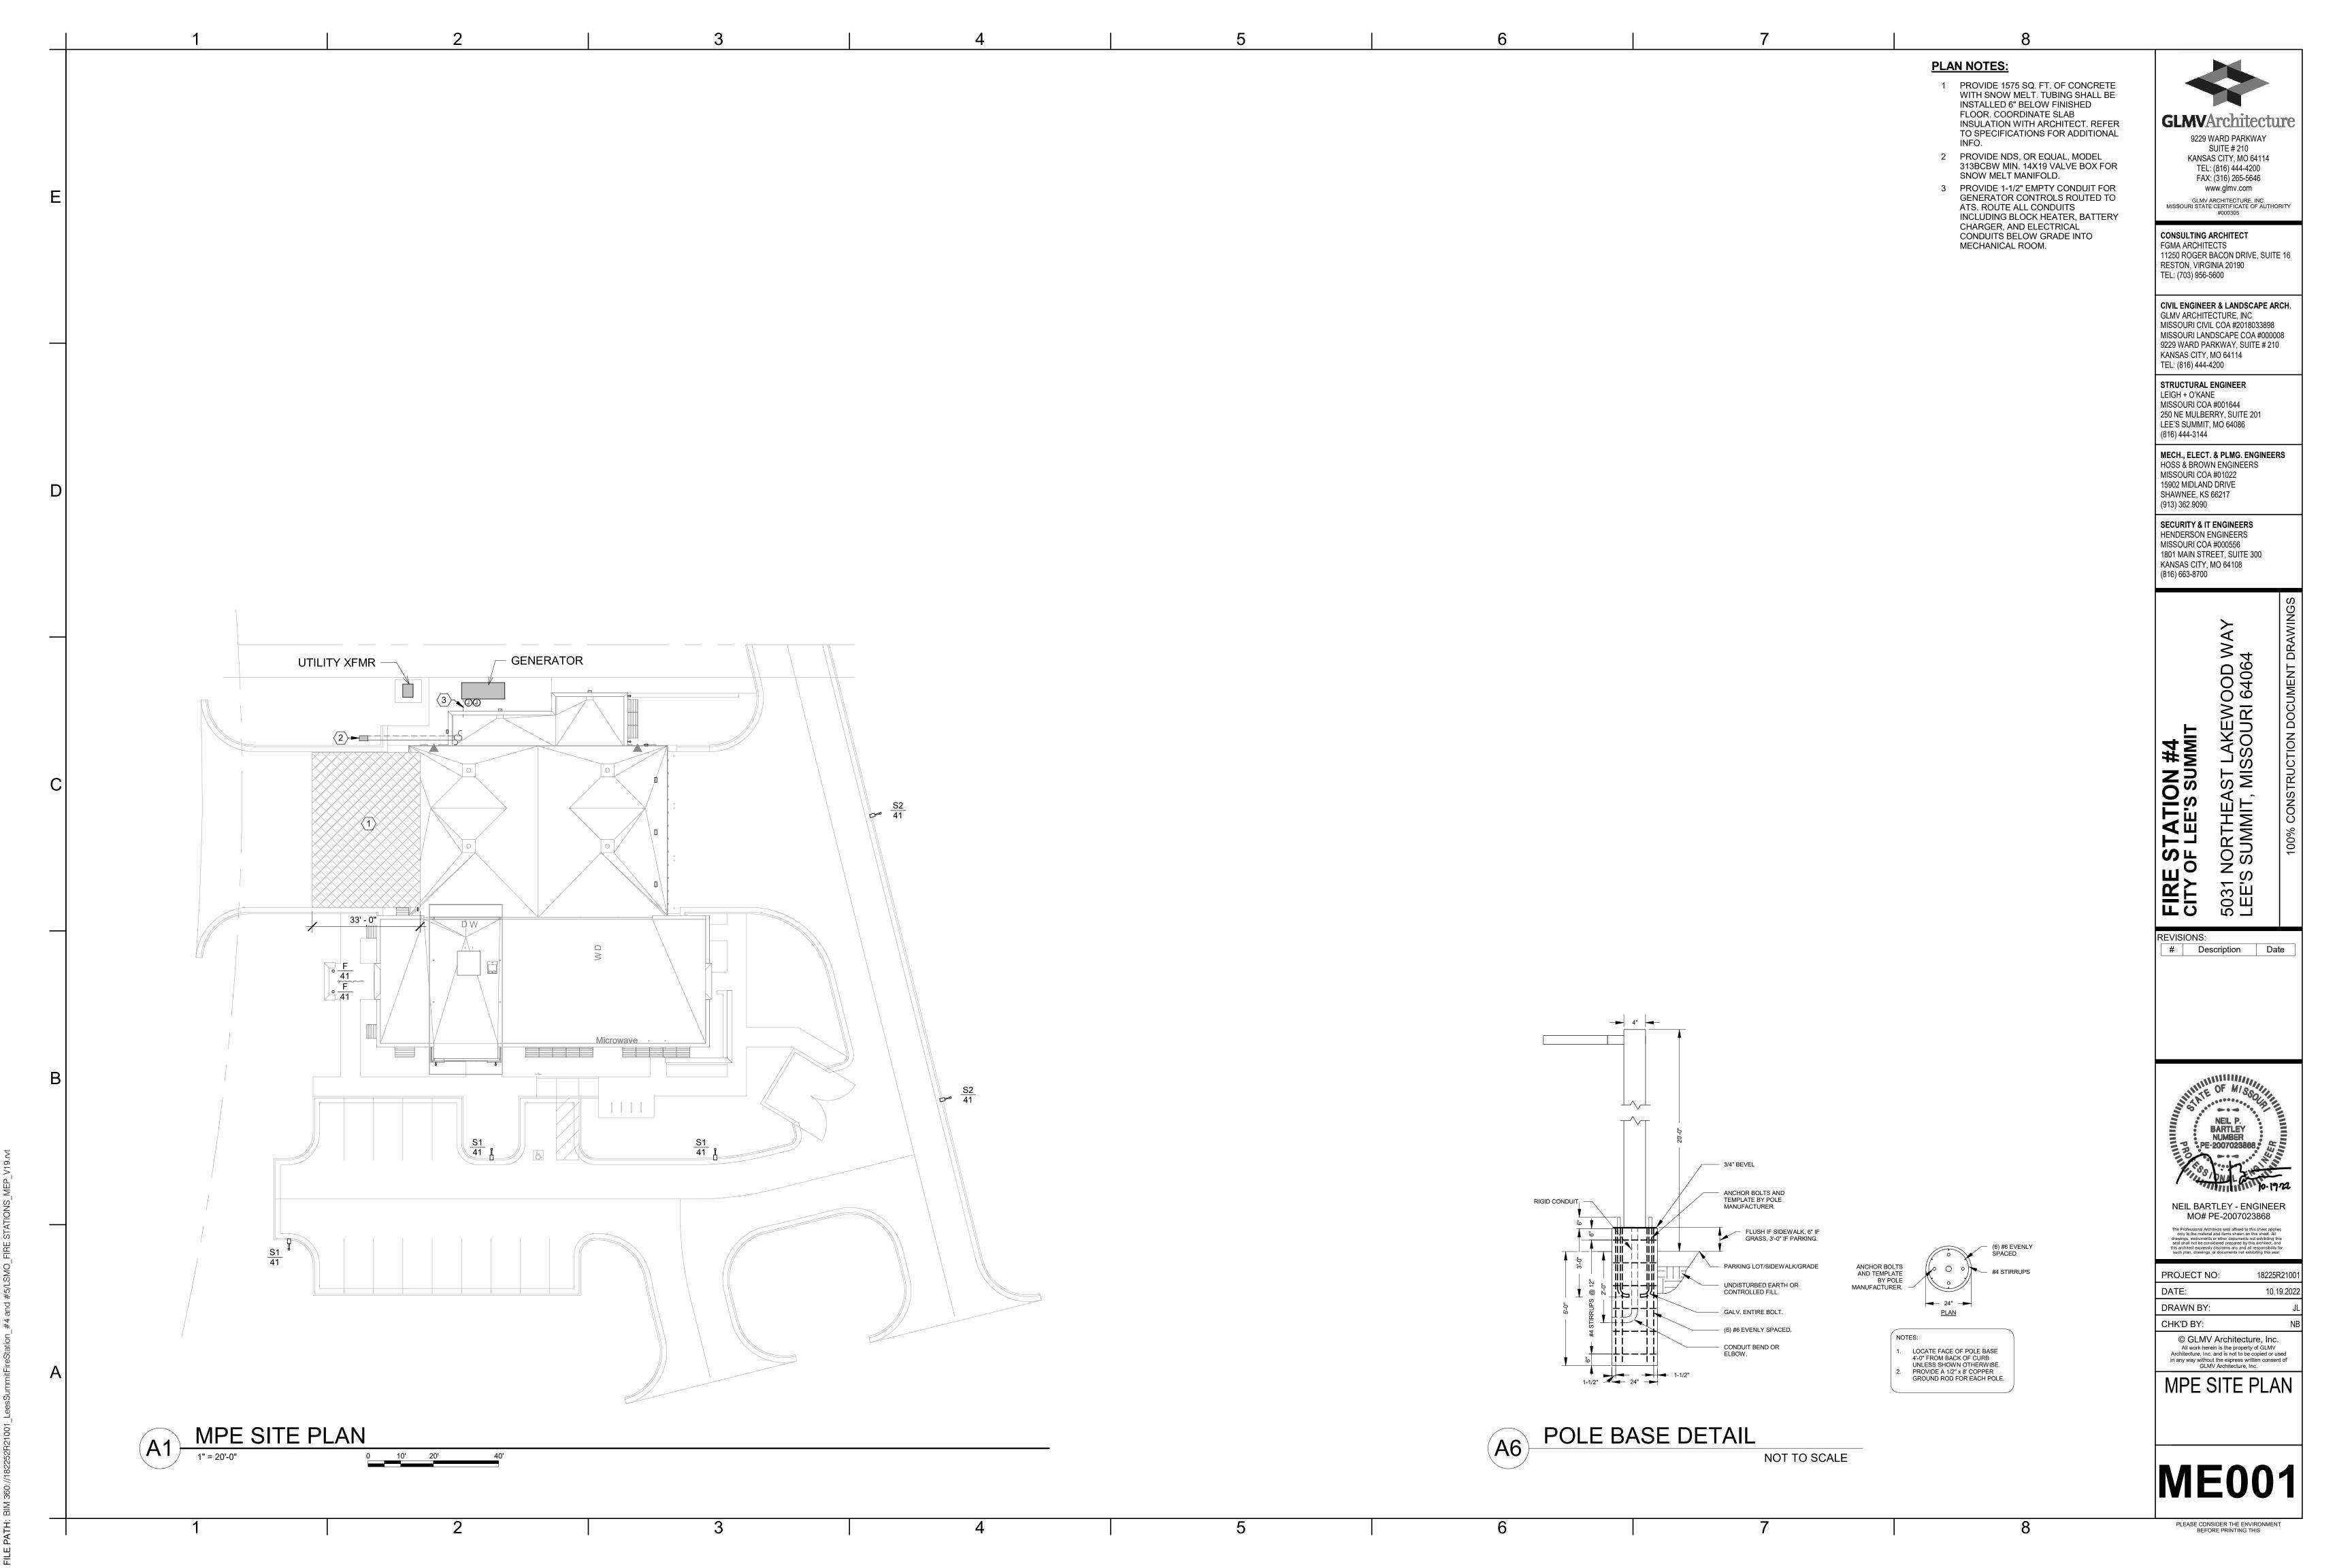
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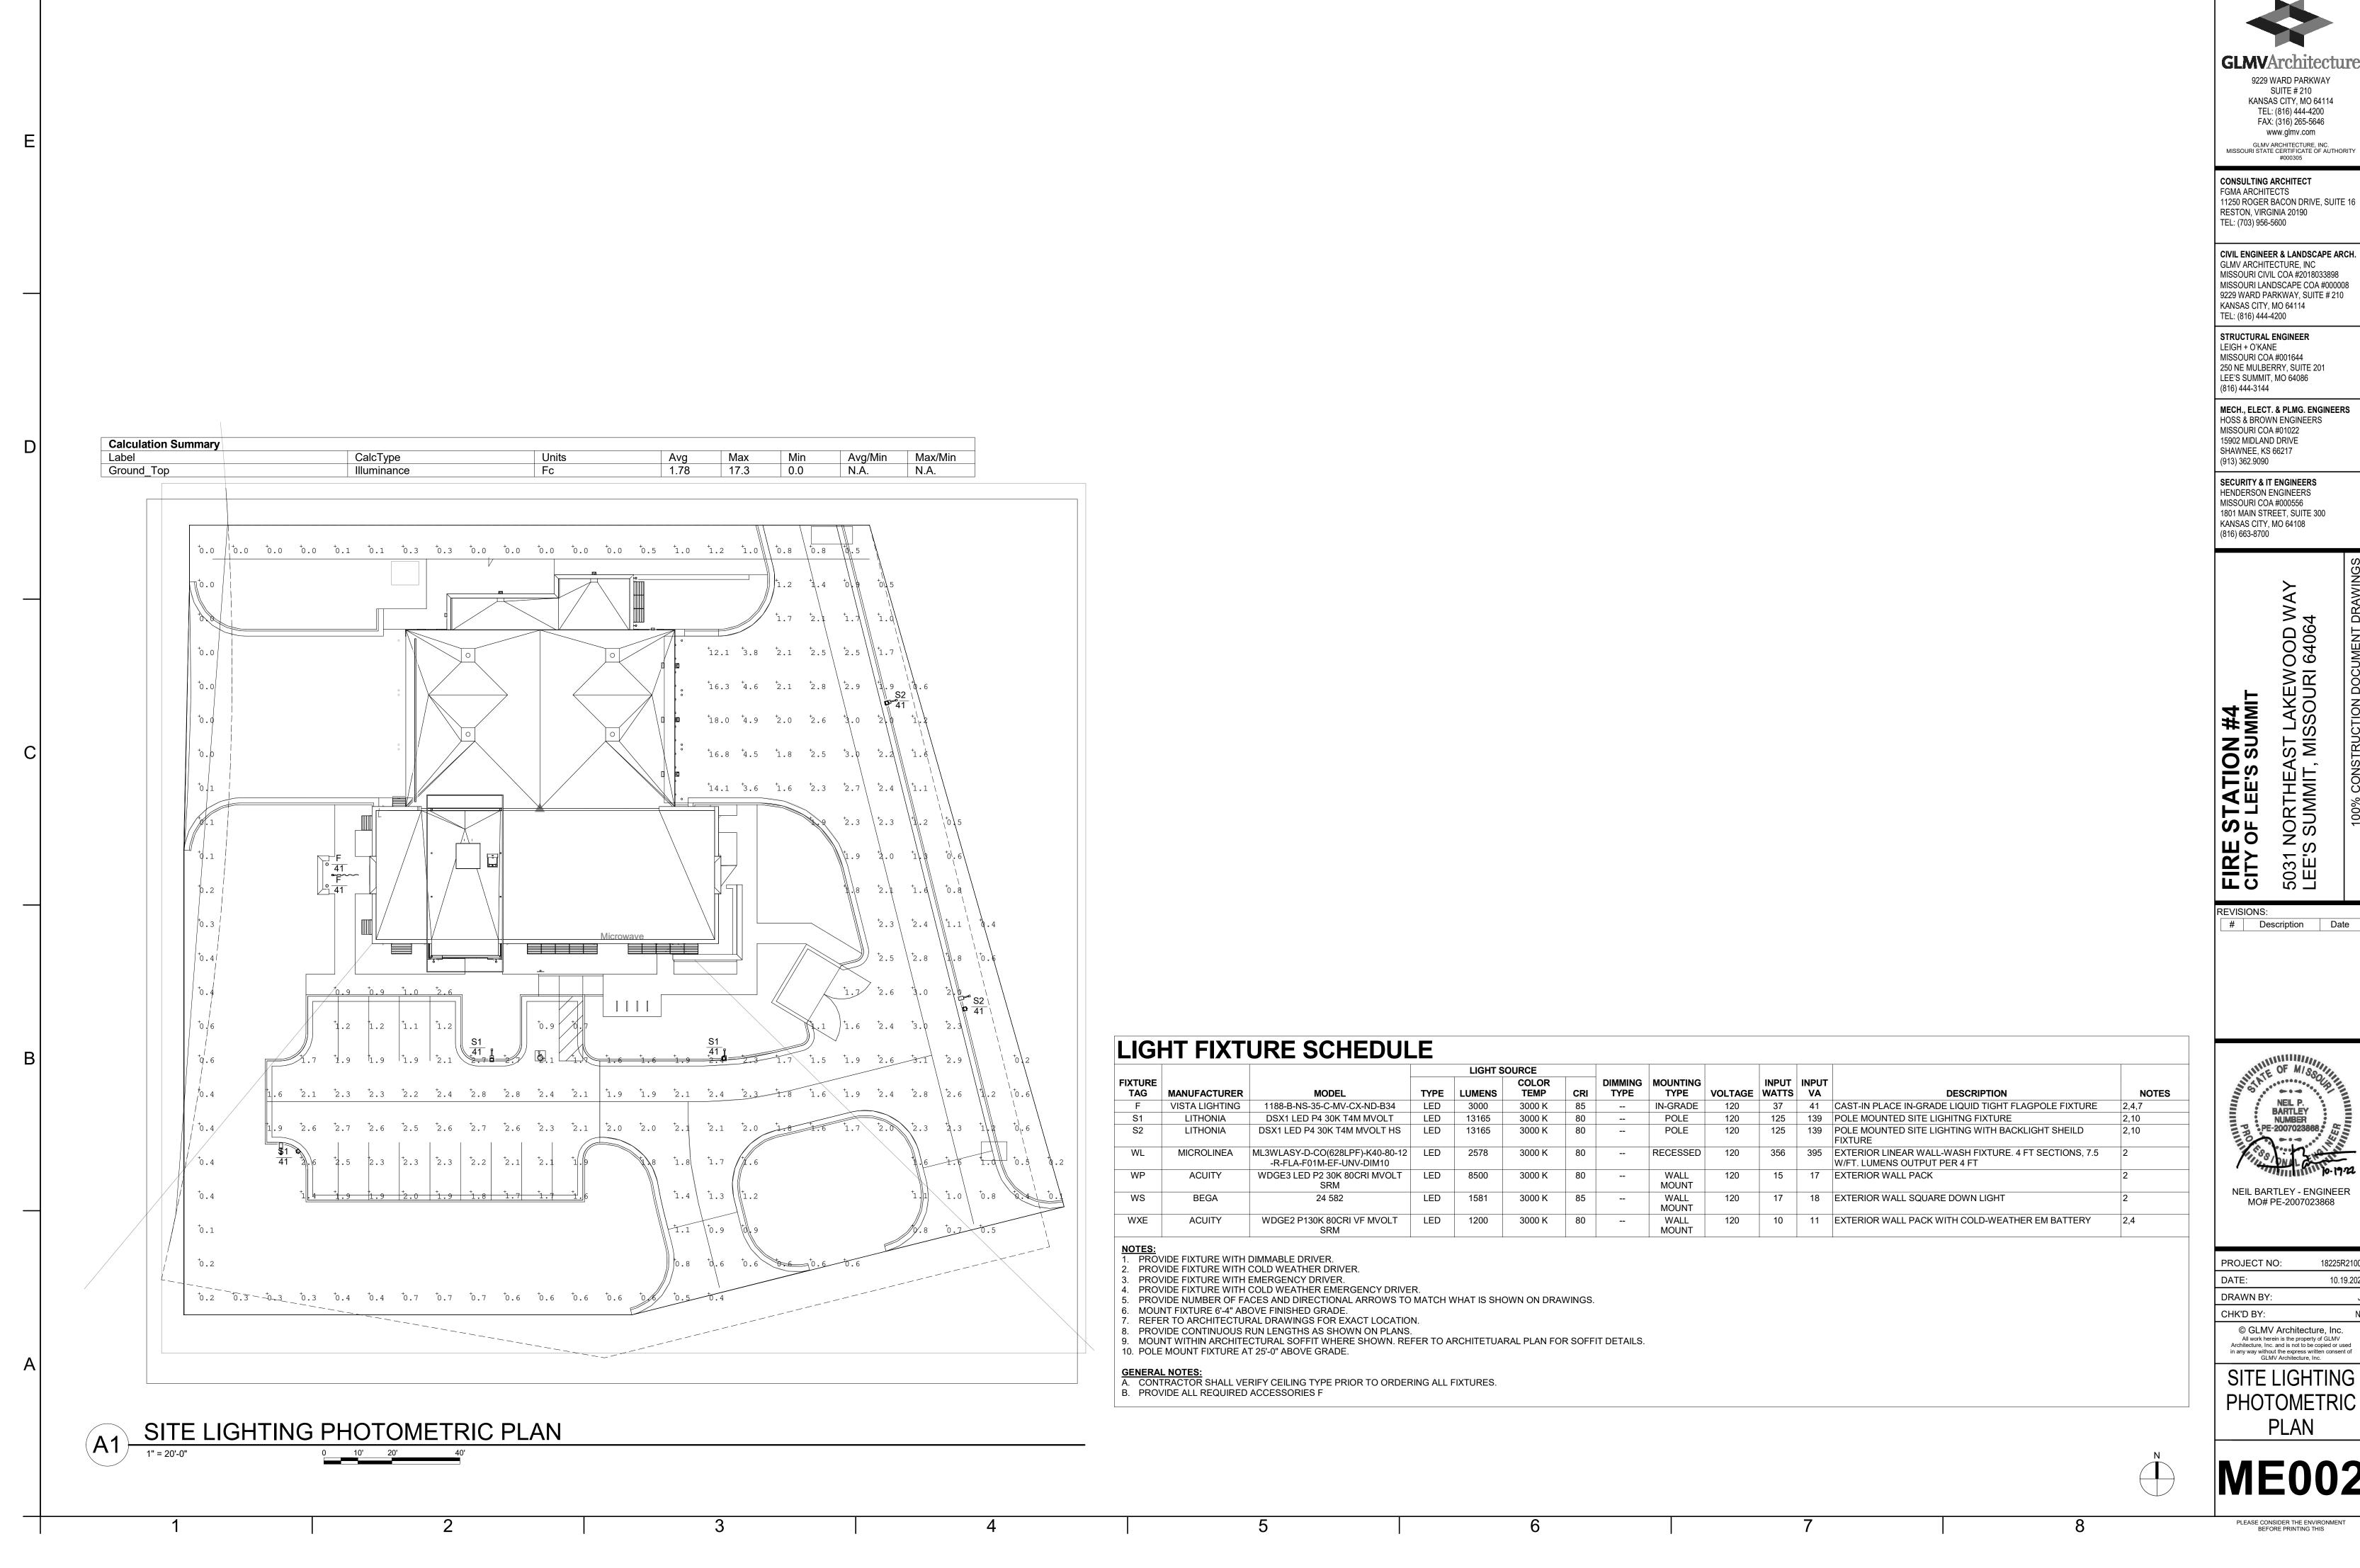
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	DATE:	10.19.2022
	DRAWN BY:	JL
	CHK'D BY:	NB
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**SHRUB PLANTING** 

# GENERAL LANDSCAPE SITE NOTES

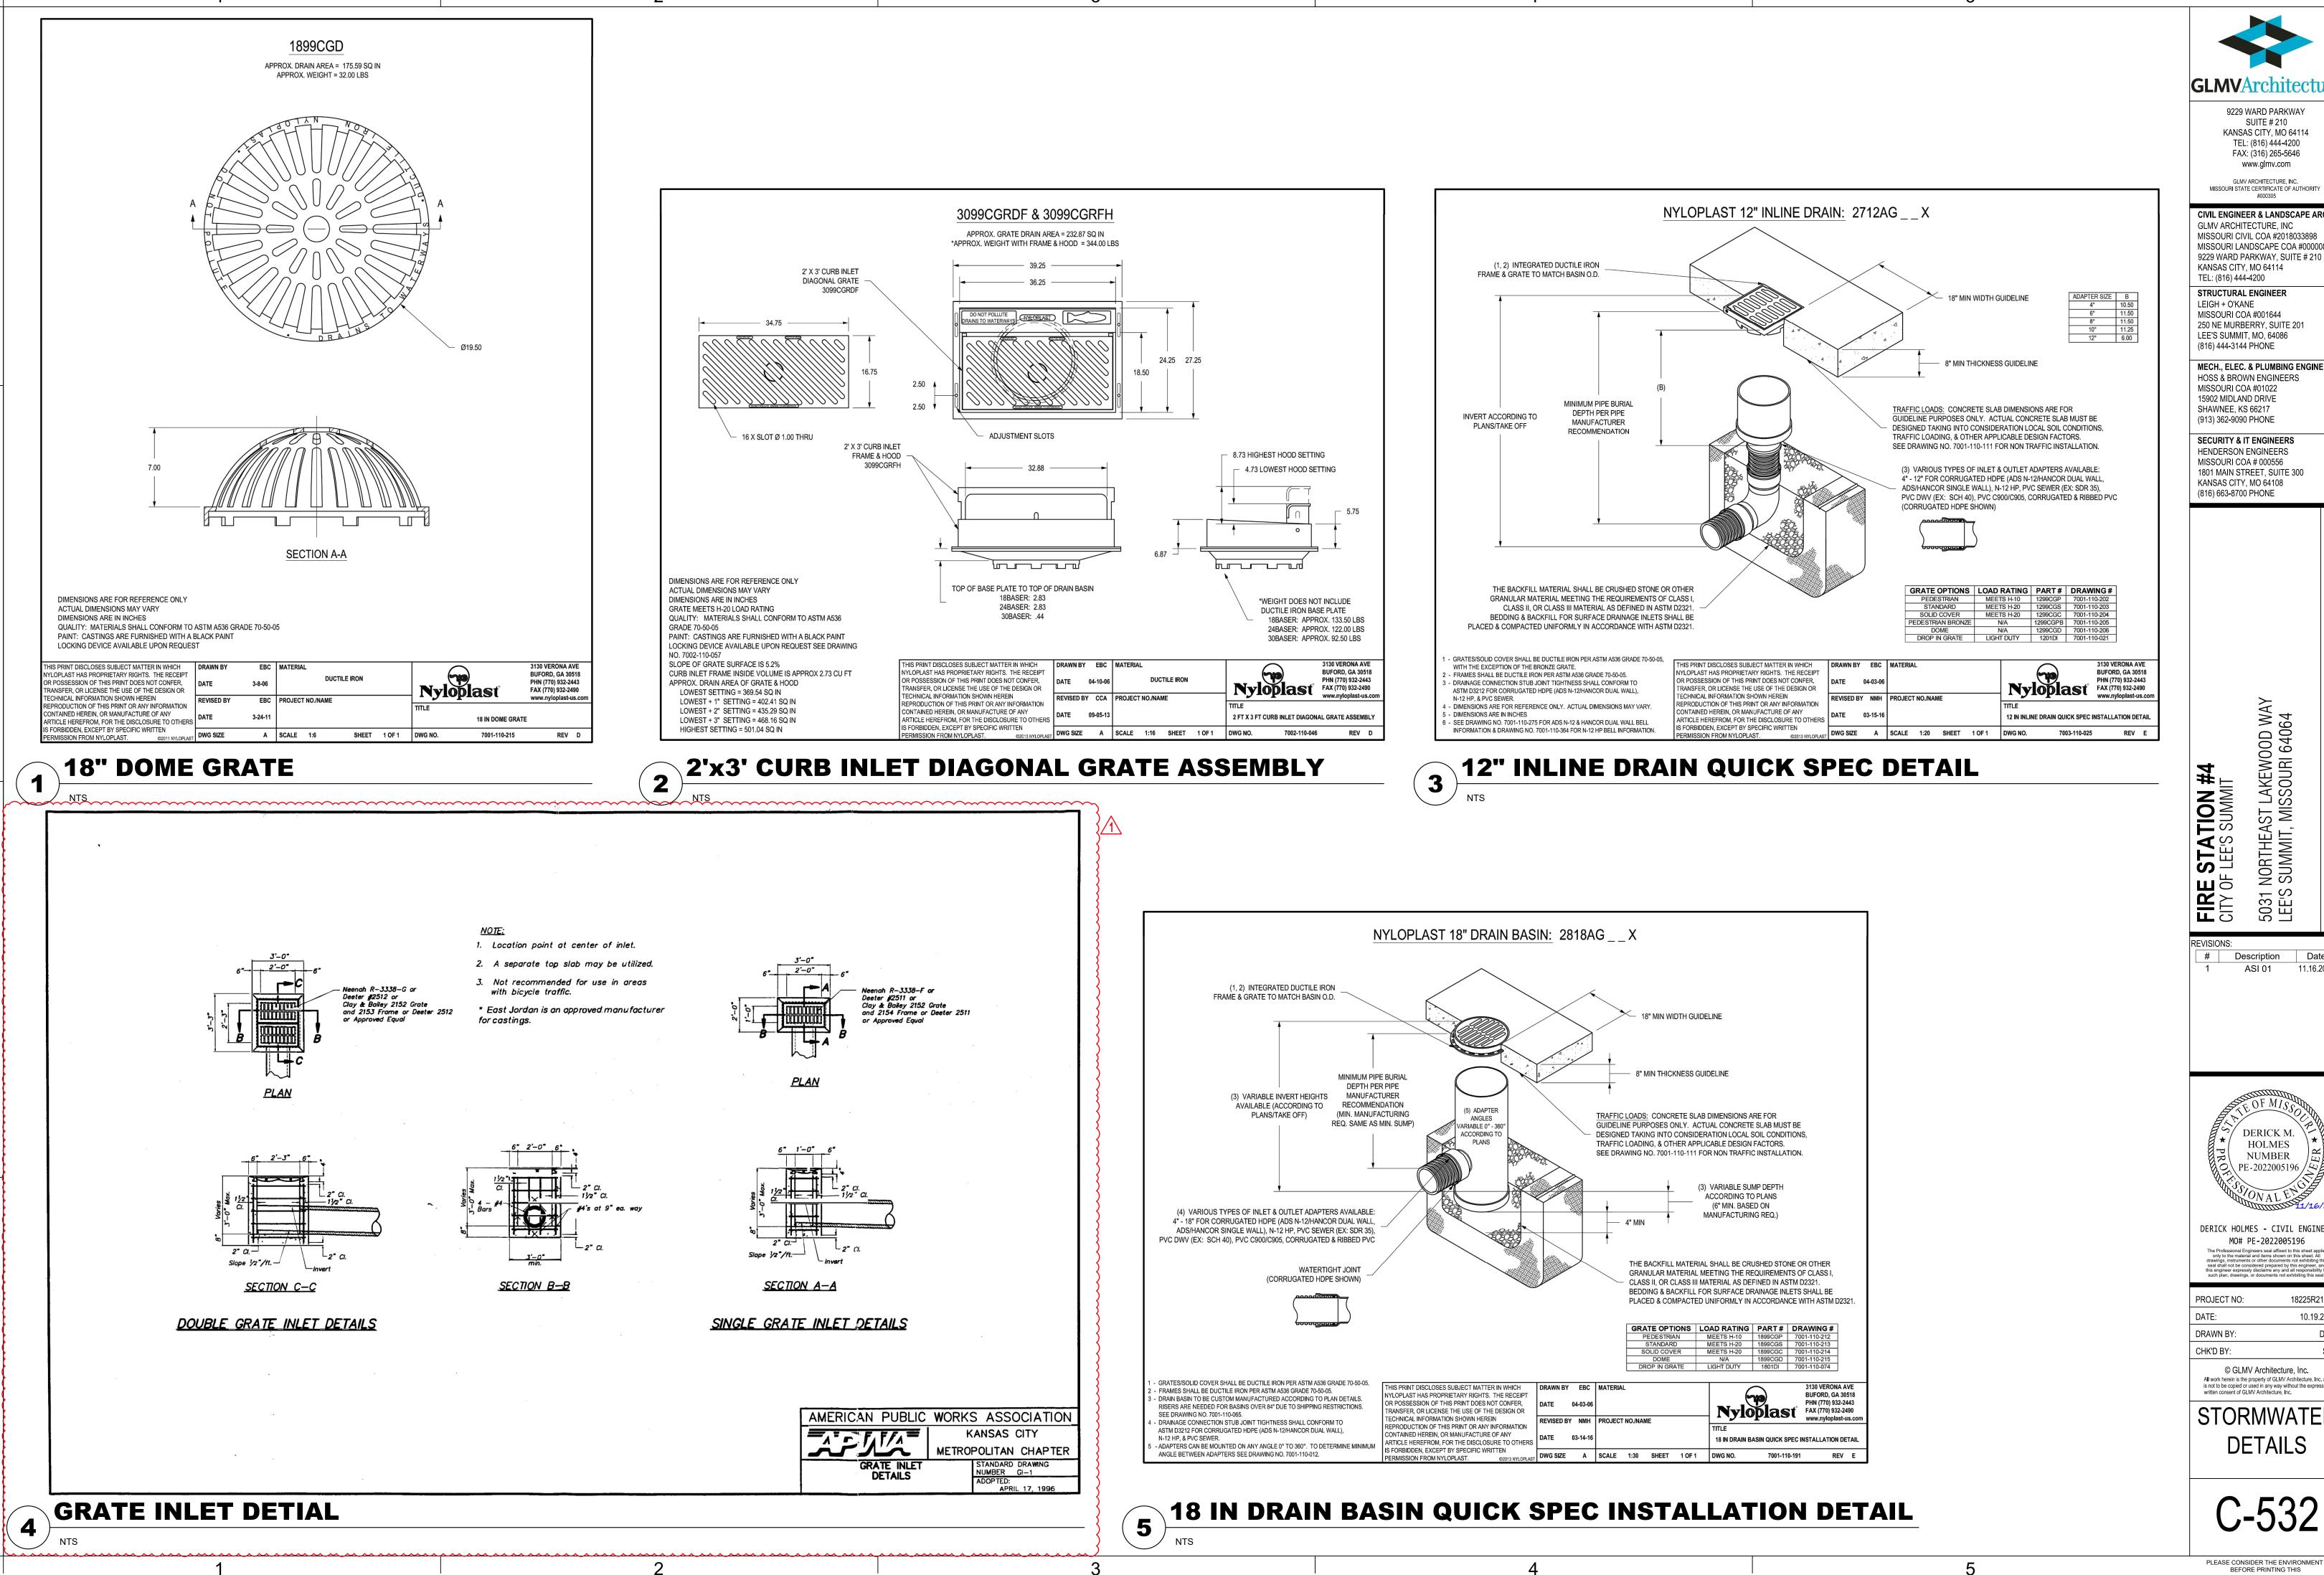- 1. PRIOR TO COMMENCEMENT OF WORK, THE CONTRACTOR SHALL GIVE 48 HOURS ADVANCE NOTICE TO ALL COMPANIES/UTILITIES THAT HAVE FACILITIES IN THE NEAR VICINITY OF THE CONSTRUCTION TO BE PERFORMED.
- 2. CONTRACTOR SHALL VERIFY ALL PLANT COUNTS, QUANTITIES AND AREAS AND REPORT ANY DISCREPANCIES TO THE LANDSCAPE ARCHITECT PRIOR TO
- 3. SEE PLANT SCHEDULE FOR PLANT LEGEND AND QUANTITIES.
- 4. SYMBOLS INDICATED ON THE PLAN TAKE PRIORITY OVER WRITTEN QUANTITIES AND LABELS.
- 5. PLANTS CALLED OUT IN PLAN ARE CONSIDERED IN CLUSTERS EVEN IF NOT ATTACHED BY CONNECTING LINES. CALLOUTS HAVE TOTAL COUNTS NEEDED.
- 6. CONTRACTOR SHALL MAINTAIN THE LANDSCAPE UNTIL SUBSTANTIAL COMPLETION. MAINTENANCE WORK SHALL CONSIST OF APPLYING WATER, WEEDING, AND FERTILIZING.
- 7. CONTRACTOR SHALL BE RESPONSIBLE FOR DISEASE AND PEST CONTROL DURING THE MAINTENANCE PERIOD.
- 8. CONTRACTOR TO VERIFY, WITH SOIL ANALYSIS, THE SOIL AMENDMENT NEEDED AND CONTACT THE LANDSCAPE ARCHITECT IF THERE ARE ANY INADEQUATE AMENITIES.
- 9. PLANT MATERIAL SHALL NOT BE DELIVERED TO THE SITE NOR INSTALLED WHEN TEMPERATURES ARE ABOVE 90°F OR BELOW 40°F AT THE TIME OF PLANTING AND FORECASTED FOR A PERIOD OF 2 WEEKS AFTER INSTALLATION.

**BOTANICAL NAME** 

Malus x 'Adirondack'

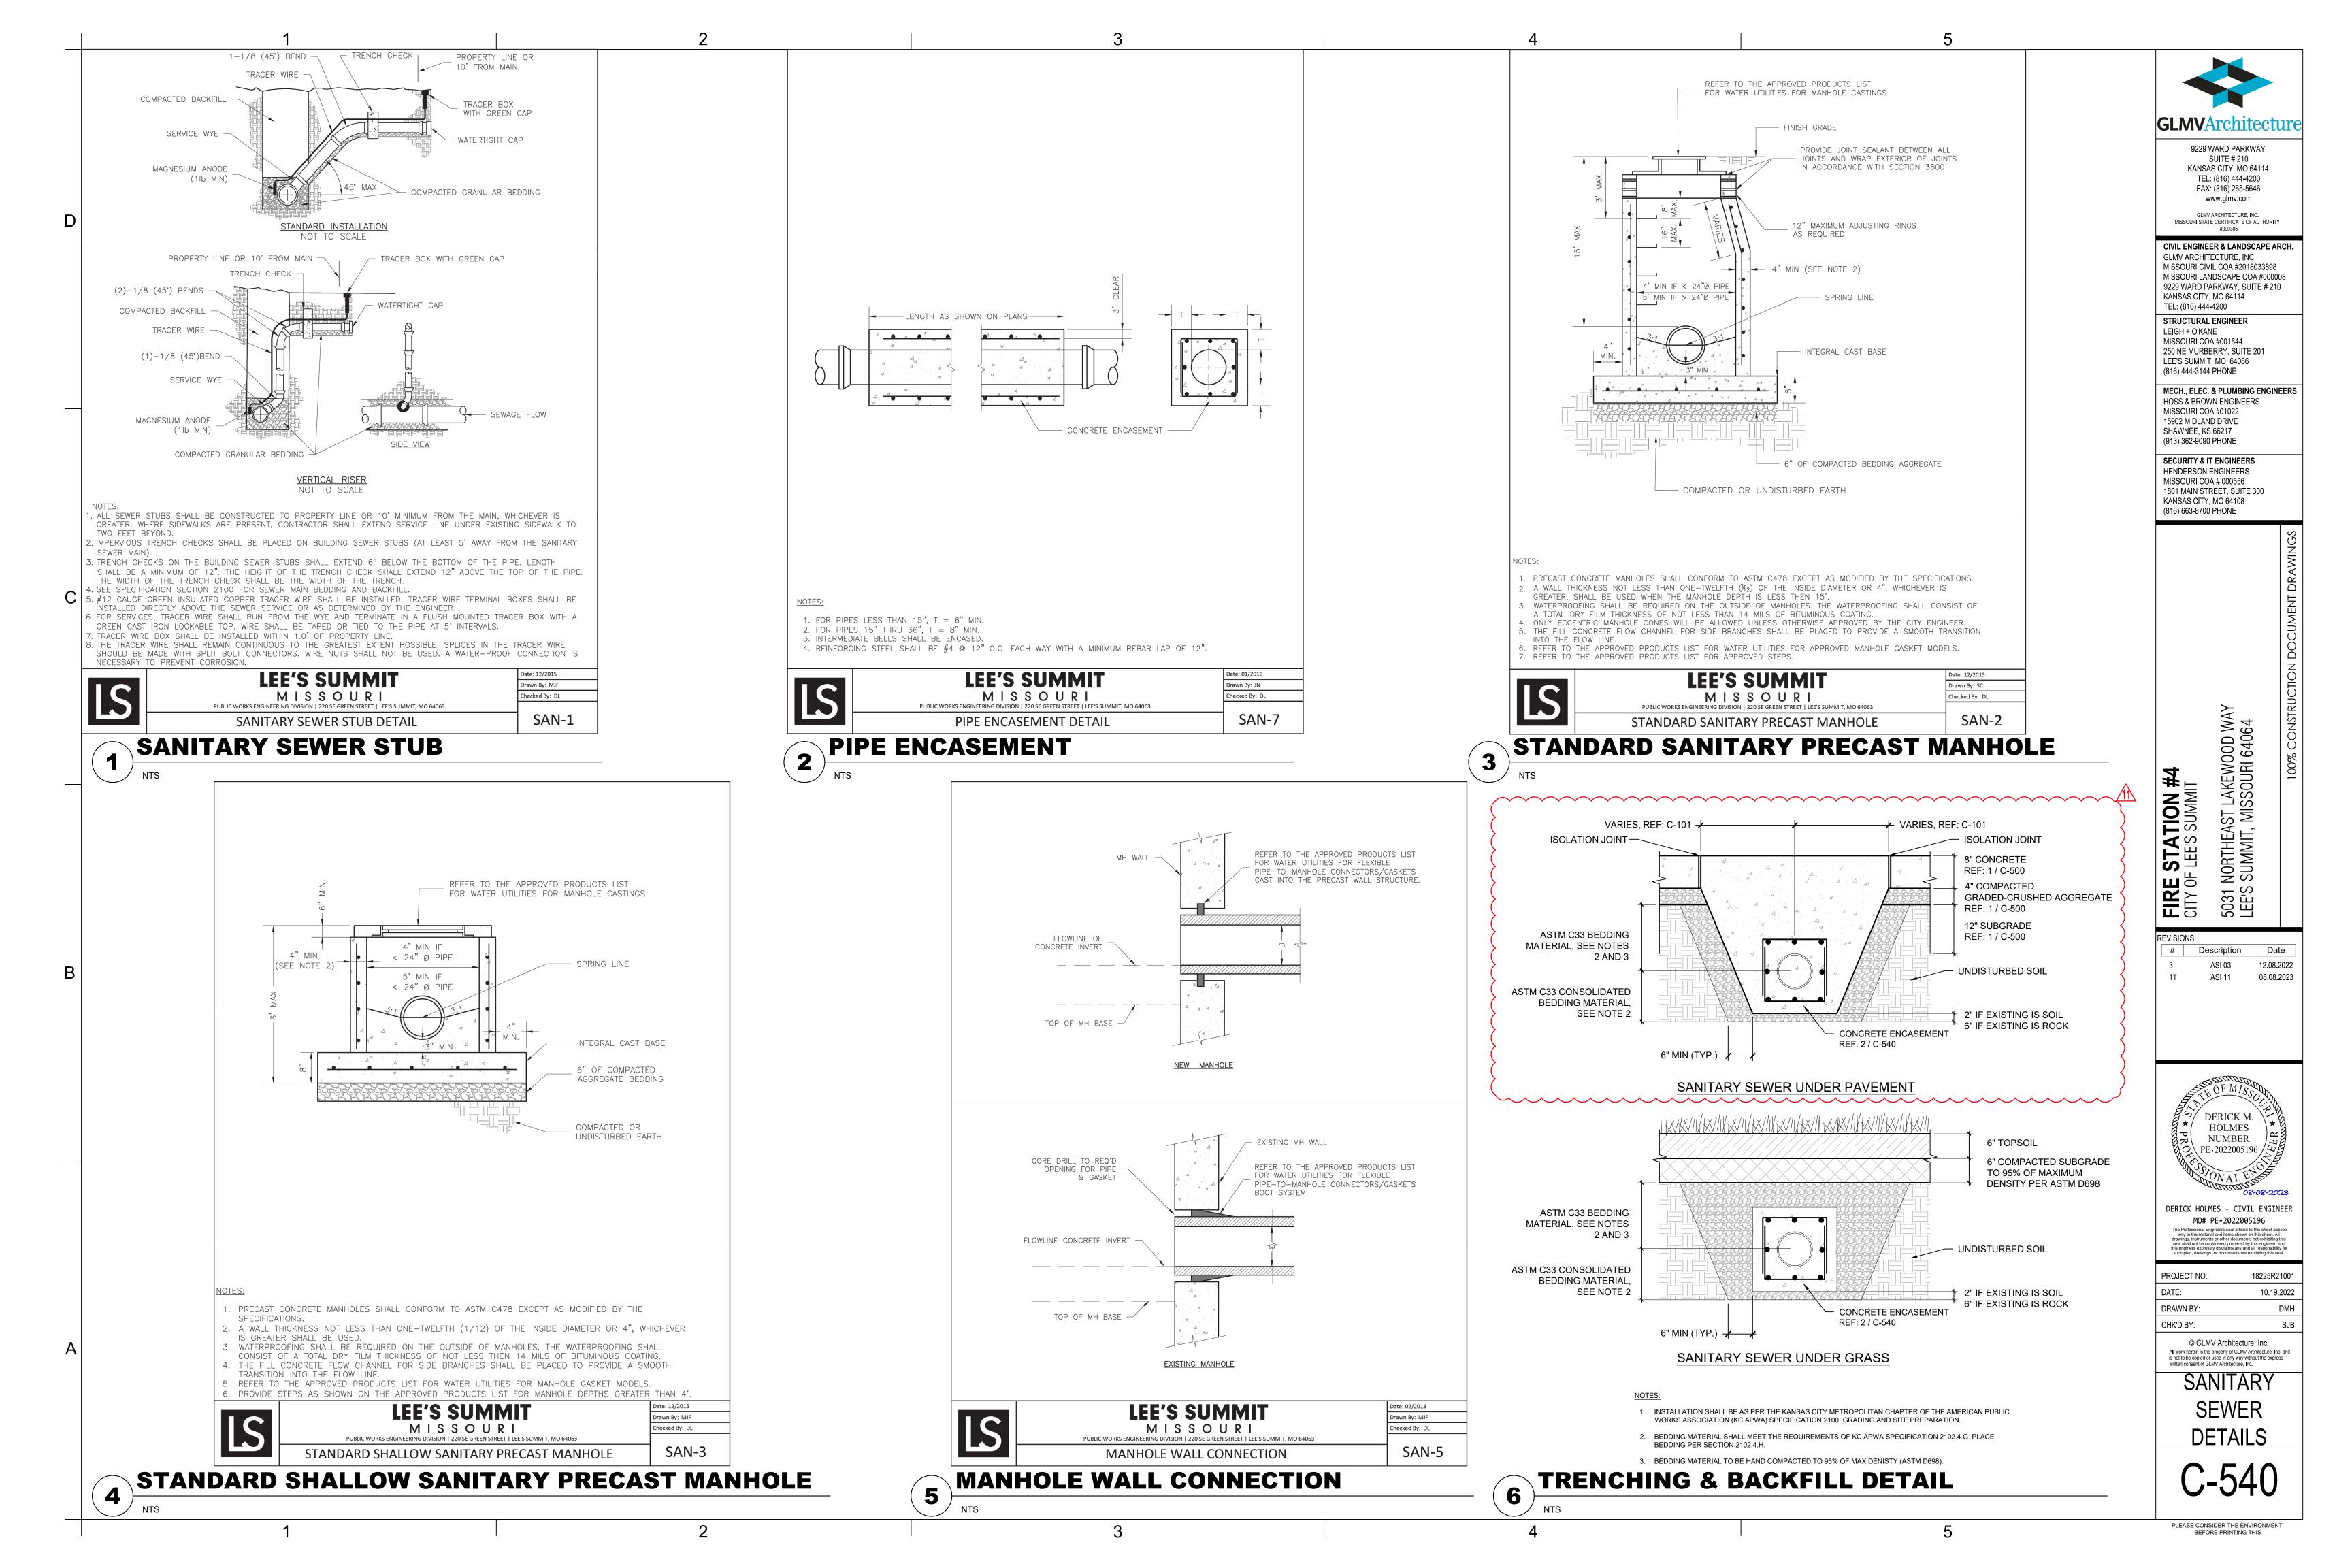**BOTANICAL NAME** 

BOTANICAL NAME

Hosta x 'First Frost'

Rosa x `Knockout` TM

**BOTANICAL NAME** 

Festuca glauca `Elijah Blue

Sporobolus heterolepis

**BOTANICAL NAME** 

BOTANICAL NAME

Festuca arundinacea

Juniperus chinensis 'Gold Lace'

Juniperus horizontalis 'Andorra'

90% Fescue, 10% Bluegrass Mix

Cornus sericea 'Artic Fire'

Euonymus alatus 'Compactus'

Hemerocallis x 'Stella de Oro'

Itea virginica `Little Henry` TM

Perovskia atriplicifolia `Little Spire` TM

Calamagrostis x acutiflora `Karl Foerster

Schizachyrium scoparium 'Prairie Munchkin'

Nyssa sylvatica `Wildfire

Zelkova serrata 'Musashino

Picea pungens 'Baby Blue'

Thuja occidentalis 'Smaragd'

10. CONTRACTOR TO PROVIDE A 1-YEAR WARRANTY ON ALL INSTALLED PLANTINGS FROM POINT OF SUBSTANTIAL COMPLETION.

PLANT SCHEDULE

CODE

NW

PΒ

TS

CODE

Ck

EVERGREEN

SHRUBS

# **PLANTING NOTES**

**COMMON NAME** 

Black Gum

**COMMON NAME** 

**COMMON NAME** 

Artic Fire Dogwood

Compact Burning Bush

Stella de Oro Daylily

First Frost Hosta

Virginia Sweetspire

**COMMON NAME** 

Feather Reed Grass

Elijah Blue Fescue

Prairie Dropseed

COMMON NAME

Gold Lace Juniper

Andorra Juniper

**COMMON NAME** 

Tall Fescue

Prairie Munchkin Little Bluestem

Little Spire Russian Sage

Adirondack Crabapple

Musashino Sawleaf Zelkova

Baby Blue Colorado Spruce

Emerald Green Arborvitae

- ALL PLANT MATERIAL SHALL BE OF EXCELLENT QUALITY, FREE OF DISEASE AND INFESTATION, AND TRUE TO TYPE, VARIETY, SIZE SPECIFIED, AND FORM PER THE AMERICAN STANDARD FOR NURSERY STOCK (ANSI Z60.1, CURRENT VERSION), PUBLISHED BY THE AMERICAN NURSERYMEN'S ASSOCIATION.
- 2. PLANT MATERIAL SHALL BE PLANTED AND MAINTAINED TO ASNS SPECIFICATIONS.
- 3. CONTRACTOR SHALL VERIFY ALL LANDSCAPE MATERIAL QUANTITIES AND SHALL REPORT ANY DISCREPANCIES IMMEDIATELY TO THE LANDSCAPE ARCHITECT.
- 4. NO SUBSTITUTIONS FOR VARIETY OR CULTIVAR SHALL BE ACCEPTED WITHOUT FIRST OBTAINING WRITTEN APPROVAL FROM LANDSCAPE ARCHITECT.
- 5. ALL TREES AND SHRUBS SHALL BE LAID OUT IN A UNIFORM AND CONSISTENT PATTERN, FOLLOWING THE LANDSCAPE PLAN ACCURATELY, PAYING ATTENTION TO EVEN SPACING IN THE ROW OR COVERAGE AREA OF THE INDIVIDUAL SPECIES AND HOW IT IS BEING USED.
- ALL PLANTING BEDS ABUTTING LAWN AREAS SHALL HAVE STEEL EDGING (SEE DETAIL FOR TYPE) INSTALLED AS THE BED EDGE RESTRAINT. NO STEEL EDGING SHALL BE INSTALLED BETWEEN ROCK MULCH AND PAVEMENT
- ALL PLANTINGS SHALL BE THOROUGHLY WATERED IN WITH A GARDEN HOSE, TWICE, THE SAME DAY AS INSTALLATION TO ELIMINATE AIR POCKETS IN THE BACKFILL.
- 8. NO PLANTINGS SHALL BE PLACED CLOSER THAN 3' FROM THE BACK OF THE CURB TO ALLOW FOR VEHICLE BUMPER OVERHANG.
- 9. PROPOSED TREES SHALL NOT BE PLACED OVER EXISTING OR PROPOSED UTILITY SERVICE LINES. IT IS THE CONTRACTOR'S RESPONSIBILITY TO UNDERSTAND UTILITY LOCATIONS AND HAVE THEM MARKED DURING TREE PLANTING OPERATIONS. IF UTILITY IS DAMAGED DURING PLANTING, CONTRACTOR IS RESPONSIBLE FOR NOTIFYING THE GENERAL CONTRACTOR AND OWNER OF UTILITY AND PAYING FOR REPAIR OF THE DAMAGED UTILITY.
- 10. ALL PLANTING BEDS SHALL BE MULCHED WITH A 3" DEEP LAYER OF MISSOURI RIVER ROCK (1/2" - 1 1/4" IN SIZE) AT THE CONCLUSION OF THE PLANTING OPERATIONS. PLACE ROCK MULCH OVER GÉOTEXTILE FABRIC.
- 11. ALL TREES SHALL HAVE A 5'-0" DIAMETER MULCH RING WITH A CULTIVATED EDGE, SEE DETAIL 6/L-100. MULCH SHALL BE A 3" DEEP LAYER OF BROWN, DOUBLE GROUND, HARDWOOD, 1" DIAMETER IN SIZE OR SMALLER INSTALLED AT THE CONCLUSION OF ALL PLANTING OPERATIONS.

CONT SIZE

B & B 2.5"

2.5"

6` Ht

SPACING

48" o.c.

72" o.c.

18" o.c.

30" o.c.

36" o.c.

24" o.c.

48" o.c.

SPACING

36" o.c.

18" o.c.

30" o.c.

SPACING

60" o.c.

48" o.c.

B & B

B & B

<u>CONT</u>

B & B

5 gal

5 gal

Quart

2 gal

2 gal

2 gal

2 gal

CONT.

3 gal.

2 gal

CONT.

2 gal

SIZE

B&B 6 Ht

**GLMV**Architecture 9229 WARD PARKWAY SUITE # 210 KANSAS CITY, MO 64114

> www.glmv.com GLMV ARCHITECTURE, INC.

TEL: (816) 444-4200

FAX: (316) 265-5646

MISSOURI STATE CERTIFICATE OF AUTHORITY

CIVIL ENGINEER & LANDSCAPE ARCH. GLMV ARCHITECTURE, INC MISSOURI CIVIL COA #2018033898

MISSOURI LANDSCAPE COA #000008 9229 WARD PARKWAY, SUITE # 210 KANSAS CITY, MO 64114 TEL: (816) 444-4200

STRUCTURAL ENGINEER LEIGH + O'KANE MISSOURI COA #001644 250 NE MURBERRY, SUITE 201

LEE'S SUMMIT, MO, 64086 (816) 444-3144 PHONE

**MECH., ELEC. & PLUMBING ENGINEERS HOSS & BROWN ENGINEERS** 

MISSOURI COA #01022 15902 MIDLAND DRIVE SHAWNEE, KS 66217 (913) 362-9090 PHONE

**SECURITY & IT ENGINEERS** HENDERSON ENGINEERS MISSOURI COA # 000556 1801 MAIN STREET, SUITE 300

KANSAS CITY, MO 64108 (816) 663-8700 PHONE

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KYLE WARD - LANDSCAPE ARCHITEC MO# PLA-2016002020

such plan, drawings, or documents not exhibiting this sea

PROJECT NO: 18225R21001 DATE: 10.19.2022 DRAWN BY: KDW CHK'D BY: CDW © GLMV Architecture, Inc.

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**SCHEDULE** 

17,029 sf

<u>QTY</u>

<u>QTY</u>

LANDSCAPE SCHEDULE

PLEASE CONSIDER THE ENVIRONMENT

CULTIVATED EDGE

STEEL EDGING

