


LEGEND:	
A/E	- ACCESS EASEMENT
BC	- BACK OF CURB
B/B	- BACK TO BACK
BM	- BENCHMARK
BL or B.L.	- BUILDING LINE
CO	- CLEANOUT
TJB	- TELEPHONE JUNCTION BOX
C&G	- CURB AND GUTTER
D/E	- DRAINAGE EASEMENT
E/E	- ELECTRICAL EASEMENT
EL	- ELEVATION
FL	- FLOW LINE
G/E	- GAS LINE EASEMENT
HDPE	- HIGH-DENSITY POLYETHYLENE
UE	- LANDSCAPE EASEMENT
MSFE	- MINIMUM SERVICEABLE FLOOR ELEVATION
PVC	- POLYVINYL CHLORIDE
P/L	- PROPERTY LINE
PUB/E	- PUBLIC EASEMENT
RCP	- REINFORCED CONCRETE PIPE
ROW or R/W	- RIGHT-OF-WAY
S/E	- SANITARY SEWER EASEMENT
SL	- SERVICE LINE
S/W	- SIDEWALK
TE	- TOP ELEVATION
U/E	- UTILITY EASEMENT
WSE	- WATER SURFACE ELEVATION
W/E	- WATERLINE EASEMENT
ASPHALT PAVEMENT - EXISTING	
ASPHALT PAVEMENT - PROPOSED	
CONCRETE PAVEMENT - EXISTING	
ASPHALT PAVEMENT - EXISTING	
CONCRETE SIDEWALK - EXISTING	
CONCRETE SIDEWALK - PROPOSED	
CURB & GUTTER	
CURB & GUTTER - EXISTING	
TREELINE	
EXISTING LOT AND R/W LINES	
EXISTING PLAT LINES	
PROPERTY LINES	
RIGHT-OF-WAY	
SANITARY SEWER MAIN	
SANITARY SEWER MAIN - EXIST.	
STORM SEWER	
STORM SEWER - EXISTING	
CABLE TV - EXISTING	
FIBER OPTIC CABLE - EXISTING	
TELEPHONE LINE - EXIST.	
ELECTRIC LINE - EXISTING	
OVERHEAD POWER LINE - EXIST.	
UNDERGROUND ELECTRIC - EX.	
GAS LINE - EXISTING	
WATERLINE - EXISTING	
LIGHT - EXISTING	
EXISTING MANHOLE	
CLEANOUT	
EXISTING SANITARY MANHOLE	
PROPOSED SANITARY MANHOLE	
EXISTING AREA INLET	
EXISTING CURB INLET	
EXISTING GRATE INLET	
EXISTING JUNCTION BOX	
EXISTING STORM MANHOLE	

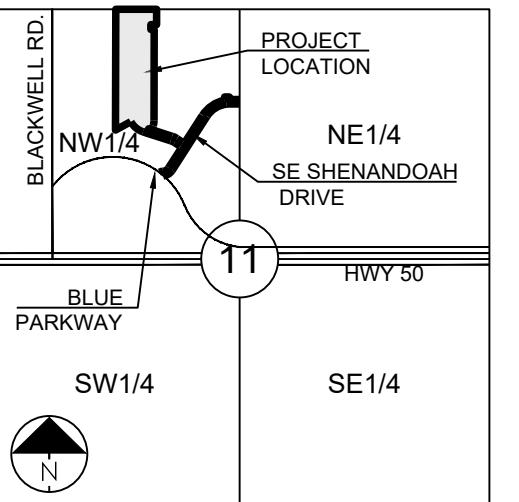

SECTION 11-47-31

LOCATION MAP

SCALE 1" = 2000'

UTILITY CONTACTS:

MISSOURI DEPARTMENT OF TRANSPORTATION (MODOT)

Steve Holloway
600 NE Coborn Road
Lee's Summit, MO 64086
(816) 607-2186

SPIRE

Brent Jones
3025 SE Clover Drive
Lee's Summit, MO 64082
(816) 399-0663 brent.jones@spireenergy.com

EVERGY

Philip Ingram
1300 SE Hamblin Road
Lee's Summit, MO 64081
Office: (816) 347-3474-4339
philip.ingram@evergy.com

CITY OF LEE'S SUMMIT PUBLIC WORKS

Dena Mezger
220 SE Green Street
Lee's Summit, MO 64063
(816) 969-1800

AT&T

Mark Manion or Marty Loper
500 E. 8th Street, Room 370
Kansas City, MO 64106
(816) 275-2341 or (816) 275-1550

COMCAST CABLE

John Meadows
4700 Little Blue Parkway
Independence, MO 64057
(816) 795-2257

CITY OF LEE'S SUMMIT WATER UTILITIES

Mark Schaefer
1200 SE Hamblin Road
Lee's Summit, MO 64081
(816) 969-1900



811 or
1-800-344-7483
mo1call.com

SUMMARY OF QUANTITIES			
ITEM	QUANTITY	UNITS	
1 EARTHWORK (FINAL GRADING)	1	LS	
2 INSTALL 6" TYPE 5 BASE	5,580	SY	
3 INSTALL 9" SUBGRADE STABILIZATION	5,580	SY	
4 INSTALL 4" TYPE 5 BASE	2,988	SY	
5 INSTALL 6" SUBGRADE STABILIZATION	2,988	SY	
6 INSTALL 2" TYPE 5 OR 6 ASPHALT PAVEMENT	4,538	SY	
7 INSTALL 4" TYPE 5 ASPHALT PAVEMENT	4,538	SY	
8 INSTALL 6" PCC PAVEMENT	2,769	SY	
9 INSTALL 8" PCC DRIVEWAY	58	SY	
10 INSTALL TYPE CG-2 CURB AND GUTTER	3,011	LF	
11 INSTALL 5' CONCRETE SIDEWALK	293	LF	
12 INSTALL TYPE A SIDEWALK RAMPS	4	EA	
13 INSTALL 6'x4' CURB INLET	9	EA	
14 INSTALL 4'x4' AREA INLET	1	EA	
15 INSTALL 4'x4' GRADE INLET	4	EA	
16 INSTALL 15" HDPE	1,260	LF	
17 INSTALL 18" HDPE	158	LF	
18 INSTALL 24" HDPE	271	LF	
19 INSTALL 30" HDPE	114	LF	
20 TRENCHING UNDER FUTURE STREET	913	LF	
21 EROSION CONTROL (MAINTENANCE & REMOVAL)	1	LS	
22 SEED & MULCH DISTRIBUTED AREAS	1	LS	
23 PERMANENT STREET SIGNING	1	LS	

STREET AND STORM SEWER PLANS FOR **BLACKWELL RESERVE** IN THE CITY OF LEE'S SUMMIT JACKSON COUNTY, MO

RELEASED FOR CONSTRUCTION
As Noted on Plan Review
Development Services Department
Lee's Summit, Missouri
09/21/2023

Sheet List Table	
Sheet Number	Sheet Title
1	COVER SHEET
2	GENERAL LAYOUT
3	OVERALL GRADING PLAN
4	MASTER DRAINAGE PLAN - GRADING PLAN
5	MASTER DRAINAGE PLAN - OVERALL DRAINAGE MAP
6	MASTER DRAINAGE PLAN - DRAINAGE MAP
7	FIRE ROAD GRADING PLAN
8	PRE-CONSTRUCTION EROSION CONTROL PLAN
9	EROSION CONTROL PLAN
10	POST-CONSTRUCTION EROSION CONTROL PLAN
11	FIRE ROAD EROSION CONTROL PLAN
12	SE WOOD LANE (PUBLIC) - PLAN & PROFILE
13	NEW ALLEY (PRIVATE) - PLAN & PROFILE
14	SE 6TH STREET (PRIVATE) - PLAN & PROFILE
15	FIRE ROAD - PLAN & PROFILE
16	INTERSECTION DETAILS
17	INTERSECTION DETAILS
18	INTERSECTION DETAILS
19	STREET DETAILS
20	STREET DETAILS
21	STORM PLAN
22	STORM CALCS
23	STORM CALCS
24	STORM PROFILES
25	STORM PROFILES
26	STORM DETAILS
27	STORM DETAILS
28	STREET SIGN PLAN
29	STREET SIGN DETAILS
30	LANDSCAPE PLAN



PREPARED BY:
MARK ALLEN BREUER
PE-2009007268
09.06.2023
SCHLAGEL & ASSOCIATES, P.A.

BLACKWELL RESERVE LEE'S SUMMIT, MO STREET AND STORM SEWER PLANS

DESCRIPTION	PER CITY COMMENTS	PER CITY COMMENTS	PER CITY COMMENTS
REVISION DATE	09/05/2023	09/27/2023	09/06/2023
DRAWN BY:	TRC	JAC	JAC
CHECKED BY:			
MAB			
DATE PREPARED	09/05/2023	09/27/2023	09/06/2023
PROJ. NUMBER:	PL2023051	PRSUBD20231351	22-093
COVER SHEET	SHEET	SHEET	SHEET

1

DESIGN SPEED = 30 MPH

POSTED SPEED = 25 MPH

PL2023051
PRSUBD20231351

MO GRS BENCHMARK:

STATION NAME - JA-90


KC METRO ALUMINUM GRS DISK SET IN CONCRETE STAMPED "JA-90, 1988"
LOCATED NEAR THE INTERSECTION OF LANGSFORD ROAD AND OLD
LANGSFORD ROAD, 43 FEET SOUTHEAST OF THE CENTER OF LANGSFORD ROAD.
N:1001052.8503, E:2845604.8272

ELEV. 997.045

PROJECT BENCHMARK:

"SQUARE" CUT IN TOP OF CONCRETE STORM MANHOLE
STORM MANHOLE IS LOCATED APPROX. 130 FEET EAST OF THE
INTERSECTION OF SE JOEL AVE & BLUE PARKWAY AND 26 FEET SOUTH
OF THE CENTERLINE OF BLUE PARKWAY.
N:996874.9600, E:2840937.1365

ELEV. 1005.719

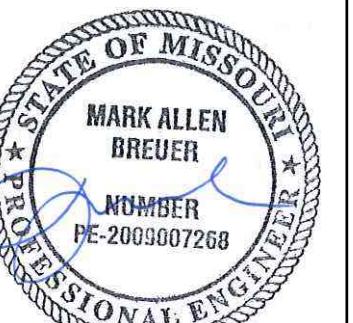
PREPARED BY:

MARK ALLEN BREUER
NUMBER PE-2009007268
09.06.2023

SCHLAGEL & ASSOCIATES, P.A.

**BLACKWELL RESERVE
STREET AND STORM SEWER PLANS**

SE SHENANDOAH DRIVE LEE'S SUMMIT, MO

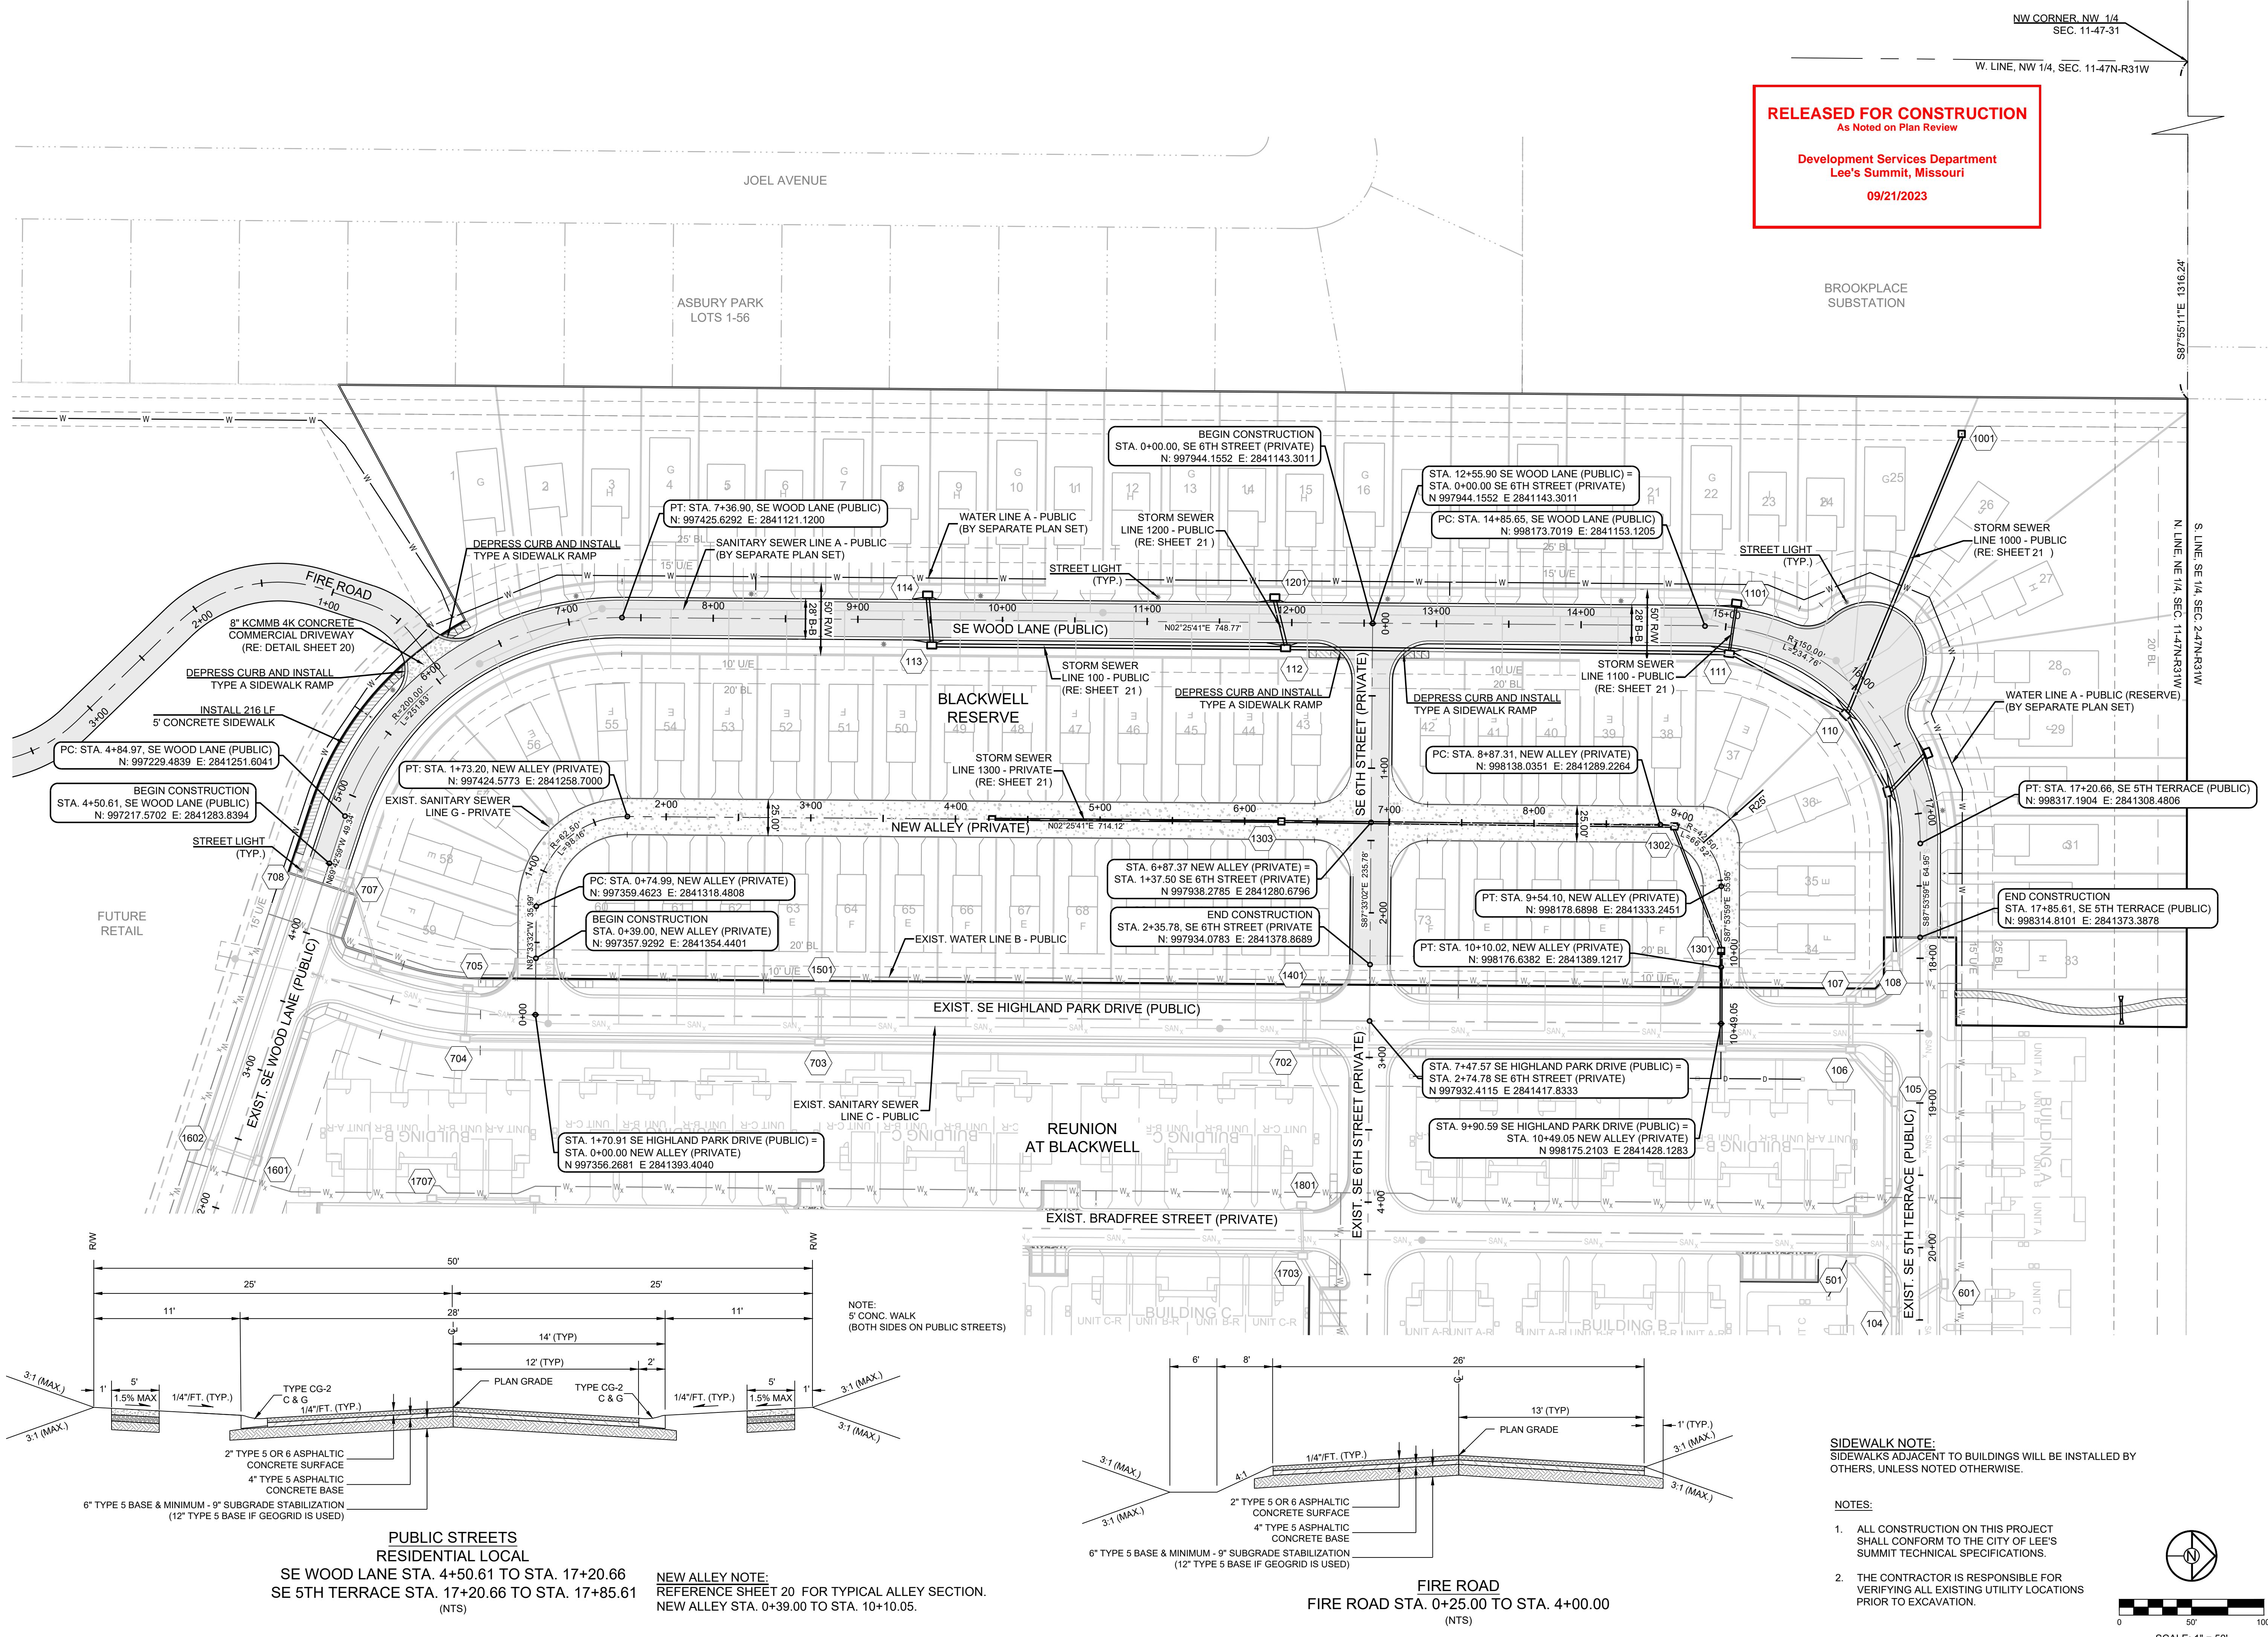RELEASED FOR CONSTRUCTION
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Lee's Summit, Missouri
09/21/2023



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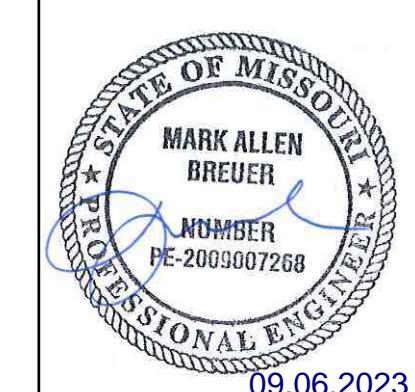
Lee's Summit, Missouri

09/21/2023

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ENGINEERS PLANNERS SURVEYORS LANDSCAPE ARCHITECTS

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(913) 492-5158 • Fax: (913) 492-3400
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MAILING ADDRESS: 14920 W 107TH ST, SUITE 200, LENEXA, KS 66215
#E2020038005 F BLAC2010000237 4LS202008859-F

PREPARED BY:



SCHLAGEL & ASSOCIATES, P.A.

**BLACKWELL RESERVE
STREET AND STORM SEWER PLANS**

SE SHENANDOAH DRIVE LEE'S SUMMIT, MO



GRADING LEGEND:

- 1000 — EXISTING CONTOUR
— 1000 — PROPOSED CONTOUR (FINISHED GRADE)

NOTES:

1. ALL CONSTRUCTION ON THIS PROJECT SHALL CONFORM TO THE CITY OF LEE'S SUMMIT TECHNICAL SPECIFICATIONS.
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MO GRS BENCHMARK:

STATION NAME - JA-90

KC METRO ALUMINUM GRS DISK SET IN CONCRETE STAMPED "JA-90, 1988" LOCATED NEAR THE INTERSECTION OF LANGSFORD ROAD AND OLD LANGSFORD ROAD, 43 FEET SOUTHEAST OF THE CENTERLINE OF LANGSFORD ROAD AND 32 FEET NORTH OF THE CENTER OF OLD LANGSFORD ROAD.
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N:996874.9690, E:2840937.1365

ELEV. 1005.719

OVERALL GRADING PLAN	
DRAWN BY: TRC	REVISION DATE 09/05/2023

09/05/2023

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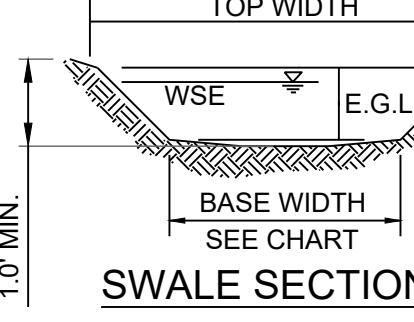
PREPARED BY:

 MARK ALLEN BREUER
 NUMBER PE-2009007268
 09.06.2023

**BLACKWELL RESERVE
STREET AND STORM SEWER PLANS
SE SHENANDOAH DRIVE LEE'S SUMMIT, MO**

DRAWN BY:	REVISION DATE	DESCRIPTION
TRC	05/05/2023	PER CITY COMMENTS
	05/22/2023	PER CITY COMMENTS
	06/06/2023	PER CITY COMMENTS
CHECKED BY:		
MAB	4	
DATE PREPARED:		
05/05/2023		
PROJ. NUMBER:		
22-093		
MASTER DRAINAGE PLAN - GRADING PLAN		
Sheet		

4



RUNOFF CALCULATIONS:
 $Q = K * C * I * A$
 $K_{100} = 1.25$ $I_{100} = 1.0$ $C = 0.51$
 $I_0 = 7.35$ $I_{100} = 10.32$
 $VELOCITY HEAD = (VELOCITY)^2 / 64.4$
 $EGL = DEPTH + VELOCITY HEAD$
 SEE CHART

ENGINEERED CHANNELS															
LOCATION	SECTION	DRAINAGE AREA (AC.)	Q100 (CFS)	Q10 (CFS)	DESIGN OVERFLOW FORMULA	DESIGN OVERFLOW (CFS)	BED SLOPE (%)	SIDE SLOPE (X:1)	BASE WIDTH (FT)	CROSS SECTION AREA (FT²)	TOP WIDTH (FT)	NOMINAL DEPTH (FT.)	AVERAGE VELOCITY (FPS)	VELOCITY HEAD (FT.)	EGL (FT.)
LOT 25	A	1.25	10.64	6.06	Q100(A)	10.64	2.40	5.00	6.00	5.05	11.70	0.38	3.50	0.19	0.57
LOT 33	B	0.40	3.41	1.94	Q100(B)	3.41	2.00	5.00	6.00	2.16	8.90	0.21	2.27	0.08	0.29

NOTES:

1. MBOE = MINIMUM BUILDING OPENING ELEVATION FOR HOUSES ADJACENT TO ENGINEERED OVERFLOW SWALES SHALL BE A MINIMUM OF 2 FEET ABOVE THE WATER SURFACE ELEVATION FOR THE 1% CHANCE STORM EVENT. APPROVED INDIVIDUAL LOT PLOT PLANS MAY ALTER THE CONSTRUCTED SWALES IN ELEVATION (CONTOUR) FROM THE GRADING PLAN AS LONG AS THE MBOE IS ADJUSTED ACCORDING TO THE ABOVE CRITERIA.
2. EGL = ENERGY GRADE LINE (100 YR)
3. MWSE = MAXIMUM WATER SURFACE ELEVATION (100 YR)
4. MBOE'S ADJACENT TO THE SUMPED AREA INLETS SHALL BE A MINIMUM OF 1' ABOVE TOP OF ADJACENT BERM.


RELEASED FOR CONSTRUCTION

As Noted on Plan Review

Development Services Department

Lee's Summit, Missouri

09/21/2023

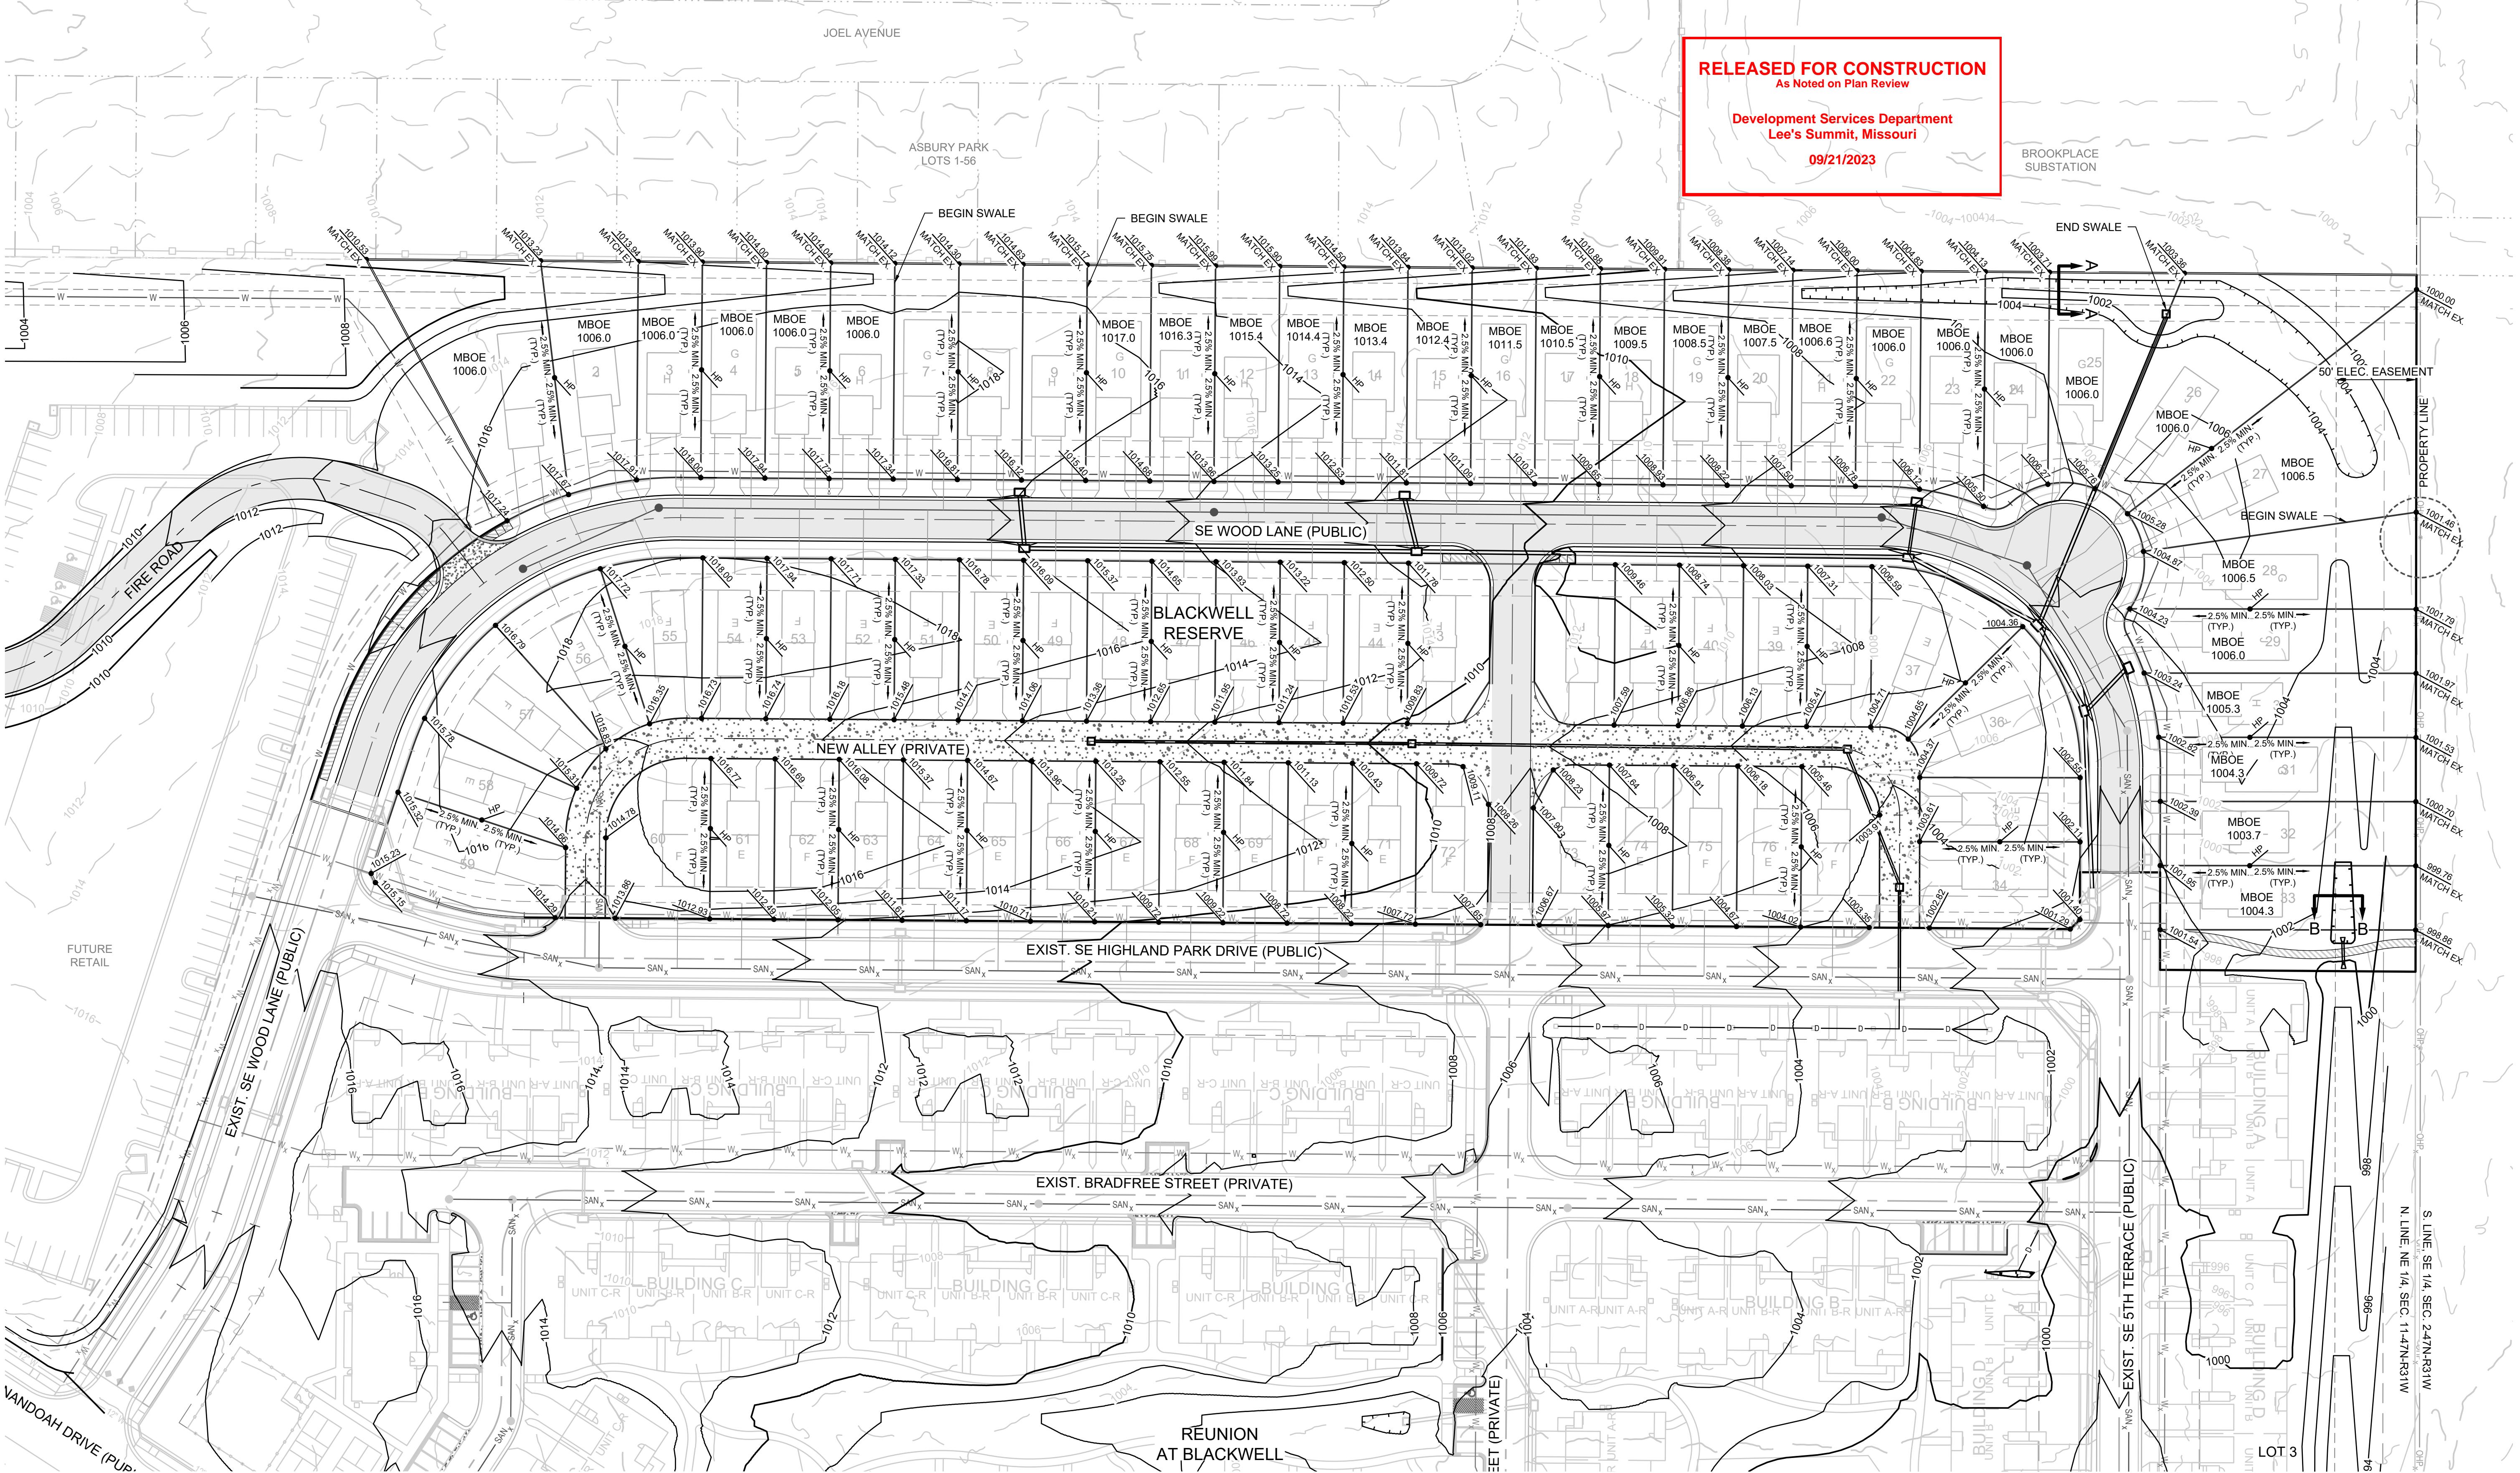

TURF REINFORCEMENT MAT NOTES:

1. REFERENCE "MASS GRADING & EROSION SEDIMENT CONTROL PLANS FOR RESIDENCES, TRADITIONS & RESERVE AT BLACKWELL" FOR TURF REINFORCEMENT MAT INSTALLATION.
2. MAINTAIN, REPAIR AND REPLACE TURF REINFORCEMENT MAT AS NECESSARY.

GRADING LEGEND:

- 1000 — EXISTING CONTOUR
- 1000 — PROPOSED CONTOUR (FINISHED GRADE)

NOTES:

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2. THE CONTRACTOR IS RESPONSIBLE FOR VERIFYING ALL EXISTING UTILITY LOCATIONS PRIOR TO EXCAVATION.

TRANSMISSION EASEMENT NOTES:

1. EXCAVATION NOT PERMITTED WITHIN 25 FEET OF TRANSMISSION POLES.
2. SOIL SHALL NOT COME INTO CONTACT WITH TRANSMISSION POLES.
3. OPERATION OF EQUIPMENT OVER 14 FEET IN HEIGHT WITHIN TRANSMISSION EASEMENT IS NOT PERMITTED.
4. CONSTRUCTION EQUIPMENT SHALL ALWAYS MAINTAIN A MINIMUM DISTANCE OF 20 FEET FROM ENERGIZED TRANSMISSION LINE CONDUCTORS.
5. ALL SPOILS ARE TO BE MAINTAINED OUTSIDE THE TRANSMISSION EASEMENT IMMEDIATELY AFTER EXCAVATION TO ASSURE PROPER CLEARANCES.
6. FOR ADDITIONAL TRANSMISSION EASEMENT ENCROACHMENT REQUIREMENTS SEE <https://www.energy.com/partner-with-us/transmission-projects/transmission-line-easements>

MO GRS BENCHMARK:

STATION NAME - JA-90


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ELEV. 997.045

PROJECT BENCHMARK:

"SQUARE" CUT IN TOP OF CONCRETE STORM MANHOLE STORM MANHOLE IS LOCATED APPROX. 130 FEET EAST OF THE INTERSECTION OF SE JOEL AVE & BLUE PARKWAY AND 26 FEET SOUTH OF THE CENTERLINE OF BLUE PARKWAY. N:996874.9690, E:2840937.1365

ELEV. 1005.719

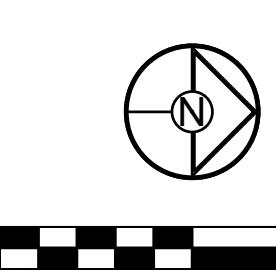

SCALE: 1" = 50'

RELEASED FOR CONSTRUCTION

As Noted on Plan Review

Development Services Department

Lee's Summit, Missouri

09/21/2023

SCHLAGEL
ENGINEERS PLANNERS SURVEYORS LANDSCAPE ARCHITECTS

14920 West 107th Street Lenexa Kansas 66215
(913) 492-5158 • Fax: (913) 492-3400
WWW.SCHLAGELASSOCIATES.COM
#E2020038005 F BLAC201000237 #S202009859-F


PREPARED BY:

MARK ALLEN DREUER
JUNIOR
PROFESSIONAL ENGINEER
09.06.2023

SCHLAGEL & ASSOCIATES, P.A.

**BLACKWELL RESERVE
STREET AND STORM SEWER PLANS**

SE SHENANDOAH DRIVE LEE'S SUMMIT, MO

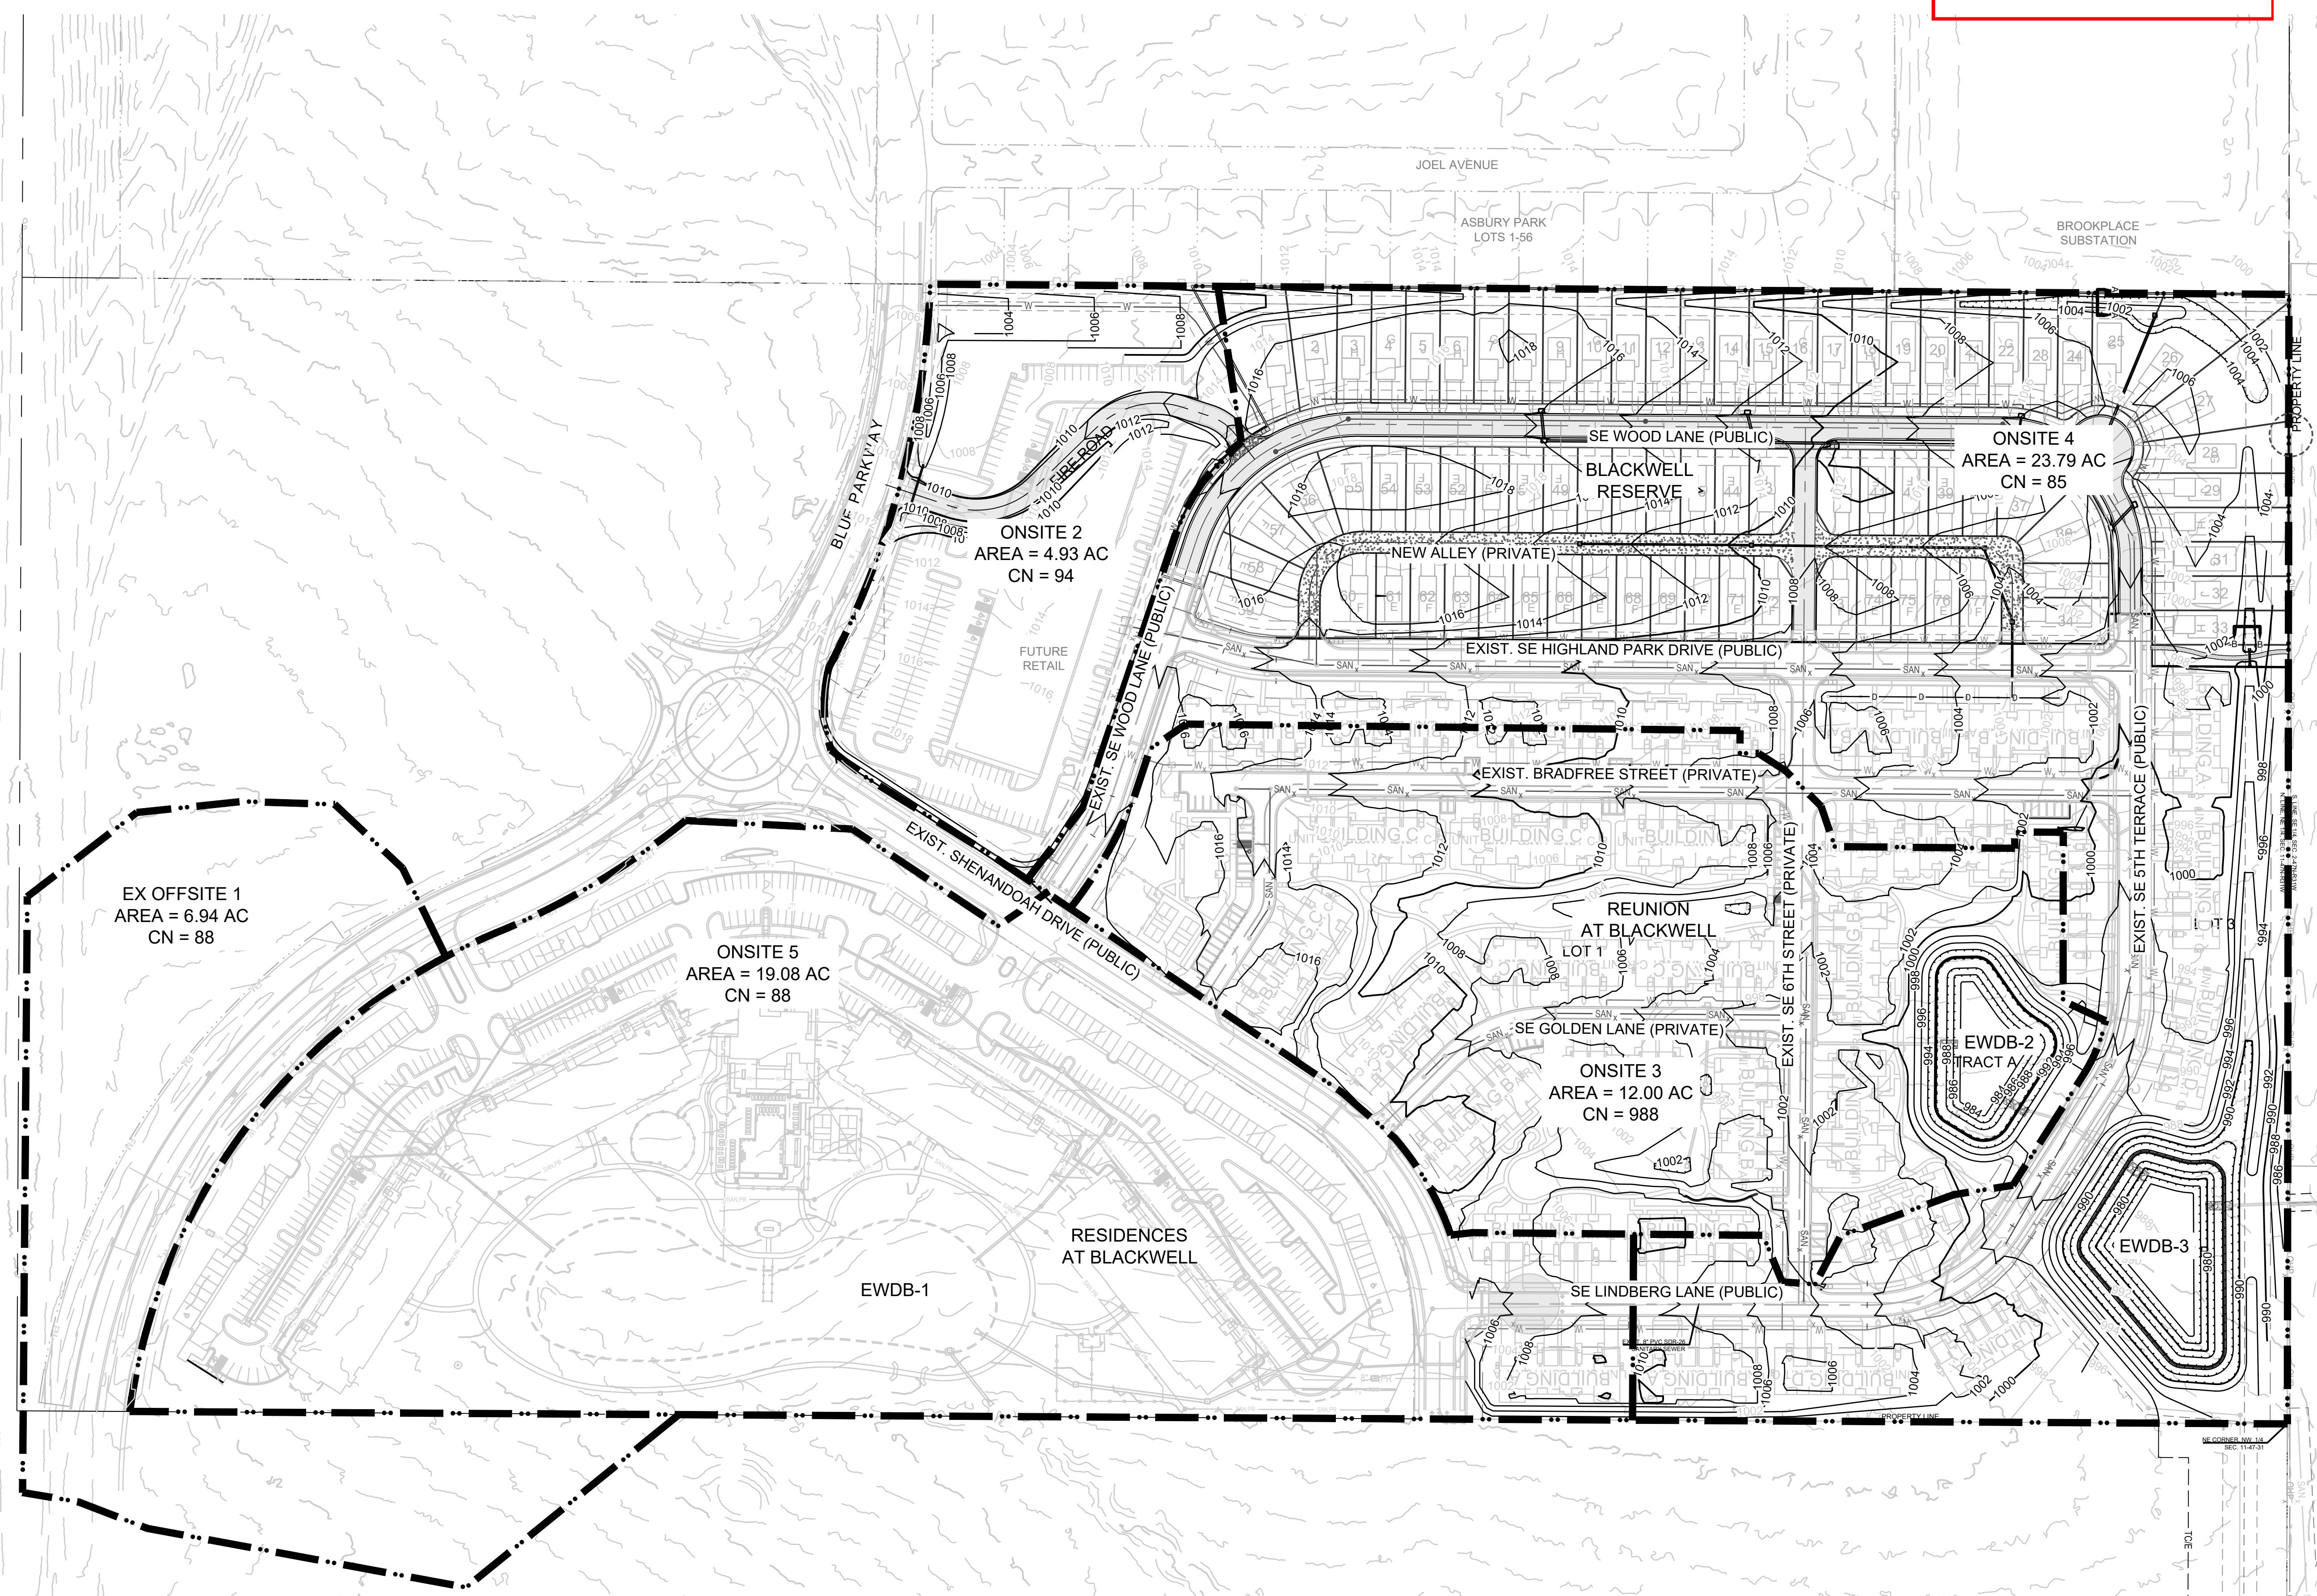

GRADING LEGEND:

- | | |
|----------|-----------------------------------|
| — 1000 — | EXISTING CONTOUR |
| — 1000 — | PROPOSED CONTOUR (FINISHED GRADE) |

NOTES:

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MO GRS BENCHMARK:

STATION NAME - JA-90


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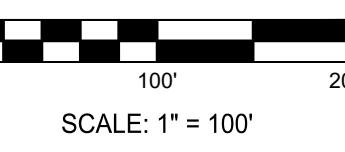


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DRAWN BY:	REVISION DATE	DESCRIPTION
TRC	09/05/2023	PER CITY COMMENTS
CHECKED BY:	09/27/2023	PER CITY COMMENTS
MAB	09/27/2023	PER CITY COMMENTS
DATE PREPARED	09/05/2023	
PROJ. NUMBER	22-093	

MASTER
DRAINAGE PLAN
- OVERALL
DRAINAGE MAP

SHEET

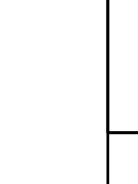

5

100'

SCALE: 1" = 100'

RELEASED FOR CONSTRUCTION
 As Noted on Plan Review


Development Services Department
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**BLACKWELL RESERVE
 STREET AND STORM SEWER PLANS**


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####	09/27/2023	PER CITY COMMENTS
####	09/06/2023	PER CITY COMMENTS
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####		
DATE PREPARED:		
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22-093		


MASTER
 DRAINAGE PLAN
 - DRAINAGE MAP

SHEET

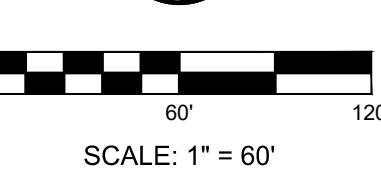

6

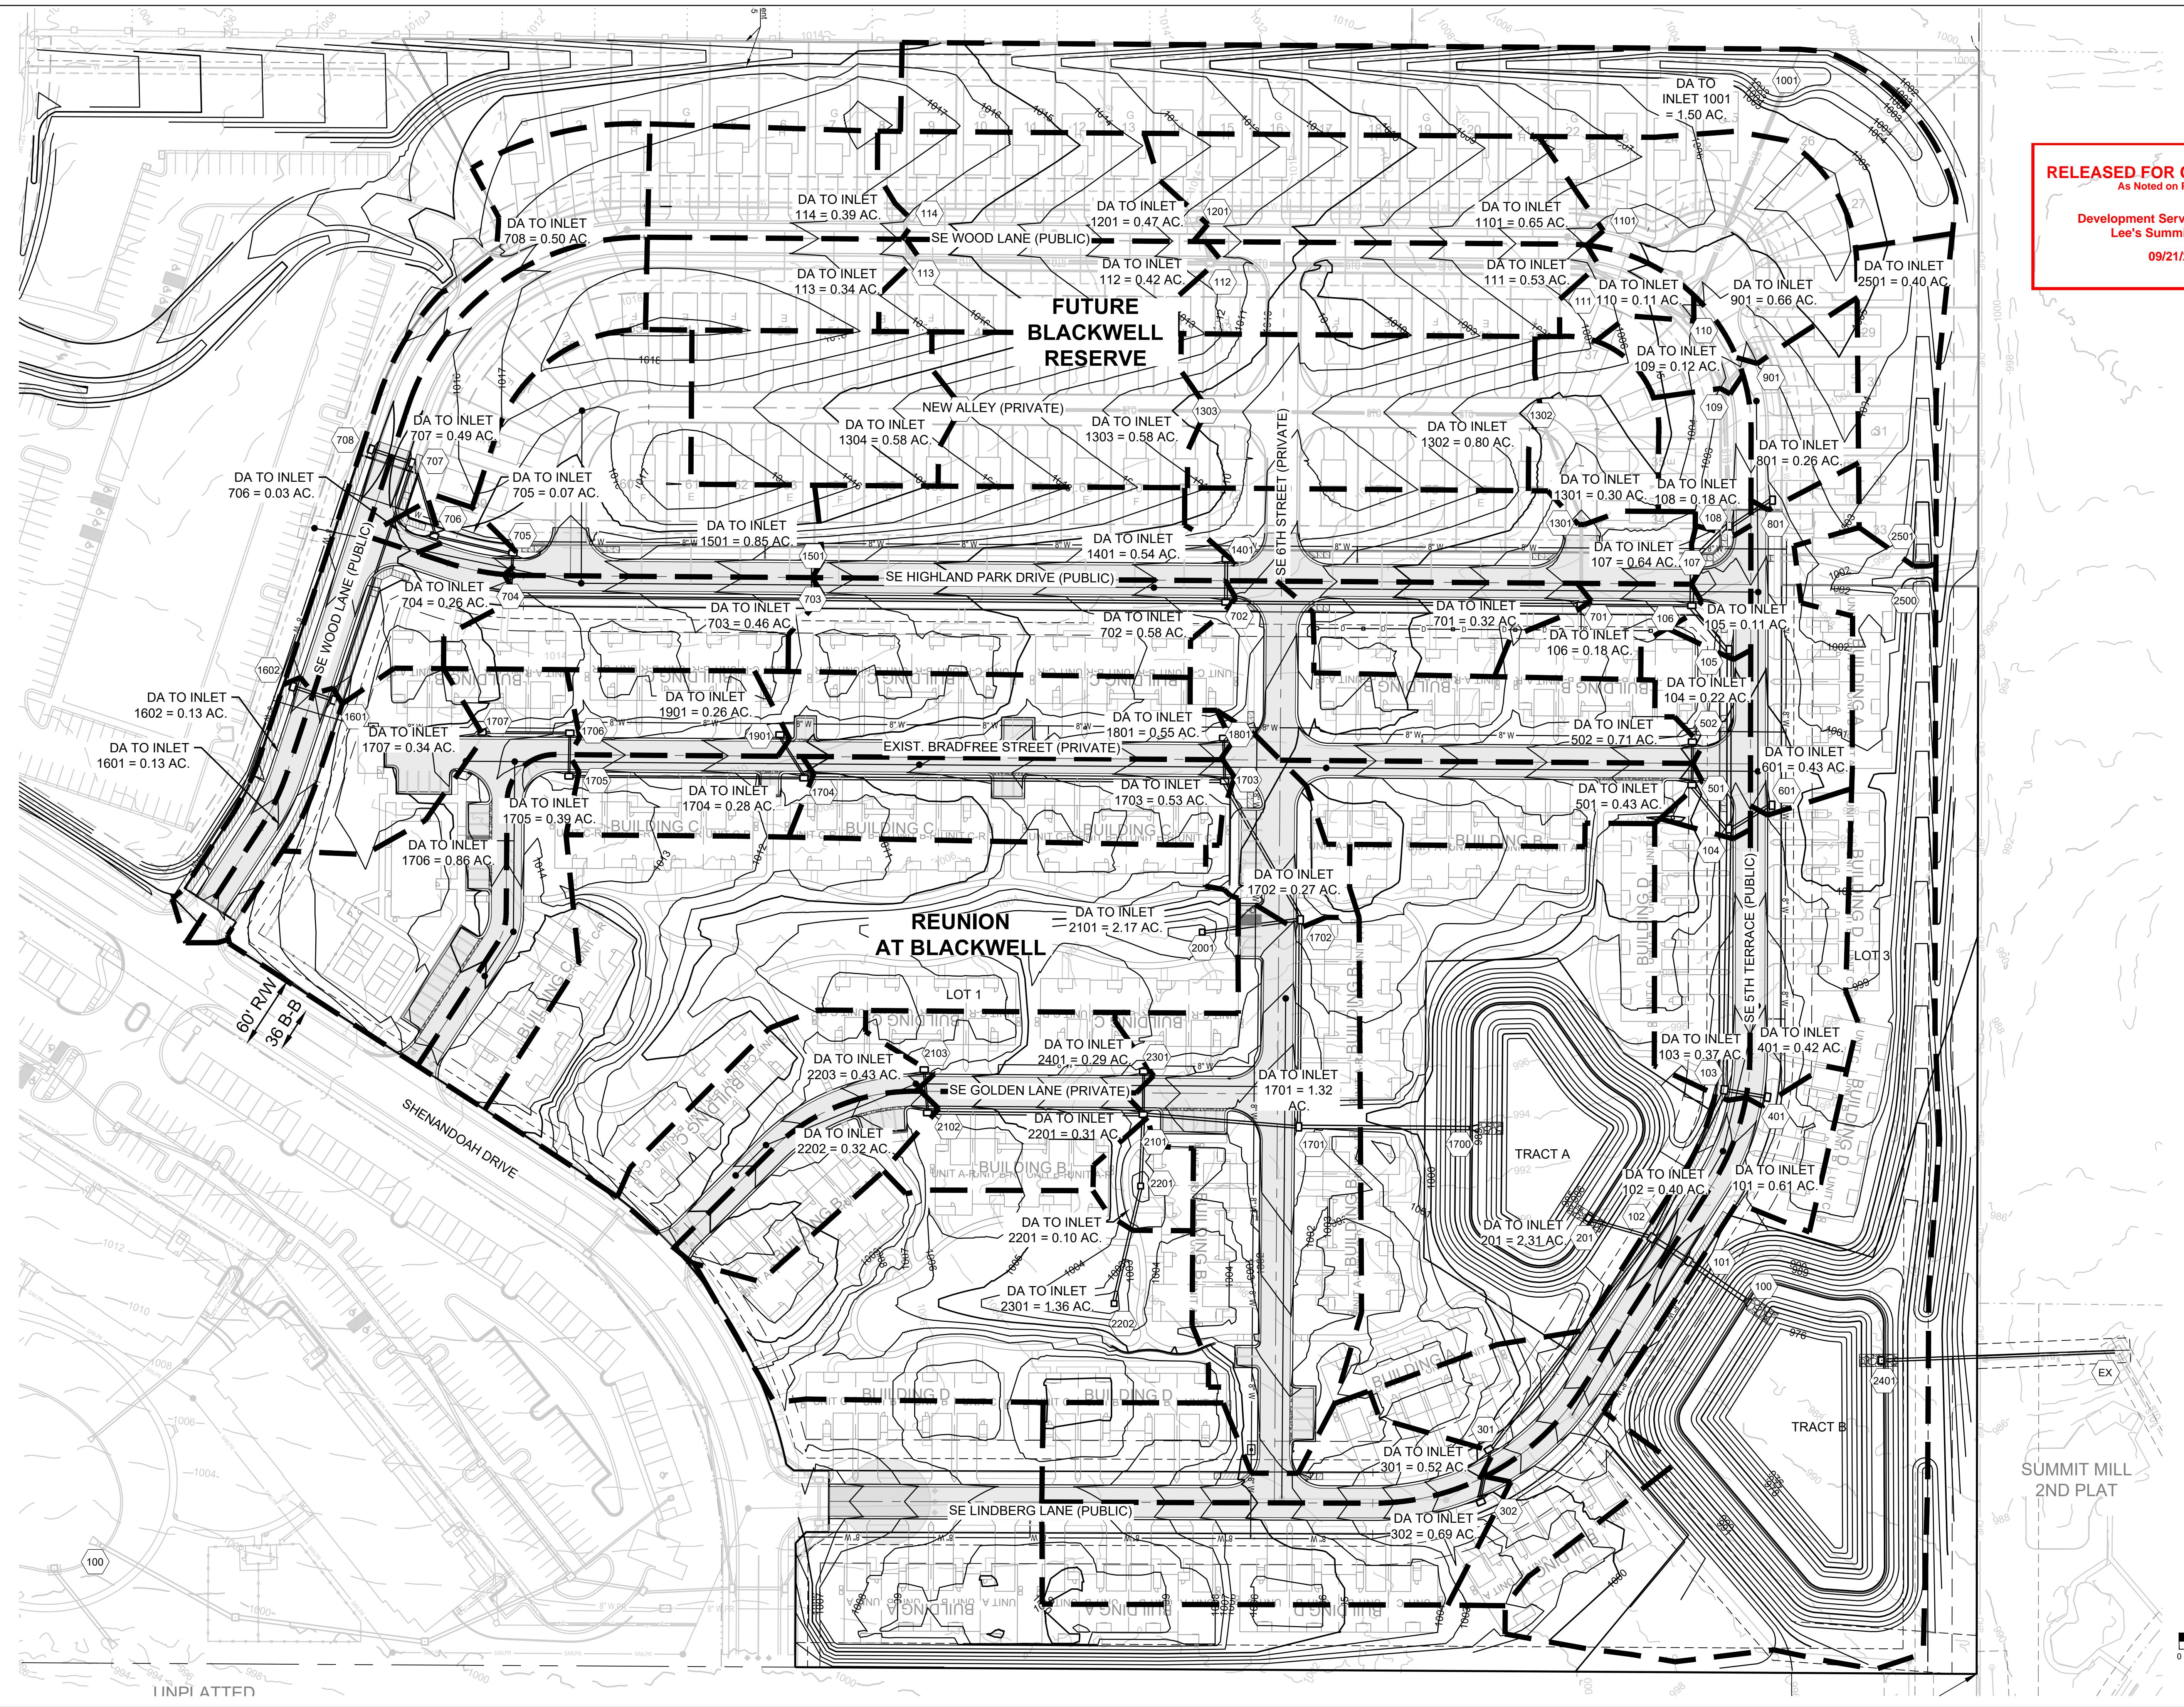

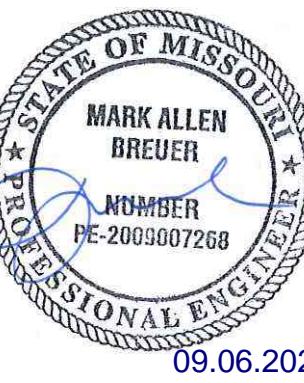PREPARED BY:

 MARK ALLEN DREUER
 NUMBER PE-2009007268
 09.06.2023

SCHLAGEL & ASSOCIATES, P.A.


**BLACKWELL RESERVE
 STREET AND STORM SEWER PLANS
 SE SHENANDOAH DRIVE LEE'S SUMMIT, MO**

DESCRIPTION		REVISION DATE	PER CITY COMMENTS	PER CITY COMMENTS	PER CITY COMMENTS
DRAWN BY:	TRC	09/05/2023			
CHECKED BY:	MAB	09/07/2023			
DATE PREPARED:	09/05/2023				
PROJ. NUMBER:	22-093				

**FIRE ROAD
 GRADING PLAN**

SHEET

7

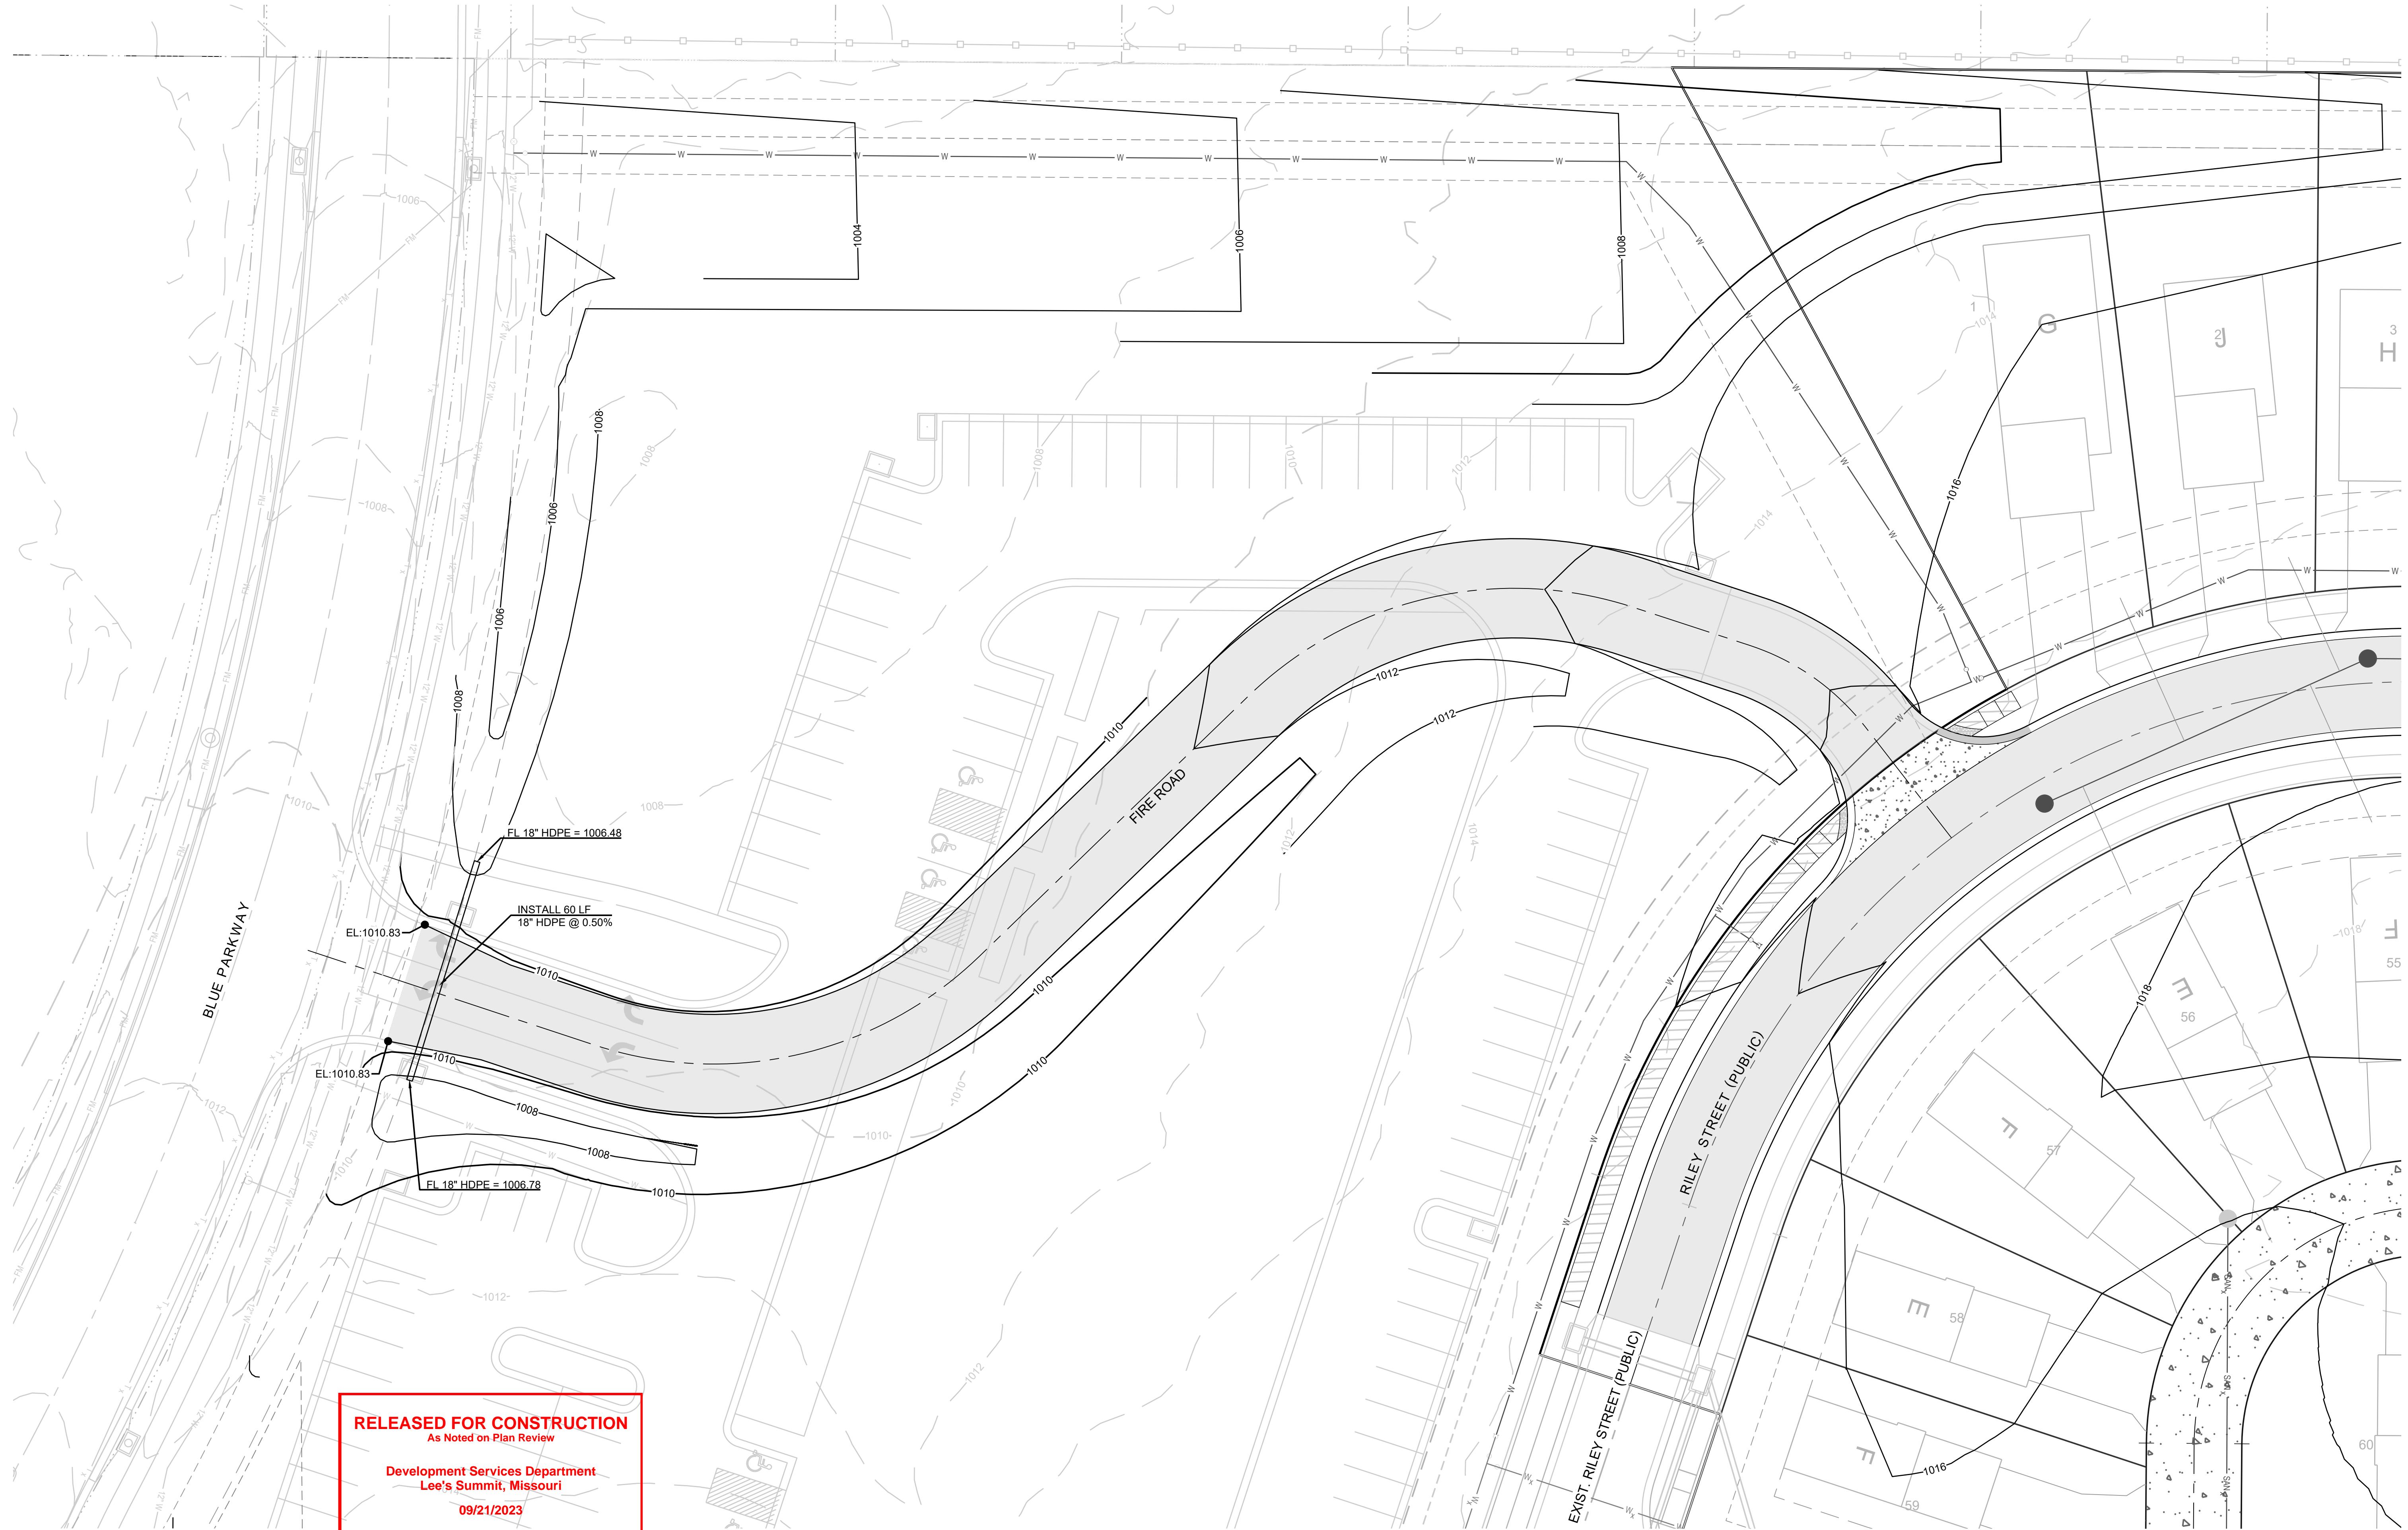

RELEASED FOR CONSTRUCTION

As Noted on Plan Review

Development Services Department

Lee's Summit, Missouri

09/21/2023

GRADING LEGEND:

- 1000 — EXISTING CONTOUR
- 1000 — PROPOSED CONTOUR (FINISHED GRADE)

NOTES:

1. ALL CONSTRUCTION ON THIS PROJECT SHALL CONFORM TO THE CITY OF LEE'S SUMMIT TECHNICAL SPECIFICATIONS.
2. THE CONTRACTOR IS RESPONSIBLE FOR VERIFYING ALL EXISTING UTILITY LOCATIONS PRIOR TO EXCAVATION.

MO GRS BENCHMARK:

STATION NAME - JA-90


KC METRO ALUMINUM GRS DISK SET IN CONCRETE STAMPED "JA-90, 1988" LOCATED NEAR THE INTERSECTION OF LANGSFORD ROAD AND OLD LANGSFORD ROAD, 43 FEET SOUTHEAST OF THE CENTER OF LANGSFORD ROAD AND 32 FEET NORTH OF THE CENTER OF OLD LANGSFORD ROAD. N:1001052.8503, E:2845604.8272

ELEV. 997.045


PROJECT BENCHMARK:

"SQUARE" CUT IN TOP OF CONCRETE STORM MANHOLE STORM MANHOLE IS LOCATED APPROX. 130 FEET EAST OF THE INTERSECTION OF SE JOEL AVE & BLUE PARKWAY AND 26 FEET SOUTH OF THE CENTERLINE OF BLUE PARKWAY. N:996874.9690, E:2840937.1365

ELEV. 1005.719

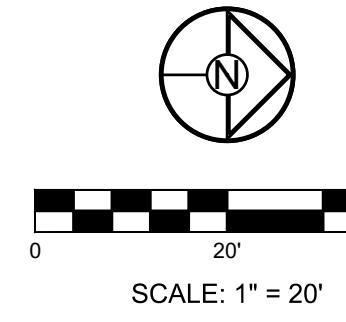


SCALE: 1" = 20'

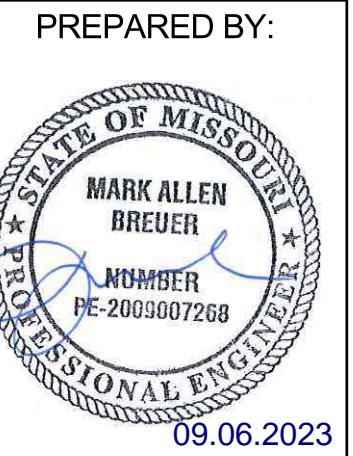

SCHLAGEL & ASSOCIATES, P.A.

BLACKWELL RESERVE STREET AND STORM SEWER PLANS


SE SHENANDOAH DRIVE LEE'S SUMMIT, MO

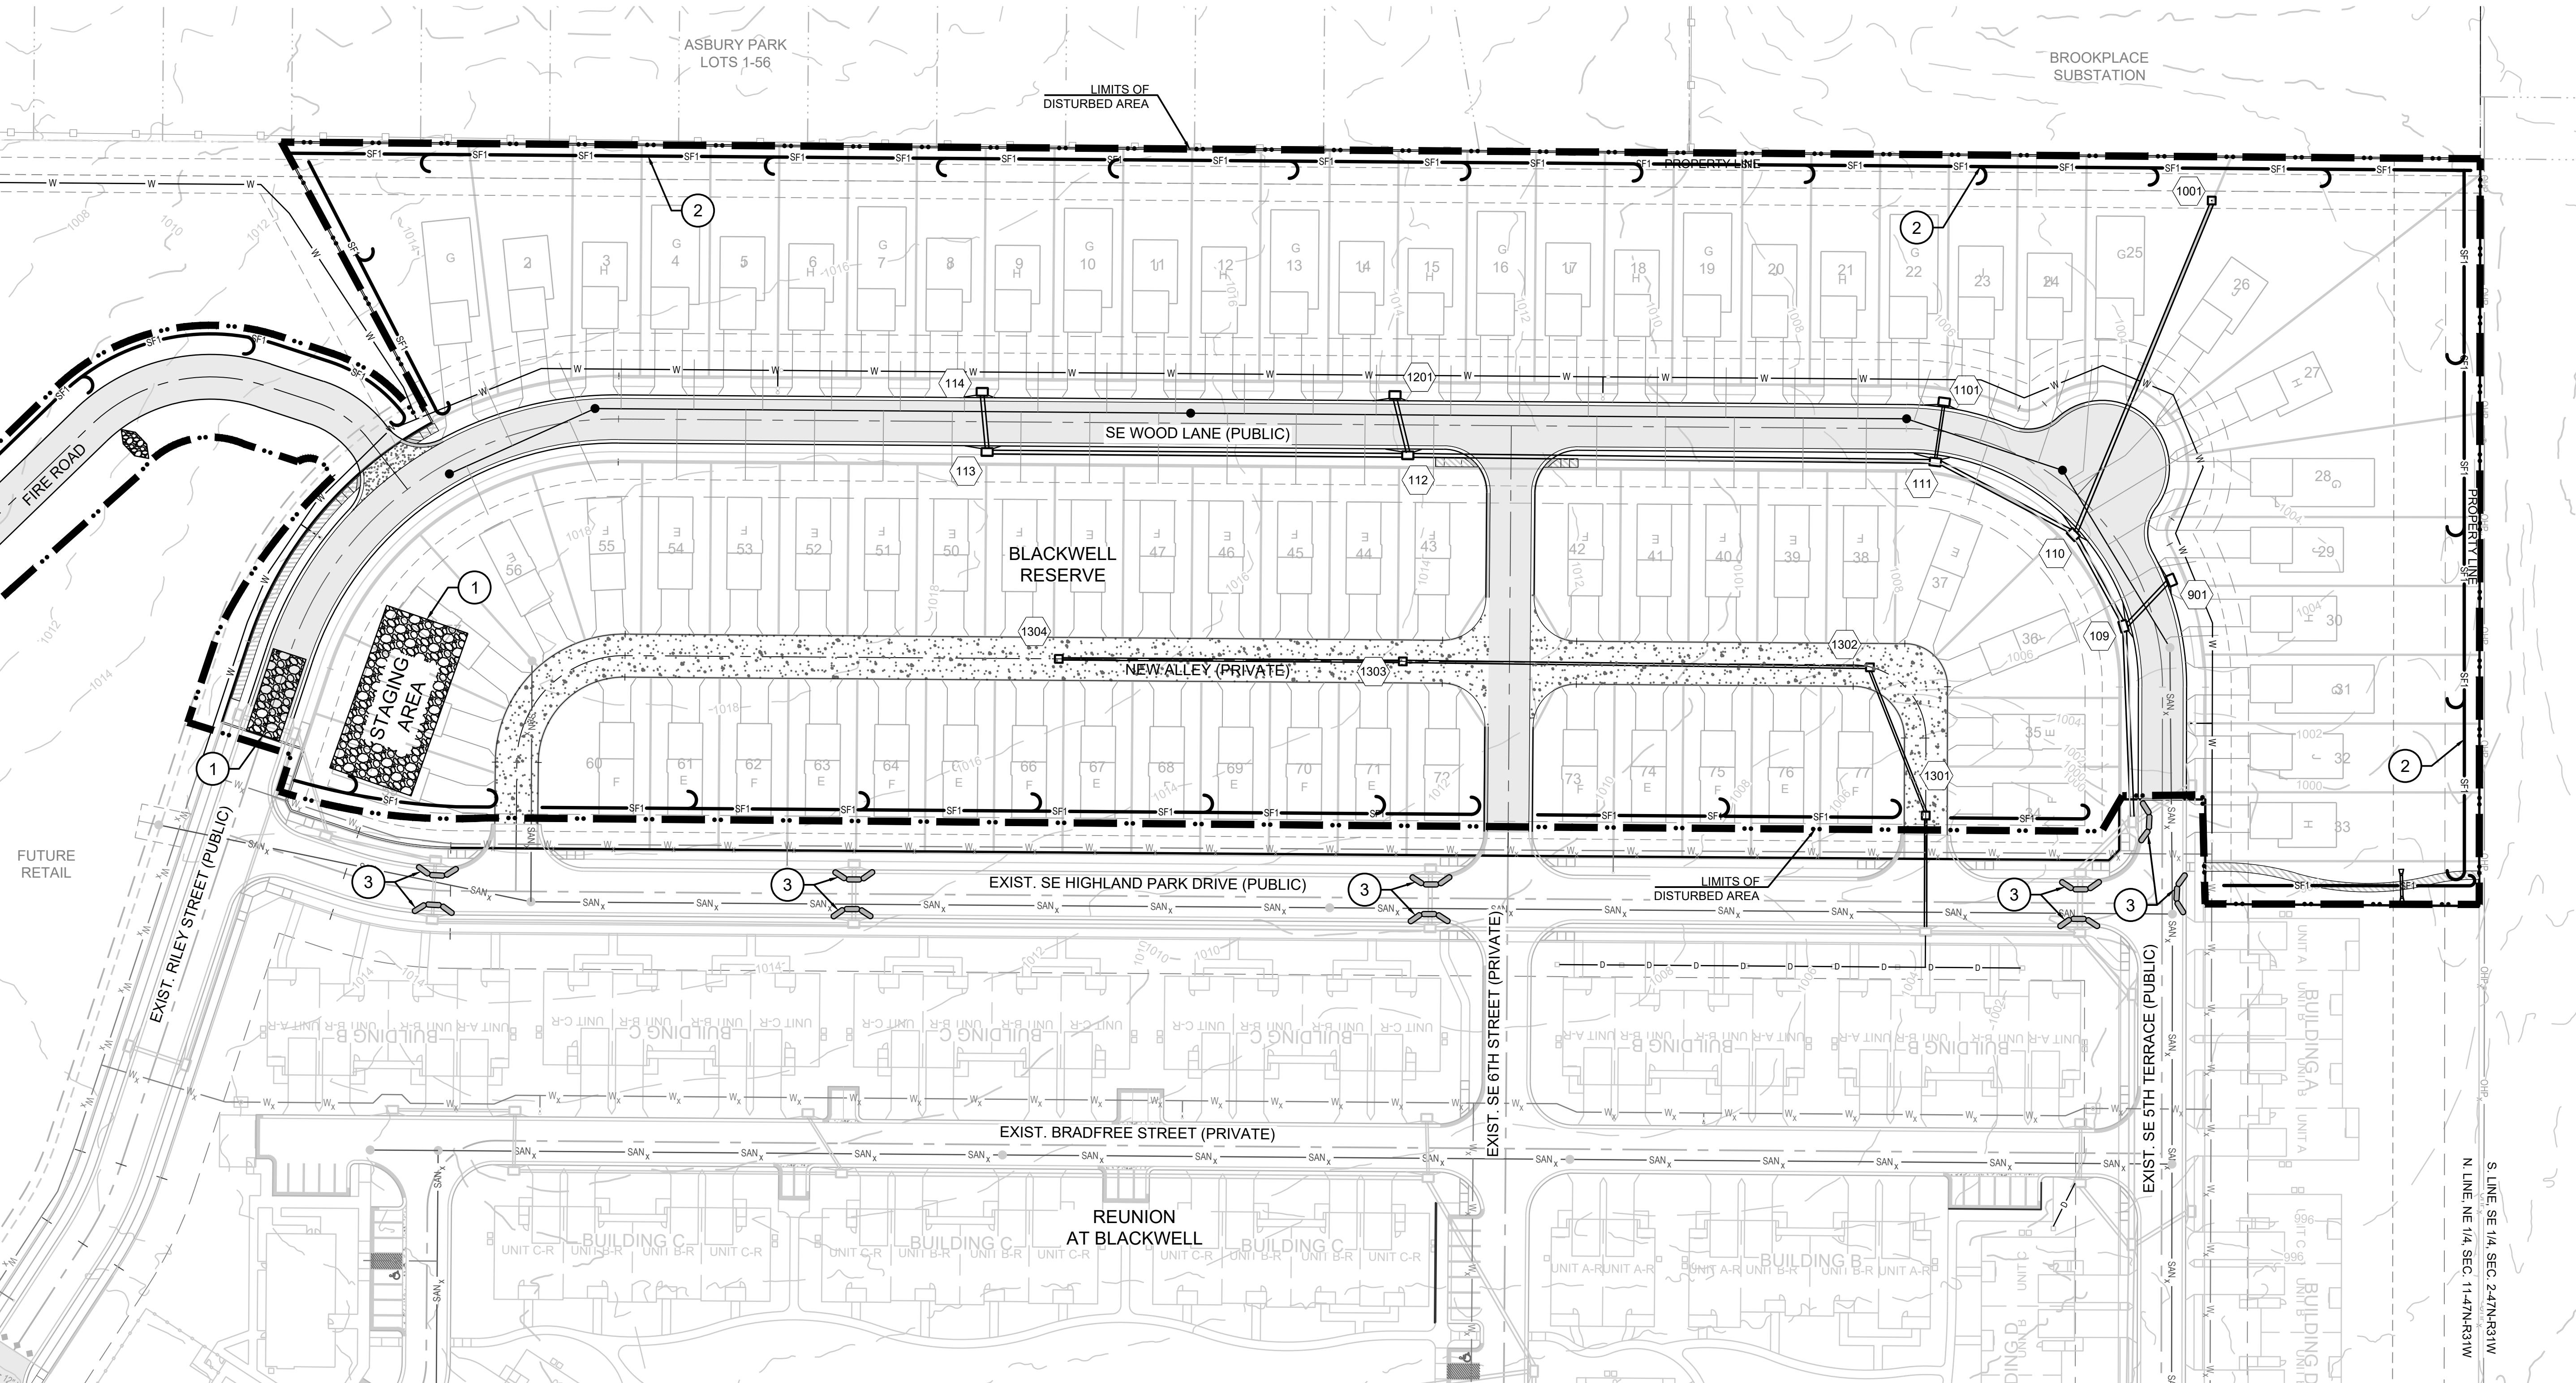

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Development Services Department
Lee's Summit, Missouri
09/21/2023


SCHLAGEL
ENGINEERS PLANNERS SURVEYORS LANDSCAPE ARCHITECTS
14920 West 107th Street Lenexa Kansas 66215
(913) 492-5158 • Fax: (913) 492-3400
WWW.SCHLAGELASSOCIATES.COM
#E2020038005 F BLAC2010000237 4LS202009889-F

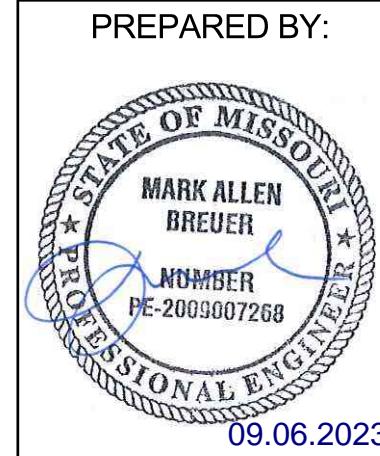

SCHLAGEL & ASSOCIATES, P.A.

BLACKWELL RESERVE STREET AND STORM SEWER PLANS

SE SHENANDOAH DRIVE LEE'S SUMMIT, MO

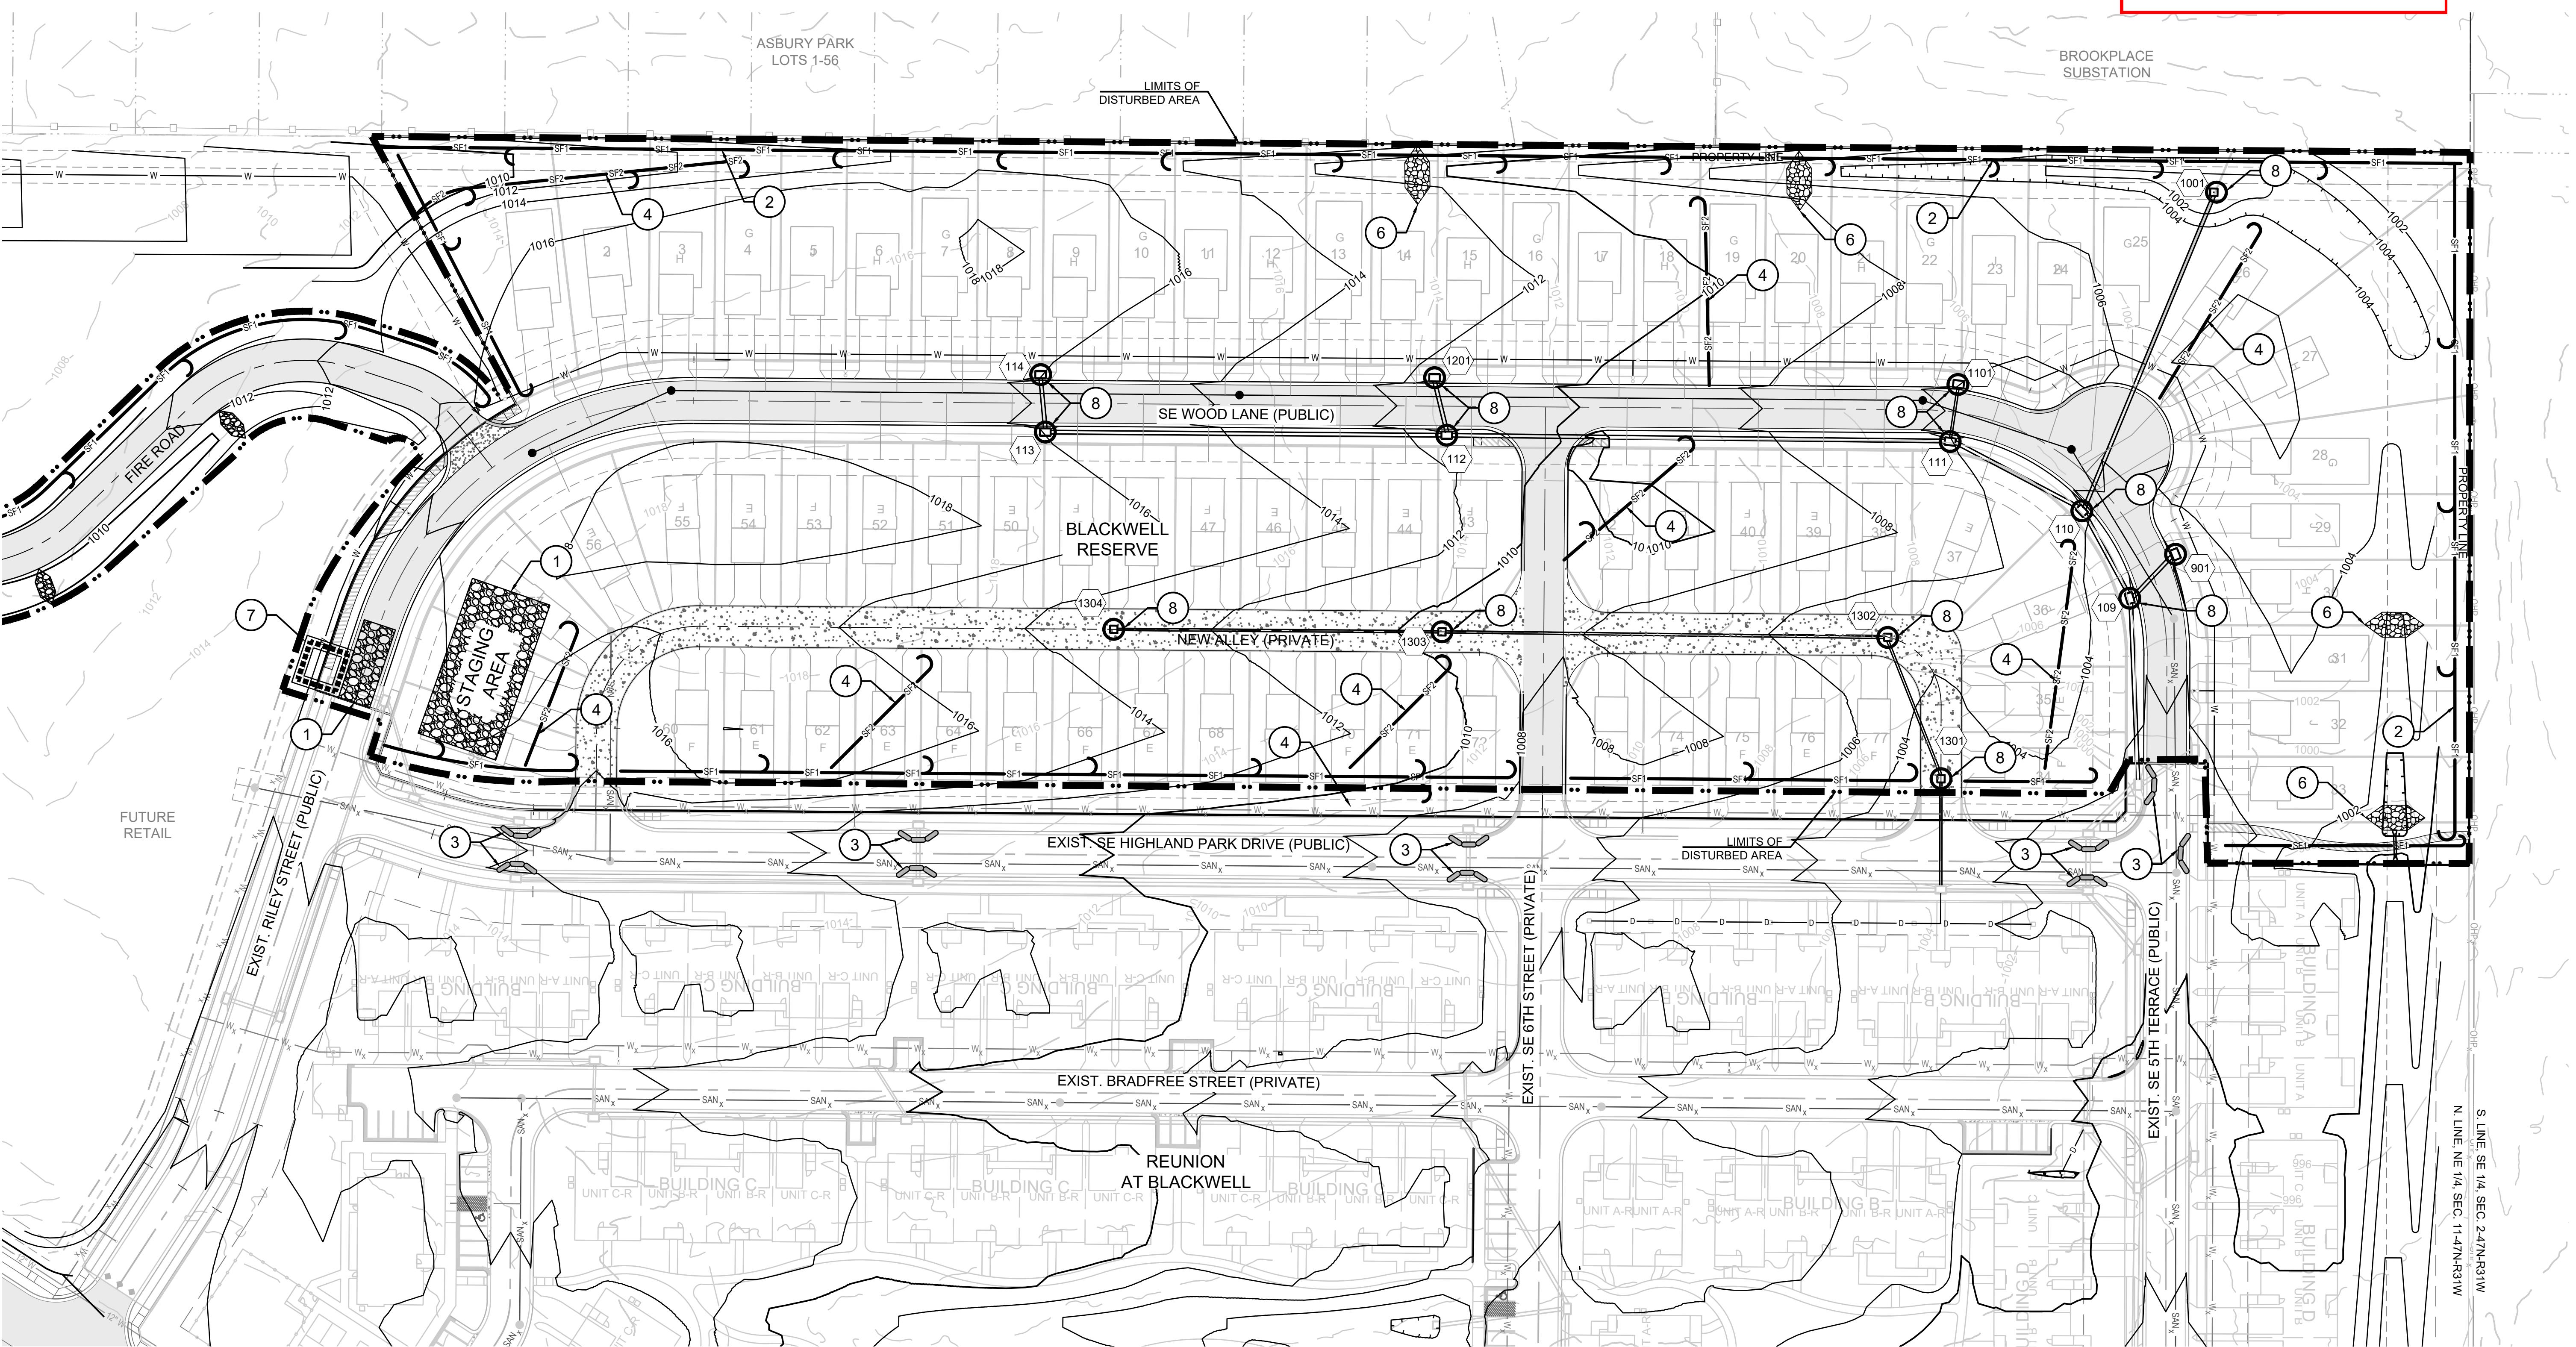

EROSION NOTE:

SEE SHEET 8 FOR EROSION CONTROL STAGING
CHART, LEGEND AND SITE SPECIFIC NOTES.

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N:996874.9690, E:2845604.8272

ELEV. 997.045

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N:996874.9690, E:2840937.1365

ELEV. 1005.719

DESCRIPTION		PER CITY COMMENTS	PER CITY COMMENTS	PER CITY COMMENTS
DRAWN BY:		09/05/2023	09/05/2023	09/05/2023
TRC				
CHECKED BY:		09/05/2023	09/05/2023	09/05/2023
MAB				
DATE PREPARED:		09/05/2023	09/05/2023	09/05/2023
PROJ. NUMBER:				
EROSION CONTROL PLAN				
SHEET				
22-093				



N

0 50' 100'

9

RELEASED FOR CONSTRUCTION


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Development Services Department


Lee's Summit, Missouri

09/21/2023

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14920 West 107th Street Lenexa Kansas 66215
(913) 492-5158 • Fax: (913) 492-3400
WWW.SCHLAGELASSOCIATES.COM
MAILING ADDRESS: P.O. BOX 20000 F • BLACKWOOD CLOUD CENTER • SUITE 100 • LEE'S SUMMIT, MO 64063
#E2020038005 F • BLAC201000237 • MS2020038859-F

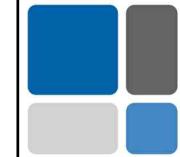


PREPARED BY:

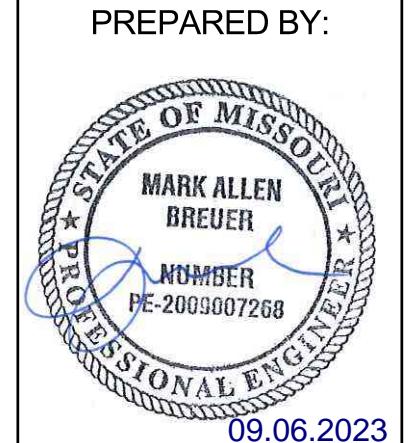MARK ALLEN DREUER
NUMBER PE-2009007268
09.06.2023

SCHLAGEL & ASSOCIATES, P.A.

BLACKWELL RESERVE STREET AND STORM SEWER PLANS

SE SHENANDOAH DRIVE LEE'S SUMMIT, MO

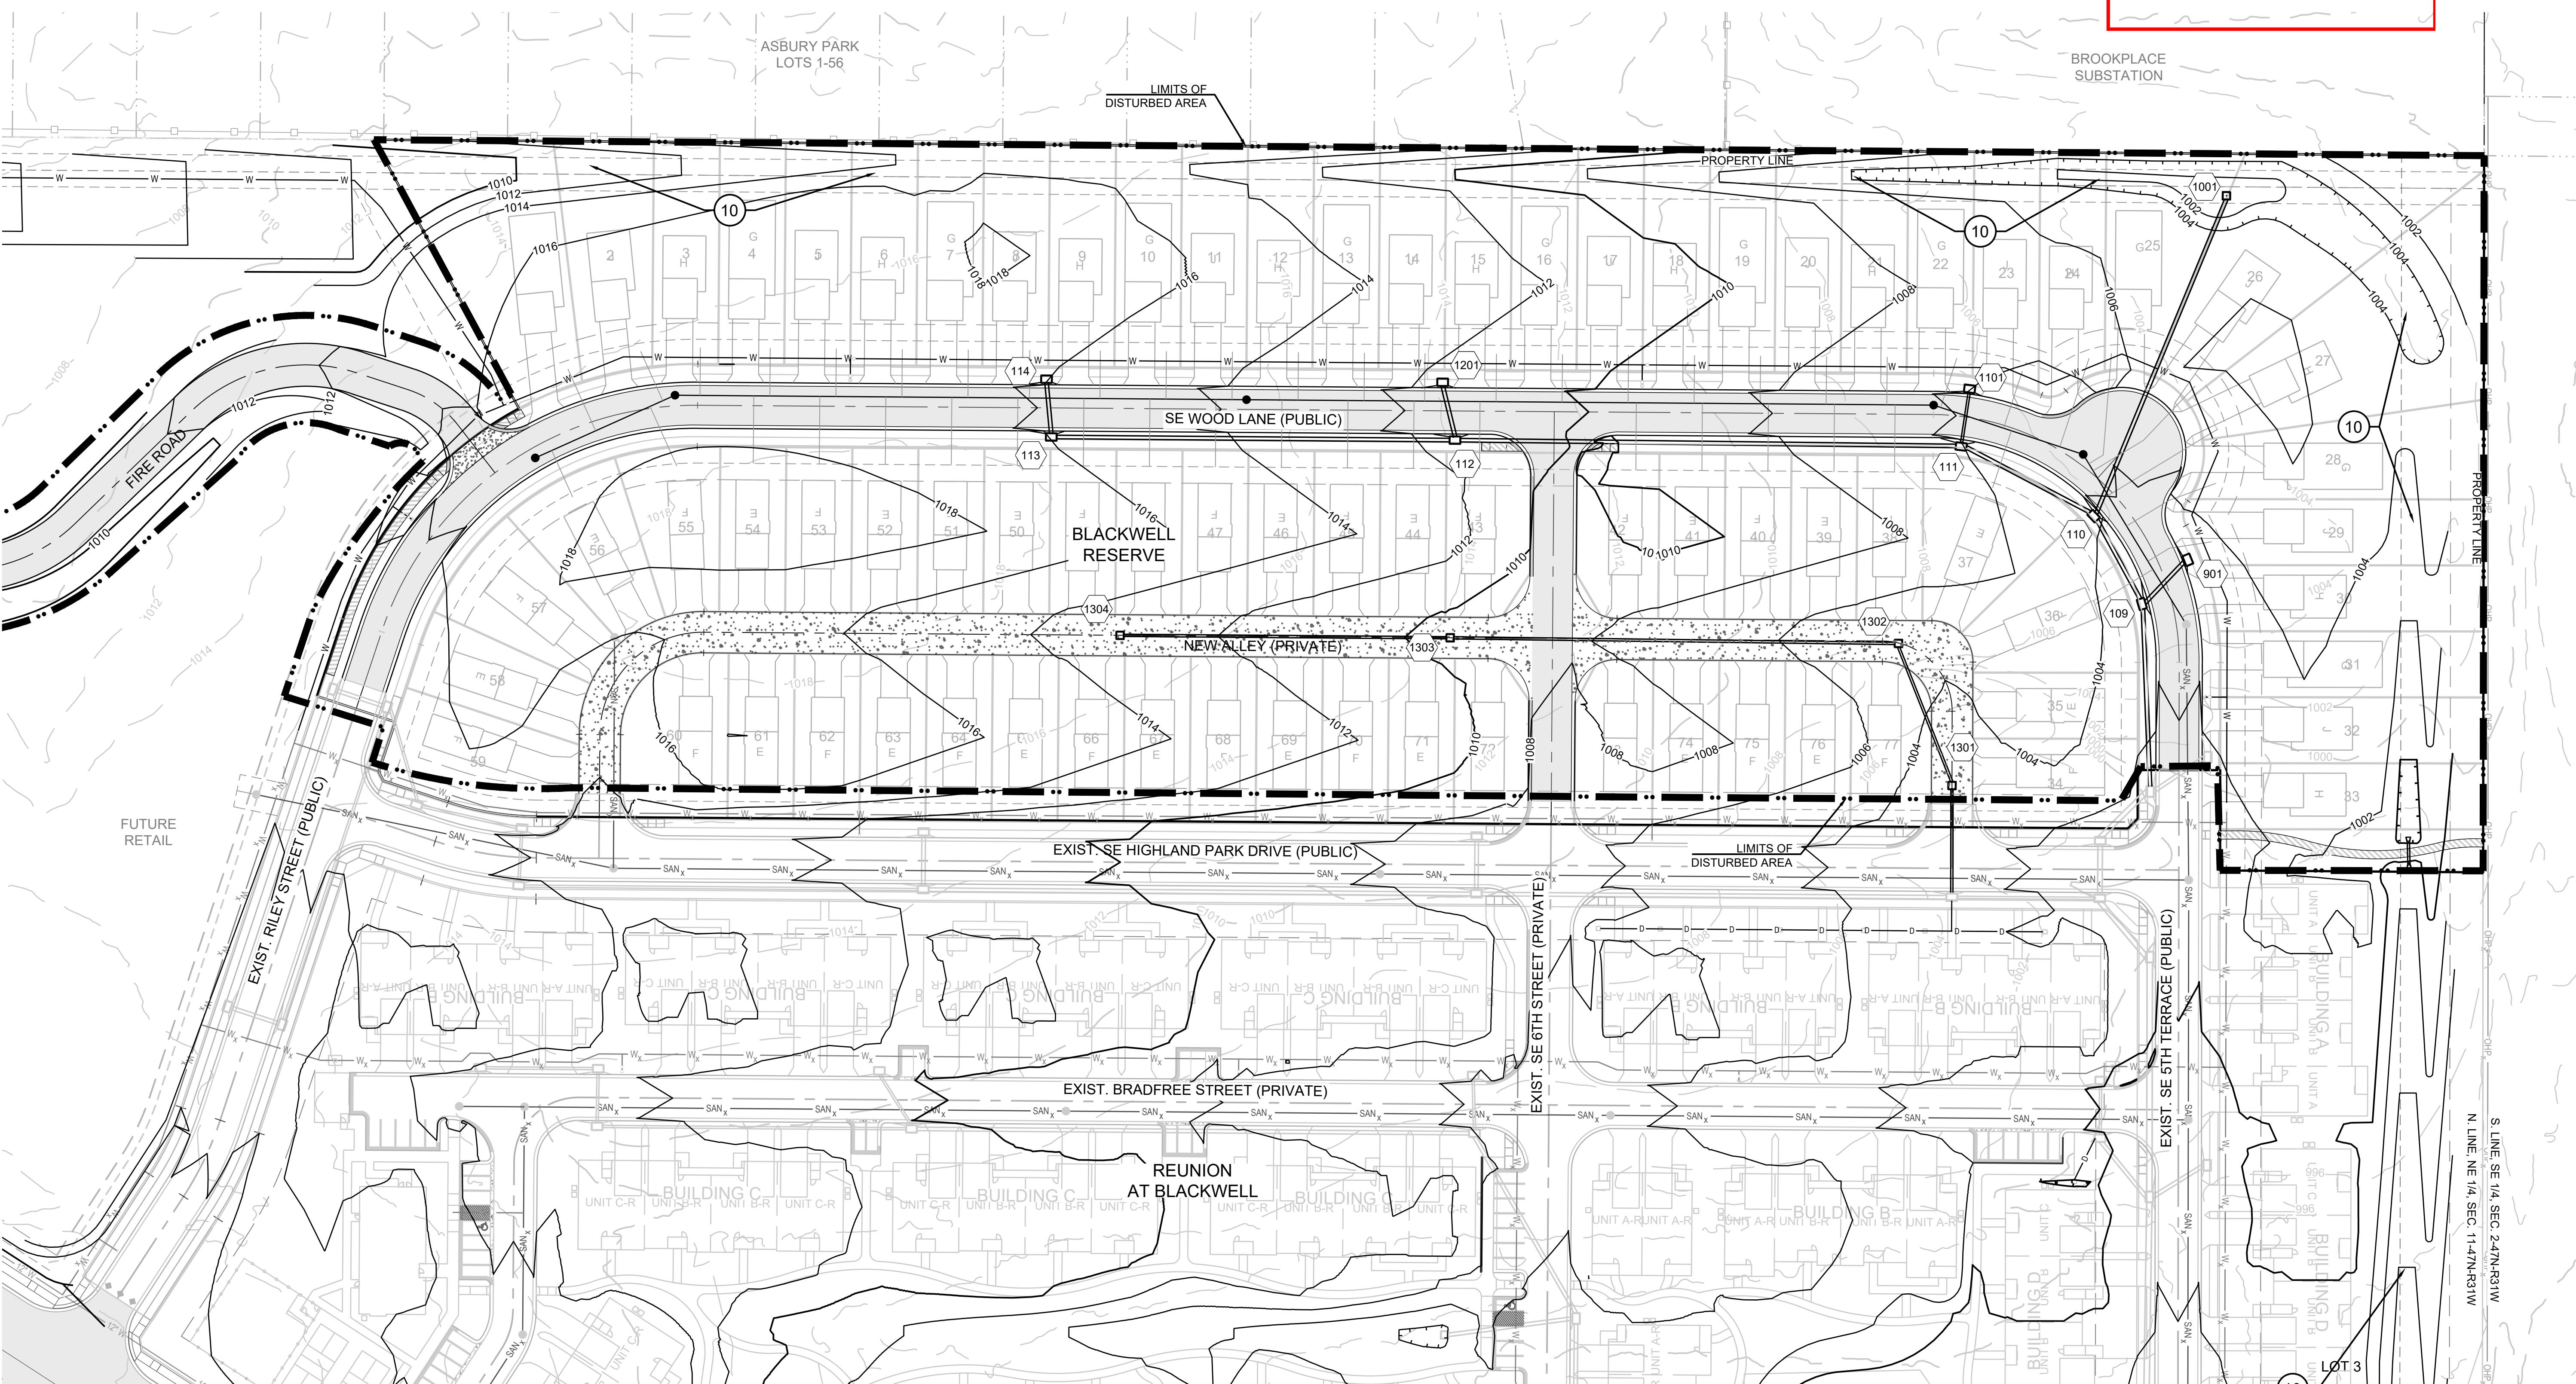

EROSION NOTE:

SEE SHEET 8 FOR EROSION CONTROL STAGING
CHART, LEGEND AND SITE SPECIFIC NOTES.

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N:996874.9690, E:2840937.1365

ELEV. 1005.719



0 50' 100'
SCALE: 1" = 50'

POST-CONSTRUCTION
EROSION
CONTROL PLAN

SHEET

10

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Lee's Summit, Missouri

09/21/2023

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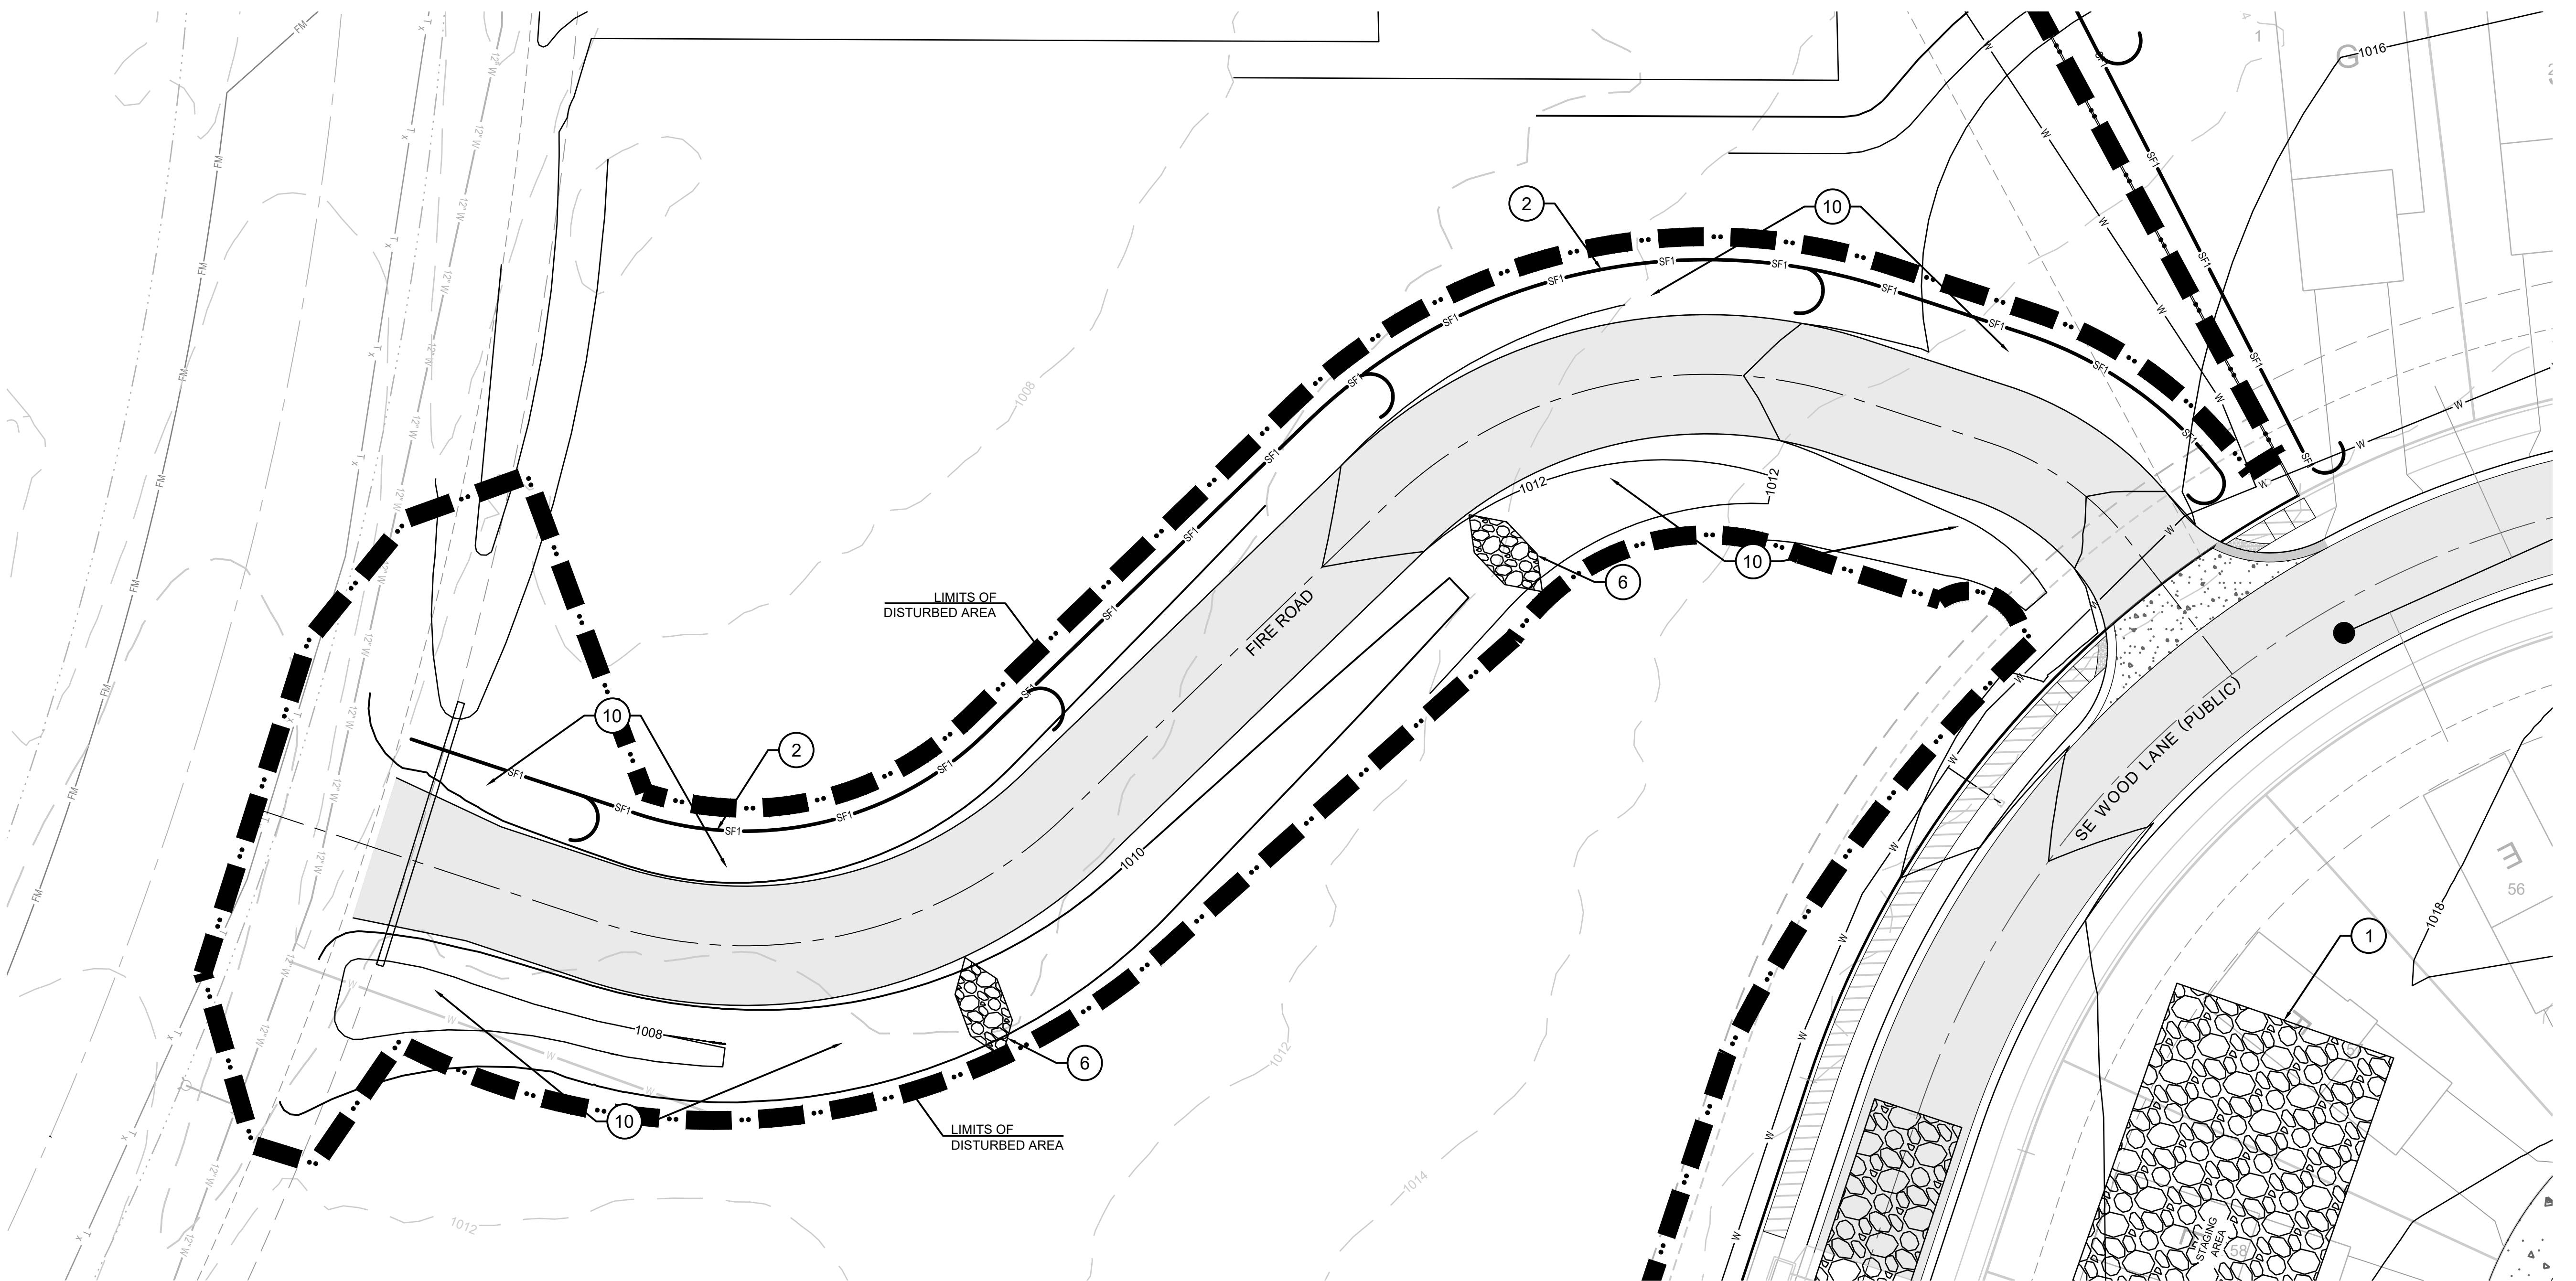
MAILING ADDRESS: 14920 W 107TH STREET, LENEXA, KS 66215


#E2020038005 F BLAC201000237 #S202008859-F

PREPARED BY:
MARK ALLEN DREUER
NUMBER
PE-2009007268
09.06.2023

SCHLAGEL & ASSOCIATES, P.A.

**BLACKWELL RESERVE
STREET AND STORM SEWER PLANS
SE SHENANDOAH DRIVE LEE'S SUMMIT, MO**



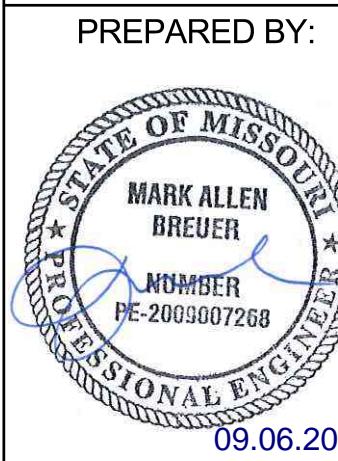

SCHLAGEL & ASSOCIATES, P.A.

09.06.2023

PREPARED BY:


MARK ALLEN DREUER
 PE-2009007268

09.06.2023

BLACKWELL RESERVE STREET AND STORM SEWER PLANS

12

SE SHENANDOAH DRIVE LEE'S SUMMIT, MO

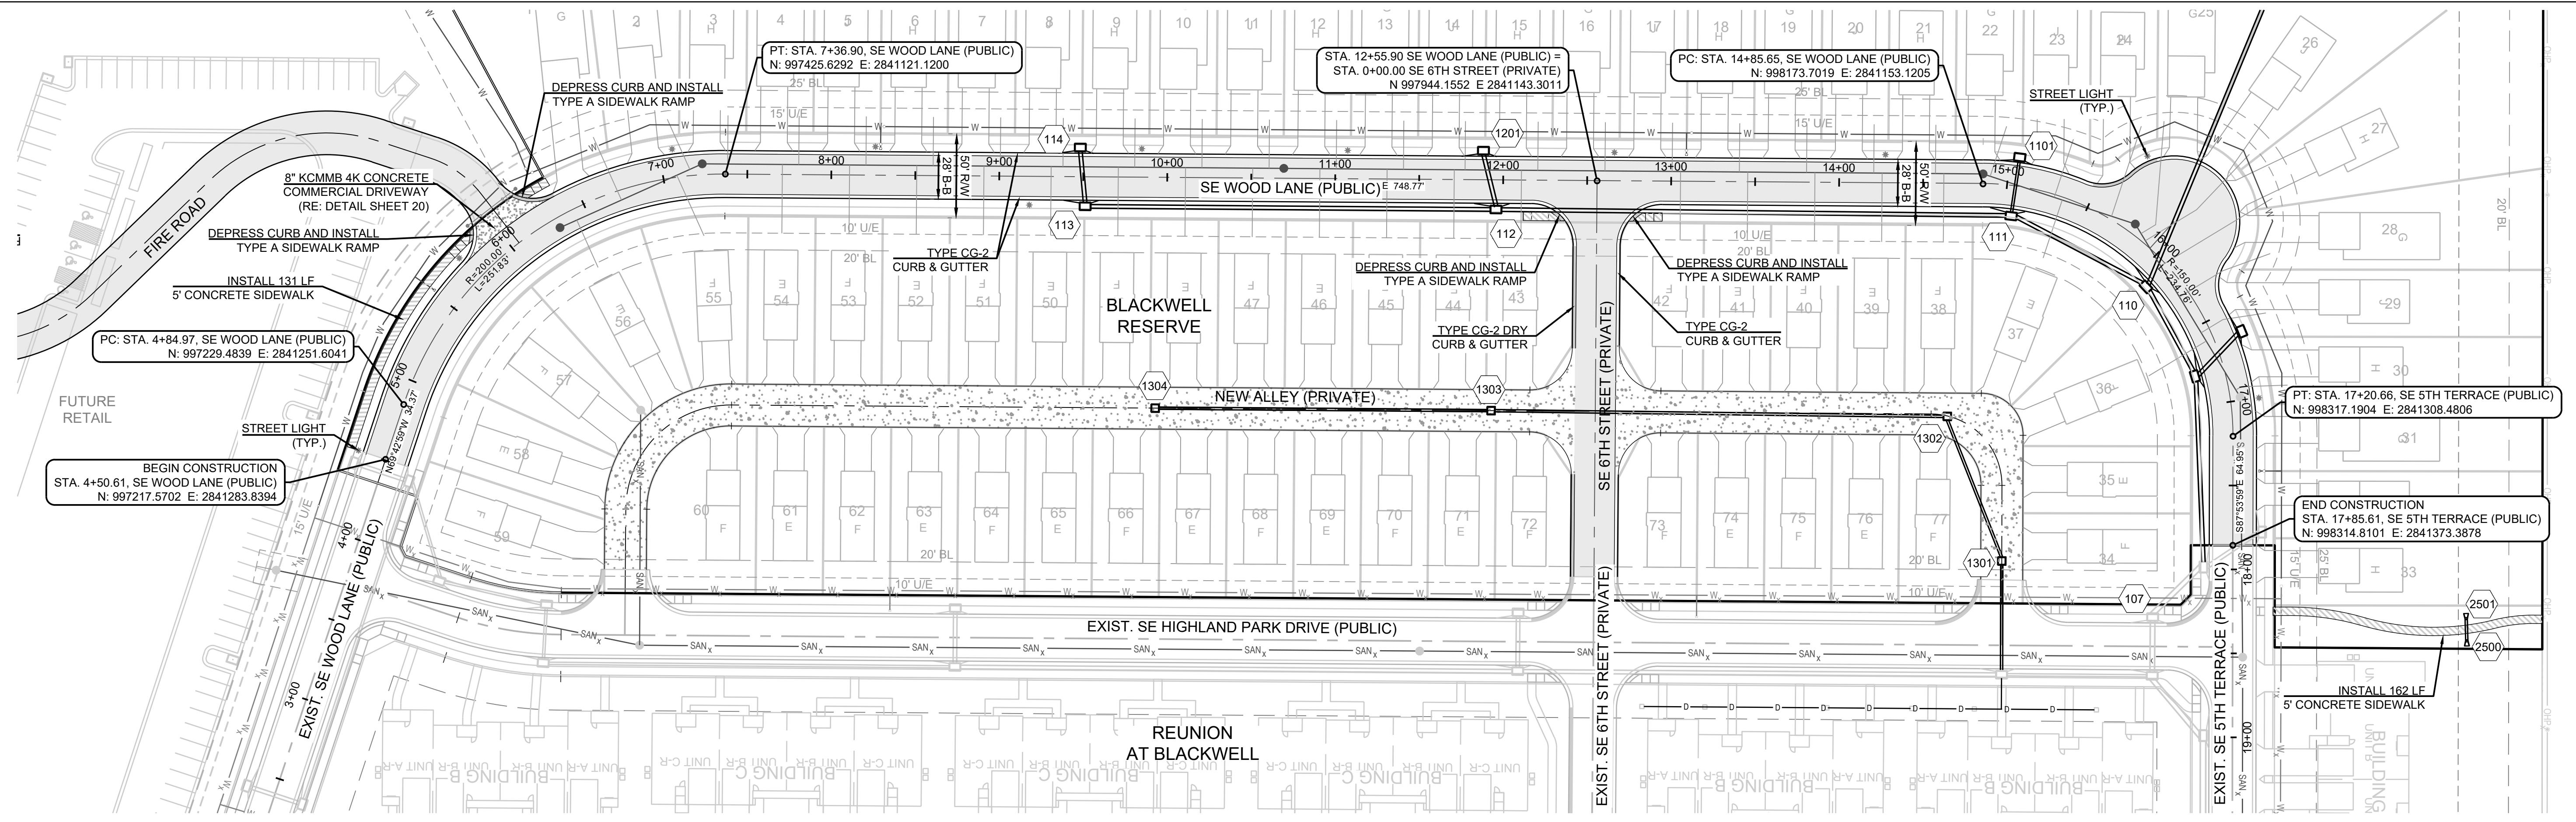

STREET NOTES:

- ALL STREET CONSTRUCTION SHALL BE IN ACCORDANCE WITH THE LATEST EDITION OF THE CITY OF LEE'S SUMMIT DESIGN AND CONSTRUCTION MANUAL. ALL APPLICABLE AASHTO STANDARDS HAVE BEEN MET.
- THE CONTRACTOR IS RESPONSIBLE FOR VERIFYING ALL EXISTING UTILITY LOCATIONS PRIOR TO EXCAVATION.
- ALL INSPECTION OF STREET CONSTRUCTION TO BE PERFORMED BY THE CITY OF LEE'S SUMMIT DEVELOPMENT ENGINEERING.
- CURB RETURN RADII SHALL BE 25' BACK OF CURB UNLESS OTHERWISE NOTED.
- SUBGRADE TO BE COMPACTED TO 95% STANDARD PROCTOR DENSITY.
- ASSUMED DESIGN SPEED = 25 MPH (RESIDENTIAL LOCAL).
- MINIMUM STOPPING SIGHT DISTANCE = 155 FEET.
- MINIMUM K, SAG CURVE = 26 (14 WITH LIGHTING), CREST CURVE = 12.
- GRADE INTERSECTIONS TO DRAIN AS SHOWN.
- SSD = STOPPING SIGHT DISTANCE.
- ALL ADA SIDEWALK RAMPS SHALL BE CONSTRUCTED BY THE DEVELOPER WITH THE PUBLIC INFRASTRUCTURE.

RELEASED FOR CONSTRUCTION

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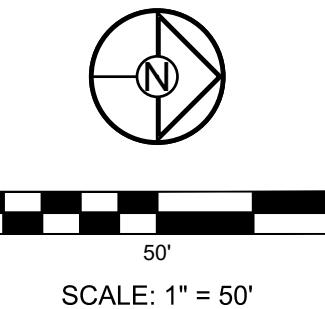
Development Services Department
 Lee's Summit, Missouri
 09/21/2023

MO GRS BENCHMARK:


STATION NAME - JA-90
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 N:996874.9690, E:2840937.1365
 ELEV. 1005.719

PROJECT BENCHMARK:


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 N:996874.9690, E:2840937.1365



BLACKWELL RESERVE STREET AND STORM SEWER PLANS

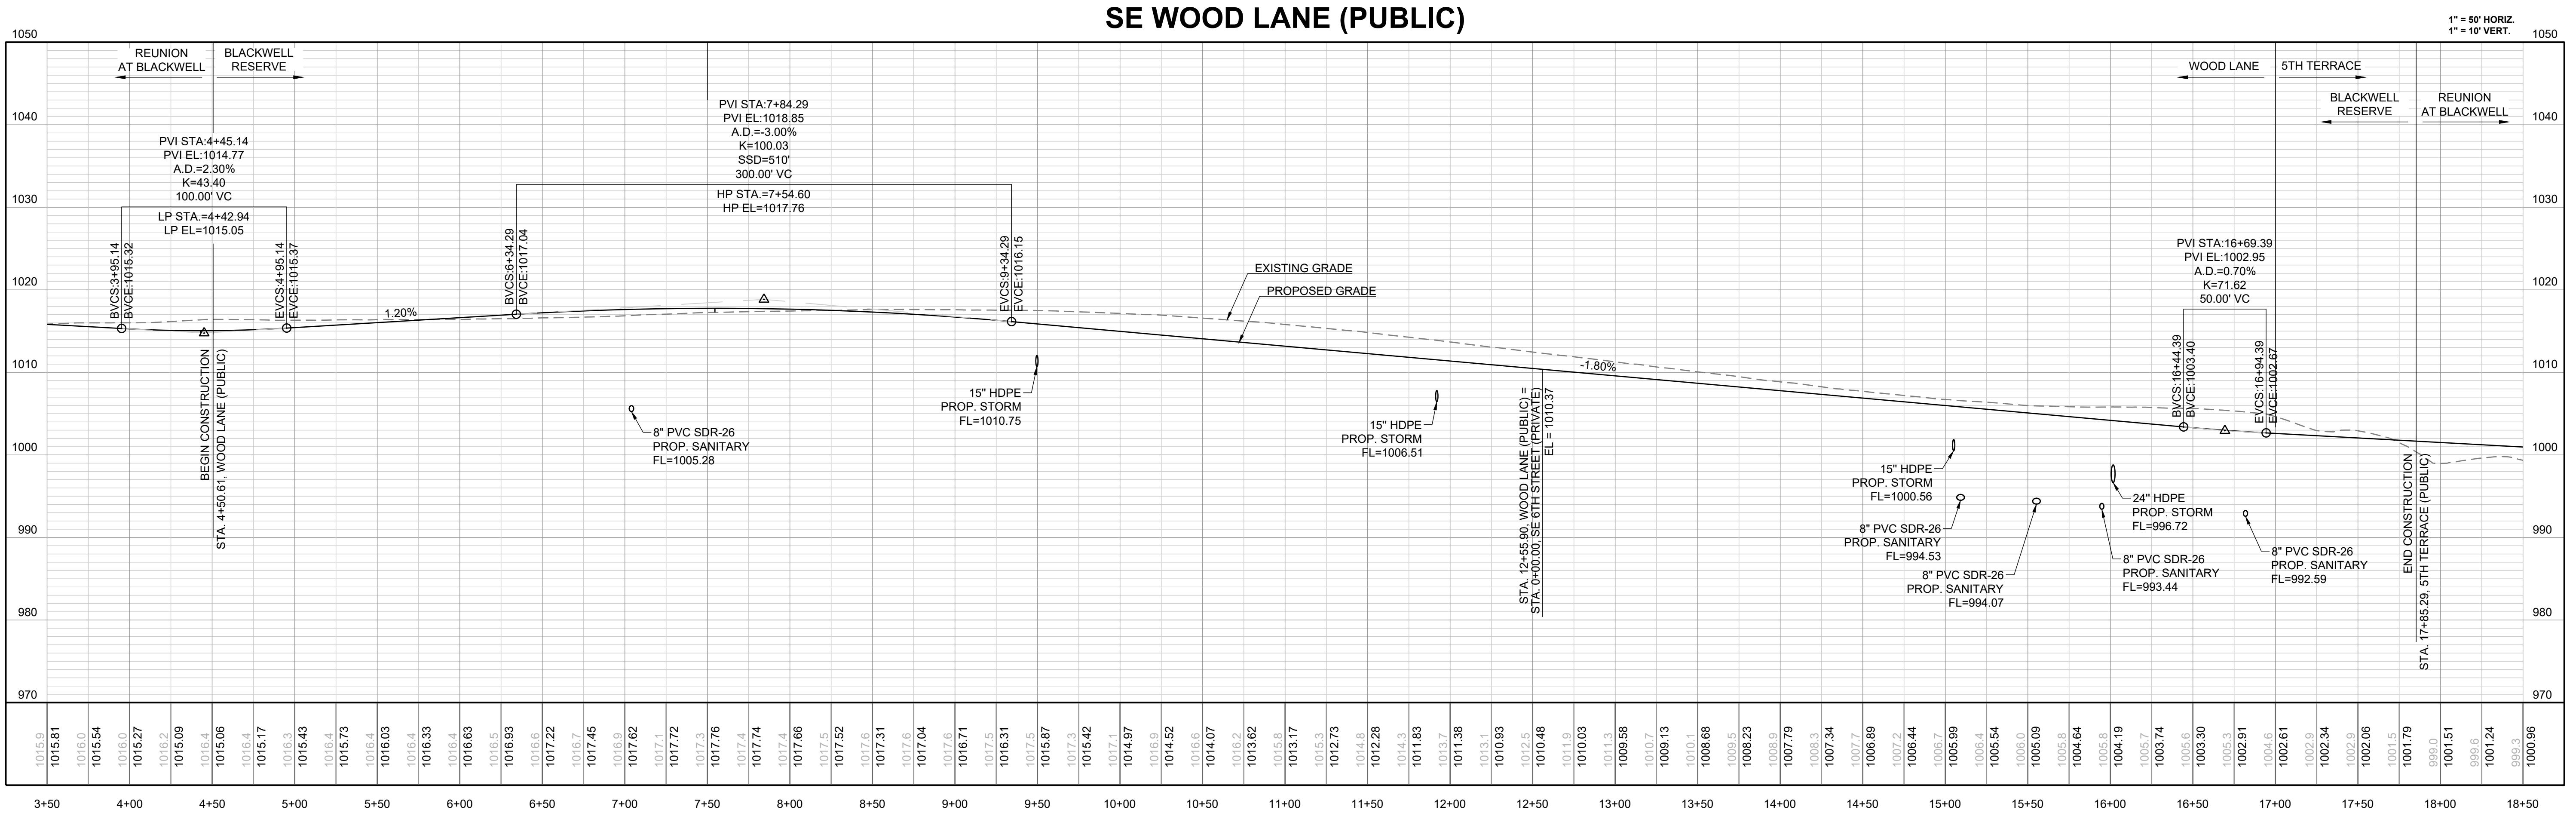

PREPARED BY:

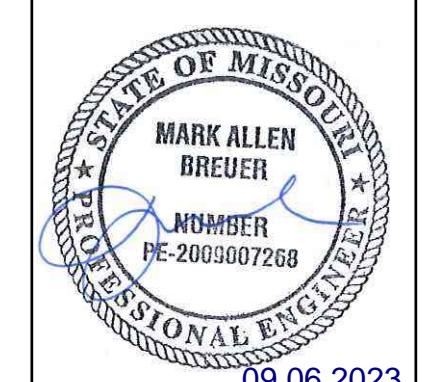

MARK ALLEN DREUER
NUMBER PE-2009007268
09.06.2023


SCHLAGEL & ASSOCIATES, P.A.

LEE'S SUMMIT, MO

BLACKWELL RESERVE

STREET AND STORM SEWER PLANS

SE SHENANDOAH DRIVE LEE'S SUMMIT, MO

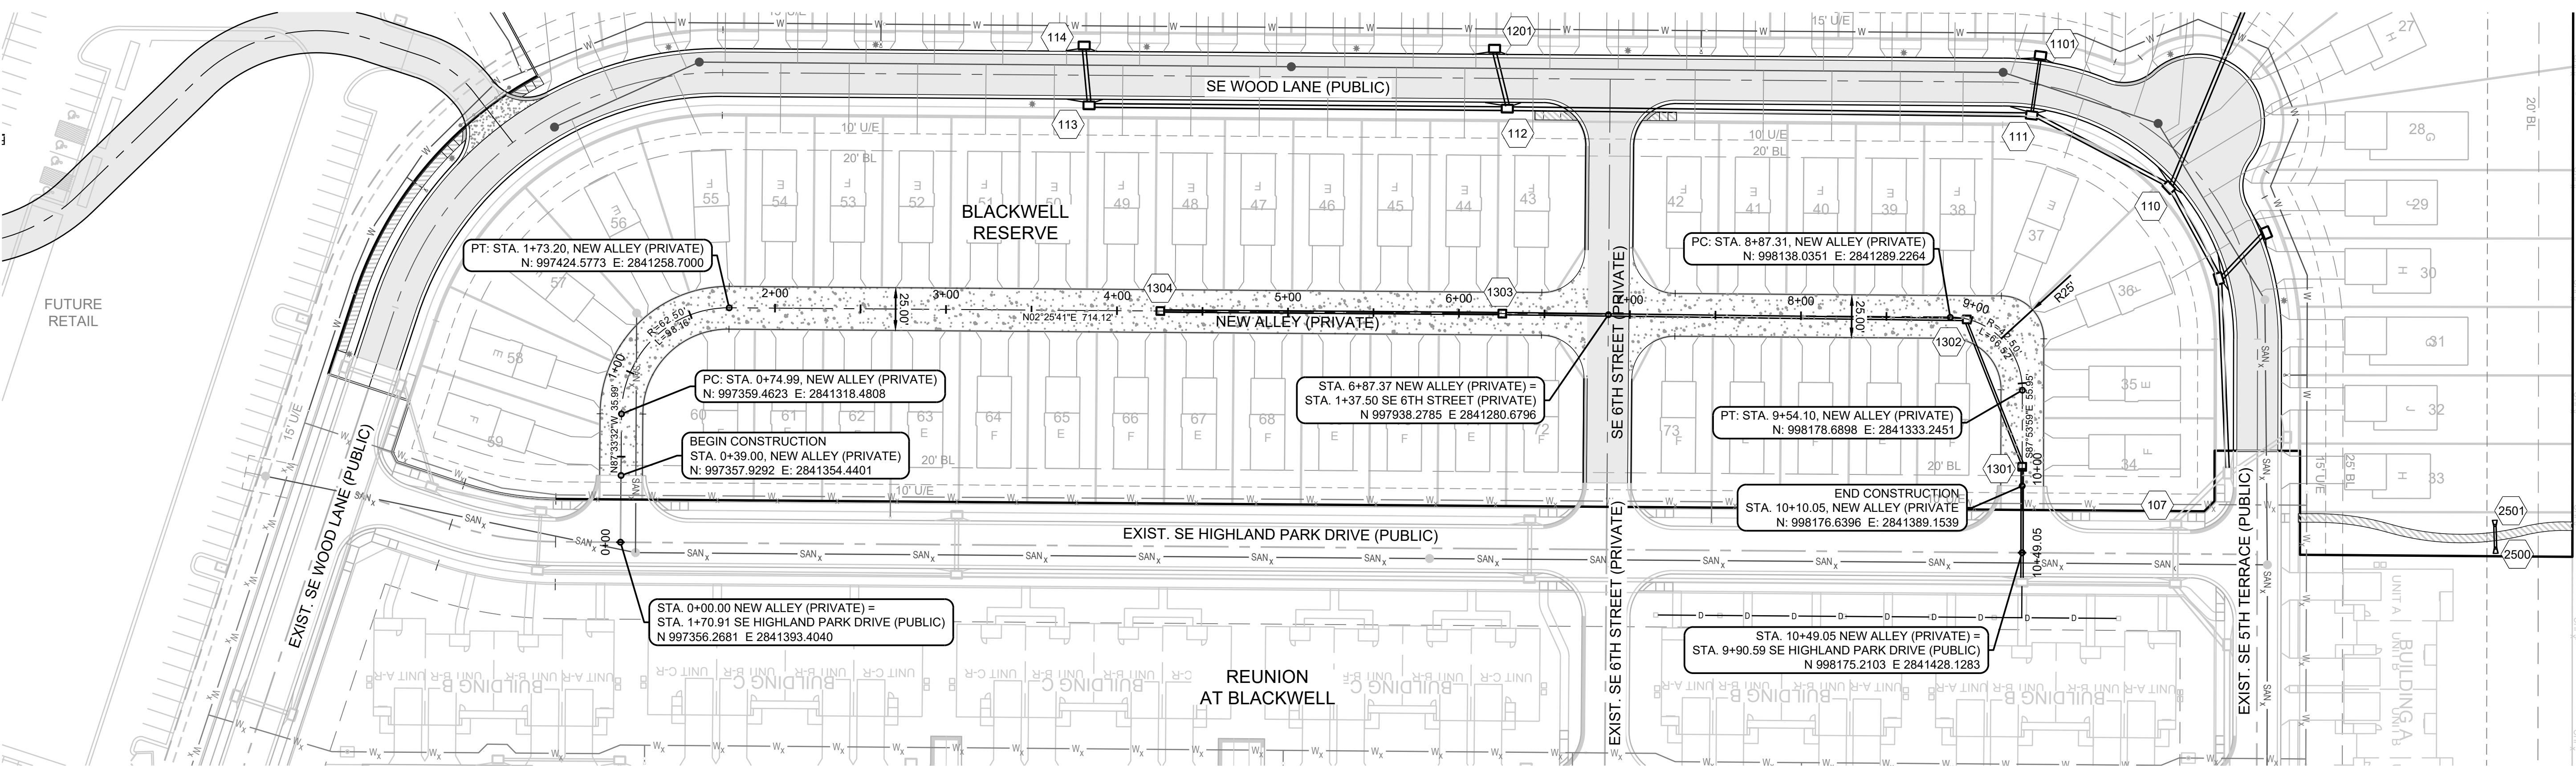

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- MINIMUM STOPPING SIGHT DISTANCE = 155 FEET.
- MINIMUM K, SAG CURVE = 26 (14 WITH LIGHTING), CREST CURVE = 12.
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- SSD = STOPPING SIGHT DISTANCE.
- ALL ADA SIDEWALK RAMPS SHALL BE CONSTRUCTED BY THE DEVELOPER WITH THE PUBLIC INFRASTRUCTURE.

NEW ALLEY NOTE:

REFERENCE SHEET 20 FOR TYPICAL ALLEY SECTION.
TYPICAL ALLEY SECTION STA. 0+39.00 TO STA. 10+10.05.

SIDEWALK NOTE:

SIDEWALKS AT BUILDINGS WILL BE INSTALLED BY OTHERS,
UNLESS NOTED OTHERWISE.

MO GRS BENCHMARK:

STATION NAME - JA-90


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ELEV. 997.045


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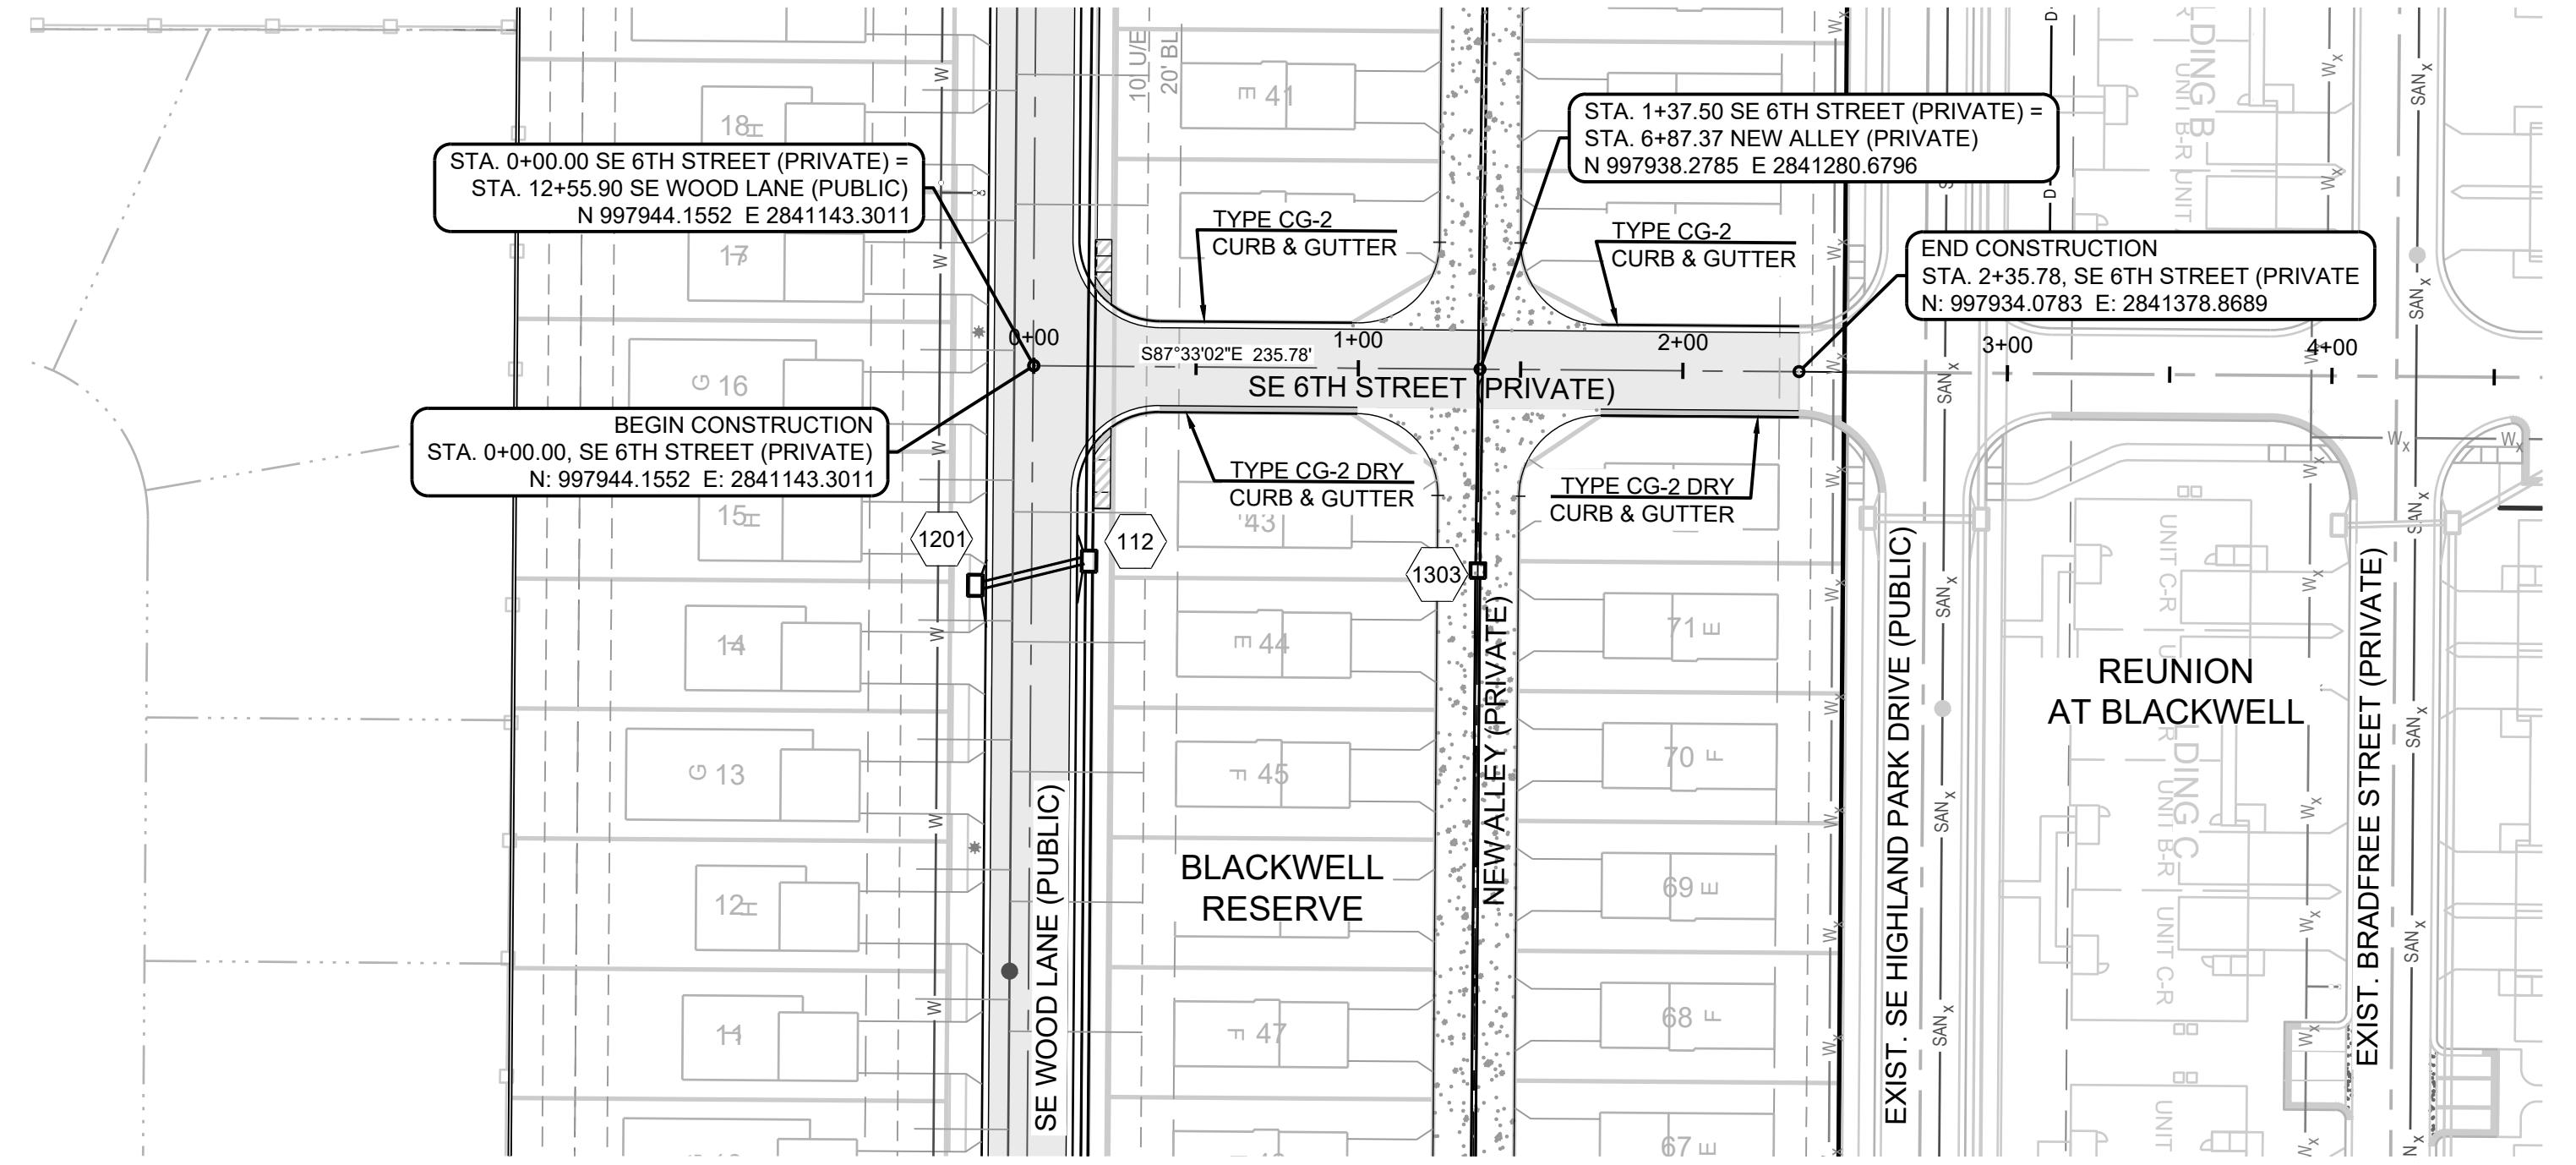


NEW ALLEY (PRIVATE)



RELEASED FOR CONSTRUCTION
As Noted on Plan Review

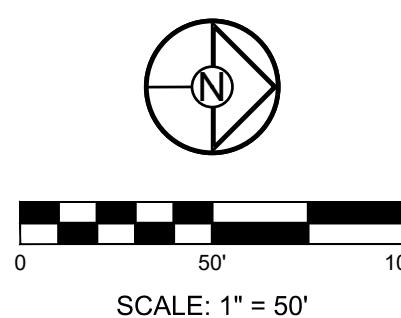Development Services Department
Lee's Summit, Missouri
09/21/2023

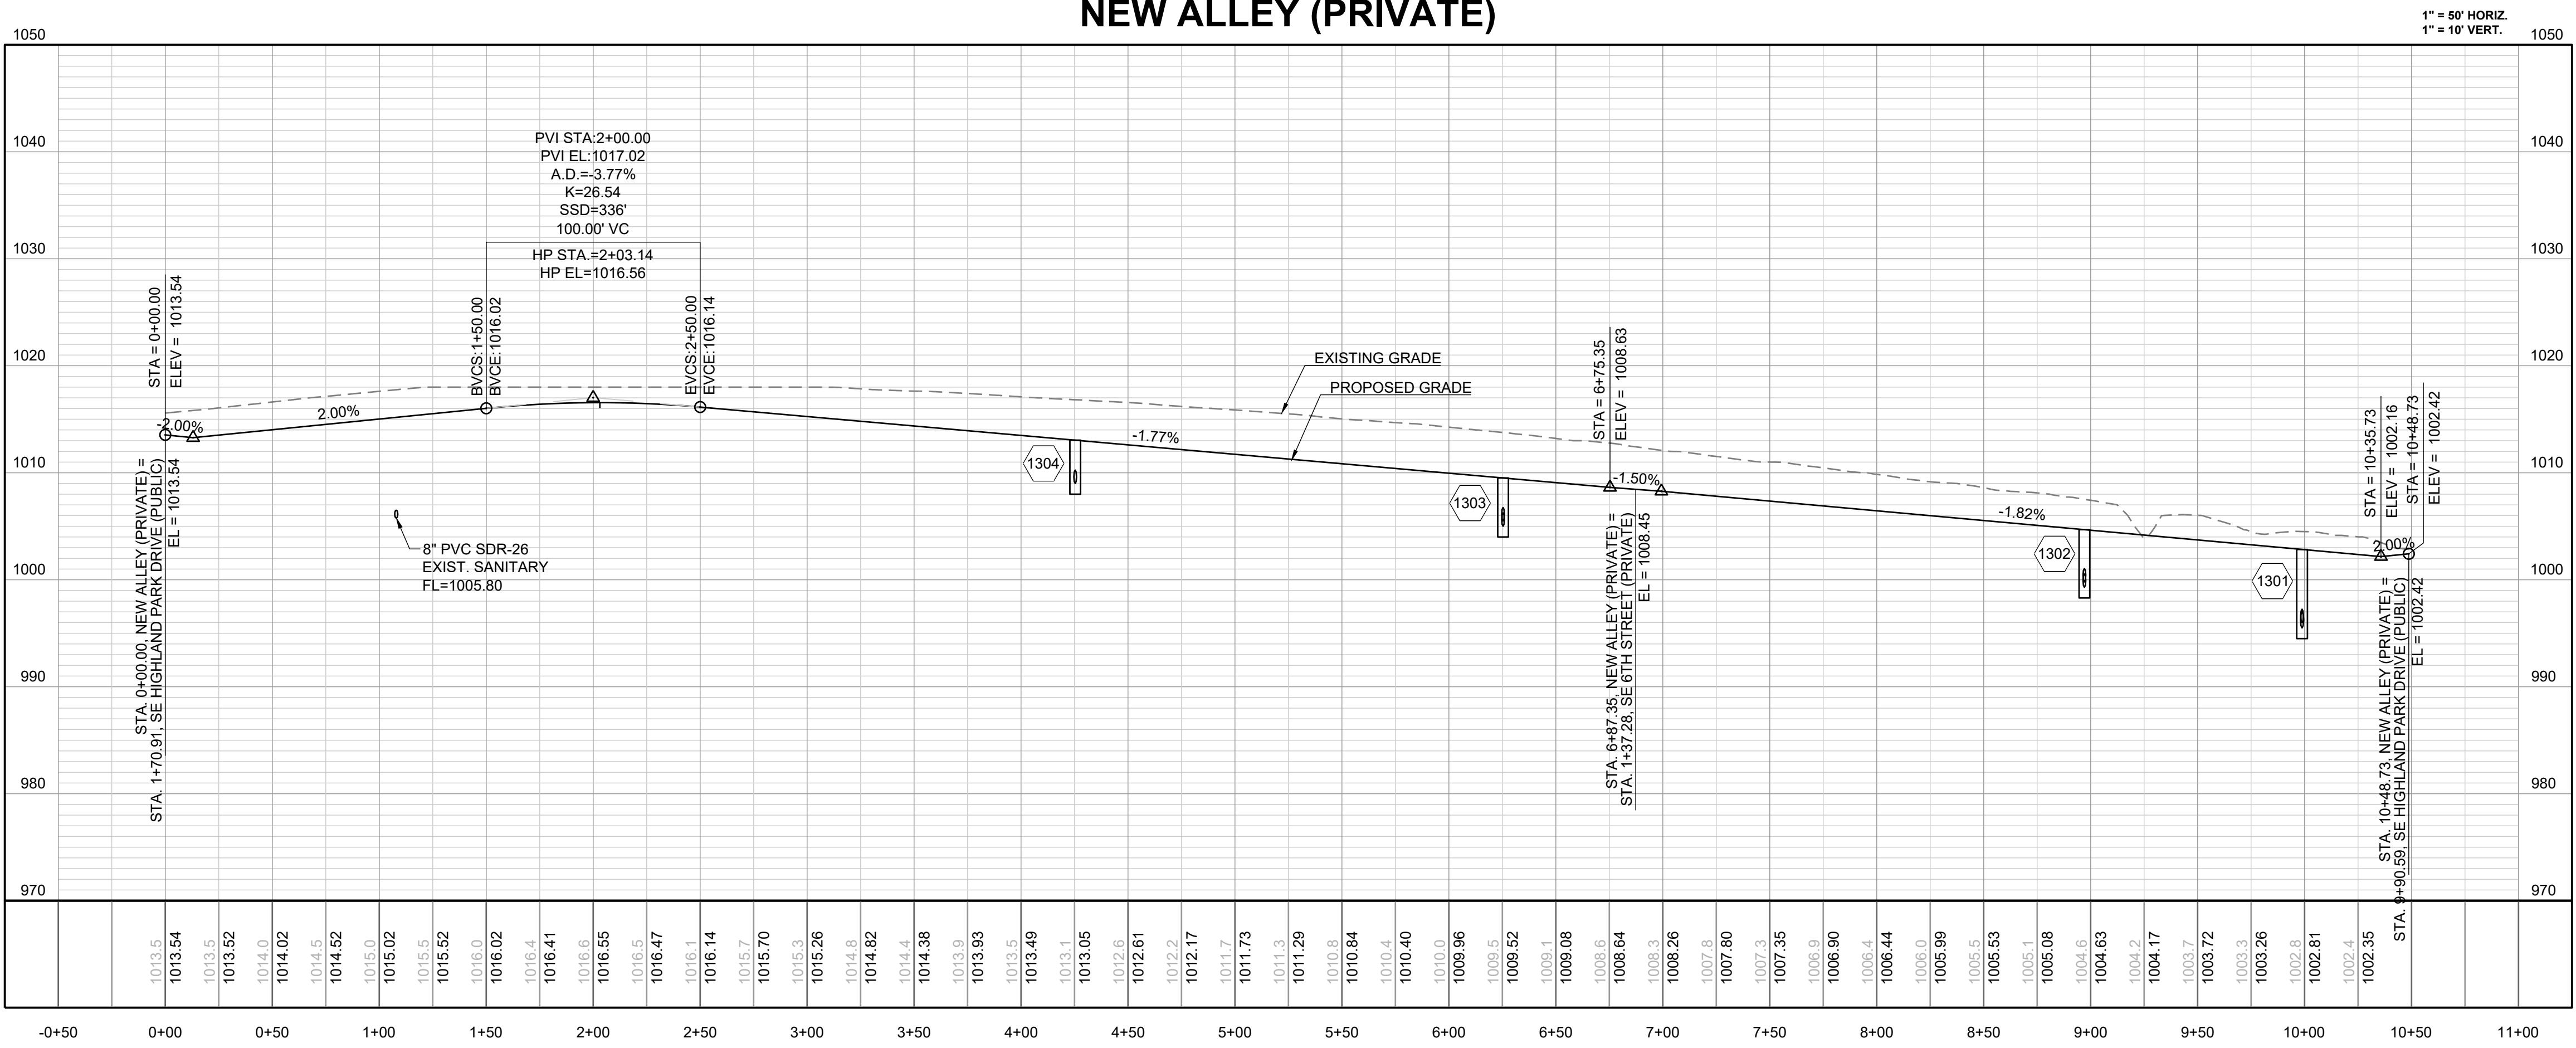

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www.schlagelassociates.com
MAILING ADDRESS: C/O Schlagel Associates, Inc.
#E2020038005 F BLAC201000237 45 S2020098859-F

PREPARED BY:

MARK ALLEN DREHER
NUMBER PE-2009007268
09.06.2023

SCHLAGEL & ASSOCIATES, P.A.

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SIDEWALK NOTE:

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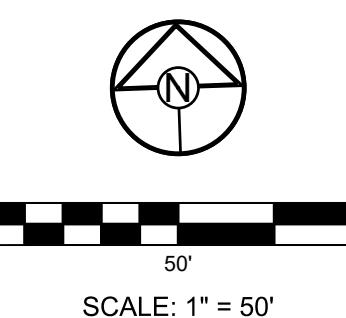
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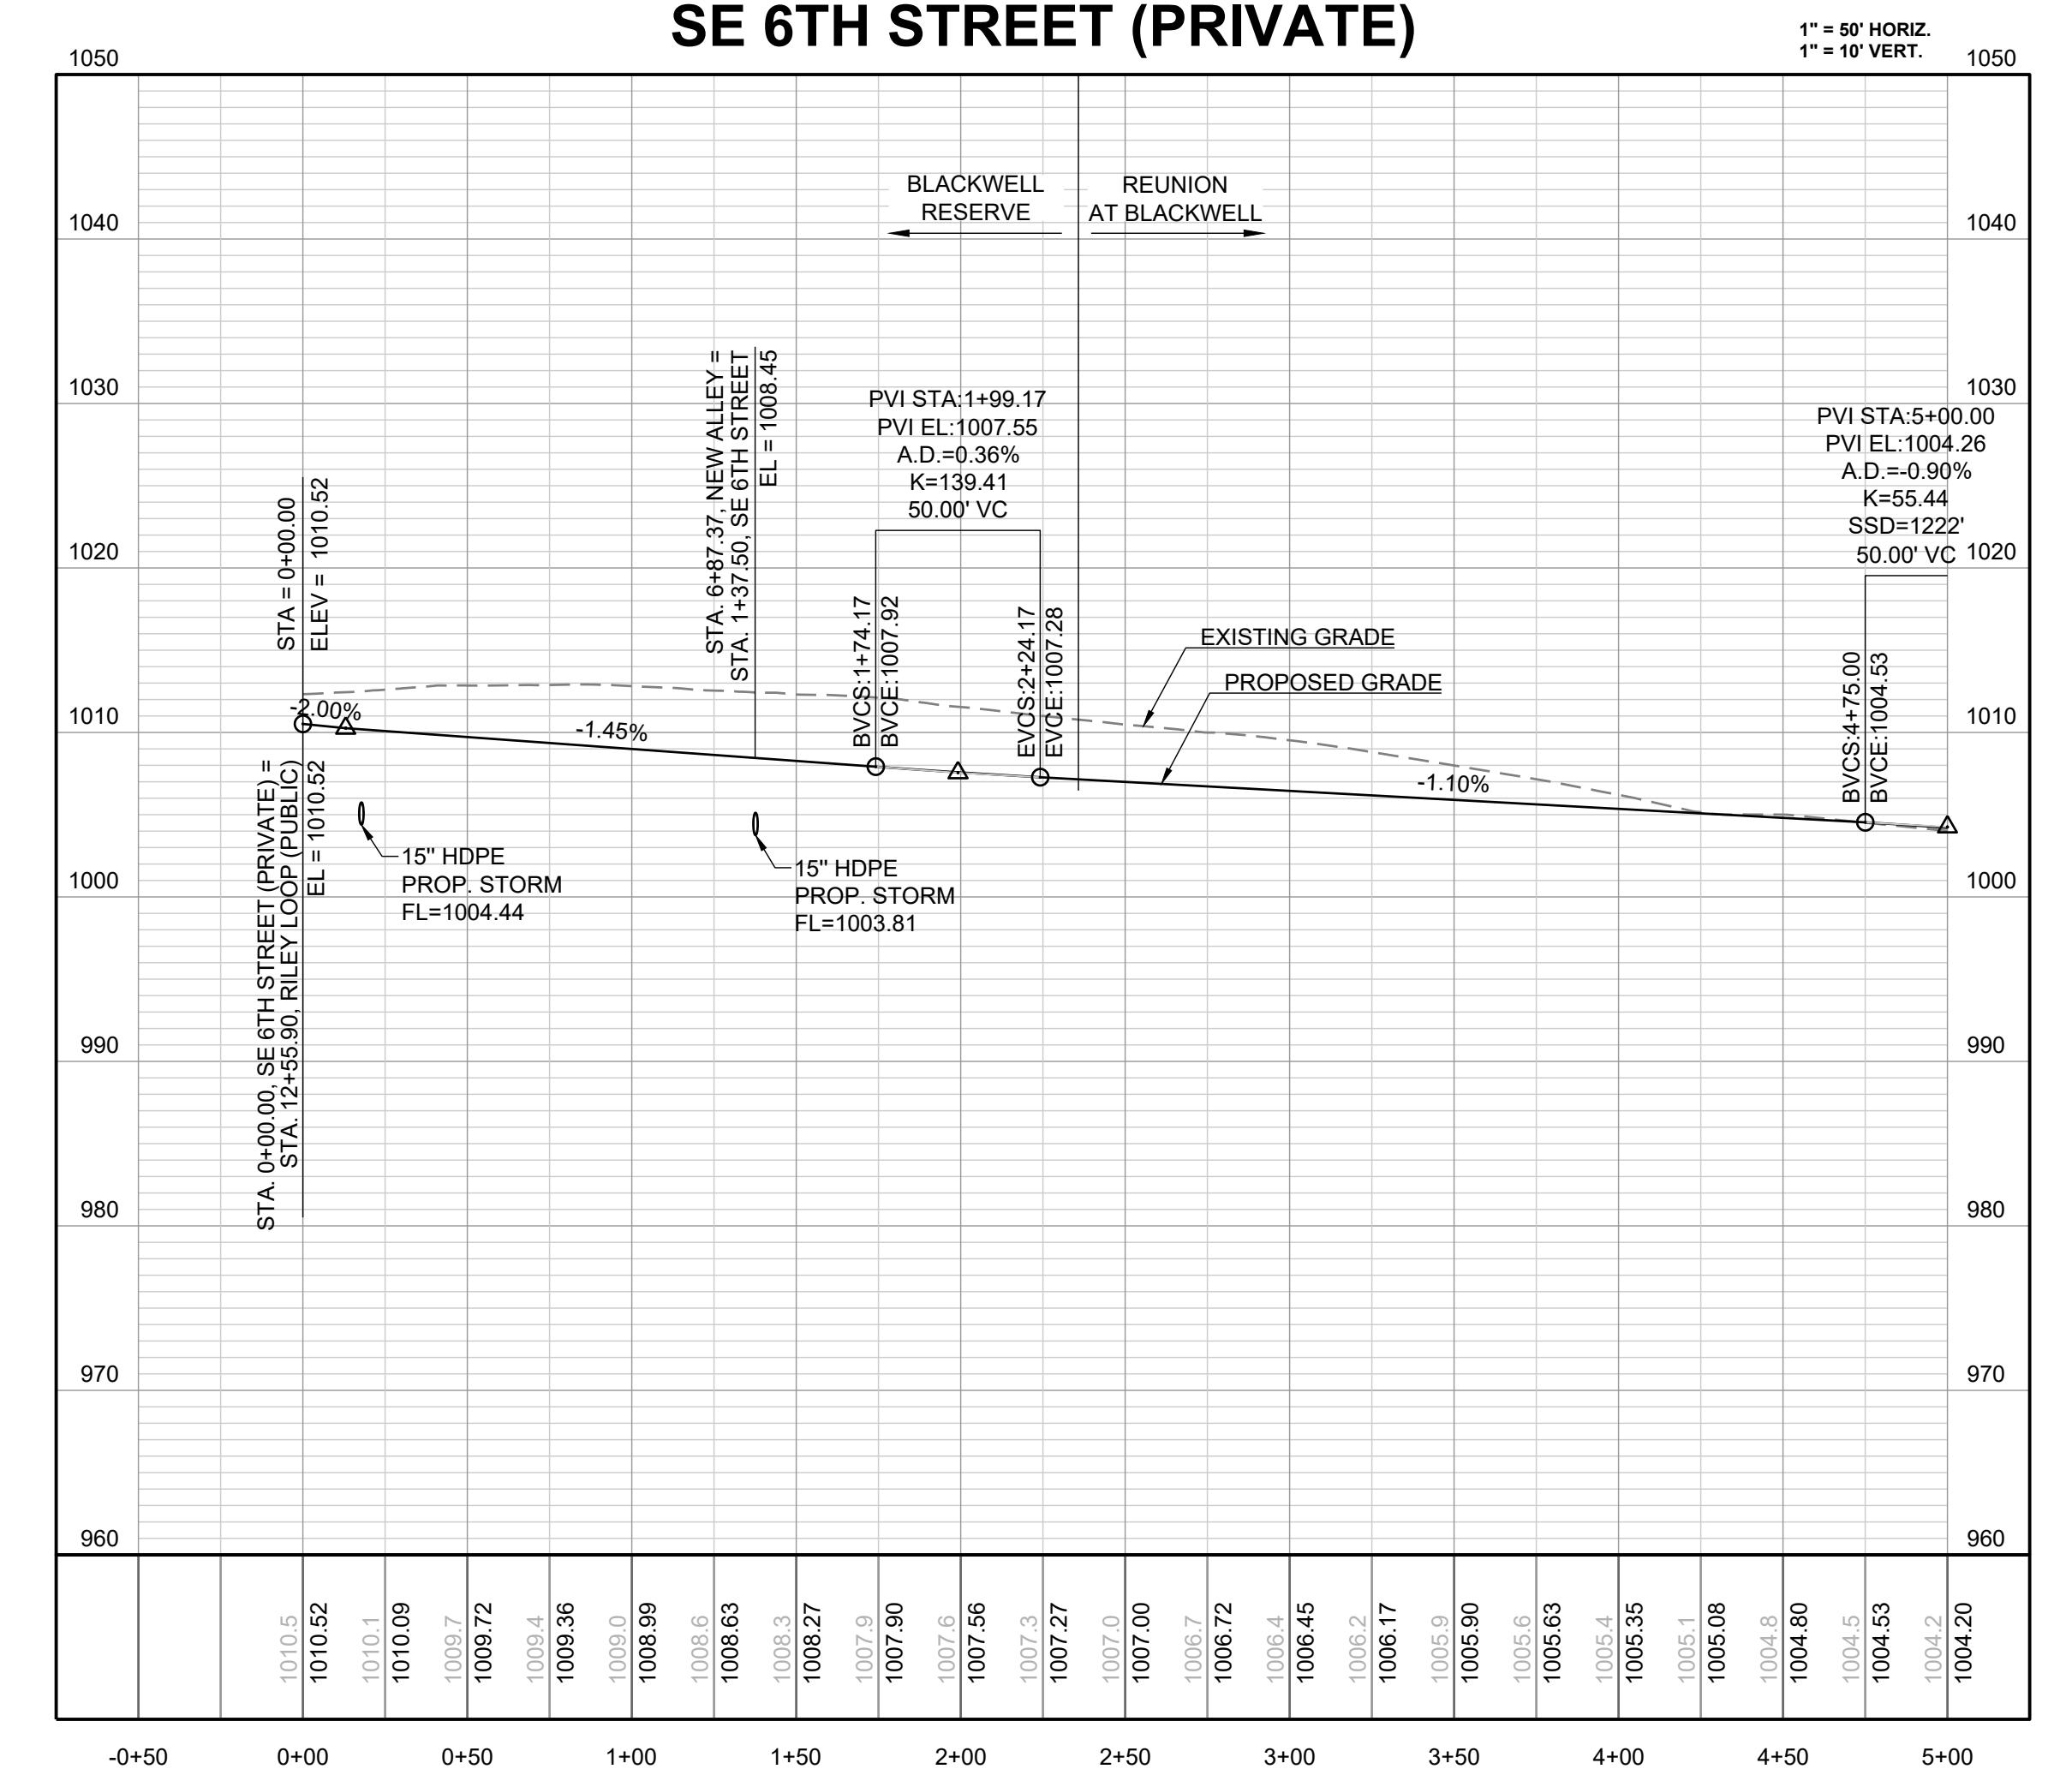
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BLACKWELL RESERVE STREET AND STORM SEWER PLANS

SE SHENANDOAH DRIVE LEE'S SUMMIT, MO

SE 6TH STREET (PRIVATE)




14

SHEET	DRAWN BY: TRC	REVISION DATE: 09/05/2023	DESCRIPTION		
			PER CITY COMMENTS	PER CITY COMMENTS	PER CITY COMMENTS
SE 6TH STREET (PRIVATE) - PLAN & PROFILE	CHECKED BY: MAB	09/05/2023			
	DATE PREPARED: 09/05/2023				
	PROJ. NUMBER: 22-093				

PREPARED BY:

 MARK ALLEN BREUER
 PE-2009007268
 09.06.2023

SCHLAGEL & ASSOCIATES, P.A.

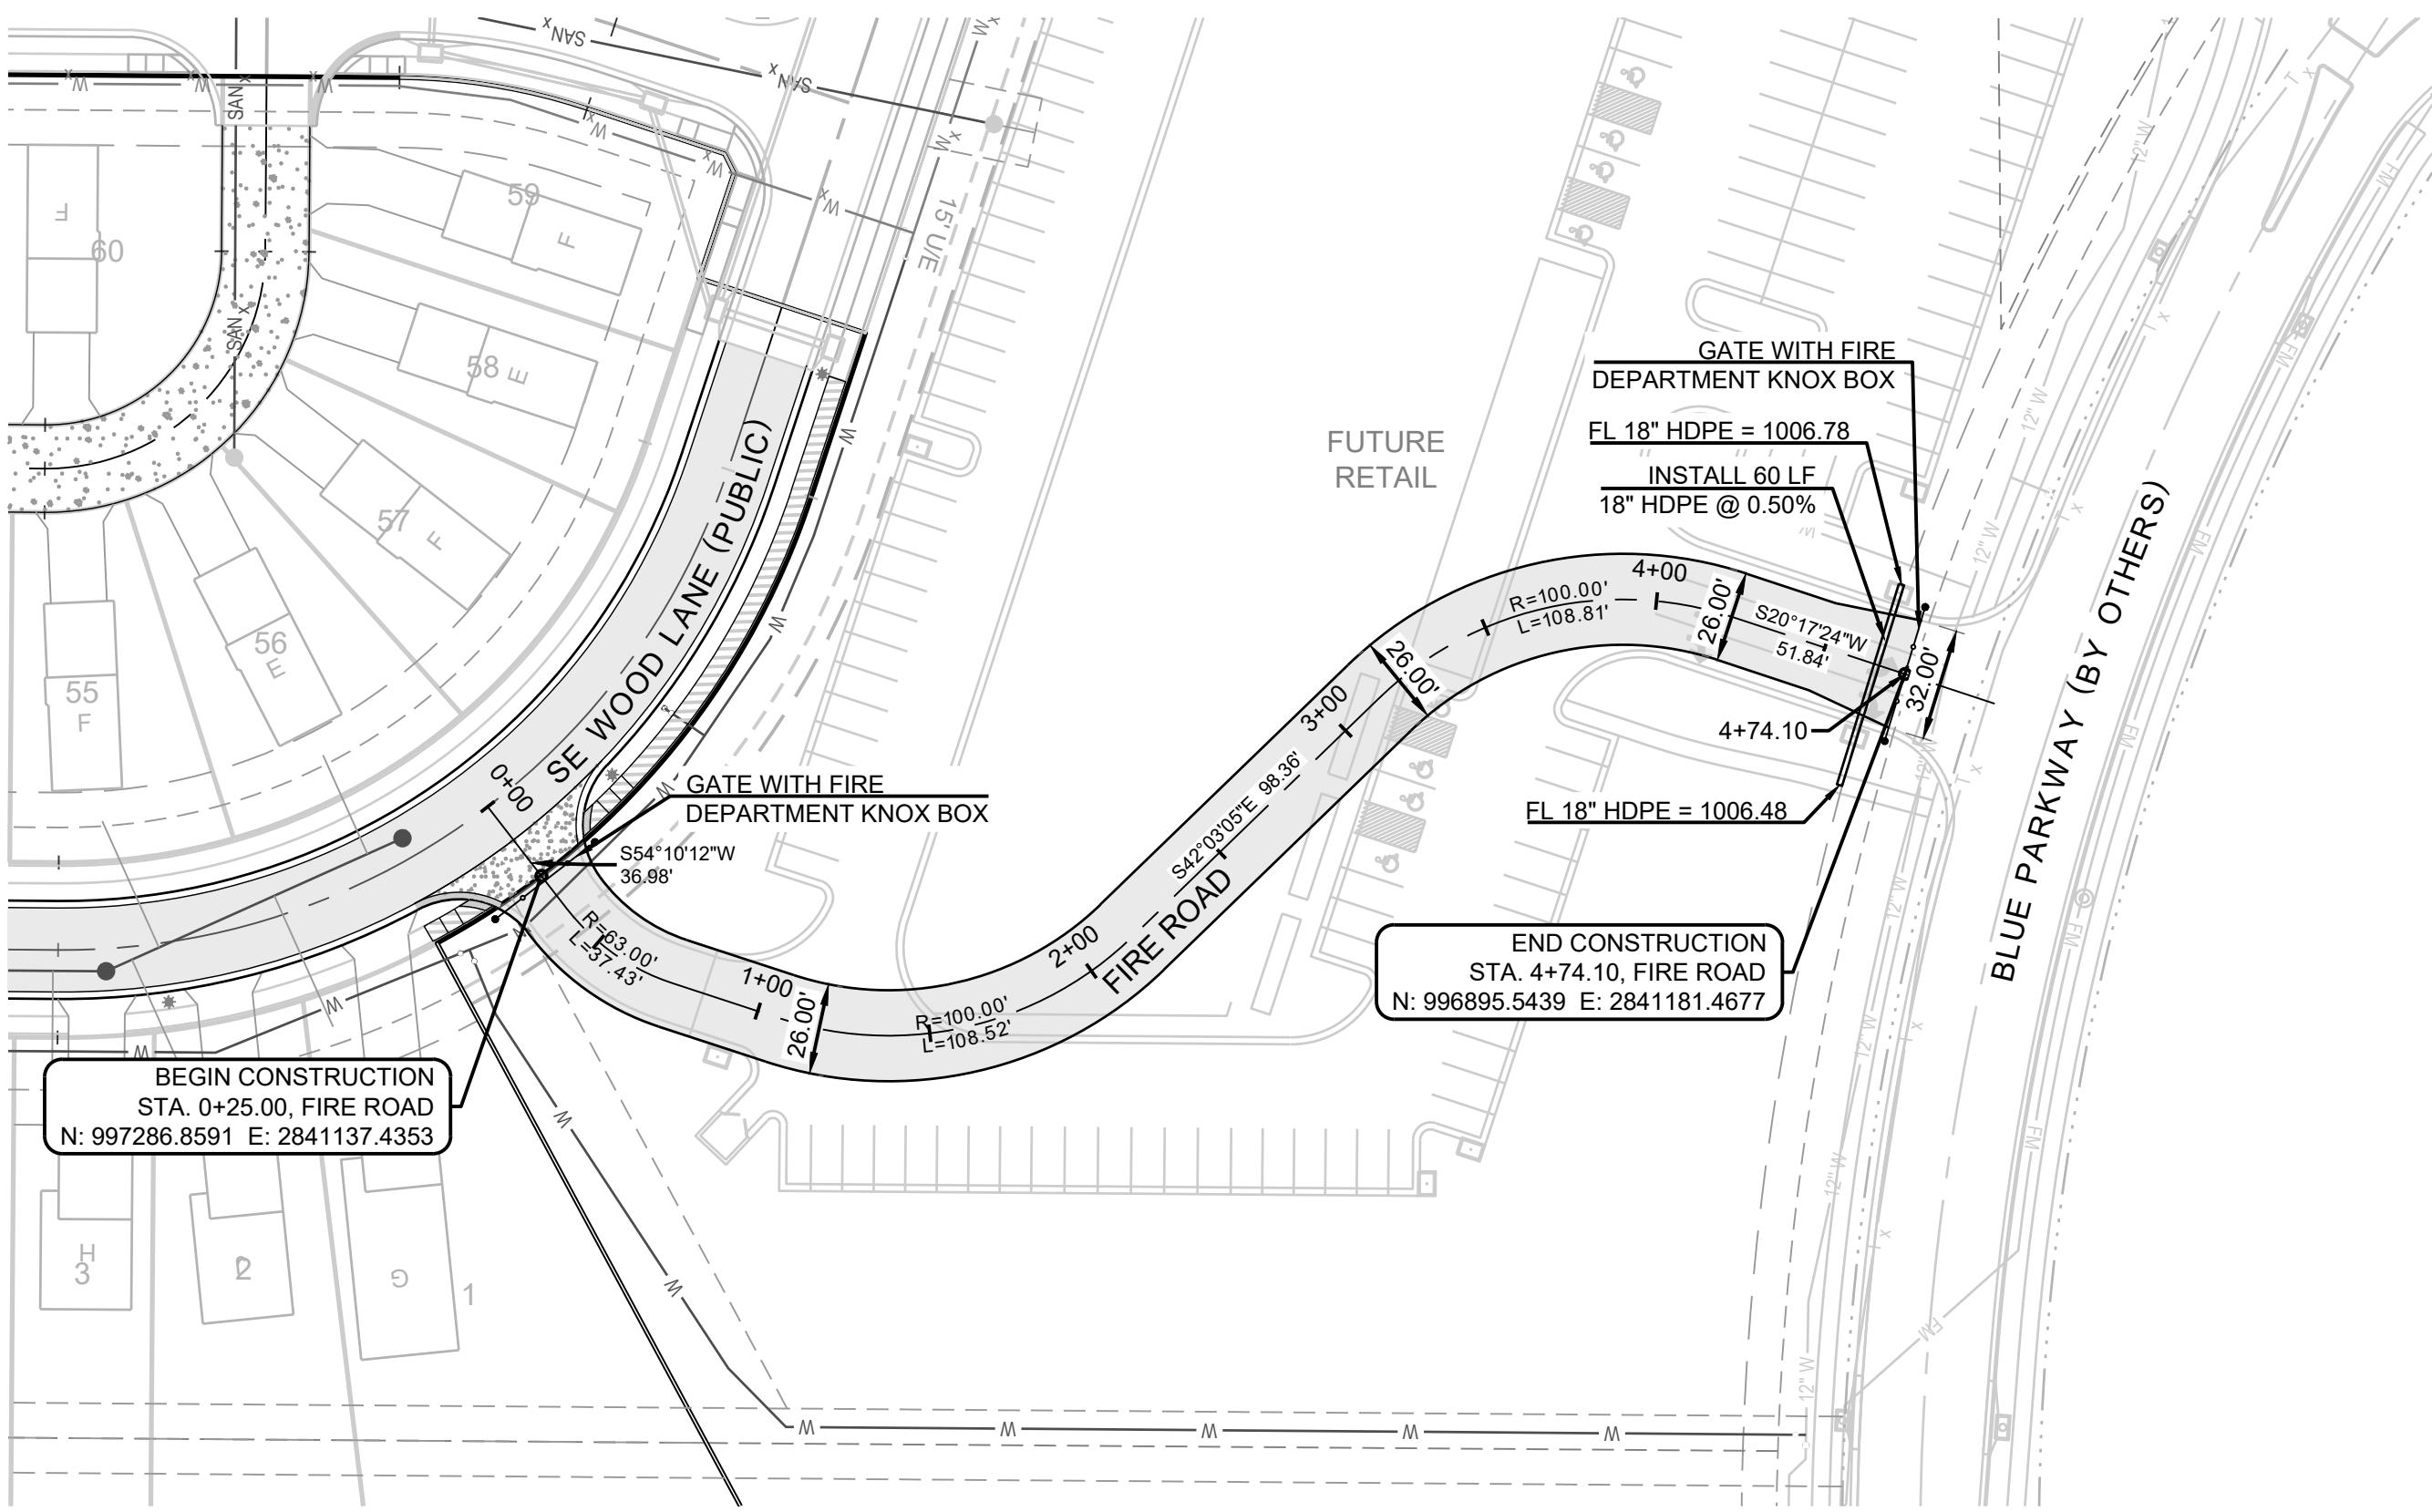

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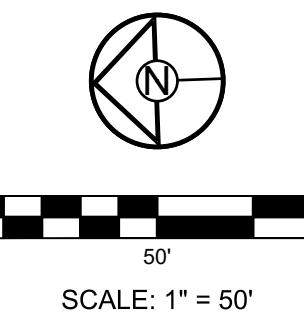
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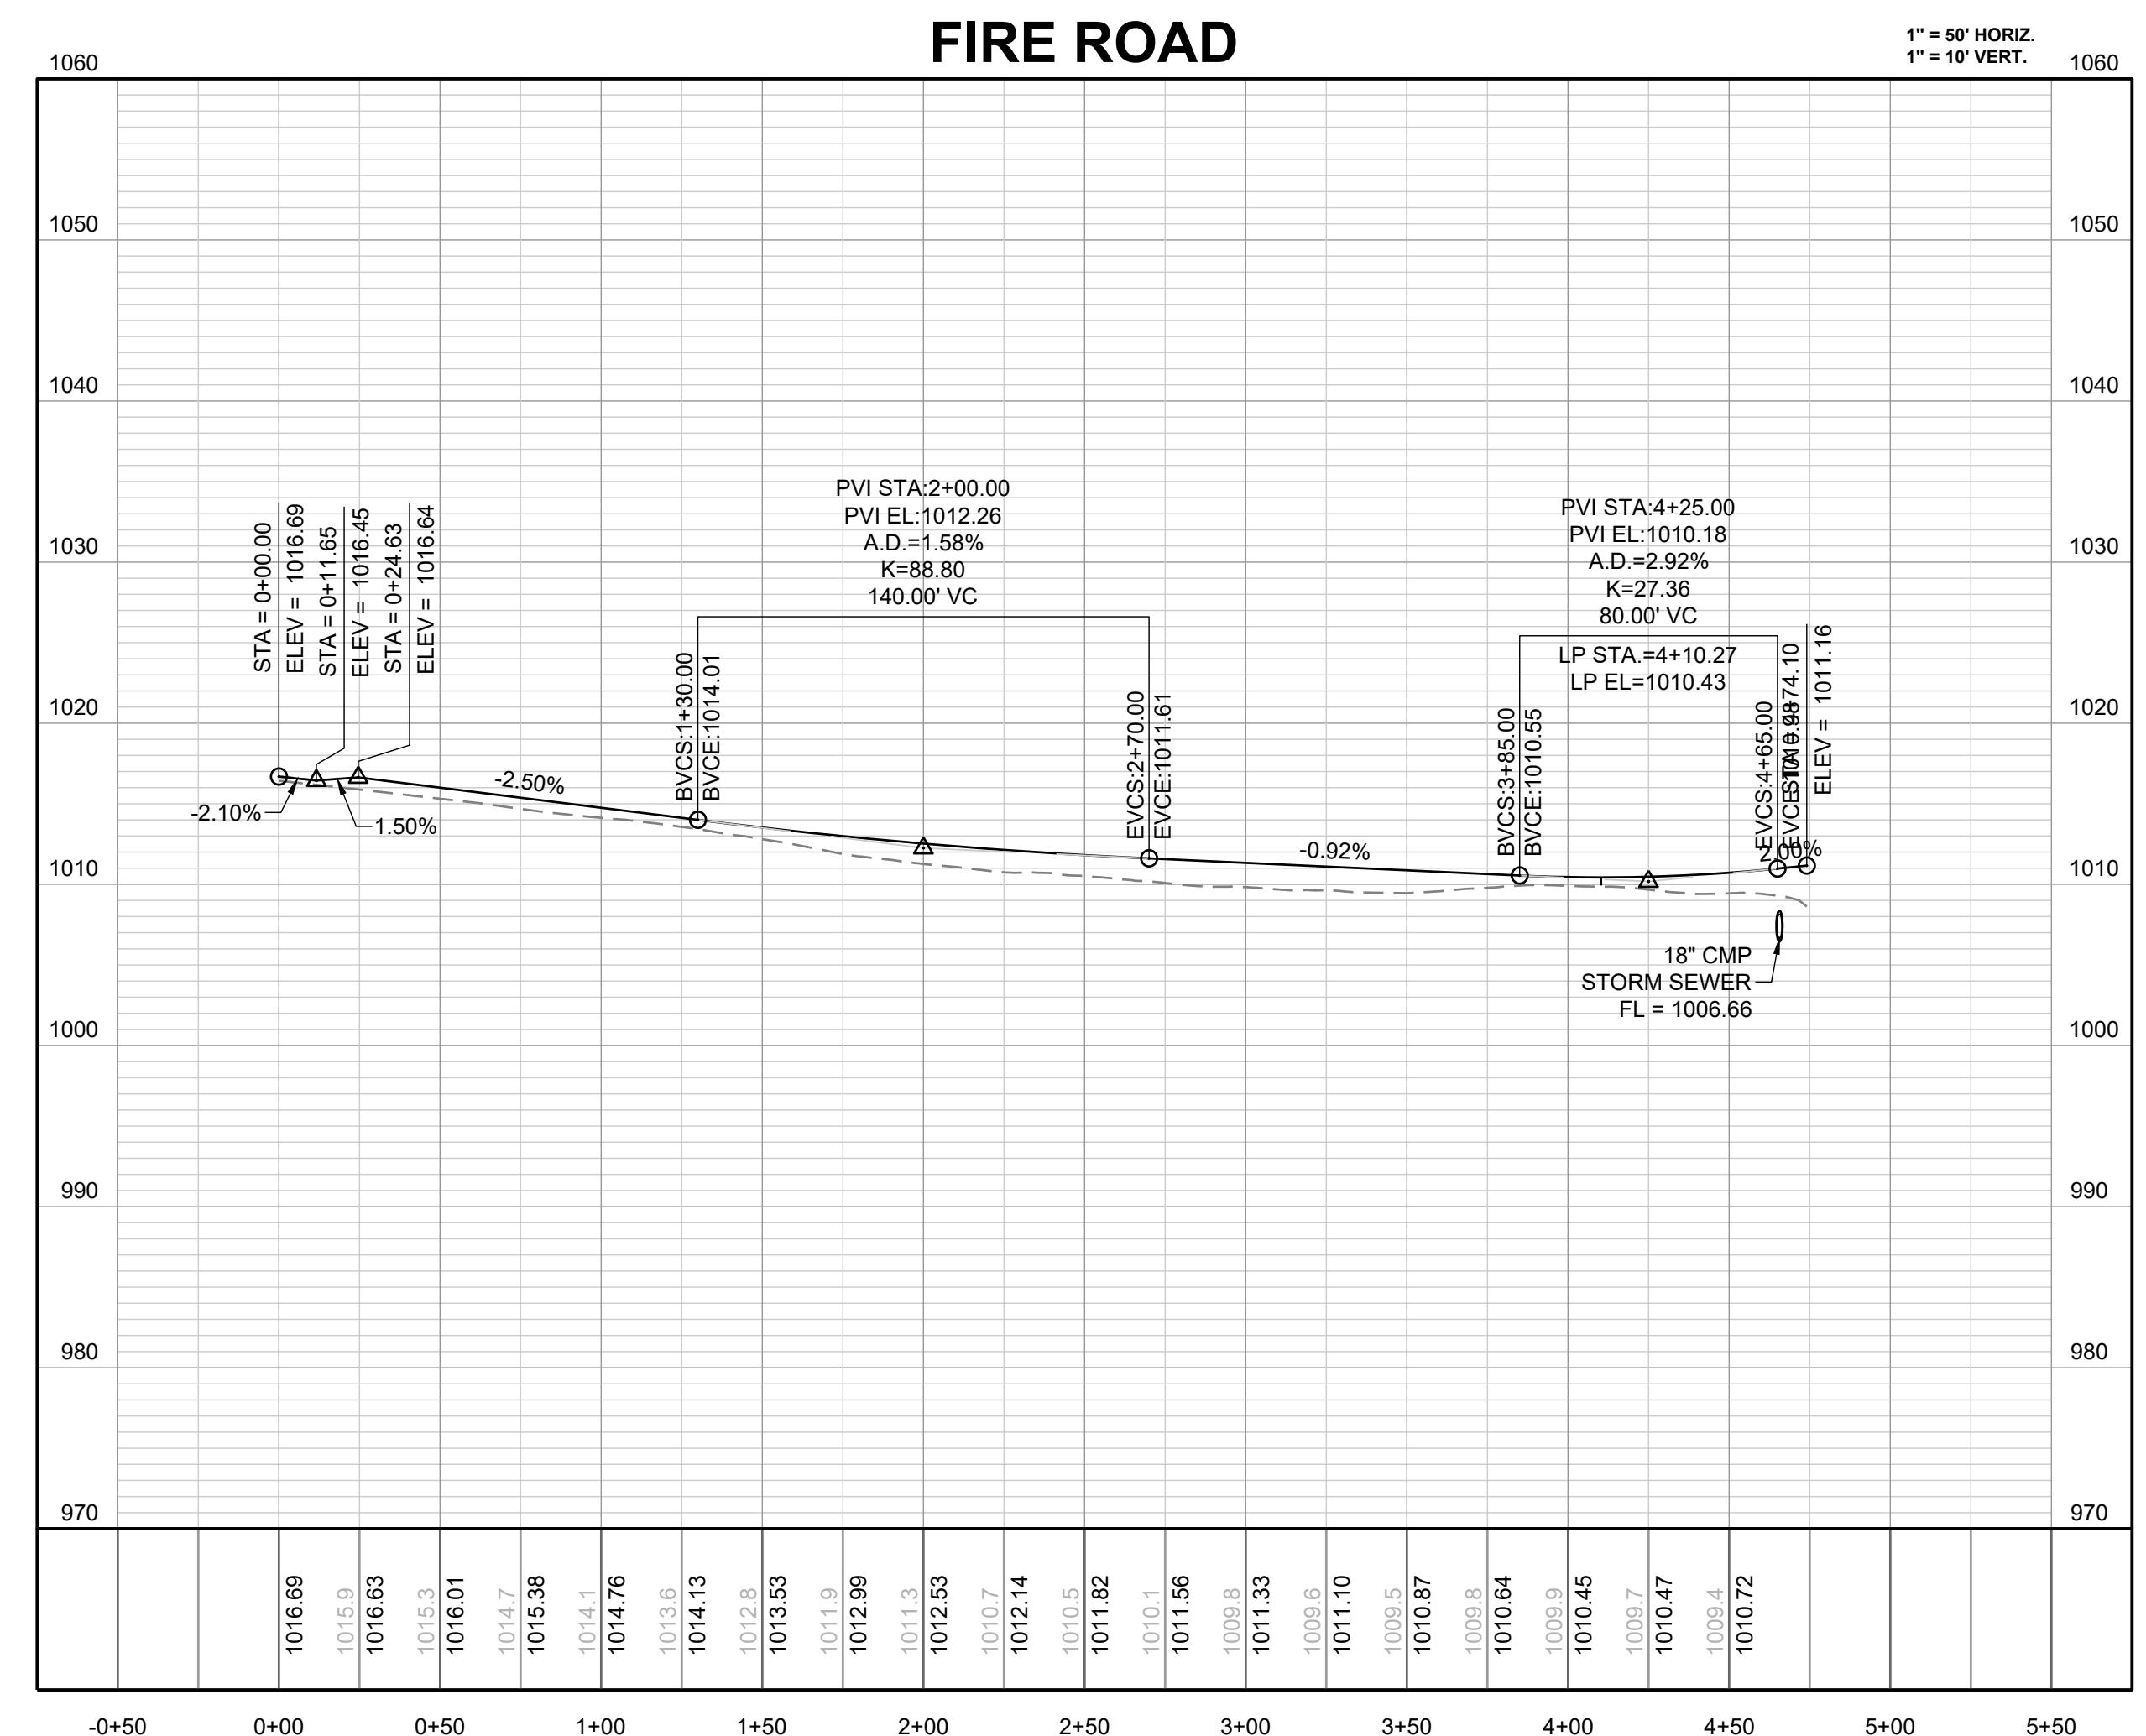
ELEV. 1005.719




SCALE: 1" = 50'


RELEASED FOR CONSTRUCTION

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Development Services Department
Lee's Summit, Missouri
09/21/2023



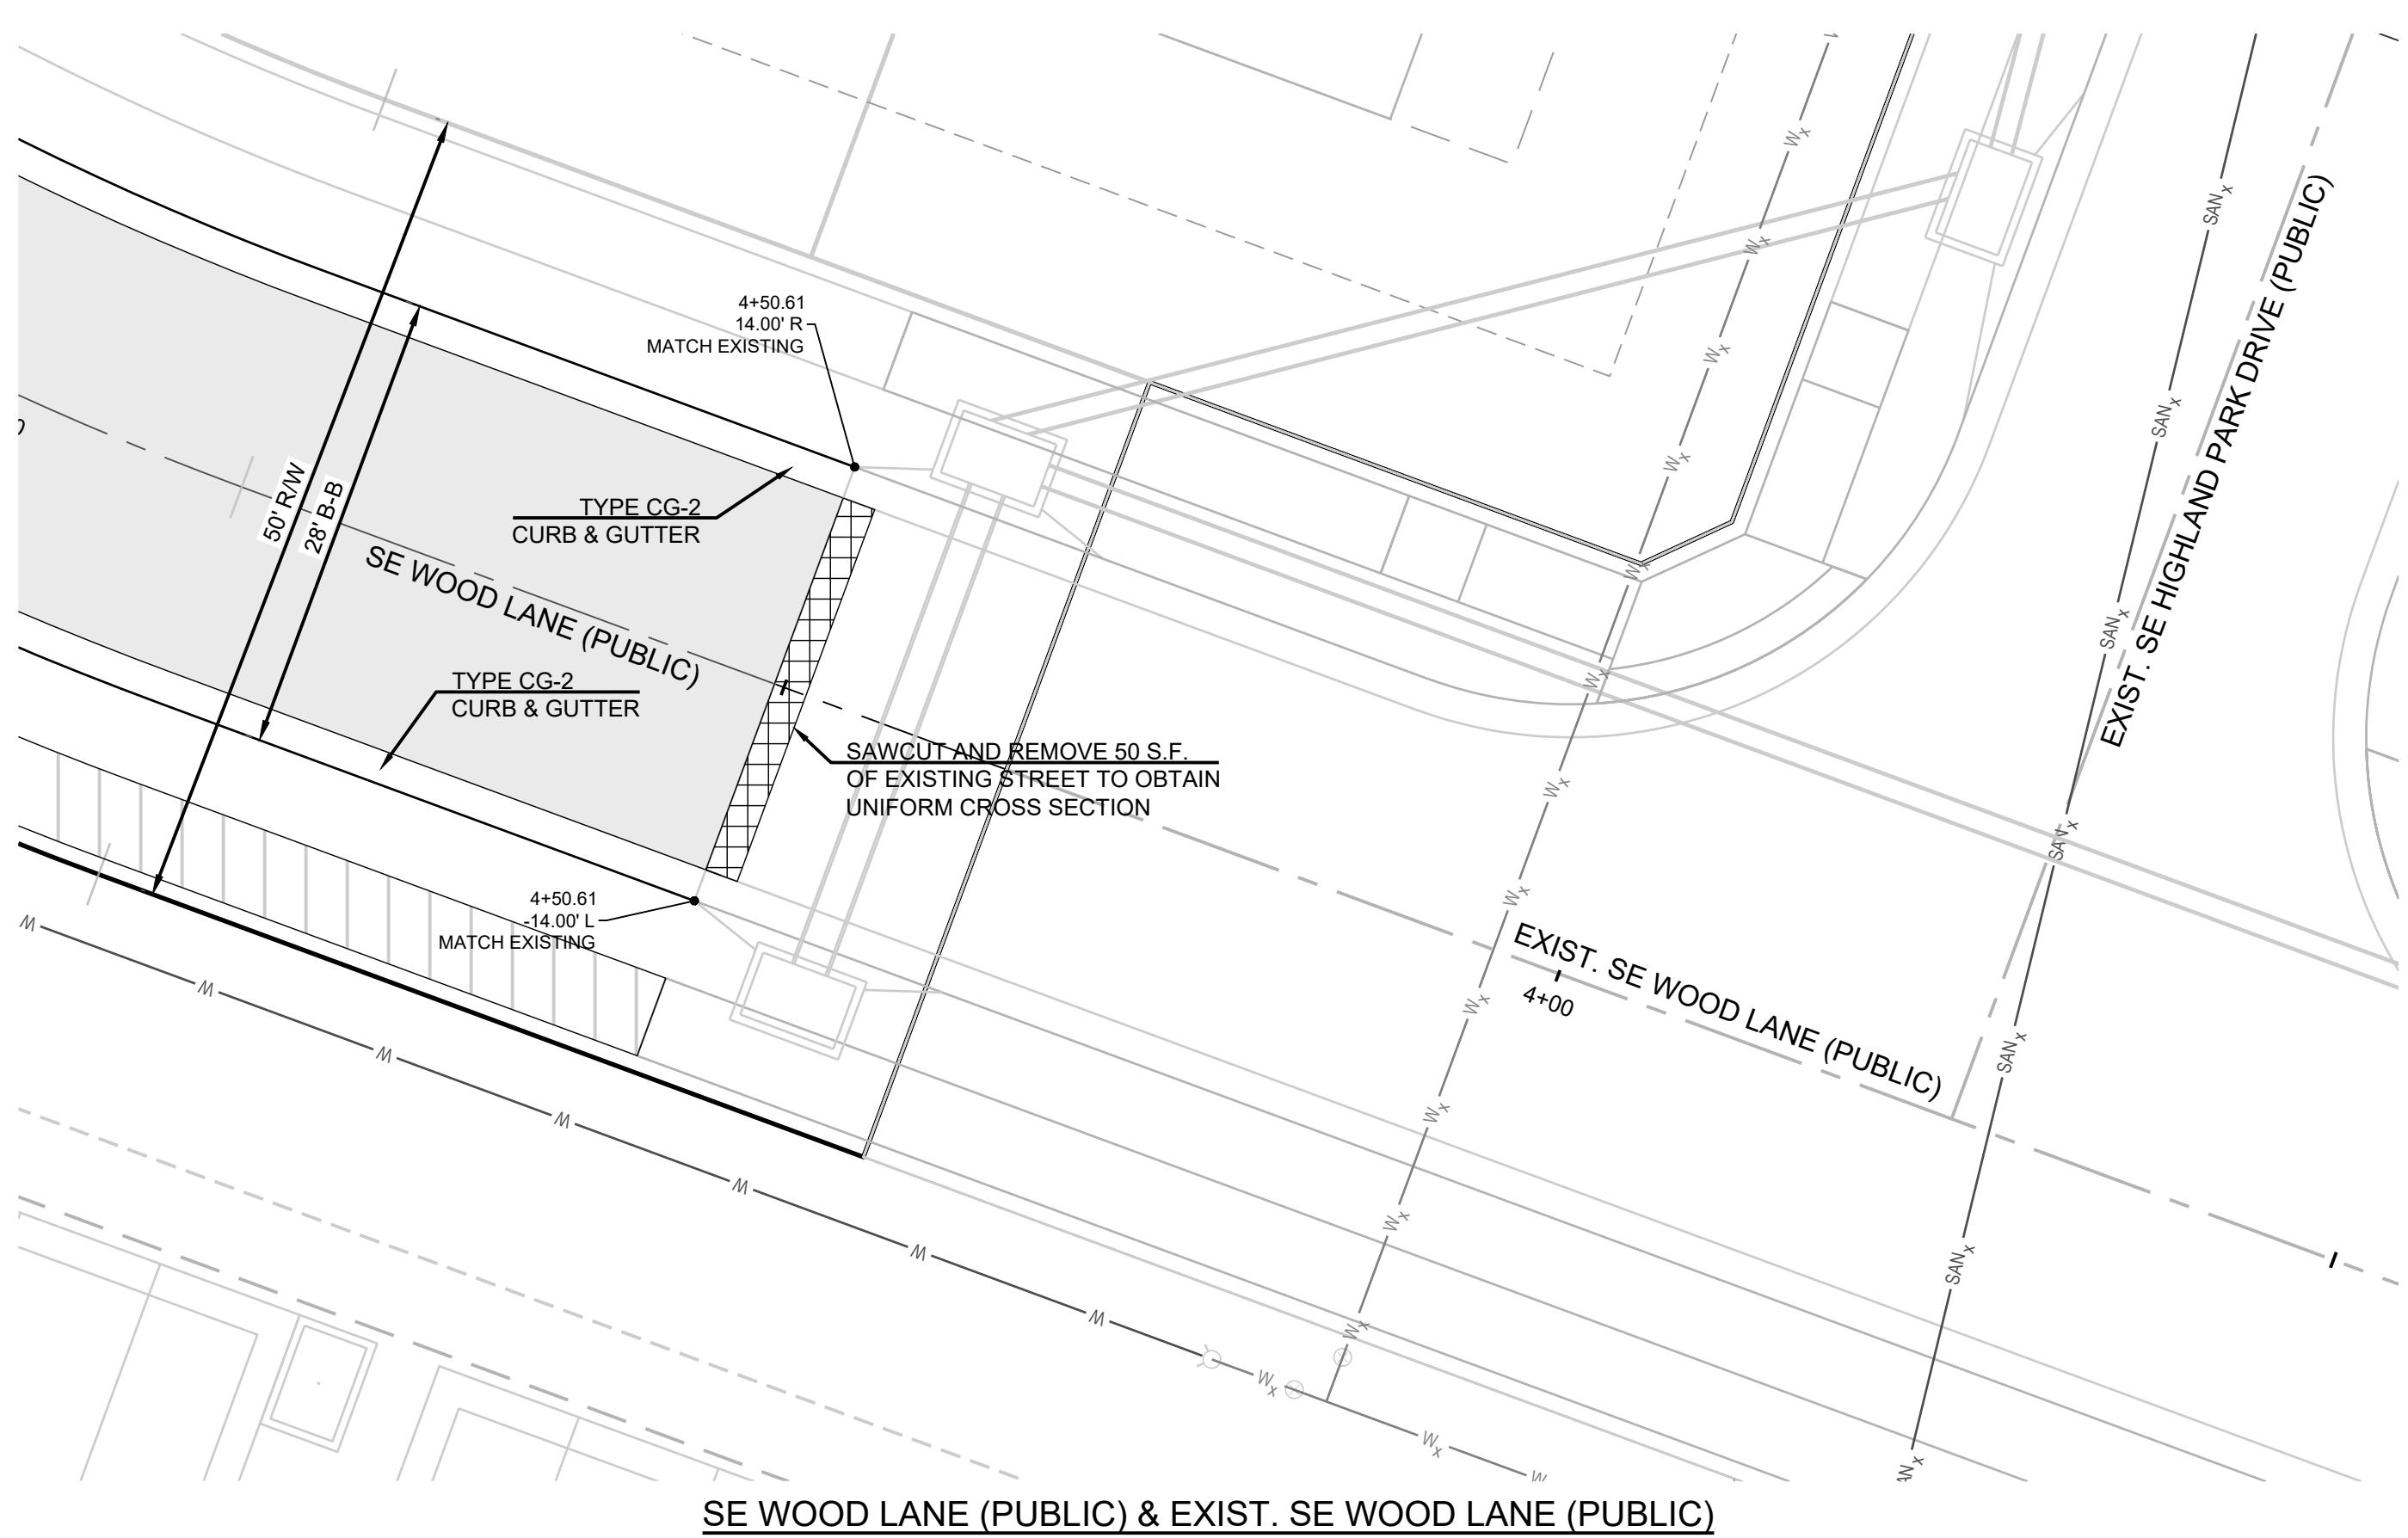


SE WOOD LANE (PUBLIC) & EXIST. SE WOOD LANE (PUBLIC)

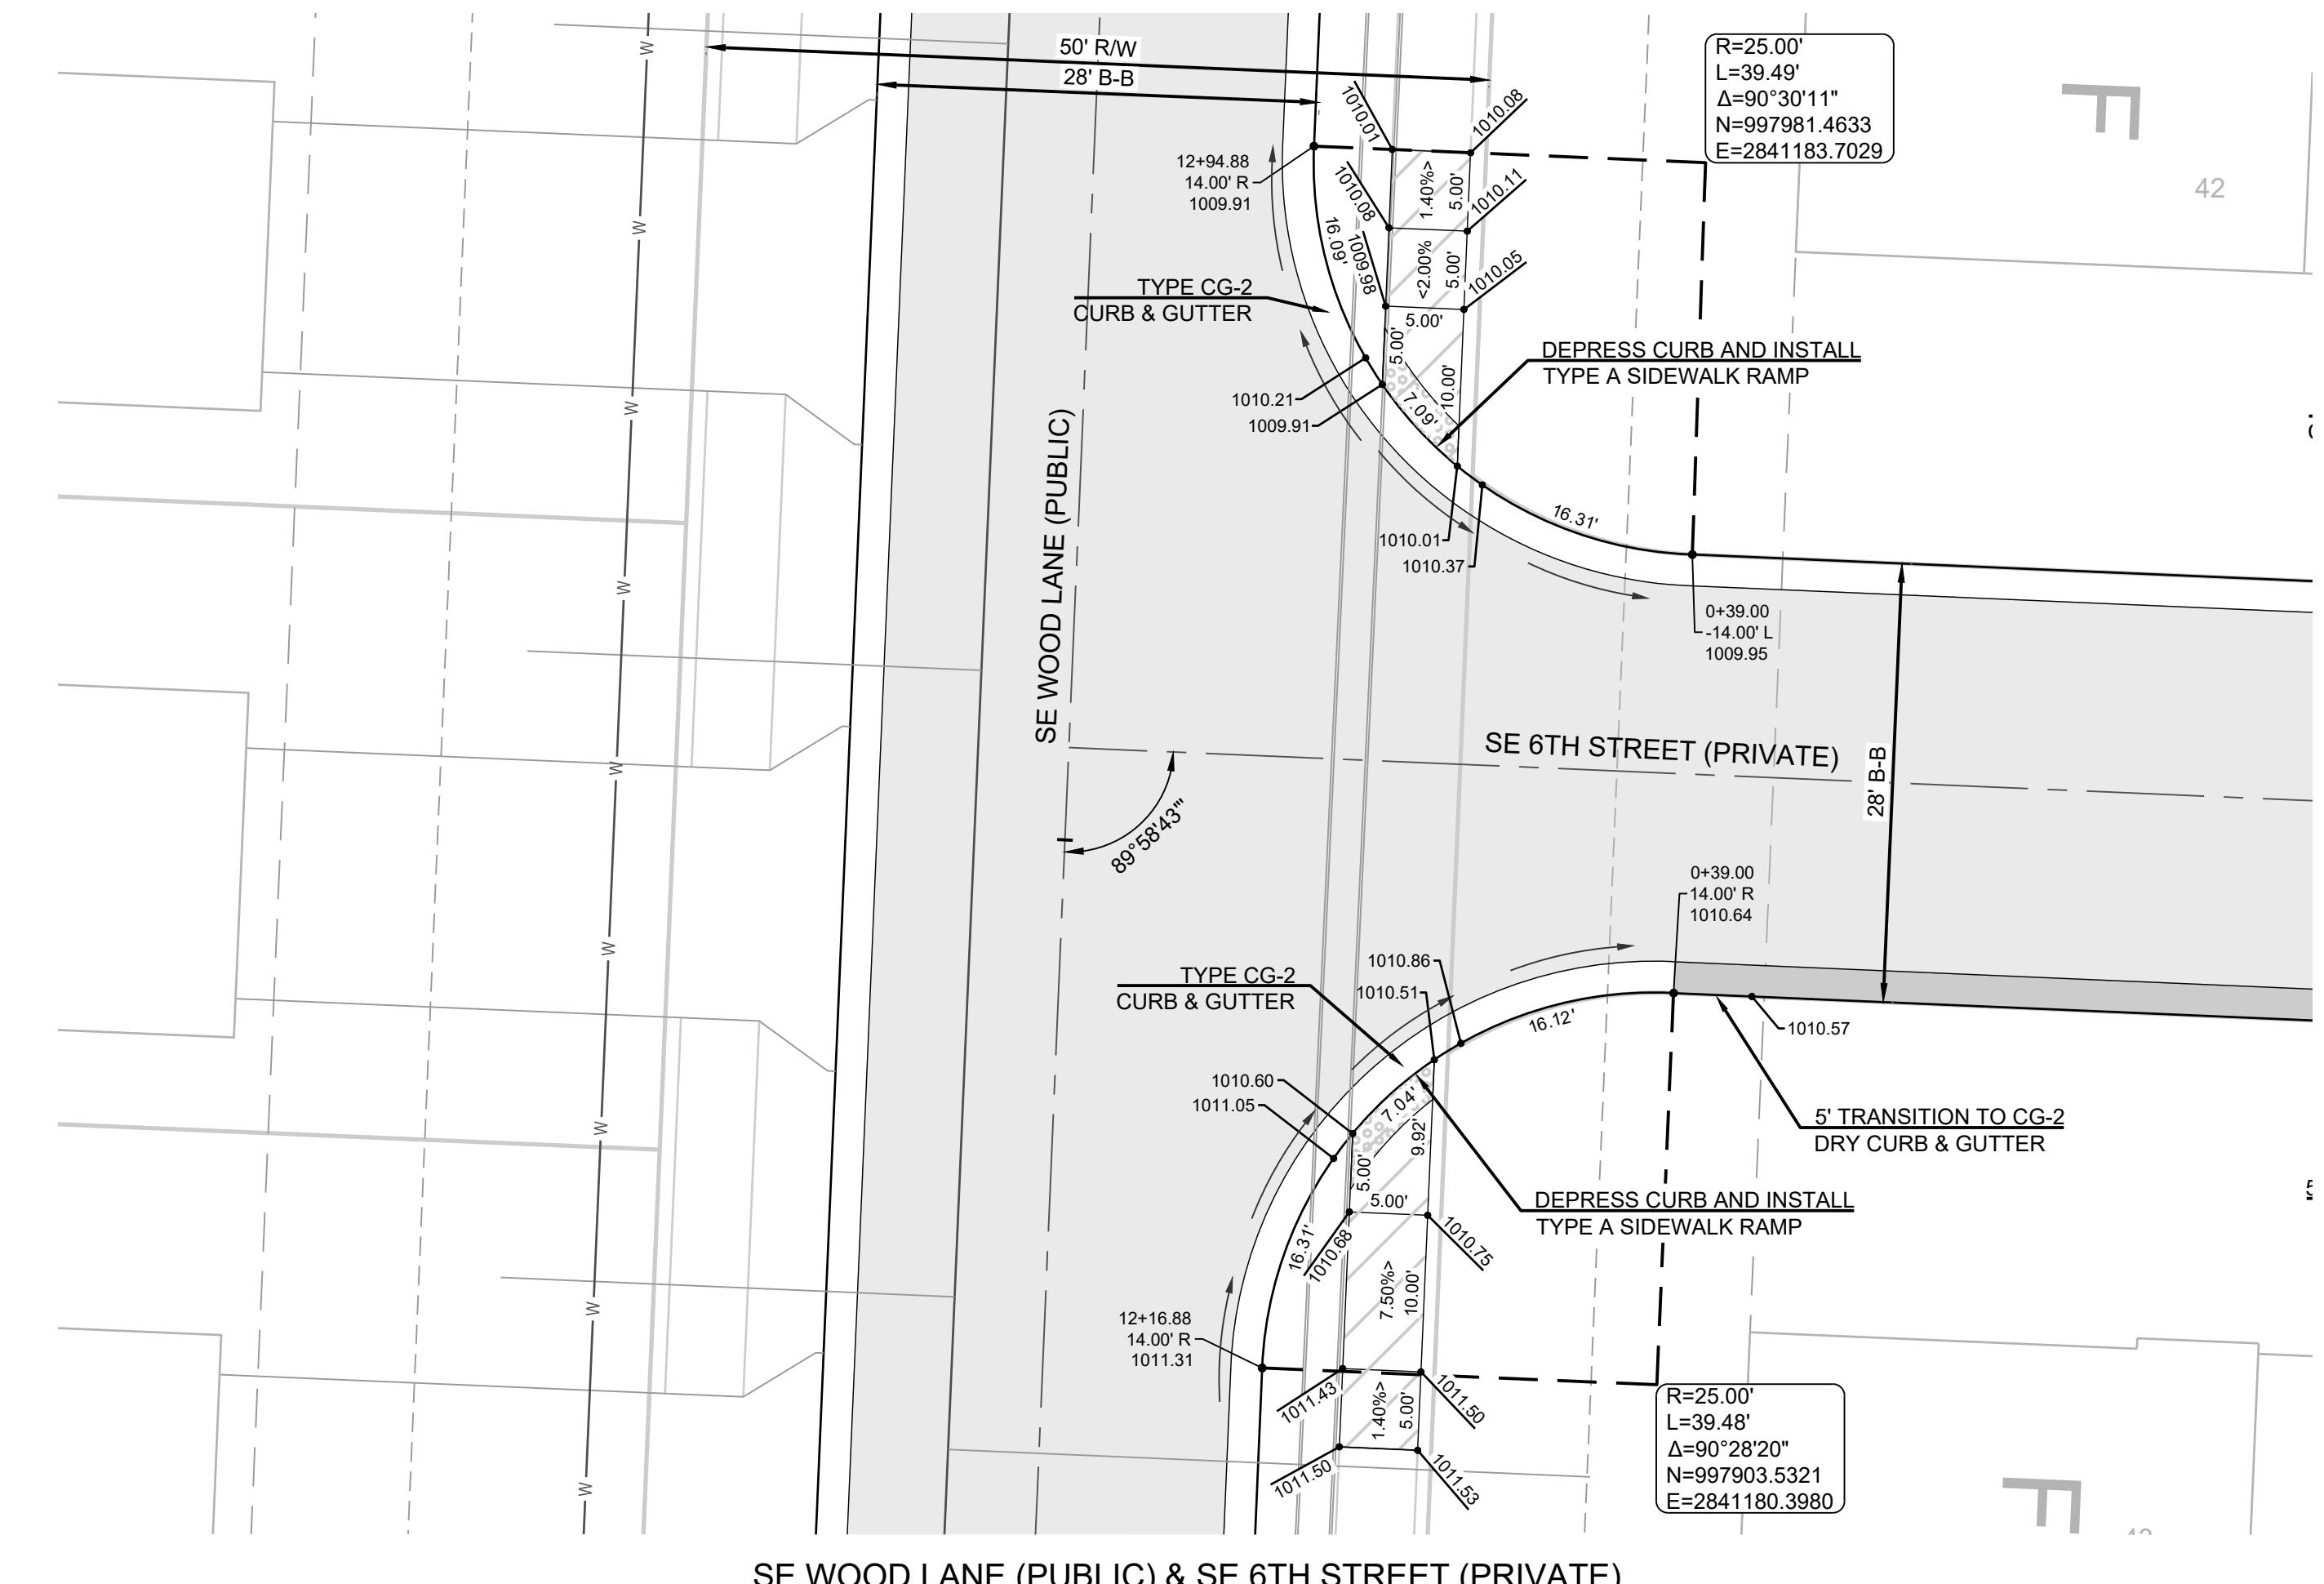


SE WOOD LANE (PUBLIC) & SE 6TH STREET (PRIVATE)


RELEASED FOR CONSTRUCTION

As Noted on Plan Review

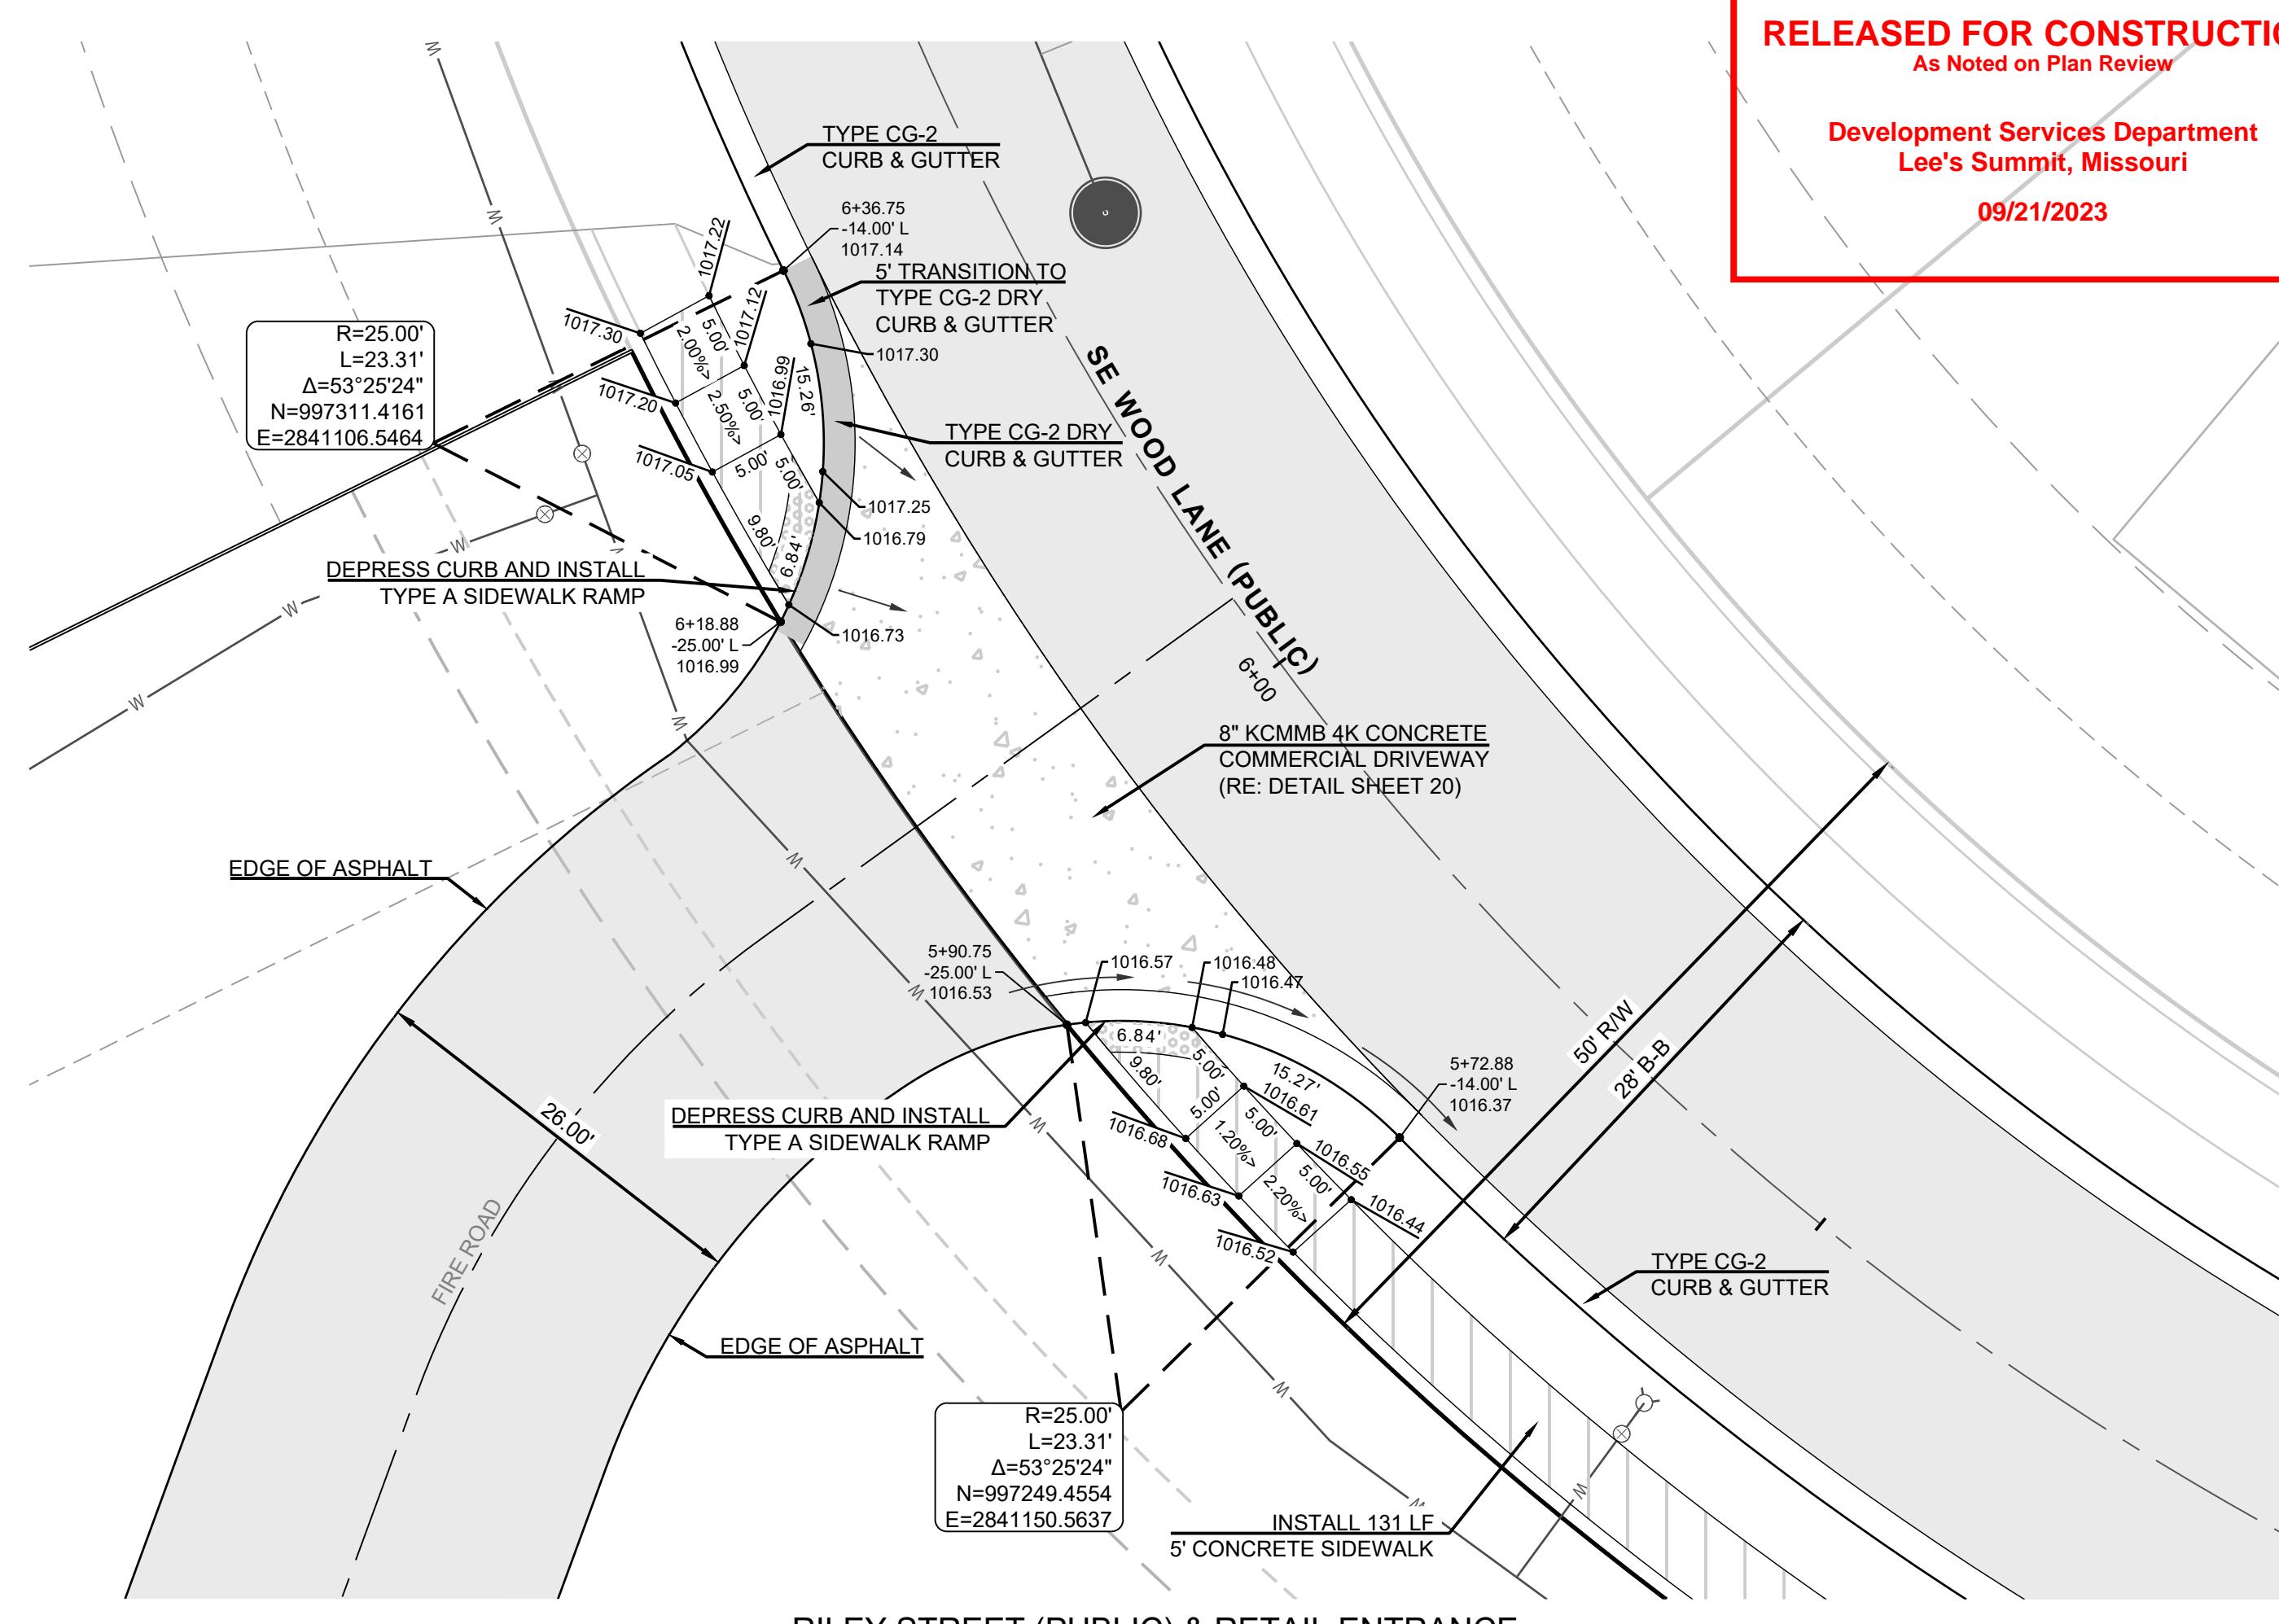

RILEY STREET (PUBLIC) & RETAIL ENTRANCE

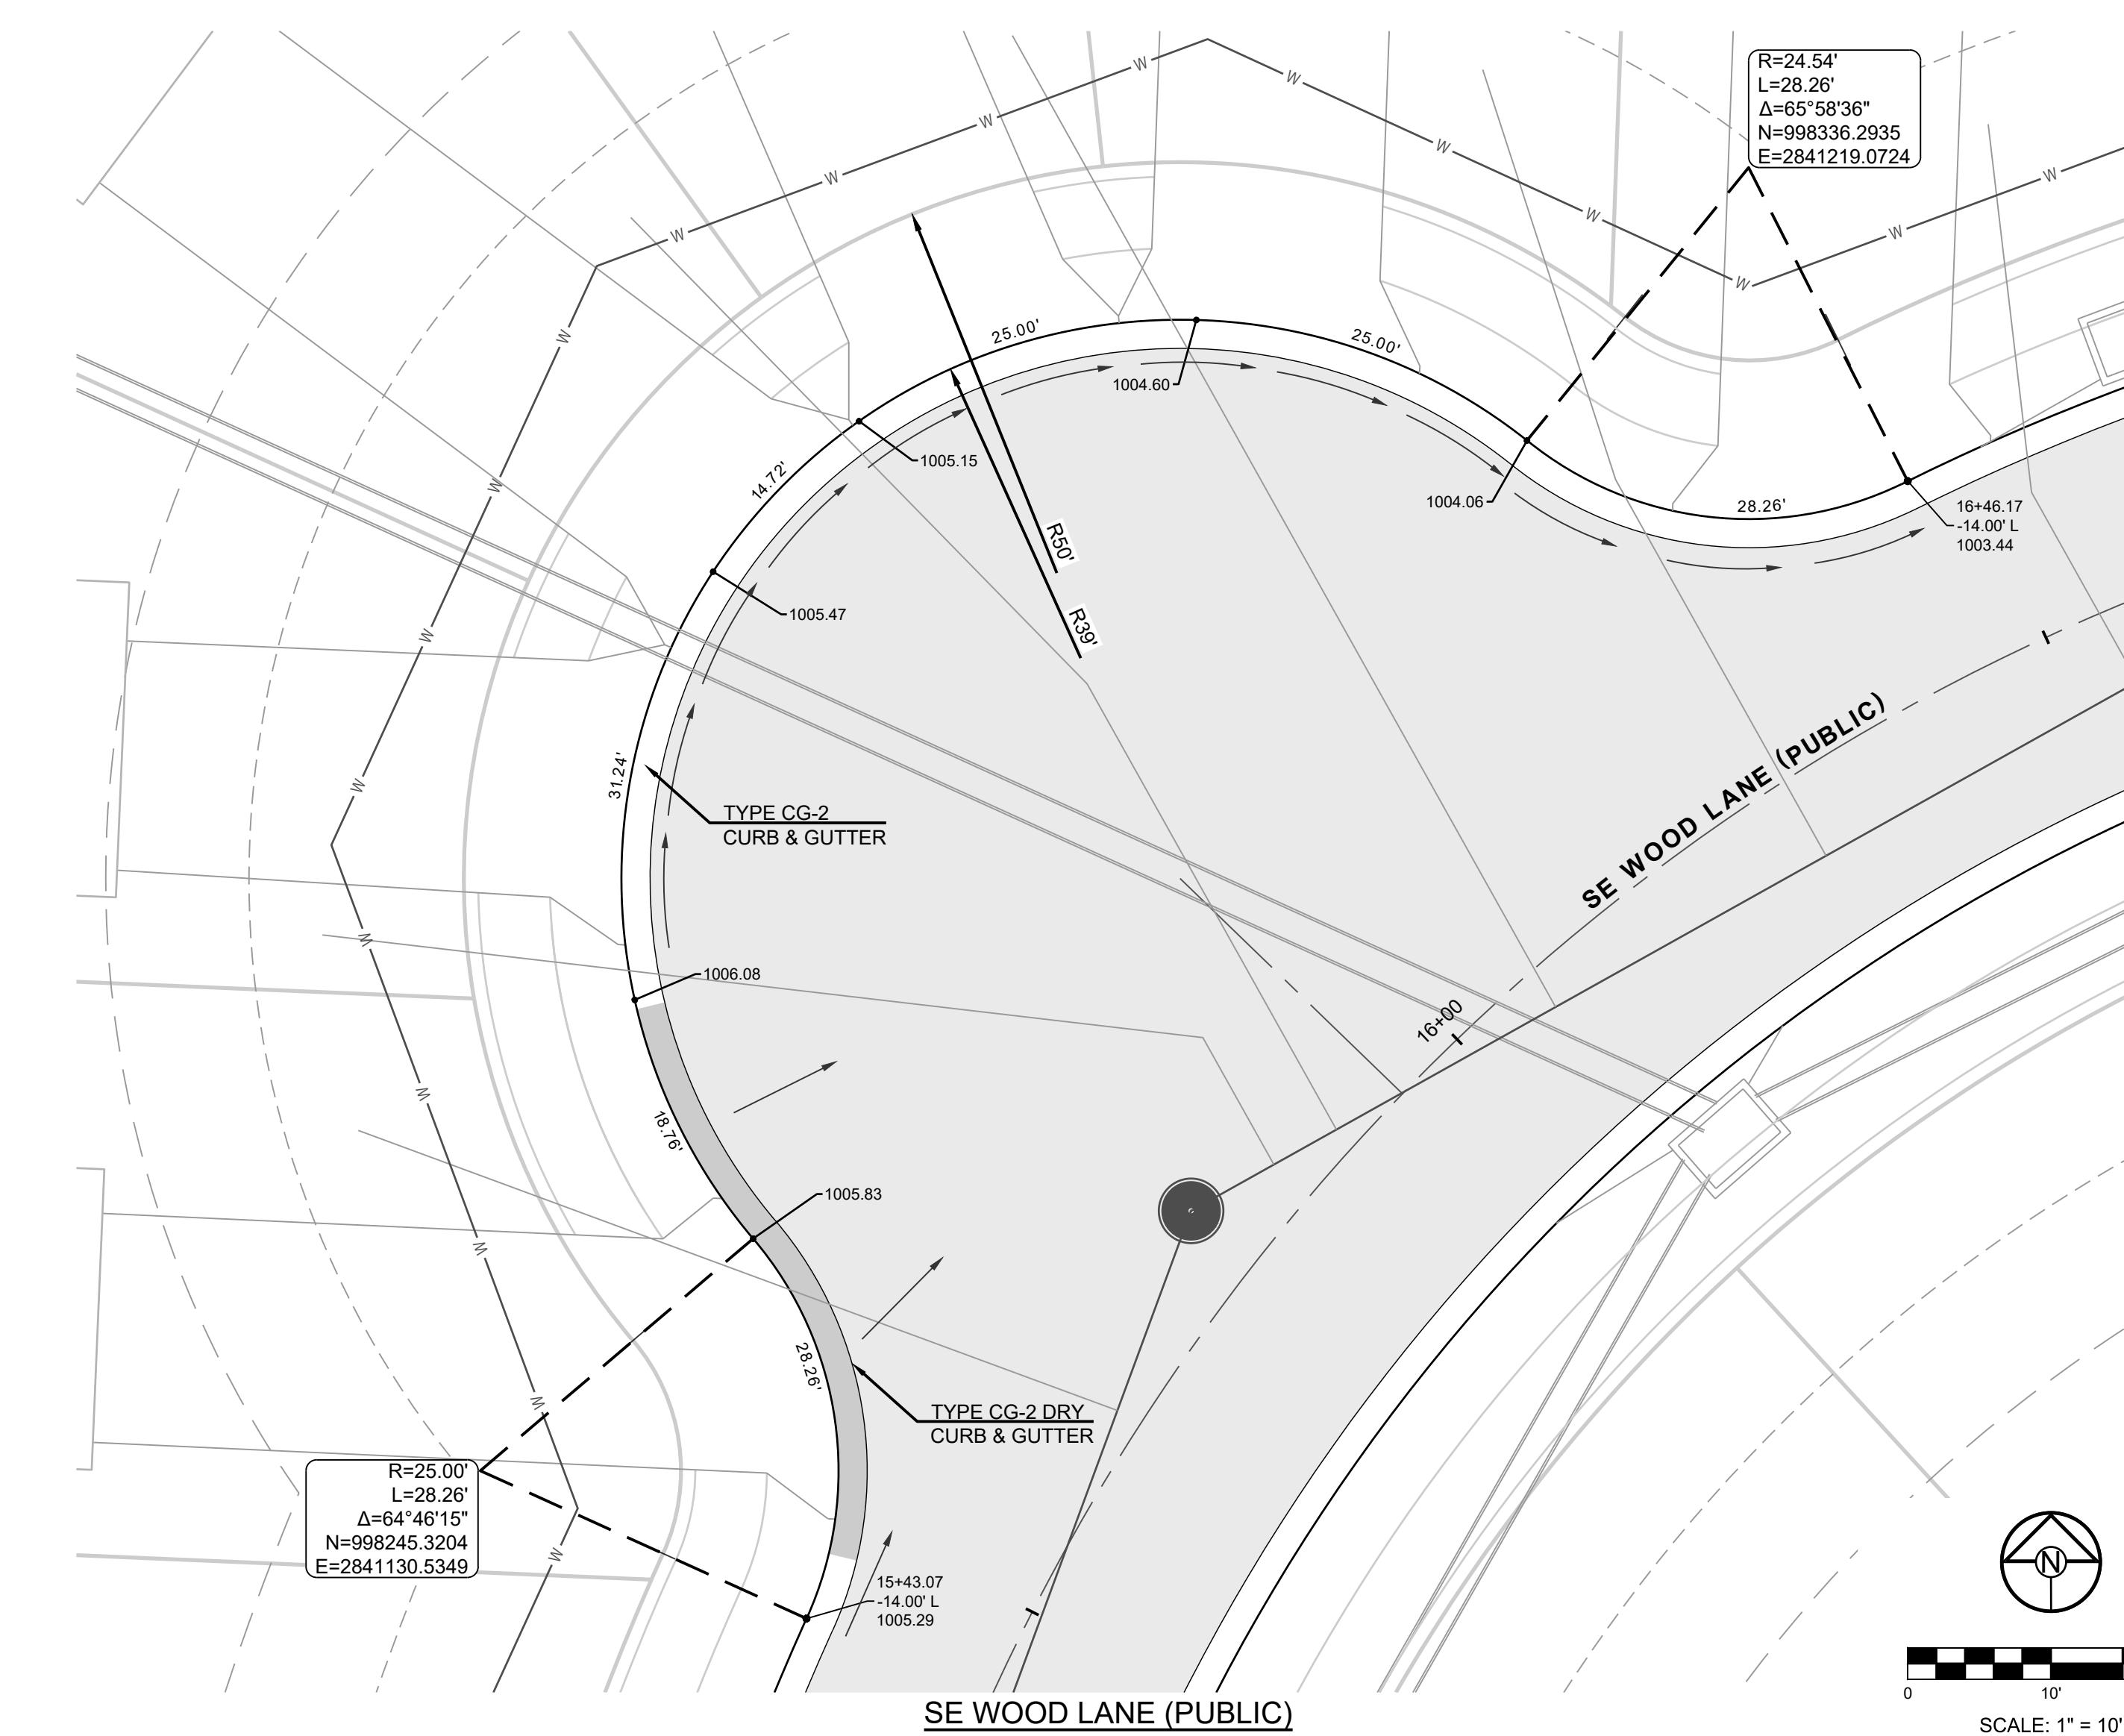

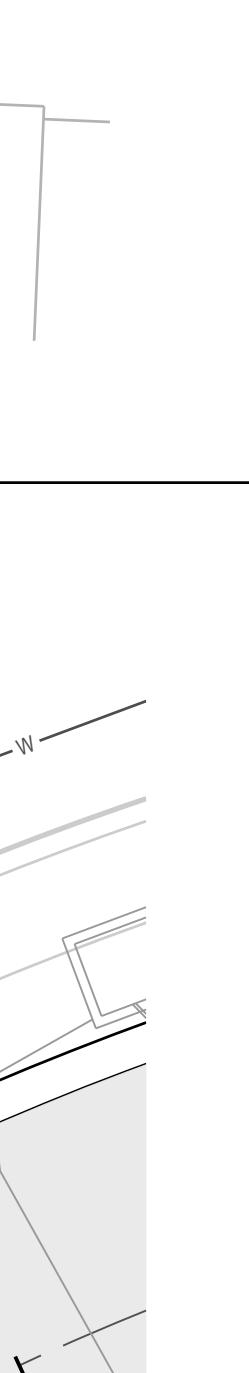

BLACKWELL RESERVE STREET AND STORM SEWER PLANS

16



A circular seal for a Missouri professional engineer. The outer ring contains the words "STATE OF MISSOURI" at the top and "PROFESSIONAL ENGINEER" at the bottom, separated by stars. The inner circle contains the name "MARK ALLEN BREUER" above the word "NUMBER", which is followed by the identification number "PE-2009007268". A blue signature line is visible across the center of the seal.

RELEASED FOR CONSTRUCTION

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Development Services Department
Lee's Summit, Missouri
09/21/2023

SCHLAGEL

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MAILING ADDRESS: 14920 W 107TH ST, LENEXA, KS 66215
#E2020038005 F BLAC201000237 45 S202008859-F



PREPARED BY:



SCHLAGEL & ASSOCIATES, P.A.

**BLACKWELL RESERVE
STREET AND STORM SEWER PLANS**

SE SHENANDOAH DRIVE LEE'S SUMMIT, MO

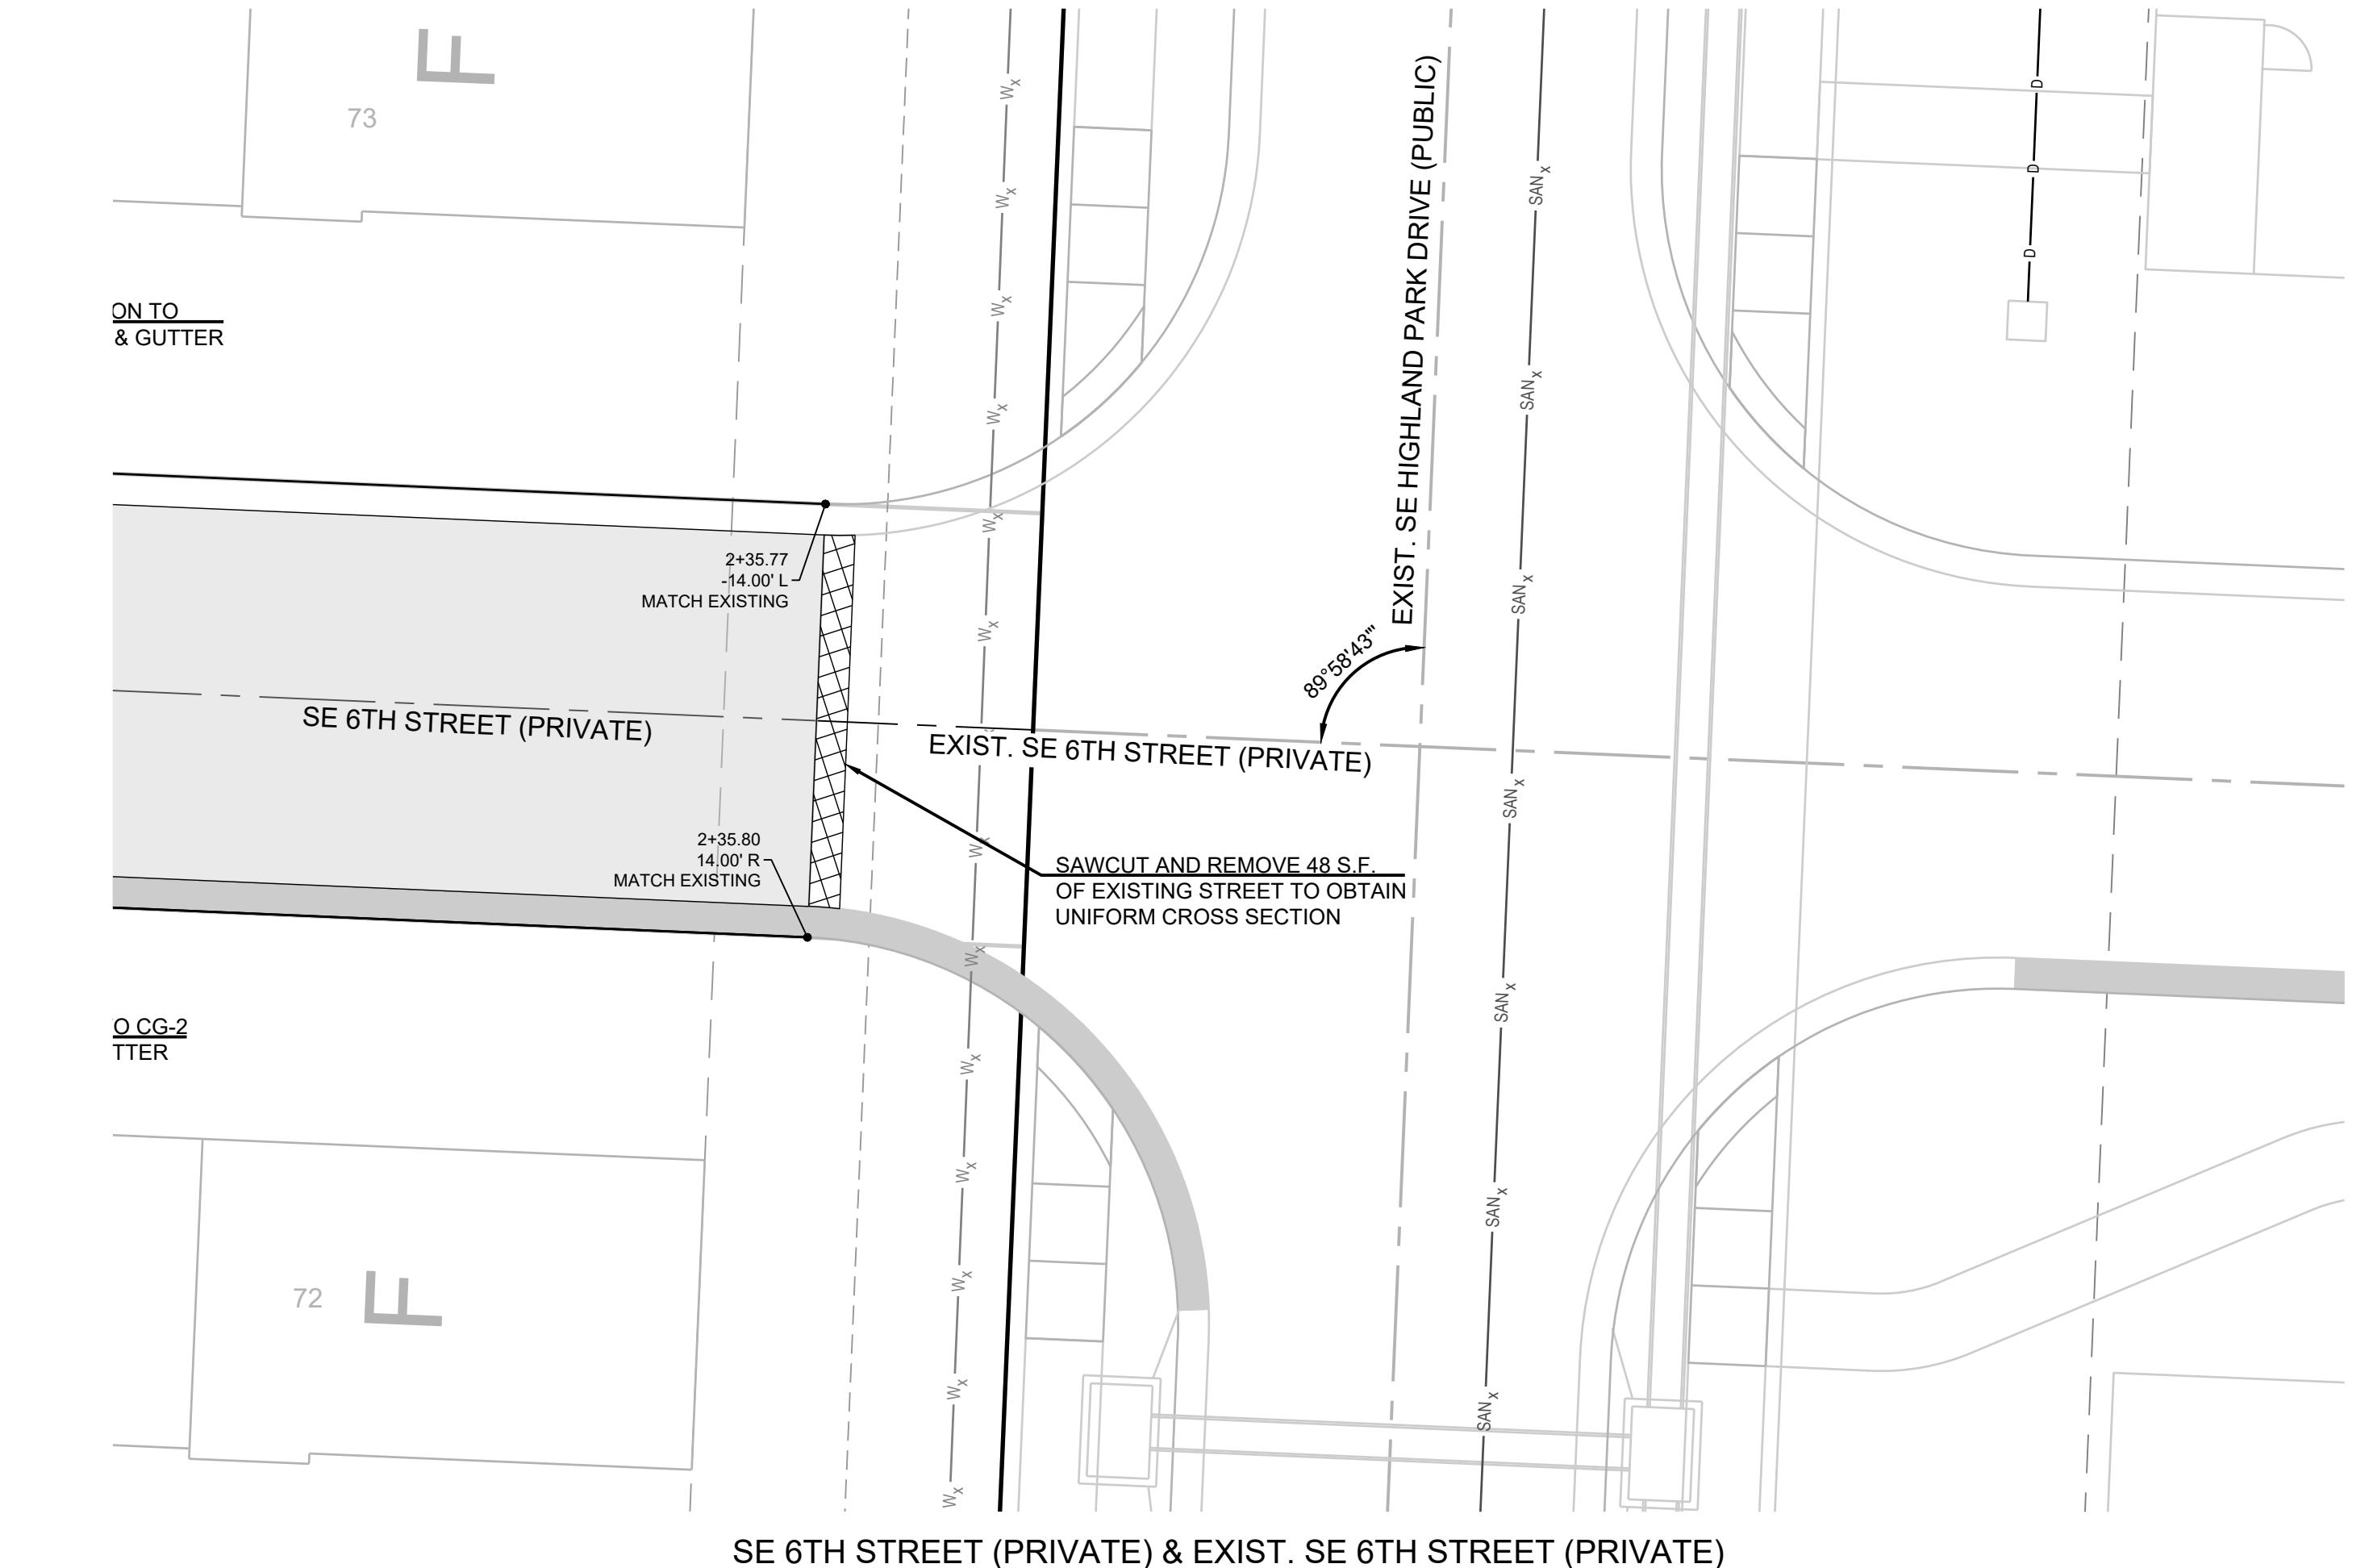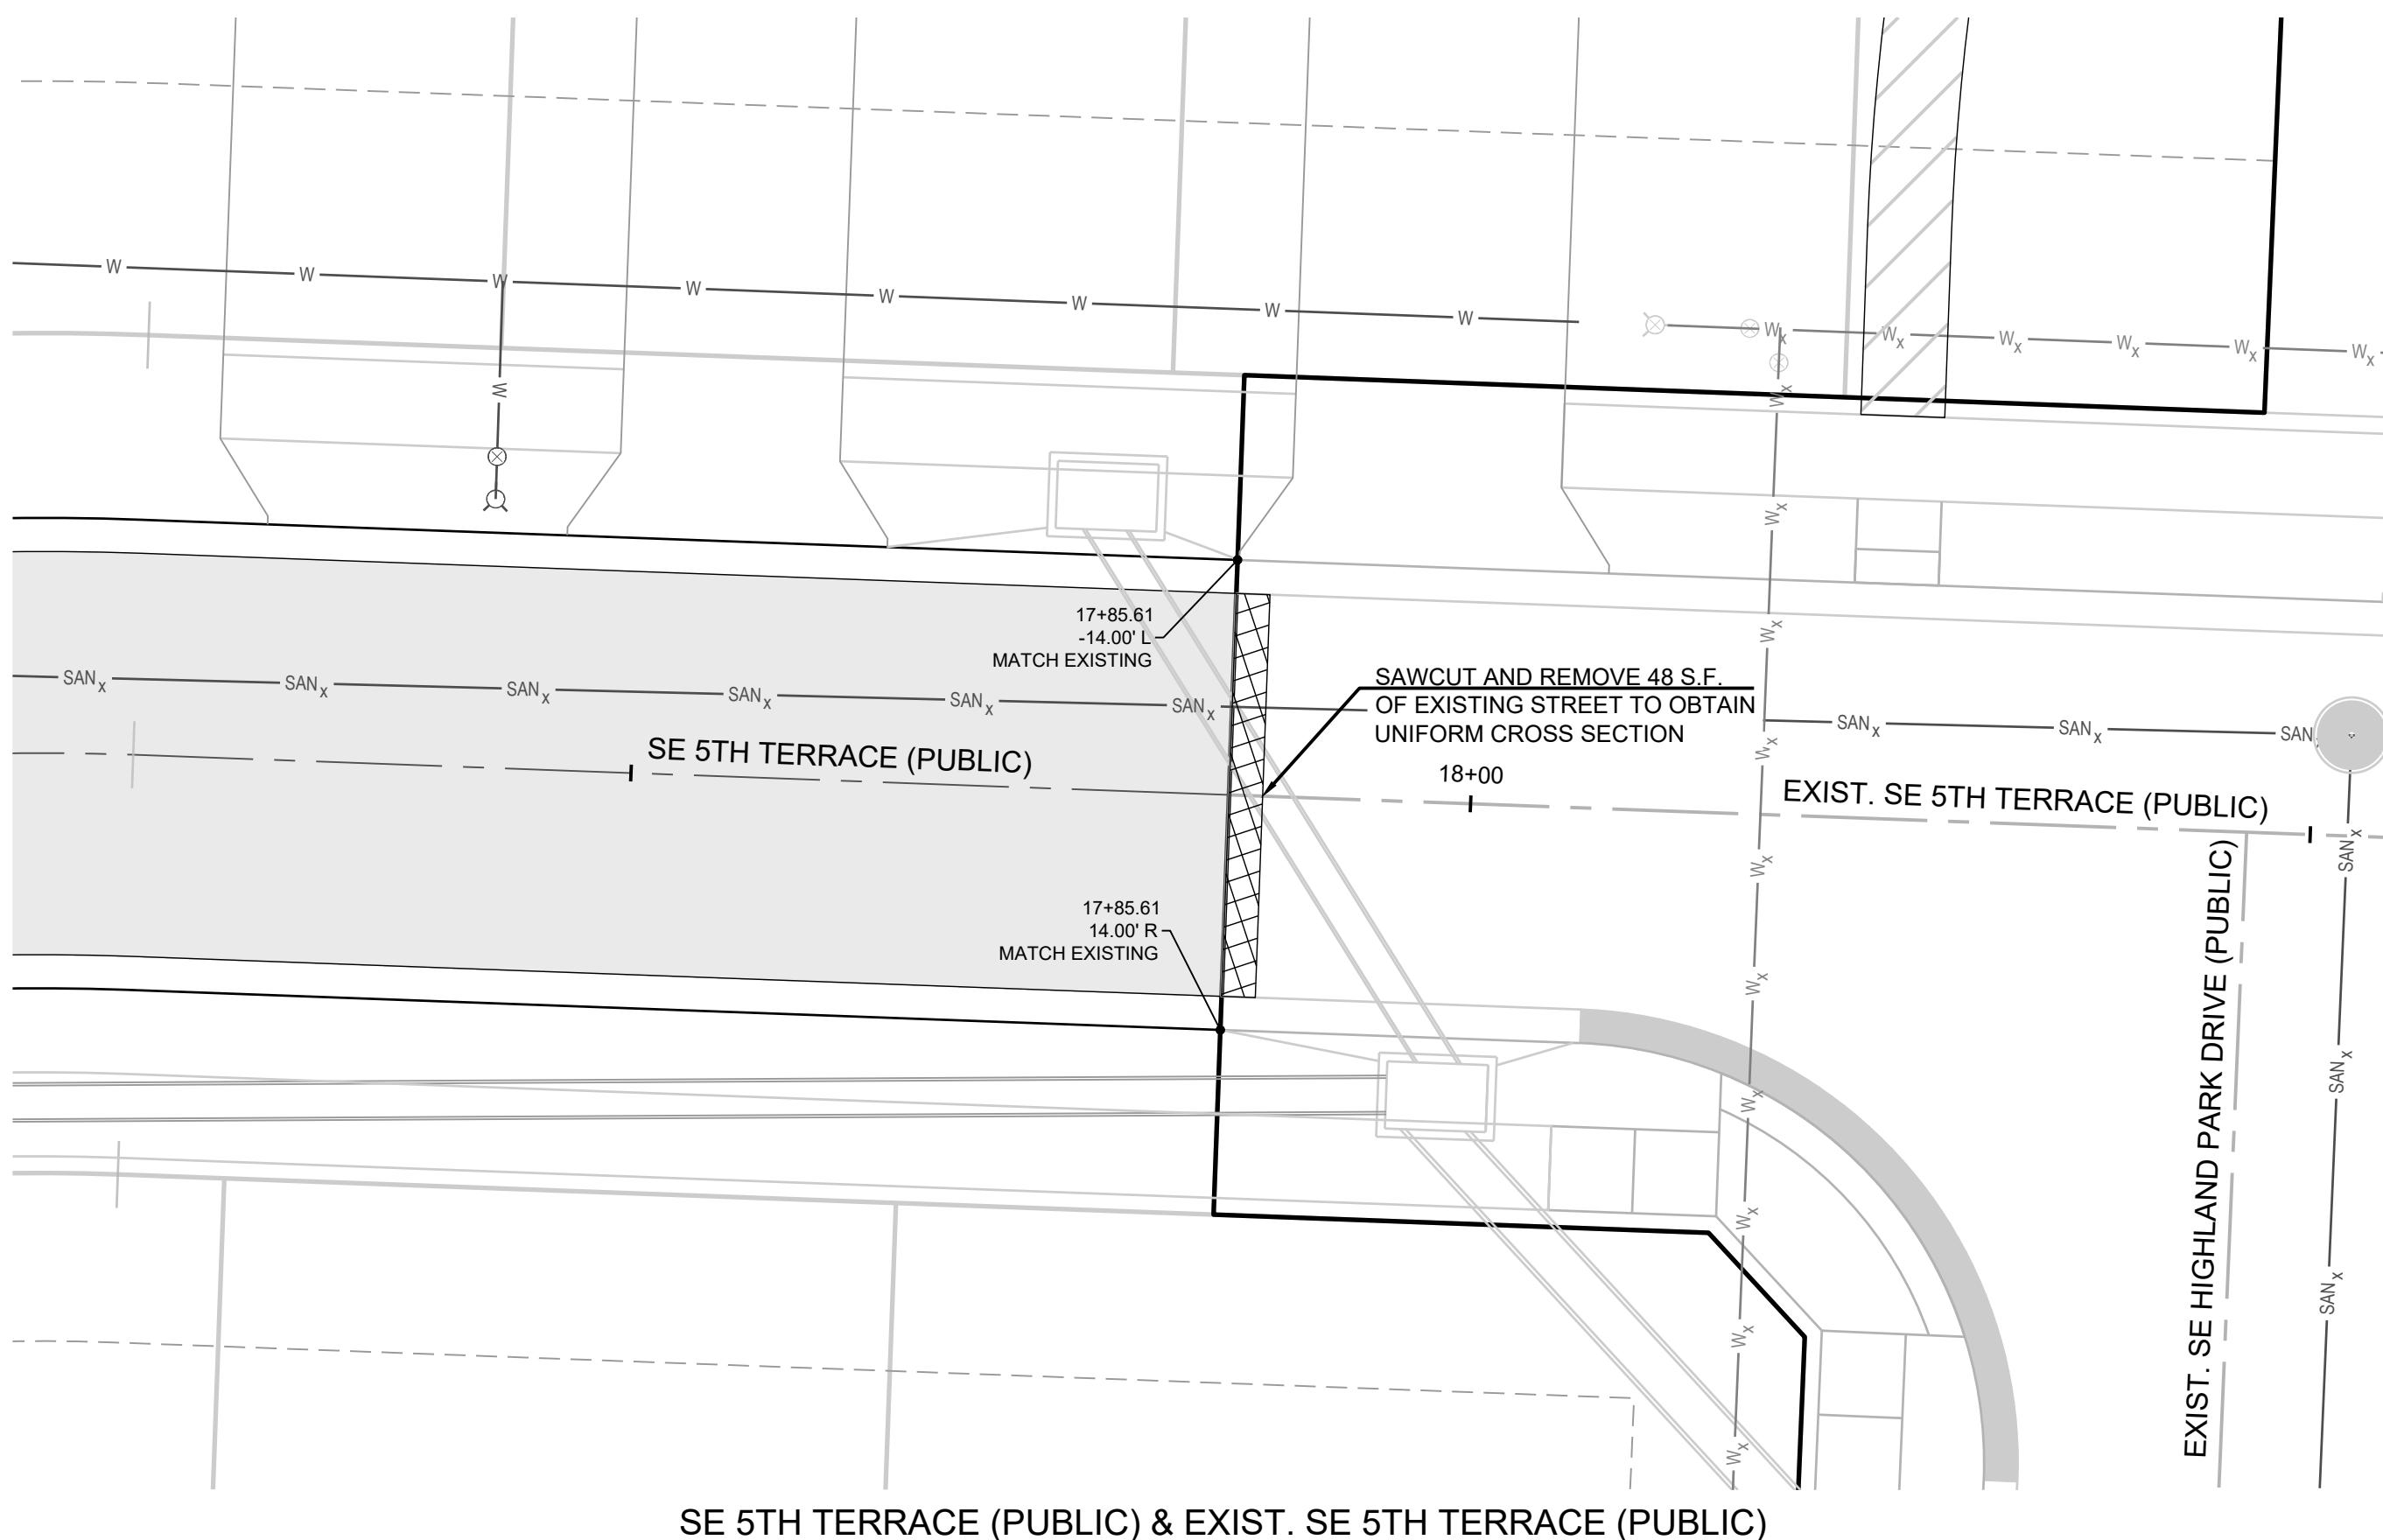


DRAWN BY:		REVISION DATE	DESCRIPTION
TRC		09/05/2023	PER CITY COMMENTS
		09/27/2023	PER CITY COMMENTS
MAB		09/06/2023	PER CITY COMMENTS
CHECKED BY:			
DATE PREPARED		09/05/2023	
PROJ. NUMBER:		22-093	

INTERSECTION DETAILS


SHEET

17

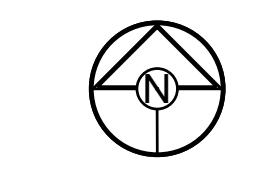

0 10' 20'



SCALE: 1" = 10'

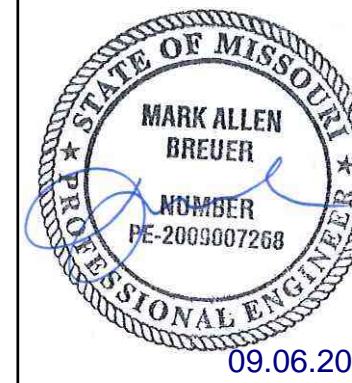PREPARED BY:

 MARK ALLEN DREUER
 PE-2009007268
 09.06.2023

SCHLAGEL & ASSOCIATES, P.A.

**BLACKWELL RESERVE
 STREET AND STORM SEWER PLANS**

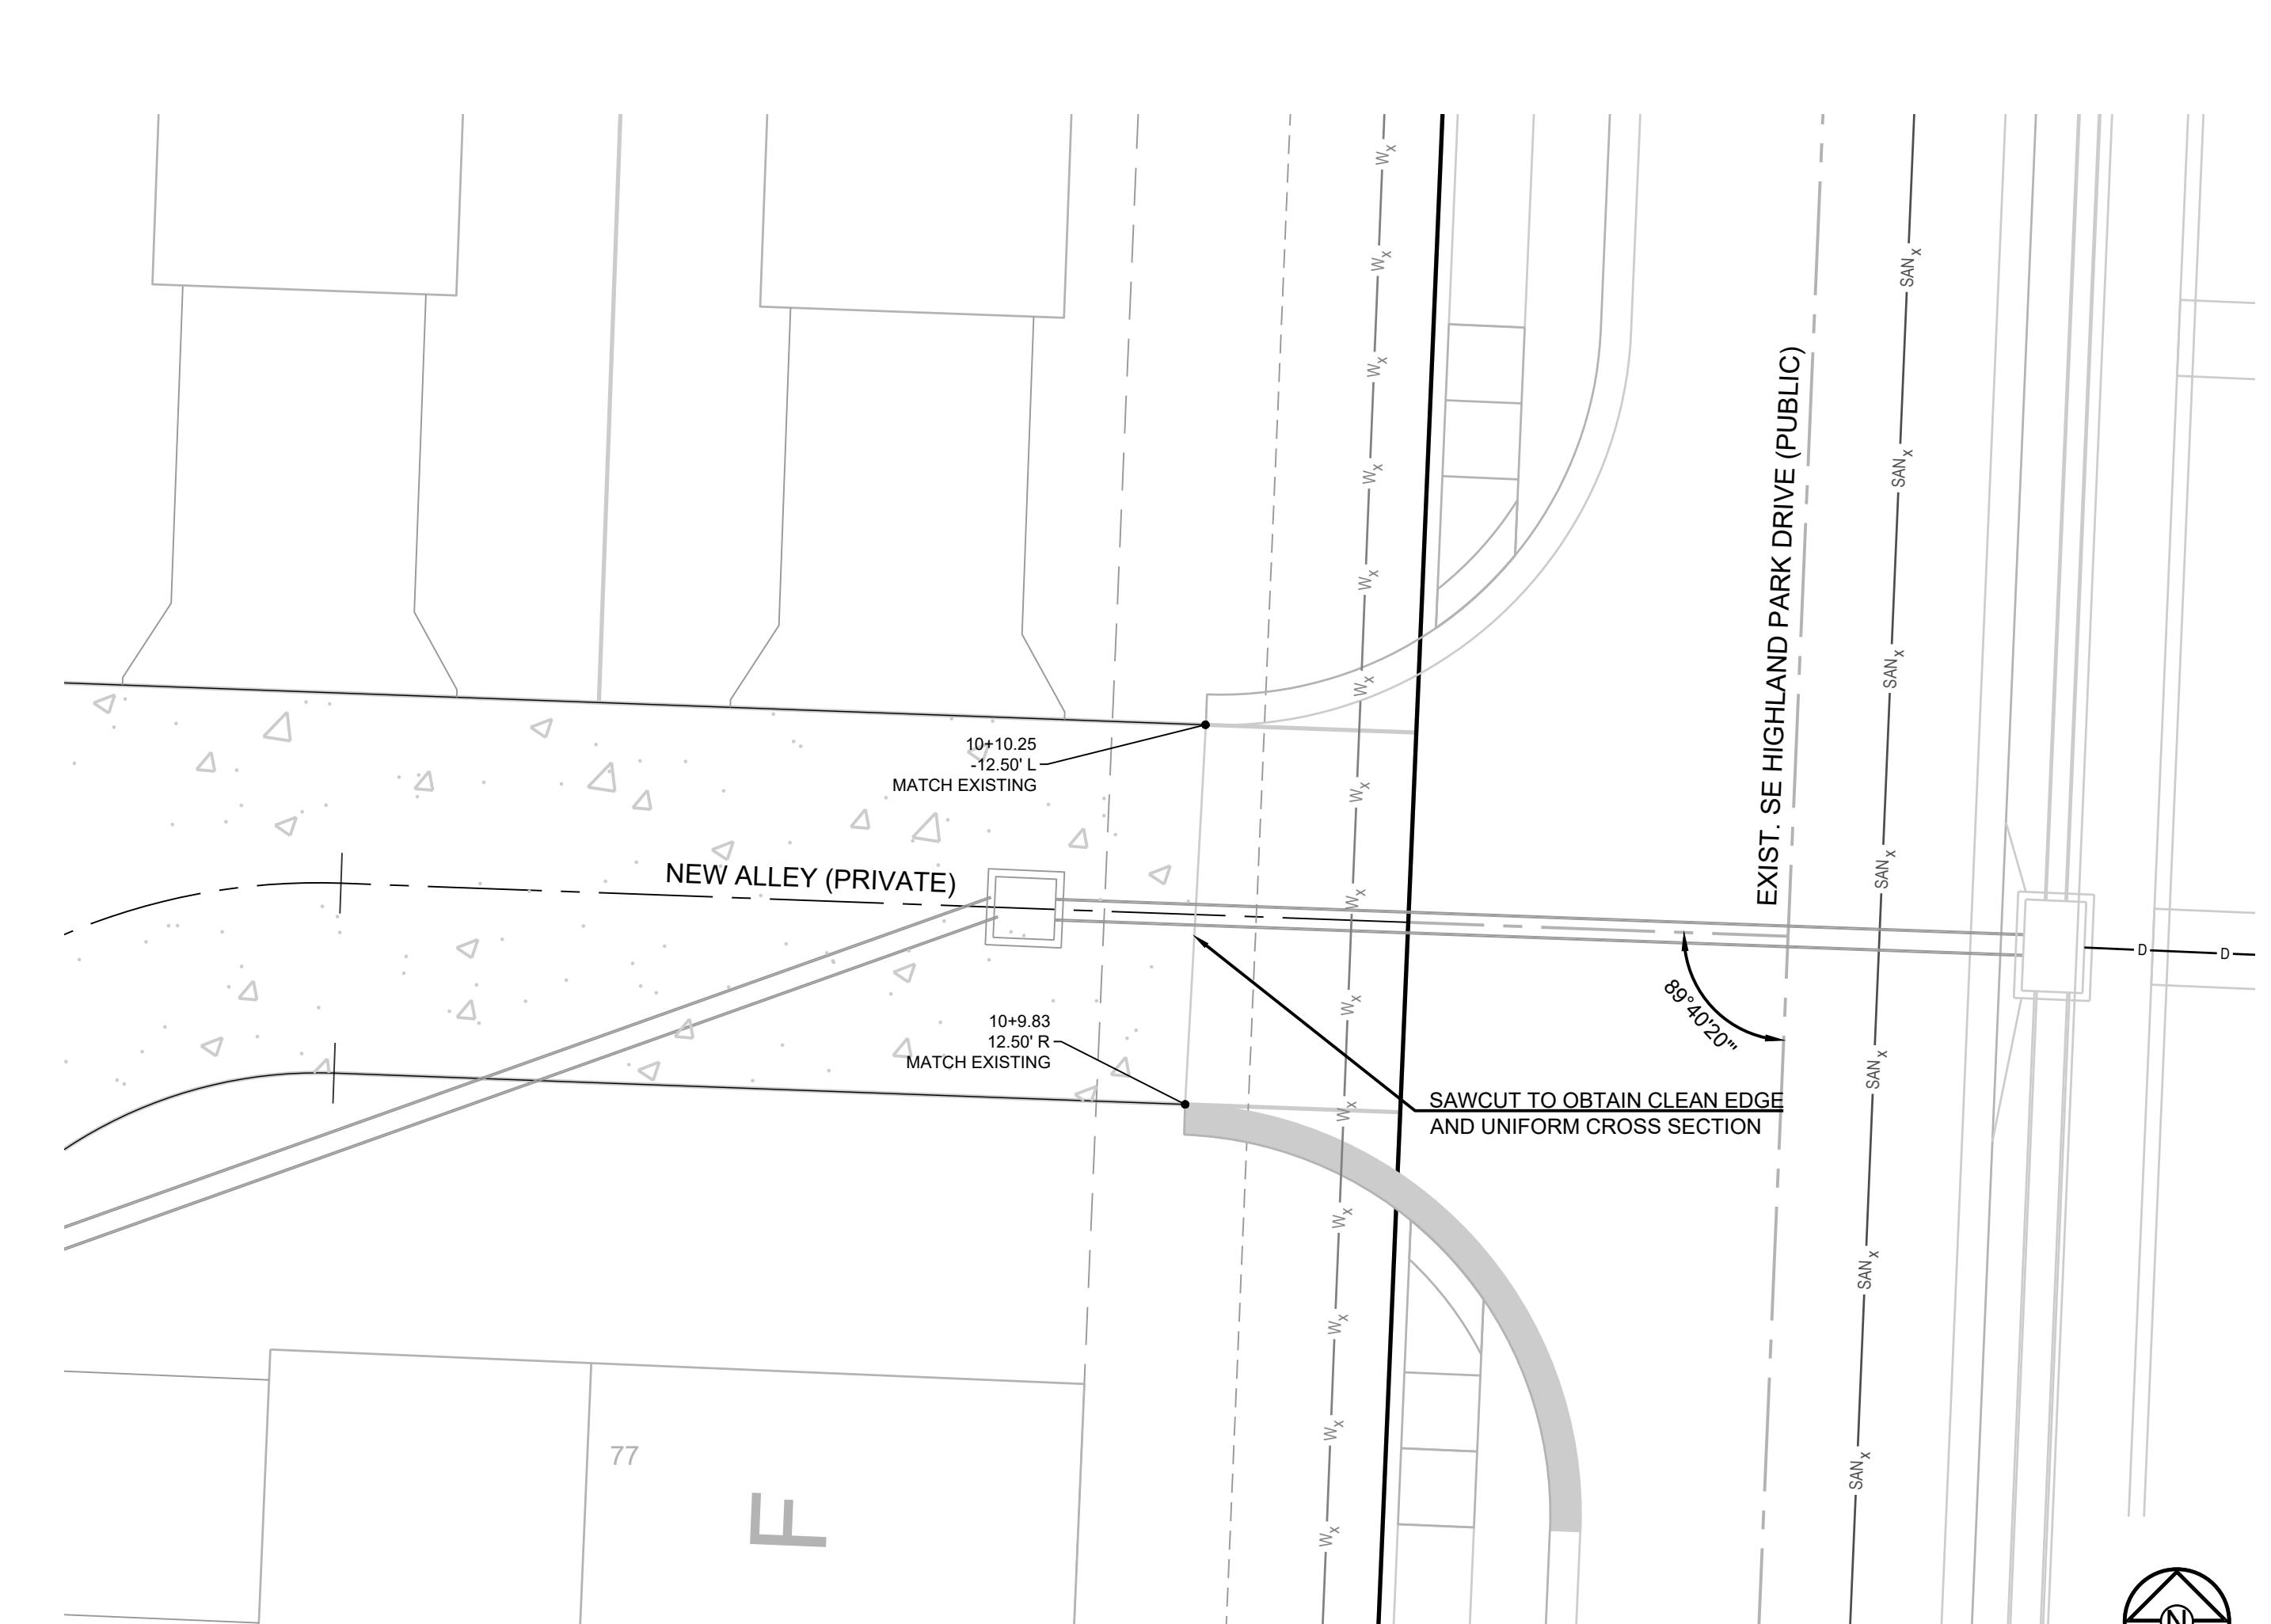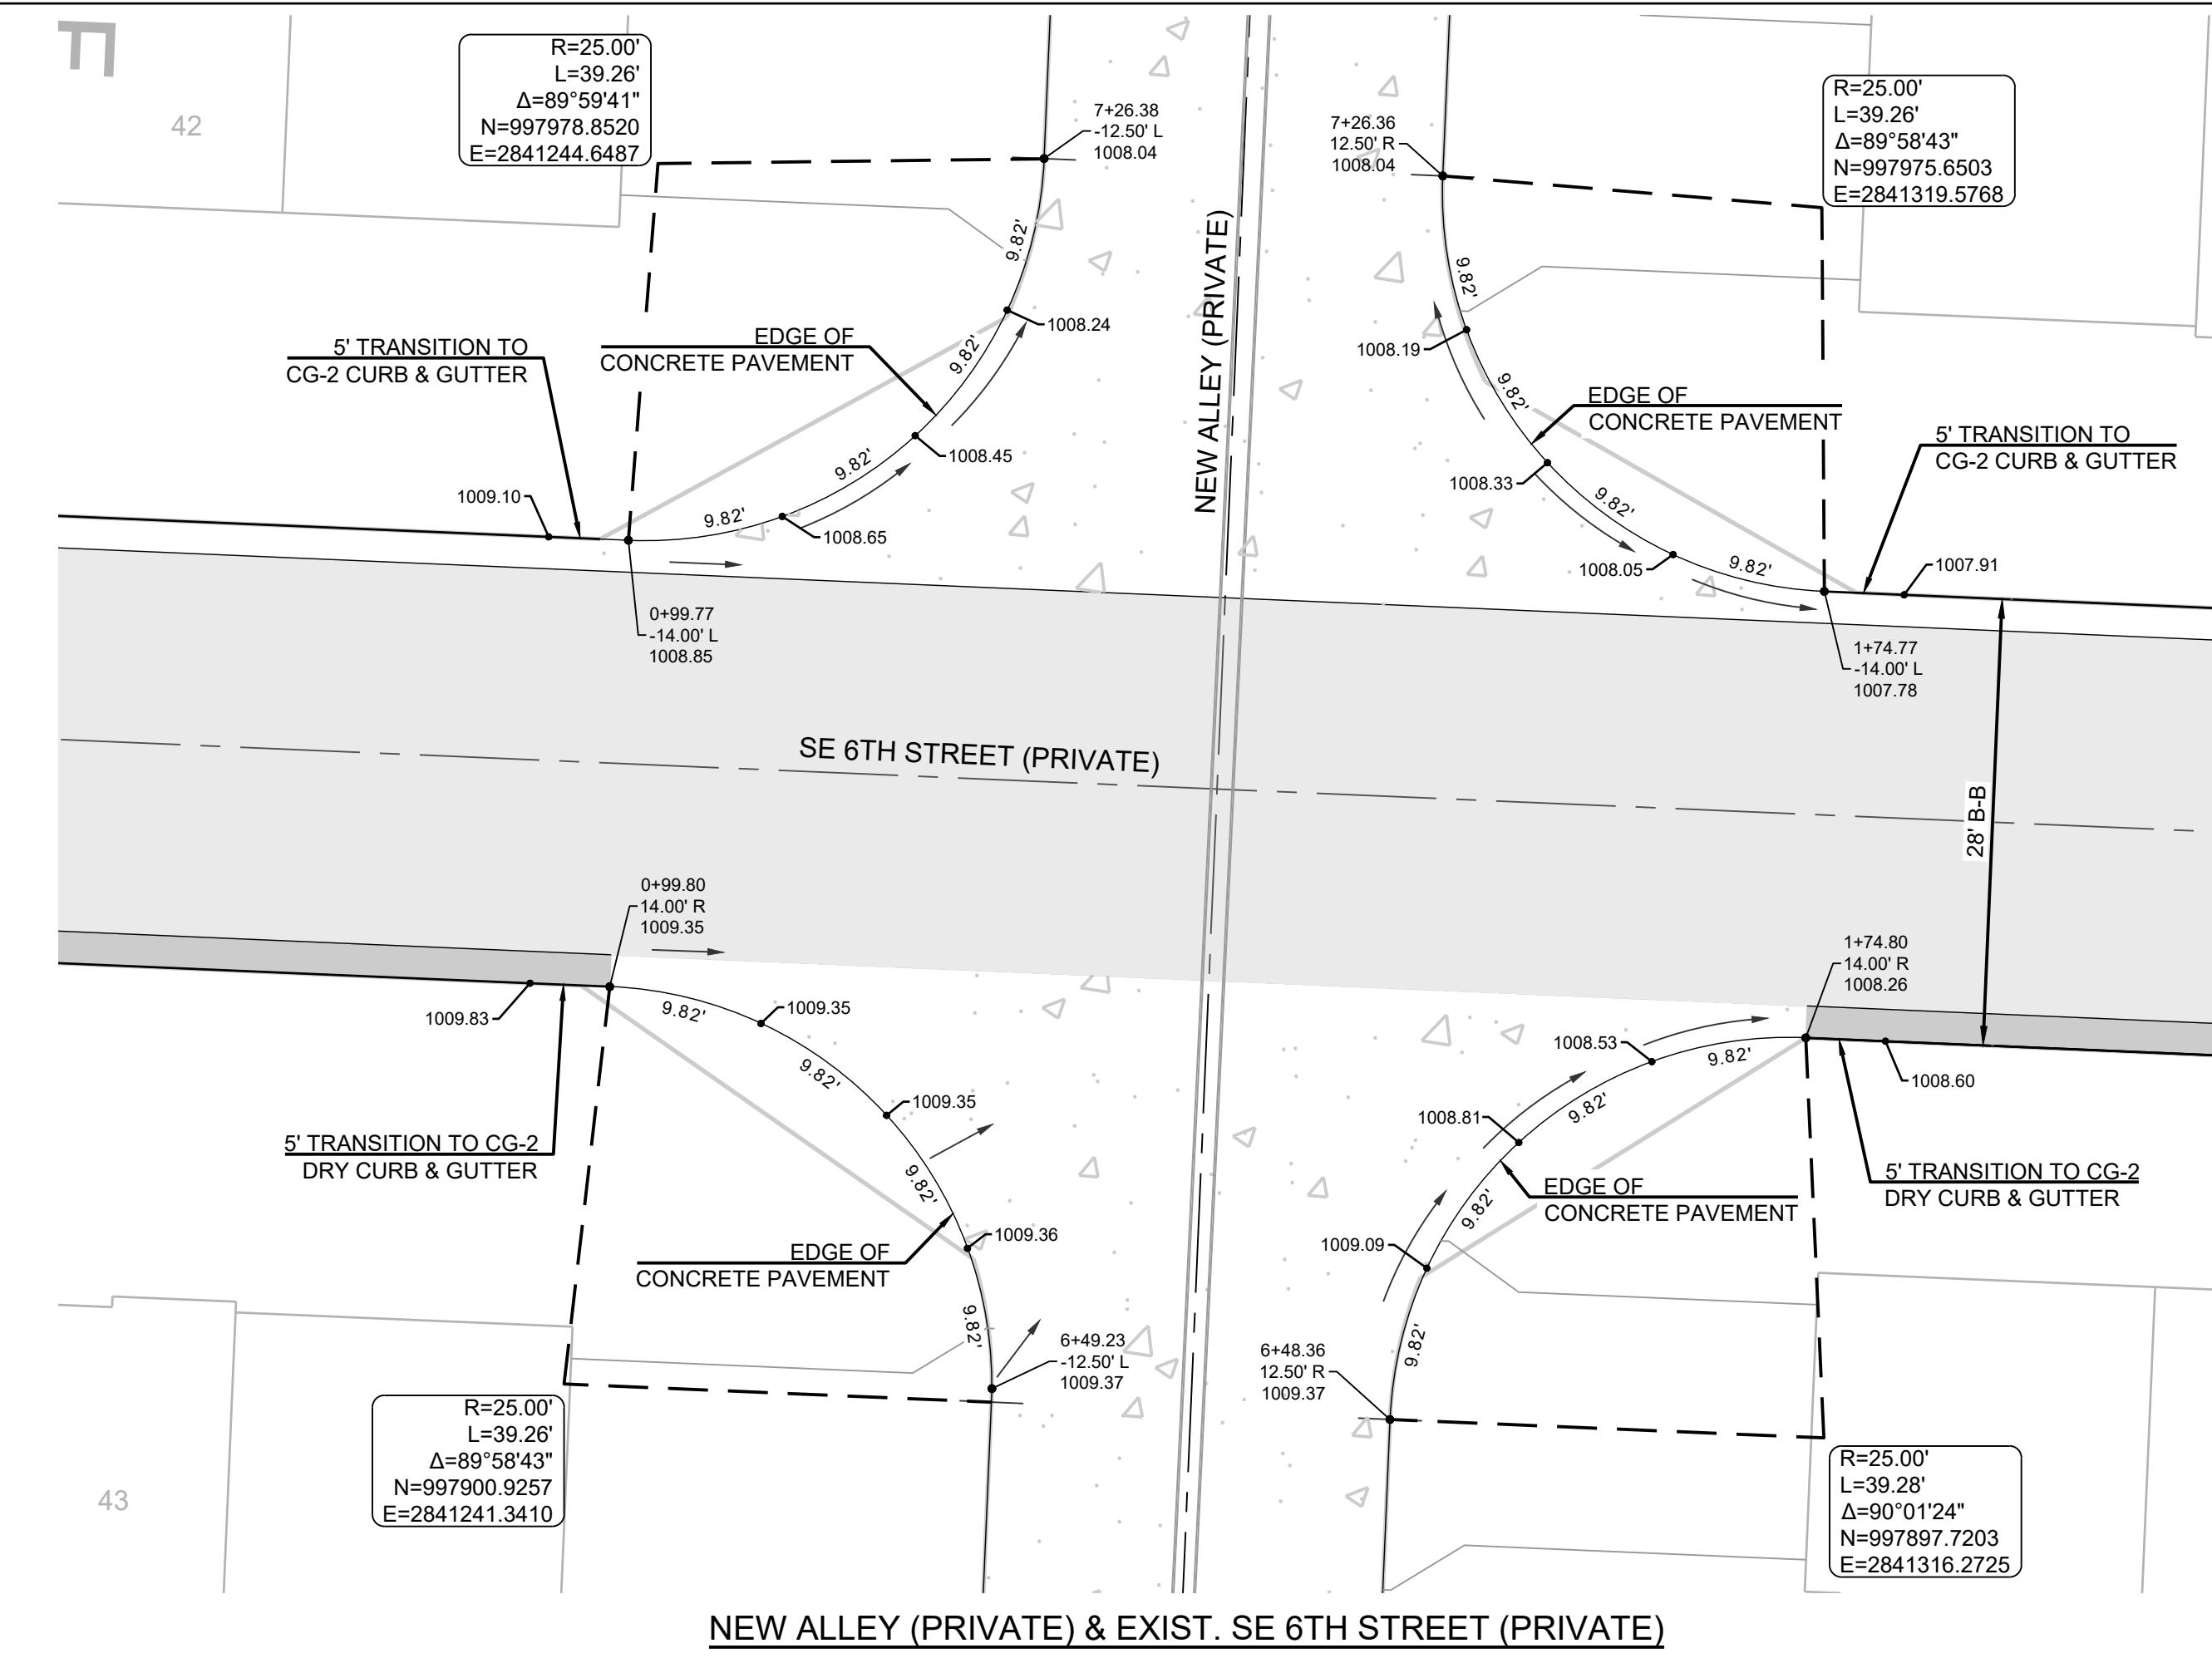SE SHENANDOAH DRIVE LEE'S SUMMIT, MO







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 As Noted on Plan Review
 Development Services Department
 Lee's Summit, Missouri
 09/21/2023

NEW ALLEY (PRIVATE) & EXIST. SE HIGHLAND PARK DRIVE (PUBLIC)



18

SCALE: 1" = 10'

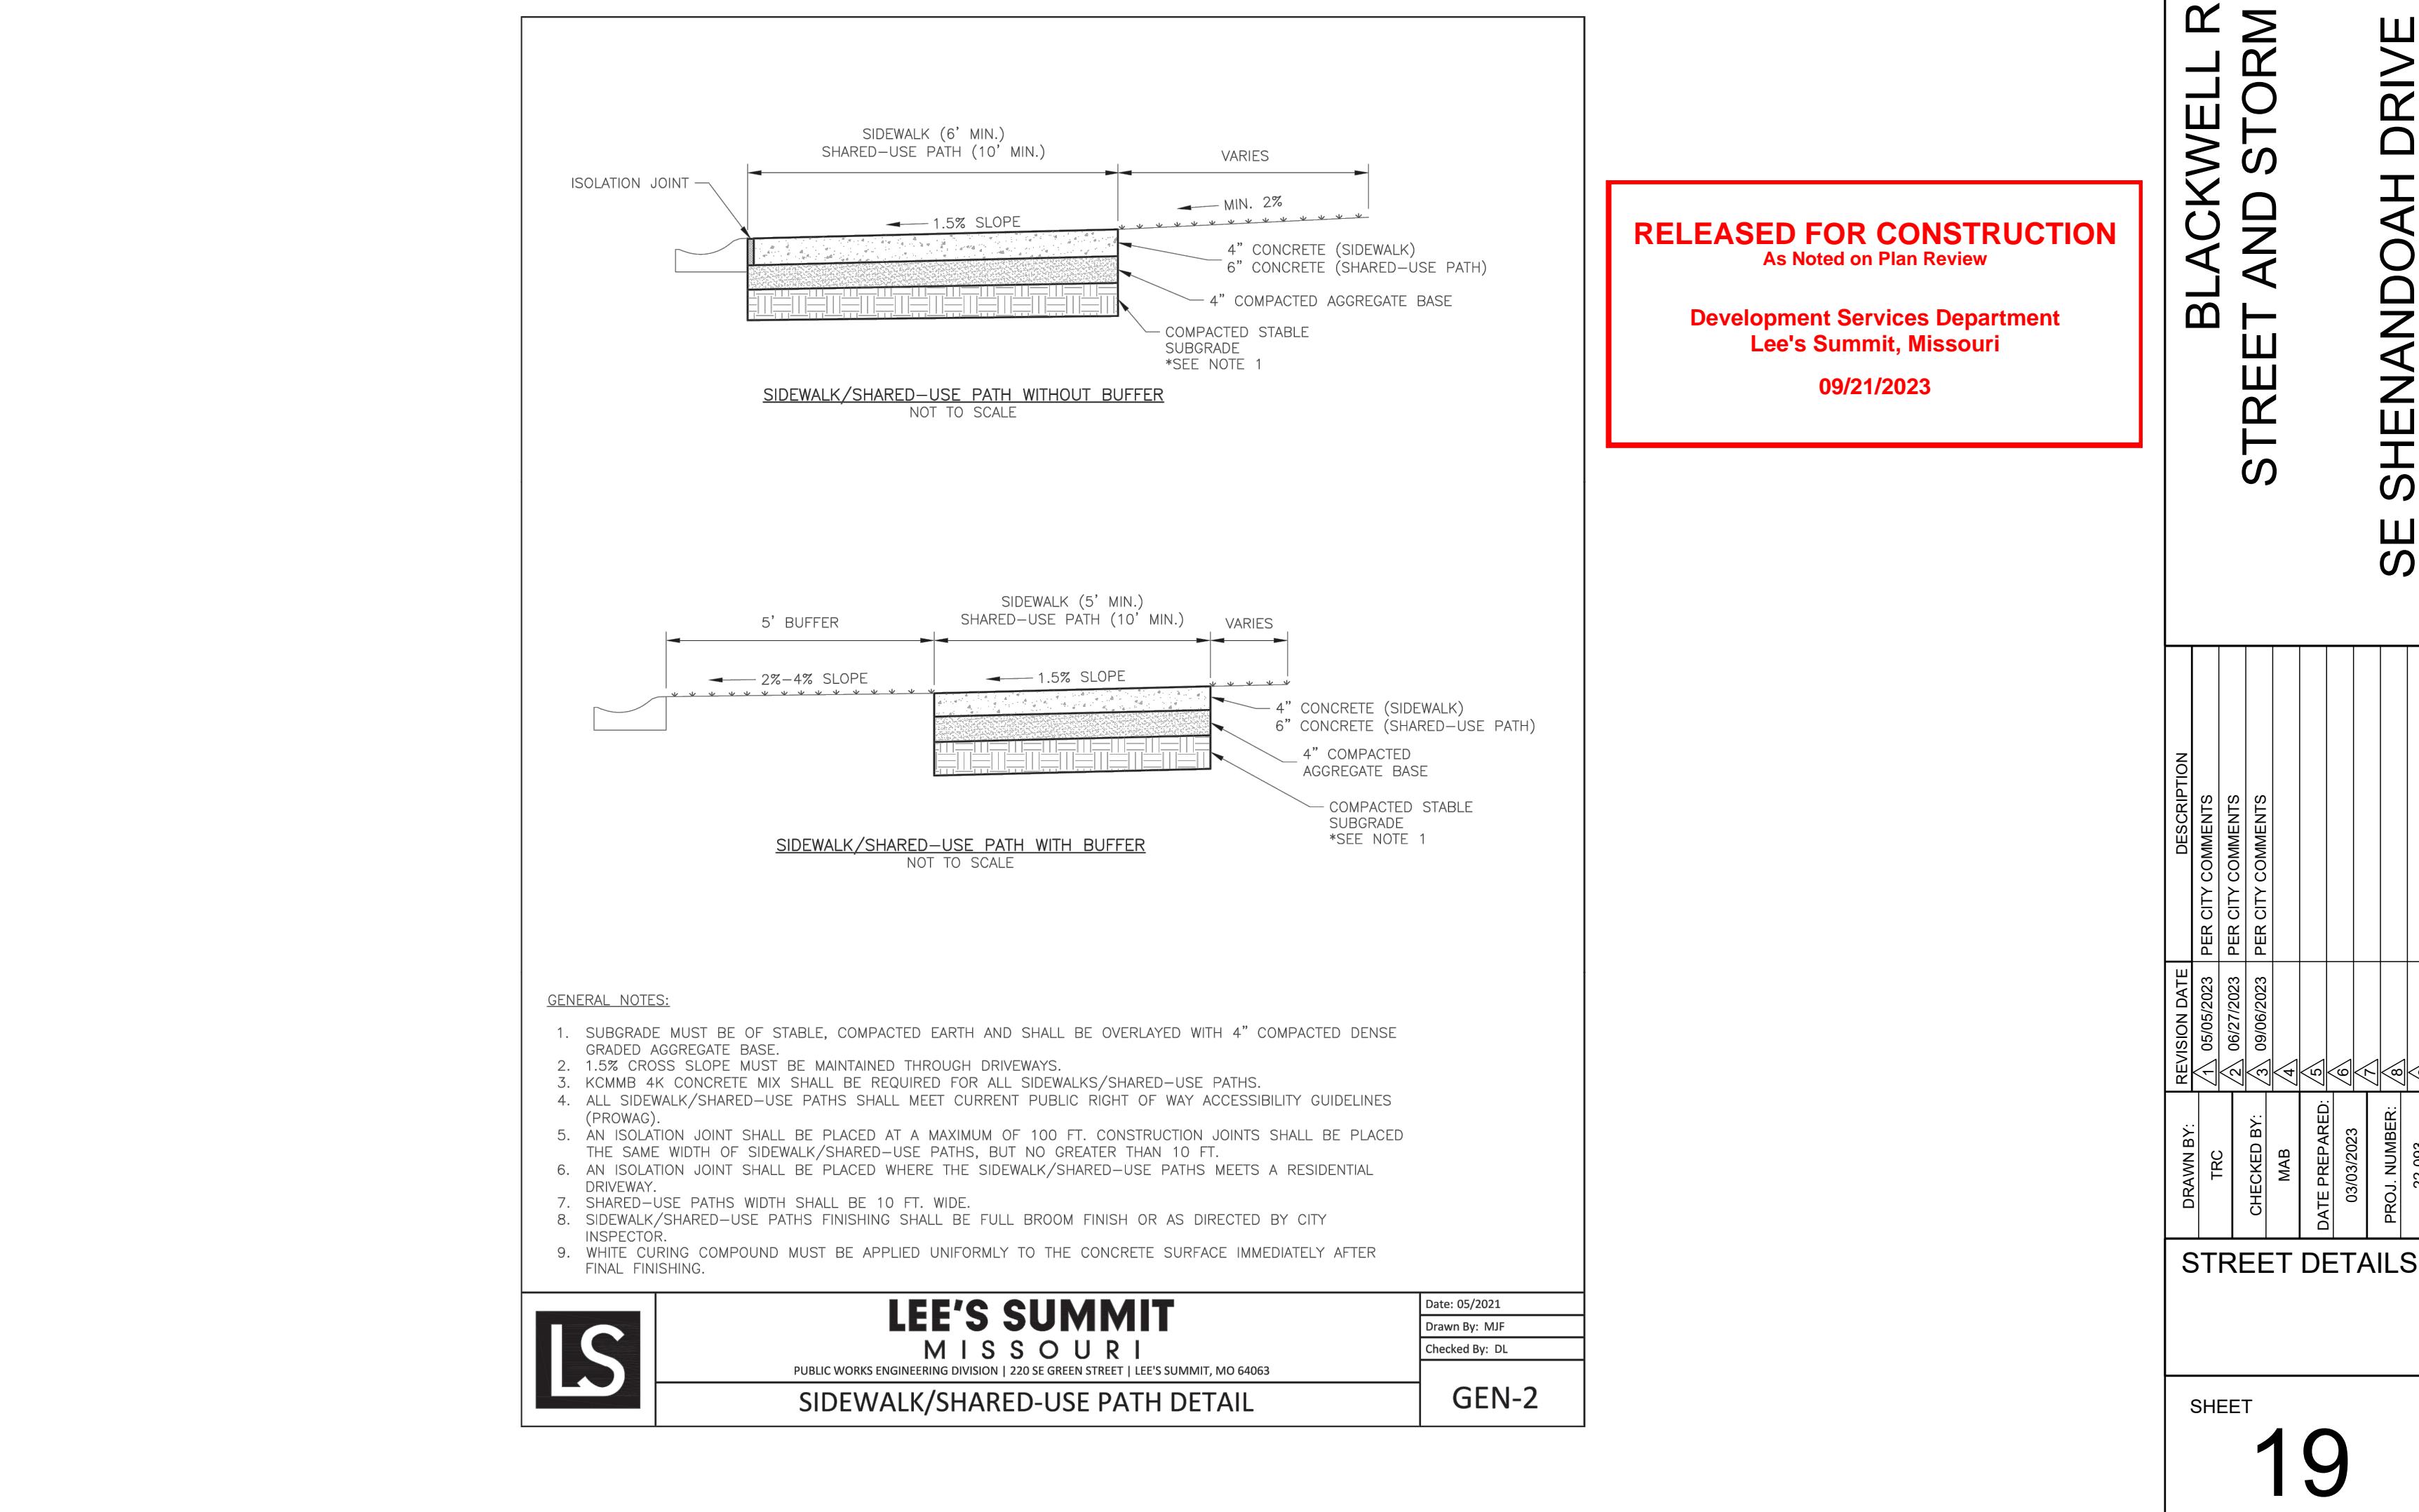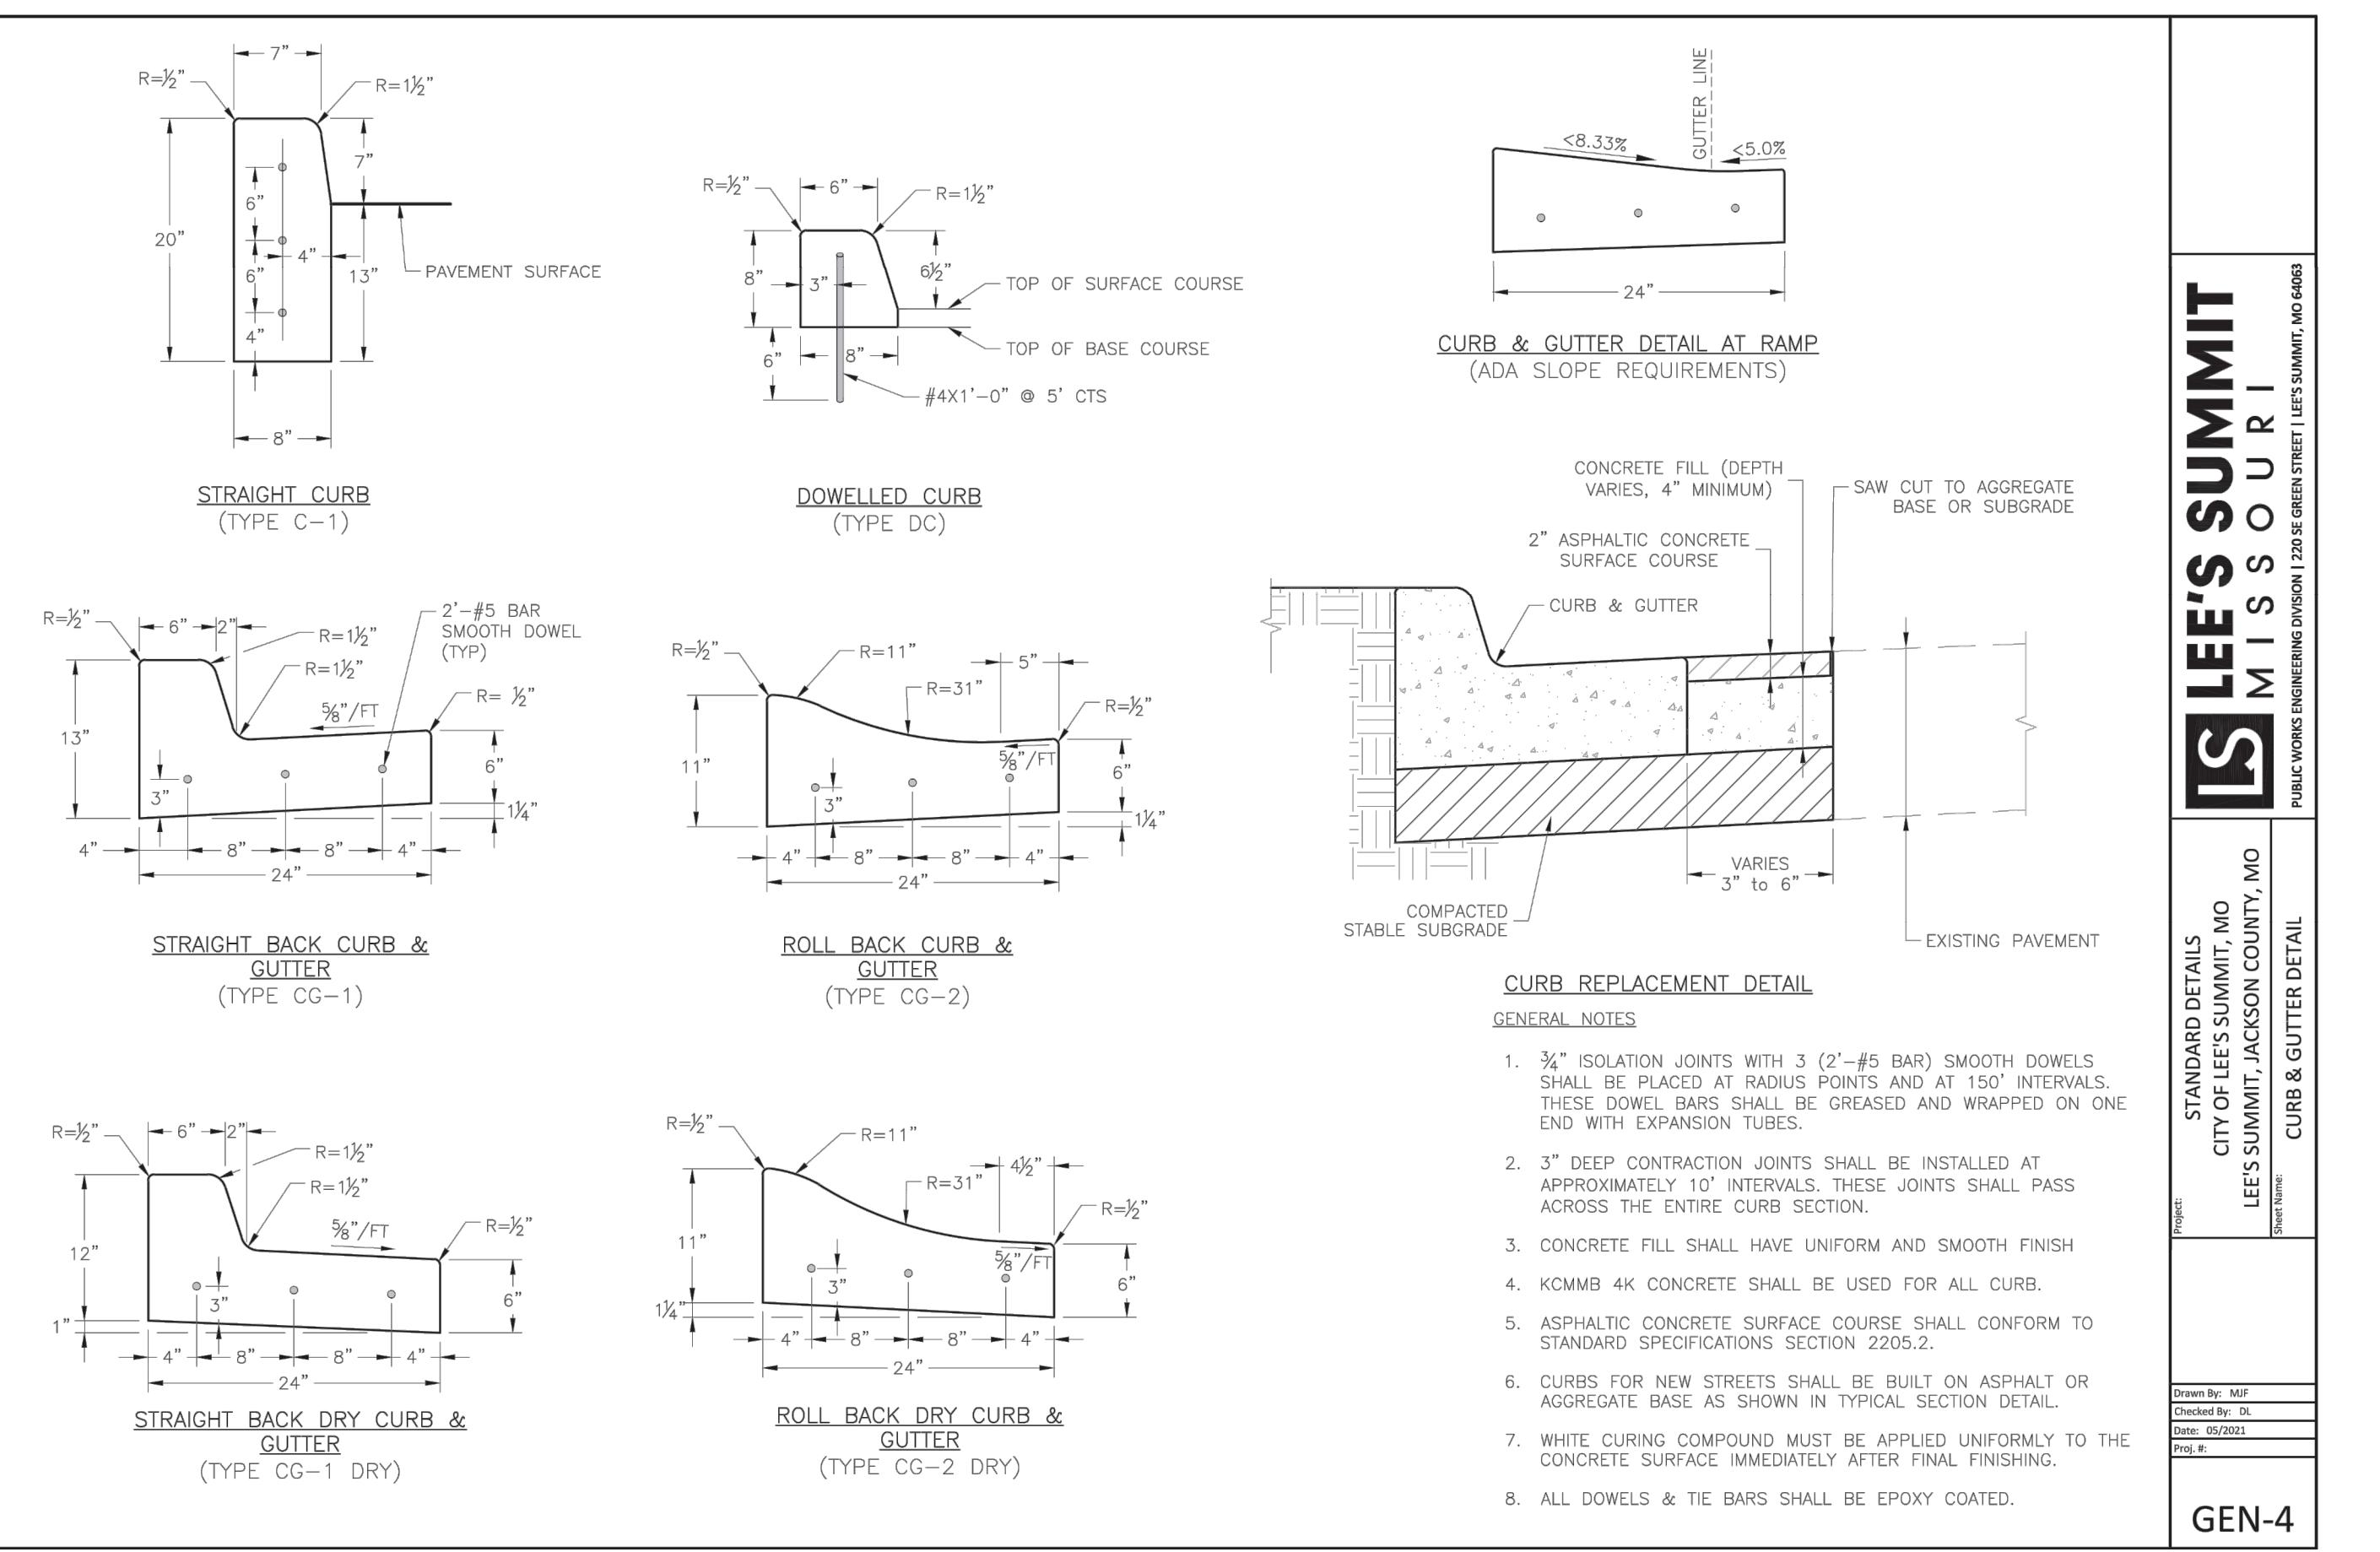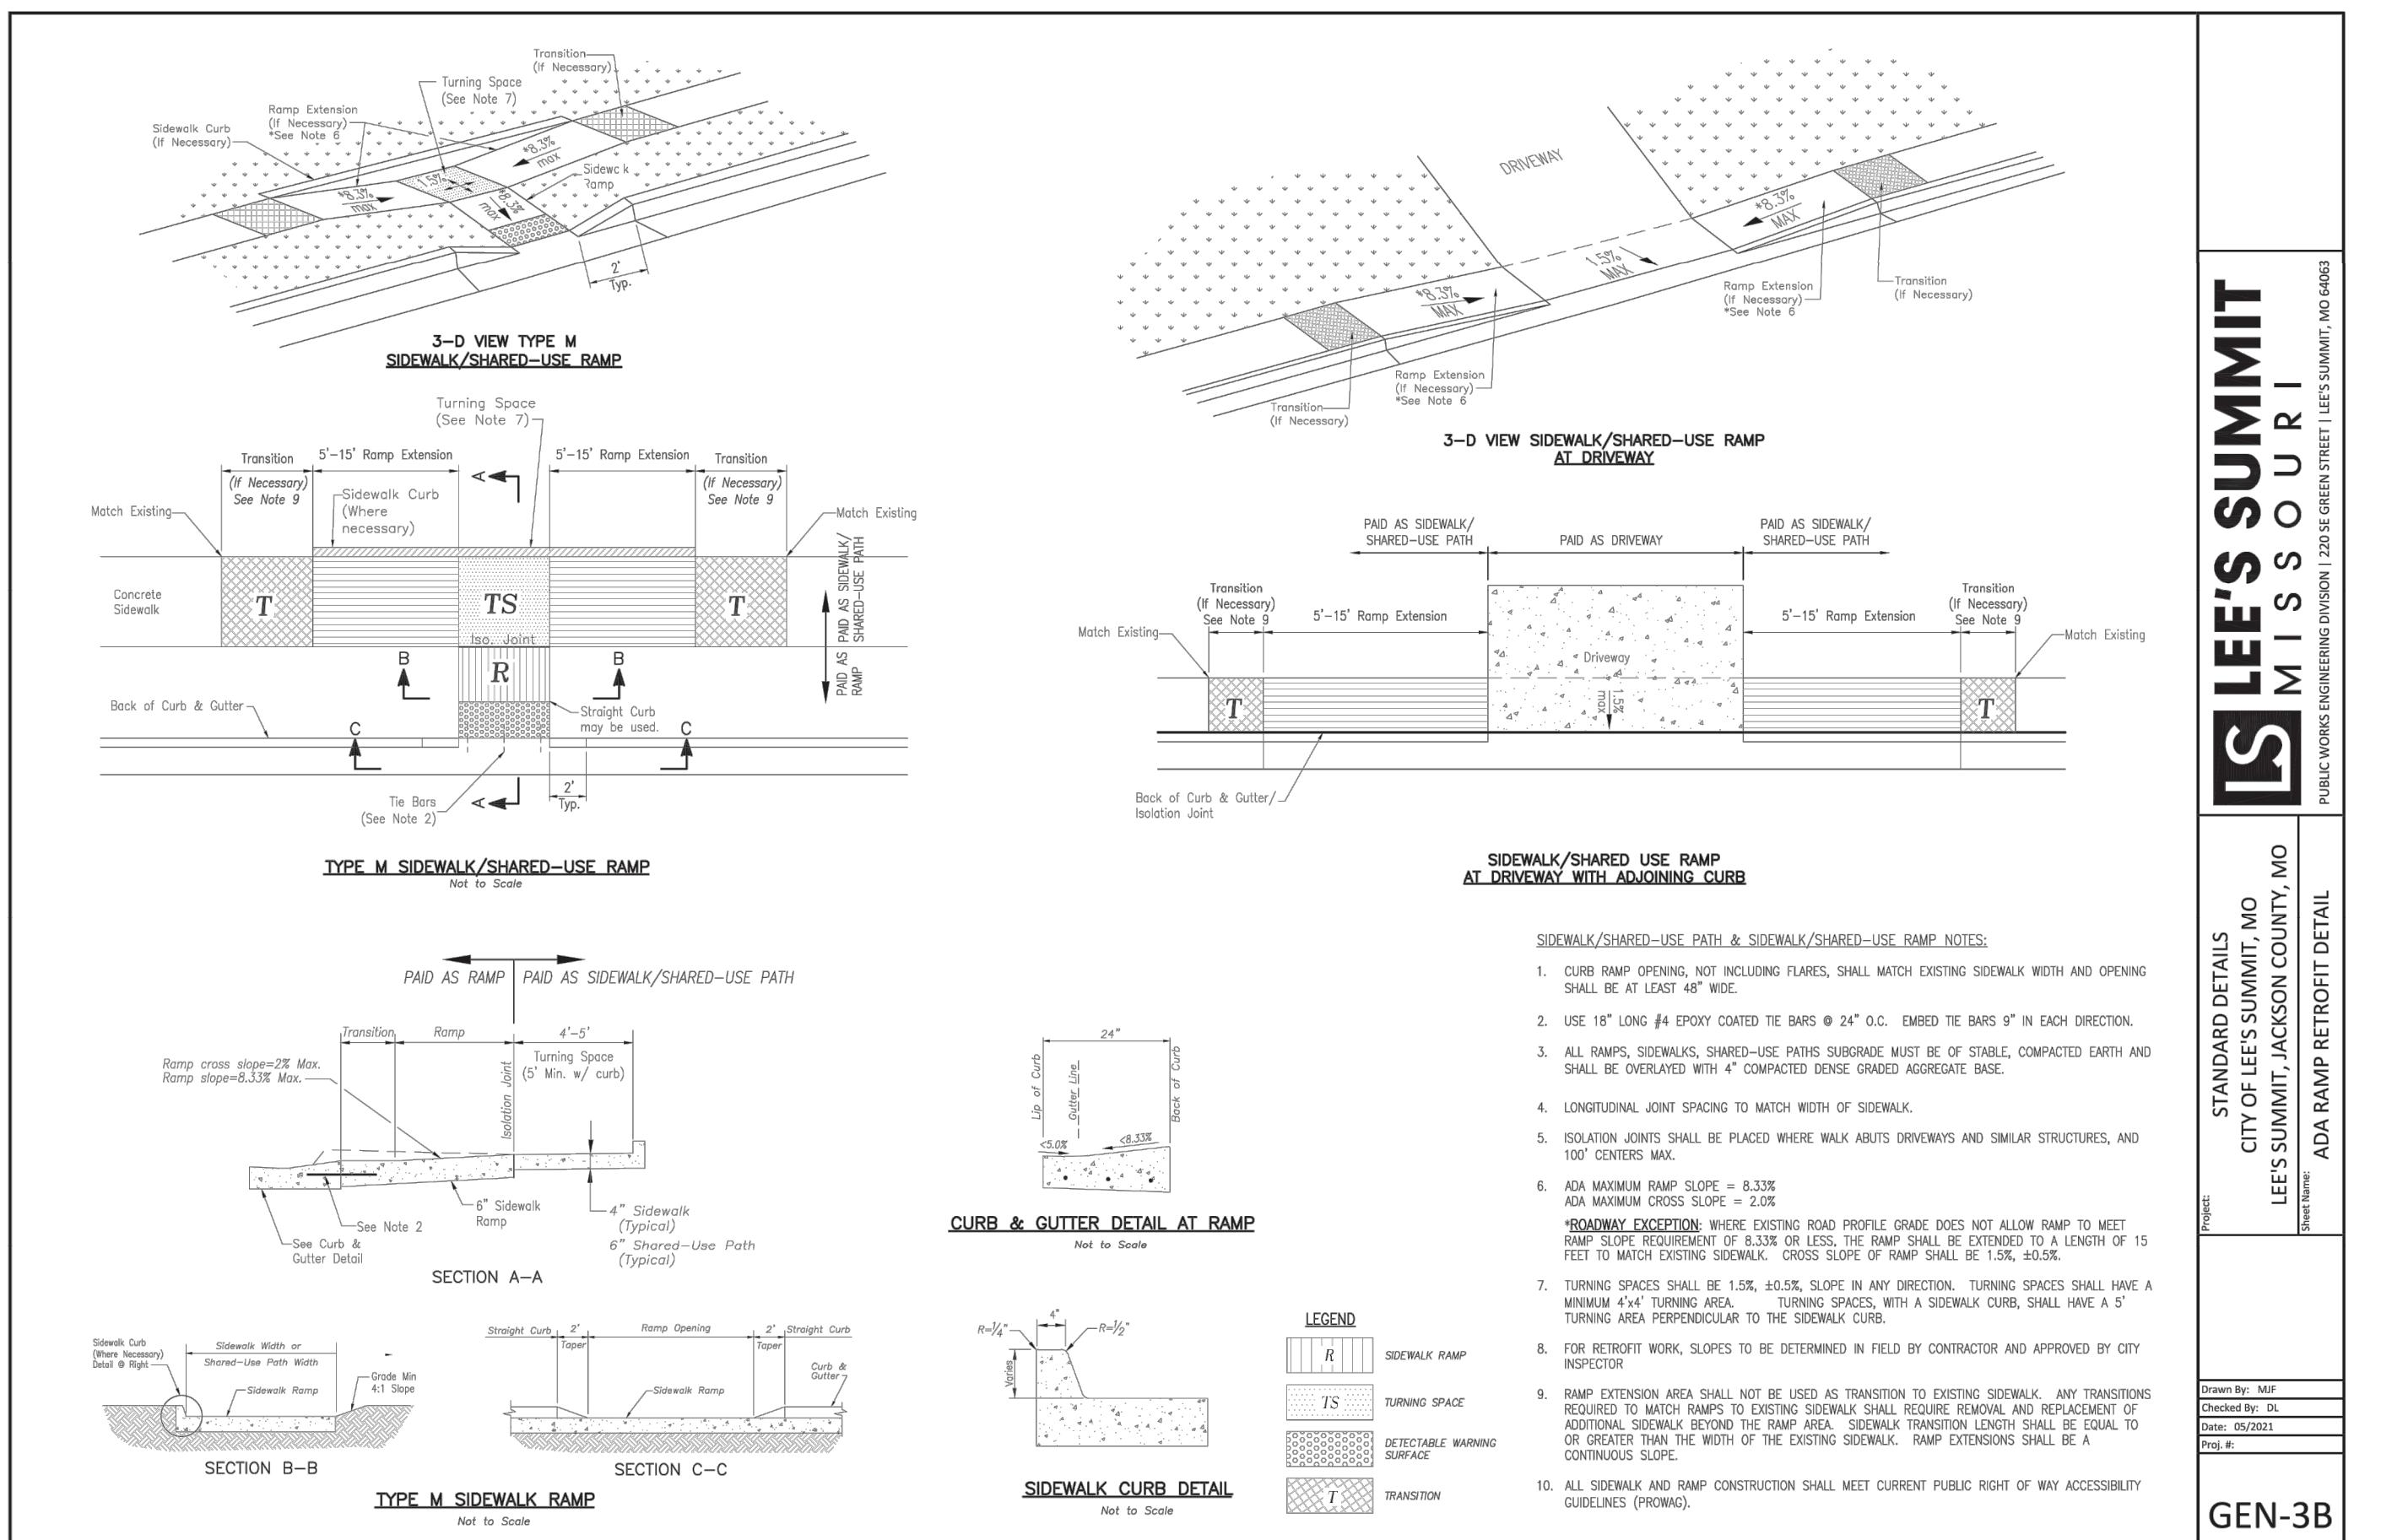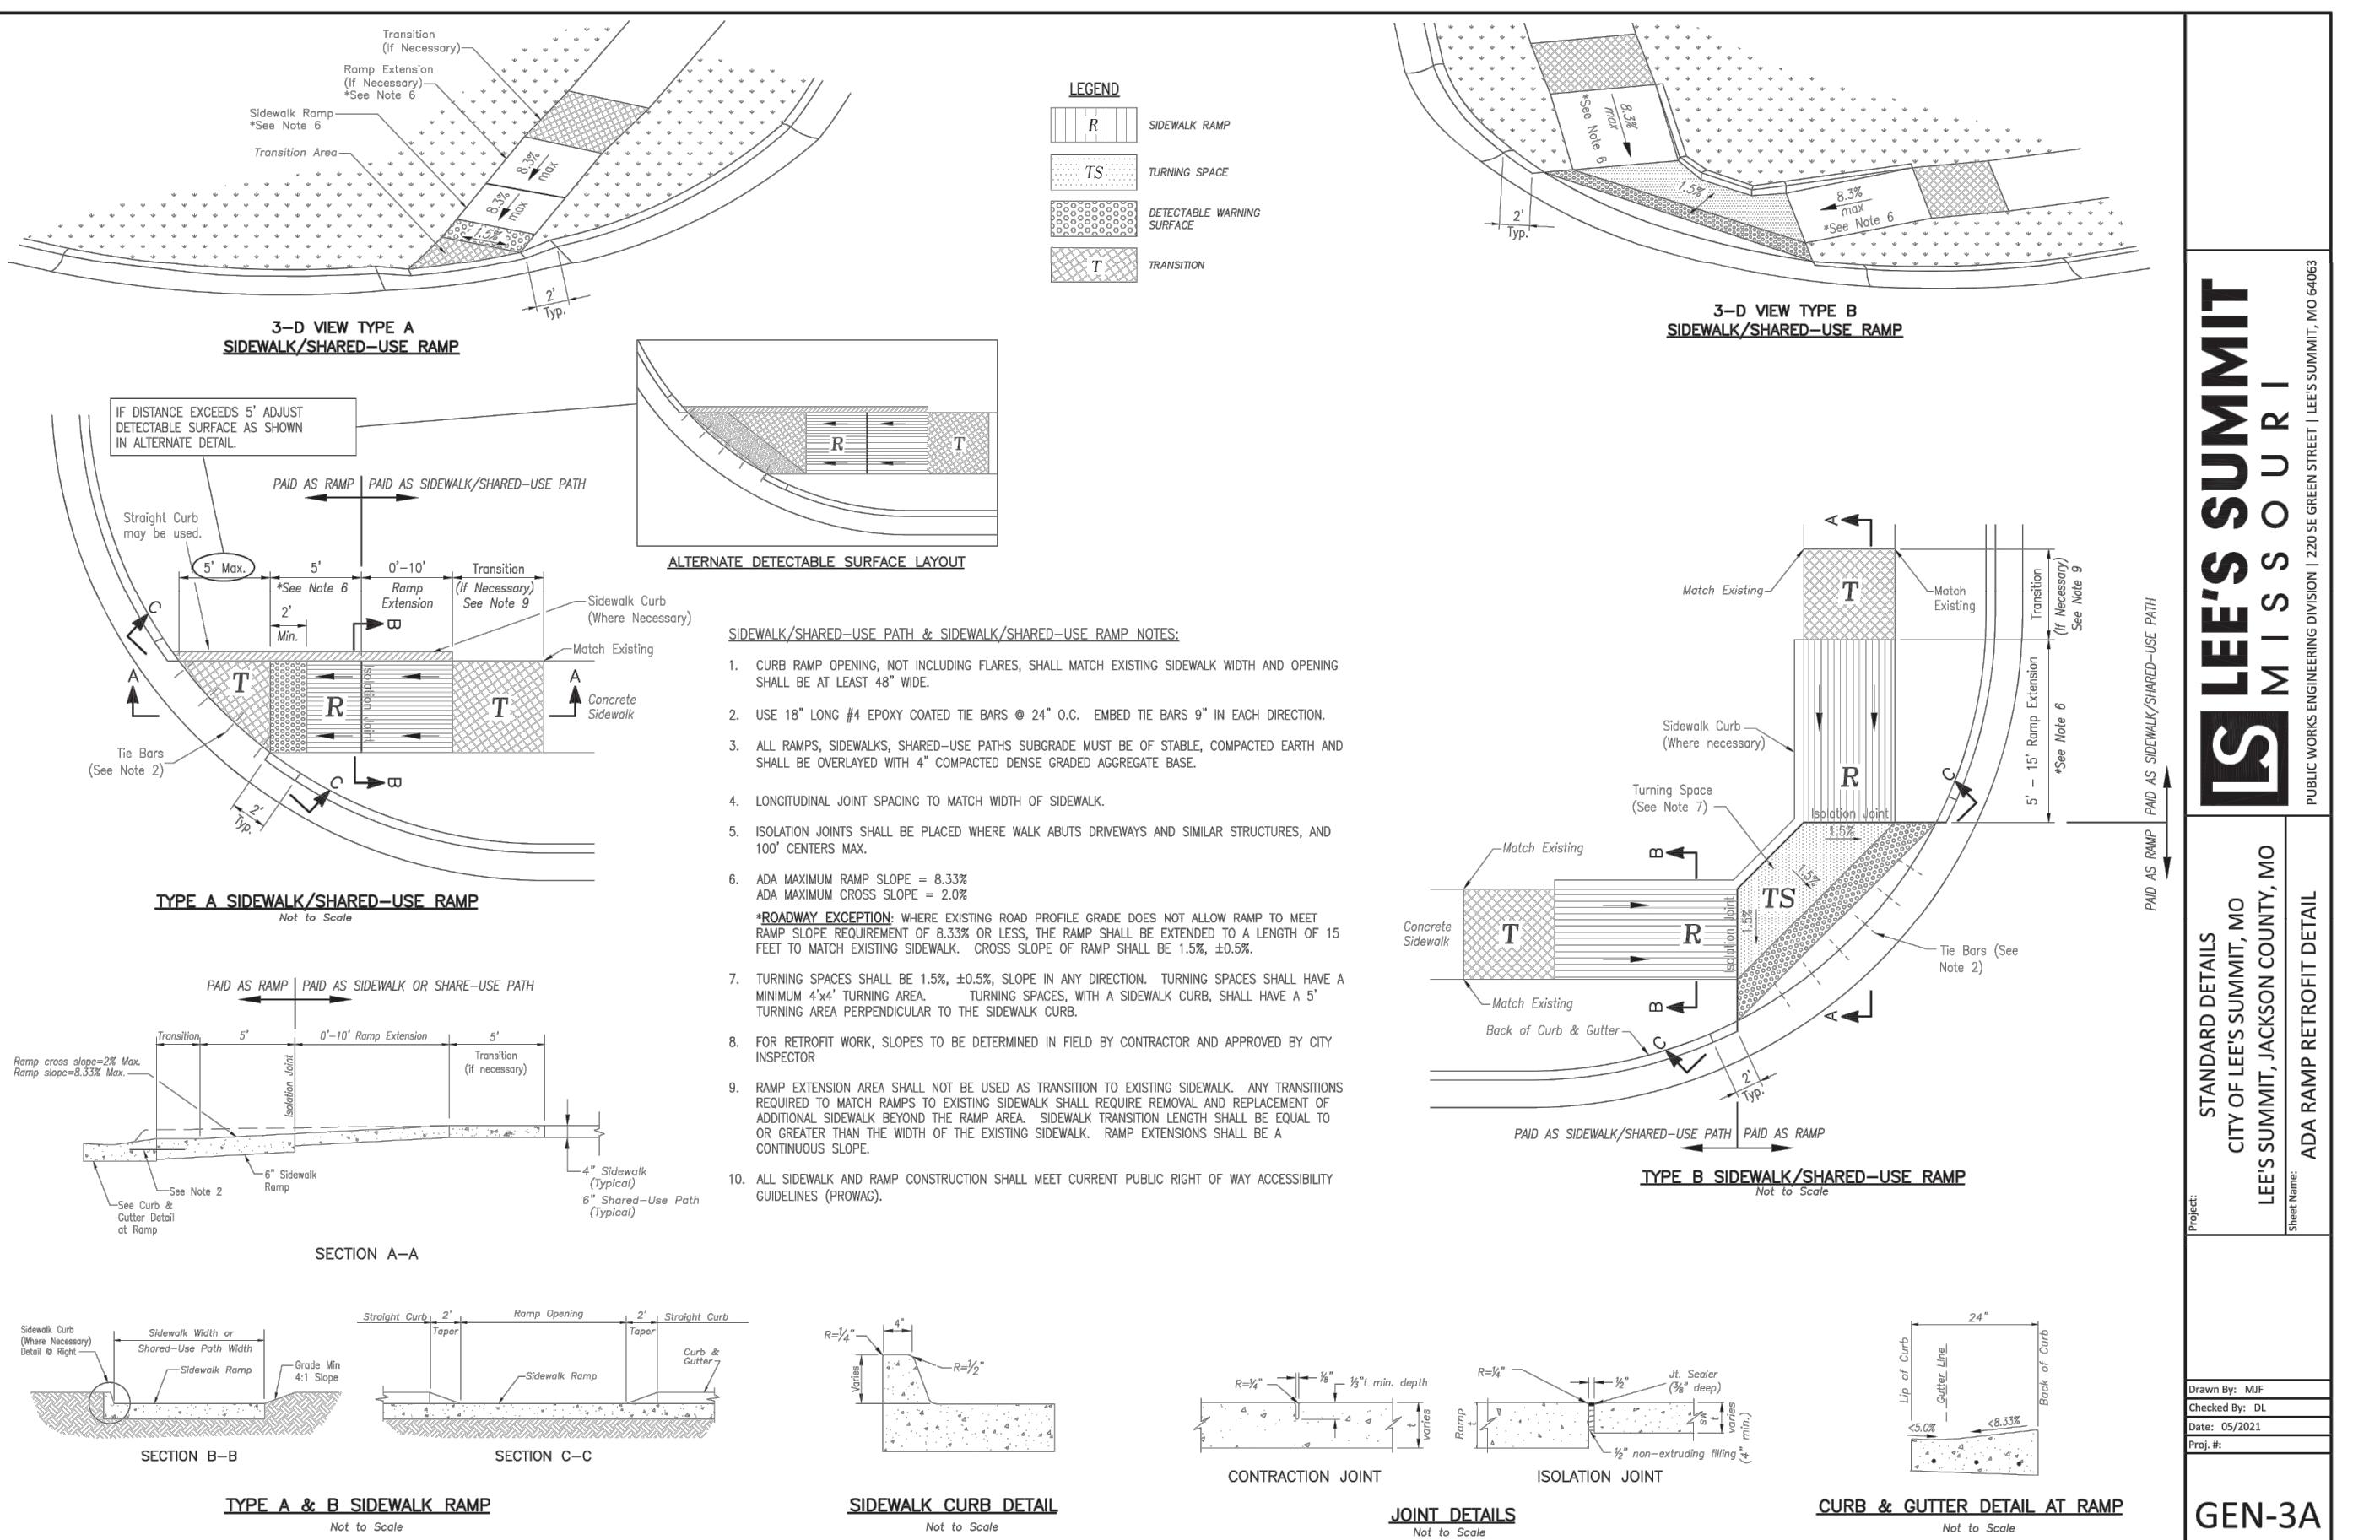


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SE SHENANDOAH DRIVE LEE'S SUMMIT, MO


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DRAWN BY:	REVISION DATE
TRC	09/05/2023
CHECKED BY:	PER CITY COMMENTS
MAB	09/05/2023
DATE PREPARED	PER CITY COMMENTS
09/05/2023	PER CITY COMMENTS
PROJ. NUMBER:	PER CITY COMMENTS
22-093	PER CITY COMMENTS

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Lee's Summit, Missouri
09/21/2023



STANDARD DETAILS
CITY OF LEE'S SUMMIT, MO
LEE'S SUMMIT, JACKSON COUNTY, MO
DRIVEWAY DETAIL
Date: 05/2021
Proj. #


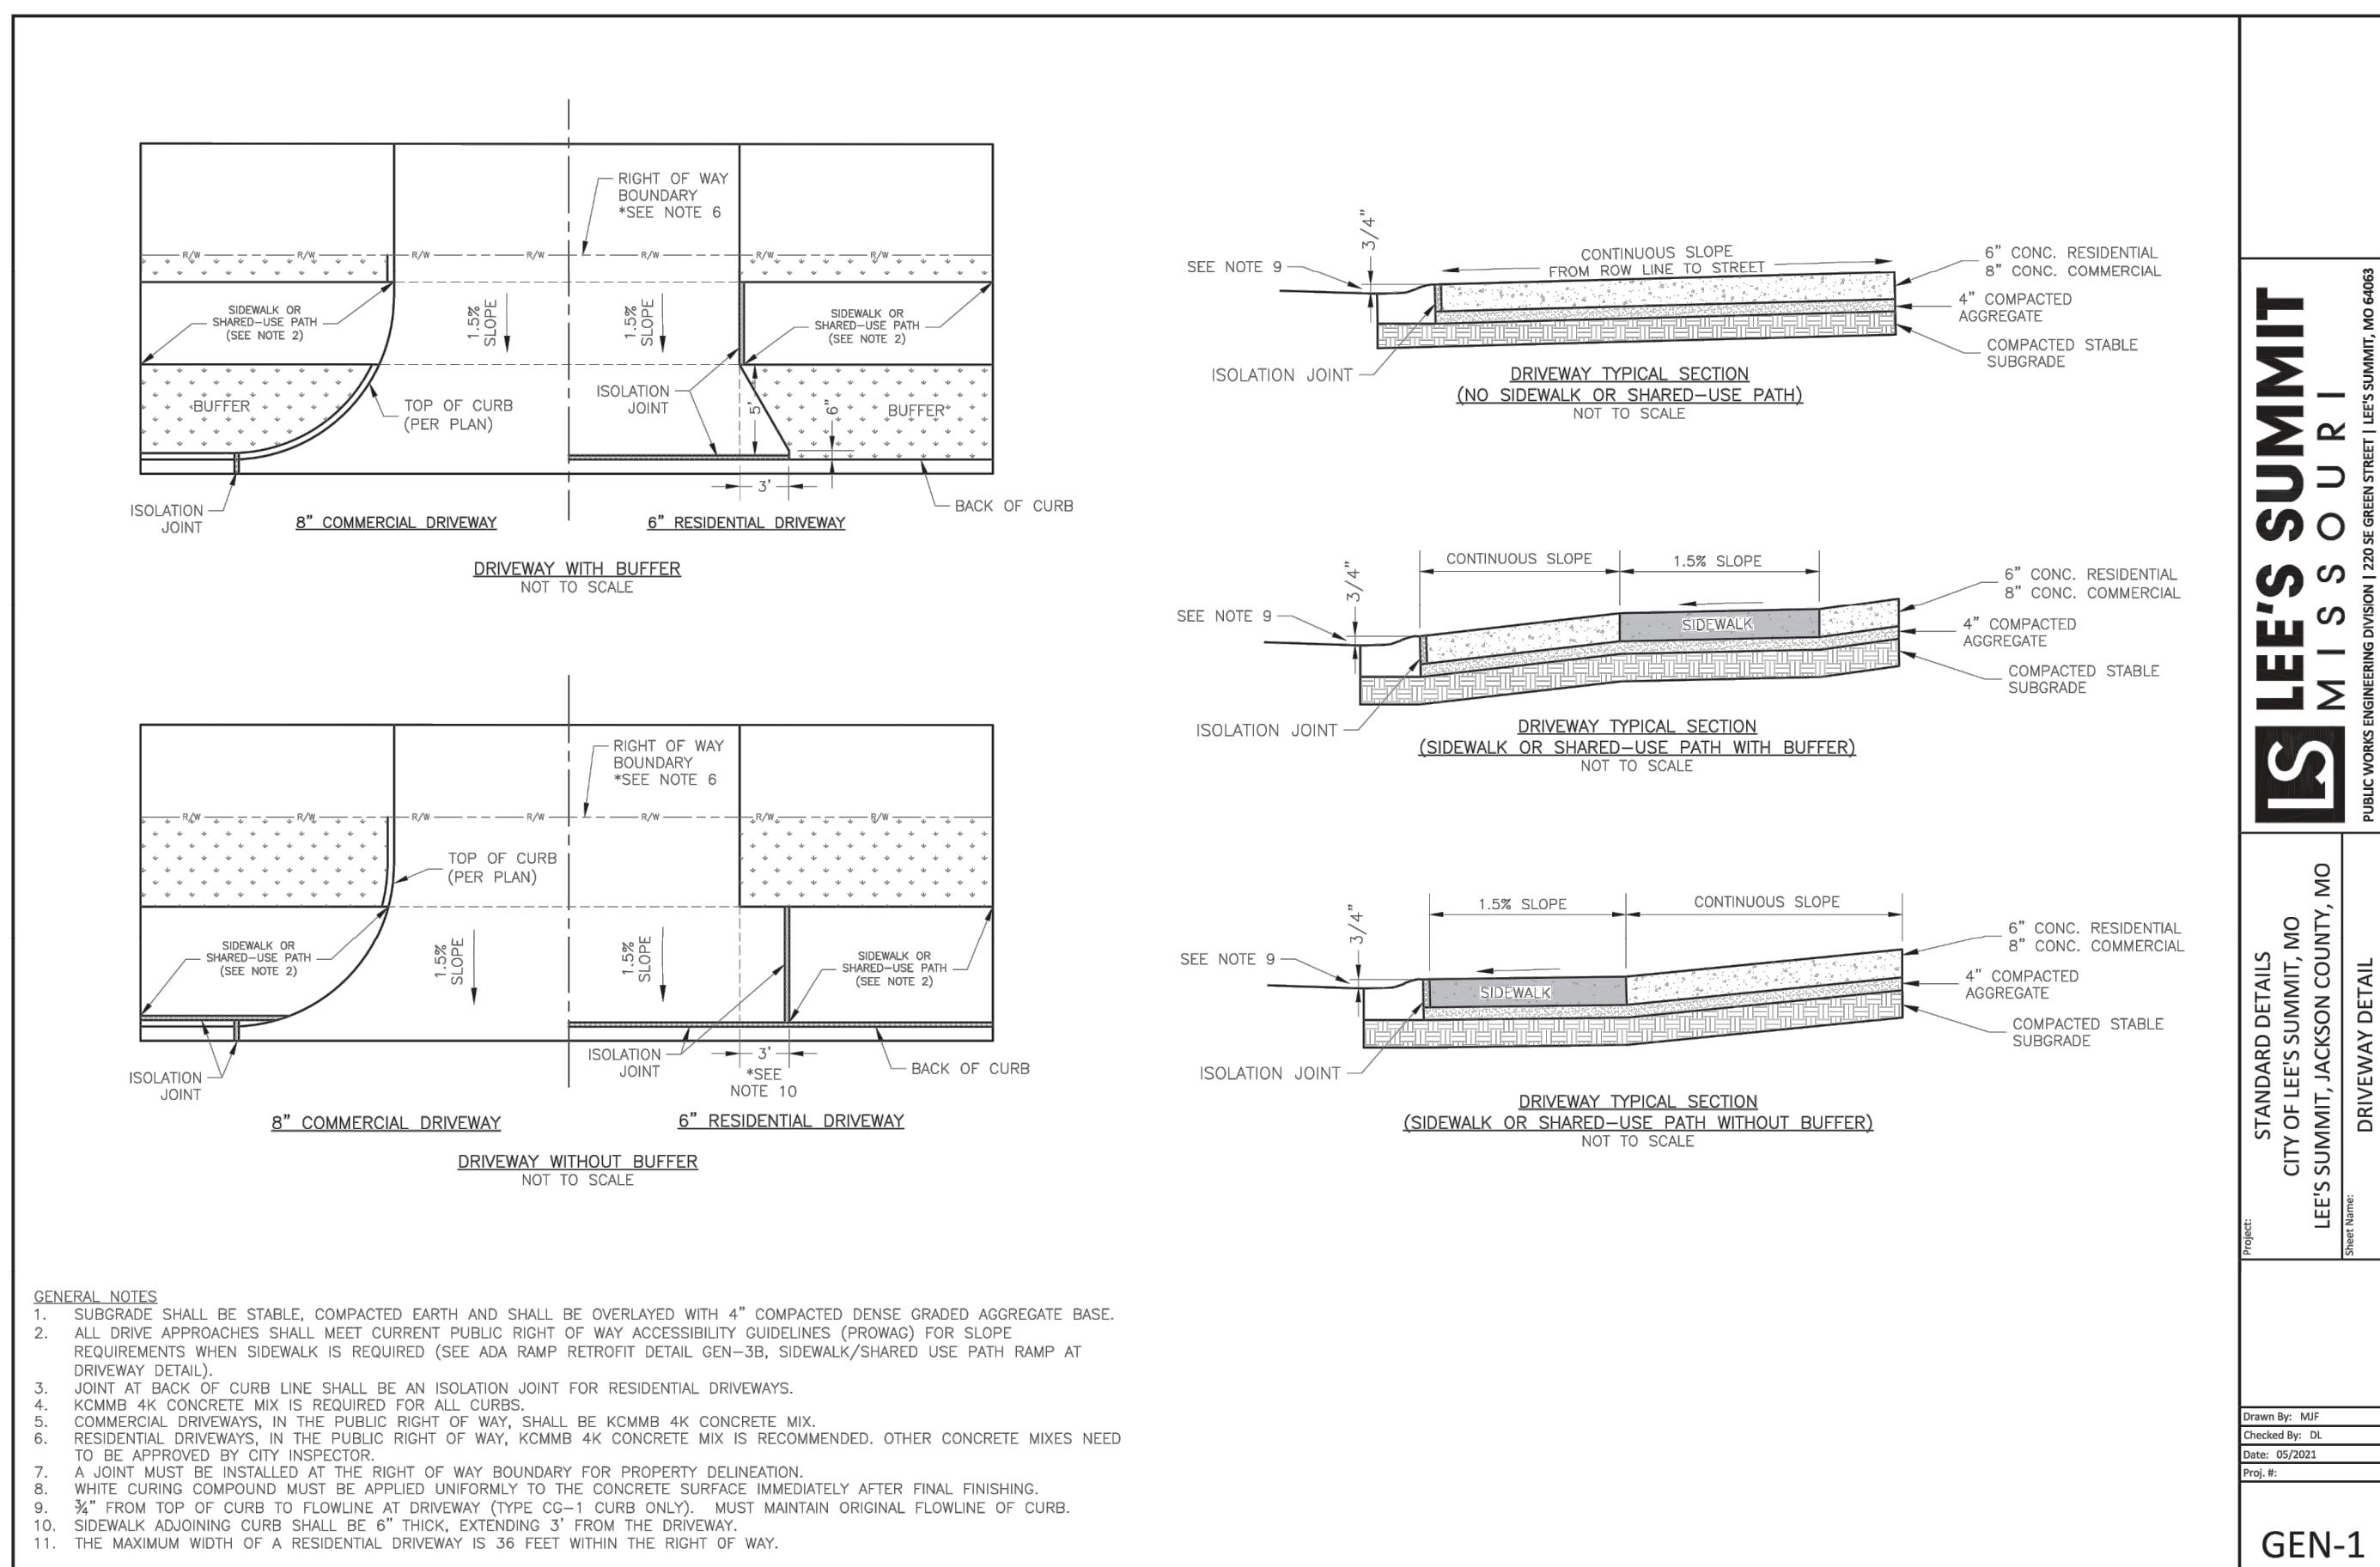
GEN-1

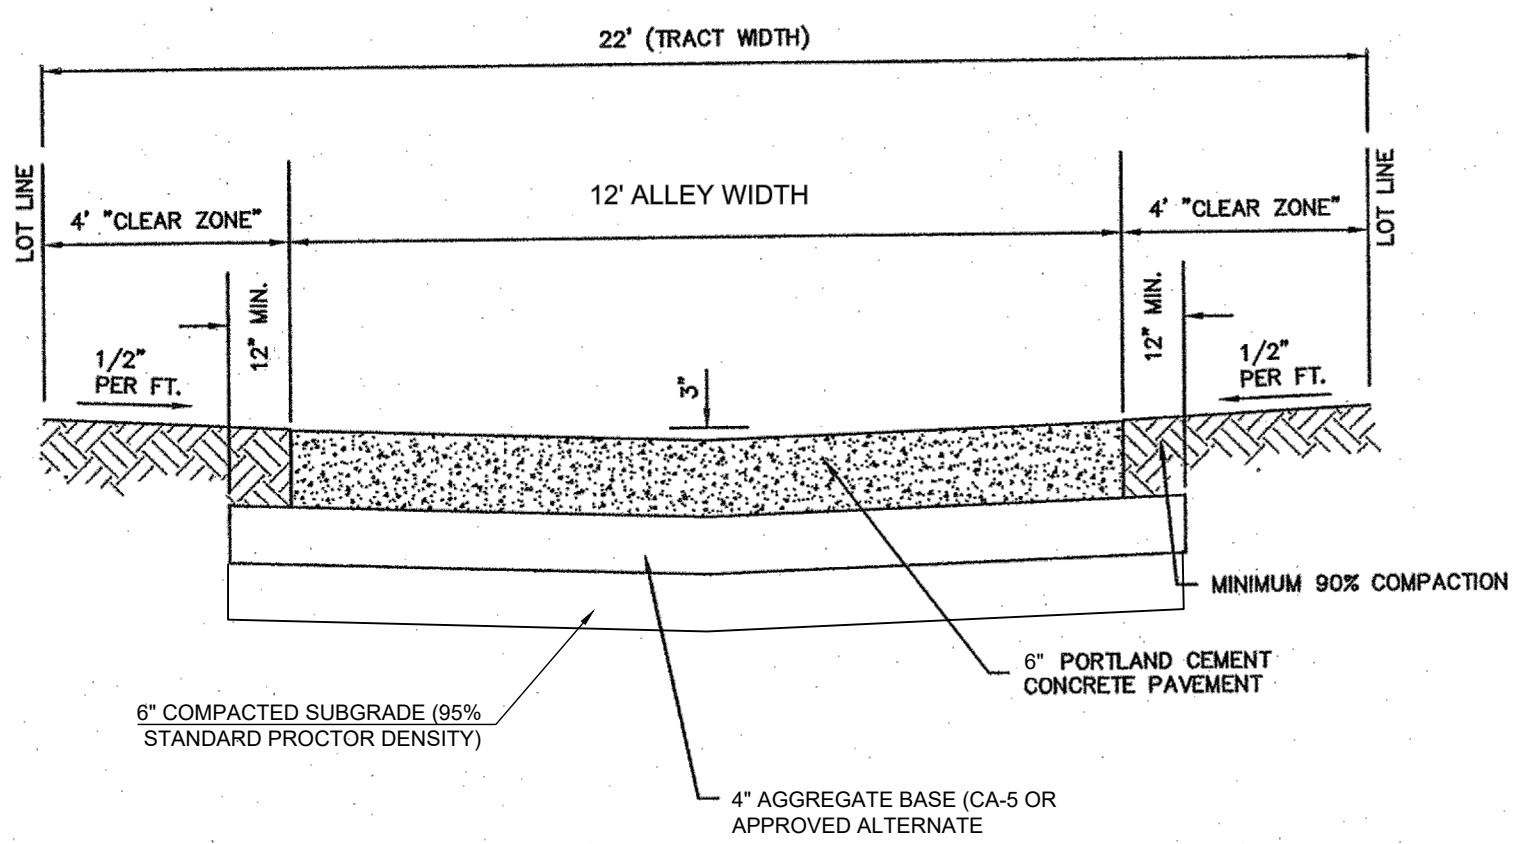

TYPICAL ALLEY SECTION

NOTES

1. COMPACTION JOINTS TO BE SAWED AT INTERVALS OF 20 FEET MAXIMUM. JOINTS SHALL BE FILLED WITH BITUMINOUS COMPOUND IMMEDIATELY FOLLOWING SAWING.
2. DOWELED EXPANSION JOINTS SHALL BE LOCATED EVERY 100 FEET MAXIMUM.
3. REINFORCE CONCRETE WITH 6x6 WOVEN WIRE MESH.
4. USE ADDITIONAL REINFORCEMENT AROUND DRAINAGE STRUCTURES AS NECESSARY.

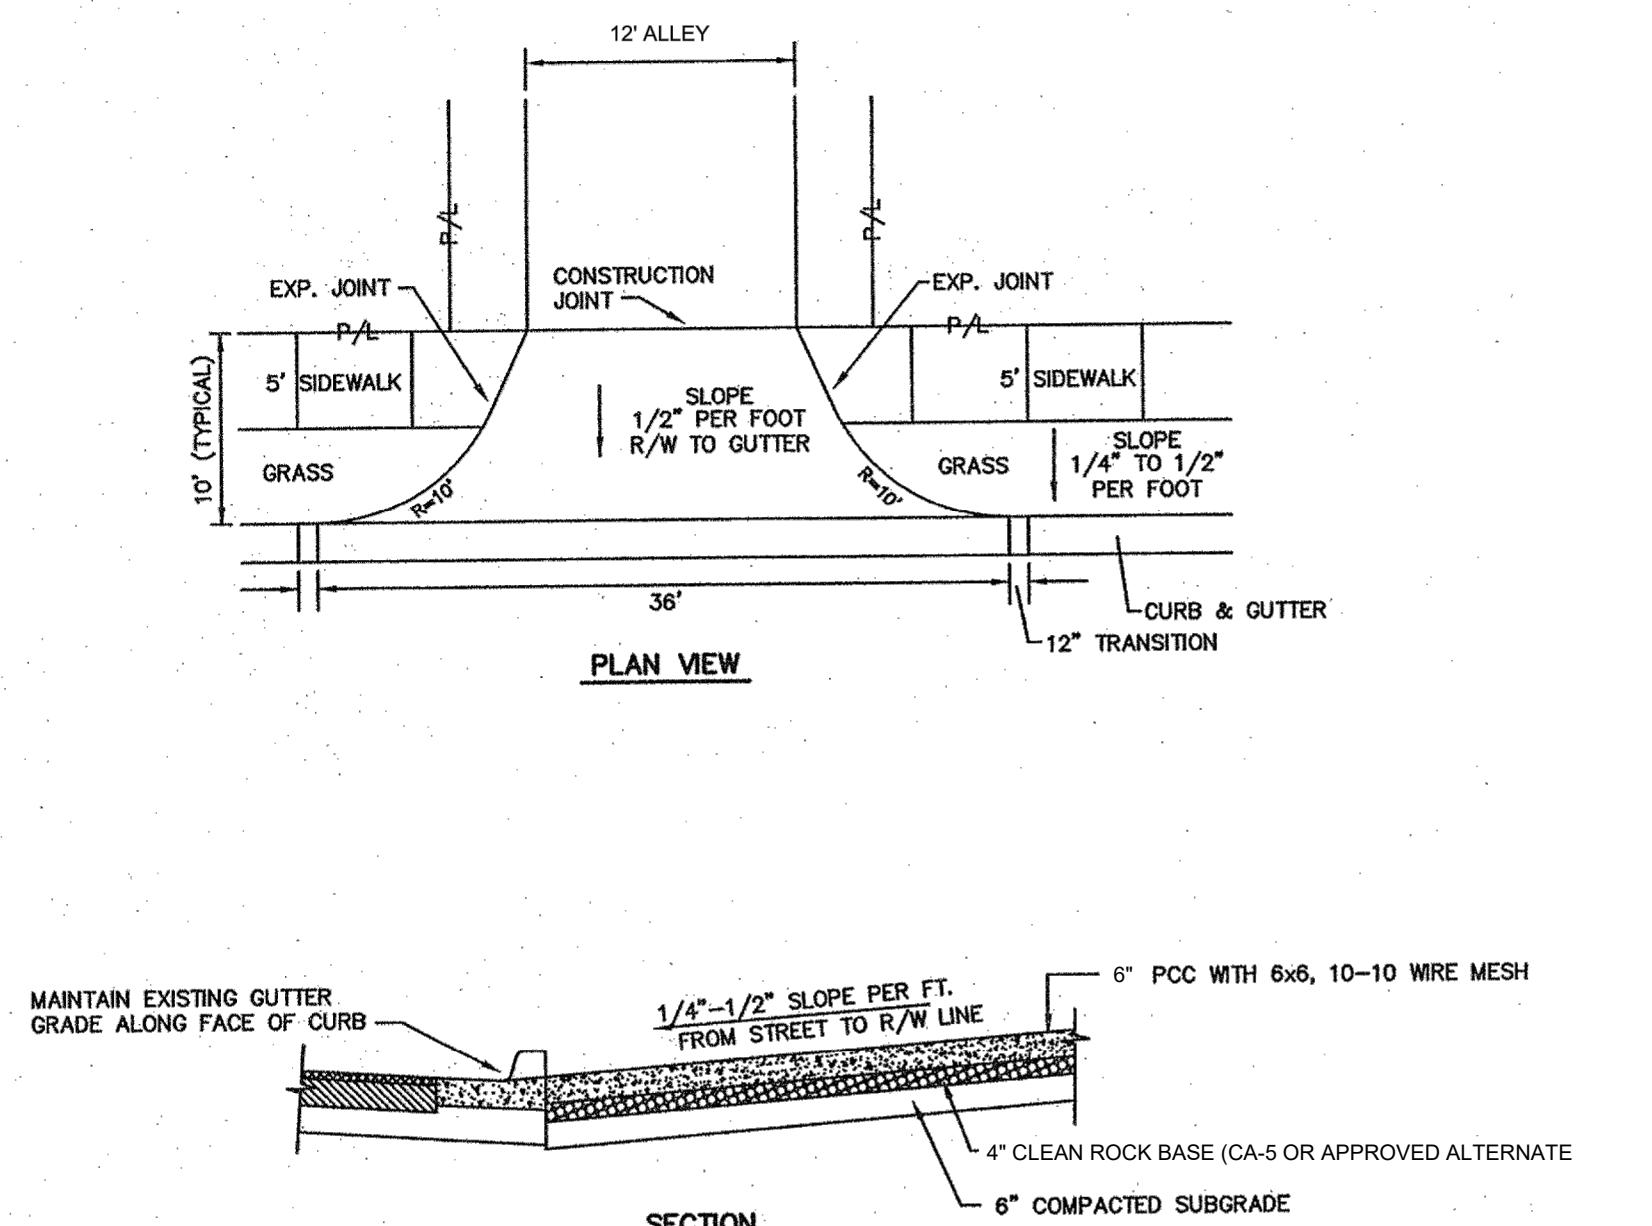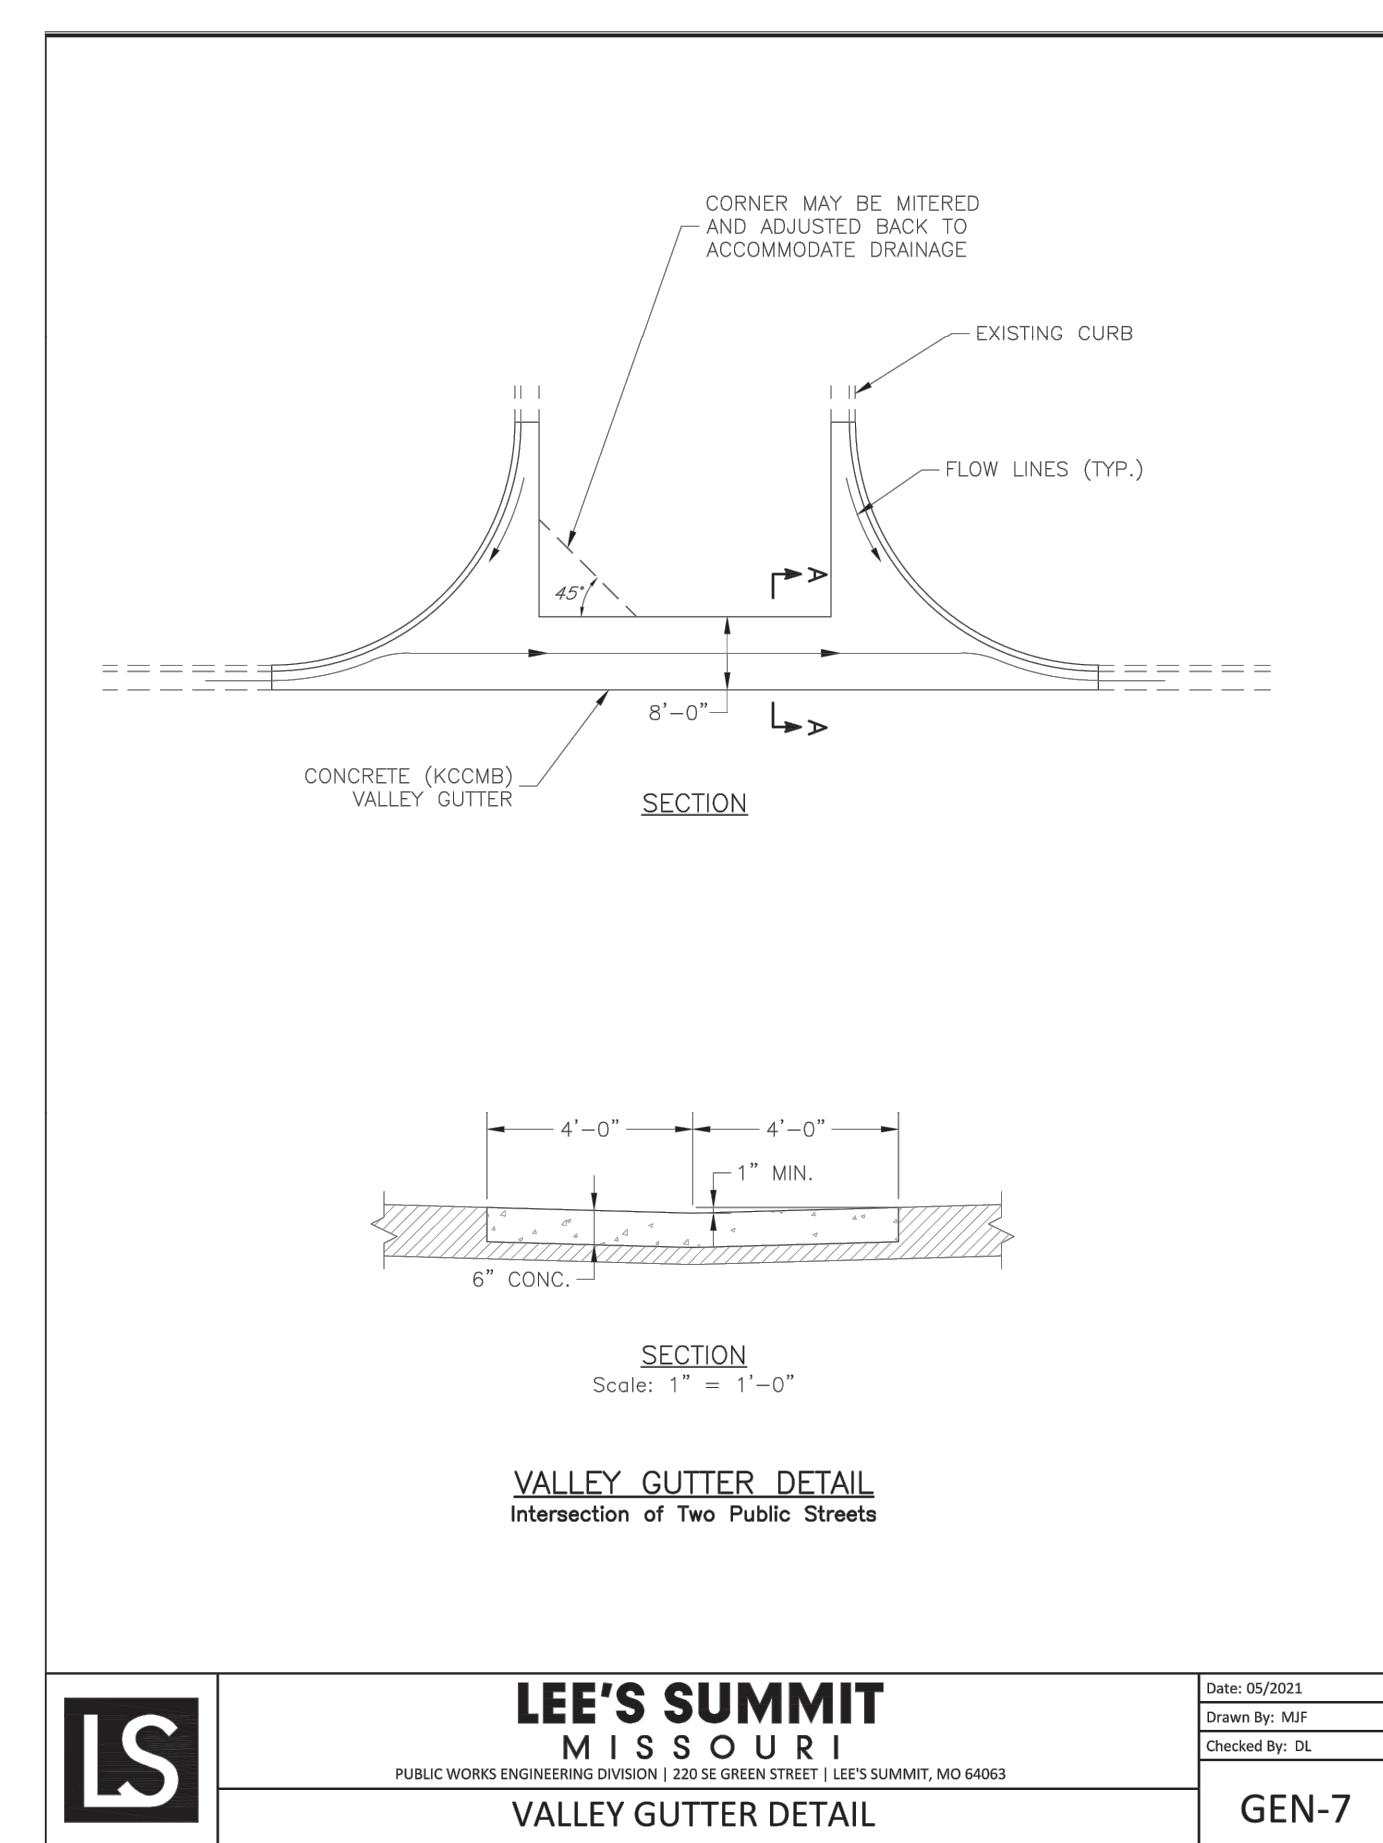

ALLEY APRON

PREPARED BY:


 MARK ALLEN DREUER
 NUMBER PE-2009007268
 09.06.2023

SCHLAGEL & ASSOCIATES, P.A.

**BLACKWELL RESERVE
STREET AND STORM SEWER PLANS**

SE SHENANDOAH DRIVE LEE'S SUMMIT, MO

ASBURY PARK LOTS 1-56 BROOKPLACE SUBSTATION
 S87°55'11"E 1316
 LINE NE 1/4 SEC 14-TN-21W

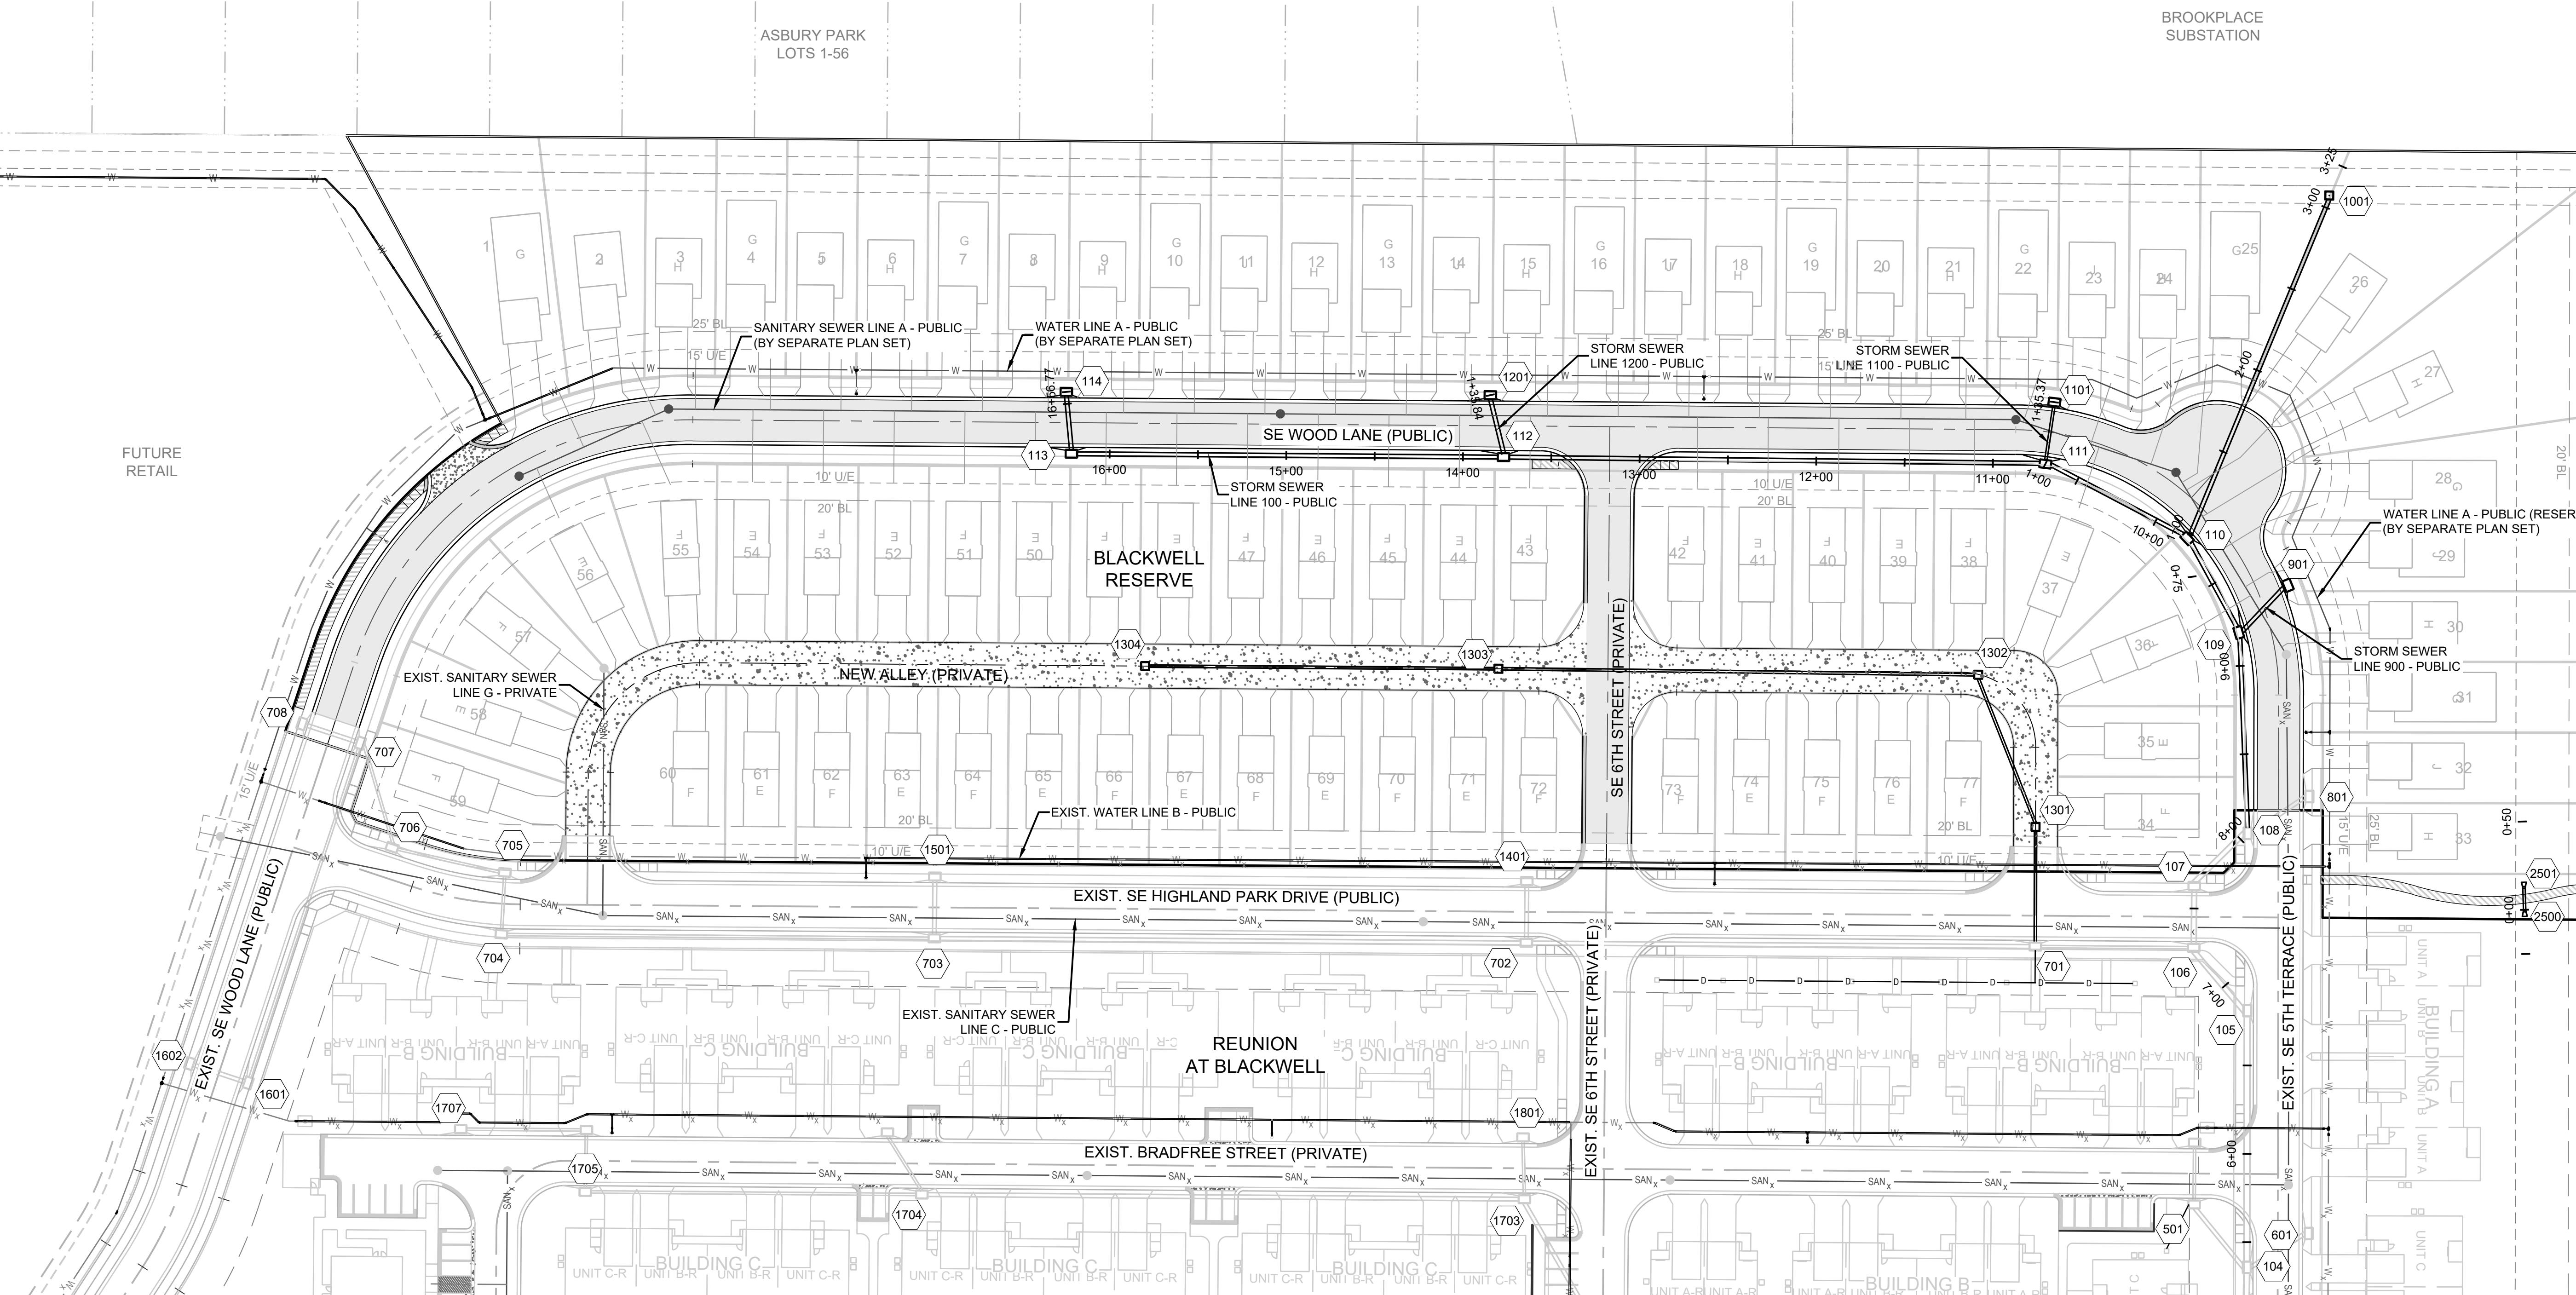

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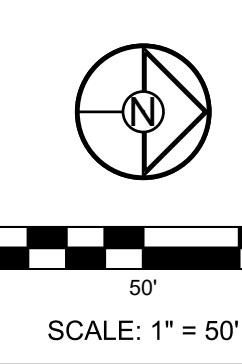
Storm Sewer Construction Notes	
Structure	Notes
109	STA 9+18.95, LINE 100 INSTALL 6 X 4 CURB INLET N 998295.8027 E 2841271.9796
110	STA 9+79.67, LINE 100 INSTALL 6 X 4 CURB INLET N 998268.4964 E 2841217.7404
111	STA 10+70.33, LINE 100 INSTALL 6 X 4 CURB INLET N 998189.7687 E 2841172.7919
112	STA 13+77.04, LINE 100 INSTALL 6 X 4 CURB INLET N 997863.4033 E 2841158.2175
113	STA 16+21.63, LINE 100 INSTALL 6 X 4 CURB INLET N 997639.0338 E 2841147.7641
114	STA 16+56.77, LINE 100 INSTALL 6 X 4 CURB INLET N 997637.4132 E 2841112.6641

Storm Sewer Construction Notes	
Structure	Notes
901	STA 1+38.65, LINE 900 INSTALL 6 X 4 CURB INLET N 997876.3091 E 2841277.8309
1001	STA 3+07.03, LINE 1000 INSTALL 4 X 4 FIELD INLET W/OPENINGS ON NORTH, EAST, SOUTH & WEST N 998335.6970 E 2841026.5189
1101	STA 7+31.36, LINE 1200 INSTALL 4 X 4 DOUBLE GRATE INLET N 997676.4887 E 2841269.3562
2500	STA 0+00.00, LINE 2500 INSTALL 15' FLARED HDPE END SECTION W/ TOEWALL AND 3 CY (12X6X1.5') STONE RIP-RAP USING A MIN.50# (D50=12") STONE. PLACE FILTER FABRIC PRIOR TO CONSTRUCTION. N 998452.0477 E 2841434.4945
1201	STA 1+35.84, LINE 1200 INSTALL 6 X 4 CURB INLET N 997877.1874 E 284122.9204
1301	STA 1+67.73, LINE 1300 INSTALL 4 X 4 DOUBLE GRATE INLET N 998177.0512 E 2841377.9295
1302	STA 2+59.76, LINE 1300 INSTALL 4 X 4 DOUBLE GRATE INLET N 998147.6085 E 2841290.7496

Storm Sewer Construction Notes	
Structure	Notes
1303	STA 5+31.36, LINE 1300 INSTALL 4 X 4 DOUBLE GRATE INLET N 997876.3091 E 2841277.8309
1304	STA 7+31.36, LINE 1300 INSTALL 4 X 4 DOUBLE GRATE INLET N 997676.4887 E 2841269.3562
1101	STA 0+00.00, LINE 2500 INSTALL 15' FLARED HDPE END SECTION W/ TOEWALL AND 3 CY (12X6X1.5') STONE RIP-RAP USING A MIN.50# (D50=12") STONE. PLACE FILTER FABRIC PRIOR TO CONSTRUCTION. N 998452.0477 E 2841434.4945
2501	STA 1+35.84, LINE 1200 INSTALL 6 X 4 CURB INLET N 997877.1874 E 284122.9204
1301	STA 1+67.73, LINE 1300 INSTALL 4 X 4 DOUBLE GRATE INLET N 998177.0512 E 2841377.9295
1302	STA 2+59.76, LINE 1300 INSTALL 4 X 4 DOUBLE GRATE INLET N 998147.6085 E 2841290.7496

NOTES:

- ALL CONSTRUCTION ON THIS PROJECT SHALL CONFORM TO THE CITY OF LEE'S SUMMIT TECHNICAL SPECIFICATIONS.
- THE CONTRACTOR IS RESPONSIBLE FOR VERIFYING ALL EXISTING UTILITY LOCATIONS PRIOR TO EXCAVATION.




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Development Services Department
Lee's Summit, Missouri

09/21/2023

SCHLAGEL
ENGINEERS PLANNERS SURVEYORS LANDSCAPE ARCHITECTS
14920 107th Street Lenexa, Kansas 66215
(913) 492-5158 • Fax: (913) 492-3400
WWW.SCHLAGELASSOCIATES.COM
#E2020038005 F-BLAC2020100237 #S202003859-F

PREPARED BY:

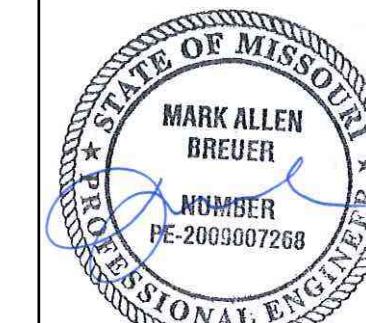MARK ALLEN BREUER
PE-2009007268
09.06.2023

SCHLAGEL & ASSOCIATES, P.A.

**BLACKWELL RESERVE
STREET AND STORM SEWER PLANS
SE SHENANDOAH DRIVE LEE'S SUMMIT, MO**

22

Design Storm:		10																								
"K" Value:		1.00																								
"F" Factor:		1.00																								
Runoff Calculations																										
Inlet #	Area (acres)	"C" Value	Cumul. Area (acres)	Cumul. Cx A	Cumul. Tc	Intensity	Runoff To Inlet	Cumul. Runoff	Pipe Cap.	Pipe Vel.	Up Inlet 1	Up Inlet 2	Up Area (acres)	Up Cx A	Up Inlet	Down Inlet	Pipe Type	"n" Value	Pipe Size	Slope %	Drop In Inlet	FL Up	FL Down	Inlet Top	HGL Elev.	
Pipe Properties																										
LINE 100																										
101	0.61	0.66	20.40	13.46	8.6	6.38	2.57	85.94	103.97	10.81	201	301	0.00	0.00	101	100	HDPE	0.012	42	55.00	0.91	0.50	984.50	984.00	995.20	988.80
102	0.40	0.66	19.79	13.06	8.6	6.39	1.69	83.45	231.47	24.06	201	301	3.52	2.32	102	101	HDPE	0.012	42	35.50	4.51	0.50	986.60	985.00	995.20	990.22
103	0.37	0.66	15.87	10.47	8.3	6.45	1.58	67.59	78.60	8.17	401		0.42	0.28	103	102	HDPE	0.012	42	133.63	0.52	0.50	987.80	987.10	996.61	999.99
104	0.22	0.66	15.08	9.95	7.9	6.55	0.95	65.22	82.29	8.55	501	601	1.57	1.04	104	103	HDPE	0.012	42	211.60	0.57	0.50	989.50	988.30	998.95	992.63
105	0.11	0.66	13.29	8.77	7.7	6.61	0.48	58.02	68.17	9.64			0.00	0.00	105	104	HDPE	0.012	36	145.31	0.89	0.50	991.30	990.00	1000.55	994.44
106	0.18	0.66	13.18	8.70	7.6	6.64	0.79	57.72	67.01	9.48	701		6.73	4.44	106	105	HDPE	0.012	36	46.74	0.86	0.50	992.20	991.80	1001.44	995.33
107	0.64	0.66	6.27	4.14	6.9	6.80	2.87	28.14	41.21	8.39			0.00	0.00	107	106	HDPE	0.012	30	35.00	0.86	0.50	993.00	992.70	1001.44	995.72
108	0.18	0.66	5.63	3.72	6.8	6.82	0.81	25.36	37.44	7.63	801		0.26	0.17	108	107	HDPE	0.012	30	42.40	0.71	0.50	993.80	993.50	1001.65	1002.51
109	0.12	0.66	5.19	3.43	6.6	6.89	0.55	23.61	37.18	7.57	901		0.66	0.44	109	108	HDPE	0.012	30	11.76	0.70	0.50	995.10	994.30	1002.98	1001.20
110	0.11	0.66	4.41	2.91	6.4	6.93	0.50	20.17	22.19	7.06	1001		1.50	0.99	110	109	HDPE	0.012	24	60.72	0.82	0.50	996.09	995.60	1004.14	1005.24
111	0.53	0.66	2.80	1.85	6.3	6.97	2.44	12.87	20.70	11.72	1101		0.65	0.43	111	110	HDPE	0.012	18	90.66	3.31	0.50	999.59	996.59	1006.03	1001.40
112	0.42	0.66	1.62	1.07	5.6	7.16	1.98	7.65	9.28	7.57	1201		0.47	0.31	112	111	HDPE	0.012	15	306.71	1.76	0.50	1005.49	1000.09	1011.58	1006.94
113	0.34	0.66	0.73	0.48	5.1	7.33	1.64	3.53	8.96	7.30			0.00	0.00	113	112	HDPE	0.012	15	244.59	1.64	0.50	1010.00	1005.99	1015.97	1013.70
114	0.39	0.66	0.39	0.26	5.0	7.35	1.89	1.89	8.34	6.80			0.00	0.00	114	113	HDPE	0.012	15	35.14	1.42	N/A	1011.00	1010.50	1016.02	1013.84
DS TAILWATER @ STR #100																										
101	0.61	0.66	20.40	13.46	8.6	6.38	2.57	85.94	103.97	10.81	201	301	0.00	0.00	101	100	HDPE	0.012	42	55.00	0.91	0.50	984.50	984.00	995.20	992.90
102	0.40	0.66	19.79	13.06	8.6	6.39	1.69	83.45	231.47	24.06	201	301	3.52	2.32	102	101	HDPE	0.012	42	35.50	4.51	0.50	986.60	985.00	995.20	990.57
103	0.37	0.66	15.87	10.47	8.3	6.45	1.58	67.59	78.60	8.17	401		0.42	0.28	103	102	HDPE	0.012	42	133.63	0.52	0.50	987.80	987.10	996.61	997.99
104	0.22	0.66	15.08	9.95	7.9	6.55	0.95	65.22	82.29	8.55	501	601	1.57	1.04	104	103	HDPE	0.012	42	211.60	0.57	0.50	989.50	988.30	998.95	1000.07
105	0.11	0.66	13.29	8.77	7.7	6.61	0.48	58.02	68.17	9.64			0.00	0.00	105	104	HDPE	0.012	36	145.31	0.89	0.50	991.30	990.00	1000.55	1003.49
106	0.18	0.66	13.18	8.70	7.6	6.64	0.79	57.72	67.01	9.48	701		6.73	4.44	106	105	HDPE	0.012	36	46.74	0.86	0.50	992.20	991.80	1001.44	1003.08
107																										

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 Lee's Summit, Missouri
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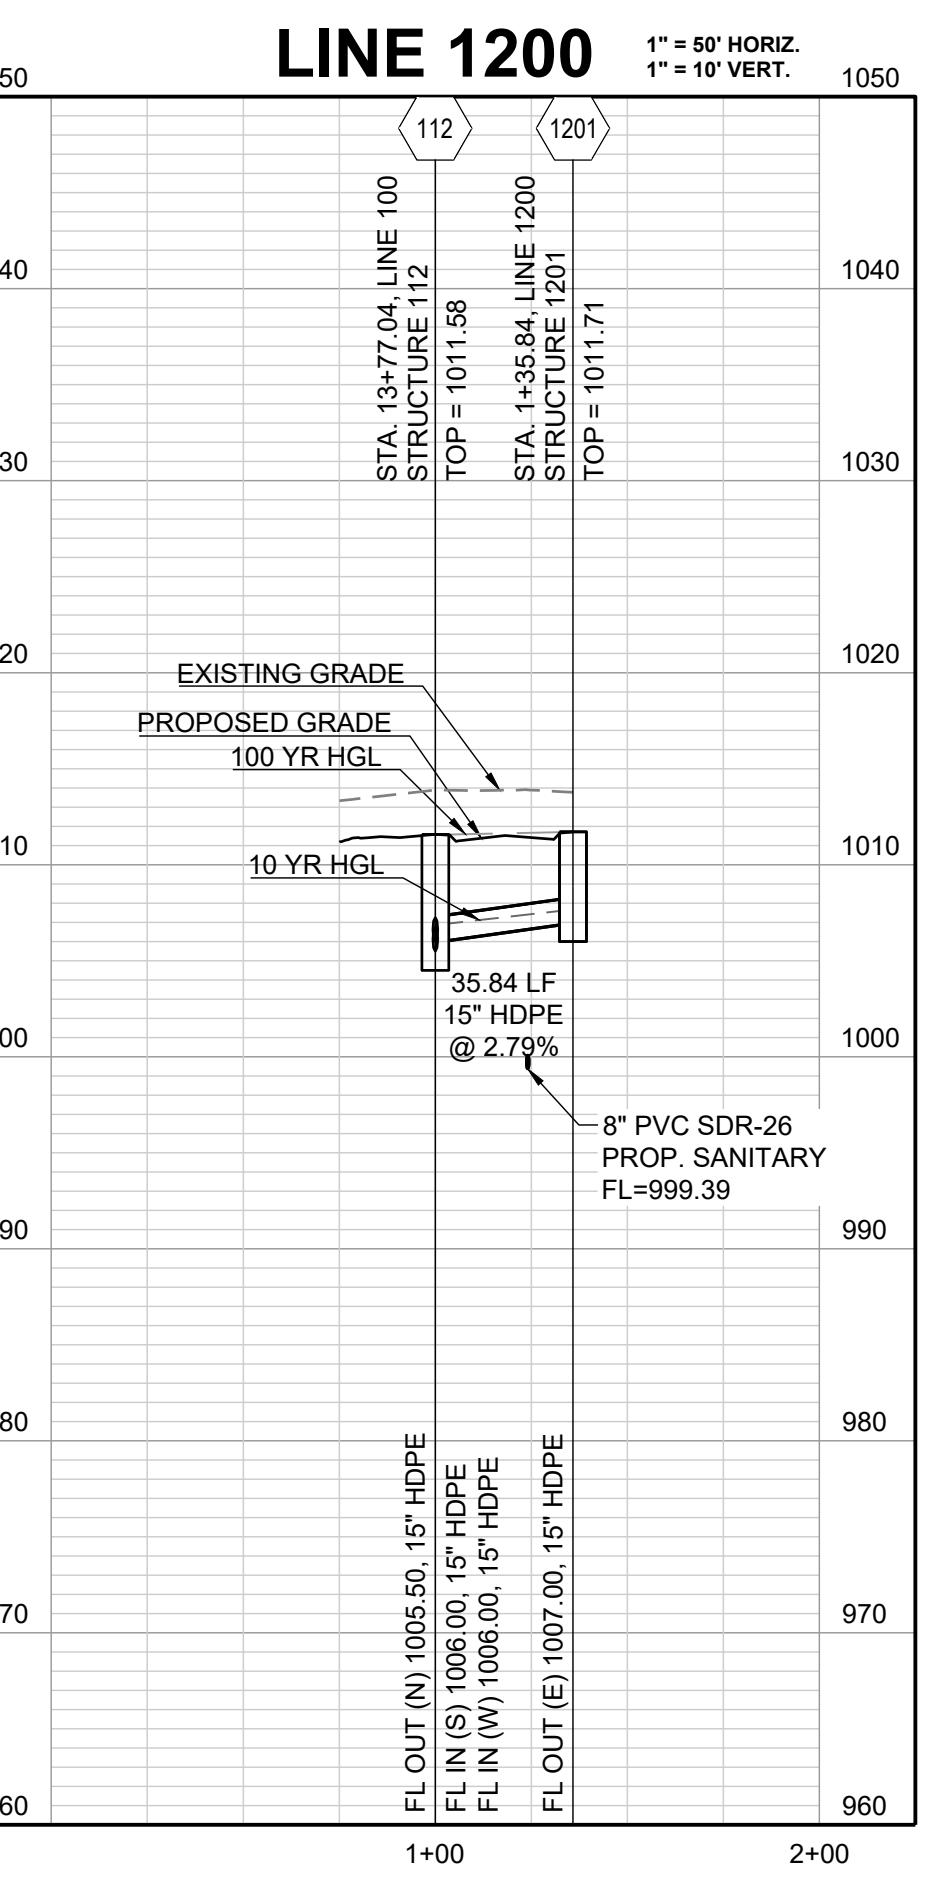
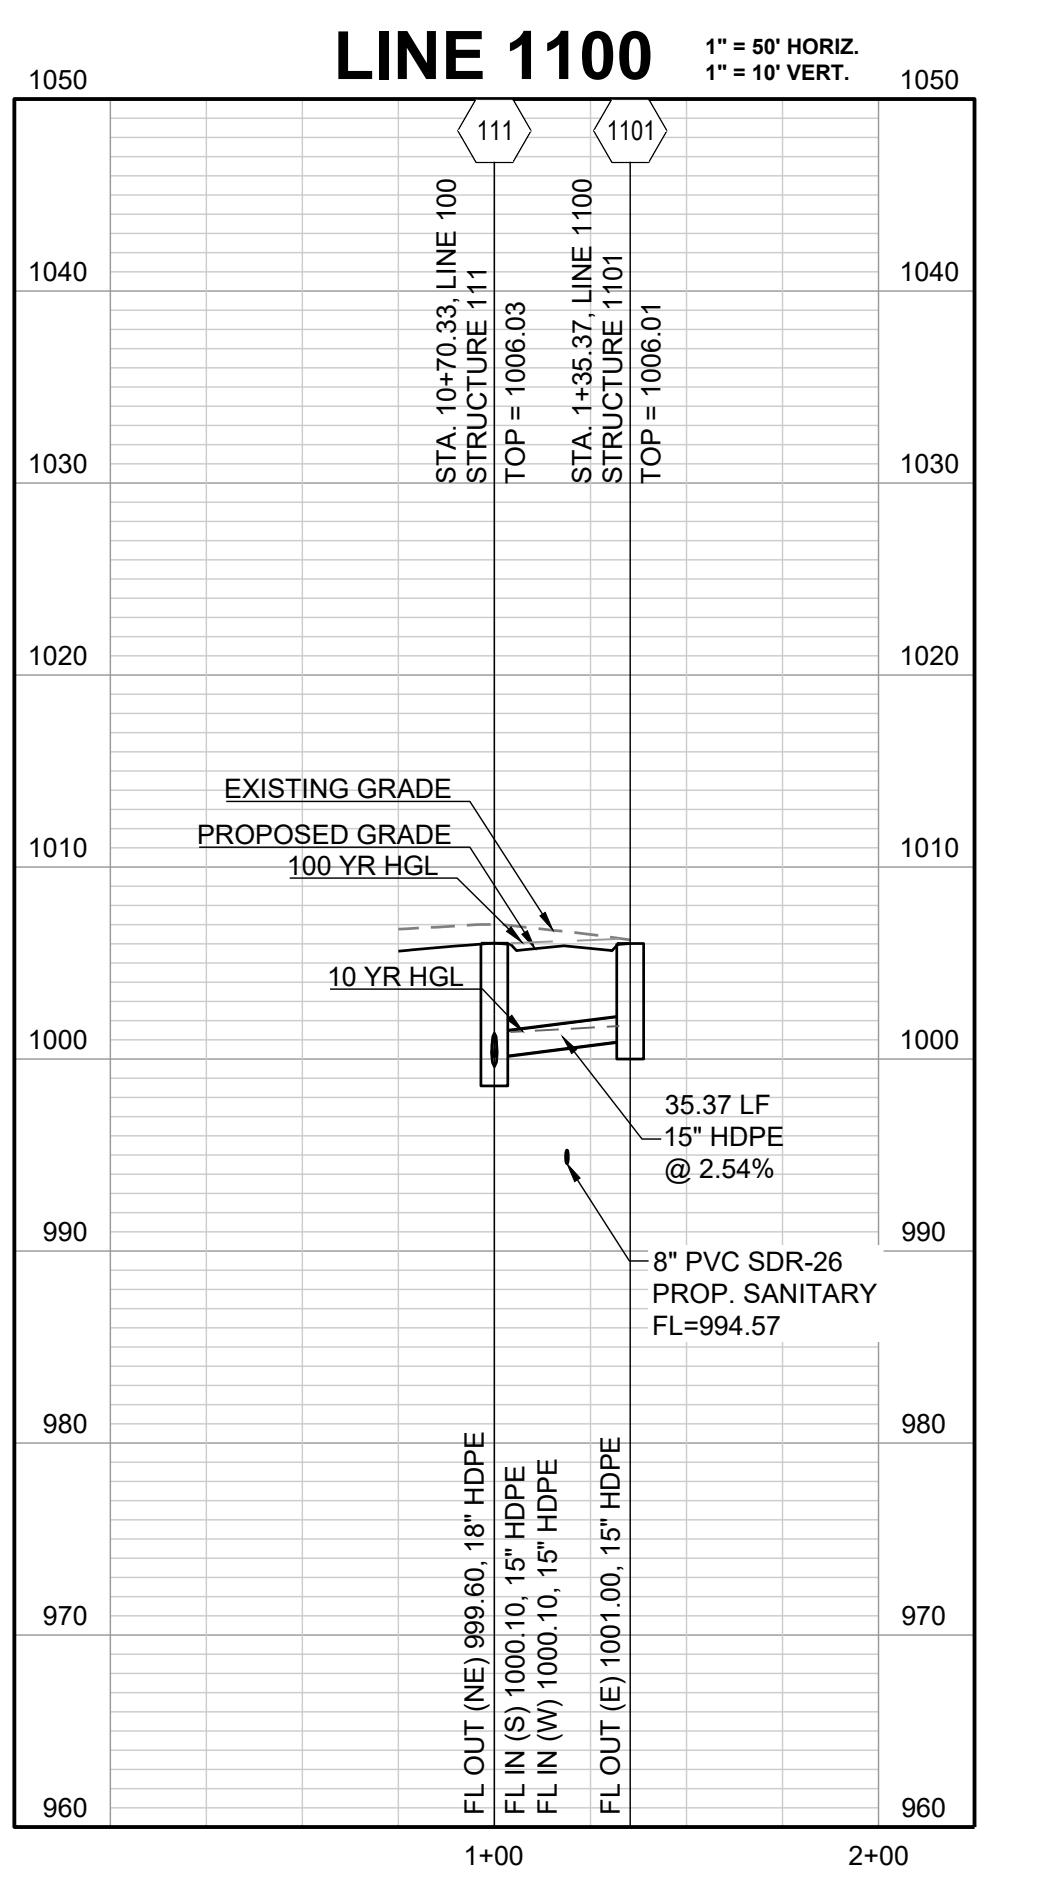
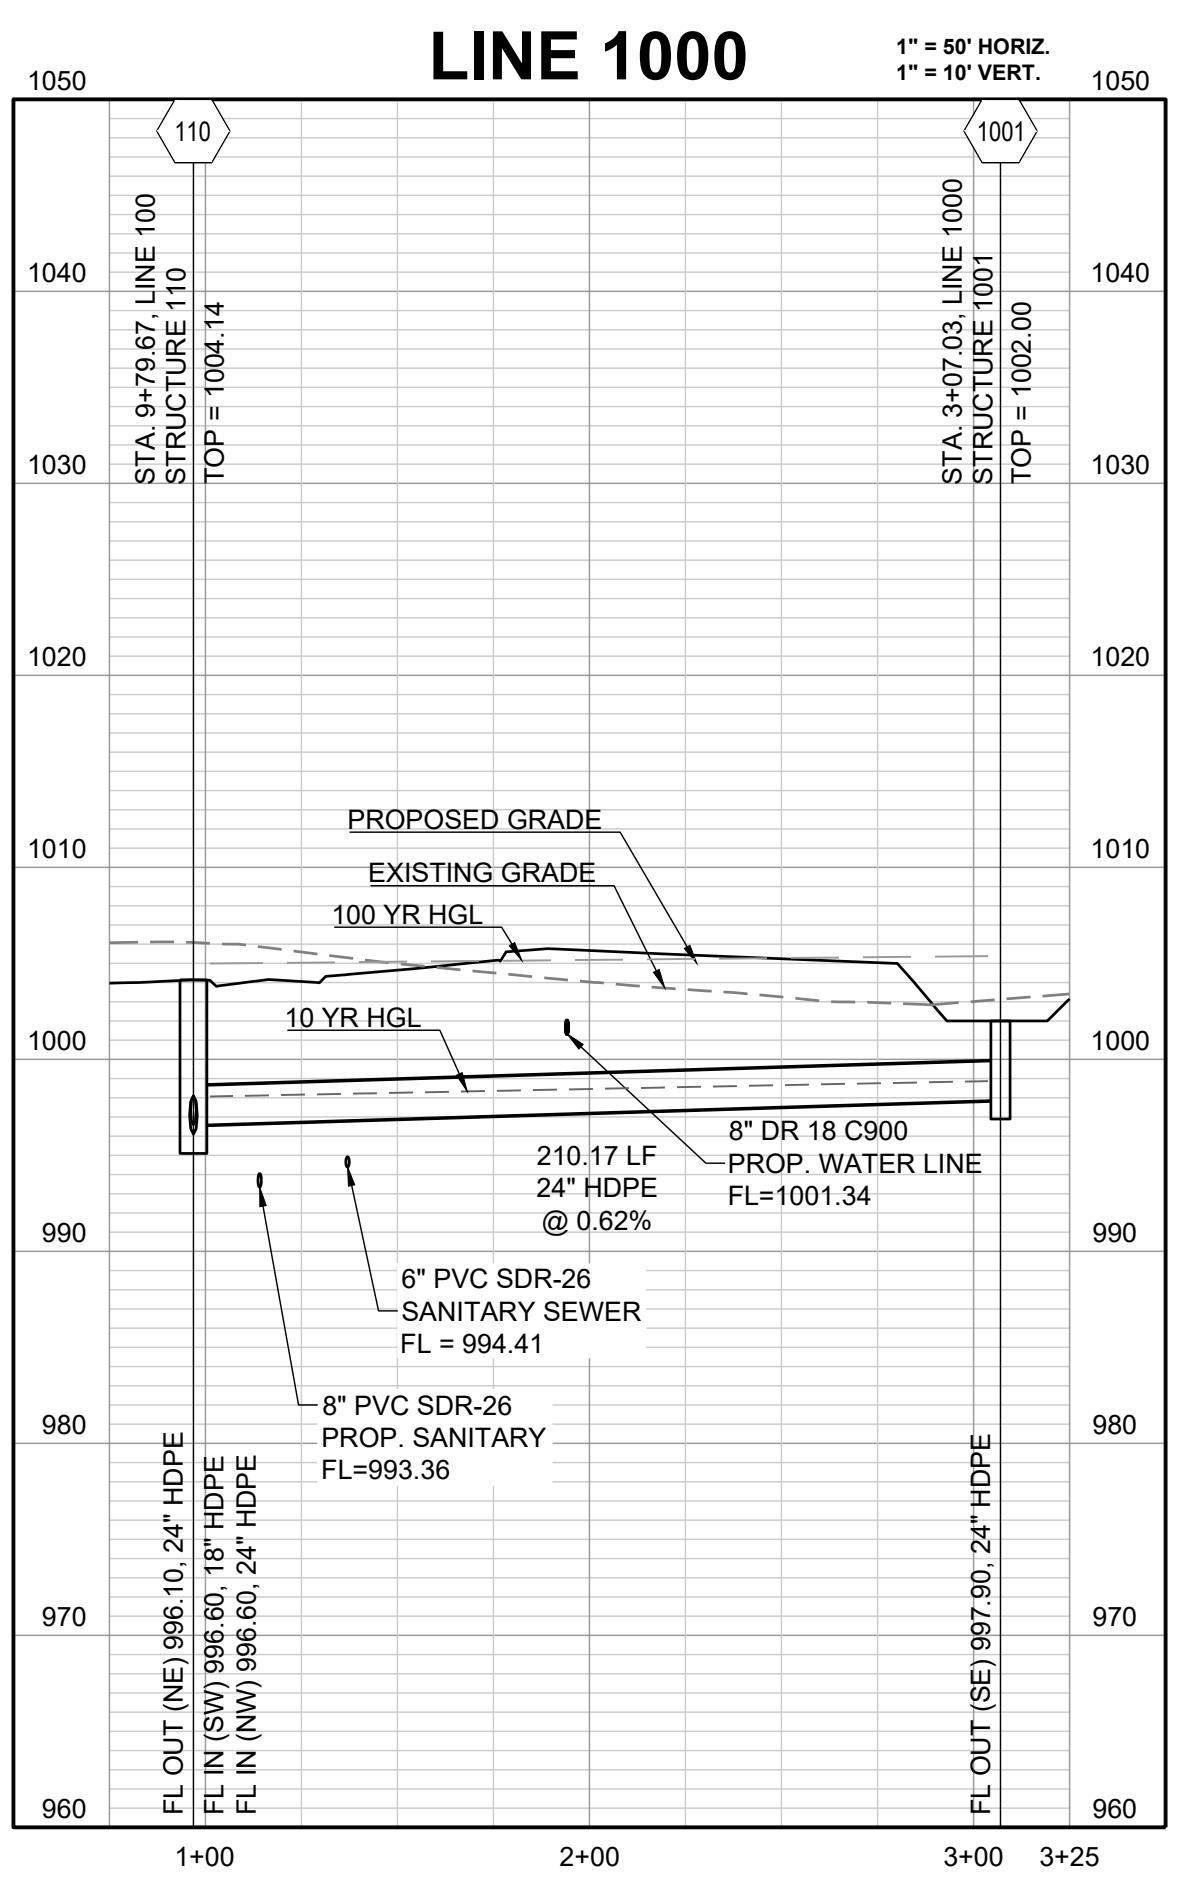
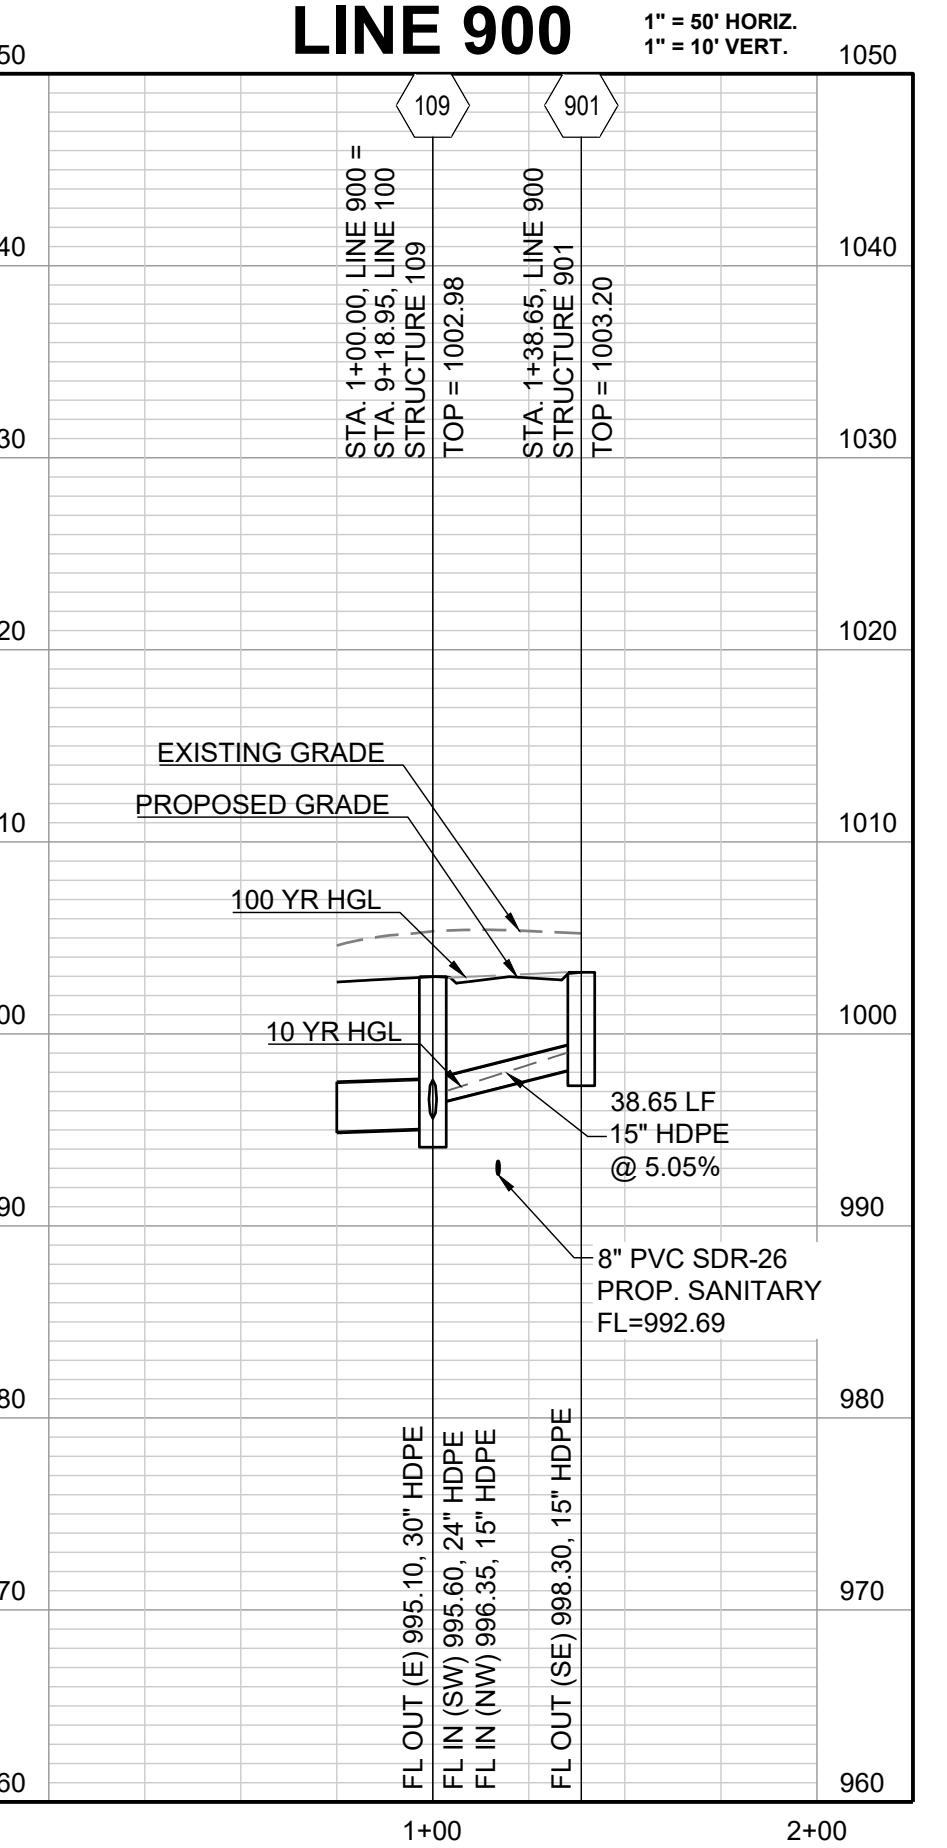
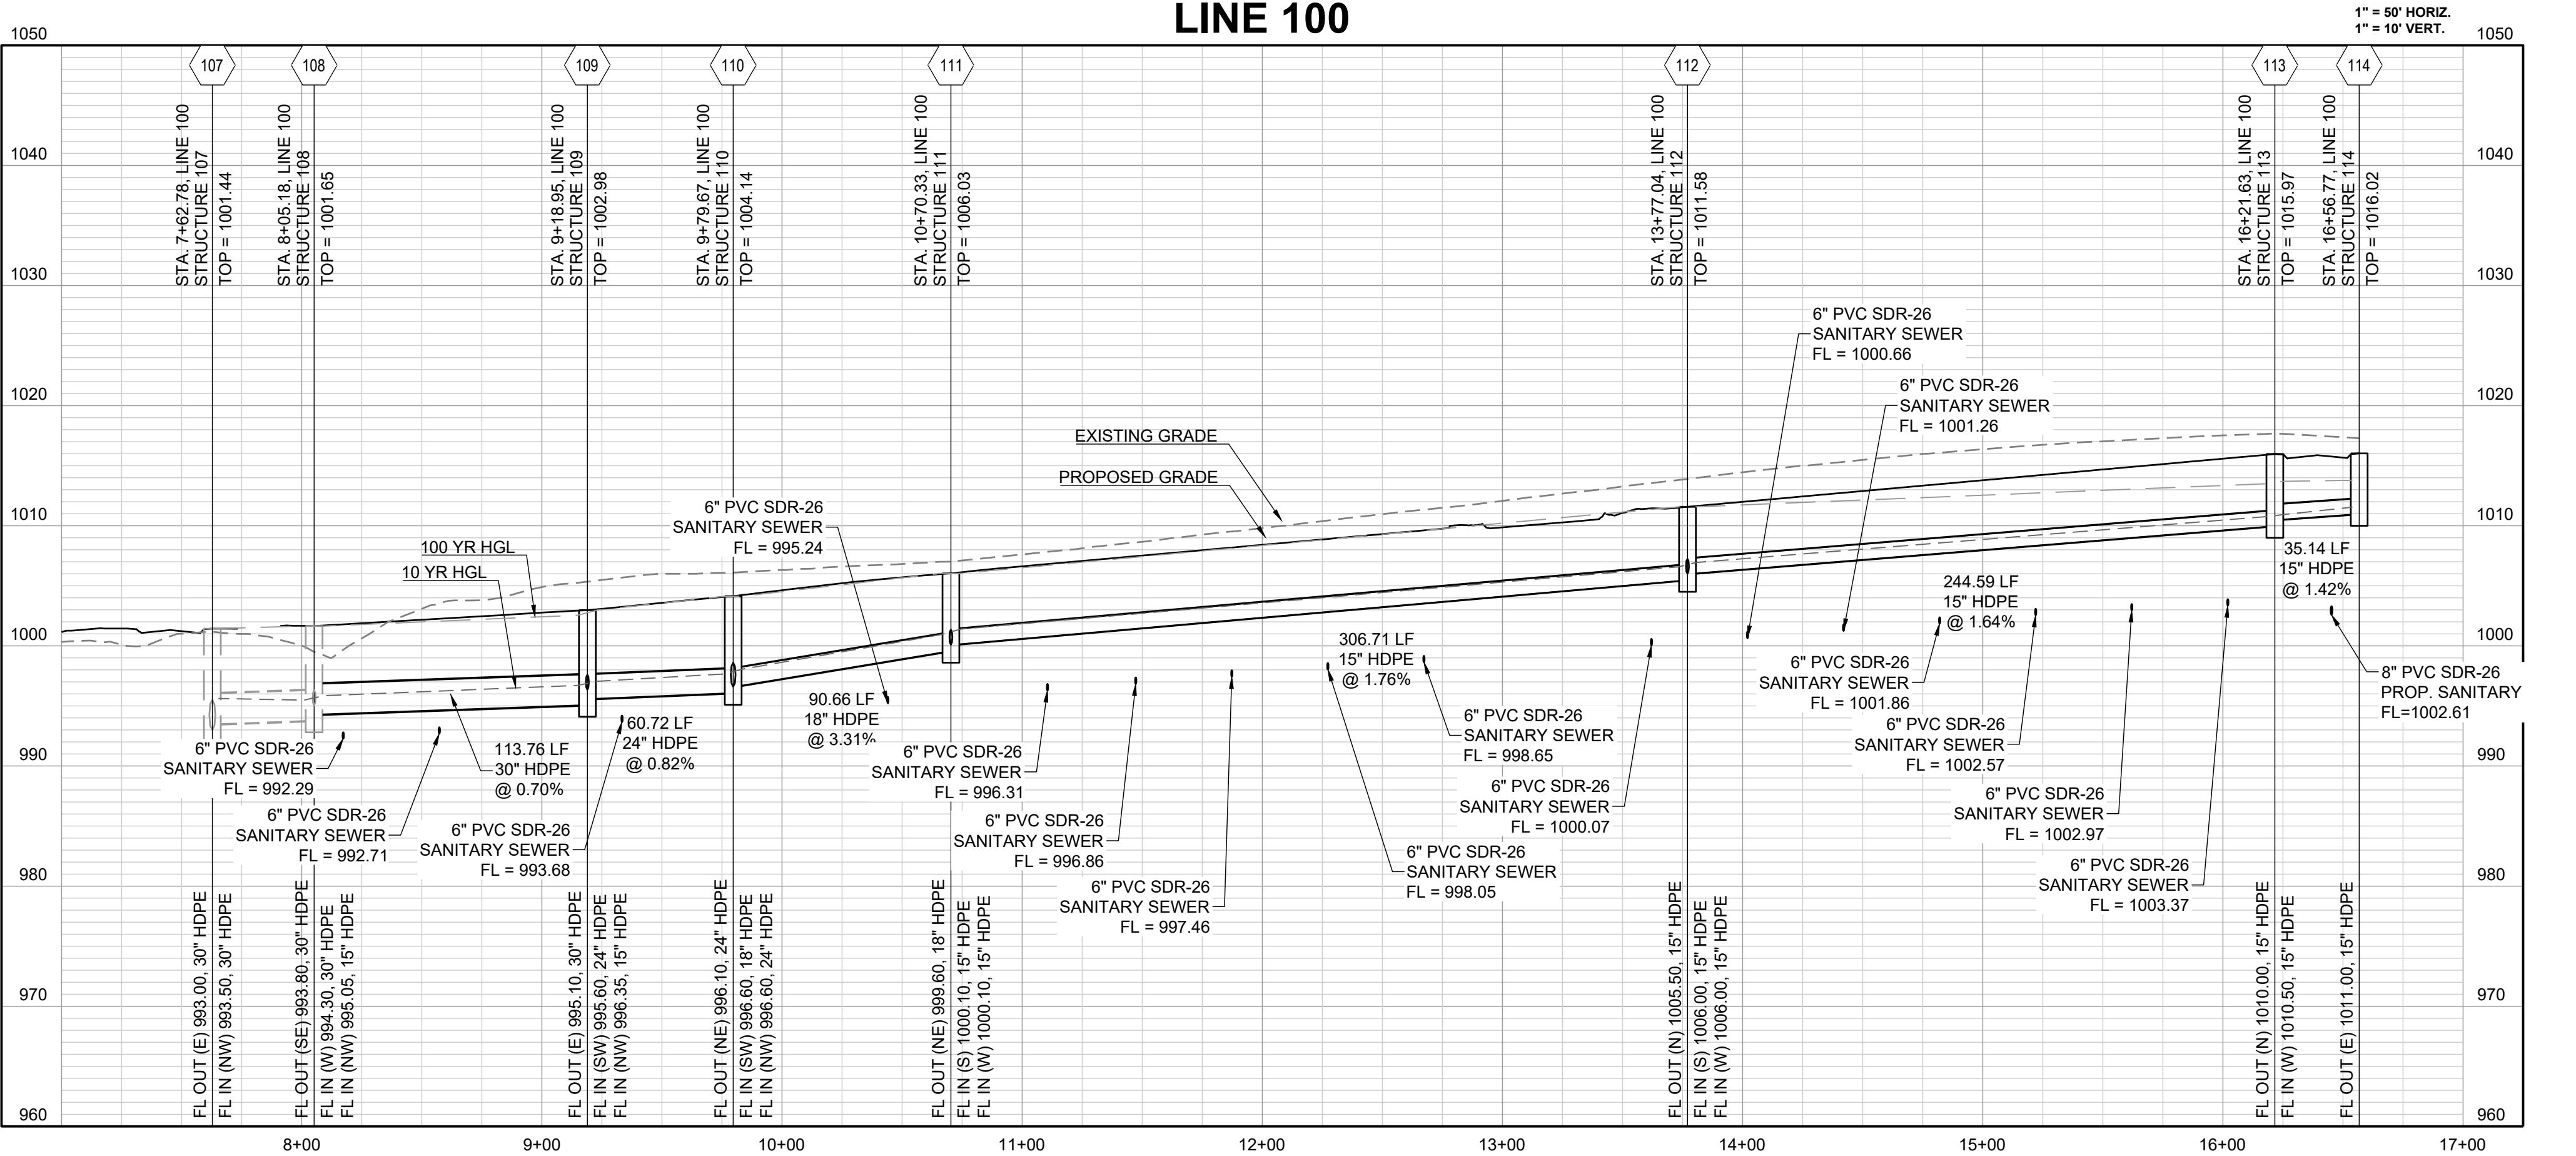
**BLACKWELL RESERVE
 STREET AND STORM SEWER PLANS**

SE SHENANDOAH DRIVE LEE'S SUMMIT, MO



DRAWN BY:	REVISION DATE	DESCRIPTION											
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TRC	09/05/2023												
	09/21/2023												
	09/06/2023												
MAB													
DATE PREPARED													
09/05/2023													
PROJ. NUMBER:													
22-093													

STORM CALCS	SHEET											
	23											

RUNOFF CALCULATIONS												INLET DESIGN						GUTTER DESIGN				
INLET #	COMPOSITE "C"	AREA	Tc	INLET INTENSITY	RUNOFF	UPSTREAM INLET	UPSTREAM INLET	UPSTREAM INLET	BYPASS FROM UPSTREAM INLET	TOTAL RUNOFF	STREET GRADE	STREET CROSS SLOPE	CURB TYPE	INLET LENGTH	EFFECTIVE LENGTH 80% CAP	INLET INTERCEPTION	BYPASS TO DOWNTSTREAM INLET	STREET GRADE	STREET CROSS SLOPE	DEPTH AT CURB	SPREAD OF FLOW	
LINE 1																						
101	0.66	0.61	5	7.35	2.96	302	401			1.31	4.27	SUMP	2.00	A	6	4.8	13.44	0.00	SUMP	2.00	< 0.21	< 12
102	0.66	0.40	5	7.35	1.94	103	301			0.82	2.76	SUMP	2.00	A	6	4.8	13.44	0.00	SUMP	2.00	< 0.21	< 12
103	0.66	0.37	5	7.35	1.79	104				0.23	2.03	1.20	2.00	A	6	6	1.81	0.22	1.20	2.00	0.18	9.27
104	0.66	0.22	5	7.35	1.07	501	502			1.02	2.08	1.20	2.00	A	6	6	1.85	0.23	1.20	2.00	0.18	9.36
105	0.66	0.11	5	7.35	0.53	106	107	108		0.86	1.39	1.20	2.00	A	6	6	1.29	0.10	1.20	2.00	0.15	8.11
106	0.66	0.18	5	7.35	0.87	701				0.12	1.00	1.20	2.00	A	6	6	0.95	0.05	1.20	2.00	0.13	7.22
107	0.66	0.64	5	7.35	3.10	1401				0.68	3.78	1.20	2.00	A	6	6	3.00	0.77	1.20	2.00	0.22	11.57
108	0.66	0.18	5	7.35	0.87	109				0.02	0.89	1.20	2.00	A	6	6	0.85	0.03	1.20	2.00	0.13	6.93
109	0.66	0.12	5	7.35	0.58	110				0.08	0.66	1.21	2.00	A	6	6	0.64	0.02	1.21	2.00	0.11	6.25
110	0.66	0.11	5	7.35	0.53	111				0.58	1.11	1.66	2.00	A	6	6	1.03	0.08	1.66	2.00	0.13	7.08
111	0.66	0.53	5	7.35	2.57	112				0.34	2.91	1.66	2.00	A	6	6	2.33	0.58	1.66	2.00	0.19	9.94
112	0.66	0.42	5	7.35	2.04	113				0.18	2.22	1.66	2.00	A	6	6	1.88	0.34	1.66	2.00	0.17	9.03
113	0.66	0.34	5	7.35	1.65					0.00	1.65	1.66	2.00	A	6	6	1.47	0.18	1.66	2.00	0.15	8.13
114	0.66	0.39	5	7.35	1.89					0.00	1.89	1.64	2.00	A	6	6	1.65	0.24	1.64	2.00	0.16	8.55
LINE 3																						
301	0.66	0.52	5	7.35	2.52					0.00	2.52	2.70	2.00	A	6	6	1.92	0.60	2.70	2.00	0.16	8.67
302	0.66	0.69	5	7.35	3.35					0.00	3.35	2.70	2.00	A	6	6	2.33	1.02	2.70	2.00	0.18	9.59
LINE 4																						
401	0.66	0.42	5	7.35	2.04	601				0.30	2.34	1.20	2.00	A	6	6	2.04	0.30	1.20	2.00	0.18	9.75
LINE 5																						
501	0.66	0.43	5	7.35	2.09					0.00	2.09	1.09	2.00	A	6	6	1.87	0.22	1.09	2.00	0.18	9.52
502	0.66	0.71	5	7.35	3.44	702				0.52	3.97	1.09	2.00	A	6	6	3.17	0.80	1.09	2.00	0.23	11.98
LINE 6																						
601	0.66	0.43	5	7.35	2.09	801				0.27	2.35	1.20	2.00	A	6	6	2.05	0.30	1.20	2.00	0.19	9.77
LINE 7																						
701	0.66	0.32	5	7.35	1.55					0.00	1.55</											



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SCHLAGEL
ENGINEERS PLANNERS SURVEYORS LANDSCAPE ARCHITECTS
14920 West 107th Street Lenexa Kansas 66215
(913) 492-5158 • Fax: (913) 492-3400
WWW.SCHLAGELASSOCIATES.COM
Mark Allen Dreuer PE#2009007268
#E2020038005 F BLAC201000237 AL2020038859-F
09.06.2023

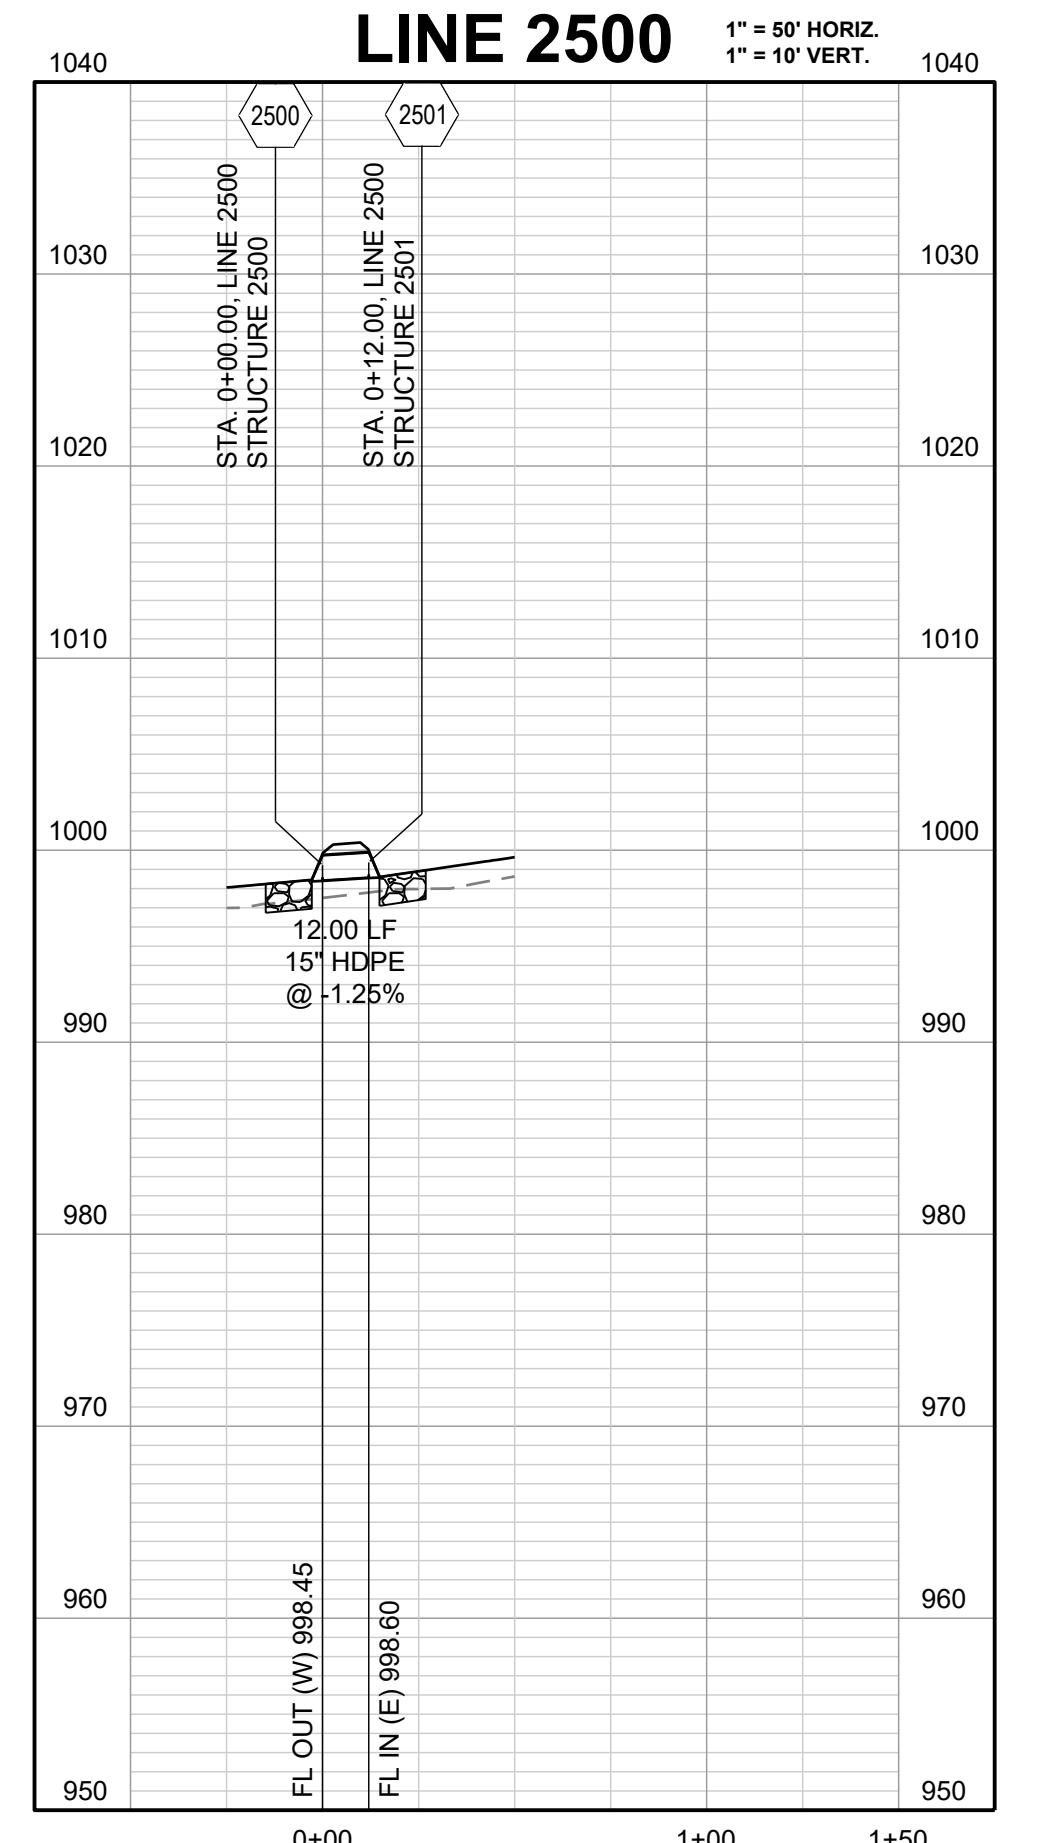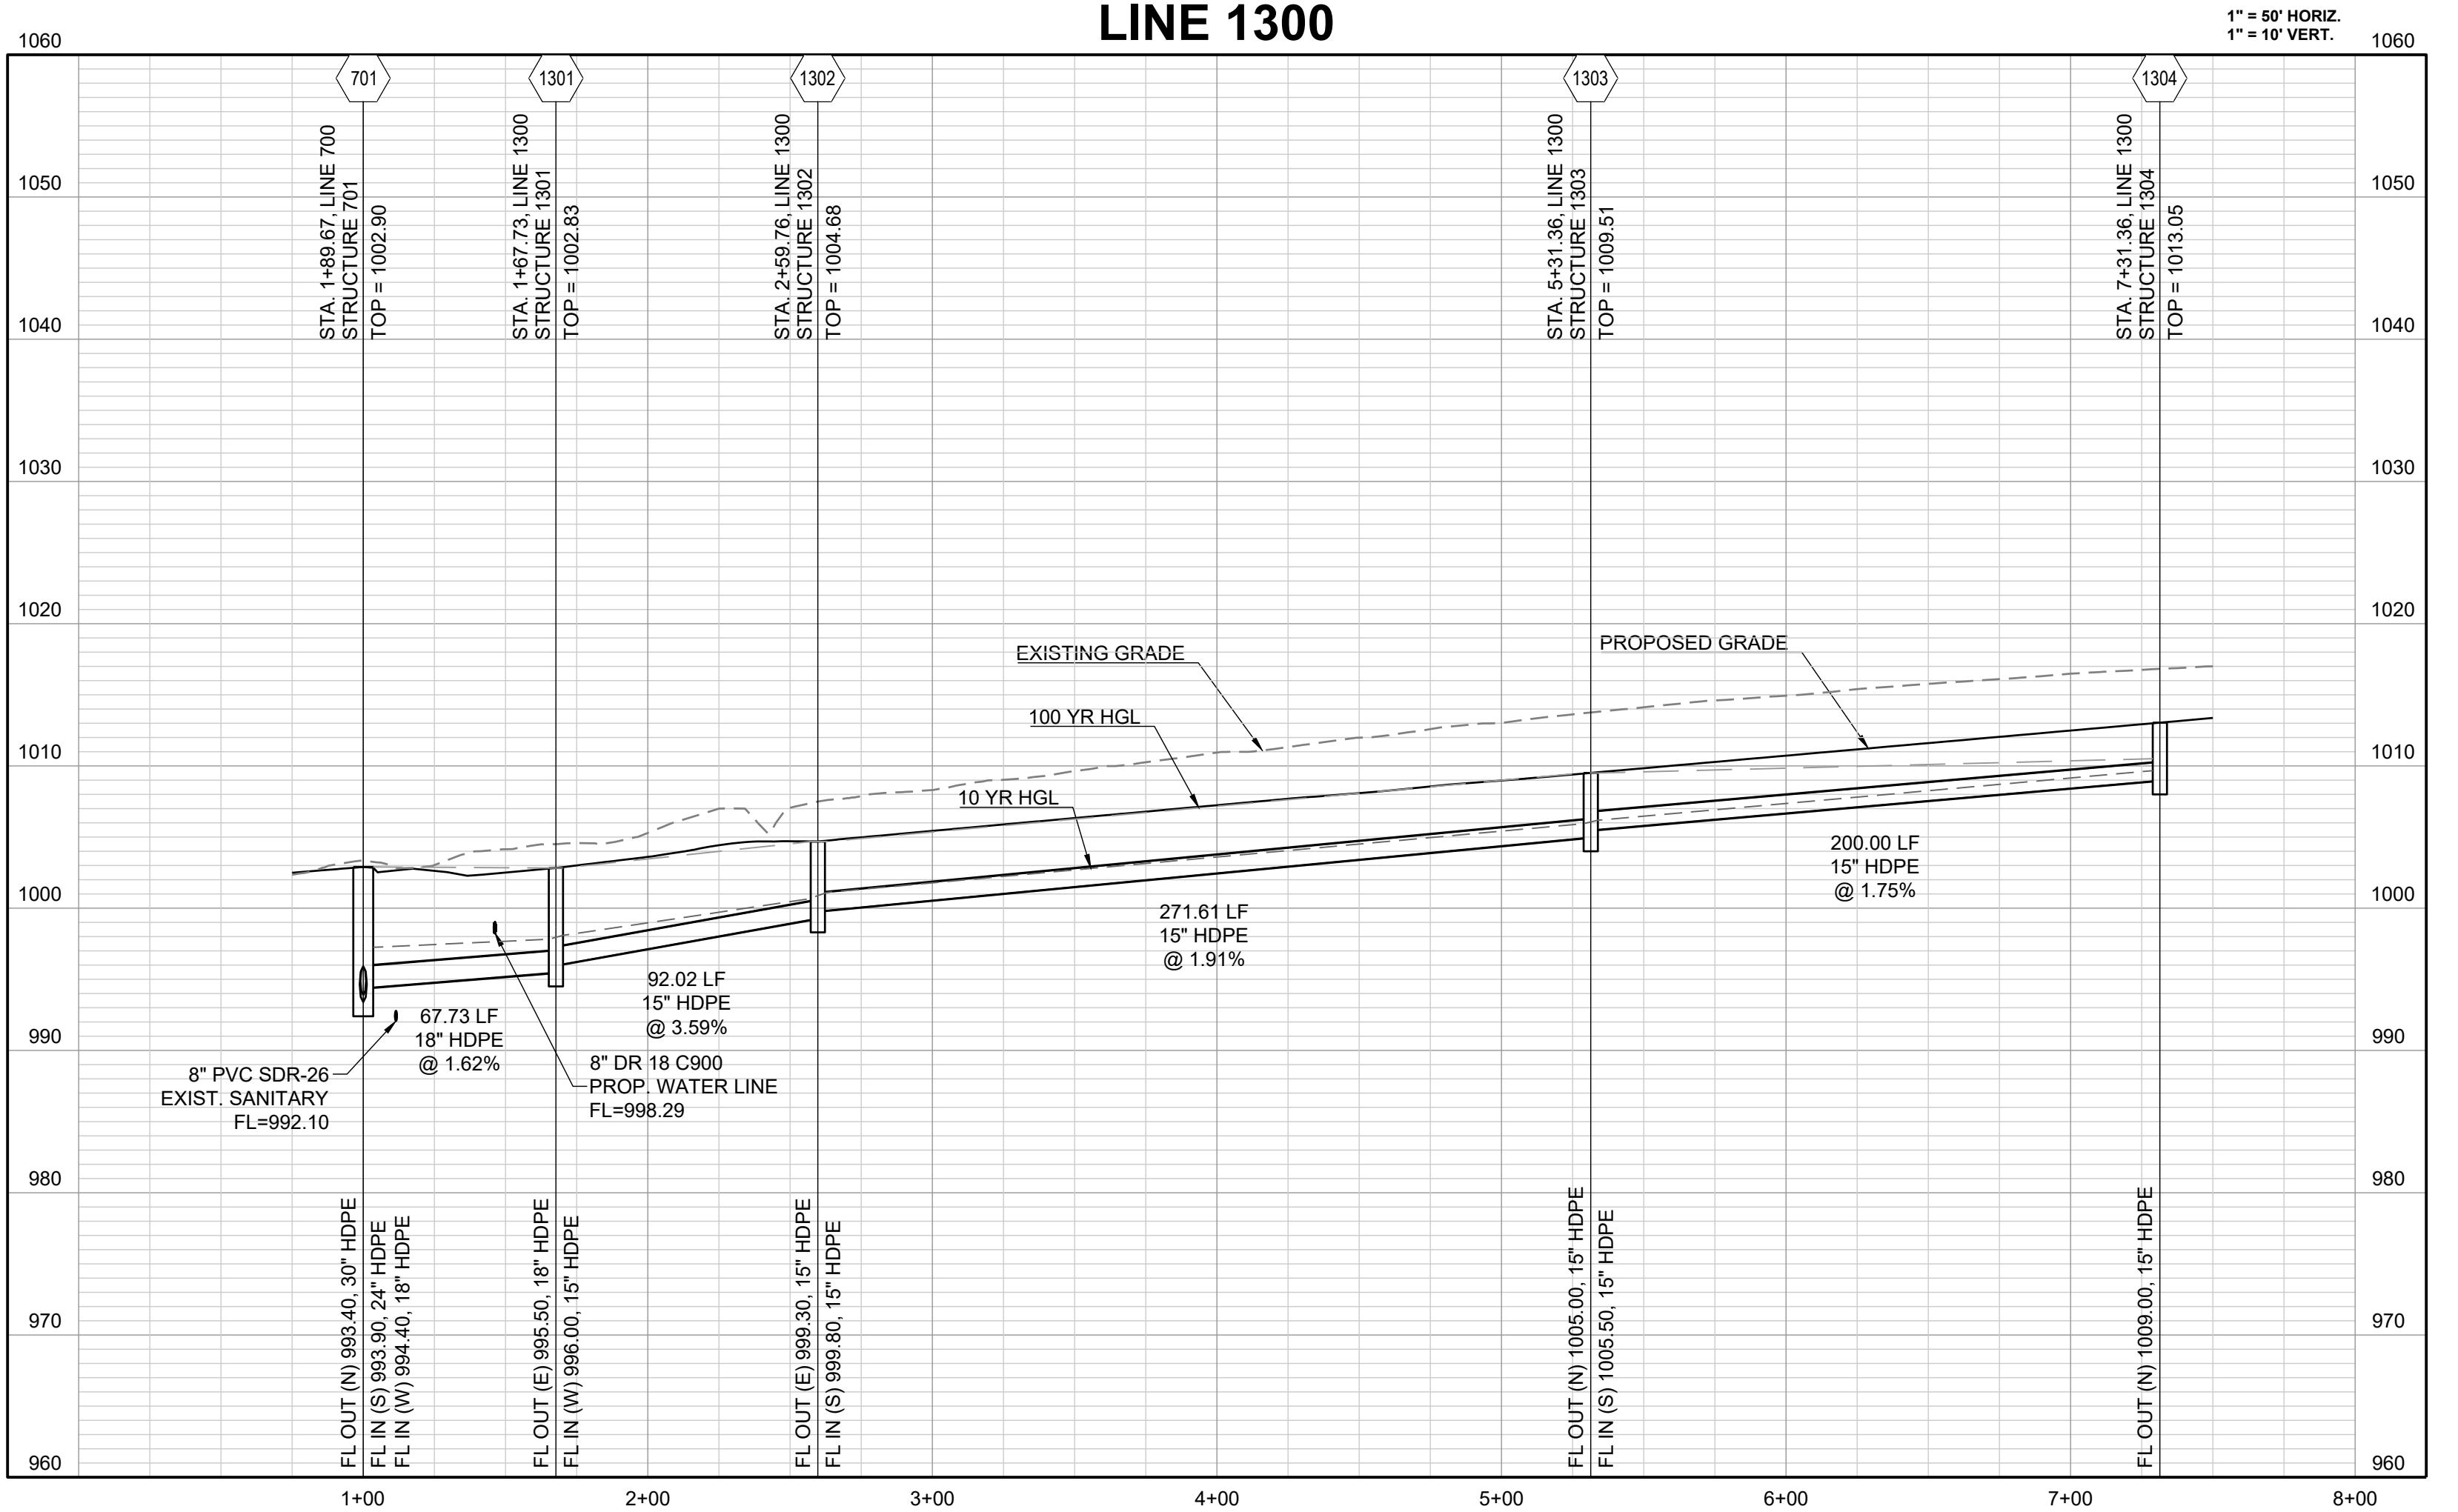PREPARED BY:

SCHLAGEL & ASSOCIATES, P.A.

**BLACKWELL RESERVE
STREET AND STORM SEWER PLANS**
SE SHENANDOAH DRIVE LEE'S SUMMIT, MO

SHEET	DRAWN BY: TRC	REVISION DATE 09/05/2023	DESCRIPTION	
			PER CITY COMMENTS 09/27/2023	PER CITY COMMENTS 09/05/2023
	CHECKED BY: MAB			
	DATE PREPARED: 09/05/2023			
	PROJ. NUMBER: 22-093			







MARK ALLEN BREUER
NUMBER PE-2009007268
PROFESSIONAL ENGINEER
09.06.2023

SCHLAGEL & ASSOCIATES, P.A.

SE SHENANDOAH DRIVE LEE'S SUMMIT, MO


STORM DETAILS	
DRAWN BY:	REVISION DATE
TRC	09/21/2023
CHECKED BY:	PER CITY COMMENTS
MAB	09/21/2023
DATE PREPARED	PER CITY COMMENTS
09/21/2023	PER CITY COMMENTS
PROJ. NUMBER:	9
22-093	

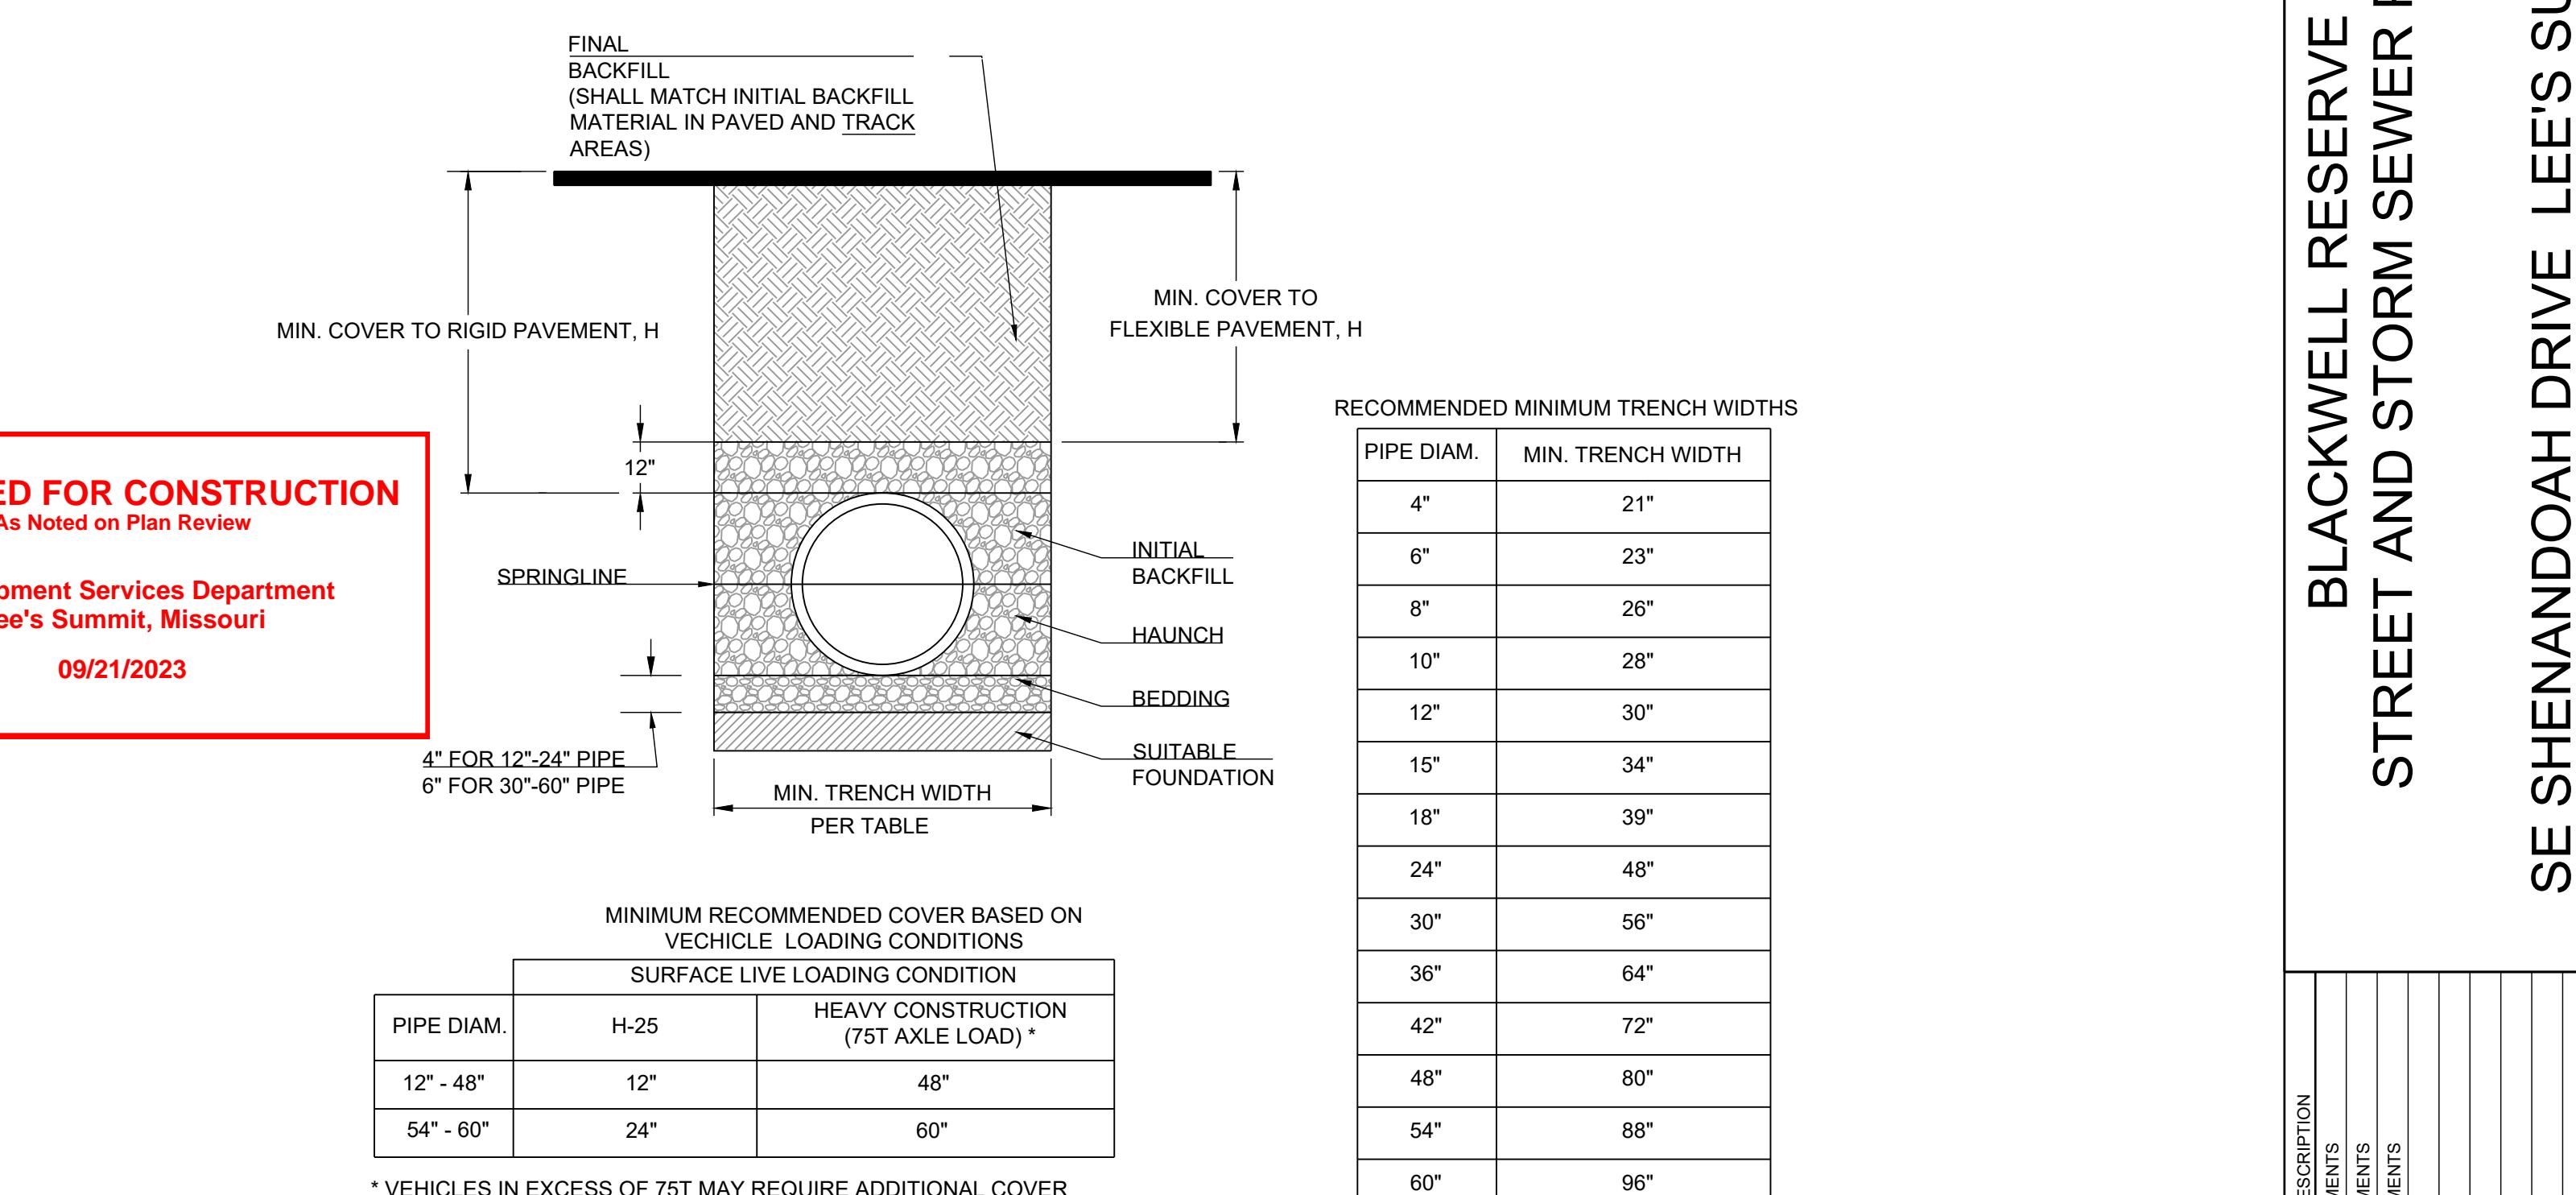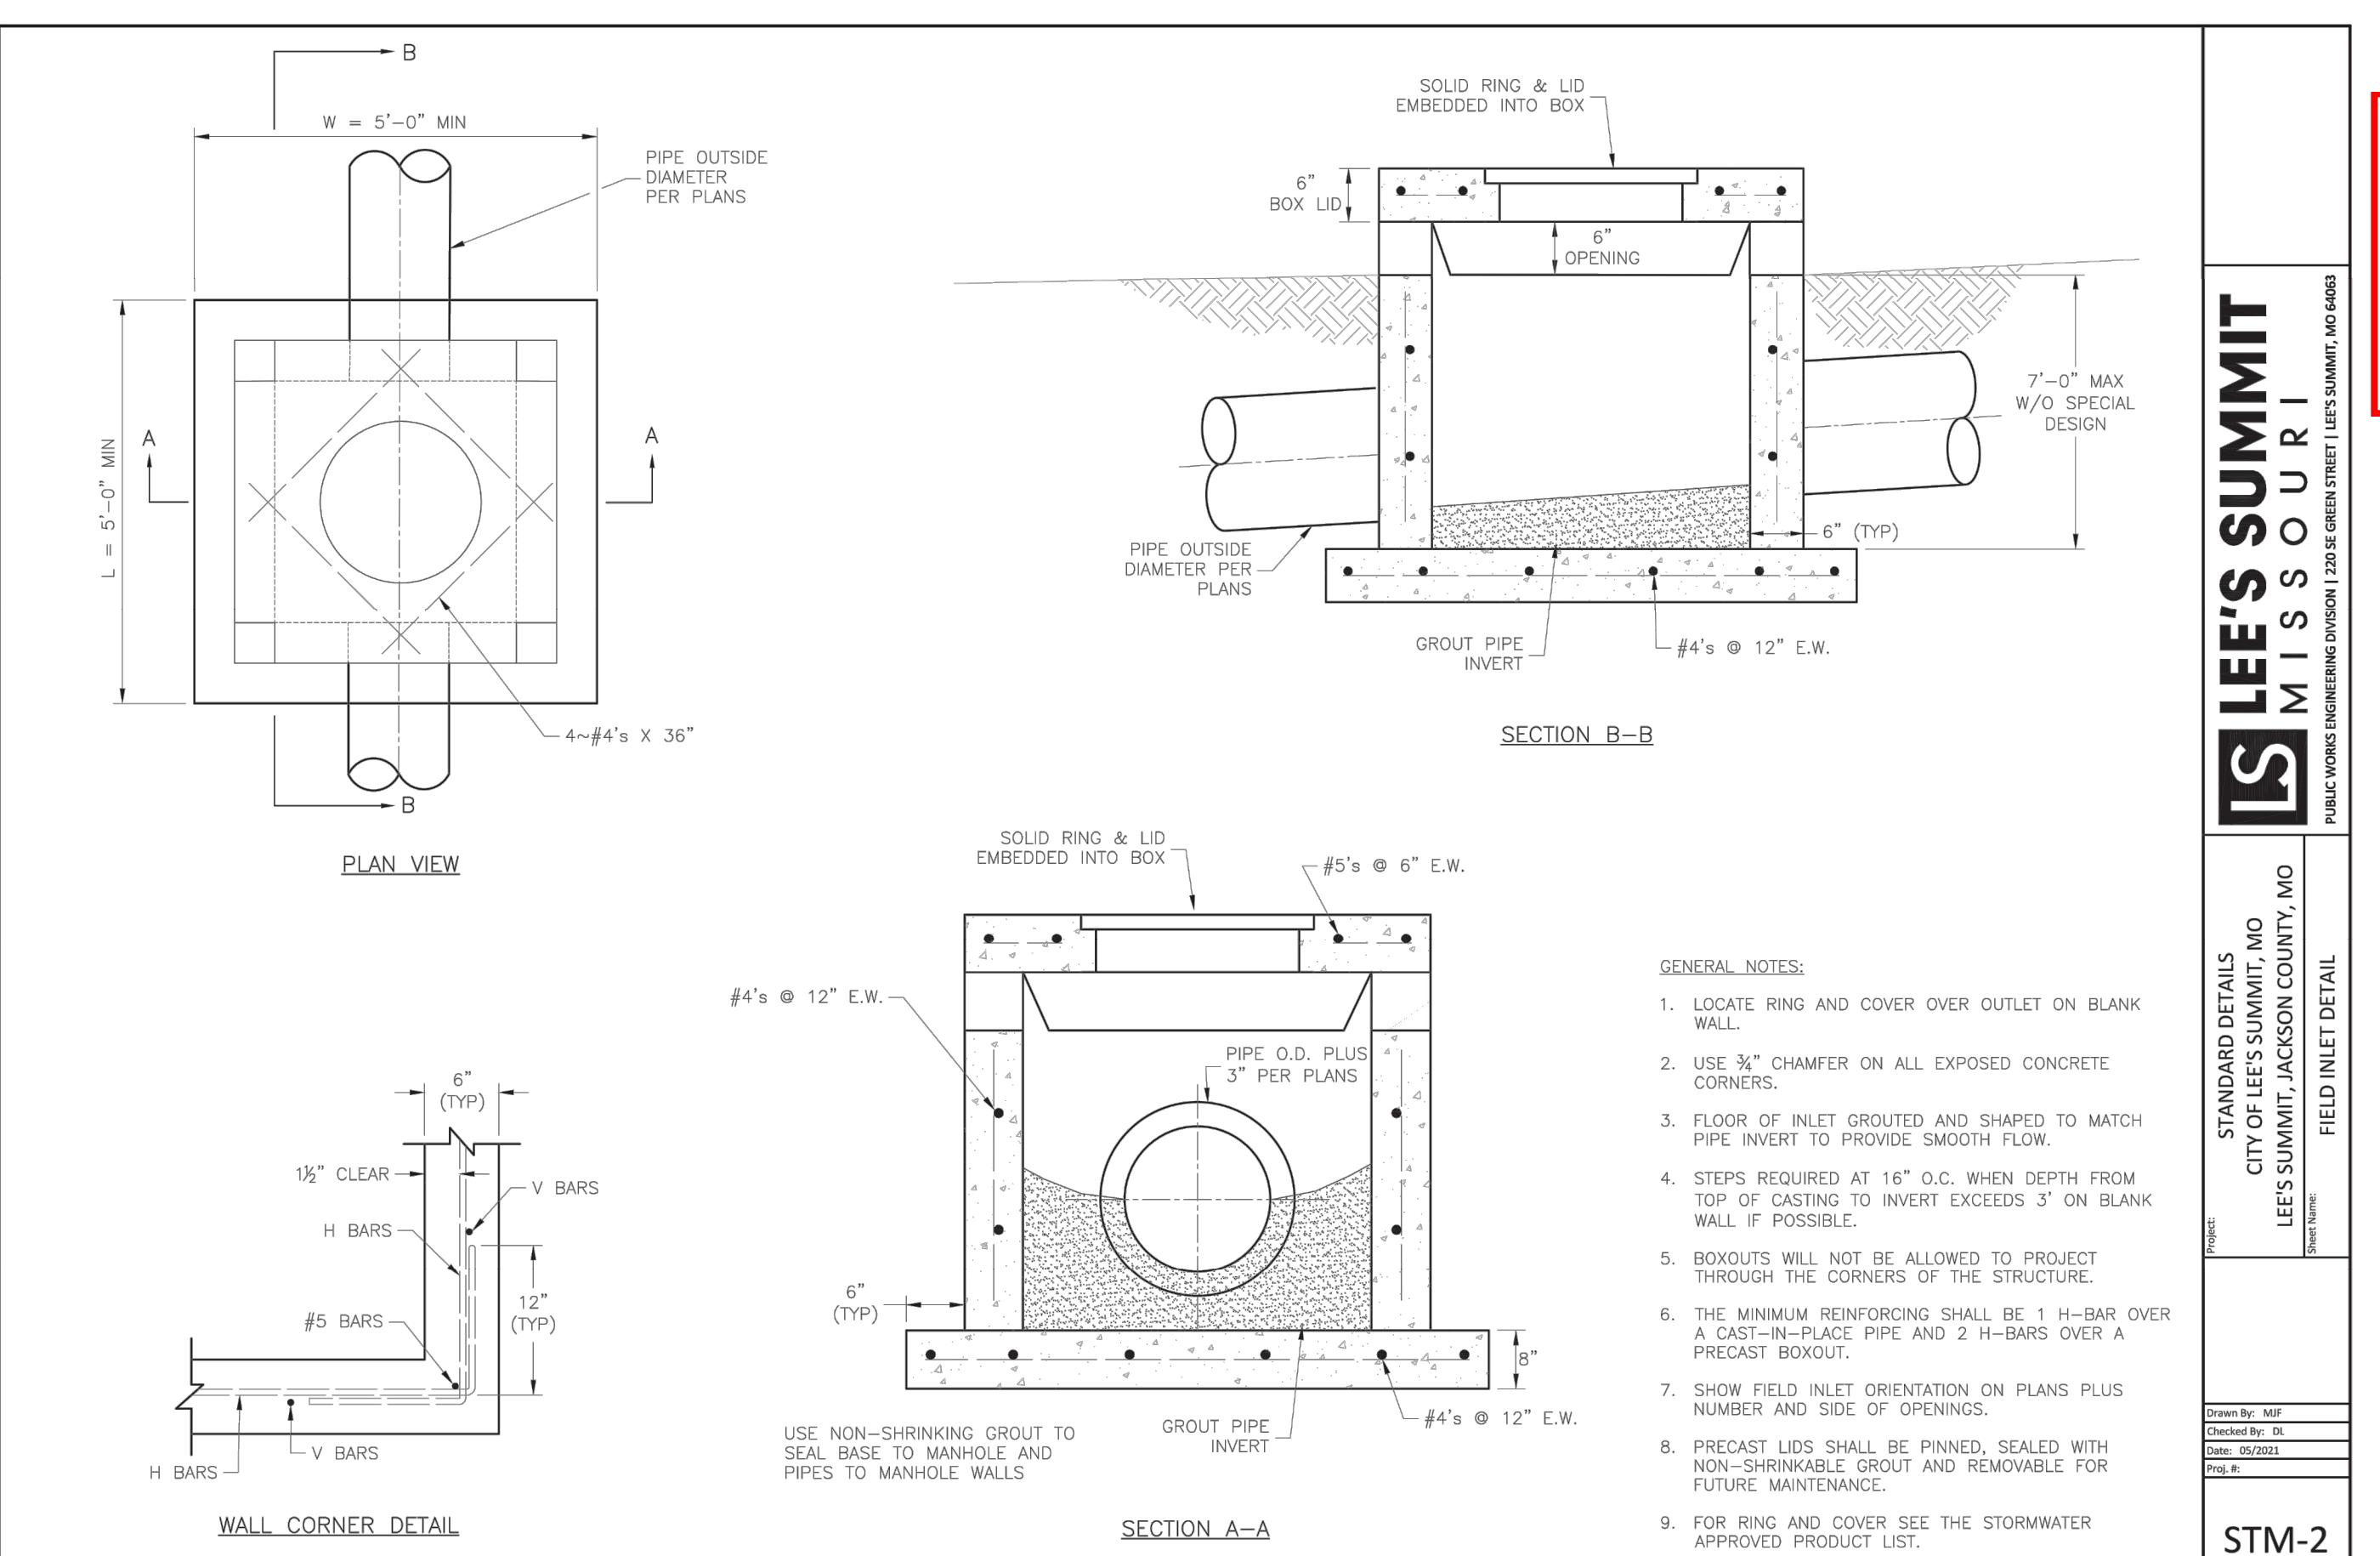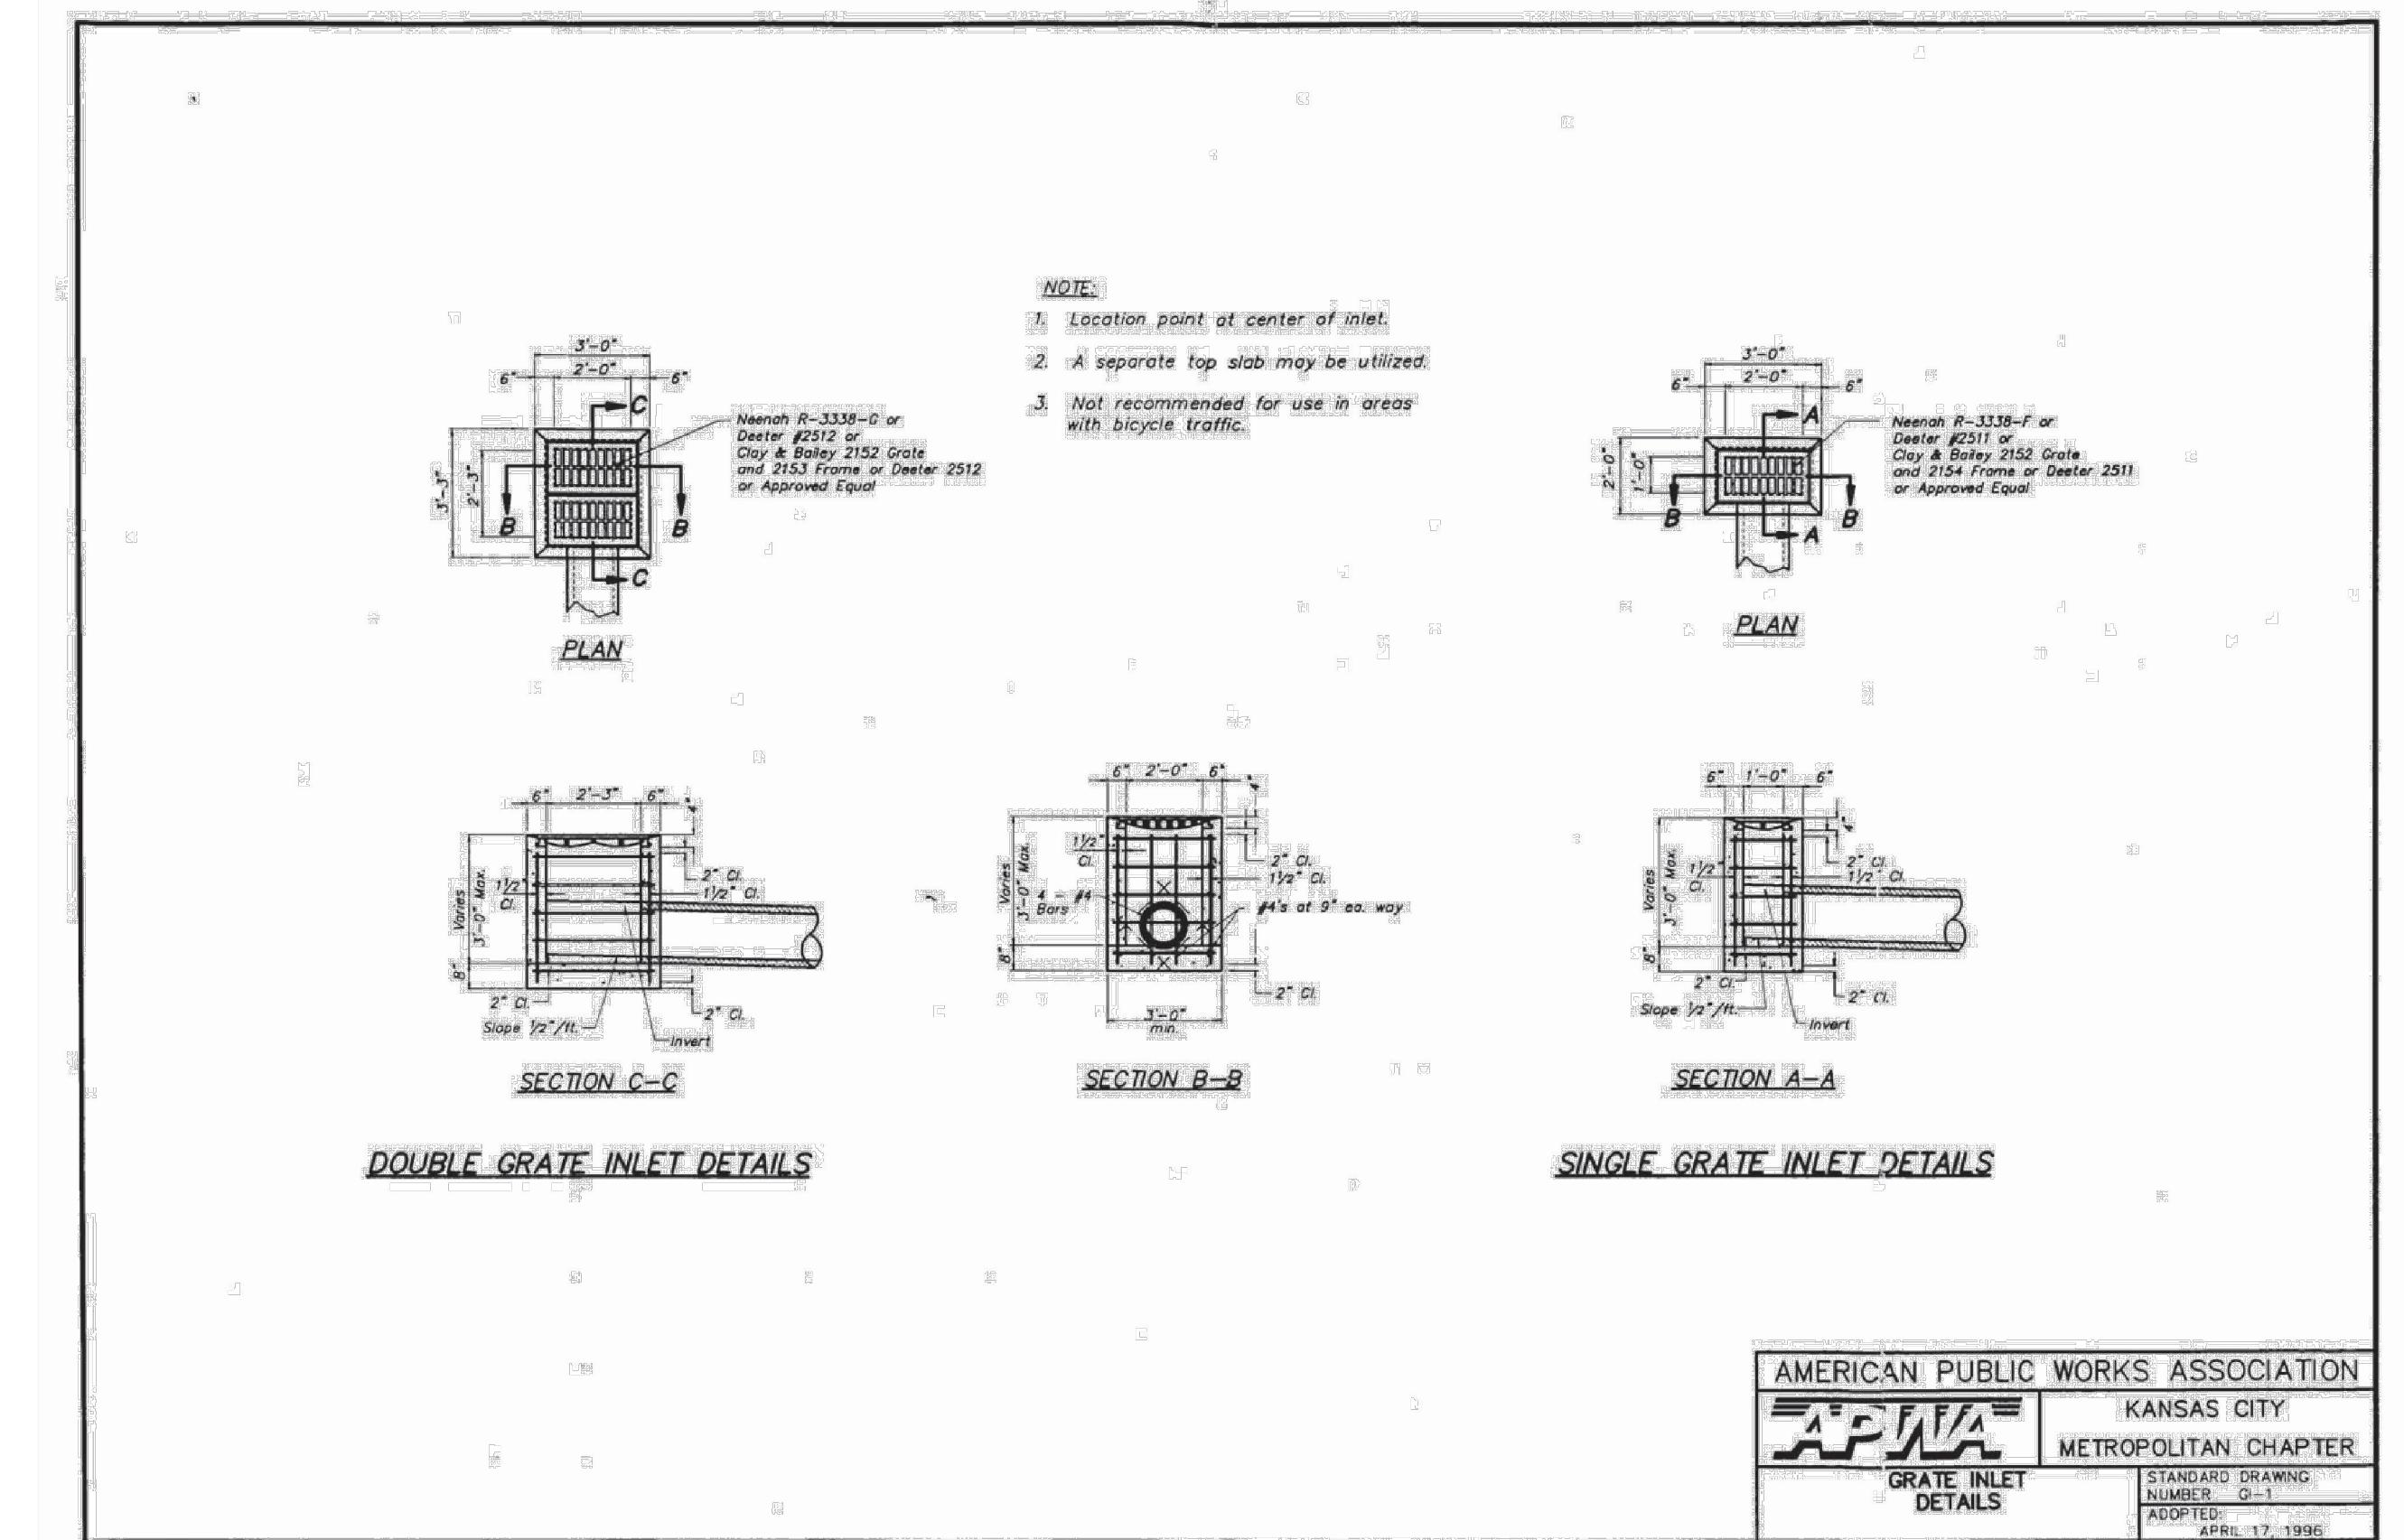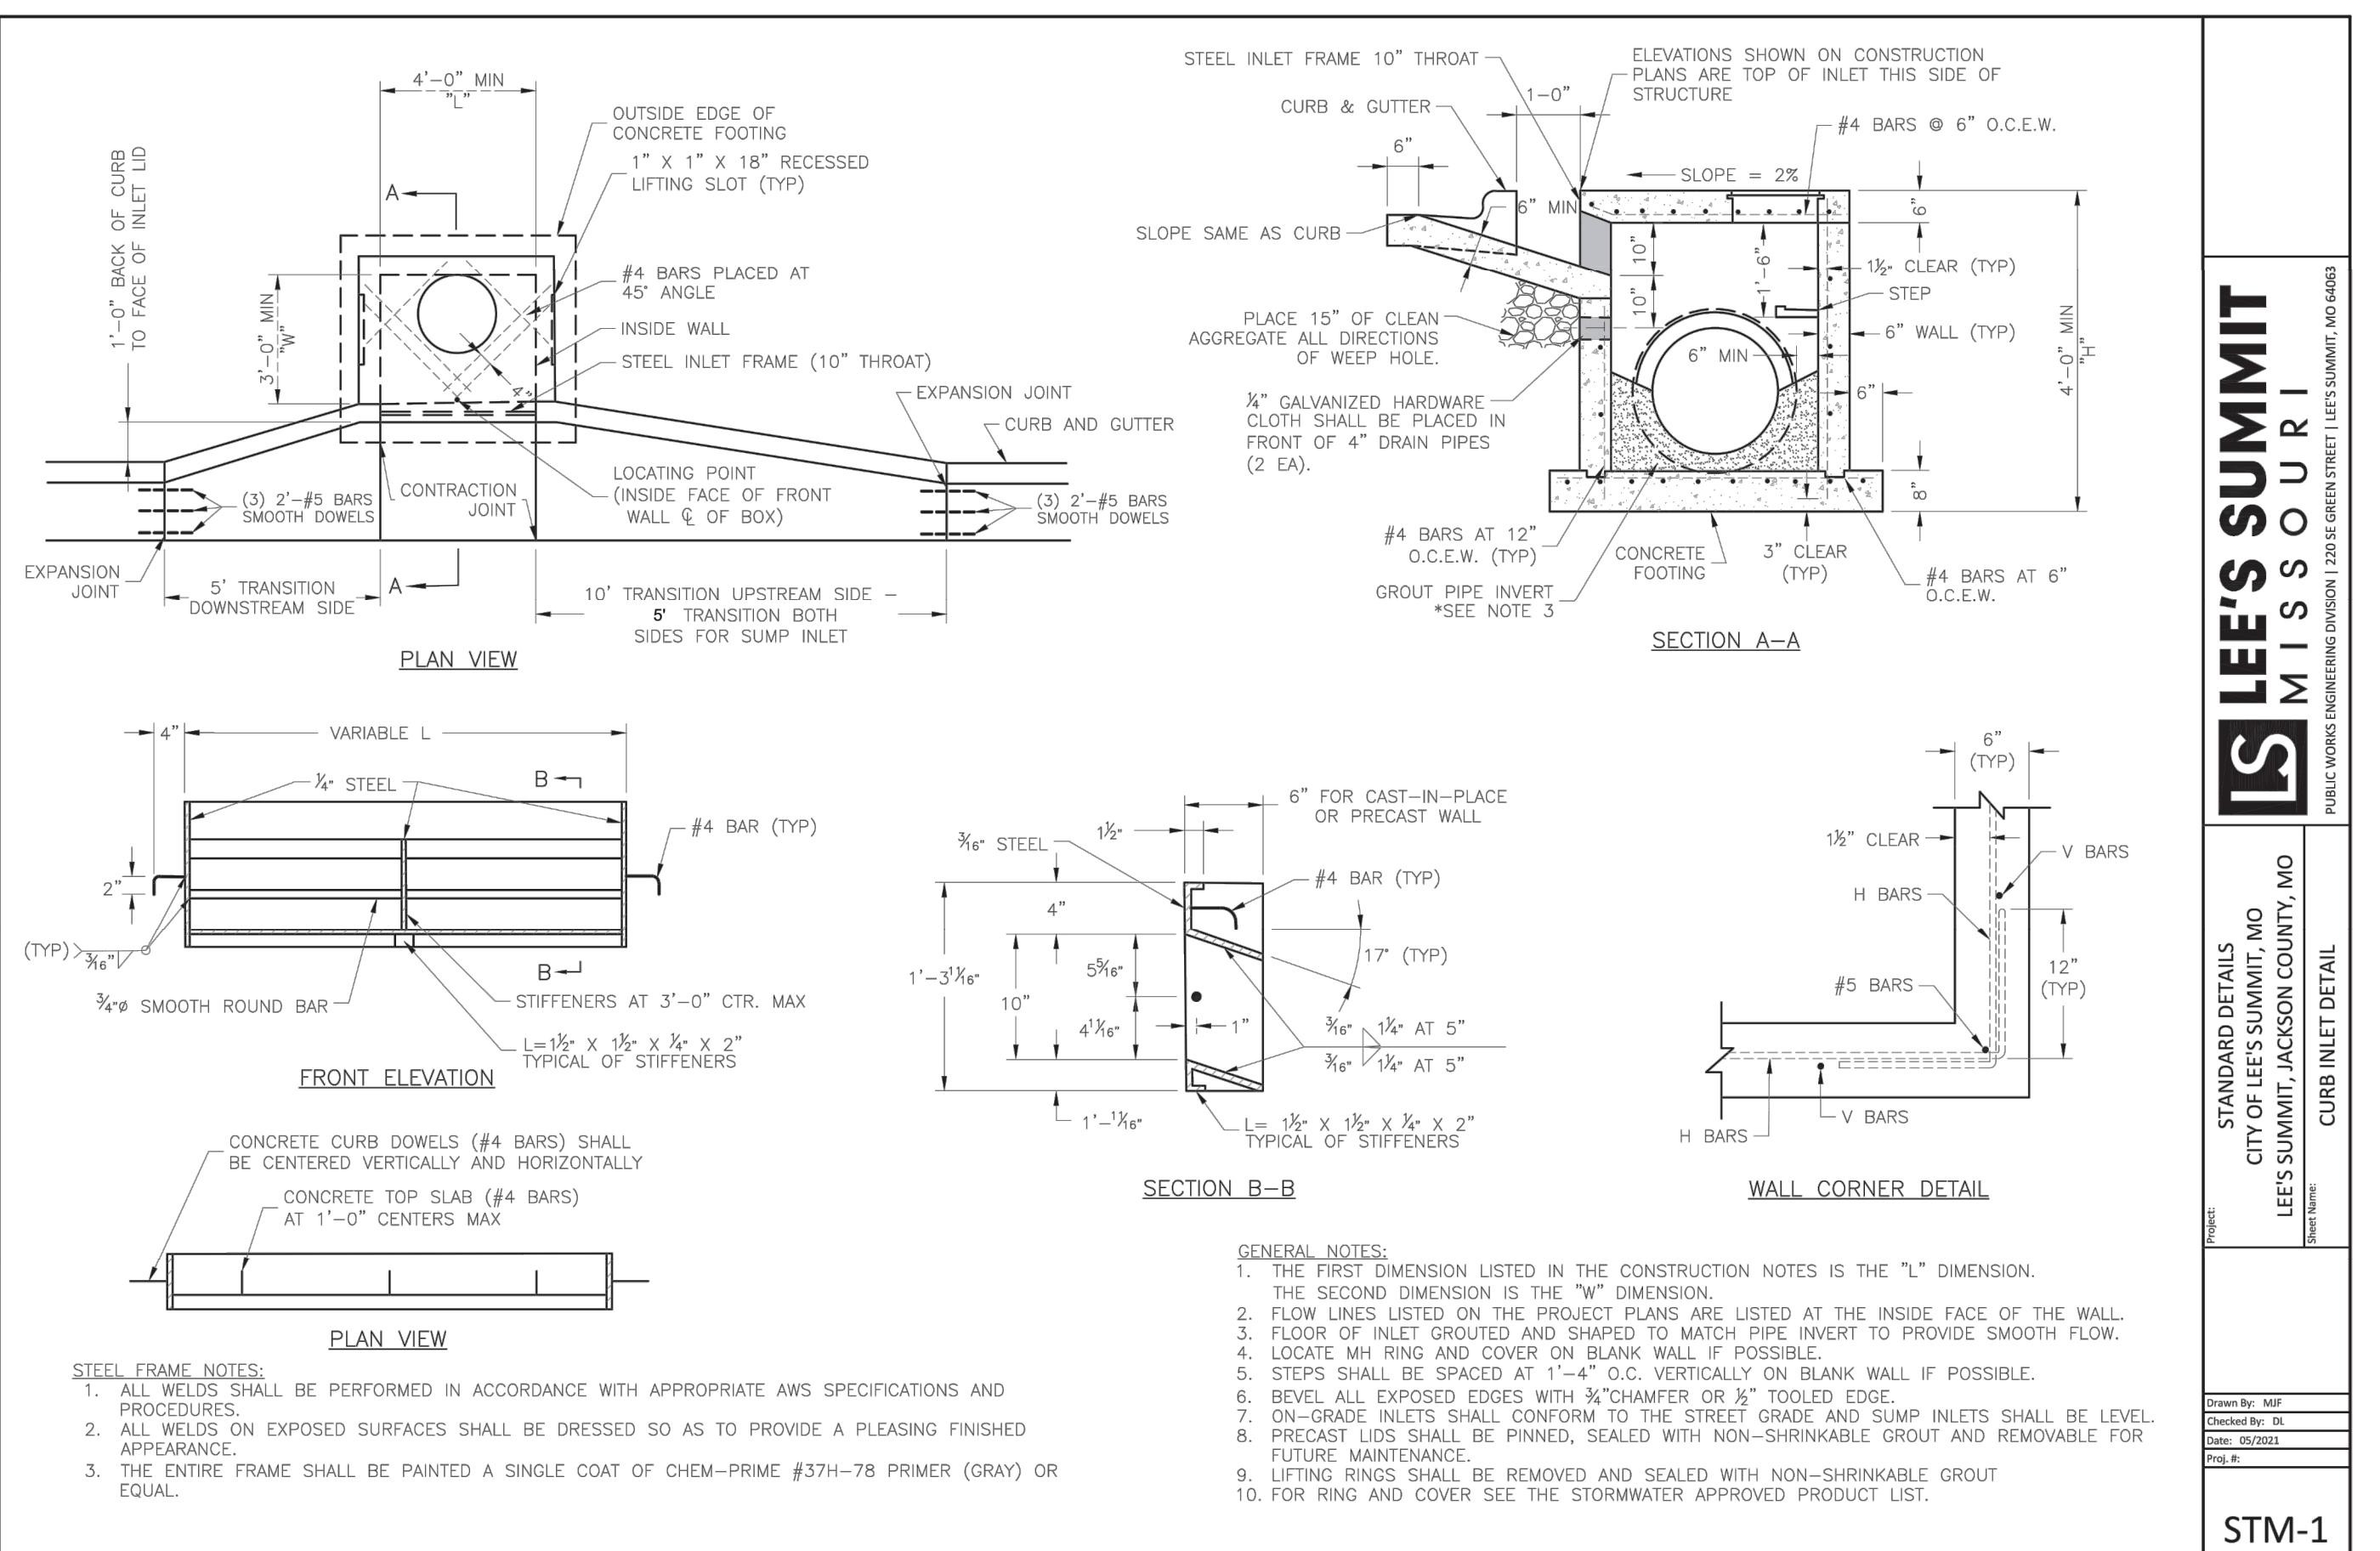

NOTES:

- ALL PIPE SYSTEMS SHALL BE INSTALLED IN ACCORDANCE WITH ASTM D2321, "STANDARD PRACTICE FOR UNDERGROUND INSTALLATION OF THERMOPLASTIC PIPE FOR SEWERS AND OTHER GRAVITY FLOW APPLICATIONS", LATEST EDITION
- MEASURES SHOULD BE TAKEN TO PREVENT MIGRATION OF NATIVE FINES INTO BACKFILL MATERIAL, WHEN REQUIRED.
- FOUNDATION: WHERE THE TRENCH BOTTOM IS UNSTABLE, THE CONTRACTOR SHALL EXCAVATE TO A DEPTH REQUIRED BY THE ENGINEER AND REPLACE WITH SUITABLE MATERIAL AS SPECIFIED BY THE ENGINEER, AS AN ALTERNATIVE AND AT THE DISCRETION OF THE DESIGN ENGINEER, THE TRENCH BOTTOM MAY BE STABILIZED USING A GEOTEXTILE MATERIAL.
- BEDDING: SUITABLE MATERIAL SHALL BE CLASS I, II OR III. THE CONTRACTOR SHALL PROVIDE DOCUMENTATION FOR MATERIAL SPECIFICATION TO ENGINEER, UNLESS OTHERWISE NOTED BY THE ENGINEER, MINIMUM BEDDING THICKNESS SHALL BE 4" (100mm) FOR 4"-24" (100mm-600mm); 6" (150mm) FOR 30"-60" (750mm-900mm).
- INITIAL BACKFILL: SUITABLE MATERIAL SHALL BE CLASS I, II OR III IN THE PIPE ZONE EXTENDING NOT LESS THAN 6" ABOVE CROWN OF PIPE. THE CONTRACTOR SHALL PROVIDE DOCUMENTATION FOR MATERIAL SPECIFICATION TO ENGINEER. MATERIAL SHALL BE INSTALLED AS REQUIRED IN ASTM D2321, LATEST EDITION.
- MINIMUM COVER: MINIMUM COVER, H, IN NON-TRAFFIC APPLICATIONS (GRASS OR LANDSCAPE AREAS) IS 12" FROM THE TOP OF PIPE TO GROUND SURFACE. ADDITIONAL COVER MAY BE REQUIRED TO PREVENT FLOATATION. FOR TRAFFIC APPLICATIONS, MINIMUM COVER, H, IS 12" UP TO 48" DIAMETER PIPE AND 24" OF COVER FOR 54"-60" DIAMETER PIPE, MEASURED FROM TOP OF PIPE TO BOTTOM OF FLEXIBLE PAVEMENT OR TO TOP OF RIGID PAVEMENT.
- TESTING: CONTRACTOR IS RESPONSIBLE FOR THE COORDINATION OF ALL MATERIAL TESTING REQUIRED FOR THEIR WORK. THIS INCLUDES SCHEDULING OF TESTS, COORDINATING AND PROVIDING ACCESS TO SAMPLE LOCATIONS, AND SATISFYING ALL TEST RESULT REPORTING REQUIREMENTS.







PREPARED BY:

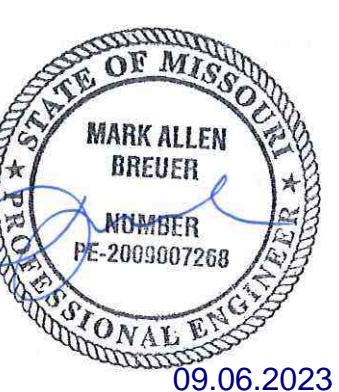


SCHLAGEL & ASSOCIATES, P.A.

**BLACKWELL RESERVE
STREET AND STORM SEWER PLANS**

STORM DETAILS	
DRAWN BY: TRC	REVISION DATE: 05/05/2023
CHECKED BY: MAB	PER CITY COMMENTS: 09/27/2023
DATE PREPARED: 09/09/2023	PER CITY COMMENTS: 09/09/2023
PROJ. NUMBER: 22-093	PER CITY COMMENTS: 09/09/2023

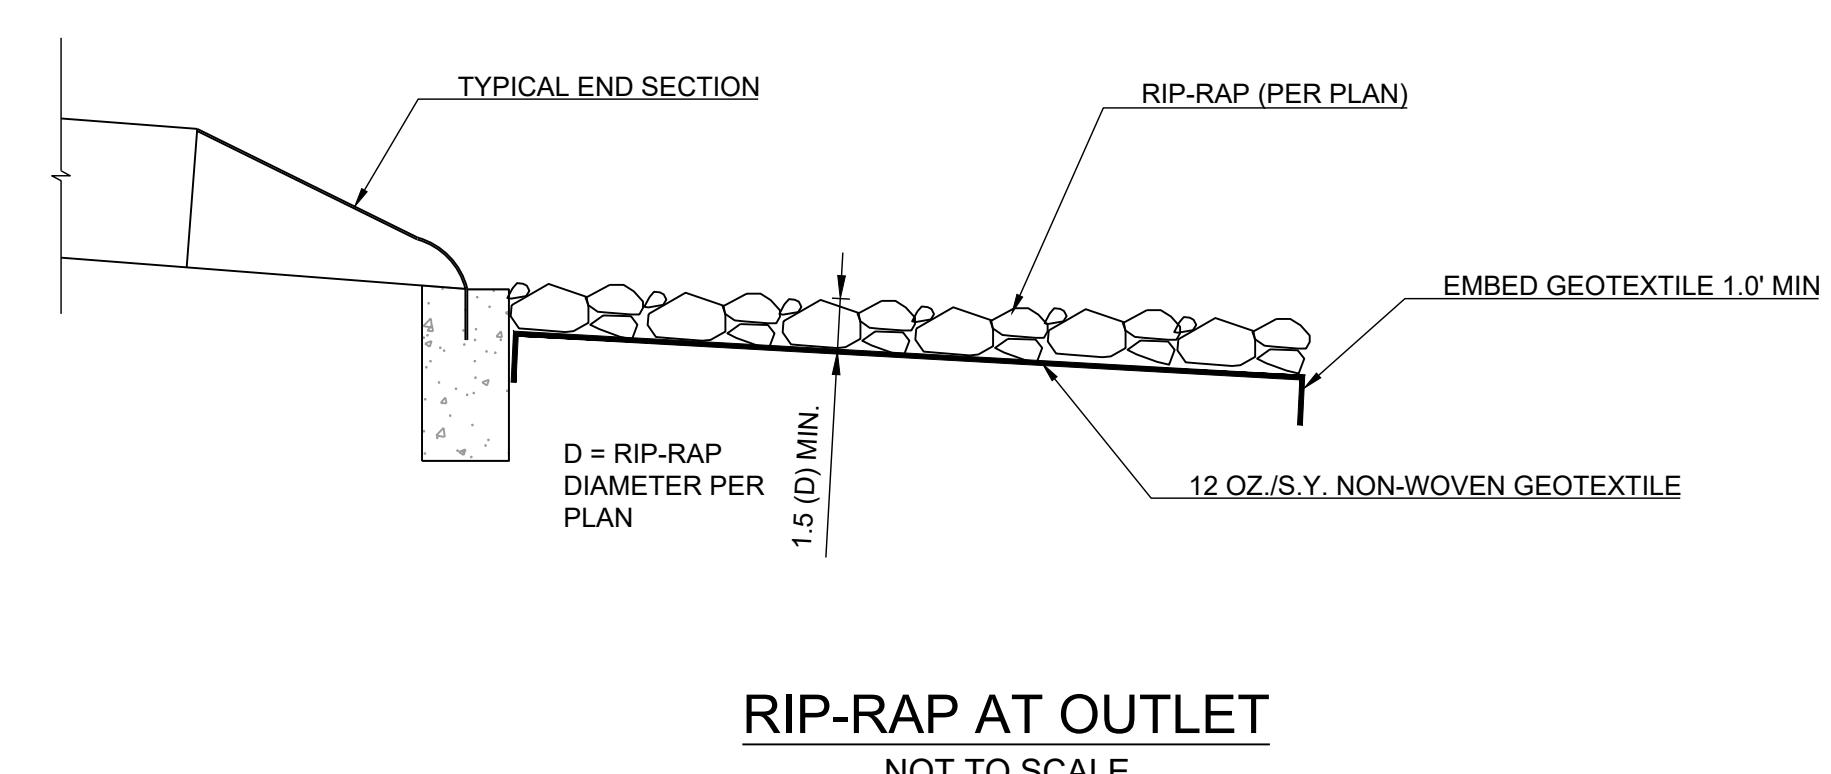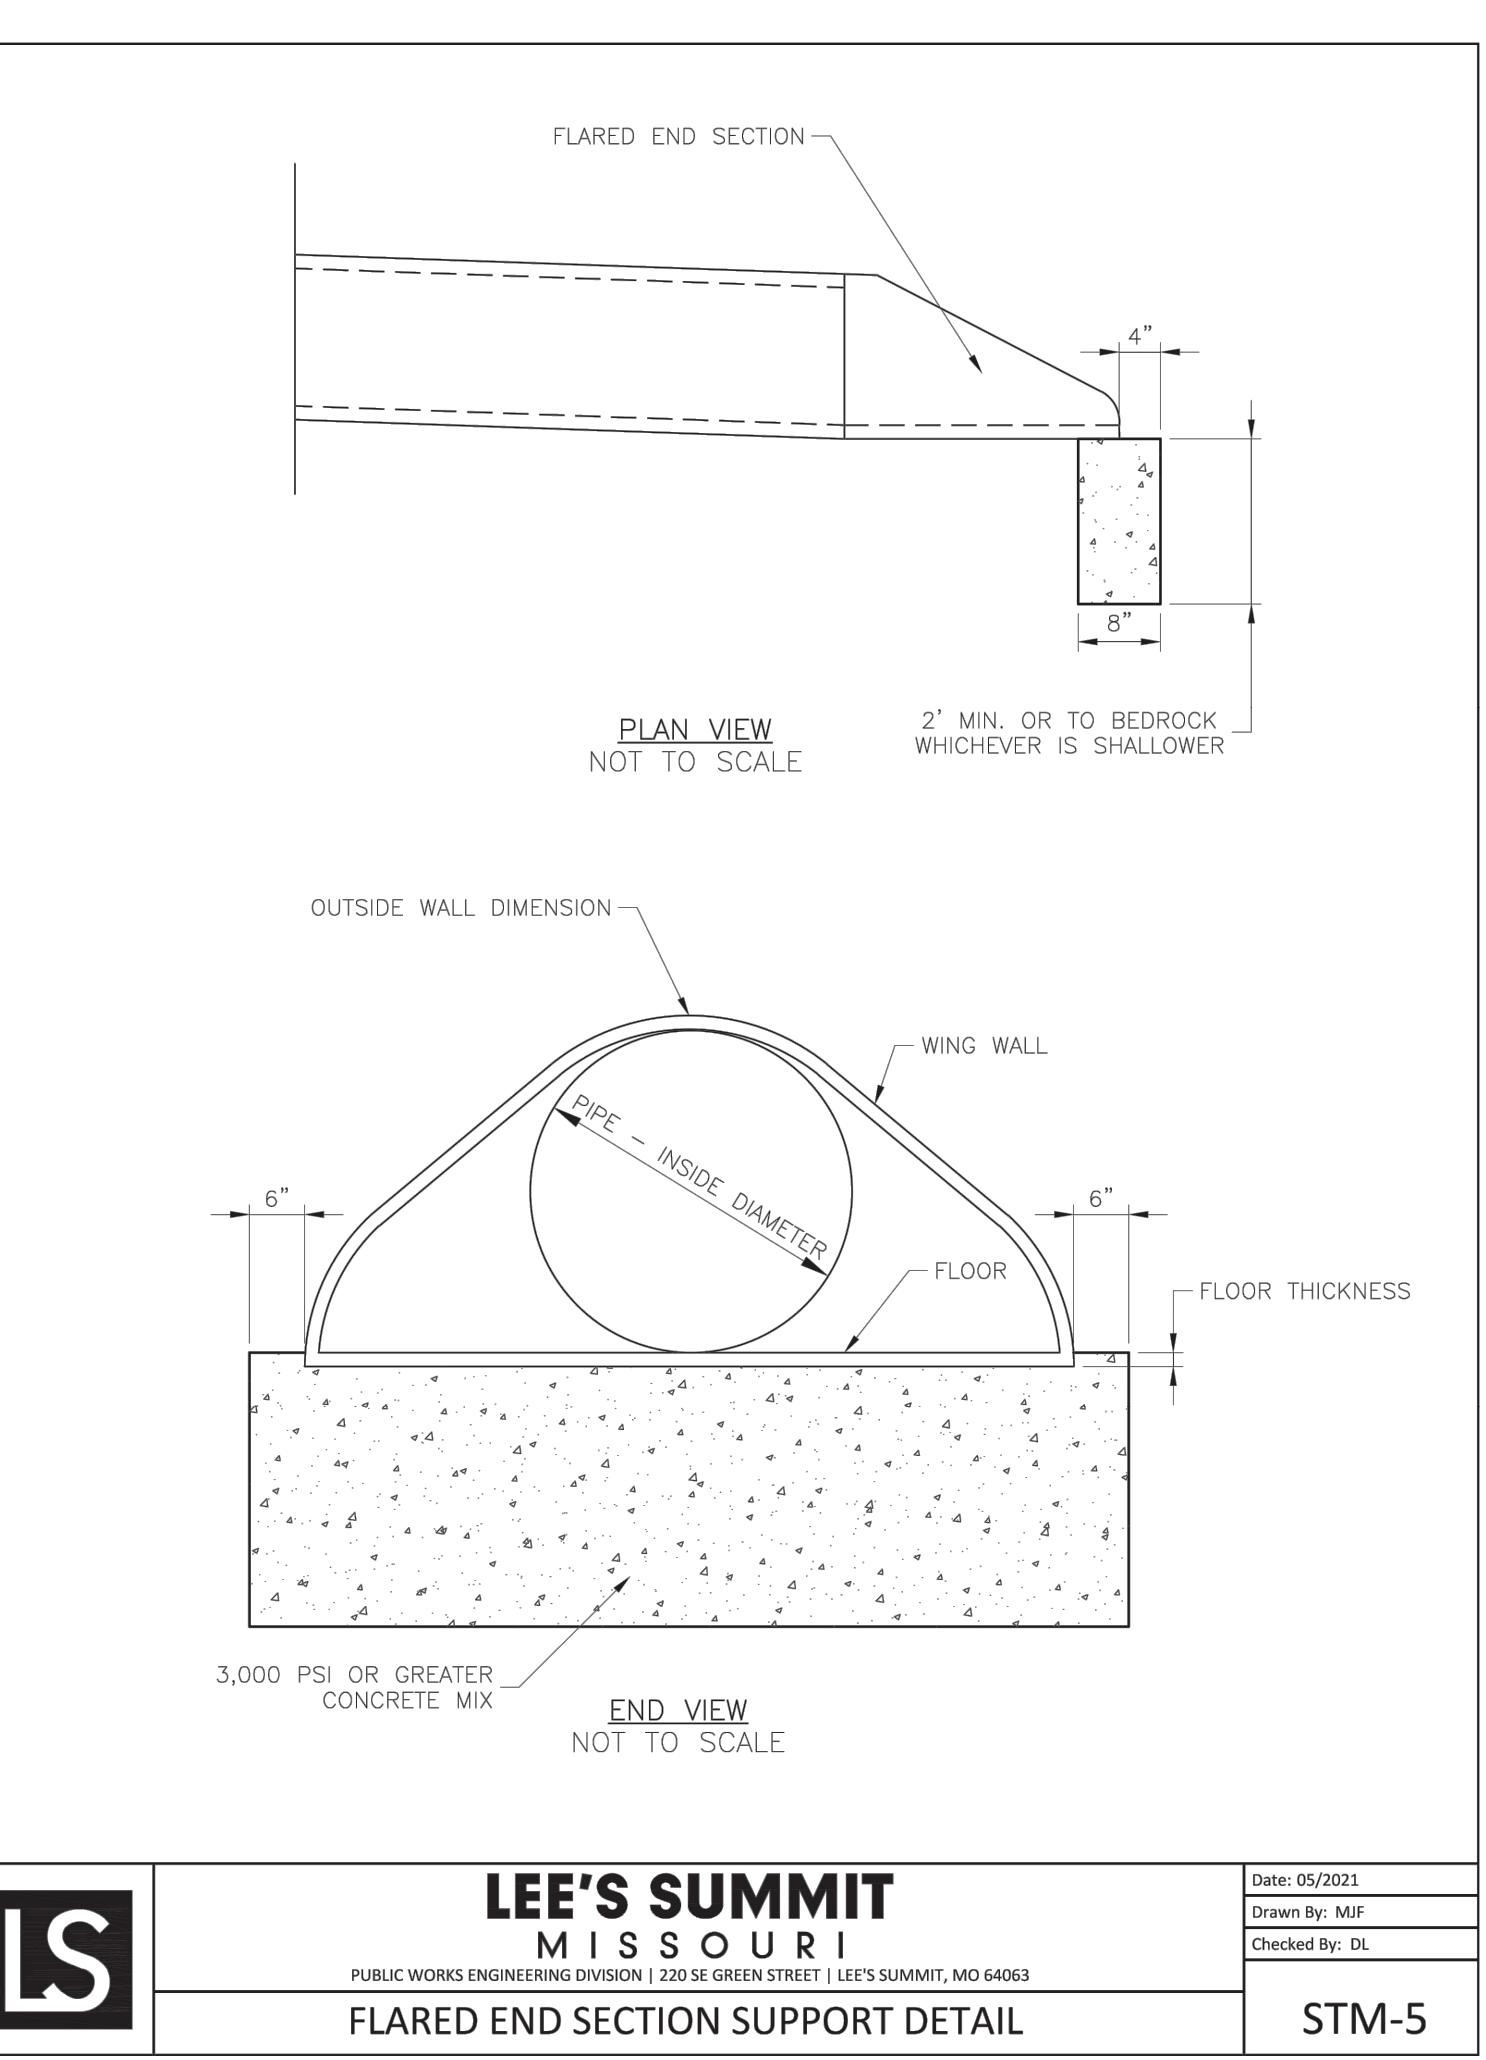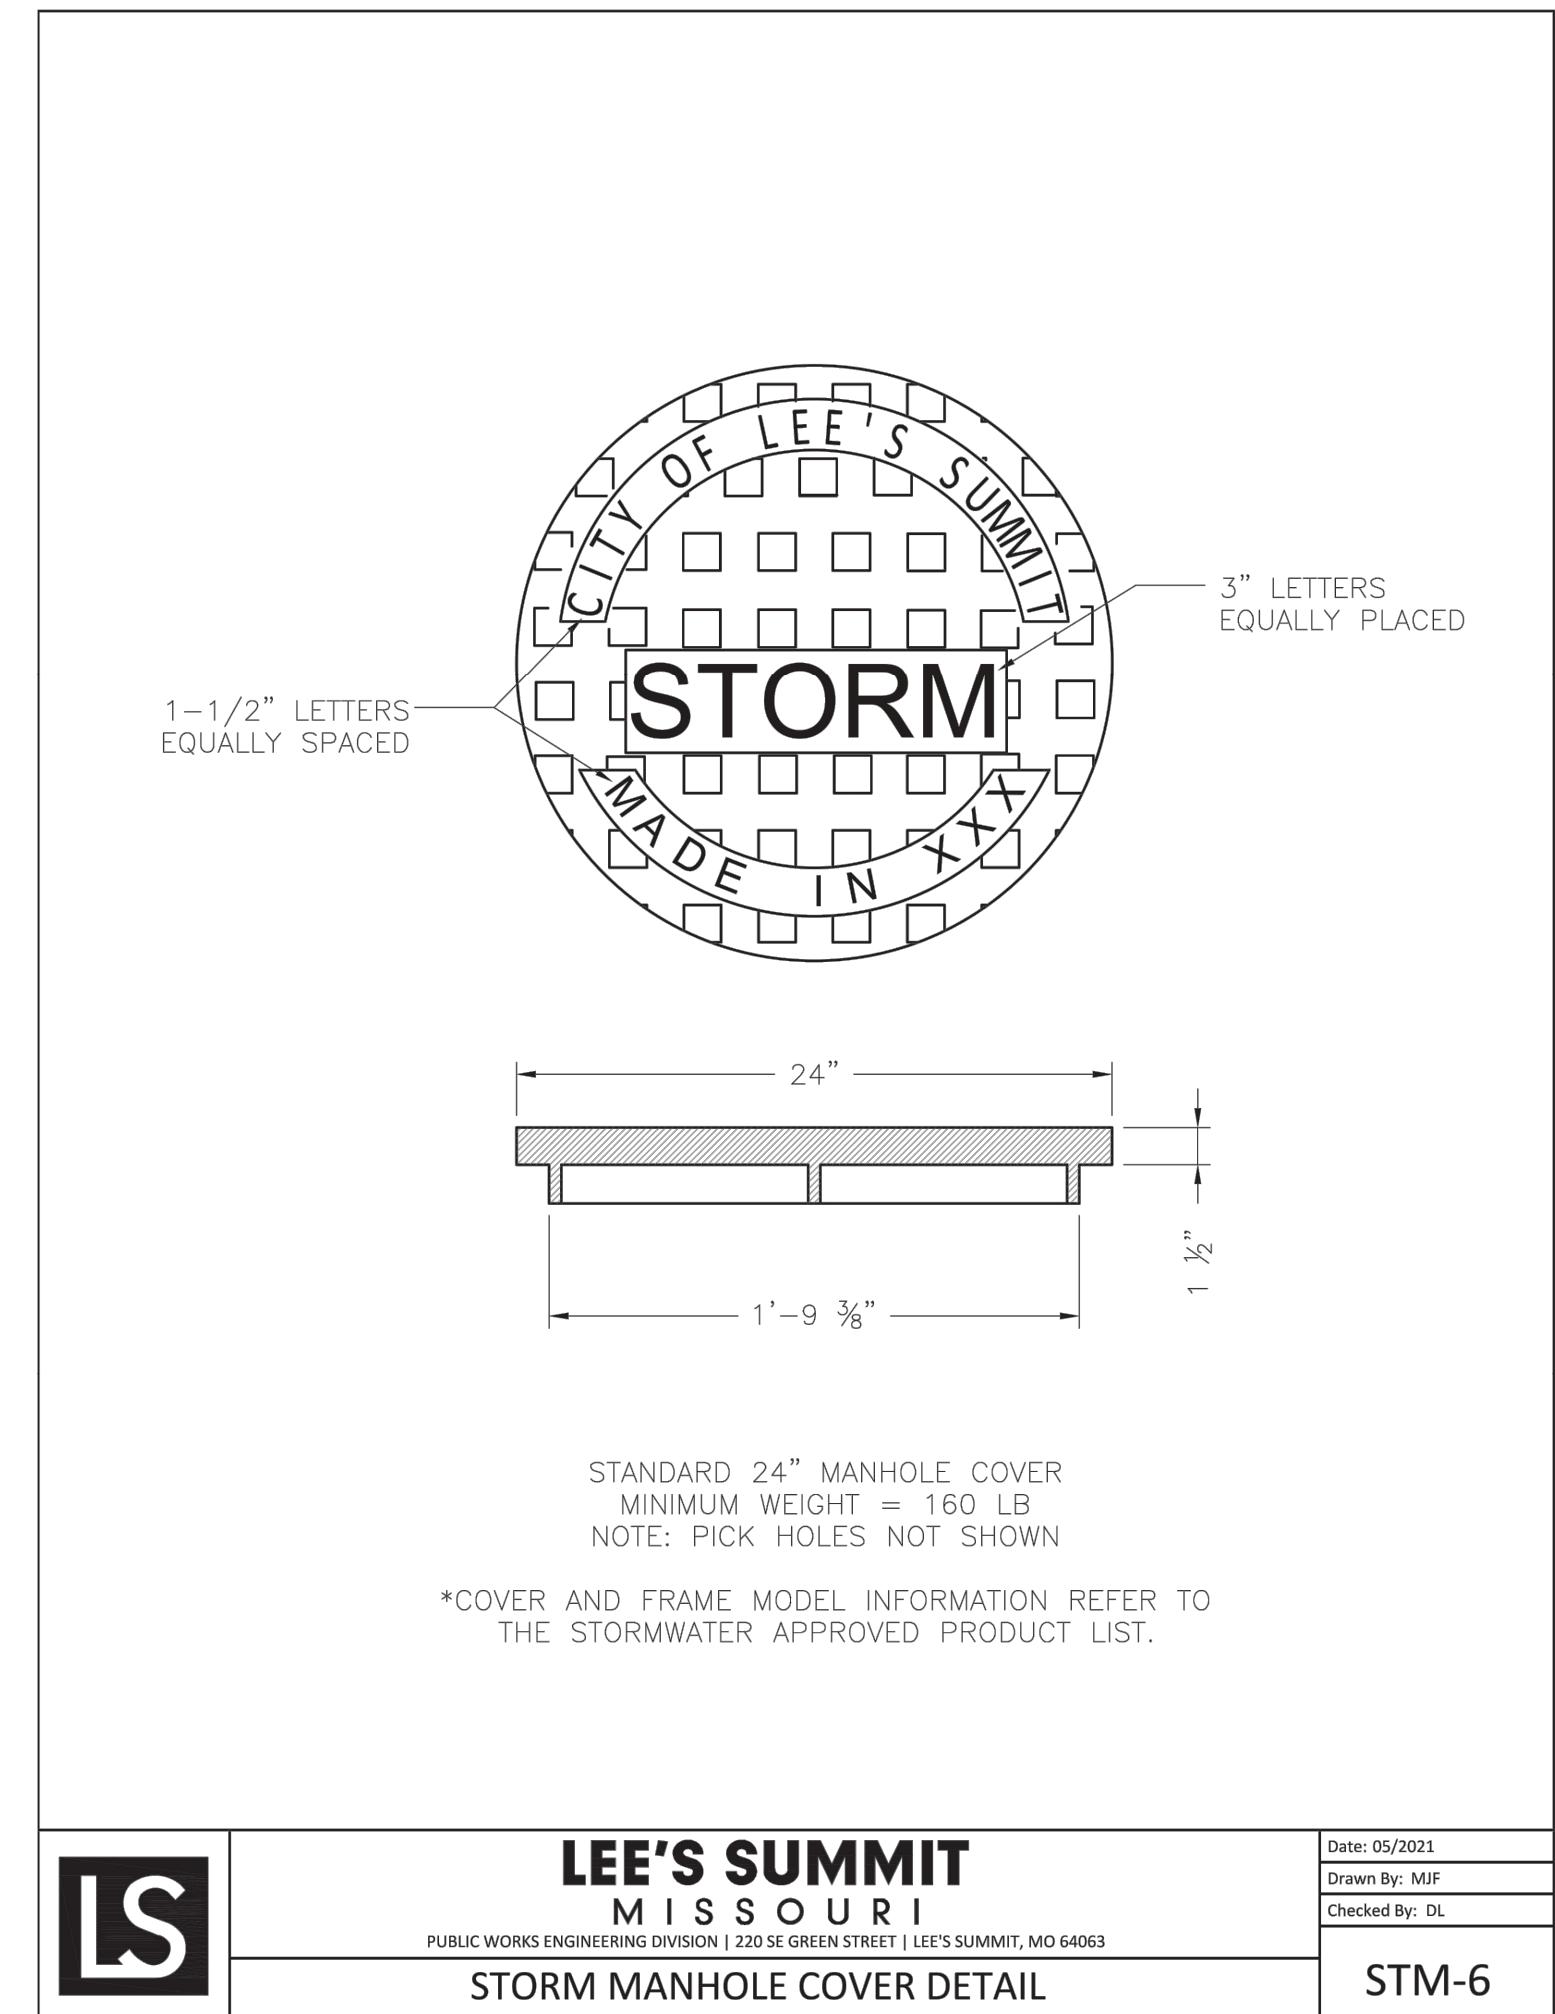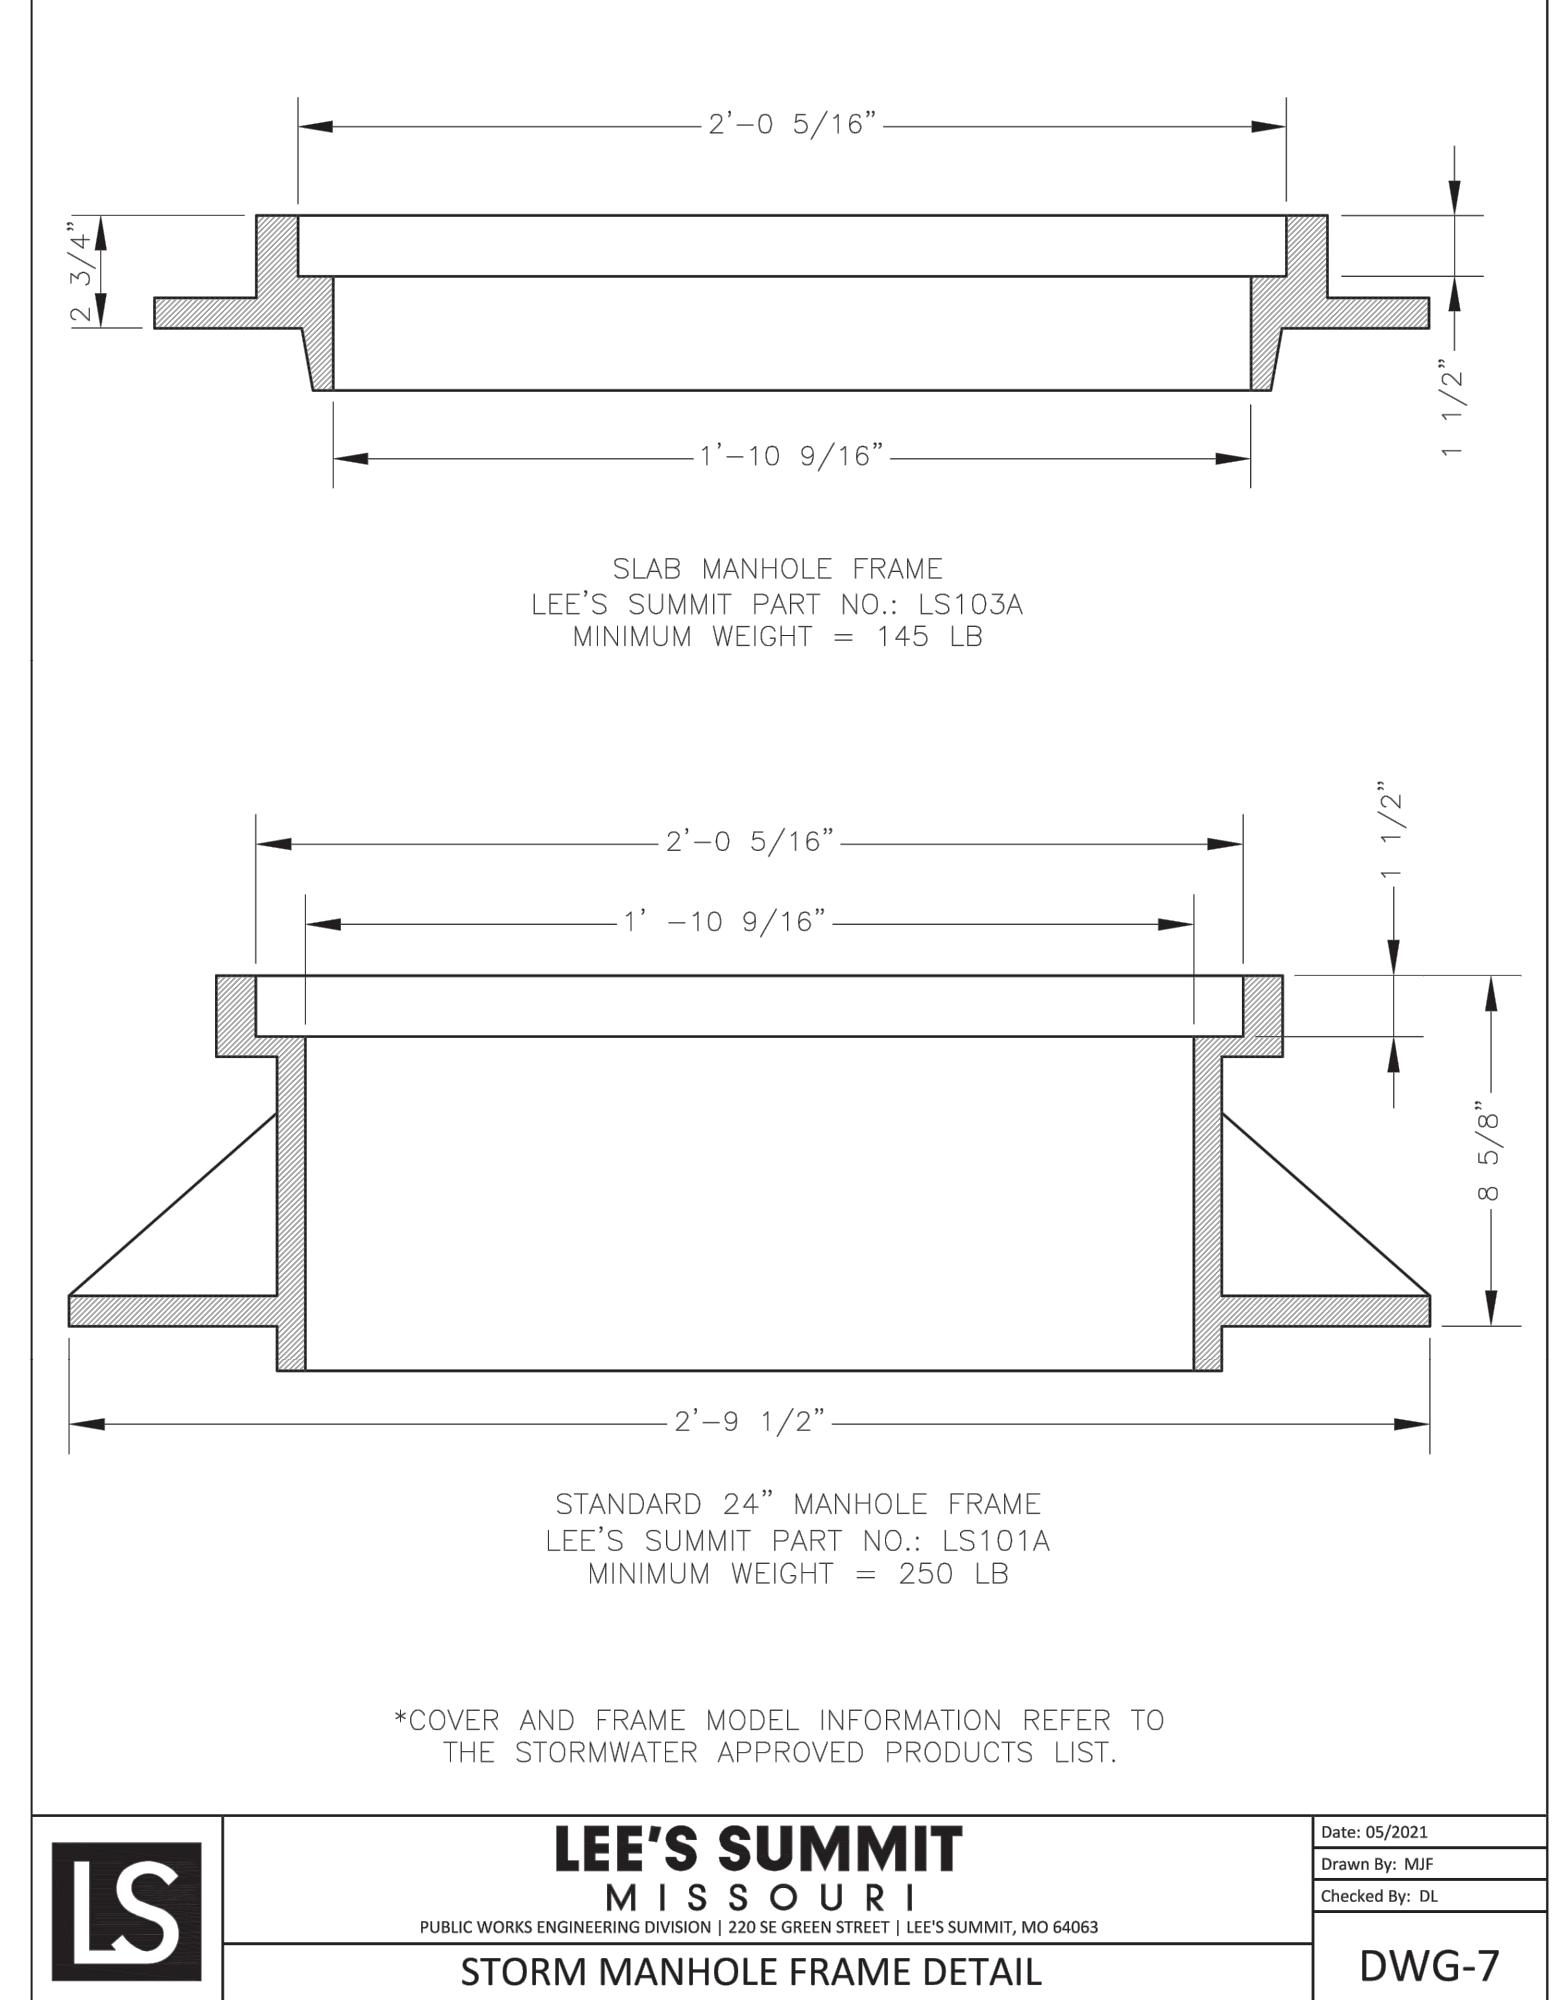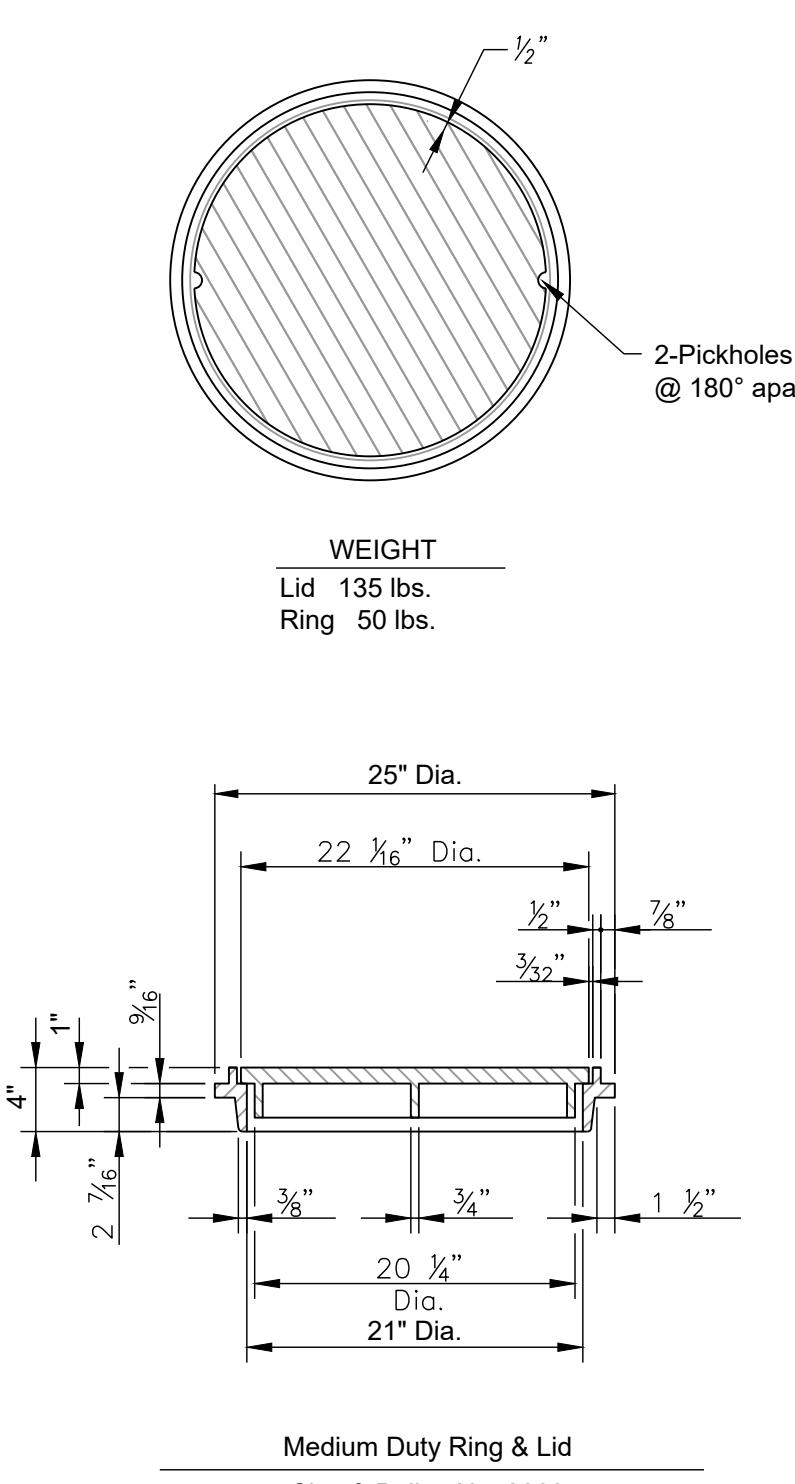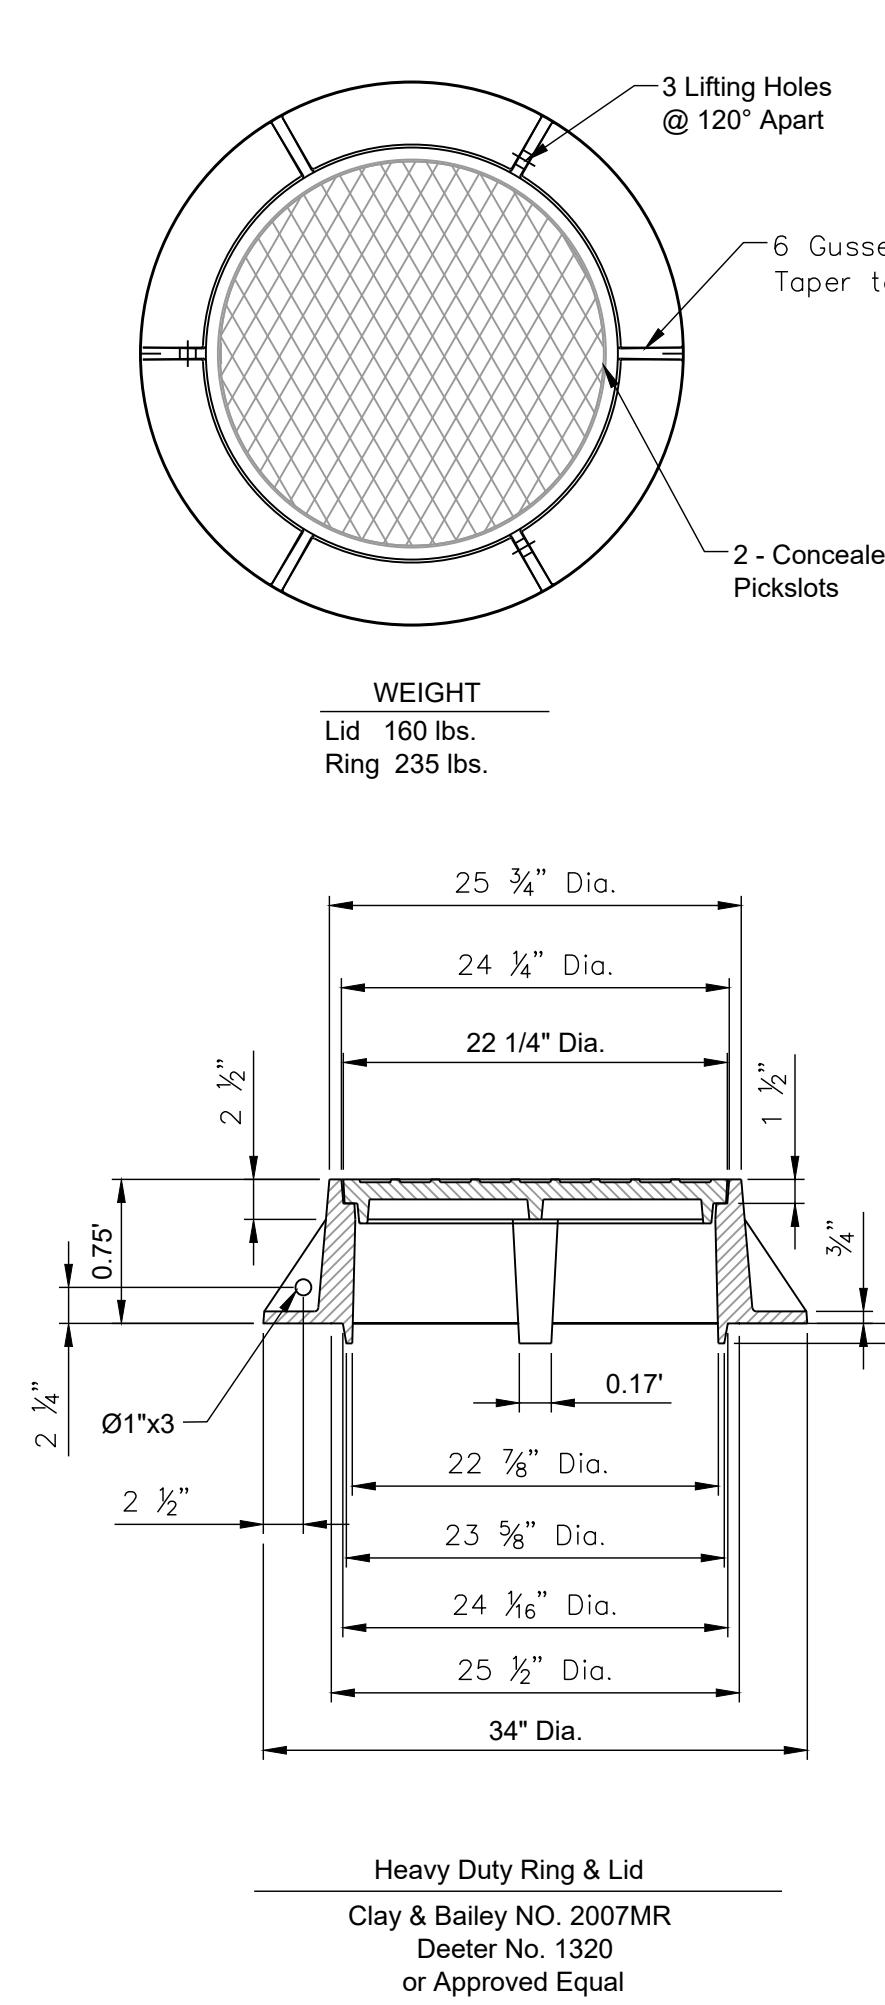

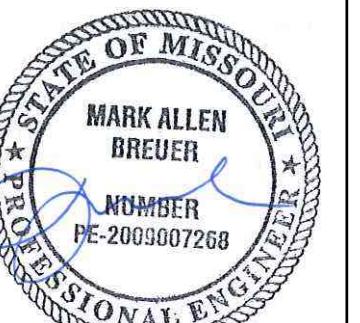PREPARED BY:

MARK ALLEN BREUER
NUMBER PE-2009007268
09.06.2023

SCHLAGEL & ASSOCIATES, P.A.

**BLACKWELL RESERVE
STREET AND STORM SEWER PLANS**

LINE NO. 14 SEC 24 NW 1/4

LINE NO. 14 SEC 24 NW 1/4

STREET SIGN PLAN


SHEET

28

SCALE: 1" = 50'


0 50' 100'

RELEASED FOR CONSTRUCTION
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Development Services Department
Lee's Summit, Missouri
09/21/2023

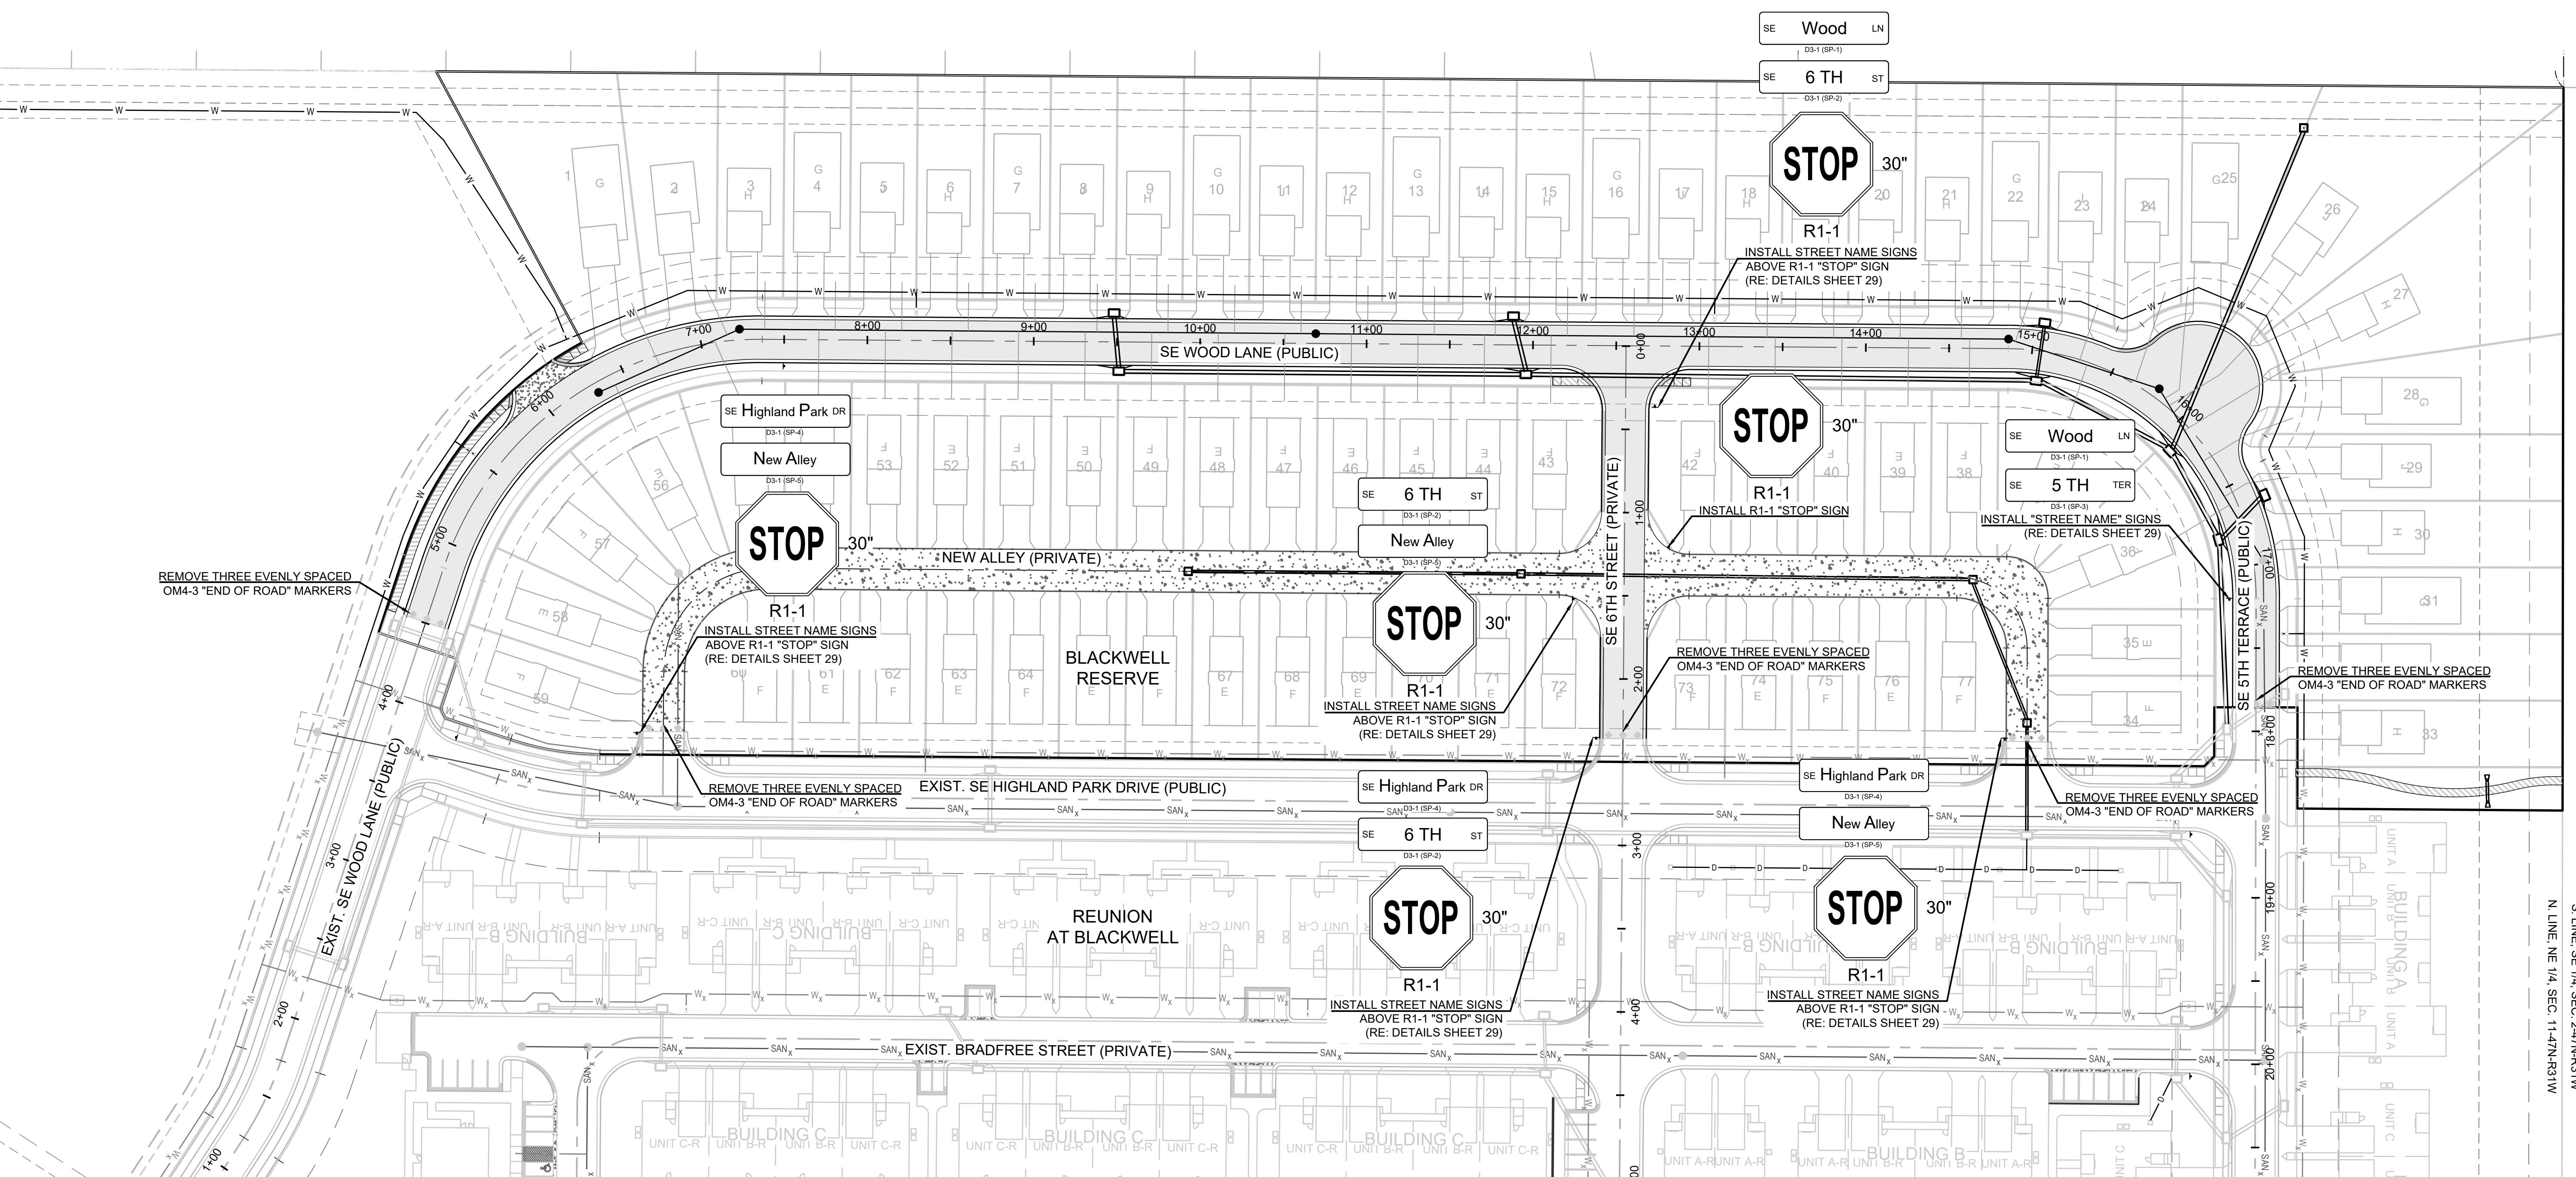

DRAWN BY:	REVISION DATE	DESCRIPTION
TRC	09/05/2023	PER CITY COMMENTS
MAB	09/05/2023	PER CITY COMMENTS
DATE PREPARED	09/05/2023	
PROJ. NUMBER	22-093	

STREET SIGN PLAN	
SHEET	28

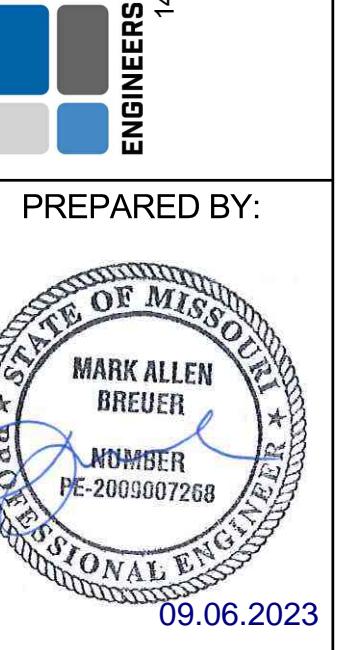

SCHLAGEL & ASSOCIATES, P.A.

PREPARED BY:

MARK ALLEN DREUER
NUMBER PE-2009007268
PROFESSIONAL ENGINEER
09.06.2023

SN-1	STANDARD DETAILS CITY OF LEE'S SUMMIT, MO LEE'S SUMMIT, JACKSON COUNTY, MO SIGN MOUNTING DETAILS SIGN NAME: LEE'S SUMMIT SIGN NUMBER: MO 546483 DRAWN BY: BWC CHECKED BY: MP DATE: 09/20/2023 PROJ #: SN-1
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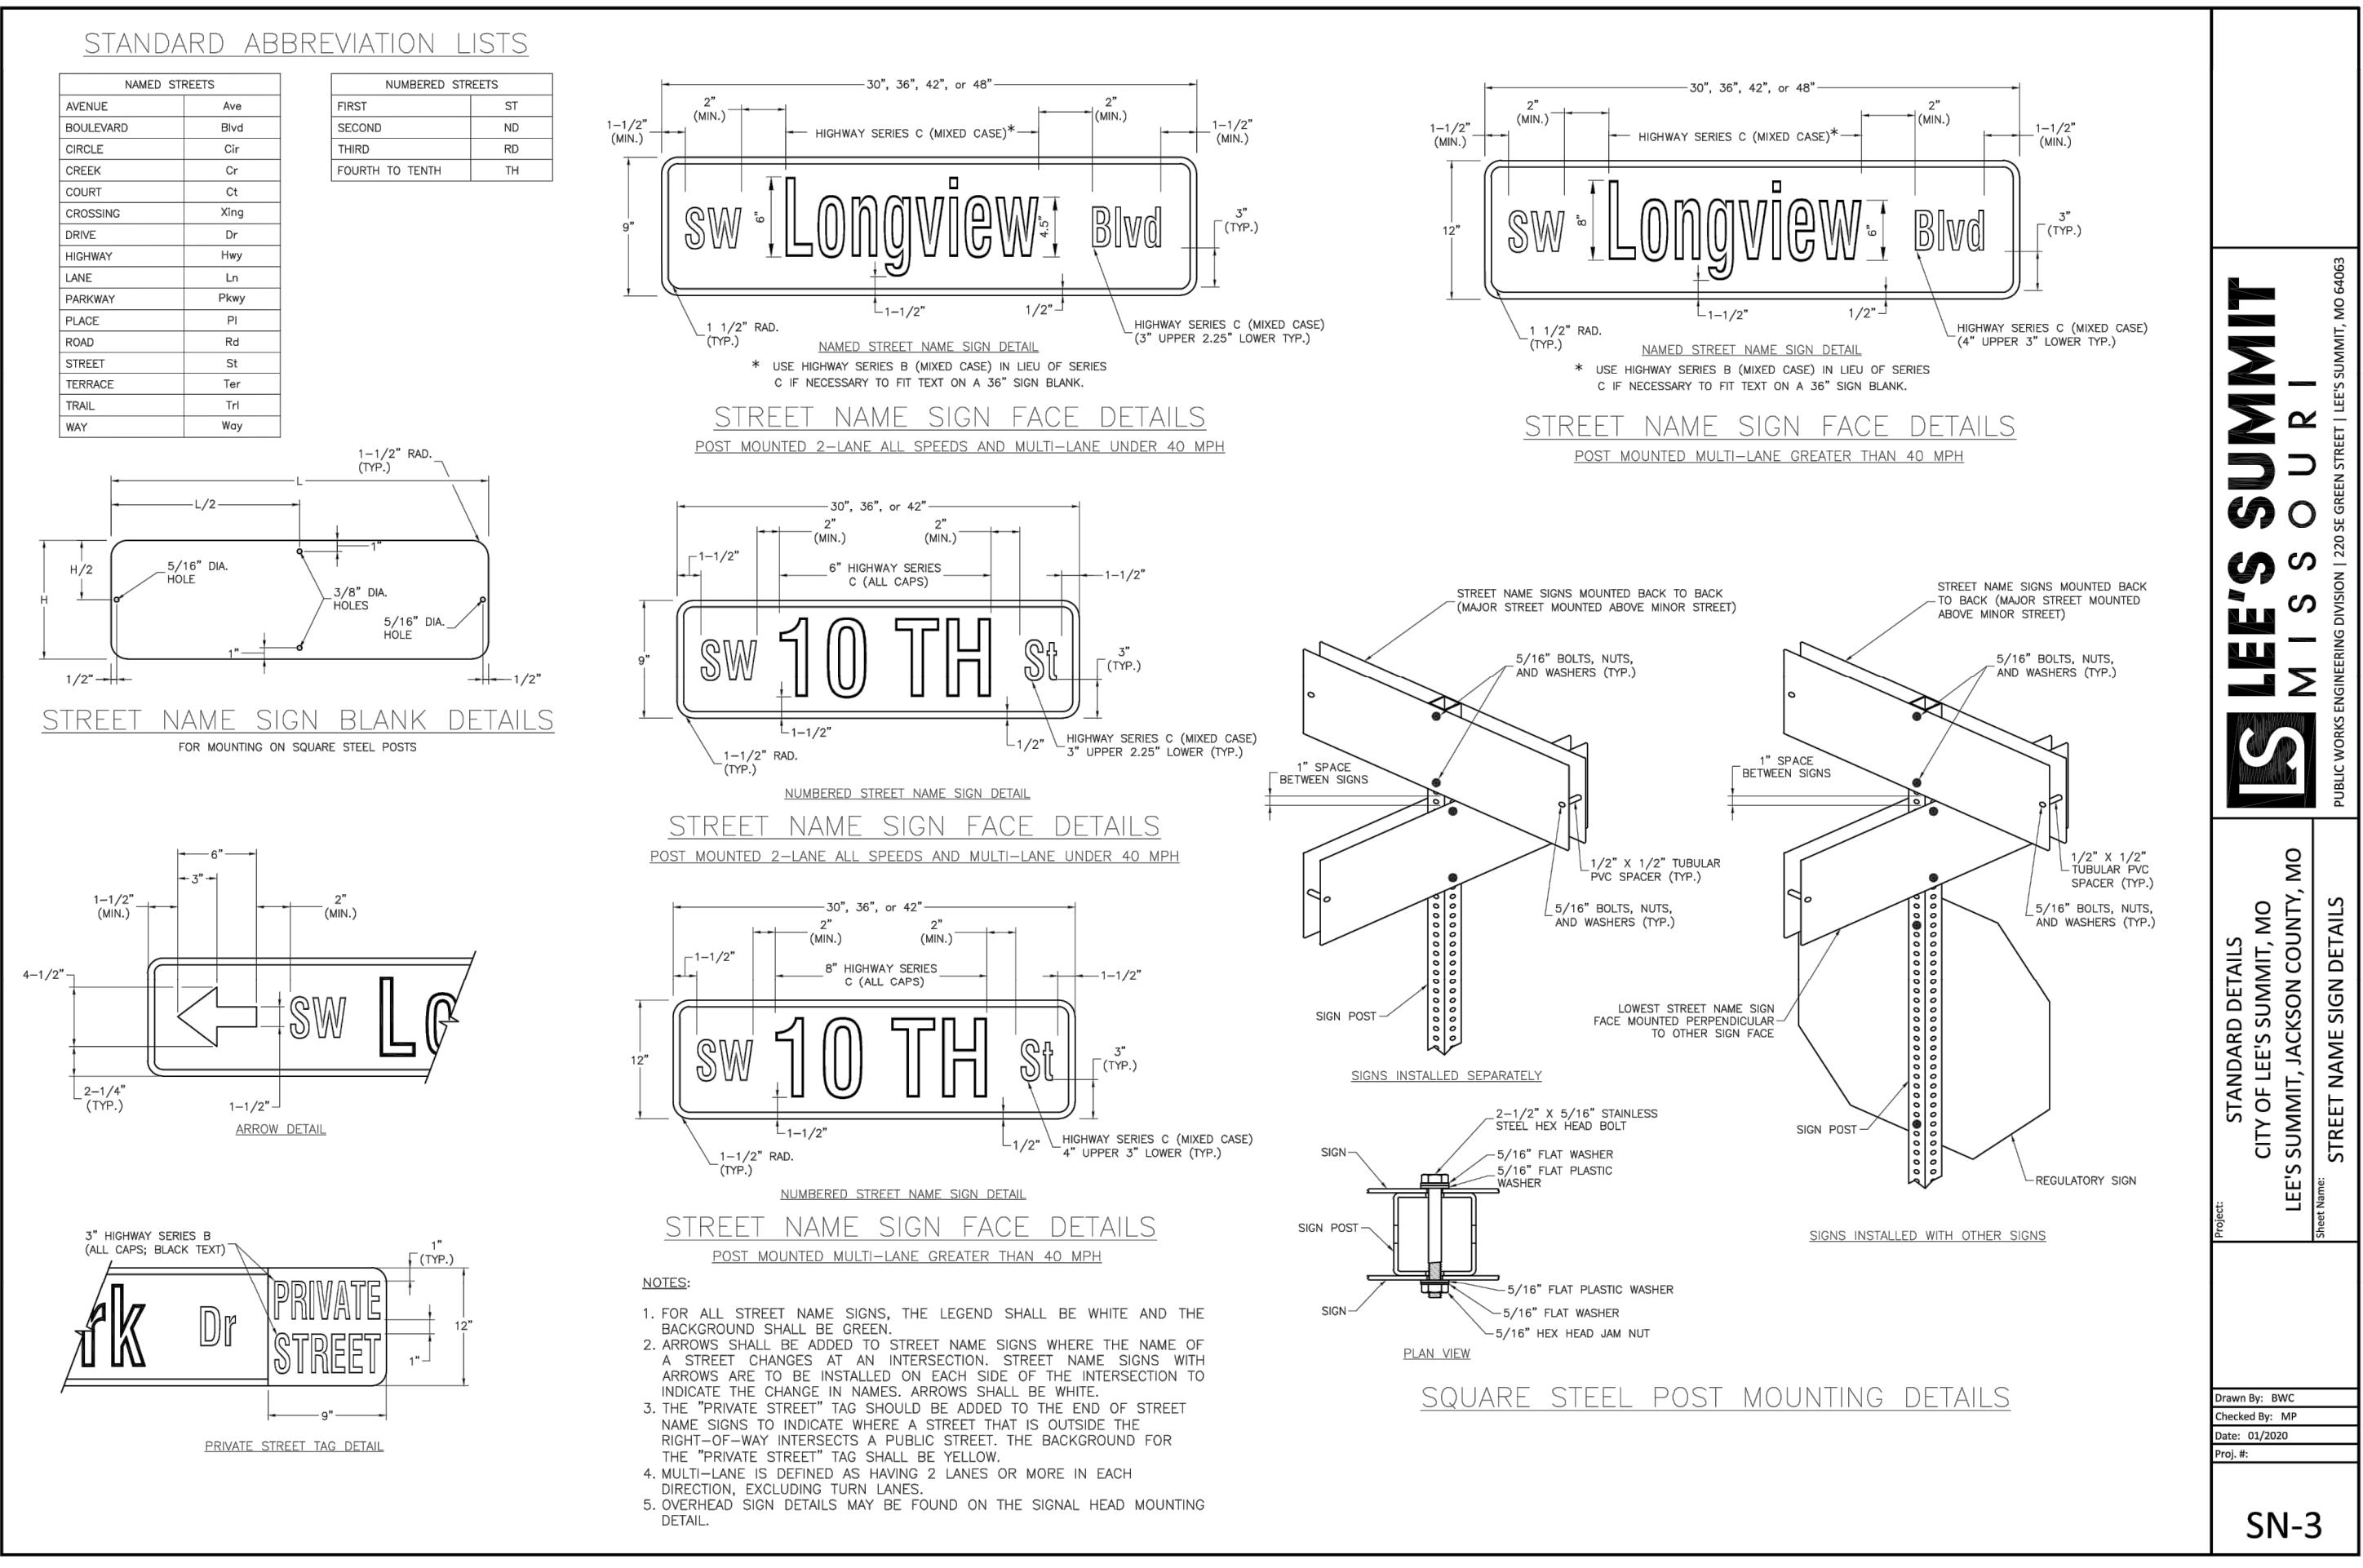
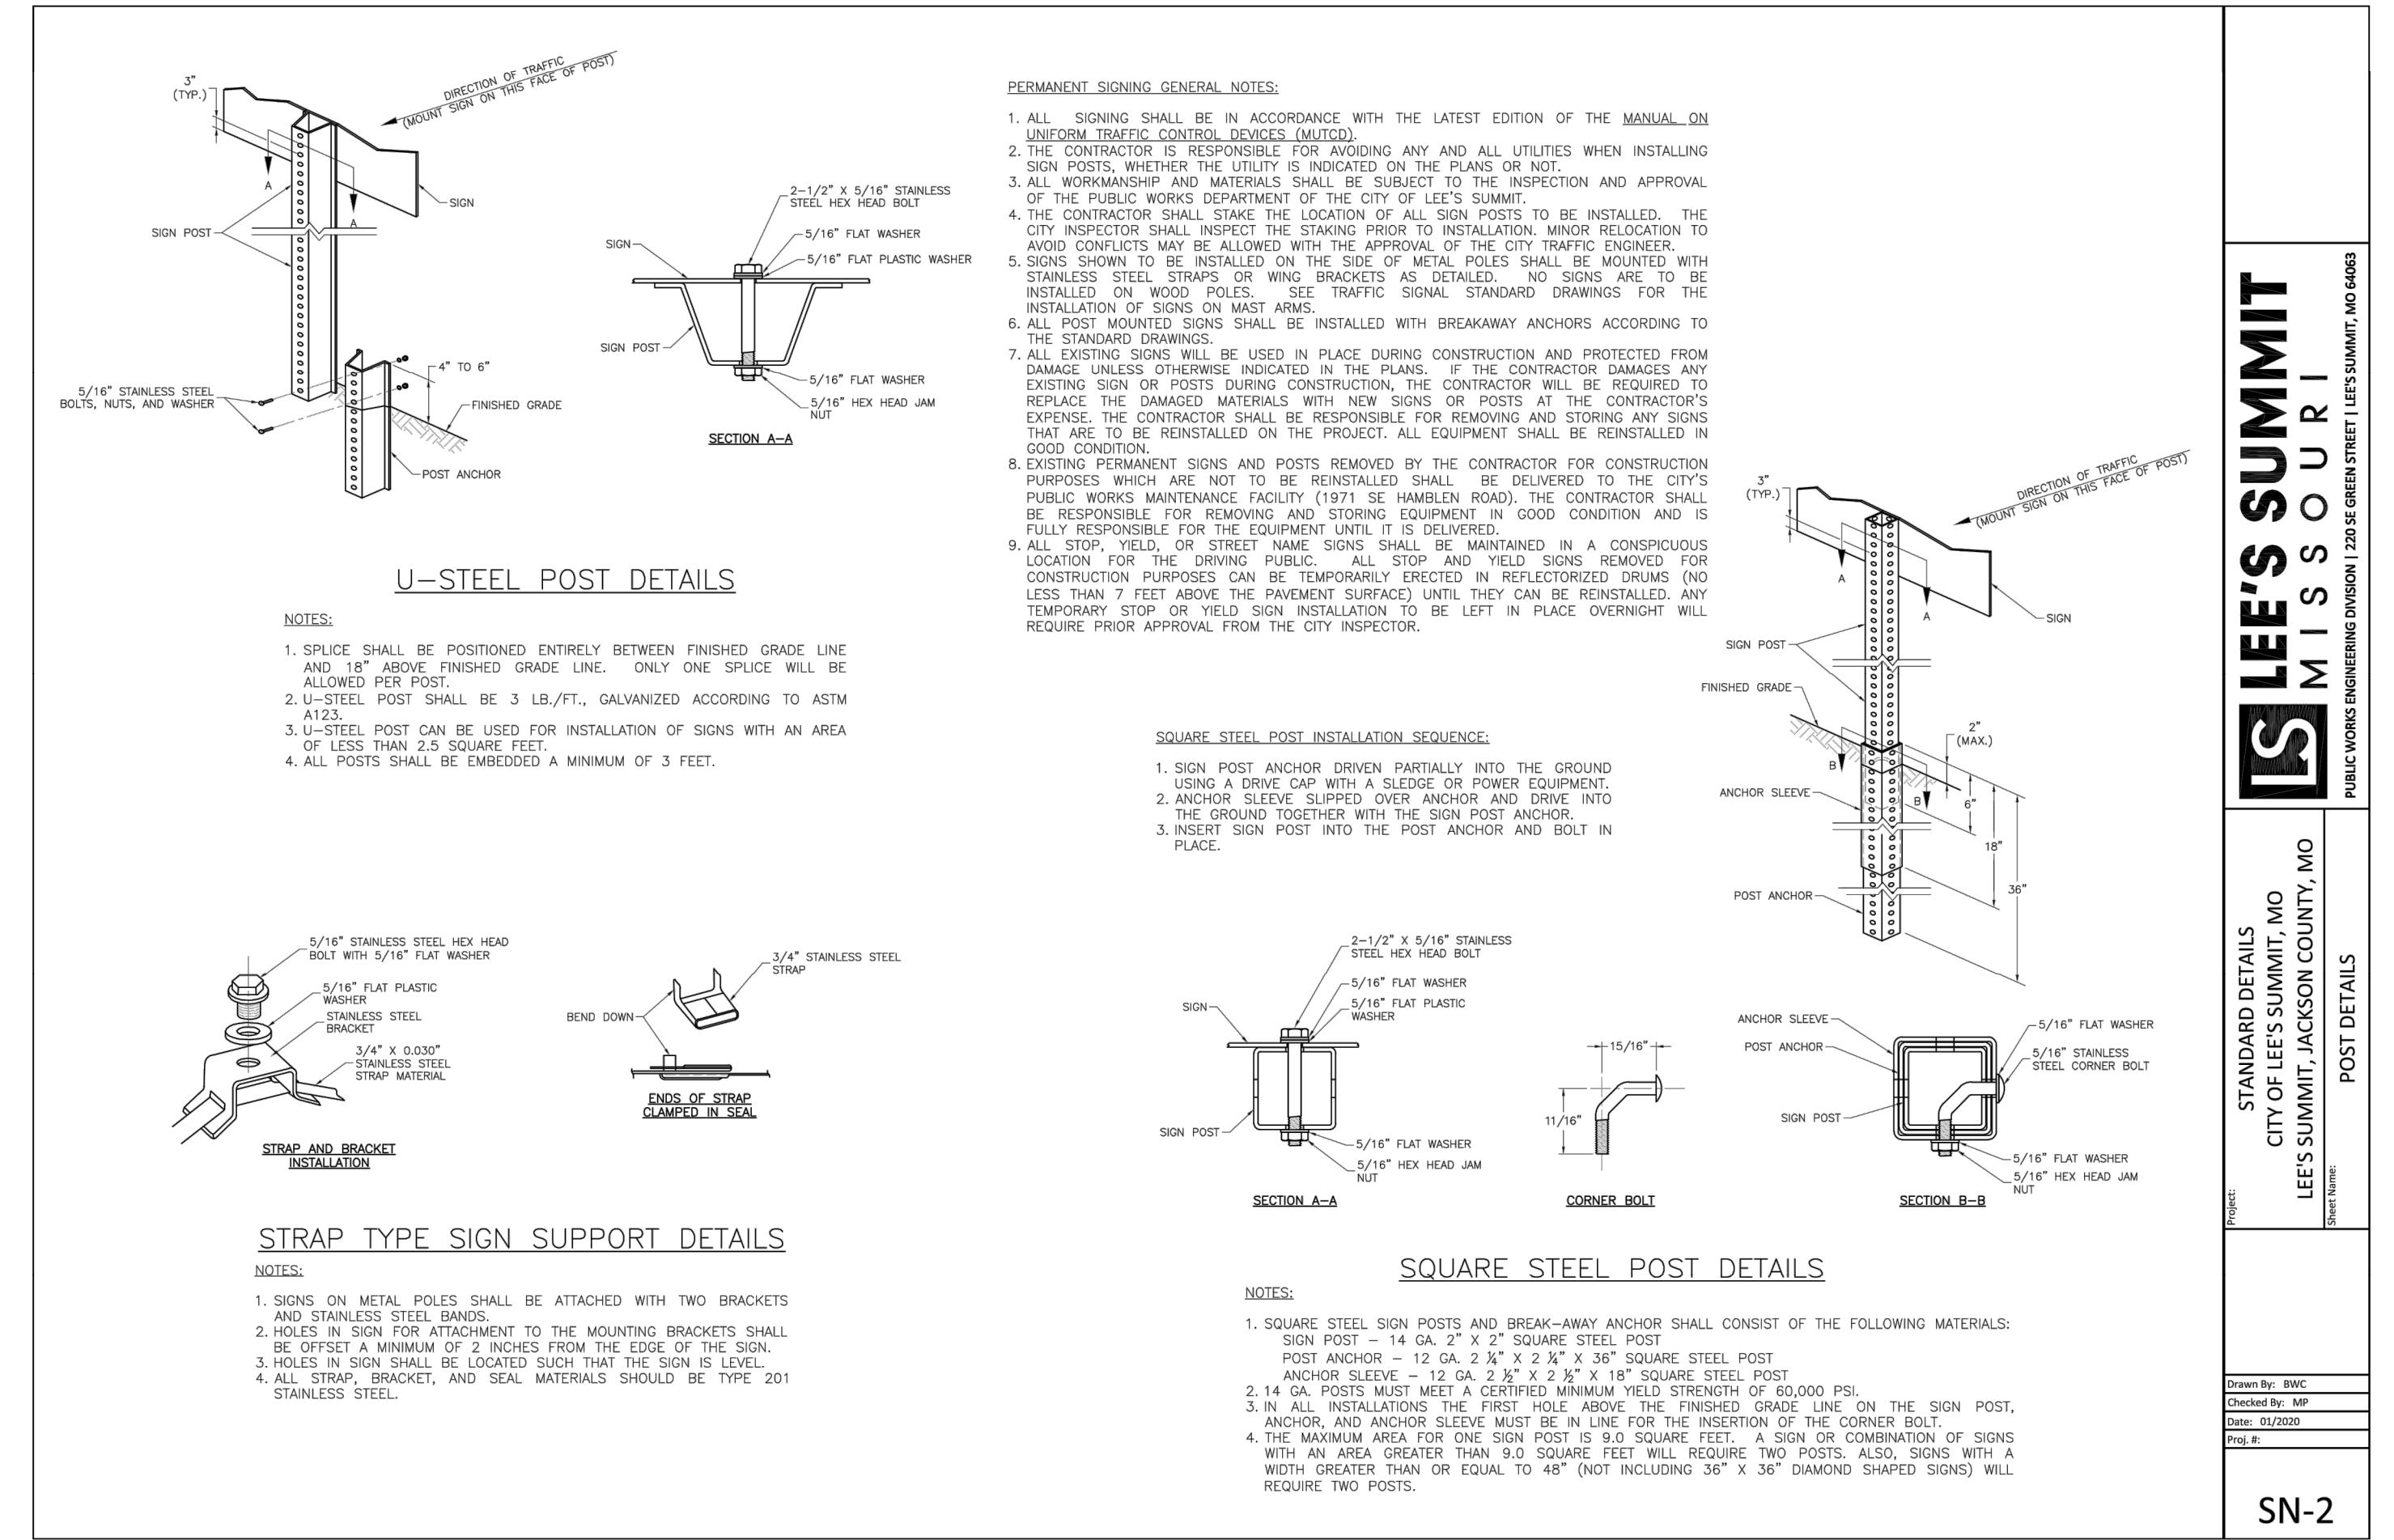
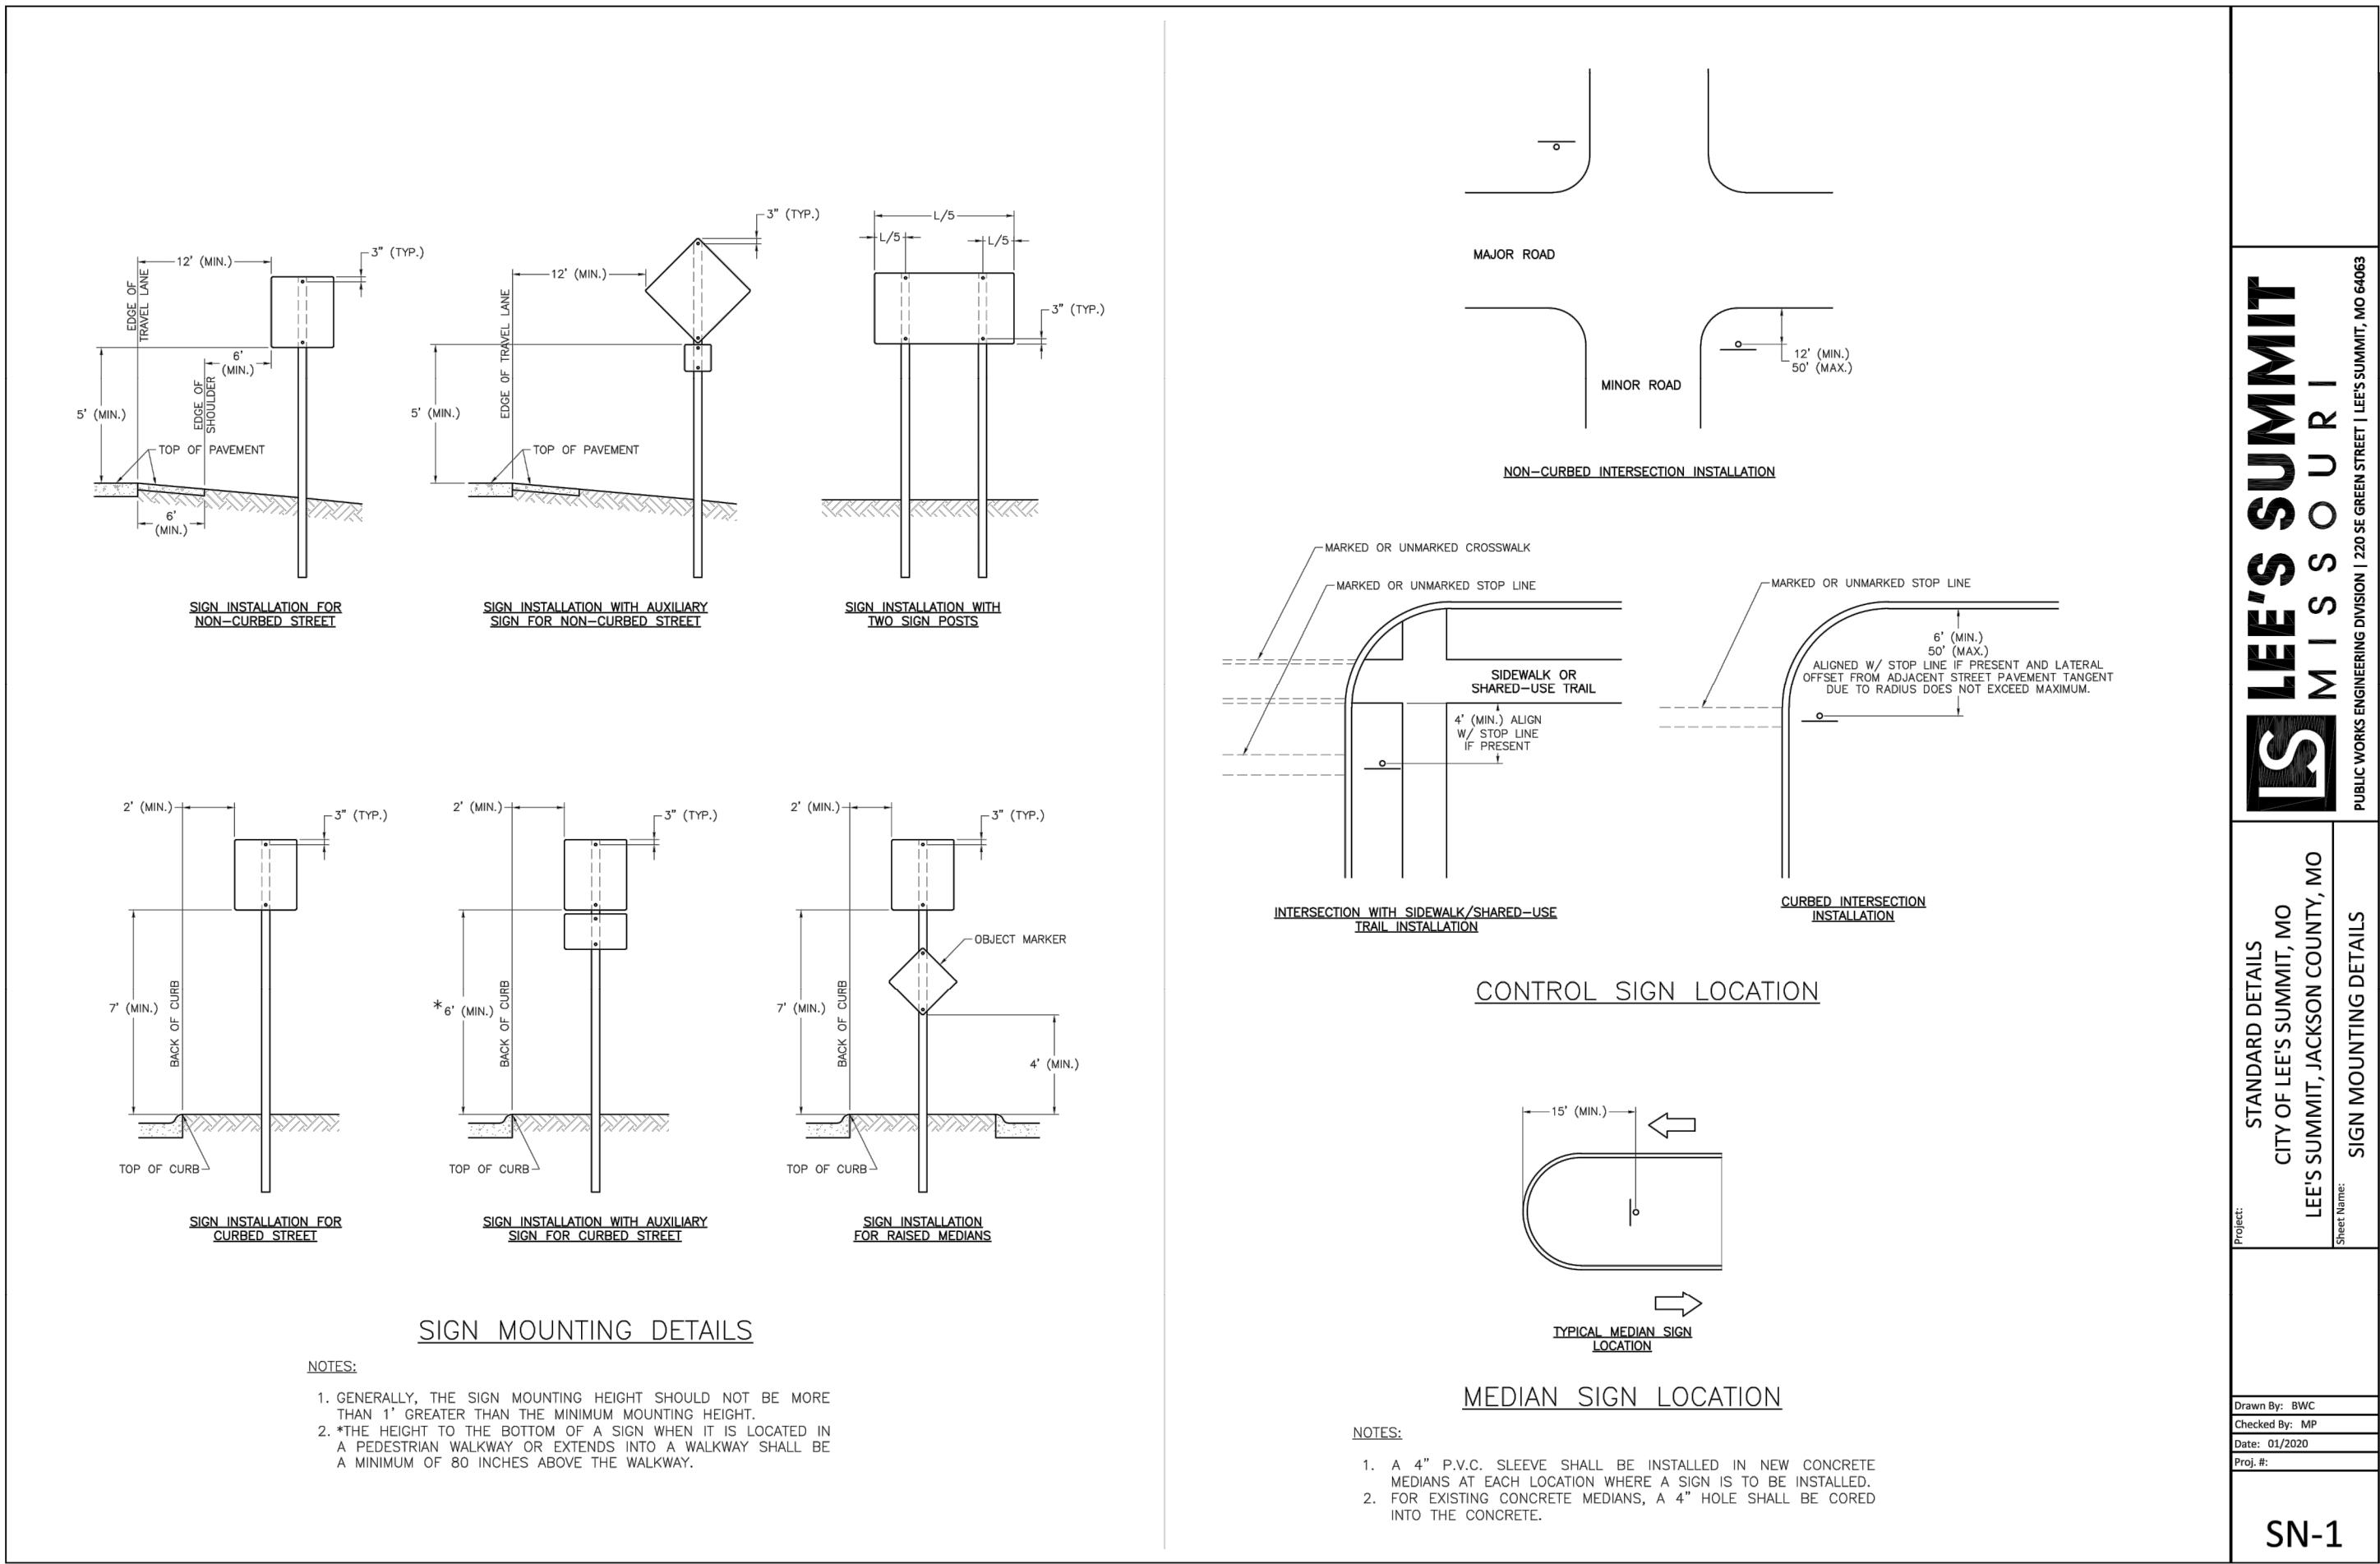
SN-2


SN-2	STANDARD DETAILS CITY OF LEE'S SUMMIT, MO LEE'S SUMMIT, JACKSON COUNTY, MO SIGN MOUNTING DETAILS SIGN NAME: LEE'S SUMMIT SIGN NUMBER: MO 546483 DRAWN BY: BWC CHECKED BY: MP DATE: 09/20/2023 PROJ #: SN-2
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SN-3	STREET SIGN DETAILS SIGN NAME: LEE'S SUMMIT SIGN NUMBER: MO 546483 DRAWN BY: BWC CHECKED BY: MP DATE: 09/20/2023 PROJ #: SN-3
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SN-3

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RELEASED FOR CONSTRUCTION
As Noted on Plan Review
Development Services Department
Lee's Summit, Missouri
09/21/2023

SHADE TREES

		DESCRIPTION
- ATW	33 EA.	Acer truncatum 'Warrenrd'
GPC	5 EA.	Ginkgo biloba "Princeton Sentry"
- QR	35 EA.	Quercus rubra
QS	1 EA.	Quercus shumardii
- UXF	38 EA.	Ulmus x Frontier

PER CITY COMMENTS	PER CITY COMMENTS	PER CITY COMMENTS
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ORNAMENTAL TREES

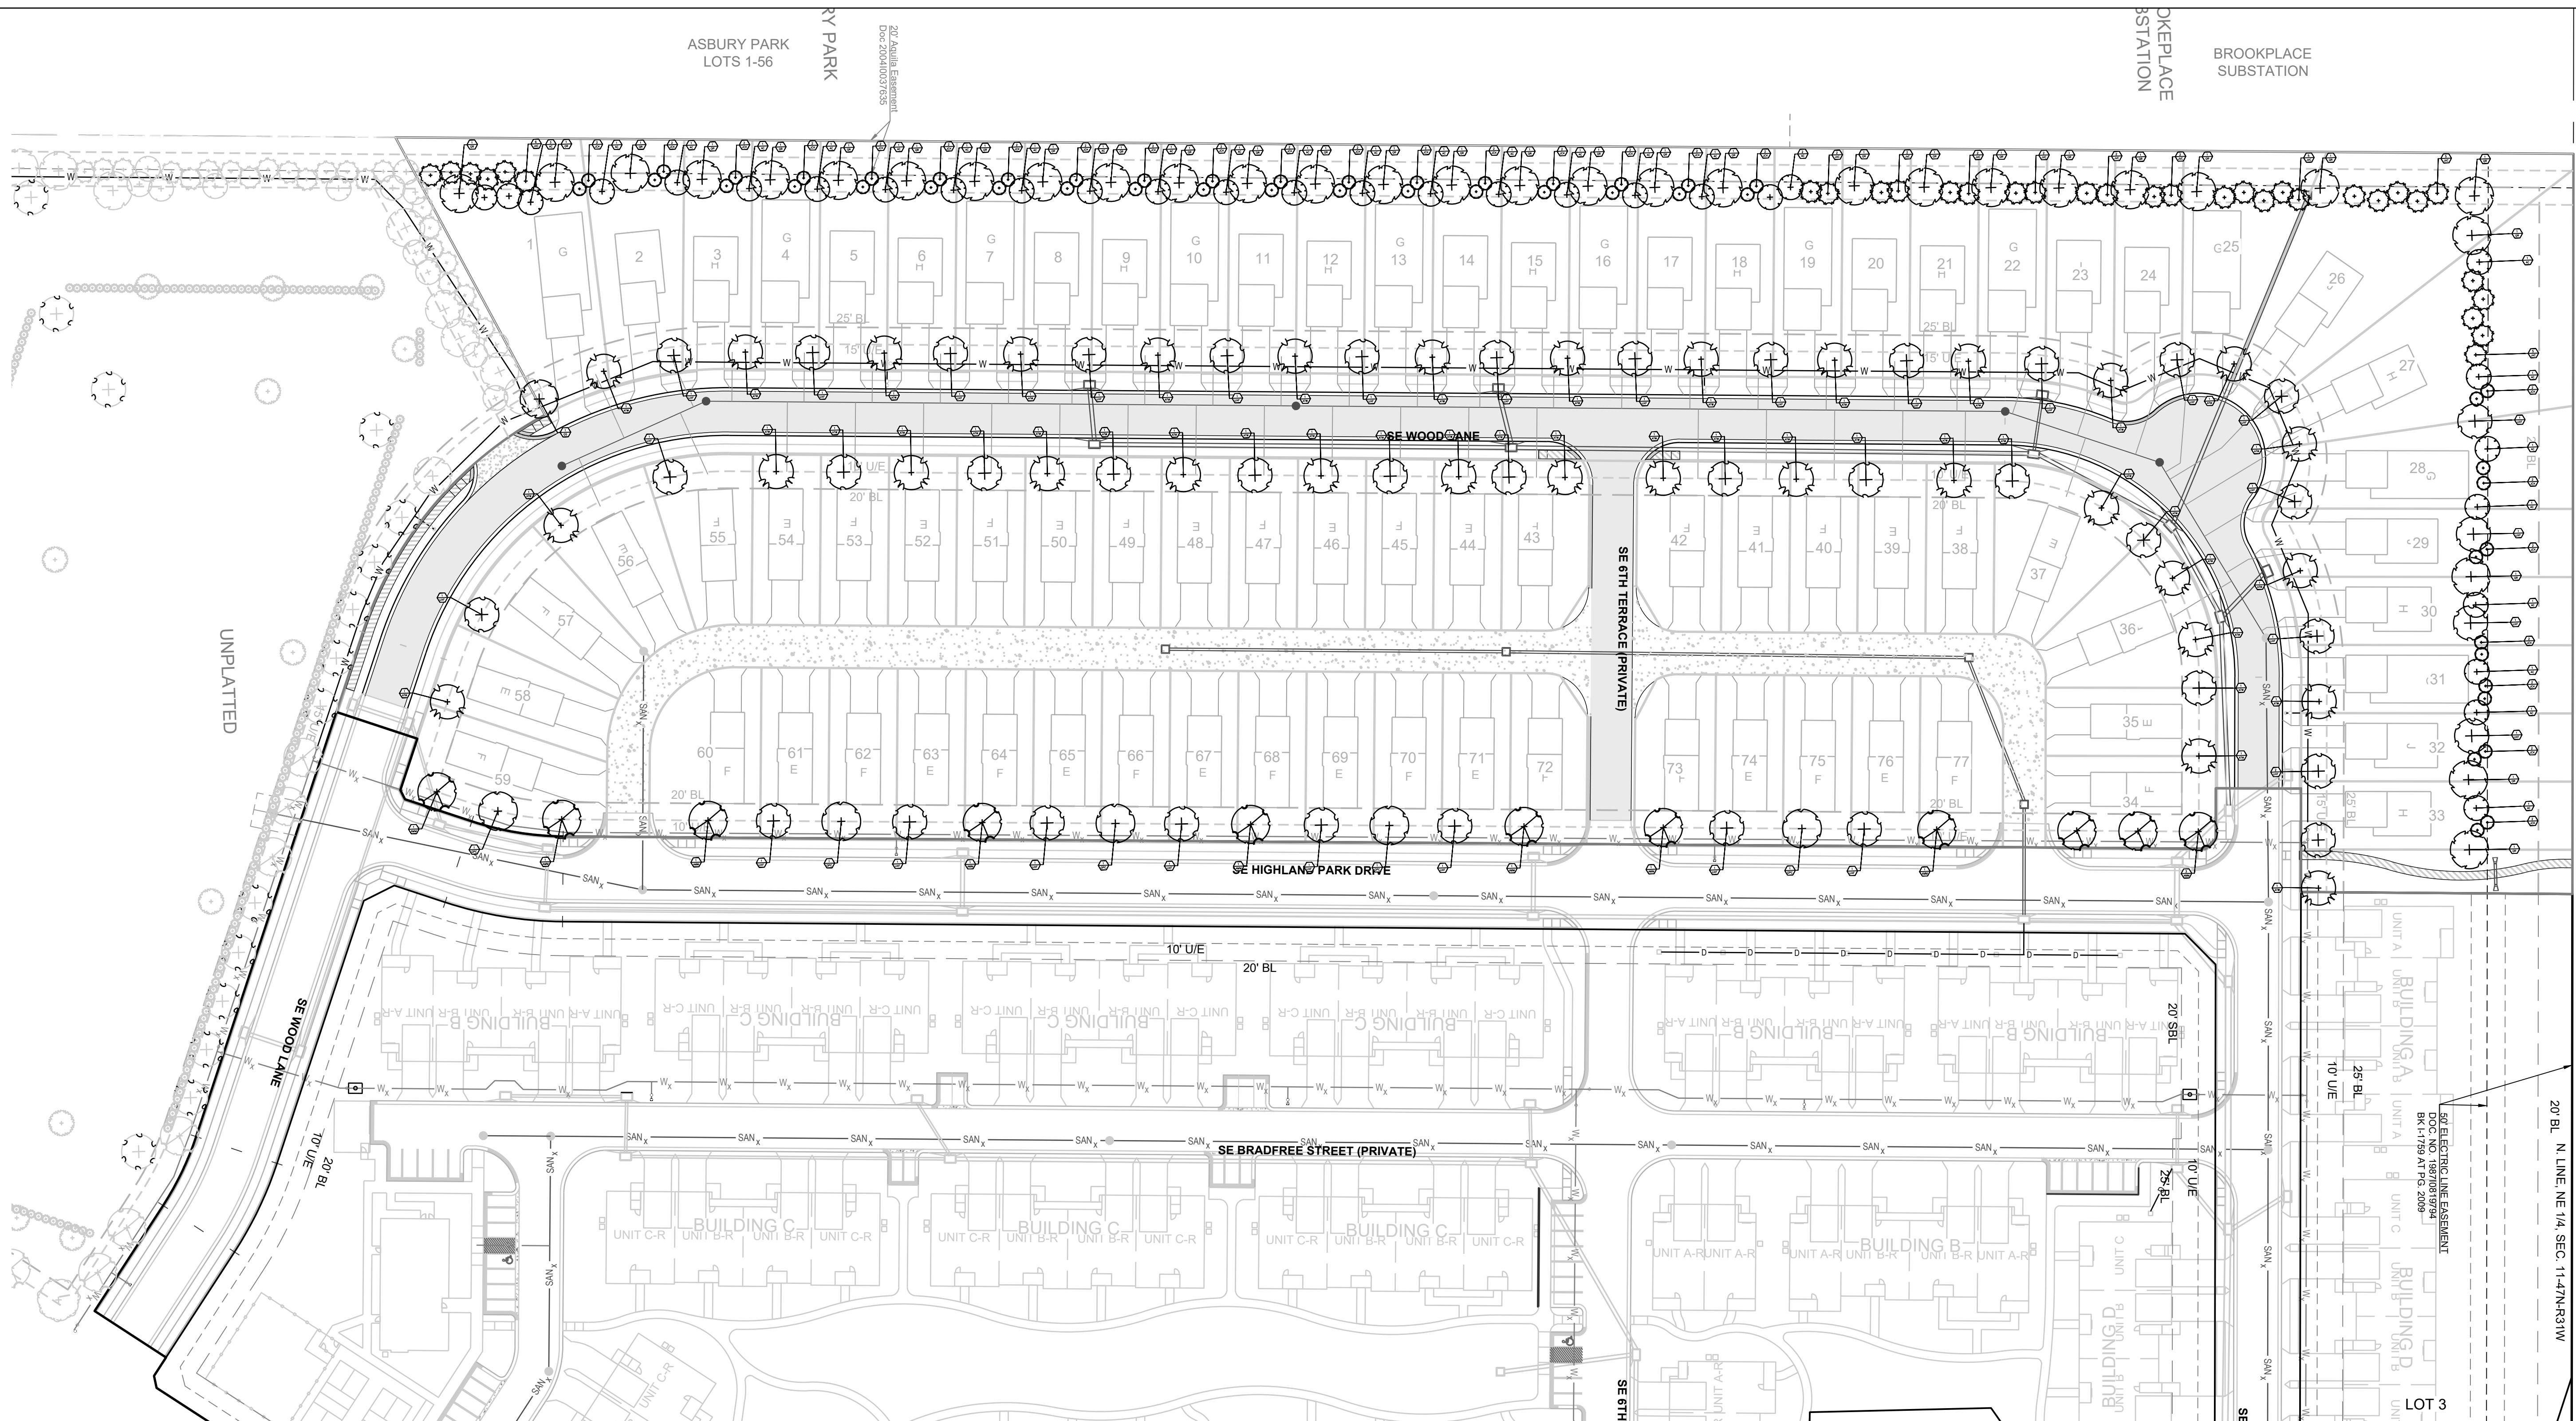		DESCRIPTION
- AC	30 EA.	Amelanchier canadensis

PER CITY COMMENTS	PER CITY COMMENTS	PER CITY COMMENTS
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MAB	09/21/2023	09/21/2023
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PROJ. NUMBER	22-093	22-093

EVERGREEN TREES

		DESCRIPTION
- JCK	50 EA.	Juniperus chinensis 'Keteleerii'
- JVC	33 EA.	Juniperus virginiana 'Canaertii'

PER CITY COMMENTS	PER CITY COMMENTS	PER CITY COMMENTS
TRC	09/21/2023	09/21/2023
MAB	09/21/2023	09/21/2023
DATE PREPARED	09/21/2023	09/21/2023
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