CO

W/E

SERVICE LINE

- TOP ELEVATION

CURB & GUTTER

TREELINE

—— P/L —— PROPERTY LINES

----- STORM SEWER

----- CATV, ---- CABLE TV - EXISTING

——Ty—— TELEPHONE LINE - EXIST.

GAS LINE - EXISTING

——W<sub>x</sub> — WATERLINE - EXISTING

CLEANOUT

- UTILITY EASEMENT

- WATER SURFACE ELEVATION

**ASPHALT PAVEMENT - EXISTING** 

ASPHALT PAVEMENT - PROPOSED

**CONCRETE PAVEMENT - EXISTING** 

**ASPHALT PAVEMENT - EXISTING** 

CONCRETE SIDEWALK - EXISTING

CONCRETE SIDEWALK - PROPOSED

CURB & GUTTER - EXISTING

EXISTING LOT AND R/W LINES

**EXISTING PLAT LINES** 

SANITARY SEWER MAIN

STORM SEWER - EXISTING

—— SANITARY SEWER MAIN - EXIST

FIBER OPTIC CABLE - EXISTING

----- OHP, ---- OVERHEAD POWER LINE - EXIST

—— UGE<sub>Y</sub> —— UNDERGROUND ELECTRIC - EX.

LIGHT - EXISTING

**EXISTING MANHOLE** 

EXISTING AREA INLET **EXISTING CURB INLET** 

EXISTING GRATE INLET **EXISTING JUNCTION BOX** 

EXISTING STORM MANHOLE

**EXISTING SANITARY MANHOLE** 

PROPOSED SANITARY MANHOLE

WATERLINE EASEMENT

- SIDEWALK

#### **UTILITY CONTACTS:**

MISSOURI DEPARTMENT OF TRANSPORTATION (MODOT) Steve Holloway 600 NE Colbern Road

Lee's Summit, MO 64086 (816) 607-2186 SPIRE

Brent Jones 3025 SE Clover Drive Lee's Summit, MO 64082 (816) 399-0663brent.jones@spireenergy.com

**EVERGY** Philip Ingram 1300 SE Hamblin Road Lee's Summit, MO 64081 Office: (816) 347-347-4339 philip.inghram@evergy.com

CITY OF LEES SUMMIT PUBLIC WORKS Dena Mezger

220 SE Green Street Lee's Summit, MO 64063 (816) 969-1800

Mark Manion or Marty Loper 500 E. 8th Street, Room 370 Kansas City, MO 64106 (816) 275-2341 or (816) 275-1550

COMCAST CABLE John Meadows 4700 Little Blue Parkway (816) 795-2257

CITY OF LEE'S SUMMIT WATER UTILITIES Mark Schaufler 1200 SE Hamblen Road Lee's Summit, MO 64081



811 or 1-800-344-7483 mo1call.com

# MASS GRADING & EROSION SEDIMENT CONTROL PLANS RESIDENCES, REUNION & RESERVE AT **BLACKWELL**

## IN THE CITY OF LEE'S SUMMIT JACKSON COUNTY, MO

#### **GENERAL NOTES**

STREET NOTES:

UNITS

DEVELOPMENT ENGINEERING.

10. SSD = STOPPING SIGHT DISTANCE.

- ALL CONSTRUCTION TO FOLLOW THE CITY OF LEE'S SUMMIT DESIGN AND CONSTRUCTION MANUAL AS ADOPTED BY ORDINANCE 5813.
- ALL WORKMANSHIP AND MATERIALS SHALL BE SUBJECT TO THE INSPECTION AND APPROVAL OF THE ENGINEERING DEPARTMENT OF THE CITY OF LEE'S SUMMIT, MISSOURI.
- LINEAL FOOT MEASUREMENTS SHOWN ON THE PLANS ARE HORIZONTAL MEASUREMENTS, NOT SLOPE MEASUREMENTS. ALL PAYMENTS SHALL BE MADE ON HORIZONTAL MEASUREMENTS.
- NO GEOLOGICAL INVESTIGATION HAS BEEN PERFORMED ON THE SITE THE UTILITY LOCATIONS SHOWN ON THESE PLANS ARE TAKEN FROM UTILITY COMPANY RECORDS AND
- WHICH HAVE FACILITIES IN THE NEAR VICINITY OF THE CONSTRUCTION TO BE PERFORMED
- PRIOR TO ORDERING PRECAST STRUCTURES. SHOP DRAWING SHALL BE SUBMITTED TO THE DESIGN ENGINEER FOR APPROVAL. AFTER APPROVAL OF THE SHOP DRAWINGS, A COPY OF THE APPROVED AND SIGNED SHOP DRAWINGS SHALL BE PROVIDED TO THE CITY INSPECTOR UPON REQUEST
- THE CONTRACTOR SHALL PROTECT ALL MAJOR TREES FROM DAMAGE. NO TREE SHALL BE REMOVED WITHOUT PERMISSION OF THE OWNER, UNLESS SHOWN OTHERWISE
- CLEARING AND GRUBBING OPERATIONS AND DISPOSAL OF ALL DEBRIS THEREFROM SHALL BE PERFORMED BY THE CONTRACTOR IN STRICT ACCORDANCE WITH ALL LOCAL CODES AND ORDINANCES.
- ALL WASTE MATERIAL RESULTING FROM THE PROJECT SHALL BE DISPOSED OF OFF-SITE BY THE CONTRACTOR, OR AS DIRECTED BY THE OWNER. ALL EXCAVATIONS SHALL BE UNCLASSIFIED. NO SEPARATE PAYMENT WILL BE MADE FOR ROCK
- THE CONTRACTOR SHALL CONTROL THE EROSION AND SILTATION DURING ALL PHASED OF CONSTRUCTION
- AND SHALL KEEP THE STREETS CLEAN OF MUD AND DEBRIS. ALL MANHOLES. CATCH BASINS. UTILITY VALVES AND METER PITS TO BE ADJUSTED OR REBUILT TO GRADE
- THE CONTRACTOR SHALL CONTACT DEVELOPMENT SERVICES INSPECTIONS AT: 816-969-1200 TO OBTAIN A
- THE CONTRACTOR SHALL CONTACT THE RIGHT OF WAY INSPECTOR AT 816-969-1800 PRIOR TO ANY LAND
- DISTURBANCE ACTIVITIES WITHIN THE RIGHT OF WAY. THESE ACTIVITIES MAY REQUIRE A PERMIT. THE CONTRACTOR SHALL PROVIDE AND MAINTAIN ALL TRAFFIC HANDLING MEASURES NECESSARY TO ENSURE THAT THE GENERAL PUBLIC IS PROTECTED AT ALL TIMES. TRAFFIC CONTROL SHALL CONFORM TO THE MANUAL ON UNIFORM TRAFFIC CONTROL DEVICES (MUTCD-LATEST EDITION).

1. ALL STREET CONSTRUCTION SHALL BE IN ACCORDANCE WITH THE LATEST EDITION OF THE CITY OF LEE'S

3. ALL INSPECTION OF STREET CONSTRUCTION TO BE PERFORMED BY THE CITY OF LEE'S SUMMIT

11. ALL ADA SIDEWALK RAMPS SHALL BE CONSTRUCTED BY THE DEVELOPER WITH THE PUBLIC

4. CURB RETURN RADII SHALL BE 30' AT BACK OF CURB UNLESS OTHERWISE NOTED.

SUBGRADE TO BE COMPACTED TO 95% STANDARD PROCTOR DENSITY.

ASSUMED DESIGN SPEED = 30 MPH (RESIDENTIAL COLLECTOR).

8. MINIMUM K, SAG CURVE = 37 (20 WITH LIGHTING), CREST CURVE = 19.

MINIMUM STOPPING SIGHT DISTANCE = 200 FEET.

9. GRADE INTERSECTIONS TO DRAIN AS SHOWN.

SUMMIT DESIGN AND CONSTRUCTION MANUAL. ALL APPLICABLE AASHTO STANDARDS HAVE BEEN MET.

2. THE CONTRACTOR IS RESPONSIBLE FOR VERIFYING ALL EXISTING UTILITY LOCATIONS PRIOR TO EXCAVATION.

#### **GENERAL NOTES:**

- ALL CONSTRUCTION TO FOLLOW THE CITY OF LEE'S SUMMIT DESIGN AND CONSTRUCTION MANUAL AS ADOPTED BY ORDINANCE 5813.
- ALL WORKMANSHIP AND MATERIALS SHALL BE SUBJECT TO THE INSPECTION AND APPROVAL OF THE
- ENGINEERING DEPARTMENT OF THE CITY OF LEE'S SUMMIT, MISSOURI. LINEAL FOOT MEASUREMENTS SHOWN ON THE PLANS ARE HORIZONTAL MEASUREMENTS, NOT SLOPE MEASUREMENTS. ALL PAYMENTS SHALL BE MADE ON HORIZONTAL MEASUREMENTS.
- NO GEOLOGICAL INVESTIGATION HAS BEEN PERFORMED ON THE SITE.
- THE UTILITY LOCATIONS SHOWN ON THESE PLANS ARE TAKEN FROM UTILITY COMPANY RECORDS AND
- INFORMATION FROM, UTILITY COMPANIES. STATE LAW REQUIRES 48 HOURS ADVANCE NOTICE. THE CALL SYSTEM, INC.": 1-800-DIG-RITE. THIS PHONE NUMBER IS APPLICABLE ANYWHERE WITHIN THE STATE OF MISSOURI. PRIOR TO COMMENCEMENT OF WORK, THE CONTRACTOR SHALL NOTIFY ALL THOSE COMPANIES WHICH HAVE FACILITIES IN THE NEAR VICINITY OF THE CONSTRUCTION TO BE PERFORMED
- PRIOR TO ORDERING PRECAST STRUCTURES. SHOP DRAWING SHALL BE SUBMITTED TO THE DESIGN ENGINEER FOR APPROVAL. AFTER APPROVAL OF THE SHOP DRAWINGS, A COPY OF THE APPROVED AND SIGNED SHOP DRAWINGS SHALL BE PROVIDED TO THE CITY INSPECTOR UPON REQUEST.
- THE CONTRACTOR SHALL PROTECT ALL MAJOR TREES FROM DAMAGE. NO TREE SHALL BE REMOVED WITHOUT PERMISSION OF THE OWNER, UNLESS SHOWN OTHERWISE
- CLEARING AND GRUBBING OPERATIONS AND DISPOSAL OF ALL DEBRIS THEREFROM SHALL BE PERFORMED
- BY THE CONTRACTOR IN STRICT ACCORDANCE WITH ALL LOCAL CODES AND ORDINANCES.
- ALL WASTE MATERIAL RESULTING FROM THE PROJECT SHALL BE DISPOSED OF OFF-SITE BY THE CONTRACTOR, OR AS DIRECTED BY THE OWNER.
- THE CONTRACTOR SHALL CONTROL THE EROSION AND SILTATION DURING ALL PHASED OF CONSTRUCTION
- AND SHALL KEEP THE STREETS CLEAN OF MUD AND DEBRIS ALL MANHOLES, CATCH BASINS, UTILITY VALVES AND METER PITS TO BE ADJUSTED OR REBUILT TO GRADE
- THE CONTRACTOR SHALL CONTACT DEVELOPMENT SERVICES INSPECTIONS AT: 816-969-1200 TO OBTAIN A
- THE CONTRACTOR SHALL CONTACT THE RIGHT OF WAY INSPECTOR AT 816-969-1800 PRIOR TO ANY LAND DISTURBANCE ACTIVITIES WITHIN THE RIGHT OF WAY. THESE ACTIVITIES MAY REQUIRE A PERMIT.
- 16. THE CONTRACTOR SHALL PROVIDE AND MAINTAIN ALL TRAFFIC HANDLING MEASURES NECESSARY TO ENSURE THAT THE GENERAL PUBLIC IS PROTECTED AT ALL TIMES. TRAFFIC CONTROL SHALL CONFORM TO THE MANUAL ON UNIFORM TRAFFIC CONTROL DEVICES (MUTCD-LATEST EDITION)

#### **COVER SHEET** GRADING PLAN FULL SITE 2 PRE-CONSTRUCTION EROSION CONTROL PLAN **EROSION CONTROL PLAN** POST-CONSTRUCTION EROSION CONTROL PLAN **EROSION CONTROL DETAILS EROSION CONTROL DETAILS** 8 OUTLET STRUCTURE 801 9 **OUTLET STRUCTURE 2401 OUTLET STRUCTURE 201**

**Sheet List Table** 

Sheet Title

**Sheet Number** 

PREPARED BY

MARK ALLEN BREUER MUMBER PE-2009007268 05.30.2023

SCHLAGEL & ASSOCIATES, P.A.

RVE MENT

ШШ

#### OWNER/DEVELOPER

**APPROVED BY** 

CITY ENGINEER

GRIFFIN RILEY PROPERTY GROUP JAKE LOVELESS, VICE PRESIDENT 21 SE 29TH TERRACE LEE'S SUMMIT p 816-366-7900

APPROVED FOR ONE YEAR FROM THIS DATE

JAKE@GRIFFINRILEY.COM

	SUMMARY OF QUANTITIE					
	ITEM	QUANTITY				
1	CLEARING, GRUBBING & DISPOSAL	1				
2	CONSTRUCTION ENTRANCE	1				
3	CONCRETE WASHOUT AREA	1				
4	SILT FENCE (PRIOR TO CONSTRUCTION)	7,470				
5	SILT FENCE (DURING CONSTRUCTION)	8,504				
6	SEDIMENT BASIN	3				
7	ROCK DITCH CHECK	7				
8	INLET PROTECTION (SILT FENCE)	624				
9	INLET PROTECTION (GRAVEL FILTER BAGS)	28				
10	TURF REINFORCEMENT MAT	21,553				
11	EARTHWORK - TOTAL FOR FULL SITE	294,618				
12	EARTHWORK - TOTAL 3RD PLAT PUBLIC IMPROVEMENTS	72,334				
13	EARTHWORK - TOTAL 3RD PLAT PRIVATE IMPROVEMENTS	222,284				
14	SEEDING & MULCHING	37				

### **UTILITIES**

- EXISTING UTILITIES HAVE BEEN SHOWN TO THE GREATEST EXTENT POSSIBLE BASED UPON INFORMATION PROVIDED TO THE ENGINEER. THE CONTRACTOR IS RESPONSIBLE FOR CONTACTING THE RESPECTIVE UTILITY COMPANIES AND FIELD LOCATING UTILITIES PRIOR TO CONSTRUCTION AND IDENTIFYING ANY POTENTIAL CONFLICTS. ALL CONFLICTS SHALL IMMEDIATELY BE BROUGHT TO THE ATTENTION OF THE
- THE CONTRACTOR SHALL BE RESPONSIBLE FOR COORDINATING ANY REQUIRED UTILITY RELOCATIONS. UTILITIES DAMAGED THROUGH THE NEGLIGENCE OF THE CONTRACTOR SHALL BE REPAIRED AT THE
- CONTRACTOR SHALL VERIFY FLOW-LINES AND STRUCTURE TOPS PRIOR TO CONSTRUCTION, AND SHALL NOTIFY ENGINEER OF ANY DISCREPANCIES. PROVIDE SHOP DRAWINGS FOR ALL PRECAST AND MANUFACTURED UTILITY STRUCTURES FOR REVIEW BY THE ENGINEER PRIOR TO CONSTRUCTION OF THE
- UTILITY SEPARATION: WATERLINES SHALL HAVE A MINIMUM OF 10 FEET HORIZONTAL AND 2 FEET VERTICAL SEPARATION FROM ALL SANITARY SEWER LINES, MANHOLES, AND SANITARY SEWER SERVICE LATERALS, AS MEASURED FROM EDGE TO EDGE. IF MINIMUM SEPARATIONS CAN NOT BE OBTAINED, CONCRETE
- ENCASEMENT OF THE SANITARY LINE SHALL BE REQUIRED 10 FEET IN EACH DIRECTION OF THE CONFLICT. PAYMENT FOR TRENCHING, BACKFILLING, PIPE EMBEDMENT, FLOWABLE FILL, BACKFILL MATERIALS, CLEAN UP, SEEDING, SODDING AND ANY OTHER ITEMS NECESSARY FOR THE CONSTRUCTION OF THE UTILITY LINE
- SHALL BE INCLUDED IN THE CONTRACT PRICE FOR THE UTILITY INSTALLATION. THE CONTRACTOR SHALL BE RESPONSIBLE FOR CONTACTING RESPECTIVE UTILITY COMPANIES 48-HOURS IN ADVANCE FOR THE INSPECTION OF ANY PROPOSED UTILITY MAIN EXTENSION OR SERVICE LINE OR SERVICE
- CONNECTION TO ANY EXISTING MAIN. TRENCH SPOILS SHALL BE NEATLY PLACED ONSITE ADJACENT TO THE TRENCH, AND COMPACTED TO PREVENT SATURATION AND EXCESS SEDIMENT RUNOFF. UNSUITABLE MATERIALS, EXCESS ROCK AND SHALE, ASPHALT, CONCRETE, TREES, BRUSH ETC. SHALL BE PROPERLY DISPOSED OF OFFSITE. MATERIALS MAY BE WASTED ONSITE AT THE DIRECTION OF THE OWNER OR HIS APPOINTED REPRESENTATIVE.

#### MO GRS BENCHMARK:

STATION NAME - JA-90

KC METRO ALUMINUM GRS DISK SET IN CONCRETE STAMPED "JA-90, 1988" LOCATED NEAR THE INTERSECTION OF LANGSFORD ROAD AND OLD LANGSFORD ROAD, 43 FEET SOUTHEAST OF THE CENTER OF LANGSFORD ROAD AND 32 FEET NORTH OF THE CENTER OF OLD LANGSFORD ROAD. N:1001052.8503, E:2845604.8272


ELEV. 997.045

#### PROJECT BENCHMARK:


"SQUARE" CUT IN TOP OF CONCRETE STORM MANHOLE STORM MANHOLE IS LOCATED APPROX. 130 FEET EAST OF THE INTERSECTION OF SE JOEL AVE & BLUE PARKWAY AND 26 FEET SOUTH OF THE CENTERLINE OF BLUE PARKWAY. N:996874.9690, E:2840937.1365

ELEV. 1005.719

**COVER SHEET** 

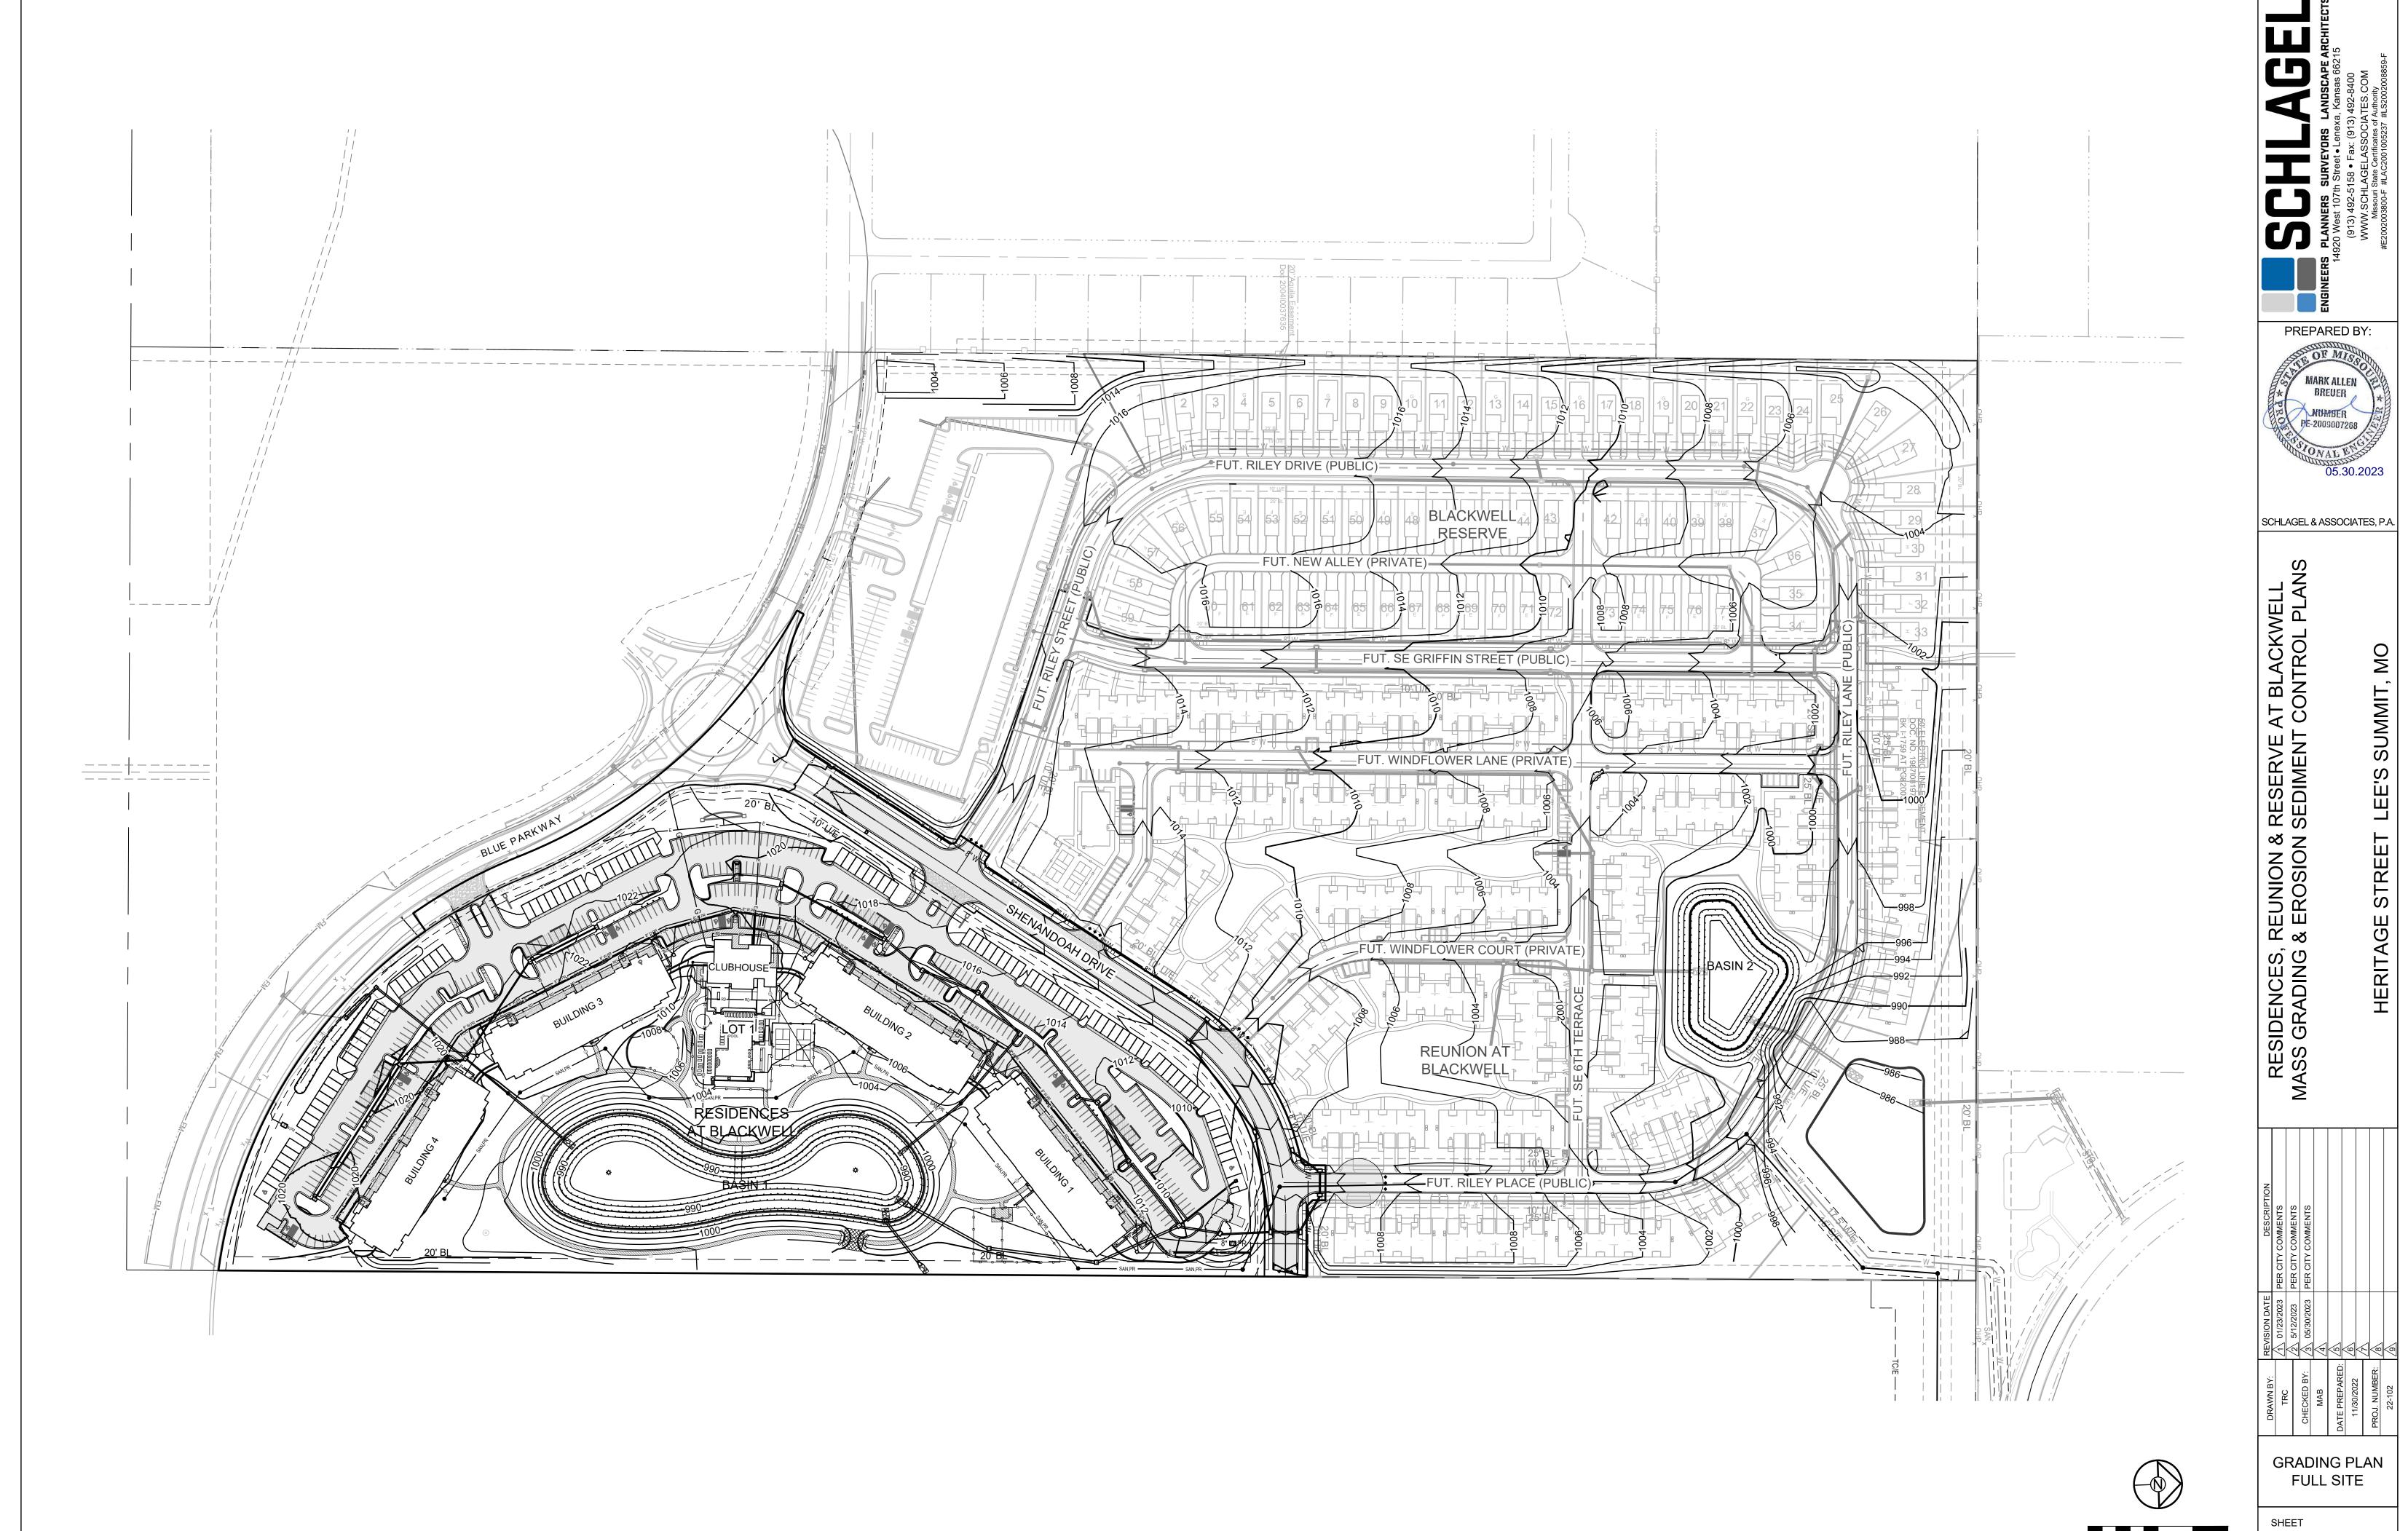

SCALE: 1" = 100'

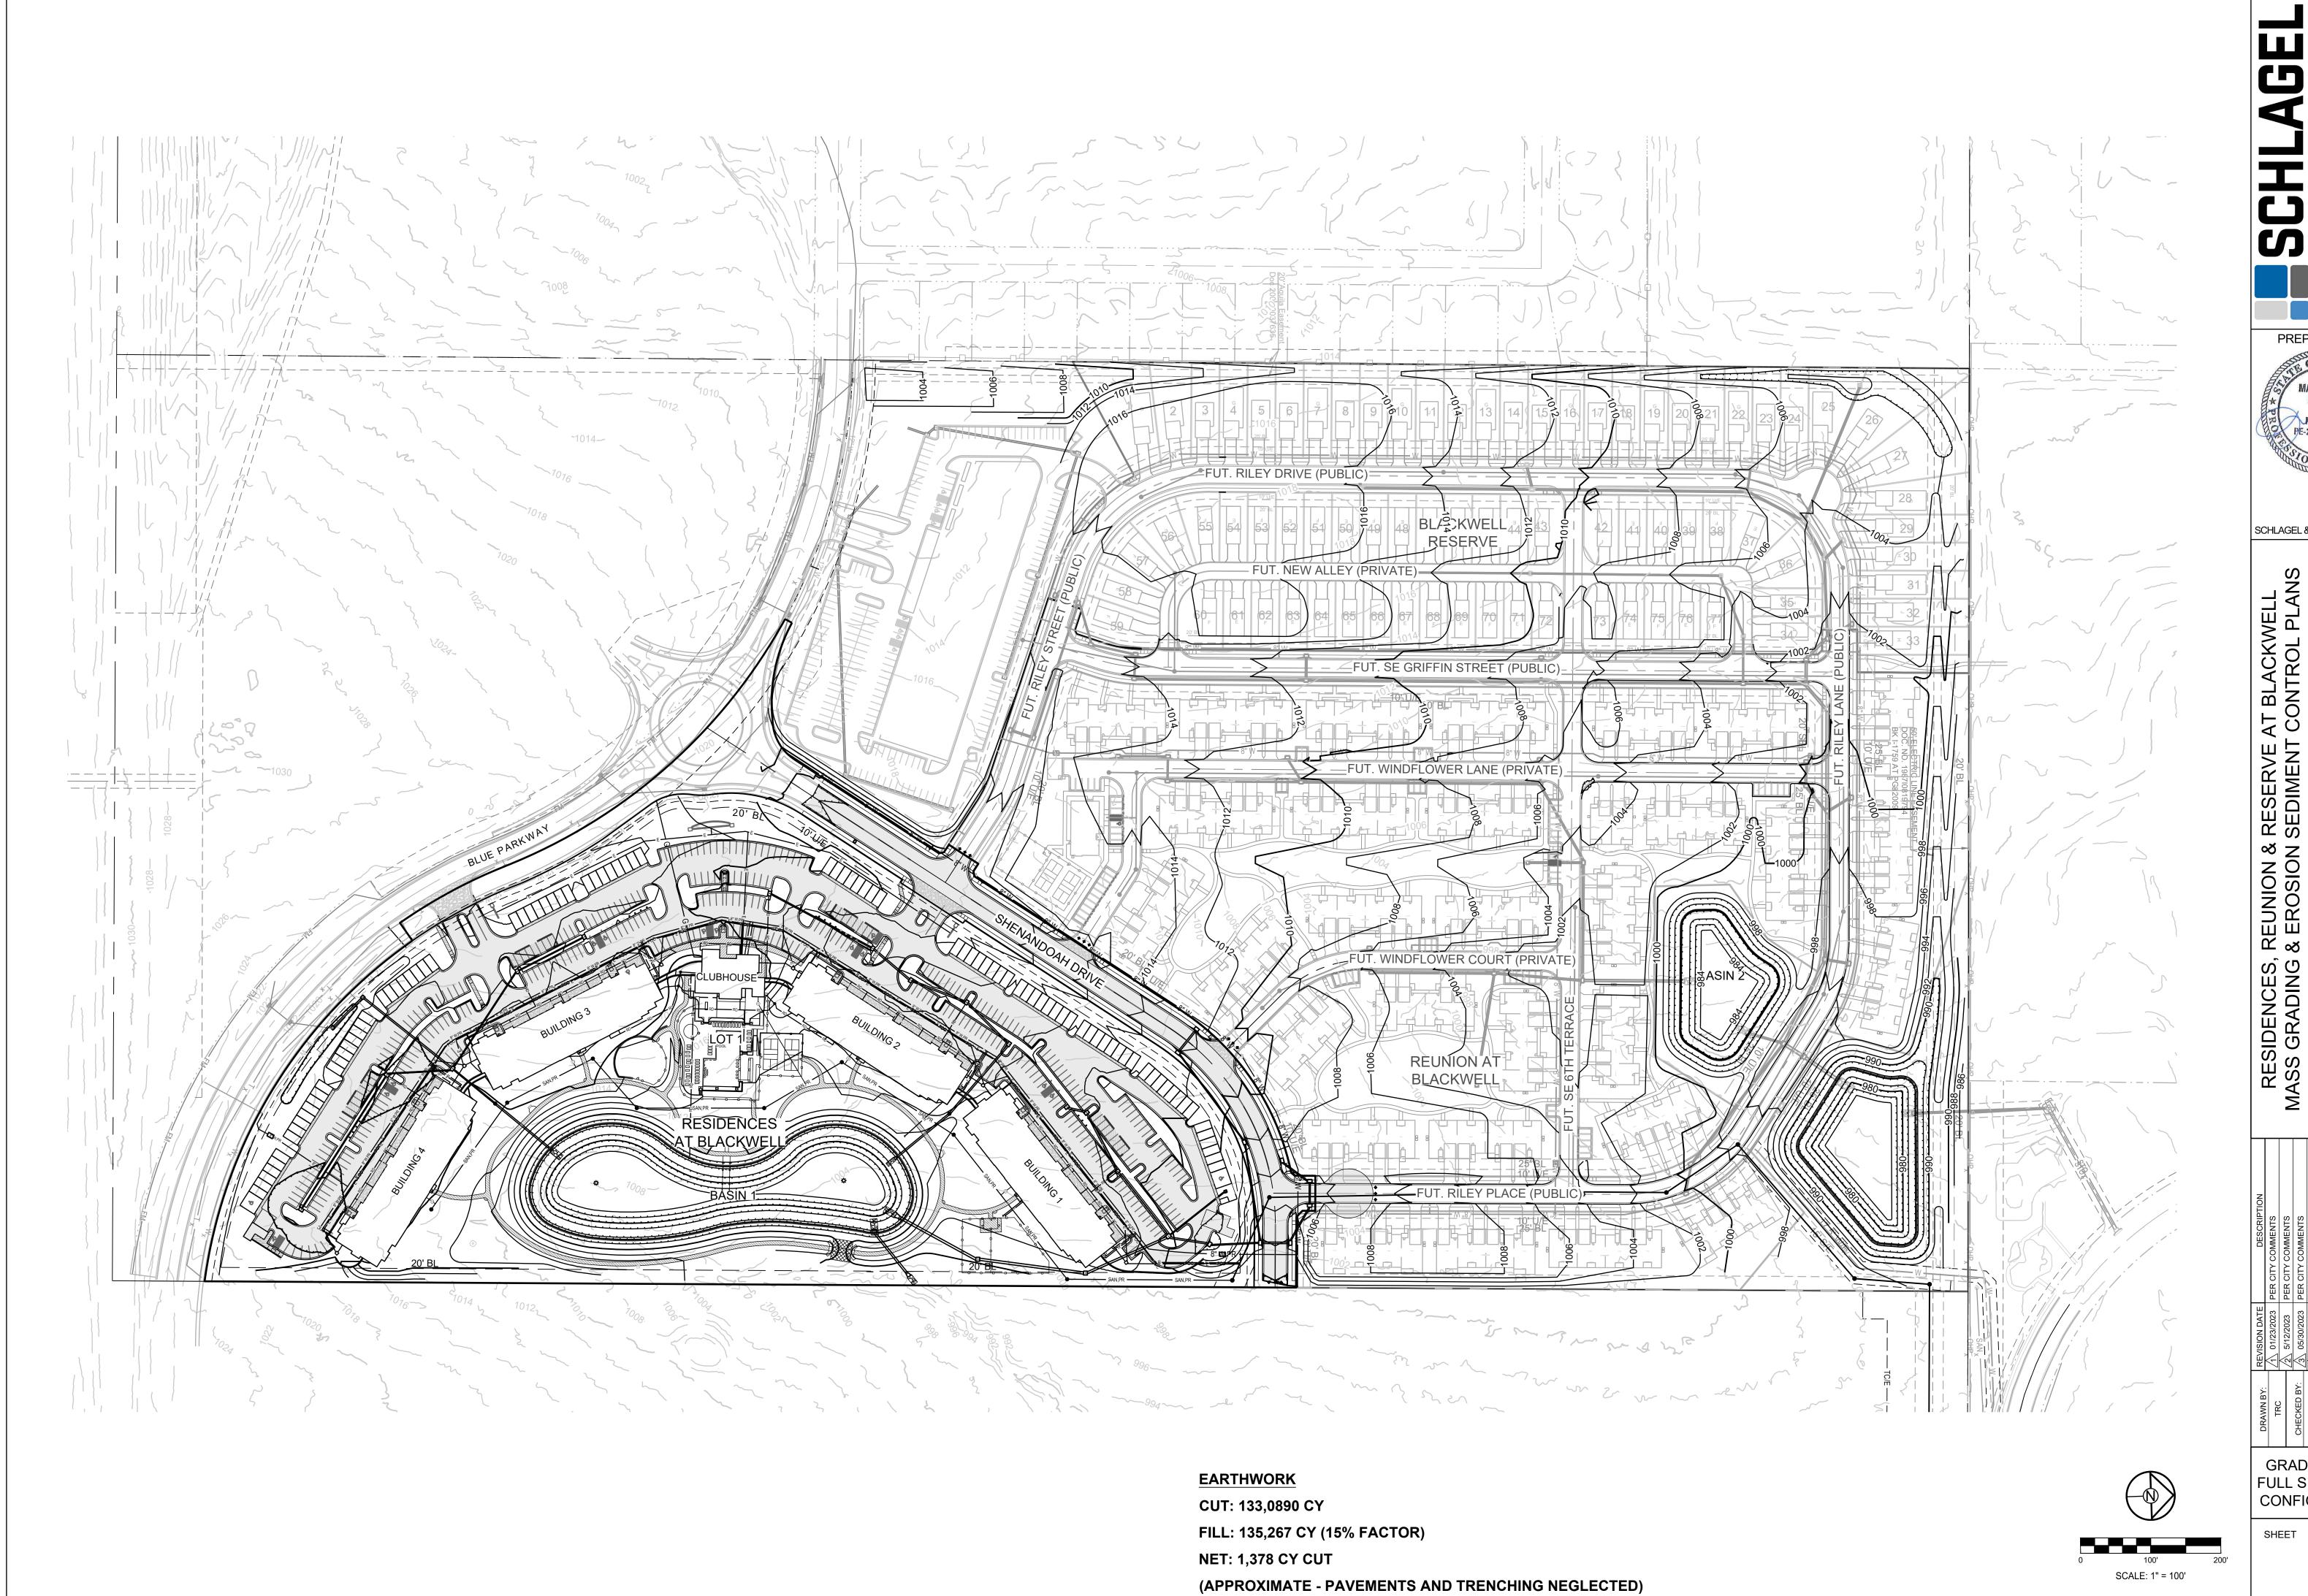

PLANS

BURNIERS SI

BURNIERS SI

CONTROL

CONTRO

ROSION SEDIMENT CONTROL PLA


ER CITY COMMENTS

THE CITY COMME

GRADING PLAN
FULL SITE - FINAL
CONFIGURATION

CONFIGURATI

3

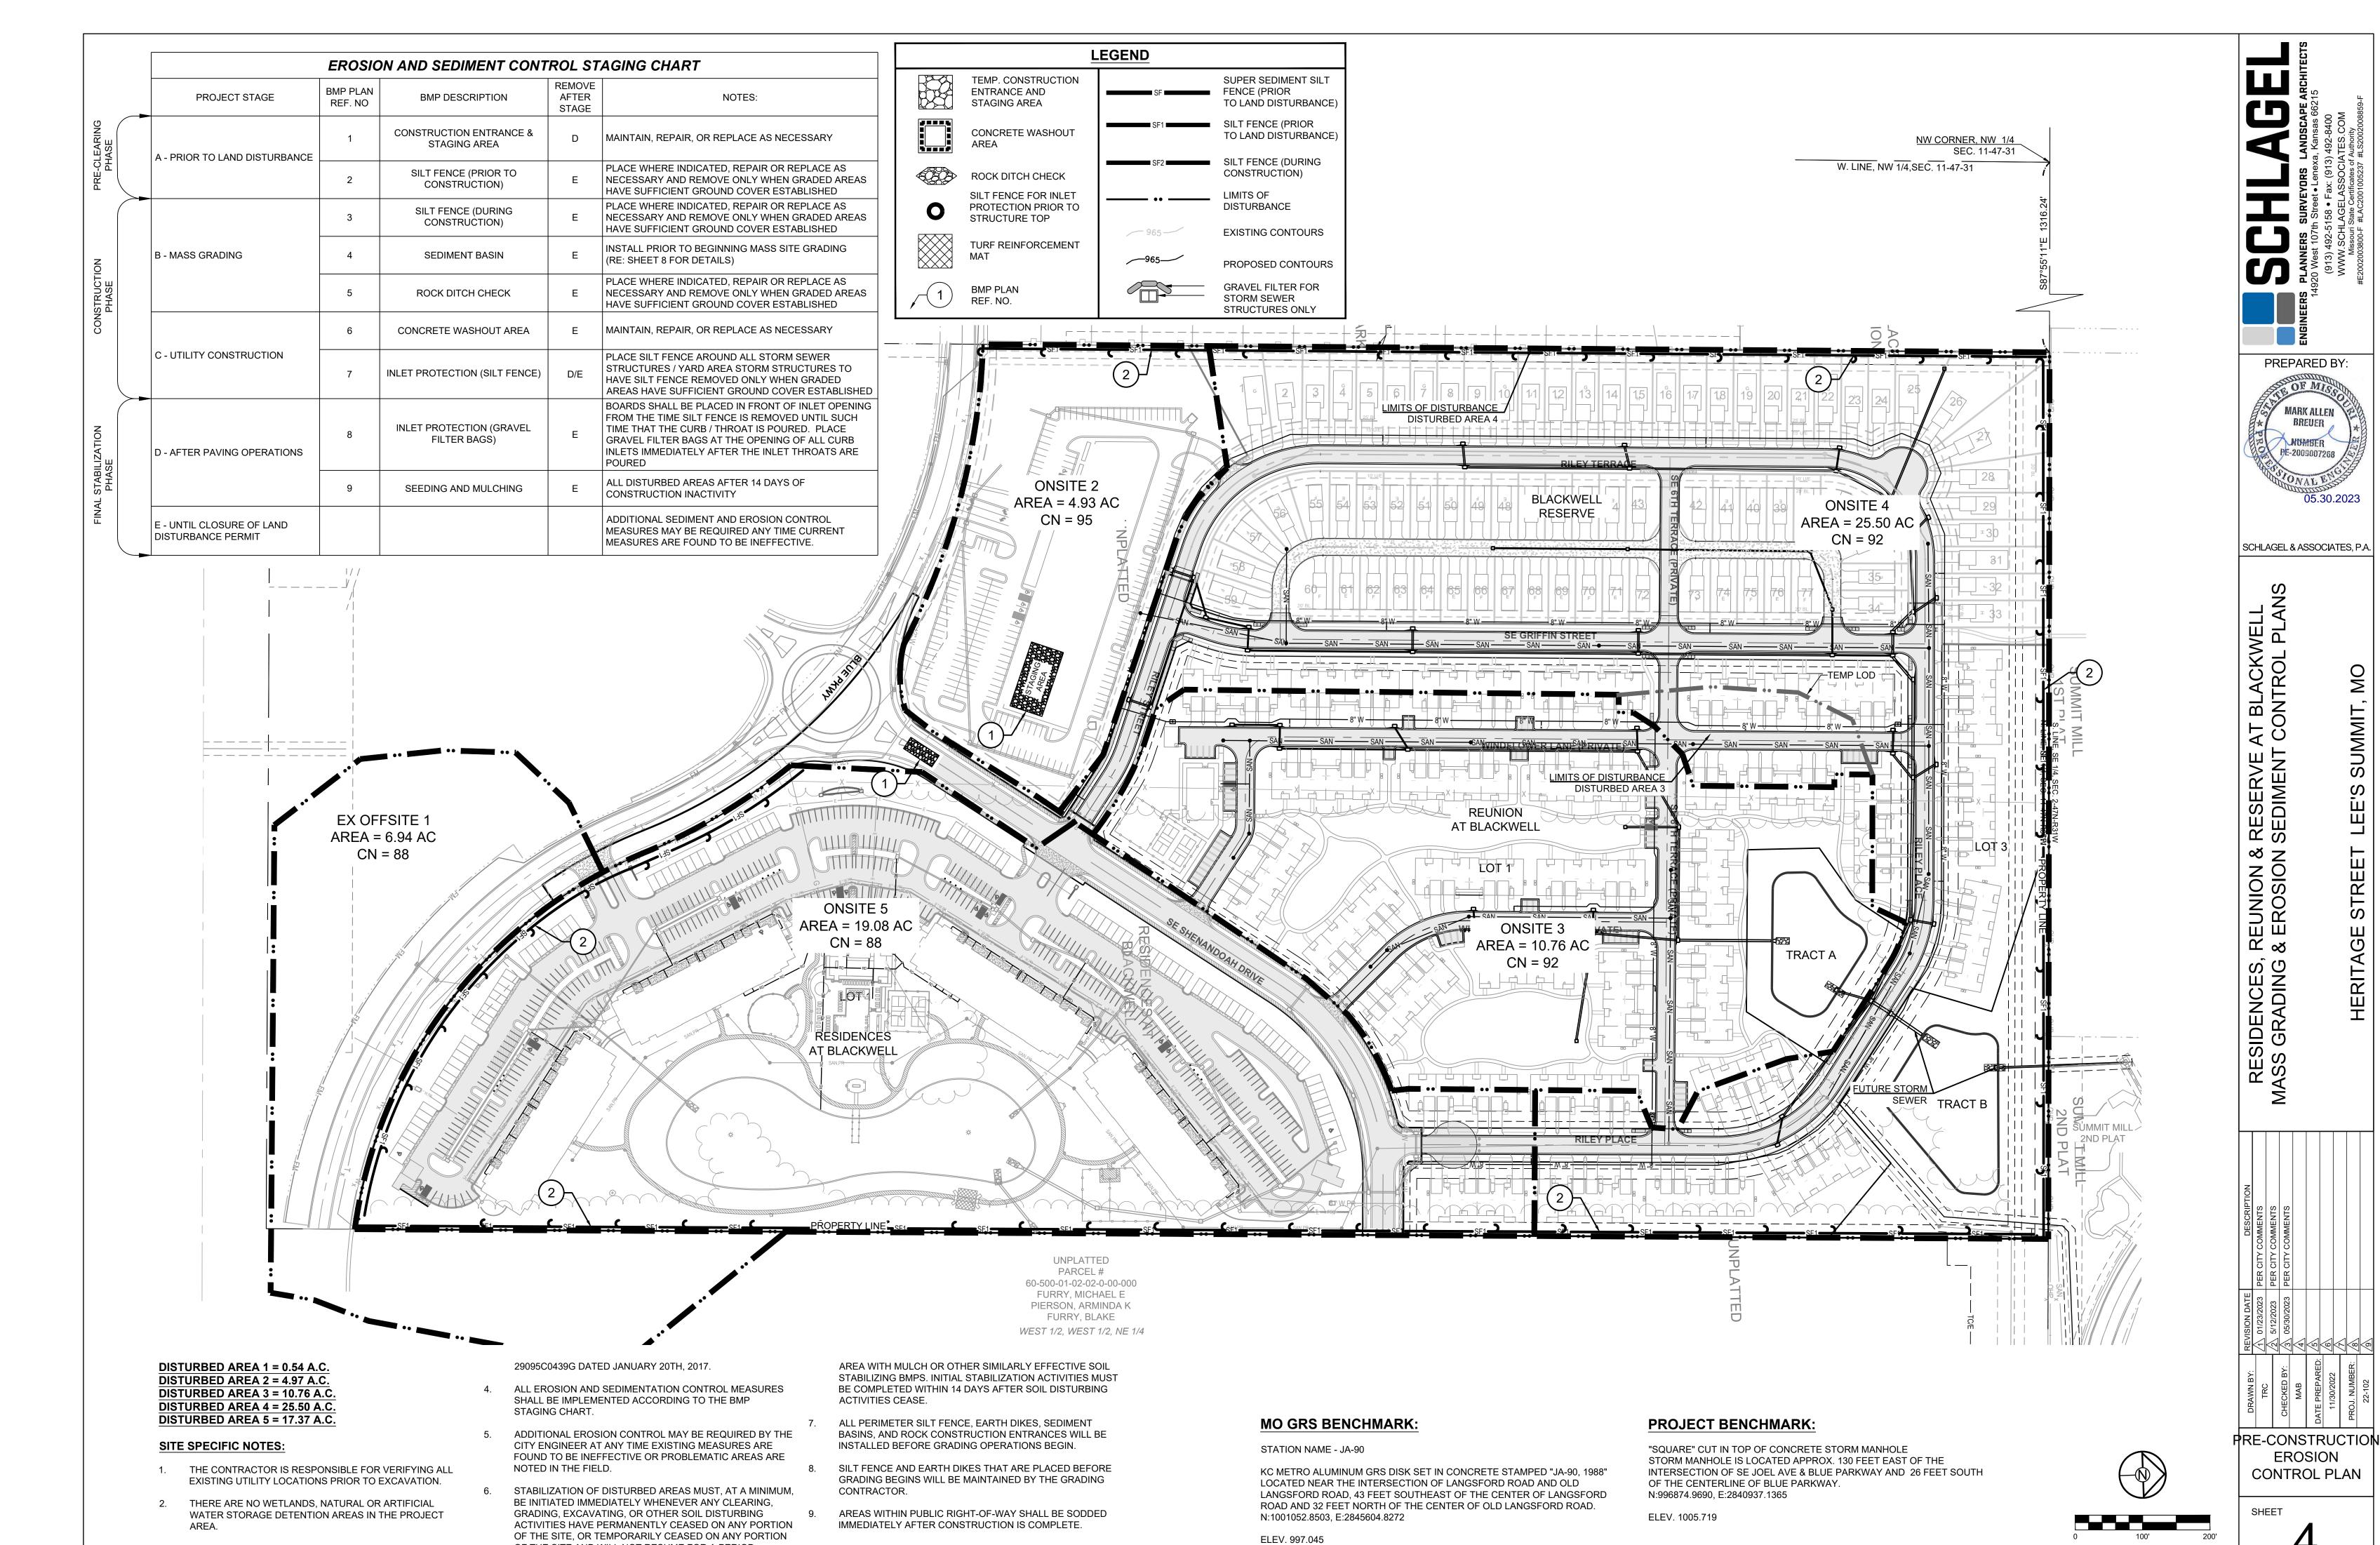

SCALE: 1" = 100'

I:\PROJECTS\2022\22-102\3.0 Design\3.0 DWG Plans\5.0 LD\22-102 - L

OF THE SITE AND WILL NOT RESUME FOR A PERIOD


EXCEEDING 14 CALENDAR DAYS. THE DISTURBED AREAS

SHALL BE PROTECTED FROM EROSION BY STABILIZING THE

NO PART OF THE PROJECT LIES WITHIN THE 100 YEAR

FLOOD PLAIN PER FEMA FLOOD INSURANCE RATE MAP

NUMBERS 29095C0441G, 29095C0445G, 29095C0437G AND

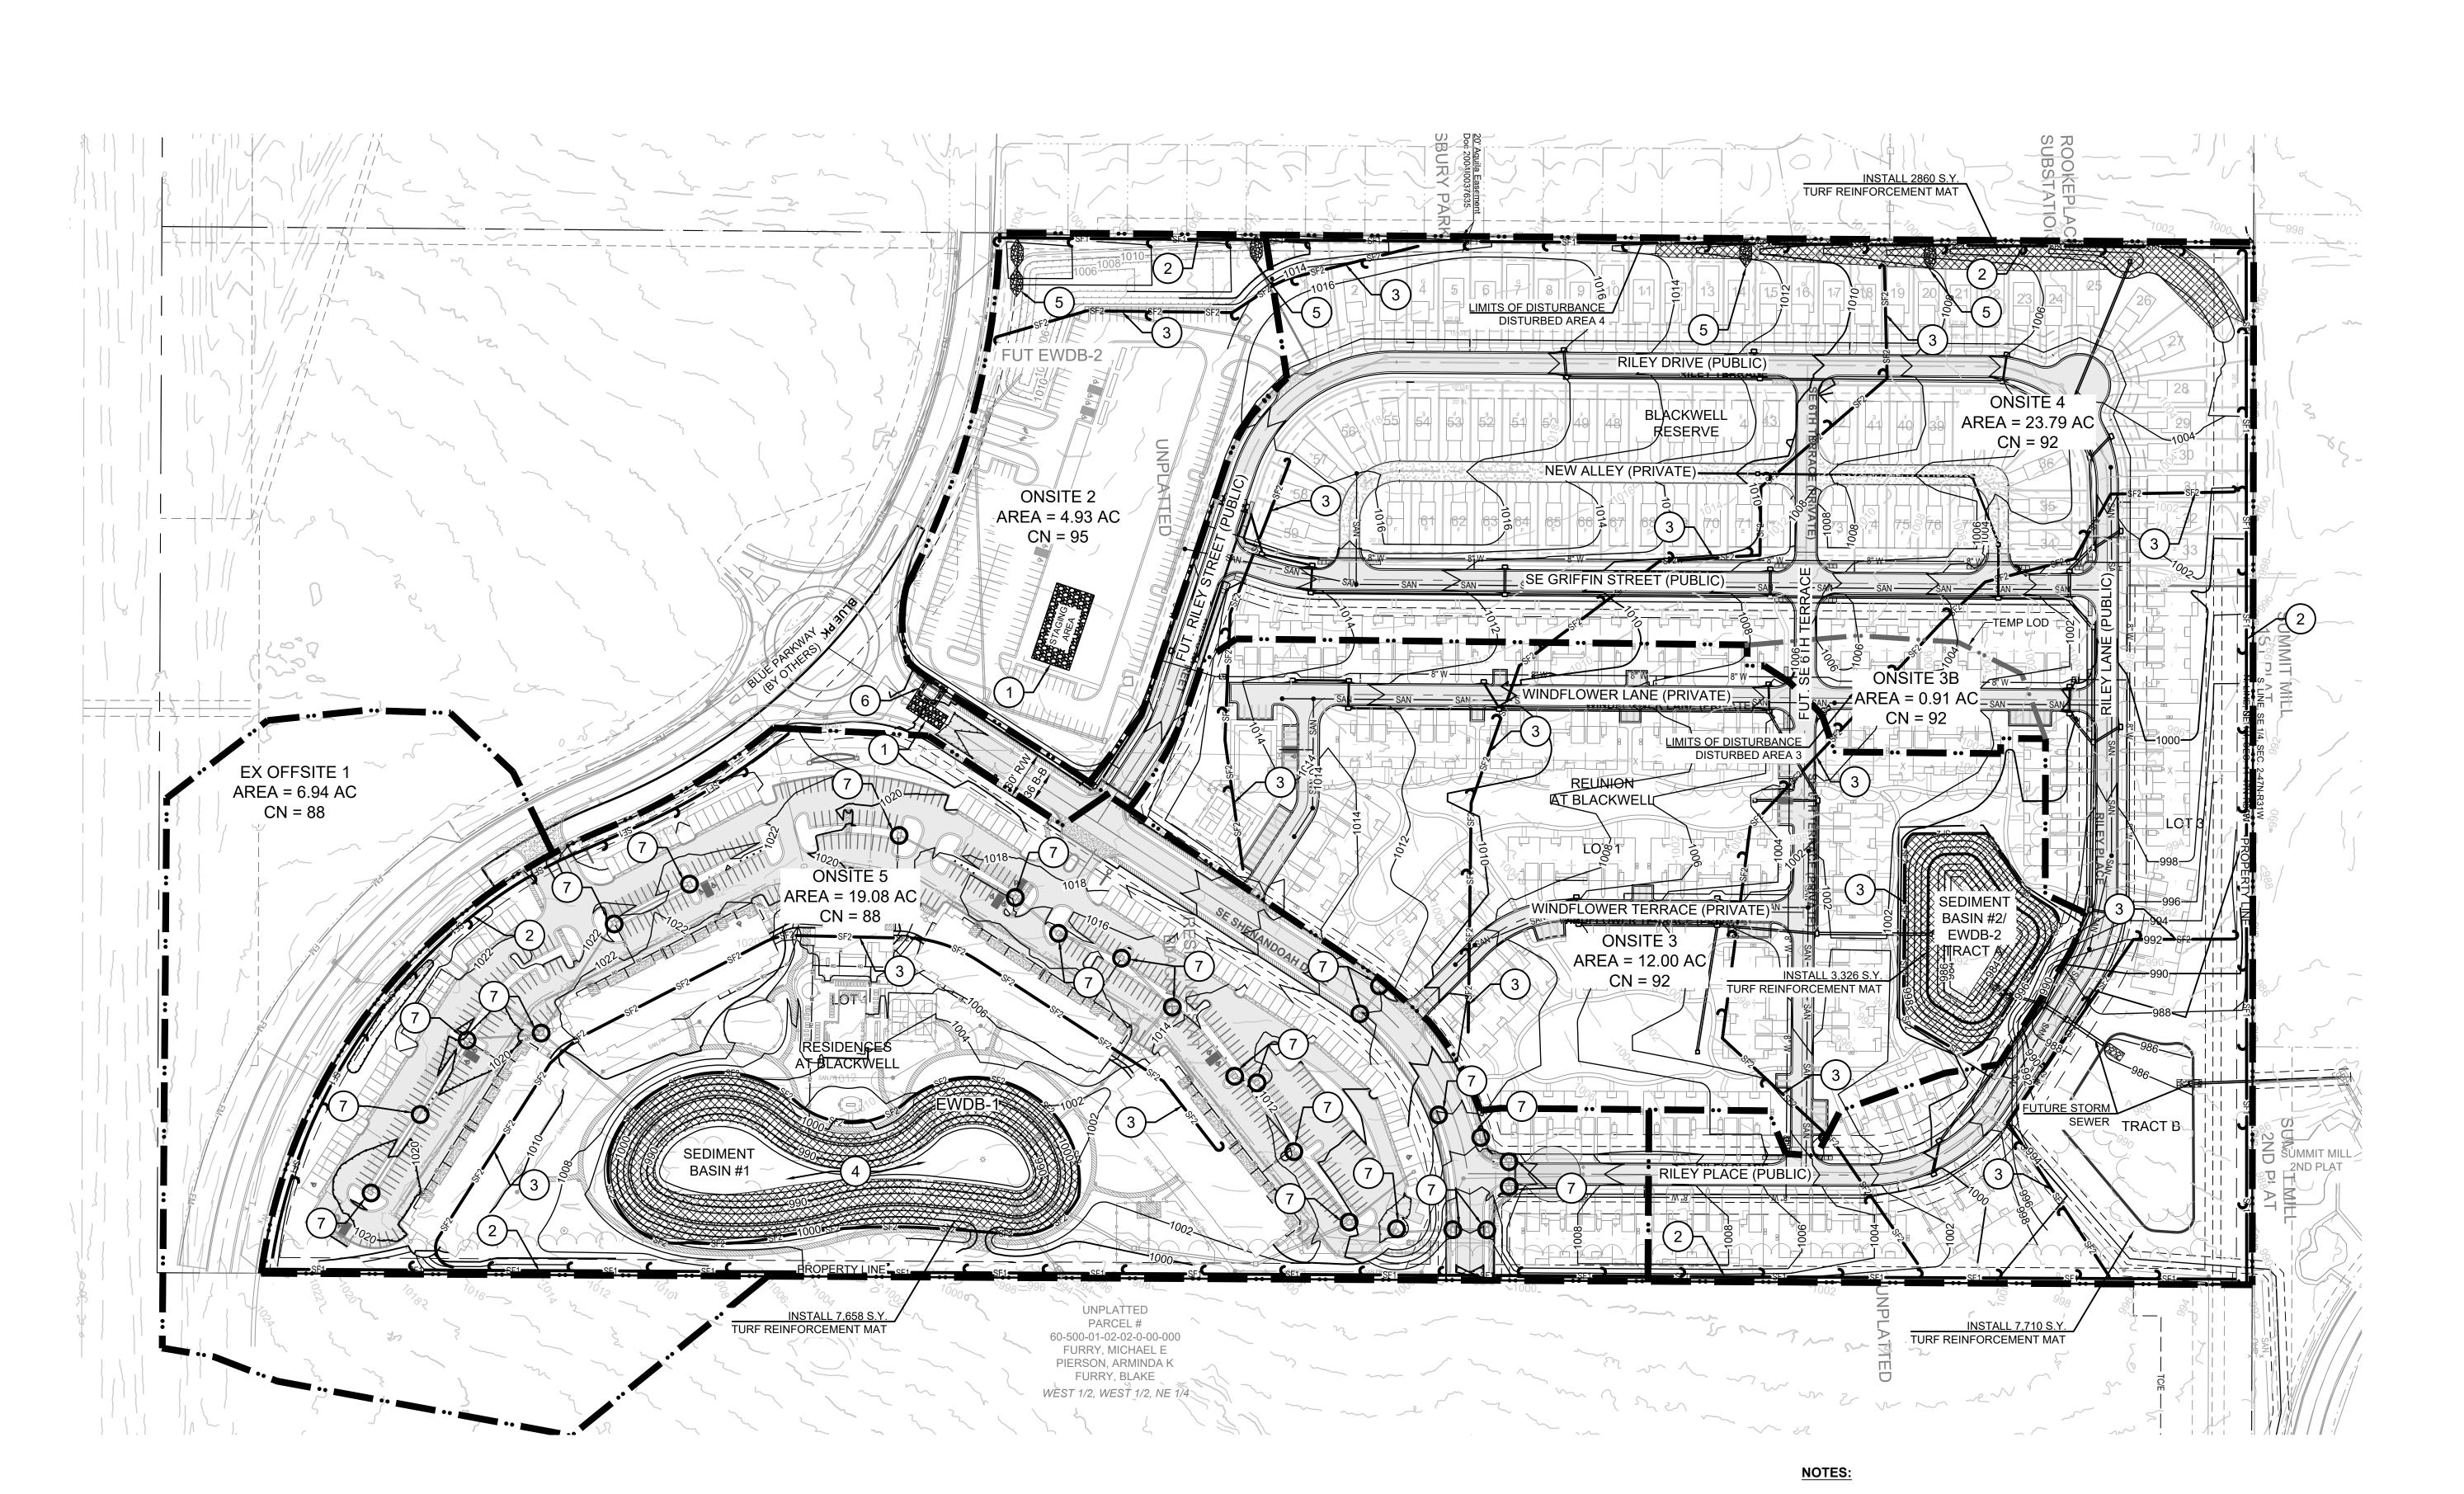

REUNION & & EROSION &

PREPARED BY:

MOMBER PE-2009007268

SCHLAGEL & ASSOCIATES, P.A.

05.30.2023

RESIDENCES, F MASS GRADING 8

TRC			CHECKED BY:	MAB	DATE PREPARED:	11/30/2022	11,30/2022	PROJ. NUMBER:	000
7		7	ED BY:	B	Z GARED: 7	7	7	JMBER:	2
$1 \setminus 01/23/20$	C (17/7)	Z\ 2\ 12\Z\Z	3 05/30/20	1 1	5	9	<u></u>	8	<

**EROSION** CONTROL PLAN

SHEET

SCALE: 1" = 100'

1. SEE SHEET 4 FOR EROSION CONTROL NOTES, LEGEND AND


BASIN #3 SHALL BE INSTALLED AND SEDIMENT BASIN #2

2. SEDIMENT BASIN #2 SHALL BE INSTALLED AND UTILIZED UNTIL

SUCH TIME THAT THE 20' D/E DOWNSTREAM OF SEDIMENT BASIN #3 IS ACQUIRED. UPON DEDICATION OF SAID 20' D/E SEDIMENT


STAGING CHART.

CONVERTED TO AN EWDB.

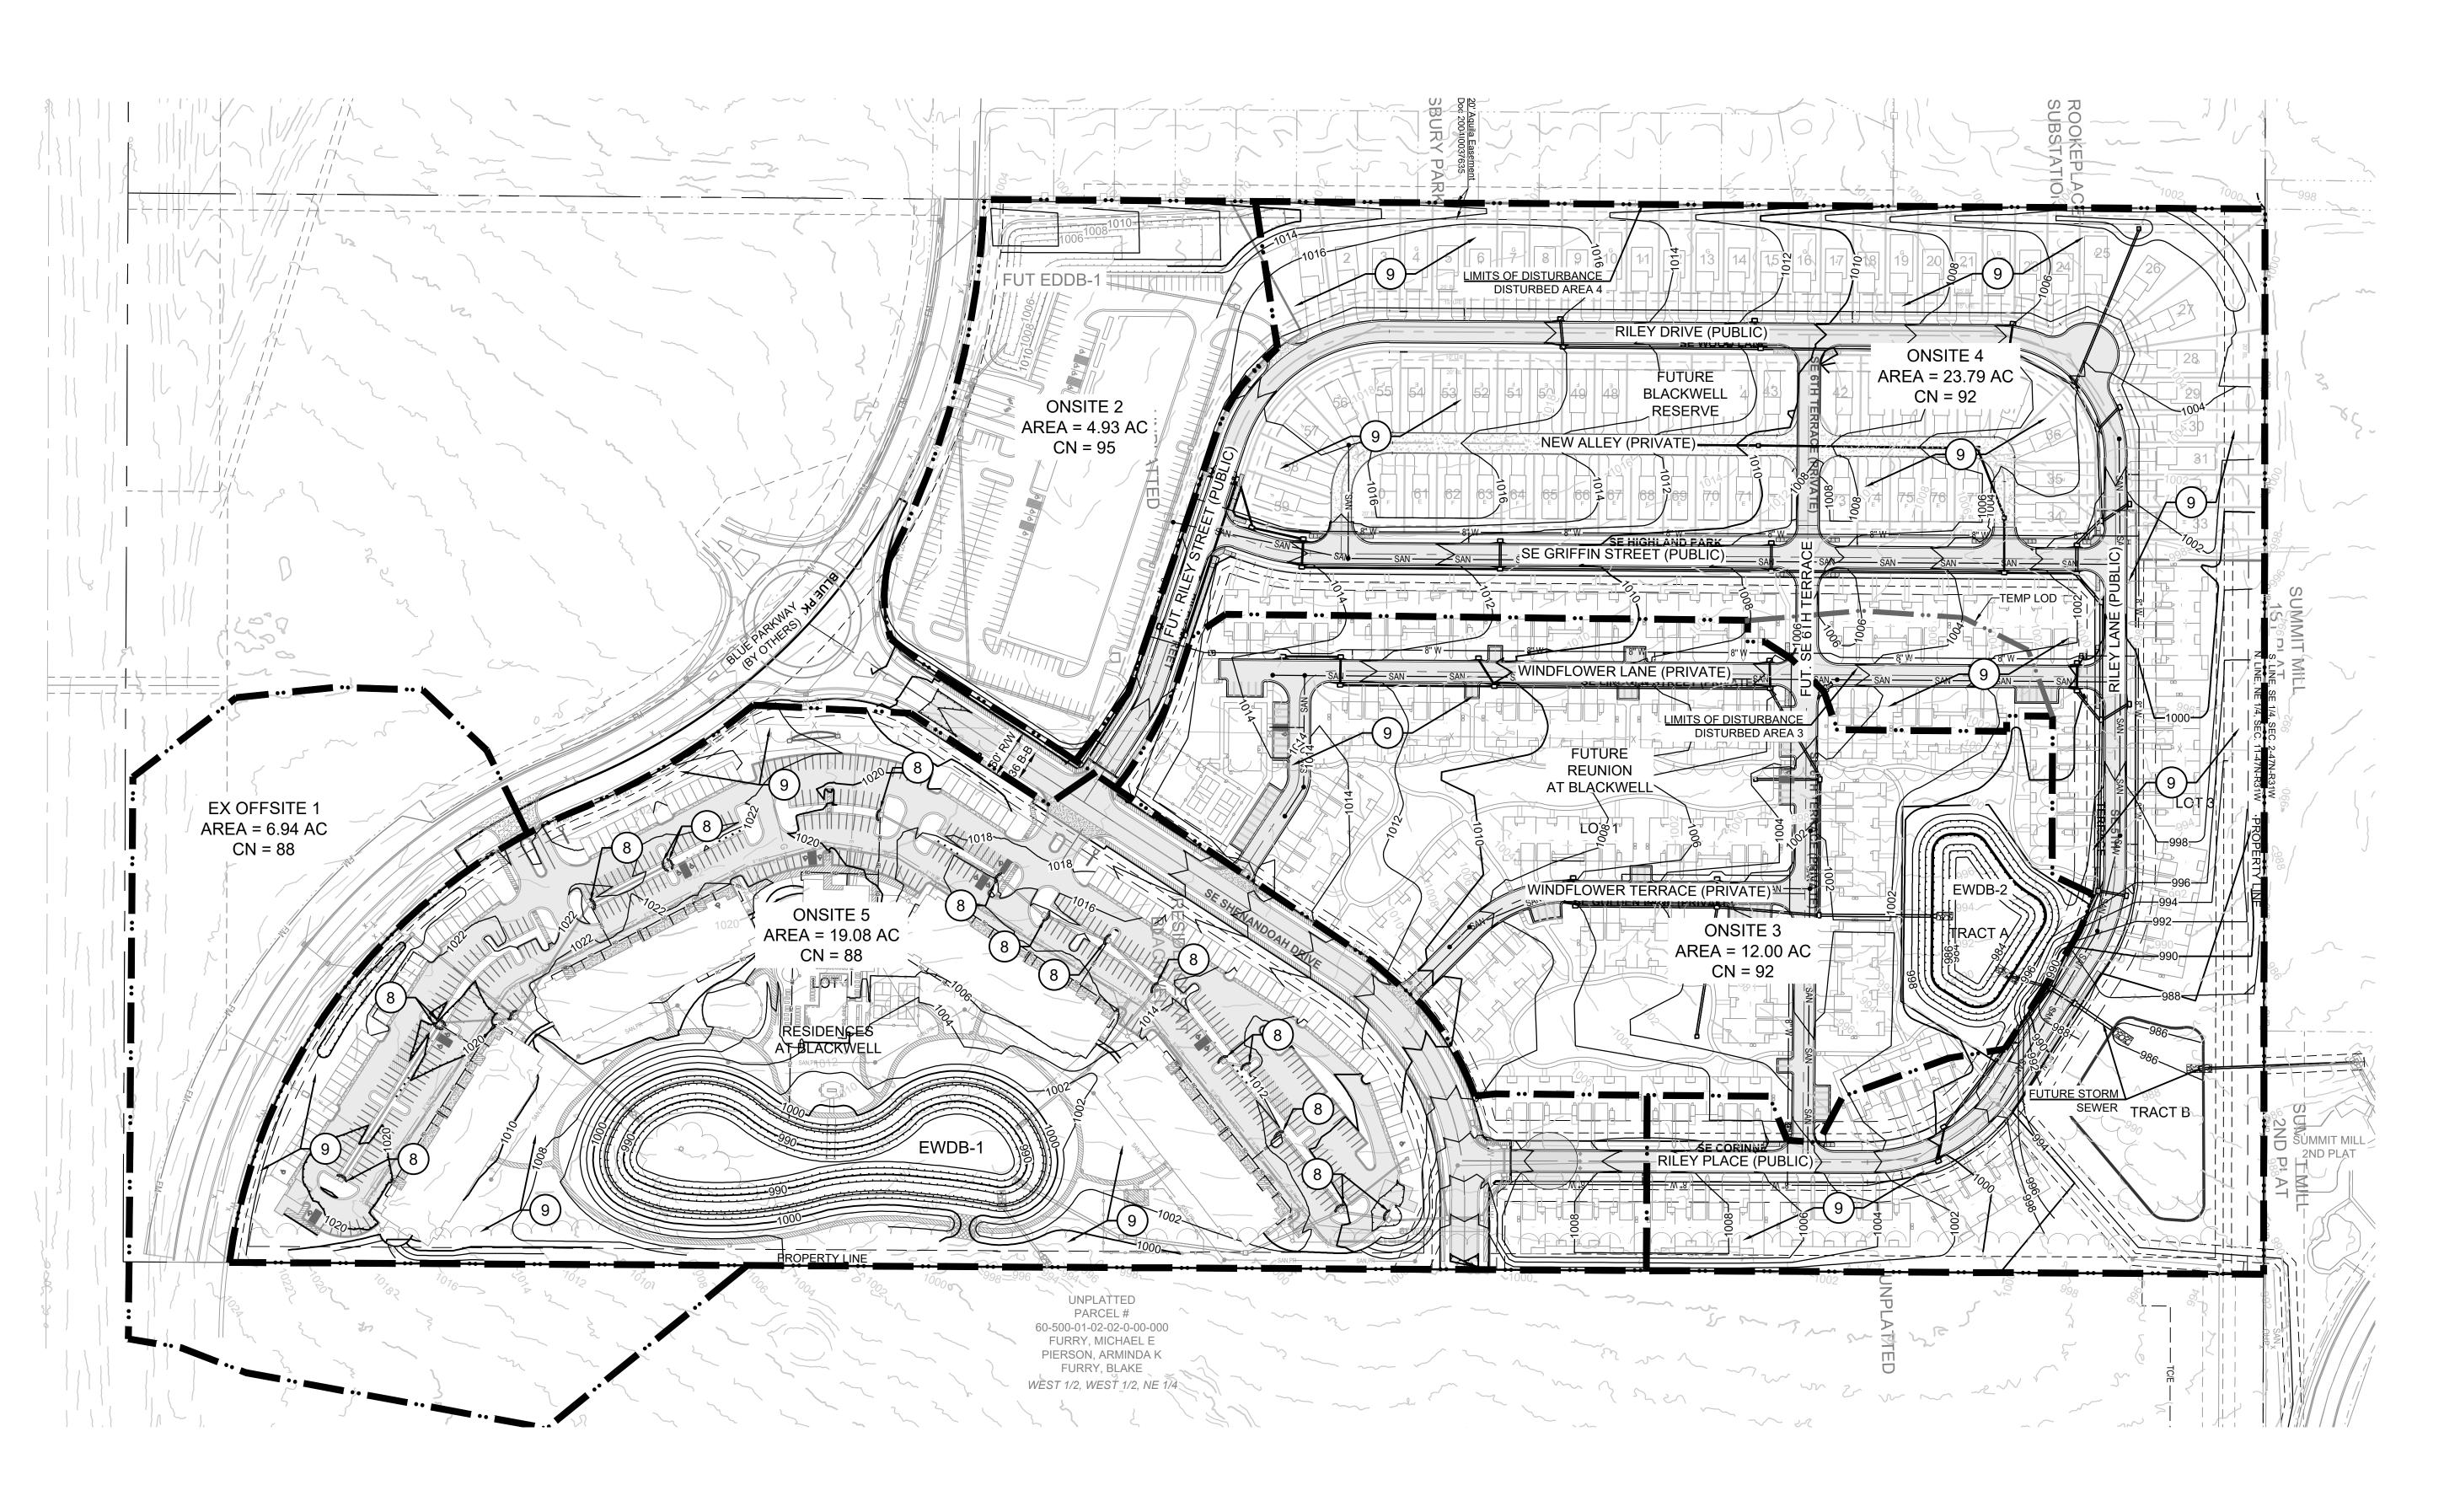

NOTE:

SEE SHEET 4 FOR EROSION CONTROL NOTES, LEGEND AND STAGING CHART.

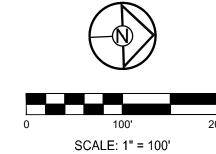

	щ		_	ш			
REVISION DATE	1 01/23/2023	\ E14010000	SZ0Z/Z1/6 \Z/	/3\ 05/30/2023	4	\ <del>\$</del>	<
DRAWN BY:	TRC			CHECKED BY:	MAB	DATE PREPARED:	
				F	90	S	Γ
_(	C	C	١	1S	TF	RU	
			E	F	O	SI	0
(	C	C	١	ΙT	R(	DL	ŀ

JCTION NC L PLAN


PREPARED BY:


SCHLAGEL & ASSOCIATES, P.A.

RESIDENCES, REUNIC BLACKV MASS GRADING & ER CONTROL HERITAGE STREET I

& RESERVE AT




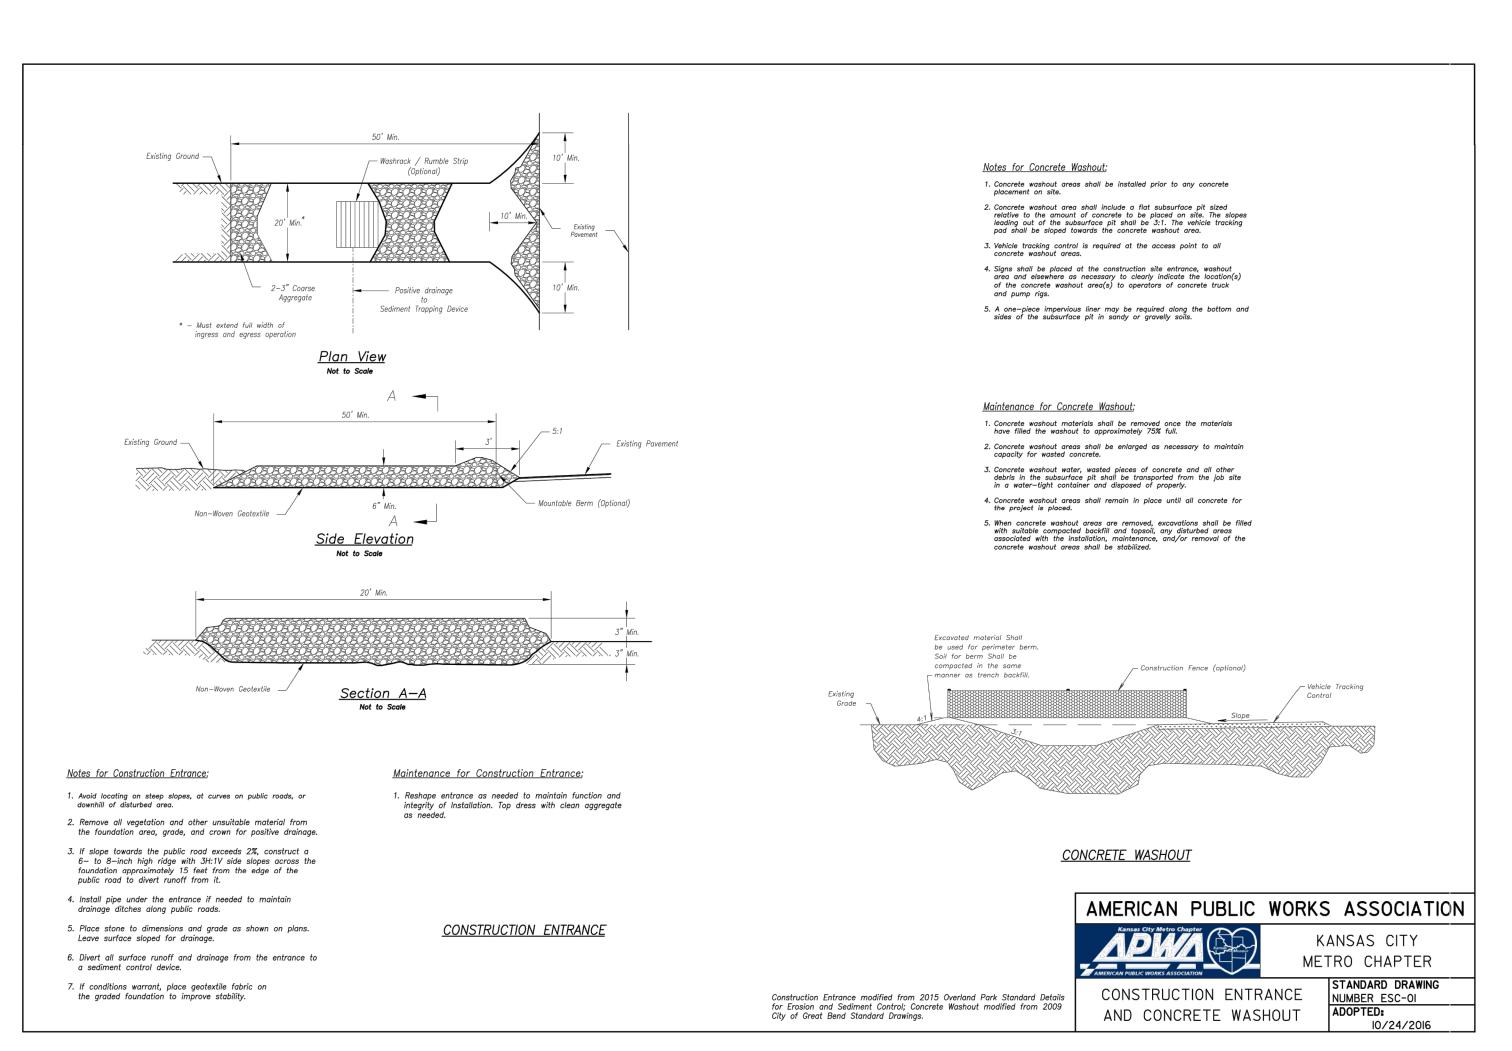


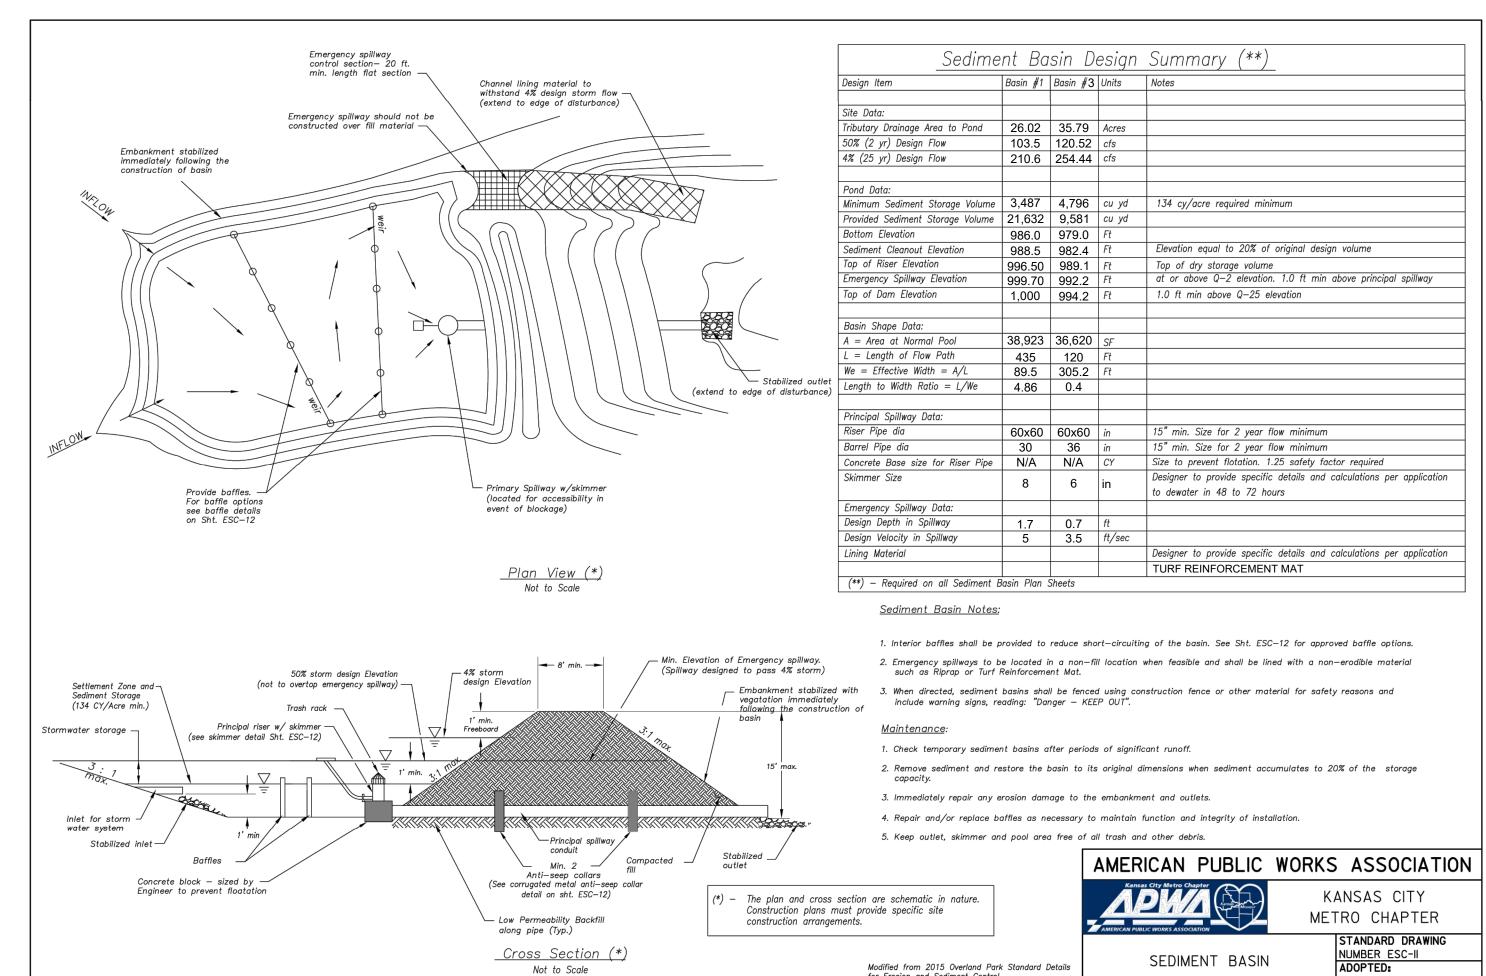

SEDIMENT BASIN #2 SHALL BE INSTALLED AND UTILIZED UNTIL SUCH TIME THAT THE 20' D/E DOWNSTREAM OF SEDIMENT BASIN #3 IS ACQUIRED. DURING THIS TIME NO GRADING ACTIVITIES MAY TAKE PLACE WITHIN SUBCATCHMENT "ONSITE 4." UPON DEDICATION OF SAID 20' D/E SEDIMENT BASIN #3 SHALL BE

for Erosion and Sediment Control.

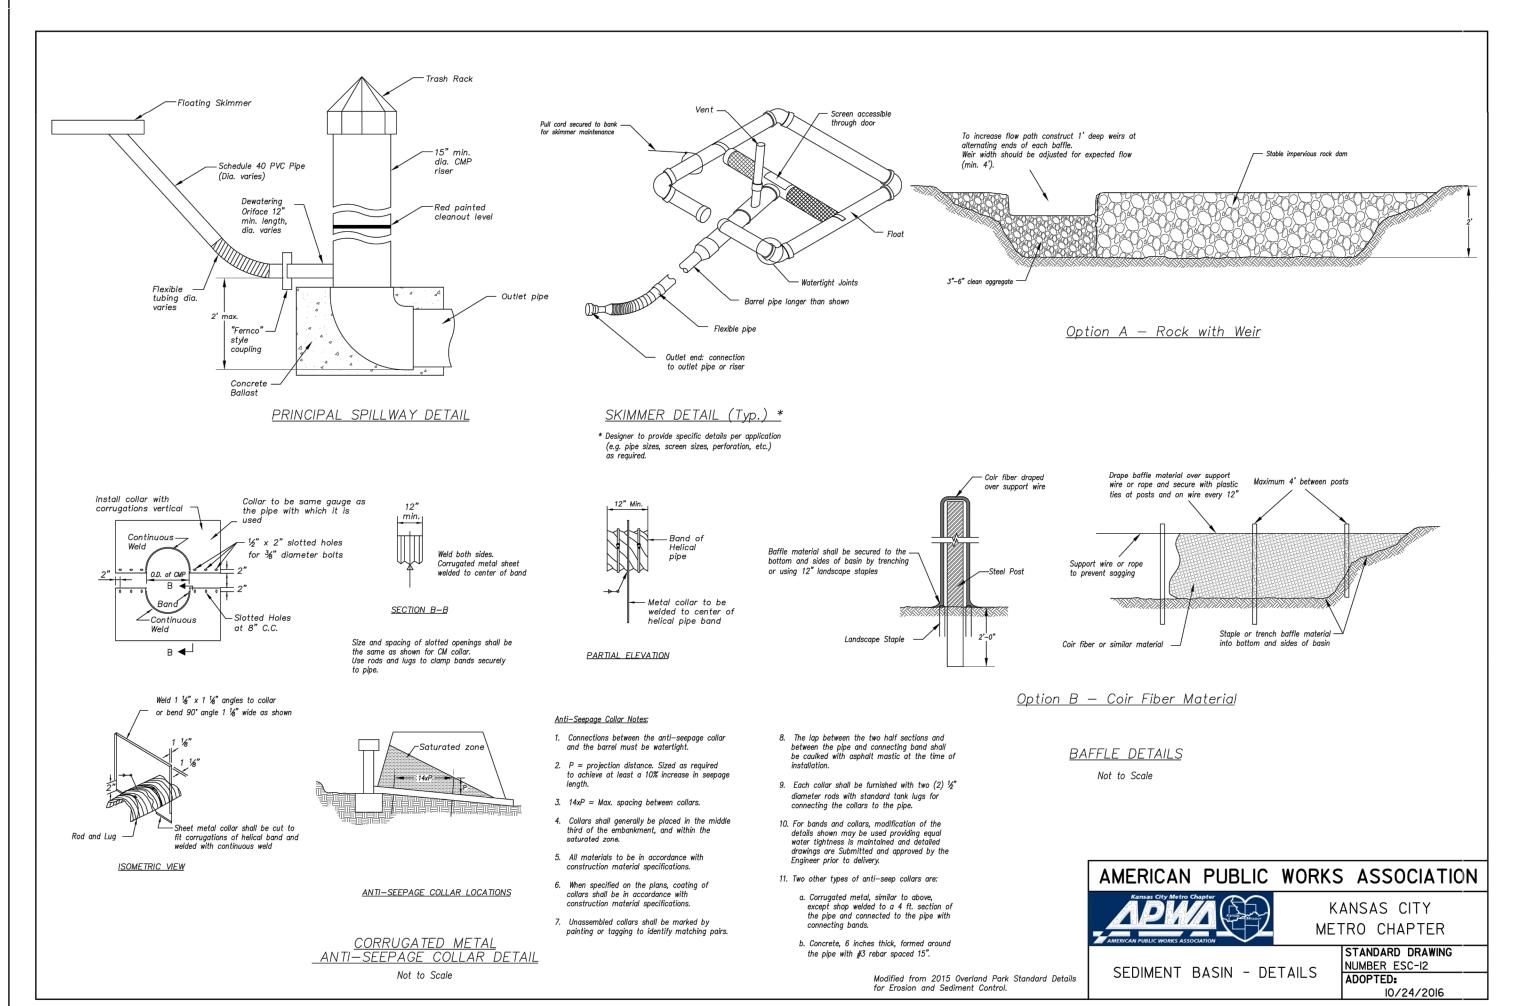

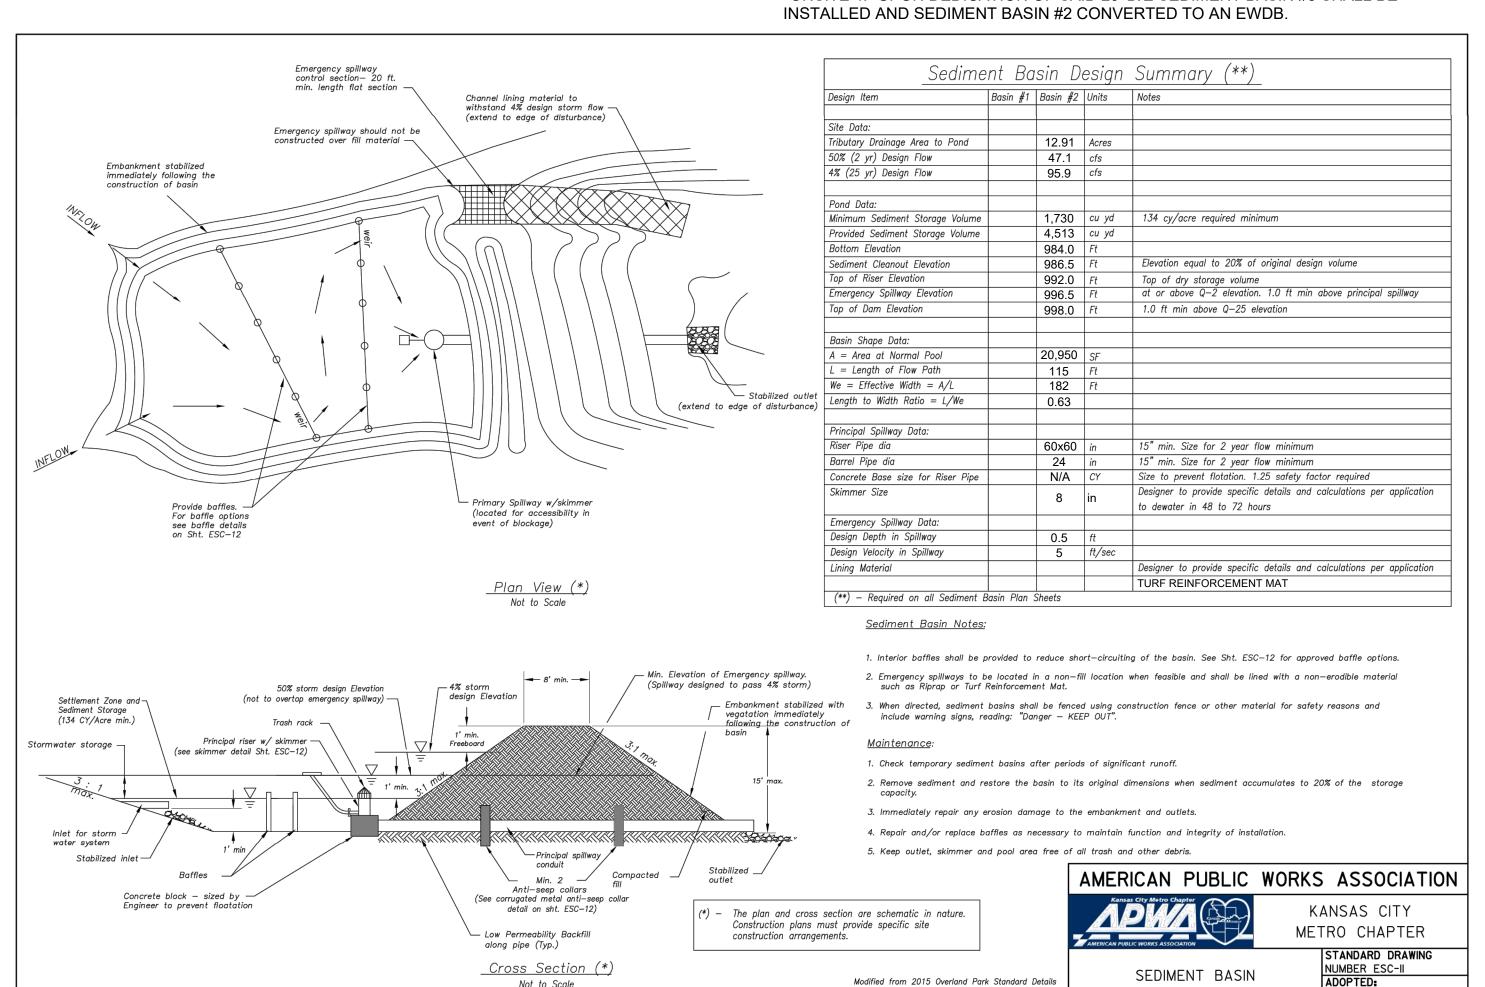

Not to Scale




ONAL E 05.30.2023


SCHLAGEL & ASSOCIATES, P.A.


10/24/2016


BLACKWELL ONTROL PLAN SERVE DIMENT RE. SEC ENOSION & REI & E S, D RESIDENCES


**EROSION** CONTROL **DETAILS** 

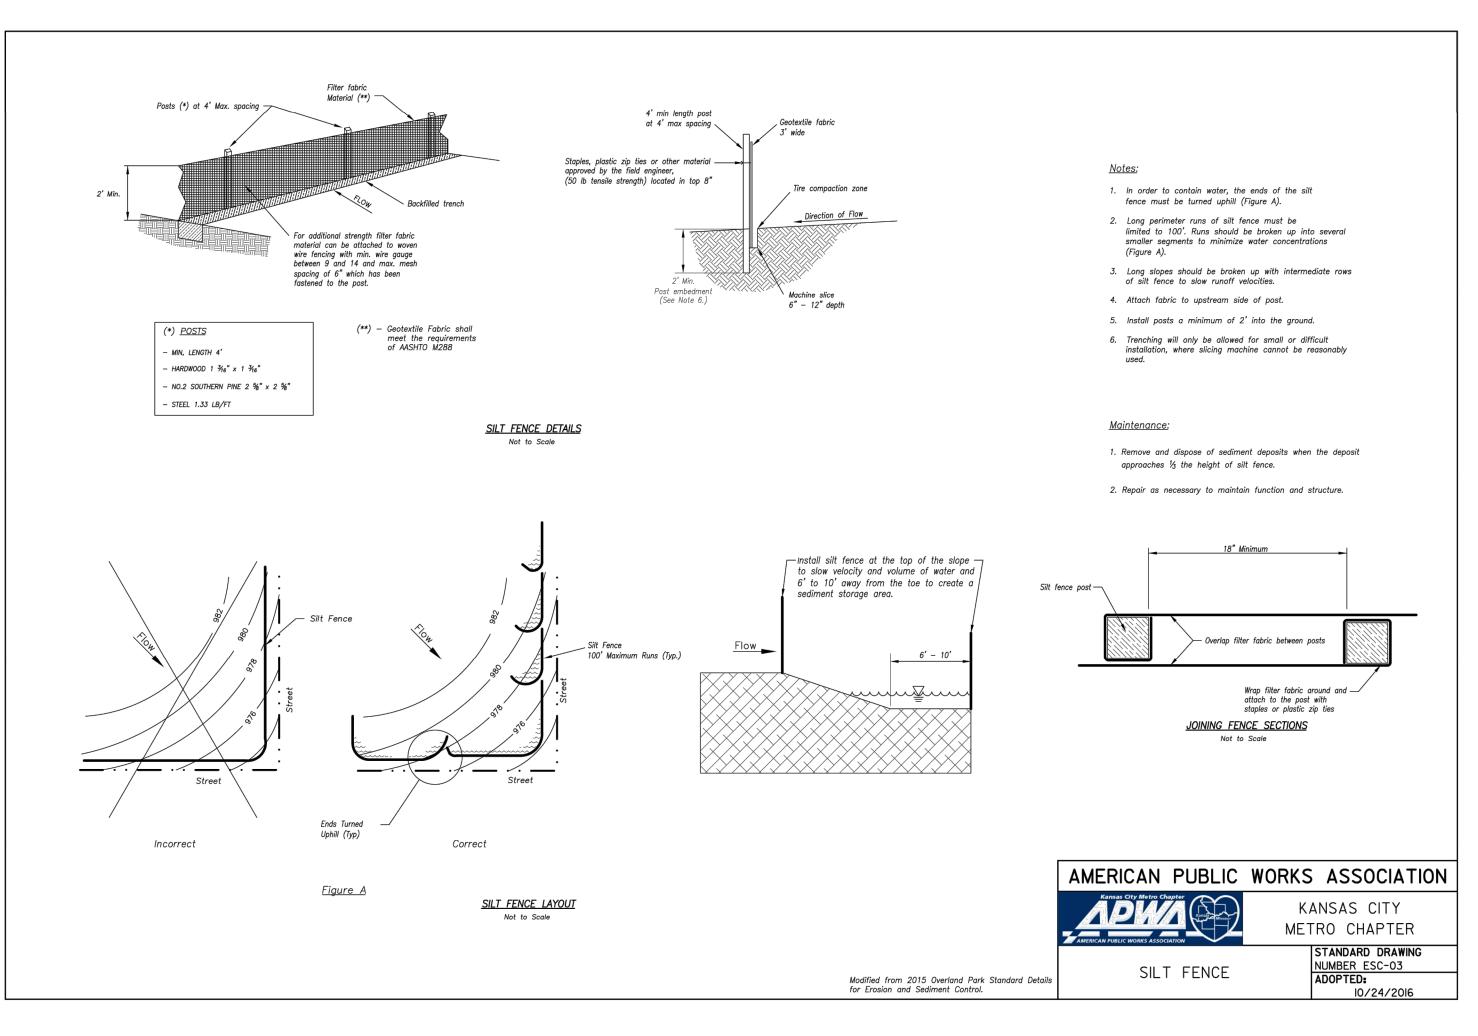

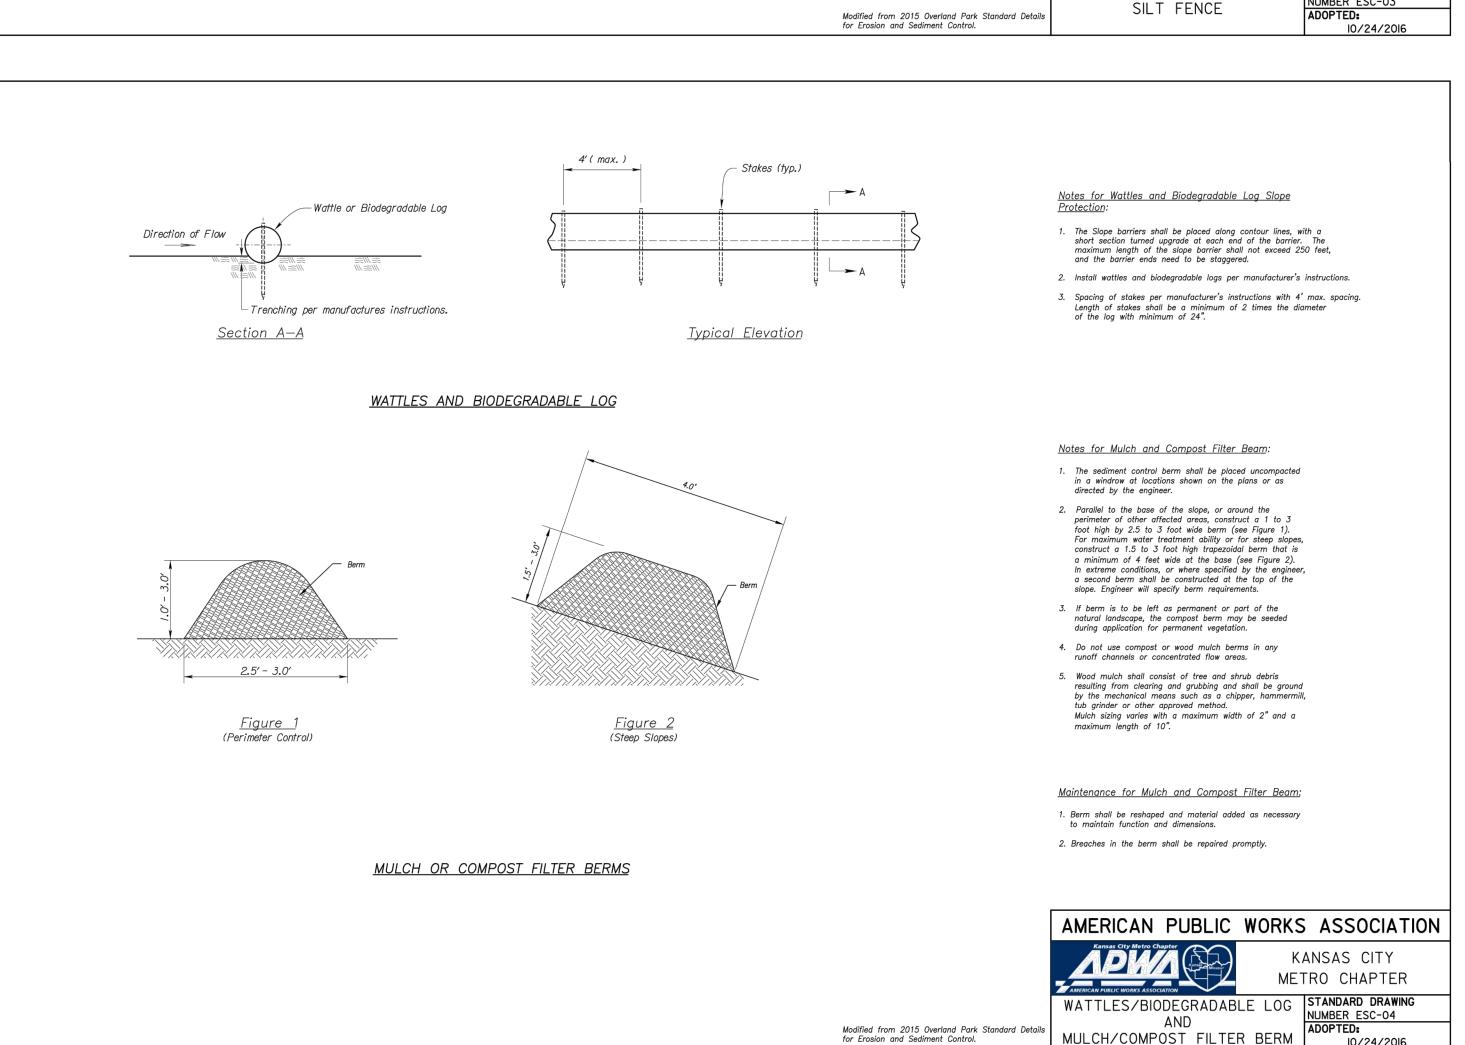

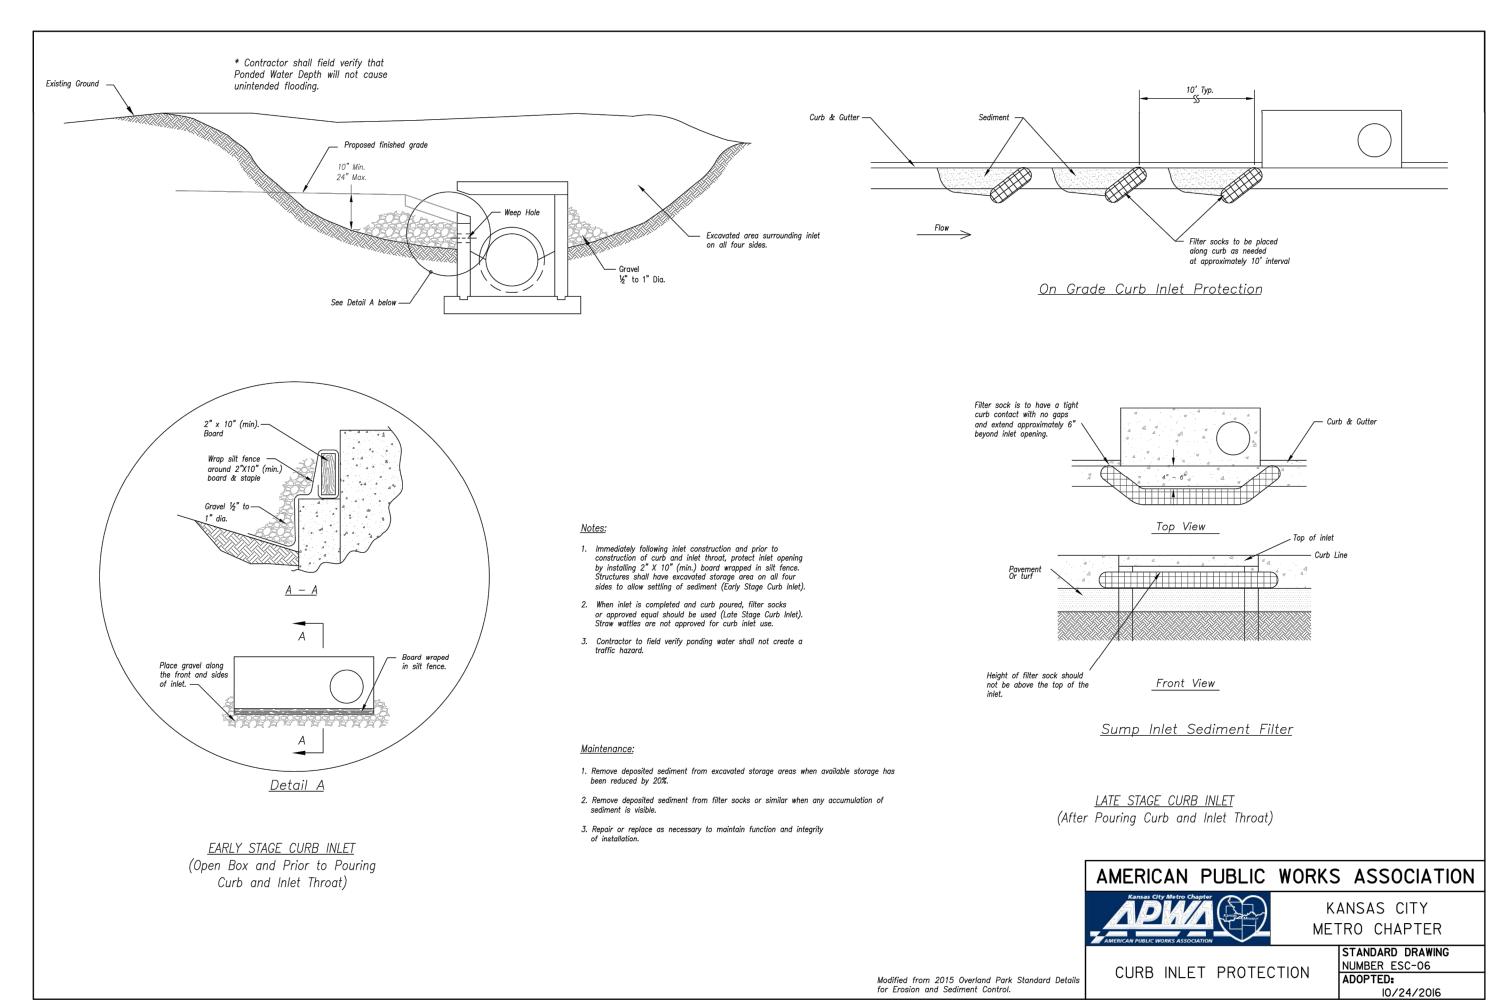

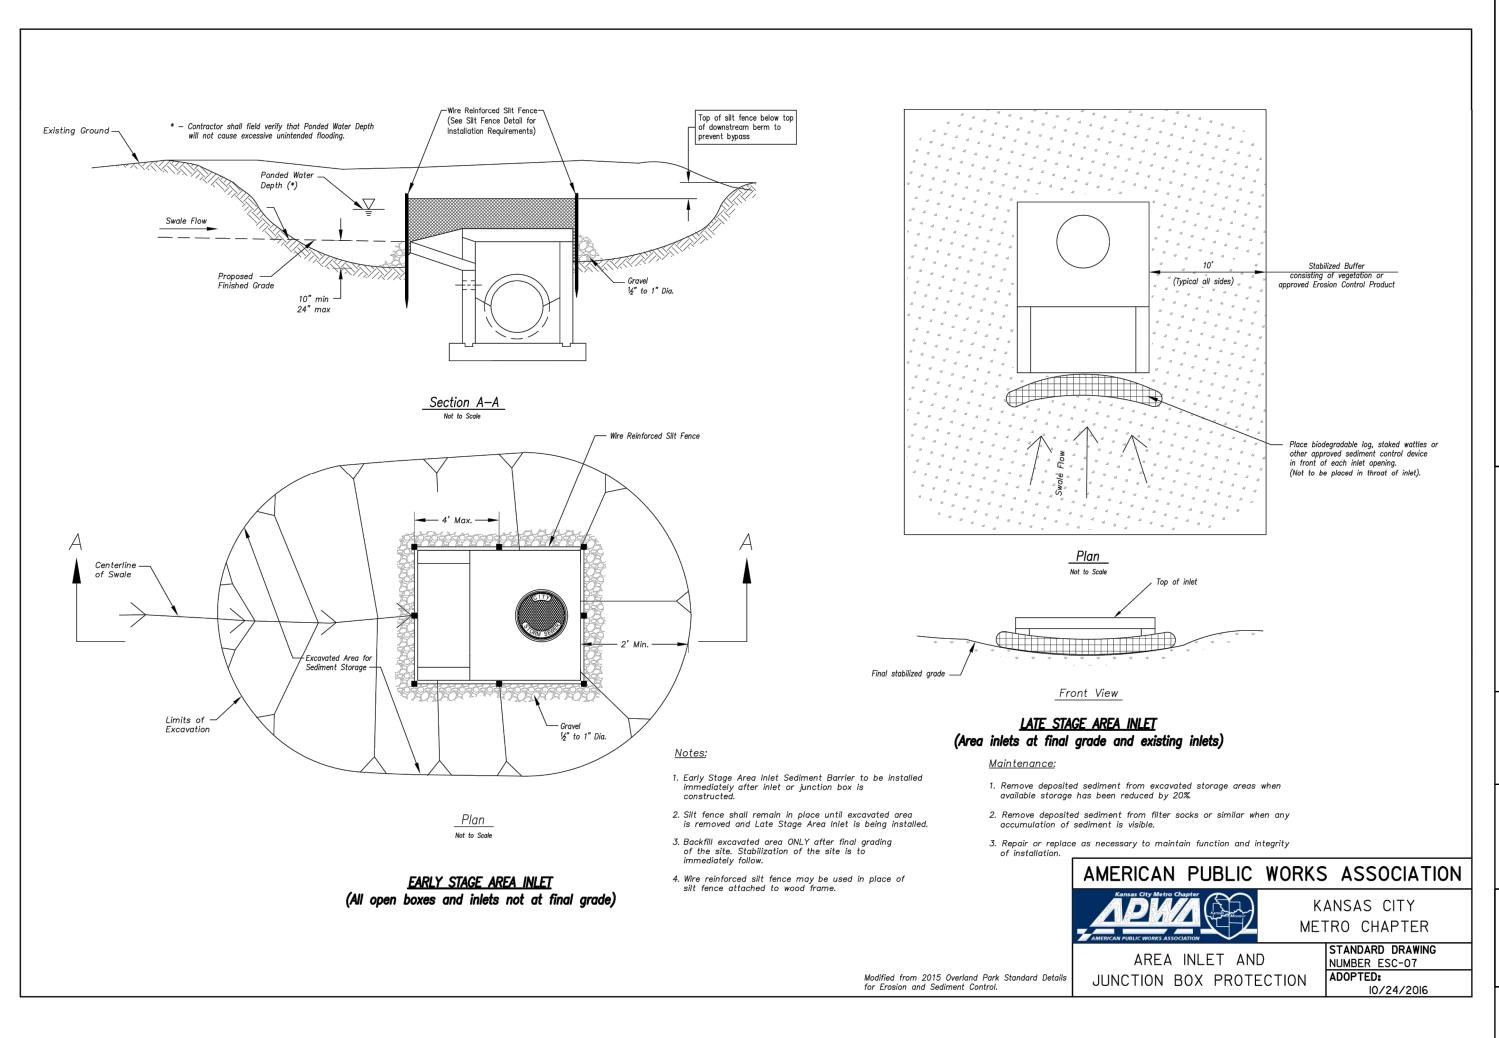

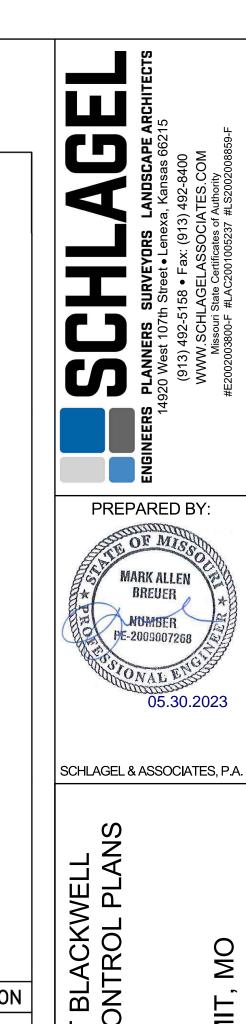


RESIDENCES, REUNION & RESERVE AT BLACKWE MASS GRADING & EROSION SEDIMENT CONTROL PL


EROSION CONTROL DETAILS


DLIAIL

SHEET

3

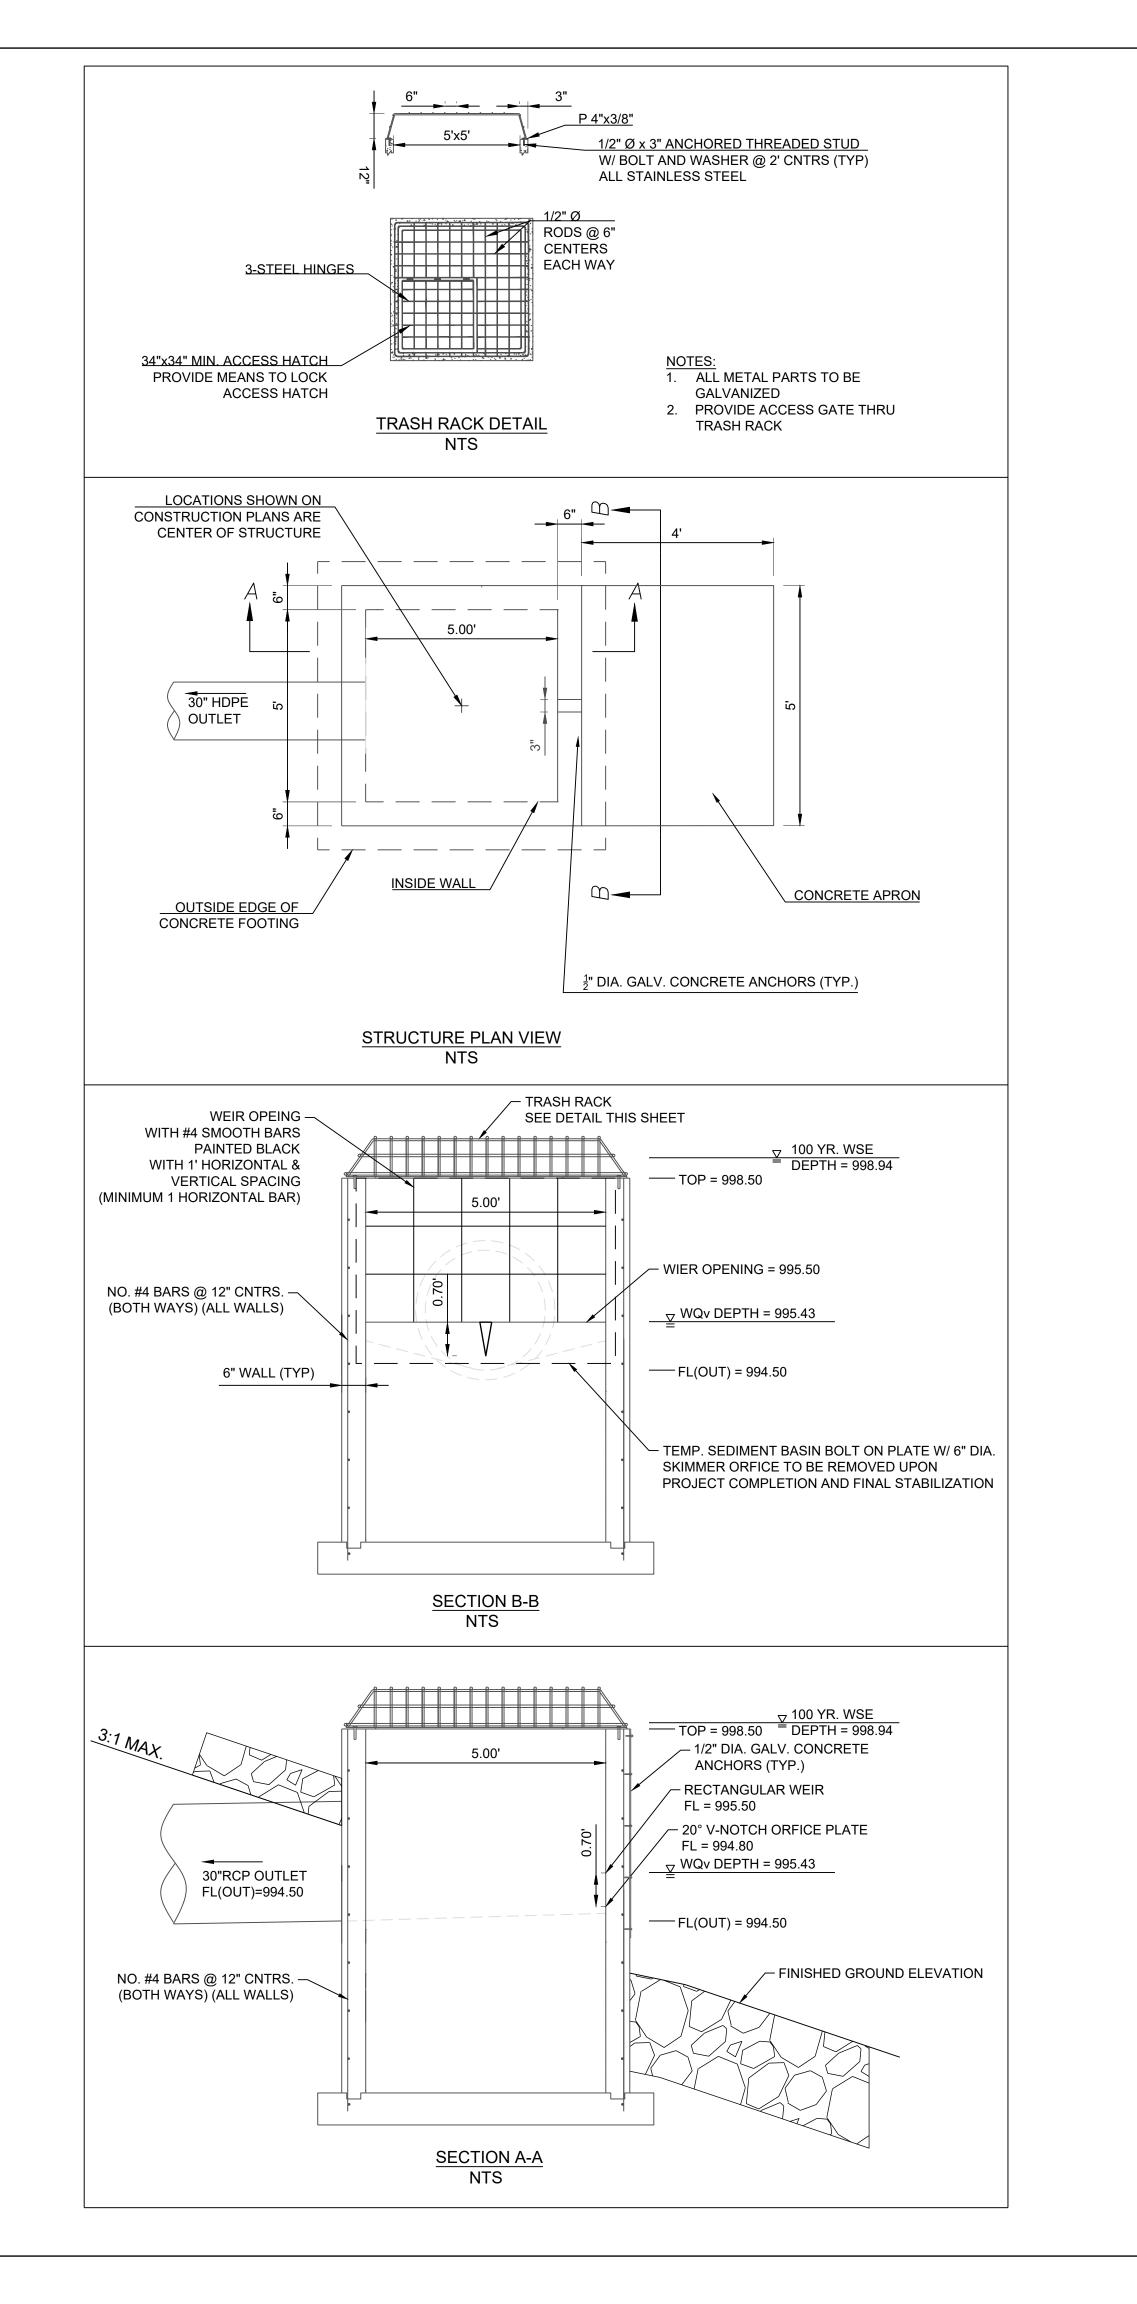

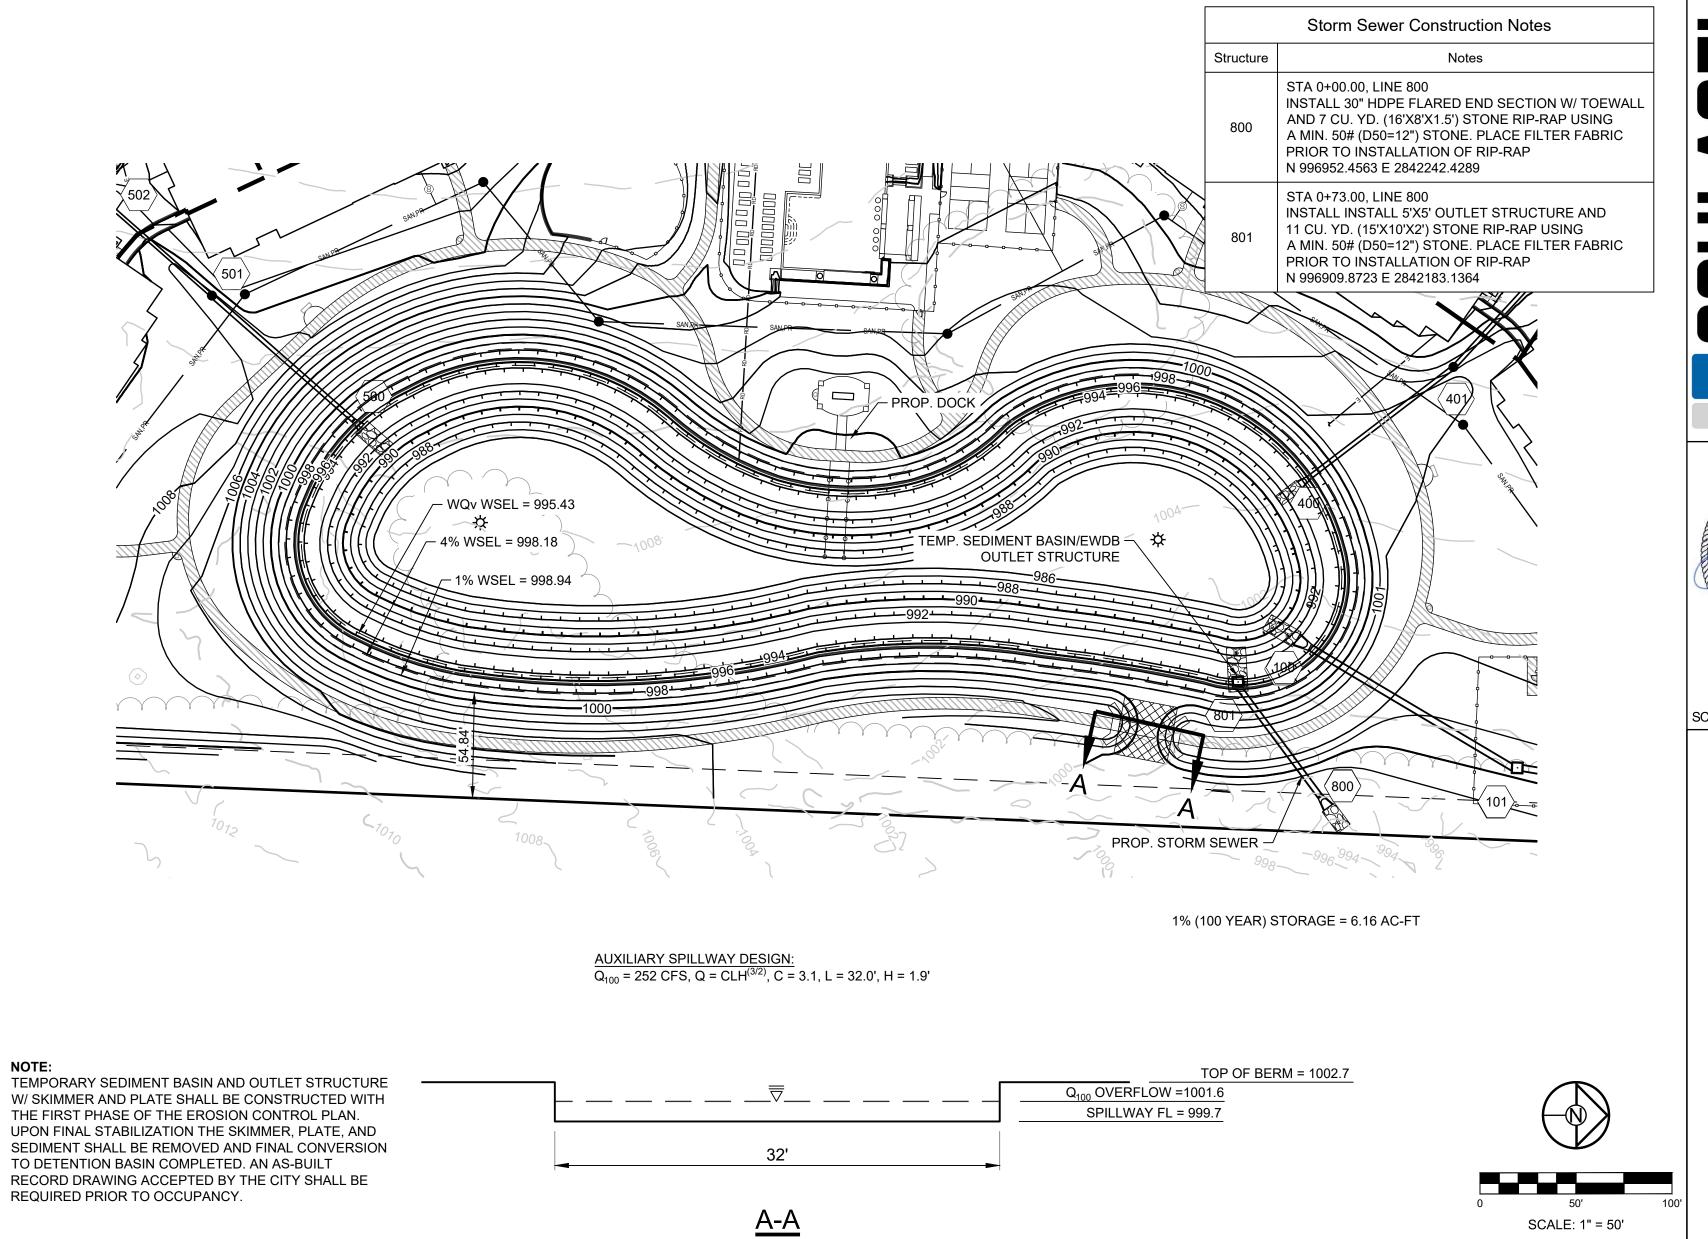

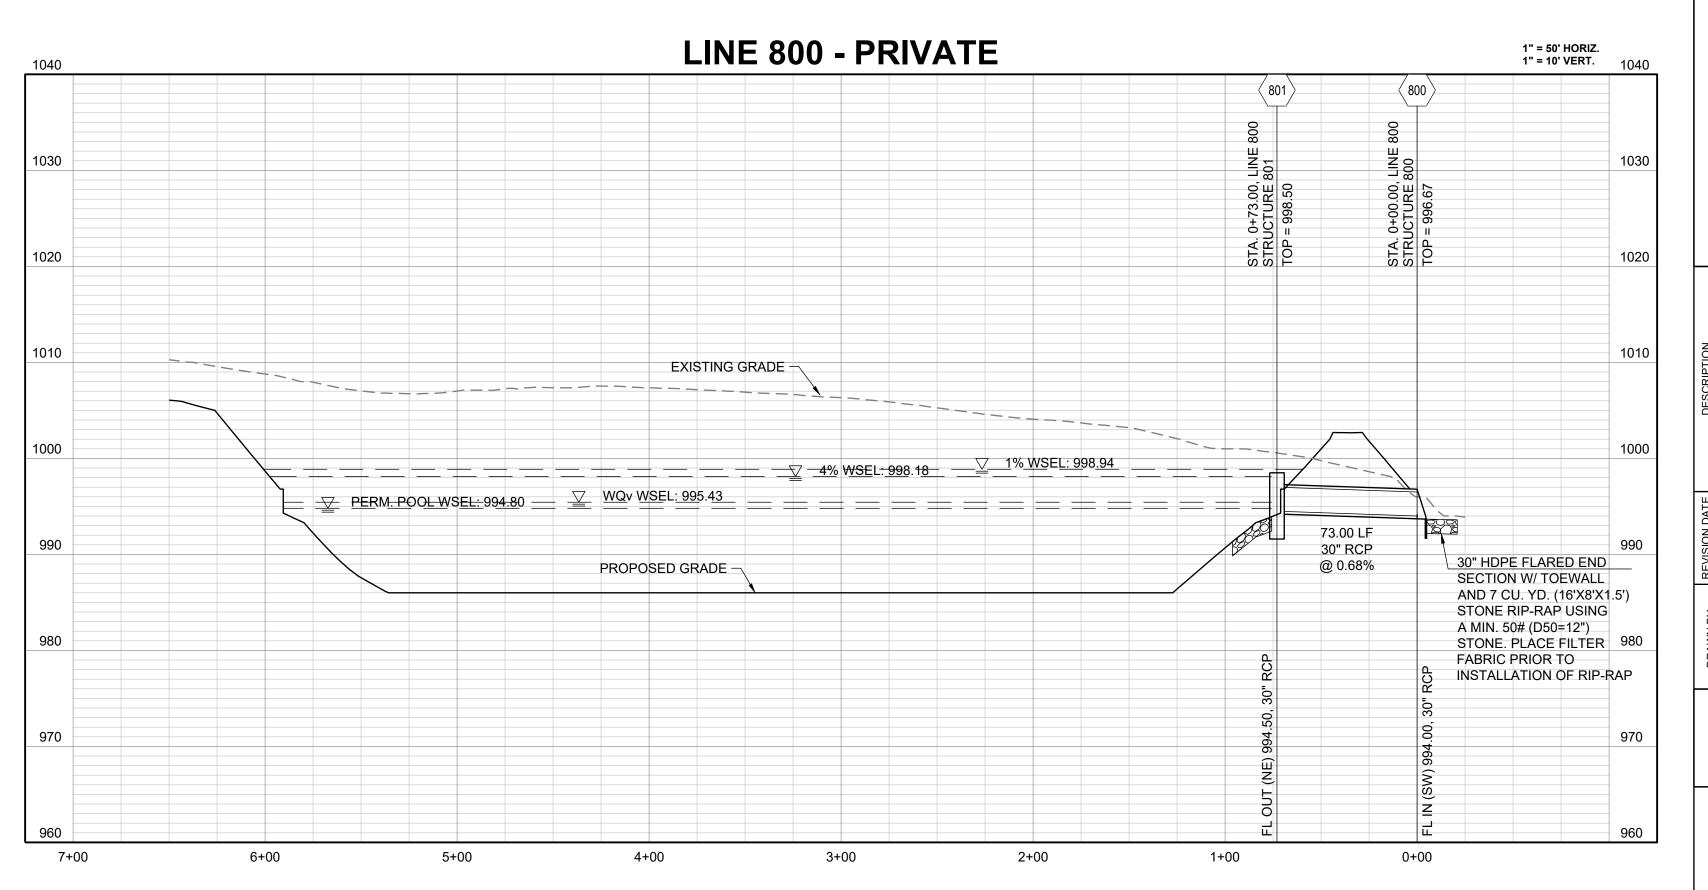

ENGINEERS PLANNERS SURVEYORS LANDSCAPE ARCHITECTS
14920 West 107th Street • Lenexa, Kansas 66215
(913) 492-5158 • Fax: (913) 492-8400
WWW.SCHLAGELASSOCIATES.COM
Missouri State Certificates of Authority
#E2002003800-F #LAC2001005237 #LS2002008859-F

PREPARED BY:

MARK ALLEN
BREUER

MUMBER
PE-2009007268

05.30.2023

SCHLAGEL & ASSOCIATES, P.A.

LANS


JION & RESERVE AT BLACKWELL DSION SEDIMENT CONTROL PLANS


RESIDENCES, REUNION & MASS GRADING & EROSION (


OUTLET
STRUCTURE 801

SHEET


9

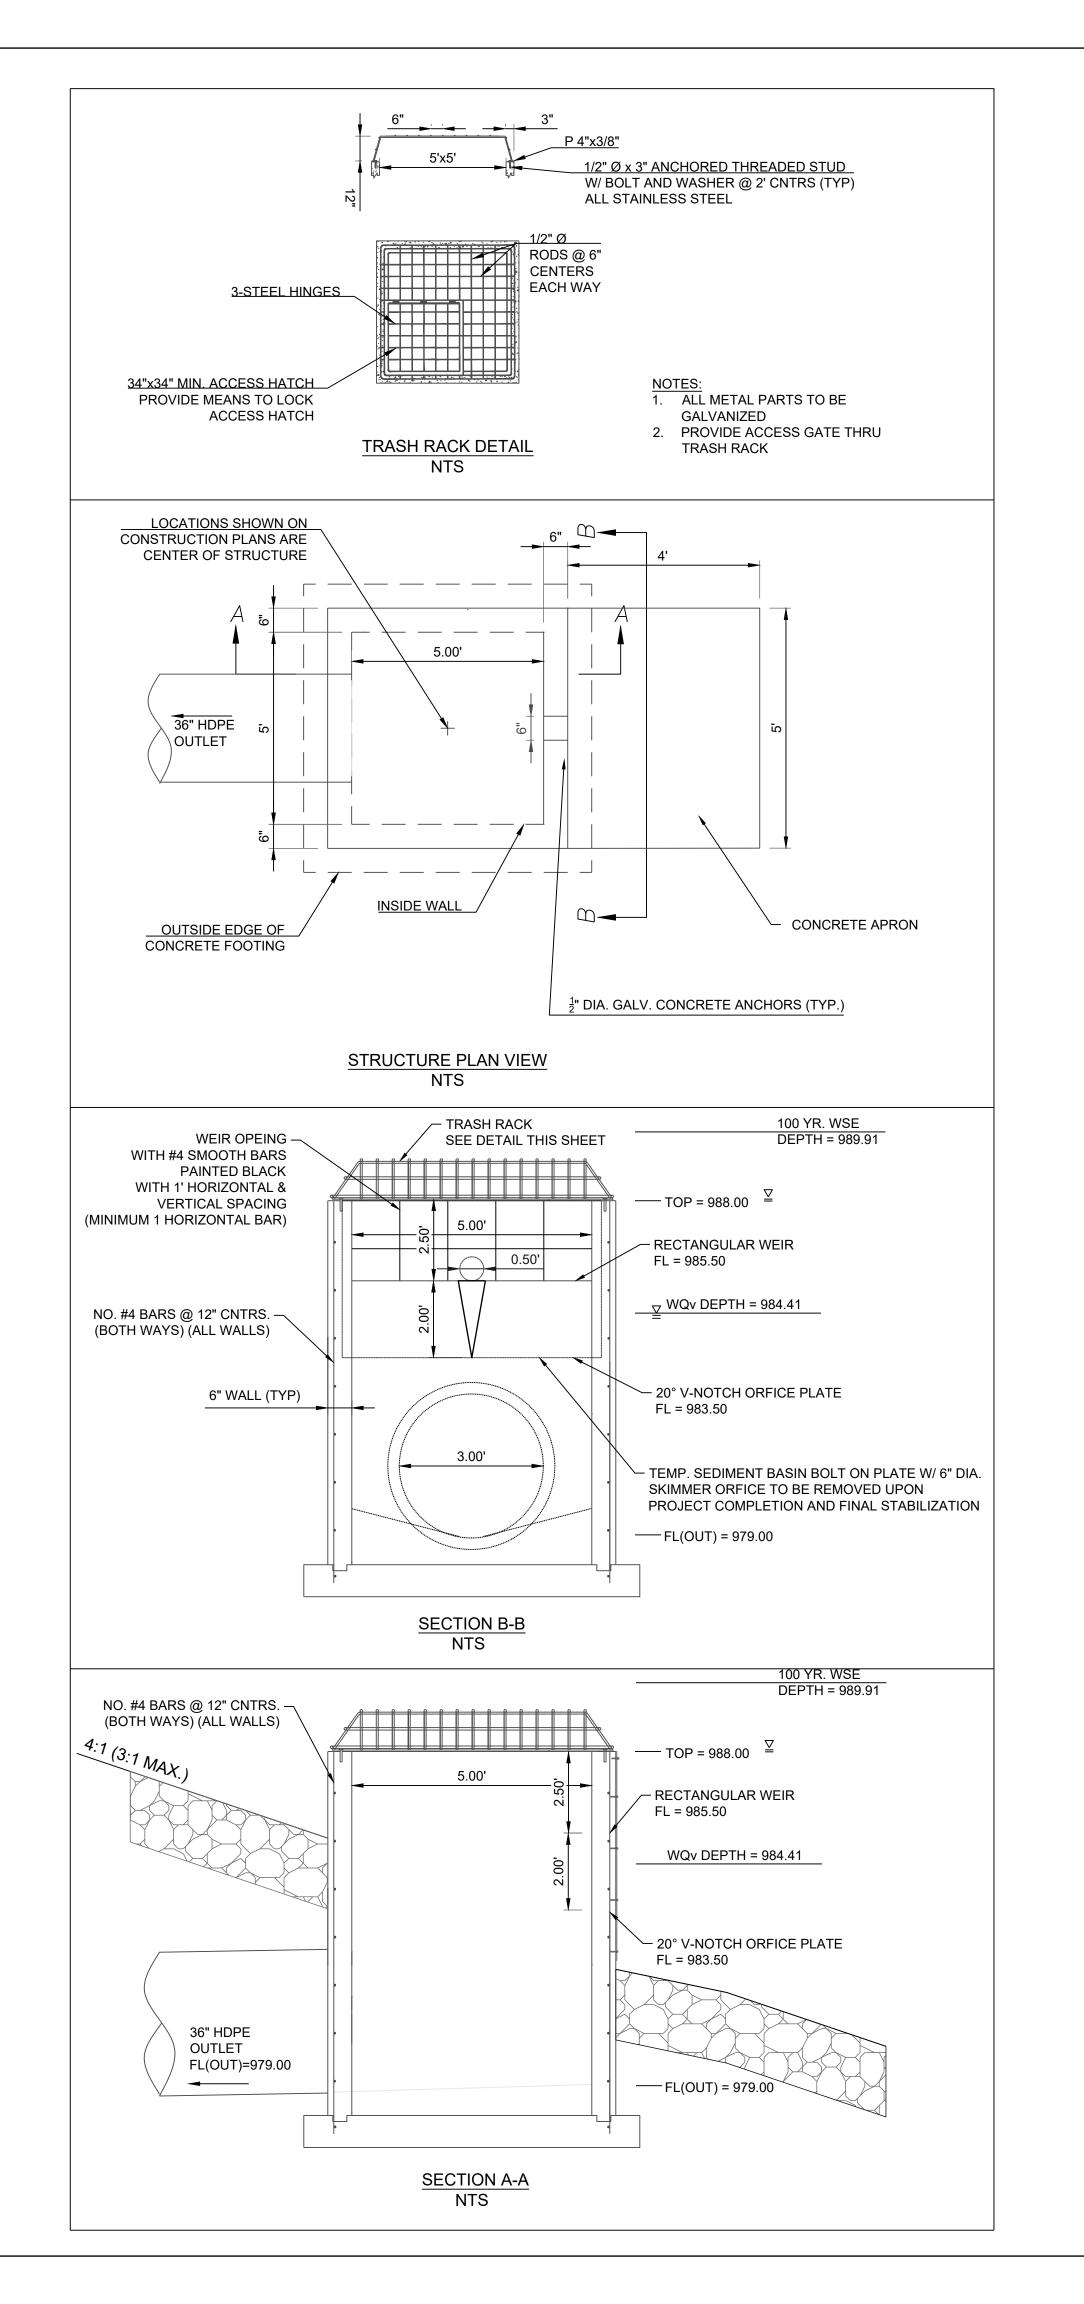

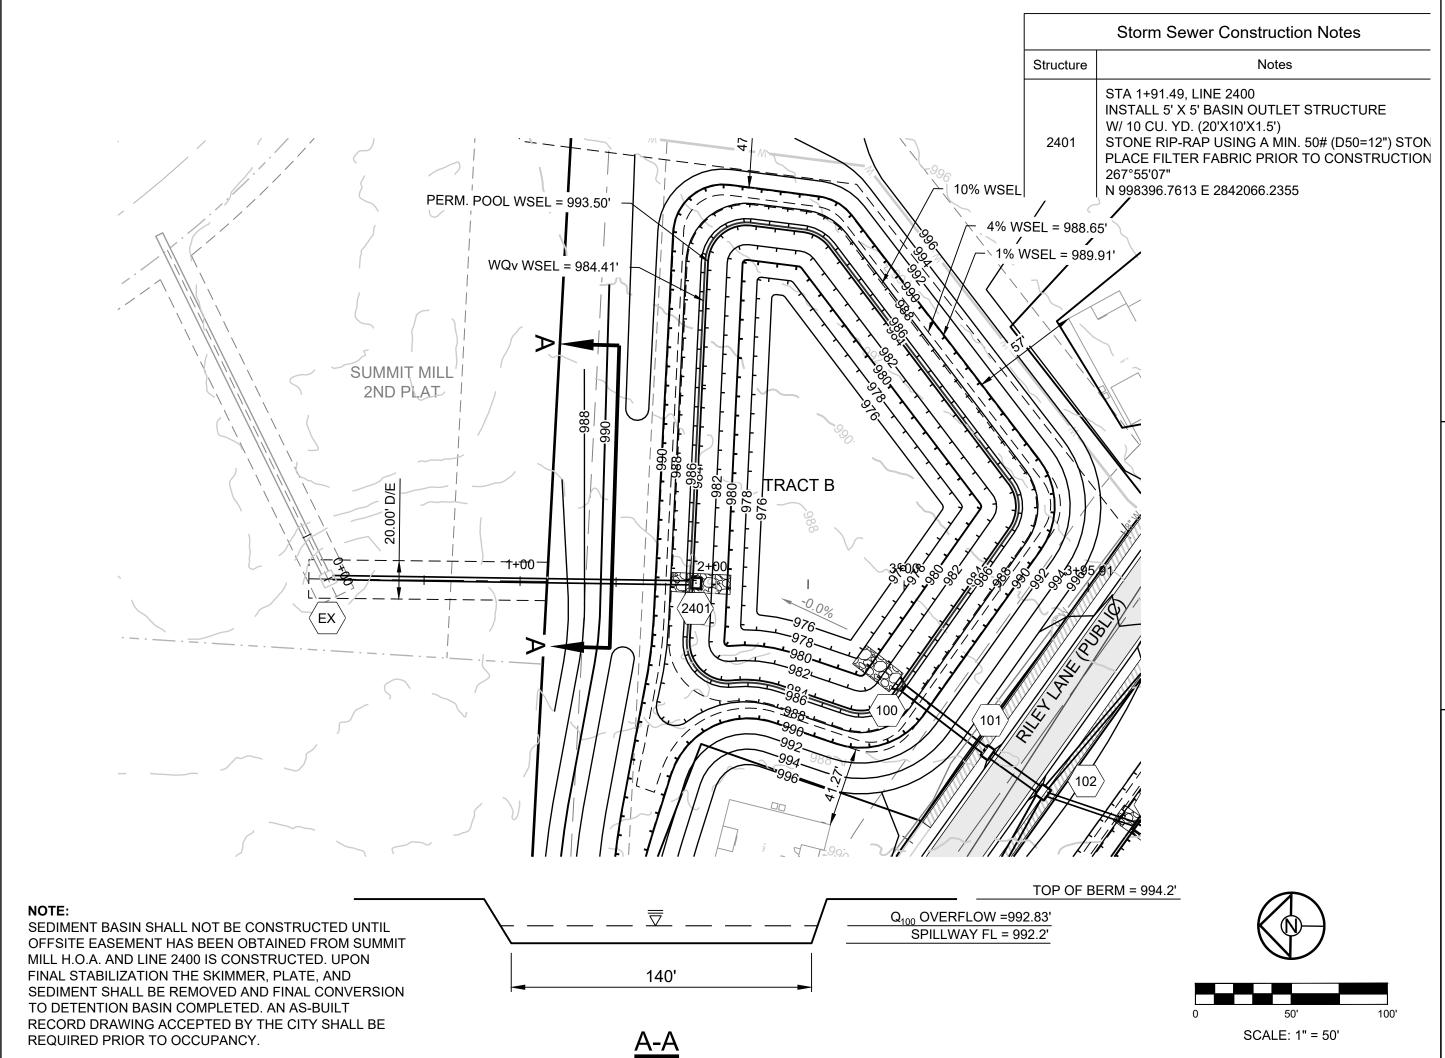

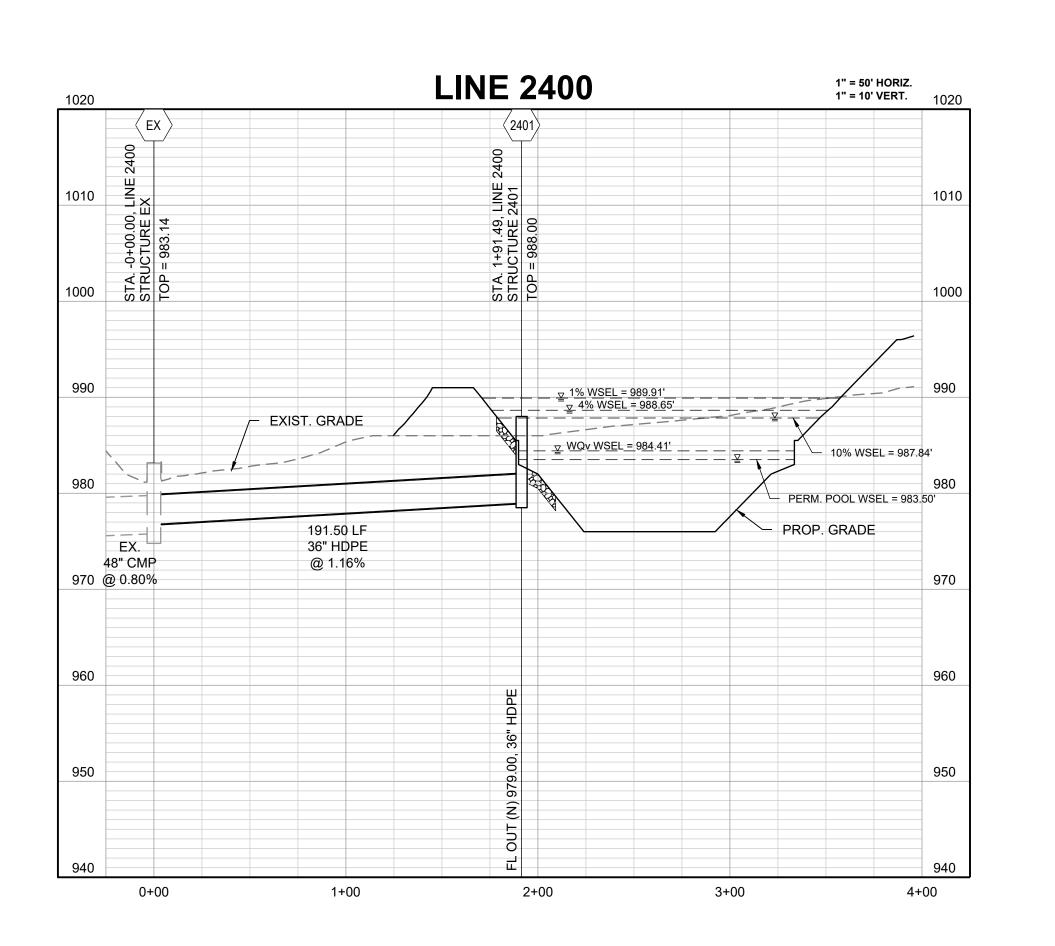

PREPARED BY:

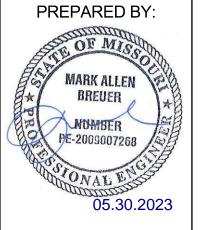



SCHLAGEL & ASSOCIATES, P.A.


AT BLACKW CONTROL I RESERVE A REUNION & & EROSION &


RESIDENCES, I MASS GRADING 8

OUTLET STRUCTURE 2401

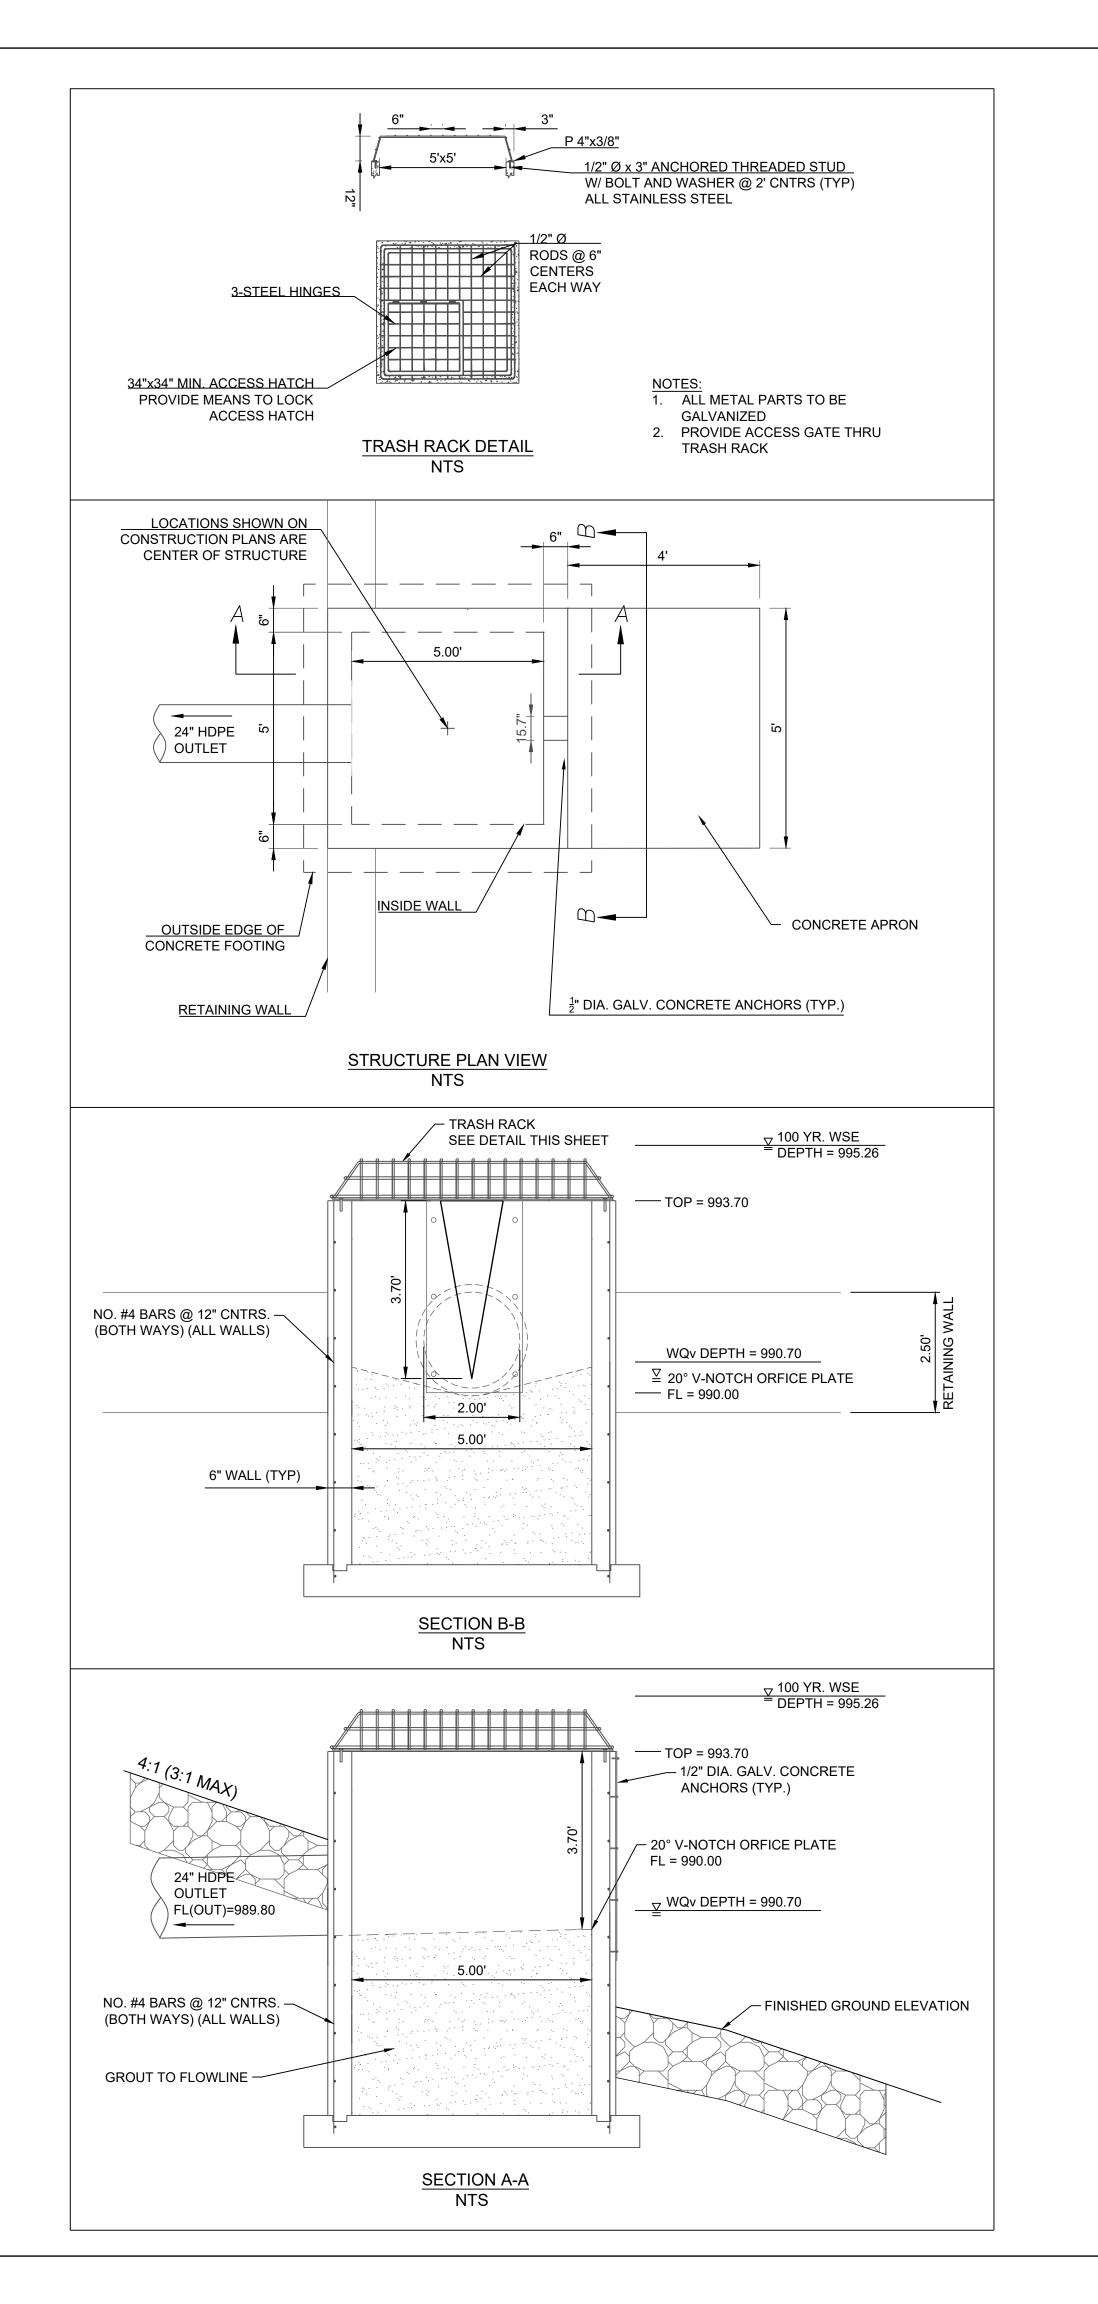

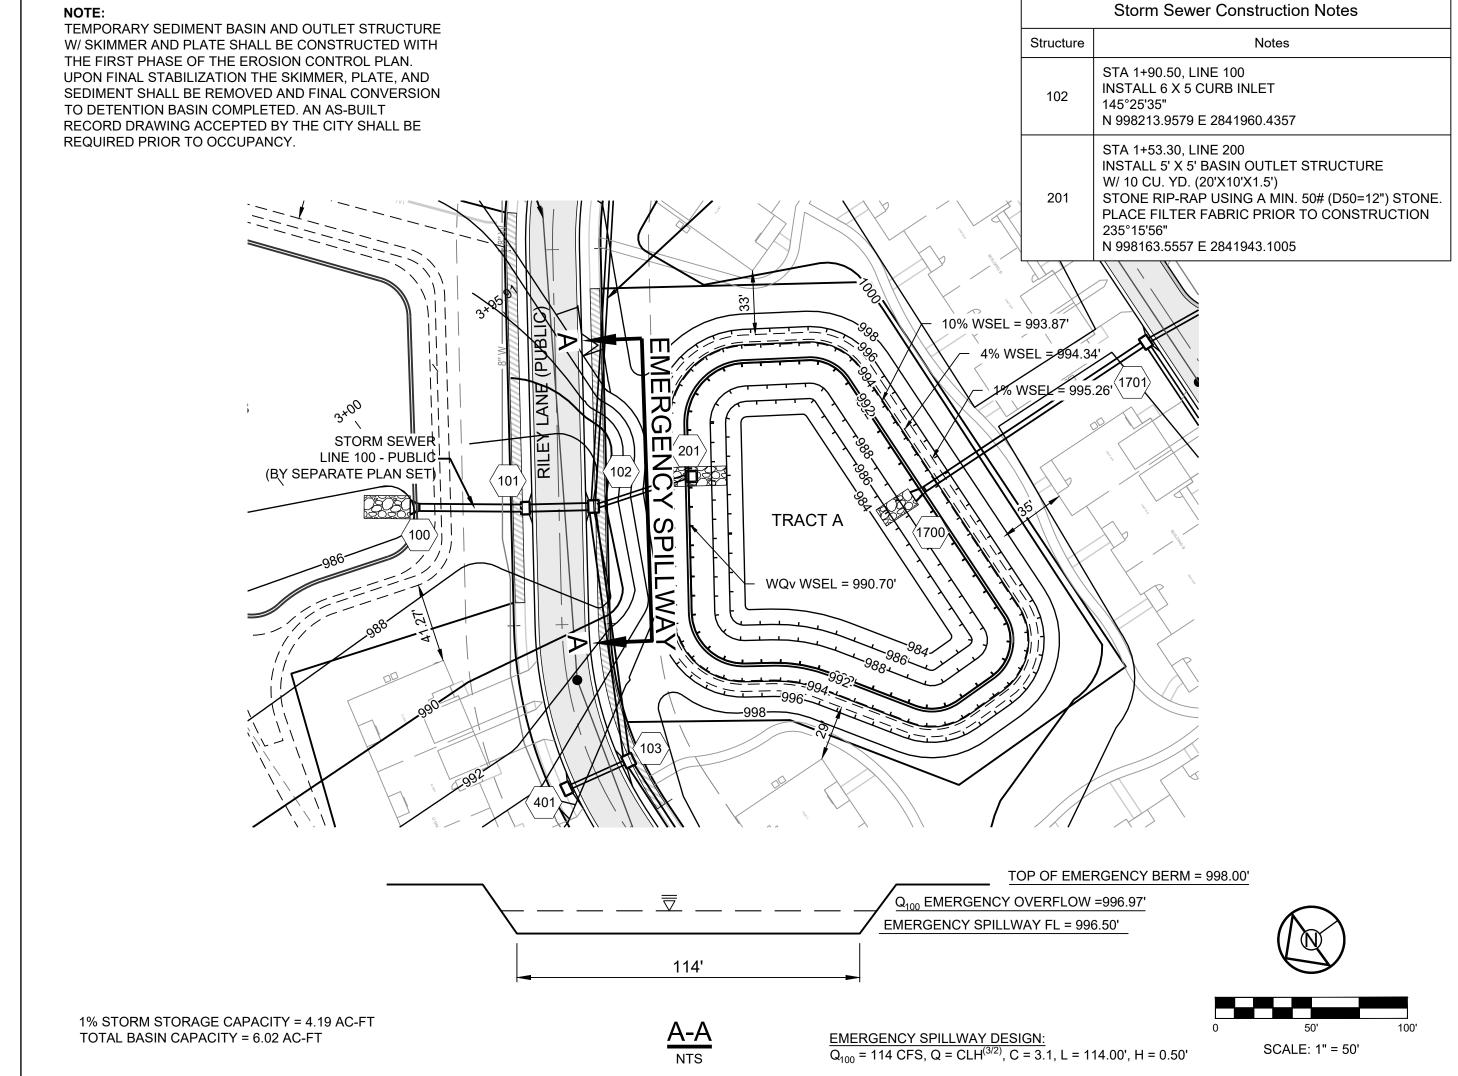

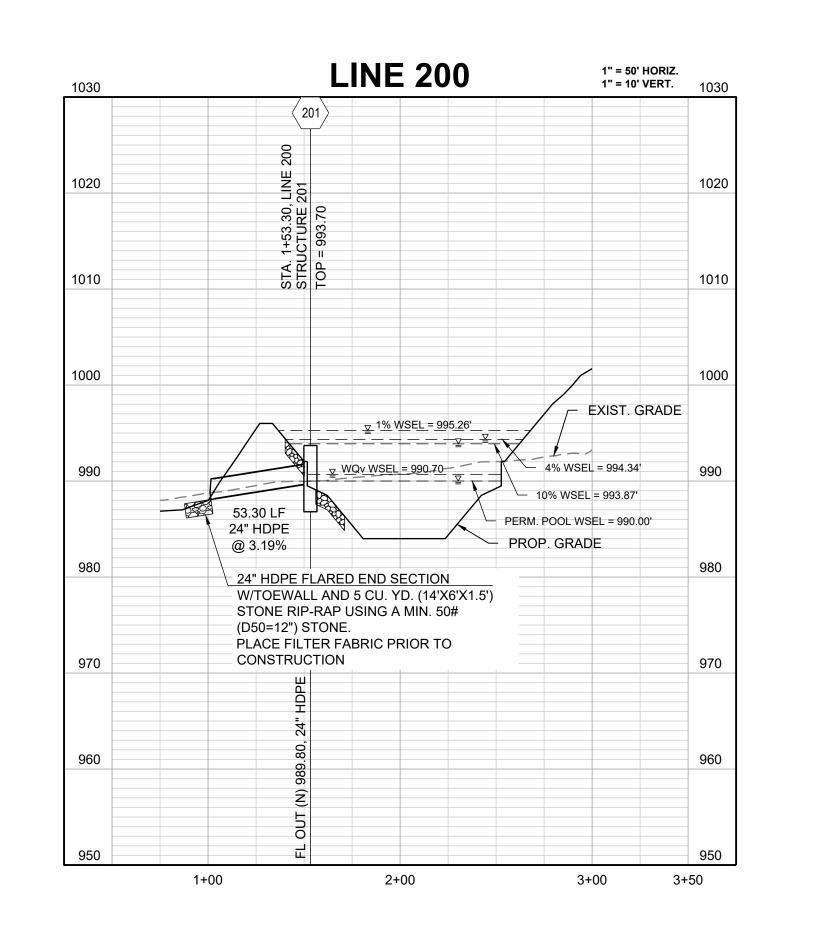

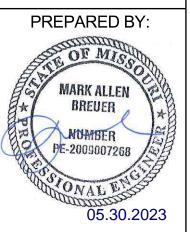

SCHLAGEL & ASSOCIATES, P.A.

RESERVE A EUNION & EROSION

OUTLET STRUCTURE 201