

- 1. PRIOR TO STARTING CONSTRUCTION THE CONTRACTOR SHALL BE RESPONSIBLE TO MAKE SURE THAT ALL REQUIRED PERMITS AND APPROVALS HAVE BEEN OBTAINED. NO CONSTRUCTION OR FABRICATION SHALL BEGIN UNTIL THE CONTRACTOR HAS RECEIVED AND THOROUGHLY REVIEWED ALL PLANS AND OTHER DOCUMENTS
- 2. ALL WORK SHALL BE PERFORMED IN ACCORDANCE WITH THESE PLANS, SPECIFICATIONS, AND THE REQUIREMENTS
- 4. ALL EXISTING CONDITIONS, DIMENSIONS, AND GRADES SHOWN ON THE PLANS SHALL BE FIELD VERIFIED BY THE CONTRACTOR PRIOR TO CONSTRUCTION. CONTRACTOR SHALL NOTIFY THE CONSTRUCTION MANAGER IF ANY DISCREPANCIES EXIST, PRIOR TO PROCEEDING WITH CONSTRUCTION, FOR NECESSARY PLAN OR GRADE CHANGES. NO EXTRA COMPENSATION SHALL BE PAID TO THE CONTRACTOR FOR WORK HAVING TO BE REDONE DUE TO

LEGEND

TYP. CURB & GUTTER

ASPHALT PATCH

CONCRETE SIDEWALK

TYP. CONCRETE PAVING



9229 WARD PARKWAY SUITE # 210 KANSAS CITY, MO 64114 TEL: (816) 444-4200 FAX: (316) 265-5646 www.glmv.com

GLMV ARCHITECTURE, INC. MISSOURI STATE CERTIFICATE OF AUTHORITY

CIVIL ENGINEER & LANDSCAPE ARCH. GLMV ARCHITECTURE, INC MISSOURI CIVIL COA #2018033898 MISSOURI LANDSCAPE COA #000008 9229 WARD PARKWAY, SUITE # 210

KANSAS CITY, MO 64114 TEL: (816) 444-4200 STRUCTURAL ENGINEER LEIGH + O'KANE

MISSOURI COA #001644 250 NE MURBERRY, SUITE 201 LEE'S SUMMIT, MO, 64086 (816) 444-3144 PHONE

MECH., ELEC. & PLUMBING ENGINEERS HOSS & BROWN ENGINEERS

MISSOURI COA #01022 15902 MIDLAND DRIVE SHAWNEE, KS 66217 (913) 362-9090 PHONE

SECURITY & IT ENGINEERS HENDERSON ENGINEERS MISSOURI COA # 000556 1801 MAIN STREET. SUITE 300 KANSAS CITY, MO 64108

(816) 663-8700 PHONE

FIRE STATIC CITY OF LEE'S SUN 5031 NORTHEAST LEE'S SUMMIT, MI

REVISIONS: # Description Date 11.16.2022 ASI 01 ASI 07 04.25.2023

> DERICK M. HOLMES NUMBER PE 2022005196 /Æ


DERICK HOLMES - CIVIL ENGINEER MO# PE-2022005196

PROJECT NO: 18225R21001 DATE: 10.19.2022 DRAWN BY: KDW

CHK'D BY: © GLMV Architecture, Inc. All work herein is the property of GLMV Architecture, Inc. and is not to be copied or used in any way without the express written consent of GLMV Architecture, Inc.

SITE PLAN

PLEASE CONSIDER THE ENVIRONMENT

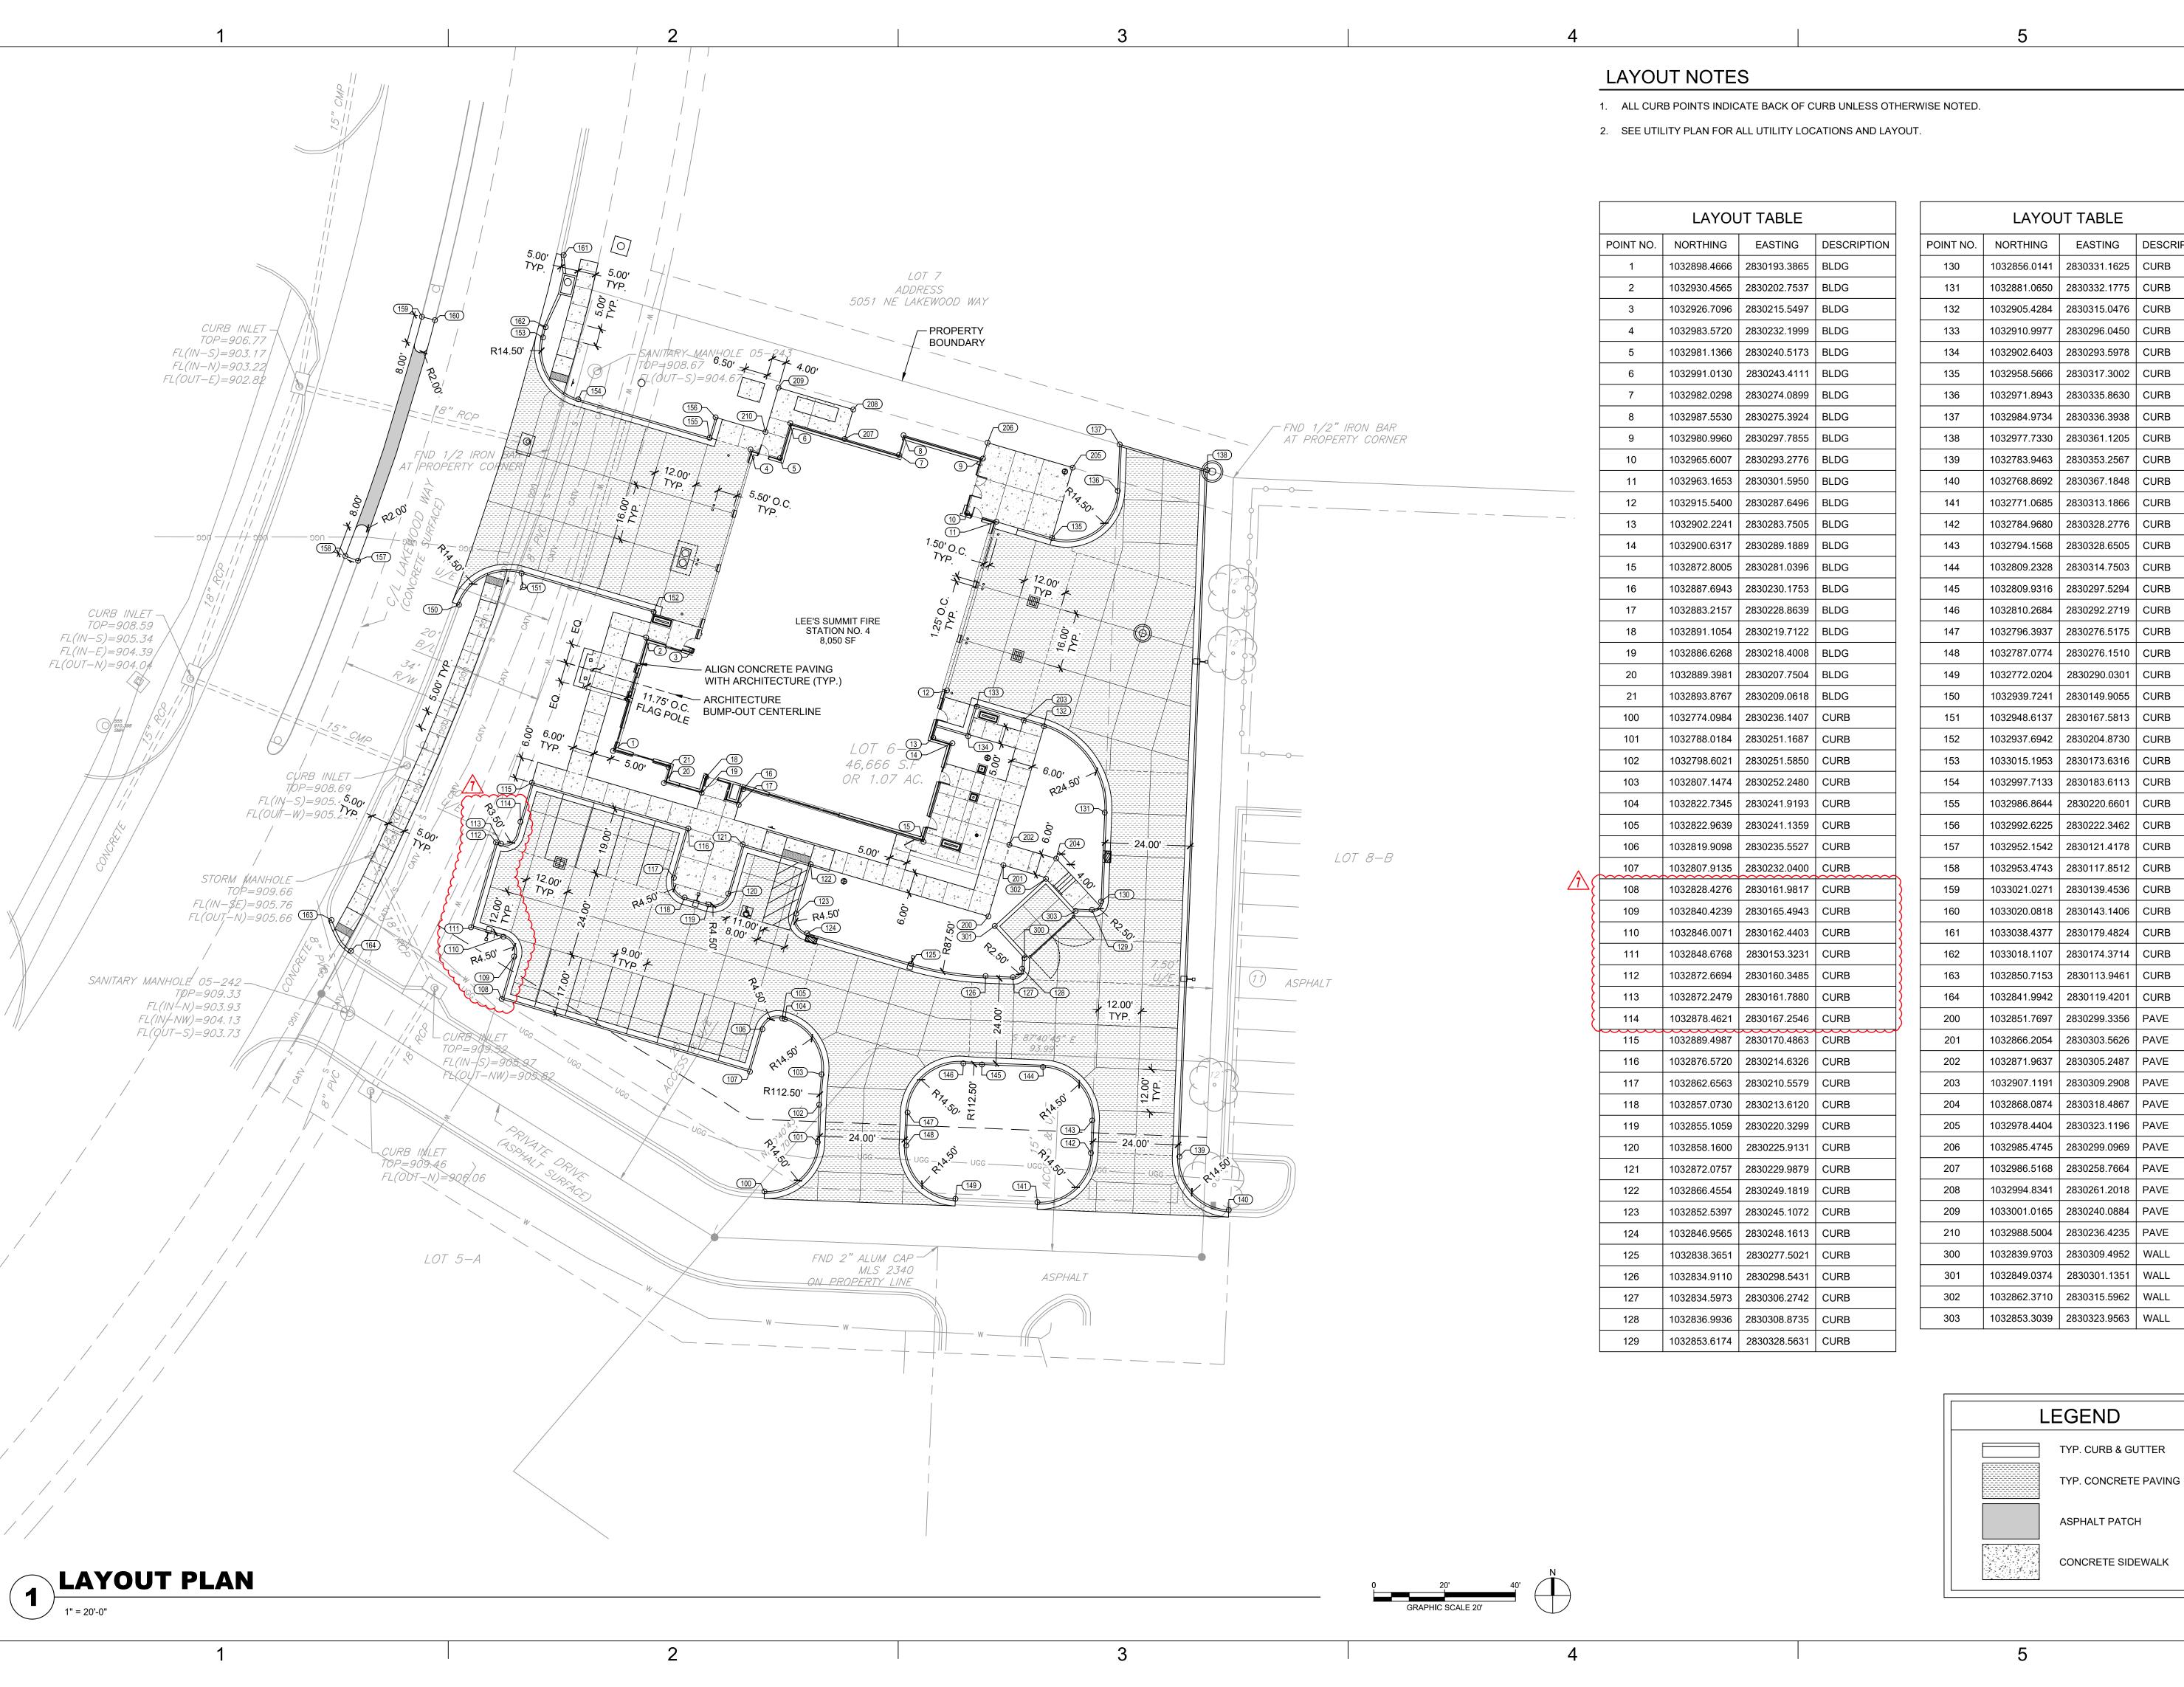

	LAYOU	JT TABLE	
POINT NO.	NORTHING	EASTING	DESCRIPTION
130	1032856.0141	2830331.1625	CURB
131	1032881.0650	2830332.1775	CURB
132	1032905.4284	2830315.0476	CURB
133	1032910.9977	2830296.0450	CURB
134	1032902.6403	2830293.5978	CURB
135	1032958.5666	2830317.3002	CURB
136	1032971.8943	2830335.8630	CURB
137	1032984.9734	2830336.3938	CURB
138	1032977.7330	2830361.1205	CURB
139	1032783.9463	2830353.2567	CURB
140	1032768.8692	2830367.1848	CURB
141	1032771.0685	2830313.1866	CURB
142	1032784.9680	2830328.2776	CURB
143	1032794.1568	2830328.6505	CURB
144	1032809.2328	2830314.7503	CURB
145	1032809.9316	2830297.5294	CURB
146	1032810.2684	2830292.2719	CURB
147	1032796.3937	2830276.5175	CURB
148	1032787.0774	2830276.1510	CURB
149	1032772.0204	2830290.0301	CURB
150	1032939.7241	2830149.9055	CURB
151	1032948.6137	2830167.5813	CURB
152	1032937.6942	2830204.8730	CURB
153	1033015.1953	2830173.6316	CURB
154	1032997.7133	2830183.6113	CURB
155	1032986.8644	2830220.6601	CURB
156	1032992.6225	2830222.3462	CURB
157	1032952.1542	2830121.4178	CURB
158	1032953.4743	2830117.8512	CURB
159	1033021.0271	2830139.4536	CURB
160	1033020.0818	2830143.1406	CURB
161	1033038.4377	2830179.4824	CURB
162	1033018.1107	2830174.3714	CURB
163	1032850.7153	2830113.9461	CURB
164	1032841.9942	2830119.4201	CURB
200	1032851.7697	2830299.3356	PAVE
201	1032866.2054	2830303.5626	PAVE
202	1032871.9637	2830305.2487	PAVE
203	1032907.1191	2830309.2908	PAVE
204	1032868.0874	2830318.4867	PAVE
205	1032978.4404	2830323.1196	PAVE
206	1032985.4745	2830299.0969	PAVE
207	1032986.5168	2830258.7664	PAVE
208	1032994.8341	2830261.2018	PAVE
209	1032994.0341	2830240.0884	PAVE
210	1033001.0103	2830236.4235	PAVE
300	1032988.5004	2830309.4952	WALL
300	1032839.9703	2830309.4952	WALL
301	1032849.0374	2830301.1351	WALL
303	1032853.3039	2830323.9563	WALL

GLMVArchitecture

9229 WARD PARKWAY SUITE # 210 KANSAS CITY, MO 64114 TEL: (816) 444-4200 FAX: (316) 265-5646 www.glmv.com

GLMV ARCHITECTURE, INC. MISSOURI STATE CERTIFICATE OF AUTHORITY

CIVIL ENGINEER & LANDSCAPE ARCH. GLMV ARCHITECTURE, INC MISSOURI CIVIL COA #2018033898 MISSOURI LANDSCAPE COA #000008 9229 WARD PARKWAY, SUITE # 210 KANSAS CITY, MO 64114 TEL: (816) 444-4200

STRUCTURAL ENGINEER LEIGH + O'KANE MISSOURI COA #001644 250 NE MURBERRY, SUITE 201 LEE'S SUMMIT, MO, 64086

(816) 444-3144 PHONE MECH., ELEC. & PLUMBING ENGINEERS HOSS & BROWN ENGINEERS MISSOURI COA #01022 15902 MIDLAND DRIVE

SECURITY & IT ENGINEERS HENDERSON ENGINEERS MISSOURI COA # 000556 1801 MAIN STREET. SUITE 300 KANSAS CITY, MO 64108

SHAWNEE, KS 66217 (913) 362-9090 PHONE

(816) 663-8700 PHONE

5031 NORTHEAST LEE'S SUMMIT, MI FIRE STATIC CITY OF LEE'S SUI

|REVISIONS: # Description Date ASI 01 11.16.2022 ASI 07 04.25.2023

> HOLMES NUMBER PE-2022005196 /


DERICK HOLMES - CIVIL ENGINEER MO# PE-2022005196

PROJECT NO: 18225R21001 DATE: 10.19.2022 DRAWN BY: KDW CHK'D BY:

© GLMV Architecture, Inc. All work herein is the property of GLMV Architecture, Inc. and is not to be copied or used in any way without the express written consent of GLMV Architecture, Inc.

LAYOUT PLAN

PLEASE CONSIDER THE ENVIRONMENT BEFORE PRINTING THIS

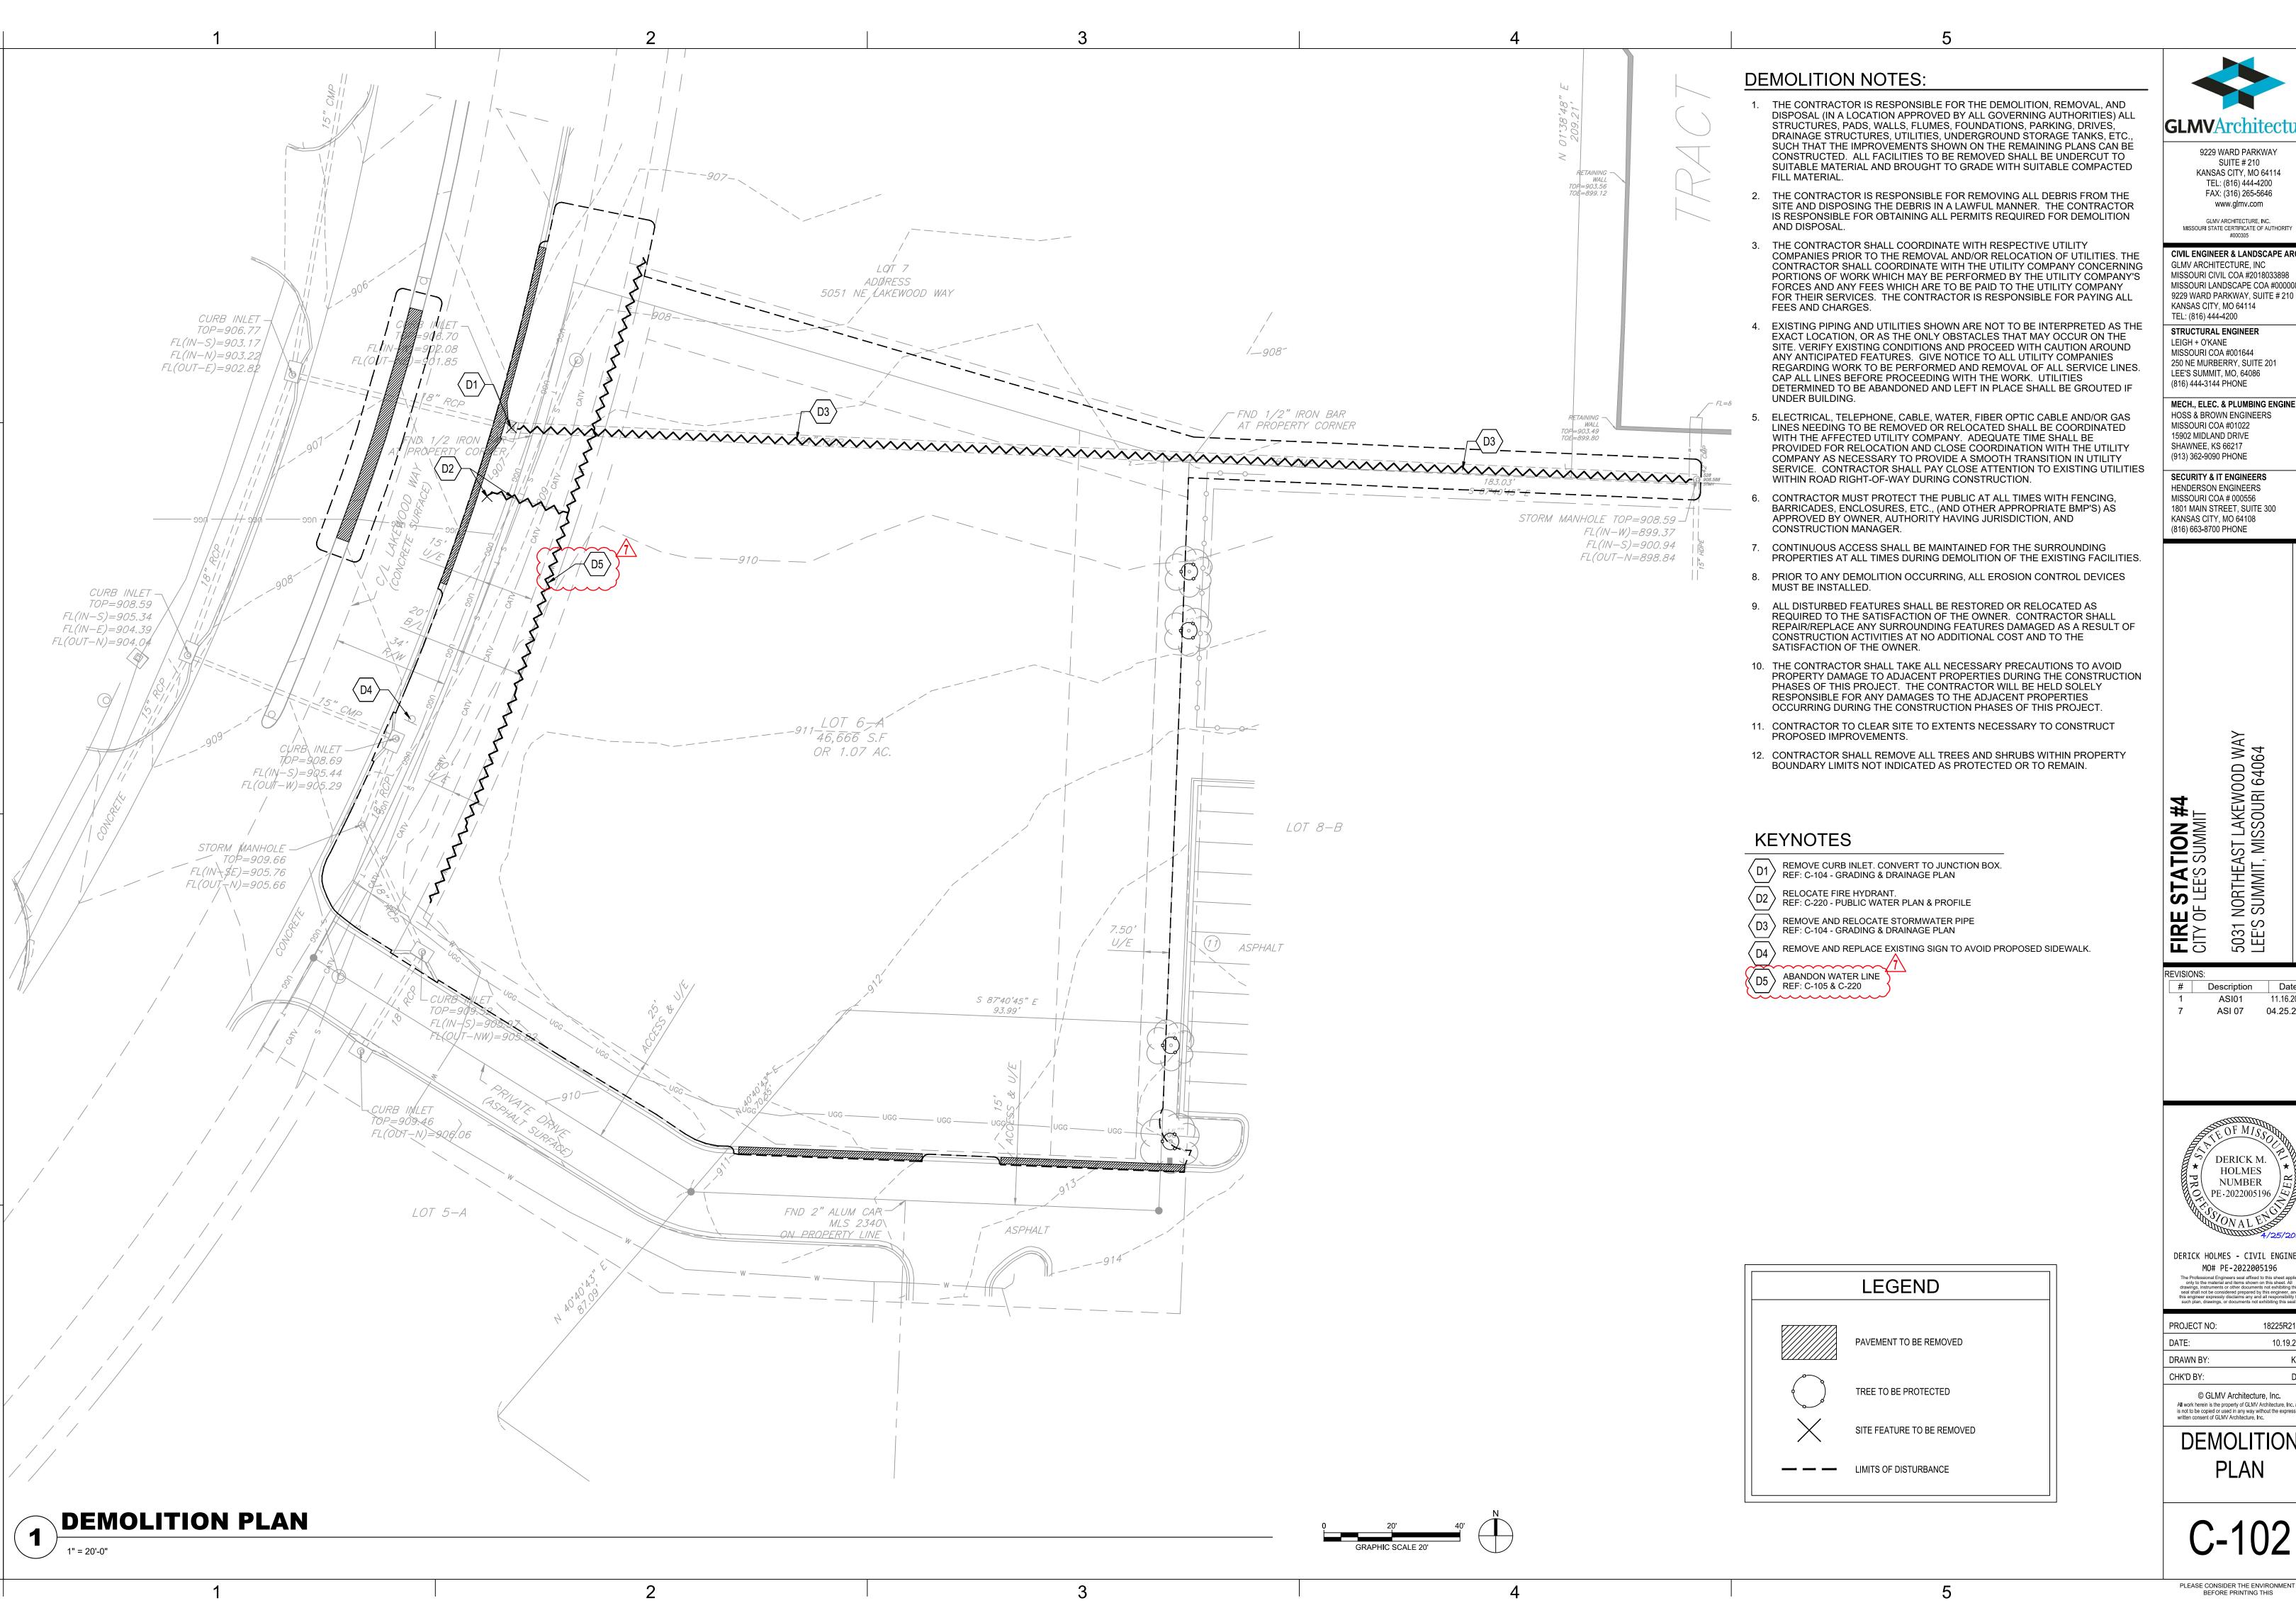

9229 WARD PARKWAY SUITE # 210 KANSAS CITY, MO 64114 TEL: (816) 444-4200 FAX: (316) 265-5646

www.glmv.com GLMV ARCHITECTURE, INC. MISSOURI STATE CERTIFICATE OF AUTHORITY

CIVIL ENGINEER & LANDSCAPE ARCH. GLMV ARCHITECTURE, INC MISSOURI CIVIL COA #2018033898 MISSOURI LANDSCAPE COA #000008 9229 WARD PARKWAY, SUITE # 210

KANSAS CITY, MO 64114 TEL: (816) 444-4200 STRUCTURAL ENGINEER LEIGH + O'KANE

MISSOURI COA #001644 250 NE MURBERRY, SUITE 201 LEE'S SUMMIT, MO, 64086

(816) 444-3144 PHONE MECH., ELEC. & PLUMBING ENGINEERS HOSS & BROWN ENGINEERS

MISSOURI COA #01022 15902 MIDLAND DRIVE SHAWNEE, KS 66217 (913) 362-9090 PHONE

SECURITY & IT ENGINEERS HENDERSON ENGINEERS MISSOURI COA # 000556

1801 MAIN STREET, SUITE 300 KANSAS CITY, MO 64108 (816) 663-8700 PHONE

5031 NORTHEAST LEE'S SUMMIT, M

Description Date ASI01

11.16.2022 ASI 07 04.25.2023


HOLMES NUMBER ↑ PE 2022005196


DERICK HOLMES - CIVIL ENGINEER MO# PE-2022005196

PROJECT NO: 18225R21001 DATE: 10.19.2022 DRAWN BY: KDW CHK'D BY:

© GLMV Architecture, Inc. All work herein is the property of GLMV Architecture. Inc. and

DEMOLITION PLAN

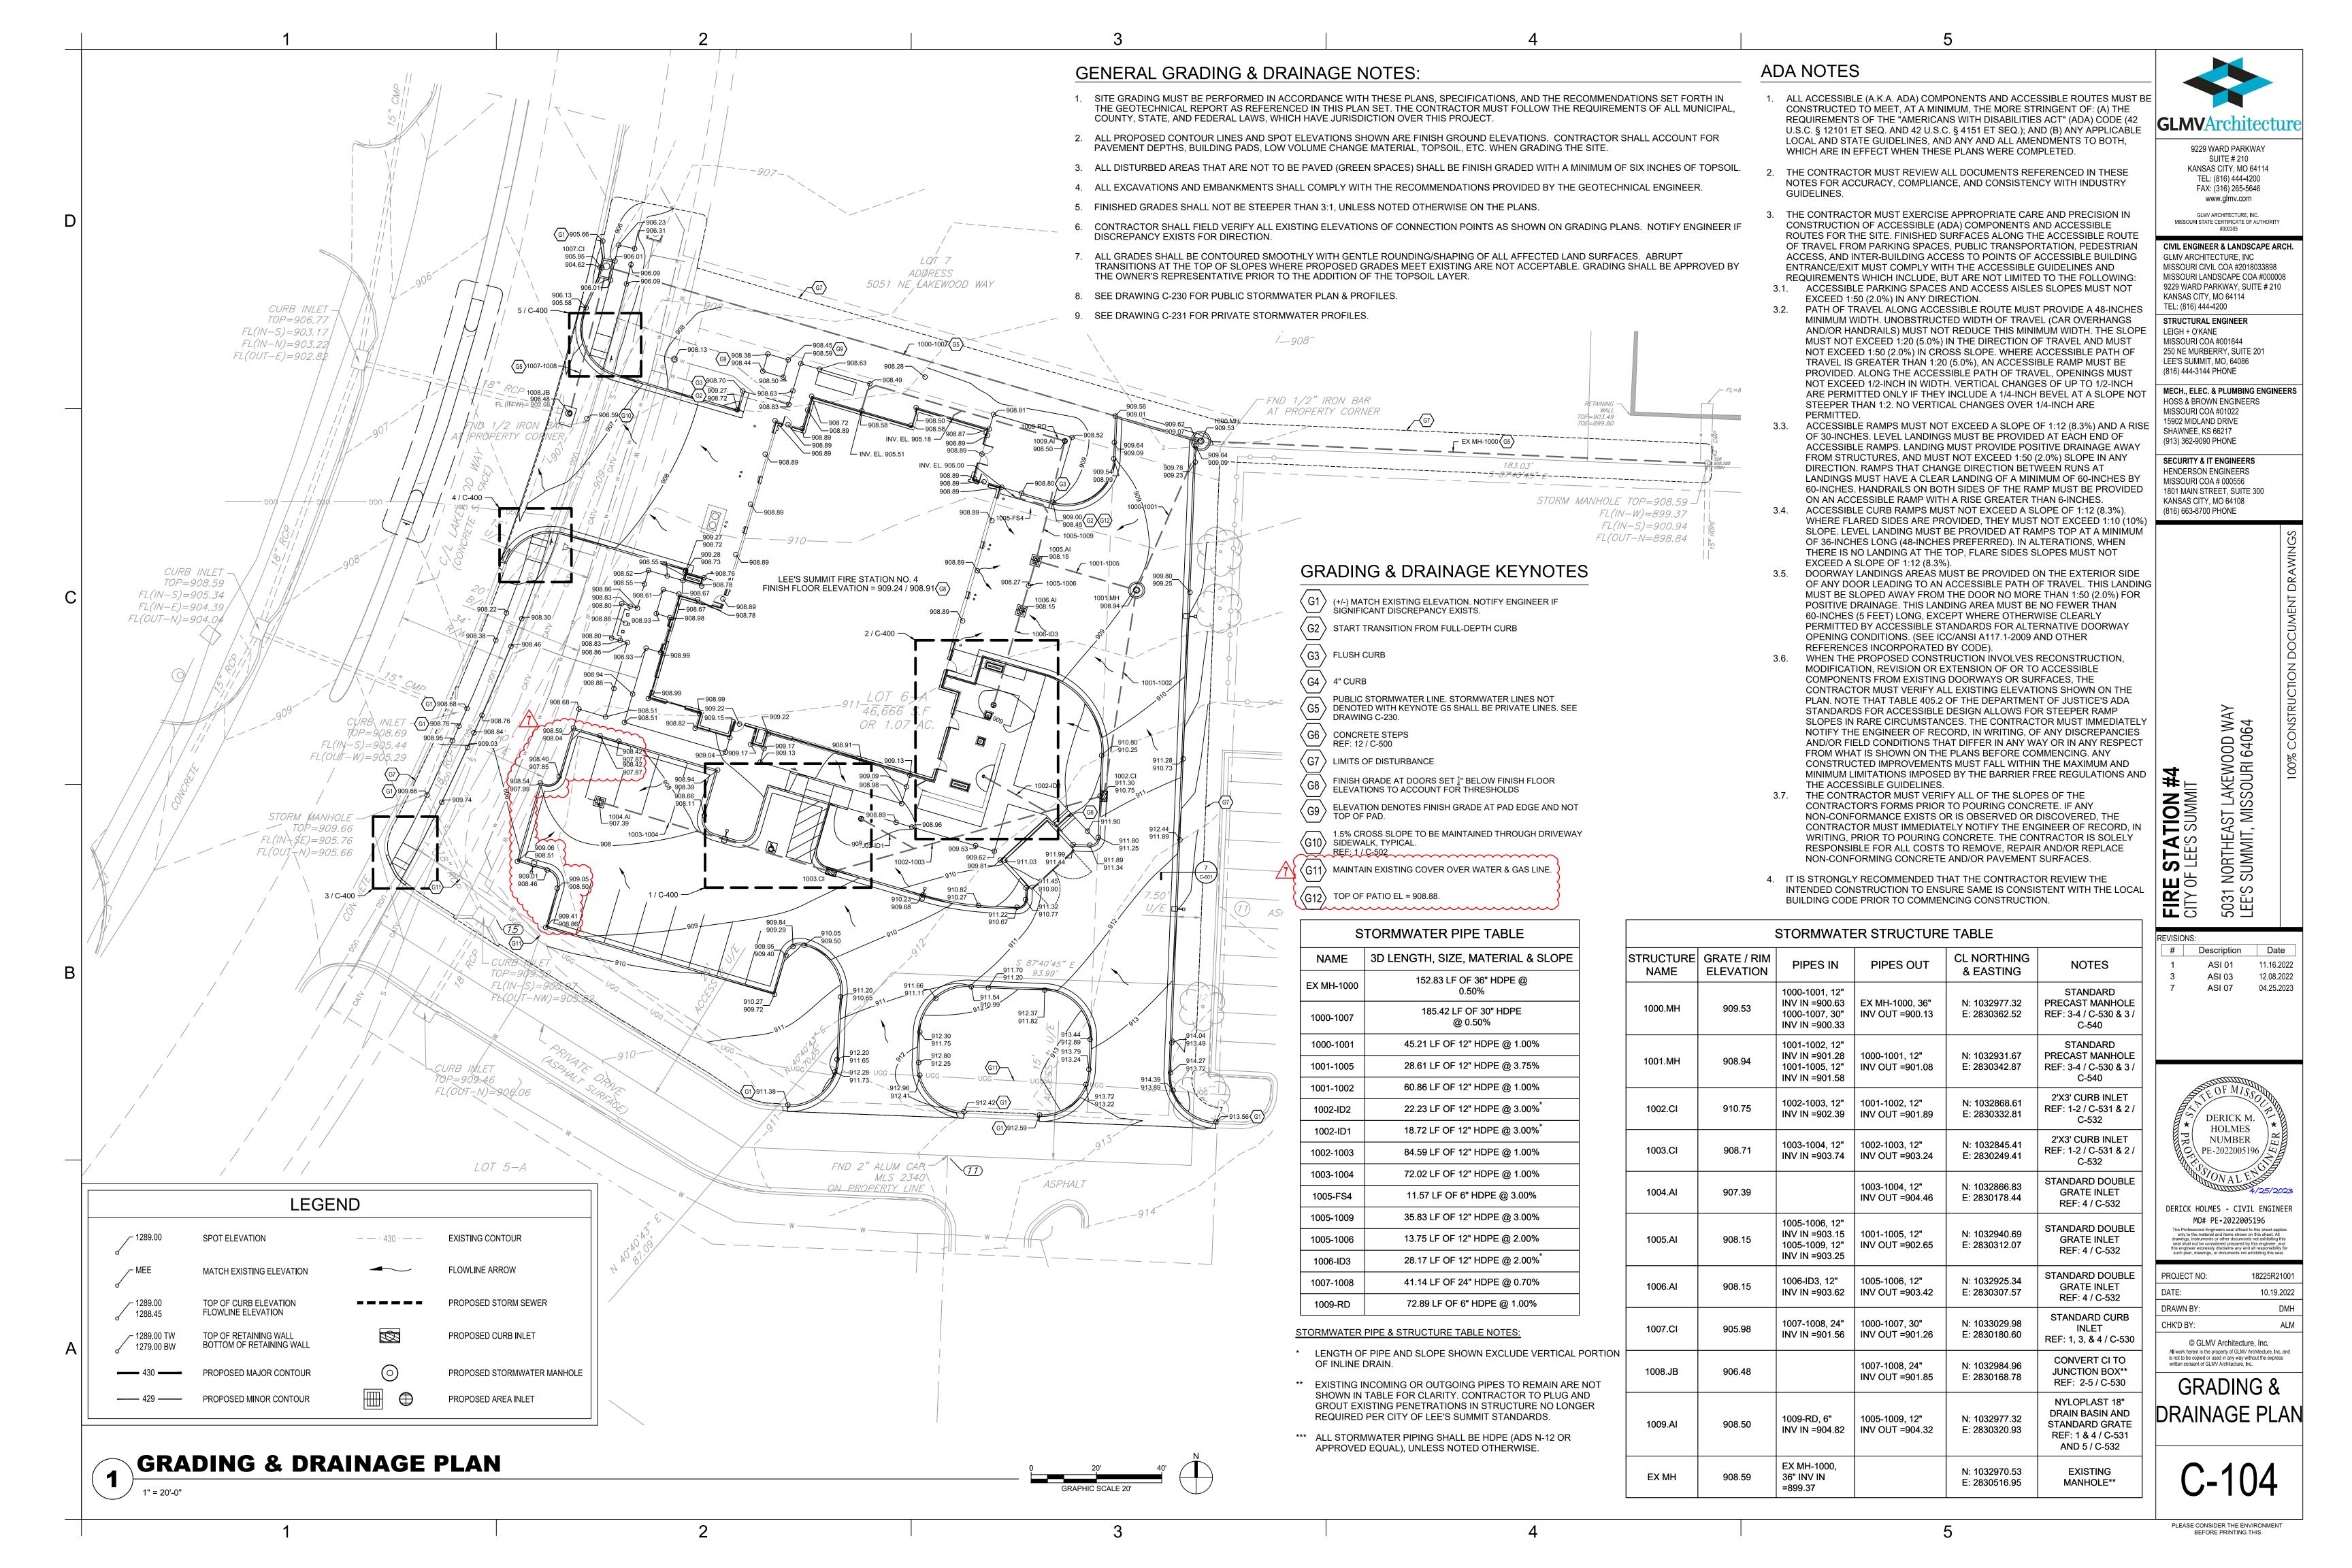

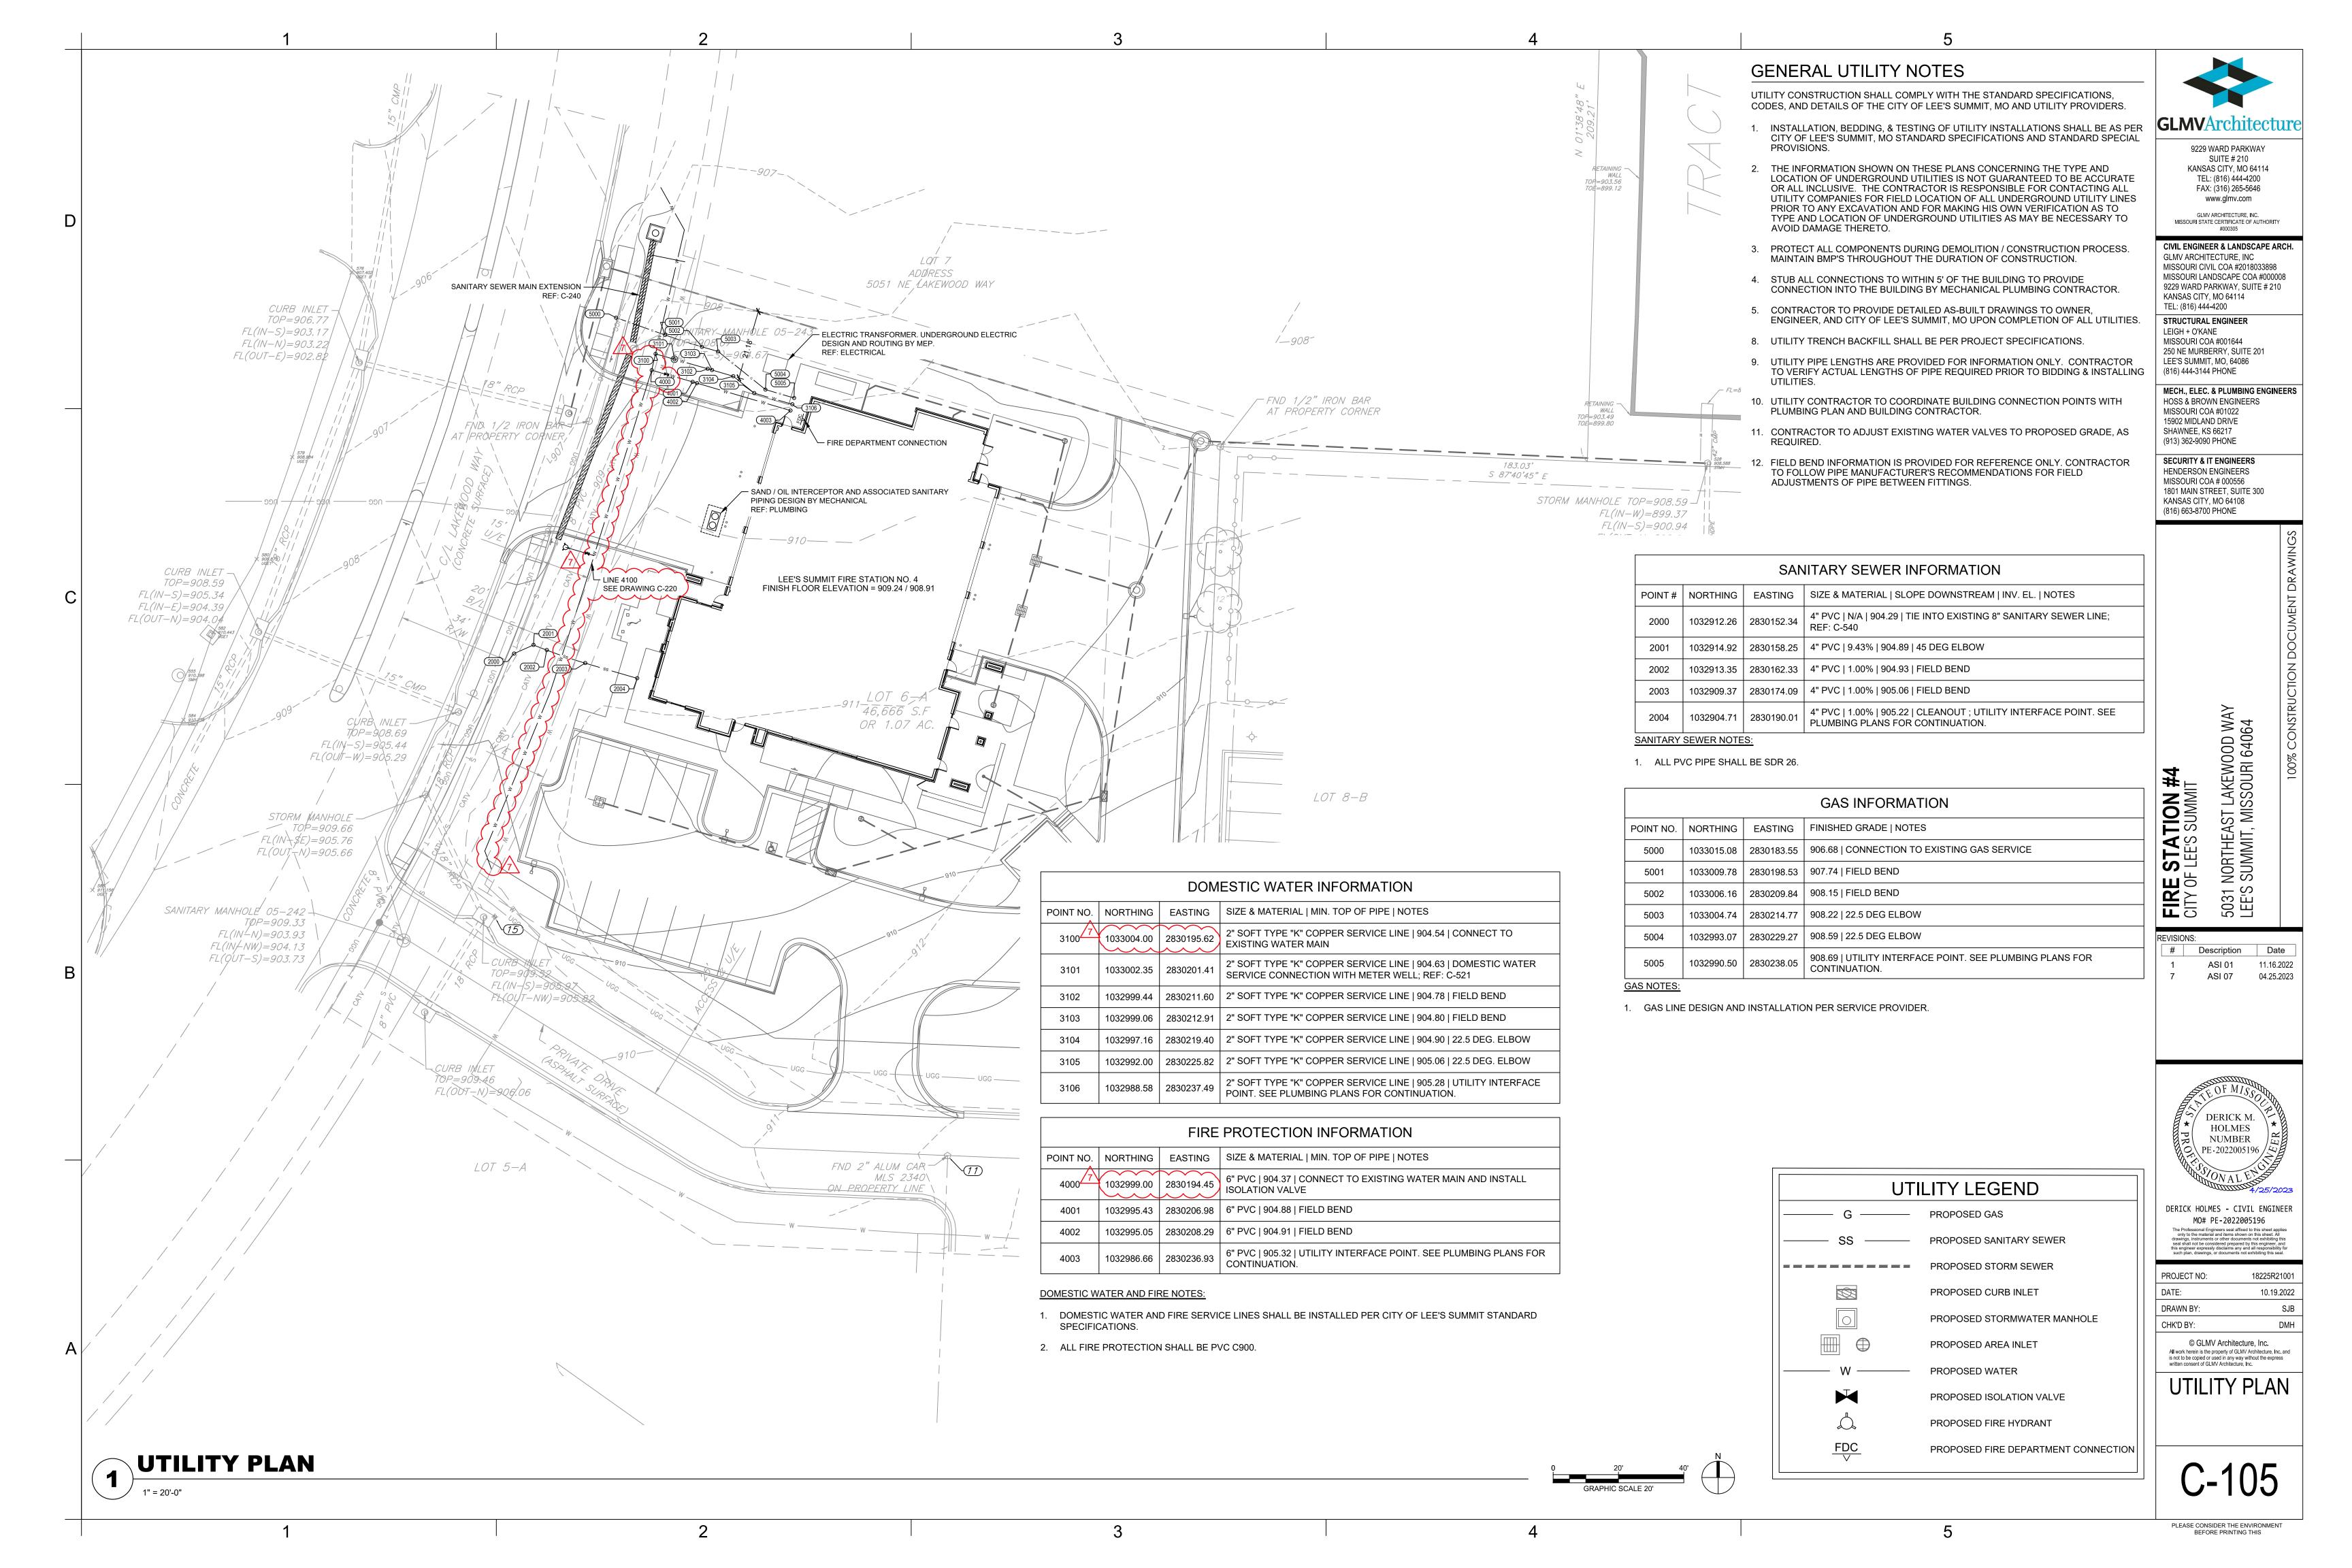

GENERAL NOTES: 1. SEE DRAWING C-105 FOR GENERAL NOTES APPLICABLE TO THIS DRAWING. /--STA. 0+70.46, PUBLIC WTR LINE 4100 STA. 0+59.46, PUBLIC WTR LINE 4100-0.7° DEFLECTION INSTALL FIRE HYDRANT ASSEMBLY - STRAIGHT SET N=1032931.75 LENGTH = 9.0' E=2830173.55 REF: 5 / C-520 N=1032942.25 E=2830176.82 -STA. 1+03.63, PUBLIC WTR LINE 4100 4.4° DEFLECTION N=1032900.20 LEE'S SUMMIT FIRE STATION NO. E=2830163.30 LINE 3100 + REF: C-105 LINE 4000 --STA. 1+61.98, PUBLIC WTR LINE 4100 REF: C-105 REF: C-105 INSTALL 45° BEND & CONNECT TO EXISTING PIPE N=1032846.16 E=2830145.43 STA. 0+00.00, PUBLIC WTR LINE 4100-CONNECT TO EXISTING PIPE (CONCRETE SURFACE) — C/L LAKEWOOD WAY N=1032999.03 -STA. 1+55.95, PUBLIC WTR LINE 4100 E=2830194.46 INSTALL 45° BEND N=1032851.83 E=2830143.37 **PUBLIC WATER LINE 4100 PLAN** SCALE: HORIZONTAL 1"=40' EXISTING GRADE 910.00 910.00 FINAL GRADE -900.00 8 " DIP @ 5.24% 52.32 LF 8 " PVC C900 @ 5.24% 8 " PVC C900 8 ' PV¢ C900 @ -0.18% @ 2.66%

> **PUBLIC WATER LINE 4100 PROFILE** SCALE: HORIZONTAL 1"=40' SCALE: VERTICAL 1"=4'

908.63 907.76 909.13 909.44 907.54 909.68 908.60 910.21 910.21 909.03 910.31 909.03

-0+40 -0+20 0+00 0+20 0+40 0+60 0+80 1+00 1+20 1+40 1+60 1+80

GLMVArchitecture

9229 WARD PARKWAY SUITE # 210 KANSAS CITY, MO 64114 TEL: (816) 444-4200 FAX: (316) 265-5646 www.glmv.com

GLMV ARCHITECTURE, INC. MISSOURI STATE CERTIFICATE OF AUTHORITY #000305

CIVIL ENGINEER & LANDSCAPE ARCH. GLMV ARCHITECTURE, INC MISSOURI CIVIL COA #2018033898 MISSOURI LANDSCAPE COA #000008 9229 WARD PARKWAY, SUITE # 210 KANSAS CITY, MO 64114

TEL: (816) 444-4200 STRUCTURAL ENGINEER LEIGH + O'KANE MISSOURI COA #001644

250 NE MURBERRY, SUITE 201 LEE'S SUMMIT, MO, 64086 (816) 444-3144 PHONE MECH., ELEC. & PLUMBING ENGINEERS


HOSS & BROWN ENGINEERS MISSOURI COA #01022 15902 MIDLAND DRIVE SHAWNEE, KS 66217

SECURITY & IT ENGINEERS HENDERSON ENGINEERS MISSOURI COA # 000556 1801 MAIN STREET, SUITE 300 KANSAS CITY, MO 64108 (816) 663-8700 PHONE

(913) 362-9090 PHONE

FIRE STATION #
CITY OF LEE'S SUMMIT 5031 NORTHEAST LEE'S SUMMIT, M

REVISIONS: # Description Date ASI 07 04.25.2023

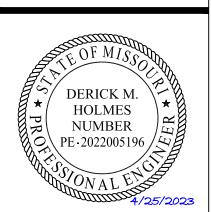

DERICK HOLMES - CIVIL ENGINEER MO# PE-2022005196


PROJECT NO:	18225R21001
DATE:	10.19.2022
DRAWN BY:	HFL
CHK'D BY:	CDW

© GLMV Architecture, Inc.

All work herein is the property of GLMV Architecture, Inc. and is not to be copied or used in any way without the express written consent of GLMV Architecture, Inc.

PUBLIC WATER PLAN & PROFILE

PLEASE CONSIDER THE ENVIRONMENT BEFORE PRINTING THIS

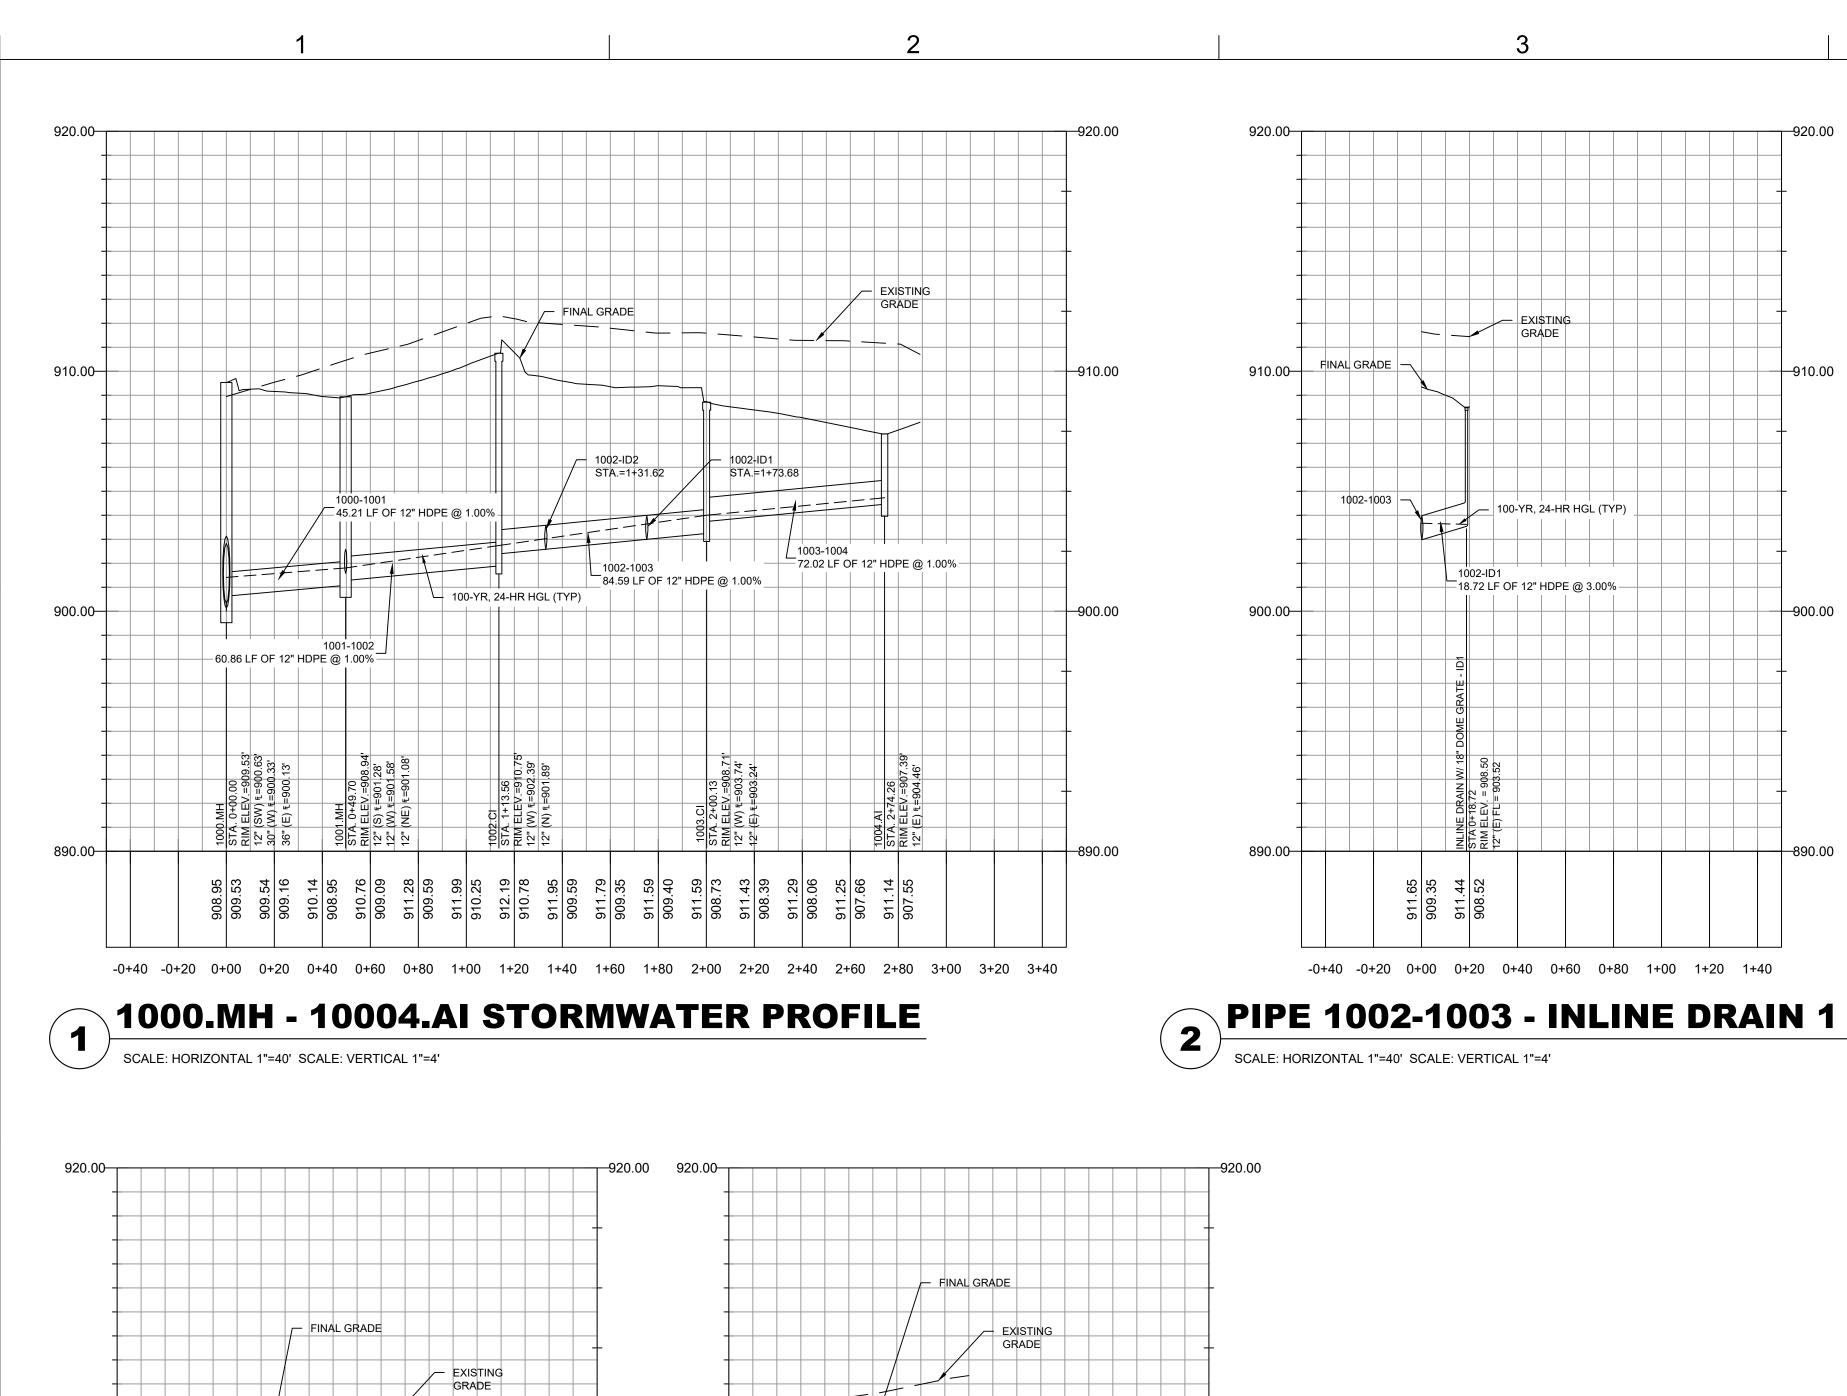

--910.00 910.00--


--900.00 900.00-


STA.=0+47.31

35.83 LF OF 12" HDPE @ 3.00%

1005-1006

13.75 LF OF 12" HDPE @ 2.00%

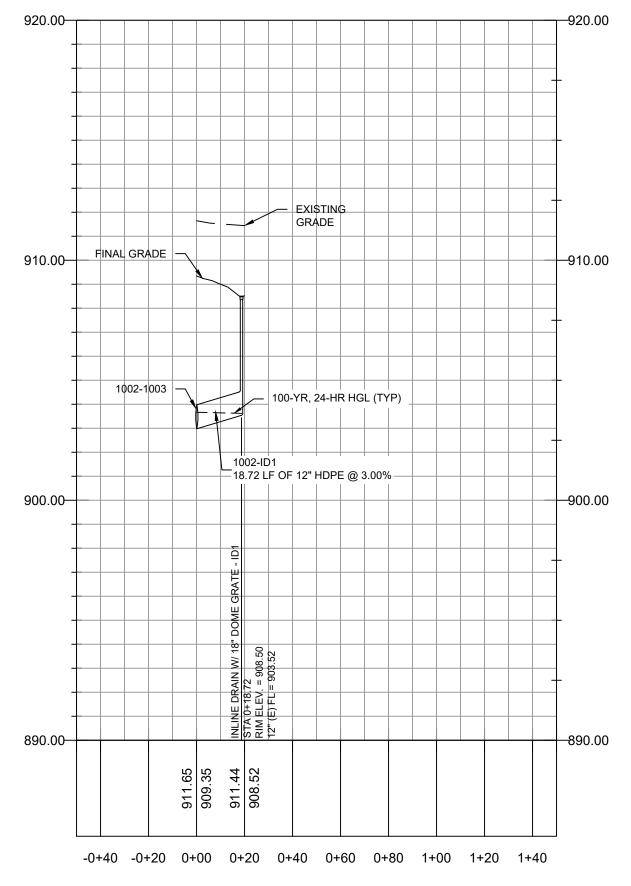

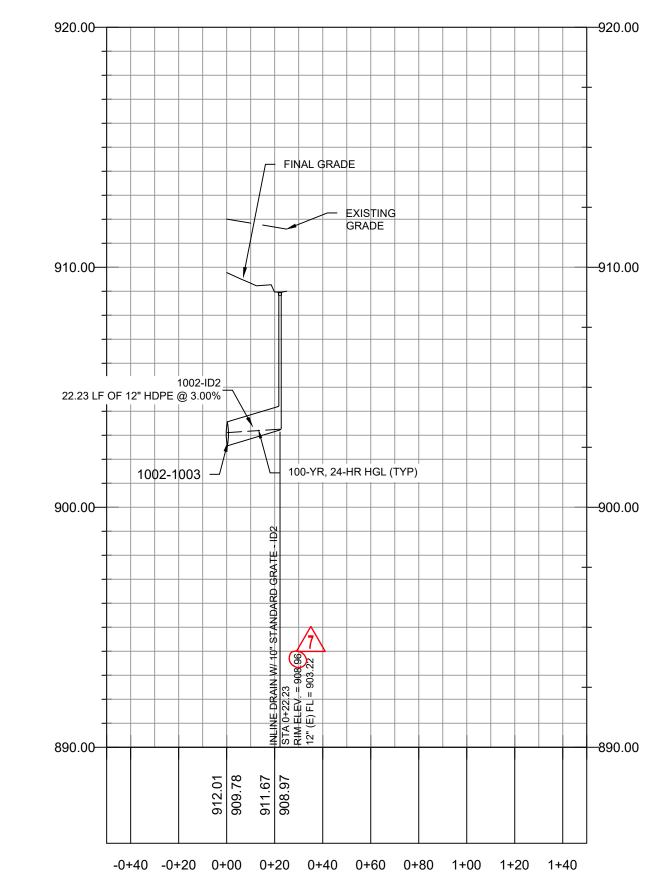

PIPE 1002-1003 - INLINE DRAIN 2

GENERAL NOTES:

- 1. CONSTRUCTION OF STORMWATER IMPROVEMENTS SHALL BE AS PER CITY OF LEE'S SUMMIT, MO AND PROJECT SPECIFICATIONS.
- 2. THE INFORMATION SHOWN ON THESE PLANS CONCERNING THE TYPE AND LOCATION OF UNDERGROUND UTILITIES IS NOT GUARANTEED TO BE ACCURATE OR ALL INCLUSIVE. THE CONTRACTOR IS RESPONSIBLE FOR CONTACTING ALL UTILITY COMPANIES FOR FIELD LOCATION OF ALL UNDERGROUND UTILITY LINES PRIOR TO ANY EXCAVATION AND FOR MAKING HIS OWN VERIFICATION AS TO TYPE AND LOCATION OF UNDERGROUND UTILITIES AS MAY BE NECESSARY TO AVOID DAMAGE THERETO.
- PROTECT ALL COMPONENTS DURING DEMOLITION / CONSTRUCTION PROCESS. MAINTAIN BMP'S THROUGHOUT THE DURATION OF CONSTRUCTION.
- 4. CONTRACTOR TO PROVIDE DETAILED AS-BUILT DRAWINGS TO OWNER, ENGINEER, AND CITY OF LEE'S SUMMIT, MO UPON COMPLETION OF ALL IMPROVEMENTS.



9229 WARD PARKWAY SUITE # 210 KANSAS CITY, MO 64114 TEL: (816) 444-4200 FAX: (316) 265-5646 www.glmv.com

GLMV ARCHITECTURE, INC. MISSOURI STATE CERTIFICATE OF AUTHORITY

CIVIL ENGINEER & LANDSCAPE ARCH. GLMV ARCHITECTURE, INC MISSOURI CIVIL COA #2018033898 MISSOURI LANDSCAPE COA #000008 9229 WARD PARKWAY, SUITE # 210 KANSAS CITY, MO 64114

TEL: (816) 444-4200 STRUCTURAL ENGINEER LEIGH + O'KANE MISSOURI COA #001644

250 NE MURBERRY, SUITE 201 LEE'S SUMMIT, MO, 64086 (816) 444-3144 PHONE

MECH., ELEC. & PLUMBING ENGINEERS HOSS & BROWN ENGINEERS MISSOURI COA #01022 15902 MIDLAND DRIVE

SHAWNEE, KS 66217 (913) 362-9090 PHONE SECURITY & IT ENGINEERS HENDERSON ENGINEERS

MISSOURI COA # 000556 1801 MAIN STREET, SUITE 300 KANSAS CITY, MO 64108 (816) 663-8700 PHONE

FIRE STATION # 5031 NORTHEAST LEE'S SUMMIT, M

REVISIONS: ASI 03 12.08.2022 ASI 07 04.25.2023

HOLMES NUMBER PE-2022005196 /

DERICK HOLMES - CIVIL ENGINEER MO# PE-2022005196

PROJECT NO:	18225R21001
DATE:	10.19.2022
DRAWN BY:	HFL
CHK'D BY:	DMH

© GLMV Architecture, Inc. All work herein is the property of GLMV Architecture, Inc. and


PRIVATE

STORMWATER **PROFILES**

PLEASE CONSIDER THE ENVIRONMENT

100-YR, 24-HR STORM EVENT																		
PIPE NAME	UPSTREAM NODE	DOWNSTREAM NODE	LENGTH (FT)	INLET INVERT ELEVATION (FT)	OUTLET INVERT ELEVATION (FT)	SLOPE (%)	PIPE DIAMETER (INCHES)	MANNING'S ROUGHNESS (N)	ENTRANCE LOSSES	EXIT/BEND LOSSES	PEAK FLOW (CFS)	TIME OF PEAK FLOW OCCURRENCE (DAYS HH:MM)	MAX FLOW VELOCITY (FT/SEC)	TRAVEL TIME (MIN)	DESIGN FLOW CAPACITY (CFS)	MAX FLOW / DESIGN FLOW RATIO	MAX FLOW DEPTH (FT)	MAX FLOW DEPTH / TOTAL DEPTH RATIO
1000-1001	1001.MH	1000.MH	45.21	901.08	900.63	1.00	12	0.012	0.50	0.80	1.89	0 12:05	4.89	0.15	3.85	0.49	0.50	0.50
1001-1002	1002.CI	1001.MH	60.86	901.89	901.28	1.00	12	0.012	0.50	0.90	1.03	0 12:05	4.18	0.24	3.86	0.27	0.35	0.35
1001-1005	1005.AI	1001.MH	28.61	902.65	901.58	3.75	12	0.012	0.50	0.90	0.86	0 12:05	6.34	0.08	7.46	0.12	0.23	0.23
1002-1003	1003.CI	1002.CI	84.59	903.24	902.39	1.00	12	0.012	0.50	0.70	1.00	0 12:05	4.12	0.17	3.91	0.26	0.35	0.35
1002-ID1	ID1	WYE	18.72	903.52	902.98	3.00	12	0.012	0.50	0.70	0.09	0 12:05	2.95	0.11	6.56	0.01	0.08	0.08
1002-ID2	ID2	WYE	22.23	903.22	902.56	3.00	12	0.012	0.50	0.70	0.01	0 10:15	1.69	0.22	6.65	0.00	0.03	0.03
1003-1004	1004.AI	1003.CI	72.02	904.46	903.74	1.00	12	0.012	0.50	0.60	0.61	0 12:05	3.60	0.33	3.86	0.16	0.27	0.27
1005-1006	1006.AI	1005.AI	13.75	903.42	903.15	2.00	12	0.012	0.50	0.80	0.25	0 12:05	3.52	0.07	5.41	0.05	0.15	0.15
1005-1009	1009.AI	1005.AI	35.83	904.32	903.25	3.00	12	0.012	0.50	0.80	0.47	0 11:40	4.92	0.12	6.67	0.07	0.18	0.18
1006-ID3	ID3	1006.AI	28.17	904.18	903.62	2.00	12	0.012	0.50	0.50	0.08	0 12:05	2.50	0.19	5.44	0.01	0.08	0.08

SCALE: HORIZONTAL 1"=40' SCALE: VERTICAL 1"=4'

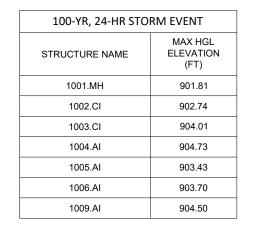

1001.MH - 1009.AI

SCALE: HORIZONTAL 1"=40' SCALE: VERTICAL 1"=4'

-0+40 -0+20 0+00 0+20 0+40 0+60 0+80 1+00 1+20 1+40

28.61 LF OF 12" HDPE @ 3.75%


1005.AI - INLINE DRAIN 3 SCALE: HORIZONTAL 1"=40' SCALE: VERTICAL 1"=4'

-0+40 -0+20 0+00 0+20 0+40 0+60 0+80 1+00 1+20 1+40

100-YR, 24-HR HGL (TYP)

28.17 LF OF 12" HDPE @ 2.00%

900.00

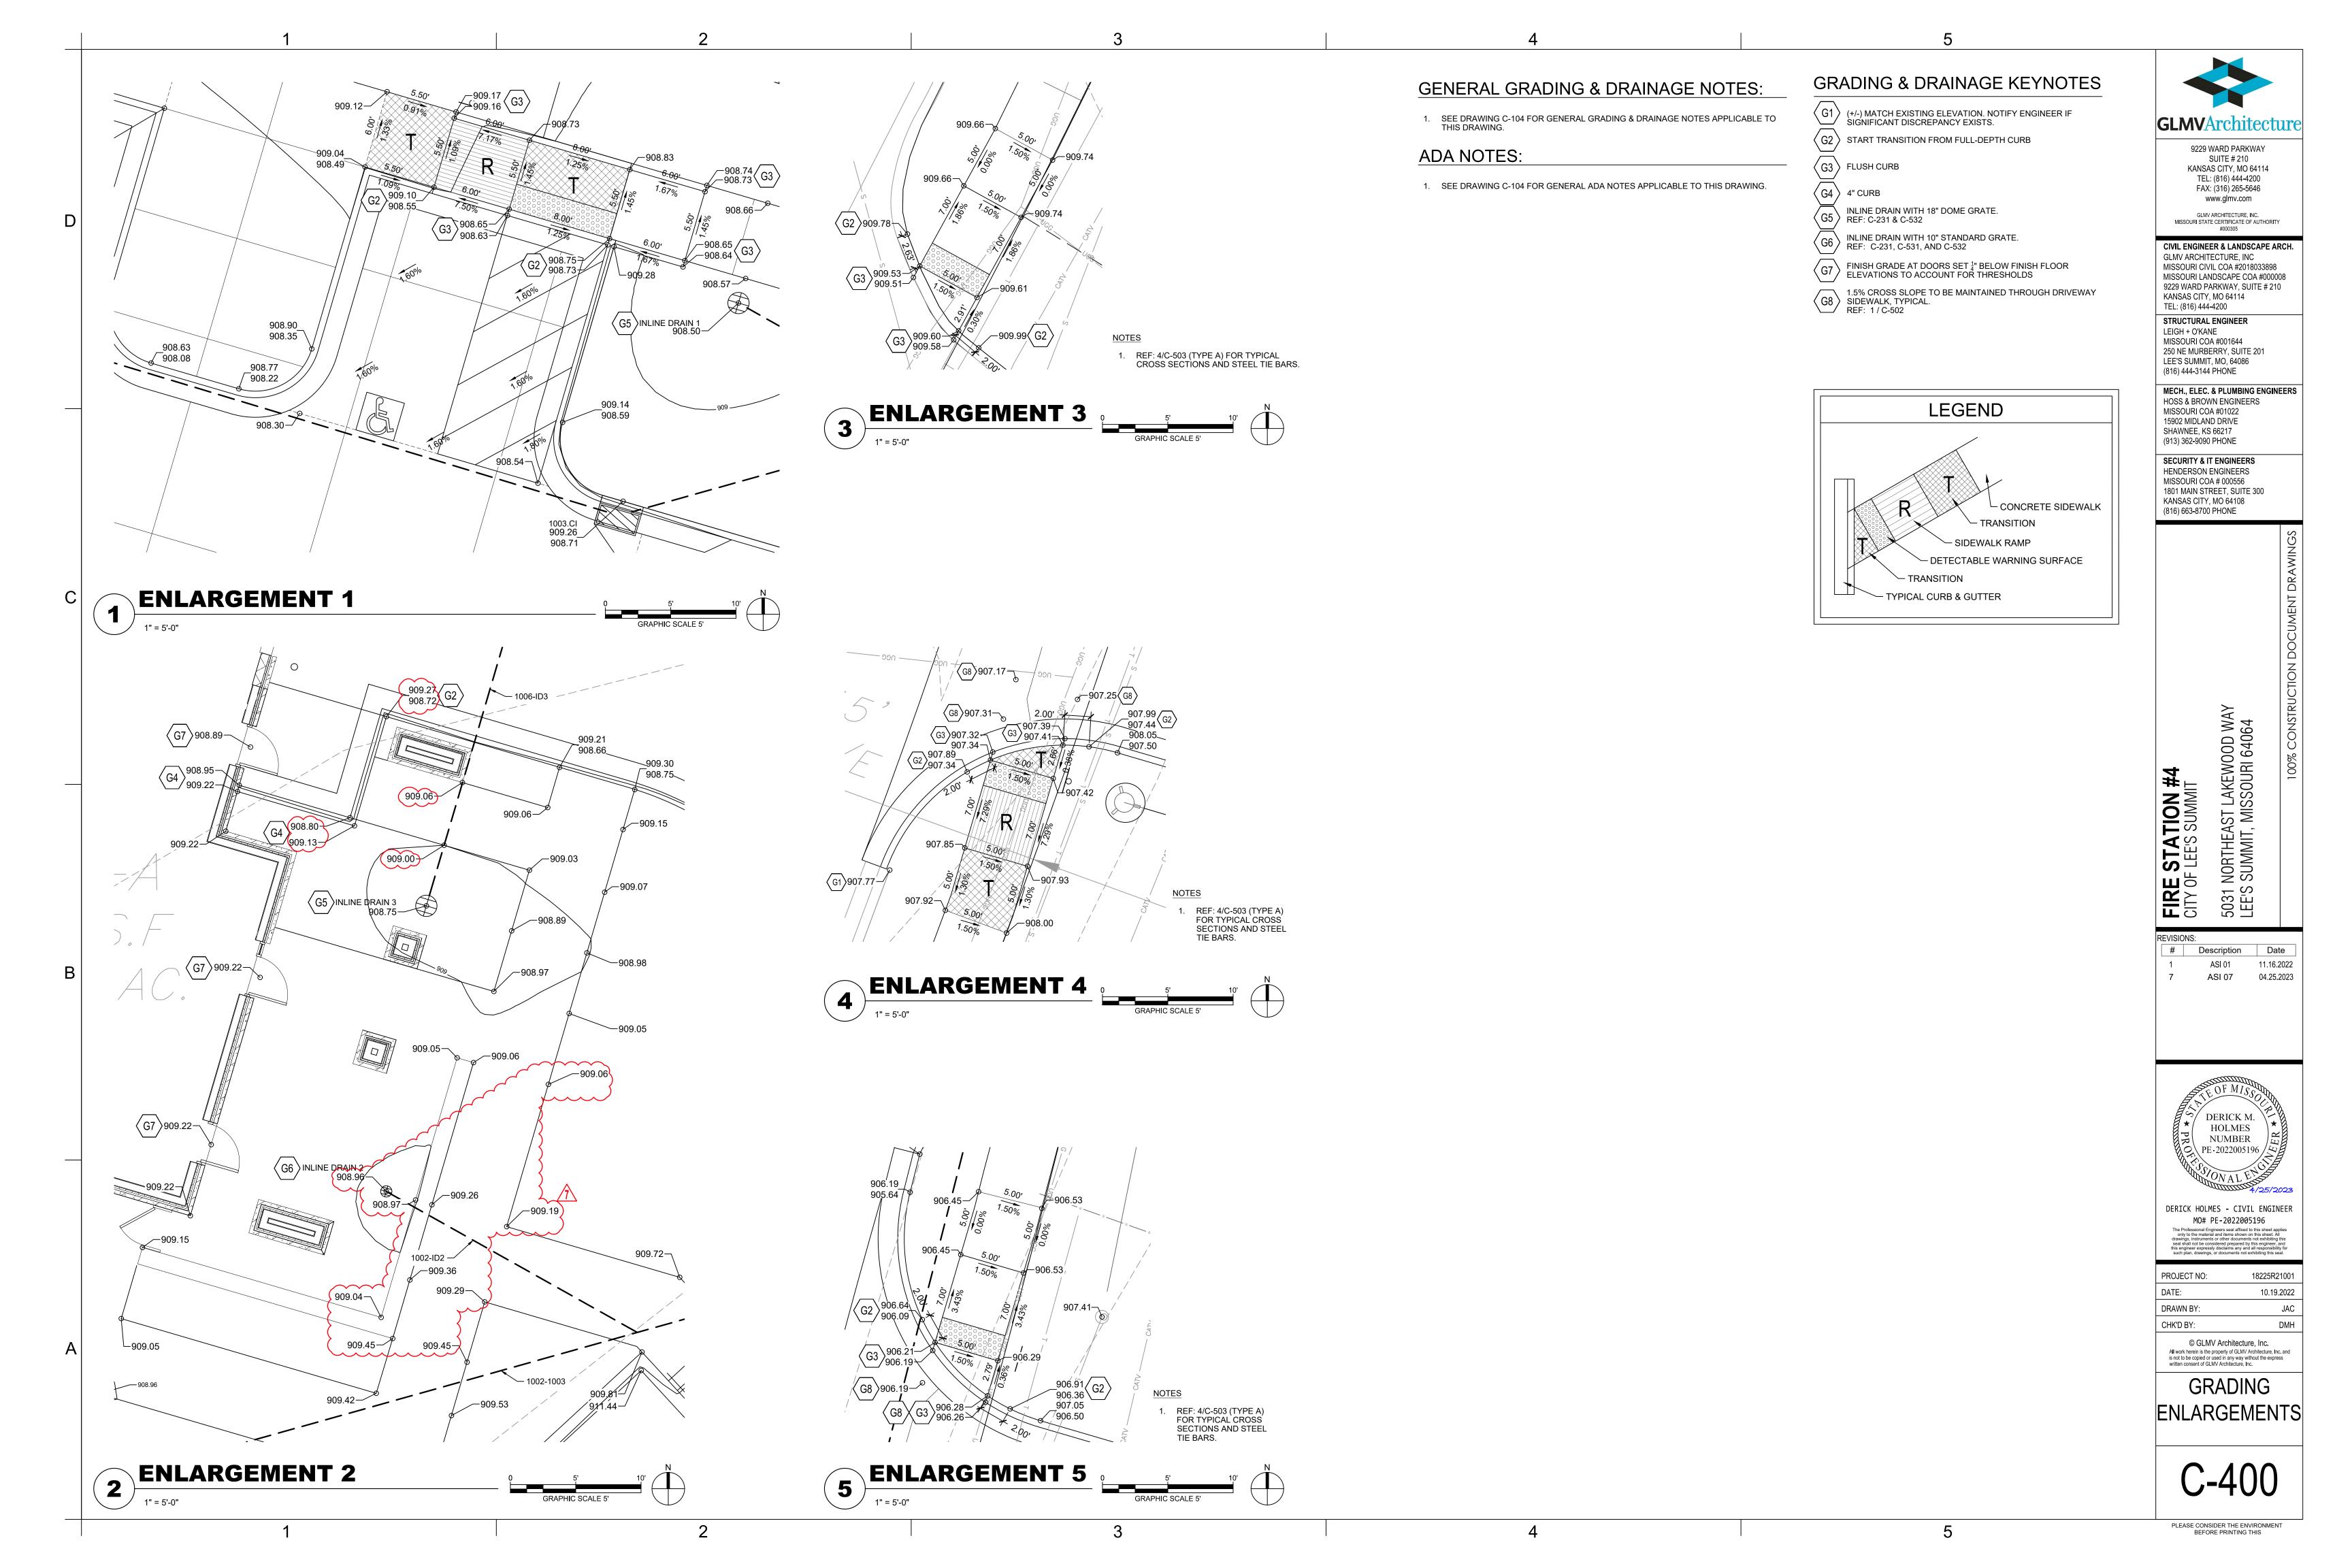

NOTCH STAKE FOR WIRE. POLYPROPYLENE TREE STRAP AT 2/3 TREE HEIGHT WITH NO. 12 GA. GALVANIZED WIRE. PROVIDE SUFFICIENT TENSION TO SUPPORT TREE BUT DO NOT GIRDLE TOP OF ROOTBALL AT 2" ABOVE FINISHED GRADE REMOVE TOP 1/3 OF BURLAP AND ROPE FROM BALL 3" DEPTH HARDWOOD MULCH. KEEP 4" AWAY FROM TRUNK. NOTE: ALL TREES, EXISTING AND PROPOSED, IN TURF AREAS FINISHED GRADE / SHALL HAVE 5' DIAM. MULCH RING. THIS DIMENSION EQUALS 1/2 THE DIAMETER OF THE ROOTBALL AT THE CENTERLINE OF ROOTBALL. 1/2 BALL DIA. PLACE TREE IN PLANTING POSITION, BACK FILL 1/3RD OR DEPTH, THEN REMOVE ALL TWINE AND BURLAP FROM TOP OF ROOTBALL. WIRE BASKET TO REMAIN IN PLACE, BEND TOP LOOPS DOWN. EXPOSE ROOT FLARE AT BASE OF TRUNK. PLANTING SOIL BACKFILL UNDISTURBED SUBGRADE **PREVAILING** WINDS

EVERGREEN TREE PLANTING

FINISHED GRADE

SECTION

PREVAILING WINDS

DECIDUOUS TREE PLANTING

NOTE: PRUNE ALL BROKEN AND DAMAGED

(SEE SPECS)

(5) 1" DEEP CUTS.

PLANTING SOIL BACKFILL

PLANTING SOIL BACKFILL

3" DEPTH HARDWOOD MULCH

REMOVE TOP 1/3 OF BURLAP

REMOVE CONTAINER AND SLASH

SIDES OF ROOTBALL WITH (4) TO

AND ROPE FROM BALL OR

UNDISTURBED SUBGRADE

BRANCHES, AFTER PLANTING

TREE PIT EQUALS 2X DIAM. OF ROOTBALL AT CENTERLINE OF ROOTBALL BOTTOM OF TREE PIT (VARIES) ROOTBALL VARIES

> 2 X 2 SOUND HARDWOOD STAKE TO BE ANGLED APPROX. 30 DEGREES FROM VERTICAL AND DRIVEN 2'-0" MIN. INTO UNDISTURBED SOIL. PLACE STAKE ON WINDWARD SIDE OF TRUNK, I.E. IF PREVAILING WIND IS FROM THE N/NW, PLACE STAKE ON WEST SIDE OF TREE.

TOP OF TREE PIT (VARIES)

POLYPROPYLENE TREE STRAP ABOVE LOWEST BRANCHES WITH NO. 12 GA. GALVANIZED WIRE TIE ASSEMBLY

5' DIAM. MULCH RING AROUND ALL

EXISTING TREES

TREES IN TURF AREAS INCLUDING

9. PLANT MATERIAL SHALL NOT BE DELIVERED TO THE SITE NOR INSTALLED WHEN TEMPERATURES ARE ABOVE 90°F OR BELOW 40°F AT THE TIME OF PLANTING AND FORECASTED FOR A PERIOD OF 2 WEEKS AFTER INSTALLATION.

INADEQUATE AMENITIES.

QUANTITIES AND LABELS.

WEEDING, AND FERTILIZING.

DURING THE MAINTENANCE PERIOD.

10. CONTRACTOR TO PROVIDE A 1-YEAR WARRANTY ON ALL INSTALLED PLANTINGS FROM POINT OF SUBSTANTIAL COMPLETION.

IN THE NEAR VICINITY OF THE CONSTRUCTION TO BE PERFORMED.

ORDERING OR INSTALLING MATERIALS SPECIFIED.

3. SEE PLANT SCHEDULE FOR PLANT LEGEND AND QUANTITIES.

4. SYMBOLS INDICATED ON THE PLAN TAKE PRIORITY OVER WRITTEN

2. CONTRACTOR SHALL VERIFY ALL PLANT COUNTS, QUANTITIES AND AREAS

5. PLANTS CALLED OUT IN PLAN ARE CONSIDERED IN CLUSTERS EVEN IF NOT

7. CONTRACTOR SHALL BE RESPONSIBLE FOR DISEASE AND PEST CONTROL

NEEDED AND CONTACT THE LANDSCAPE ARCHITECT IF THERE ARE ANY

8. CONTRACTOR TO VERIFY, WITH SOIL ANALYSIS, THE SOIL AMENDMENT

6. CONTRACTOR SHALL MAINTAIN THE LANDSCAPE UNTIL SUBSTANTIAL

ATTACHED BY CONNECTING LINES. CALLOUTS HAVE TOTAL COUNTS NEEDED.

COMPLETION. MAINTENANCE WORK SHALL CONSIST OF APPLYING WATER,

AND REPORT ANY DISCREPANCIES TO THE LANDSCAPE ARCHITECT PRIOR TO

- ALL PLANT MATERIAL SHALL BE OF EXCELLENT QUALITY, FREE OF DISEASE AND INFESTATION, AND TRUE TO TYPE, VARIETY, SIZE SPECIFIED, AND FORM PER THE AMERICAN STANDARD FOR NURSERY STOCK (ANSI Z60.1, CURRENT VERSION), PUBLISHED BY THE AMERICAN NURSERYMEN'S ASSOCIATION.
- 2. PLANT MATERIAL SHALL BE PLANTED AND MAINTAINED TO ASNS SPECIFICATIONS.
- 3. CONTRACTOR SHALL VERIFY ALL LANDSCAPE MATERIAL QUANTITIES AND SHALL REPORT ANY DISCREPANCIES IMMEDIATELY TO THE LANDSCAPE ARCHITECT.
- 4. NO SUBSTITUTIONS FOR VARIETY OR CULTIVAR SHALL BE ACCEPTED WITHOUT FIRST OBTAINING WRITTEN APPROVAL FROM LANDSCAPE ARCHITECT.
- 5. ALL TREES AND SHRUBS SHALL BE LAID OUT IN A UNIFORM AND CONSISTENT PATTERN, FOLLOWING THE LANDSCAPE PLAN ACCURATELY, PAYING ATTENTION TO EVEN SPACING IN THE ROW OR COVERAGE AREA OF THE INDIVIDUAL SPECIES AND HOW IT IS BEING USED.
- 6. ALL PLANTING BEDS ABUTTING LAWN AREAS SHALL HAVE A CULTIVATED EDGE (SEE DETAIL, THIS SHEET).
- 7. ALL PLANTINGS SHALL BE THOROUGHLY WATERED IN WITH A GARDEN HOSE, TWICE, THE SAME DAY AS INSTALLATION TO ELIMINATE AIR POCKETS IN THE BACKFILL.
- 8. NO PLANTINGS SHALL BE PLACED CLOSER THAN 3' FROM THE BACK OF THE CURB TO ALLOW FOR VEHICLE BUMPER OVERHANG.
- 9. PROPOSED TREES SHALL NOT BE PLACED OVER EXISTING OR PROPOSED UTILITY SERVICE LINES. IT IS THE CONTRACTOR'S RESPONSIBILITY TO UNDERSTAND UTILITY LOCATIONS AND HAVE THEM MARKED DURING TREE PLANTING OPERATIONS. IF UTILITY IS DAMAGED DURING PLANTING, CONTRACTOR IS RESPONSIBLE FOR NOTIFYING THE GENERAL CONTRACTOR AND OWNER OF UTILITY AND PAYING FOR REPAIR OF THE DAMAGED UTILITY.
- 10. ALL PLANTING BEDS WILL HAVE 3-INCHES OF SHREDDED BROWN HARDWOOD MULCH UNLESS OTHERWISE SPECIFIED.

CONT SIZE

GIRDLE TRUNK.

FINISHED GRADE

5' DIAM. MULCH RING.

CENTERLINE OF ROOTBALL.

PLANTING SOIL BACKFILL UNDISTURBED SUBGRADE

NOTE: REMOVE STAKING MATERIAL AFTER FIRST GROWING SEASON

FROM BALL

(3) POLYPROPYLENE TREE STRAPS ABOVE


EVERGREEN TREE STAKING

PREVAILING

WINDS

PLAN

 $==\pm\pm=$

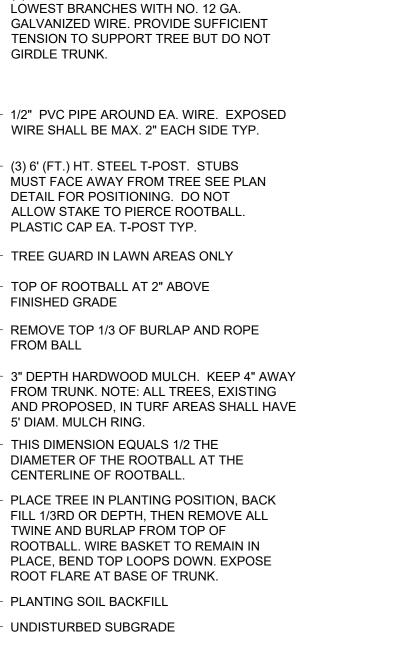


TOP OF TREE PIT (VARIES) TREE PIT EQUALS 2X DIAM. OF ROOTBALL AT CENTERLINE OF ROOTBALL BOTTOM OF TREE PIT (VARIES) ROOTBALL VARIES (3) 6' (FT.) HT. STEEL T-POST PAINTED REFLECTIVE ORANGE. DO NOT ALLOW STAKE TO PIERCE ROOTBALL. PLASTIC CAP EA. T-POST TYP. 1/2" PVC PIPE AROUND EA. WIRE. EXPOSED WIRE SHALL BE MAX. 2" EACH SIDE TYP. (3) POLYPROPYLENE TREE STRAPS ABOVE LOWEST BRANCHES WITH NO. 12 GA. GALVANIZED WIRE. PROVIDE SUFFICIENT TENSION TO

> SUPPORT TREE BUT DO NOT GIRDLE TRUNK. 5' DIAM. MULCH RING AROUND ALL TREES IN TURF AREAS INCLUDING EXISTING TREES PREVAILING NOTE: REMOVE STAKING MATERIAL AFTER FIRST GROWING SEASON

CULTIVATED EDGE: 6"

CULTIVATED EDGE

DECIDUOUS TREE STAKING

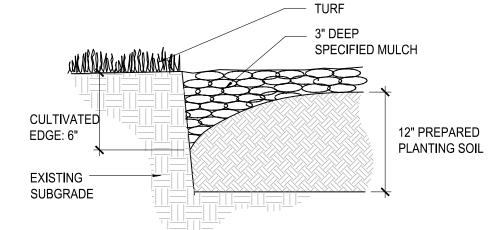

LANDSCAPE SCHEDULE

90% Fescue, 10% Bluegrass Mix

PLANT SCHEDULE <u>QTY</u>

BOTANICAL NAME

IKEES	CODE	<u>QII</u>	BOTANICAL NAME	COMMON NAME	CONT	SIZE	
	MA	4	Malus x 'Adirondack'	Adirondack Crabapple	B & B	3"	
•)	NW	7	Nyssa sylvatica `Wildfire`	Black Gum	В&В	3"	
	ZM	5	Zelkova serrata 'Musashino'	Musashino Sawleaf Zelkova	B & B	3"	
CONIFERS	CODE	<u>QTY</u>	BOTANICAL NAME	COMMON NAME	CONT	SIZE	
	РВ	2	Picea pungens `Baby Blue`	Baby Blue Colorado Spruce	B & B	8` Ht	
	TS	18	Thuja occidentalis 'Smaragd'	Emerald Green Arborvitae	В&В	8` Ht	
SHRUBS	CODE	<u>QTY</u>	BOTANICAL NAME	COMMON NAME	CONT.	SPACING	<u>SPACING</u>
5 5 5 5 5 5 5 5 5 5 5 5 5 5 5 5 5 5 5	Ca	17	Cornus sericea `Artic Fire`	Artic Fire Dogwood	5 gal	Pot	48" o.c.
$\langle \cdot \rangle$	Ec	10	Euonymus alatus `Compactus`	Compact Burning Bush	5 gal	Pot	72" o.c.
And	Но	43	Hemerocallis x 'Stella de Oro'	Stella de Oro Daylily	Quart	Pot	18" o.c.
*	Hf	17	Hosta x 'First Frost'	First Frost Hosta	2 gal	Pot	30" o.c.
\odot	II	10	Itea virginica `Little Henry` TM	Virginia Sweetspire	2 gal	Pot	36" o.c.
\odot	PI	6	Perovskia atriplicifolia `Little Spire` TM	Little Spire Russian Sage	2 gal	Pot	24" o.c.
\odot	Rr	18	Rosa x `Knockout` TM	Rose	2 gal	Pot	48" o.c.
GRASSES	CODE	QTY	BOTANICAL NAME	COMMON NAME	CONT.	SPACING	SPACING
\odot	Ck	21	Calamagrostis x acutiflora `Karl Foerster`	Feather Reed Grass	3 gal.	Pot	36" o.c.
	Fe	28	Festuca glauca `Elijah Blue`	Elijah Blue Fescue	1 gal.	Pot	18" o.c.
(+)	Sp	18	Schizachyrium scoparium `Prairie Munchkin`	Prairie Munchkin Little Bluestem	2 gal	Pot	24" o.c.
\odot	Sh	42	Sporobolus heterolepis	Prairie Dropseed	2 gal	Pot	30" o.c.
EVERGREEN	CODE	QTY	BOTANICAL NAME	COMMON NAME	CONT.	SPACING	SPACING
	JI	19	Juniperus chinensis 'Gold Lace'	Gold Lace Juniper	5 gal	Pot	60" o.c.
\odot	Ja	8	Juniperus horizontalis `Andorra`	Andorra Juniper	2 gal	Pot	48" o.c.
SOD/SEED	CODE	QTY	BOTANICAL NAME	COMMON NAME	SIZE		
* * * * * * * * * * * * * * * * * * *	Fa	17,165 sf	Festuca arundinacea	Tall Fescue	sod		

COMMON NAME

GLMVArchitecture

9229 WARD PARKWAY SUITE # 210 KANSAS CITY, MO 64114 TEL: (816) 444-4200 FAX: (316) 265-5646 www.glmv.com

GLMV ARCHITECTURE, INC. MISSOURI STATE CERTIFICATE OF AUTHORITY

CIVIL ENGINEER & LANDSCAPE ARCH. GLMV ARCHITECTURE, INC MISSOURI CIVIL COA #2018033898 MISSOURI LANDSCAPE COA #000008 9229 WARD PARKWAY, SUITE # 210

KANSAS CITY, MO 64114 TEL: (816) 444-4200 STRUCTURAL ENGINEER LEIGH + O'KANE MISSOURI COA #001644

250 NE MURBERRY, SUITE 201 LEE'S SUMMIT, MO, 64086 (816) 444-3144 PHONE

MECH., ELEC. & PLUMBING ENGINEERS HOSS & BROWN ENGINEERS


MISSOURI COA #01022 15902 MIDLAND DRIVE SHAWNEE, KS 66217 (913) 362-9090 PHONE

SECURITY & IT ENGINEERS HENDERSON ENGINEERS MISSOURI COA # 000556 1801 MAIN STREET, SUITE 300 KANSAS CITY, MO 64108 (816) 663-8700 PHONE

STATIC - LEE'S SU FIRE CITY OF

5031 I LEE'S |REVISIONS:

Description Date ASI 01 11.16.2022 ASI 07 04.25.2023

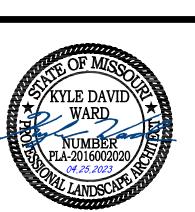

KYLE WARD - LANDSCAPE ARCHITECT MO# PLA-2016002020

PROJECT NO: 18225R21001 DATE: 10.19.2022 DRAWN BY: KDW CHK'D BY: CDW

© GLMV Architecture, Inc. All work herein is the property of GLMV Architecture. Inc. and

LANDSCAPE **SCHEDULE**

PLEASE CONSIDER THE ENVIRONMENT

| • • |

SURROUNDED BY PAVEMENT),

MIXTURE ON WHICH TO POSITION SHRUB

SHRUB PLANTING


GRADE

ROOT BALL

PLANTING BED EDGING (NOT-REQUIRED IN PLANTING BEDS

REF: 6/L-100

COMPACTED PLANTING SOIL

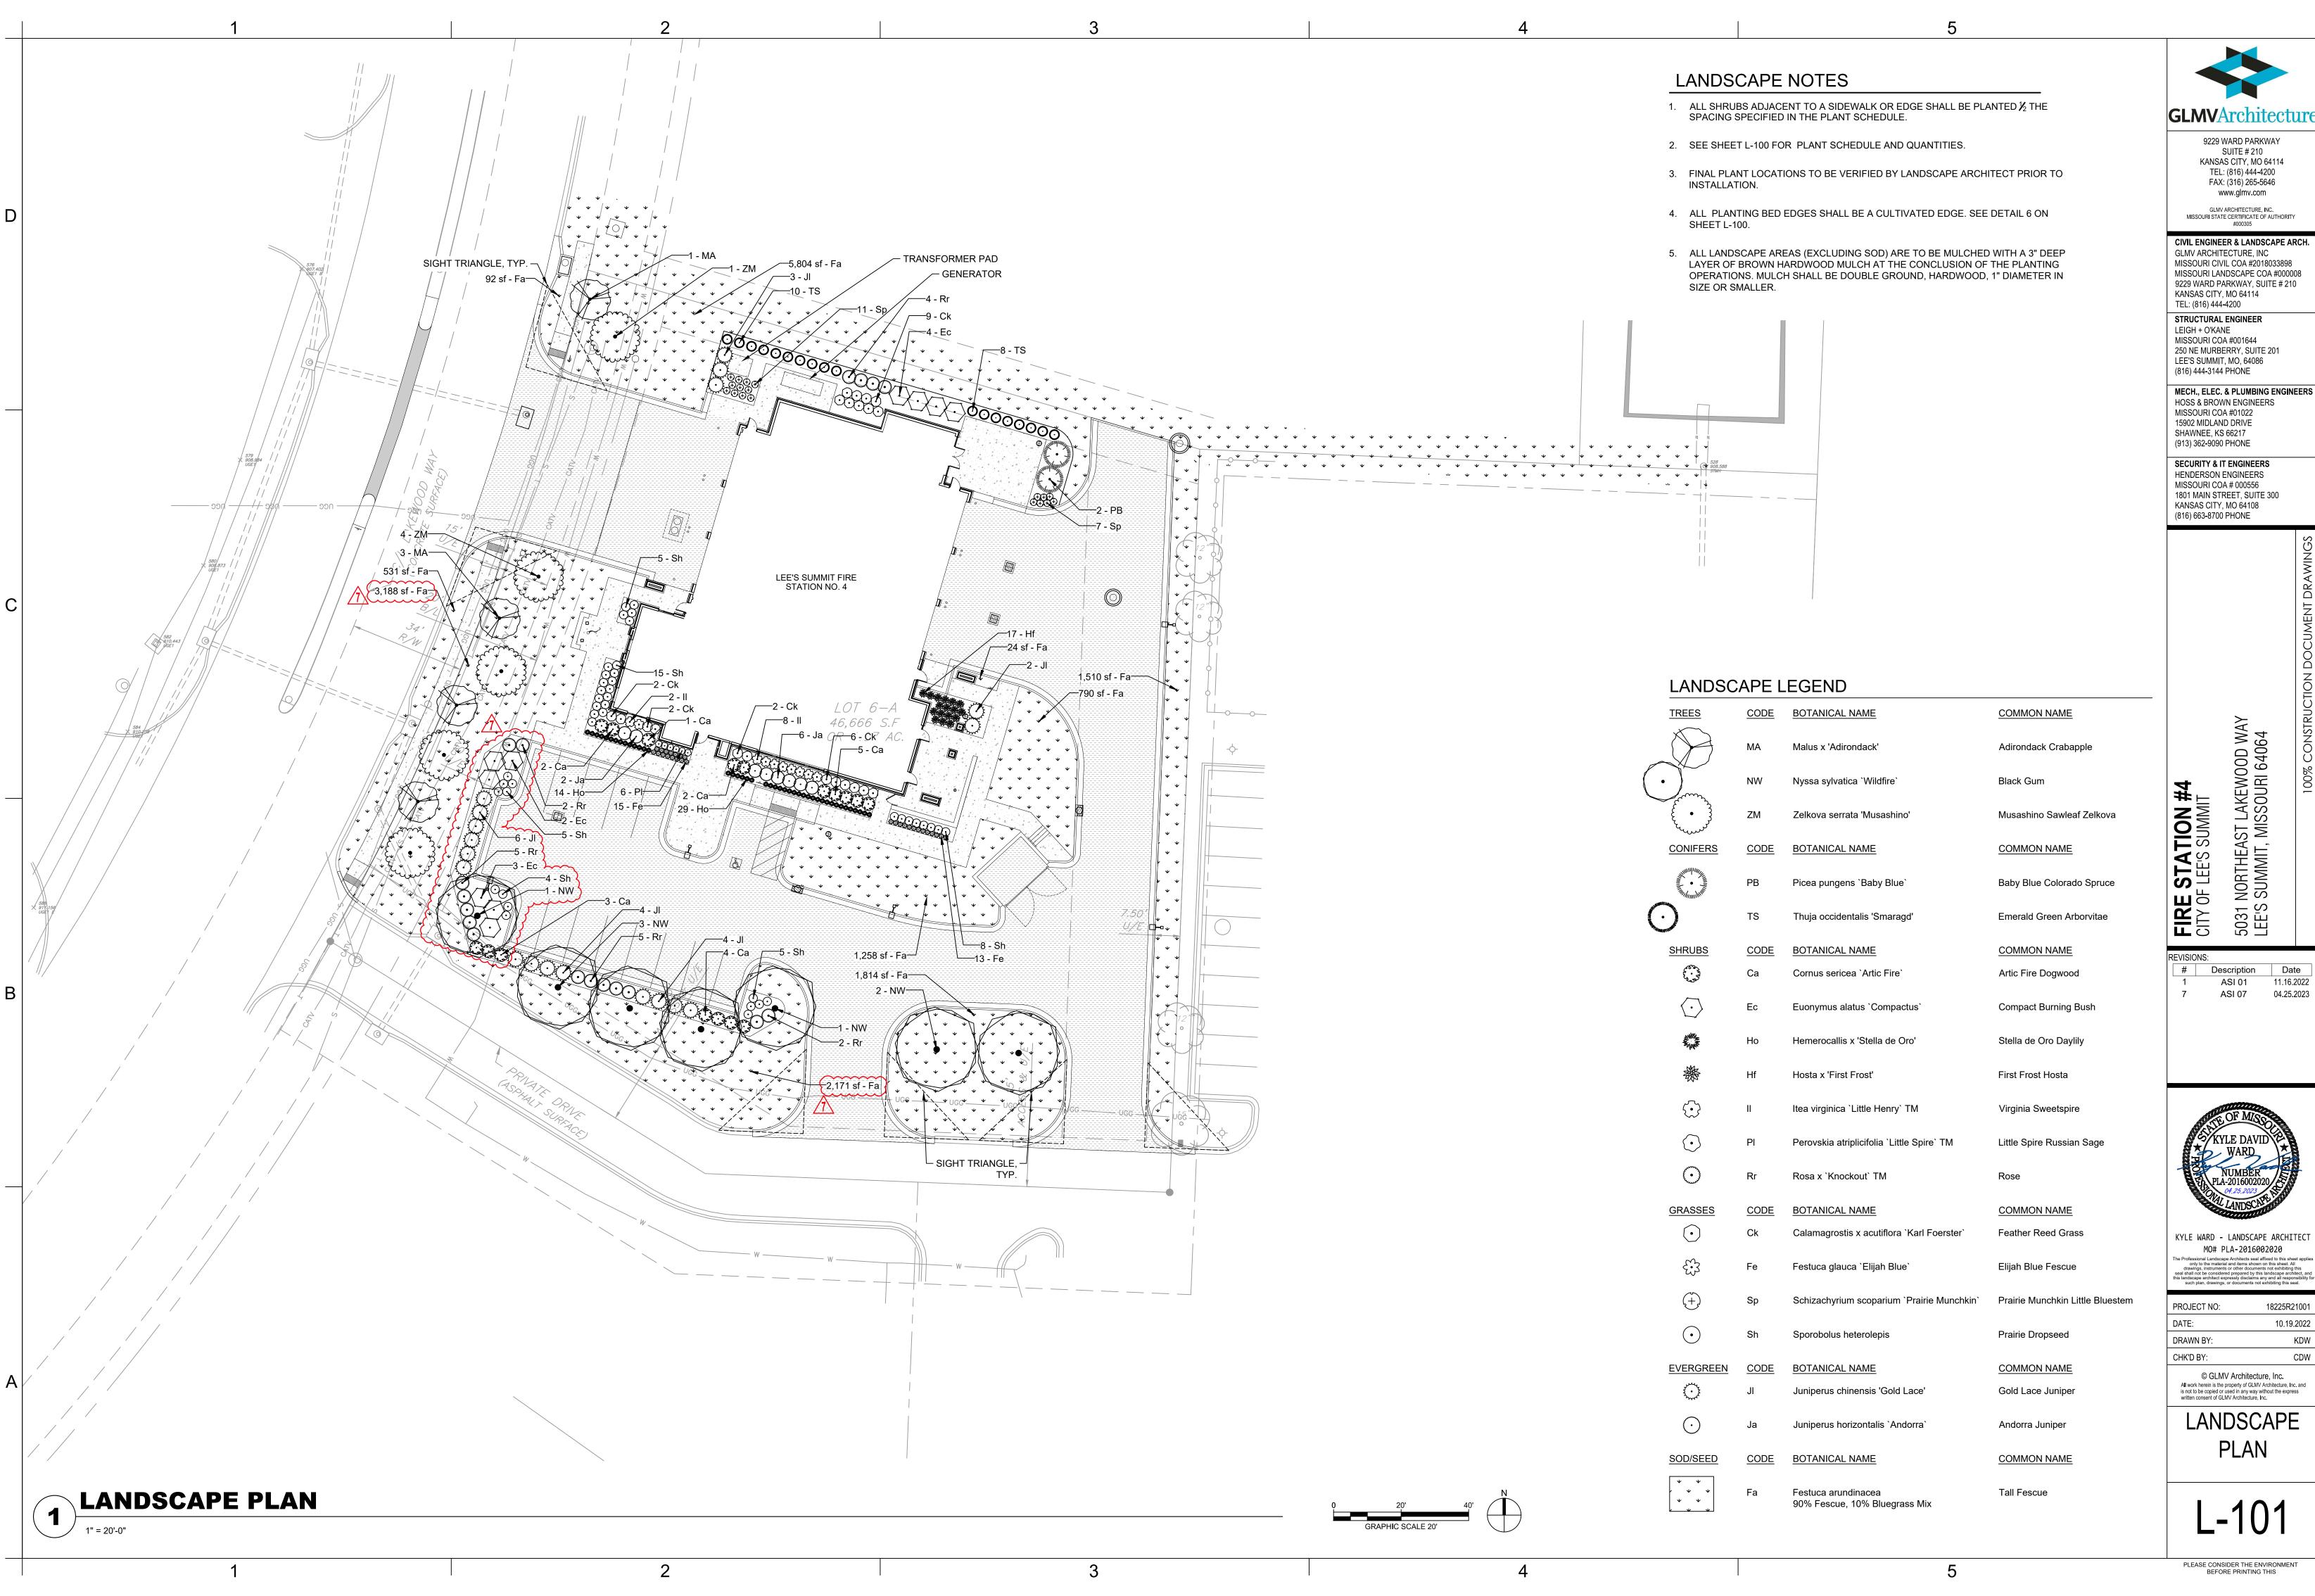

11.16.2022 04.25.2023



KYLE WARD - LANDSCAPE ARCHITECT

10.19.2022 KDW CDW