SUMMIT SQUARE III APARTMENTS FINAL DEVELOPMENT PLANS

IN LEE'S SUMMIT, JACKSON COUNTY, MO



PROJECT TEAM:

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3515 W. 75™ STREET, SUITE 201 PRAIRIE VILLAGE, KS 86208

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PROPERTY DESCRIPTION:

AN 11.830 ACRE PORTION OF LOT 10, SUMMIT FAIR, SECOND PLAT, LOTS 8, 10-14 AND TRACT C, A SUBDIVISION IN LEE'S SUMMIT, JACKSON COUNTY, MISSOURI, BEING MORE PARTICULARLY DESCRIBED AS FOLLOWS:

BEGINNING AT A POINT ON THE WEST LINE OF SAID LOT 10 BEING NORTH 3° 08' 10" EAST, A DISTANCE OF 457.59 FEET FROM A 1/2" IRON BAR FOUND AT THE SOUTHEAST CORNER THEREOF;

THENCE NORTH 3° 08' 10" EAST, A DISTANCE OF 1025.00 FEET ALONG SAID WEST LINE;

THENCE, DEPARTING SAID LINE AT RIGHT ANGLES, SOUTH 86° 51' 50" EAST, A DISTANCE OF 587.85 FEET TO THE EAST LINE OF SAID LOT 10; THENCE SOUTHERLY ALONG THE EAST LINE OF LOT 10, ON A CURVE TO THE RIGHT 848.89 FEET, SAID CURVE HAVING A RADIUS OF 1514.91 FEET, CENTRAL ANGLE OF 32° 06' 23" AND A CHORD BEARING SOUTH 15° 21' 15" WEST FOR 837.83 FEET;

THENCE SOUTH 31° 24' 27" WEST ALONG THE EAST LINE OF LOT 10, A DISTANCE OF 132.80 FEET TO A POINT OF CURVATURE;


THENCE SOUTHERLY ALONG THE EAST LINE OF LOT 10, ON A CURVE TO THE LEFT 98.13 FEET, SAID CURVE HAVING A RADIUS OF 760.00 FEET, CENTRAL ANGLE OF 7° 23' 53" AND A CHORD BEARING SOUTH 27° 42' 30" WEST FOR 98.06 FEET;

THENCE, DEPARTING SAID EAST LINE, NORTH 86° 51' 50" WEST, A DISTANCE OF 306.85 FEET TO THE POINT OF BEGINNING.


NOTE: ALL BEARINGS HEREIN ARE BASED ON MISSOURI STATE PLANE GRID NORTH, WEST ZONE, NAD 83 (NSRS 2011) AS OBSERVED BY TOBIN ROBERTS, MORLS 2001015269 IN JANUARY OF 2022 AT WHICH POINT 5/8" IRON BARS WITH ID CAPS WERE SET AT ALL CORNERS.

PL2022436 PRCOM20231105

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- 1. CONTRACTOR SHALL BE RESPONSIBLE FOR LOCATING ALL UTILITIES, WHETHER PUBLIC OR PRIVATE, PRIOR TO EXCAVATION. CONTRACTOR SHALL NOTIFY THE ENGINEER OF ANY DISCREPANCY BETWEEN LOCATED UTILITIES AND UTILITIES SHOWN ON THE PLANS. THE OWNER, DEVELOPER, CIVIL ENGINEER, AND GOVERNMENT ENTITIES SHALL NOT BE HELD RESPONSIBLE FOR ACCURACY OR COMPLETENESS OF ANY SUCH INFORMATION. CONTRACTOR SHALL HAVE FULL RESPONSIBILITY FOR CHECKING ALL SUCH INFORMATION, LOCATING ALL UNDERGROUND FACILITIES, COORDINATING WITH THE FACILITY OWNERS,
- AND ANY DAMAGE THERETO RESULTING FROM THE WORK. THIS SHALL BE CONSIDERED A SUBSIDIARY ITEM OF THE WORK, THE COST OF WHICH SHALL BE INCLUDED IN THE CONTRACTOR'S BID FOR THE
- 2. ALL MATERIALS AND CONSTRUCTION SHALL CONFORM TO THE DETAILS AND SPECIFICATIONS SHOWN OR REFERENCED IN THESE PLANS. FOR WORK WITHIN CITY, COUNTY OR STATE RIGHT OF WAY, THE RESPECTIVE CITY, COUNTY OR STATE DEPARTMENT OF TRANSPORTATION (DOT) STANDARD DETAILS AND SPECIFICATIONS SHALL TAKE PRECEDENCE.
- 3. CONTRACTOR SHALL NOTIFY ANY AFFECTED OWNERS (UTILITY COMPANIES OR AGENCIES) IN WRITING AT LEAST 48 HOURS PRIOR TO CONSTRUCTION. NOTIFY MO ONE CALL OR DIG SAFE SERVICE TO LOCATE EXISTING UTILITIES PRIOR TO ANY CONSTRUCTION ACTIVITIES.
- 4. CONTRACTOR SHALL VERIFY AND ACCEPT ALL TOPOGRAPHY, SURVEY MONUMENTS, CONTROL POINTS, AND BENCHMARKS SHOWN HEREIN. CONTRACTOR SHALL NOTIFY THE ENGINEER IF ANY
- DISCREPANCIES ARE FOUND PRIOR TO ANY CONSTRUCTION ACTIVITIES.
- 5. DIMENSIONS AND COORDINATES ARE PROVIDED TO INDICATE THE DESIGN INTENT OF THE ENGINEER. CONTRACTOR SHALL IMMEDIATELY NOTIFY THE ENGINEER OF ANY INCONSISTENCIES OR DISCREPANCIES FOUND DURING CONSTRUCTION. CONTRACTOR SHALL VERIFY ALL DIMENSIONS AND COORDINATES PRIOR TO THE COMMENCEMENT OF CONSTRUCTION.
- 6. ALL CONSTRUCTION SHALL CONFORM TO LOCAL DESIGN AND CONSTRUCTION MANUALS APPLICABLE TO PRIVATE DEVELOPMENTS. WHERE DISCREPANCIES BETWEEN THESE PLANS AND LOCAL DESIGN AND CONSTRUCTION MANUALS EXIST THE LOCAL DESIGN AND CONSTRUCTION MANUALS SHALL GOVERN.
- 7. CONTRACTOR WILL BE RESPONSIBLE FOR SECURING ALL BONDS, INSURANCE, AND PERMITS REQUIRED BY THE CONTRACT DOCUMENTS, ALL GOVERNING AGENCIES HAVING JURISDICTION OVER THE WORK PROPOSED BY THESE DOCUMENTS, THE OWNER, AND THE DEVELOPER. THE COST FOR ALL BONDS AND INSURANCE SHALL BE INCLUDED IN THE CONTRACTOR'S BID FOR THE WORK.
- 8. CONTRACTOR SHALL BE RESPONSIBLE FOR REMOVING AND DISPOSING OF ALL WASTE FROM THE PROPOSED PROJECT SITE. WASTE INCLUDES ALL DEMOLITION DEBRIS, UNSUITABLE FILL MATERIALS, TRASH, OR OTHERWISE USELESS OR DEFECTIVE MATERIALS THAT CONFLICT WITH THE PROPOSED IMPROVEMENTS. WASTE SHALL BE DISPOSED OF IN ACCORDANCE WITH ALL APPLICABLE JURISDICTIONAL
- 9. CONTRACTOR SHALL PERFORM A FINAL CLEAN-UP OF ALL WORK IN THESE DOCUMENTS PRIOR TO ACCEPTANCE BY THE OWNER OR DEVELOPER. THE SITE SHALL BE CLEAN AND ORDERLY TO THE SATISFACTION OF THE OWNER OR DEVELOPER.
- 10. BUILDING INFORMATION, INCLUDING BUT NOT LIMITED TO BUILDING DIMENSIONS, DOOR LOCATIONS, DOCK LOCATIONS, RAMP LOCATIONS, DOWNSPOUTS LOCATIONS, AND UTILITY CONNECTIONS, IS SHOWN FOR REFERENCE ONLY. CONTRACTOR SHALL REFER TO ARCHITECTURAL, MEP, AND OTHER BUILDING SPECIFIC PLANS FOR SUCH INFORMATION. CONTRACTOR SHALL VERIFY THAT THERE ARE NO DISCREPANCIES BETWEEN THOSE PLANS AND THESE PLANS PRIOR TO CONSTRUCTION.
- 11. THERE MAY BE OTHER PROJECTS UNDER CONSTRUCTION, OR SCHEDULED TO SOON BEGIN CONSTRUCTION, IN THE IMMEDIATE VICINITY OF THIS PROJECT. CONTRACTOR SHALL COORDINATE THEIR
- PROPOSED CONSTRUCTION ACTIVITIES WITH THOSE OF THE OTHER CONTRACTORS. 12. BY USE OF THE DOCUMENTS, THE CONTRACTOR HEREBY ACCEPTS TO HOLD THE OWNER, DEVELOPER, AND ENGINEER HARMLESS FOR ANY AND ALL INJURIES, CLAIMS, LOSSES OR DAMAGES RELATED TO
- 13. ALL PAVEMENT SECTIONS IN THE PLANS ARE AT THE RECOMMENDATION OF THE GEOTECHNICAL ENGINEER. THE OWNER, DEVELOPER, AND CONTRACTOR SHALL HOLD THE CIVIL ENGINEER HARMLESS FOR ANY PAVEMENT SECTION DEFICIENCIES.
- 14. ALL QUANTITIES LISTED IN THESE PLANS ARE PROVIDED FOR REFERENCE ONLY. 15. CONTRACTOR SHALL VERIFY ALL QUANTITIES. IF THE CONTRACTOR USES QUANTITIES IN THESE PLANS, THE CONTRACTOR ACCEPTS THEM AS THEIR OWN AND AGREES TO HOLD THE CIVIL ENGINEER,
- OWNER, AND DEVELOPER HARMLESS FOR ANY ERRORS OR OMISSIONS IN THE QUANTITIES. 16. CONTRACTOR IS RESPONSIBLE FOR RESTORATION OF THE RIGHT OF WAY AND REPLACEMENT OF CURB, DRIVEWAYS, IRRIGATION SYSTEMS, SIDEWALKS, TRAFFIC SIGNALS, AND ANY OTHER IMPROVEMENTS
- TO THE REGULATORY AUTHORITY'S SPECIFICATIONS PRIOR TO ANY CONSTRUCTION ACTIVITIES. 17. CONTRACTOR SHALL PROTECT ALL PROPERTY CORNERS AND SURVEY MONUMENTS. IF ANY ARE DISTURBED OR DAMAGED THEY SHALL BE RESET BY A PROFESSIONAL SURVEYOR LICENSED IN THE STATE OF MO AT THE CONTRACTOR'S EXPENSE. CONTRACTOR SHALL HOLD THE OWNER, DEVELOPER, GOVERNMENT AND CIVIL ENGINEER HARMLESS FOR THIS EXPENSE OR ANY EXPENSE RESULTING FROM

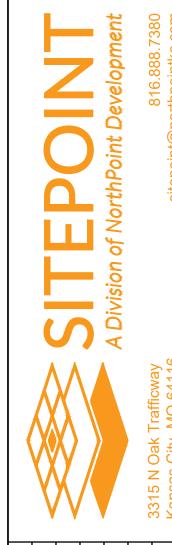WITHIN THE RIGHT OF WAY WHICH ARE DAMAGED DURING CONSTRUCTION. CONTRACTOR IS RESPONSIBLE FOR DOCUMENTING ANY IMPROVEMENTS WITHIN THE RIGHT OF WAY THAT ARE NOT CONSTRUCTED

- DISTURBING A PROPERTY CORNER OR SURVEY MONUMENT. 18. PRIOR TO ORDERING PRECAST STRUCTURES, SHOP DRAWINGS SHALL BE SUBMITTED TO THE ENGINEER FOR APPROVAL 19. CONTRACTOR SHALL REPAIR ALL INFRASTRUCTURE TO REMAIN AND AREAS TO REMAIN UNDISTURBED THAT ARE DAMAGED BY CONSTRUCTION ACTIVITIES. CONTRACTOR REPAIR SHALL BE BETTER OR
- EQUAL TO THE PRECONSTRUCTION CONDITION. 20. CONTRACTOR SHALL MAINTAIN ONE SET OF AS-BUILT DRAWINGS ON SITE AND DISTRIBUTE THOSE DRAWINGS TO THE ENGINEER UPON COMPLETION.
- 21. CONTRACTOR SHALL COORDINATE WITH THE OWNER AND/OR DEVELOPER'S TESTING AGENCY FOR TESTING AND SPECIAL INSPECTIONS. COORDINATION WILL INCLUDE SCHEDULING, OBTAINING SAMPLES, AND
- 22. CONTRACTOR IS RESPONSIBLE FOR CONSTRUCTION STAKING.
- 23. CONTRACTOR SHALL PROTECT ALL TREES TO REMAIN. CONTRACTOR SHALL NOT OPERATE EQUIPMENT OR STORE MATERIALS UNDER THE DRIPLINES OF TREES TO REMAIN. 24. ALL PAINT ON ASPHALT OR CONCRETE PAVEMENT SHALL BE FAST DRY TRAFFIC MARKING PAINT. CONTRACTOR SHALL APPLY 2 COATS.

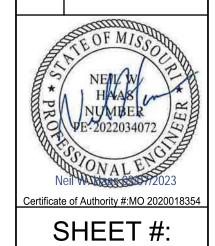NOTIFYING THE TESTING AGENCY. ANY RETESTING OR REINSPECTION AS A RESULT OF NONCOMPLIANCE WILL BE AT THE EXPENSE OF THE CONTRACTOR.

- 25. IF LIVESTOCK OR OTHER DOMESTICATED ANIMALS ARE PRESENT ON SITE, CONTRACTOR SHALL COORDINATE WITH THE OWNER AND DEVELOPER TO PROVIDE TEMPORARY FENCING TO PROTECT THE ANIMALS.
- 26. CONTRACTOR IS RESPONSIBLE FOR PERFORMING ALL WORK IN COMPLIANCE WITH OSHA REGULATIONS.
- 27. CONTRACTOR SHALL SUPPLY THE OWNER/DEVELOPER WITH A LIST OF ALL SUBCONTRACTORS PRIOR TO COMMENCEMENT OF ANY CONSTRUCTION.

- 1. CONTRACTOR IS RESPONSIBLE FOR PROVIDING ADEQUATE PROTECTION FOR ANY EXISTING UTILITIES THAT ARE TO REMAIN.
- 2. FOR ANY UTILITIES REMOVED, CONTRACTOR SHALL PROVIDE TEMPORARY SERVICE TO THE SATISFACTION OF THE OWNER OR DEVELOPER.
- 3. FOR ANY UTILITIES REMOVED, CONTRACTOR SHALL LEAVE A GOOD CONNECTION POINT AND MARK THE TERMINATION POINT WITH A 4' METAL STAKE PAINTED WITH THE UTILITY'S CORRESPONDING APWA UNIFIED COLOR CODE FOR MARKING OF UNDERGROUND UTILITIES.
- 4. CONTRACTOR IS RESPONSIBLE FOR PRESERVING ANY IRRIGATION SYSTEMS NOT INDICATED TO BE REMOVED IN THE DEMOLITION PLANS. 5. CONTRACTOR SHALL PROVIDE CONTINUOUS ACCESS FOR THE SURROUNDING PROPERTIES AT ALL TIMES.
- 6. ANY EXCAVATION CONDUCTED AS PART OF DEMOLITION SHALL BE BACKFILLED WITH SUITABLE MATERIAL IN ACCORDANCE WITH THE GEOTECHNICAL ENGINEER'S REPORT.
- 7. ANY FENCES REMOVED TO FACILITATE CONSTRUCTION SHALL BE REPLACED AT THE EXISTING LOCATION OR THE PROPOSED LOCATION AS DIRECTED BY THE ENGINEER. ALL REPLACED FENCE SHALL BE OF THE SAME MATERIAL AND OF EQUAL OR GREATER CONDITION THAN PRIOR TO CONSTRUCTION.

SITE PLAN NOTES:

- 1. PARKING STRIPES SHALL BE 4-INCH WHITE PAINT.
- 2. HANDICAP STALL MARKINGS AND SIGNAGE SHALL BE CONSTRUCTED AT LOCATIONS SHOWN ON THE PLANS.
- 3. ALL PAVING DIMENSIONS ARE MEASURED FROM THE BACK OF CURB. WHERE NO CURB IN PROPOSED DIMENSIONS ARE MEASURED FROM THE EDGE OF PAVEMENT.
- 4. ALL DIMENSIONS SHOWN TO BUILDING ARE TO FACE OF BUILDING. REFER TO ARCHITECTURAL PLANS FOR BUILDING DIMENSIONS. 5. ALL STRIPING SHALL BE INCLUDED IN PAVING CONTRACTOR'S SCOPE OF WORK.

CONTROLS THE PHYSICAL CONSTRUCTION ON A CONTEMPORARY BASIS AT THE SITE.

- 6. TRAFFIC CONTROL SIGNAGE SHALL BE FABRICATED AND INSTALLED PER THE NATIONAL MANUAL ON UNIFORM TRAFFIC CONTROL DEVICES (MUTCD).
- 7. CURB RETURN RADII ARE 4' UNLESS OTHERWISE NOTED.

EROSION CONTROL NOTES:

- 1. ALL CONSTRUCTION ACTIVITIES DISTURBING ONE ACRE OR MORE MUST OBTAIN STORM WATER DISCHARGE AUTHORIZATION FROM THE MISSOURI DEPARTMENT OF NATURAL RESOURCES (MDNR). THE PRIMARY CONSTRUCTION SITE OPERATOR(S) MUST PREPARE AND IMPLEMENT A STORMWATER POLLUTION PREVENTION PLAN (SWPPP) THROUGHOUT CONSTRUCTION WHICH INCLUDES THE EROSION
- CONTROL PLAN AND OTHER BEST MANAGEMENT PRACTICES (BMPS) SPECIFIED IN THESE PLANS. 2. LARGE CONSTRUCTION ACTIVITIES DISTURBING 5 ACRES OR MORE SHALL SUBMIT NOTICE OF INTENT (NOI) TO MDNR AND POST THE NOI ON SITE AT LEAST SEVEN (7) DAYS PRIOR TO BEGINNING
- CONSTRUCTION. POSTED NOTICES SHALL BE MAINTAINED THROUGHOUT CONSTRUCTION. 3. CONTRACTOR SHALL REVISE THE SWPPP WHENEVER CHANGING SITE CONDITIONS OR A CHANGE IN DESIGN, CONSTRUCTION, OPERATION, OR MAINTENANCE HAS SIGNIFICANT EFFECT ON THE DISCHARGE OF POLLUTANTS NOT PREVIOUSLY ADDRESSED; OR WHEN RESULTS OF INSPECTIONS BY SITE OPERATORS OR AUTHORITIES HAVING JURISDICTION INDICATE THE SWPPP IS PROVING INEFFECTIVE IN ELIMINATING OR SIGNIFICANTLY MINIMIZING POLLUTANTS IN DISCHARGES FROM THE SITE.
- 4. A SWPPP MUST BE WRITTEN BY A LICENSED PROFESSIONAL ENGINEER IN THE STATE OF MO OR CERTIFIED PROFESSIONAL IN EROSION & SEDIMENT CONTROL (CPESC) CERTIFICATION.
- 5. ONLY AN INDIVIDUAL WITH THE CERTIFICATION OR LICENSURE REQUIRED BY THE LOCAL JURISDICTION MAY COMPLETE A STORM WATER EROSION CONTROL INSPECTION 6. CONTRACTOR TO IMPLEMENT EROSION CONTROL MEASURES ACCORDING TO THE SWPPP.
- 7. CONTRACTOR TO KEEP A COPY OF THE SWPPP AND A COPY OF THESE PLANS ON SITE AT ALL TIMES TO COMPLY WITH THE NATIONAL POLLUTANT DISCHARGE ELIMINATION SYSTEM (NPDES) GENERAL
- 8. CONTRACTOR SHALL INCLUDE ALL REQUIRED INSPECTIONS, MONITORING, AND RECORDINGS OF SWPPP MANAGEMENT 9. CONTRACTOR SHALL MAINTAIN EROSION CONTROL MEASURES TO THE SATISFACTION OF THE OWNER, DEVELOPER, ENGINEER, AND AUTHORITY HAVING JURISDICTION. CONTRACTOR SHALL INSPECT ALL
- EROSION CONTROL DEVICES IMMEDIATELY AFTER EACH HEAVY RAINSTORM AND AT LEAST DAILY DURING PROLONGED RAINFALL. 10. PRIOR TO COMMENCING SITE CLEARING, CONTRACTOR SHALL IMPLEMENT ALL PHASE 1 EROSION CONTROL MEASURES.
- 11. SITE SHALL BE CLEARED TO REMOVE ANY ORGANIC MATERIAL. EXISTING VEGETATION, AND GROWTH SUCH AS SHRUBS, STUMPS, BUSHES, UNDERBRUSH AND TREES UNLESS NOTED TO REMAIN. ALL SUCH MATERIALS ARE TO BE REMOVED FROM THE SITE OR BURNED ONLY AS PERMITTED BY THE LOCAL AUTHORITIES HAVING JURISDICTION.
- 12. DISTURBED AREAS WHERE CONSTRUCTION ACTIVITIES HAVE CEASED FOR 14 OR MORE DAYS SHALL BE TEMPORARILY SEEDED AND WATERED UNLESS CONSTRUCTION ACTIVITIES WILL RESUME WITHIN 21 DAYS IN THE AREA.
- 13. CONTRACTOR SHALL BE RESPONSIBLE FOR THE CONTROL OF EROSION AND SILTATION DURING ALL PHASES OF CONSTRUCTION. 14. CONTRACTOR IS RESPONSIBLE FOR PROVIDING ANY ADDITIONAL EROSION CONTROL MEASURES REQUIRED TO COMPLY WITH THE SWPPP OR MDNR STORM WATER POLLUTION REGULATIONS, AT HIS
- 15. CONTRACTOR SHALL NOT REMOVE EROSION CONTROL MEASURES UNTIL ACCEPTABLE VEGETATION IS ESTABLISHED AS DEFINED BY THE GENERAL PERMIT.
- 16. CONTRACTOR SHALL WATER THE SEEDED AND SODDED AREAS UNTIL 95% OF VEGETATION IS ESTABLISHED. 17. IRRIGATION SYSTEMS MUST BE INSTALLED AND REPAIRED BY A LICENSED IRRIGATION CONTRACTOR. CONTRACTOR SHALL INSTALL ANY REQUIRED IRRIGATION SYSTEMS PRIOR TO SODDING OR
- HYDROSEEDING. 18. CONTRACTOR SHALL FILE NOTICE OF TERMINATION WITHIN 30 DAYS OF FINAL STABILIZATION. NOTICE CANNOT BE FILED UNTIL LOCAL JURISDICTION APPROVAL IS GRANTED. 19. THE INTENT OF THIS EROSION CONTROL PLAN IS TO ASSIST THE CONTRACTOR IN HIS RESPONSIBILITY TO PROVIDE ALL MATERIALS, TOOLS, EQUIPMENT AND LABOR NECESSARY TO CONTROL EROSION, SILTATION AND DISCHARGES OF SOIL MATERIAL INTO DOWNSTREAM SYSTEMS OR RECEIVING CHANNELS. IF ANY METHOD OF CONTROL FAILS, THE CONTRACTOR SHALL NOTIFY THE OWNER OR ENGINEER
- IMMEDIATELY, SO THE OWNER OR HIS AGENT CAN REVIEW THE CONTRACTOR'S PROPOSED METHOD OF REPAIR. 20. THIS PLAN INDICATES THE CRITICAL AREA(S) OF CONCERN AND THESE AREA(S) WILL BE CONTROLLED AT A MINIMUM. THE CONTROL MAY CONSIST OF TEMPORARY CONTROL MEASURES AS SHOWN ON
- THE PLANS OR ORDERED BY THE OWNER/DEVELOPER DURING THE LIFE OF THE CONTRACT TO CONTROL EROSION OR WATER POLLUTION. 21. THE OWNER OR DEVELOPER HAS THE AUTHORITY TO LIMIT THE SURFACE AREA OF ERODIBLE EARTH MATERIAL EXPOSED BY THE CONSTRUCTION OPERATION AND TO DIRECT THE CONTRACTOR TO PROVIDE CONSTRUCTION OPERATIONS AND TO DIRECT THE CONTRACTOR TO PROVIDE IMMEDIATE PERMANENT OR TEMPORARY POLLUTION CONTROL MEASURE TO PREVENT CONTAMINATION OF ADJACENT WATERS OR CONVEYANCES.

EARTHWORK AND GRADING NOTES:

- 1. ALL SITE PREPARATION. GRADING, EXCAVATION AND EMBANKMENT SHALL CONFORM TO THE GEOTECHNICAL ENGINEER'S REPORT AND RECOMMENDATIONS.
- ALL GRADED AREAS SHOULD BE STRIPPED OF TOPSOIL, VEGETATION, ROOTS, STUMPS, DEBRIS, AND OTHER ORGANIC MATERIALS.
- CONTRACTOR IS RESPONSIBLE FOR DEWATERING AND IT SHALL BE PERFORMED AT HIS EXPENSE.
- MEDIANS, LANDSCAPE AREAS, AND CURB ISLANDS SHOULD BE GRADED TO DRAIN WATER OVER THE CURB OR ADJACENT PAVEMENT TO PREVENT PONDING UNLESS NOTED OTHERWISE. CONTRACTOR SHALL PROVIDE THE ENGINEER WITH THEIR ESTIMATE OF EARTHWORK QUANTITIES PRIOR TO THE START OF CONSTRUCTION SO THAT ANY NECESSARY SITE MODIFICATION CAN BE
- ADDRESSED PRIOR TO CONSTRUCTION.
- CONTRACTOR SHALL INCLUDE ALL ROCK EXCAVATION QUANTITIES WHERE NECESSARY TO MEET DESIGN GRADE. CONTRACTOR TO SPECIFY METHOD FOR SUCH EXCAVATION. SUBGRADE SOIL SHALL BE PREPARED IN ACCORDANCE WITH THE GEOTECHNICAL ENGINEER'S RECOMMENDATIONS.
- 8. CONTRACTOR SHALL GRADE LANDSCAPED AREAS TO PROVIDE POSITIVE DRAINAGE AWAY FROM BUILDINGS. HOLD DOWN SUBGRADE AS NEEDED FOR TOPSOIL AND MULCH PLACEMENT 9. SPOT ELEVATIONS SHOWN HEREIN SHALL GOVERN OVER CONTOURS.
- 10. STOCKPILE AND HAUL ROAD LOCATIONS SHALL BE APPROVED BY THE ENGINEER, AUTHORITY HAVING JURISDICTION, AND OWNER. 11. CONTRACTOR SHALL BACKFILL ALL CURBS WITHIN 72 HOURS OF PLACEMENT.
- 12. ALL AREAS TO BE STABILIZED WITH VEGETATION OR MULCH SHALL HAVE A MINIMUM OF SIX (6) INCHES OF TOPSOIL, UNLESS OTHERWISE SPECIFIED ON THE LANDSCAPING PLAN.
- 13. PRIOR TO FINAL ACCEPTANCE OF THE PROJECT, ALL SLOPES AND AREAS DISTURBED BY CONSTRUCTION SHALL BE GRADED SMOOTH, TOPSOIL APPLIED, AND VEGETATION ESTABLISHED AS REQUIRED BY THE LOCAL JURISDICTION AND OWNER.

PAVING NOTES:

- 1. CONTRACTOR SHALL MATCH EXISTING ELEVATIONS AT PAVEMENT CONNECTIONS, PROVIDE POSITIVE DRAINAGE TO PREVENT PONDING, AND PROVIDE A SMOOTH TRANSITION BETWEEN EXISTING AND PROPOSED IMPROVEMENTS.
- CONTRACTOR SHALL PROVIDE A FULL DEPTH SAW-CUT AND SMOOTH TRANSITION AT CONNECTION TO EXISTING PAVEMENT AND CURB. 3. CONTRACTOR SHALL NOT DAMAGE OR DISTURB EXISTING REINFORCING STEEL FOR SITE WORK. ALL REINFORCING SHALL BE INSTALLED WITH CHAIRS PER THE
- PLANS AND SPECIFICATIONS. 4. SUBGRADE SHALL BE MAINTAINED TO WITHIN THE SPECIFIED REQUIREMENTS OF MOISTURE AND DENSITY UNTIL PAVING IS PLACED. PRIOR TO PLACING
- PAVEMENT, THE CONTRACTOR SHALL RE-TEST THE AREAS SELECTED BY THE CONSTRUCTION MATERIALS TESTING LAB PERSONNEL AT THE CONTRACTOR'S EXPENSE IF THE SUBGRADE HAS BEEN PLACED AND ACCEPTED FOR LONGER THAN TEN DAYS AND NO PAVEMENT HAS BEEN PLACED.
- 5. PAVING CONTRACTOR TO VERIFY AND COORDINATE THE INSTALLATION OF ALL SLEEVES AND CONDUIT UNDER PAVEMENT FOR THE IRRIGATION SYSTEM, IRRIGATION CONTROLS, ELECTRICAL, SITE LIGHTING AND SIGNAGE, COMMUNICATION, AND LOW VOLTAGE WIRING PRIOR TO THE PLACEMENT OF PAVEMENT. ALL CONDUIT SHALL BE INSTALLED ACCORDING TO THE STANDARDS AND SPECIFICATION OF THE UTILITY AND/OR SHALL BE 4" SCHEDULE 40 PVC UNLESS
- OTHERWISE NOTED. 6. CONTRACTOR SHALL AVOID CONSTRUCTING NON-SQUARE SHAPED PANELS, PANELS WITH SHARP ANGLES, AND PANELS WITH LENGTH TO WIDTH RATIOS
- GREATER THAN 3:1.
- 8. ALL EXPANSION JOINTS SHALL CONFORM TO THE STANDARDS AND SPECIFICATION OF THE LOCAL JURISDICTION. IF LOCAL STANDARDS ARE NOT AVAILABLE THEY SHALL CONFORM TO MO DOT STANDARDS.

- 1. ALL ACCESSIBLE ROUTE CONSTRUCTION SHALL CONFORM TO THE LATEST VERSION OF THE AMERICANS WITH DISABILITIES ACT (ADA) STANDARDS FOR ACCESSIBLE DESIGN PUBLISHED BY THE DEPARTMENT OF JUSTICE (DOJ) AND THE PROPOSED ACCESSIBILITY GUIDELINES FOR PEDESTRIAN FACILITIES IN THE PUBLIC RIGHT OF WAY PUBLISHED BY THE UNITED STATES ACCESSIBILITY BOARD.
- OTHER THAN RAMPS AND RAMP RUNS, WALKING SURFACES MUST HAVE A RUNNING SLOPE NOT STEEPER THAN 1:20 (V:H).
- THE CROSS SLOPE OF WALKING SURFACES SHALL NOT BE STEEPER THAN 2%. 4. THE MINIMUM WIDTH FOR A LINEAR SEGMENT OF ACCESSIBLE ROUTE SHALL BE 36 INCHES.
- 5. WHERE THE ACCESSIBLE ROUTE MAKES A 180 DEGREE TURN AROUND AN ELEMENT WHICH IS LESS THAN 48 INCHES WIDE, CLEAR WIDTH SHALL BE 42 INCHES
- MINIMUM APPROACHING THE TURN, 48 INCHES MINIMUM AT THE TURN AND 42 INCHES LEAVING THE TURN. 6. AN ACCESSIBLE ROUTE WITH A CLEAR WIDTH LESS THAN 60 INCHES SHALL PROVIDE PASSING SPACES AT INTERVALS OF 200 FEET MAXIMUM. PASSING SPACES SHALL BE 60 INCH BY 60 INCH MINIMUM.
- RAMP RUNS SHALL HAVE A RUNNING SLOPE NOT STEEPER THAN 1:12 (V:H).

ALL JOINTS ARE TO CONTINUE THROUGH THE CURB.

- 8. RAMP RUNS WITH A RISE GREATER THAN 6 INCHES SHALL HAVE HANDRAILS. 9. RAMP LANDINGS WITH A MAXIMUM SLOPE OF 1:48 (V:H) SHALL BE PROVIDED BEFORE AND AFTER RAMP RUNS.
- 10. THE MAXIMUM RISE OF A RAMP RUN SHALL BE 30 INCHES.
- 11. THE MAXIMUM COUNTER SLOPE BETWEEN PAVEMENT AND THE CURB AT A CURB RAMP SHALL BE 1:20. 12. CURB RAMP LANDINGS WITH A MAXIMUM SLOPE OF 1:48 SHALL BE PROVIDED AT THE TOP OF CURB RAMPS WITH A CLEAR WIDTH OF 60 INCHES.
- 13. DETECTABLE WARNING SURFACES COMPLYING WITH THE LATEST ADA STANDARDS SHALL BE PROVIDED AT PEDESTRIAN STREET CROSSINGS AND REFUGE
- 14. PASSENGER LOADING ZONES SHALL BE PROVIDED ADJACENT TO ANY ADA ACCESSIBLE STALL AND HAVE A 2% MAXIMUM SLOPE IN ALL DIRECTIONS. 15. CONTRACTOR IS RESPONSIBLE FOR VERIFYING ALL SIDEWALKS, RAMPS, ACCESSIBLE PATHS, AND ACCESSIBLE PARKING AREAS COMPLY WITH THE ADA.

- UTILITY NOTES:

 1. CONTRACTOR SHALL INSTALL UTILITIES TO AVOID CONFLICTS WITH OTHER UTILITIES AND STRUCTURES. PRIOR TO INSTALLATION OF ANY PROPOSED UTILITY,

 1. CONTRACTOR SHALL INSTALL UTILITIES TO AVOID CONFLICTS WITH OTHER UTILITIES AND STRUCTURES. THE ENGINEER WILL BE HELD HARMLEY. CONTRACTOR SHALL EXCAVATE, VERIFY AND CALCULATE ALL CROSSINGS WITH EXISTING UTILITIES AND STRUCTURES. THE ENGINEER WILL BE HELD HARMLESS IN THE EVENT THE ENGINEER IS NOT NOTIFIED OF CONFLICTS WITH EXISTING UTILITIES.
- CONTRACTOR SHALL PLACE 3/4" WASHED ROCK TO 6" BELOW AND 6" ABOVE THE UTILITY LINE IF GROUNDWATER IS ENCOUNTERED DURING INSTALLATION. CONTRACTOR SHALL COORDINATE WITH AND ADHERE TO THE REQUIREMENTS OF OWNERS AND AUTHORITIES HAVING JURISDICTION WHEN MAKING CONNECTIONS TO EXISTING UTILITIES.
- 4. CONTRACTOR SHALL ADJUST ALL HYDRANTS, VALVE BOXES, CLEAN OUTS AND MANHOLE RIMS TO FINAL GRADE.
- CONTRACTOR SHALL COORDINATE THE FINAL LOCATION OF ELECTRIC, TELEPHONE, AND GAS SERVICE WITH EACH RESPECTIVE UTILITY COMPANY, AND SHALL INCLUDE ALL ASSOCIATED COSTS IN THE BID.
- 6. CONTRACTOR SHALL REMOVE OR RELOCATE ONSITE UTILITY POLES AS REQUIRED TO COMPLETE THE WORK. CONTRACTOR SHALL ALSO PROVIDE TEMPORARY
- SERVICE IF REMOVAL WILL IMPACT SERVICE. CONTRACTOR SHALL EXERCISE EXTREME CAUTION WHEN WORKING ADJACENT TO EXISTING UTILITIES.
- 8. IN THE EVENT EXISTING UTILITIES TO REMAIN ARE DAMAGED, CONTRACTOR SHALL IMMEDIATELY NOTIFY THE OWNER OF THE RESPECTIVE UTILITY. IF THERE IS AN IMMEDIATE THREAT OF DANGER TO THE GENERAL PUBLIC, CONTRACTOR SHALL IMMEDIATELY NOTIFY LOCAL EMERGENCY PERSONNEL. CONTRACTOR IS RESPONSIBLE FOR REPLACING OR REPAIRING ANY DAMAGE.
- 9. CONTRACTOR SHALL ACHIEVE COMPACTION TO 95% STANDARD PROCTOR IN AREAS EXCAVATED AT THE BUILDING FOR UTILITY CONNECTION. 10. UTILITIES SHOULD BE INSTALLED AS SHOWN ON THE PLANS. HOWEVER, FIELD ADJUSTMENTS APPROVED BY THE ENGINEER MAY BE MADE TO PROTECT TREES,
- STRUCTURES, EXISTING INFRASTRUCTURE, OR TO ACCOMMODATE OTHER ENVIRONMENT OR ECONOMIC CONSTRAINTS ENCOUNTERED DURING CONSTRUCTION. 11. CONTRACTOR SHALL MAKE APPLICATION WITH THE APPROPRIATE UTILITY COMPANIES FOR ALL NECESSARY METERS.
- 1. CONTRACTOR SHALL INSTALL STORM SEWER LINES TO AVOID CONFLICTS WITH OTHER UTILITIES AND STRUCTURES. PRIOR TO INSTALLATION, CONTRACTOR SHALL EXCAVATE, VERIFY AND CALCULATE ALL CROSSINGS WITH EXISTING UTILITIES AND STRUCTURES. THE ENGINEER WILL BE HELD HARMLESS IN THE EVENT THE ENGINEER IS NOT NOTIFIED OF CONFLICTS WITH EXISTING UTILITIES.
- 2. CONTRACTOR SHALL MAINTAIN MINIMUM SEPARATION REQUIREMENTS FROM OTHER UTILITIES AS REQUIRED AUTHORITIES HAVING JURISDICTION. IF THERE ARE
- MULTIPLE SEPARATION REQUIREMENTS THE MOST STRINGENT SHALL GOVERN. ALL PIPES SHALL BE GROUTED AT THE CONNECTION TO THE STORM SEWER STRUCTURE. CONNECTIONS SHALL BE WATERTIGHT.
- 4. ALL STRUCTURE COORDINATES ARE THE CENTER OF THE STRUCTURE PIPE LENGTHS PROVIDED ON PLANS ARE FROM CENTER OF STRUCTURE TO CENTER OF STRUCTURE.
- 6. ALL PIPES SHALL BE INSTALLED ACCORDING TO THE MANUFACTURERS SPECIFICATIONS.
- HDPE PIPE SHALL CONFORM TO AASHTO M294, TYPE S OR AASHTO M252, TYPE S, AS APPLICABLE TO THE RESPECTIVE PIPE'S SIZE. RCP SHALL BE MANUFACTURED IN ACCORDANCE WITH THE PROVISIONS OF ASTM C-76.
- 9. RCP CLASS, WALL THICKNESS, AND BEDDING MATERIAL SHALL BE SELECTED IN ACCORDANCE WITH ASCE 15-17 AND ADEQUATE FOR AASHTO HS25 LOADING. 10. ALL STORM SEWER MANHOLE COVERS IN PAVED AREAS SHALL BE RATED FOR HS25 LOADING AND FLUSH WITH THE PAVEMENT.
- 11. CONTRACTOR SHALL ADJUST ALL STRUCTURE LIDS SO THEY ARE FLUSH WITH THE PAVEMENT OR 6" ABOVE FINISHED GRADE.
- 12. CONTRACTOR SHALL FILL AND COMPACT TO A MINIMUM OF 18" ABOVE THE TOP OF PIPE BEFORE TRENCHING FOR INSTALLATION OF STORM SEWERS. 13. PUBLIC STORM SEWER SHALL BE PER THE STANDARDS AND SPECIFICATIONS OF THE LOCAL GOVERNING AGENCY.

SANITARY SEWER NOTES:

- 1. CONTRACTOR SHALL INSTALL SANITARY SEWER LINES TO AVOID CONFLICTS WITH OTHER UTILITIES AND STRUCTURES. PRIOR TO INSTALLATION, CONTRACTOR SHALL EXCAVATE, VERIFY AND CALCULATE ALL CROSSINGS WITH EXISTING UTILITIES AND STRUCTURES. THE ENGINEER WILL BE HELD HARMLESS IN THE EVENT THE ENGINEER IS NOT NOTIFIED OF CONFLICTS WITH EXISTING UTILITIES.
- 2. CONTRACTOR SHALL MAINTAIN MINIMUM SEPARATION REQUIREMENTS FROM OTHER UTILITIES AS REQUIRED AUTHORITIES HAVING JURISDICTION. IF THERE ARE MULTIPLE SEPARATION REQUIREMENTS THE MOST STRINGENT SHALL GOVERN. CONTRACTOR IS RESPONSIBLE FOR PERFORMING ANY TESTING AS REQUIRED BY THE AUTHORITY HAVING JURISDICTION. THIS TESTING SHALL BE DONE AT NO
- ADDITIONAL COST TO THE OWNER. 4. PRIVATE SANITARY SEWER SHALL BE SDR-35 PVC AND SDR-26 WHERE DEPTHS EXCEED 12'. ALL SANITARY SEWER PIPE FITTING SHALL CONFORM TO ASTM
- TRENCH BACKFILL COMPACTION SHALL BE TESTED AS REQUIRED BY THE GEOTECHNICAL ENGINEER. IF NO RECOMMENDATIONS ARE PROVIDED BY THE GEOTECHNICAL ENGINEER TESTING SHOULD BE CONDUCTED PER EVERY 12 INCH LIFT (LOOSE) AND AT LEAST 1 TEST PER EVERY 100 LF OF SEWER. TESTING SHOULD BE STAGGERED SO TESTING IS NOT DONE OVER TESTING IN A PREVIOUS LIFT.
- CONTRACTOR SHALL FILL AND COMPACT TO A MINIMUM OF 18" ABOVE THE TOP OF PIPE BEFORE TRENCHING FOR INSTALLATION OF SANITARY SEWERS 7. PUBLIC SANITARY SEWER SHALL SHALL BE PER THE STANDARDS AND SPECIFICATIONS OF THE LOCAL GOVERNING AGENCY.

- 1. CONTRACTOR SHALL COORDINATE WITH THE LOCAL GOVERNING AGENCY FOR CONNECTION TO EXISTING WATER. UNLESS NOTED OTHERWISE, PRIVATE WATER LINES 4" OR LARGER IN DIAMETER SHALL BE C900 DR-19 PVC MINIMUM CLASS 150, WITH NSF SEAL, PRESSURE TESTED AND DISINFECTED IN ACCORDANCE WITH THE NCTCOG STANDARD SPECIFICATIONS. SERVICE LINE CONNECTORS SHALL BE COMPRESSION TYPE WITH STAINLESS STEEL TUBE LINERS.
- CORPORATION STOPS SHOULD BE TESTED FOR LEAKAGE AND FULL FLOW WHEN SYSTEM IS PRESSURE TESTED.
- 4. CONTRACTOR SHALL BE REQUIRED FOR DISINFECTION, CHLORINATION, AND FLUSHING REQUIREMENTS. THIS INCLUDES PROVIDING TEMPORARY ISOLATION VALVES, PLUGS, INJECTION PORTS, FLUSHING VALVES, TOOLS, AND EQUIPMENT NECESSARY TO COMPLETE THE TASK. THE CONTRACTOR SHALL CONTACT THE WATER UTILITY 48 HOURS PRIOR TO FLUSHING WATERLINES. ALL WATERLINE FITTINGS SHALL BE DUCTILE IRON MECHANICAL JOINTS
- 6. CONTRACTOR SHALL INSTALL HORIZONTAL BLOCKING IN ACCORDANCE WITH APPLICABLE CITY DETAILS, EVEN IF NO BLOCKING IS SHOWN ON THE PLANS. CONCRETE BLOCKING SHALL BE PLACED AT ALL VALVES, BENDS, TEES, AND PLUGS. CONTRACTOR SHALL KEEP BELLS AND FLANGES CLEAN OF CONCRETE. 7. CONTRACTOR SHALL REMOVE ANY BLOCKING OR RESTRAINTS THAT PROHIBIT THE CONTRACTOR FROM PERFORMING THEIR WORK. CONTRACTOR SHALL REPLACE
- ANY REMOVED BLOCKING OR RESTRAINTS AT HIS EXPENSE IF REQUIRED BY THE AUTHORITY HAVING JURISDICTION. 8. CONTRACTOR SHALL MAINTAIN 42 INCHES OF MINIMUM COVER OVER ALL WATER LINES (INCLUDING FIRE LINES). CONTRACTOR SHALL MAINTAIN ALL DEFLECTION AND JOINT STRESSES WITHIN MANUFACTURER RECOMMENDATIONS.
- 10. IN THE EVENT OF A CONFLICT WITH A UTILITY, THE CONTRACTOR SHALL ADJUST THE WATERLINE DOWNWARD UNDER THE CONFLICTING UTILITY.
- 11. ALL VALVES AT THE END OF A LINE SHALL BE PLUGGED AND BLOCKED. 12. PUBLIC WATER LINES SHALL BE PER THE STANDARDS AND SPECIFICATIONS OF THE LOCAL GOVERNING AGENCY.
- 1. FIRE APPARATUS ACCESS ROADS AND FIRE LANES SHALL BE MARKED WITH RED PAINTED LINES, 6 INCHES IN WIDTH, TO DELINEATE THE BOUNDARY OF THE

2. THE WORDS "NO PARKING FIRE LANE" SHALL BE PAINTED IN 4 INCH WHITE LETTERS EVERY 25 FEET ON THE BORDER OF THE FIRE LANE OR ON THE FACE OF

- CURB WHERE AVAILABLE. 3. THE FACE OF THE CURB SHALL BE PAINTED RED WHERE THE CURB IS THE BOUNDARY OF THE FIRE LANE.
- 4. ALL FIRE PROTECTION WORK MUST BE PERMITTED AND APPROVED BY THE APPLICABLE FIRE MARSHAL HAVING JURISDICTION
- 5. CONTRACTOR SHALL PRESSURE TEST ALL FIRE PROTECTION LINES TO THE SATISFACTION OF THE OWNER AND THE CITY'S FIRE MARSHAL. 6. ALL FIRE HYDRANTS SHALL BE LOCATED IN ACCORDANCE WITH CURRENTLY PUBLISHED CITY DESIGN STANDARDS.

LOCAL GOVERNING AGENCY.

- CONTRACTOR IS RESPONSIBLE FOR PROVIDING TRAFFIC CONTROL AS REQUIRED BY THE LOCAL GOVERNING AGENCY. CONTRACTOR SHALL PREPARE. FURNISH, MAINTAIN, ALL TRAFFIC CONTROL DEVICES THROUGHOUT CONSTRUCTION, CONTRACTOR SHALL REMOVE TRAFFIC
- CONTROL DEVICES UPON COMPLETION. 3. CONTRACTOR IS RESPONSIBLE FOR PROVIDING A TRAFFIC CONTROL AND SEQUENCING PLAN AND OBTAINING A TRAFFIC CONTROL PERMIT IF REQUIRED BY THE
- 4. CONTRACTOR SHALL COORDINATE WITH ADJACENT PROPERTY OWNERS AND AUTHORITIES HAVING JURISDICTION FOR ROAD OR DRIVEWAY CLOSURES.
- Development Services Departme Lee's Summit, Missouri 03/20/2023


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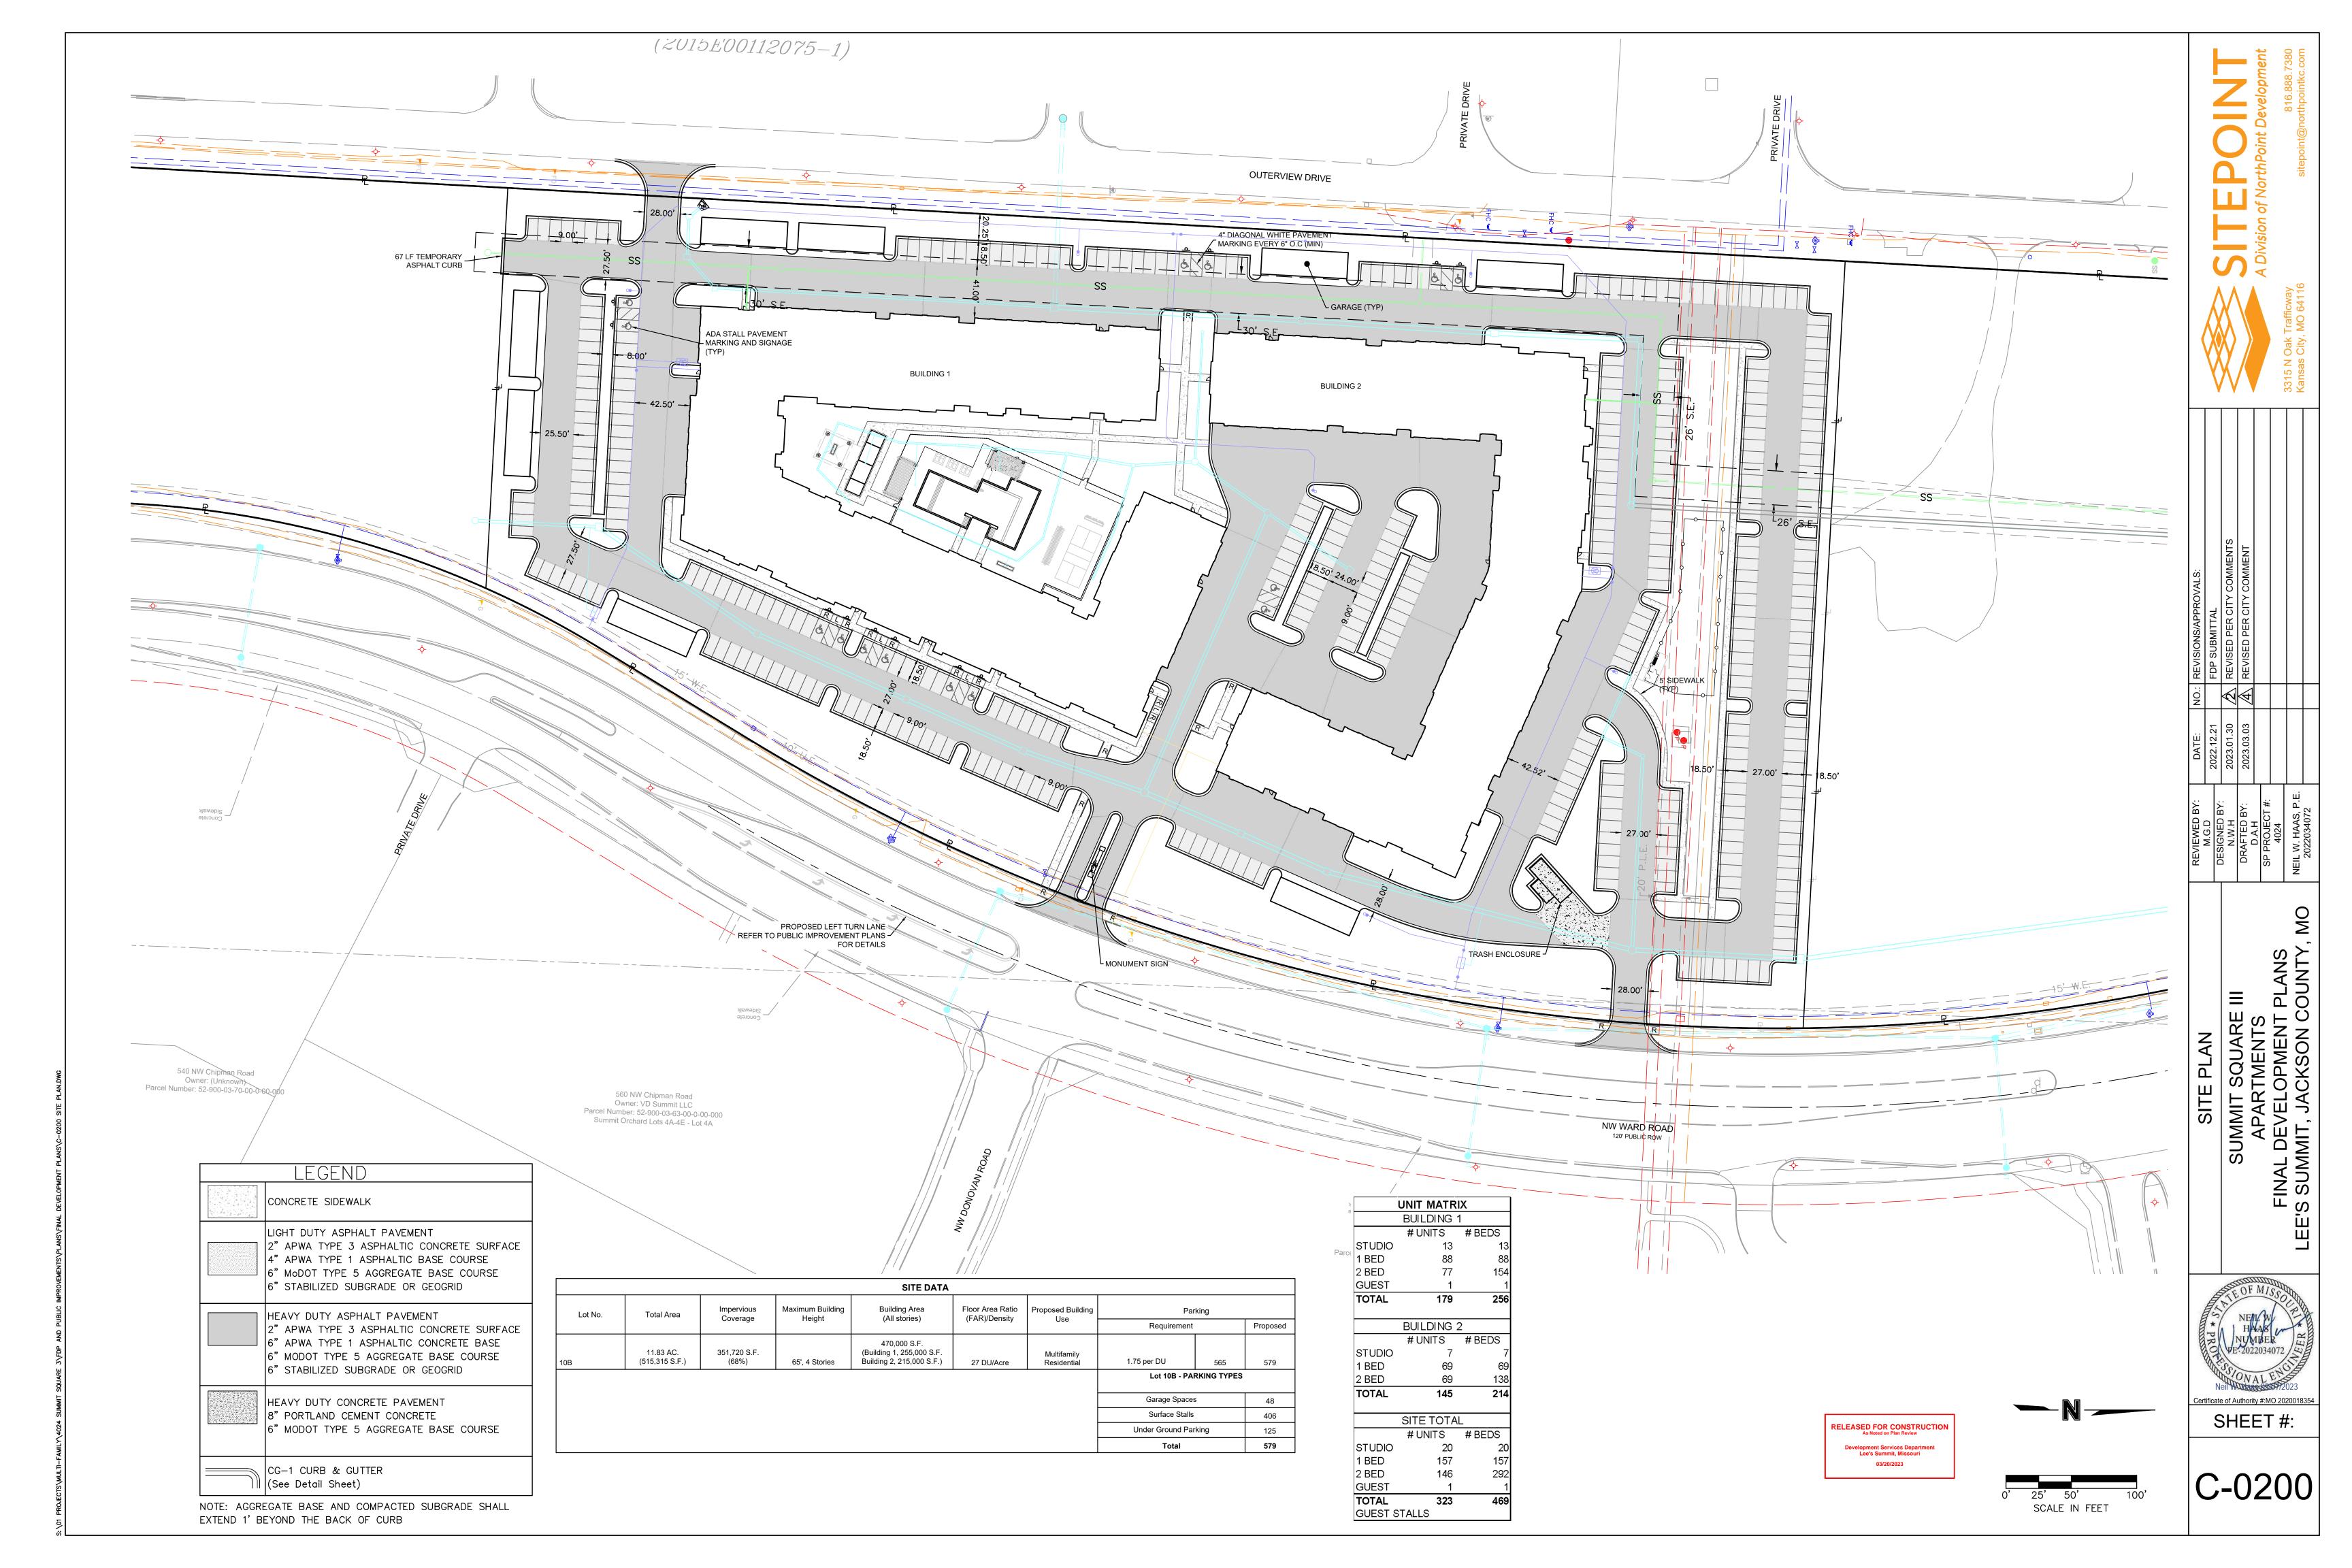
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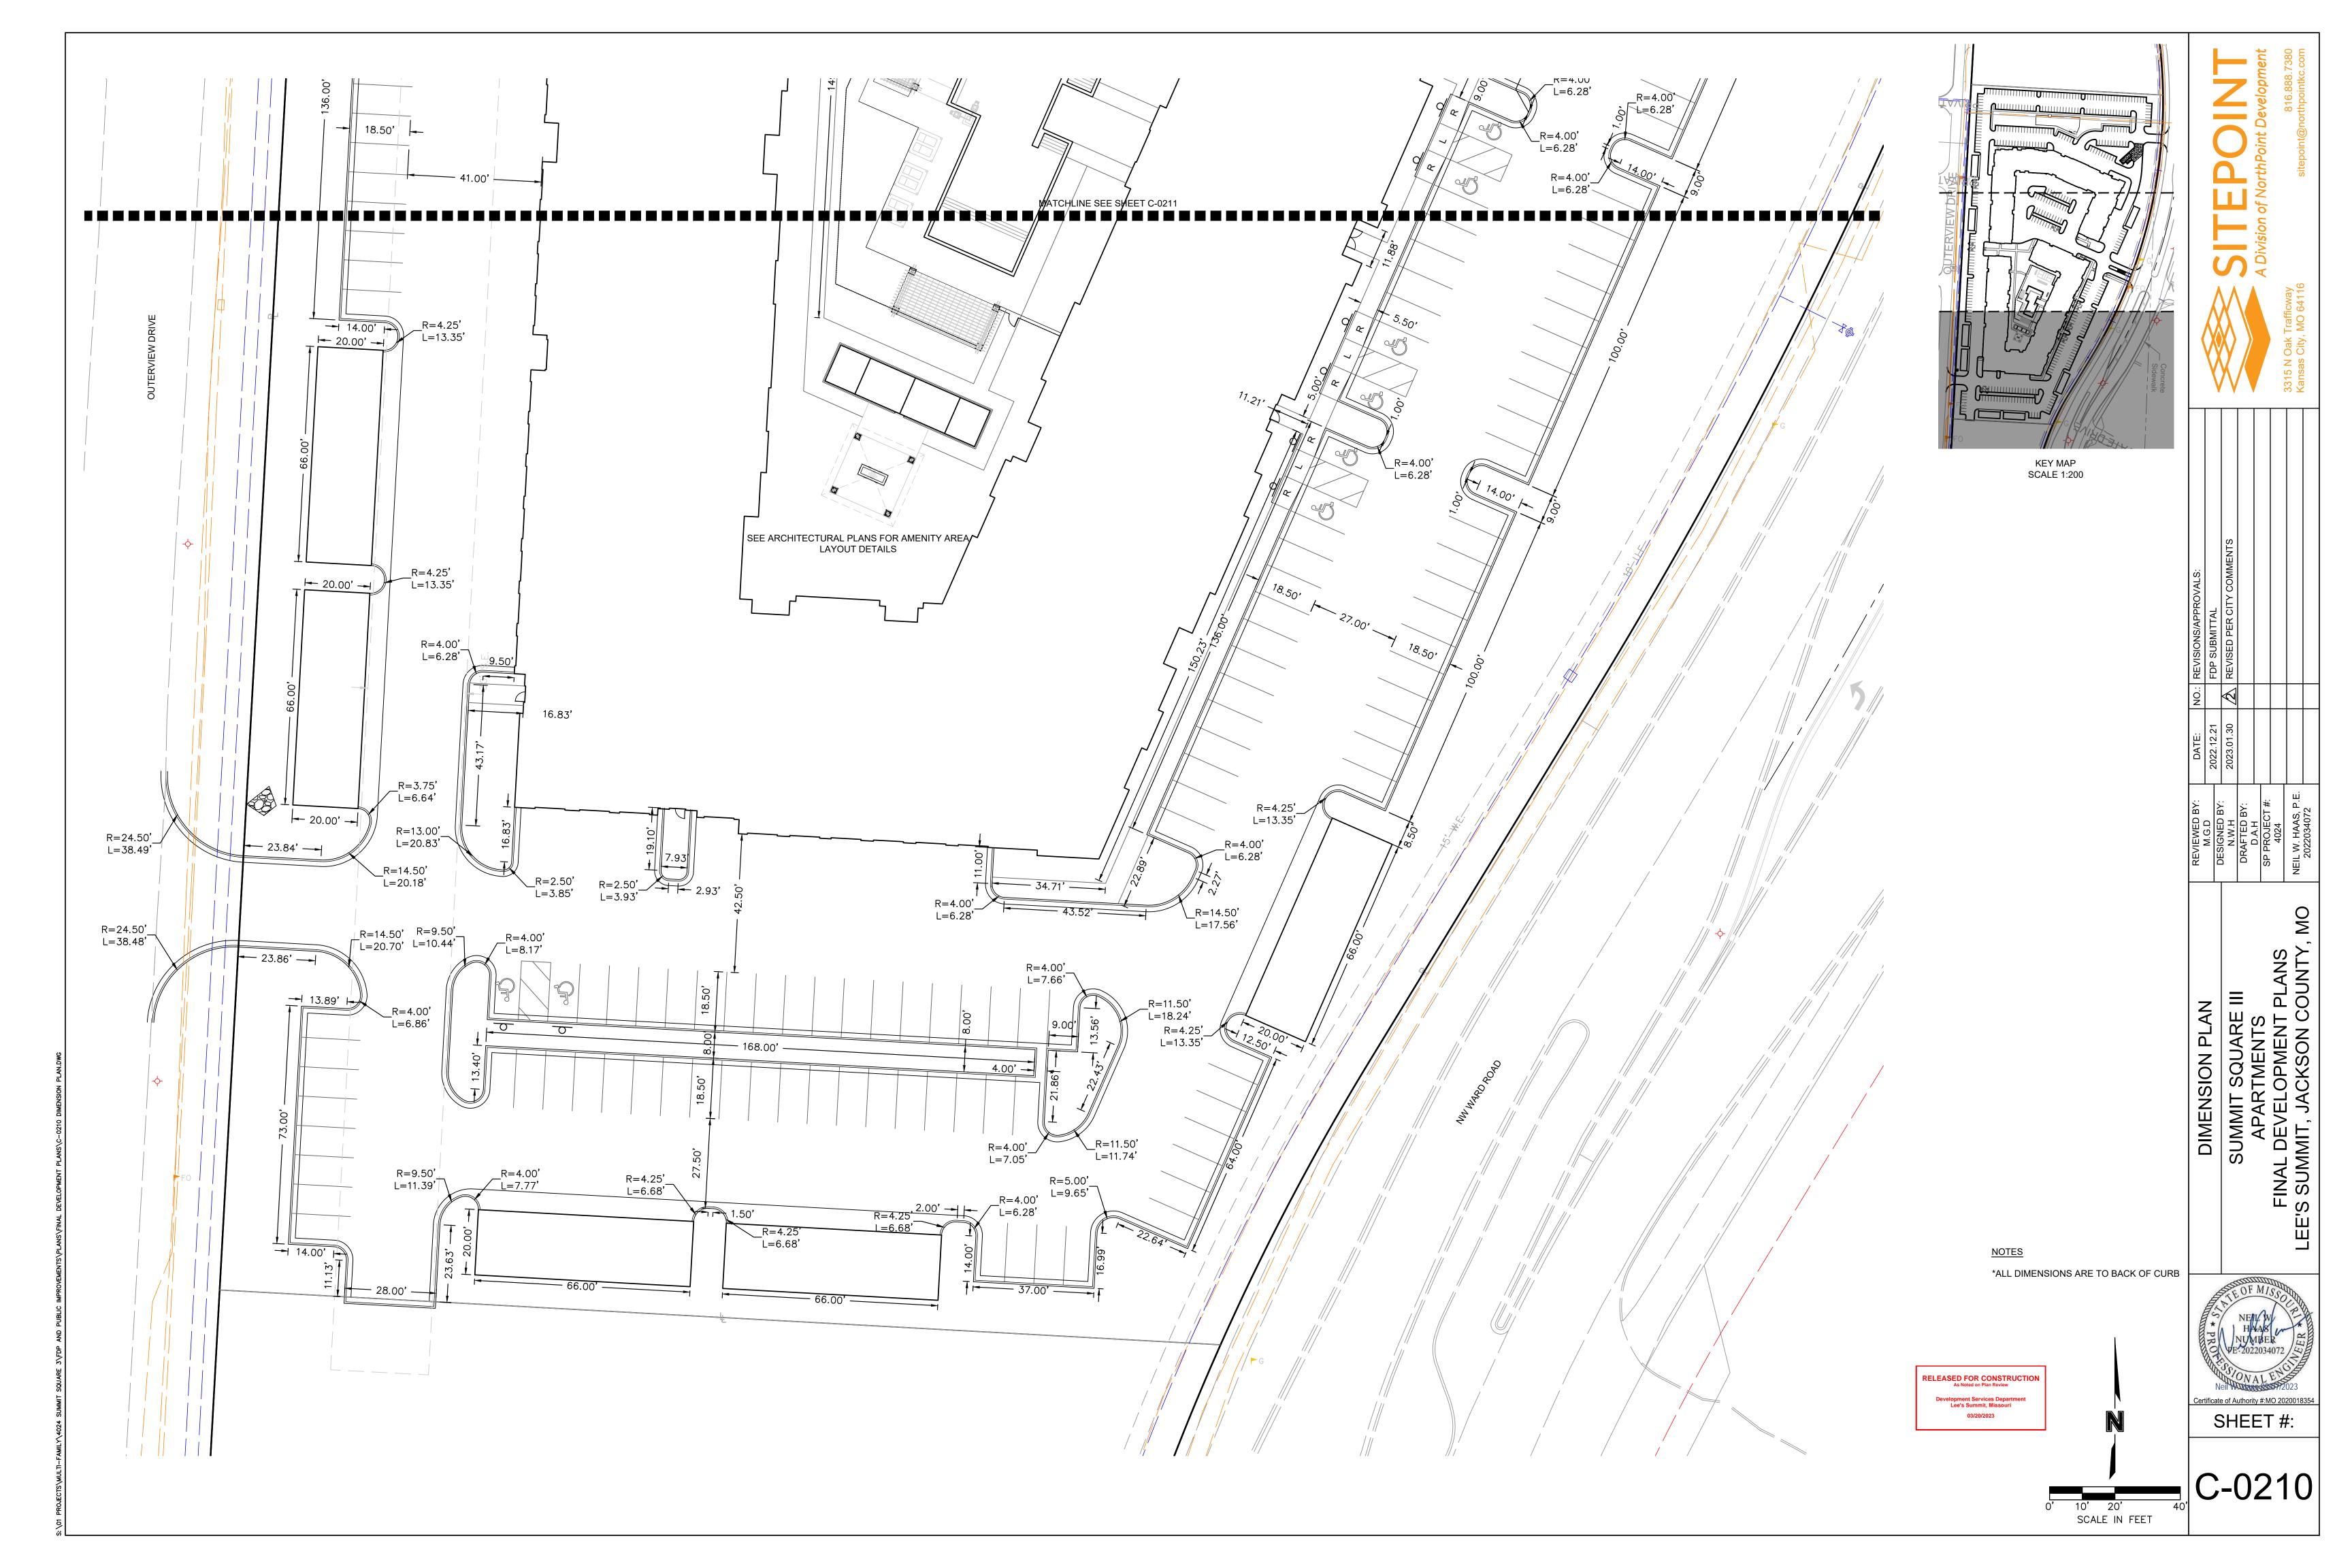
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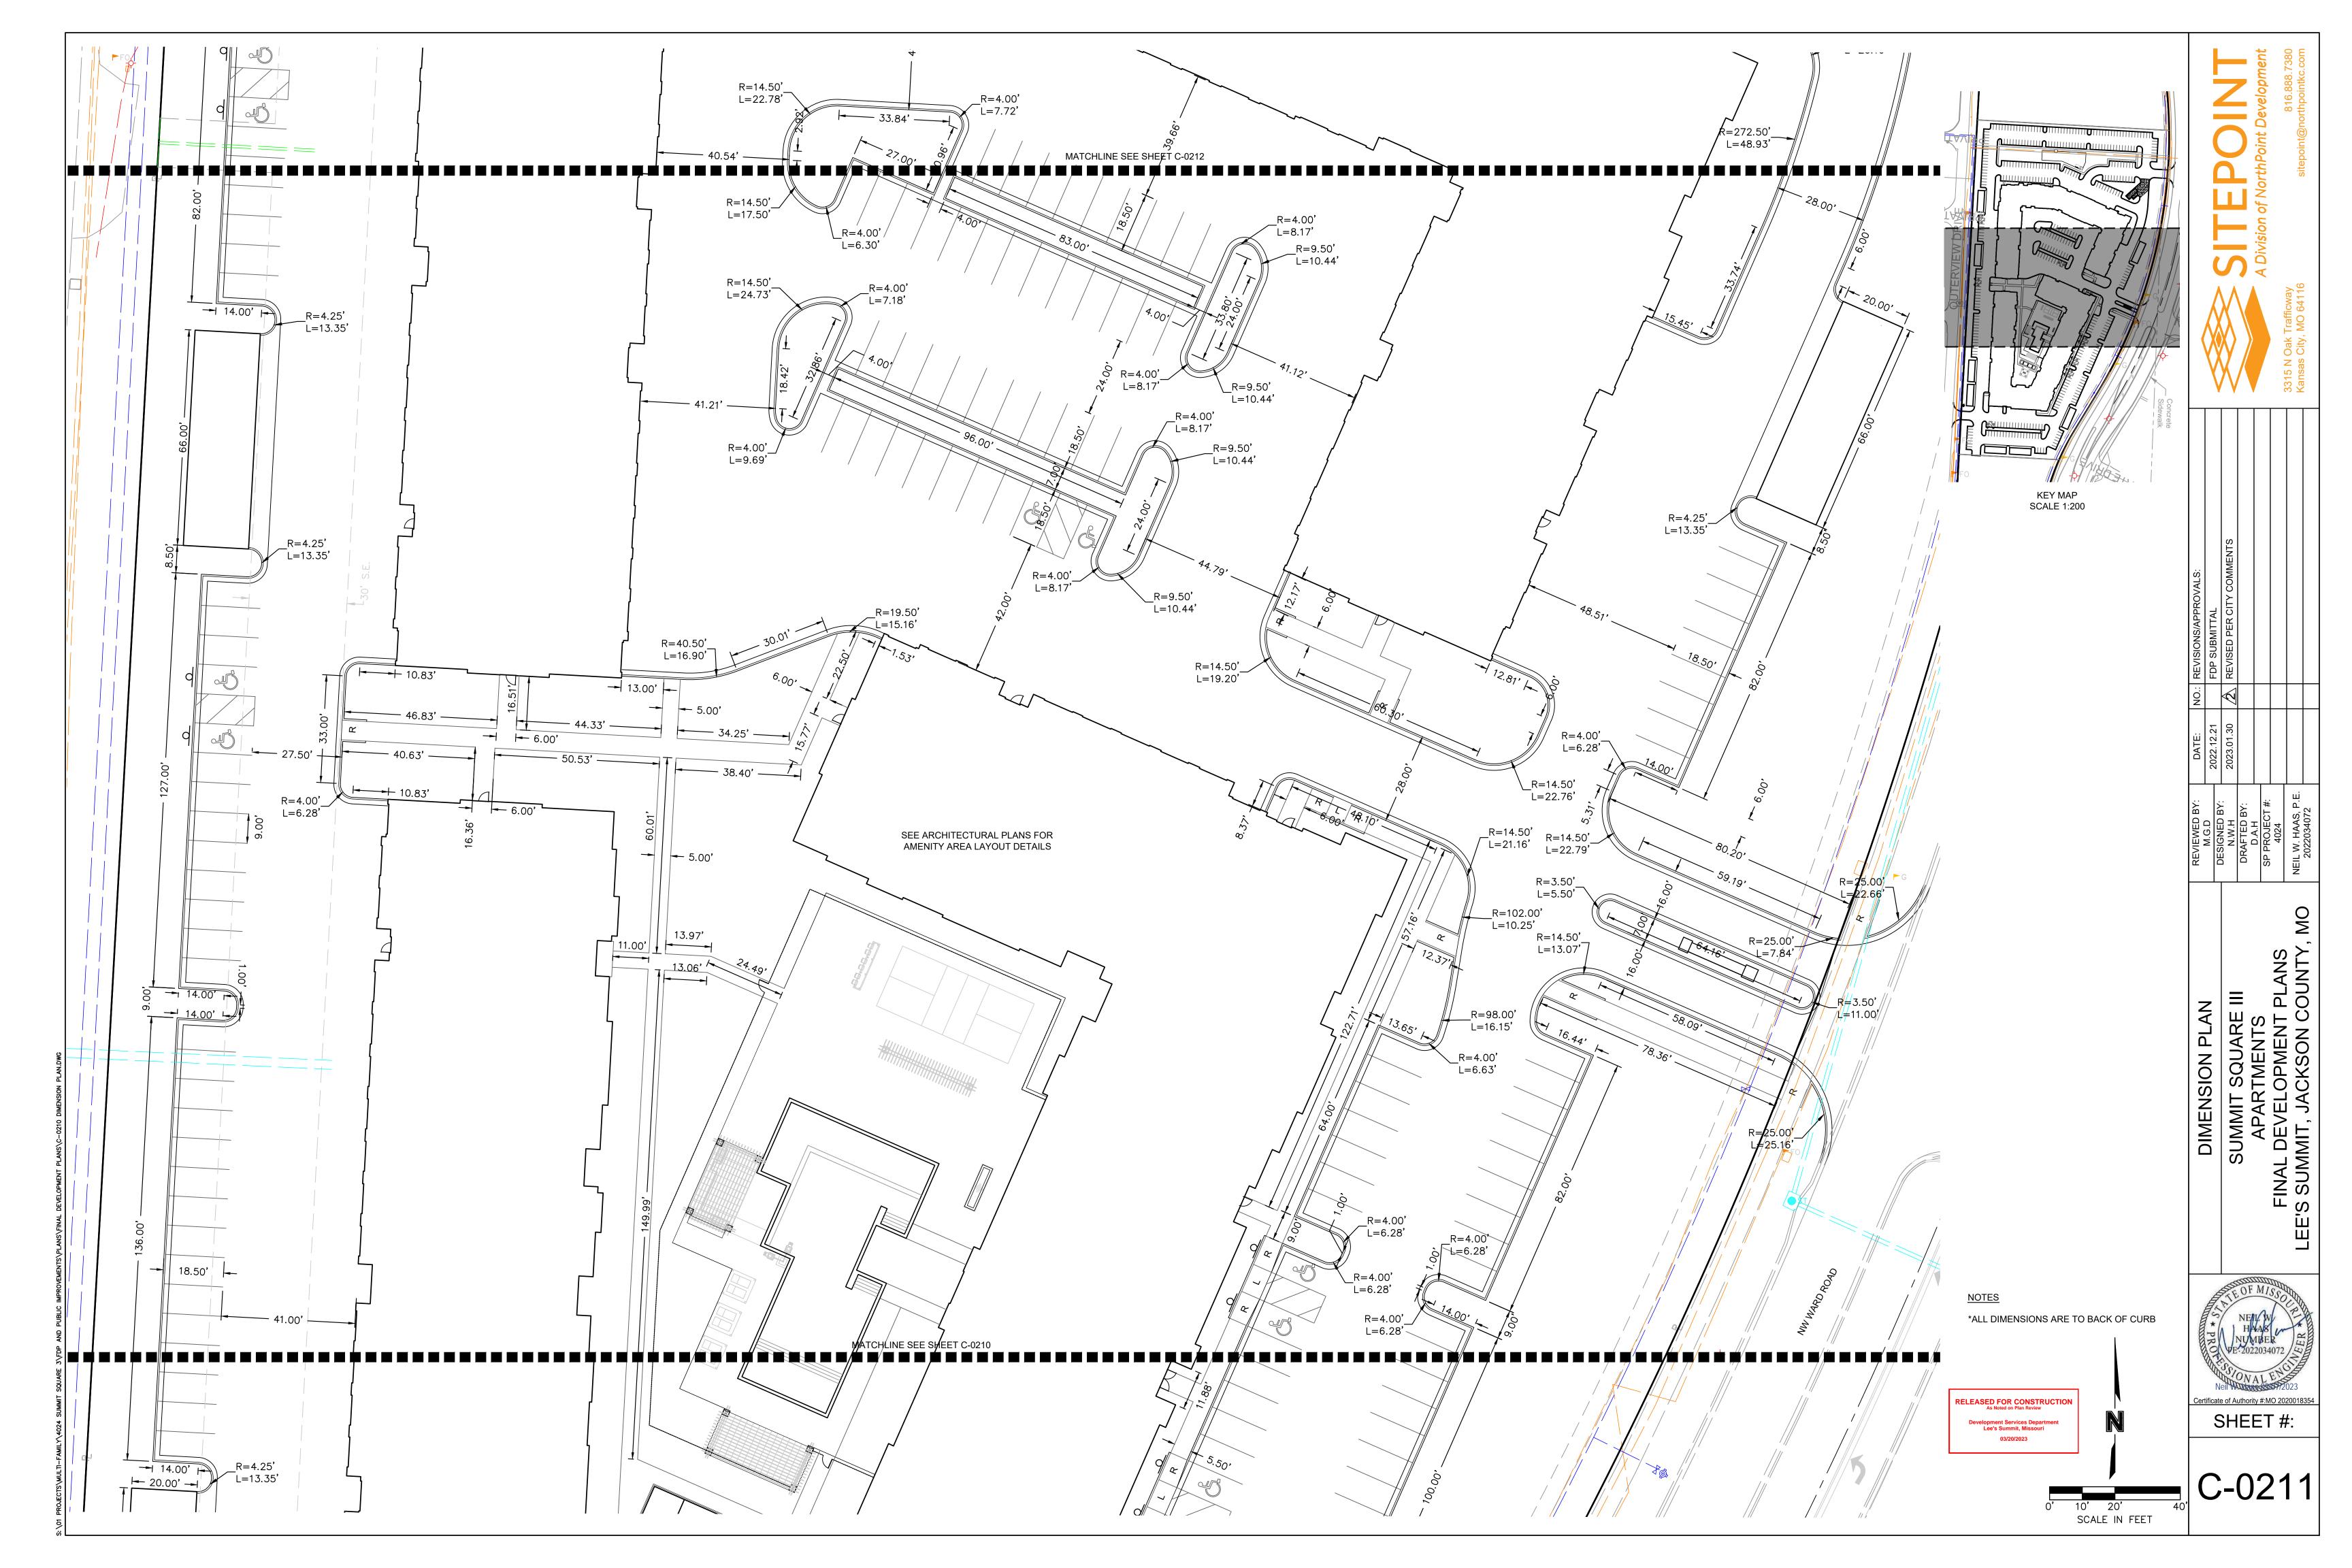
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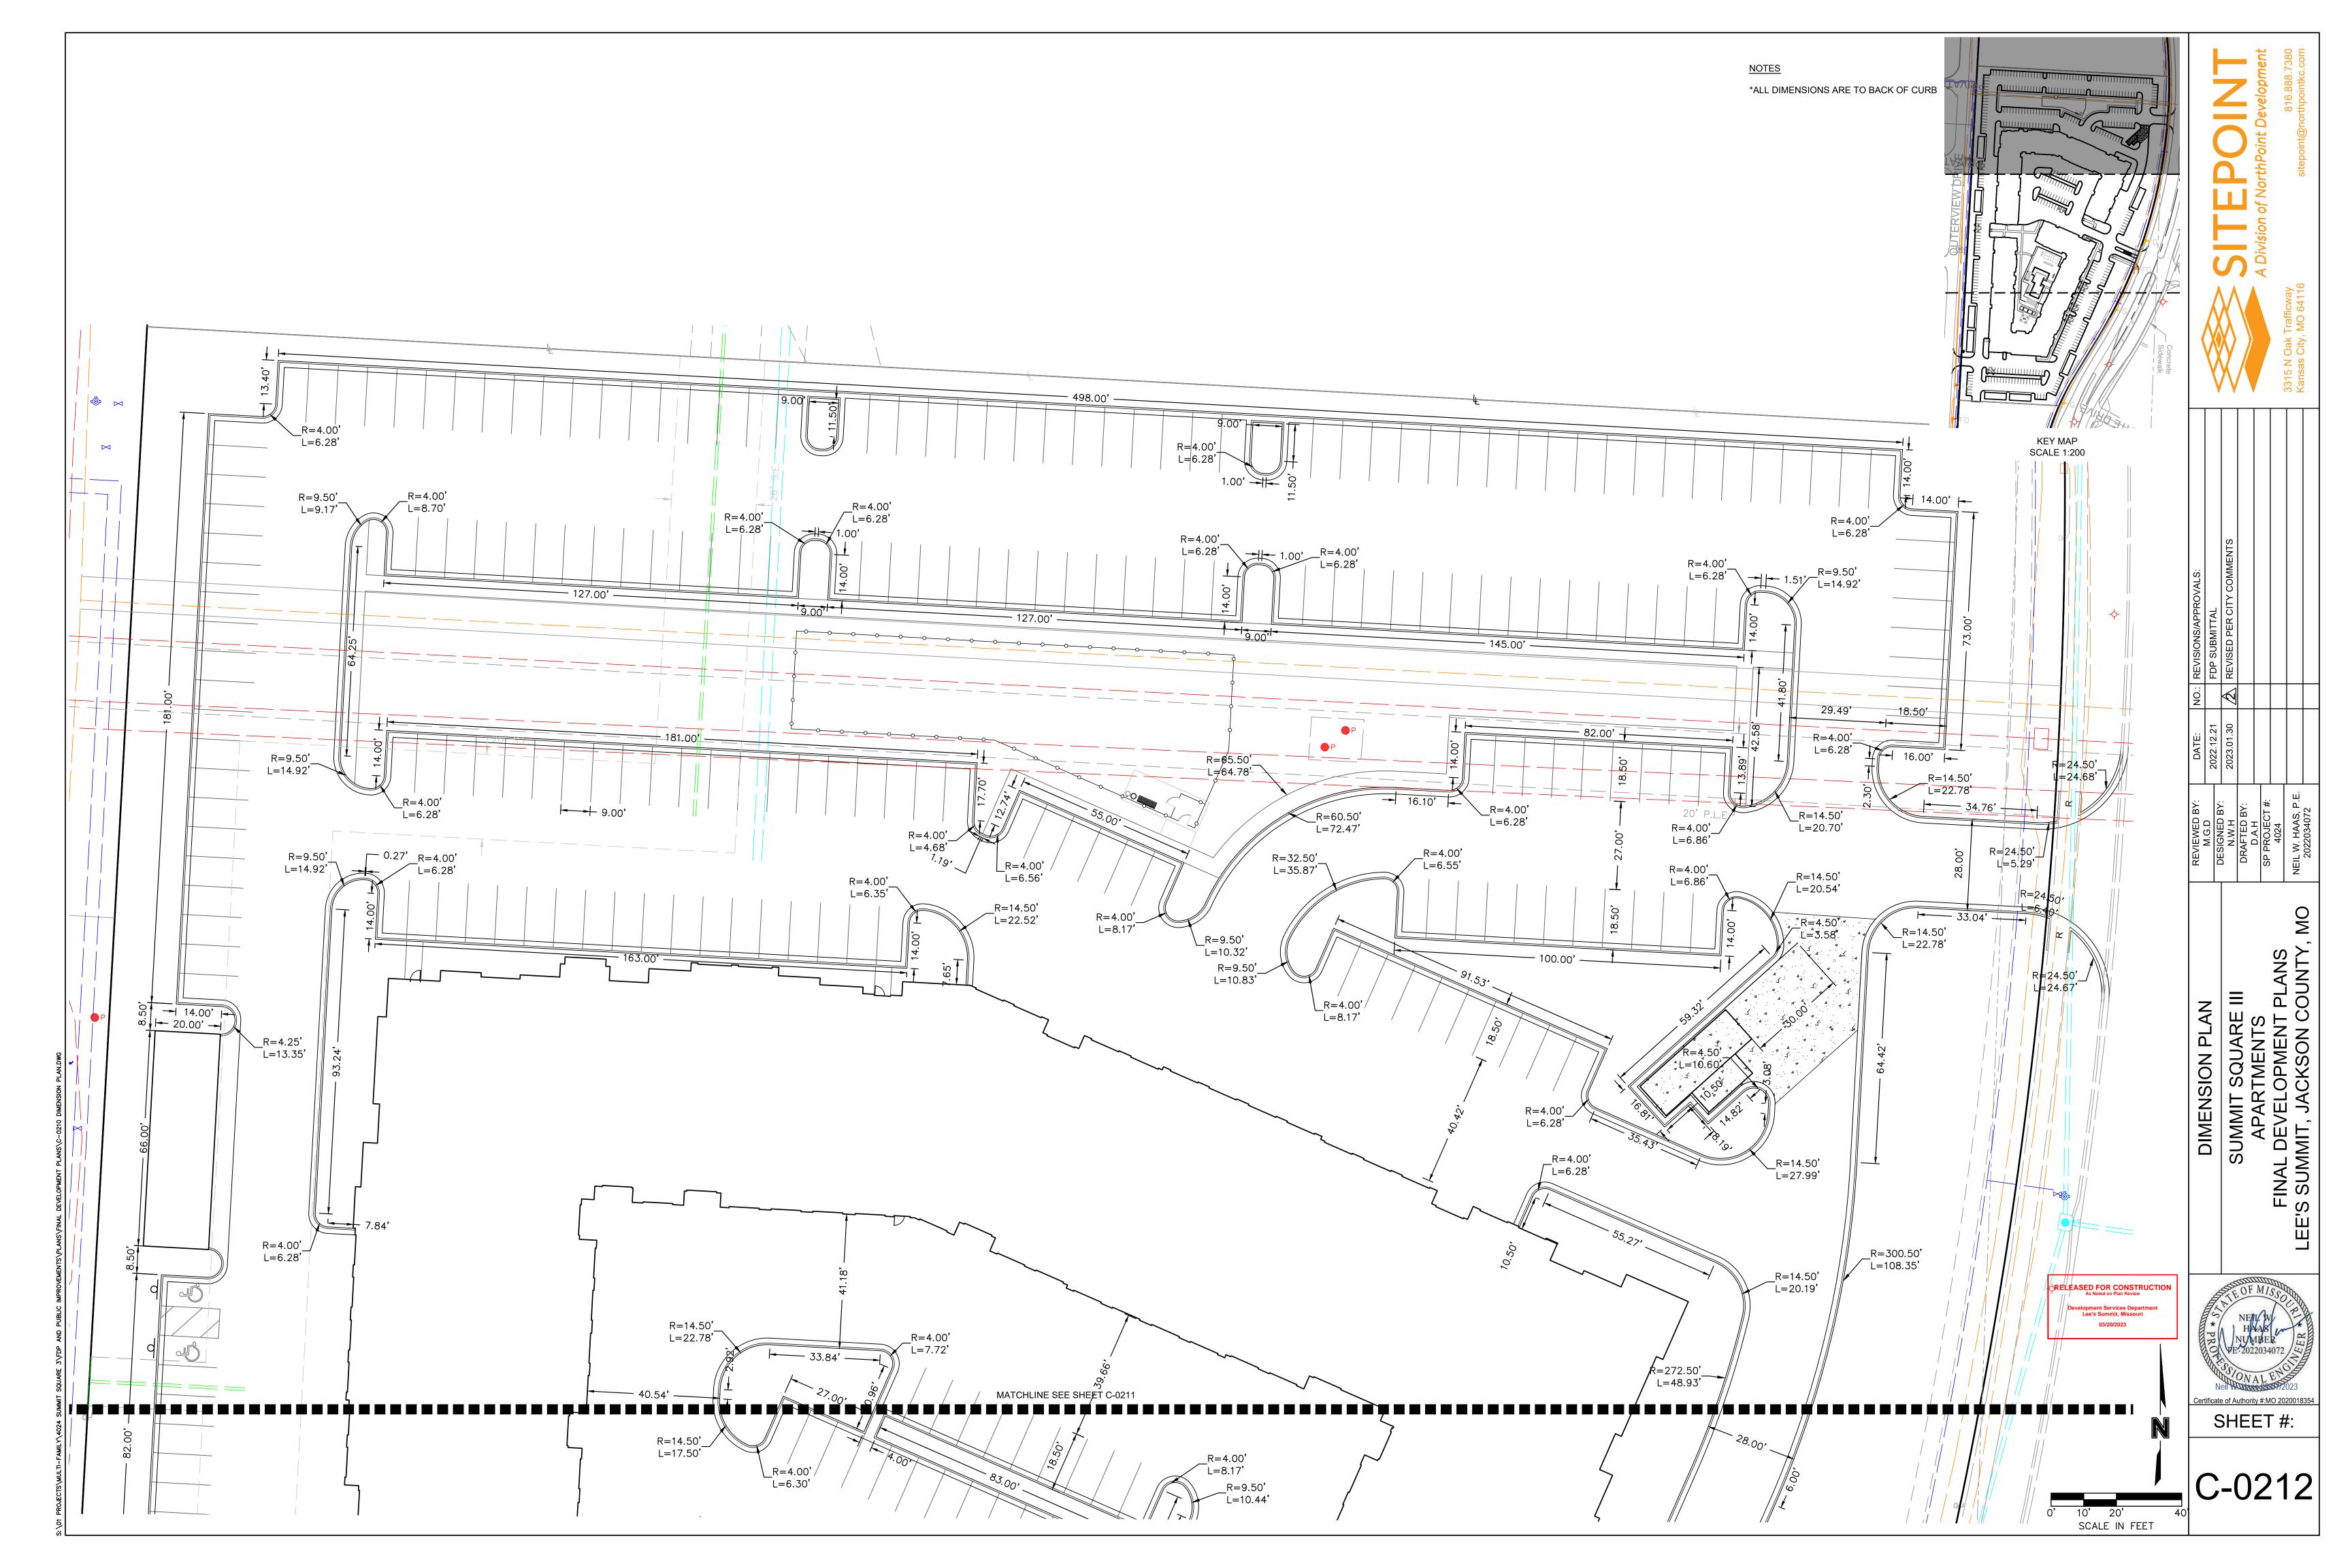
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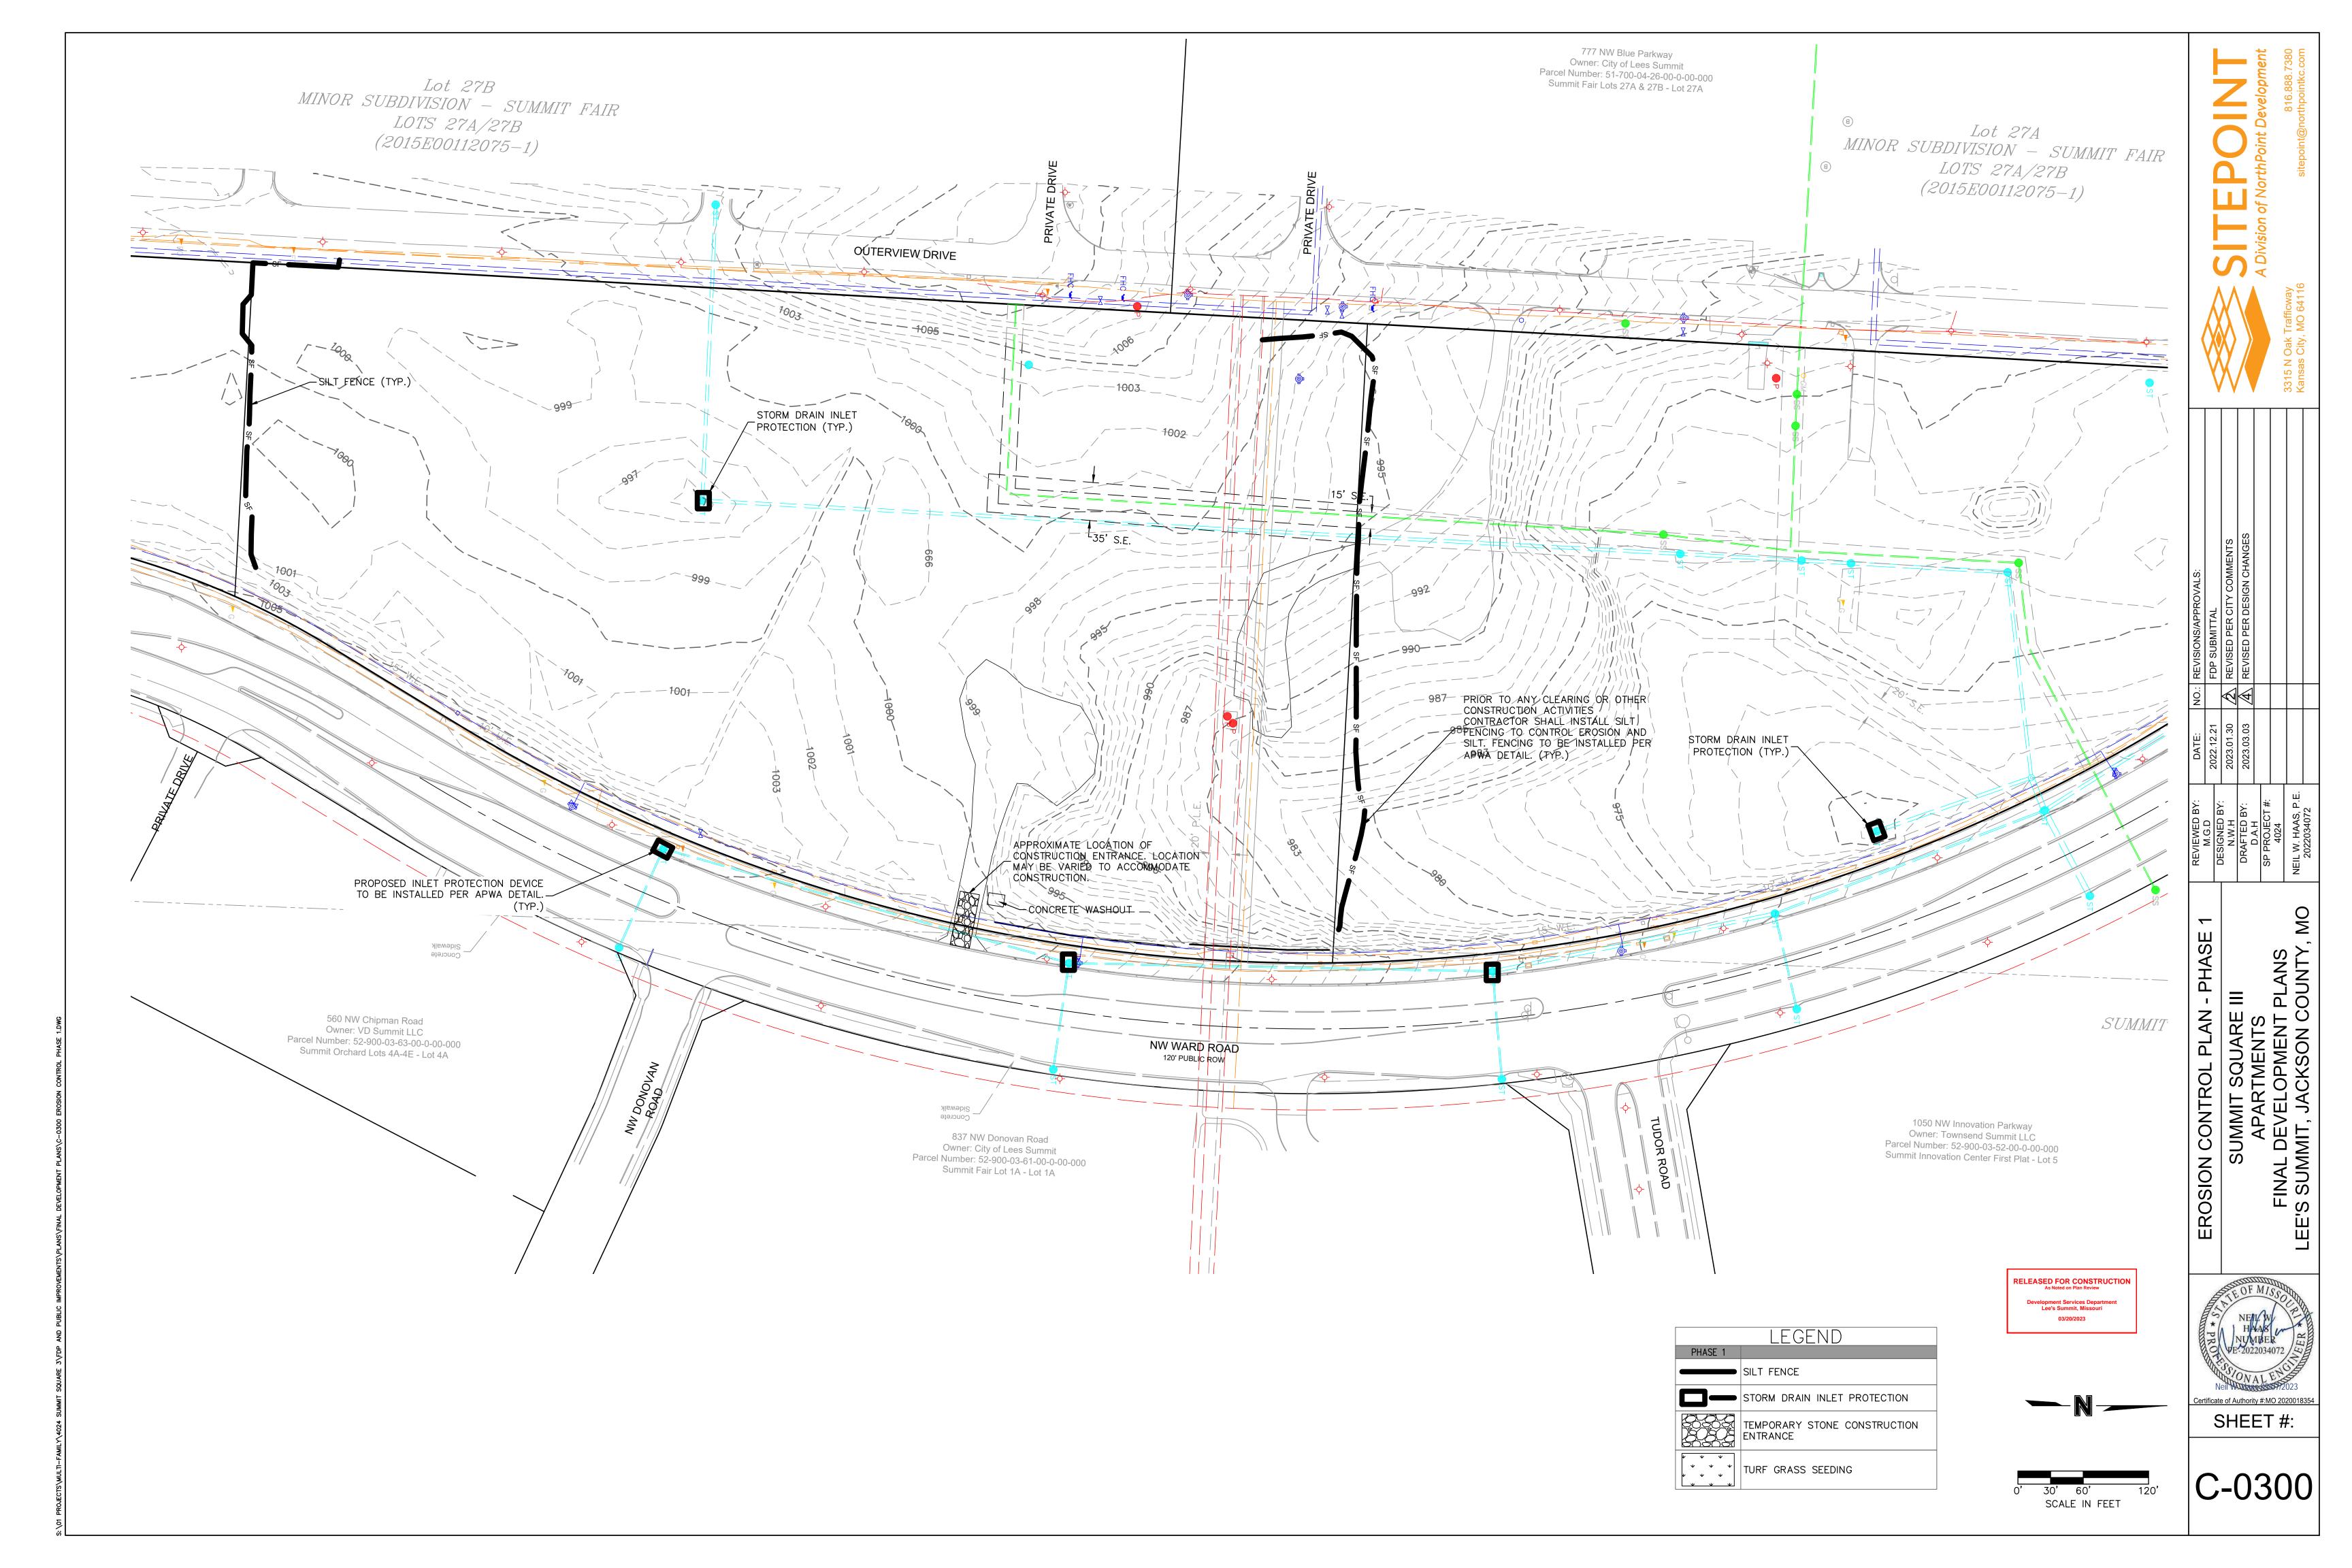














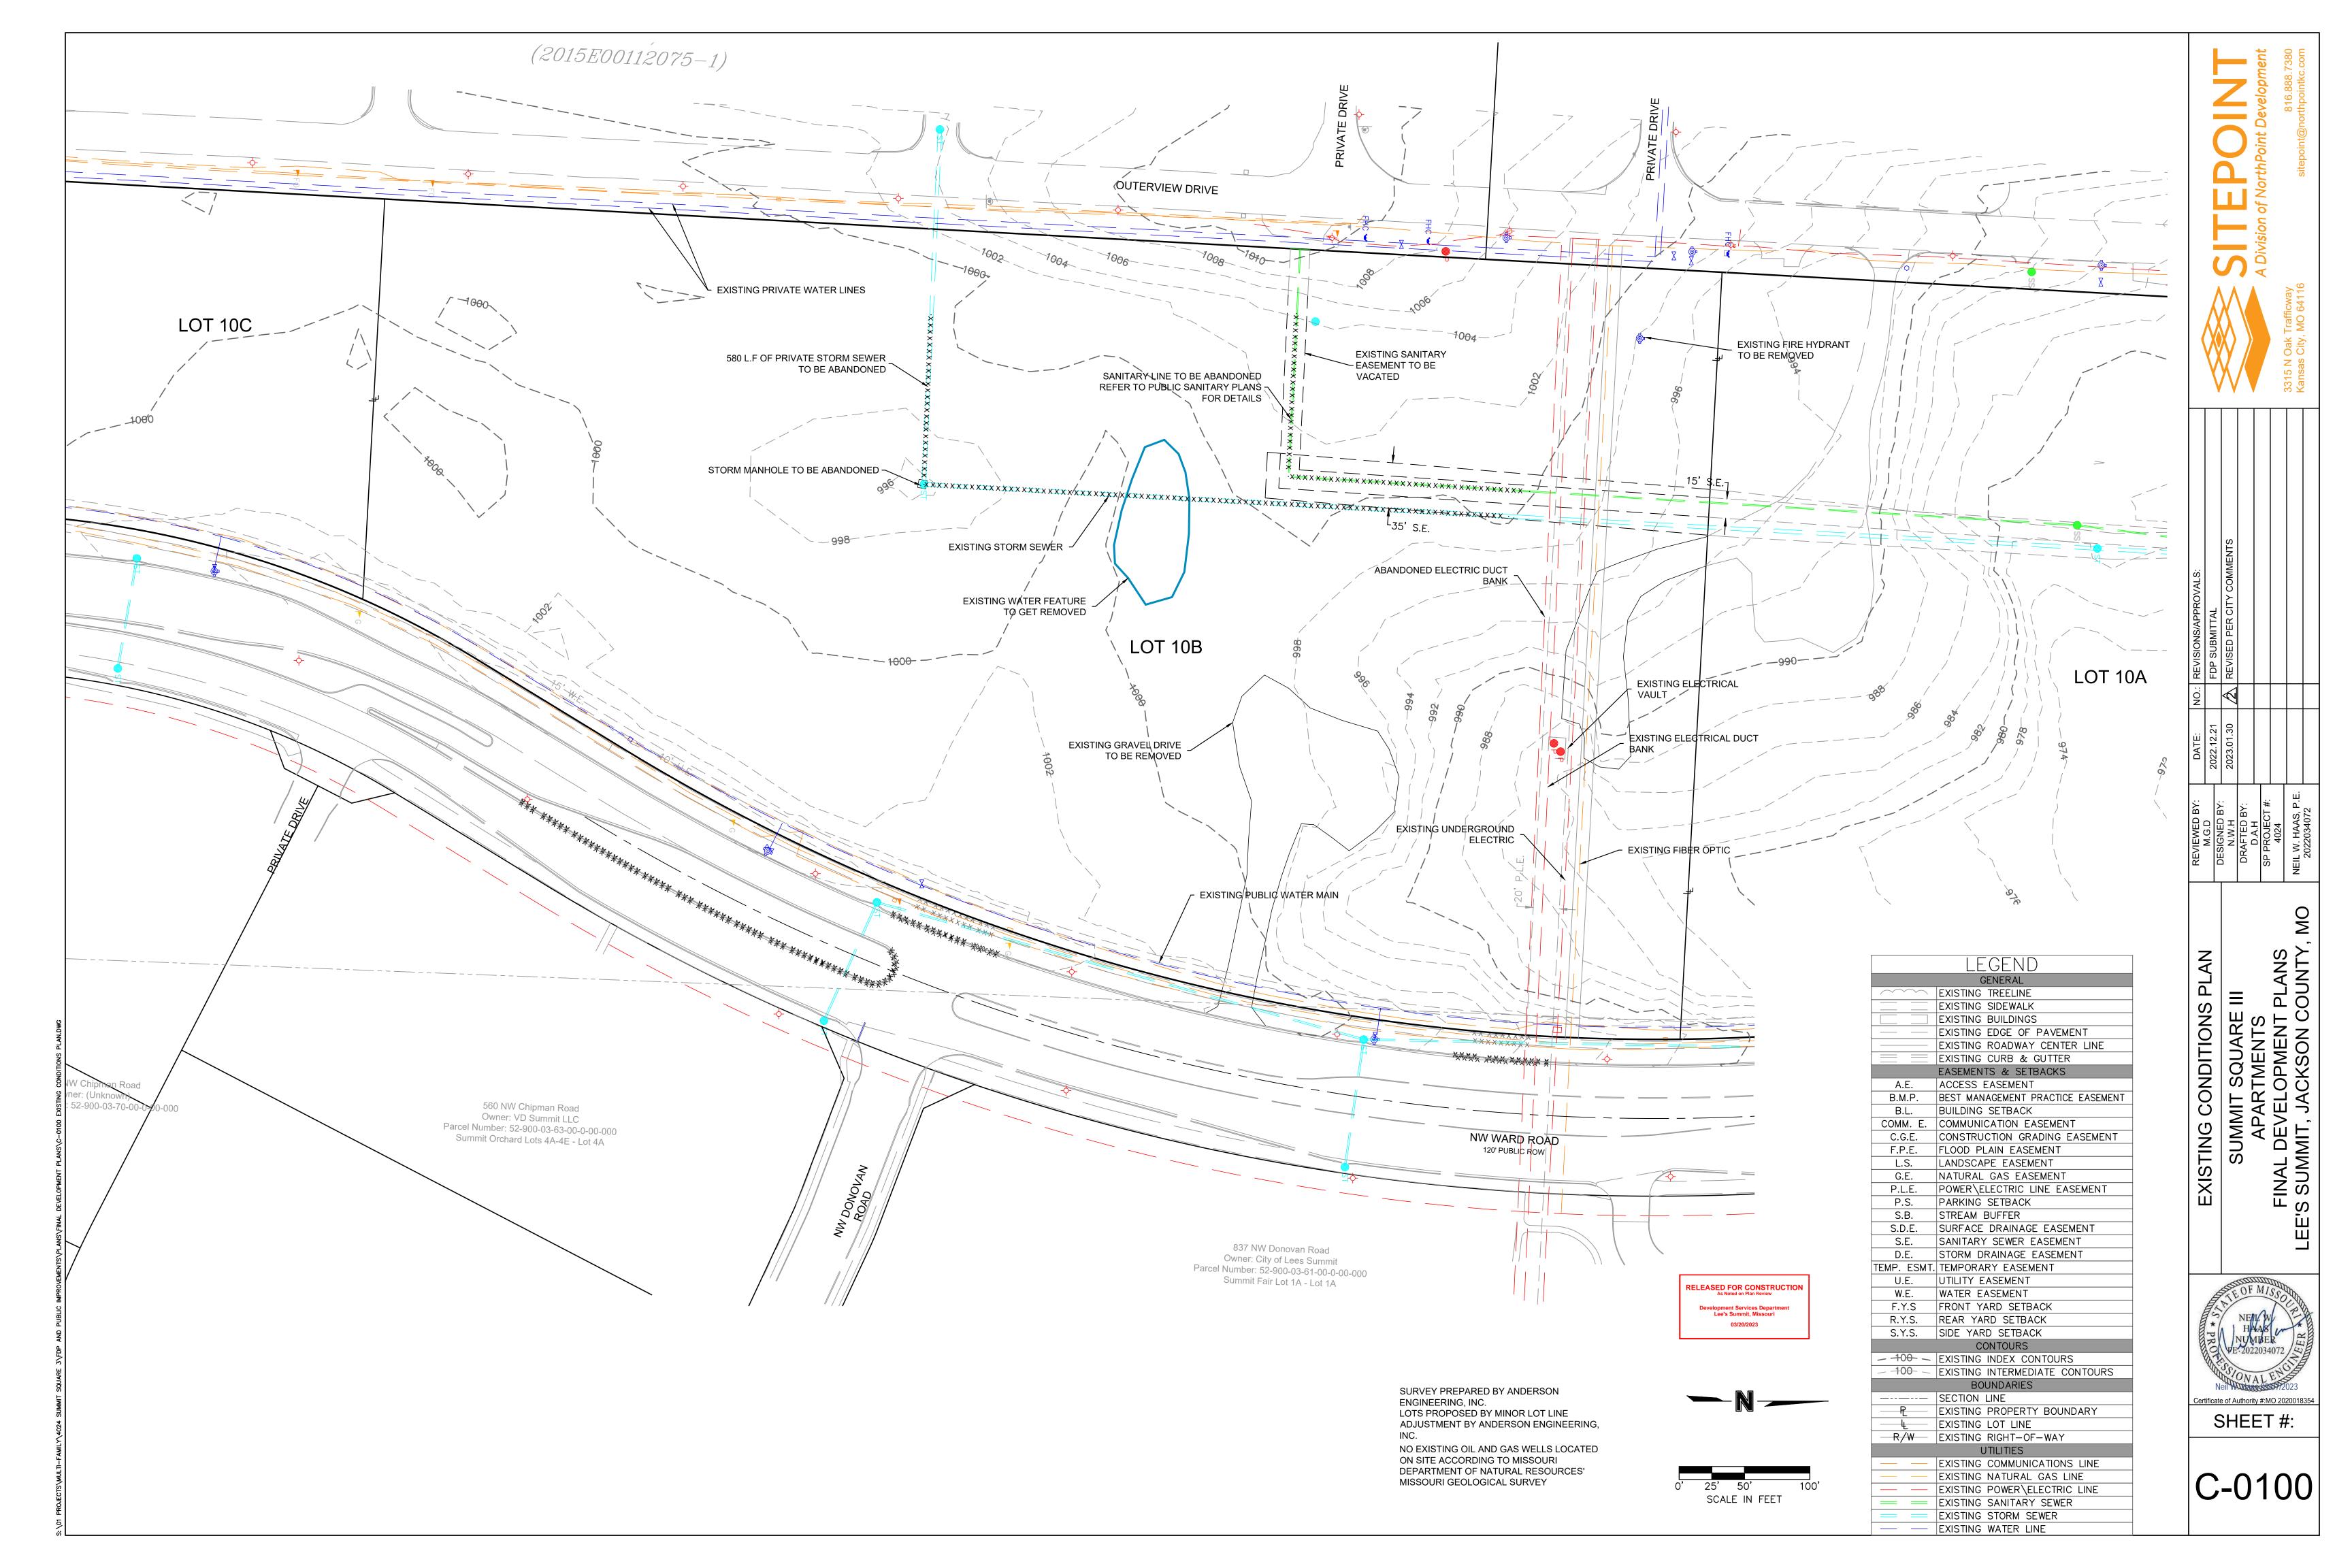


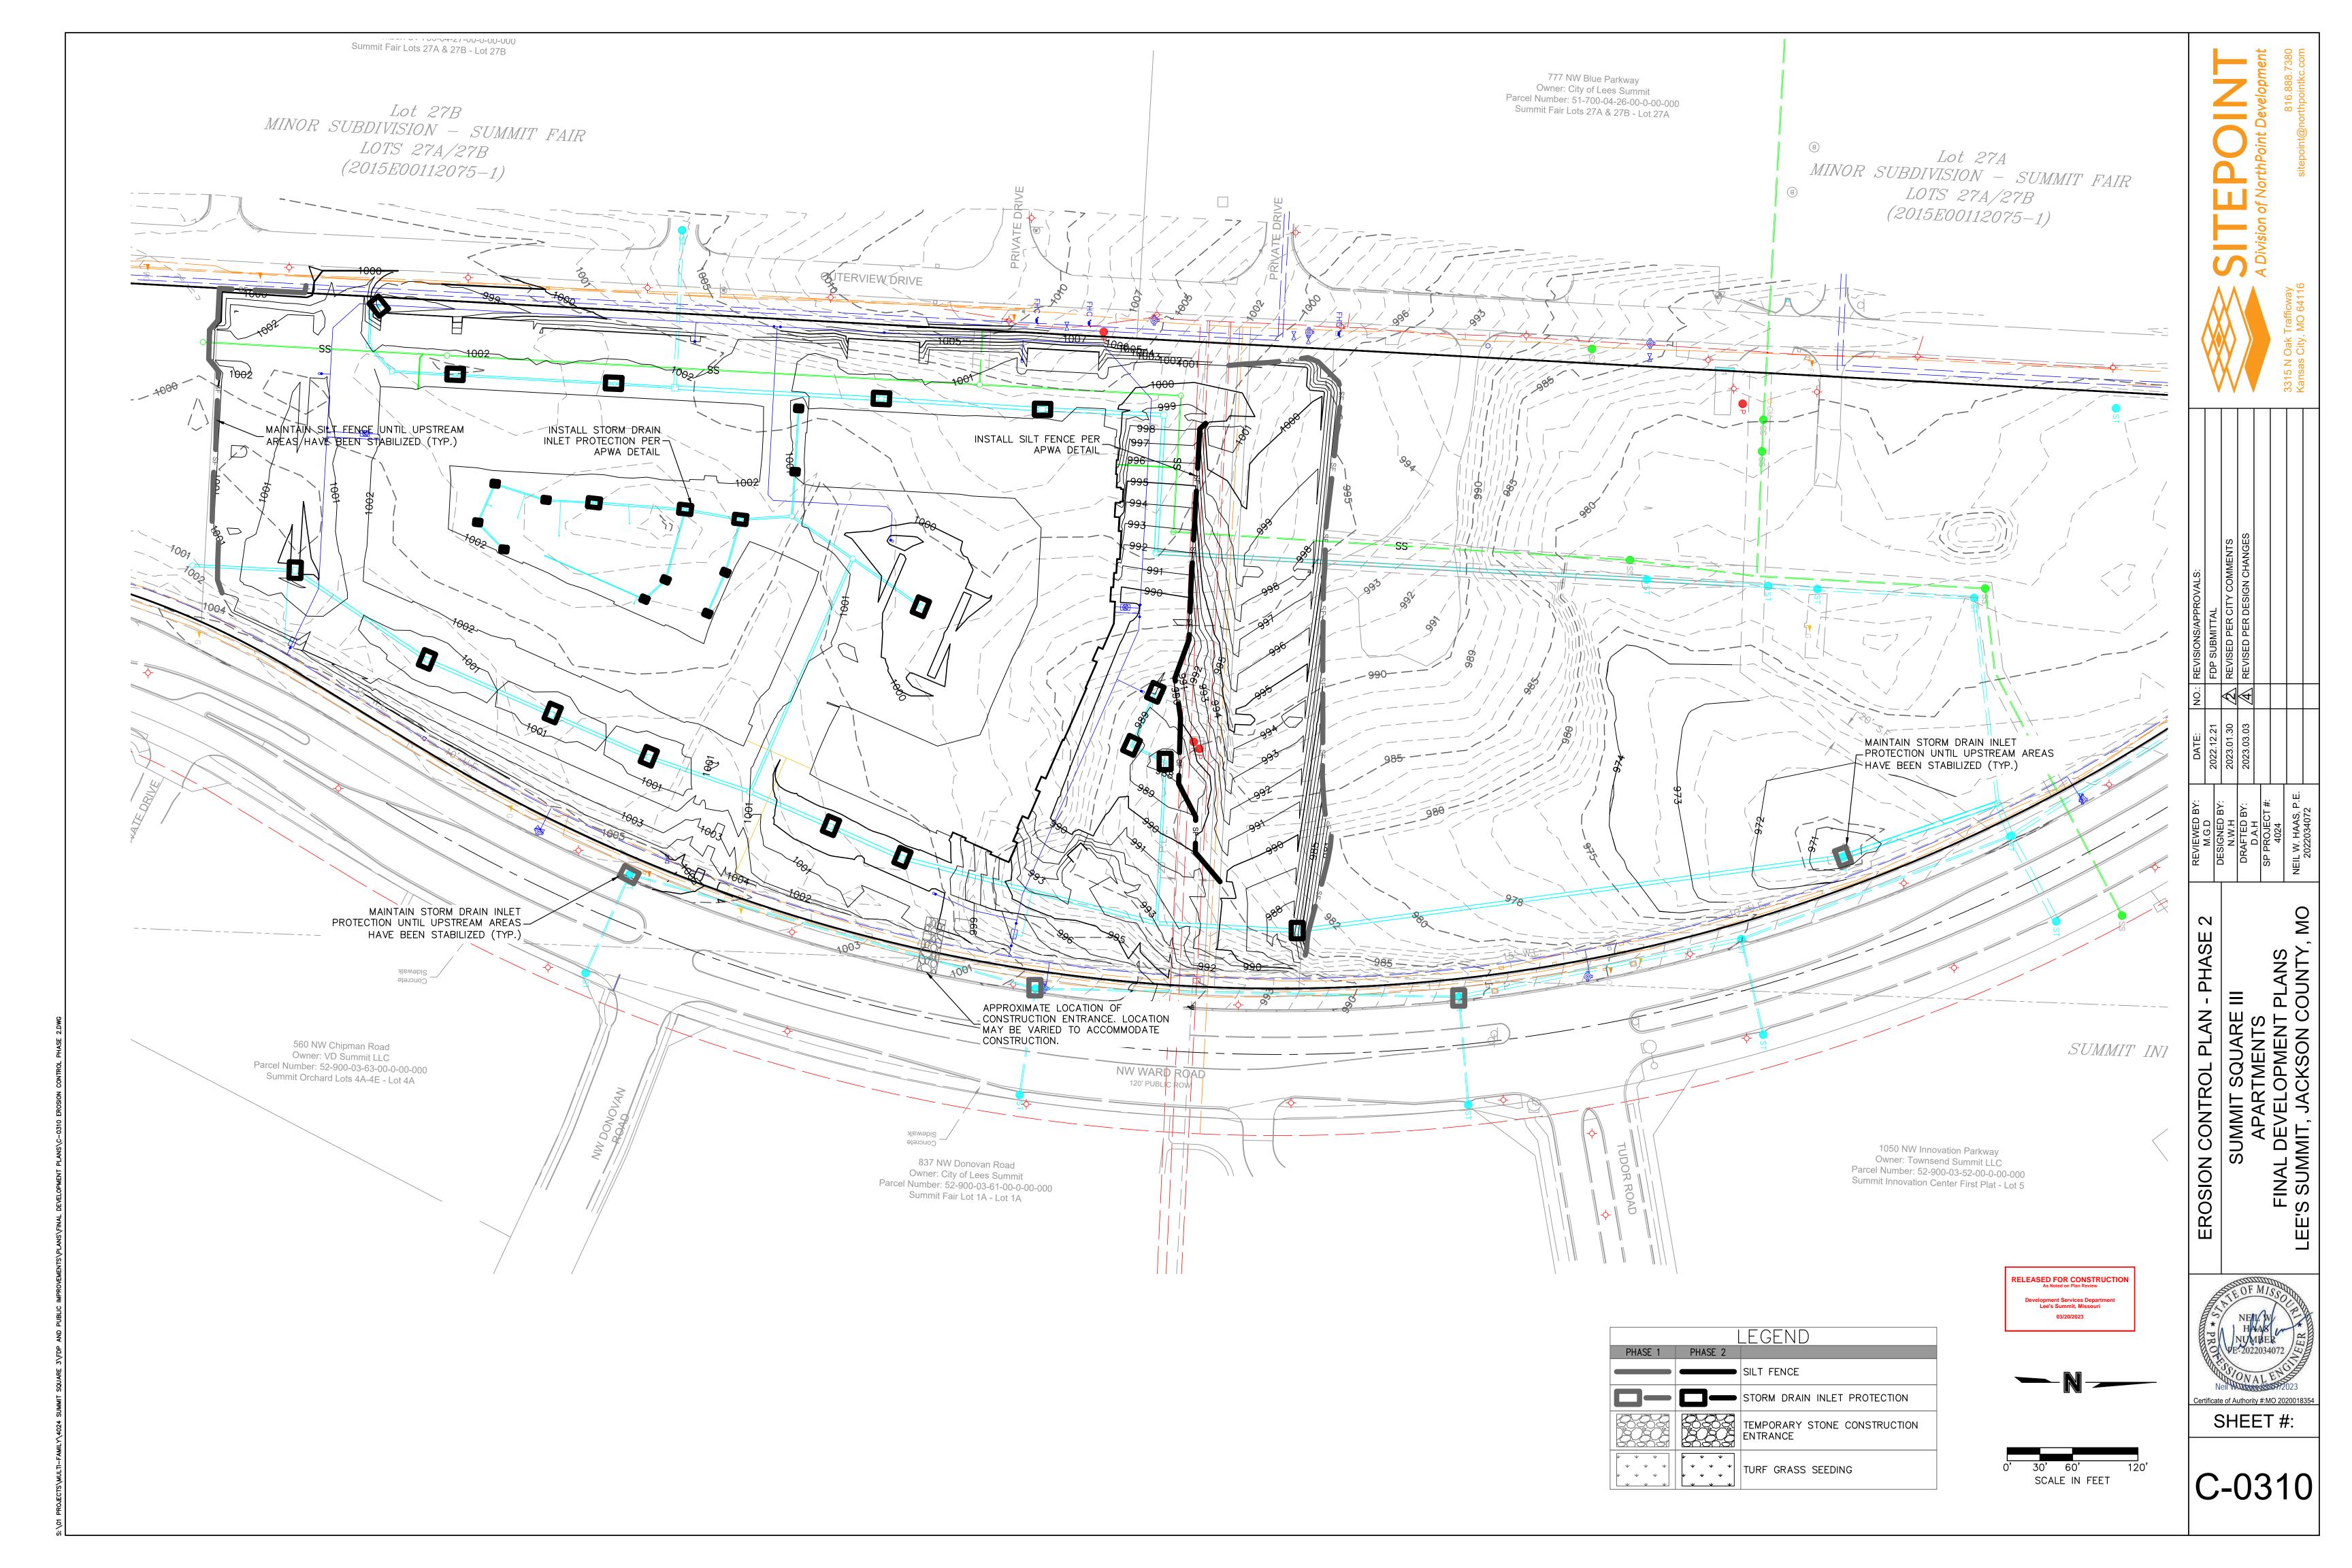

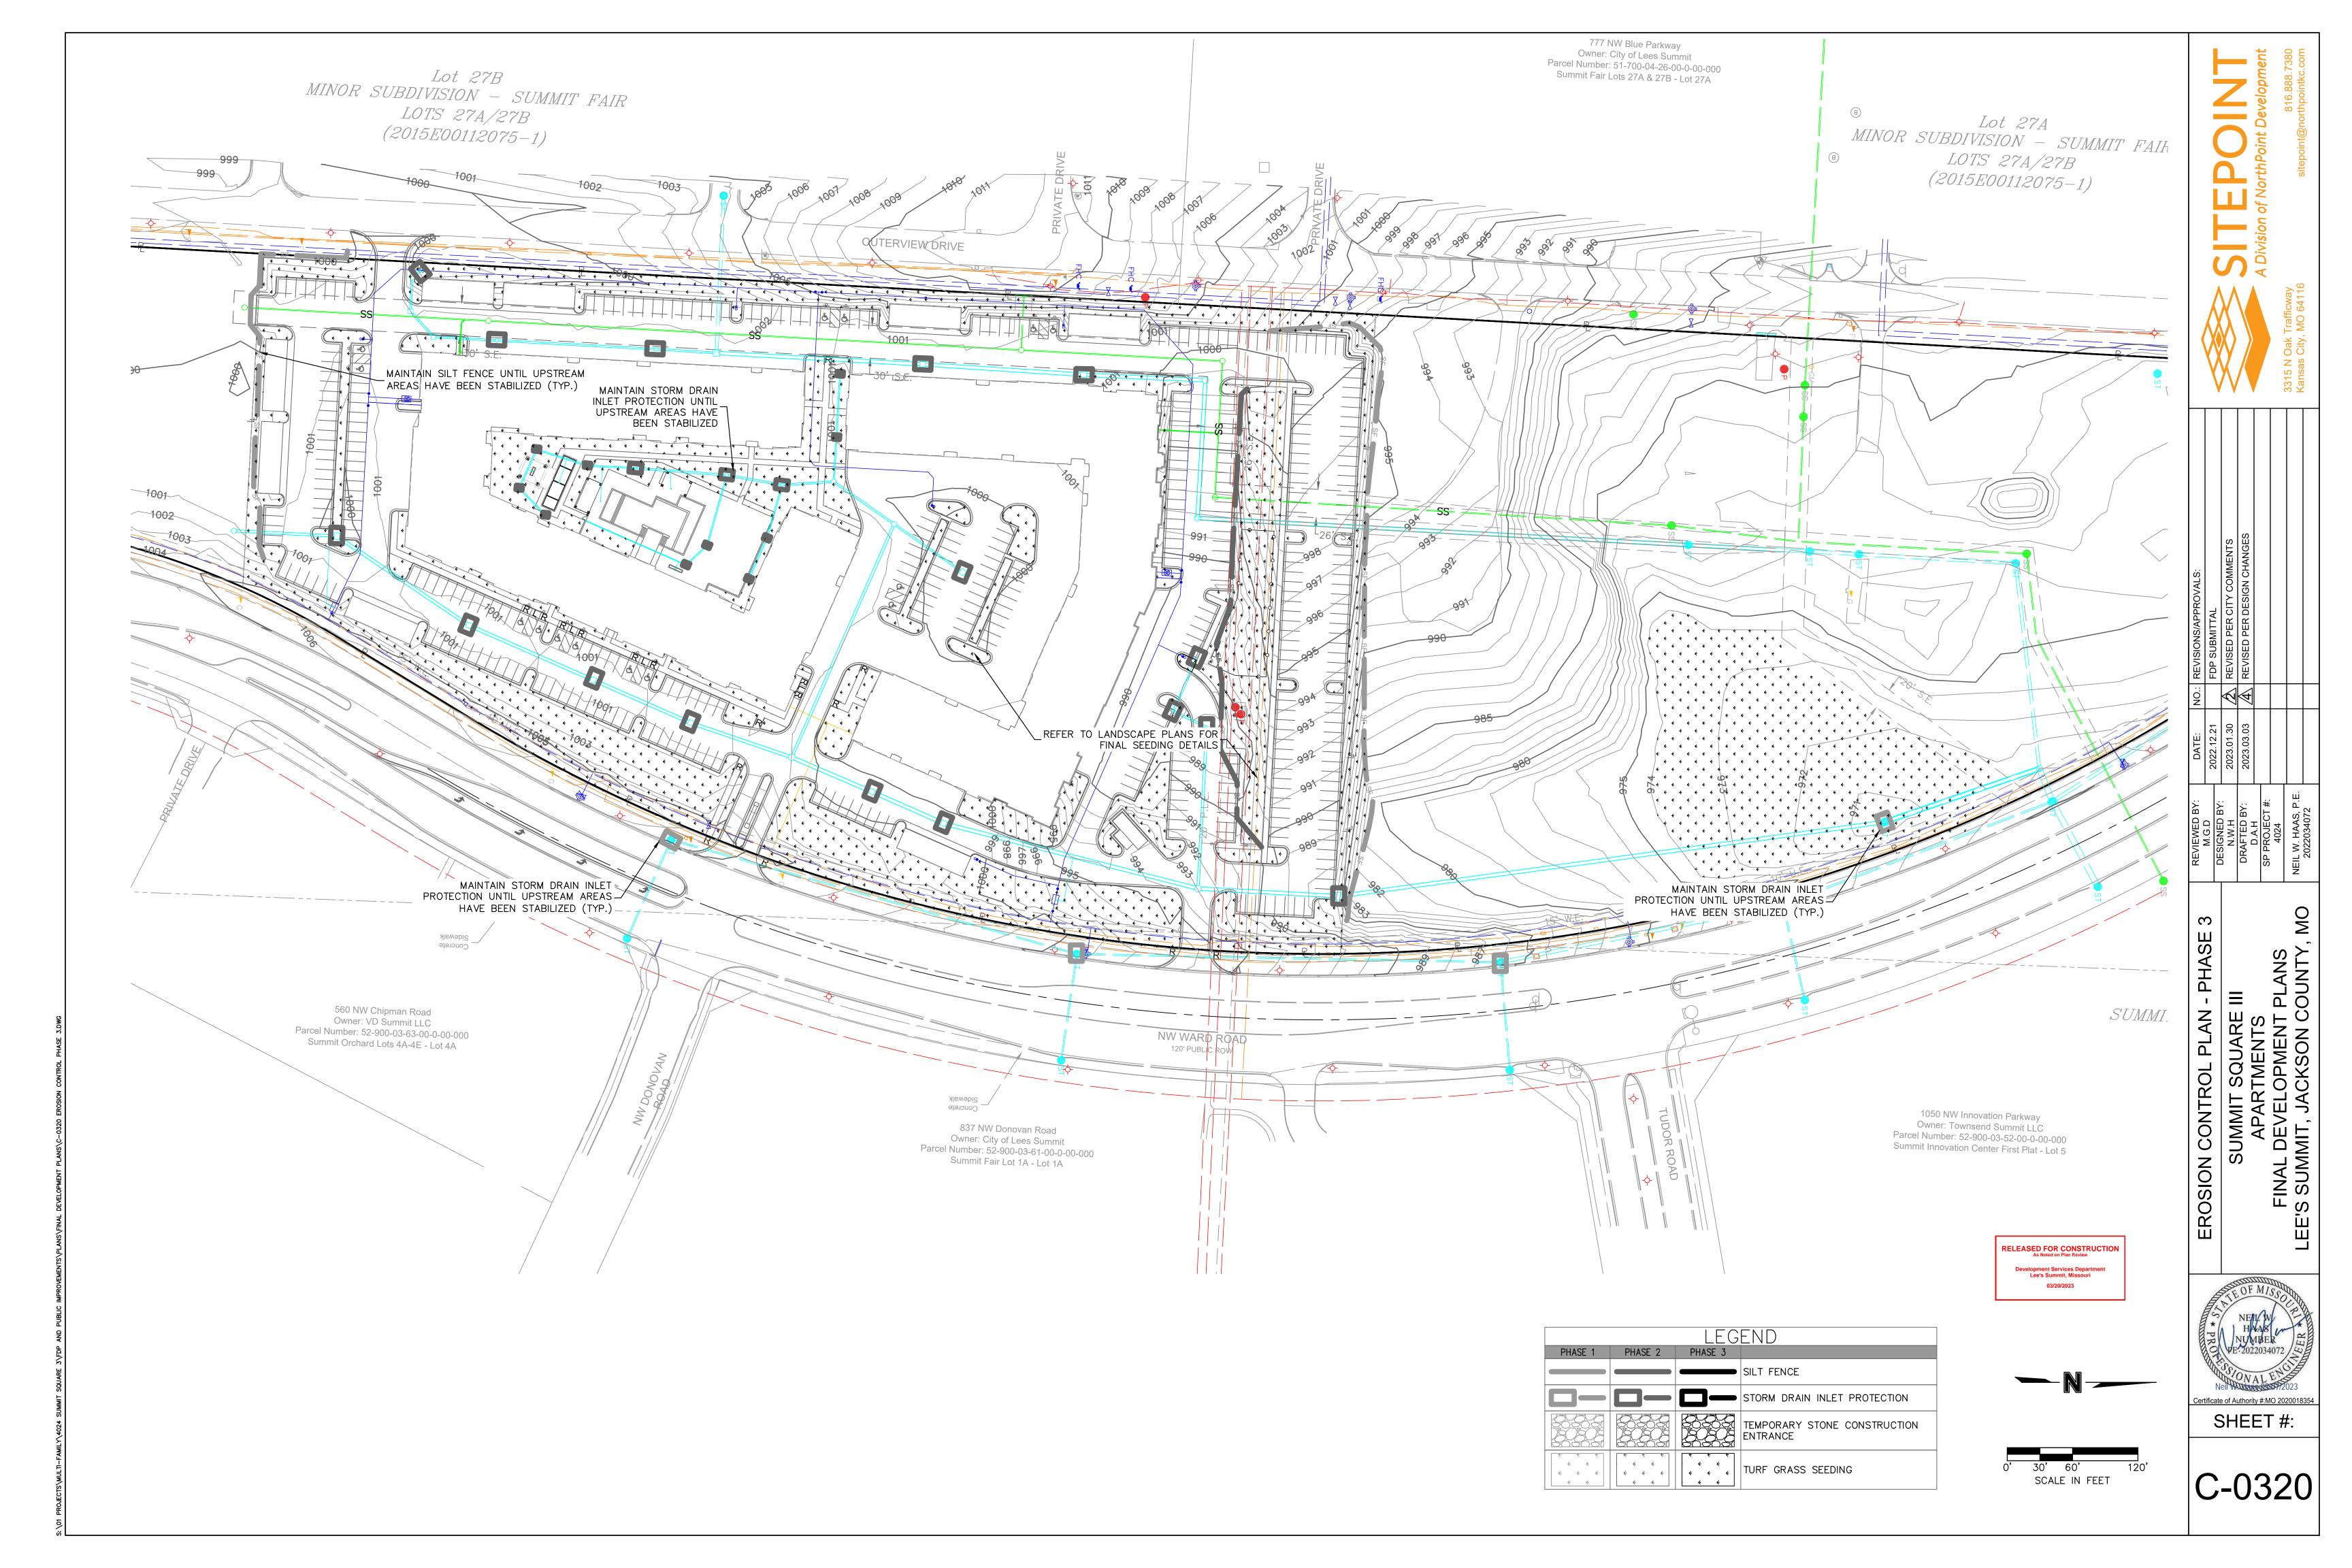

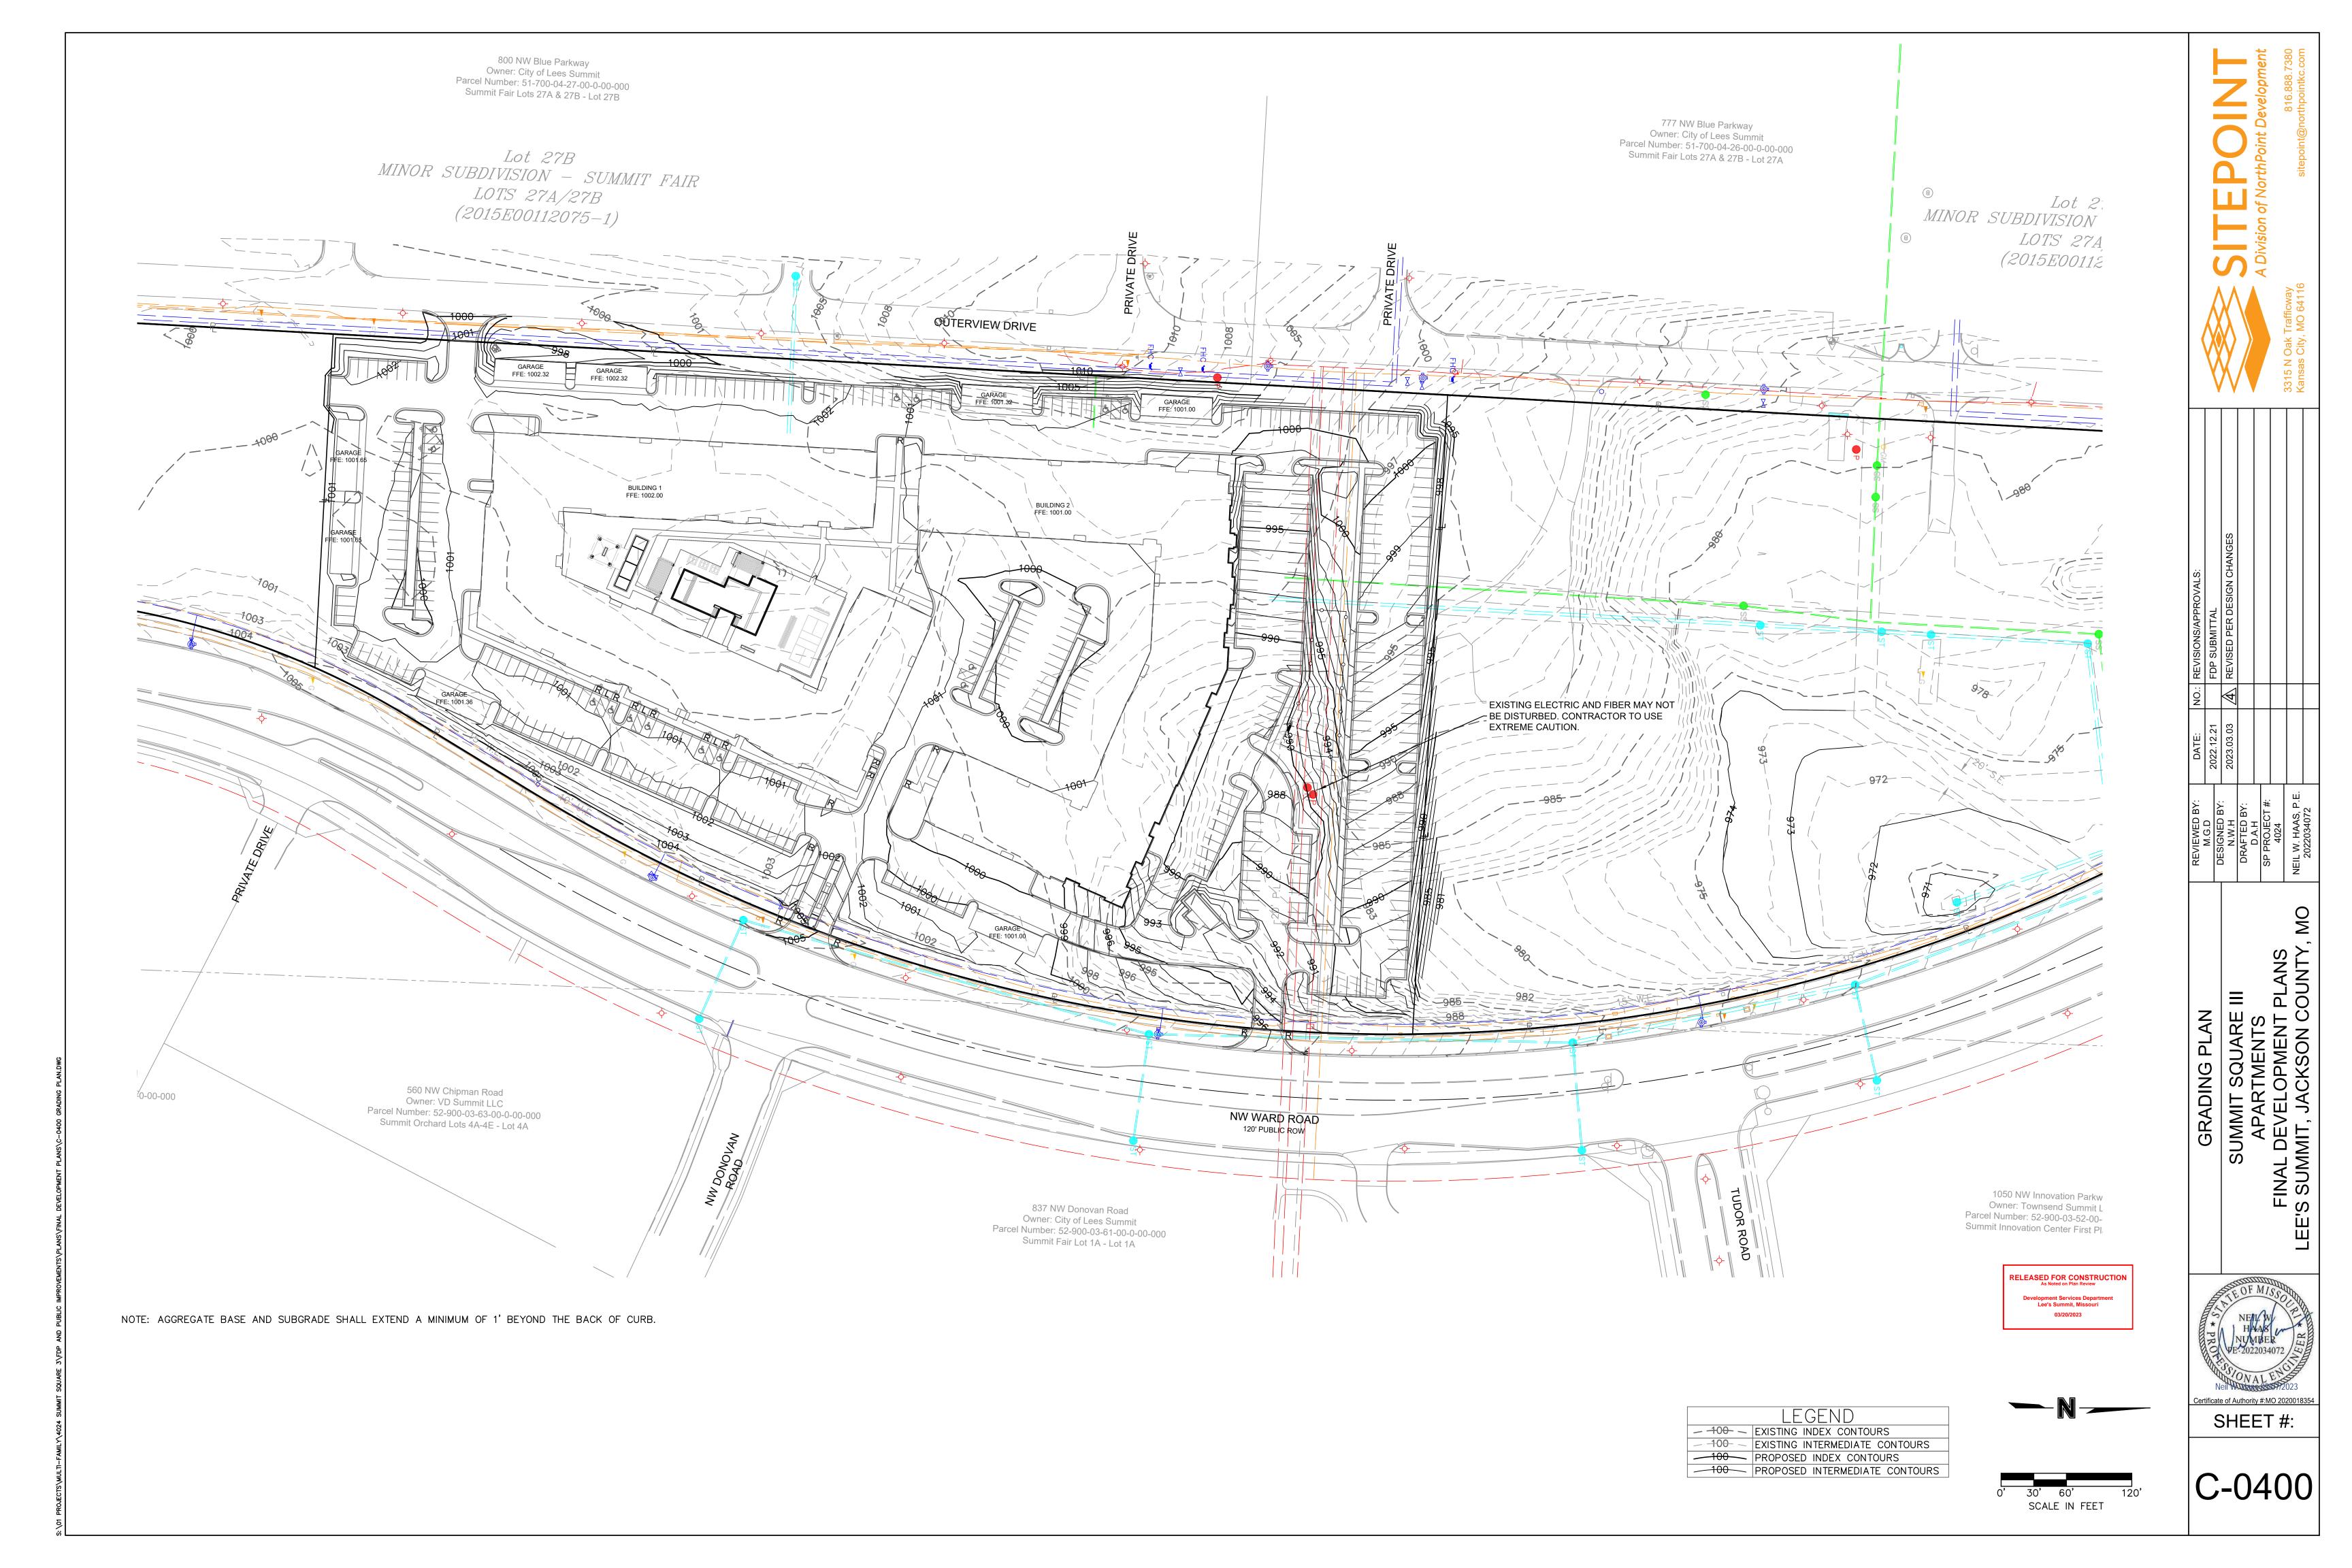

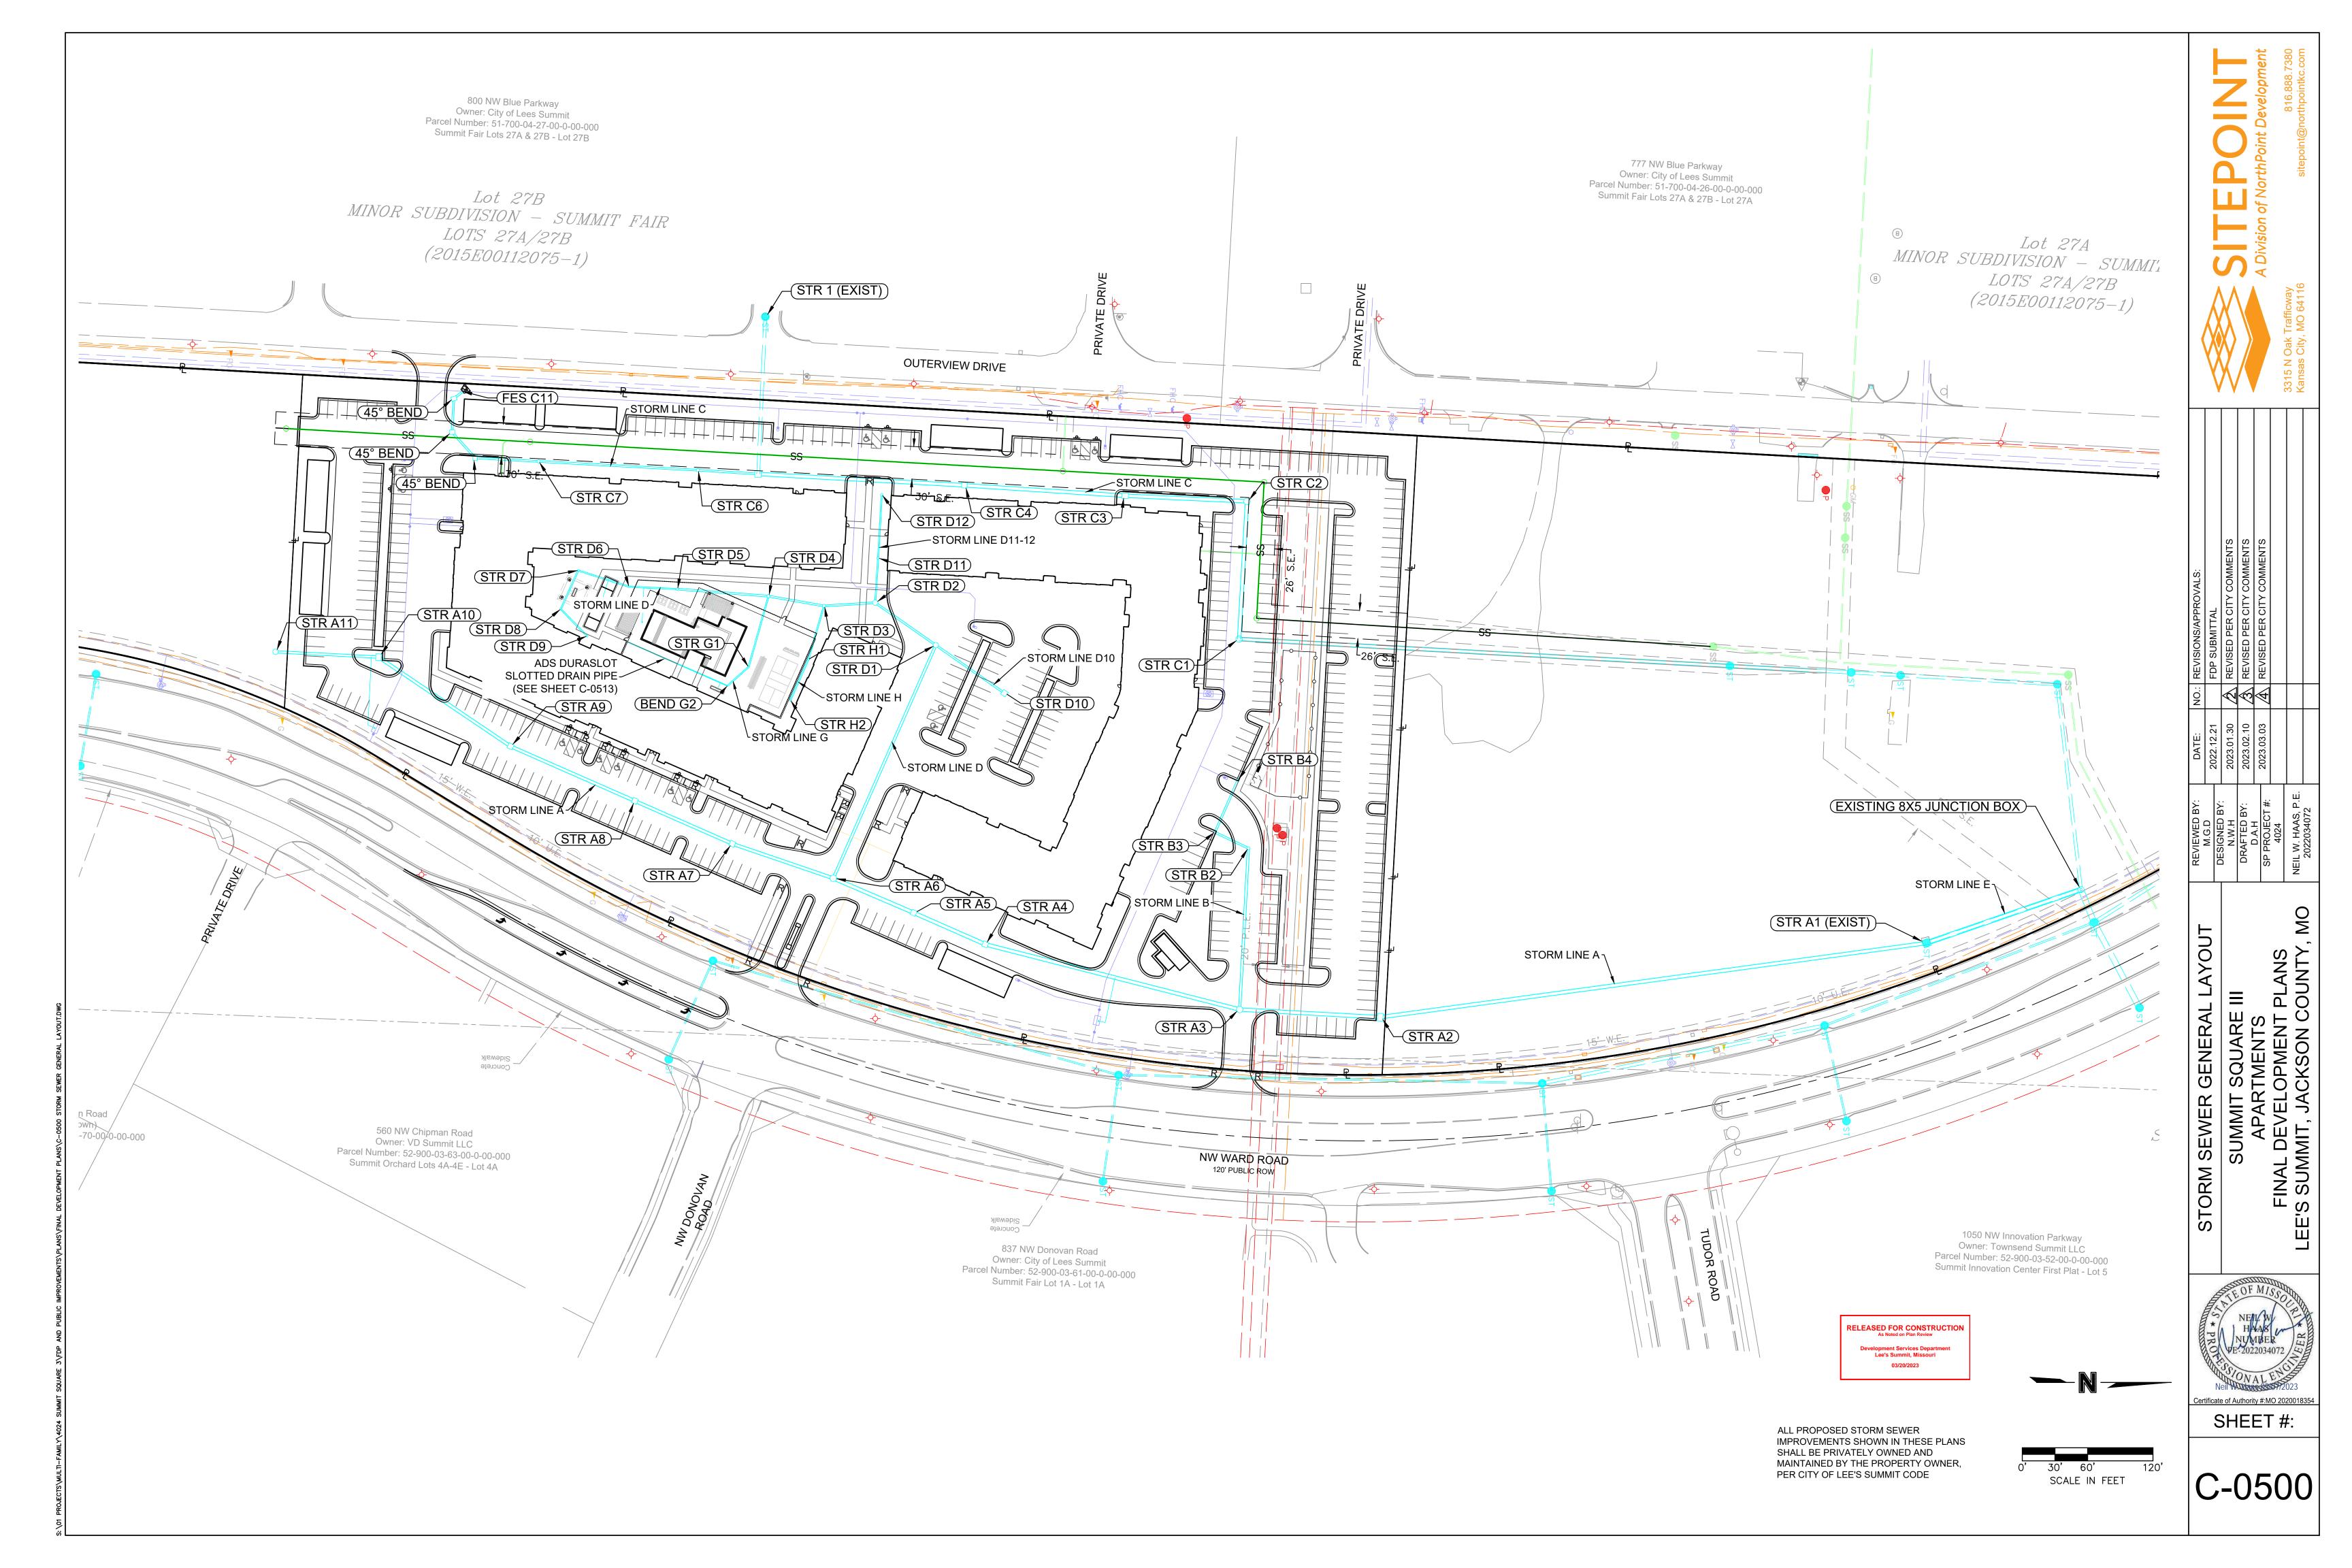


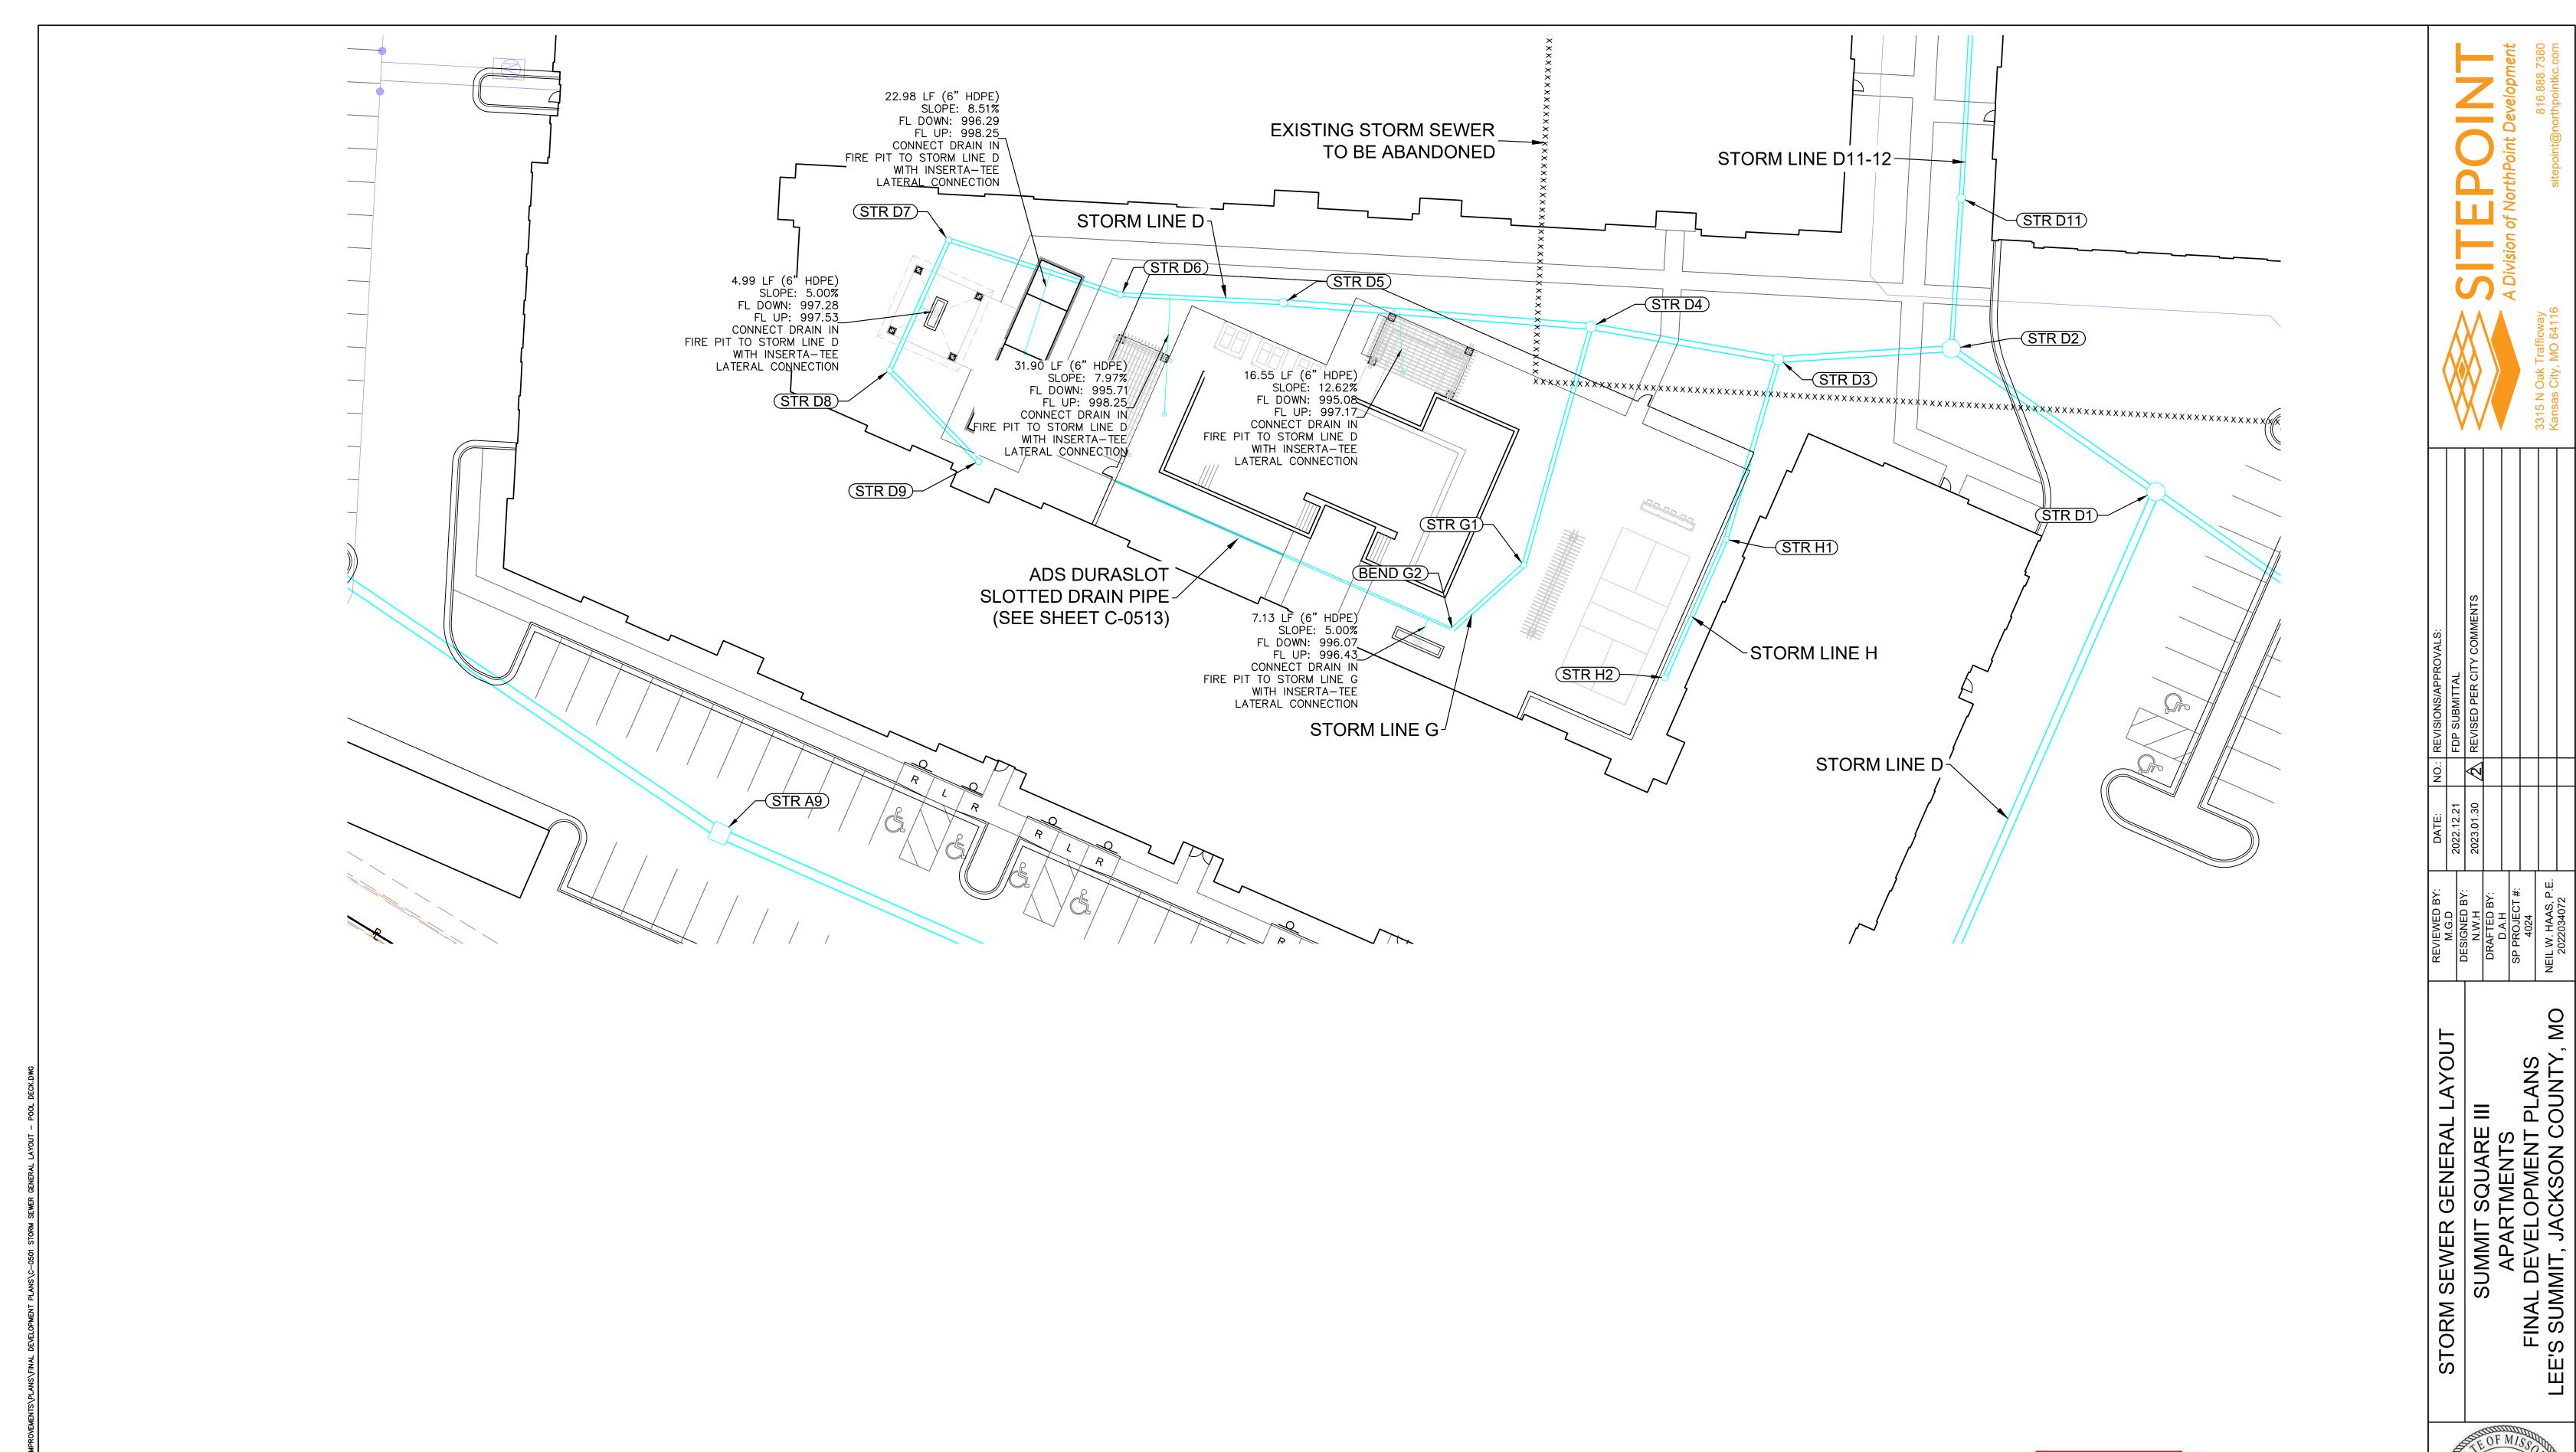


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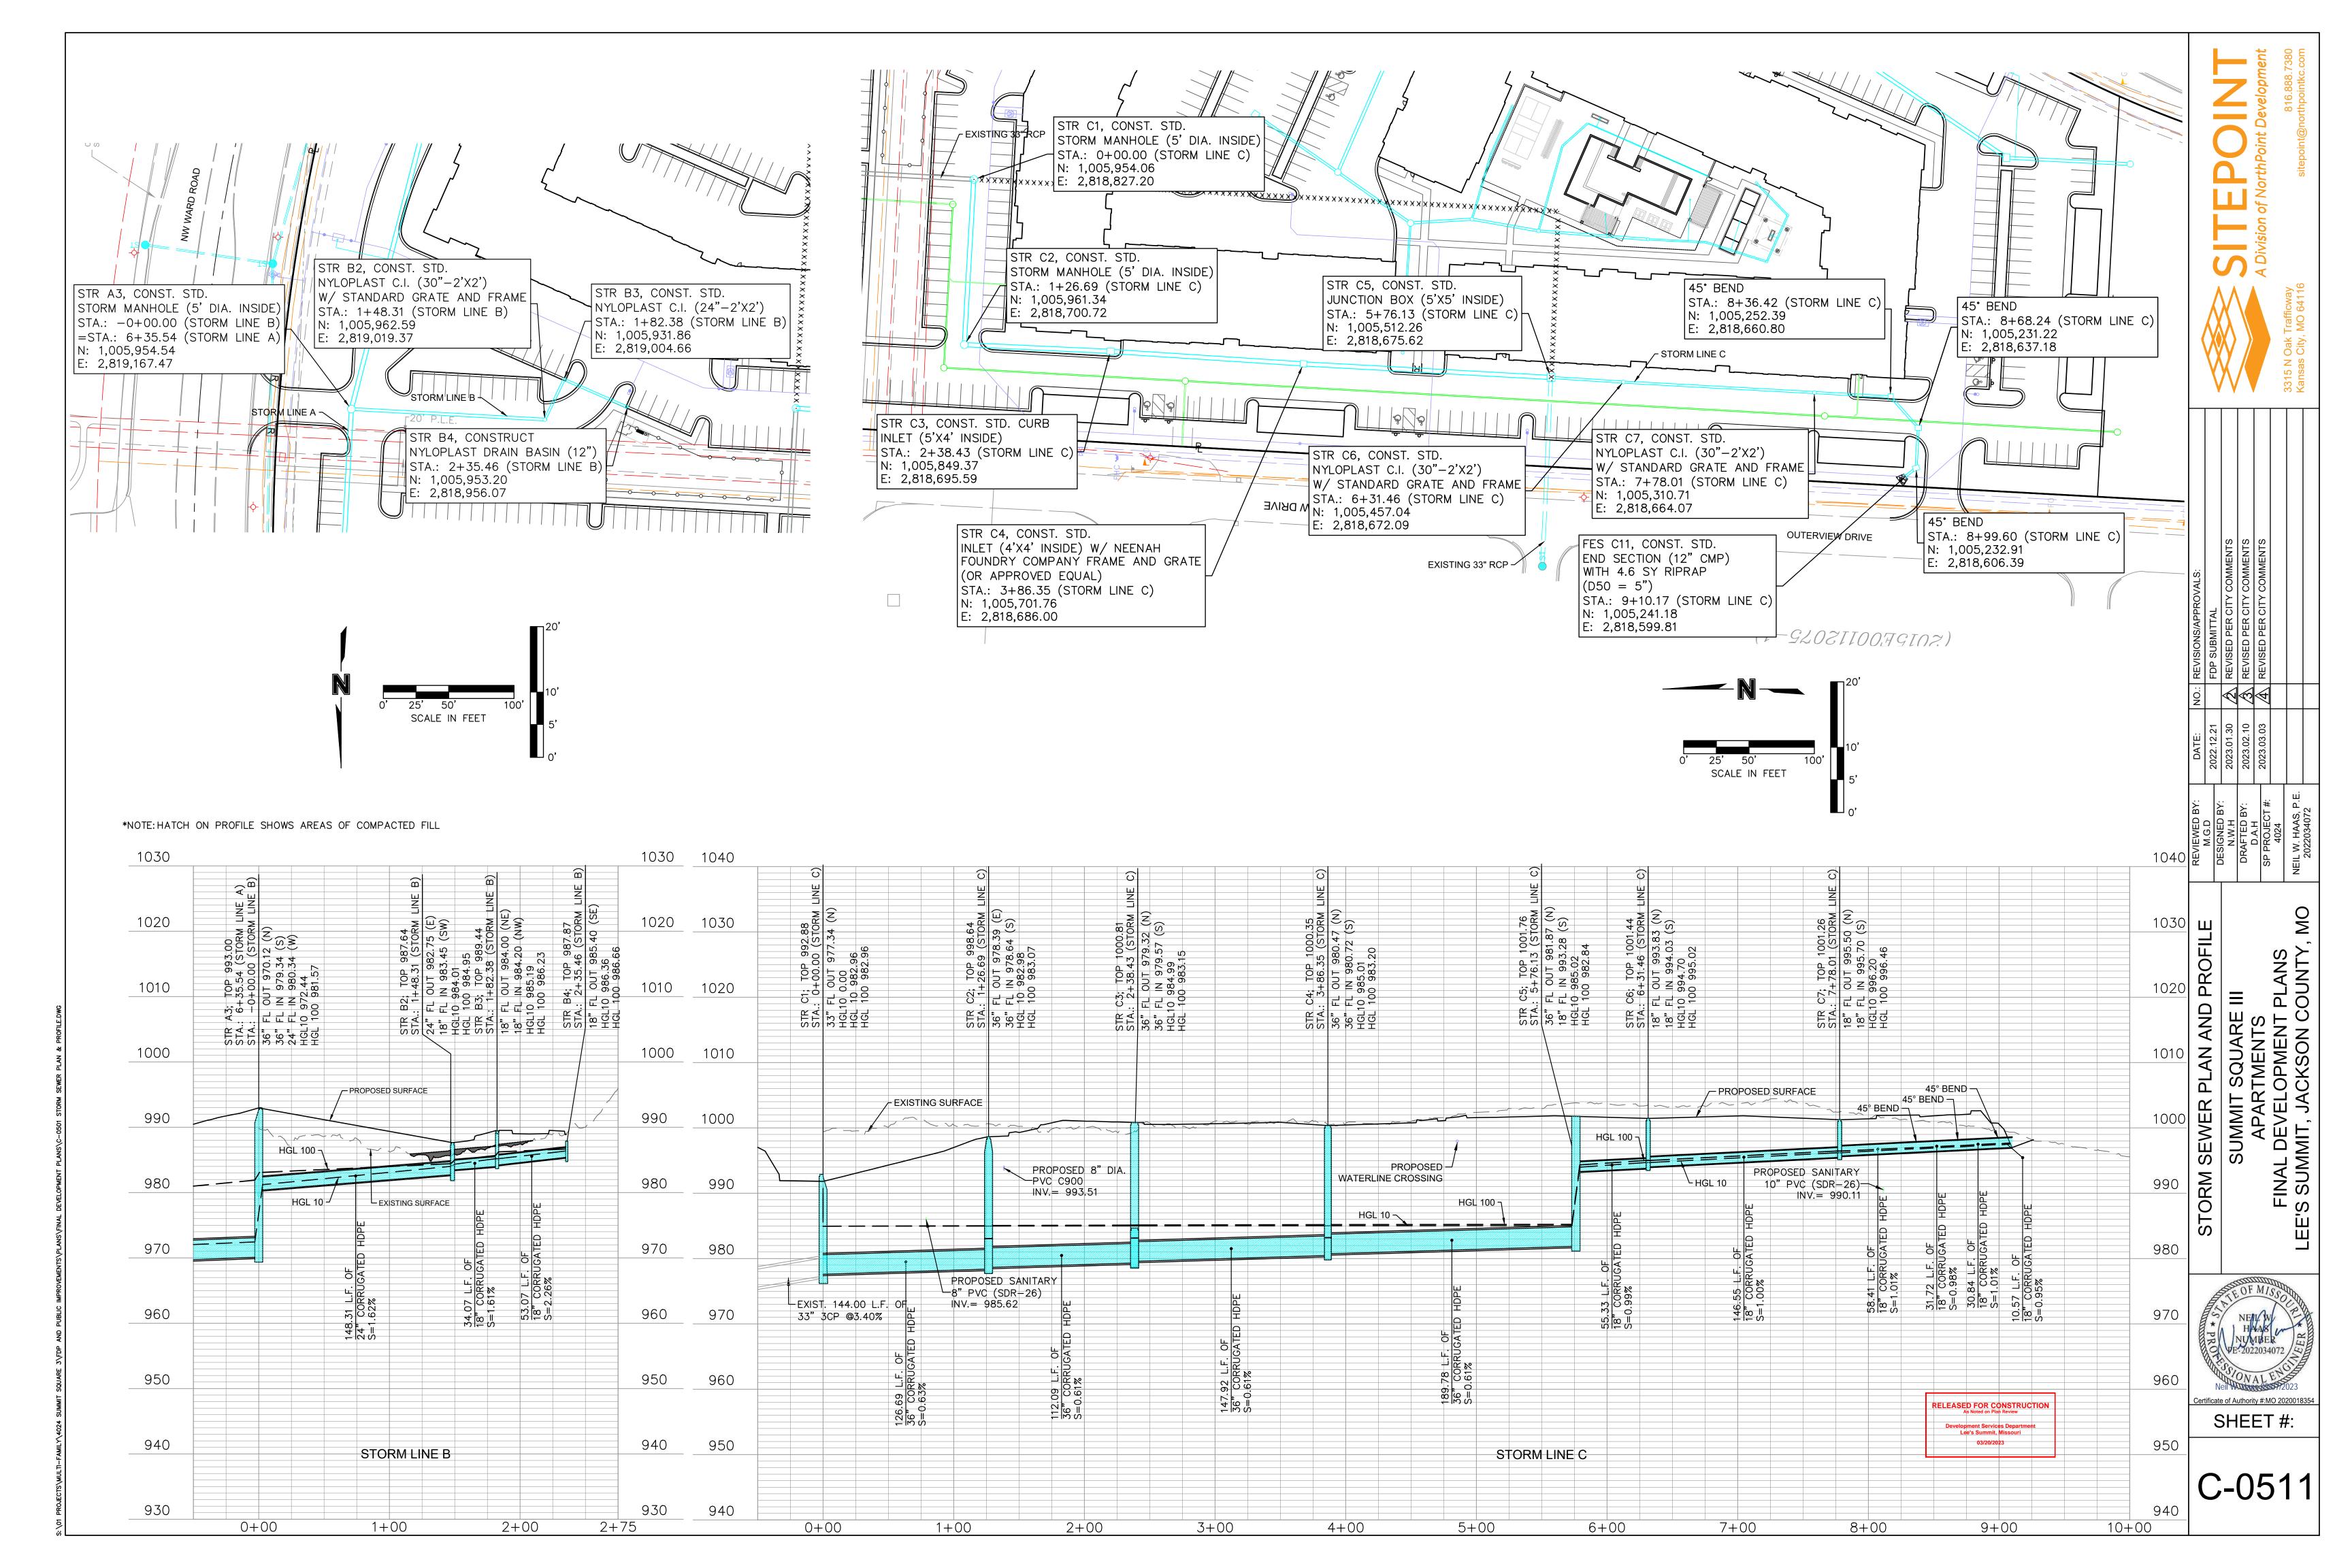
Development Services Department
Lee's Summit, Missouri
03/20/2023


ALL PROPOSED STORM SEWER
IMPROVEMENTS SHOWN IN THESE PLANS
SHALL BE PRIVATELY OWNED AND
MAINTAINED BY THE PROPERTY OWNER,
PER CITY OF LEE'S SUMMIT CODE




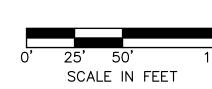




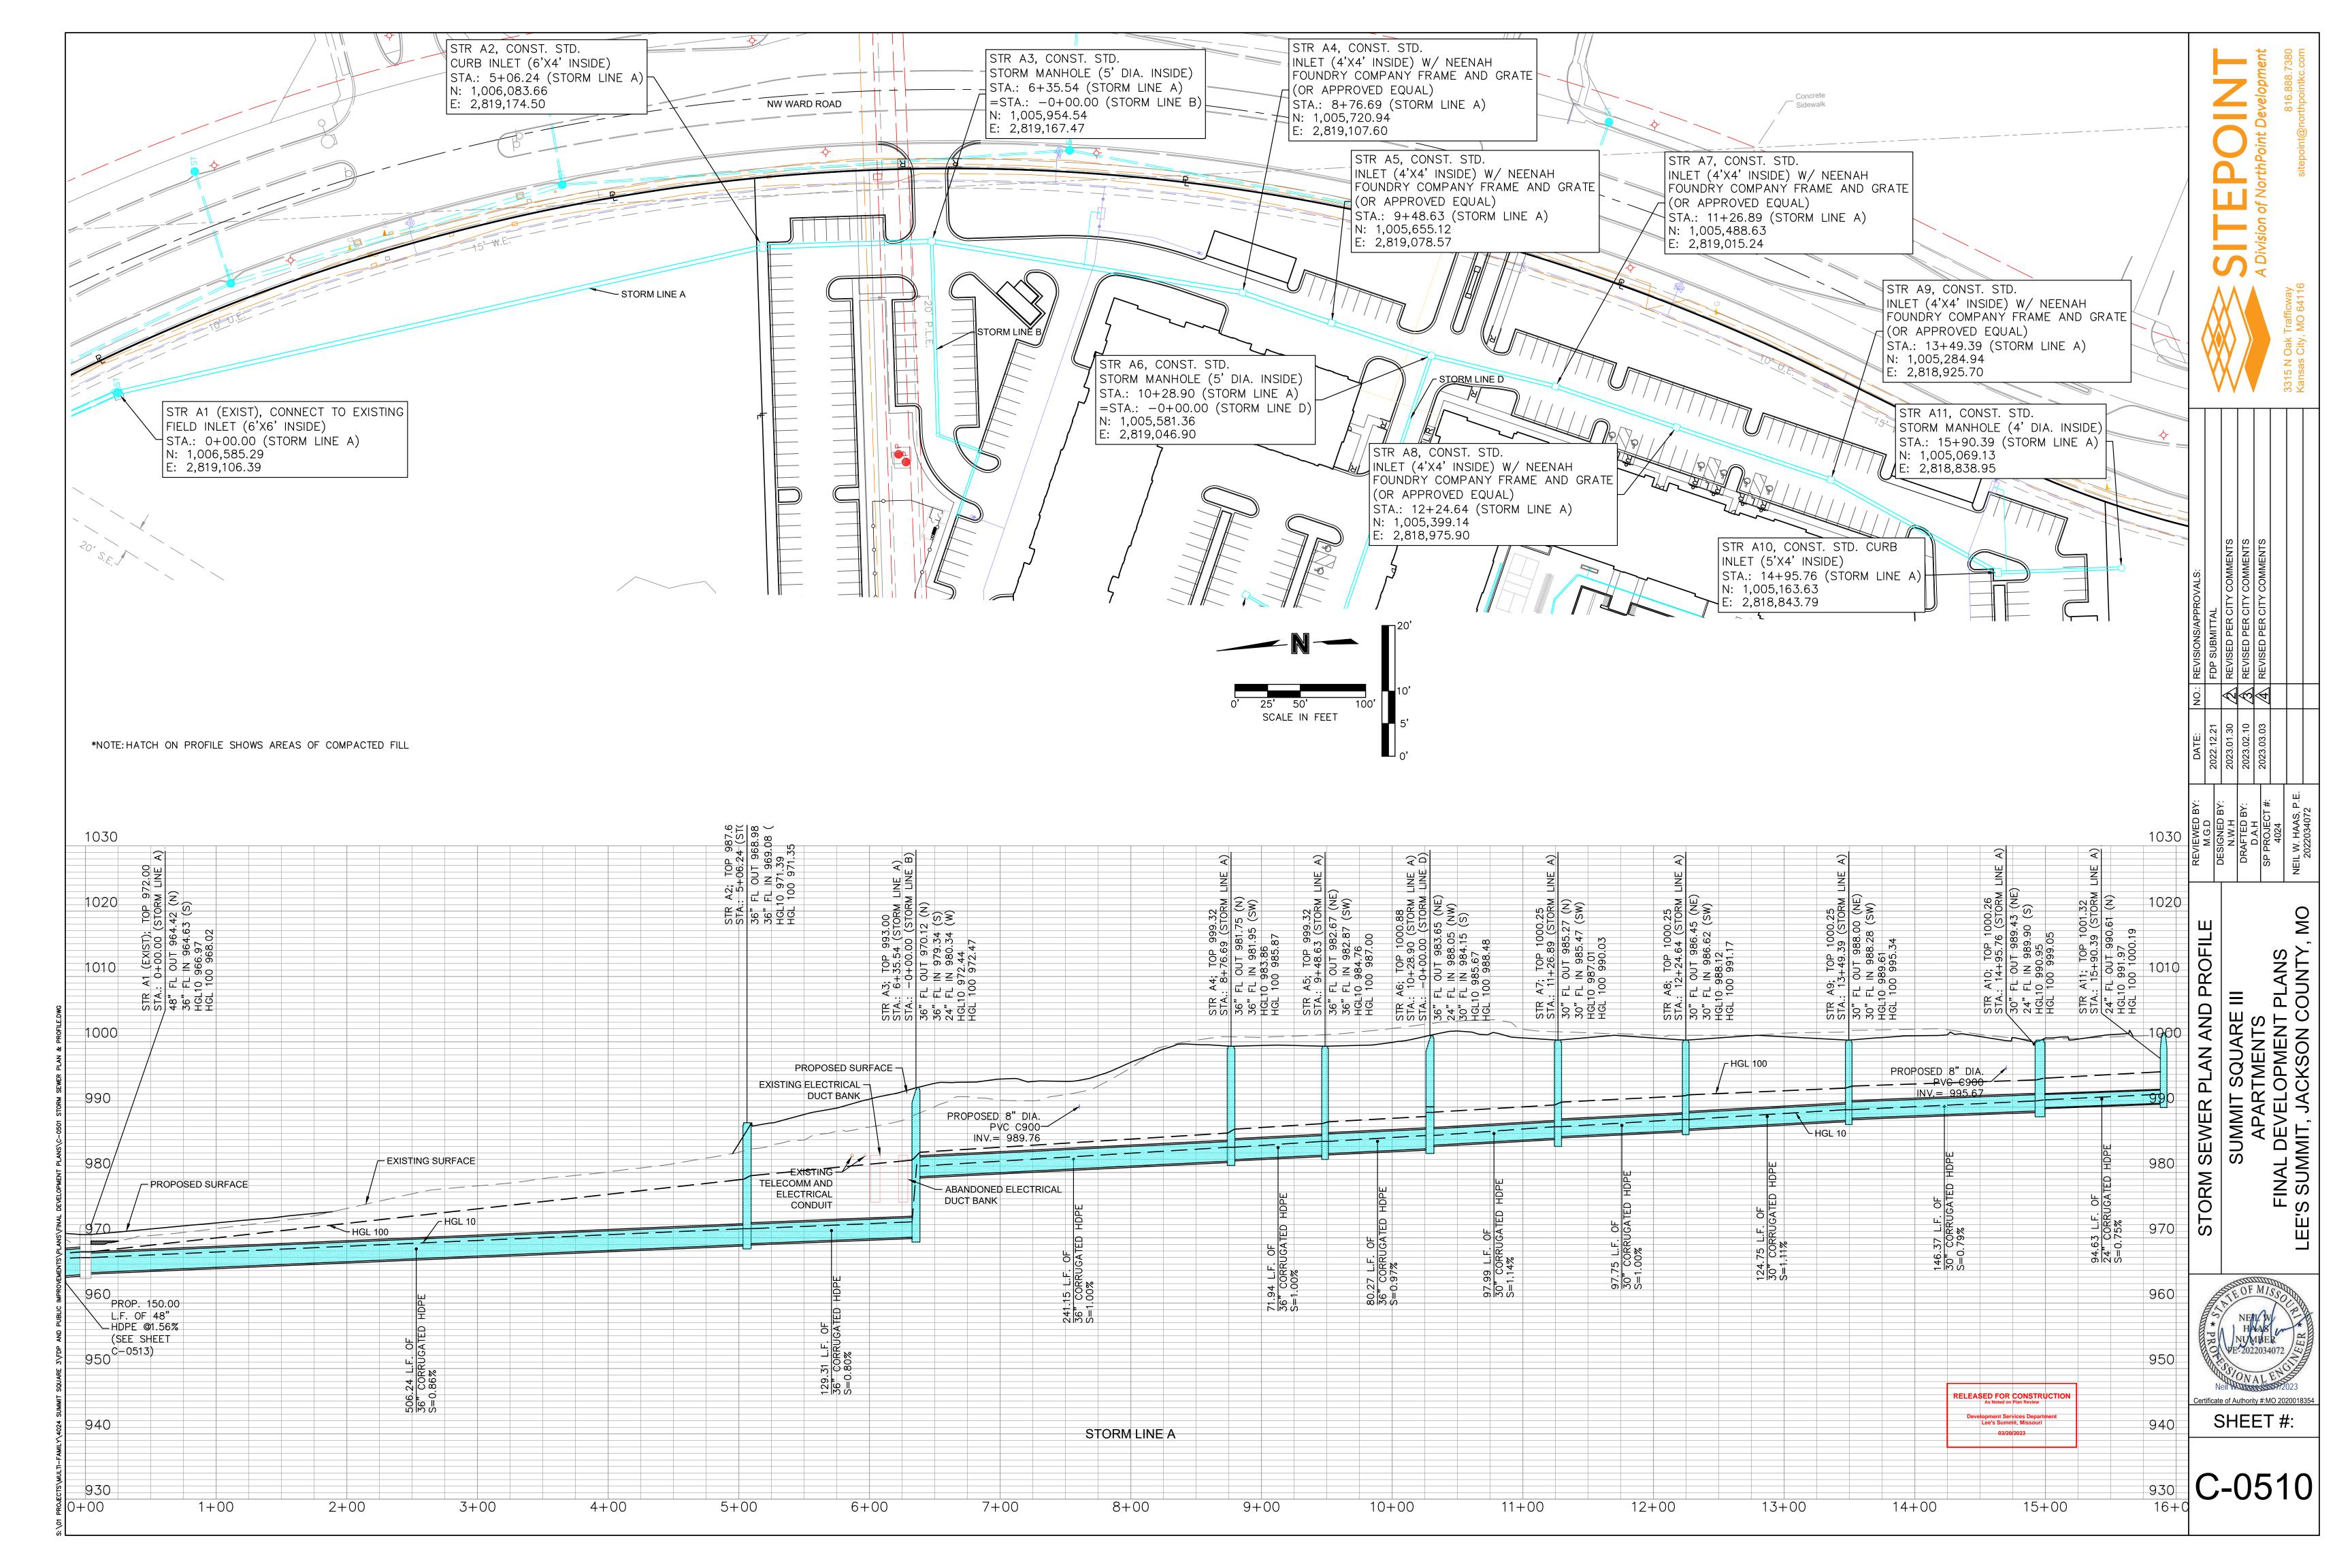

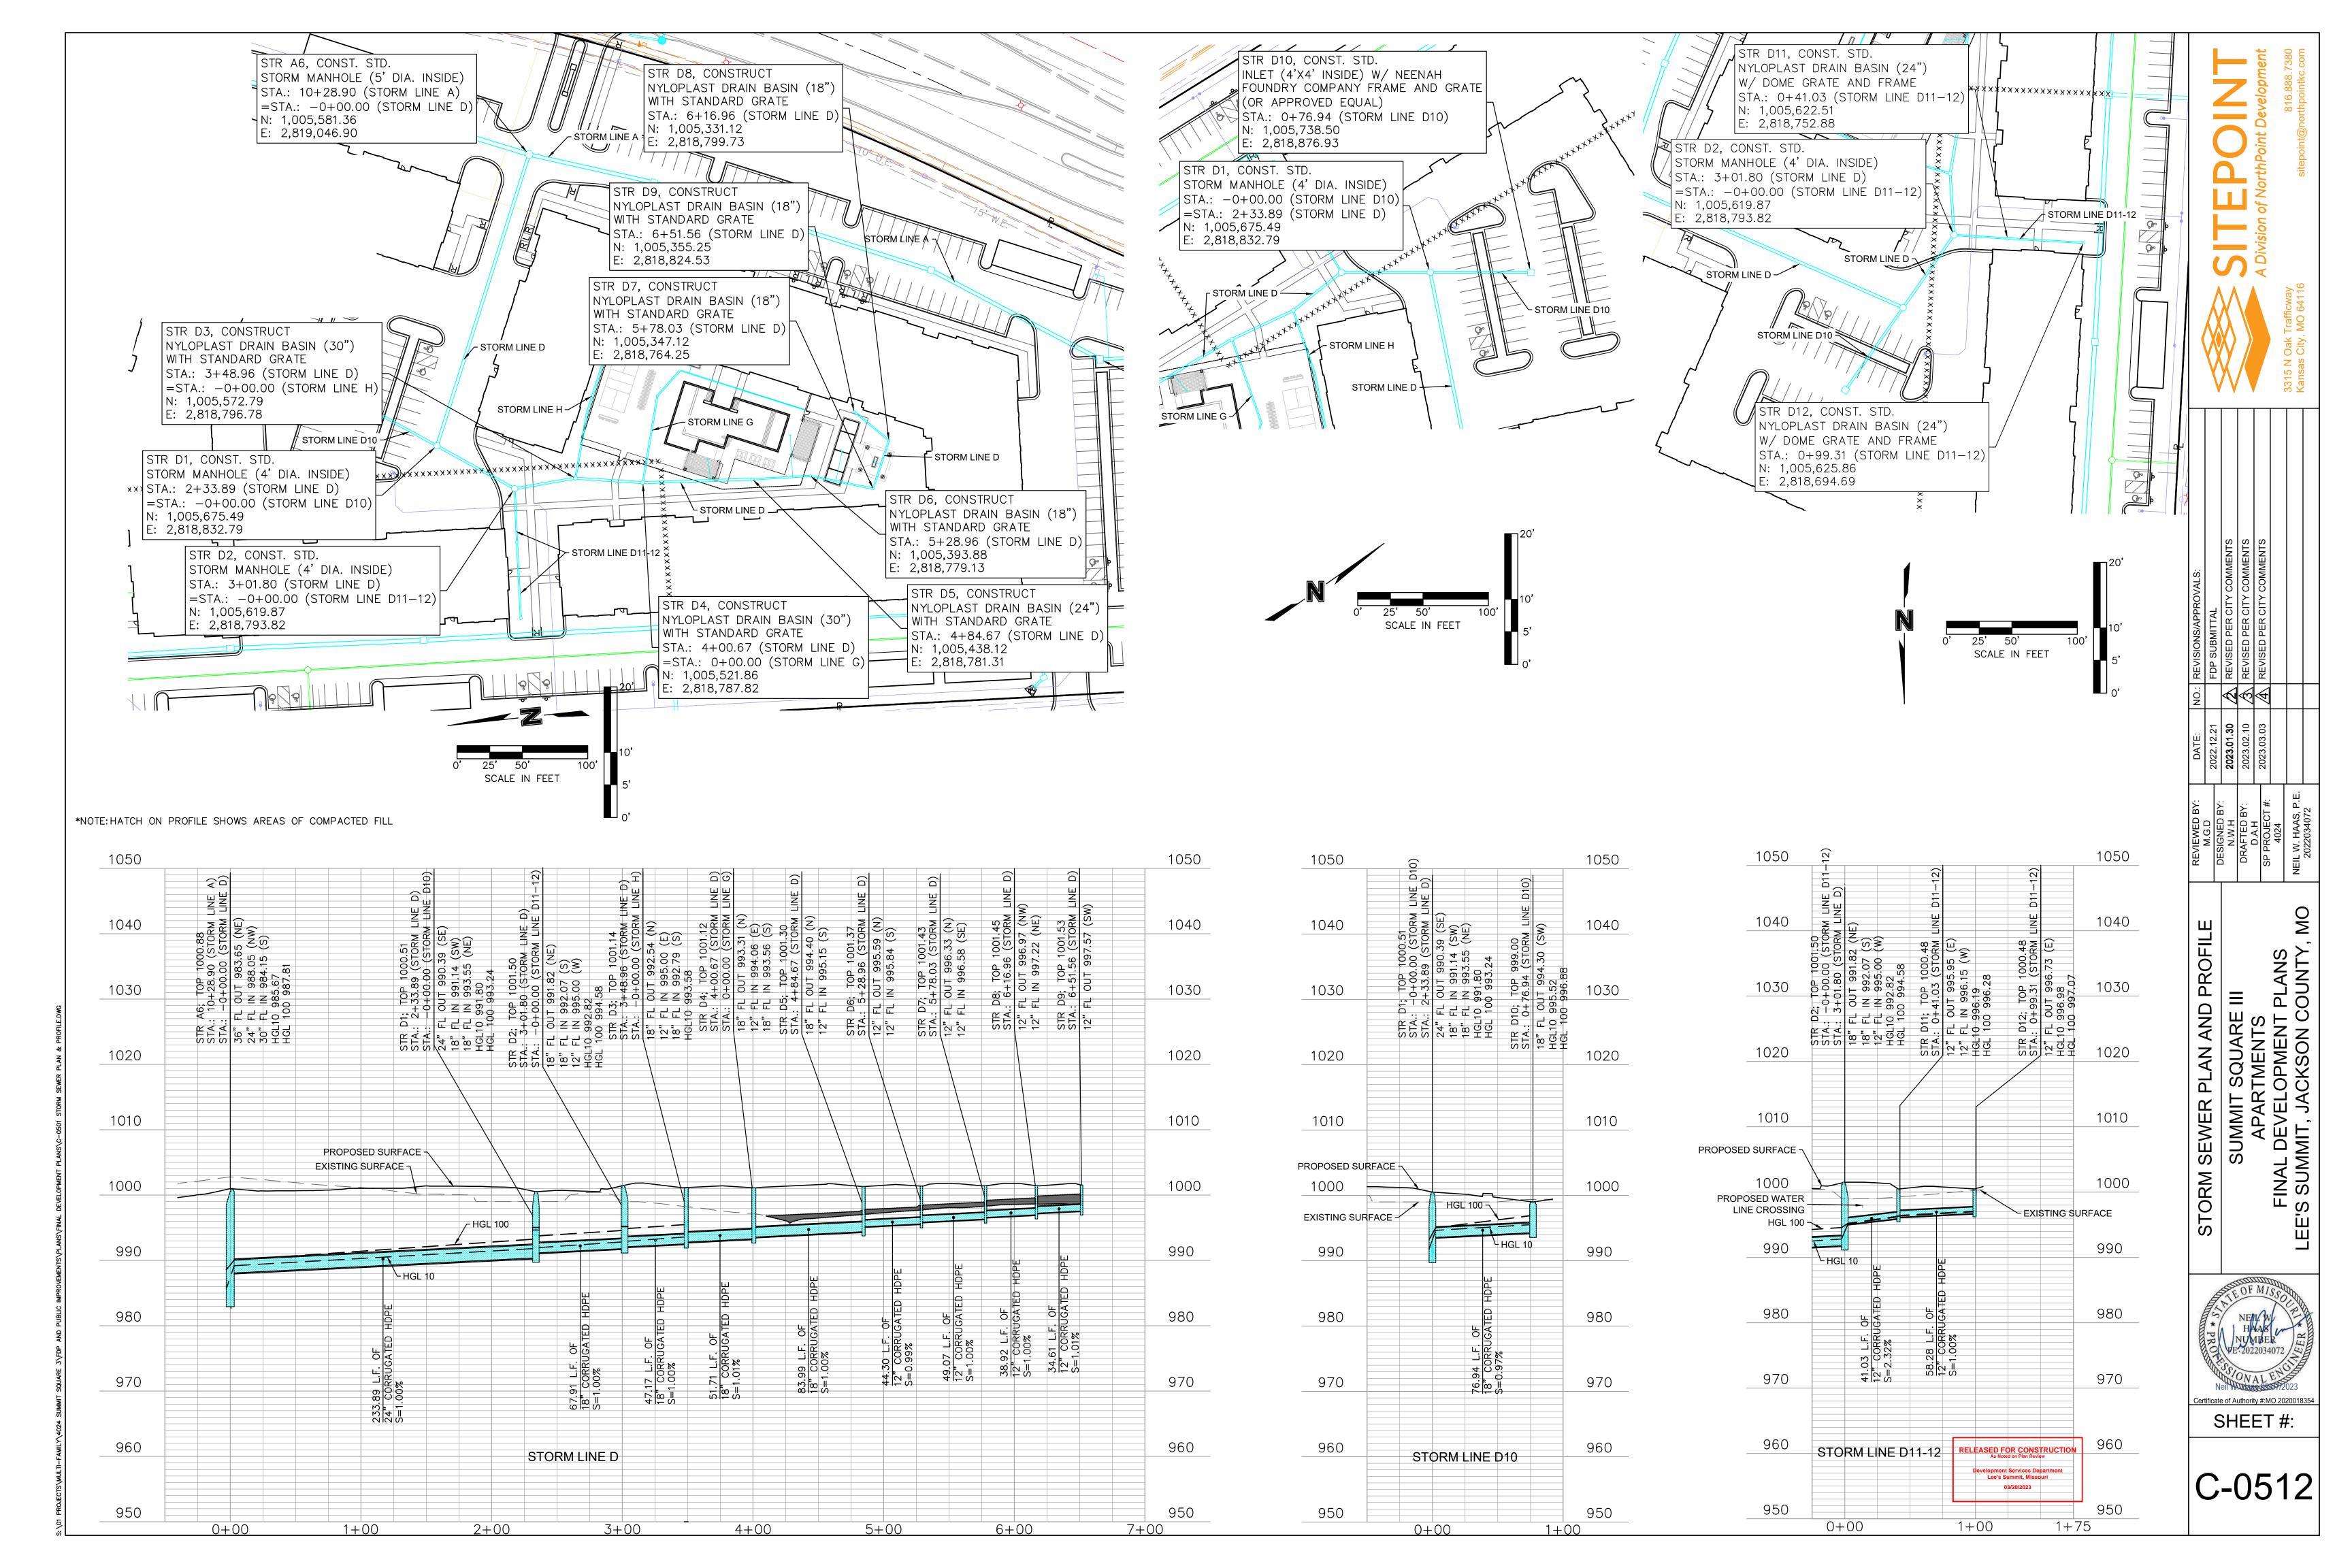

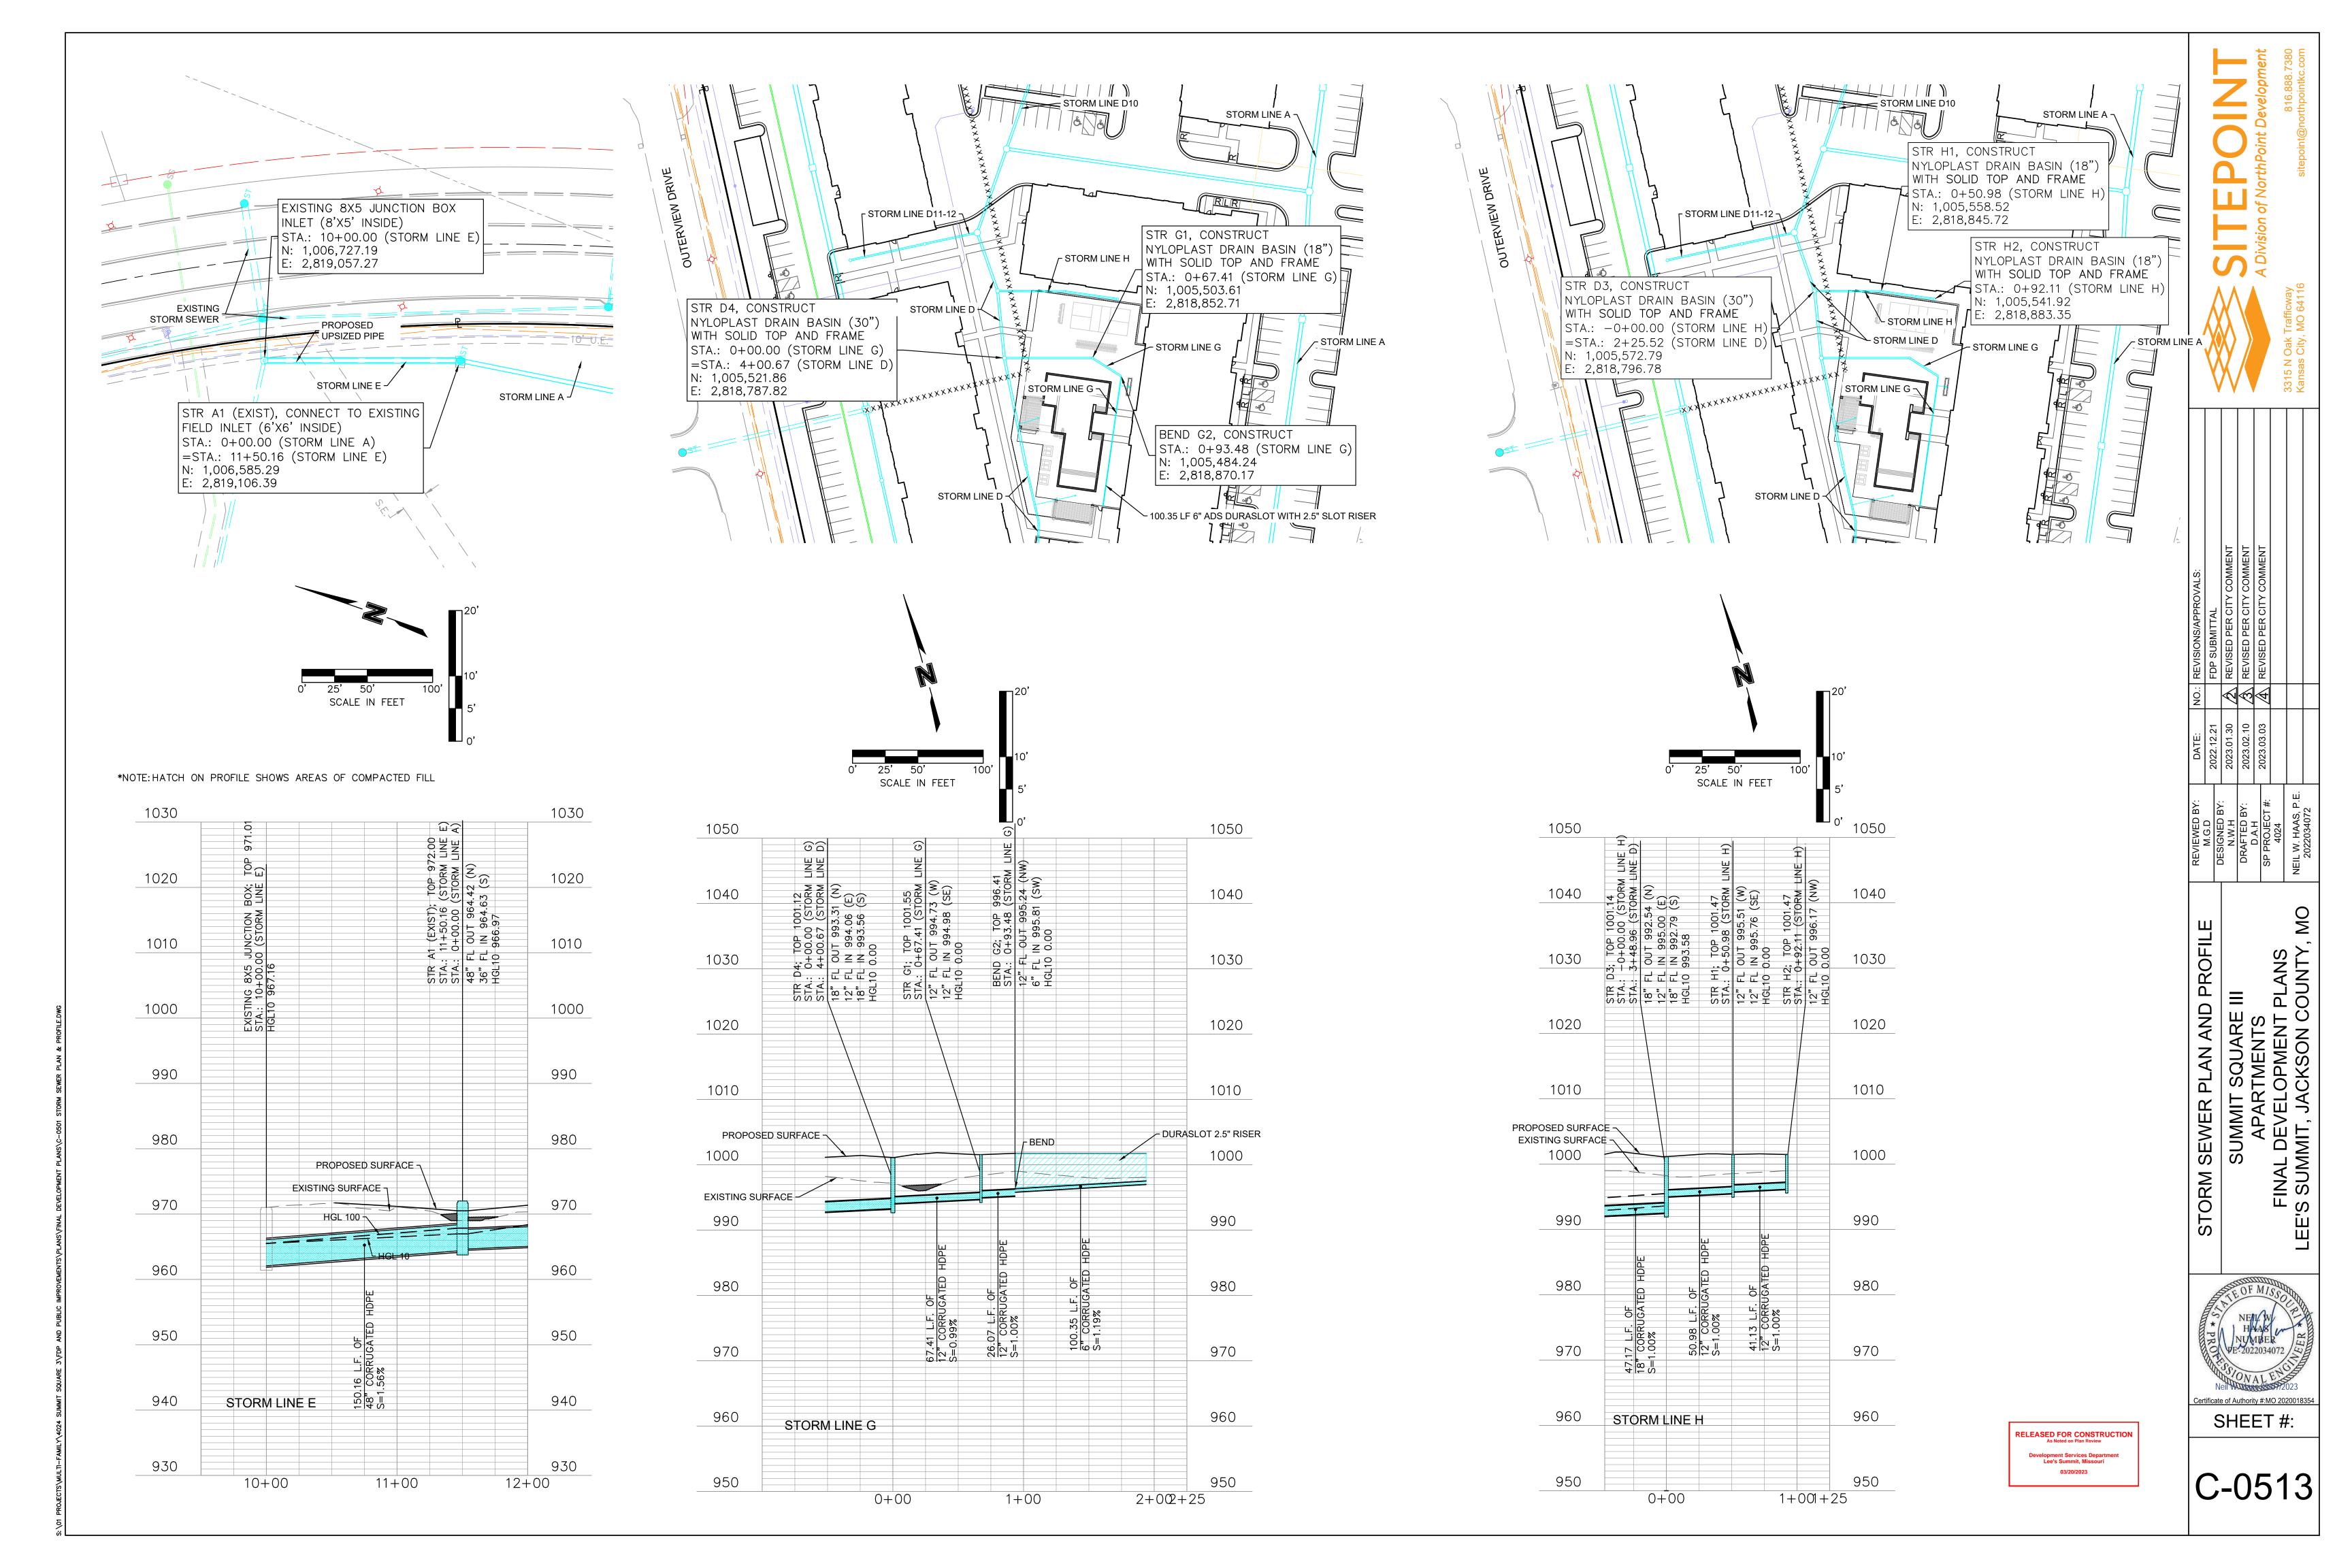

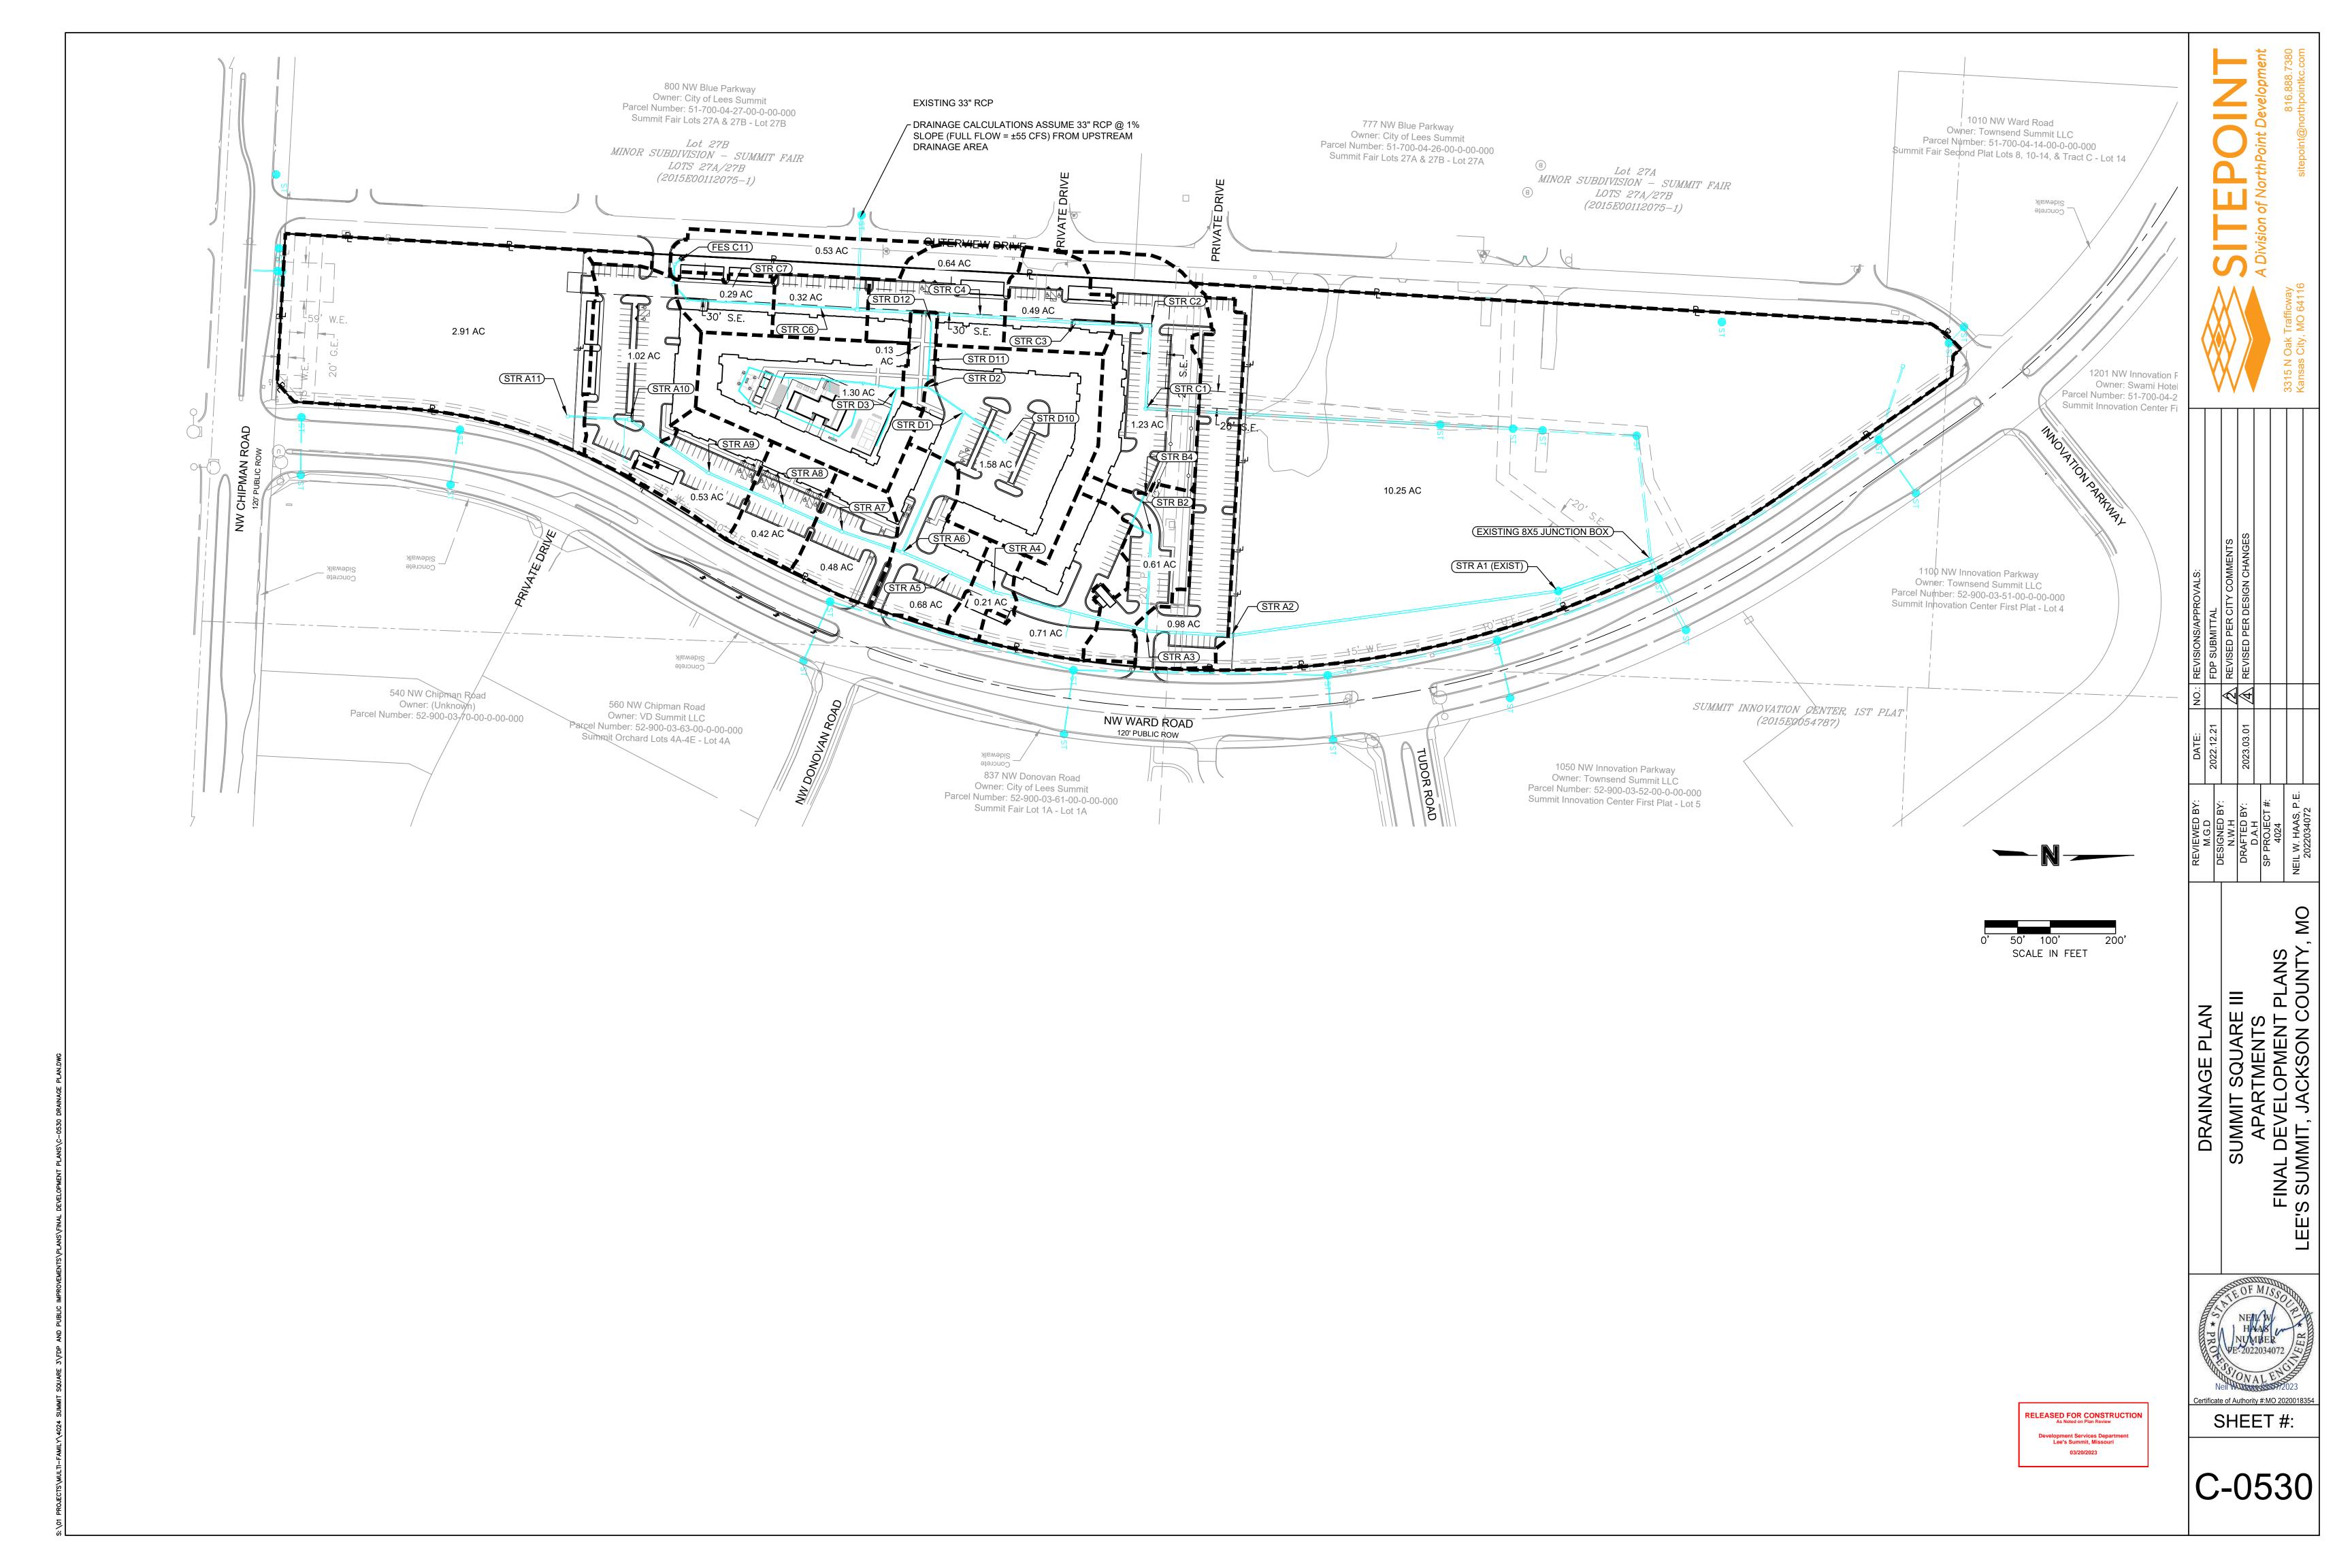


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Development Services Department
Lee's Summit, Missouri

03/20/2023


							PIPE DESIGN	TABLE (100-YEAR))							
Inlet ID	Pipe Length	Upstream Invert	Downstream Invert	Line Slope	Pipe Diameter	Manning's n	Pipe Capacity	Total Flow	Velocity	Junction Loss Coefficient	Upstream Rim Elevation	Upstream HGL	Drainage Area	C-Value	Time of Concentration	on i
	(ft)	(ft)	(ft)	(%)	(in)		(cfs)	(cfs)	(ft/s)		(ft)	(ft)	(ac)	(C)	(min)	(in/h
STR A1 (EXIST)	150.16	964.42	962.08	1.56	48.00	0.012	194.26	131.12	10.43	0.15	972.00	969.07	10.25	0.30	11	10.
STR A2	506.24	968.98	964.63	0.86	36.00	0.012	66.98	107.08	15.15	0.15	987.61	980.44	0.98	0.83	5	12
STR A3	129.31	970.12	969.08	0.80	36.00	0.012	64.80	98.28	13.90	0.40	993.00	983.37	0	0.00	0	0.
STR A4	241.15	981.75	979.34	1.00	36.00	0.012	72.23	79.70	11.28	0.30	999.32	987.51	0.21	0.73	5	12
STR A5	71.94	982.67	981.95	1.00	36.00	0.012	72.28	78.20	11.06	0.15	999.32	988.95	0.68	0.71	5	12
STR A6	80.27	983.65	982.87	0.97	36.00	0.012	71.23	72.86	10.31	0.40	1000.88	990.05	0	0.00	0	0.
STR D1	233.89	990.39	988.05	1.00	24.00	0.012	24.51	28.63	9.11	0.40	1000.51	993.91	0	0.00	0	0.
STR D2	67.91	991.82	991.14	1.00	18.00	0.012	11.38	12.47	7.05	0.40	1001.50	995.24	0	0.00	0	0.
STR D3	47.17	992.54	992.07	1.00	18.00	0.012	11.36	12.74	7.21	0.40	1001.15	996.14	1.3	0.76	5	12
STR D11	41.03	995.95	995.00	2.32	12.00	0.012	5.87	0.63	2.78	0.15	1000.48	996.28 j	0	0.00	5	0.
STR D12	58.28	996.73	996.15	1.00	12.00	0.012	3.85	0.65	2.82	0.15	1000.48	997.07	0.13	0.39	5	12
STR D10	76.94	994.30	993.55	0.97	18.00	0.012	11.23	17.52	9.92	0.15	999.00	996.88	1.58	0.86	5	12
STR A7	97.99	985.27	984.15	1.14	30.00	0.012	47.50	47.13	9.60	0.30	1000.25	991.82	0.48	0.66	5	12
STR A8	97.75	986.45	985.47	1.00	30.00	0.012	44.49	43.49	8.86	0.15	1000.25	993.18	0.42	0.69	5	12
STR A9	124.75	988.00	986.62	1.11	30.00	0.012	46.73	40.25	8.20	0.30	1000.25	994.39	0.53	0.75	5	12
STR A10	146.37	989.43	988.28	0.79	30.00	0.012	39.38	35.67	7.27	0.30	1000.26	995.65	1.02	0.82	5	12
STR A11	94.63	990.61	989.90	0.75	24.00	0.012	21.22	25.14	8.00	0.15	1001.32	996.89	2.91	0.67	5	12
STR B2	148.31	982.75	980.34	1.62	24.00	0.012	31.23	21.68	6.90	0.40	987.64	985.74	0.61	0.65	5	12
STR B3	34.07	984.00	983.45	1.61	18.00	0.012	14.45	16.65	9.42	0.40	989.44	986.77	0.71	0.65	5	12
STR B4	53.07	985.40	984.20	2.26	18.00	0.012	17.11	10.79	6.10	0.15	987.87	987.79	1.23	0.68	5	12
STR C2	126.69	978.39	977.59	0.63	36.00	0.012	57.41	17.01	2.41	0.40	998.64	985.02	0	0.00	0	0.
STR C3	112.09	979.32	978.64	0.61	36.00	0.012	56.28	17.38	2.46	0.15	1000.81	985.12	0.49	0.73	5	12
STR C4	147.92	980.47	979.57	0.61	36.00	0.012	56.36	14.05	1.99	0.15	1000.35	985.19	0.64	0.74	5	12
STR C5	189.78	981.87	980.72	0.61	36.00	0.012	56.24	9.49	1.34	0.15	1001.76	985.23	0	0.00	0	0.
STR C6	55.33	993.83	993.28	0.99	18.00	0.012	11.34	9.54	6.34	0.15	1001.44	995.02	0.32	0.90	5	12
STR C7	146.55	995.50	994.03	1.00	18.00	0.012	11.39	6.22	5.19	0.15	1001.26	996.46 j	0.29	0.86	5	12
STR C8	58.41	996.29	995.70	1.01	18.00	0.012	11.43	3.20	4.10	0.75	1001.96	996.97 j	0	0.00	0	0
STR C9	31.72	996.60	996.29	0.98	18.00	0.012	11.25	3.24	4.12	0.75	1002.00	997.28	0	0.00	0	0
STR C10	30.84	996.91	996.60	1.01	18.00	0.012	11.41	3.27	4.13	0.79	1000.72	997.60	0	0.00	0	C
FES C11	10.57	997.01	996.91	0.95	18.00	0.012	11.07	3.28	4.14	0.15	998.64	997.70	0.53	0.48	5	12

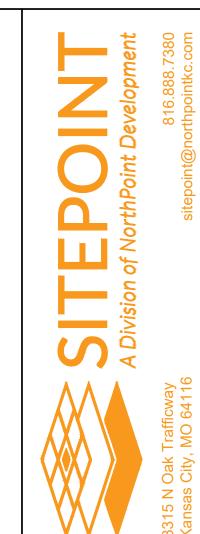

NO.: REVISIONS/APPROVALS:	FDP SUBMITTAL		REVISED PER CITY COMMENTS	REVISED PER CITY COMMENT					
NO.:			$\langle \overline{V} $	\blacksquare					
DATE:	2022 12 21	-255.	2023.01.30	2023.03.03					
REVIEWED BY:	M.G.D	DESIGNED BY:	N.W.H	DRAFTED BY:	D.A.D	SP PROJECT #:	4024	NEIL W. HAAS, P.E.	2022034072

SUMMIT SQUARE III
APARTMENTS
FINAL DEVELOPMENT PLA



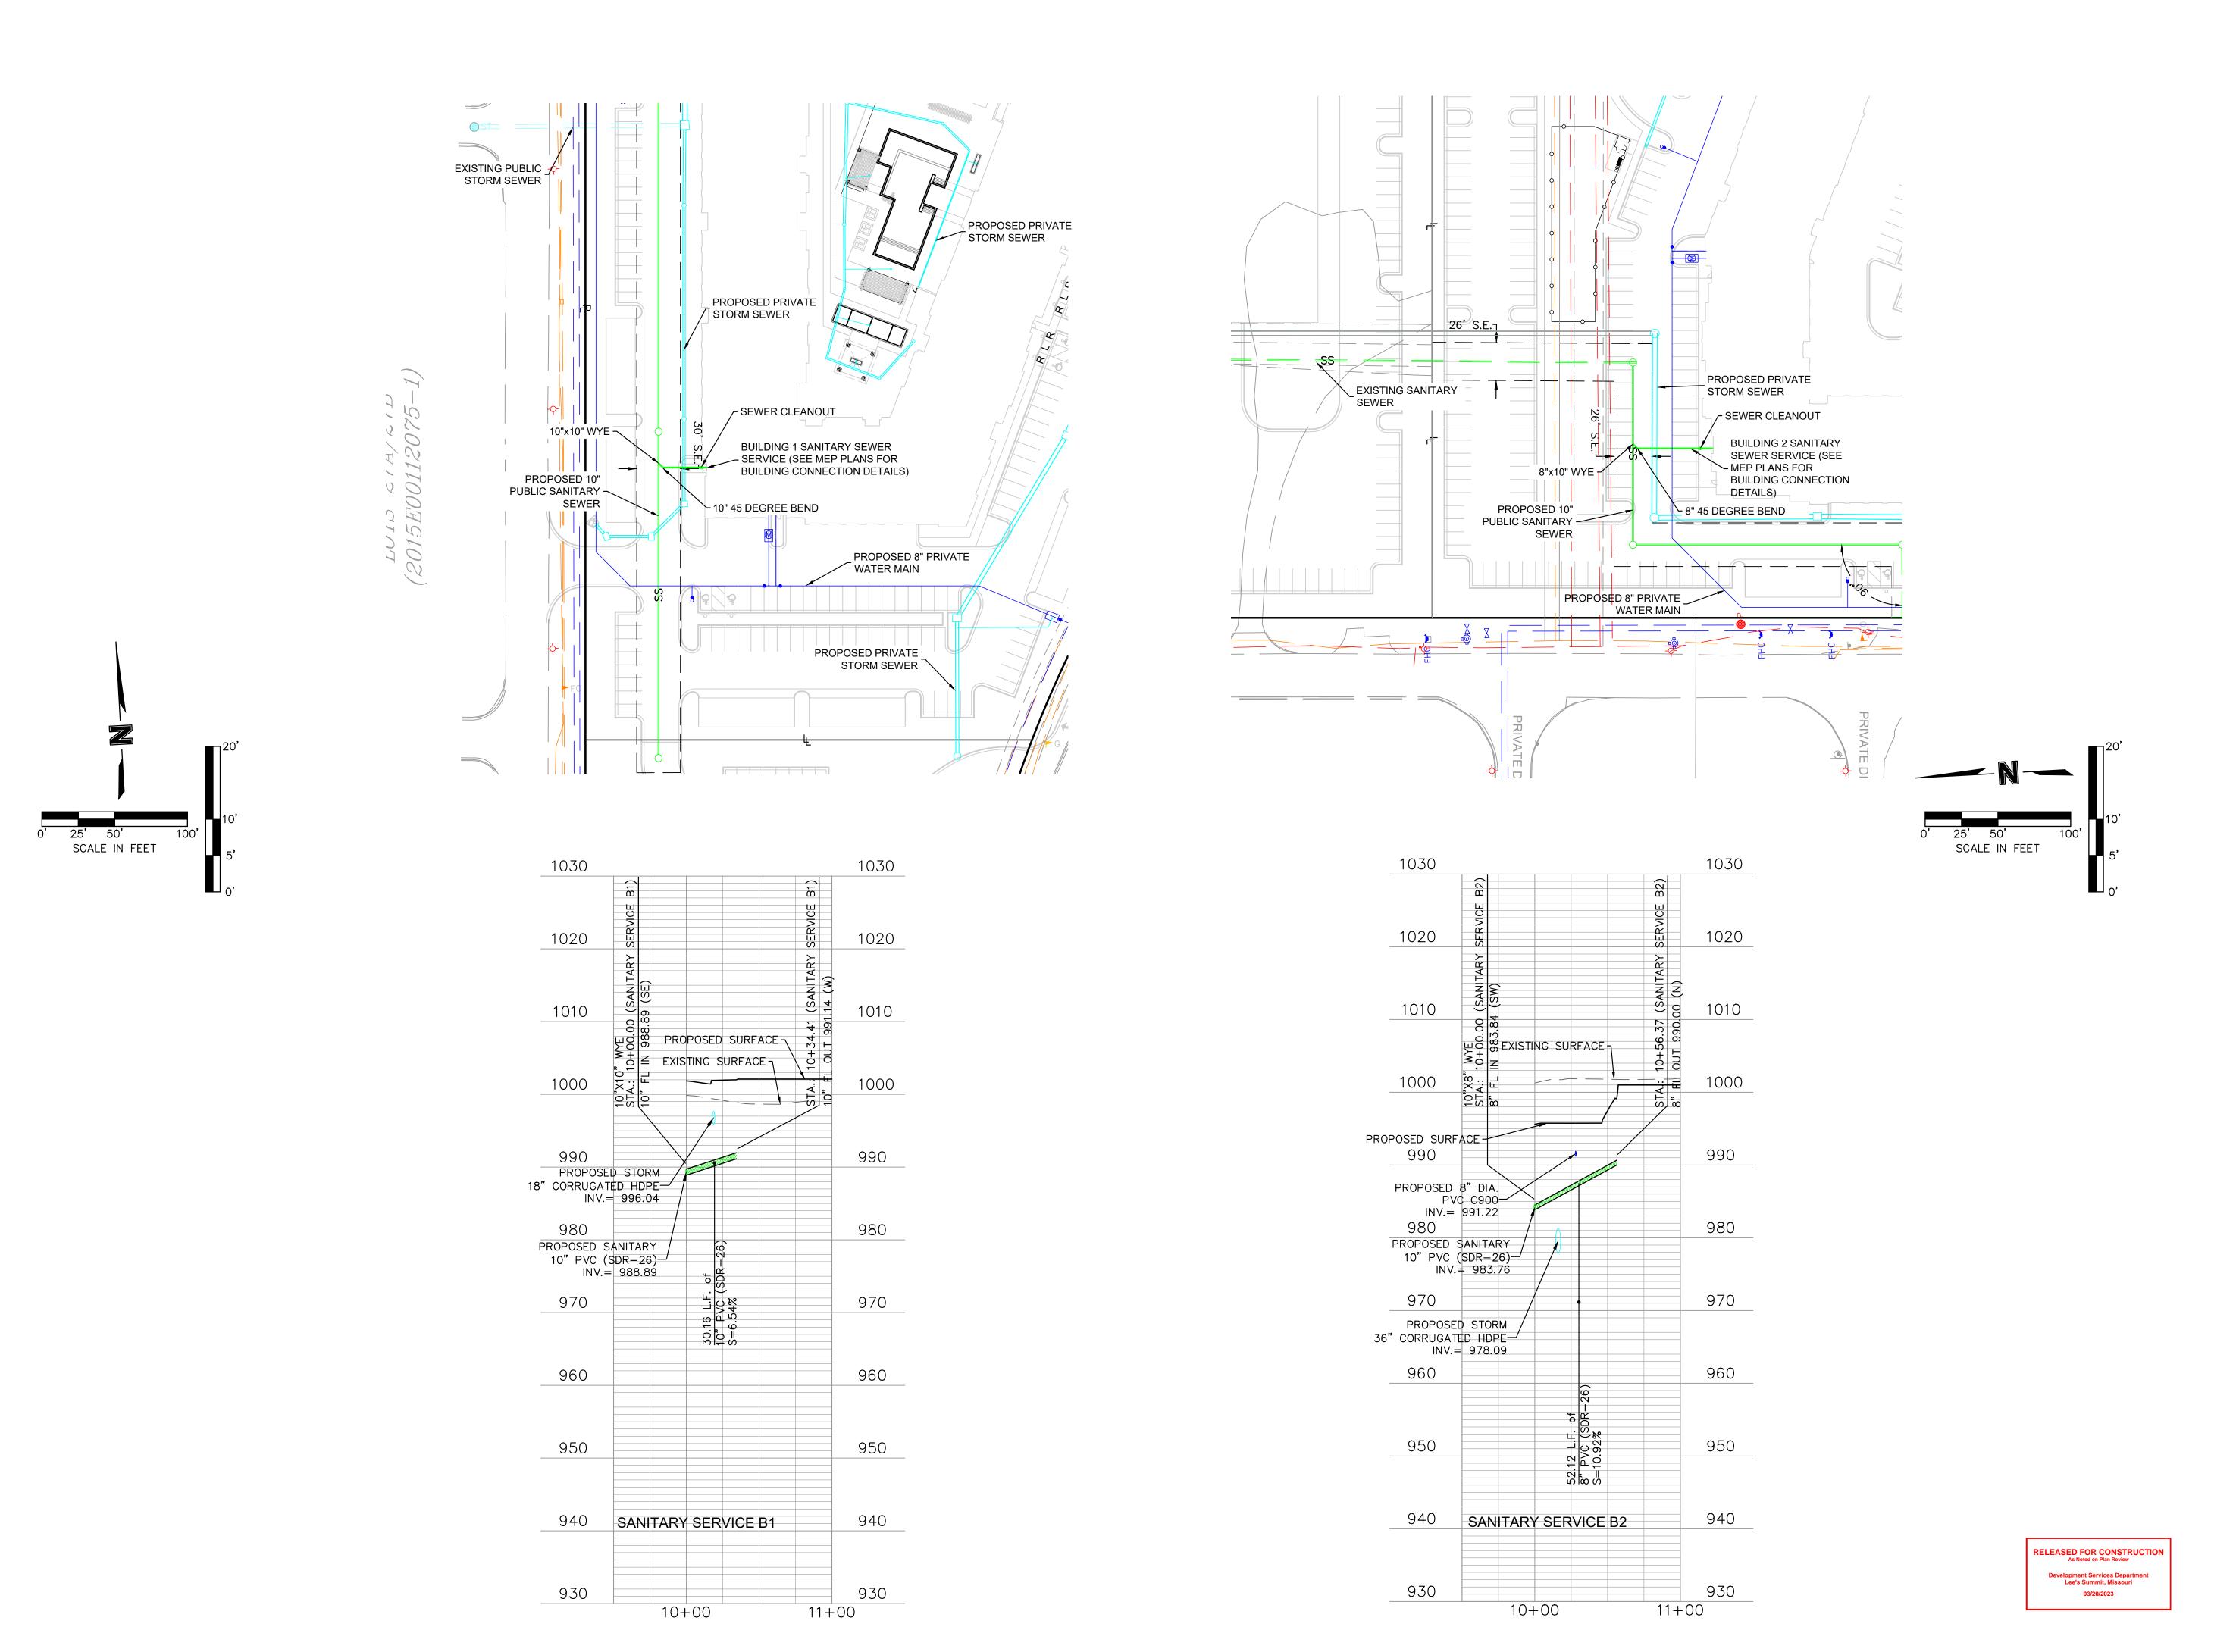

SITEPOINT Development
A Division of NorthPoint Development
816.888.7380
sitepoint@northpointkc.com

3315 N Oak Trafficw


SANITARY SEWER PLAN & PROFILE
SUMMIT SQUARE III
APARTMENTS
FINAL DEVELOPMENT PLANS
LEE'S SUMMIT, JACKSON COUNTY, M


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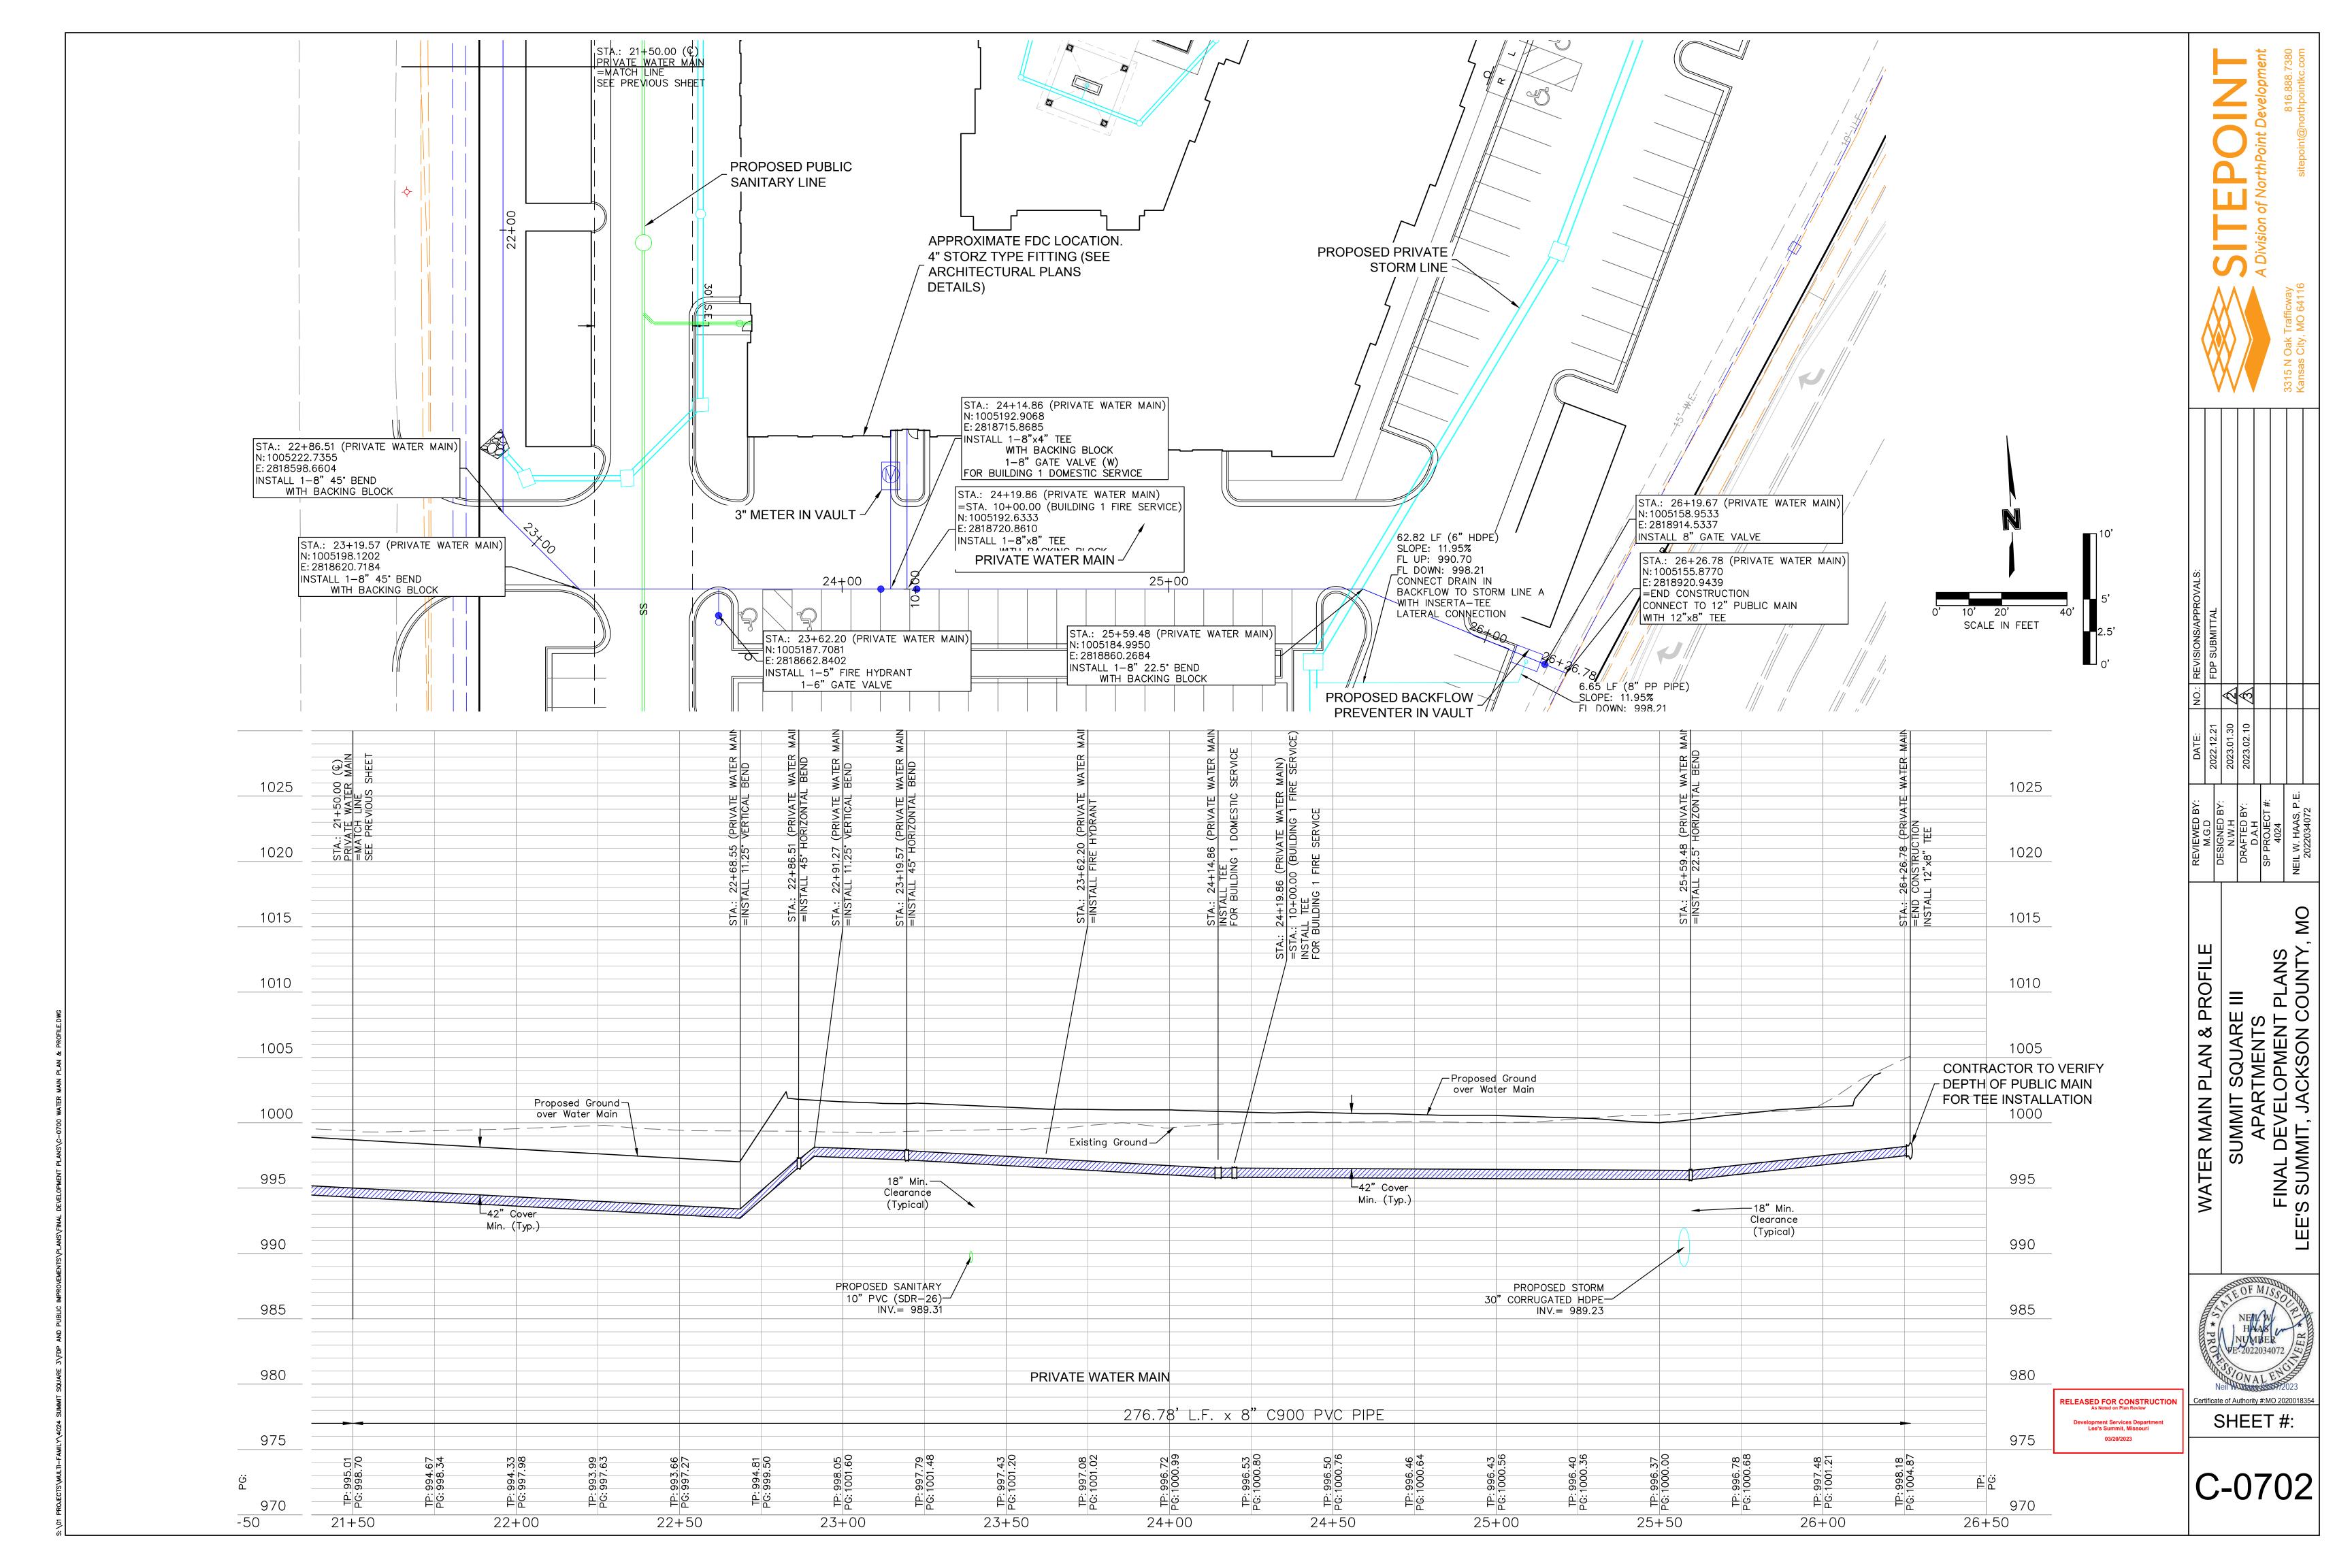
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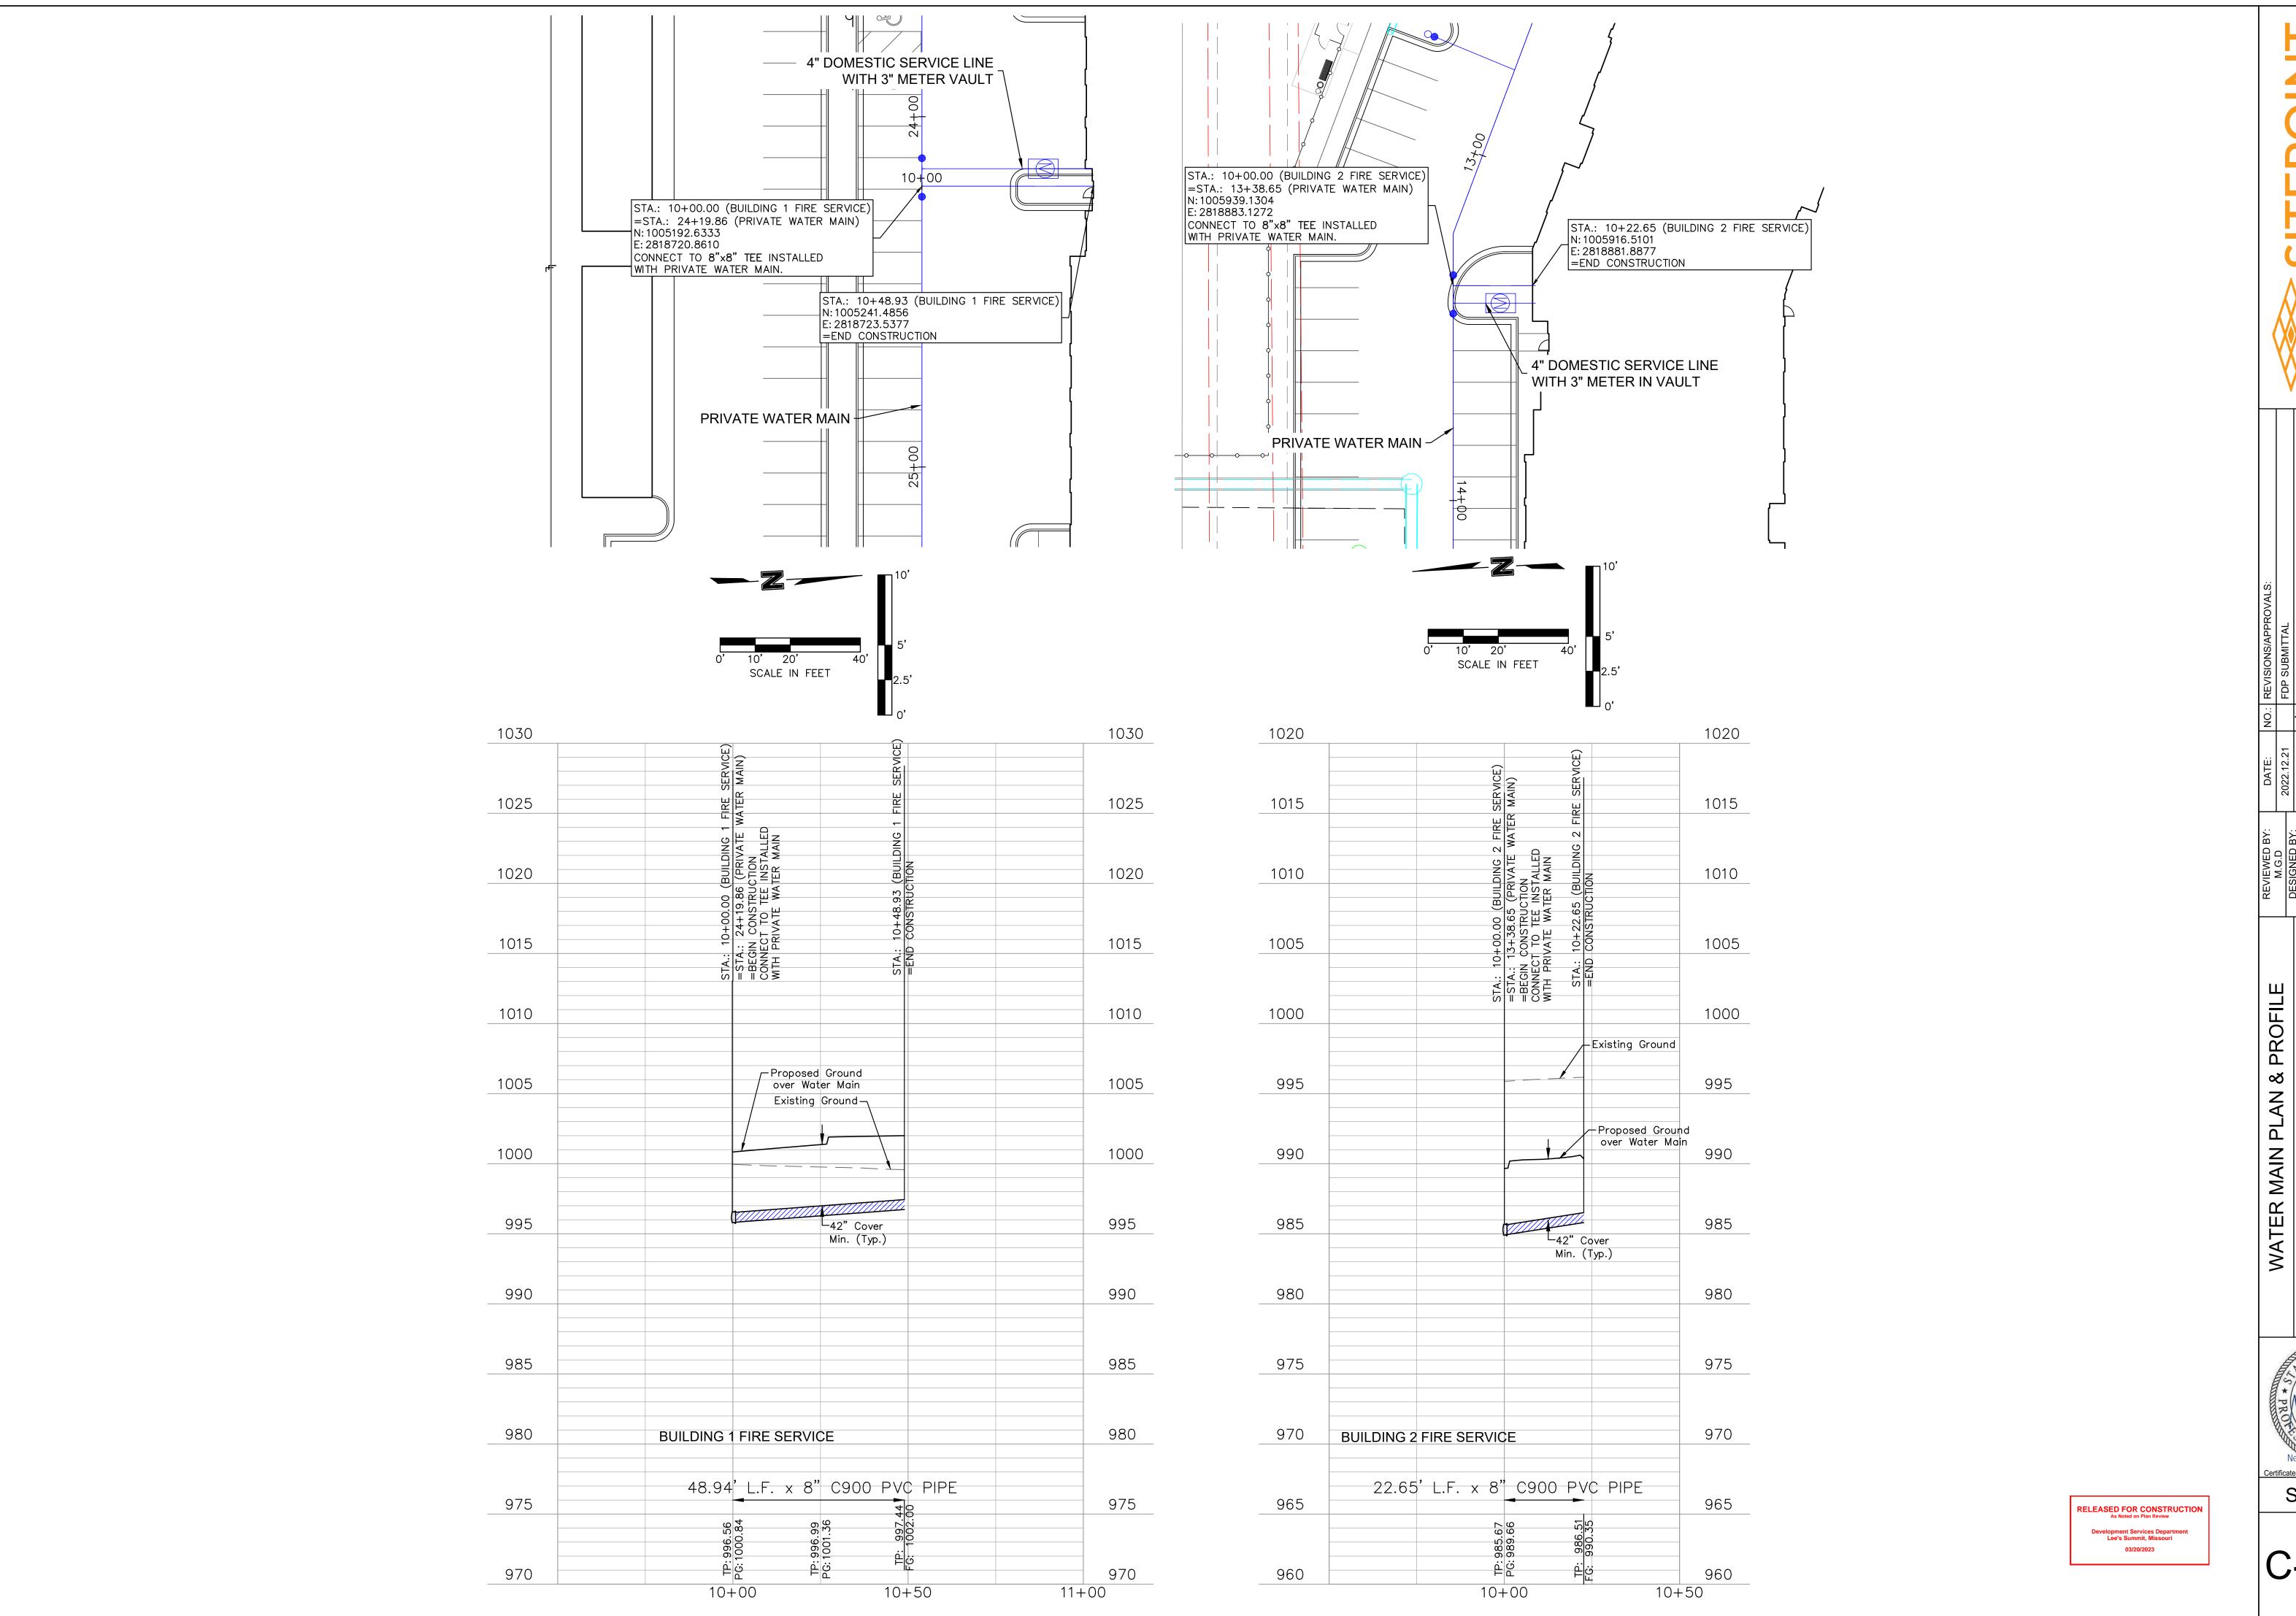
Neil Water State of Authority #:MO 2020018354

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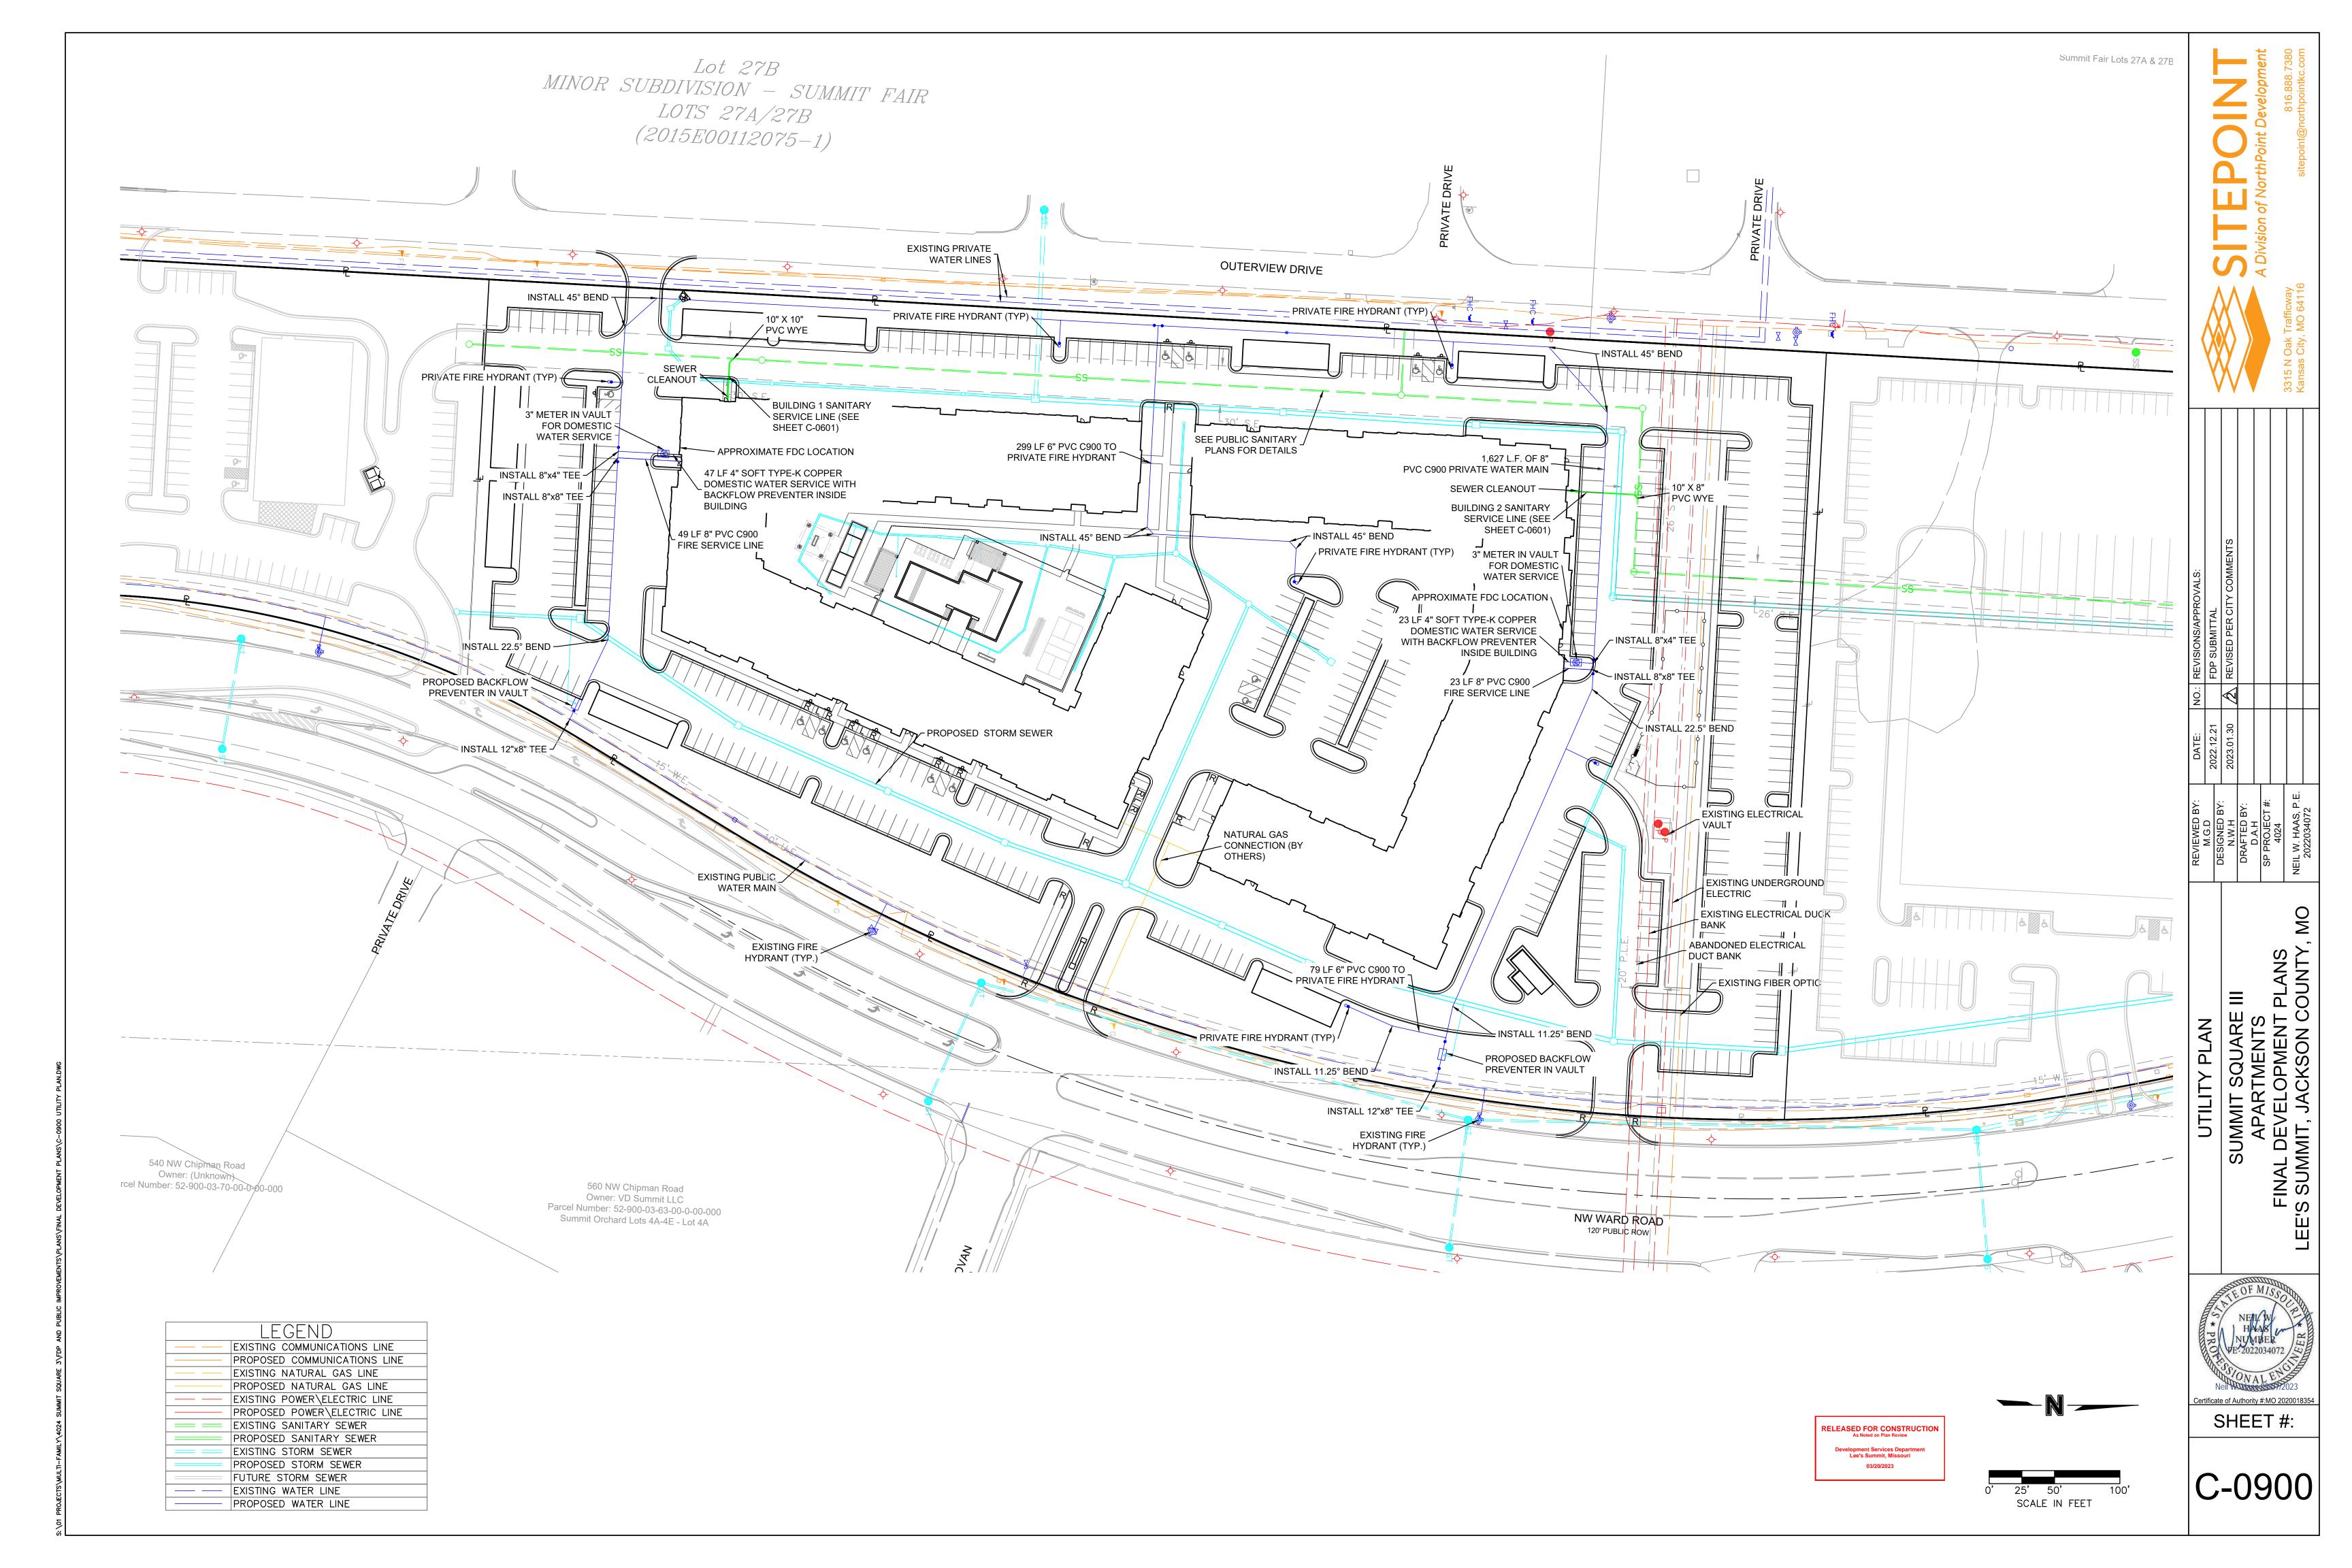





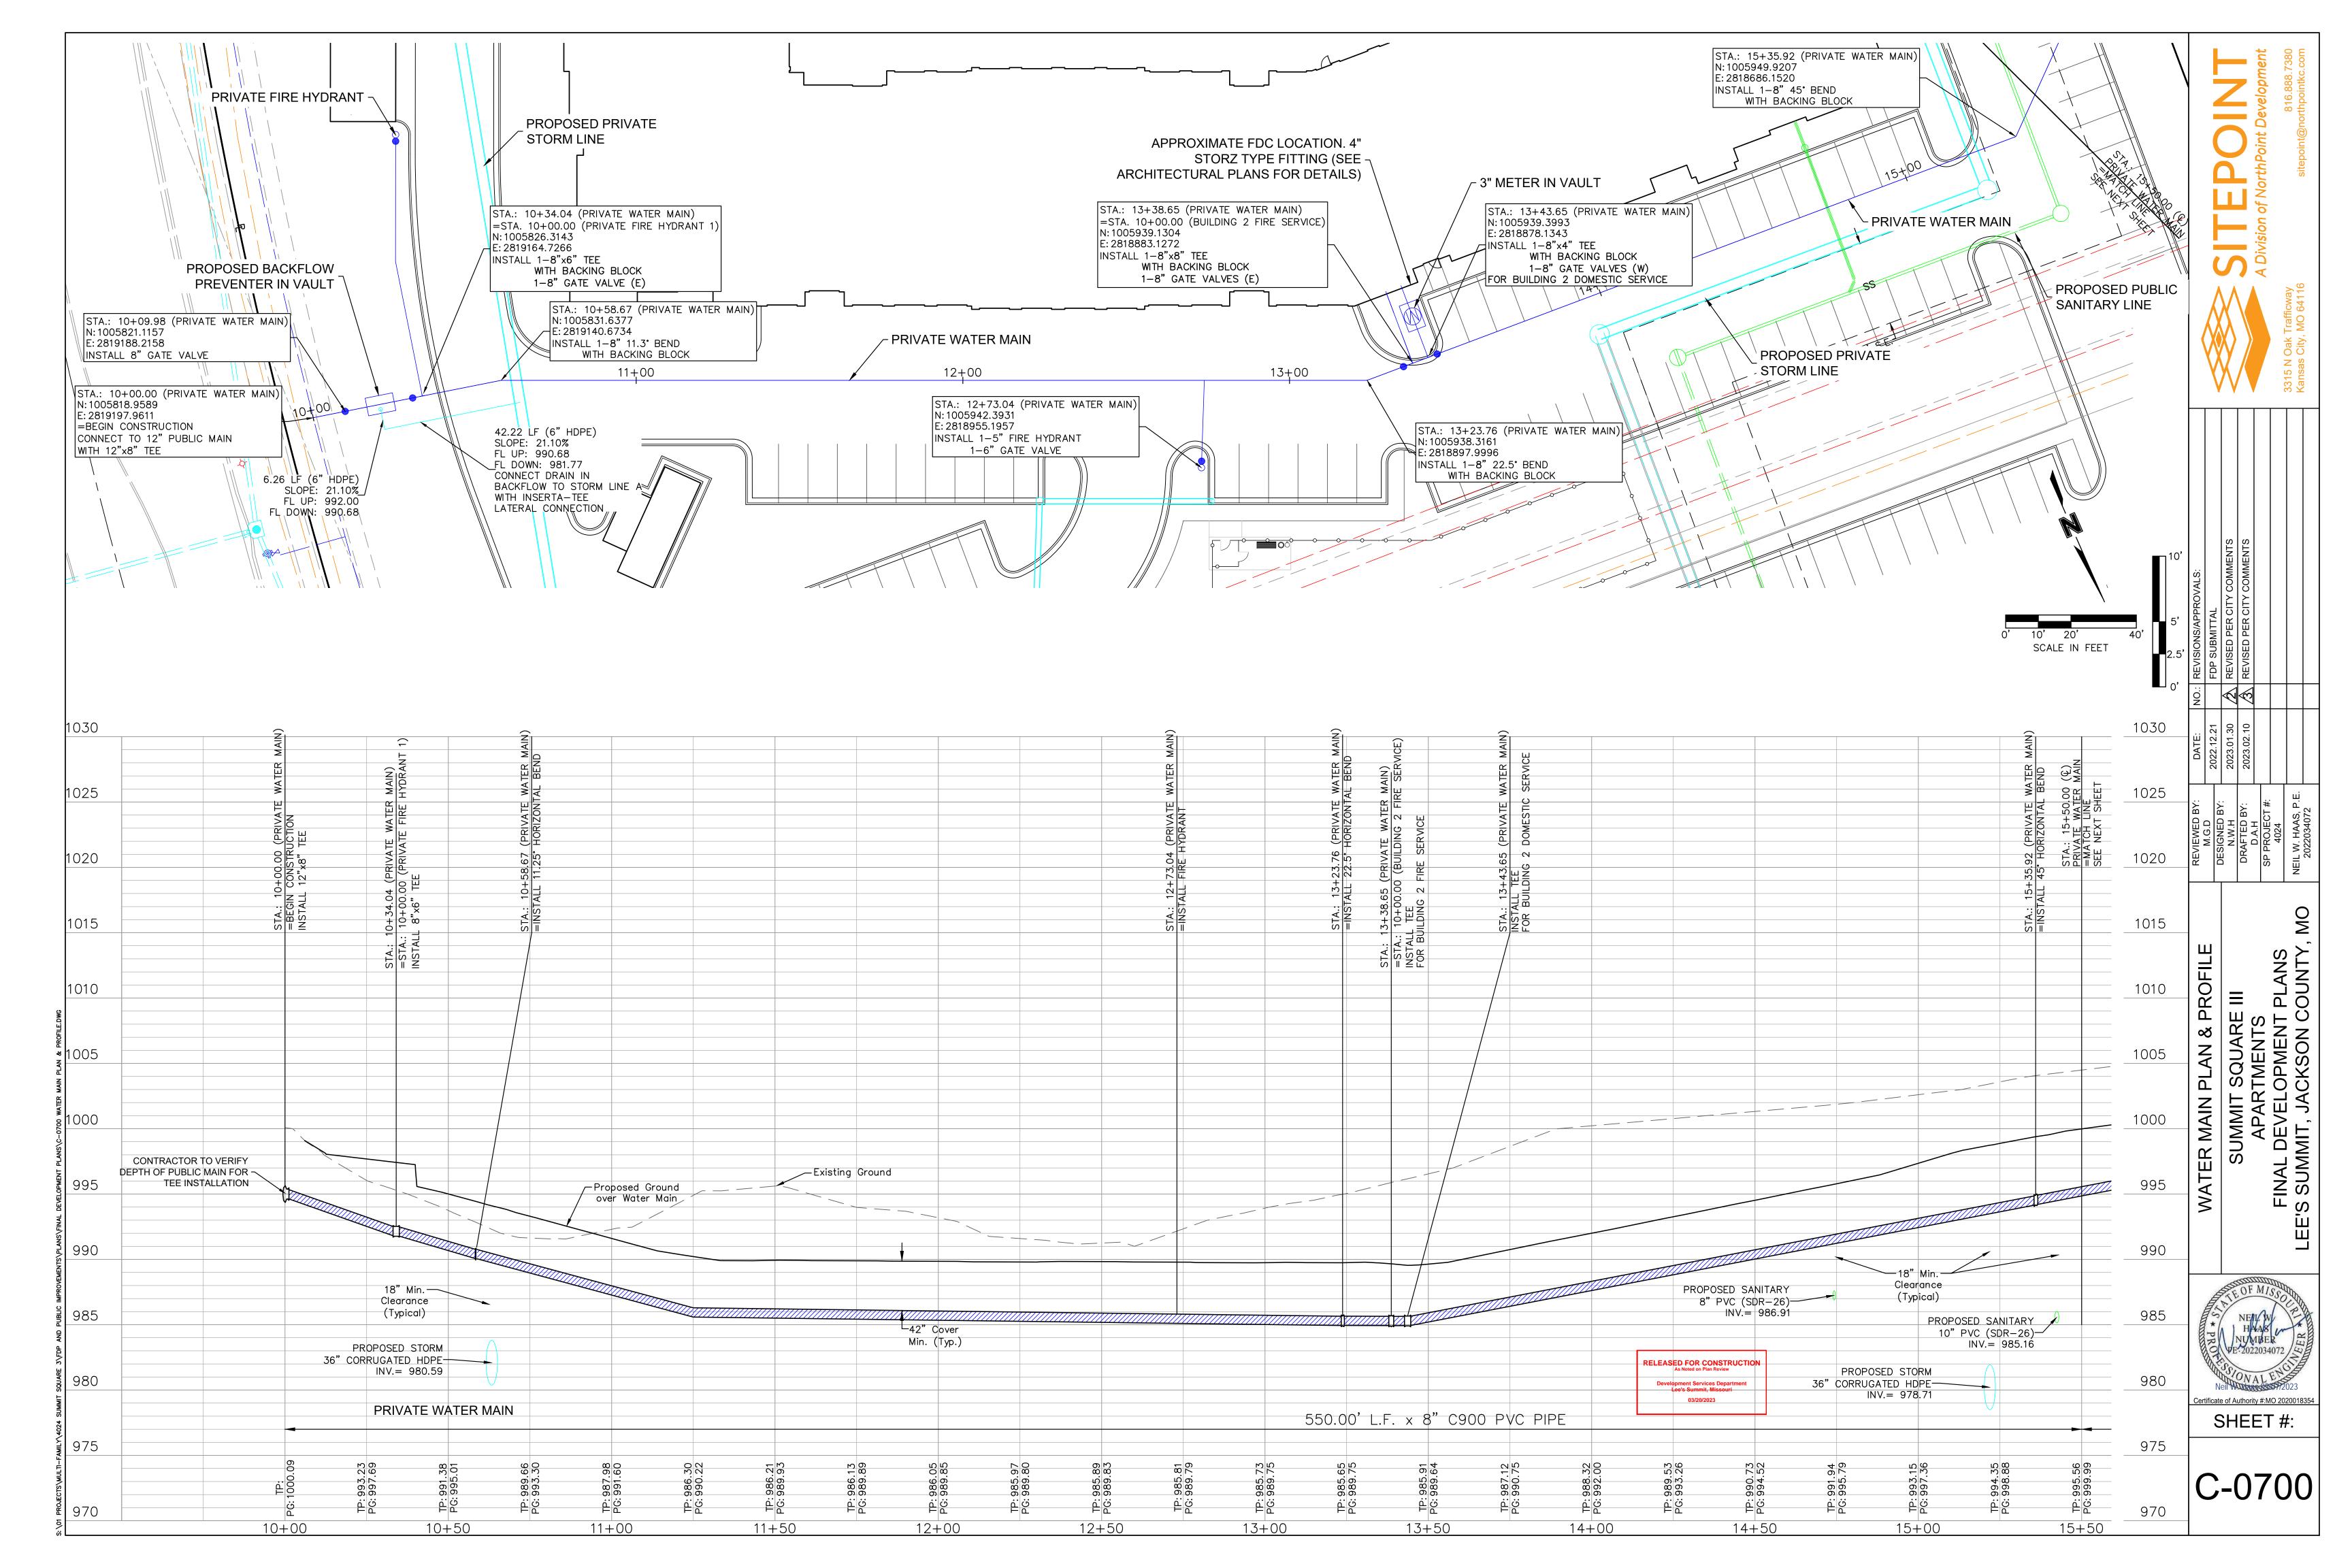



WATER MAIN PLAN & PROFILE
SUMMIT SQUARE III
APARTMENTS
FINAL DEVELOPMENT PLANS
LEE'S SUMMIT, JACKSON COUNTY, M

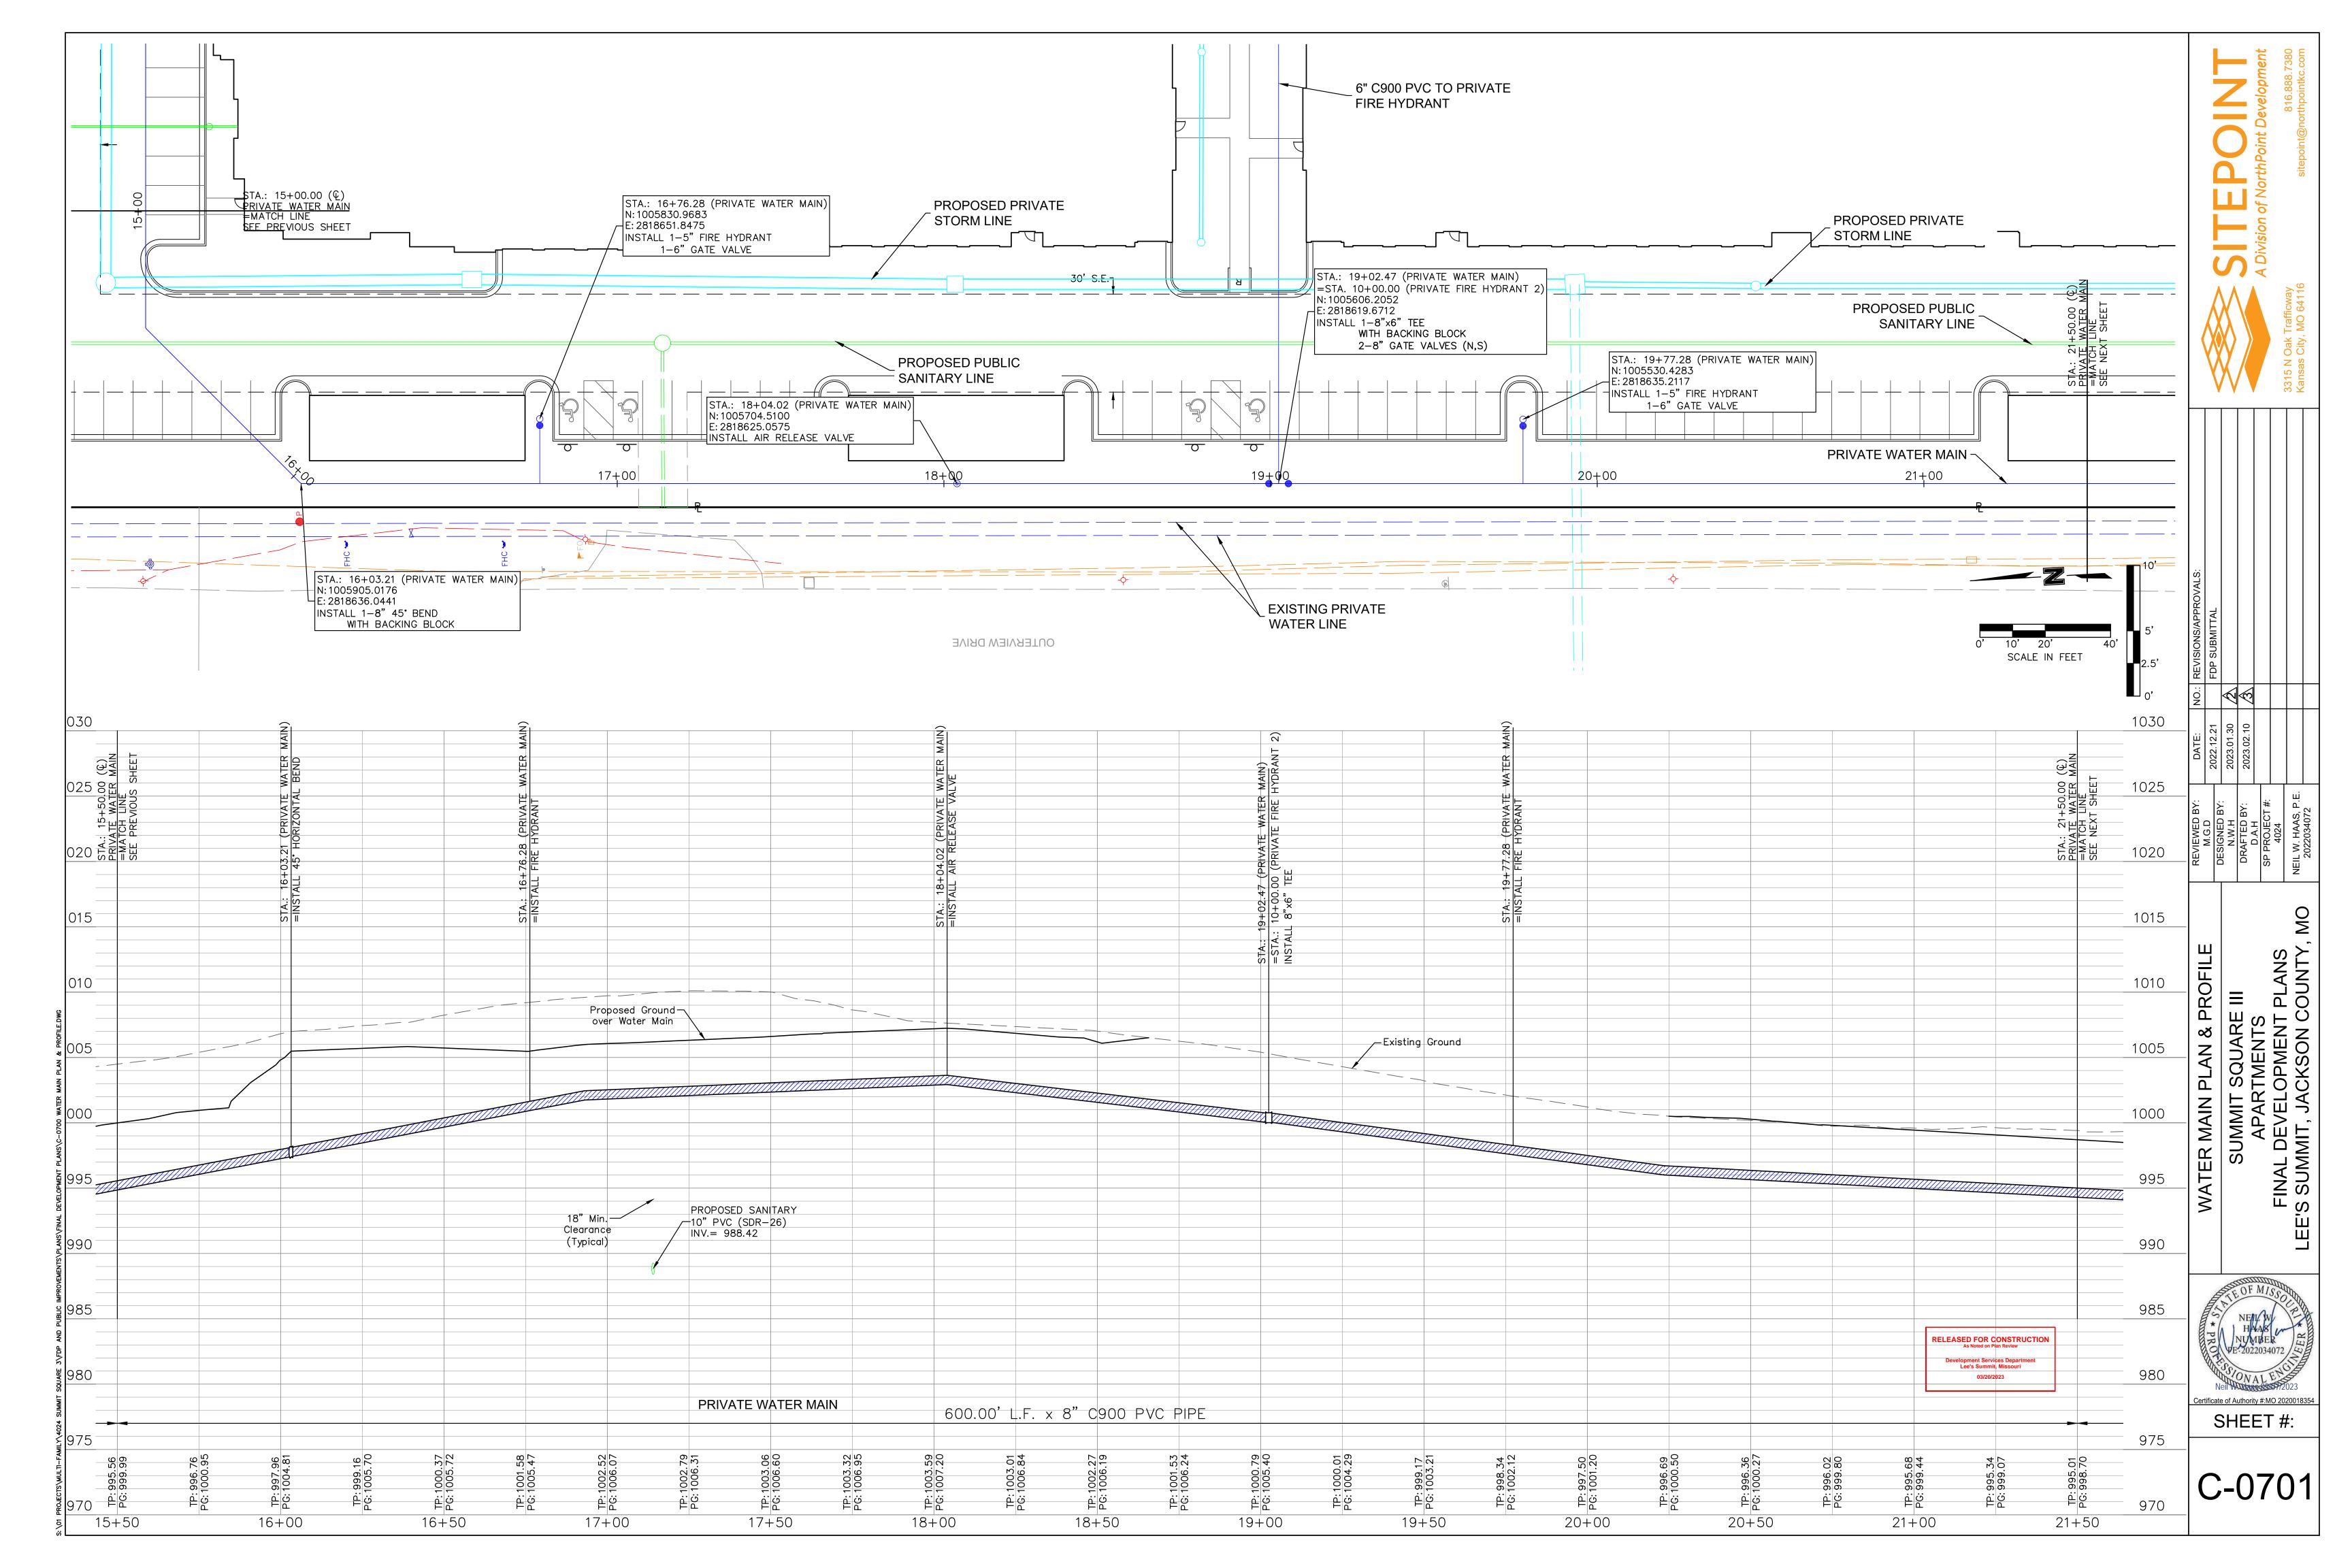




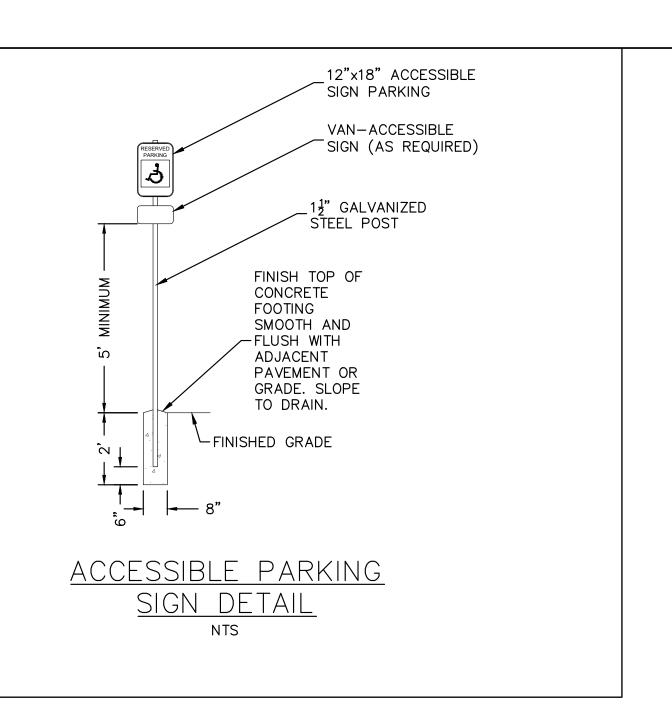

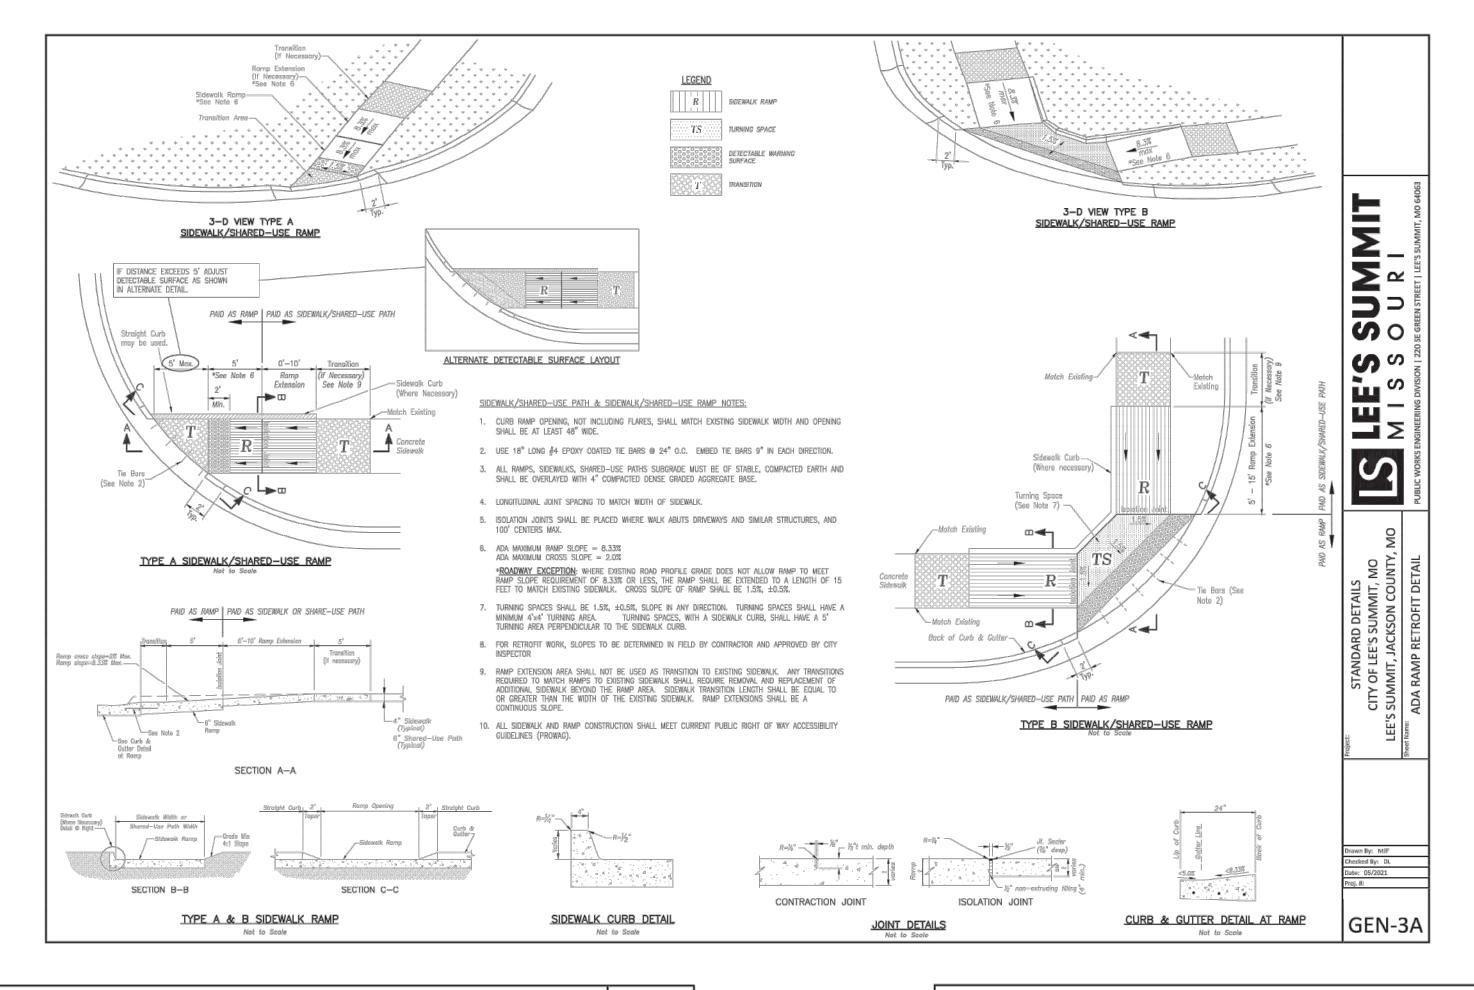

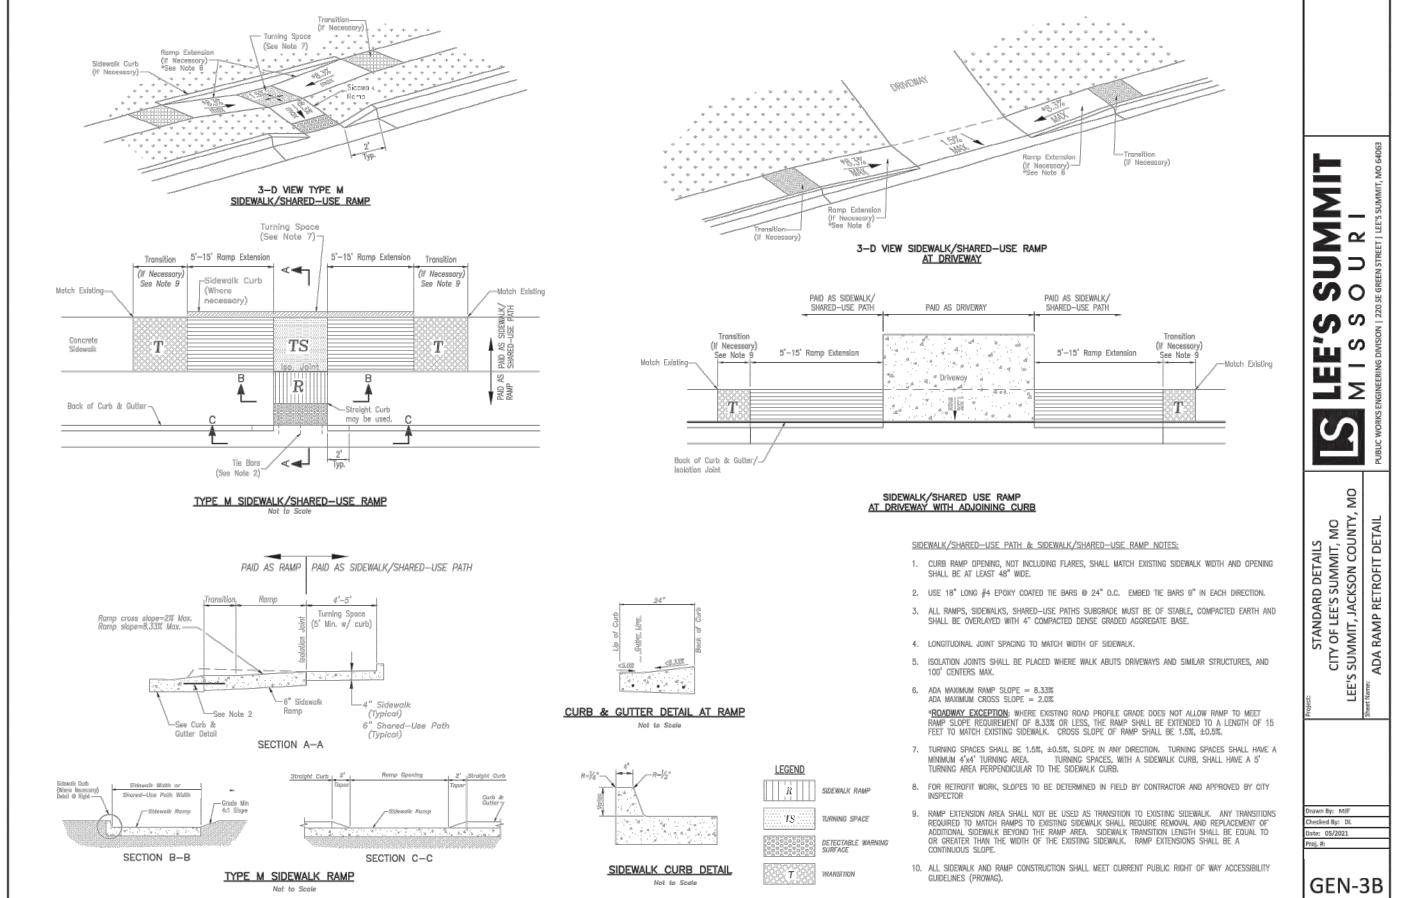

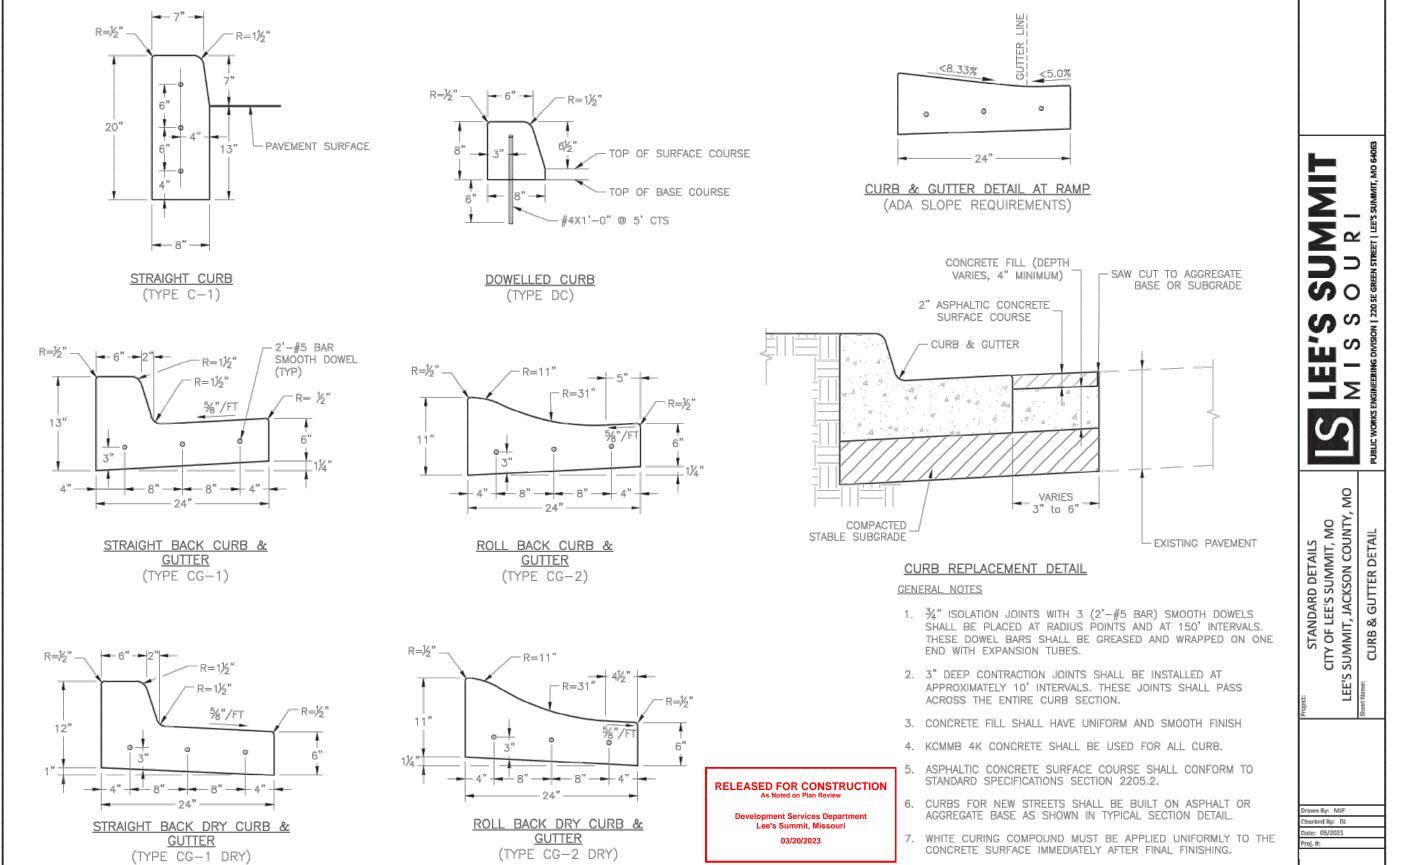

8. ALL DOWELS & TIE BARS SHALL BE EPOXY COATED.





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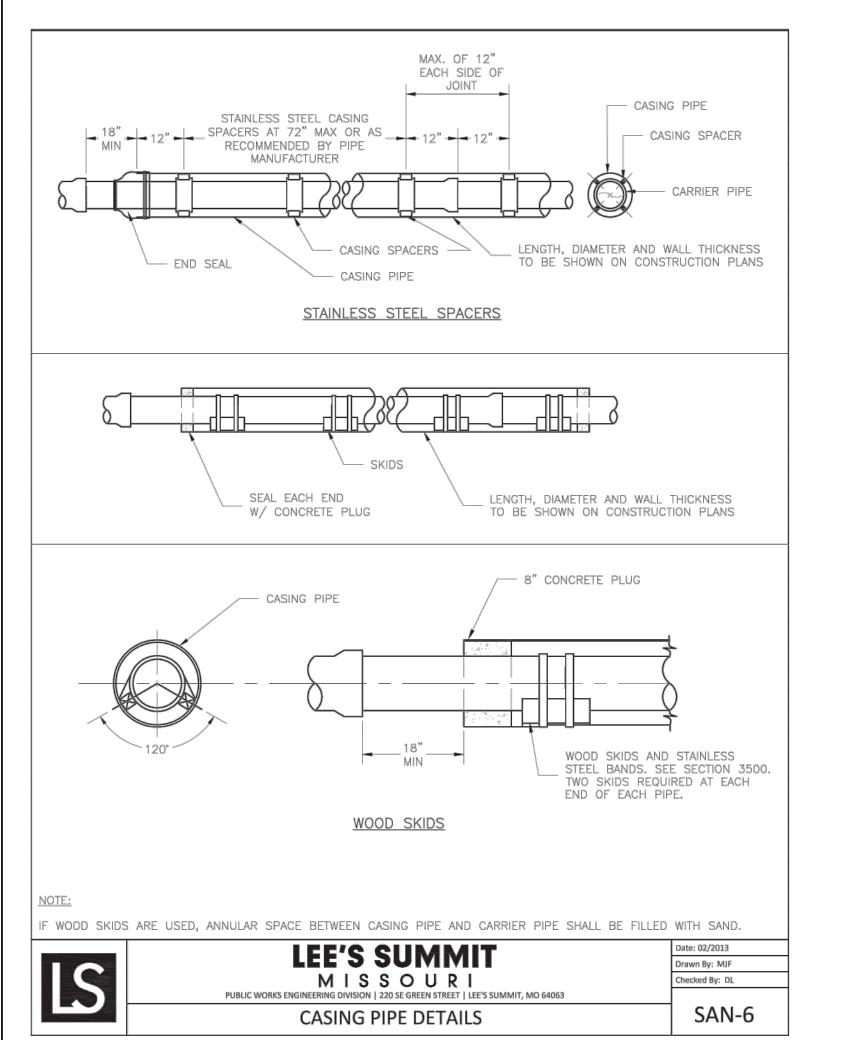
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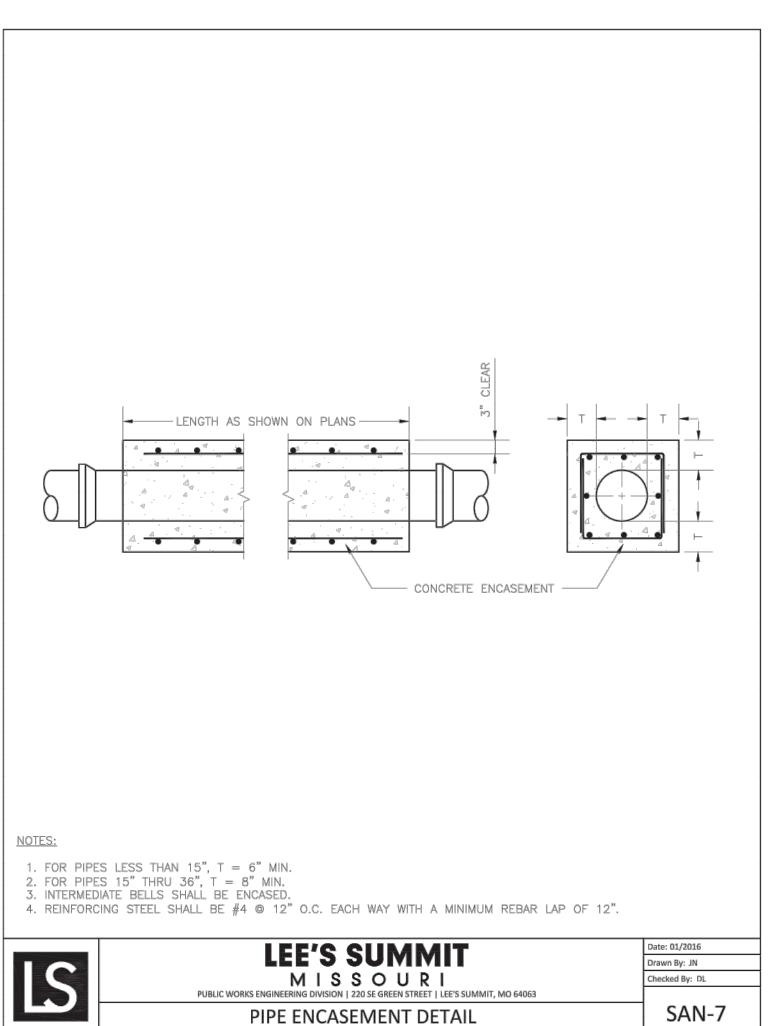





6. PROVIDE STEPS AS SHOWN ON THE APPROVED PRODUCTS LIST FOR MANHOLE DEPTHS GREATER THAN 4'.



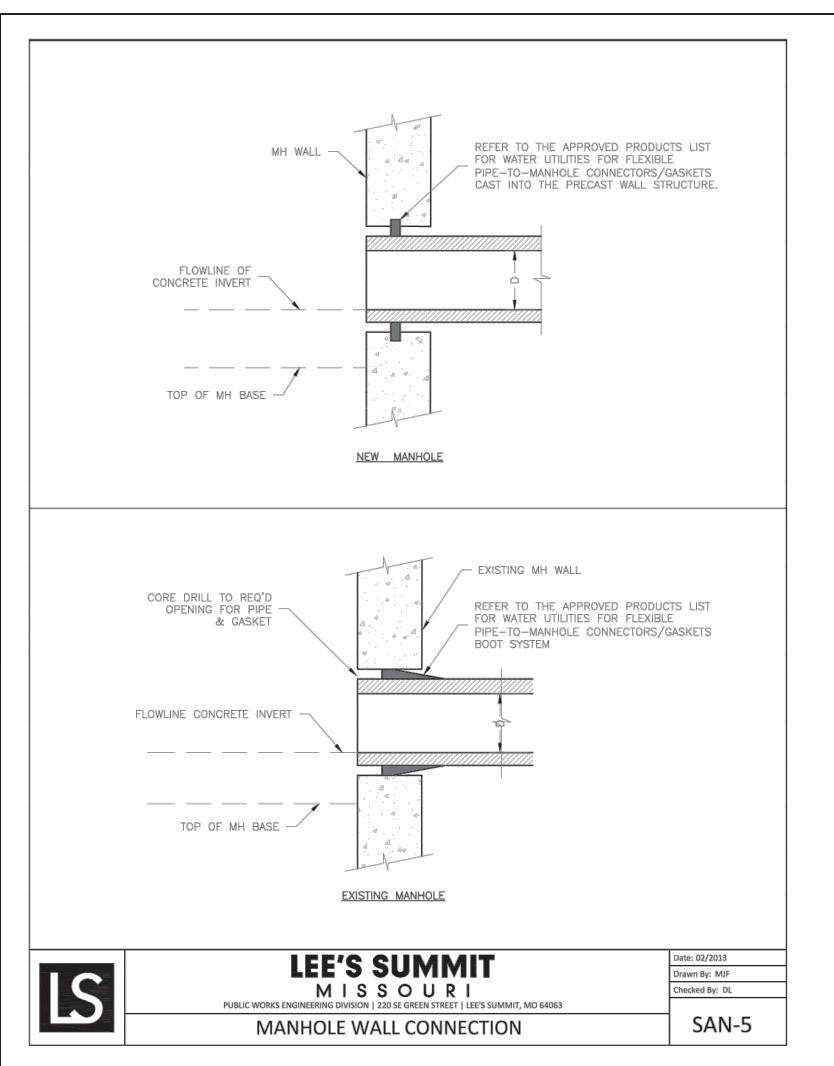

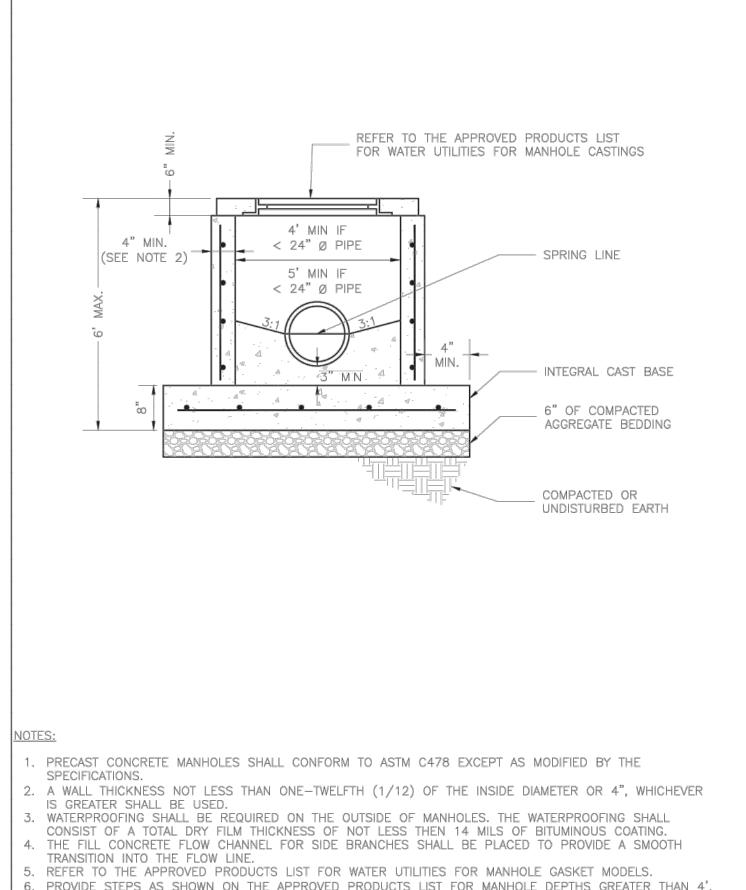


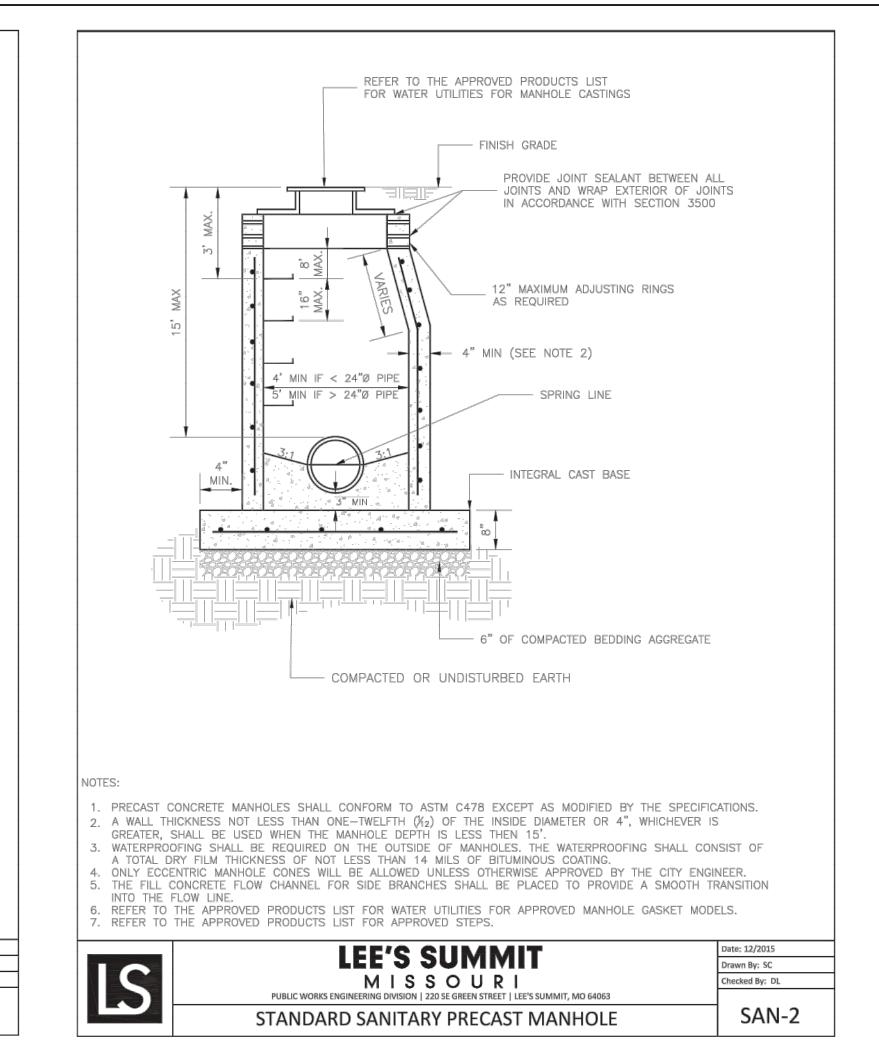








Development Services Departme Lee's Summit, Missouri

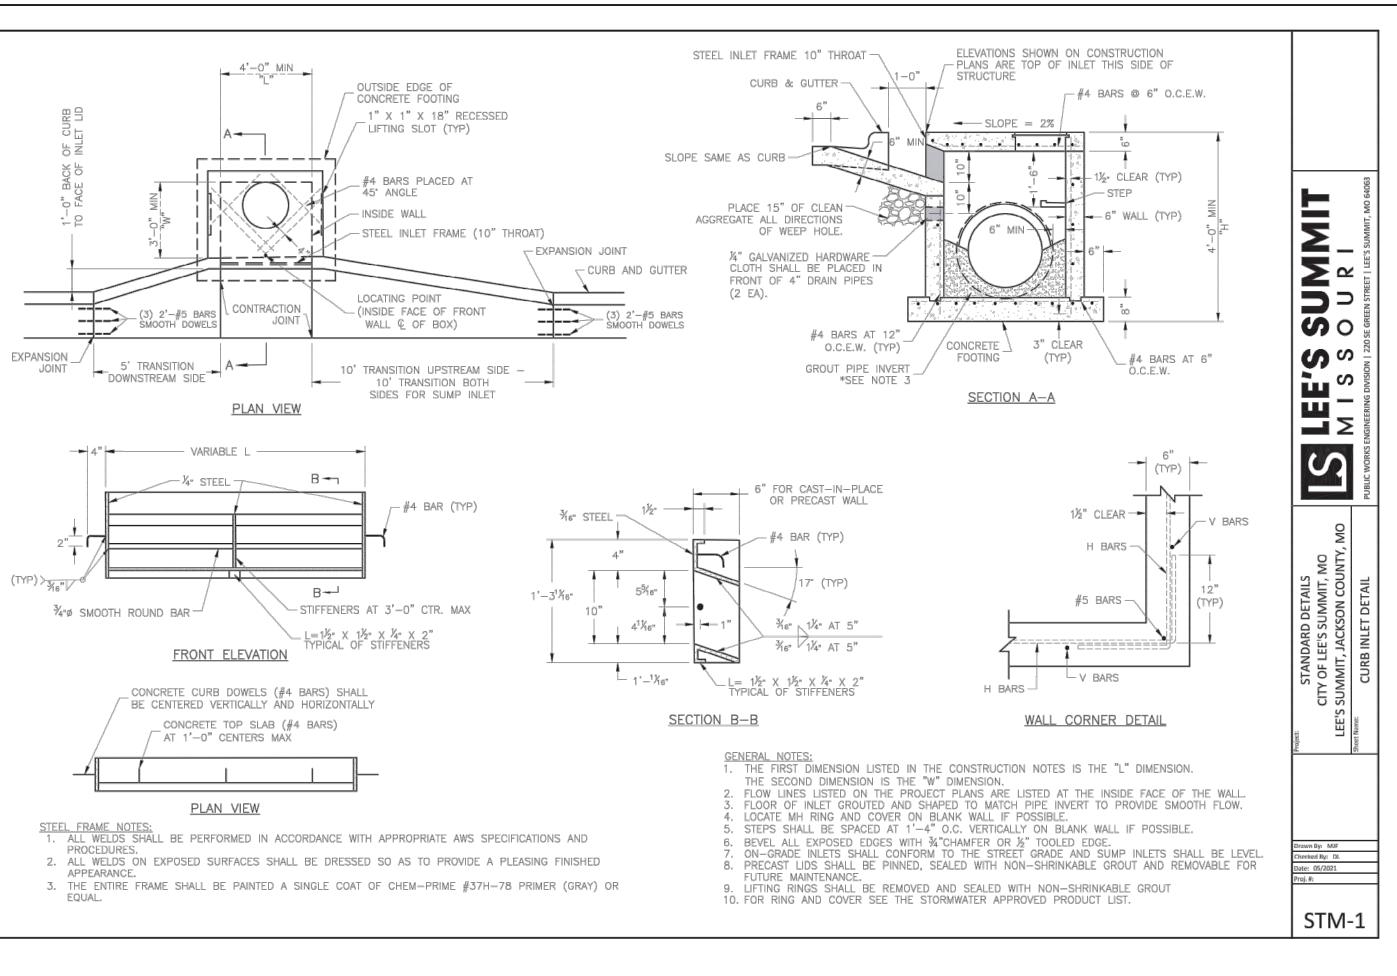

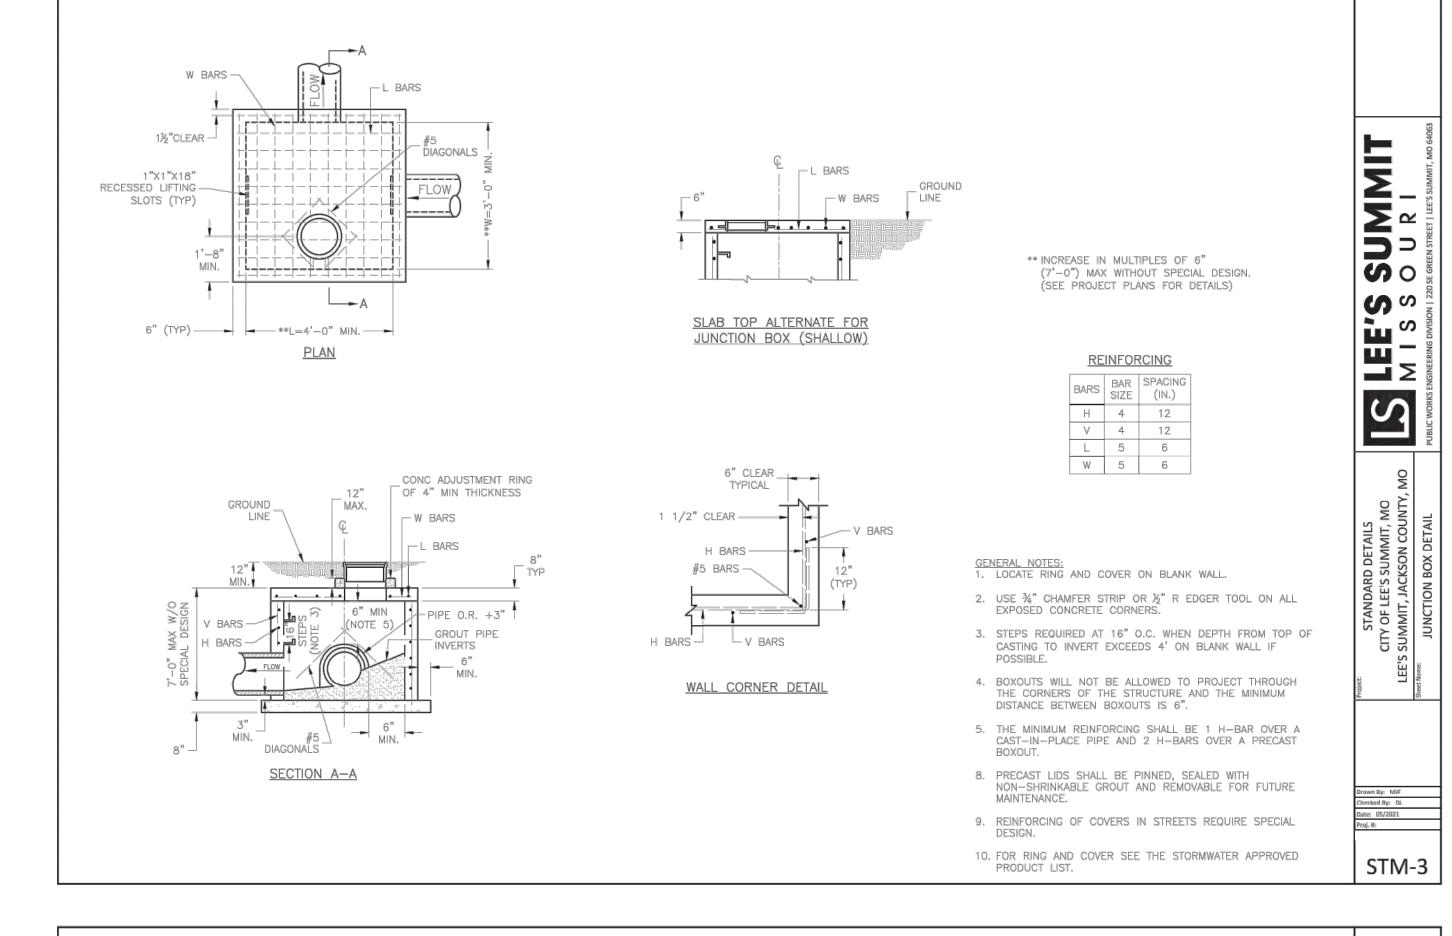

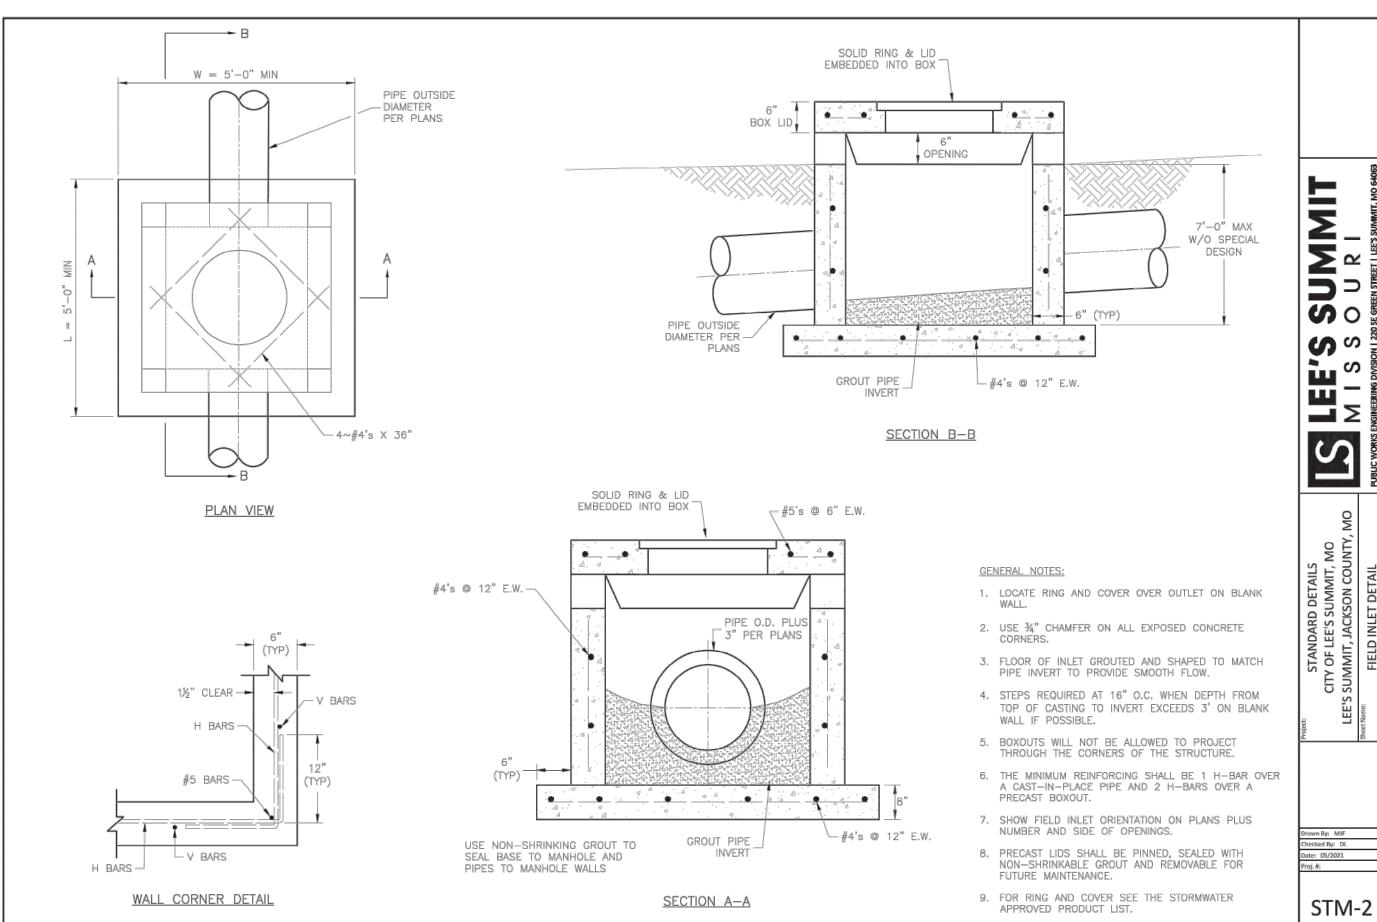

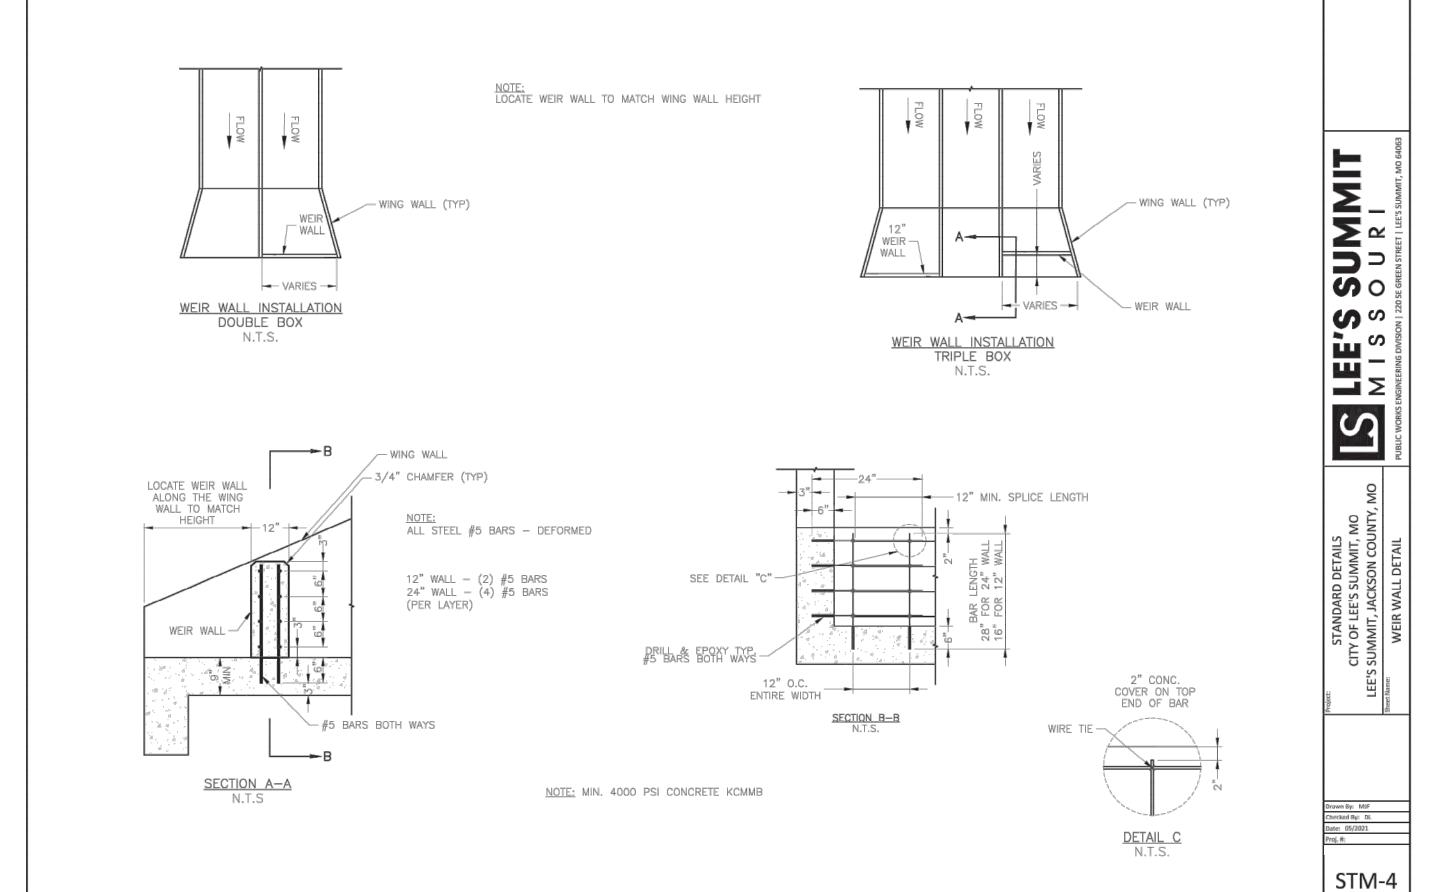

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As Noted on Plan Review


Development Services Department
Lee's Summit, Missouri
03/20/2023





טריאור טווררי	SUMMIT SQUARE III	APARTMENTS	FINAL DEVELOPMENT PLANS	LEE'S SUMMIT, JACKSON COUNTY, MO
É	55550	F MI	323	y


Certificate of Authority #:MO 202001835

SHEET #:

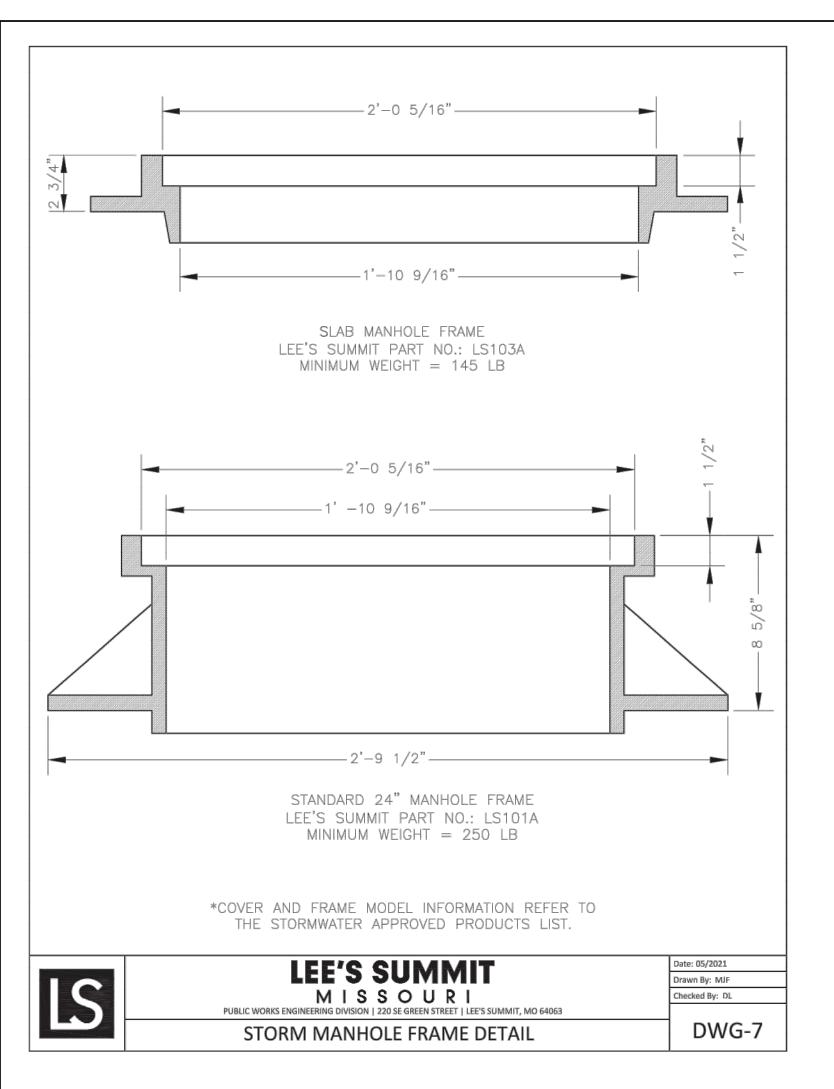

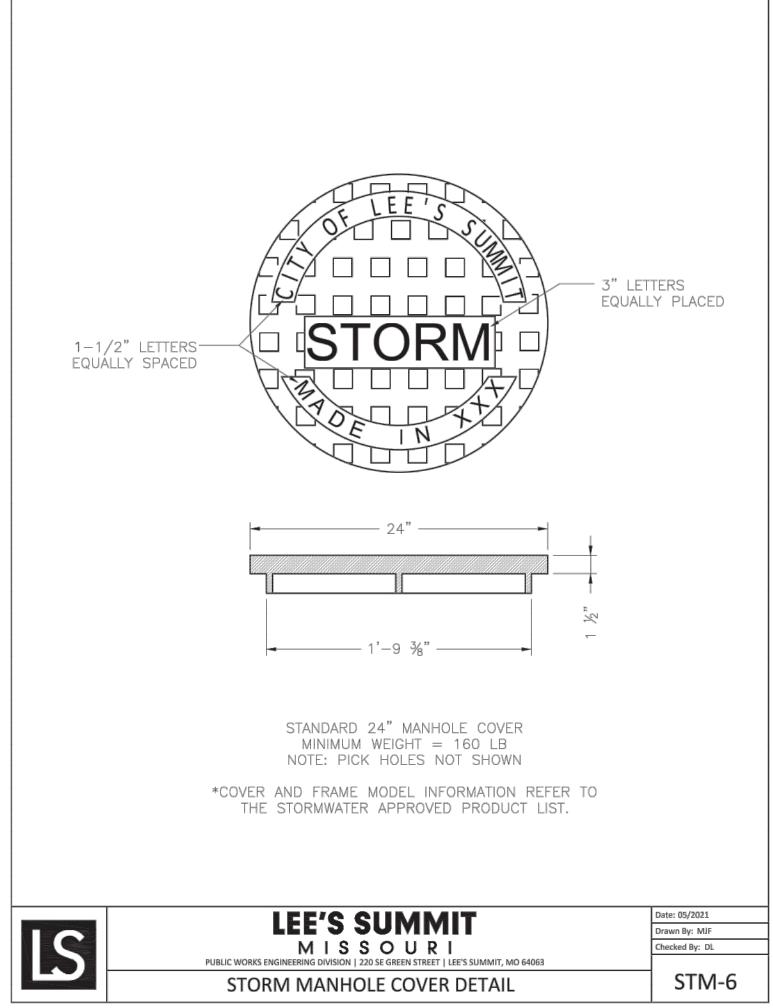


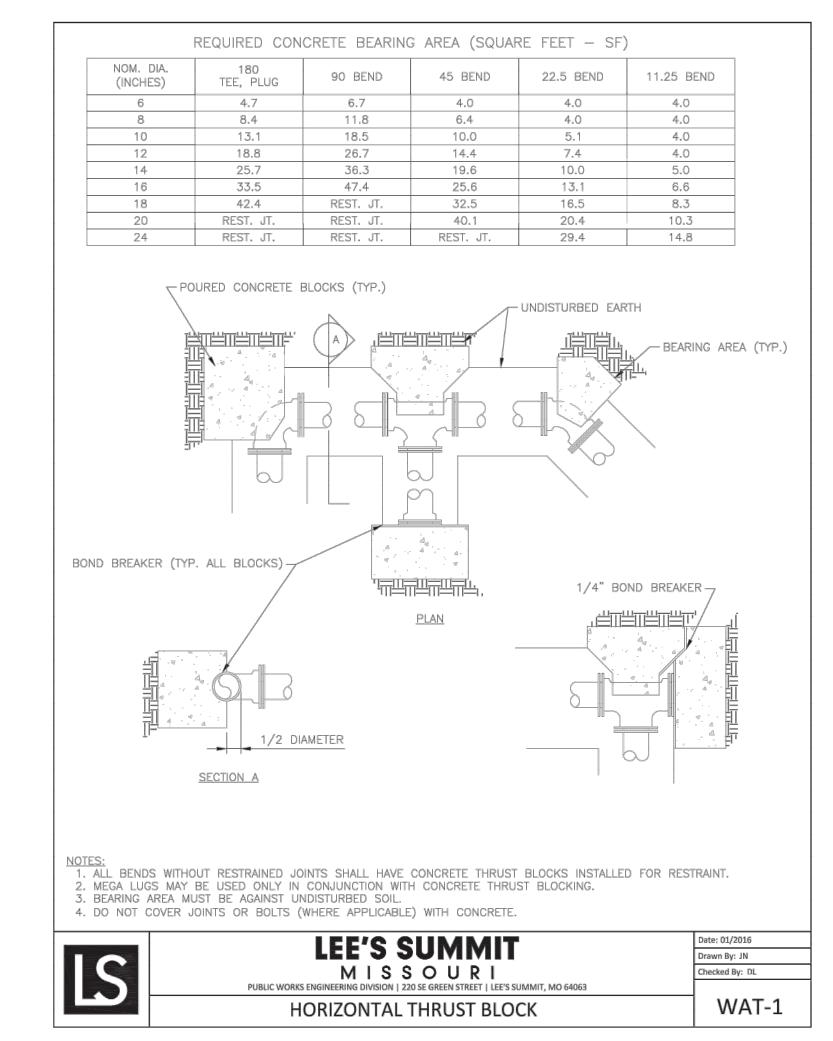


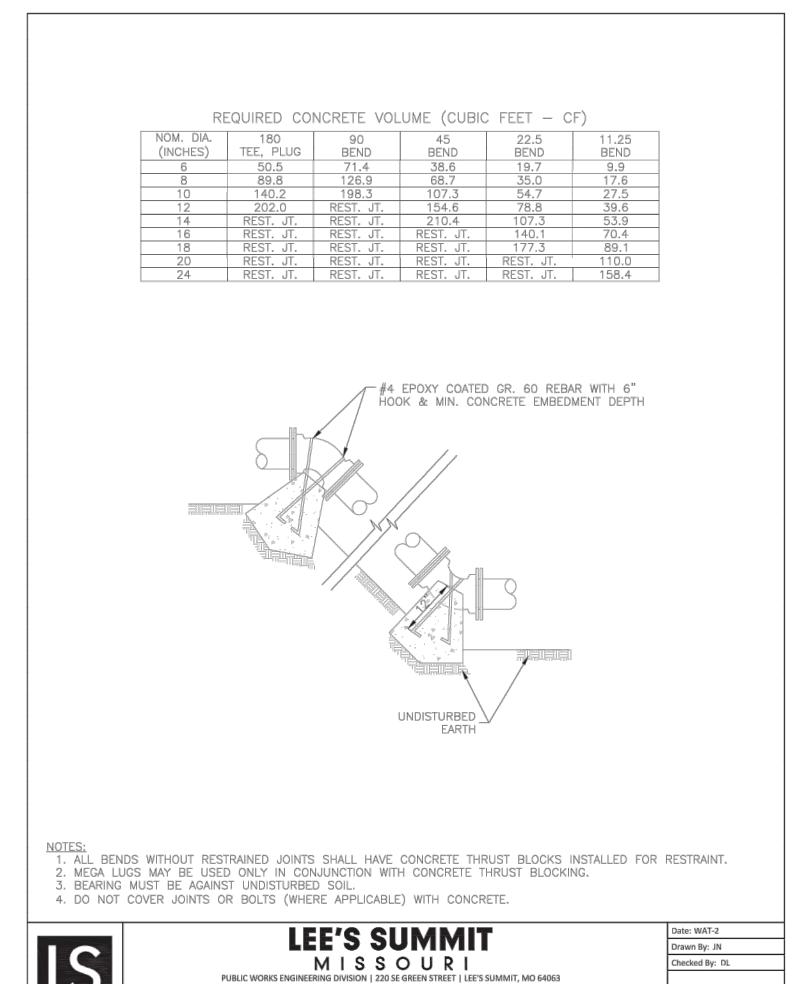


VERTICAL THRUST BLOCK


WAT-2

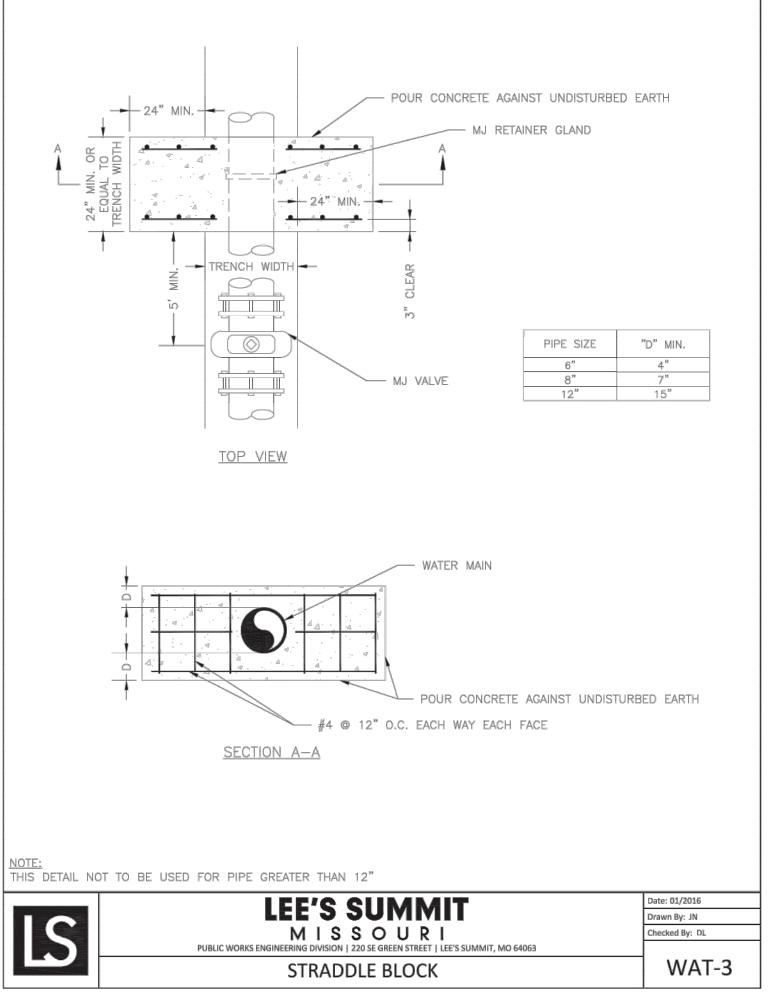

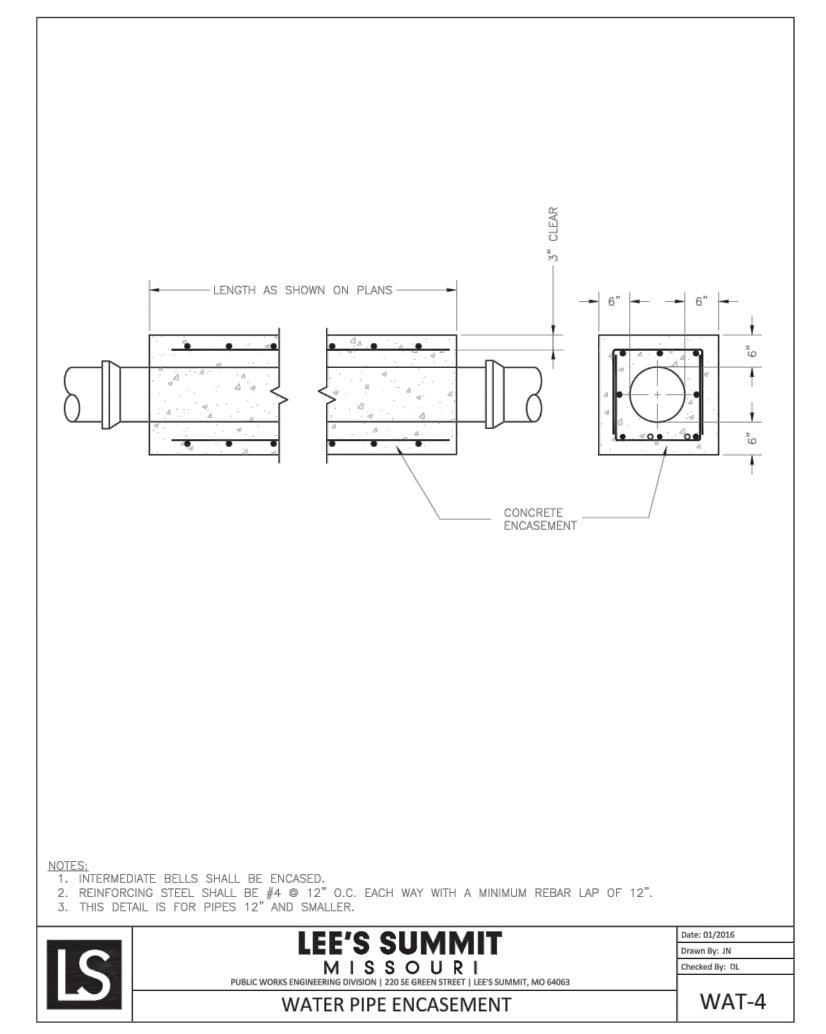

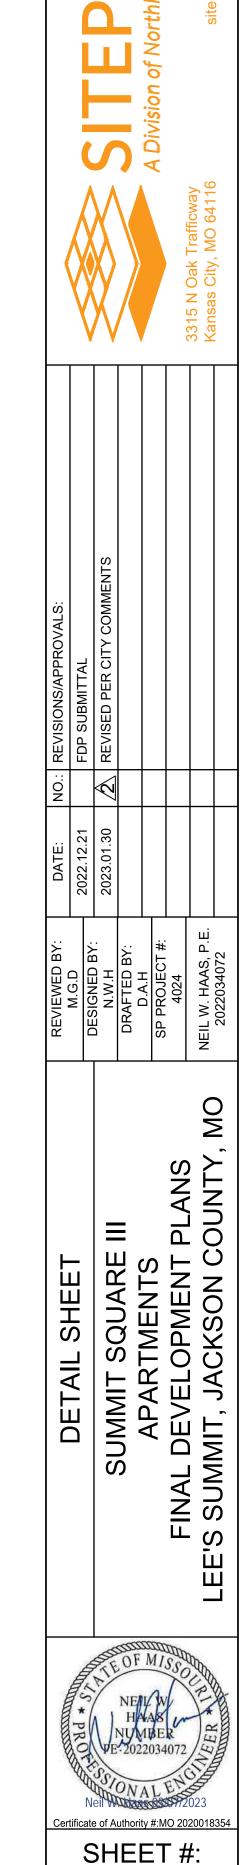

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MECHANICAL JOINT (TYP.) -

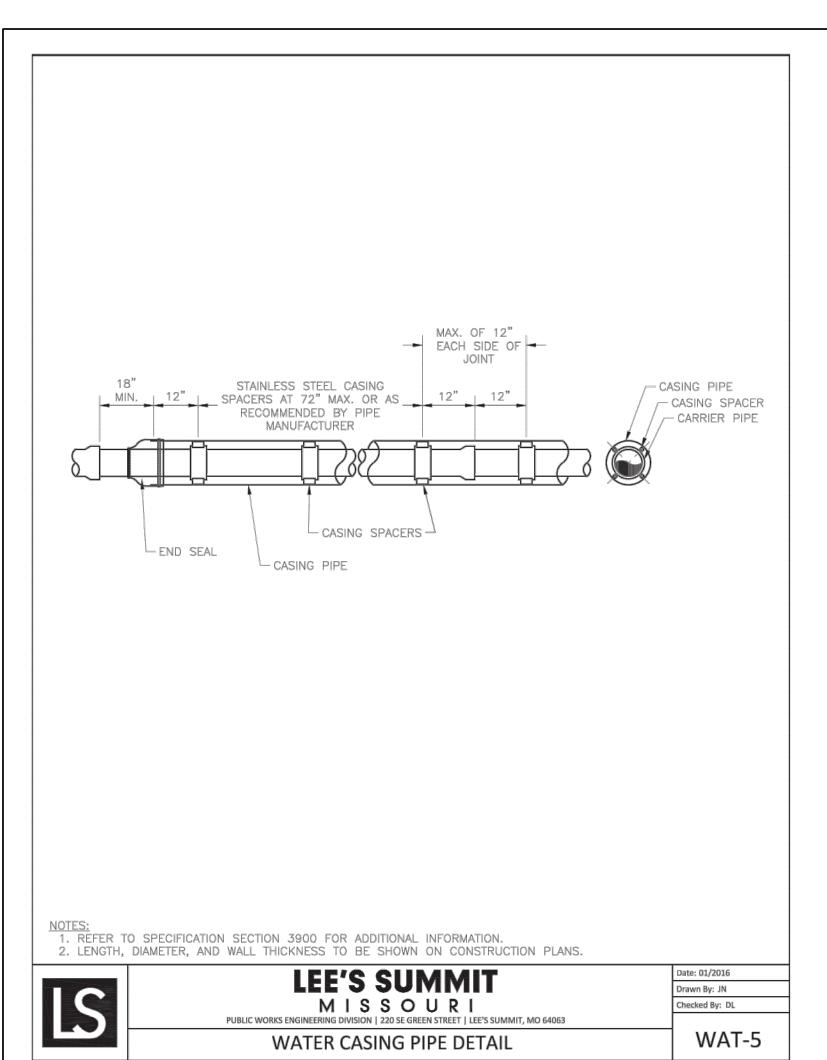VALVE LID & COVER -__

6" GATE VALVE -

HORIZONTAL THRUST BLOCKS ARE REQUIRED.

. GATE VALVE MAY BE BOLTED DIRECTLY TO MJ RESTRAINT TEE.


6. HYDRANT SHALL BE ROTATED AS DIRECTED BY INSPECTOR.


4. BOTTOM HYDRANT FLANGE SHALL BE 2" TO 6" ABOVE FINISHED GRADE.


LEE'S SUMMIT


HYDRANT WITH 90 DEGREE BEND


UNDISTURBED

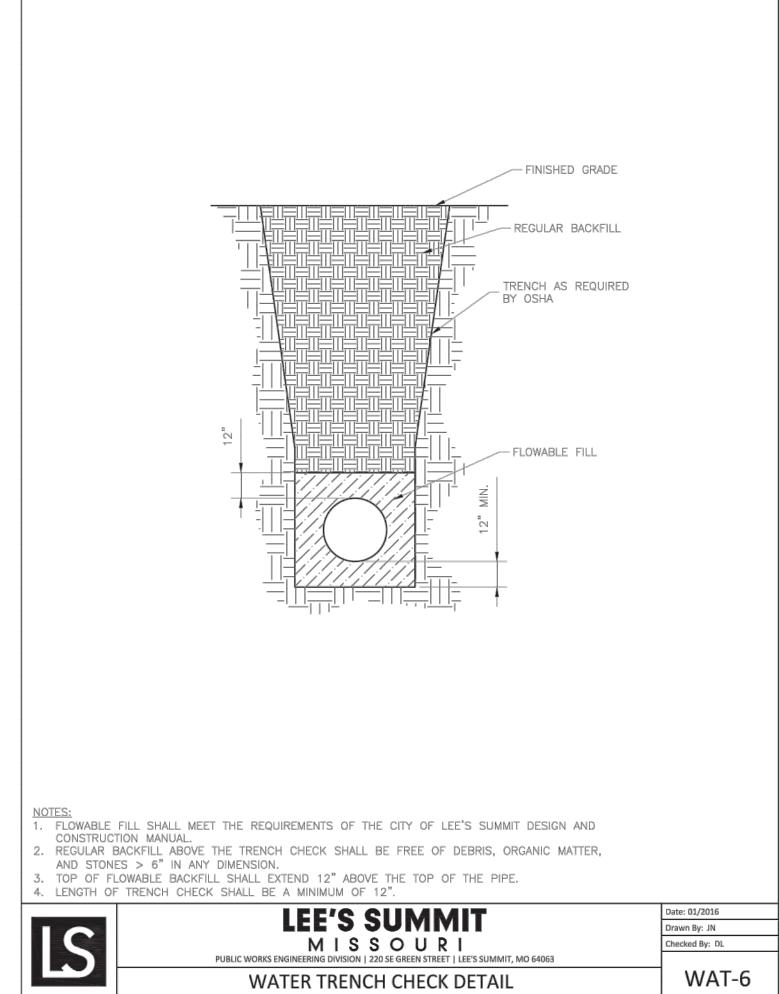

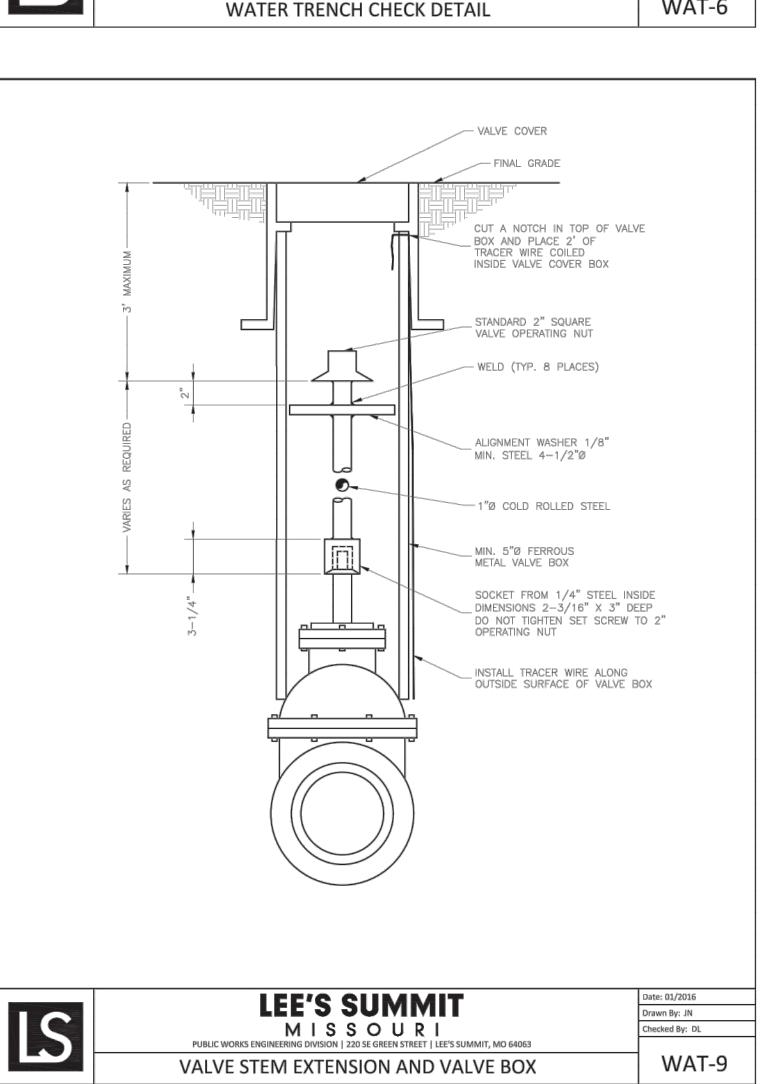


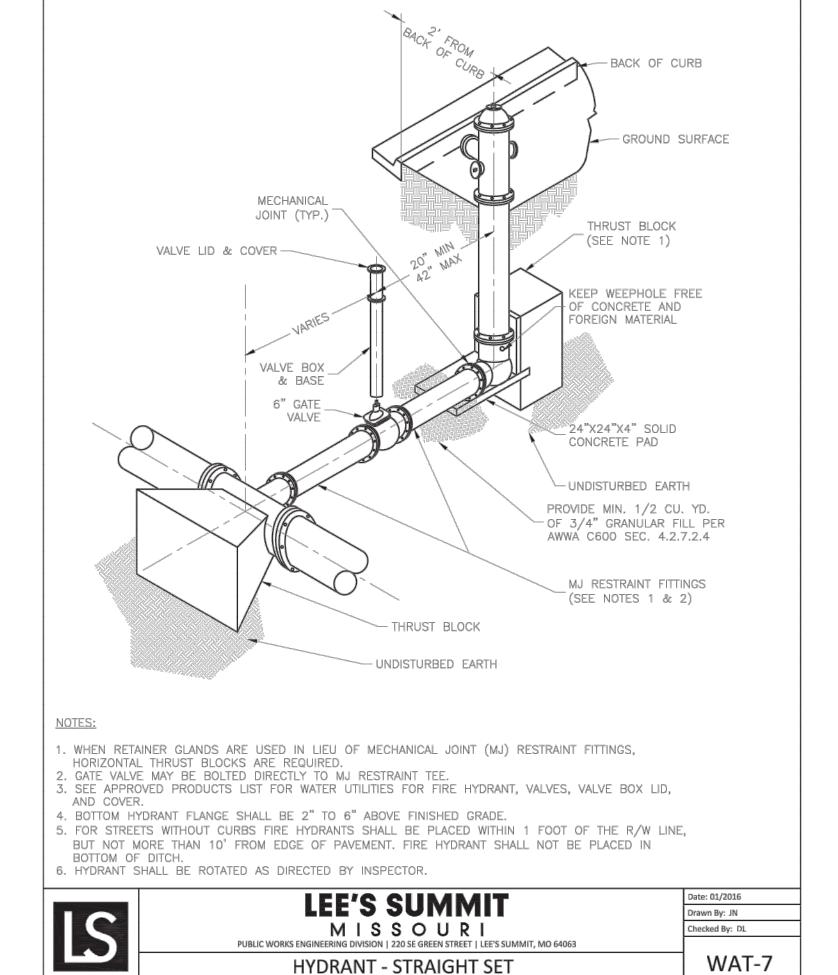

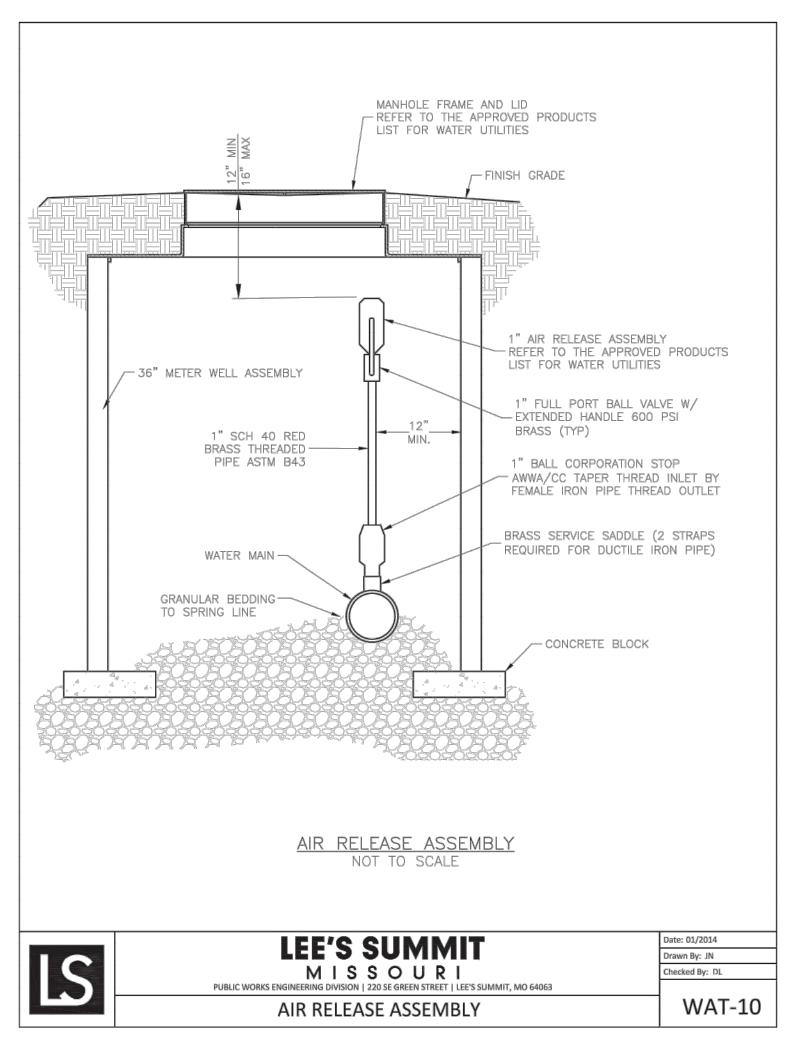


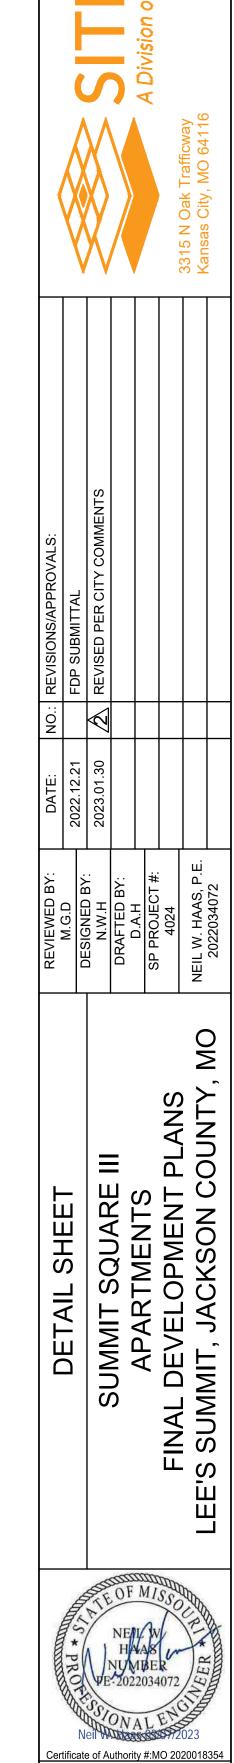


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-BACK OF CURB

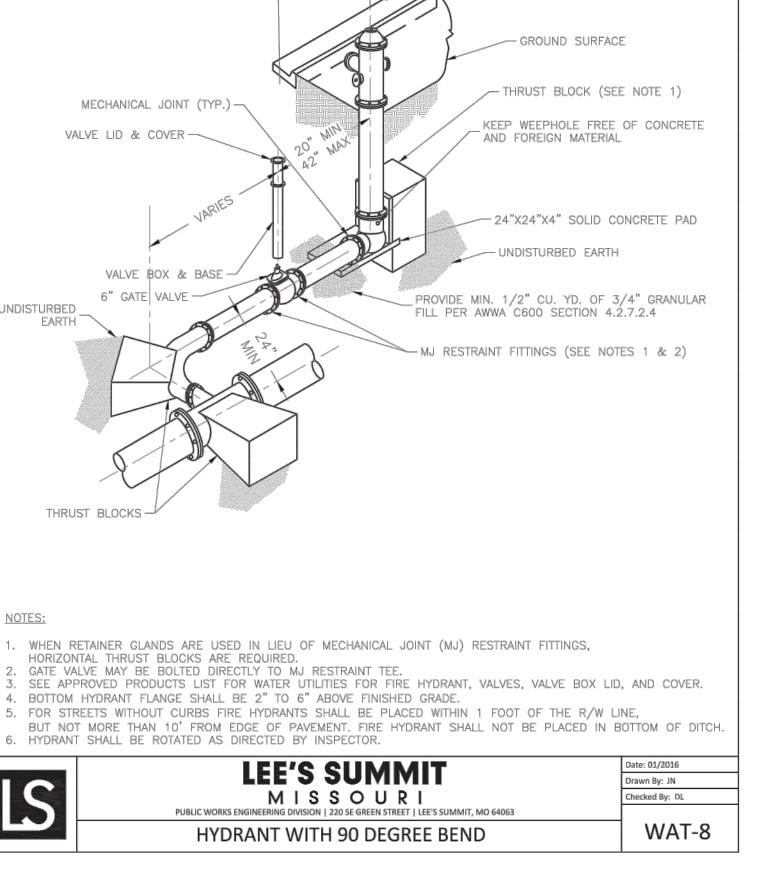

Development Services Departmen Lee's Summit, Missouri

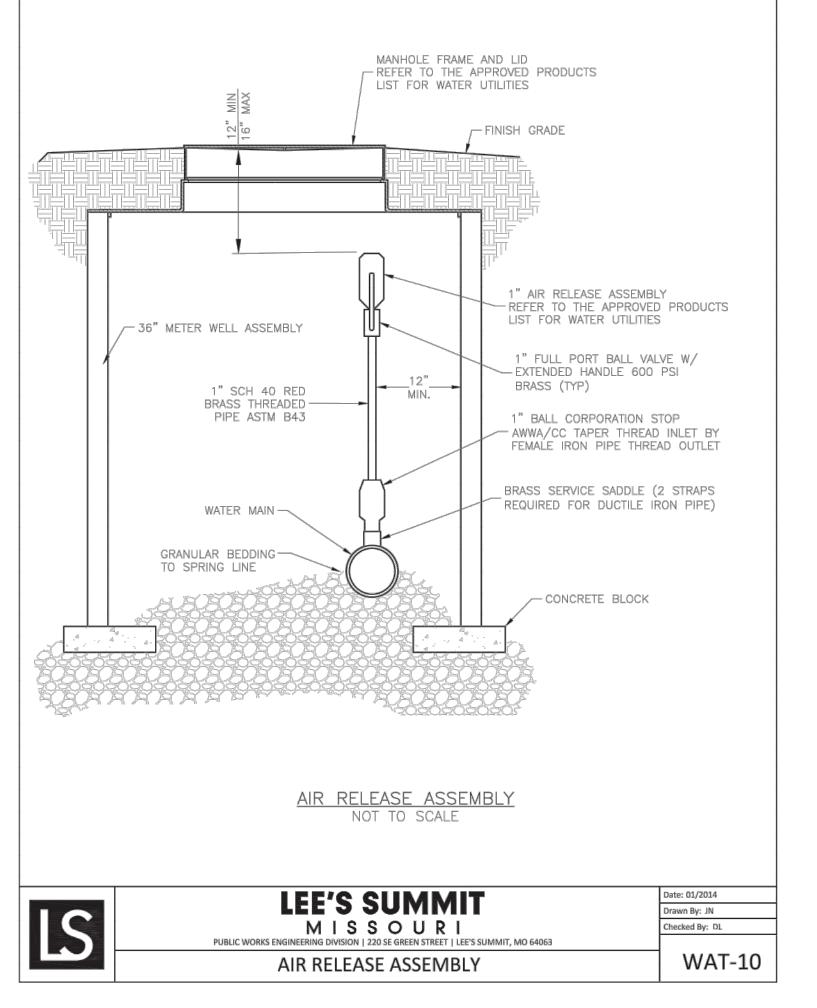

NOTES:

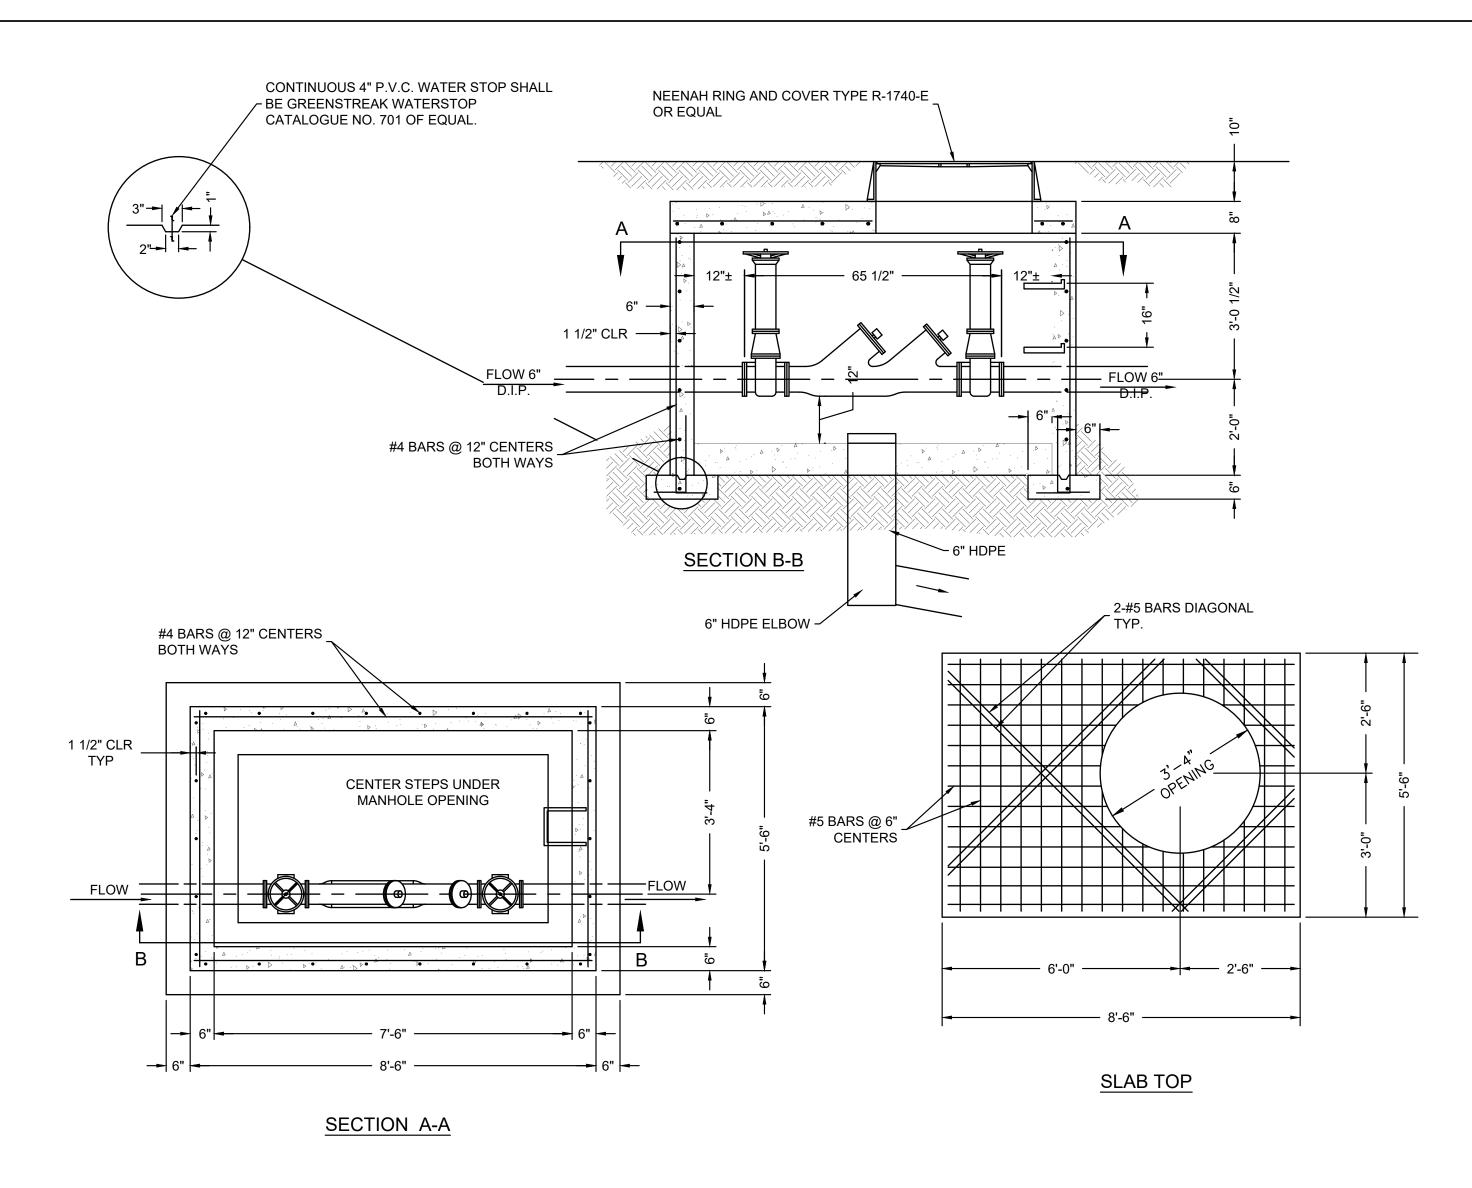1. POUR FOOTING ON FIRM UNDISTURBED EARTH.

2. ALL PIPING IN METER PIT SHALL BE D.I.P.

3. WALLS TO BE DOUBLE FORMED.

4. ALL REBARS TO HAVE 1 1/2" CLEARENCE.

5. CONCRETE SHALL BE M.C.I.B. A543-1-4.

6. LADDER SHALL BE CONSTRUCTED WITH 2"x2"x1/4" STEEL VERTICAL SIDE STRAPS DRILLED AT 16" CENTERS AND 3/4" REBAR STEPS INSERTED AND WELDED IN PLACE. INSIDE STEP WIDTH TO BE 12". LADDER SHALL BE FASTENED TO 2"x2"x1/8" ANGLE IRON. ANCHOR PLATES SHALL BE FASTENED TO TOP SLAB AND BOTTOM ANCHOR SLAB. LADDER SHALL BE GALVANIZED AFTER FABRICATION.


6" RESILIENT WEDGE GATE VALVE

FLOW

USC APPROVED 6" DOUBLE CHECK DETECTOR ASSEMBLY OR APPROVED EQUAL

<u>SCHEMATIC</u>

DOUBLE CHECK VALVE BACKFLOW PREVENTOR

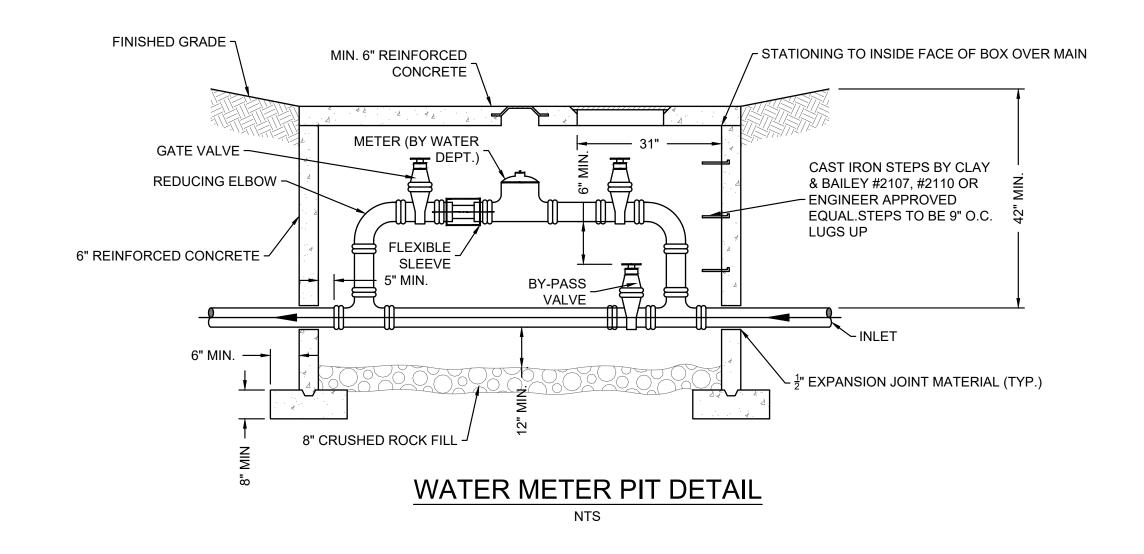



ANS

DESIGNED BY:

N.W.H

SP PROJECT #:

ANS

UNTY, MO

DESIGNED BY:

2023.01.30

2023.02.12.21

REVISED PER CITY COMMENTS

SP PROJECT #:

4024

ANS

NEIL W. HAAS, P.E.

2022.034072

FDP SUBMITTAL

REVISED PER CITY COMMENTS

REVISED PER CITY COMMENTS

A 1024


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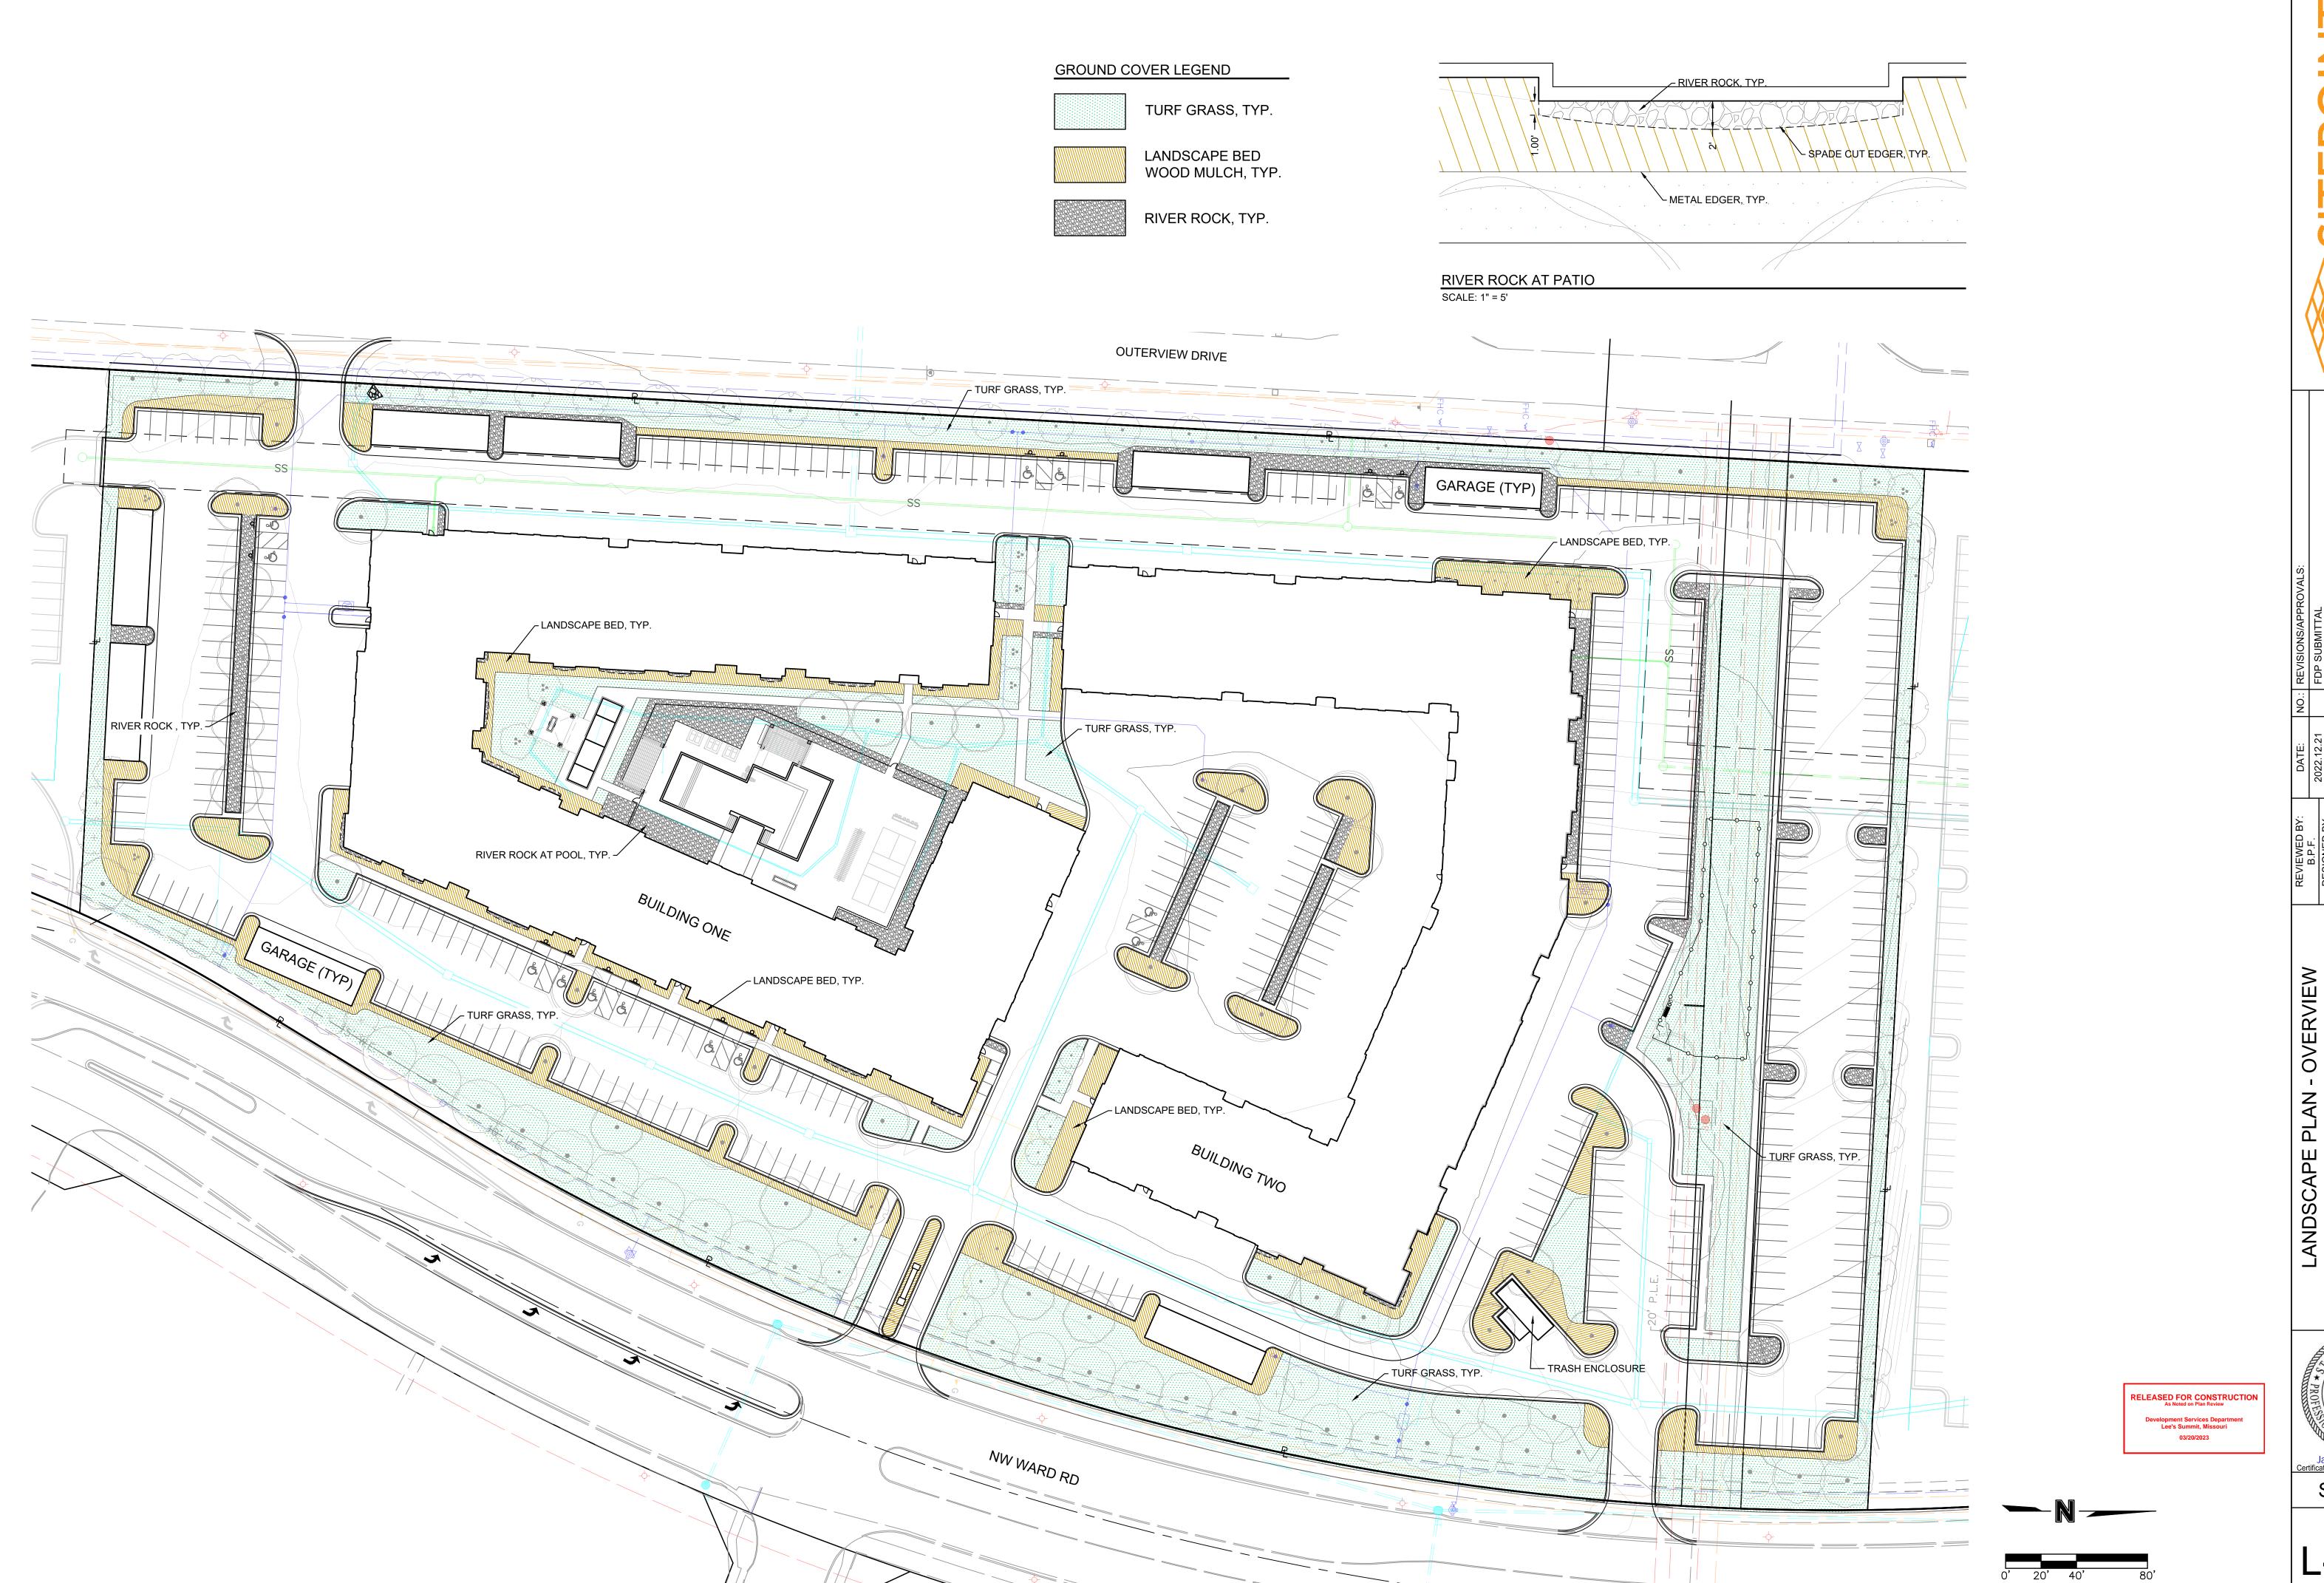
NEIL WHAS NUMBER VE 2022034072
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As Noted on Plan Review

Development Services Department
Lee's Summit, Missouri


03/20/2023





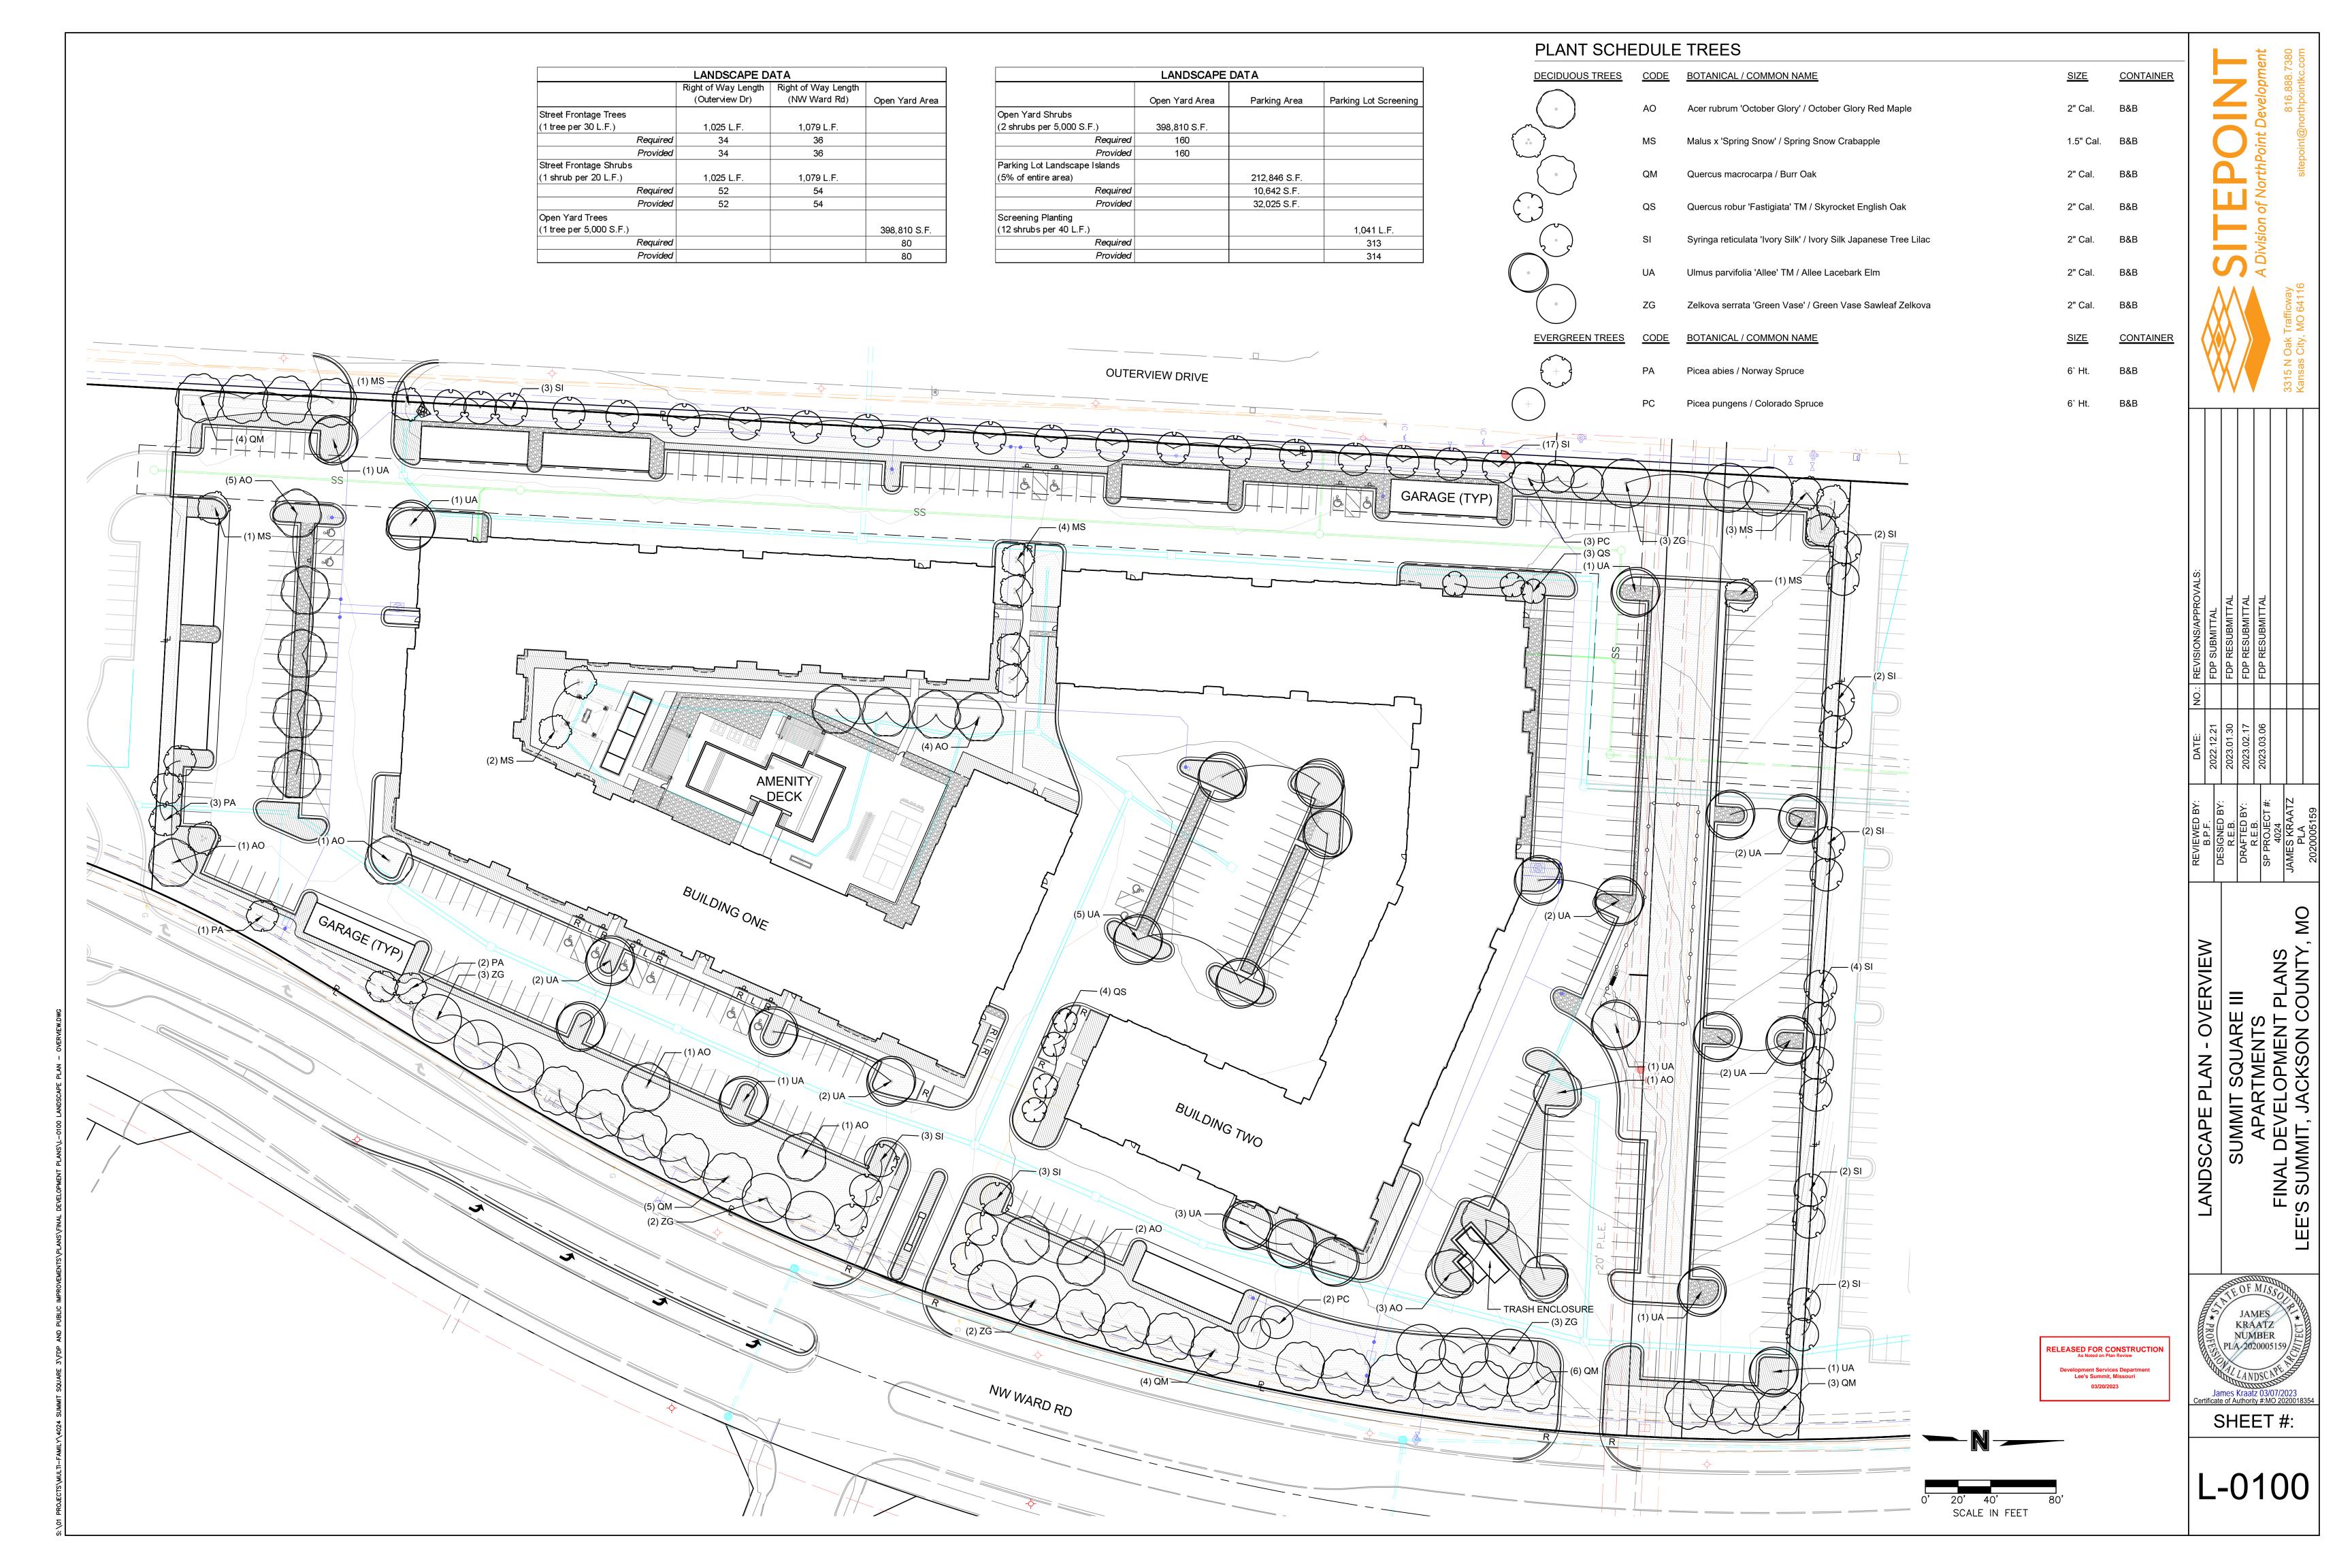



LANDSCAPE PLAN - OVERVIEW
SUMMIT SQUARE III
APARTMENTS
FINAL DEVELOPMENT PLANS
LEE'S SUMMIT, JACKSON COUNTY, M

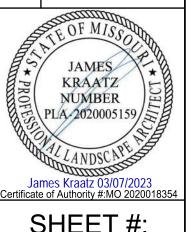



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L-0200



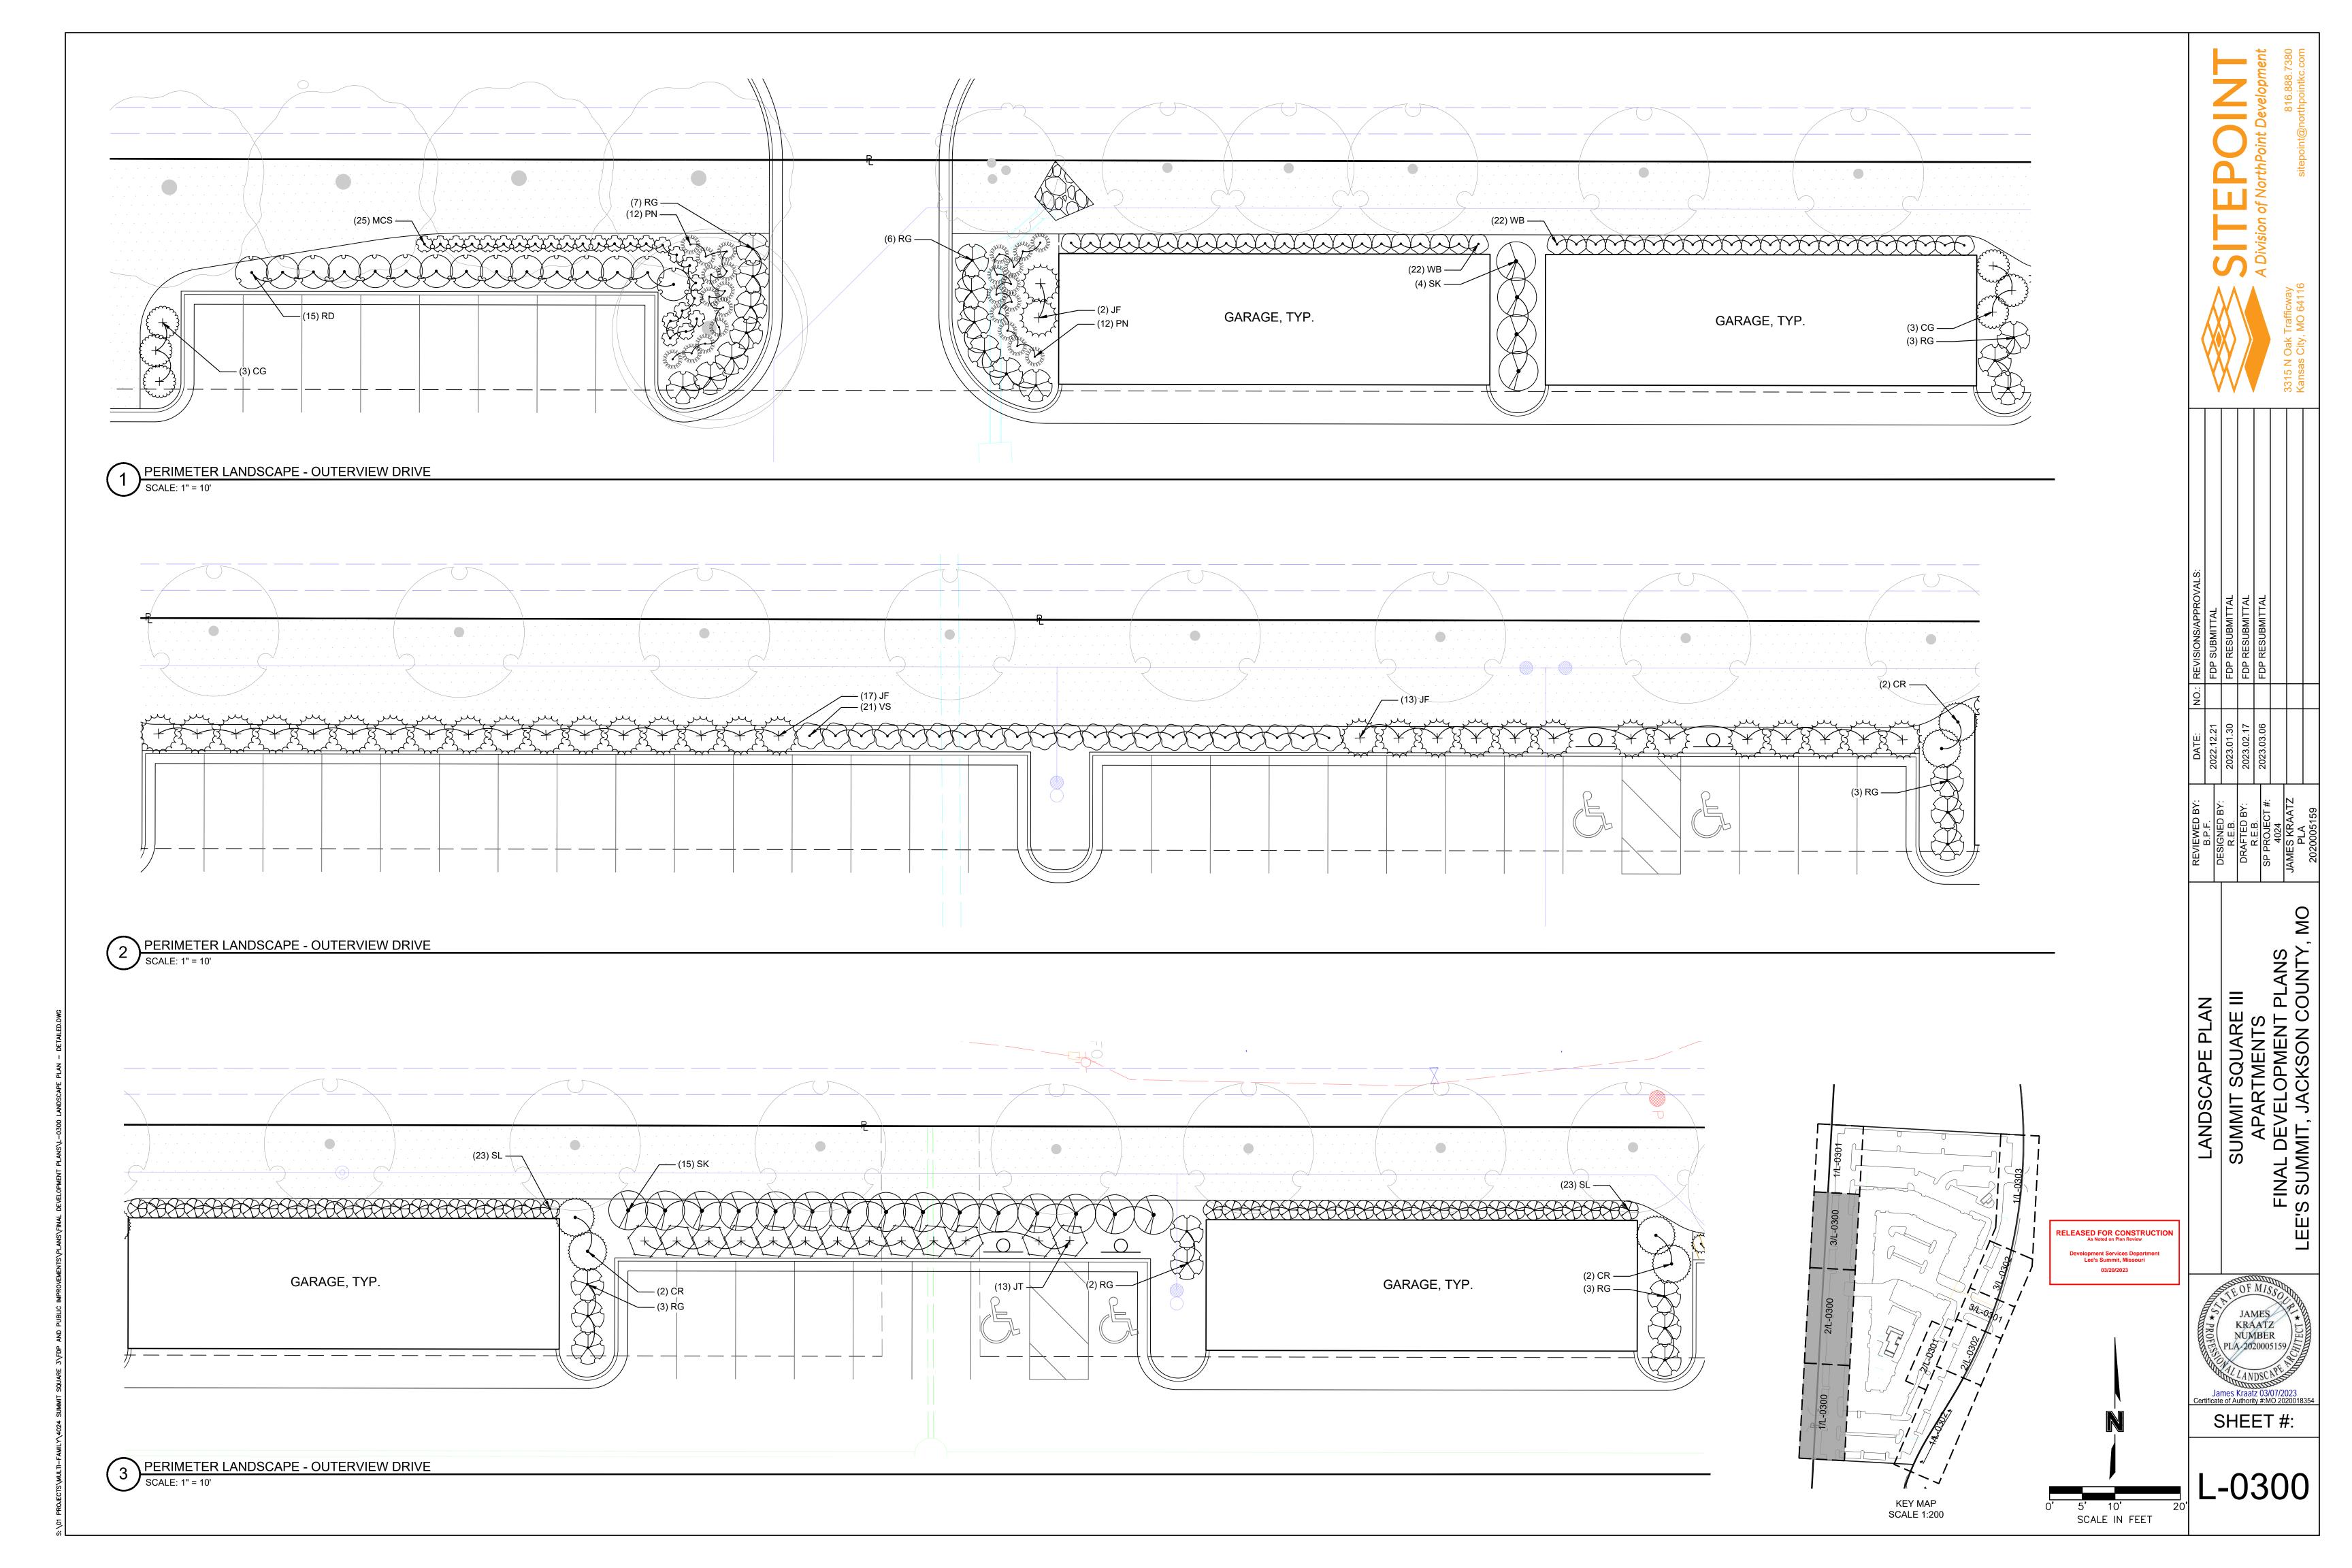


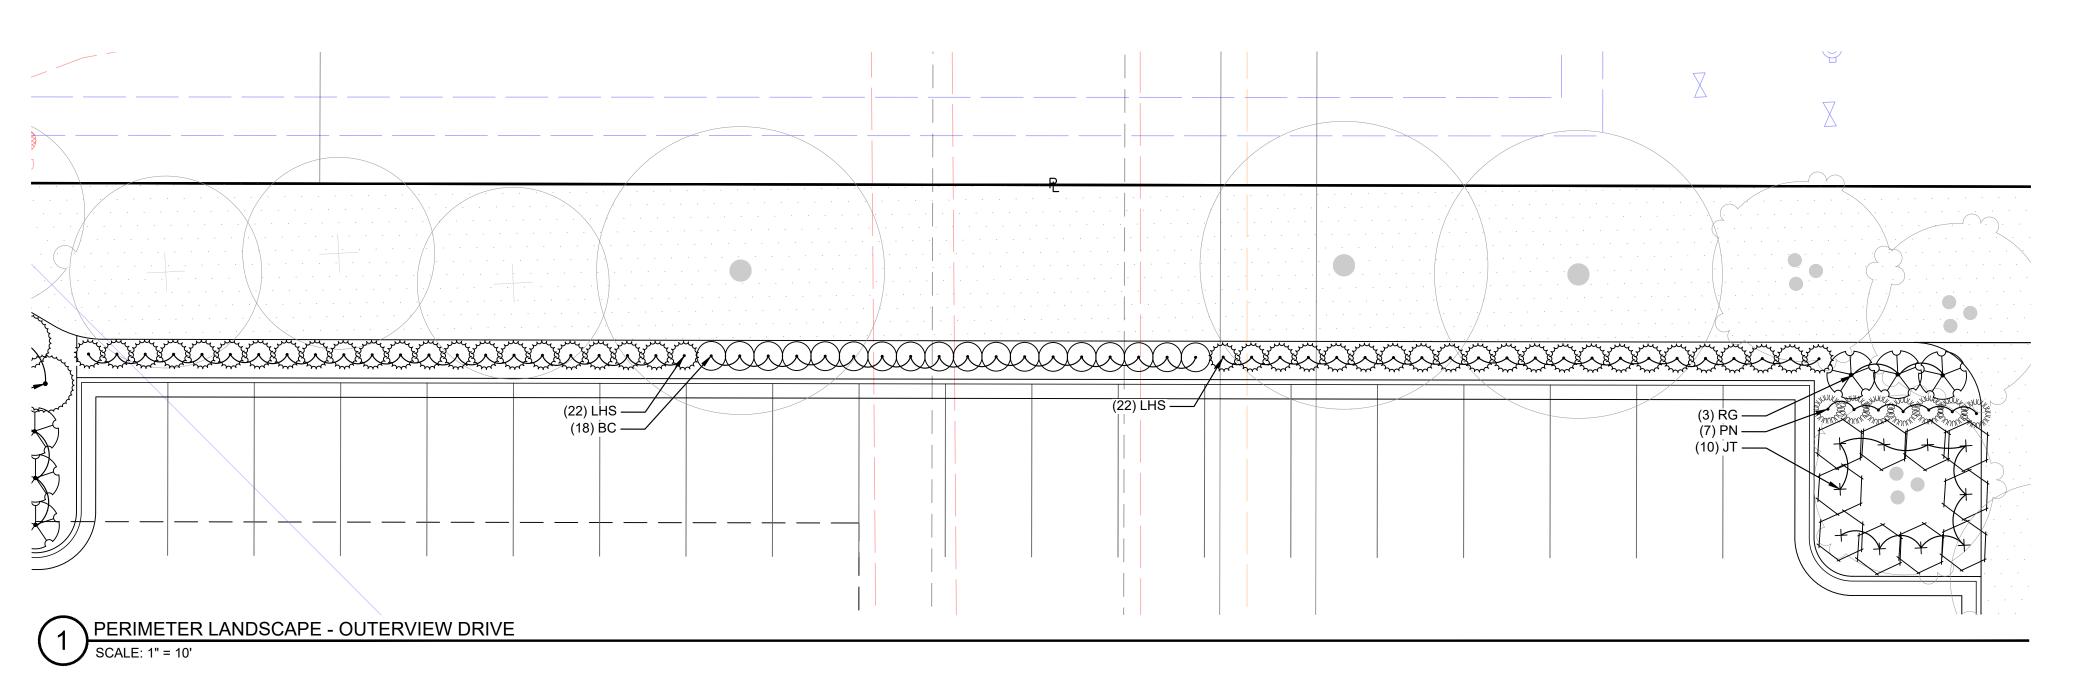

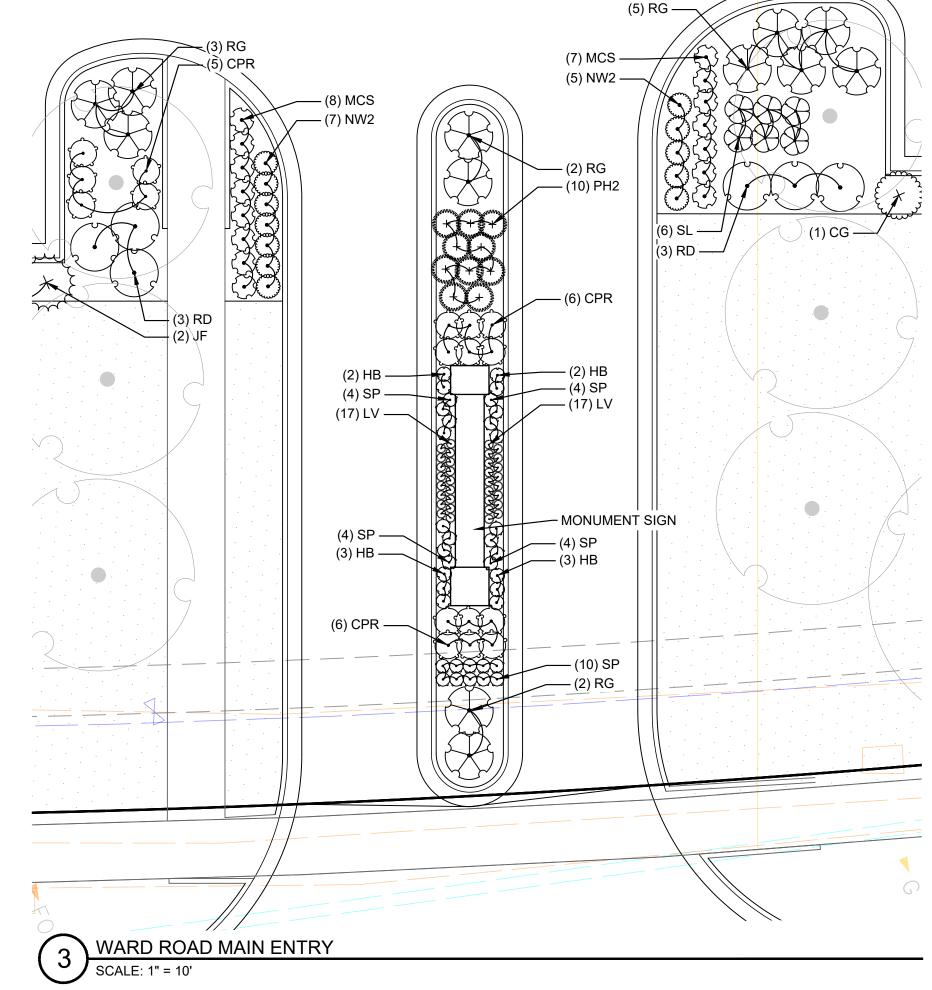


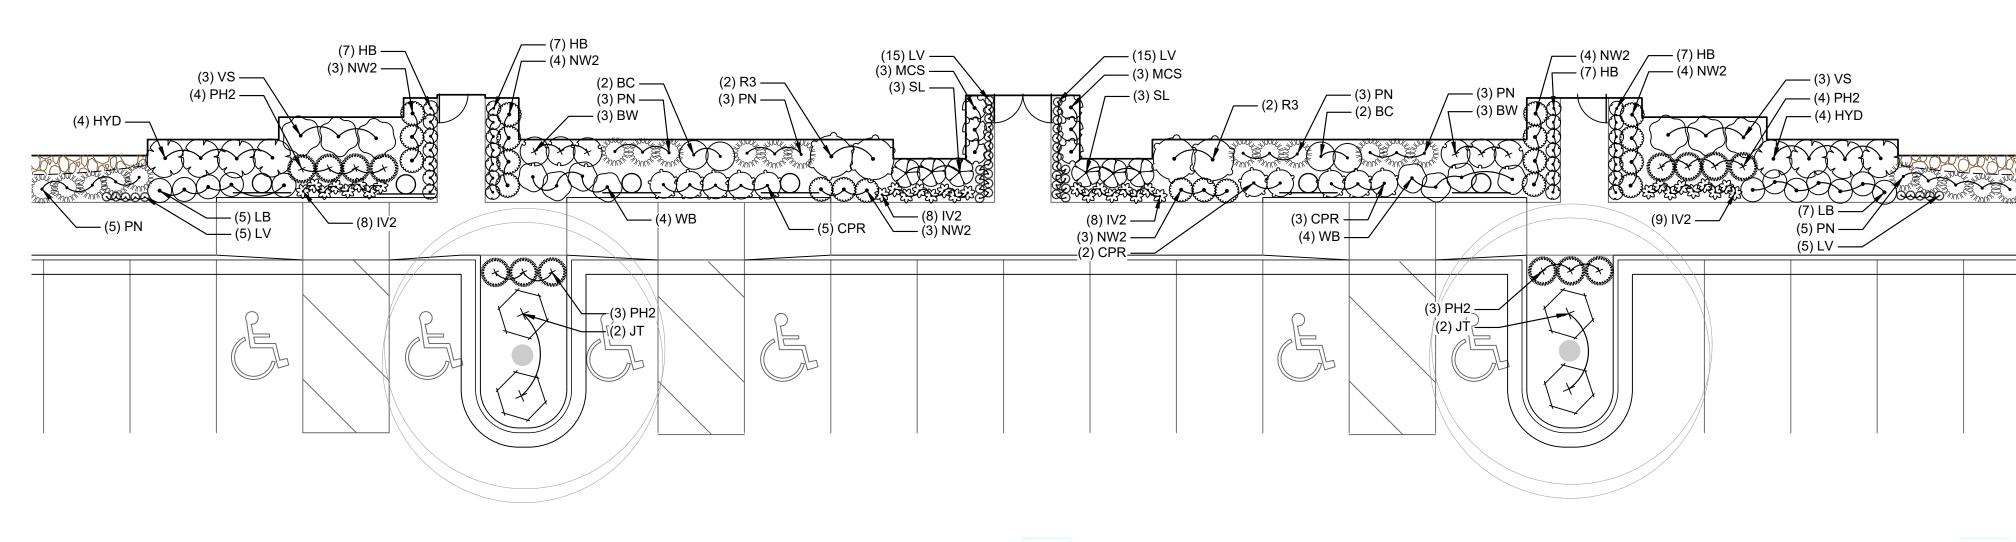CLUBHOUSE ENTRY LANDSCAPE

SCALE: 1" = 10'

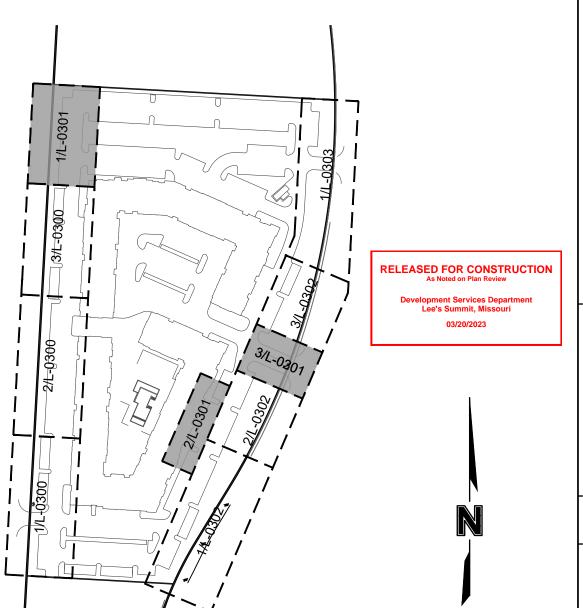



KEY MAP SCALE 1:200

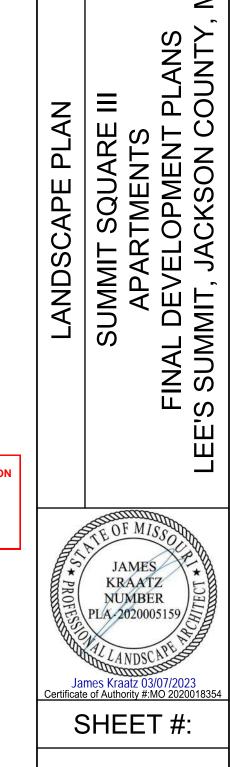

L-0301

0' 5' 10' SCALE IN FEET

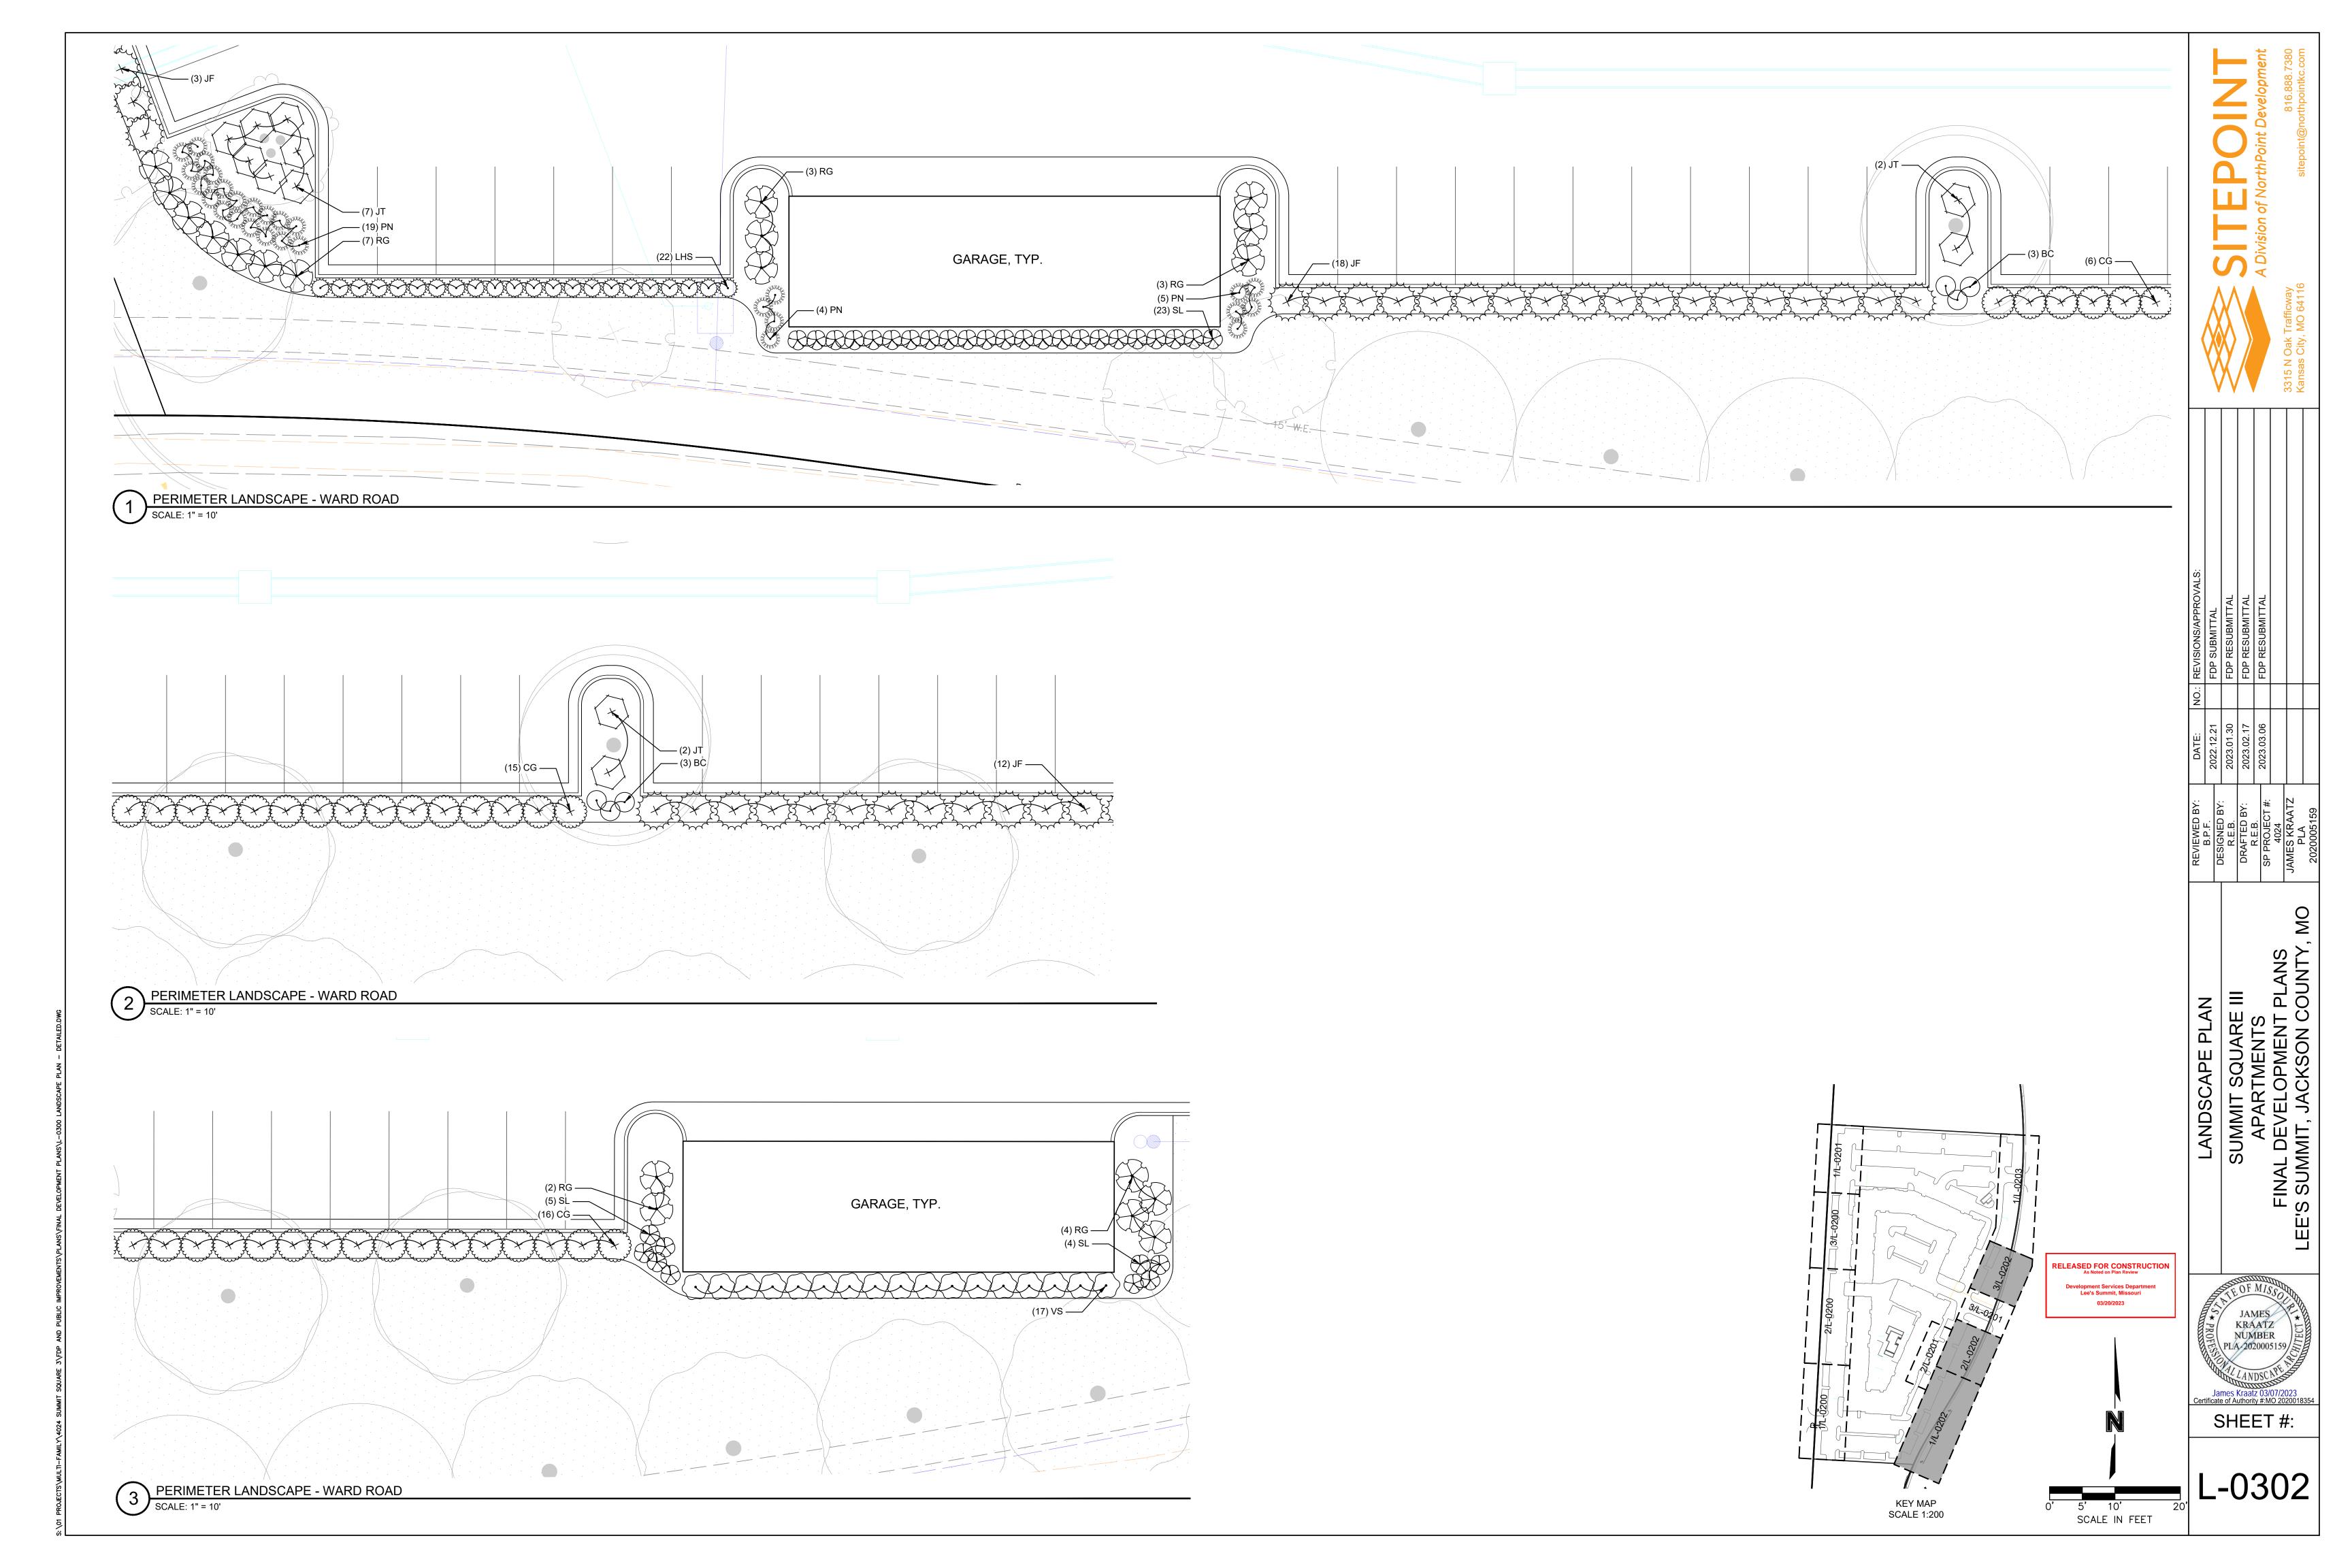


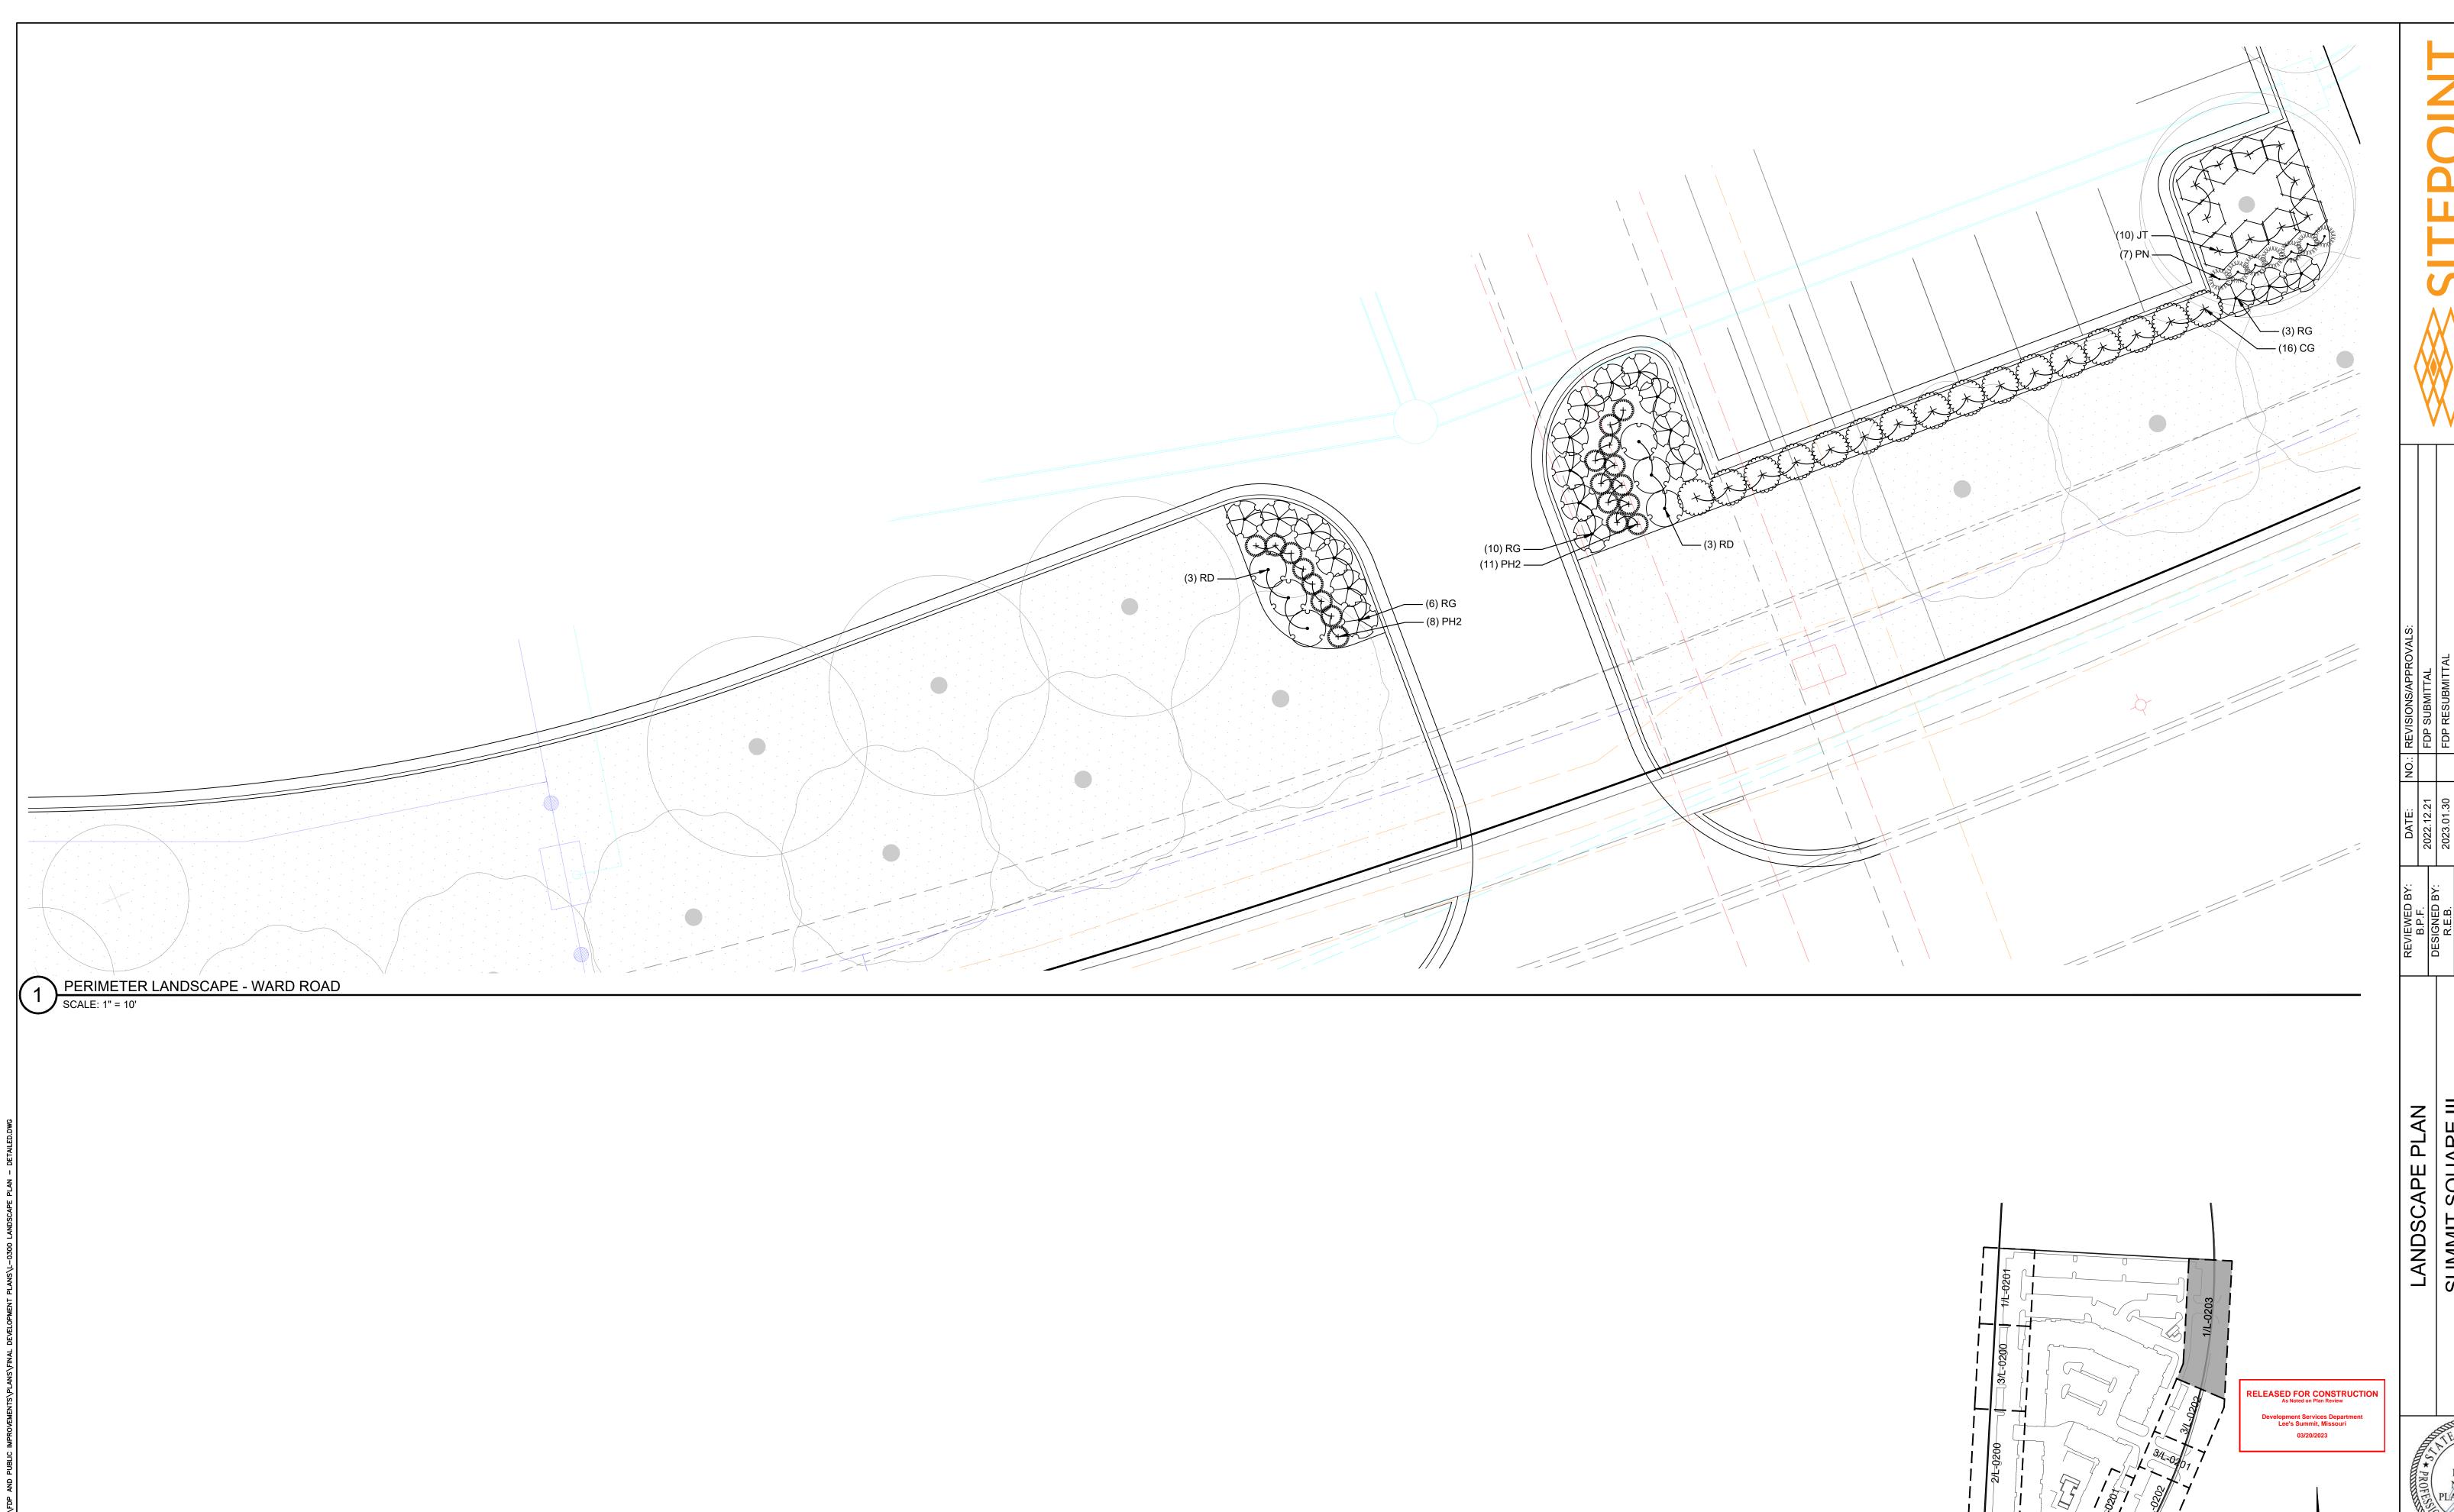



	REVIEWED BY:	DATE:	:: ON	NO.: REVISIONS/APPROVAL
	Б.Т. Т.	2022.12.21		FDP SUBMITTAL
	DESIGNED BY: R.E.B.	2023.01.30		FDP RESUBMITTAL
	DRAFTED BY:	2023.02.17		FDP RESUBMITTAL
	R.E.B.	2023.03.06		FDP RESUBMITTAL
<u>U</u>	4024			
	JAMES KRAATZ			
, <u>M</u> C	2020005159			

LANDSCAPE PLAN
SUMMIT SQUARE III
APARTMENTS
FINAL DEVELOPMENT PLANS
LEE'S SUMMIT, JACKSON COUNTY

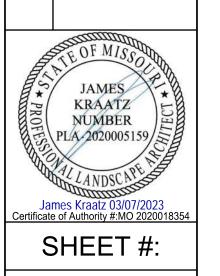

L-0303

5' 10' SCALE IN FEET

KEY MAP SCALE 1:200

PLANT SCHEDULE TREES

PLANT SCH	EDULE	TREES			
DECIDUOUS TREES	CODE	BOTANICAL / COMMON NAME	SIZE	CONTAINER	<u>QTY</u>
	АО	Acer rubrum 'October Glory' / October Glory Red Maple	2" Cal.	B&B	19
	MS	Malus x 'Spring Snow' / Spring Snow Crabapple	1.5" Cal.	B&B	13
$\left(\cdot \right)$	QM	Quercus macrocarpa / Burr Oak	2" Cal.	B&B	22
	QS	Quercus robur 'Fastigiata' TM / Skyrocket English Oak	2" Cal.	B&B	7
· >	SI	Syringa reticulata 'Ivory Silk' / Ivory Silk Japanese Tree Lilac	2" Cal.	B&B	40
•	UA	Ulmus parvifolia 'Allee' TM / Allee Lacebark Elm	2" Cal.	B&B	25
•	ZG	Zelkova serrata 'Green Vase' / Green Vase Sawleaf Zelkova	2" Cal.	B&B	13
EVERGREEN TREES	CODE	BOTANICAL / COMMON NAME	SIZE	CONTAINER	<u>QTY</u>
(+)	PA	Picea abies / Norway Spruce	6` Ht.	B&B	6
(+)	PC	Picea pungens / Colorado Spruce	6` Ht.	B&B	5
<u>SHRUBS</u>	CODE	BOTANICAL / COMMON NAME	SIZE	CONTAINER	<u>QTY</u>
\odot	ВС	Berberis thunbergii 'Crimson Pygmy' / Crimson Pygmy Japanese Barberry	5 gal.	Container	50
\odot	CR	Cornus sericea / Red Twig Dogwood	5 gal.	Container	6
\odot	HYD	Hydrangea macrophylla 'Bailmer' / Endless Summer® Hydrangea	2 gal.	Container	38
**************************************	LHS	Itea virginica 'Henry's Garnet' / Henry's Garnet Sweetspire	2 gal.	Container	66
\otimes	RG	Rhus aromatica 'Gro-Low' / Gro-Low Fragrant Sumac	2 gal.	Container	122
\bigcirc	CPR	Rosa x 'Flower Carpet Appleblossom' / Flower Carpet® Appleblossom Groundcover Rose	2 gal.	Container	45
\odot	R3	Rosa x 'Radtko' TM / Double Knock Out Red Rose	5 gal.	Container	10
	RD	Rosa x 'Radtkopink' TM / Pink Double Knock Out Rose	5 gal.	Container	39
\bigcirc	MCS	Spiraea japonica 'Walbuma' / Magic Carpet Japanese Spirea	2 gal.	Container	89
\otimes	SL	Spiraea x bumalda 'Little Princess' / Little Princess Spirea	5 gal.	Container	110
\bigcirc	SK	Syringa pubescens patula 'Miss Kim' / Miss Kim Korean Lilac	5 gal.	Container	23
\odot	VC	Viburnum carlesii / Koreanspice Viburnum	5 gal.	Container	12
\odot	VS	Viburnum plicatum tomentosum 'Summer Snowflake' / Summer Snowflake Viburnum	2 gal.	Container	66
\odot	WB	Weigela florida 'Bramwell' / Fine Wine® Weigela	2 gal.	Container	57
<u>EVERGREEN</u>	CODE	BOTANICAL / COMMON NAME	SIZE	CONTAINER	QTY
(+)	BW	Buxus sinica insularis 'Wintergreen' / Wintergreen Korean Boxwood	5 gal.	Container	6
(+)	CG	Chamaecyparis pisifera 'Golden Mop' / Golden Mop Threadleaf Sawara Cypress	5 gal.	Container	60
*** *********************************	JF	Juniperus chinensis 'Sea Green' / Sea Green Juniper	5 gal.	Container	71
+	JT	Juniperus sabina 'Tamariscifolia' / Tamarix Juniper	5 gal.	Container	93
GRASSES	CODE	BOTANICAL / COMMON NAME	<u>SIZE</u>	CONTAINER	<u>QTY</u>
Manufacture Comments of the Co	CK	Calamagrostis x acutiflora 'Karl Foerster' / Karl Foerster Feather Reed Grass	3 gal.	Container	21
Man Annards Annards Annards	LV	Liriope muscari 'Variegata' / Variegated Lilyturf	#1	Pot	116
Market State of the State of th	PN	Panicum virgatum 'Northwind' / Northwind Switch Grass	1 gal.	Container	141
+	PH2	Pennisetum alopecuroides 'Hameln' / Hameln Fountain Grass	3 gal.	Container	89
PERENNIALS	<u>CODE</u> HB	BOTANICAL / COMMON NAME Hemerocallis x 'Black Eyed Stella' / Black Eyed Stella Daylily	<u>SIZE</u> 1 gal.	<u>CONTAINER</u> Container	<u>QTY</u> 78
	IV2	Iris virginica / Blue Flag Iris	1 gal.	Container	46
	LB	Leucanthemum x superbum 'Becky' / Becky Shasta Daisy	1 gal.	Container	40
\odot			_		
	NW2	Nepeta x 'Walker's Low' / Walker's Low Catmint	1 gal.	Container	42
(·)	SP	Salvia nemorosa / Meadow Sage	1 gal.	Container	33

GENERAL NOTES:

- 1. ALL PLANTS MUST BE HEALTHY AND FREE OF PESTS AND DISEASE.
- 2. ALL TREES MUST BE STRAIGHT TRUNKED AND MEET ALL SPECIFICATIONS.
- 3. ALL PLANTS ARE SUBJECT TO APPROVAL OF NORTHPOINT DEVELOPMENT BEFORE, DURING, AND AFTER INSTALLATION.
- 4. ALL PLANTS MUST BE INSTALLED PER DETAILS.
- 5. THE CONTRACTOR SHALL BE RESPONSIBLE FOR LOCATING ALL UTILITIES AND SHALL AVOID DAMAGE TO THEM. UNDERGROUND UTILITIES ARE INDICATED ON PLANS ARE APPROXIMATE LOCATIONS. CONTRACTOR SHALL CALL UTILITY LOCATING SERVICES.
- 6. CONTRACTOR IS RESPONSIBLE FOR REPAIRING ALL DAMAGE TO UTILITIES, STRUCTURES, SITE APPURTENANCES, ETC. WHICH OCCURS AS A RESULT OF THE LANDSCAPE CONSTRUCTION.
- 7. CONTRACTOR IS RESPONSIBLE FOR VERIFYING ALL QUANTITIES INDICATED ON THE PLANS. 8. CONTRACTOR IS RESPONSIBLE FOR MAINTAINING ALL PLANTS AND LAWN UNTIL THE WORK IS
- ACCEPTED BY NORTHPOINT DEVELOPMENT. 9. CONTRACTOR SHALL GUARANTEE ALL PLANT MATERIAL FOR A PERIOD OF ONE YEAR FROM THE ACCEPTANCE OF THE LANDSCAPING. CONTRACTOR SHALL REPLACE ALL DEAD AND DYING PLANTS
- AT THE END OF THE GUARANTEE TIME. 10. ALL PLANTS THAT DIES, DEFOLIATES, OR TURNS BROWN PRIOR TO ACCEPTANCE BY NORTHPOINT
- DEVELOPMENT SHALL BE REPLACED. 11. ALL PLANT MATERIAL SHALL CONFORM TO AMERICAN STANDARD FOR NURSERY STOCK.
- 12. MULCH OR RIVER ROCK SHALL BE INSTALLED IN ALL PLANTING BEDS, AROUND TREES, AND SHALL BE 3" THICK AS INDICATED ON THE PLANS AND DETAILS.
- 13. CONTRACTOR SHALL KEEP THE WORKSITE CLEAN AND REMOVE ALL WASTE MATERIALS FOR DISPOSAL PER LOCAL, STATE, AND FEDERAL REGULATIONS.
- 14. CONTRACTOR SHALL SEED ALL DISTURBED AREAS THAT ARE NOT INDICATED ON PLANS.

SODDING NOTES:

- 1. ALL AREAS SPECIFIED AS "SOD" SHALL BE SODDED WITH EITHER STRIPS OR ROLLS OF SOD
- SPECIES AS INDICATED IN THE PLANT LIST. CONTRACTOR SHALL VERIFY QUANTITIES. 2. AREA WHERE SOD IS TO BE INSTALLED SHALL BE FREE OF STONE, STICKS, AND OTHER FOREIGN MATERIALS.
- 3. SURFACE SHALL BE RACKED TO A SMOOTH SURFACE AND BE FREE OF DEPRESSIONS AND MOUNDS.
- 4. LAY SOD WITHIN 24 HOURS OF STRIPPING. DO NOT LAY SOD IF DORMANT OR IF GROUND IS FROZEN. PROTECT SOD FROM BREAKAGE AND DRYING.
- 5. LAY SOD TO FORM A SOLID MASS WITH TIGHTLY FITTED JOINTS. BUTT ENDS AND SIDES OF SOD. STAGGER SOD TO OFFSET JOINTS IN ADJACENT COURSES. AVOID DAMAGE TO SUBGRADE OR SOD DURING INSTALLATION.
- 6. FILL IN ALL GAPS WITH PIECES OF SOD AND REMOVE EXCESS SOD.
- 7. LAY SOD ACROSS ANGLE OF SLOPES EXCEEDING 1:4.
- 8. ANCHOR SOD ON SLOPES EXCEEDING 1:4 WITH WOOD PEGS TO PREVENT SLIPPAGE.
- 9. AFTER SOD HAS BEEN INSTALLED, ROLL AND SATURATE SOD WITH FINE WATER SPRAY WITHIN 2 HOURS OF PLANTING. DURING FIRST WEEK, WATER DAILY OR MORE FREQUENTLY AS NEEDED TO MAINTAIN MOIST SOIL TO A MINIMUM DEPTH OF 1-1/2 INCHES (38 MM) BELOW THE SOD. ROLL SOD
- TO ENSURE CONTACT WITH SOIL SURFACE. 10. TWO WEEKS AFTER SOD INSTALLATION, APPLY FERTILIZER AT RECOMMENDED RATE FOR NEWLY ESTABLISHED LAWNS.
- 11. CONTRACTOR SHALL MAINTAIN TURF UNTIL ACCEPTED BY NORTHPOINT DEVELOPMENT. MAINTENANCE SHALL INCLUDE BUT NOT BE LIMITED TO: WATERING, FERTILIZING, WEEDING, MOWING, TRIMMING, AND ROLLING. CONTRACTOR SHALL REGRADE AND REPLANT AS
- NECESSARY TO ESTABLISH A SMOOTH SODDED SURFACE, FREE OF ERODED OR BARE AREAS, FREE OF WEEDS AND ACCEPTABLE TO NORTHPOINT DEVELOPMENT.

SEEDING NOTES:


- 1. ALL AREAS SPECIFIED AS "SEED" SHALL BE HYDROSEEDED WITH SEED SPECIES AS INDICATED ON PLANT LIST. CONTRACTOR SHALL VERIFY QUANTITIES.
- 2. AREA WHERE SEED IS TO BE INSTALLED SHALL BE FREE OF STONE, STICKS, AND OTHER FOREIGN MATERIALS.
- 3. SURFACE SHALL BE RAKED TO A SMOOTH SURFACE AND BE FREE OF DEPRESSIONS AND MOUNDS.
- 4. HYDROSEEDING MIX SHALL CONSIST OF SEED, FERTILIZER, AND FIBER MULCH.
- 5. ALL DISTURBED AREAS SHALL BE HYDROSEEDED. 6. SEEDED AREAS WILL BE ACCEPTED BY NORTHPOINT DEVELOPMENT WHEN SEED HAS SPROUTED, ESTABLISHED, FREE OF WEEDS AND BARE AREAS.

MULCH NOTES:

- 1. ALL PLANTING AREAS SHALL BE COVERED WITH 3" OF BROWN HARDWOOD MULCH OR 3" OF RIVER ROCK AS INDICATED ON THE PLANS AND DETAILS.
- 2. MULCH SHALL BE FREE OF ROCKS AND OTHER FOREIGN MATERIAL.
- 3. RIVER ROCK SHALL BE 1-3" IN SIZE, ROUNDED EDGES, SMOOTH SURFACE, WASHED AND FREE OF FINES AND OTHER DEBRIS.
- 4. ALL AREAS RECEIVING RIVER ROCK SHALL HAVE VIGORO WEEDBLOCK FILM INSTALLED BETWEEN THE ROCK AND SOIL.
- 5. CONTRACTOR SHALL SUBMIT SAMPLE OF RIVER ROCK TO NORTHPOINT DEVELOPMENT REPRESENTATIVE FOR APPROVAL.

METAL EDGING:

- 1. ALL AREAS RECEIVING RIVER ROCK SHALL BE SEPARATED FROM TURF AREAS WITH METAL
- 2. METAL EDGING SHALL BE INSTALLED FREE OF KINKS AND ABRUPT BENDS.
- 3. METAL EDGING SHALL BE SECURED WITH STAKES DRIVEN INTO THE GROUND.

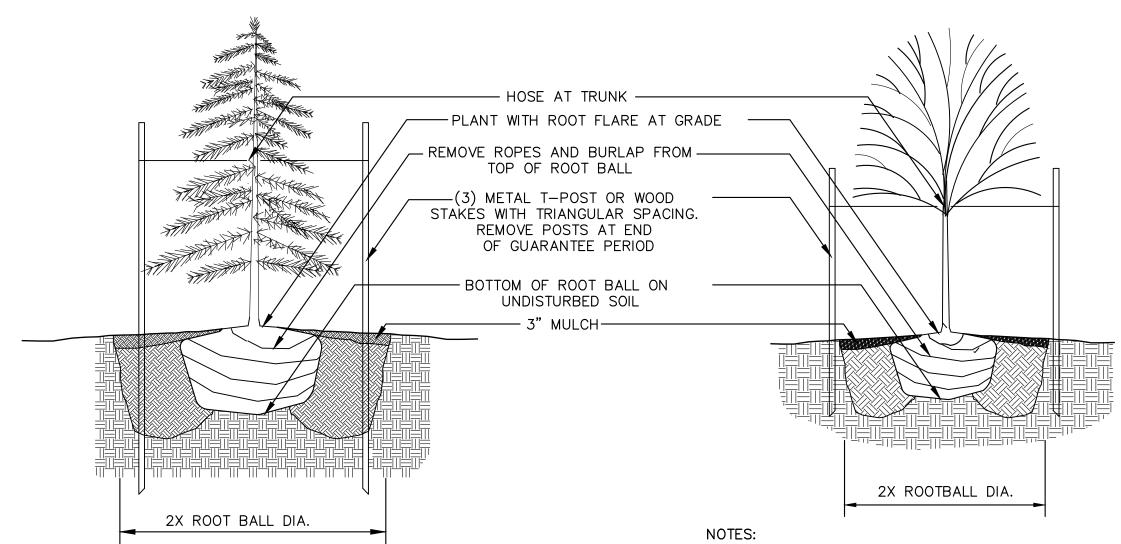

1. IN TURF AREA, PROVIDE 6' DIAMETER OF MULCH Evergreen Tree Planting Detail not to scale

2X ROOT BALL DIA.

not to scale


Shrub Planting Detail

-SHRUB AT GRADE

REMOVE FROM CONTAINER


-3" MULCH

1. IN TURF AREA, PROVIDE 6' DIAMETER OF MULCH Deciduous Tree Planting Detail

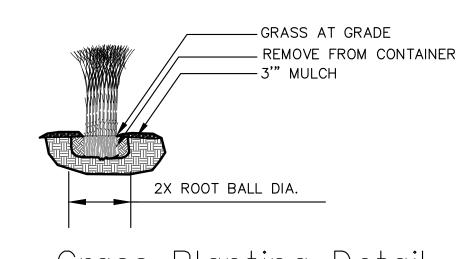

Grass Planting Detail not to scale


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> As Noted on Plan Review Development Services Department Lee's Summit, Missouri

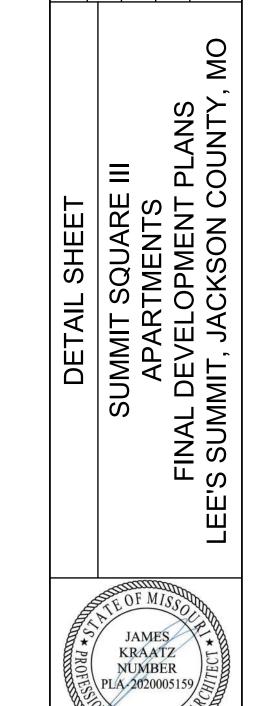

James Kraatz 03/07/2023 rtificate of Authority #:MO 202001835 SHEET #:


BUILDING 1 - EAST ELEVATION - SOUTH

1/8" = 1'-0"

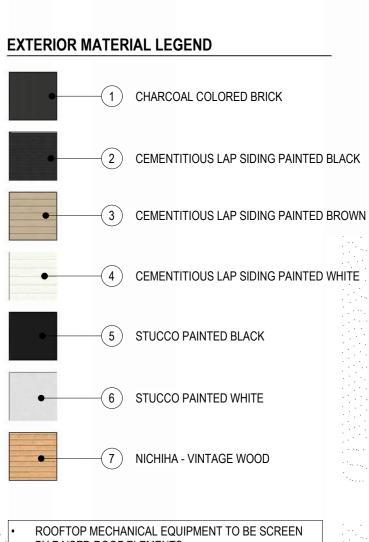

BY RAISED ROOF ELEMENTS REFER TO ELEVATIONS FOR EXTENT OF ROOF LINE

BLDG. 1 - KEY PLAN

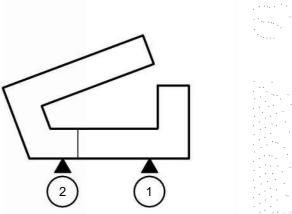

SUMMIT, MO WARD A NEW RESIDENTIAL D D D I Z I 800 & 810 NW

NOT FOR CONSTRUCTION

 \bigotimes DRAWING RELEASE LOG

• 08.26.2022 - PLAN REVIEW

• 12.16.2022 - PROGRESS SET

• 01.20.2023 - PROGRESS SET

△REVISIONS

JOB NO. **705922** DATE **01.20.2023** DRAWN BY TSC/SIW

1/27/2023 FDP RESUBMITTAL

SHEET NAME BLDG. 1 - ELEVATIONS

RELEASED FOR CONSTRUCTION
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Development Services Department Lee's Summit, Missouri





BUILDING 1 - WEST ELEVATION - SOUTH

1/8" = 1'-0"



BUILDING 1 - SOUTH ELEVATION

1/8" = 1'-0"

EXTERIOR MATERIAL LEGEND 1 CHARCOAL COLORED BRICK -(2) CEMENTITIOUS LAP SIDING PAINTED BLAC $^{\perp}_{0}$ $\stackrel{=}{\sim}$ — 3 CEMENTITIOUS LAP SIDING PAINTED BROV **TS** PA COLITE 201 $-\!(4)$ CEMENTITIOUS LAP SIDING PAINTED WHIT 5 STUCCO PAINTED BLACK 6 STUCCO PAINTED WHITE (7) NICHIHA - VINTAGE WOOD ROOFTOP MECHANICAL EQUIPMENT TO BE SCREEN

BY RAISED ROOF ELEMENTS REFER TO ELEVATIONS FOR EXTENT OF ROOF LINE



SUMMIT,

A NEW RESIDENTIAL COMMUN WARD RD 800 & 810 NW DO IZ


 \bigotimes DRAWING RELEASE LOG

• 08.26.2022 - PLAN REVIEW

• 12.16.2022 - PROGRESS SET

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△REVISIONS

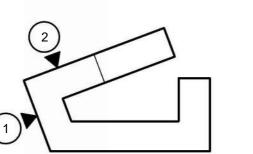

BLDG. 1 - KEY PLAN

RELEASED FOR CONSTRUCTION
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JOB NO. **705922** DATE **01.20.2023** DRAWN BY TSC/SIW 1/27/2023 FDP RESUBMITTAL SHEET NAME BLDG. 1 - ELEVATIONS

SHEET NO.

Ш BUILDING 1 - NORTH ELEVATION

1/8" = 1'-0"

EXTERIOR MATERIAL LEGEND 1 CHARCOAL COLORED BRICK — 2 CEMENTITIOUS LAP SIDING PAINTED BLACK 3 CEMENTITIOUS LAP SIDING PAINTED BROWN CEMENTITIOUS LAP SIDING PAINTED WHITE 5 STUCCO PAINTED BLACK 6 STUCCO PAINTED WHITE 7 NICHIHA - VINTAGE WOOD

ROOFTOP MECHANICAL EQUIPMENT TO BE SCREEN BY RAISED ROOF ELEMENTS
REFER TO ELEVATIONS FOR EXTENT OF ROOF LINE

BLDG. 1 - KEY PLAN

RELEASED FOR CONSTRUCTION
As Noted on Plan Review

Development Services Department Lee's Summit, Missouri



NEW RESIDENTIAL COMMUN WARD RD 800 & 810 NW

 \bigotimes DRAWING RELEASE LOG

• 08.26.2022 - PLAN REVIEW

• 12.16.2022 - PROGRESS SET

• 01.20.2023 - PROGRESS SET

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JOB NO. **705922** DATE **01.20.2023** DRAWN BY TSC/SIW

1/27/2023 FDP RESUBMITTAL SHEET NAME BLDG. 1 - ELEVATIONS



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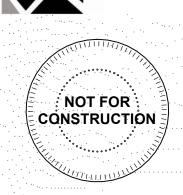
BUILDING 1 - WEST ELEVATION

1/8" = 1'-0"

EXTERIOR MATERIAL LEGEND (1) CHARCOAL COLORED BRICK -(2) CEMENTITIOUS LAP SIDING PAINTED BLAlpha ightharpoons-(3) CEMENTITIOUS LAP SIDING PAINTED BRC — 4 CEMENTITIOUS LAP SIDING PAINTED WH 5 STUCCO PAINTED BLACK 6 STUCCO PAINTED WHITE 7 NICHIHA - VINTAGE WOOD

ROOFTOP MECHANICAL EQUIPMENT TO BE SCREEN BY RAISED ROOF ELEMENTS REFER TO ELEVATIONS FOR EXTENT OF ROOF LINE





A NEW RESIDENTIAL COMMUN WARD RD DO JIX 800 & 810 NW


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BLDG. 1 - KEY PLAN

Development Services Department Lee's Summit, Missouri

JOB NO.
705922
DRAWN BY
TSC/SIW DATE **01.20.2023** 1/27/2023 FDP RESUBMITTAL SHEET NAME
BLDG. 1 - ELEVATIONS



CEMENTITIOUS LAP SIDING PAIN

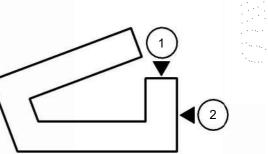CEMENTITIOUS LAP SIDING PAIN

CEMENTITIOUS LAP SIDING PAIN

CEMENTITIOUS LAP SIDING PAIN

STUCCO PAINTED BLACK

STUCCO PAINTED WHITE


NICHIHA - VINTAGE WOOD

ROOFTOP MECHANICAL EQUIPMENT TO BE SCREEN BY RAISED ROOF ELEMENTS

REFER TO ELEVATIONS FOR EXTENT OF ROOF LINE

EXTERIOR MATERIAL LEGEND



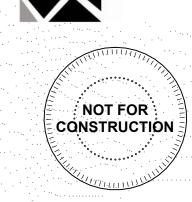

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800 & 810 NW

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BLDG. 1 - COURTYARD EAST - SOUTH

3 21

KEY PLAN



BLDG. 1 - COURTYARD EAST-NORTH

1/8" = 1'-0"

BLDG. 1 - COURTYARD NORTH

1/8" = 1'-0"

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Development Services Department
Lee's Summit, Missouri

03/20/2023

JOB NO. DATE
705922 01.20.2023
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1/27/2023
FDP RESUBMITTAL
SHEET NAME
BLDG. 1 - COURTYARD
ELEVATIONS
SHEET NO.

BLDG. 1 - COURTYARD WEST - NORTH



KEY PLAN

4

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EXTERIOR MATERIAL LEGEND

— 1 CHARCOAL COLORED BRICK

CEMENTITIOUS LAP SIDING PAINTED WHITE

5 STUCCO PAINTED BLACK

6 STUCCO PAINTED WHITE

7 NICHIHA - VINTAGE WOOD

ROOFTOP MECHANICAL EQUIPMENT TO BE SCREEN BY RAISED ROOF ELEMENTS

REFER TO ELEVATIONS FOR EXTENT OF ROOF LINE

(2) CEMENTITIOUS LAP SIDING PAINTED BLACK

(3) CEMENTITIOUS LAP SIDING PAINTED BROWN

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JOB NO. **705922** DATE **01.20.2023** DRAWN BY **TSC/SIW** 1/27/2023

FDP RESUBMITTAL SHEET NAME
BLDG. 1 - COURTYARD
ELEVATIONS

SHEET NO.

1 BLDG. 1 - COURTYARD SOUTH

BLDG. 1 - COURTYARD WEST - SOUTH

BUILDING 2 - WEST ELEVATION - NORTH

1/8" = 1'-0"



BUILDING 2 - WEST ELEVATION - SOUTH

1/8" = 1'-0"

EXTERIOR MATERIAL LEGEND 2 CEMENTITIOUS LAP SIDING PAINTED BLACK (3) CEMENTITIOUS LAP SIDING PAINTED BROWN — 4 CEMENTITIOUS LAP SIDING PAINTED WHITE 5 STUCCO PAINTED BLACK 6 STUCCO PAINTED WHITE (7) NICHIHA - VINTAGE WOOD

ROOFTOP MECHANICAL EQUIPMENT TO BE SCREEN BY RAISED ROOF ELEMENTS REFER TO ELEVATIONS FOR EXTENT OF ROOF LINE



800 & 810 NW WARD RD

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BLDG. 2 - ELEVATIONS

BLDG. 2 - KEY PLAN

BUILDING 2 - NORTH ELEVATION - EAST

1/8" = 1'-0"



BUILDING 2 - NORTH ELEVATION - WEST

CEMENTITIOUS LAP SIDING PAINTED BLACK

CEMENTITIOUS LAP SIDING PAINTED BROWN

CEMENTITIOUS LAP SIDING PAINTED BROWN

CEMENTITIOUS LAP SIDING PAINTED WHITE

STUCCO PAINTED BLACK

STUCCO PAINTED WHITE

NICHIHA - VINTAGE WOOD

ROOFTOP MECHANICAL EQUIPMENT TO BE SCREEN BY RAISED ROOF ELEMENTS
REFER TO ELEVATIONS FOR EXTENT OF ROOF LINE

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POWER BONDONS

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AN WORD ON THE PROPER

CONTROL

CONTR

ARCHITECTS AS 15 W. 75TH ST., SUITE 201



RD. | LEE'S SUMMIT, MO

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TSC/SIW
1/27/2023
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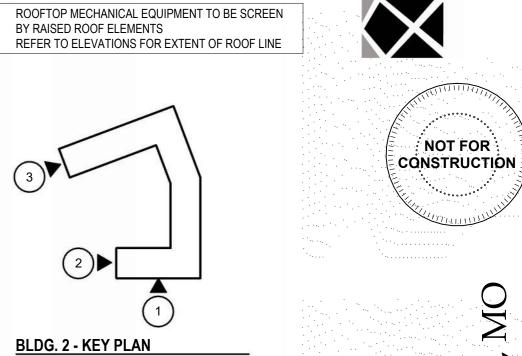
FDP RESUBMITTAL
SHEET NAME
BLDG. 2 - ELEVATIONS

SHEET NO.









EXTERIOR MATERIAL LEGEND

— 1 CHARCOAL COLORED BRICK

(2) CEMENTITIOUS LAP SIDING PAINTED BLACK

(3) CEMENTITIOUS LAP SIDING PAINTED BROWN

(4) CEMENTITIOUS LAP SIDING PAINTED WHITE

5 STUCCO PAINTED BLACK

(6) STUCCO PAINTED WHITE

7 NICHIHA - VINTAGE WOOD

BUILDING 2 - SOUTH - EAST

1/8" = 1'-0"

3 BUILDING 2 - SOUTH - WEST



1 BUILDING 2 - EAST ELEVATION

1/8" = 1'-0"

A-308

DATE **01.20.2023**

A NEW RESIDENTIAL COMMUN

800 & 810 NW

DRAWING RELEASE LOG

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■ 01.20.2023 - PROGRESS SET

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JOB NO. **705922**

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1/27/2023

FDP RESUBMITTAL

SHEET NAME BLDG. 2 - ELEVATIONS




EXTERIOR MATERIAL LEGEND — 2 CEMENTITIOUS LAP SIDING PAINTED BLACK A A B C H A (3) CEMENTITIOUS LAP SIDING PAINTED BROWN — 4 CEMENTITIOUS LAP SIDING PAINTED WHITE (5) STUCCO PAINTED BLACK 6 STUCCO PAINTED WHITE 7 NICHIHA - VINTAGE WOOD ROOFTOP MECHANICAL EQUIPMENT TO BE SCREEN BY RAISED ROOF ELEMENTS REFER TO ELEVATIONS FOR EXTENT OF ROOF LINE

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SUMMIT,

800 & 810 NW WARD RD



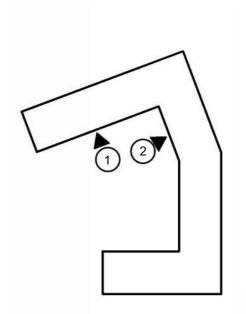

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• 01.20.2023 - PROGRESS SET

JOB NO. **705922** DATE **01.20.2023** DRAWN BY **TSC/SIW** 1/27/2023 FDP RESUBMITTAL SHEET NAME
BLDG. 2 - COURTYARD
ELEVATIONS

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As Noted on Plan Review 03/20/2023

SHEET NO. **A-309**



BLDG. 2 - COURTYARD EAST

1/8" = 1'-0"



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Development Services Department
Lee's Summit, Missouri
03/20/2023

(1) Legislania (2) Le

CEMENTITIOUS LAP SIDING PAINTED BROWN


CEMENTITIOUS LAP SIDING PAINTED BROWN


CEMENTITIOUS LAP SIDING PAINTED WHITE

STUCCO PAINTED BLACK

TO STUCCO PAINTED WHITE

NICHIHA - VINTAGE WOOD

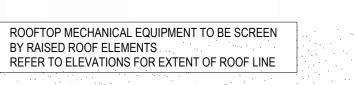

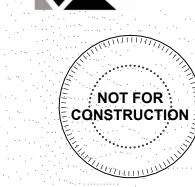

D. | LEE'S SUMMIT, MO


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JOB NO. DATE
705922 01.20.2023
DRAWN BY
TSC/SIW
1/27/2023

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TSC/SIW
1/27/2023
FDP RESUBMITTAL
SHEET NAME
BLDG. 2 - COURTYARD
ELEVATIONS
SHEET NO.

A-310





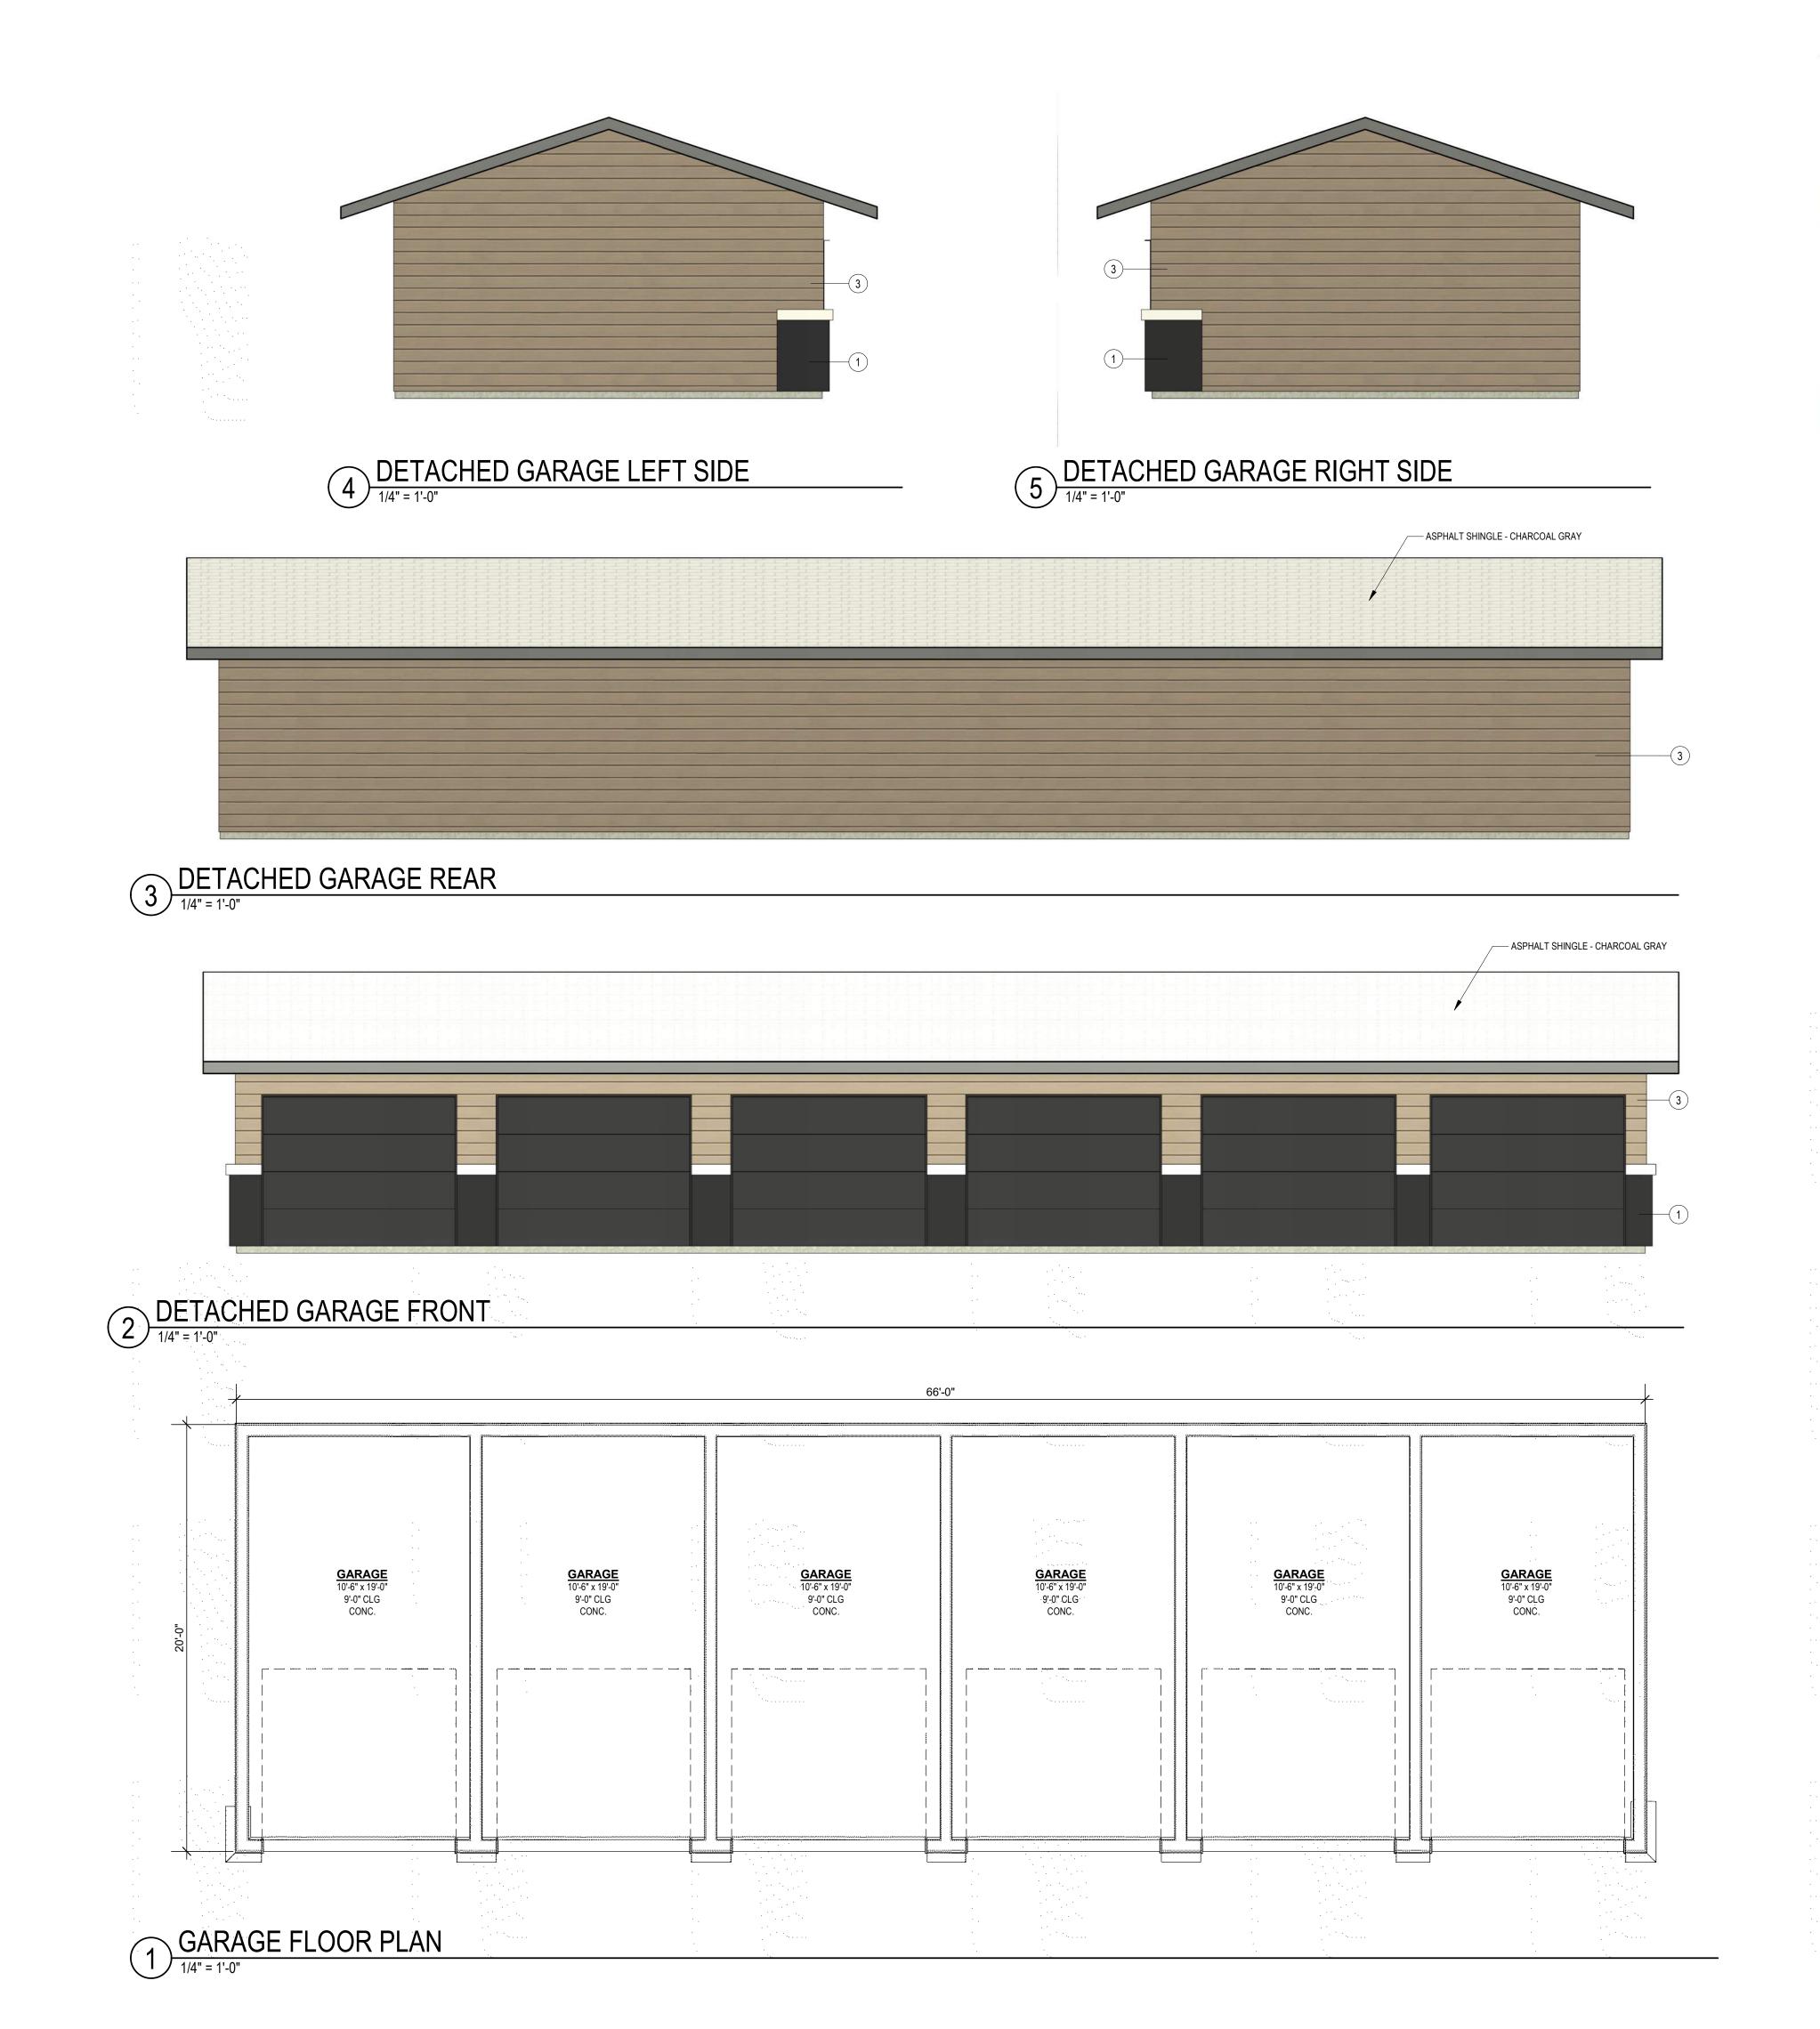



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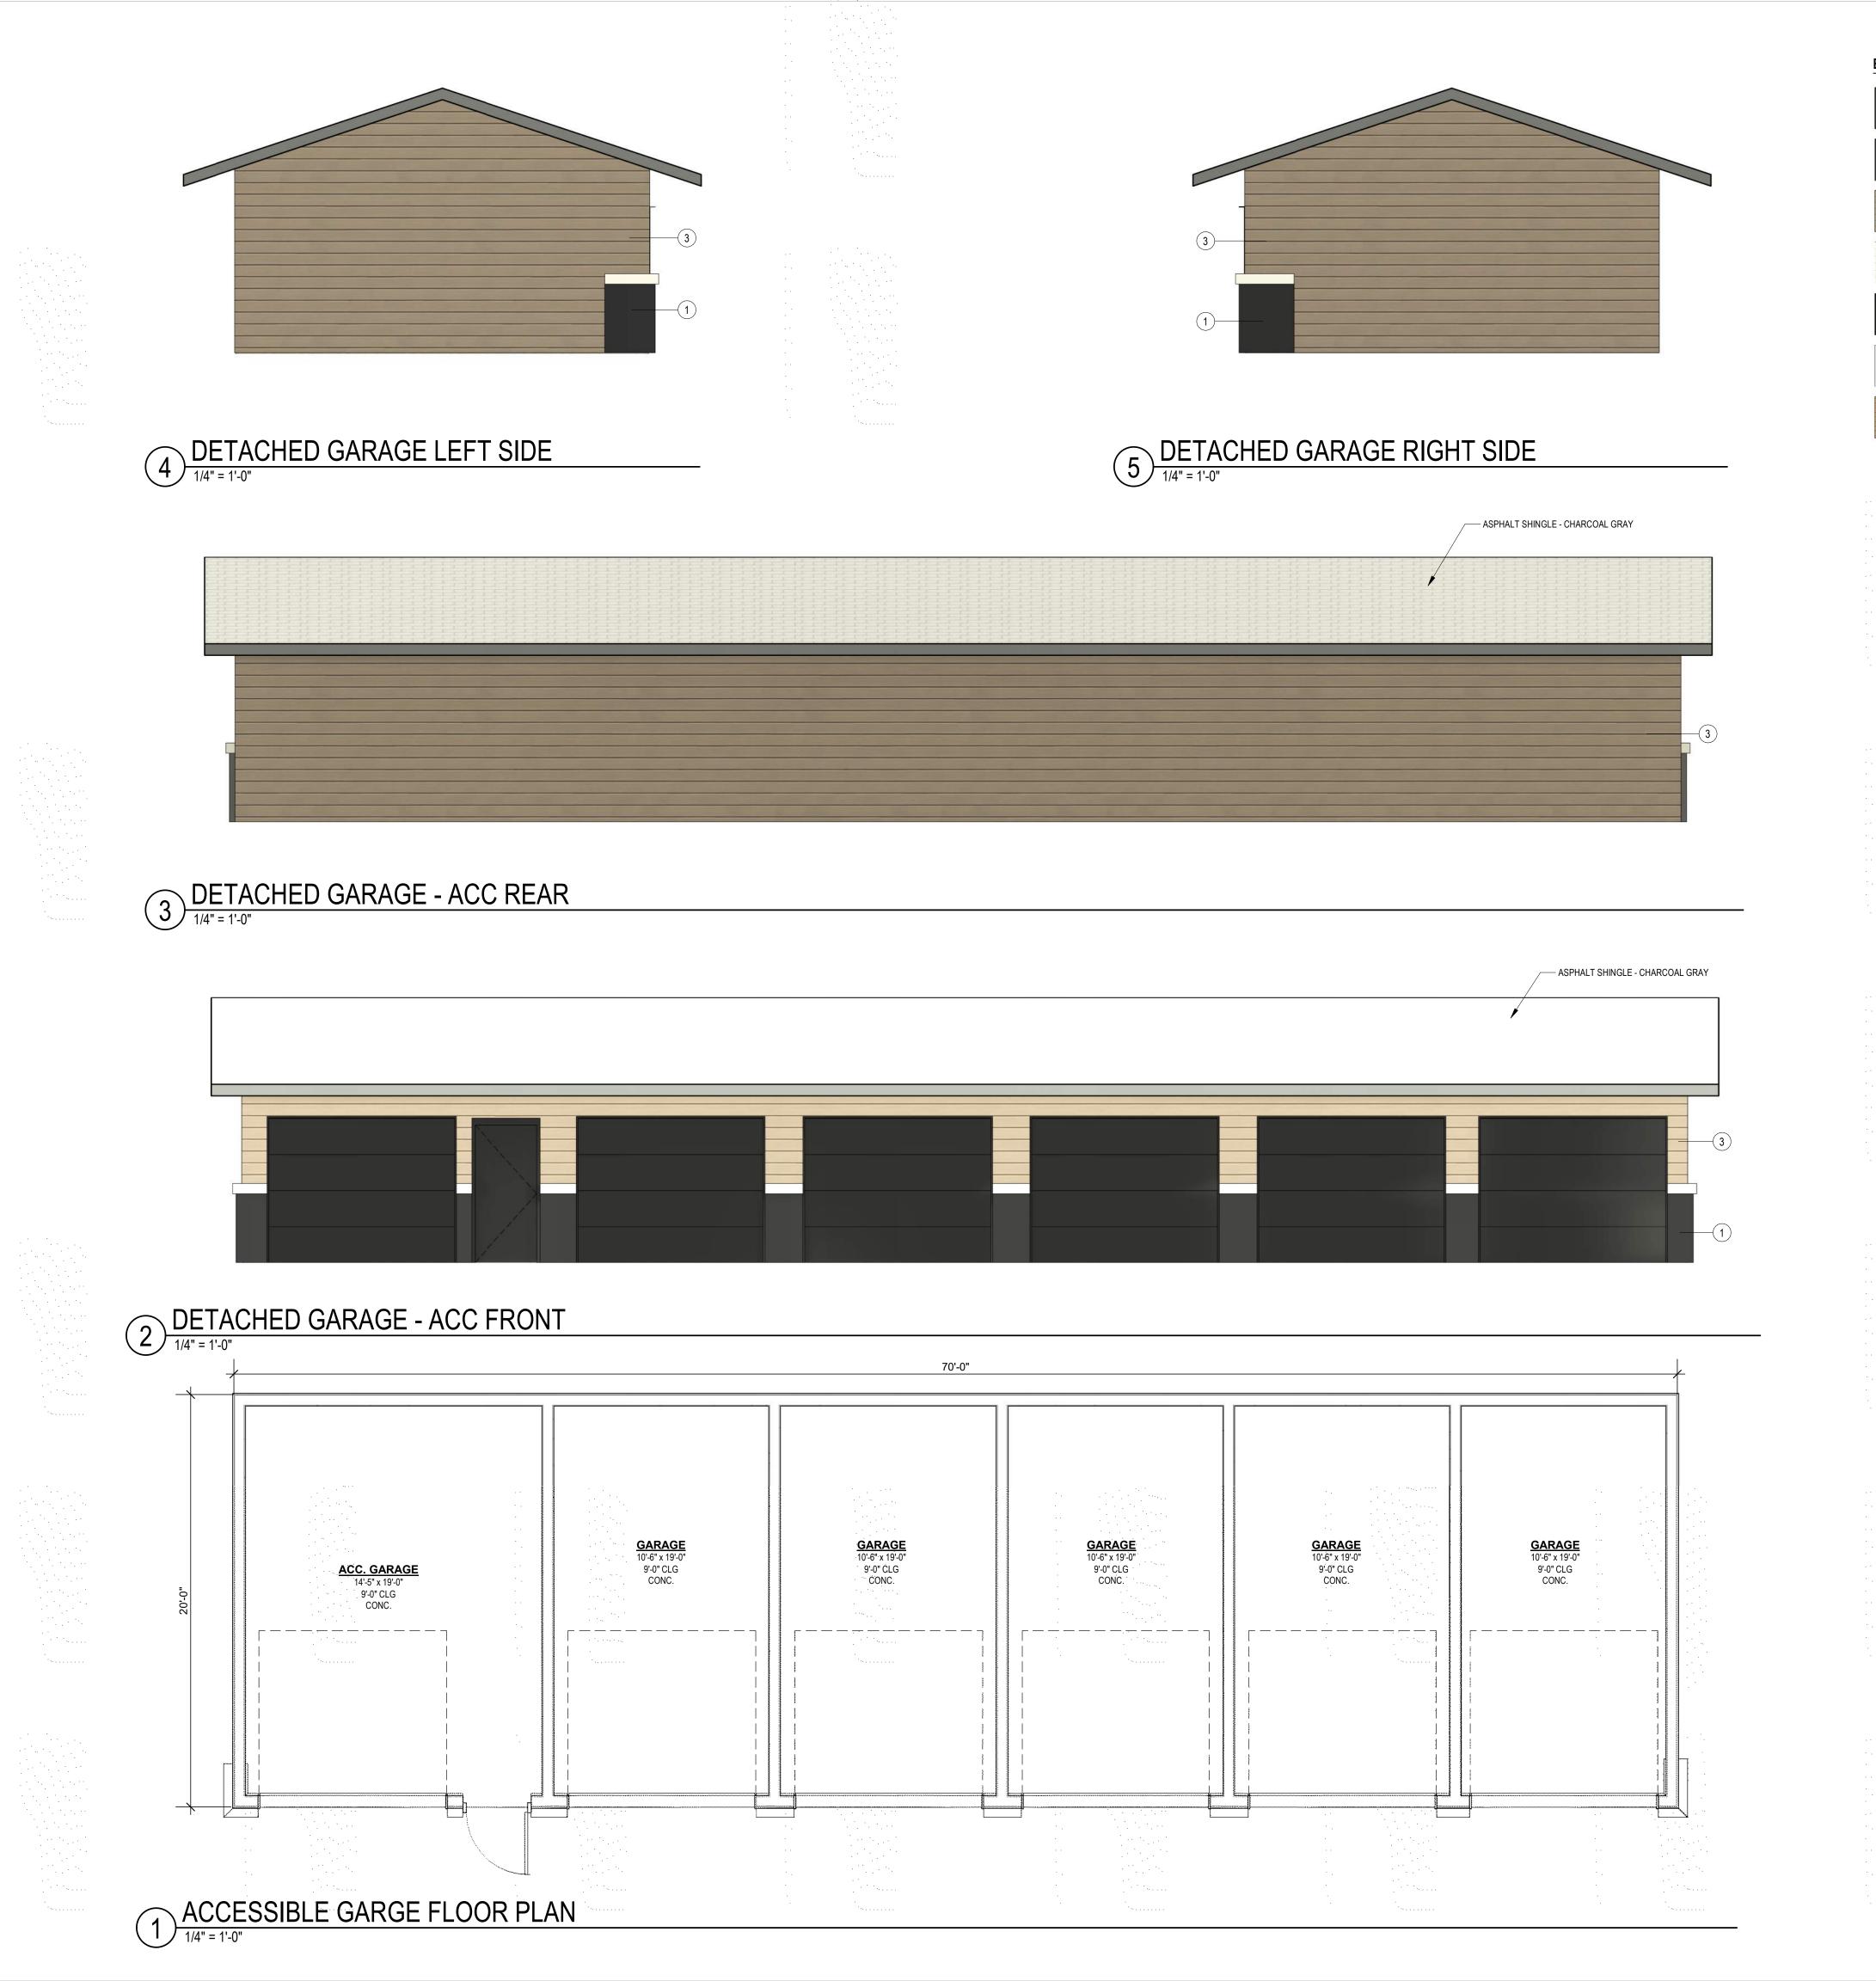
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DRAWN BY TSC/SIW 1/27/2023 FDP RESUBMITTAL SHEET NAME RELEASED FOR CONSTRUCTION
As Noted on Plan Review **DETACHED GARAGES**


JOB NO. 705922

01.20.2023







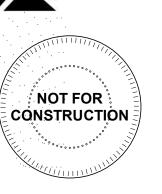

A NEW RESIDENTIAL COMMUNITY AT:

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Soo & 810 NW WARD RD. | LEE'S SUMMIT,
12.16.2023 - PROGRESS SET
10.10.2033 - PROGRESS SET

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JOB NO. DATE
705922 01.20.2023
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1/27/2023
FDP RESUBMITTAL
SHEET NAME
DETACHED GARAGES

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As Noted on Plan Review

Development Services Department
Lee's Summit, Missouri

03/20/2023

A-801

CAST STONE CAP TO MATCH ARCH., 3" THICK, 1.5" OVERHANG


SLOPED SLIGHTLY FOR DRAINAGE,

SILICONE SEAL ALL JOINTS, COLOR

BOTH SIDES, PIN IN PLACE,

TO MATCH ARCH.



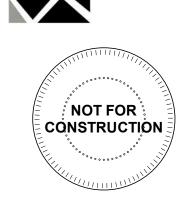

JOB NO. 705922 01.20.2023 **DRAWN BY** TSC/SIW 1/27/2023 FDP RESUBMITTAL

TRASH ENCLOSURE

Development Services Department Lee's Summit, Missouri


03/20/2023


DRAWING RELEASE LOG


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SHEET NAME





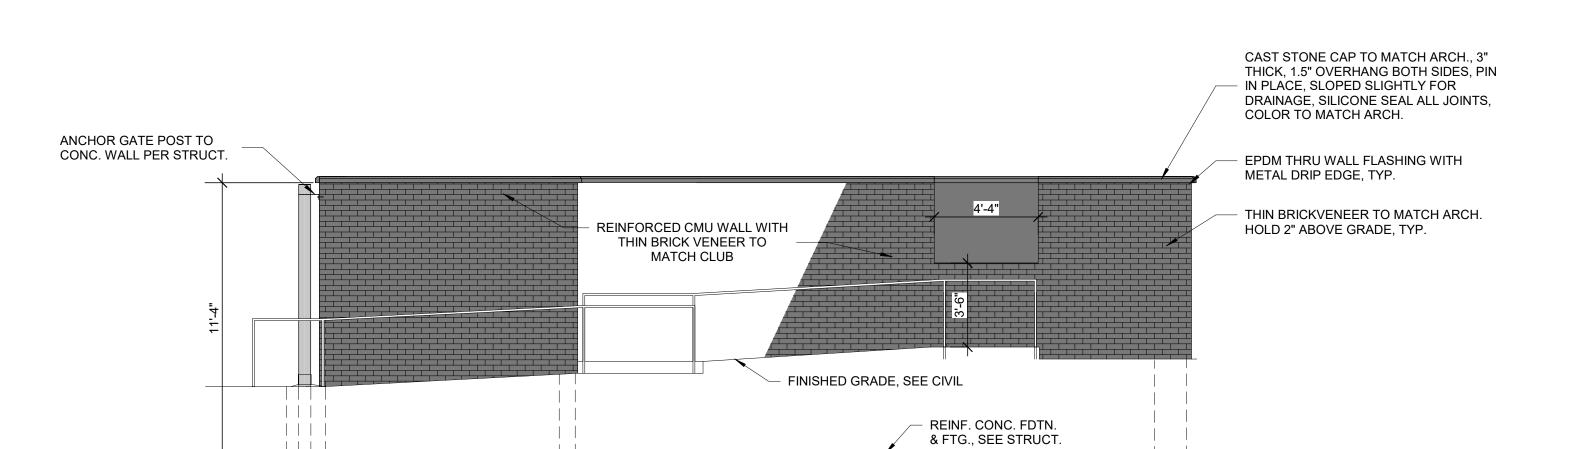

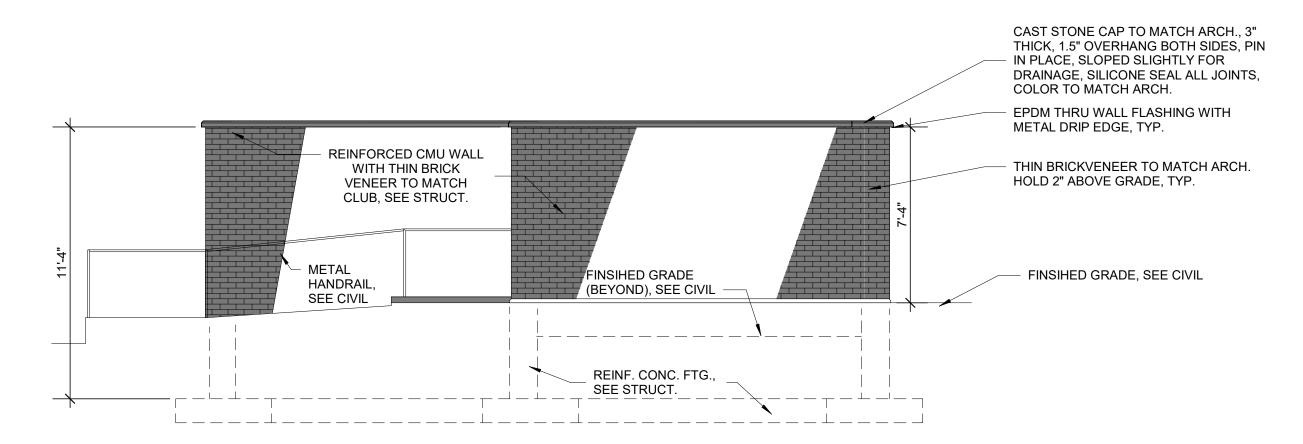PRONT ELEVATION

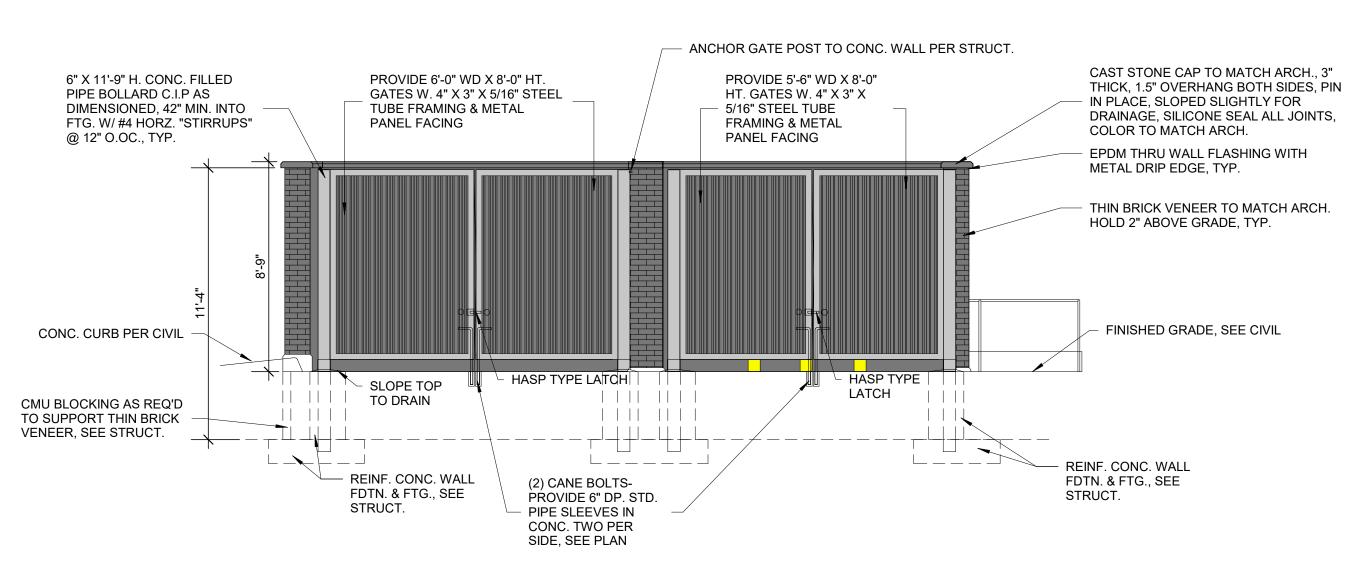
1/4" = 1'-0"

 REINF. CONC. FDTN. FINISH GRADE (BEYOND) -& FTG., SEE STRUCT.

- FINISH GRADE, SEE CIVIL

REINFORCED CMU WALL WITH

THIN BRICK VENEER TO MATCH CLUB

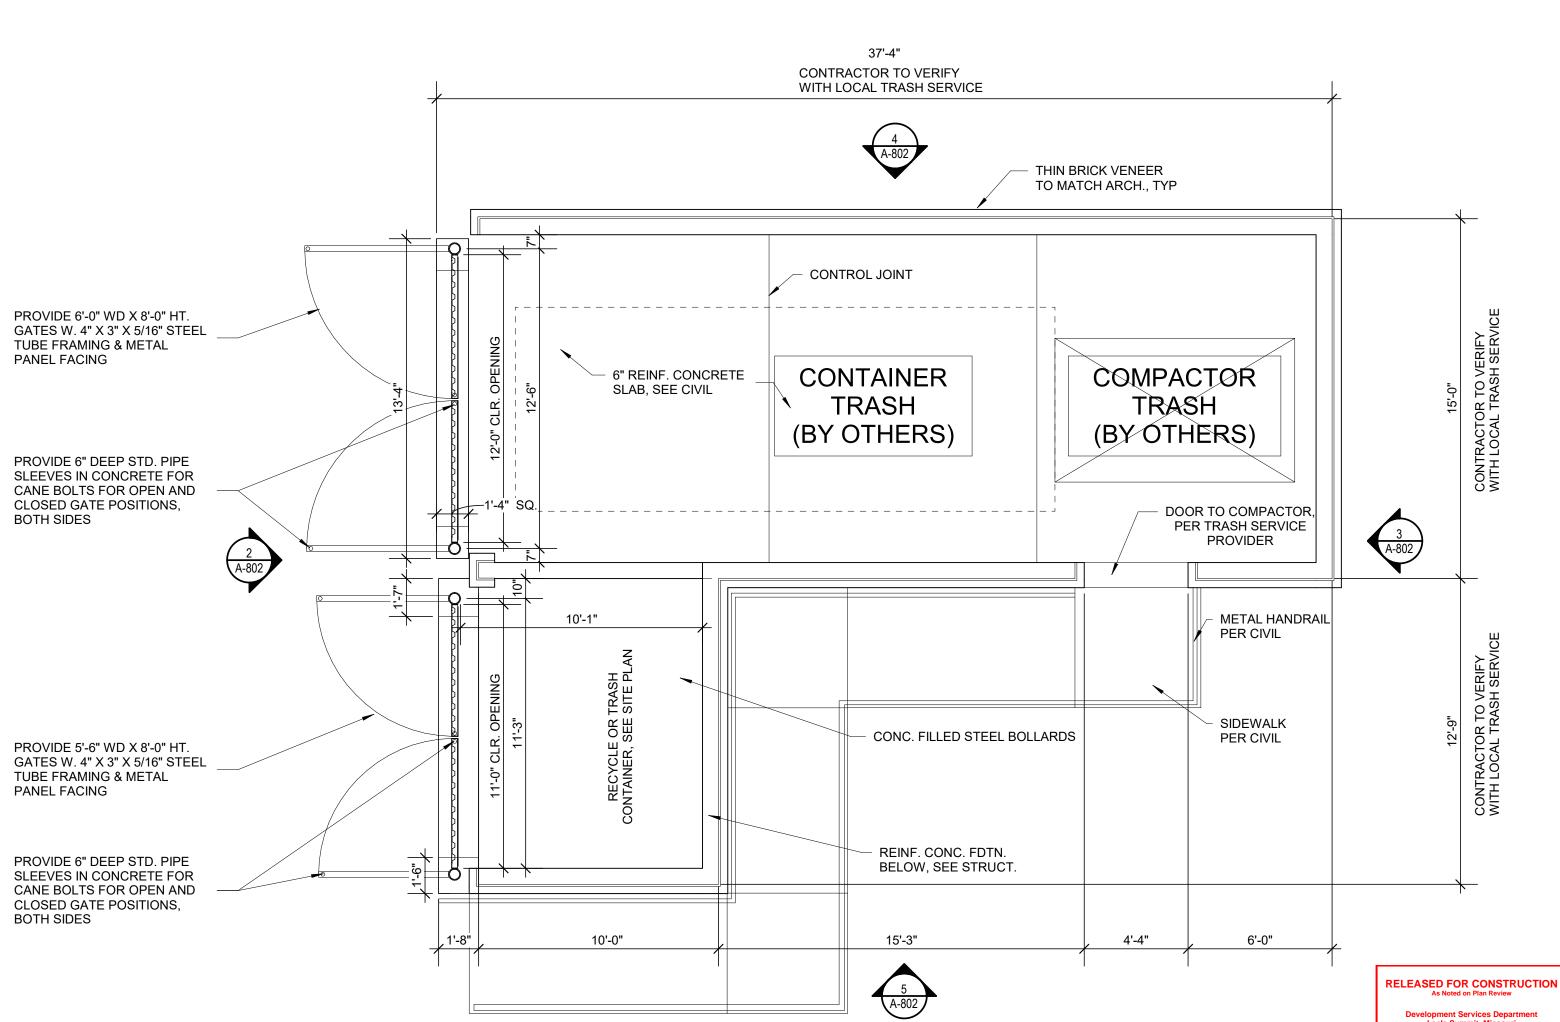

TRASH ENCLOSURE FLOOR PLAN

STATISTICS
 Description
 Avg
 Max
 Min
 Max/Min
 Avg/Min
 Avg/Max

 Drive Area
 2.1 fc
 10.2 fc
 0.2 fc
 51.0:1
 10.5:1
 0.26:1

				SITE LI	GHT FIXT	URE SCHI	EDULE						
NA	MARK MANUFACTURE	MODEL NUMBER	MOUNTING			FINISH	LAMPS					REMARK	
IVI		MODEL NOMBER	RECESS	SURFACE	WALL	FINISH	LED	FLOUR.	HID	CODE	QUANTITY	KEIVIAKI	
S	L1	PRESCOLITE	1152-962			X	BLACK	X			8W PAR 30 LED	1	1
S	L2	HUBBELL	LMC-30LU-3-K-4			X	BLACK	X				1	5
S	L3	CREE INC.	ARE-EDG-4MB-DA-12-E-UL-BK-525-40K]	POLE	÷.	BLACK	X				1	2, 3. 4
S	L4	CREE INC.	ARE-EDG-3MP-DA-06-E-UL-BK-700-40K		POLE		BLACK	X				1	3, 4
S	L5	CREE INC.	ARE-EDG-3MP-DA-06-E-UL-BK-700-40K		POLE	v	BLACK	X				1	2, 3. 4
S	L6	CREE INC.	ARE-EDG-4MB-DA-12-E-UL-BK-525-40K		POLE		BLACK	X				1	3, 4

REMARKS:

- 1 MOUNT AT 8'AFG.
- 2 PROVIDE WITH (1) HEAD.
- 3 MOUNT ON 20' POLE ROUND STRAIGHT STEEL, 80 MPH RATED.
- 4 VERIFY EPA RATING OF POLE WITH MANUFACTURER.
- 5 MOUNT AT 16' AFG

$\begin{array}{c ccccccccccccccccccccccccccccccccccc$	
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10.2 10.3 12.6 1.6 10.7 10.4 10.8 10.6 10.7 10.4 10.8 10.6 10.7	
0.1	
SL35.5 *4.3 *2.5 *1.6 *0.9 *0 7 *0 9 *1 1 *2 0 *2 7 *2.8 *2.8 *1.8 *0.9 *0.5 ** **SL1**	
0.2 5.3 5.0 2.1 1.4 0.8 0.6 0.7 1.0 3 1.5 1.3 1.0 0.6 0.4 0.3 0.4 0.8 1.6 2.6 2.6 3.6 4.2 5.7 4.2 2.1 0.8 0.4 0.2 0.2 (TYP.)	
0.5	
1.1 1.5 1.5 1.5 1.5 1.5 1.5 1.5 1.5 1.5	
0.1 0.2 0.2 0.2 0.3 0.3 0.3 0.3 0.3 0.3 0.3 0.3 0.3 0.3	
0.1 0.3 0.3 0.2 0.2 0.3 0.3 0.2 0.3 0.3 0.2 0.3 0.3 0.2 0.3 0.3 0.2 0.3 0.3 0.3 0.2 0.3 0.3 0.3 0.2 0.3 0.3 0.3 0.3 0.2 0.3 0.3 0.3 0.3 0.3 0.3 0.3 0.3 0.3 0.3	
10.2 10.7 10.6 10.6 10.6 10.5 10.4 10.9 11.8 11.3 10.7 10.4 10.9 11.3 11.0 11.0 11.0 11.0 11.0 11.0 11.0	

0.2	
1.8 2.3 1.8 1.0 0.5 0.5 0.5 0.5 0.5 0.5 0.5 0.5 0.5 0	
0.3 0.3 1.7 0.9 0.4 1.7 1.2 0.0 0.5 1.0 1.0 1.0 1.7 1.2 0.0 0.5 1.0 1.0 1.0 1.0 1.0 1.0 1.0 1.0 1.0 1.0	
1.3 1.2 1.1 1.0 0.7 0.8 1.2 1.1 1.0 0.7 0.8 1.2 1.1 1.0 0.7 0.8 1.1 1.3 1.7 1.0 0.5 0.4 0.7 1.4 1.2 1.9 1.3 1.8 1.4 1.2 1.9 1.3 1.8 1.4 1.2 1.9 1.3 1.8 1.8 1.4 1.2 1.9 1.3 1.8 1.8 1.4 1.2 1.9 1.3 1.8 1.8 1.4 1.2 1.9 1.3 1.8 1.8 1.8 1.8 1.8 1.8 1.8 1.8 1.8 1.8	
0.1 0.2 0.2 0.2 0.2 0.2 0.2 0.2 0.2 0.2 0.2	
0.1	
*\frac{1}{2} \frac{1}{2} \frac	
*\frac{1}{3} \frac{1}{3} \frac{1}{4} \frac{1}{3} \frac{1}{3} \frac{1}{4} \frac{1}{3} \frac{1}{3} \frac{1}{4} \frac{1}{3} \frac	
10.3 3.7 5.7 3.6 1.9 1.3 0.6 0.8 1	5 †0.8 †1.3 †4.4 6.9 SL1," (TYP.)
	5 1.1 0.8 0.8 1.6 2.7 5.1 5.1 5.1 5.1 5.1 5.1 5.1 5.1 5.1 5.1
**\frac{1}{0.5} **\frac{1}{4.0} **\frac{1}{4.5} **\frac{1}{3.8} **\frac{1}{2.0} **\frac{1}{0.9} **\frac{1}{0.4} **\frac{1}{0.5} **\frac{1}{0.4} **\frac{1}{0.5} **\frac{1}{0.8} **\frac{1}{0.5} **\frac{1}{0.8} **\frac{1}{0.6} *\frac{1}{0.6} *\frac{1}	1.7 1.7 1.2 0.9 0.5 1.4 1.6 1.2 1.8 2.4 4.7 5.8 5.4 4.5 1.2 1.8 1.4 1.7 1.8 1.8 1.8 1.8 1.8 1.8 1.8
1.9 1.9 1.6 1.3 0.6 0.7 0.6 0.7 0.6 0.7 0.5 0.3 0.4 0.5 1.0 1.6 2.4 0.0 1.6 2.4 0.0 1.6 2.4 0.6 1.6 1.6 1.6 2.0 1.6 1.6 1.6 1.8 2.0 1.8 1.5 1.6 1.8 2.0 1.8 1.5 1.6 1.8 1.8 1.8 1.8 1.8 1.8 1.8 1.8 1.8 1.8	0.6 0.6 0.8 1.0 1.3 1.7 2.1 2.7 4.0 4.1
0.1 0.2 0.2 0.2 0.2 0.2 0.2 0.2 0.2 0.2 0.2	0.9 \(^1.5 \) \(^1.6 \) \(^2.1 \) \(^2.1 \) \(^2.1 \) \(^3.0.7 \) \(^3.0.7 \) \(^3.0.7 \)
1.2 1.3 1.0 10.7 10.8 10.9 10.9 10.7 10.8 10.9 10.9 10.7 10.8 10.9 10.9 10.9 10.8 10.9 10.9 10.9 10.9 10.9 10.9 10.9 10.9	"SL2" 1.7 1.0 0.6 0.4 0.5 0.6 0.7 0.4 0.2 0.0
0.2 0.5 0.5 0.4 0.4 0.4 0.4 0.8 0.5 0.6 0.5 0.6 0.6 0.6 0.6 0.6 0.6 0.6 0.6 0.6 0.6	1.6 \(^1.0\) \(^1.6\) \(^1.0\) \(^1.6\) \(^1.0\) \(^1.6\) \(^1.0\) \(^1.6\) \(^1.0\) \(^1.6\) \(^1.0\) \(^1.6\) \(^1.0\) \(^1.6\) \(^1.0\) \(^1.6\) \(^1.0\) \(^1.6\) \(^1.0\) \(^1.6\) \(^1.0\) \(^1.6\) \(^1.0\) \(^1.6\) \(^1.0\) \(^1.6\) \(^1.0\) \(^1.6\) \(^1.0\) \(^1.6\) \(^1.0\) \(^1.6\) \(^1.0\) \(^1.6\) \(^1.0\) \(^1.0\) \(^1.6\) \(^1.0\)
0.4	2.5 ¹ 1.8 ¹ 1.5 ⁰ 0.9 ¹ 0.5 ¹ 0.4 10.3 ¹ 0.3 ¹ 0.3 ¹ 1.1 ¹ 5.4 + 0.1
0. 4.6 5.4 2.5 1.4 0.7 0.3	4.6 ¹ .5 ¹ .2 ¹ 0.9 ¹ 0.6 ¹ 0.6 ¹ 0.5 ¹ 0.4 ¹ 0.5 ¹ 1.4 ¹ 0.2 ¹ 0.1 ¹ 0.2 ¹ 0.1
3.5 4.2 2.5 1.6 0.6 0.4	3.3 1.1 1.5 2.2 2.5 3.2 3.0 2.4 2.1 2.4 6.6 0.1 0.1
0.2 '5.1 '5.2 '2.2 '1.4 '0.7 0.4 '1.0 '1.0 '1.1 '1.5 2.0 2.5 (0.4 0.5 0.7 1.2 1.9 2.4 1.9 2.4 (0.7 0.4 0.5 0.7 1.2 1.9 2.4 1.9 2.4 (0.7 0.4 0.5 0.7 1.2 1.9 2.4 1.9 2.4 (0.7 0.4 0.5 0.7 1.2 1.9 2.4 1.9 2.4 (0.7 0.4 0.5 0.7 1.2 1.9 2.4 (0.7 0.4 0.5 0.7 1.2 1.9 2.4 (0.7 0.4 0.5 0.7 1.2 1.9 2.4 (0.7 0.4 0.5 0.7 0.4 0.5 0.7 1.2 1.9 2.4 (0.7 0.4 0.5 0.7 0.4 0.5 0.7 0.4 0.5 0.7 0.4 (0.7 0.4 0.5 0.7 0.7 0.4 0.5 0.7 0.7 0.4 0.5 0.7 0.7 0.4 0.5 0.7 0.7 0.4 0.5 0.7 0.7 0.4 0.5 0.7 0.7 0.4 0.5 0.7 0.7 0.4 0.5 0.7 0.7 0.4 0.5 0.7 0.7 0.7 0.4 0.5 0.7	7.3 1.5 2.9 4.7 4.5 4.6 2.8 2.5 6.4 0.1 1.6 1.1 1.7 2.3 4.3 6.7 6.6 4.1 2.2 2.7 6.1 1.1 1.7 2.3 4.3 6.7 1.1 1.7 2.3 4.3 6.7 1.1 1.7 2.2 1.7 6.1 1.1 1.7 2.3 4.3 6.7 1.1 1.7 2.2 1.7 6.1 1.1 1.7 2.3 4.3 6.7 1.1 1.7 2.2 1.7 6.1 1.1 1.7 2.3 4.3 6.7 1.1 1.7 2.2 1.7 6.1 1.1 1.7 2.3 4.3 6.7 1.3 1.3 1.3 1.3 1.3 1.3 1.3 1.3 1.5 1.3 1.3 1.3 1.3 1.3 1.3 1.3 1.3 1.3 1.3
*0.2 *1.5 *1.8 *1.5 *1.5 *1.5 *1.1 *0.6 *1.0 *1.8 *1.2 *2 ** *0.2 *0.5 *0.6 *0.6 *0.6 *0.6 *0.5 *0.4 ** *0.3 *0.3 *0.3 *0.5 *1.0 *1.8 *2.0 ** *0.3 *0.3 *0.3 *0.5 *1.0 *1.8 *2.0 ** *0.3 *0.3 *0.5 *1.0 *1.8 *2.0 ** *0.4 *0.6 *1.0 *1.8 *2.0 ** *0.5 *0.6 *0.6 *0.6 *0.6 *0.5 *0.5 *0.5 *0.5 *0.5 *0.5 *0.5 *0.5	7.8 1.4 1.8 2.6 4.3 5.4 SL6 5.5 4.1 2.5 3.2 6.
0.4 0.5 0.6 0.6 0.6 0.6 0.6 0.6 0.5 0.4 0.5 0.7 0.8 0.7 0.7 0.8 0.7 0.7 0.8 0.7 0.7 0.8 0.7 0.7 0.7 0.8 0.7 0.7 0.7 0.7 0.7 0.7 0.7 0.7 0.7 0.7	1.9 ² 2.5 ⁴ 4.3 ⁶ 6.8 ⁶ 6.5 ⁴ 4.0 ² 2.2 ³ 3.8 ⁴ 9 ⁰ 2.2 ² 3.3 ³ 3.3 ⁵ 5.0 ⁴ 4.5 ⁴ 4.6 ⁴ 4.7 ² 2.6 ³ 3.4 ⁴ 43 ⁰ 2.2
*0.2 *0.4 *0.5 *0.6 *1.0 *2.1 *4.1 *1.1 *1.0.9 *1.0 *1.1 *1.0.9 *1.0 *1.1 *1.0.9 *1.0 *1.1 *1.0.9 *1.0 *1.1 *1.0.9 *1.0 *1.1 *1.0.9 *1.0 *1.1 *1.0.9 *1.0 *1.1 *1.0.9 *1.0 *1.1 *1.0.9 *1.0 *1.0 *1.0 *1.0 *1.0 *1.0 *1.0 *1.0	*2.4 *2.7 *2.8 *3.4
**** **** **** **** **** *** *** *** *** *** *** ** *** *** *** *** *** *** *** *** *** *** *** *** ** *** *** *** *** *** *** *** *** *** *** *** *** ** *** *** *** *** *** *** *** *** *** *** *** *** ** *** *** *** *** *** *** *** *** *** *** *** *** ** *** *** *** *** *** *** *** *** *** *** *** *** ** *** *** *** *** *** *** *** *** *** *** *** *** ** *** *** *** *** *** *** *** *** *** *** *** *** ** *** *** *** *** *** *** *** *** *** *** *** *** ** *** *	\$L2 2.0 *1.7 *1.2 *0.8 *0.7 *0.6 *0.5 *0.6 *3.2 *0.2 *0.2
0.1 0.9 2.4 3.1 2.6 3.3 3.7 5.6 3.8 3.3 3.7 5.6 3.8 3.3 3.7 5.6 3.8 3.3 3.7 5.6 3.8 3.3 3.7 5.6 3.8 3.3 3.0 4.2 4.9 3.0 2.3 2.1 1.9 2.0 1.6 1.4 1.4 1.5 1.6 1.4 1.2 0.8 0.5 0.5 0.8 1.2 1.4 1.4 1.5 1.6 1.8 3.8 1.2 1.4 1.4 1.5 1.6 1.8 3.8 1.2 1.4 1.4 1.5 1.6 1.8 3.8 1.2 1.4 1.4 1.5 1.6 1.8 3.8 1.2 1.4 1.4 1.5 1.6 1.8 3.8 1.2 1.1 0.9 1.8 1.8 1.6 1.4 1.1 0.9 0.7 0.9 1.2 1.5 1.6 1.6 1.8 1.3 0.7 0.5 0.5 0.7 1.2 1.4 1.7 2.2 3.1 2.6 2.6 2.7 1.5 0.8 1.3 0.9 1.3 2.6 2.6 2.6 2.5 1.5 1.8 6.1 2.1 6.2 6.5 2.7 8.6 1.6 4.9 4.5 1.3 8.1 2.4 6 6.1 1.0 1.0 1.2 1.4 1.7 2.2 3.1 2.6 2.6 2.7 1.5 0.8 1.3 0.9 1.3 2.6 2.6 4.5 3.3 3.2 5.2 1.5 1.8 6.1 2.1 6.2 6.5 2.7 8.6 1.6 4.9 4.5 1.3 8.1 2.4 6 6.1 1.0 1.0 1.2 1.4 1.5 1.6 1.8 1.0 1.2 1.4 1.5 1.6 1.8 1.3 0.7 0.5 0.5 0.7 1.2 1.4 1.7 2.2 3.1 2.6 2.6 2.6 2.7 1.5 0.8 1.3 0.9 1.3 2.6 2.6 4.5 3.3 3.2 5.2 1.5 1.8 6.1 2.1 6.2 6.5 2.7 8.6 1.6 4.9 4.5 1.3 8.1 2.4 6 6.1 1.0 1.0 1.0 1.0 1.0 1.0 1.0 1.0 1.0 1	*2.4 *1.6 *1.0 *0.6 *0.4 *0.6 *4.9 *0.2 *0.4 *0.6 *3.5 *0.2 *0.4 *0.6 *3.5 *0.2
SL2 **S	0.5 *0.5 *0.9
**\begin{array}{c c c c c c c c c c c c c c c c c c c	7 0.4 1.3 3.2 4.2 4.5 2.4 1.9 0.9 0.8 0.8 0.8 0.1 (11.7) 0.1 0.7 0.7 0.7 0.7 0.7 0.7 0.7 0.7 0.7 0.7
0.0 0.0 0.0 0.1 0.1 0.1 0.1 0.1 0.1 0.1	7c, 7 ³ 3, 1 5.7, 4.7 3.8 5.7 4.9 4.9 4.2 5.1 3.1
"SL3"	"SL3"3 5.7 4.7 3.3 5.7 4.9 4.2 5.1 3.1 5.0 5.0 5.1 4.9 5.6 5.2 6.2 4.4 3.4 6.0
	3.7 *3.4 "SL3" *0.0
	0.0

SITE PHOTOMETRIC PLAN

1"=40'-0"

NORTH








SUMMIT ORCHARDS WEST PRELIMINARY DEVELOPMENT PLAN LEE'S SUMMIT, JACKSON COUNTY, MO SITE PHOTOMETRIC PLAN

SHEET #:

E0.01

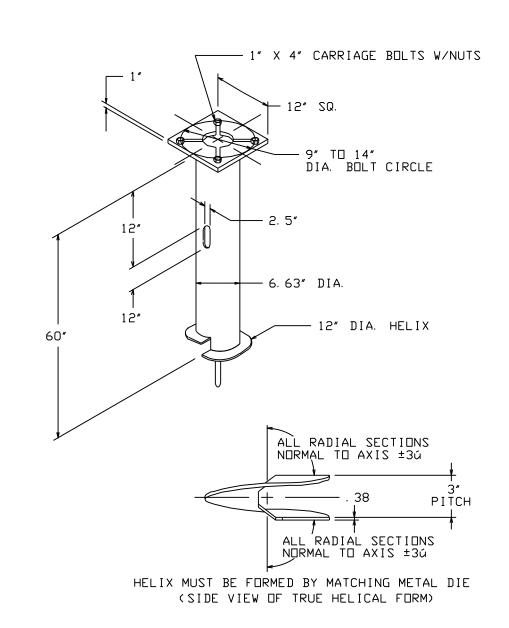



10. BASEPLATE IS PERMANENTLY STAMPED WITH MANUFACTURER'S IDENTIFICATION 'ABC' IN 1/2' LETTERS AND DATE CODE


FOLLOW MANUFACTURER'S RECOMMENDATIONS FOR BASE REINFORCING. GROUNDING LUG BASE CAP BOND LIGHT POLE TO GROUND GROUT < CONDUCTOR IN EXTERIOR LIGHTING CIRCUIT LEVELING BOLTS #4 REBAR CAGE ÄT 12" O.C. E.W. GRADE 24" MIN. 3/4" SPARE (NOTE LOCATION ON BACK OF HAND HOLE COVER PLATE) -STEEL CONDUIT 24"øx60 `PVC CONDUIT CONCRETE BASE BELOW GRADE ANCHOR BOLTS

1 LIGHT POLE FOUNDATION NO SCALE CAT. NO. C11242NG4VP

2 LIGHTING POLE BASE DETAIL NO SCALE

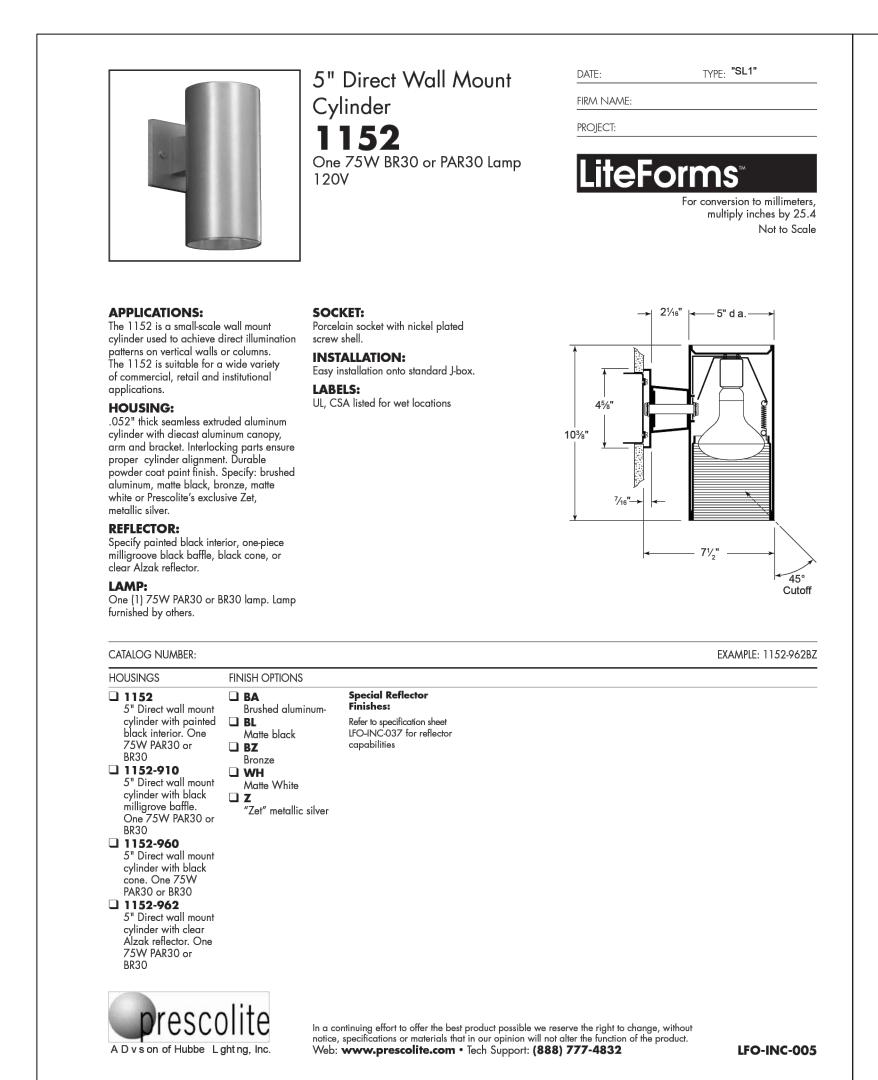

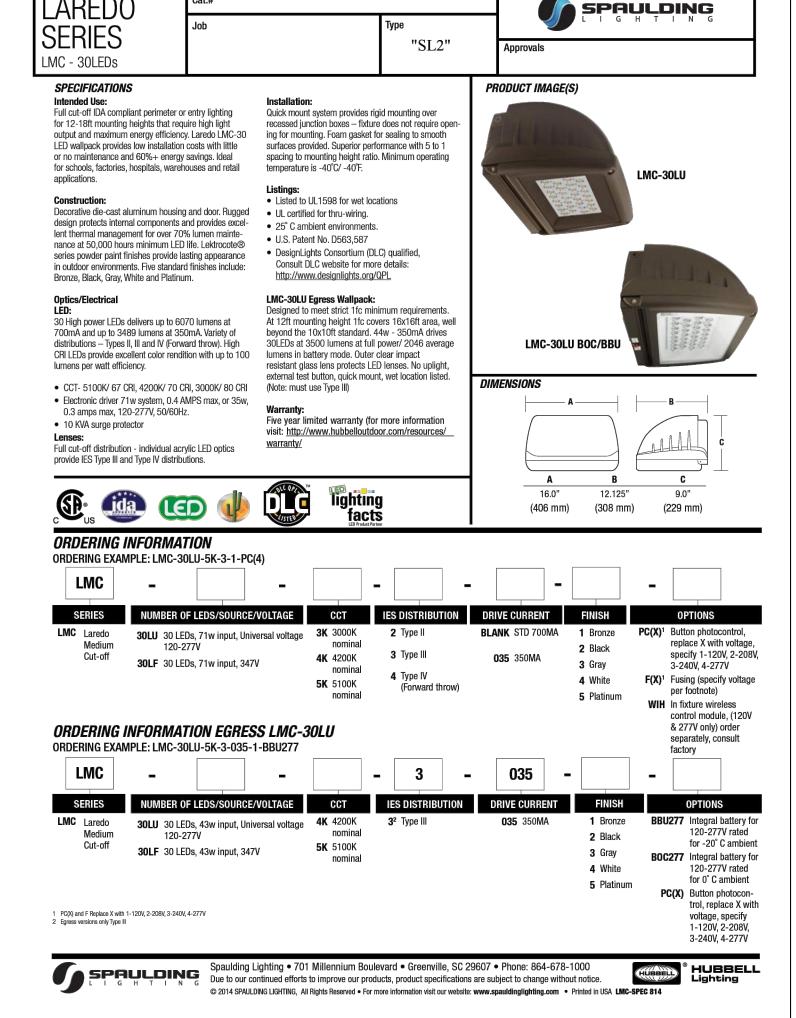

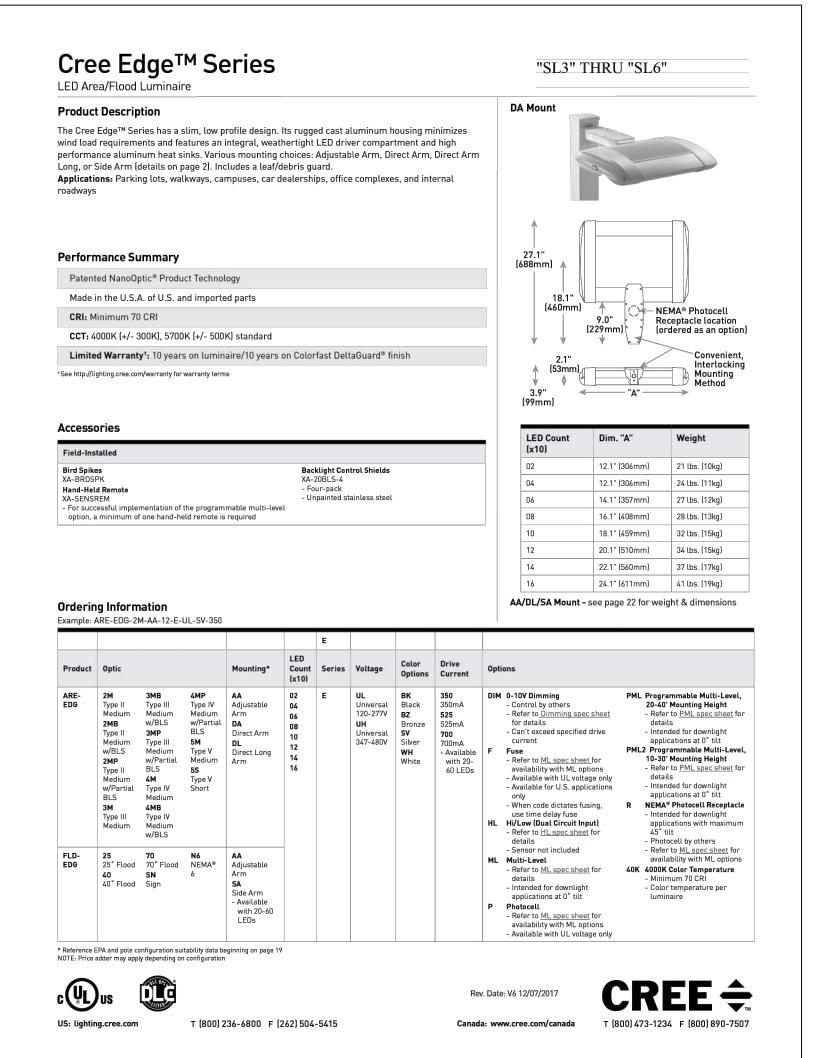







3315 N Oak Trafficway
Kansas City, MO 64116

NO.: REVISIONS/APPROVALS:	PI AN REVIEW		FDP	FDP SUBMITTAL						
NO.:			\bigvee	$\sqrt{2}$						
DATE:	30 00 0000	2022.08.26 2022.12.21		2023.01.27						
KEVIEWED BY:	KKW/KKB	DESIGNED RV.	KRW/RRB	DRAFTED BY:	CAD	SP PROJECT #:	4042	MELISSA G DEGONIA,	ЩД	<u>.</u>

SUMMIT ORCHARDS WEST RELIMINARY DEVELOPMENT PLA

CUTSHE

PICHARD R. BEARDMORE

NUMBER

E0.02