


PUBLIC STREET AND STORM SEWER PLANS FOR REUNION AT BLACKWELL IN THE CITY OF LEE'S SUMMIT JACKSON COUNTY, MO

LEGEND:

- A/E - ACCESS EASEMENT
- BC - BACK OF CURB
- B/B - BACK TO BACK
- BM - BENCHMARK
- BL or B.L. - BUILDING LINE
- CO - CLEANOUT
- TJB - TELEPHONE JUNCTION BOX
- C&G - CURB AND GUTTER
- D/E - DRAINAGE EASEMENT
- E/E - ELECTRICAL EASEMENT
- EL - ELEVATION
- FL - FLOW LINE
- G/E - GAS LINE EASEMENT
- HDPE - HIGH-DENSITY POLYETHYLENE
- L/E - LANDSCAPE EASEMENT
- MSFE - MINIMUM SERVICEABLE FLOOR ELEVATION
- PVC - POLYVINYL CHLORIDE
- P/L - PROPERTY LINE
- PUB/E - PUBLIC EASEMENT
- RCP - REINFORCED CONCRETE PIPE
- ROW or RW - RIGHT-OF-WAY
- S/E - SANITARY SEWER EASEMENT
- SL - SERVICE LINE
- SW - SIDEWALK
- TE - TOP ELEVATION
- U/E - UTILITY EASEMENT
- WSE - WATER SURFACE ELEVATION
- W/E - WATERLINE EASEMENT

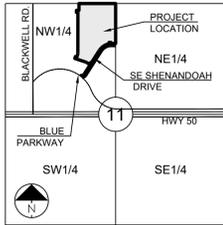

SECTION 11-47-31
LOCATION MAP
SCALE 1" = 2000'

UTILITY CONTACTS:

MISSOURI DEPARTMENT OF TRANSPORTATION (MODOT)
Steve Holloway
600 NE Colbern Road
Lee's Summit, MO 64086
(816) 607-2186

SPIRE
Brent Jones
3025 SE Clover Drive
Lee's Summit, MO 64082
(816) 399-0663/brent.jones@spireenergy.com

EVERGY
Philip Ingram
1300 SE Hamblen Road
Lee's Summit, MO 64081
Office: (816) 347-347-4339
philip.ingram@evergy.com

CITY OF LEE'S SUMMIT PUBLIC WORKS
Dena Mezger
220 SE Green Street
Lee's Summit, MO 64083
(816) 969-1800

AT&T
Mark Manion or Marty Loper
500 E. 9th Street, Room 370
Kansas City, MO 64106
(816) 275-2341 or (816) 275-1550

COMCAST CABLE
John Meadows
4700 Little Blue Parkway
Independence, MO 64057
(816) 795-2257

CITY OF LEE'S SUMMIT WATER UTILITIES
Mark Schauler
1200 SE Hamblen Road
Lee's Summit, MO 64081
(816) 969-1900



GENERAL NOTES:

1. ALL CONSTRUCTION TO FOLLOW THE CITY OF LEE'S SUMMIT DESIGN AND CONSTRUCTION MANUAL AS ADOPTED BY ORDINANCE 5813.
2. ALL WORKMANSHIP AND MATERIALS SHALL BE SUBJECT TO THE INSPECTION AND APPROVAL OF THE ENGINEERING DEPARTMENT OF THE CITY OF LEE'S SUMMIT, MISSOURI.
3. LINEAL FOOT MEASUREMENTS SHOWN ON THE PLANS ARE HORIZONTAL MEASUREMENTS, NOT SLOPE MEASUREMENTS. ALL PAYMENTS SHALL BE MADE ON HORIZONTAL MEASUREMENTS.
4. NO GEOLOGICAL INVESTIGATION HAS BEEN PERFORMED ON THE SITE.
5. THE UTILITY LOCATIONS SHOWN ON THESE PLANS ARE TAKEN FROM UTILITY COMPANY RECORDS AND APPARENT FIELD LOCATIONS. THE CONTRACTOR SHALL VERIFY THE LOCATION AND DEPTH OF ALL UTILITIES PRIOR TO CONSTRUCTION.
6. THE CONTRACTOR SHALL ADHERE TO THE PROVISIONS OF THE SENATE BILL NUMBER 583, 78TH GENERAL ASSEMBLY OF THE STATE OF MISSOURI. THE BILL REQUIRES THAT ANY PERSON OR FIRM DOING EXCAVATION ON PUBLIC RIGHT OF WAY DO SO ONLY AFTER GIVING NOTICE TO, AND OBTAINING INFORMATION FROM, UTILITY COMPANIES. STATE LAW REQUIRES 48 HOURS ADVANCE NOTICE. THE CONTRACTOR MAY ALSO UTILIZE THE FOLLOWING TOLL FREE PHONE NUMBER PROVIDED BY "MISSOURI ONE CALL SYSTEM, INC.": 1-800-DIG-RITE. THIS PHONE NUMBER IS APPLICABLE ANYWHERE WITHIN THE STATE OF MISSOURI. PRIOR TO COMMENCEMENT OF WORK, THE CONTRACTOR SHALL NOTIFY ALL THOSE COMPANIES WHICH HAVE FACILITIES IN THE NEAR VICINITY OF THE CONSTRUCTION TO BE PERFORMED.
7. PRIOR TO ORDERING PRECAST STRUCTURES, SHOP DRAWING SHALL BE SUBMITTED TO THE DESIGN ENGINEER FOR APPROVAL. AFTER APPROVAL OF THE SHOP DRAWINGS, A COPY OF THE APPROVED AND SIGNED SHOP DRAWINGS SHALL BE PROVIDED TO THE CITY INSPECTOR UPON REQUEST.
8. THE CONTRACTOR SHALL PROTECT ALL MAJOR TREES FROM DAMAGE. NO TREE SHALL BE REMOVED WITHOUT PERMISSION OF THE OWNER, UNLESS SHOWN OTHERWISE.
9. CLEARING AND GRUBBING OPERATIONS AND DISPOSAL OF ALL DEBRIS THEREFROM SHALL BE PERFORMED BY THE CONTRACTOR IN STRICT ACCORDANCE WITH ALL LOCAL CODES AND ORDINANCES.
10. ALL WASTE MATERIAL RESULTING FROM THE PROJECT SHALL BE DISPOSED OF OFF-SITE BY THE CONTRACTOR, OR AS DIRECTED BY THE OWNER.
11. ALL EXCAVATIONS SHALL BE UNCLASSIFIED. NO SEPARATE PAYMENT WILL BE MADE FOR ROCK EXCAVATION.
12. THE CONTRACTOR SHALL CONTROL THE EROSION AND SILTATION DURING ALL PHASES OF CONSTRUCTION, AND SHALL KEEP THE STREETS CLEAN OF MUD AND DEBRIS.
13. ALL MANHOLES, CATCH BASINS, UTILITY VALVES AND METER PITS TO BE ADJUSTED OR REBUILT TO GRADE AS REQUIRED.
14. THE CONTRACTOR SHALL CONTACT DEVELOPMENT SERVICES INSPECTIONS AT: 816-969-1200 TO OBTAIN A DEVELOPMENT SERVICES CONSTRUCTION PERMIT. A MINIMUM 48 HOUR NOTICE SHALL BE GIVEN PRIOR TO PERMIT ISSUANCE.
15. THE CONTRACTOR SHALL CONTACT THE RIGHT OF WAY INSPECTOR AT 816-969-1800 PRIOR TO ANY LAND DISTURBANCE ACTIVITIES WITHIN THE RIGHT OF WAY. THESE ACTIVITIES MAY REQUIRE A PERMIT.
16. THE CONTRACTOR SHALL PROVIDE AND MAINTAIN ALL TRAFFIC HANDLING MEASURES NECESSARY TO ENSURE THAT THE GENERAL PUBLIC IS PROTECTED AT ALL TIMES. TRAFFIC CONTROL SHALL CONFORM TO THE MANUAL ON UNIFORM TRAFFIC CONTROL DEVICES (MUTCD-LATEST EDITION).

STREET NOTES:

1. ALL STREET CONSTRUCTION SHALL BE IN ACCORDANCE WITH THE LATEST EDITION OF THE CITY OF LEE'S SUMMIT DESIGN AND CONSTRUCTION MANUAL. ALL APPLICABLE AASHTO STANDARDS HAVE BEEN MET.
2. THE CONTRACTOR IS RESPONSIBLE FOR VERIFYING ALL EXISTING UTILITY LOCATIONS PRIOR TO EXCAVATION.
3. ALL INSPECTION OF STREET CONSTRUCTION TO BE PERFORMED BY THE CITY OF LEE'S SUMMIT DEVELOPMENT ENGINEERING.
4. CURB RETURN RADII SHALL BE 25' AT BACK OF CURB UNLESS OTHERWISE NOTED.
5. SUBGRADE TO BE COMPACTED TO 95% STANDARD PROCTOR DENSITY.
6. ASSUMED DESIGN SPEED = 25 MPH (RESIDENTIAL LOCAL).
7. MINIMUM STOPPING SIGHT DISTANCE = 155 FEET.
8. MINIMUM K, SAG CURVE = 26 (14 WITH LIGHTING), CREST CURVE = 12.
9. GRADE INTERSECTIONS TO DRAIN AS SHOWN.
10. SSD = STOPPING SIGHT DISTANCE.
11. ALL ADA SIDEWALK RAMPS SHALL BE CONSTRUCTED BY THE DEVELOPER WITH THE PUBLIC INFRASTRUCTURE.

DESIGN SPEED = 30 MPH

POSTED SPEED = 25 MPH

EARTHWORK:

1. It is recommended that a Geotechnical Engineer observe and document all earthwork activities. Contours have been shown at 1-foot or 2-foot intervals, as indicated. Grading shall consist of completing the earthwork required to bring the physical ground elevations of the existing site to the finished grade (or sub-grade) elevations provided on the plans as spot grades, contours or others means as indicated on the plans.
2. The existing site topography depicted on the plans by contouring has been established by aerial photography and field verified by g.p.s. observation near 11/11/2021. The contour elevations provided may not be exact ground elevations, but rather interpretations of such. Accuracy shall be considered to be such that not more than 10 percent of spot elevation checks shall be in error by more than one-half the contour interval provided, as defined by the National Map Accuracy Standards. Any quantities provided for earthwork volumes are established using this topography contour accuracy, and therefore the inherent accuracy of any earthwork quantity is assumed from the topography accuracy.
3. Proposed contours are to approximate finished grade.
4. Unless otherwise noted, payment for earthwork shall include backfilling of the curb and gutter, sidewalk and further manipulation of utility trench spots. The site shall be left in a mowable condition and positive drainage maintained throughout.
5. Unless otherwise noted, all earthwork is considered Unclassified. No additional compensation will be provided for rock or shale excavation, unless specifically stated otherwise.
6. Prior to earthwork activities, pre-disturbance erosion and sediment control devices shall be in place per the Storm Water Pollution Prevention plan and/or the Erosion and Sediment Control Plan prepared for this site.
7. All topsoil shall be stripped from all areas to be graded and stockpiled adjacent to the site at an area specified by the project owner or his appointed representative. Vegetation, trash, trees, brush, tree roots and limbs, rock fragments greater than 6-inches and other deleterious materials shall be removed and properly disposed of offsite or as directed by the owner or his appointed representative.
8. Unless otherwise specified in the Geotechnical Report, all fills shall be placed in maximum 6-inch lifts and compacted to 95-percent of maximum density as defined using a standard proctor test (AASHTO T99/ASTM 698).
9. Subgrade for pavements shall be proof-rolled prior to paving operations utilizing a fully loaded tandem axle dump truck. All areas exhibiting excessive pumping and heaving shall be removed, filled and compacted with suitable materials and retested until acceptable results are achieved and final approval has been obtained from the Geotechnical Engineer.
10. Subgrade for building pad shall include a minimum of 18-inches of Low Volume Change (LVC) material, or as identified in the site specific Geotechnical Report.
11. Fill materials shall be per Geotechnical Report and shall not include organic matter, debris or topsoil. All fills placed on slopes greater than 6:1 shall be benched.
12. The Contractor shall be responsible for redistributing the topsoil over proposed turf and landscaped areas to a minimum depth of 6-inches below final grade.
13. All areas shall be graded for positive drainage. Unless noted otherwise the following grades shall apply:
 - a. Turf Areas - 2.5% Minimum, 4H:1V Maximum
 - b. Paved Areas - 1.2% Minimum, 5% Maximum
14. A.D.A. parking stalls shall not be sloped greater than 2% in any direction and constructed per A.D.A. requirements.
15. All disturbed areas shall be fertilized, seeded and mulched immediately after earthwork activities have ceased. Seeding shall be per the Erosion and Sediment Control Plan and/or Landscape Plan. If not specified seeding shall be per APWA Section 2400, latest edition. Unless otherwise noted, seeding shall be subsidiary to the contract price for earthwork and grading activities.
16. All disturbed areas in the right-of-way shall be sodded.
17. Underdrains are recommended for all paved areas adjacent to irrigated turf and landscaped beds.
18. Contractor shall adhere to the reporting requirements outlined in the Storm Water Pollution Prevention Plan (SWPPP) prepared for this project. Erosion and Sediment Control devices shall be properly maintained and kept clean of silt and debris and in good working order. Additional erosion and sediment control measures shall be installed as required.

UTILITIES:

1. Existing utilities have been shown to the greatest extent possible based upon information provided to the Engineer. The contractor is responsible for contacting the respective utility companies and field locating utilities prior to construction and identifying any potential conflicts. All conflicts shall immediately be brought to the attention of the Engineer.
2. The contractor shall be responsible for coordinating any required utility relocations. Utilities damaged through the negligence of the contractor shall be repaired at the contractor's expense.
3. Contractor shall verify flow-lines and structure tops prior to construction, and shall notify Engineer of any discrepancies. Provide shop drawings for all precast and manufactured utility structures for review by the Engineer prior to construction of the structures.
4. Utility Separation: Waterlines shall have a minimum of 10 feet horizontal and 2 feet vertical separation from all sanitary sewer lines, manholes, and sanitary sewer service laterals, as measured from edge to edge. If minimum separations can not be obtained, concrete encasement of the sanitary line shall be required 10 feet in each direction of the conflict.
5. Payment for trenching, backfilling, pipe embedment, flowable fill, backfill materials, clean up, seeding, sodding and any other items necessary for the construction of the utility line shall be included in the contract price for the utility installation.
6. The Contractor shall be responsible for contacting respective utility companies 48-hours in advance for the inspection of any proposed utility main extension or service line or service connection to any existing main.
7. Trench spoils shall be neatly placed onsite adjacent to the trench, and compacted to prevent saturation and excess sediment runoff. Unsuitable materials, excess rock and shale, asphalt, concrete, trees, brush etc. shall be properly disposed of offsite. Materials may be wasted onsite at the direction of the Owner or his appointed representative.
8. All excavation is considered unclassified, unless noted otherwise. Unclassified excavation for utility trenching is subsidiary to the unit price provided for the pipe. Any quantity provided for rock excavation is estimated based on the best information provided to the Project Engineer. The Engineer has the authority to identify and define the physical characteristics to determine the classification. Unit price quantities for rock excavation will be paid at a trench width of the nominal pipe diameter of the installed main plus 18 inches. Contractor is required to dispose of excess rock from their trenches by disposing it in areas as specified by the Project Engineer.

Sheet List Table	
Sheet Number	Sheet Title
1	COVER SHEET
2	GENERAL LAYOUT
3	OVERALL GRADING PLAN
4	GRADING PLAN
5	OVERALL DRAINAGE MAP
6	REUNION - DRAINAGE MAP
7	PRE-CONSTRUCTION EROSION CONTROL PLAN
8	EROSION CONTROL PLAN
9	POST-CONSTRUCTION EROSION CONTROL PLAN
10	RILEY STREET - PLAN & PROFILE
11	SE GRIFFIN STREET - PLAN & PROFILE
12	RILEY LANE - PLAN & PROFILE
13	RILEY PLACE - PLAN & PROFILE
14	INTERSECTION DETAILS
15	INTERSECTION DETAILS
16	STREET DETAILS
17	STREET DETAILS
18	STORM PLAN
19	STORM CALCS
20	STORM CALCS
21	STORM PROFILES
22	STORM PROFILES
23	STORM DETAILS
24	STORM DETAILS
24	STREET SIGN PLAN
26	STREET SIGN DETAILS

APPROVED BY:

FORE REVIEW ONLY

CITY ENGINEER _____ DATE _____
APPROVED FOR ONE YEAR FROM THIS DATE

OWNER/DEVELOPER:

GRIFFIN RILEY PROPERTY GROUP
JAKE LOVELESS, VICE PRESIDENT
21 SE 29TH TERRACE
LEE'S SUMMIT
p 816-366-7900
JAKE@GRIFFINRILEY.COM

MO GRS BENCHMARK:

STATION NAME - JA-90

KC METRO ALUMINUM GRS DISK SET IN CONCRETE STAMPED "JA-90, 1988" LOCATED NEAR THE INTERSECTION OF LANGSFORD ROAD AND OLD LANGSFORD ROAD, 43 FEET SOUTHEAST OF THE CENTER OF LANGSFORD ROAD AND 32 FEET NORTH OF THE CENTER OF OLD LANGSFORD ROAD. N:1001052.8503, E:2845604.8272

ELEV. 997.045

PROJECT BENCHMARK:


"SQUARE" CUT IN TOP OF CONCRETE STORM MANHOLE STORM MANHOLE IS LOCATED APPROX. 130 FEET EAST OF THE INTERSECTION OF SE JOEL AVE & BLUE PARKWAY AND 26 FEET SOUTH OF THE CENTERLINE OF BLUE PARKWAY. N:996874.9690, E:2840937.1365

ELEV. 1005.719

SUMMARY OF QUANTITIES			
ITEM	QUANTITY	UNITS	
1			
2			
3			
4			
5			
6			
7			
8			
9			
10			
11			
12			
13			
14			
15			
16			
17			
18			
19			
20			

NOTE:
QUANTITIES SHALL BE PROVIDED WITH SECOND SUBMITTAL.

SCHLAGEL
ENGINEERS PLANNERS SURVEYORS LANDSCAPE ARCHITECTS
14920 West 107th Street • Lenexa, Kansas 66215
(913) 492-5158 • Fax: (913) 492-8400
WWW.SCHLAGELASSOCIATES.COM
Missouri State Certificates of Authority
#E200203860P #LAC200100523P #LS200200869F

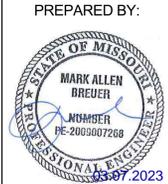

SCHLAGEL & ASSOCIATES, P.A.


**REUNION AT BLACKWELL
PUBLIC STREET AND STORM SEWER PLANS
SE SHENANDOAH DRIVE LEE'S SUMMIT, MO**

REVISION DATE	DRAWN BY	CHECKED BY	DATE PREPARED	PROJ. NUMBER	DESCRIPTION
	TRC	MAB	03/05/2023	22-297	

COVER SHEET

SHEET
1

REUNION AT BLACKWELL
PUBLIC STREET AND STORM SEWER PLANS
SE SHENANDOAH DRIVE LEE'S SUMMIT, MO

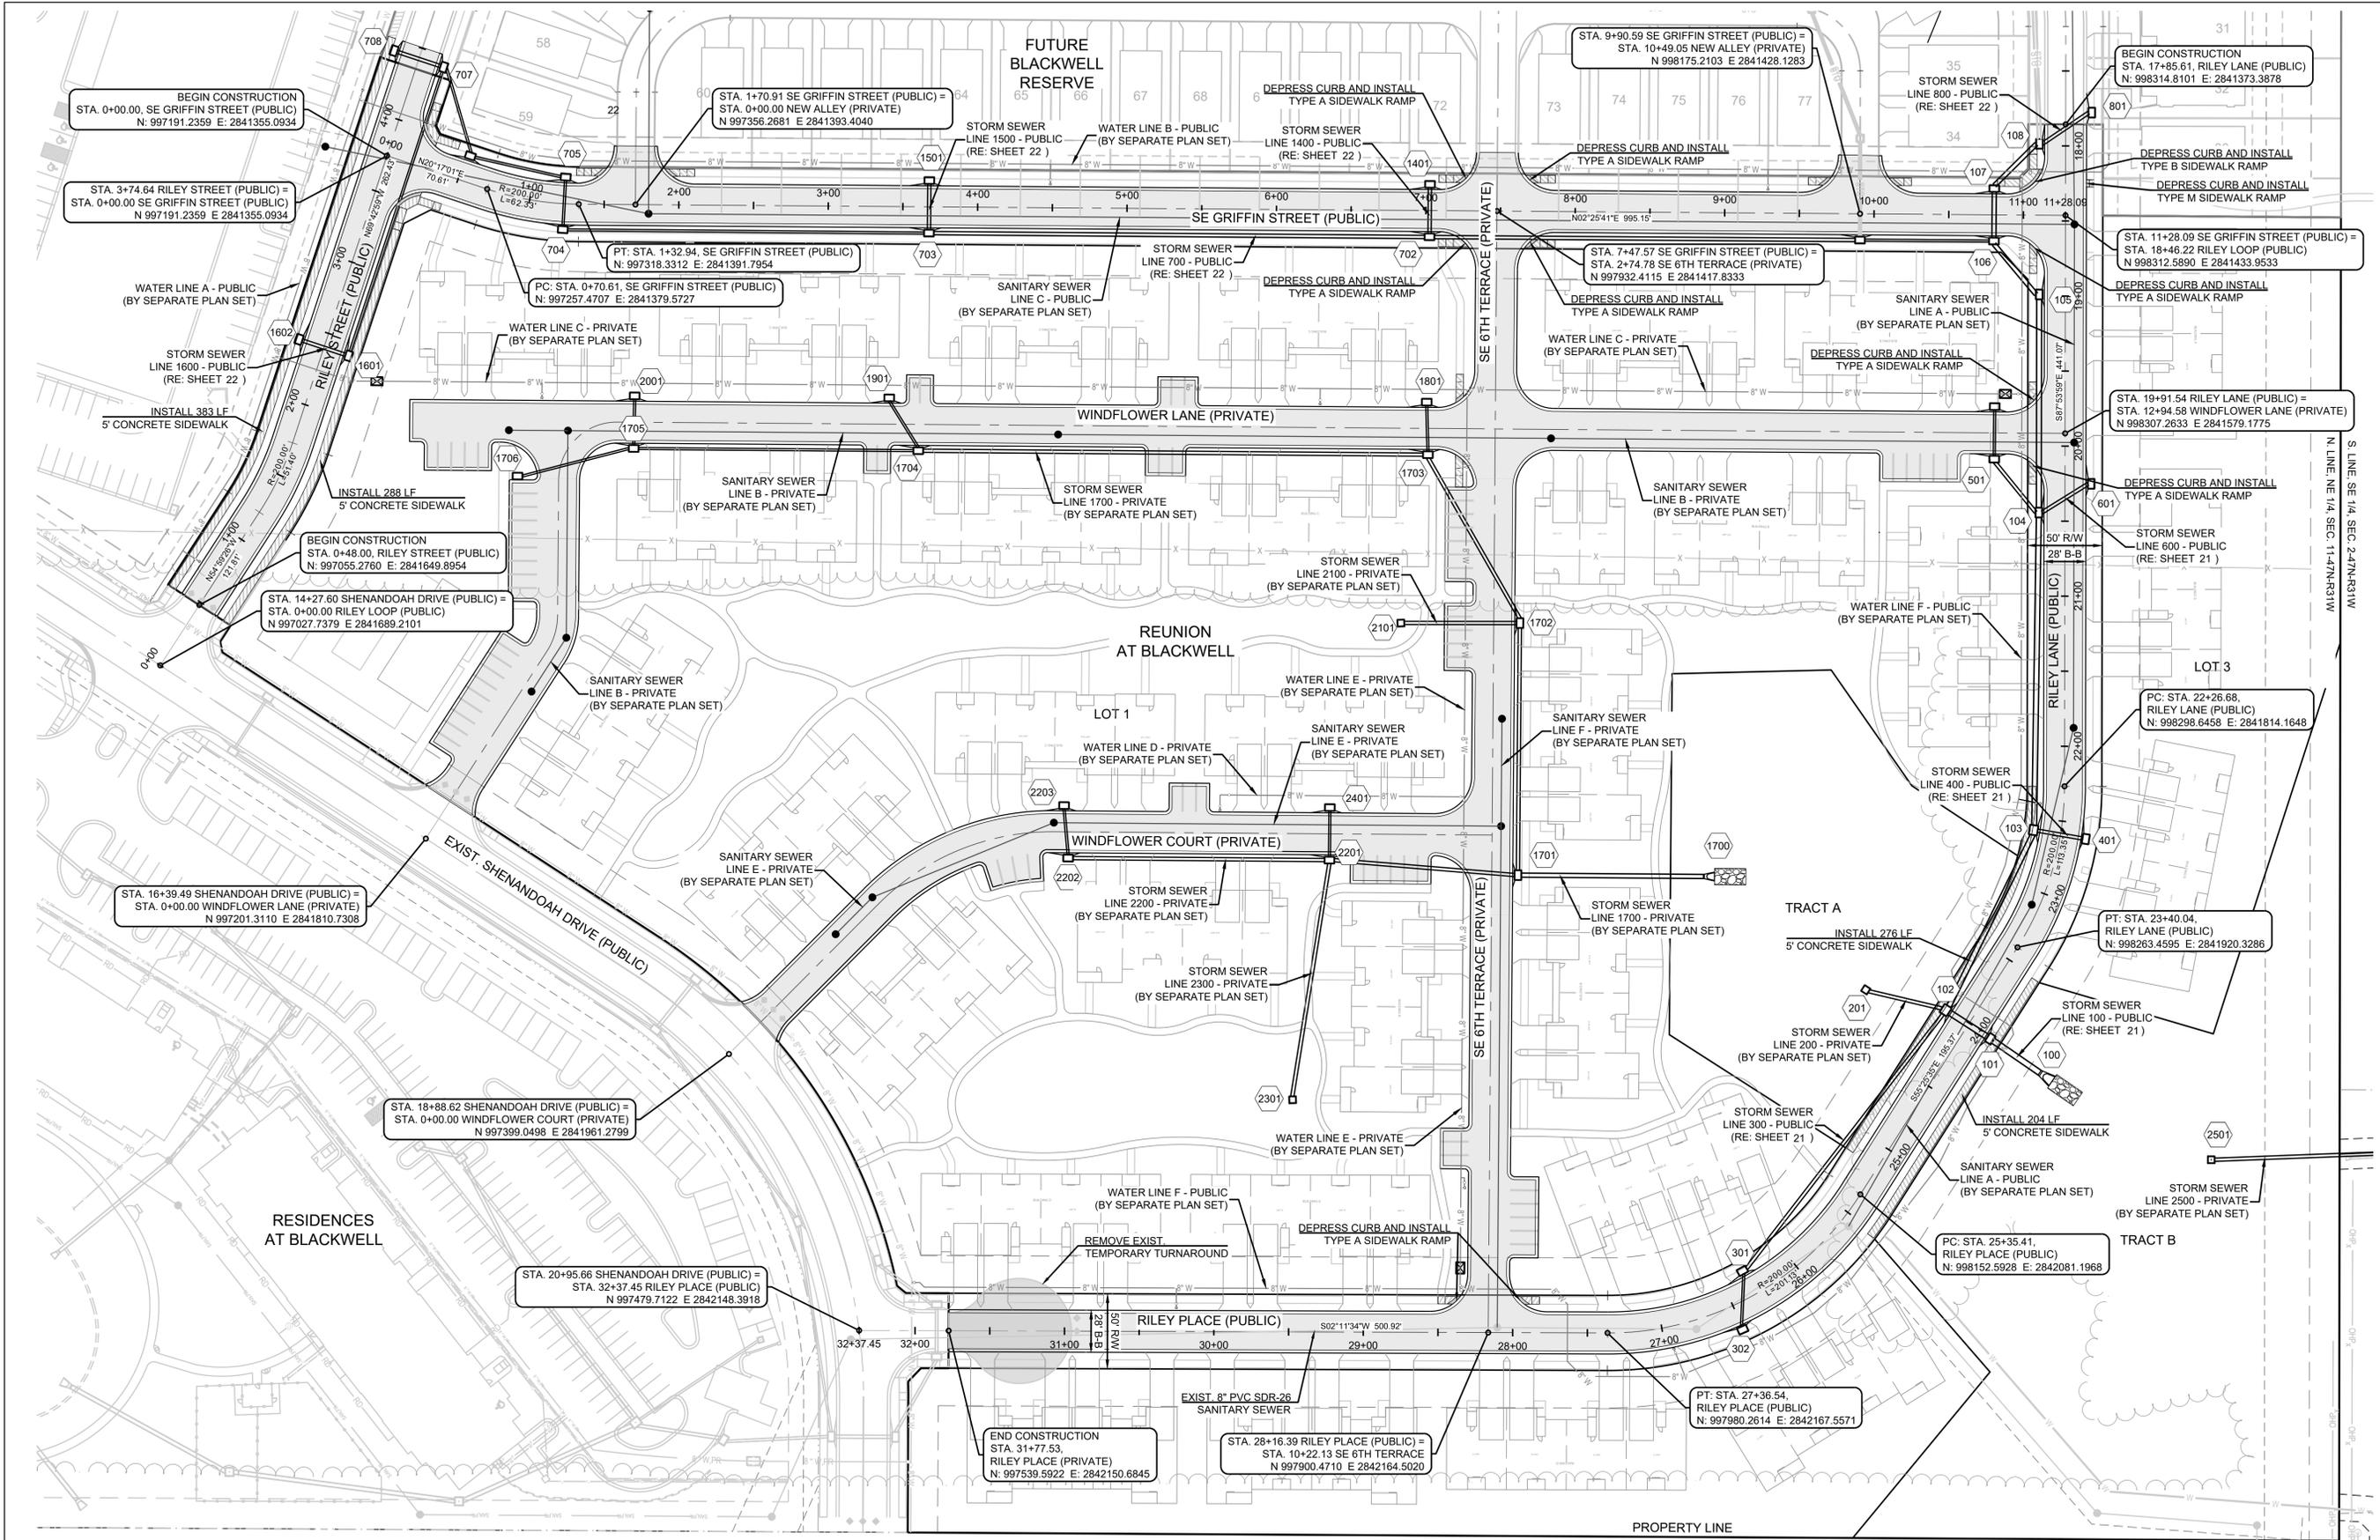


PRIVATE ROAD NOTE:
 WINDFLOWER LANE, WINDFLOWER COURT & SE 6TH TERRACE ARE PRIVATE ROADS AND WILL BE CONSTRUCTED UNDER A SEPARATE PLAN SET.

SIDEWALK NOTE:
 SIDEWALKS AT BUILDINGS WILL BE INSTALLED BY OTHERS, UNLESS NOTED OTHERWISE.


MO GRS BENCHMARK:
 STATION NAME - JA-90
 KC METRO ALUMINUM GRS DISK SET IN CONCRETE STAMPED "JA-90, 1988" LOCATED NEAR THE INTERSECTION OF LANGSFORD ROAD AND OLD LANGSFORD ROAD. 43 FEET SOUTHEAST OF THE CENTER OF LANGSFORD ROAD AND 32 FEET NORTH OF THE CENTER OF OLD LANGSFORD ROAD.
 N:1001052.8503, E:2845604.8272
 ELEV. 997.045

PROJECT BENCHMARK:
 "SQUARE" CUT IN TOP OF CONCRETE STORM MANHOLE STORM MANHOLE IS LOCATED APPROX. 130 FEET EAST OF THE INTERSECTION OF SE JOEL AVE & BLUE PARKWAY AND 26 FEET SOUTH OF THE CENTERLINE OF BLUE PARKWAY.
 N:996874.9690, E:2840937.1365
 ELEV. 1005.719

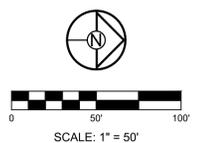

REVISION DATE	DESCRIPTION

GENERAL LAYOUT

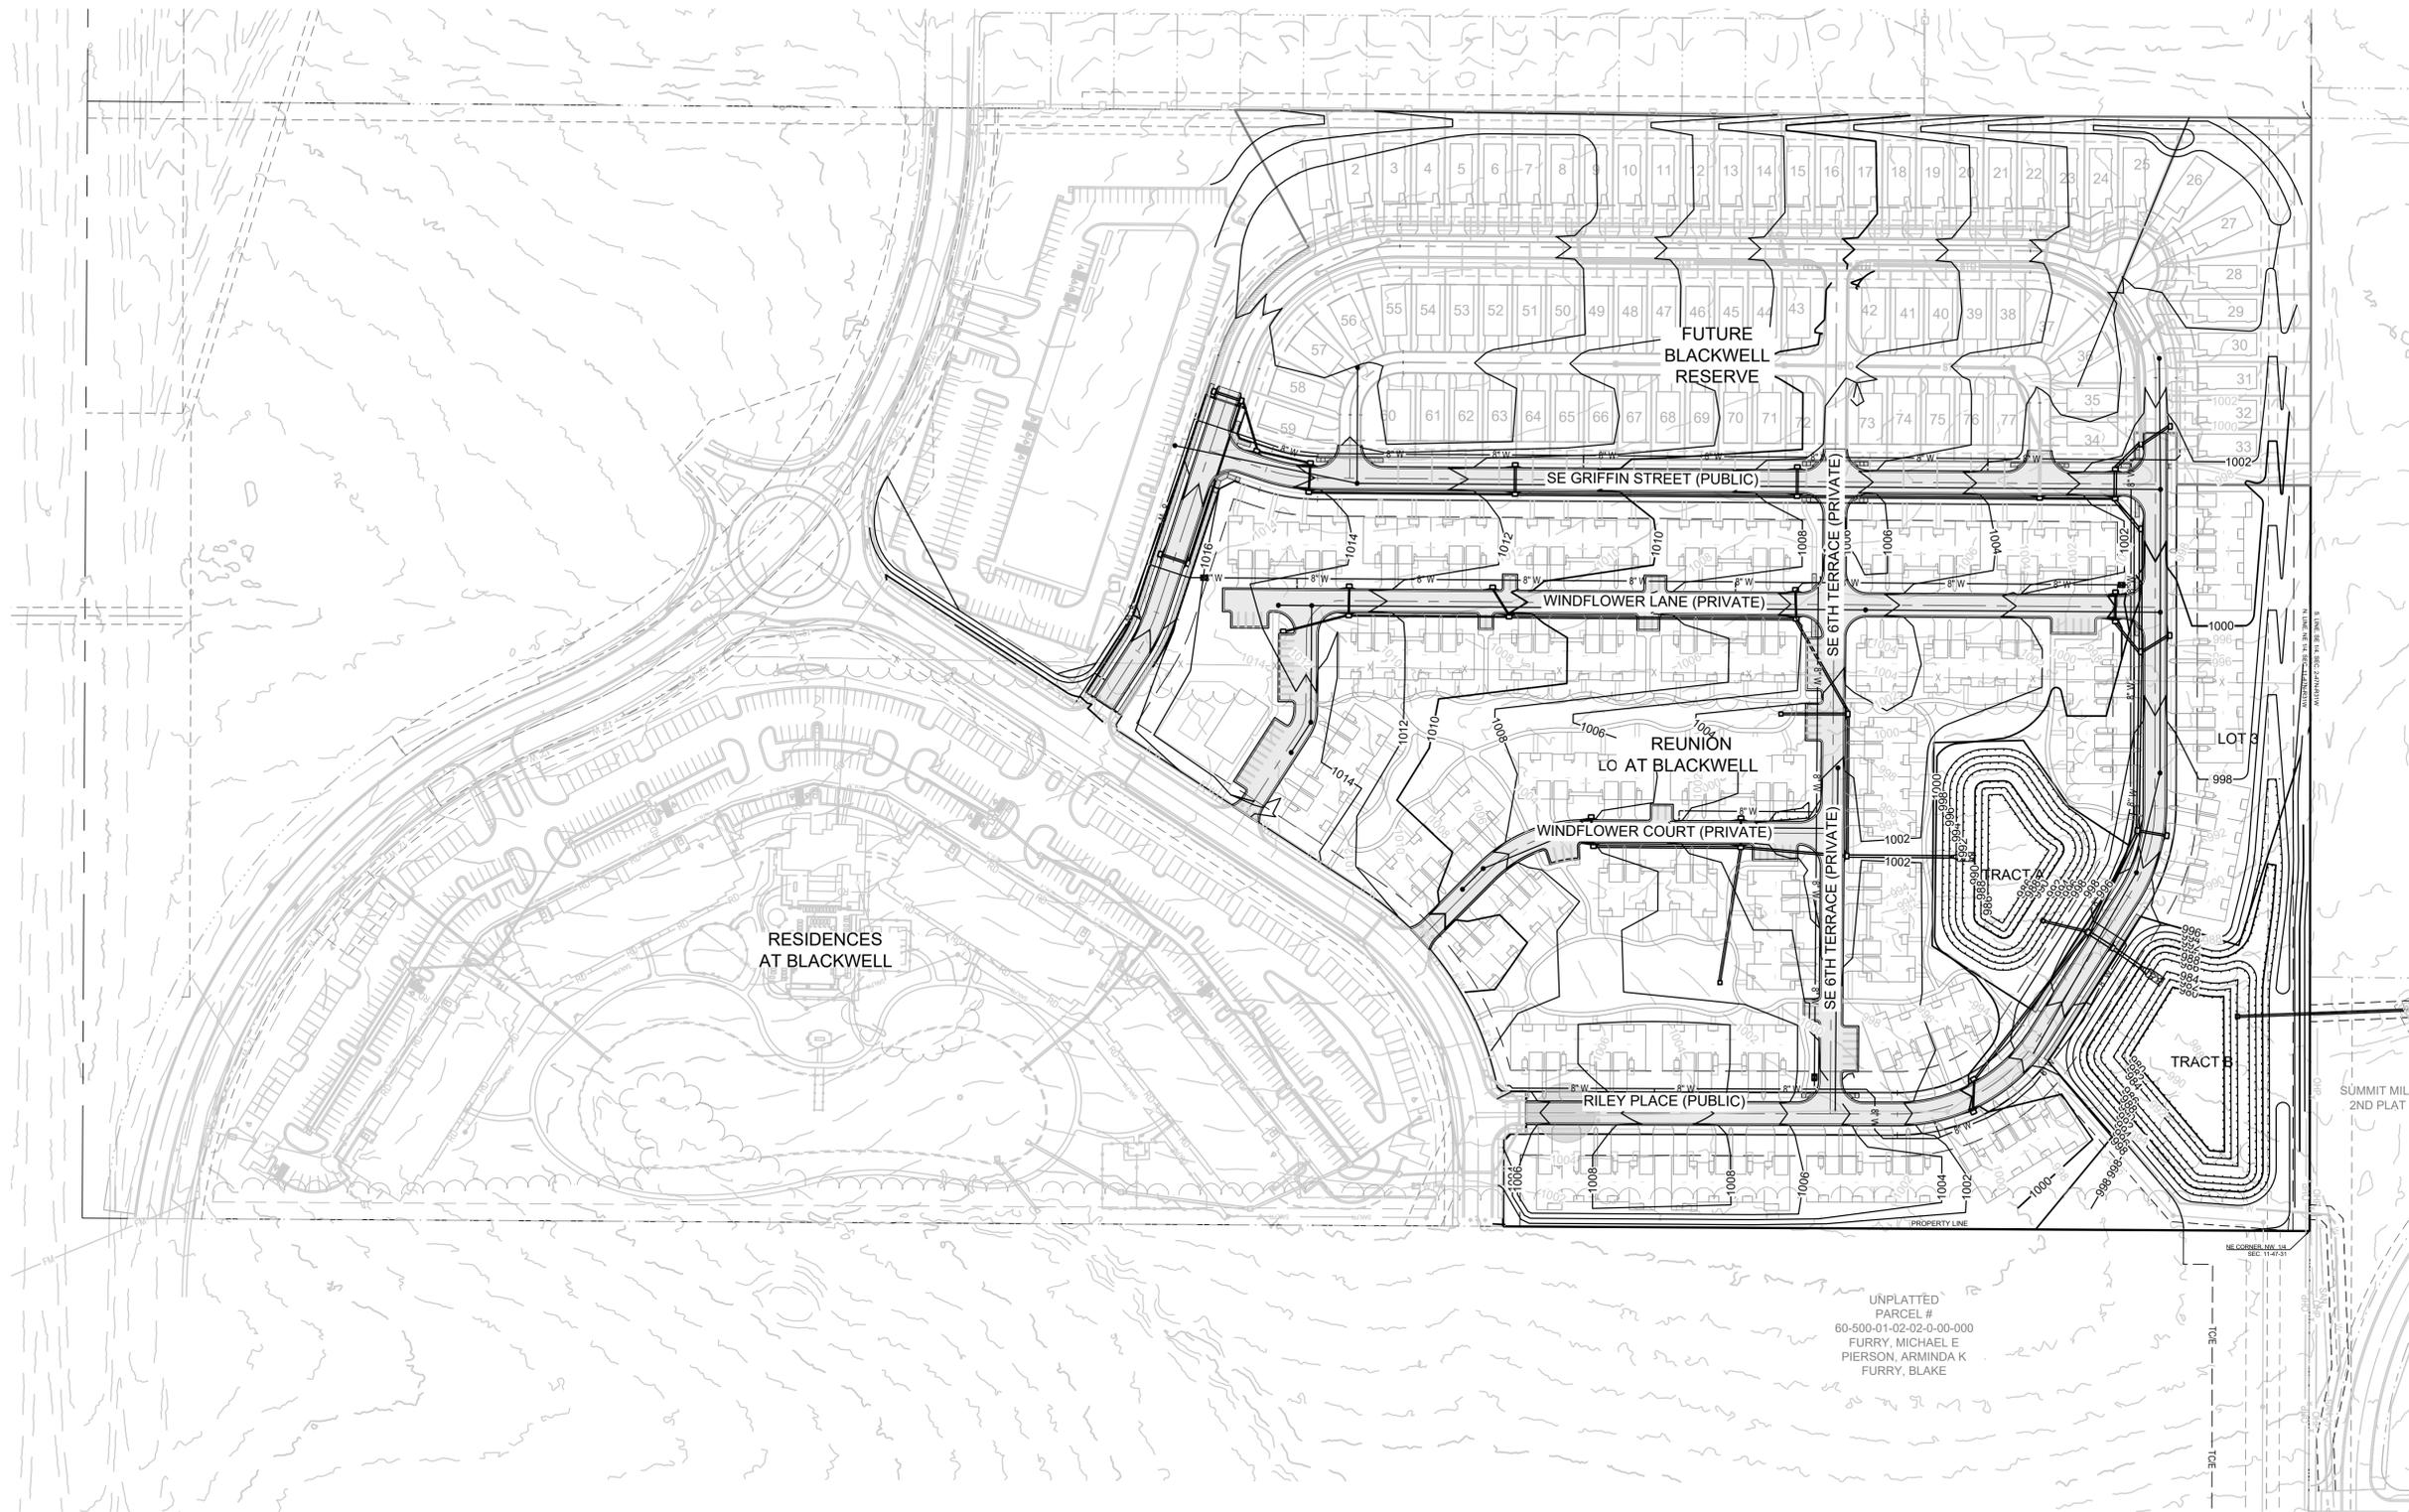


GRADING LEGEND:
 - - - 1000 - - - EXISTING CONTOUR
 ——— 1000 ——— PROPOSED CONTOUR
 (FINISHED GRADE)


- NOTES:**
- ALL CONSTRUCTION ON THIS PROJECT SHALL CONFORM TO THE CITY OF LEE'S SUMMIT TECHNICAL SPECIFICATIONS.
 - THE CONTRACTOR IS RESPONSIBLE FOR VERIFYING ALL EXISTING UTILITY LOCATIONS PRIOR TO EXCAVATION.

MO GRS BENCHMARK:
 STATION NAME - JA-90
 KC METRO ALUMINUM GRS DISK SET IN CONCRETE STAMPED "JA-90, 1988"
 LOCATED NEAR THE INTERSECTION OF LANGSFORD ROAD AND OLD LANGSFORD ROAD, 43 FEET SOUTHEAST OF THE CENTER OF LANGSFORD ROAD AND 32 FEET NORTH OF THE CENTER OF OLD LANGSFORD ROAD.
 N:1001052.8503, E:2845604.8272
 ELEV. 997.045

PROJECT BENCHMARK:
 "SQUARE" CUT IN TOP OF CONCRETE STORM MANHOLE
 STORM MANHOLE IS LOCATED APPROX. 130 FEET EAST OF THE INTERSECTION OF SE JOEL AVE & BLUE PARKWAY AND 26 FEET SOUTH OF THE CENTERLINE OF BLUE PARKWAY.
 N:996874.9690, E:2840937.1365
 ELEV. 1005.719

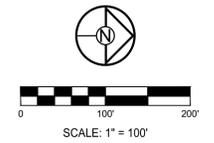


UNPLATTED PARCEL #
 60-500-01-02-02-0-00-000
 FURRY, MICHAEL E
 PIERSON, ARMINDA K
 FURRY, BLAKE

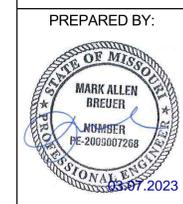

SCHLAGEL & ASSOCIATES, P.A.

**REUNION AT BLACKWELL
 PUBLIC STREET AND STORM SEWER PLANS
 SE SHENANDOAH DRIVE LEE'S SUMMIT, MO**

REVISION DATE	DESCRIPTION

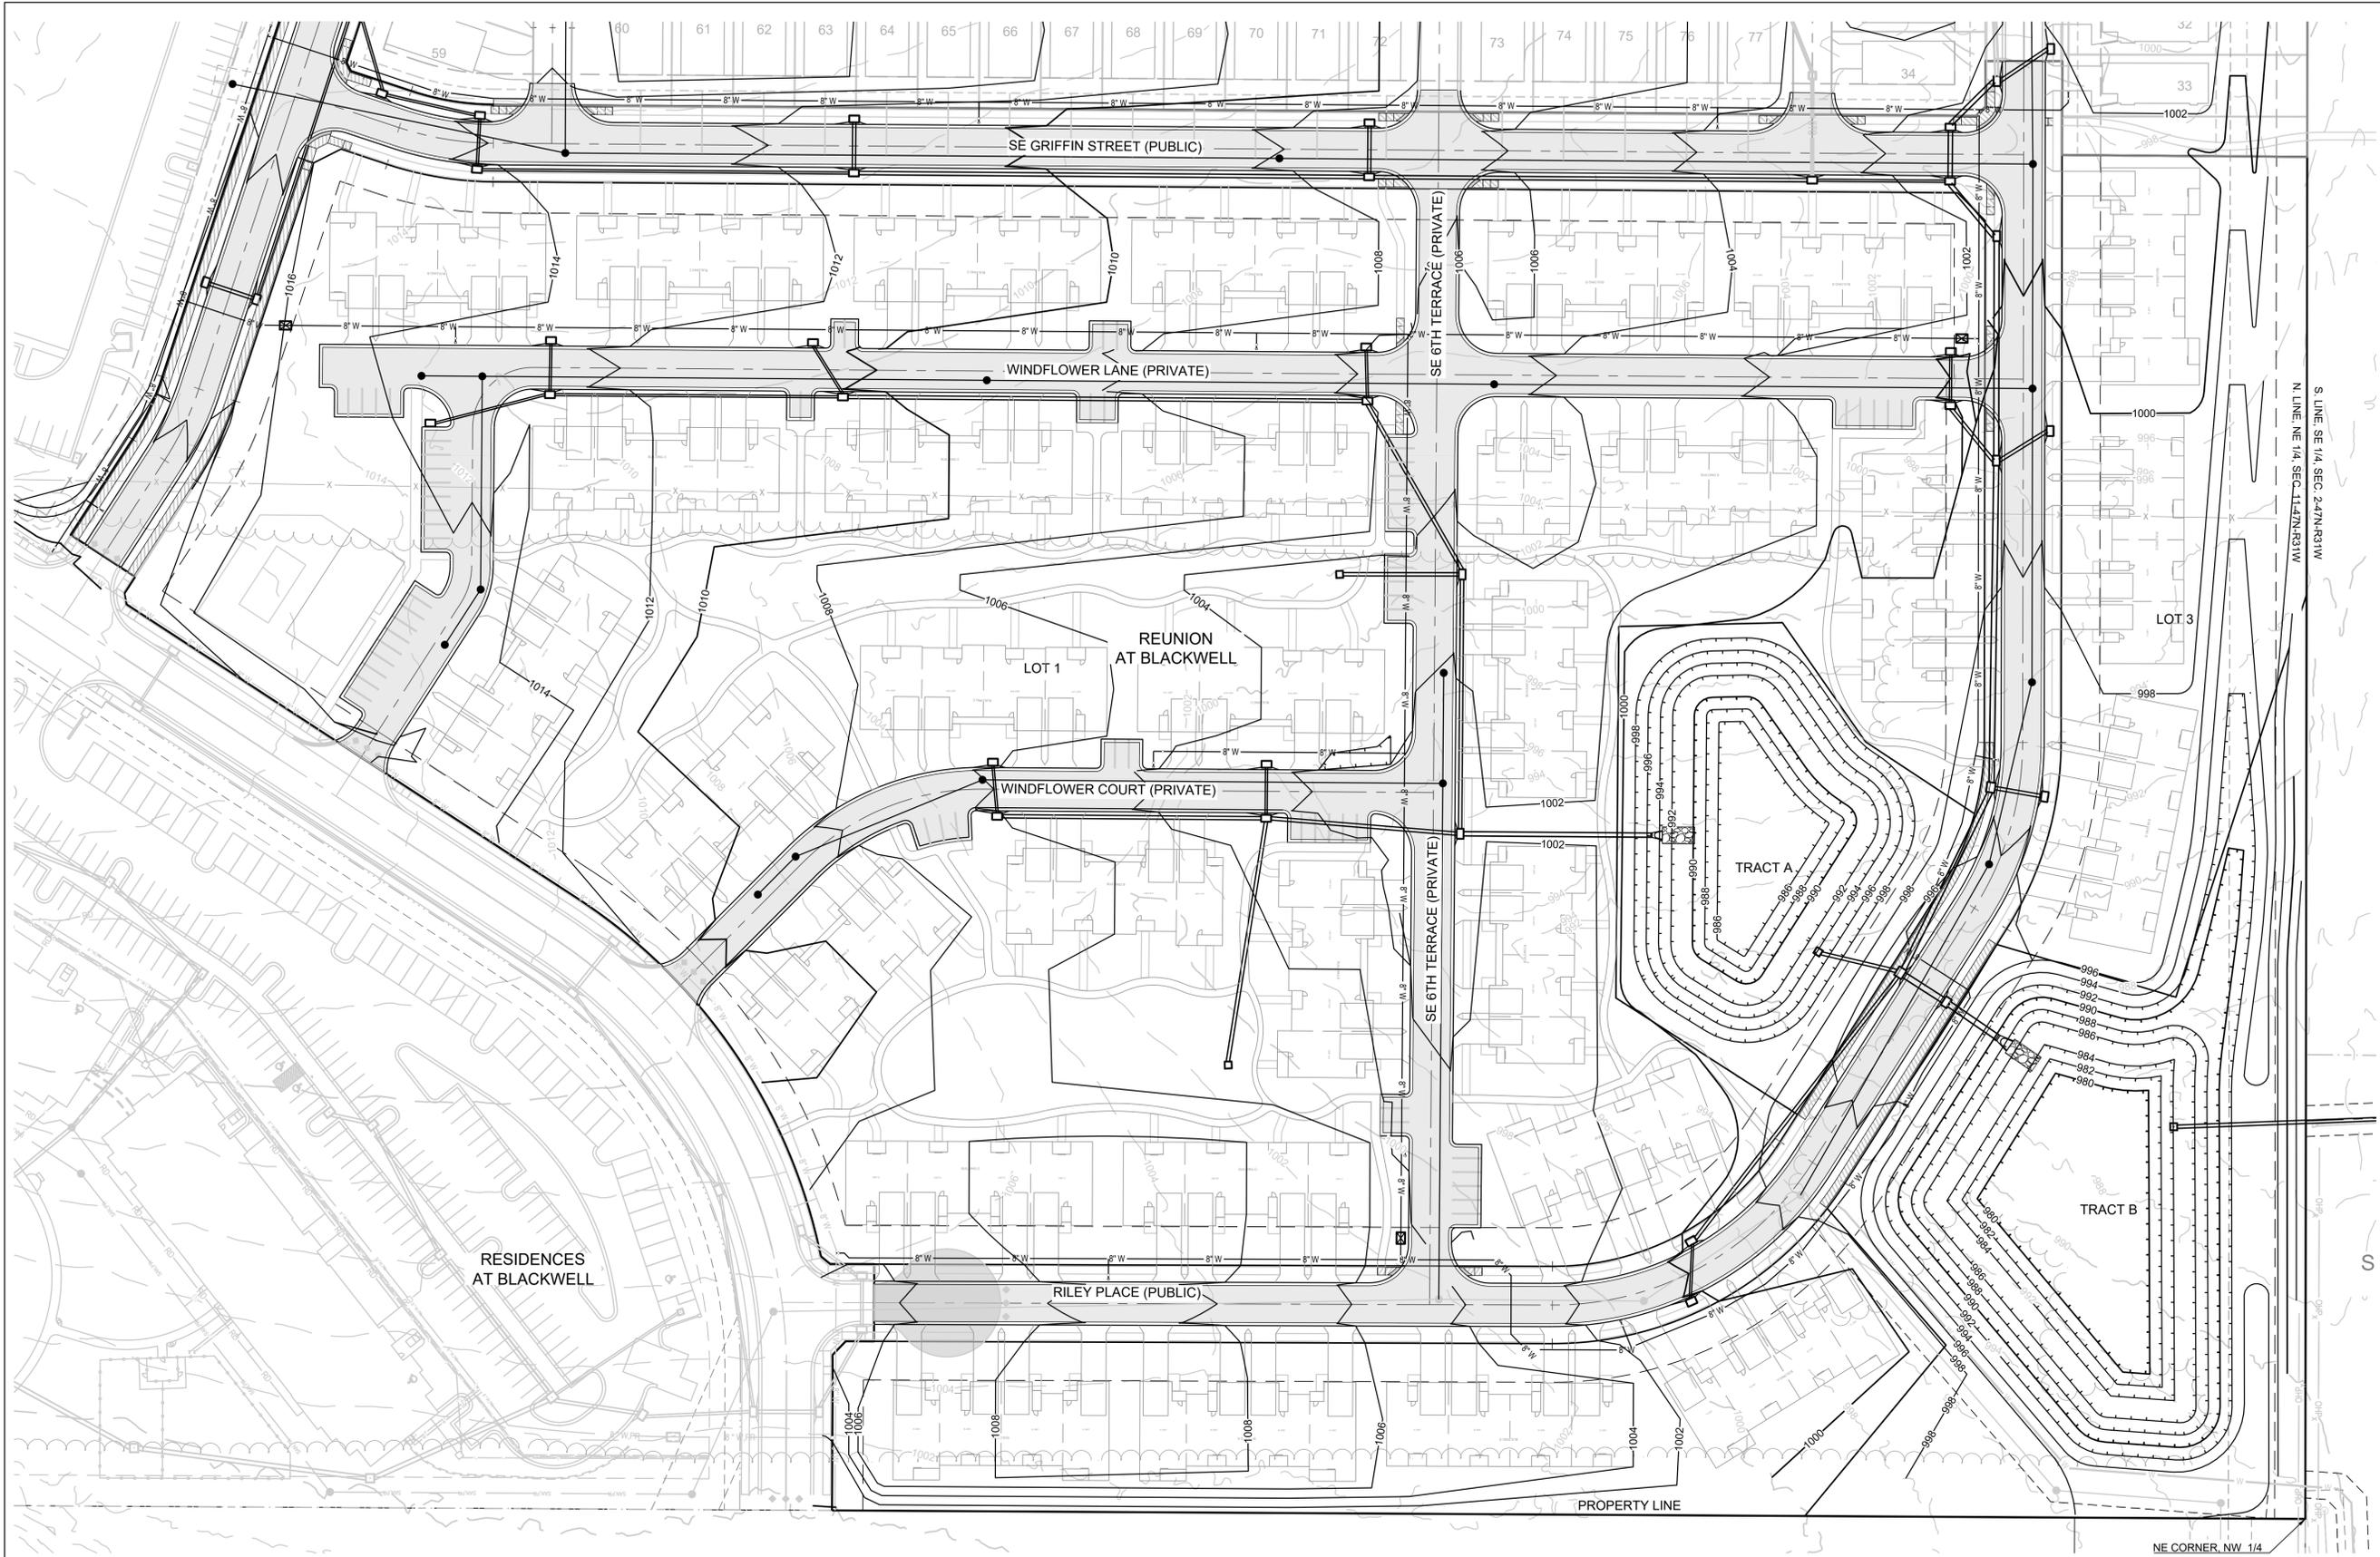


GRADING LEGEND:
 --- 1000 --- EXISTING CONTOUR
 ——— 1000 ——— PROPOSED CONTOUR (FINISHED GRADE)

- NOTES:**
1. ALL CONSTRUCTION ON THIS PROJECT SHALL CONFORM TO THE CITY OF LEE'S SUMMIT TECHNICAL SPECIFICATIONS.
 2. THE CONTRACTOR IS RESPONSIBLE FOR VERIFYING ALL EXISTING UTILITY LOCATIONS PRIOR TO EXCAVATION.

MO GRS BENCHMARK:
 STATION NAME - JA-90
 KC METRO ALUMINUM GRS DISK SET IN CONCRETE STAMPED "JA-90, 1988"
 LOCATED NEAR THE INTERSECTION OF LANGSFORD ROAD AND OLD LANGSFORD ROAD, 43 FEET SOUTHEAST OF THE CENTER OF LANGSFORD ROAD AND 32 FEET NORTH OF THE CENTER OF OLD LANGSFORD ROAD.
 N:1001052.8503, E:2845604.8272
 ELEV. 997.045

PROJECT BENCHMARK:
 "SQUARE" CUT IN TOP OF CONCRETE STORM MANHOLE
 STORM MANHOLE IS LOCATED APPROX. 130 FEET EAST OF THE INTERSECTION OF SE JOEL AVE & BLUE PARKWAY AND 26 FEET SOUTH OF THE CENTERLINE OF BLUE PARKWAY.
 N:996874.9690, E:2840937.1365
 ELEV. 1005.719

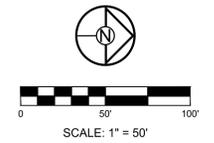

REUNION AT BLACKWELL
 PUBLIC STREET AND STORM SEWER PLANS
 SE SHENANDOAH DRIVE LEE'S SUMMIT, MO

REVISION DATE	DESCRIPTION


GRADING PLAN

PREPARED BY:




SCHLAGEL & ASSOCIATES, P.A.

REUNION AT BLACKWELL
 PUBLIC STREET AND STORM SEWER PLANS
 SE SHENANDOAH DRIVE LEE'S SUMMIT, MO

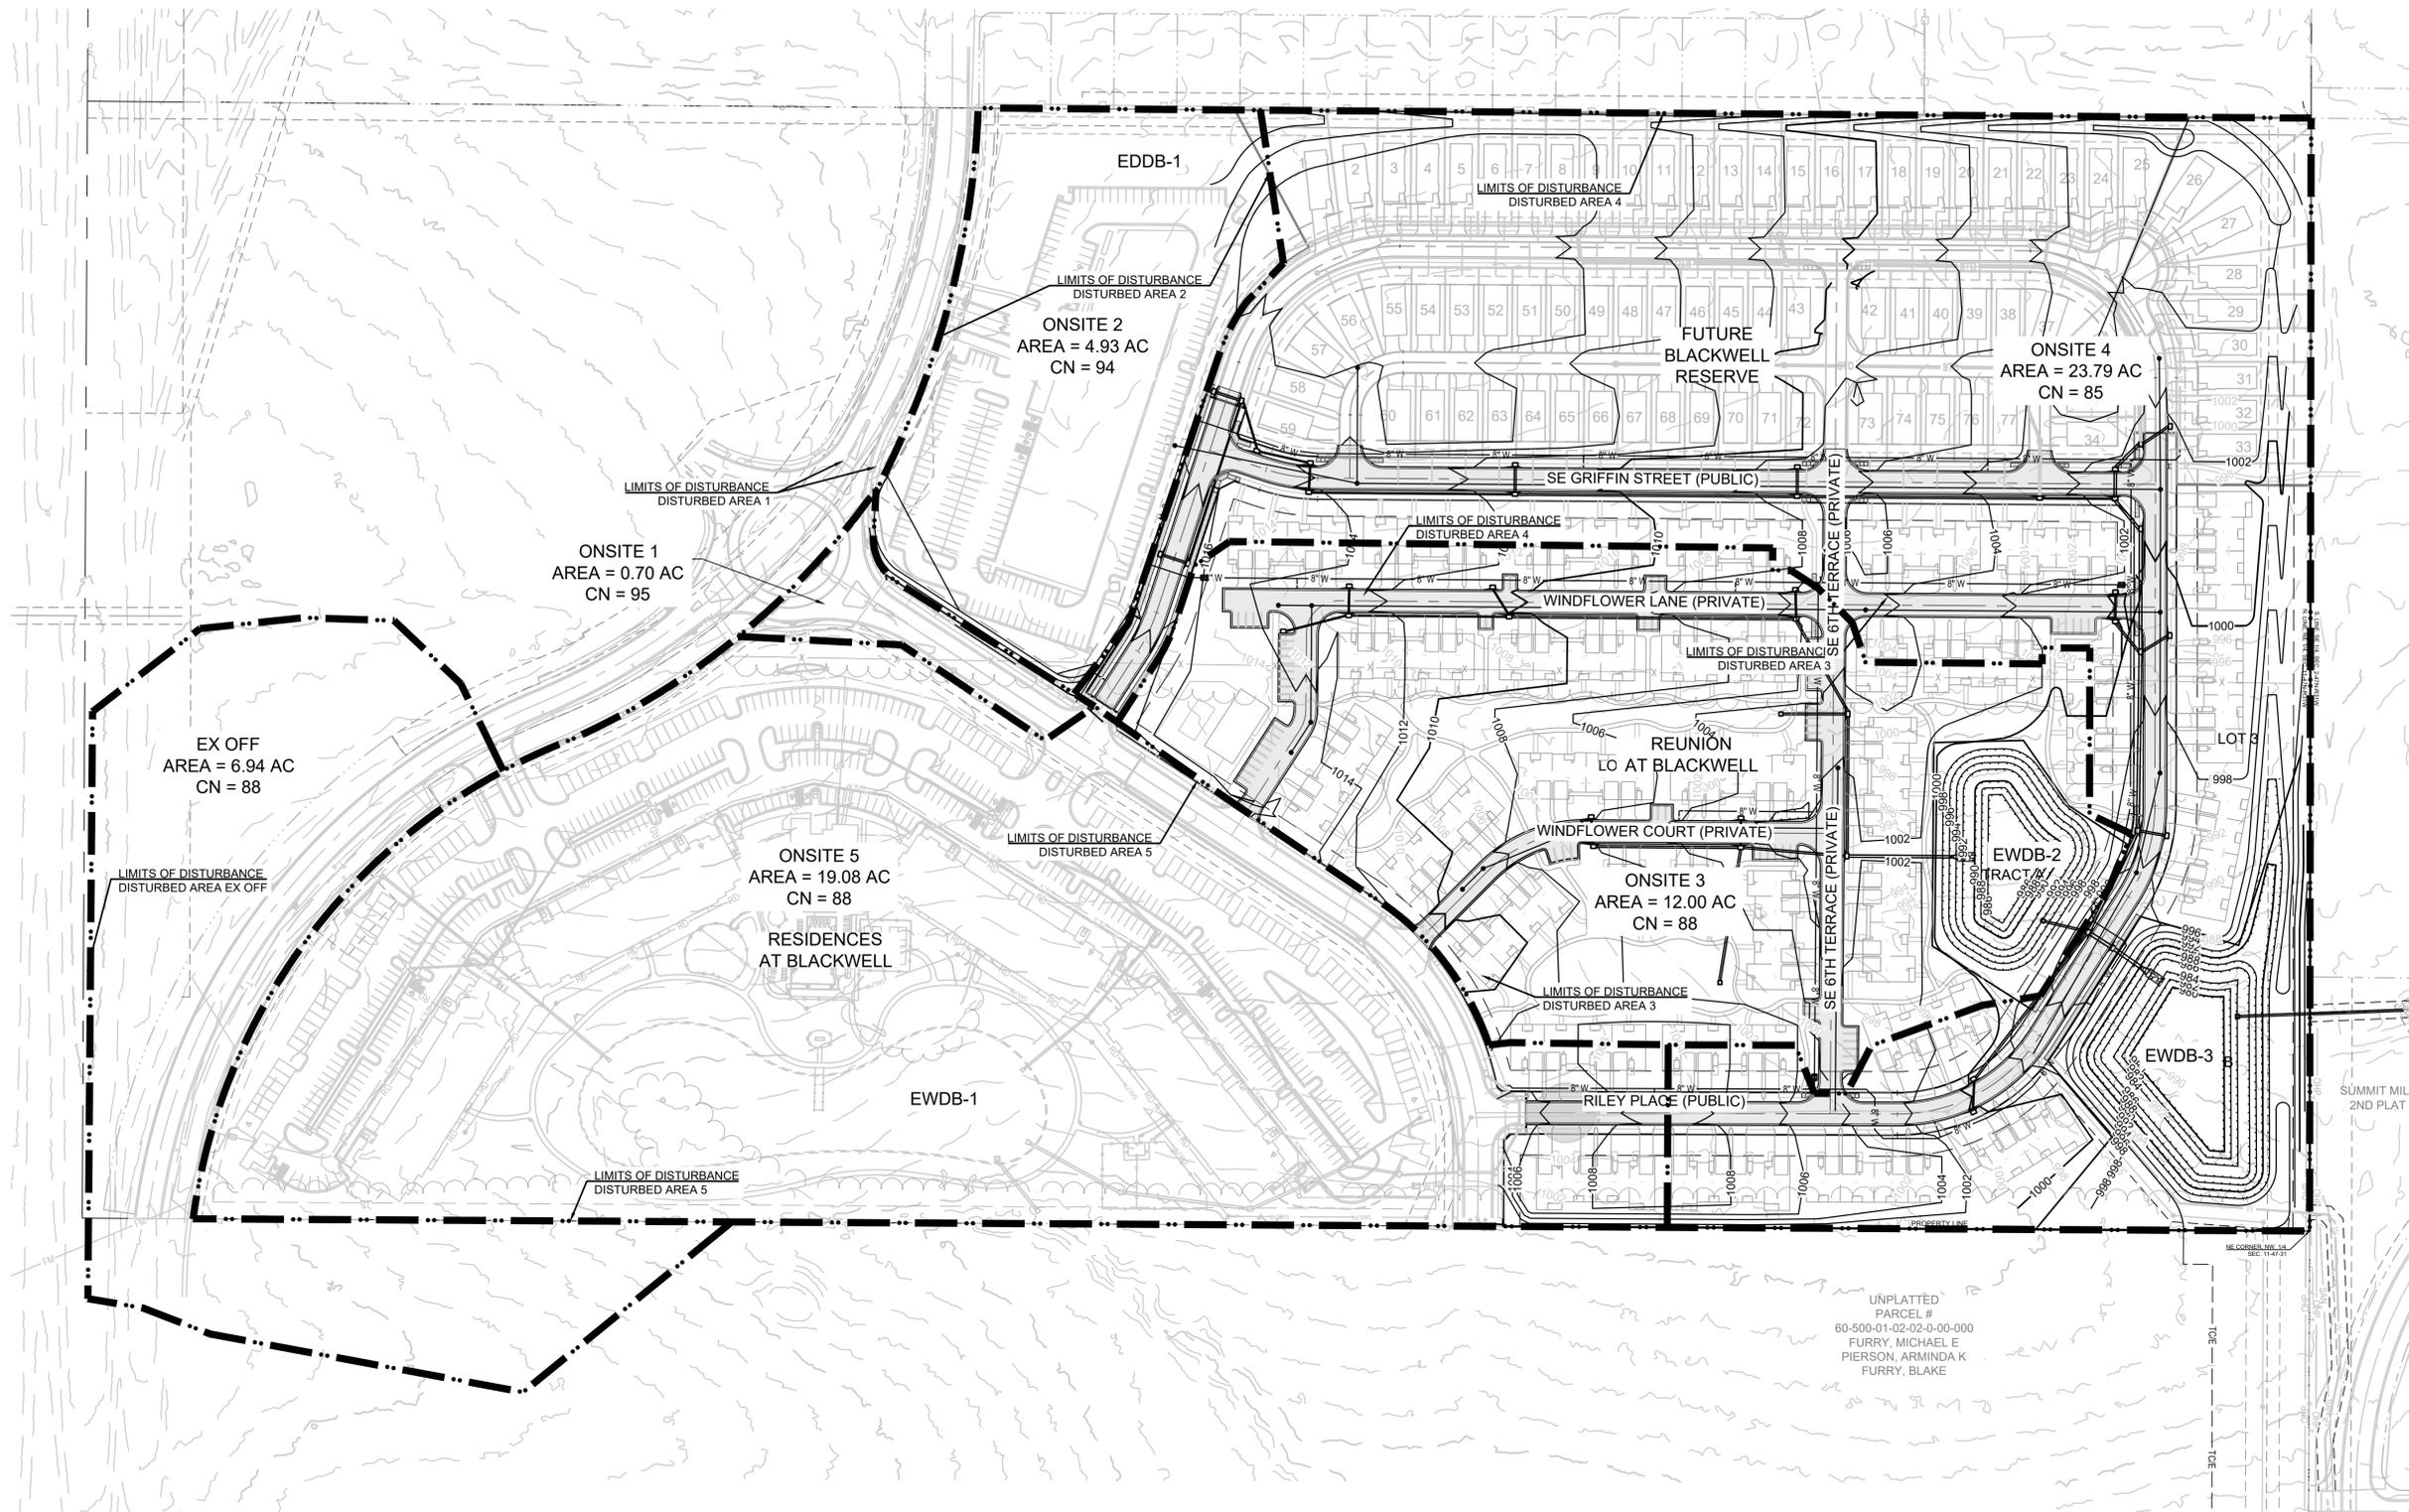

UNPLATTED
 PARCEL #
 60-500-01-02-02-0-00-000
 FURRY, MICHAEL E
 PIERSON, ARMINDA K
 FURRY, BLAKE

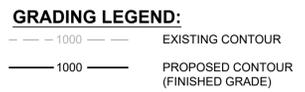

- NOTES:**
- ALL CONSTRUCTION ON THIS PROJECT SHALL CONFORM TO THE CITY OF LEE'S SUMMIT TECHNICAL SPECIFICATIONS.
 - THE CONTRACTOR IS RESPONSIBLE FOR VERIFYING ALL EXISTING UTILITY LOCATIONS PRIOR TO EXCAVATION.

MO GRS BENCHMARK:

STATION NAME - JA-90


KC METRO ALUMINUM GRS DISK SET IN CONCRETE STAMPED "JA-90, 1988" LOCATED NEAR THE INTERSECTION OF LANGSFORD ROAD AND OLD LANGSFORD ROAD, 43 FEET SOUTHEAST OF THE CENTER OF LANGSFORD ROAD AND 32 FEET NORTH OF THE CENTER OF OLD LANGSFORD ROAD.
 N:1001052.8503, E:2845604.8272

ELEV. 997.045

PROJECT BENCHMARK:


"SQUARE" CUT IN TOP OF CONCRETE STORM MANHOLE STORM MANHOLE IS LOCATED APPROX. 130 FEET EAST OF THE INTERSECTION OF SE JOEL AVE & BLUE PARKWAY AND 26 FEET SOUTH OF THE CENTERLINE OF BLUE PARKWAY.
 N:996874.9690, E:2840937.1365

ELEV. 1005.719

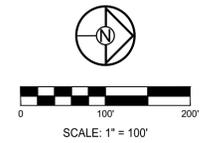

REVISION DATE	DESCRIPTION


OVERALL DRAINAGE MAP

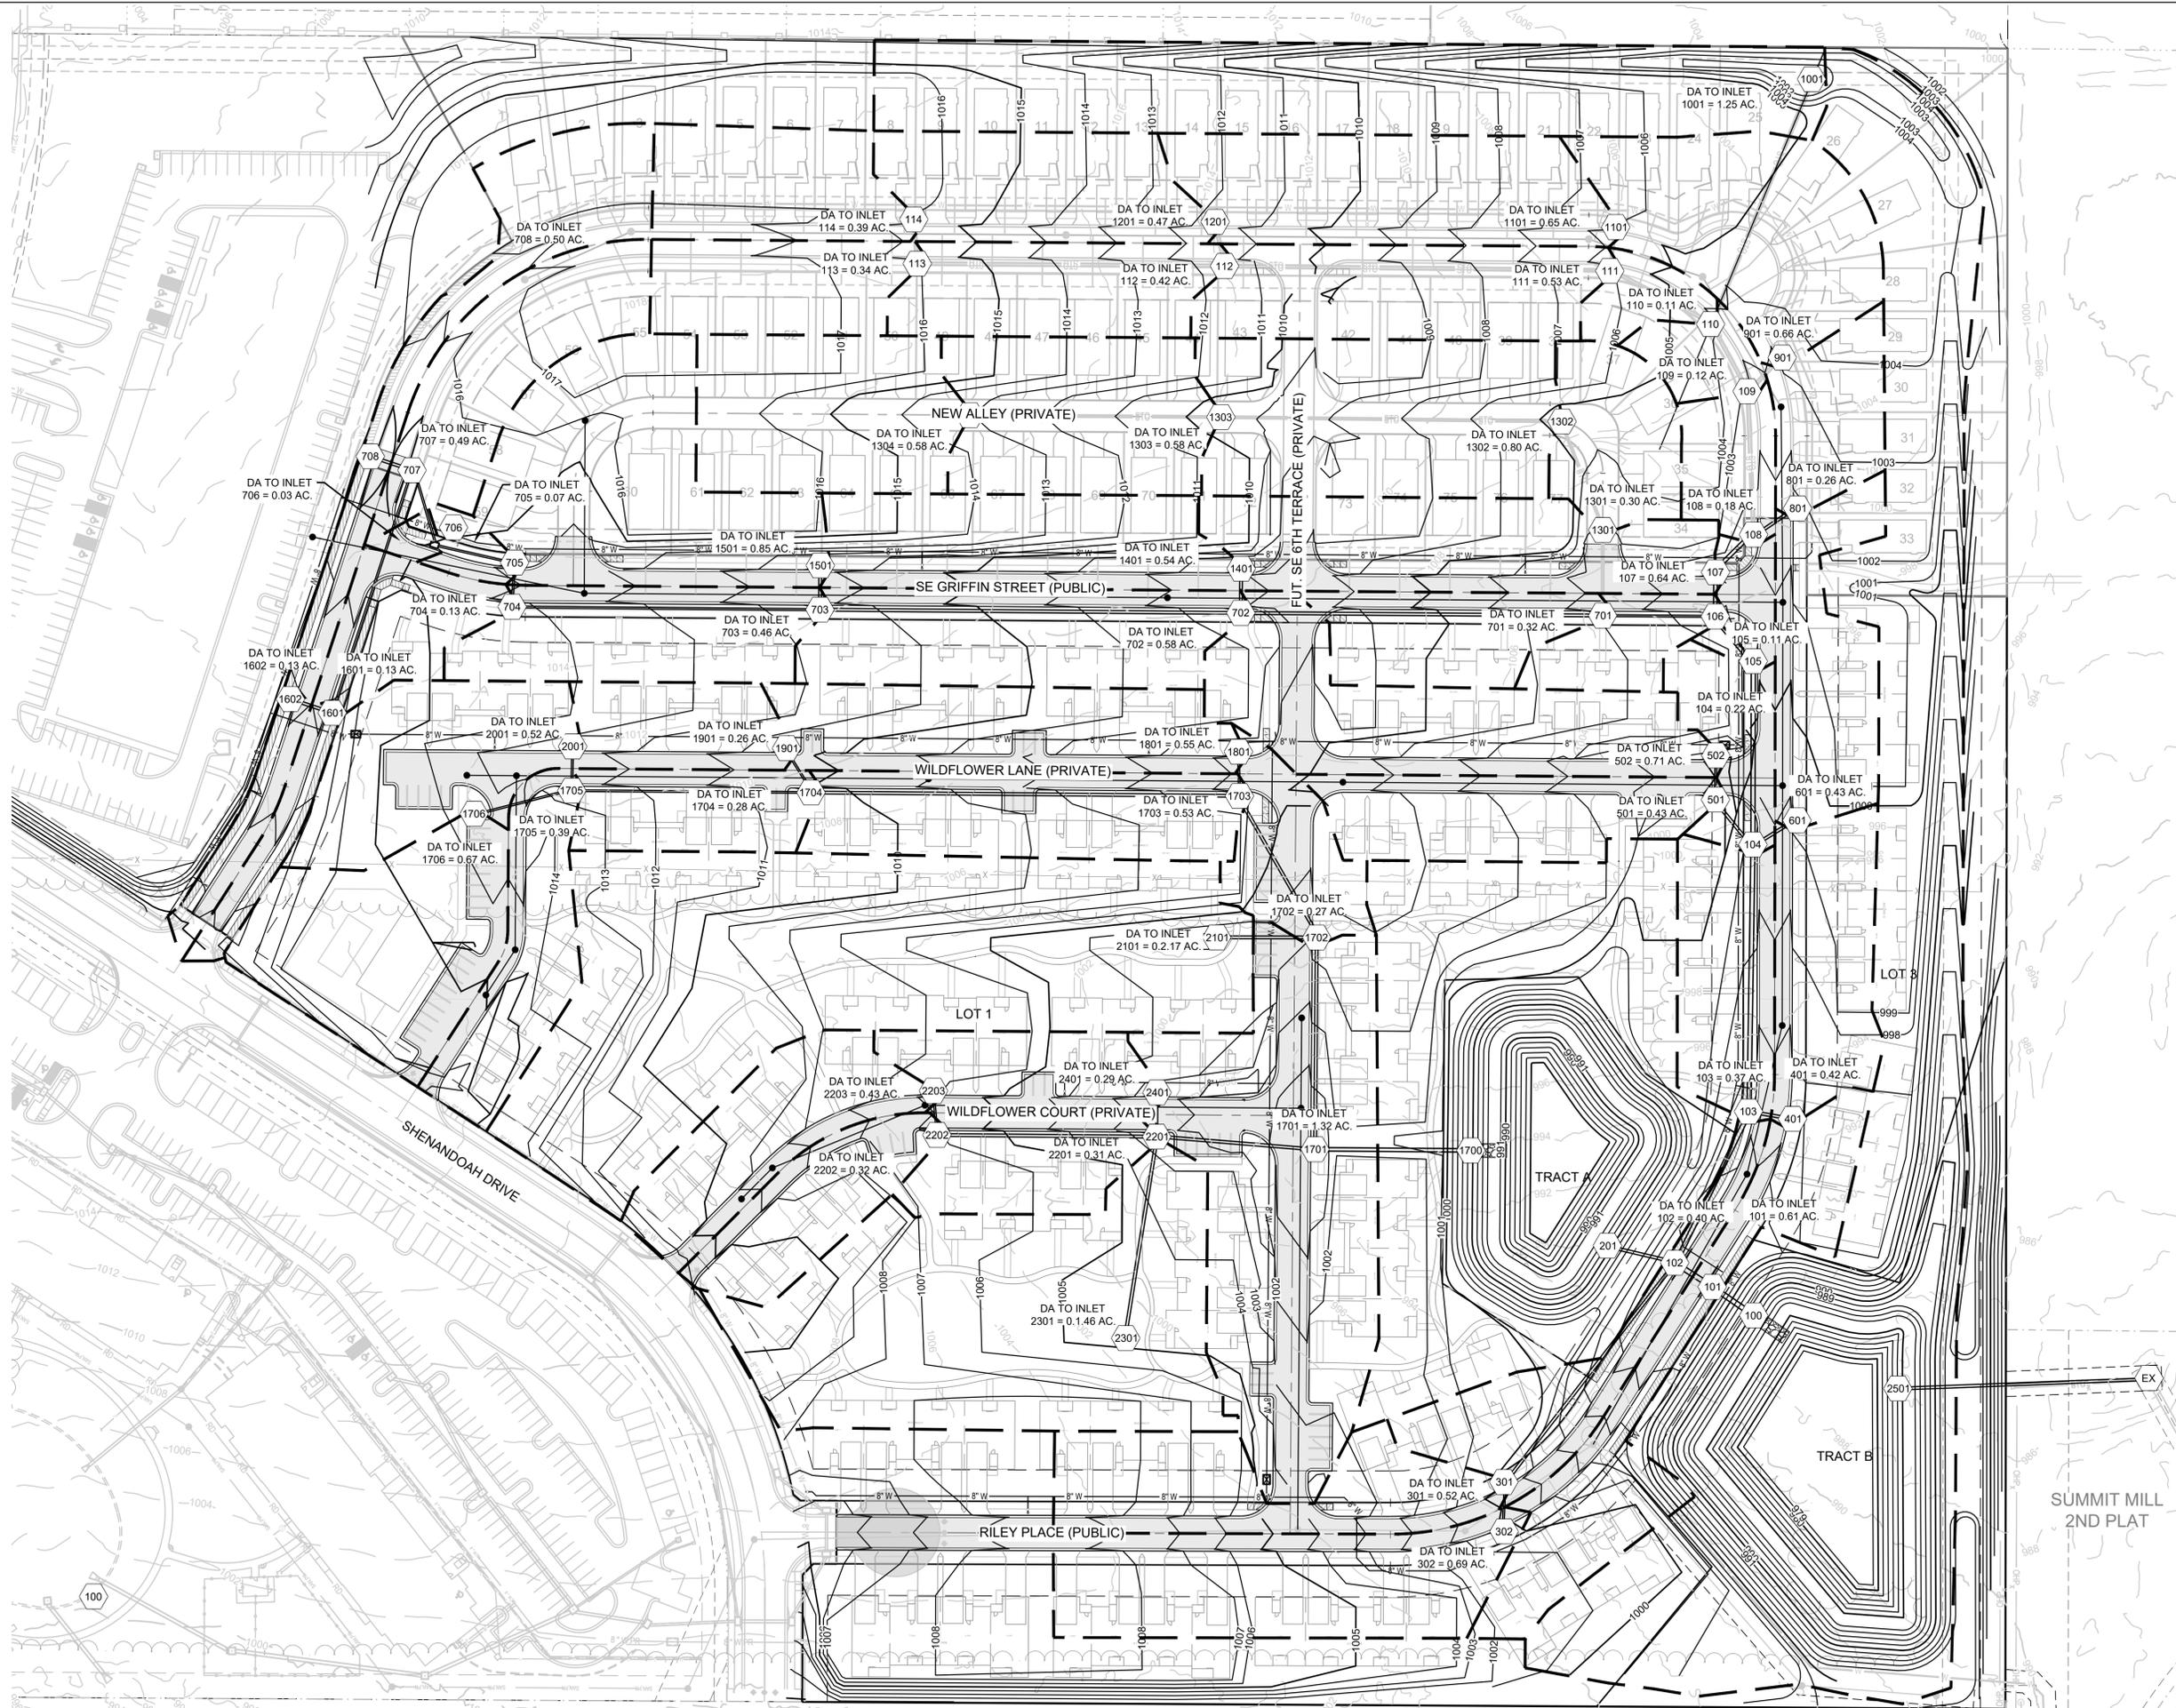


**BLACKWELL RESERVE
 STREET AND STORM SEWER PLANS
 SE SHENANDOAH DRIVE LEE'S SUMMIT, MO**

REVISION DATE	DESCRIPTION

DRAWN BY: ###
 CHECKED BY: ###
 DATE PREPARED: 03/05/2023
 PROJ. NUMBER: 22-293

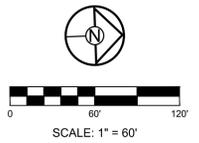

1 INPI ATTED

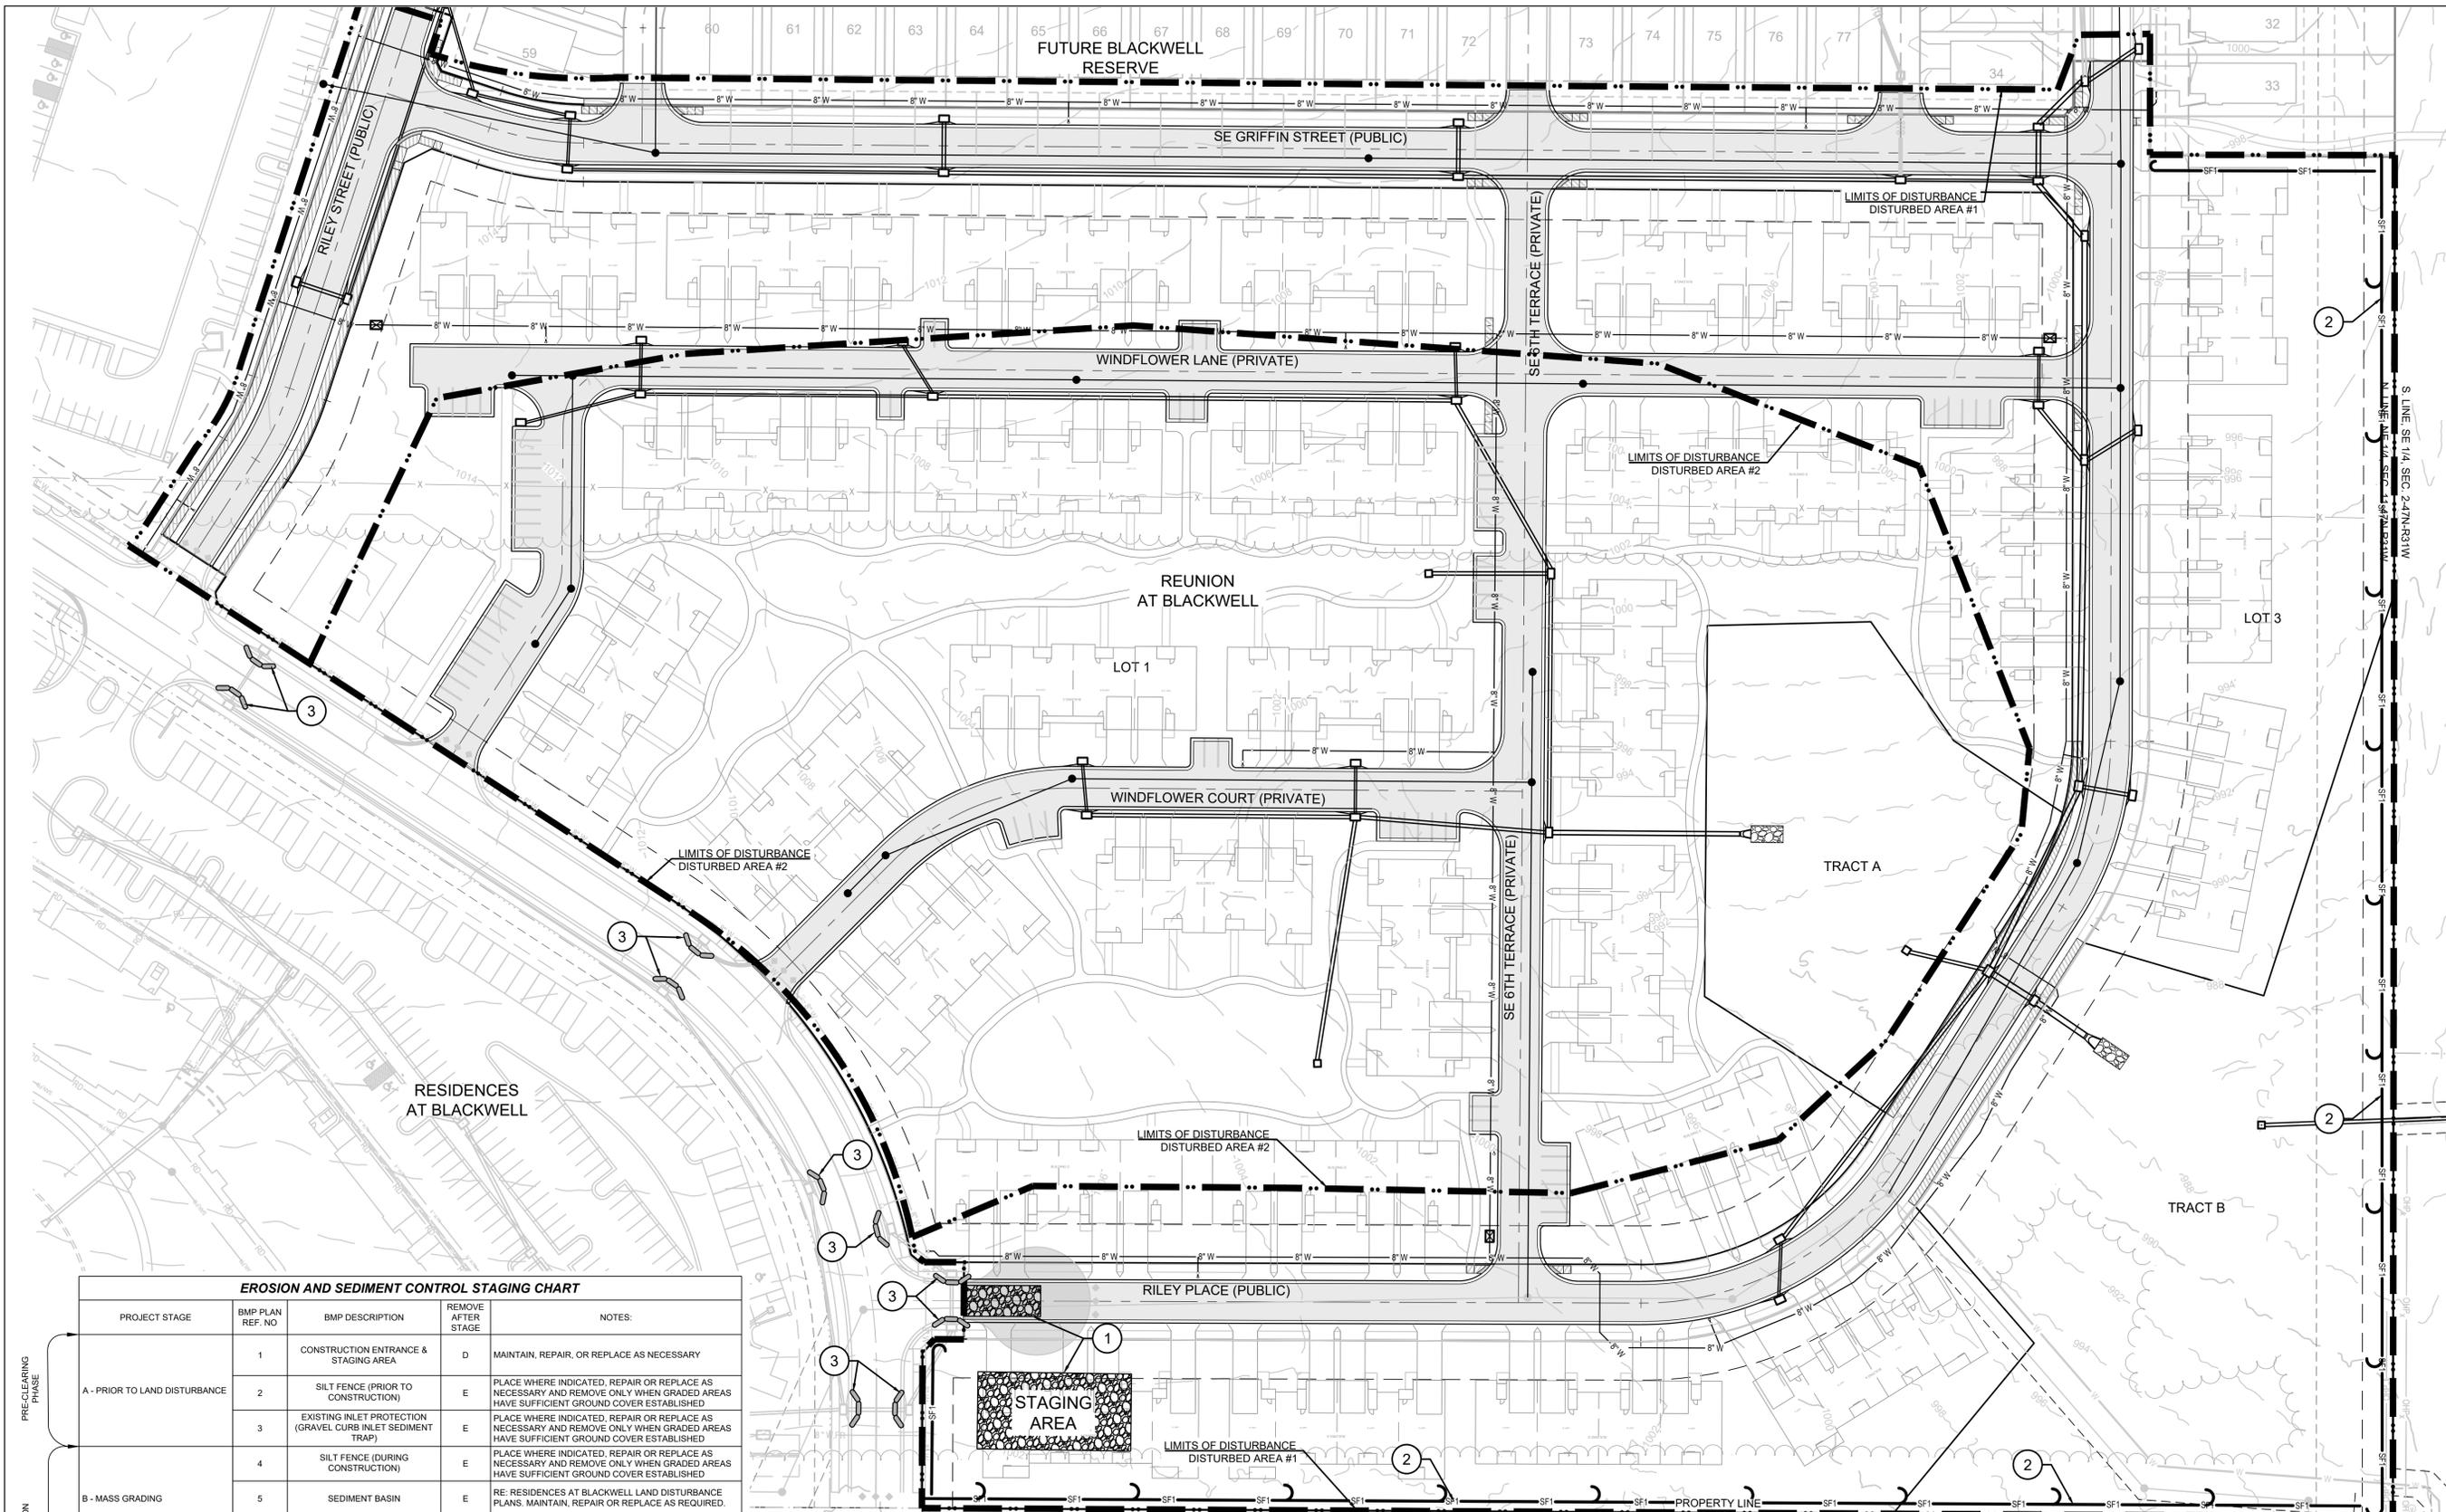

EROSION AND SEDIMENT CONTROL STAGING CHART

PROJECT STAGE	BMP PLAN REF. NO	BMP DESCRIPTION	REMOVE AFTER STAGE	NOTES:
A - PRIOR TO LAND DISTURBANCE	1	CONSTRUCTION ENTRANCE & STAGING AREA	D	MAINTAIN, REPAIR, OR REPLACE AS NECESSARY
	2	SILT FENCE (PRIOR TO CONSTRUCTION)	E	PLACE WHERE INDICATED, REPAIR OR REPLACE AS NECESSARY AND REMOVE ONLY WHEN GRADED AREAS HAVE SUFFICIENT GROUND COVER ESTABLISHED
	3	EXISTING INLET PROTECTION (GRAVEL CURB INLET SEDIMENT TRAP)	E	PLACE WHERE INDICATED, REPAIR OR REPLACE AS NECESSARY AND REMOVE ONLY WHEN GRADED AREAS HAVE SUFFICIENT GROUND COVER ESTABLISHED
B - MASS GRADING	4	SILT FENCE (DURING CONSTRUCTION)	E	PLACE WHERE INDICATED, REPAIR OR REPLACE AS NECESSARY AND REMOVE ONLY WHEN GRADED AREAS HAVE SUFFICIENT GROUND COVER ESTABLISHED
	5	SEDIMENT BASIN	E	RE: RESIDENCES AT BLACKWELL LAND DISTURBANCE PLANS. MAINTAIN, REPAIR OR REPLACE AS REQUIRED.
C - UTILITY CONSTRUCTION	6	ROCK DITCH CHECK	E	PLACE WHERE INDICATED, REPAIR OR REPLACE AS NECESSARY AND REMOVE ONLY WHEN GRADED AREAS HAVE SUFFICIENT GROUND COVER ESTABLISHED
	7	CONCRETE WASHOUT AREA	E	MAINTAIN, REPAIR, OR REPLACE AS NECESSARY
	8	INLET PROTECTION (SILT FENCE)	D/E	PLACE SILT FENCE AROUND ALL STORM SEWER STRUCTURES / YARD AREA STORM STRUCTURES TO HAVE SILT FENCE REMOVED ONLY WHEN GRADED AREAS HAVE SUFFICIENT GROUND COVER ESTABLISHED. BOARDS SHALL BE PLACED IN FRONT OF INLET OPENING FROM THE TIME SILT FENCE IS REMOVED UNTIL SUCH TIME THAT THE CURB / THROAT IS POURED. PLACE GRAVEL FILTER BAGS AT THE OPENING OF ALL CURB INLETS IMMEDIATELY AFTER THE INLET THROATS ARE POURED
D - AFTER PAVING OPERATIONS	9	INLET PROTECTION (GRAVEL FILTER BAGS)	E	
	10	SEEDING AND MULCHING	E	ALL DISTURBED AREAS AFTER 14 DAYS OF CONSTRUCTION ACTIVITY
E - UNTIL CLOSURE OF LAND DISTURBANCE PERMIT				ADDITIONAL SEDIMENT AND EROSION CONTROL MEASURES MAY BE REQUIRED ANY TIME CURRENT MEASURES ARE FOUND TO BE INEFFECTIVE.

LEGEND

	TEMP. CONSTRUCTION ENTRANCE AND STAGING AREA		SUPER SEDIMENT SILT FENCE (PRIOR TO LAND DISTURBANCE)
	CONCRETE WASHOUT AREA		SILT FENCE (PRIOR TO LAND DISTURBANCE)
	ROCK DITCH CHECK		SILT FENCE (DURING CONSTRUCTION)
	BMP PLAN REF. NO.		LIMITS OF DISTURBANCE
	SILT FENCE FOR INLET PROTECTION PRIOR TO STRUCTURE TOP		EXISTING CONTOURS
			PROPOSED CONTOURS
			GRAVEL FILTER FOR STORM SEWER STRUCTURES ONLY


DISTURBED AREA #1 = 14.34 A.C.
DISTURBED AREA #2 = 11.02 A.C.

SITE SPECIFIC NOTES:

- THE CONTRACTOR IS RESPONSIBLE FOR VERIFYING ALL EXISTING UTILITY LOCATIONS PRIOR TO EXCAVATION.
- THERE ARE NO WETLANDS, NATURAL OR ARTIFICIAL WATER STORAGE DETENTION AREAS IN THE PROJECT AREA.
- NO PART OF THE PROJECT LIES WITHIN THE 100 YEAR FLOOD PLAIN PER FEMA FLOOD INSURANCE RATE MAP NUMBERS 29095C0441G, 29095C0445G, 29095C0437G AND 29095C0439G DATED JANUARY 20TH, 2017.
- ALL EROSION AND SEDIMENTATION CONTROL MEASURES SHALL BE IMPLEMENTED ACCORDING TO THE BMP STAGING CHART.
- ADDITIONAL EROSION CONTROL MAY BE REQUIRED BY THE CITY ENGINEER AT ANY TIME EXISTING MEASURES ARE FOUND TO BE INEFFECTIVE OR PROBLEMATIC AREAS ARE NOTED IN THE FIELD.
- STABILIZATION OF DISTURBED AREAS MUST, AT A MINIMUM, BE INITIATED IMMEDIATELY WHENEVER ANY CLEARING, GRADING, EXCAVATING, OR OTHER SOIL DISTURBING ACTIVITIES HAVE PERMANENTLY CEASED ON ANY PORTION OF THE SITE, OR TEMPORARILY CEASED ON ANY PORTION OF THE SITE AND WILL NOT RESUME FOR A PERIOD EXCEEDING 14 CALENDAR DAYS. THE DISTURBED AREAS SHALL BE PROTECTED FROM EROSION BY STABILIZING THE AREA WITH MULCH OR OTHER SIMILARLY EFFECTIVE SOIL STABILIZING BMPs. INITIAL STABILIZATION ACTIVITIES MUST BE COMPLETED WITHIN 14 DAYS AFTER SOIL DISTURBING ACTIVITIES CEASE.
- ALL PERIMETER SILT FENCE, EARTH DIKES, SEDIMENT BASINS, AND ROCK CONSTRUCTION ENTRANCES WILL BE INSTALLED BEFORE GRADING OPERATIONS BEGIN.
- SILT FENCE AND EARTH DIKES THAT ARE PLACED BEFORE GRADING BEGINS WILL BE MAINTAINED BY THE GRADING CONTRACTOR.
- AREAS WITHIN PUBLIC RIGHT-OF-WAY SHALL BE SODDED IMMEDIATELY AFTER CONSTRUCTION IS COMPLETE.

NOTES:

- ALL CONSTRUCTION ON THIS PROJECT SHALL CONFORM TO THE CITY OF LEE'S SUMMIT TECHNICAL SPECIFICATIONS.
- THE CONTRACTOR IS RESPONSIBLE FOR VERIFYING ALL EXISTING UTILITY LOCATIONS PRIOR TO EXCAVATION.

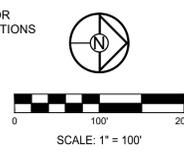

SCHLAGEL
ENGINEERS, PLANNERS, SURVEYORS, LANDSCAPE ARCHITECTS
 14920 West 107th Street • Lenexa, Kansas 66215
 (913) 492-5158 • Fax: (913) 492-8400
 WWW.SCHLAGELASSOCIATES.COM
 Missouri State Certificate of Authority
 #E2002003690P #LAC2001005237 #LS2002008959F

PREPARED BY:

 MARK ALLEN BREWER
 PE-2003007268
 03-31-2023

SCHLAGEL & ASSOCIATES, P.A.


**REUNION AT BLACKWELL
 PUBLIC STREET AND STORM SEWER PLANS
 SE SHENANDOAH DRIVE LEE'S SUMMIT, MO**

REVISION DATE	DESCRIPTION

PRE-CHECKED BY: TRC
 CHECKED BY: MAB
 DATE PREPARED: 03/05/2023
 PROJ. NUMBER: 22-597

**PRE-CONSTRUCTION
 EROSION
 CONTROL PLAN**

SHEET
7

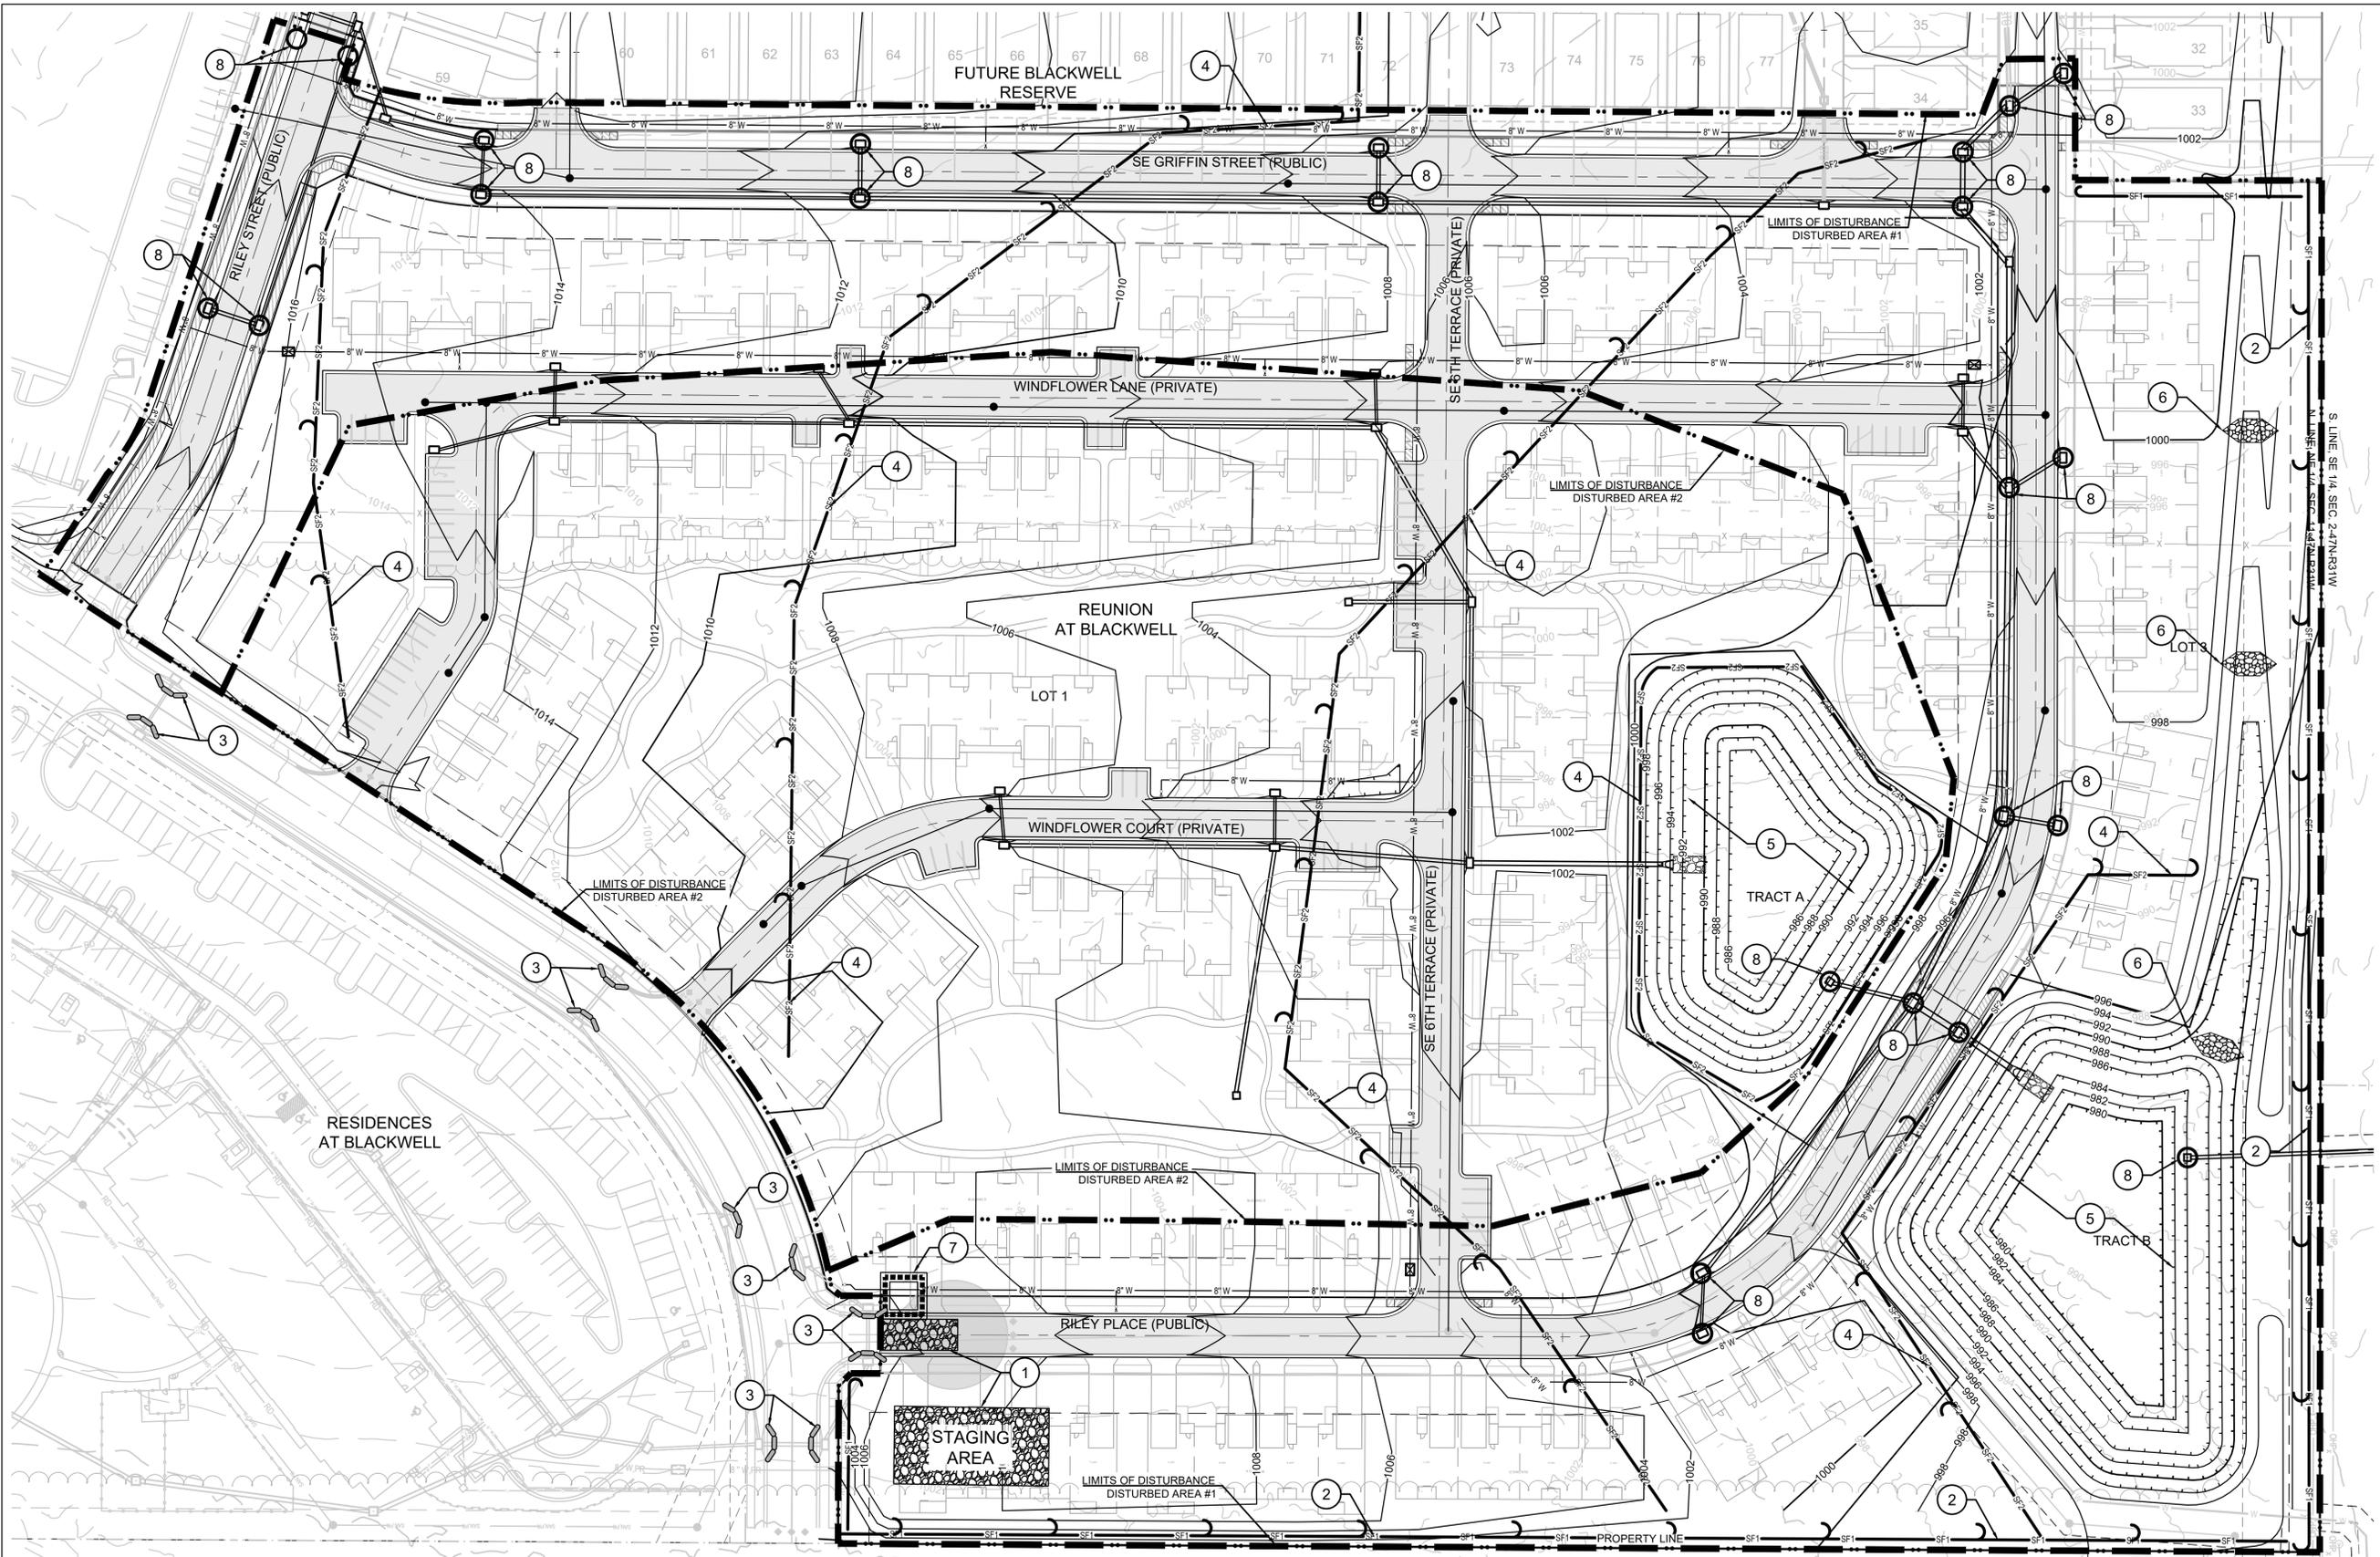

PRIVATE ROAD NOTE:
 WINDFLOWER LANE, WINDFLOWER COURT & SE 6TH TERRACE ARE PRIVATE ROADS AND WILL BE CONSTRUCTED UNDER A SEPARATE PLAN SET.

SIDEWALK NOTE:
 SIDEWALKS AT BUILDINGS WILL BE INSTALLED BY OTHERS, UNLESS NOTED OTHERWISE.

NOTE:
 SEE SHEET 7 FOR EROSION CONTROL NOTES, LEGEND AND STAGING CHART.

NOTES:


- ALL CONSTRUCTION ON THIS PROJECT SHALL CONFORM TO THE CITY OF LEE'S SUMMIT TECHNICAL SPECIFICATIONS.
- THE CONTRACTOR IS RESPONSIBLE FOR VERIFYING ALL EXISTING UTILITY LOCATIONS PRIOR TO EXCAVATION.

MO GRS BENCHMARK:

STATION NAME - JA-90
 KC METRO ALUMINUM GRS DISK SET IN CONCRETE STAMPED "JA-90, 1988" LOCATED NEAR THE INTERSECTION OF LANGSFORD ROAD AND OLD LANGSFORD ROAD, 43 FEET SOUTHEAST OF THE CENTER OF LANGSFORD ROAD AND 32 FEET NORTH OF THE CENTER OF OLD LANGSFORD ROAD. N:1001052.8503, E:2845604.8272
 ELEV. 997.045

PROJECT BENCHMARK:

"SQUARE" CUT IN TOP OF CONCRETE STORM MANHOLE STORM MANHOLE IS LOCATED APPROX. 130 FEET EAST OF THE INTERSECTION OF SE JOEL AVE & BLUE PARKWAY AND 26 FEET SOUTH OF THE CENTERLINE OF BLUE PARKWAY. N:996874.9690, E:2840937.1365
 ELEV. 1005.719

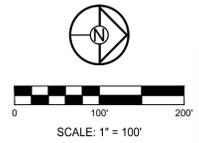

PREPARED BY:




SCHLAGEL & ASSOCIATES, P.A.

REUNION AT BLACKWELL
 PUBLIC STREET AND STORM SEWER PLANS
 SE SHENANDOAH DRIVE LEE'S SUMMIT, MO

REVISION DATE	DESCRIPTION

EROSION CONTROL PLAN

SHEET

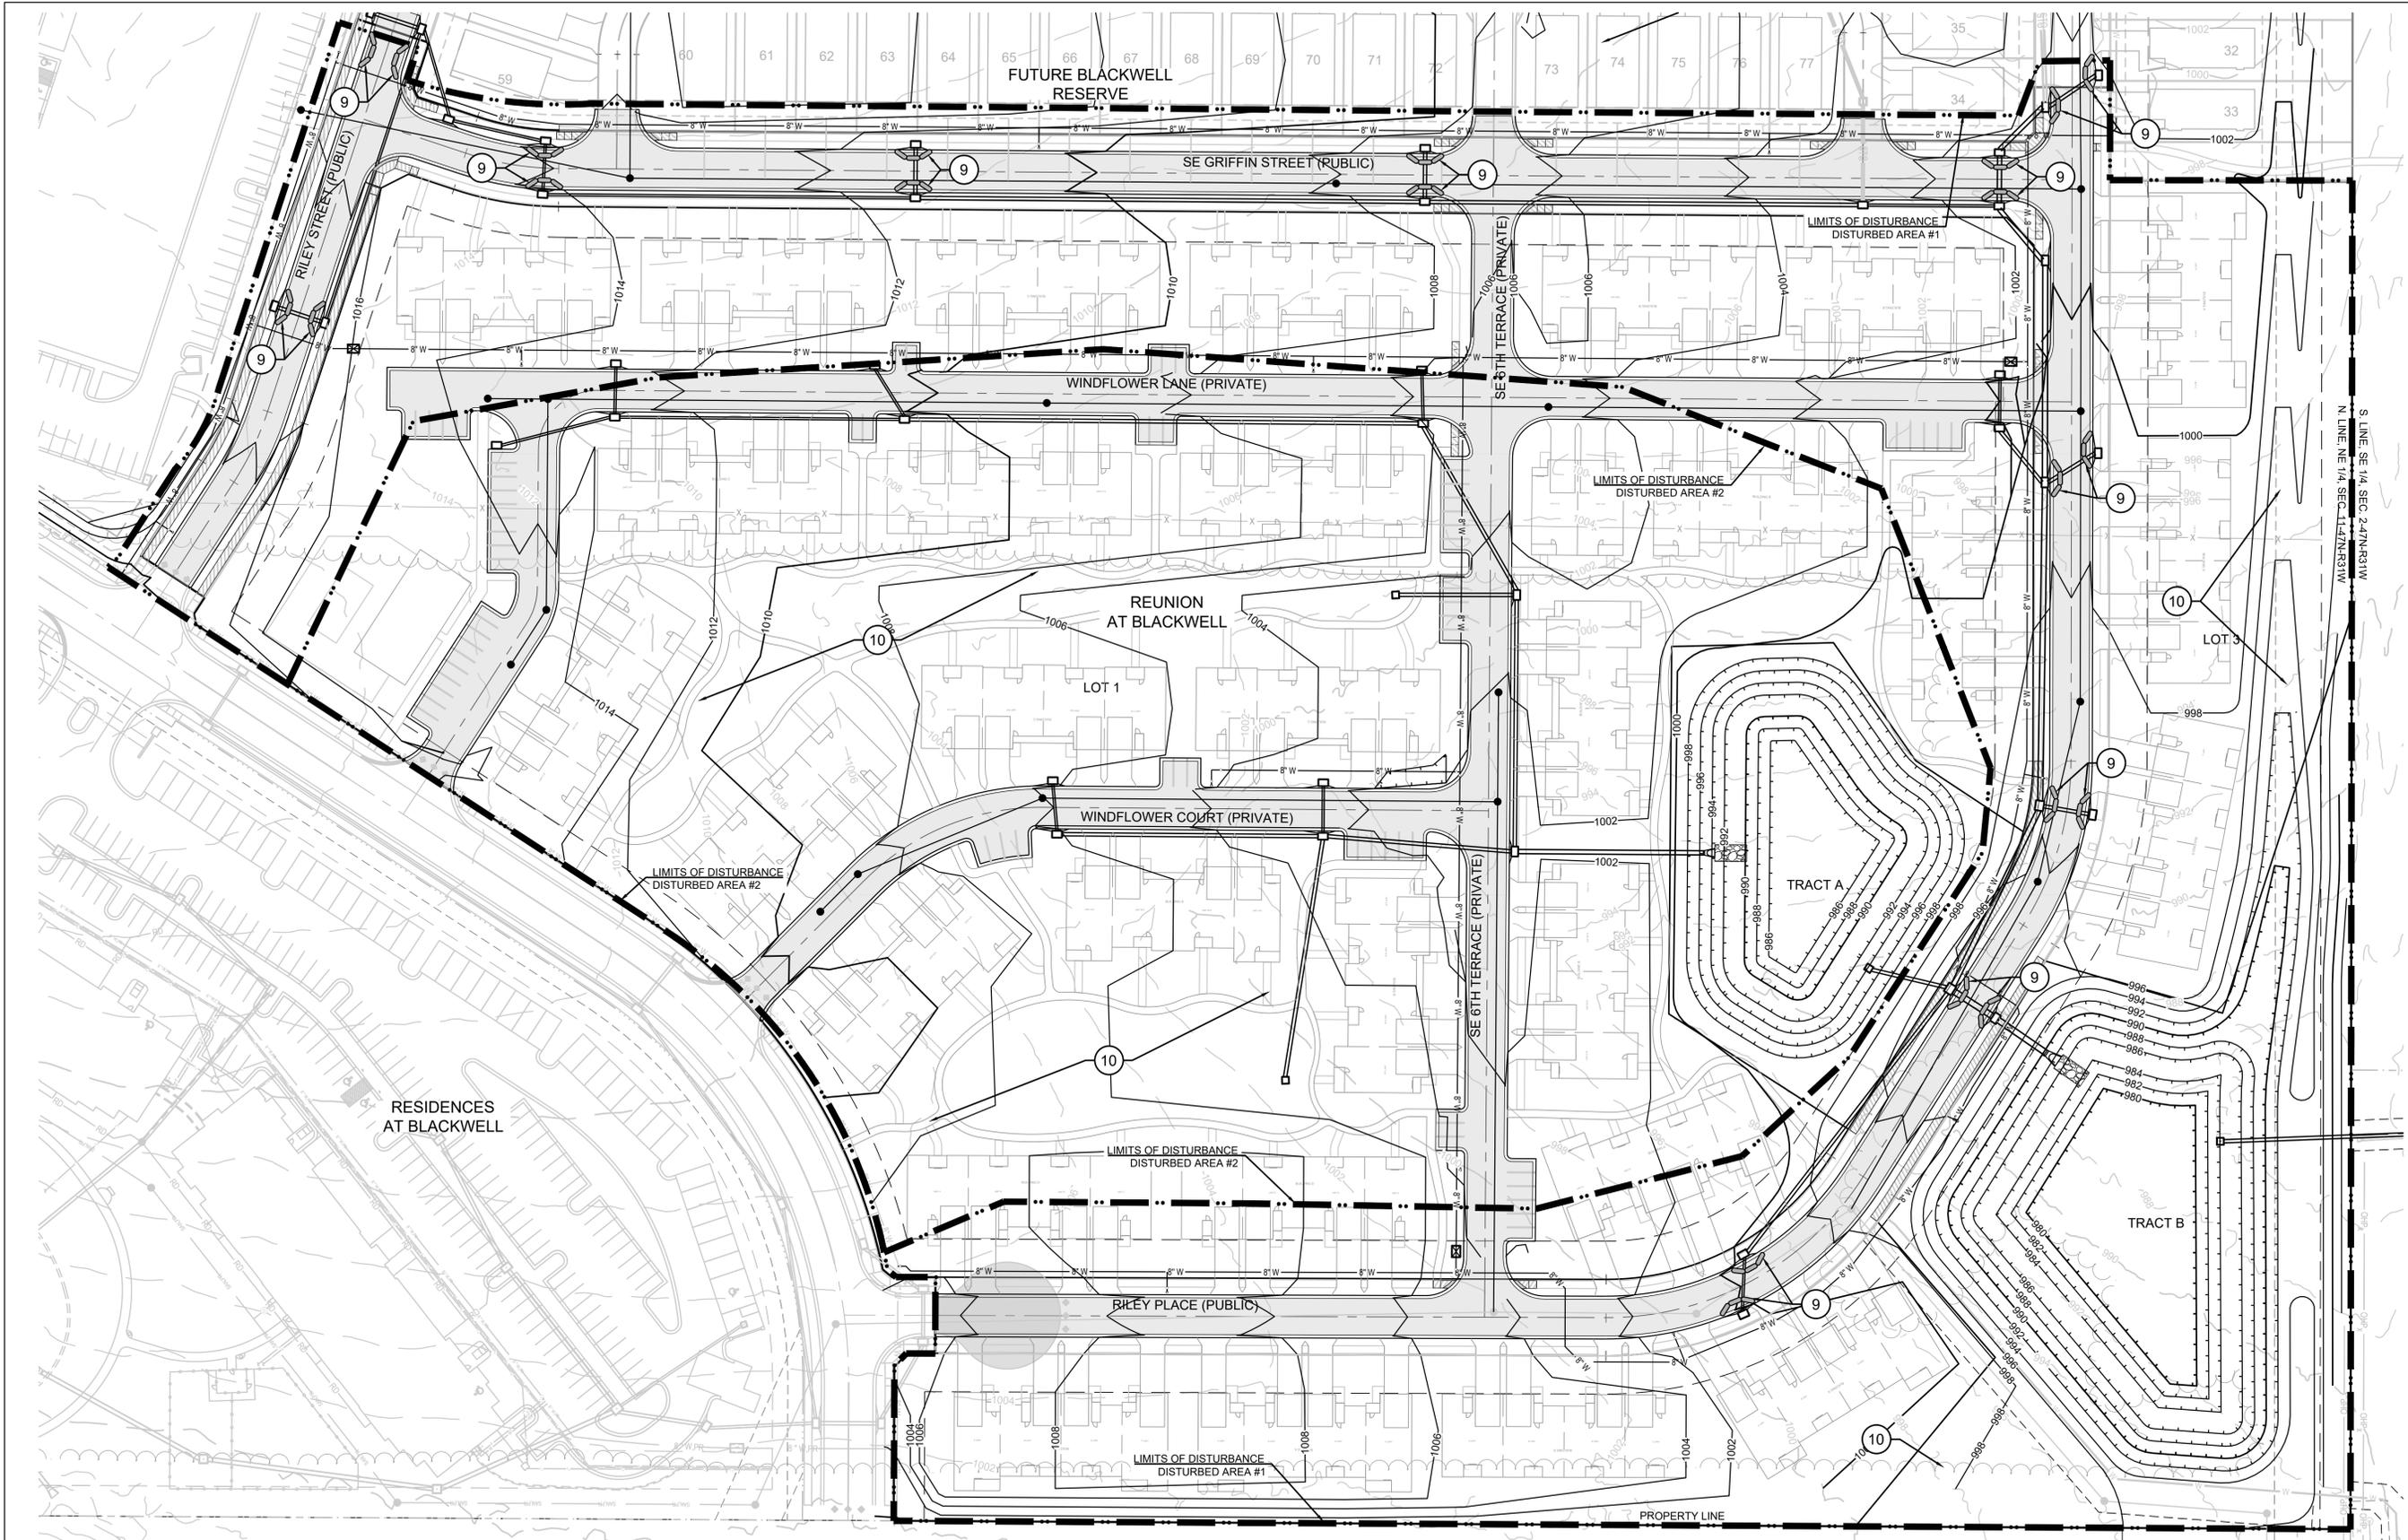

PRIVATE ROAD NOTE:
WINDFLOWER LANE, WINDFLOWER COURT & SE 6TH TERRACE ARE PRIVATE ROADS AND WILL BE CONSTRUCTED UNDER A SEPARATE PLAN SET.


SIDEWALK NOTE:
SIDEWALKS AT BUILDINGS WILL BE INSTALLED BY OTHERS, UNLESS NOTED OTHERWISE.

NOTE:
SEE SHEET 7 FOR EROSION CONTROL NOTES, LEGEND AND STAGING CHART.

- NOTES:**
- ALL CONSTRUCTION ON THIS PROJECT SHALL CONFORM TO THE CITY OF LEE'S SUMMIT TECHNICAL SPECIFICATIONS.
 - THE CONTRACTOR IS RESPONSIBLE FOR VERIFYING ALL EXISTING UTILITY LOCATIONS PRIOR TO EXCAVATION.

MO GRS BENCHMARK:
STATION NAME - JA-90
KC METRO ALUMINUM GRS DISK SET IN CONCRETE STAMPED "JA-90, 1988" LOCATED NEAR THE INTERSECTION OF LANGSFORD ROAD AND OLD LANGSFORD ROAD, 43 FEET SOUTHEAST OF THE CENTER OF LANGSFORD ROAD AND 32 FEET NORTH OF THE CENTER OF OLD LANGSFORD ROAD.
N:1001052.8503, E:2845604.8272
ELEV. 997.045

PROJECT BENCHMARK:
"SQUARE" CUT IN TOP OF CONCRETE STORM MANHOLE STORM MANHOLE IS LOCATED APPROX. 130 FEET EAST OF THE INTERSECTION OF SE JOEL AVE & BLUE PARKWAY AND 26 FEET SOUTH OF THE CENTERLINE OF BLUE PARKWAY.
N:996874.9690, E:2840937.1365
ELEV. 1005.719

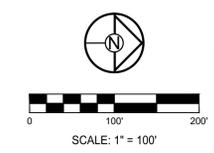

SCHLAGEL
ENGINEERS, PLANNERS, SURVEYORS, LANDSCAPE ARCHITECTS
14920 West 107th Street • Lenexa, Kansas 66215
(913) 492-5158 • Fax: (913) 492-8400
WWW.SCHLAGELASSOCIATES.COM
Missouri State Certificate of Authority
#E220020360P-F #LAC201005237 #LS2002008695F

PREPARED BY:

MARK ALLEN BREWER
PE-2003007268
03-27-2023


SCHLAGEL & ASSOCIATES, P.A.

REUNION AT BLACKWELL
PUBLIC STREET AND STORM SEWER PLANS
SE SHENANDOAH DRIVE LEE'S SUMMIT, MO

REVISION DATE	DESCRIPTION

POST-CONSTRUCTION
EROSION
CONTROL PLAN

SHEET
9

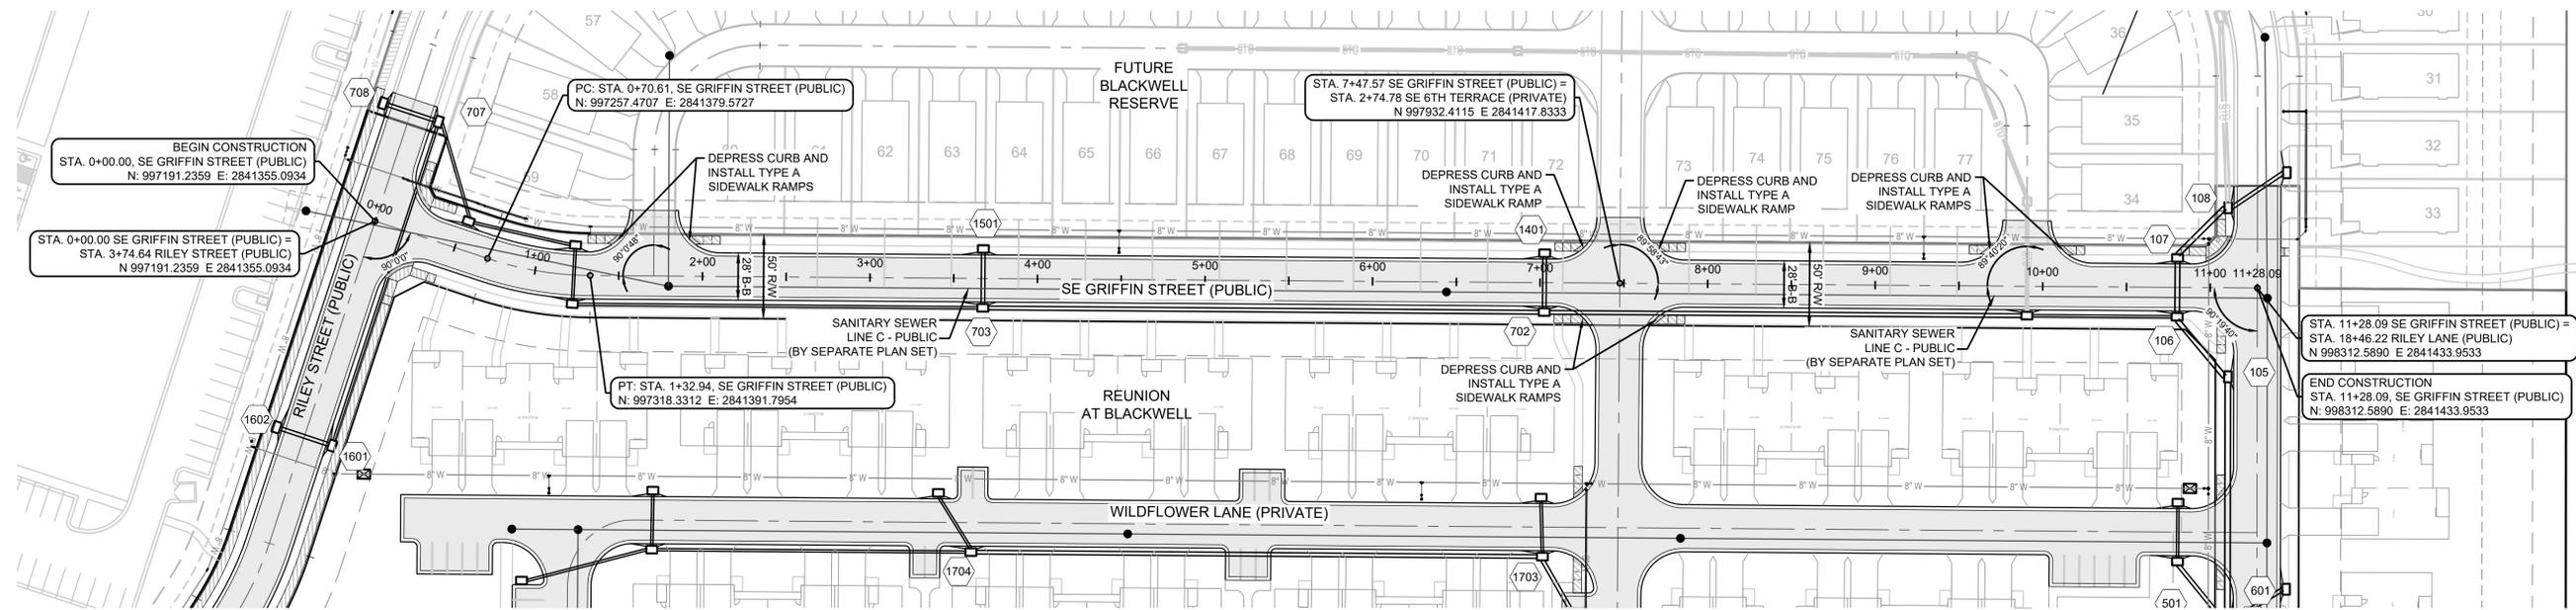

STREET NOTES:

1. ALL STREET CONSTRUCTION SHALL BE IN ACCORDANCE WITH THE LATEST EDITION OF THE CITY OF LEE'S SUMMIT DESIGN AND CONSTRUCTION MANUAL. ALL APPLICABLE AASHTO STANDARDS HAVE BEEN MET.
2. THE CONTRACTOR IS RESPONSIBLE FOR VERIFYING ALL EXISTING UTILITY LOCATIONS PRIOR TO EXCAVATION.
3. ALL INSPECTION OF STREET CONSTRUCTION TO BE PERFORMED BY THE CITY OF LEE'S SUMMIT DEVELOPMENT ENGINEERING.
4. CURB RETURN RADII SHALL BE 25' AT BACK OF CURB UNLESS OTHERWISE NOTED.
5. SUBGRADE TO BE COMPACTED TO 95% STANDARD PROCTOR DENSITY.
6. ASSUMED DESIGN SPEED = 25 MPH (RESIDENTIAL LOCAL).
7. MINIMUM STOPPING SIGHT DISTANCE = 155 FEET.
8. MINIMUM K, SAG CURVE = 26 (14 WITH LIGHTING), CREST CURVE = 12.
9. GRADE INTERSECTIONS TO DRAIN AS SHOWN.
10. SSD = STOPPING SIGHT DISTANCE.
11. ALL ADA SIDEWALK RAMP SHALL BE CONSTRUCTED BY THE DEVELOPER WITH THE PUBLIC INFRASTRUCTURE.

MO GRS BENCHMARK:


STATION NAME - JA-90
 KC METRO ALUMINUM GRS DISK SET IN CONCRETE STAMPED "JA-90, 1988"
 LOCATED NEAR THE INTERSECTION OF LANGSFORD ROAD AND OLD LANGSFORD ROAD, 43 FEET SOUTHEAST OF THE CENTER OF LANGSFORD ROAD AND 32 FEET NORTH OF THE CENTER OF OLD LANGSFORD ROAD.
 N:1001052.8503, E:2845604.8272
 ELEV. 997.045

PROJECT BENCHMARK:



"SQUARE" CUT IN TOP OF CONCRETE STORM MANHOLE
 STORM MANHOLE IS LOCATED APPROX. 130 FEET EAST OF THE INTERSECTION OF SE JOEL AVE & BLUE PARKWAY AND 26 FEET SOUTH OF THE CENTERLINE OF BLUE PARKWAY.
 N:996874.9690, E:2840937.1365
 ELEV. 1005.719

PRIVATE ROAD NOTE:
 WINDFLOWER LANE, WINDFLOWER COURT & SE 6TH TERRACE ARE PRIVATE ROADS AND WILL BE CONSTRUCTED UNDER A SEPARATE PLAN SET.

SIDEWALK NOTE:
 SIDEWALKS AT BUILDINGS WILL BE INSTALLED BY OTHERS, UNLESS NOTED OTHERWISE.

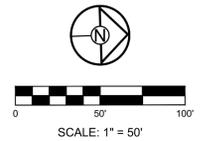

SE GRIFFIN STREET (PUBLIC)

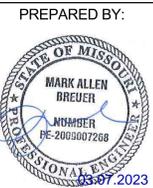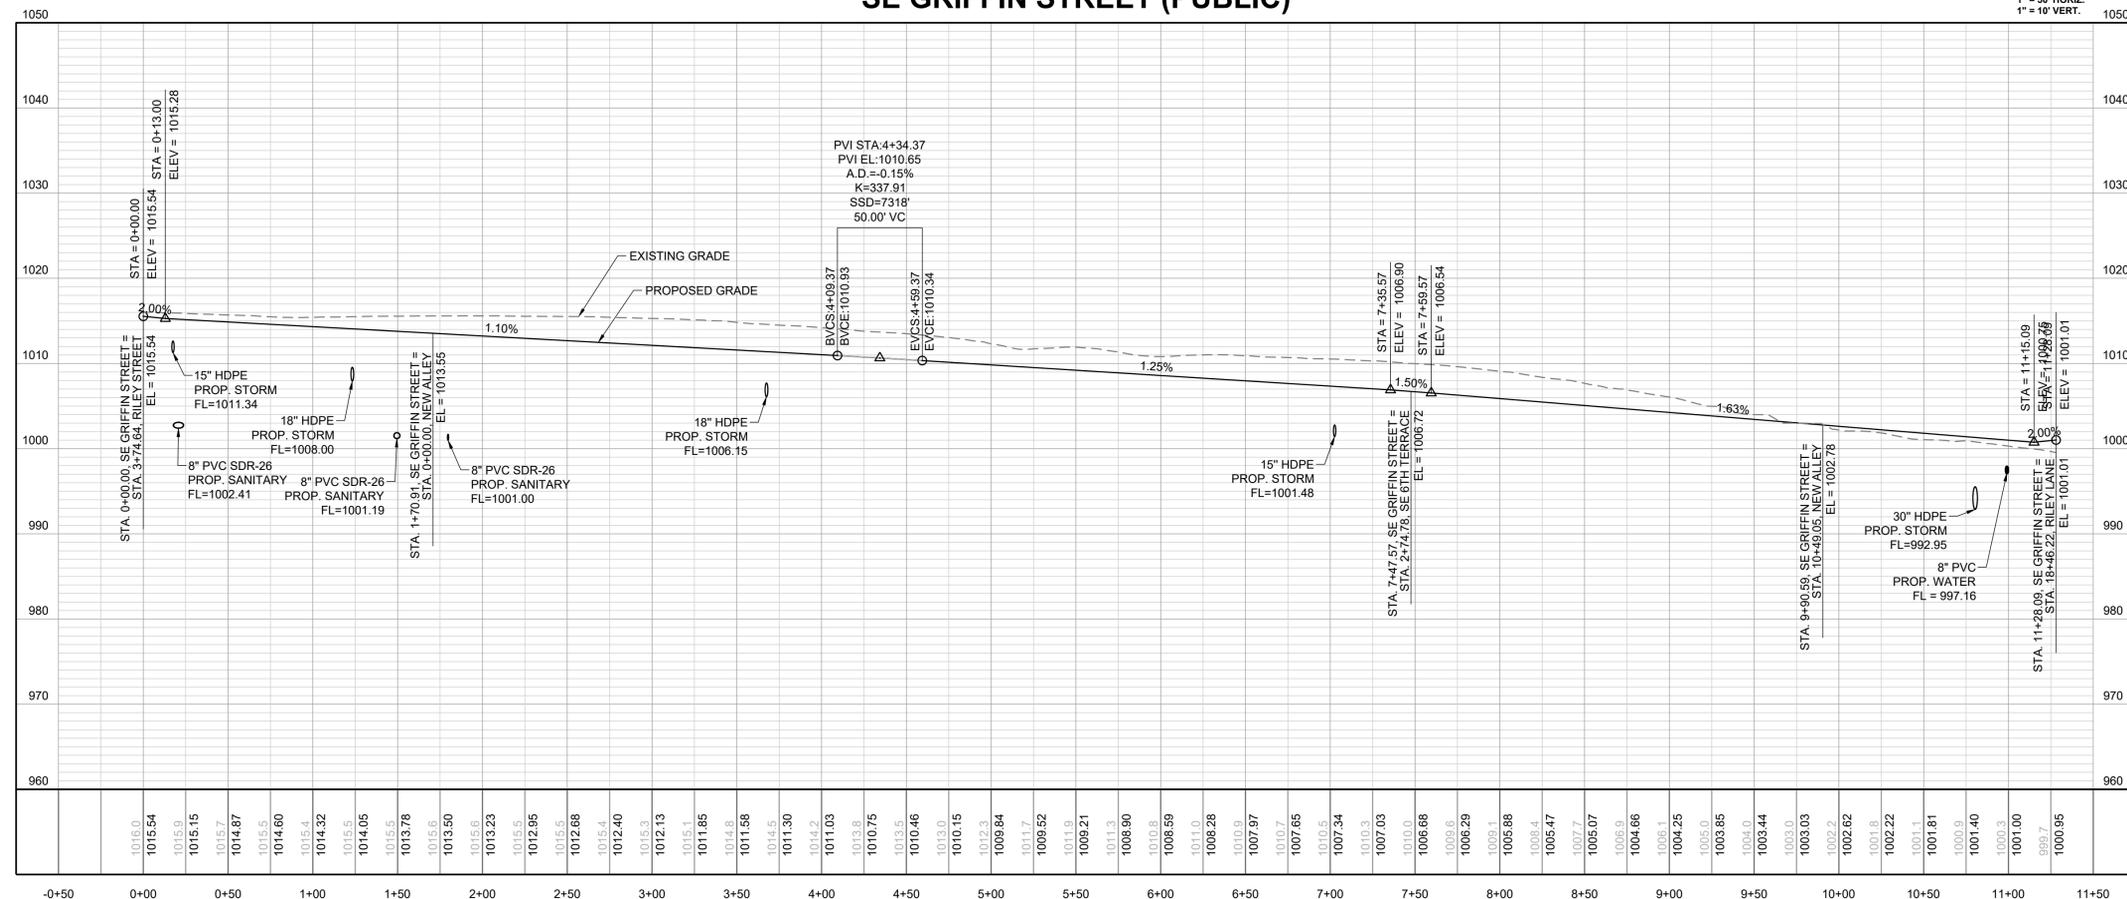


SCHLAGEL & ASSOCIATES, P.A.

**REUNION AT BLACKWELL
 PUBLIC STREET AND STORM SEWER PLANS
 SE SHENANDOAH DRIVE LEE'S SUMMIT, MO**

REVISION	DATE	DESCRIPTION
1	03/05/2023	DATE PREPARED
2	03/05/2023	PROJ. NUMBER
3	03/05/2023	22-297

SE GRIFFIN STREET - PLAN & PROFILE

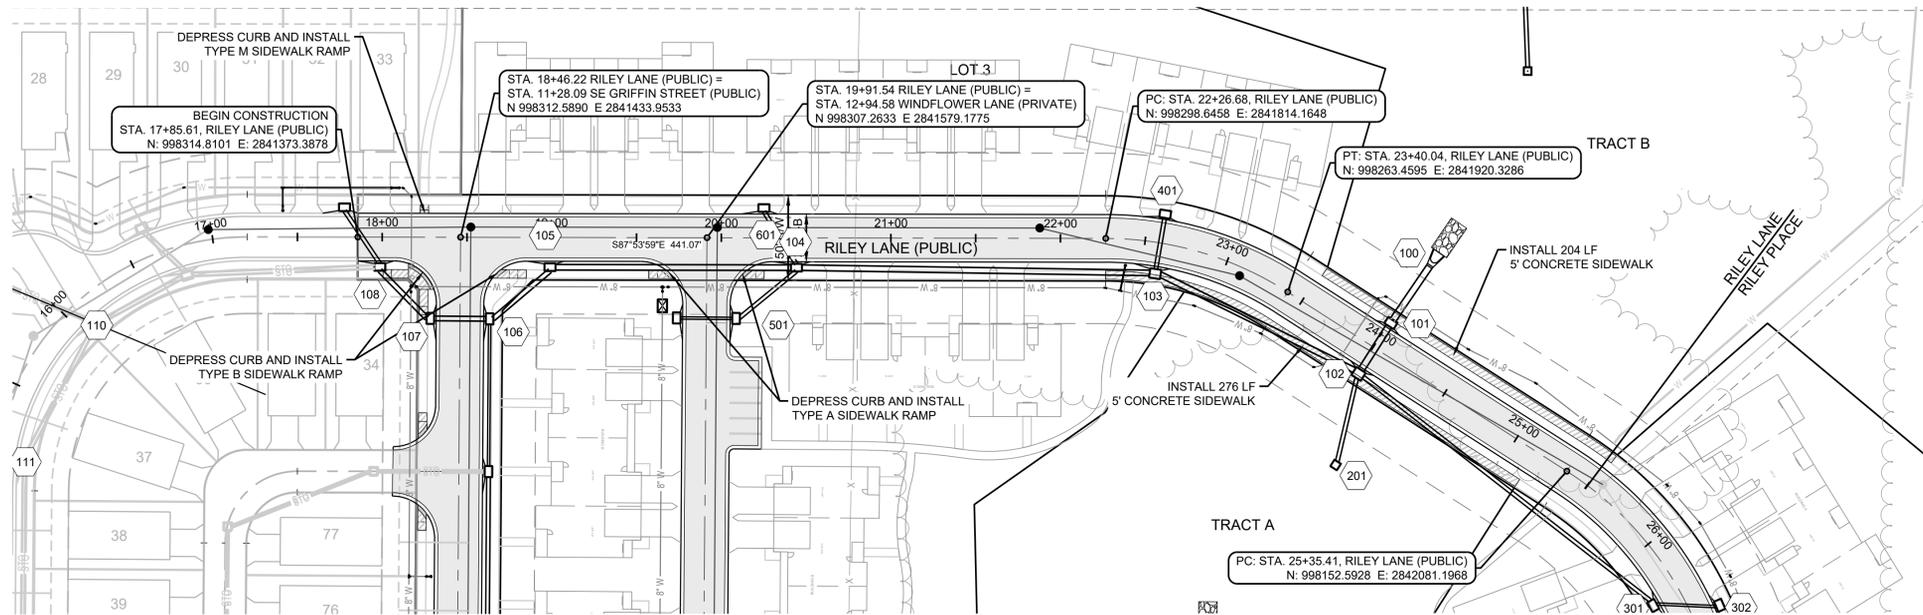

STREET NOTES:

1. ALL STREET CONSTRUCTION SHALL BE IN ACCORDANCE WITH THE LATEST EDITION OF THE CITY OF LEE'S SUMMIT DESIGN AND CONSTRUCTION MANUAL. ALL APPLICABLE AASHTO STANDARDS HAVE BEEN MET.
2. THE CONTRACTOR IS RESPONSIBLE FOR VERIFYING ALL EXISTING UTILITY LOCATIONS PRIOR TO EXCAVATION.
3. ALL INSPECTION OF STREET CONSTRUCTION TO BE PERFORMED BY THE CITY OF LEE'S SUMMIT DEVELOPMENT ENGINEERING.
4. CURB RETURN RADII SHALL BE 25' AT BACK OF CURB UNLESS OTHERWISE NOTED.
5. SUBGRADE TO BE COMPACTED TO 95% STANDARD PROCTOR DENSITY.
6. ASSUMED DESIGN SPEED = 25 MPH (RESIDENTIAL LOCAL).
7. MINIMUM STOPPING SIGHT DISTANCE = 155 FEET.
8. MINIMUM K, SAG CURVE = 26 (14 WITH LIGHTING), CREST CURVE = 12.
9. GRADE INTERSECTIONS TO DRAIN AS SHOWN.
10. SSD = STOPPING SIGHT DISTANCE.
11. ALL ADA SIDEWALK RAMP SHALL BE CONSTRUCTED BY THE DEVELOPER WITH THE PUBLIC INFRASTRUCTURE.

MO GRS BENCHMARK:


STATION NAME - JA-90
 KC METRO ALUMINUM GRS DISK SET IN CONCRETE STAMPED "JA-90, 1988"
 LOCATED NEAR THE INTERSECTION OF LANGSFORD ROAD AND OLD LANGSFORD ROAD, 43 FEET SOUTHEAST OF THE CENTER OF LANGSFORD ROAD AND 32 FEET NORTH OF THE CENTER OF OLD LANGSFORD ROAD.
 N:1001052.8503, E:2845604.8272
 ELEV. 997.045

PROJECT BENCHMARK:


"SQUARE" CUT IN TOP OF CONCRETE STORM MANHOLE
 STORM MANHOLE IS LOCATED APPROX. 130 FEET EAST OF THE INTERSECTION OF SE JOEL AVE & BLUE PARKWAY AND 26 FEET SOUTH OF THE CENTERLINE OF BLUE PARKWAY.
 N:996874.9690, E:2840937.1365
 ELEV. 1005.719

PRIVATE ROAD NOTE:
 WINDFLOWER LANE, WINDFLOWER COURT & SE 6TH TERRACE ARE PRIVATE ROADS AND WILL BE CONSTRUCTED UNDER A SEPARATE PLAN SET.

SIDEWALK NOTE:
 SIDEWALKS AT BUILDINGS WILL BE INSTALLED BY OTHERS, UNLESS NOTED OTHERWISE.

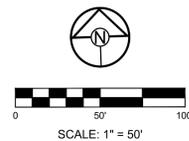


RILEY LANE (PUBLIC)

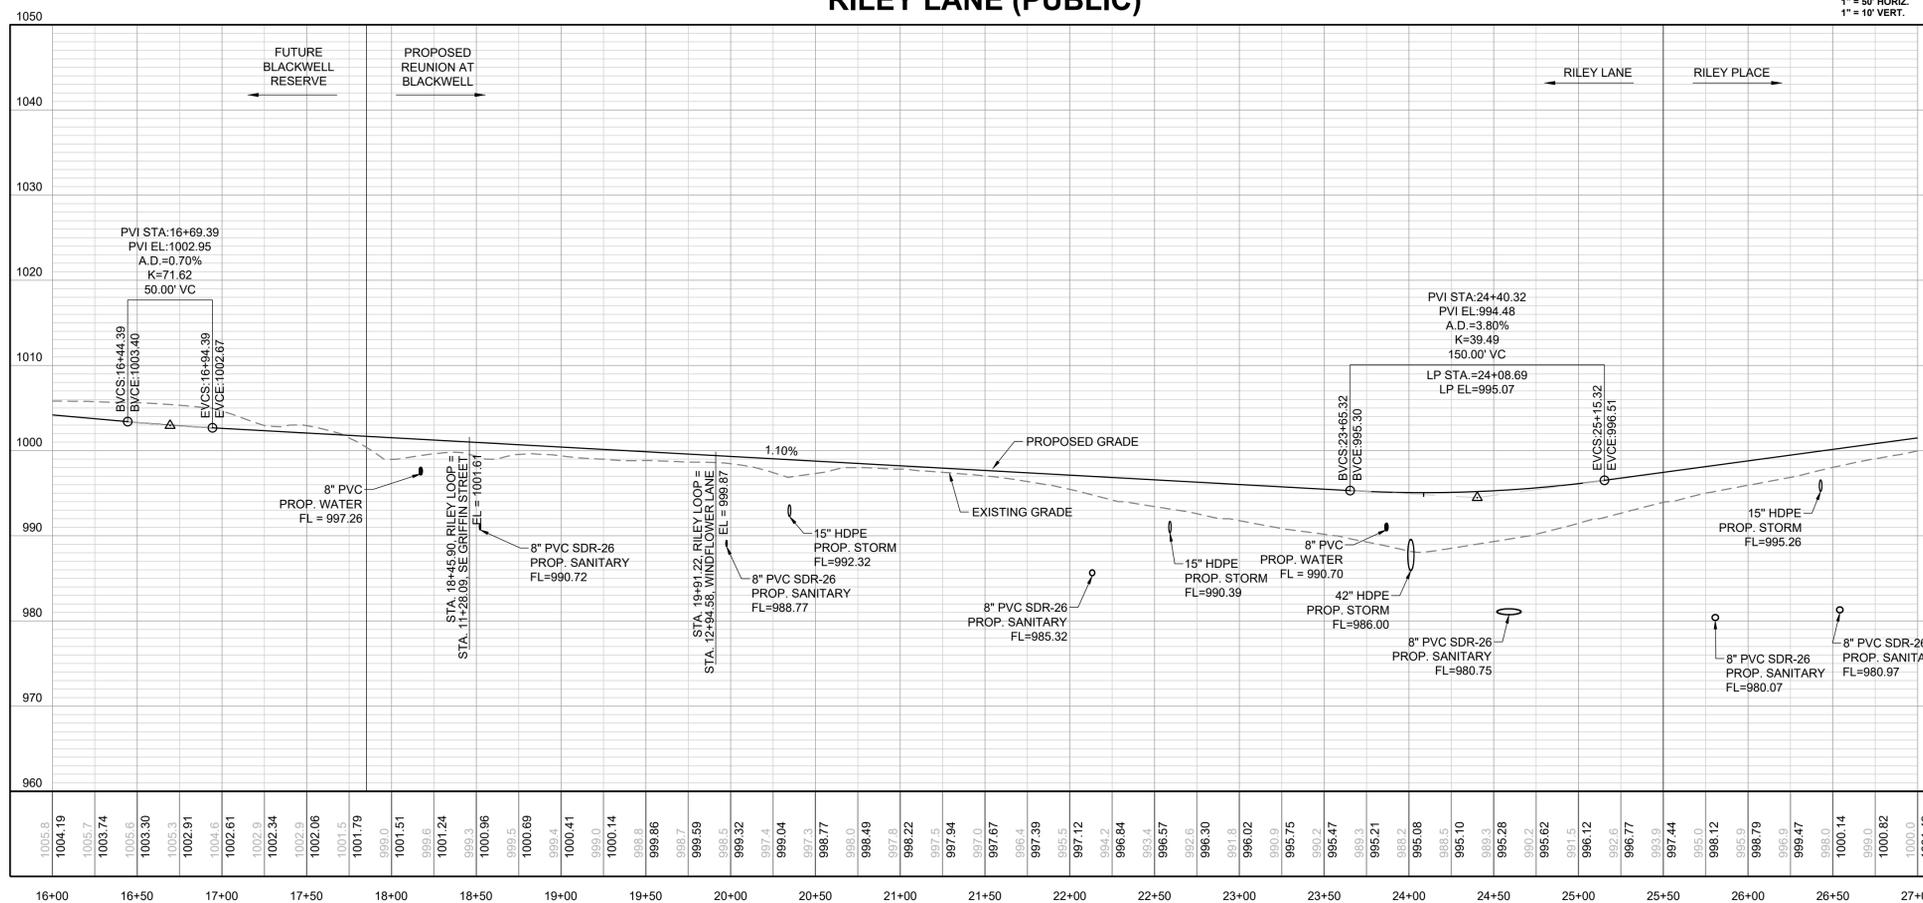

REVISION	DATE	DESCRIPTION
1	03/27/2023	ISSUED FOR PERMIT
2	03/27/2023	REVISED PER COMMENTS
3	03/27/2023	REVISED PER COMMENTS
4	03/27/2023	REVISED PER COMMENTS
5	03/27/2023	REVISED PER COMMENTS
6	03/27/2023	REVISED PER COMMENTS
7	03/27/2023	REVISED PER COMMENTS
8	03/27/2023	REVISED PER COMMENTS
9	03/27/2023	REVISED PER COMMENTS
10	03/27/2023	REVISED PER COMMENTS

RILEY LANE -
 PLAN & PROFILE

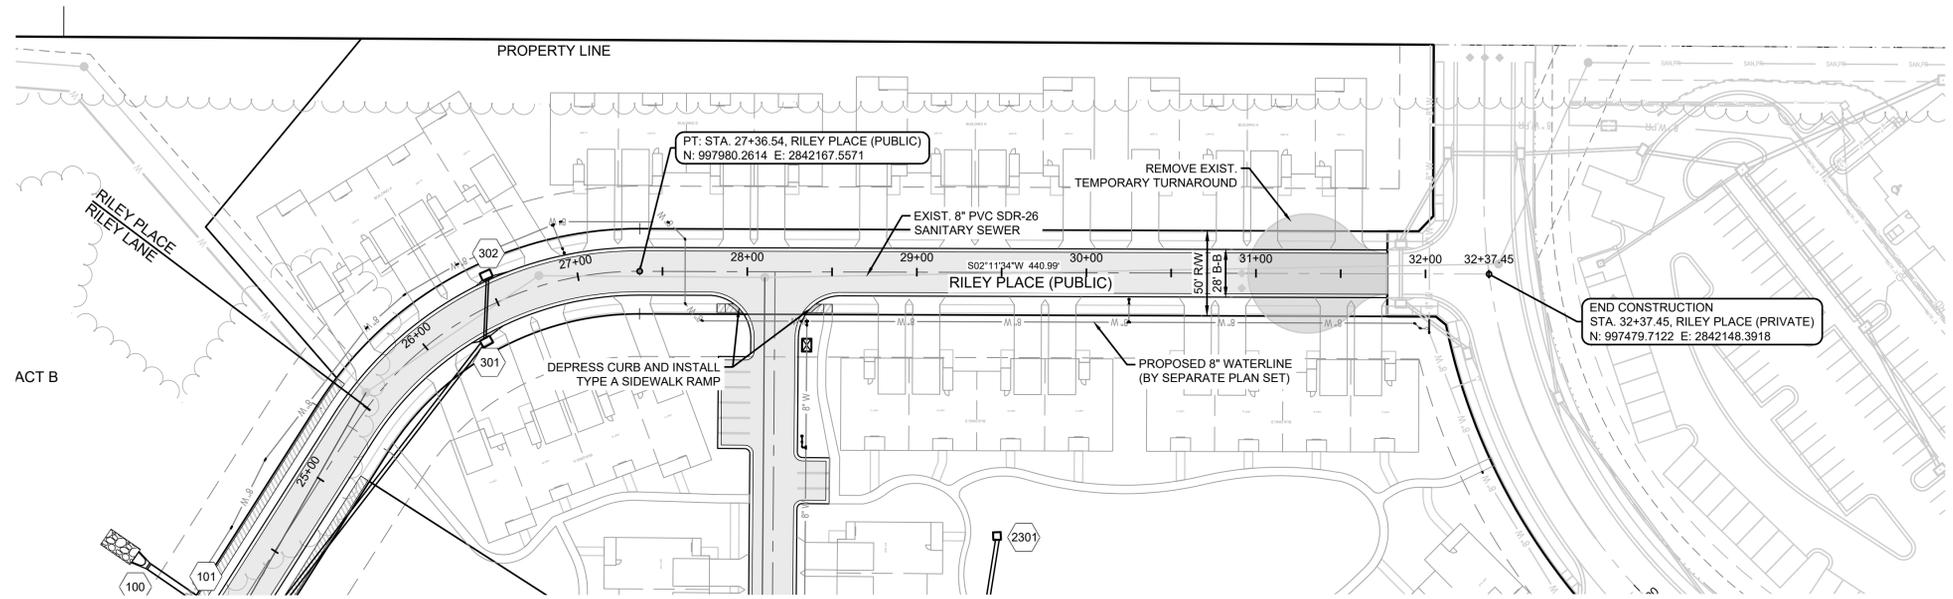

STREET NOTES:

1. ALL STREET CONSTRUCTION SHALL BE IN ACCORDANCE WITH THE LATEST EDITION OF THE CITY OF LEE'S SUMMIT DESIGN AND CONSTRUCTION MANUAL. ALL APPLICABLE AASHTO STANDARDS HAVE BEEN MET.
2. THE CONTRACTOR IS RESPONSIBLE FOR VERIFYING ALL EXISTING UTILITY LOCATIONS PRIOR TO EXCAVATION.
3. ALL INSPECTION OF STREET CONSTRUCTION TO BE PERFORMED BY THE CITY OF LEE'S SUMMIT DEVELOPMENT ENGINEERING.
4. CURB RETURN RADII SHALL BE 25' AT BACK OF CURB UNLESS OTHERWISE NOTED.
5. SUBGRADE TO BE COMPACTED TO 95% STANDARD PROCTOR DENSITY.
6. ASSUMED DESIGN SPEED = 25 MPH (RESIDENTIAL LOCAL).
7. MINIMUM STOPPING SIGHT DISTANCE = 155 FEET.
8. MINIMUM K, SAG CURVE = 26 (14 WITH LIGHTING), CREST CURVE = 12.
9. GRADE INTERSECTIONS TO DRAIN AS SHOWN.
10. SSD = STOPPING SIGHT DISTANCE.
11. ALL ADA SIDEWALK RAMP SHALL BE CONSTRUCTED BY THE DEVELOPER WITH THE PUBLIC INFRASTRUCTURE.

MO GRS BENCHMARK:


STATION NAME - JA-90
 KC METRO ALUMINUM GRS DISK SET IN CONCRETE STAMPED "JA-90, 1988"
 LOCATED NEAR THE INTERSECTION OF LANGSFORD ROAD AND OLD LANGSFORD ROAD, 43 FEET SOUTHEAST OF THE CENTER OF LANGSFORD ROAD AND 32 FEET NORTH OF THE CENTER OF OLD LANGSFORD ROAD.
 N:1001052.8503, E:2845604.8272
 ELEV. 997.045

PROJECT BENCHMARK:


"SQUARE" CUT IN TOP OF CONCRETE STORM MANHOLE
 STORM MANHOLE IS LOCATED APPROX. 130 FEET EAST OF THE INTERSECTION OF SE JOEL AVE & BLUE PARKWAY AND 26 FEET SOUTH OF THE CENTERLINE OF BLUE PARKWAY.
 N:996874.9690, E:2840937.1365
 ELEV. 1005.719

PRIVATE ROAD NOTE:
 WINDFLOWER LANE, WINDFLOWER COURT & SE 6TH TERRACE ARE PRIVATE ROADS AND WILL BE CONSTRUCTED UNDER A SEPARATE PLAN SET.

SIDEWALK NOTE:
 SIDEWALKS AT BUILDINGS WILL BE INSTALLED BY OTHERS, UNLESS NOTED OTHERWISE.

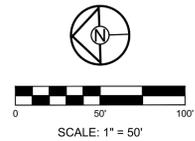

RILEY PLACE (PUBLIC)

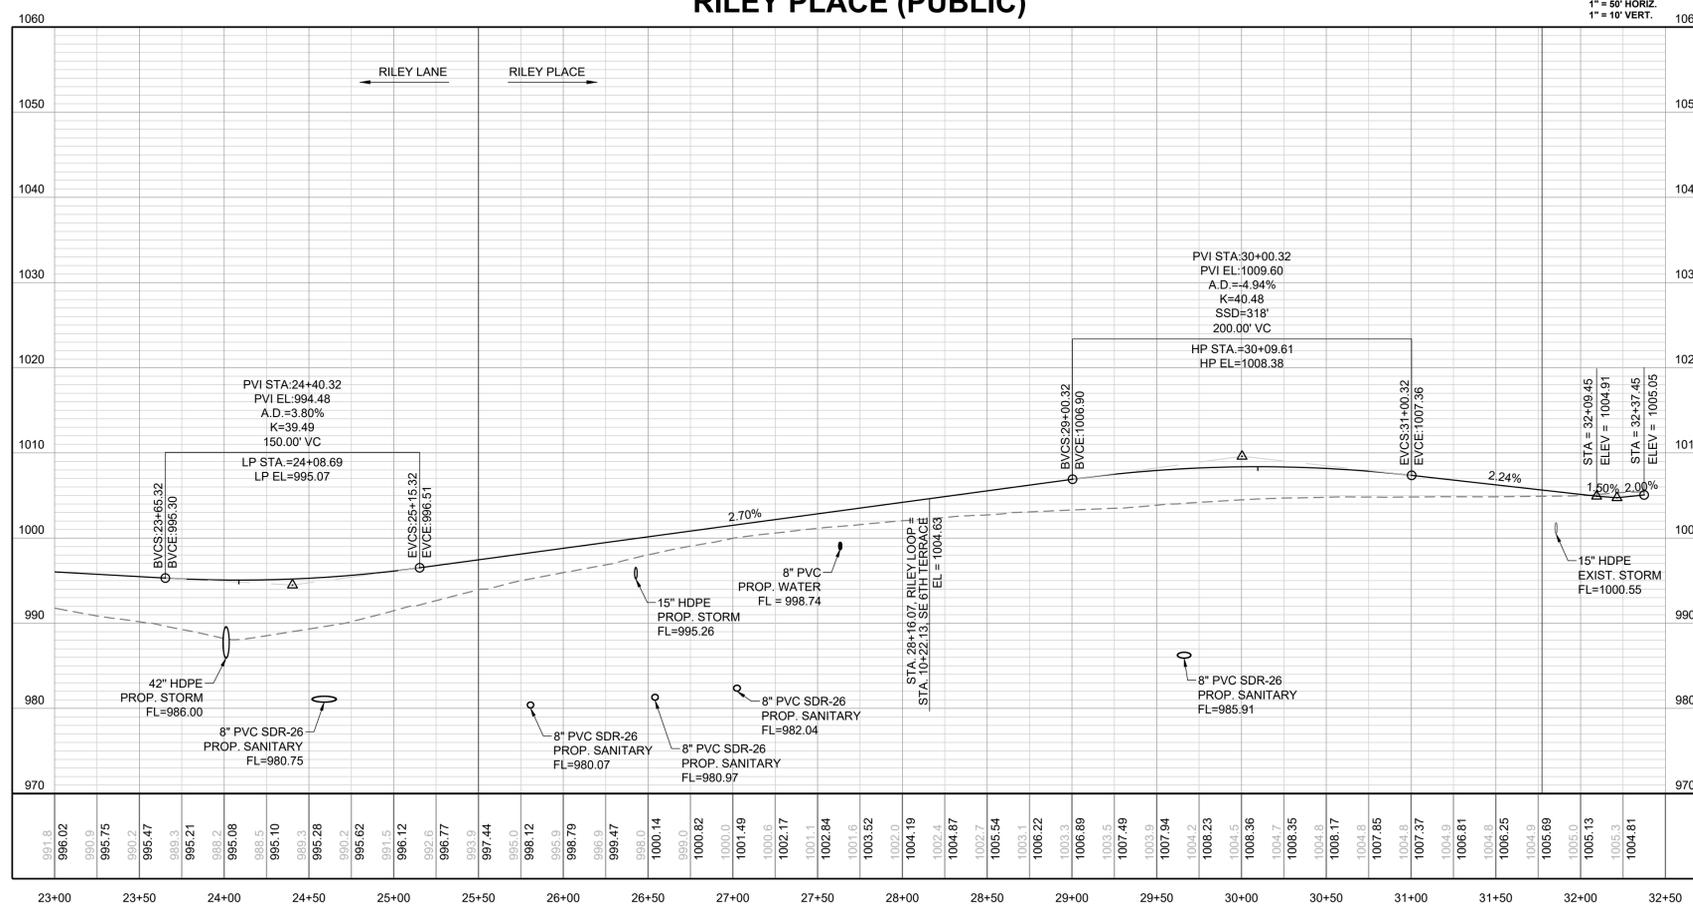

PREPARED BY:




SCHLAGEL & ASSOCIATES, P.A.

REUNION AT BLACKWELL
 PUBLIC STREET AND STORM SEWER PLANS
 SE SHENANDOAH DRIVE LEE'S SUMMIT, MO

REVISION DATE	DESCRIPTION
03/09/2023	DATE PREPARED
22-597	PROJ. NUMBER
TRC	DRAWN BY
MAB	CHECKED BY


RILEY PLACE -
 PLAN & PROFILE

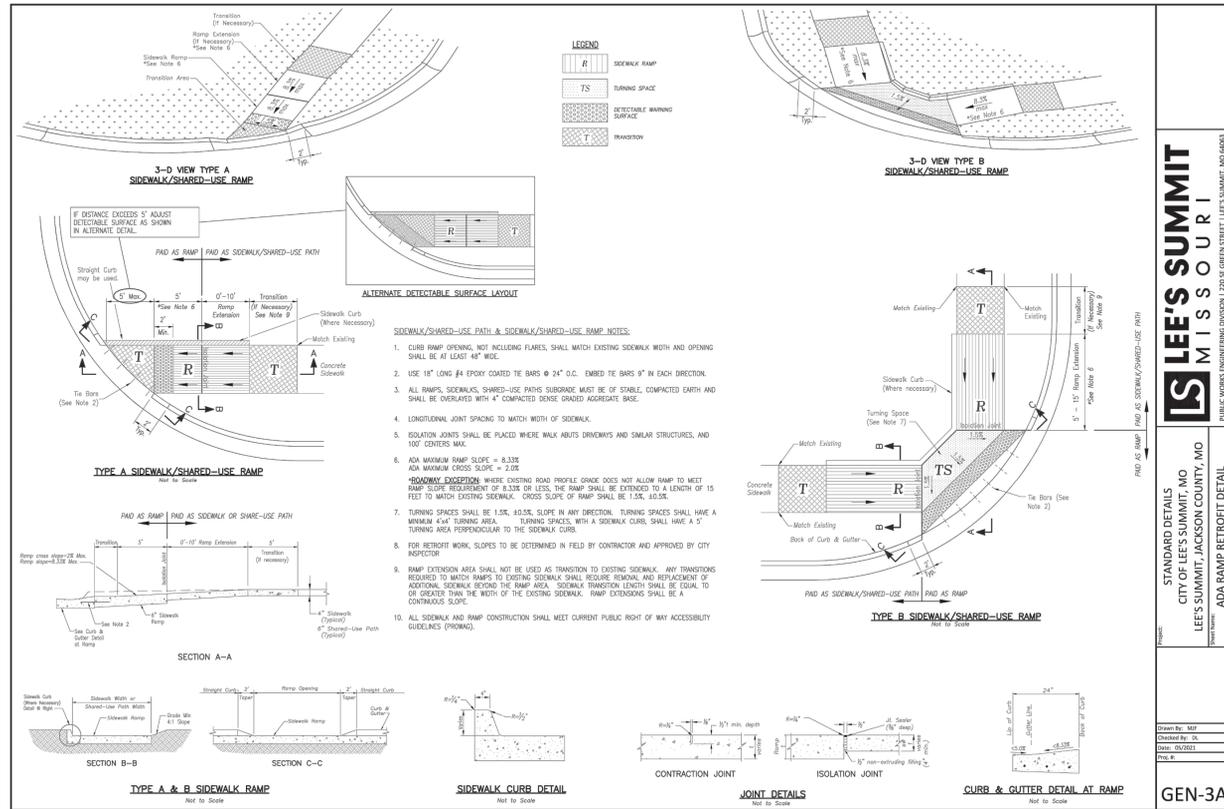

STANDARD DETAILS
CITY OF LEE'S SUMMIT, MO
LEE'S SUMMIT, JACKSON COUNTY, MO
PUBLIC WORKS ENGINEERING DIVISION | 220 SE GREEN STREET | LEE'S SUMMIT, MO 64063

GEN-3A


Drawn By: MIF
Checked By: DL
Date: 05/2021
Proj #: 22-287

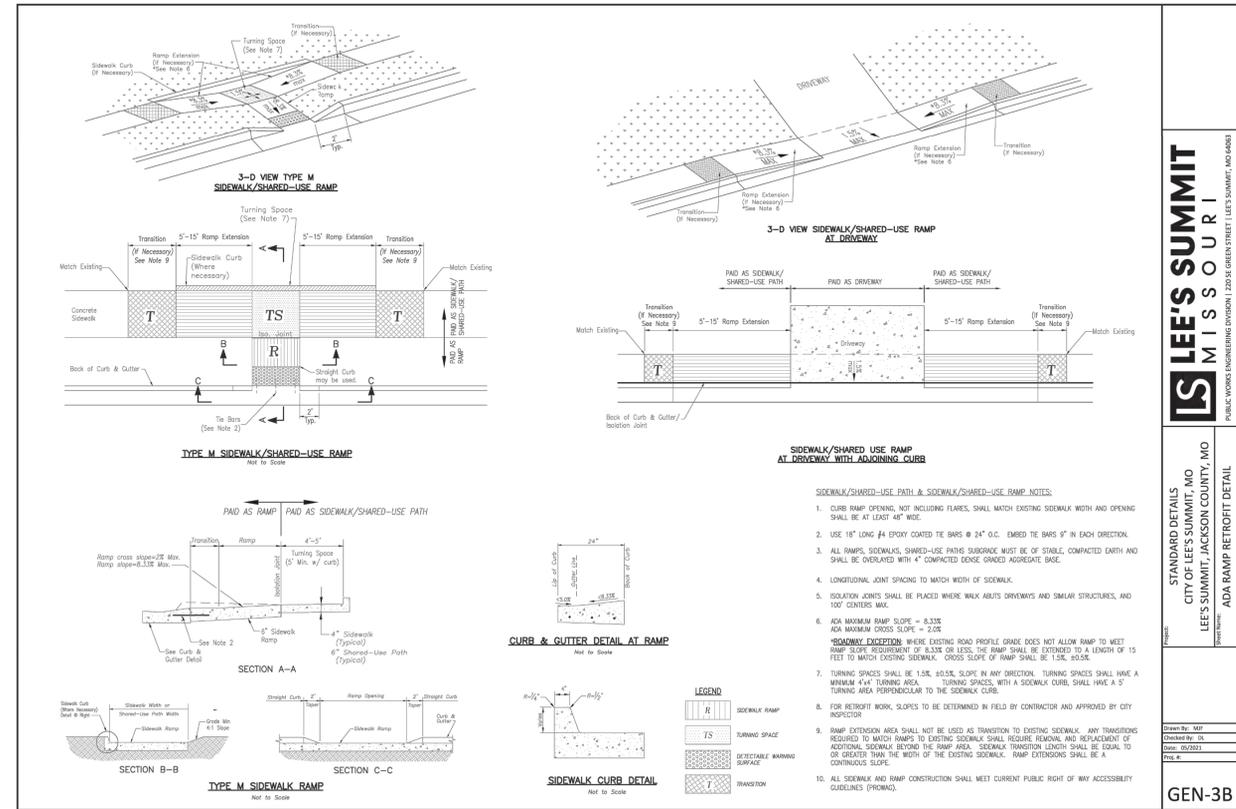

STANDARD DETAILS
CITY OF LEE'S SUMMIT, MO
LEE'S SUMMIT, JACKSON COUNTY, MO
PUBLIC WORKS ENGINEERING DIVISION | 220 SE GREEN STREET | LEE'S SUMMIT, MO 64063

GEN-3B


Drawn By: MIF
Checked By: DL
Date: 05/2021
Proj #: 22-287

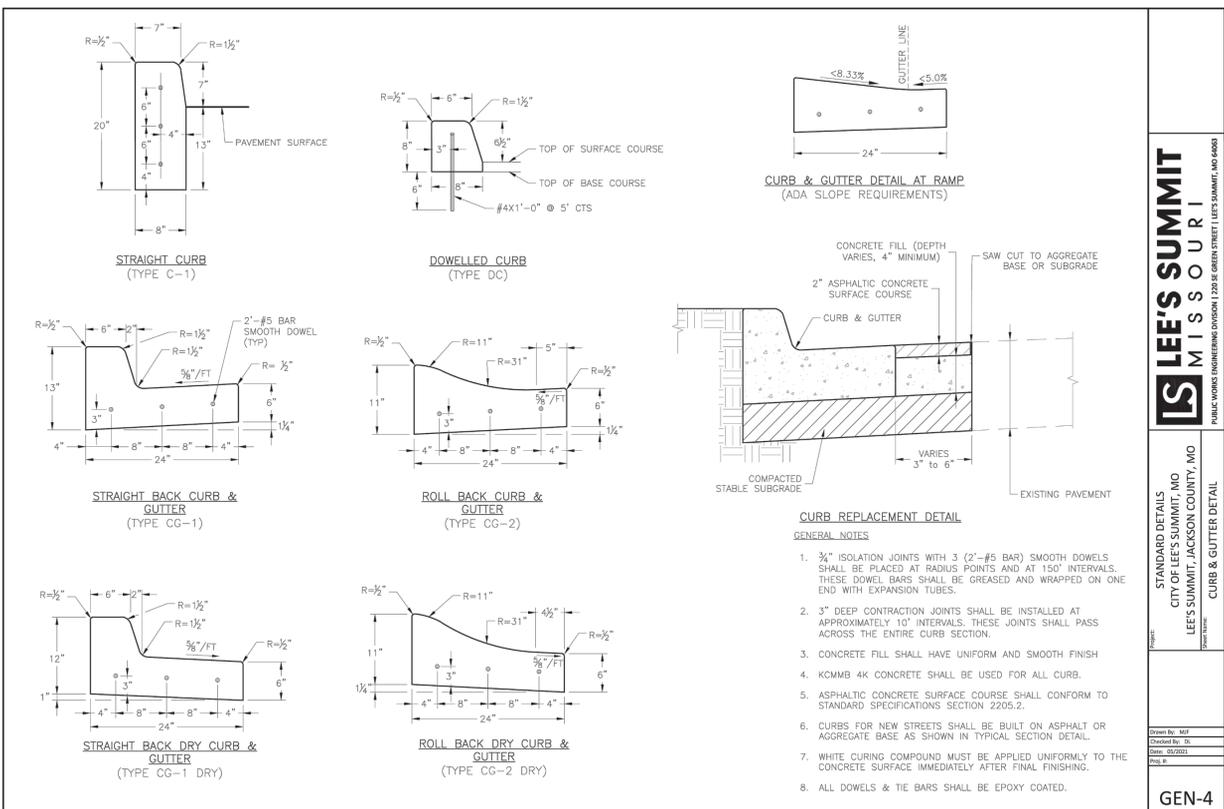

STANDARD DETAILS
CITY OF LEE'S SUMMIT, MO
LEE'S SUMMIT, JACKSON COUNTY, MO
PUBLIC WORKS ENGINEERING DIVISION | 220 SE GREEN STREET | LEE'S SUMMIT, MO 64063

GEN-4

Drawn By: MIF
Checked By: DL
Date: 05/2021
Proj #: 22-287

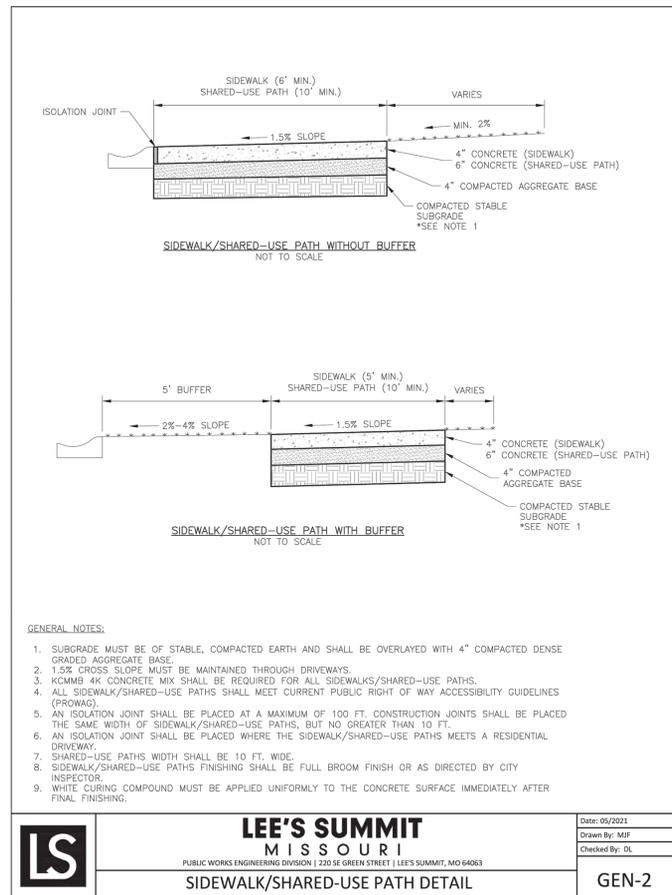


LEE'S SUMMIT
MISSOURI
PUBLIC WORKS ENGINEERING DIVISION | 220 SE GREEN STREET | LEE'S SUMMIT, MO 64063

GEN-2

Date: 05/2021
Drawn By: MIF
Checked By: DL

REVISION	DATE	DESCRIPTION
1		
2		
3		
4		
5		
6		
7		
8		
9		
10		

STREET DETAILS

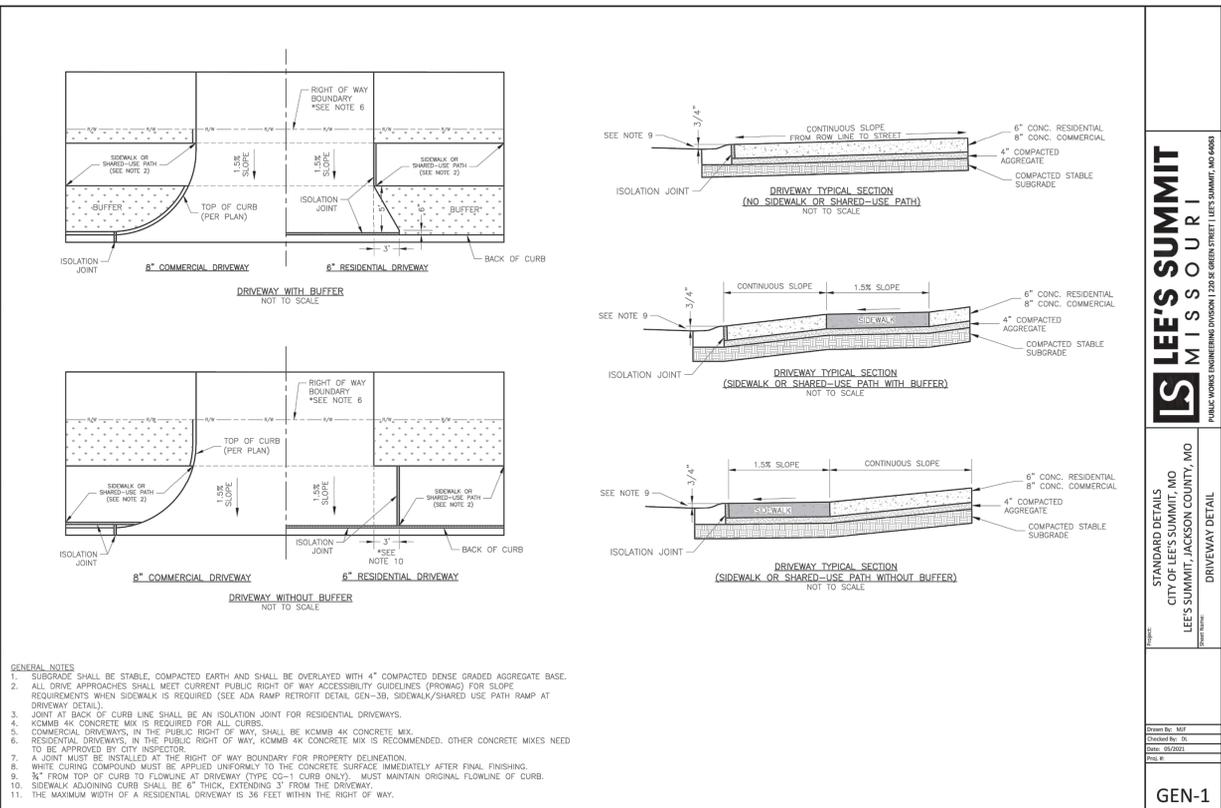


LEE'S SUMMIT MISSOURI
PUBLIC WORKS ENGINEERING DIVISION | 2201 SE GREEN STREET | LEE'S SUMMIT, MO 64080

STANDARD DETAILS
CITY OF LEE'S SUMMIT, MO
LEE'S SUMMIT, JACKSON COUNTY, MO

Drawn By: MAF
Checked By: DK
Date: 05/2021
Proj. No:

DRIVEWAY DETAIL

GEN-1

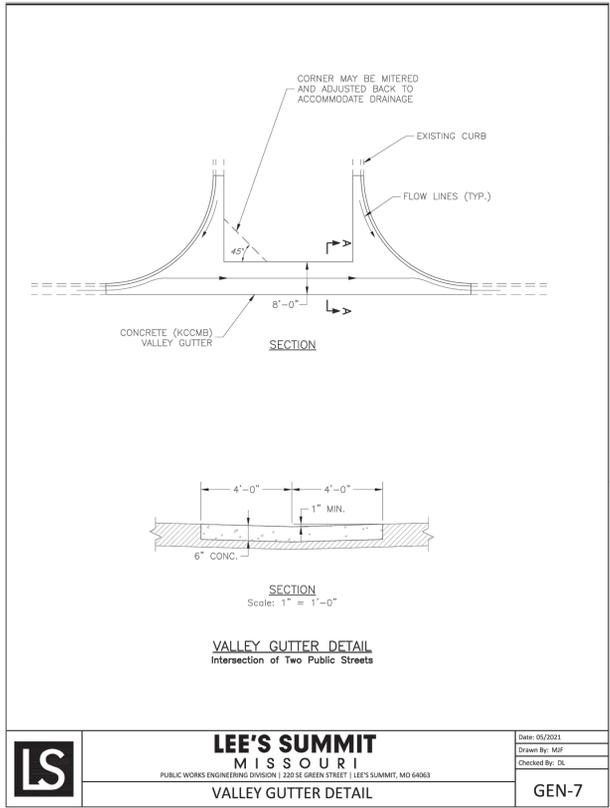

LEE'S SUMMIT MISSOURI
PUBLIC WORKS ENGINEERING DIVISION | 2201 SE GREEN STREET | LEE'S SUMMIT, MO 64080

Drawn By: MAF
Checked By: DK
Date: 05/2021

VALLEY GUTTER DETAIL

GEN-7


**REUNION AT BLACKWELL
PUBLIC STREET AND STORM SEWER PLANS
SE SHENANDOAH DRIVE LEE'S SUMMIT, MO**

REVISION DATE	DESCRIPTION
1	
2	
3	
4	
5	
6	
7	
8	
9	
10	
11	

DRAWN BY: TRC
CHECKED BY: MAB
DATE PREPARED: 05/05/2023
PROJ. NUMBER: 22-287


STREET DETAILS

LINE 100

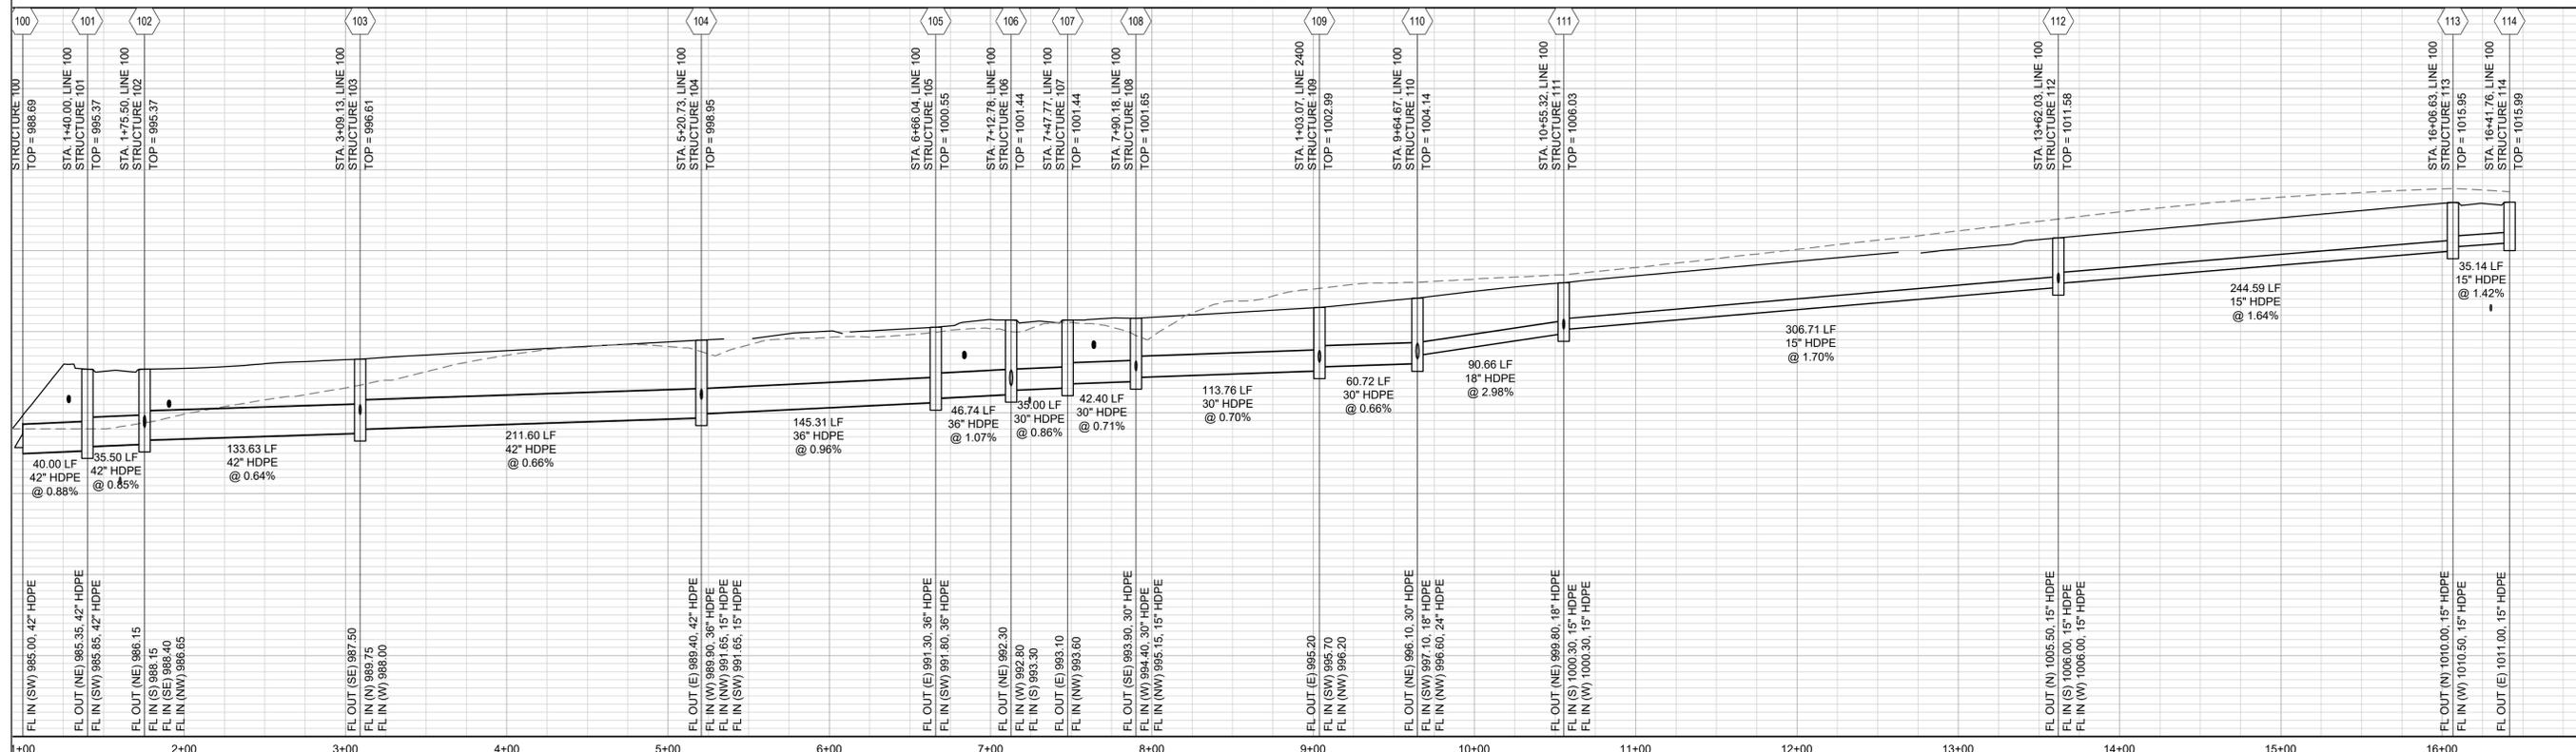


1" = 50' HORIZ
 1" = 10' VERT


LINE 300

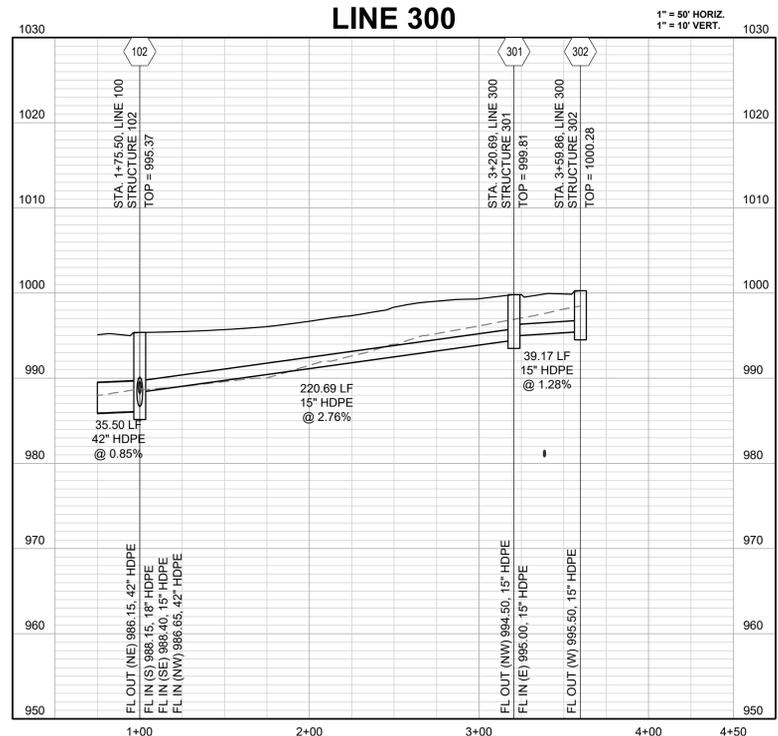

LINE 400

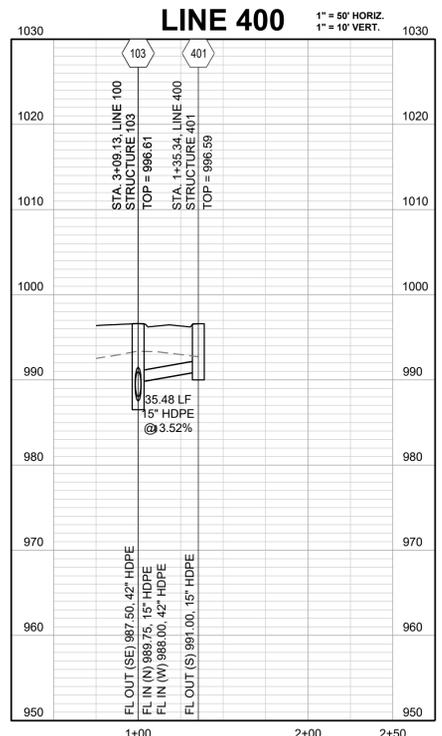

LINE 600

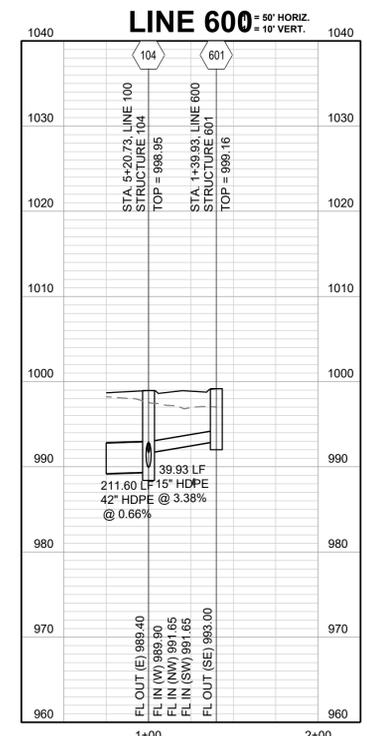

PREPARED BY:


 SCHLAGEL & ASSOCIATES, P.A.

REUNION AT BLACKWELL
 PUBLIC STREET AND STORM SEWER PLANS
 SE SHENANDOAH DRIVE LEE'S SUMMIT, MO

REVISION	DATE	DESCRIPTION
1		
2		
3		
4		
5		
6		
7		
8		
9		
10		

DRAWN BY: TRC
 CHECKED BY: MAB
 DATE PREPARED: 03/05/2023
 PROJ. NUMBER: 22-597

STORM PROFILES

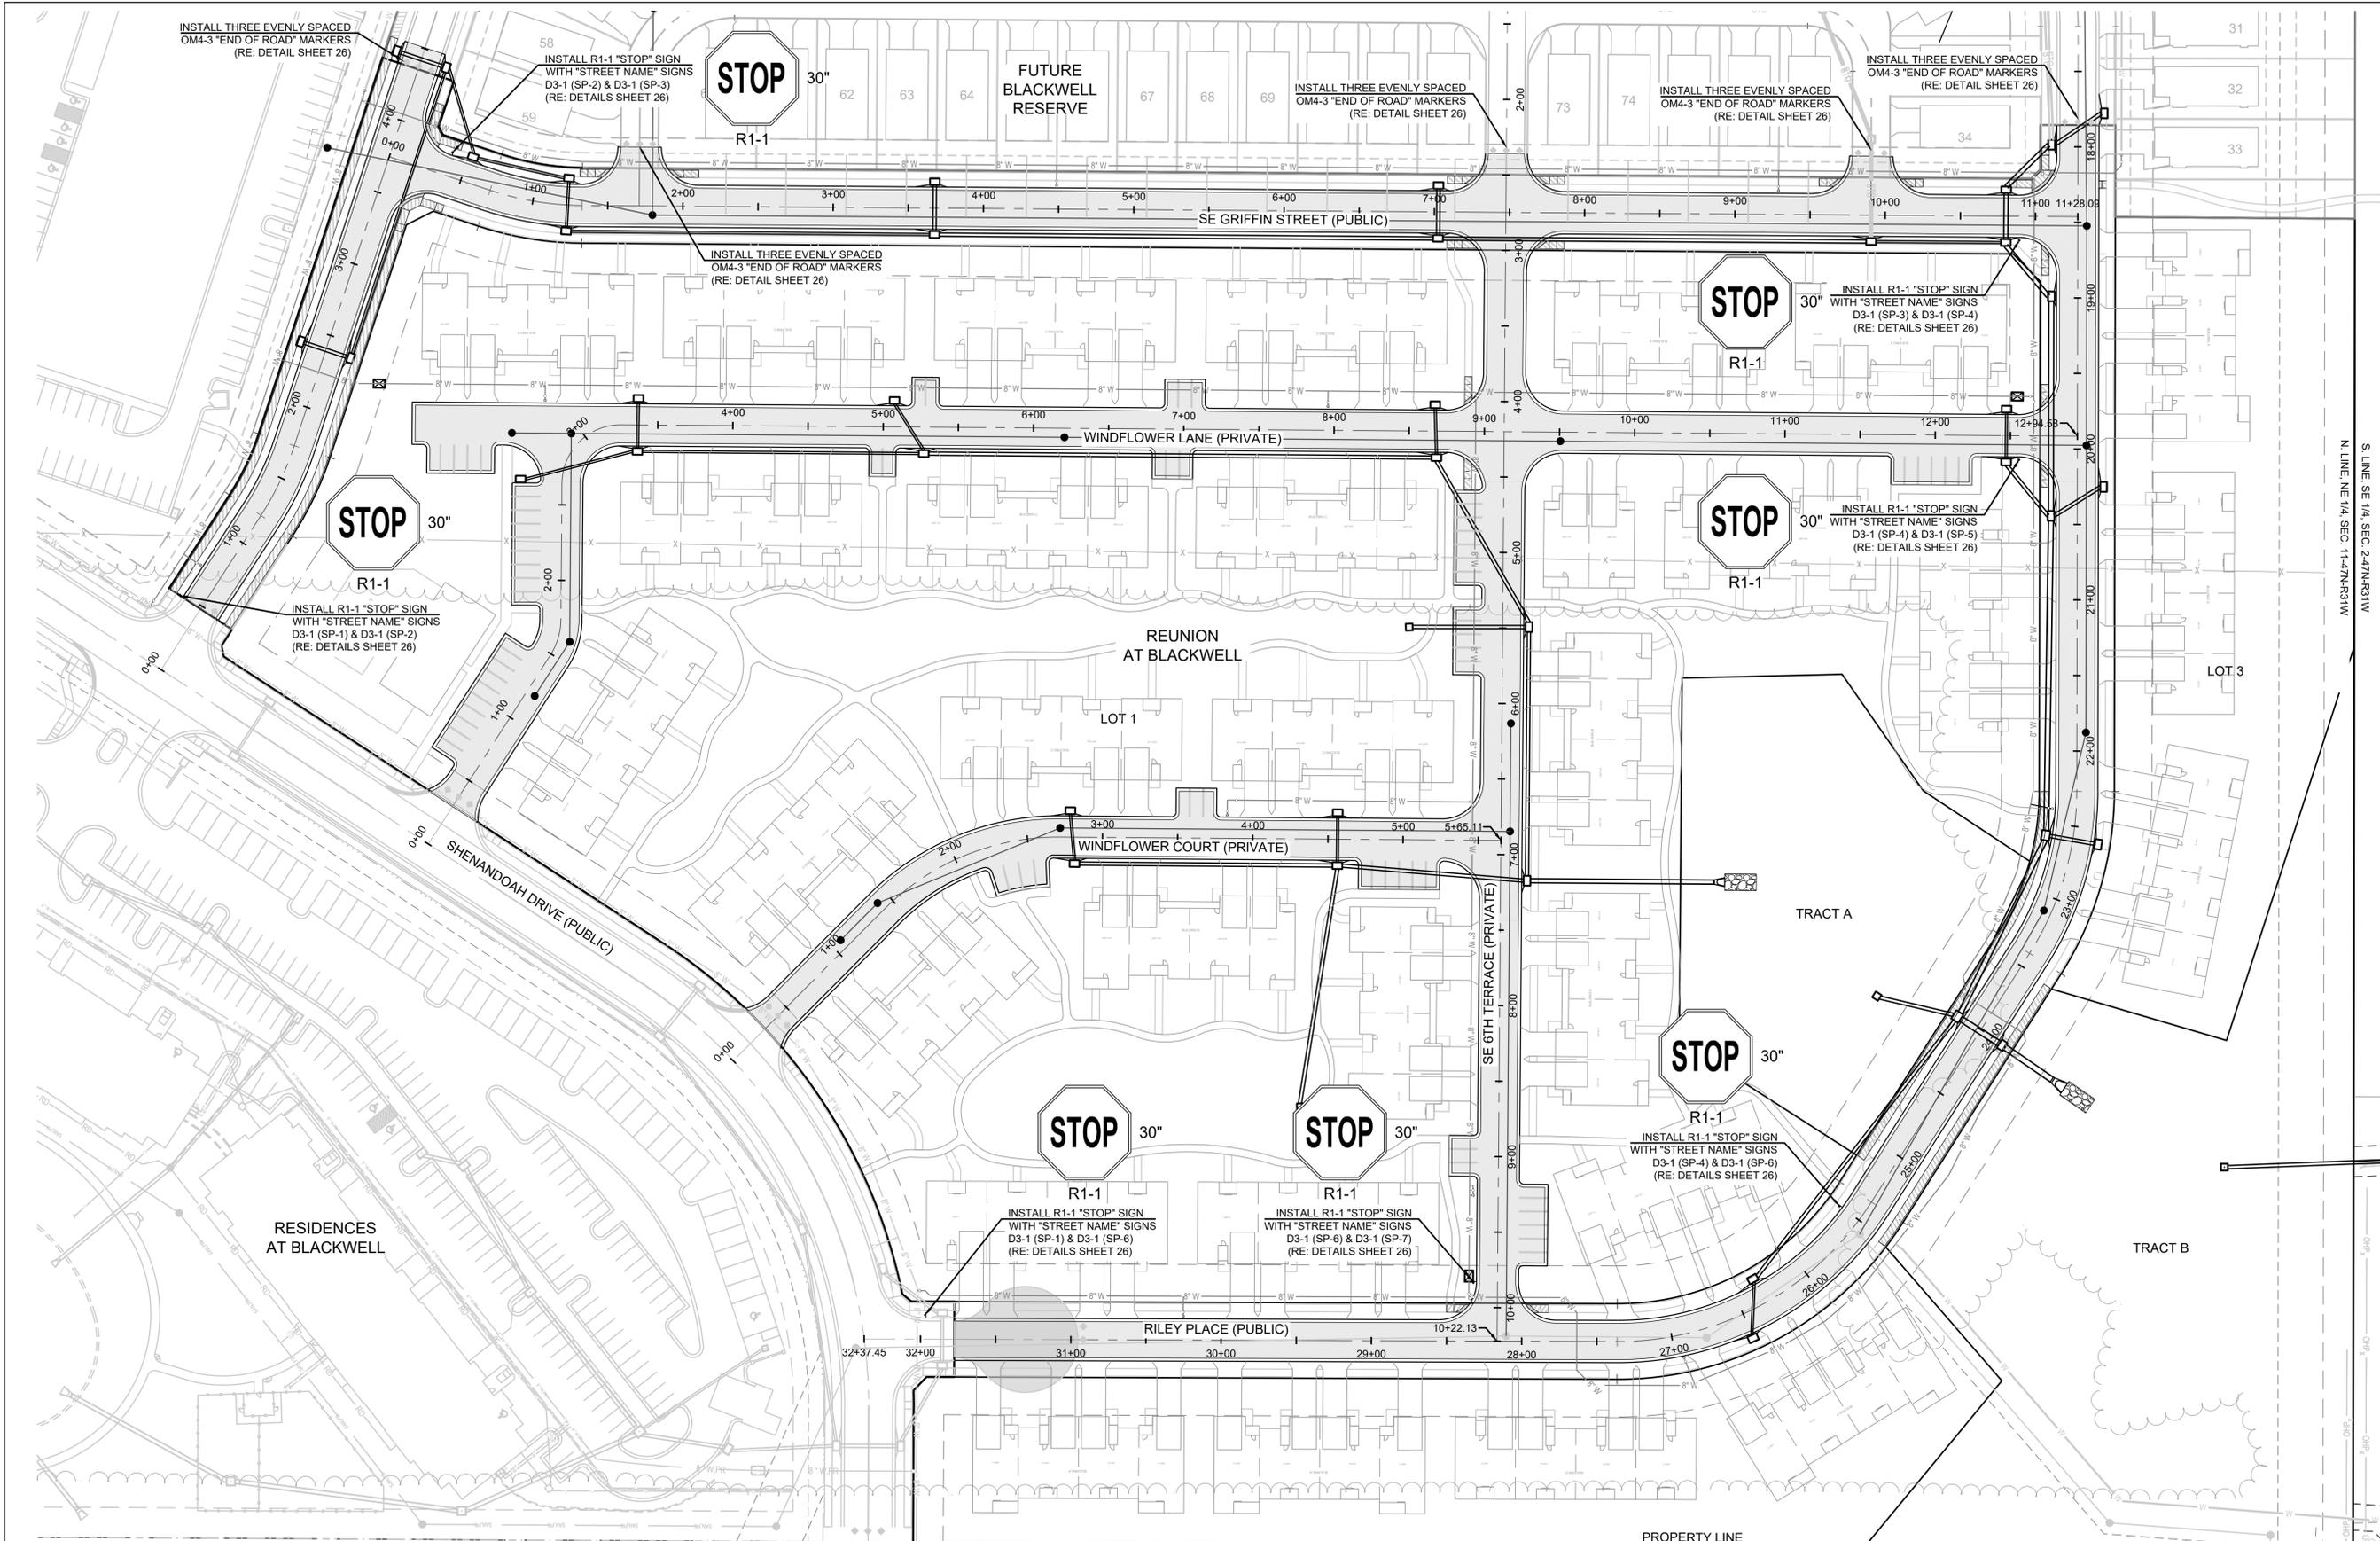

INSTALL THREE EVENLY SPACED OM4-3 "END OF ROAD" MARKERS (RE: DETAIL SHEET 26)

INSTALL R1-1 "STOP" SIGN WITH "STREET NAME" SIGNS D3-1 (SP-2) & D3-1 (SP-3) (RE: DETAILS SHEET 26)



FUTURE BLACKWELL RESERVE

INSTALL THREE EVENLY SPACED OM4-3 "END OF ROAD" MARKERS (RE: DETAIL SHEET 26)

INSTALL THREE EVENLY SPACED OM4-3 "END OF ROAD" MARKERS (RE: DETAIL SHEET 26)

INSTALL THREE EVENLY SPACED OM4-3 "END OF ROAD" MARKERS (RE: DETAIL SHEET 26)




INSTALL R1-1 "STOP" SIGN WITH "STREET NAME" SIGNS D3-1 (SP-3) & D3-1 (SP-4) (RE: DETAILS SHEET 26)



INSTALL R1-1 "STOP" SIGN WITH "STREET NAME" SIGNS D3-1 (SP-1) & D3-1 (SP-2) (RE: DETAILS SHEET 26)



INSTALL R1-1 "STOP" SIGN WITH "STREET NAME" SIGNS D3-1 (SP-4) & D3-1 (SP-5) (RE: DETAILS SHEET 26)

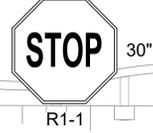

INSTALL R1-1 "STOP" SIGN WITH "STREET NAME" SIGNS D3-1 (SP-1) & D3-1 (SP-6) (RE: DETAILS SHEET 26)



INSTALL R1-1 "STOP" SIGN WITH "STREET NAME" SIGNS D3-1 (SP-6) & D3-1 (SP-7) (RE: DETAILS SHEET 26)




INSTALL R1-1 "STOP" SIGN WITH "STREET NAME" SIGNS D3-1 (SP-4) & D3-1 (SP-6) (RE: DETAILS SHEET 26)

PRIVATE ROAD NOTE:
WINDFLOWER LANE, WINDFLOWER COURT & SE 6TH TERRACE ARE PRIVATE ROADS AND WILL BE CONSTRUCTED UNDER A SEPARATE PLAN SET.

SIDEWALK NOTE:
SIDEWALKS AT BUILDINGS WILL BE INSTALLED BY OTHERS, UNLESS NOTED OTHERWISE.


MO GRS BENCHMARK:
STATION NAME - JA-90
KC METRO ALUMINUM GRS DISK SET IN CONCRETE STAMPED "JA-90, 1988" LOCATED NEAR THE INTERSECTION OF LANGSFORD ROAD AND OLD LANGSFORD ROAD, 43 FEET SOUTHEAST OF THE CENTER OF LANGSFORD ROAD AND 32 FEET NORTH OF THE CENTER OF OLD LANGSFORD ROAD.
N:1001052.8503, E:2845604.8272
ELEV. 997.045

PROJECT BENCHMARK:
"SQUARE" CUT IN TOP OF CONCRETE STORM MANHOLE STORM MANHOLE IS LOCATED APPROX. 130 FEET EAST OF THE INTERSECTION OF SE JOEL AVE & BLUE PARKWAY AND 26 FEET SOUTH OF THE CENTERLINE OF BLUE PARKWAY.
N:996874.9690, E:2840937.1365
ELEV. 1005.719

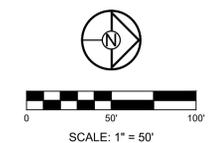


REUNION AT BLACKWELL
PUBLIC STREET AND STORM SEWER PLANS
SE SHENANDOAH DRIVE LEE'S SUMMIT, MO

REVISION DATE	DESCRIPTION
1	ISSUED FOR PERMIT
2	REVISED PER COMMENTS
3	REVISED PER COMMENTS
4	REVISED PER COMMENTS
5	REVISED PER COMMENTS
6	REVISED PER COMMENTS
7	REVISED PER COMMENTS
8	REVISED PER COMMENTS
9	REVISED PER COMMENTS
10	REVISED PER COMMENTS

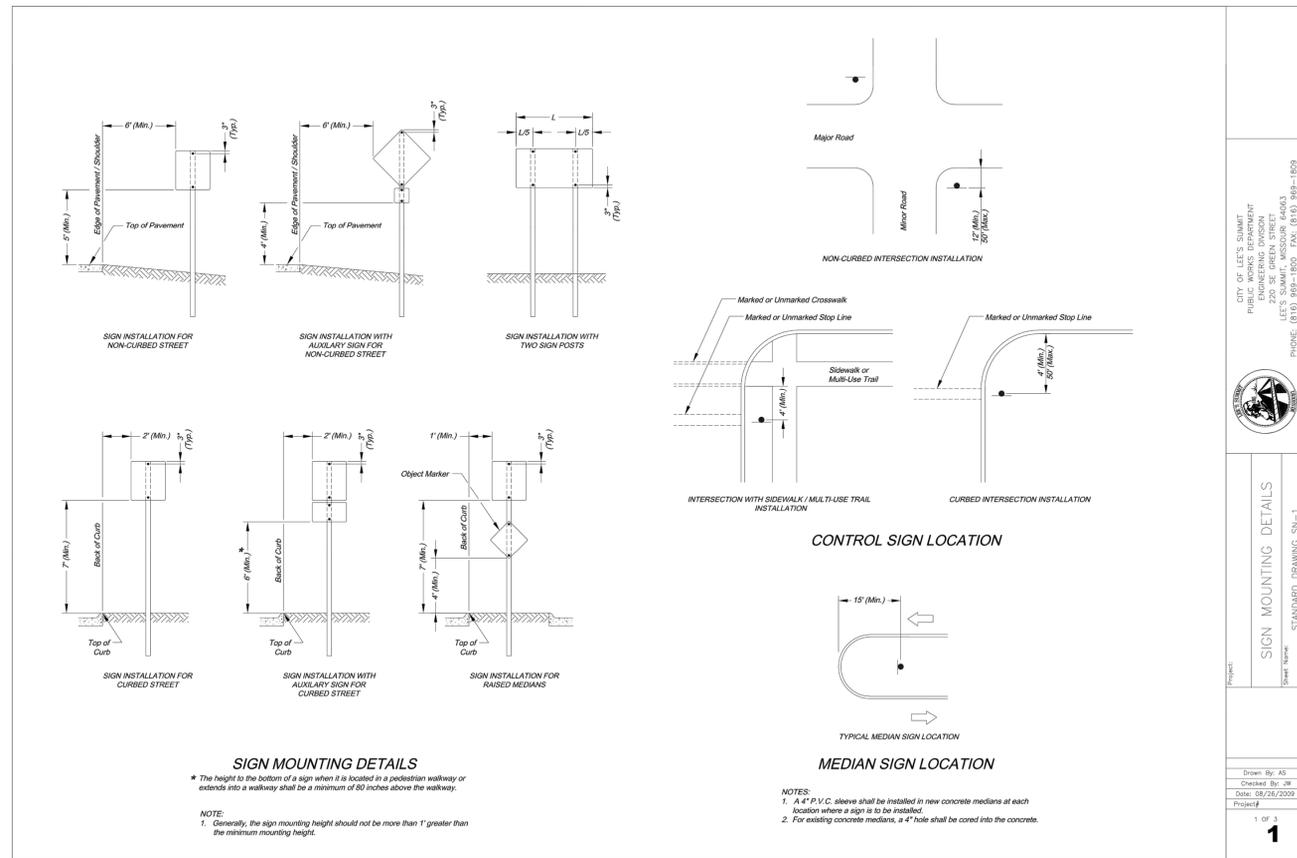


CITY OF LEE'S SUMMIT
PUBLIC WORKS DEPARTMENT
220 SE GREEN STREET
LEE'S SUMMIT, MISSOURI 64083
PHONE: (816) 899-1800 FAX: (816) 899-1809

Project: SIGN MOUNTING DETAILS
Sheet Name: STANDARD DRAWING SN-1
1 OF 3

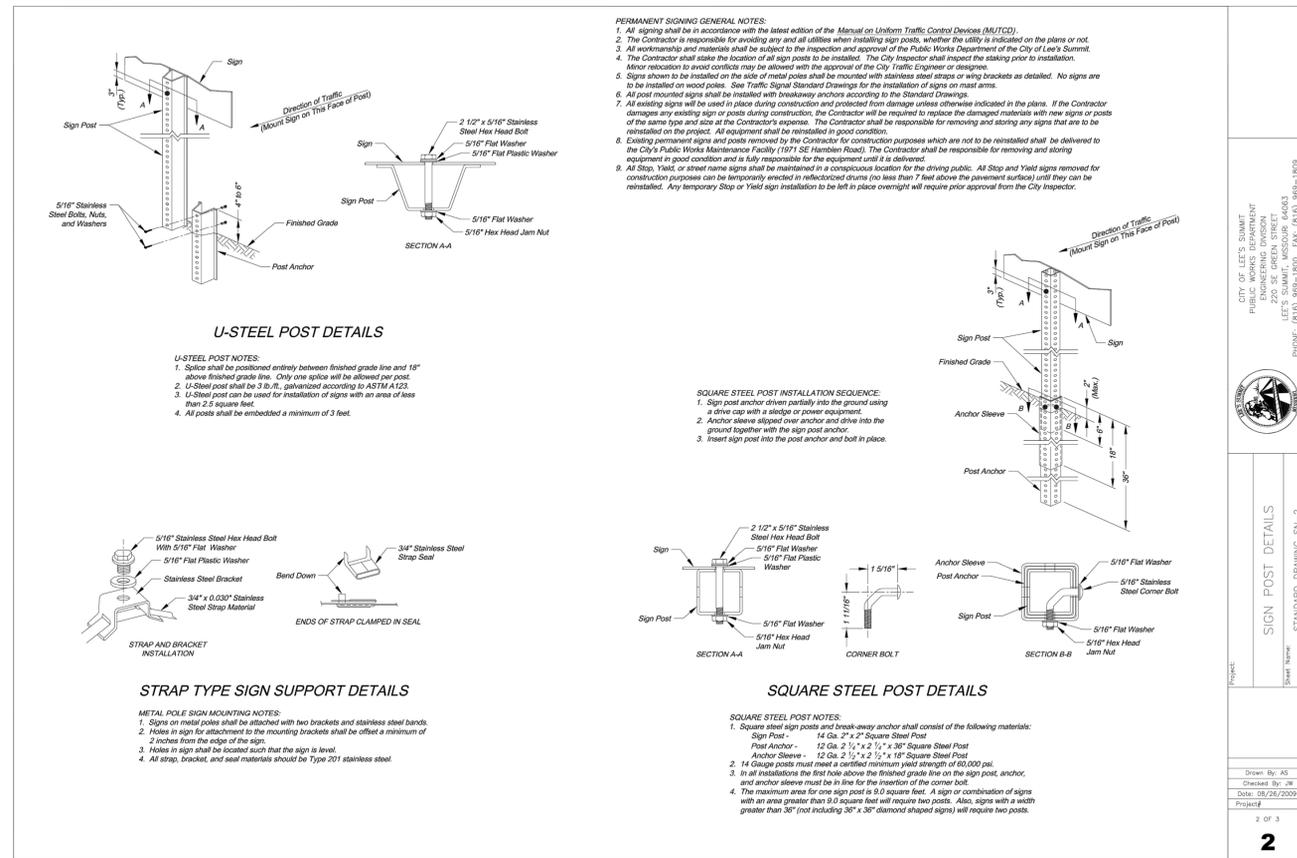


CITY OF LEE'S SUMMIT
PUBLIC WORKS DEPARTMENT
220 SE GREEN STREET
LEE'S SUMMIT, MISSOURI 64083
PHONE: (816) 899-1800 FAX: (816) 899-1809

Project: SIGN POST DETAILS
Sheet Name: STANDARD DRAWING SN-2
2 OF 3

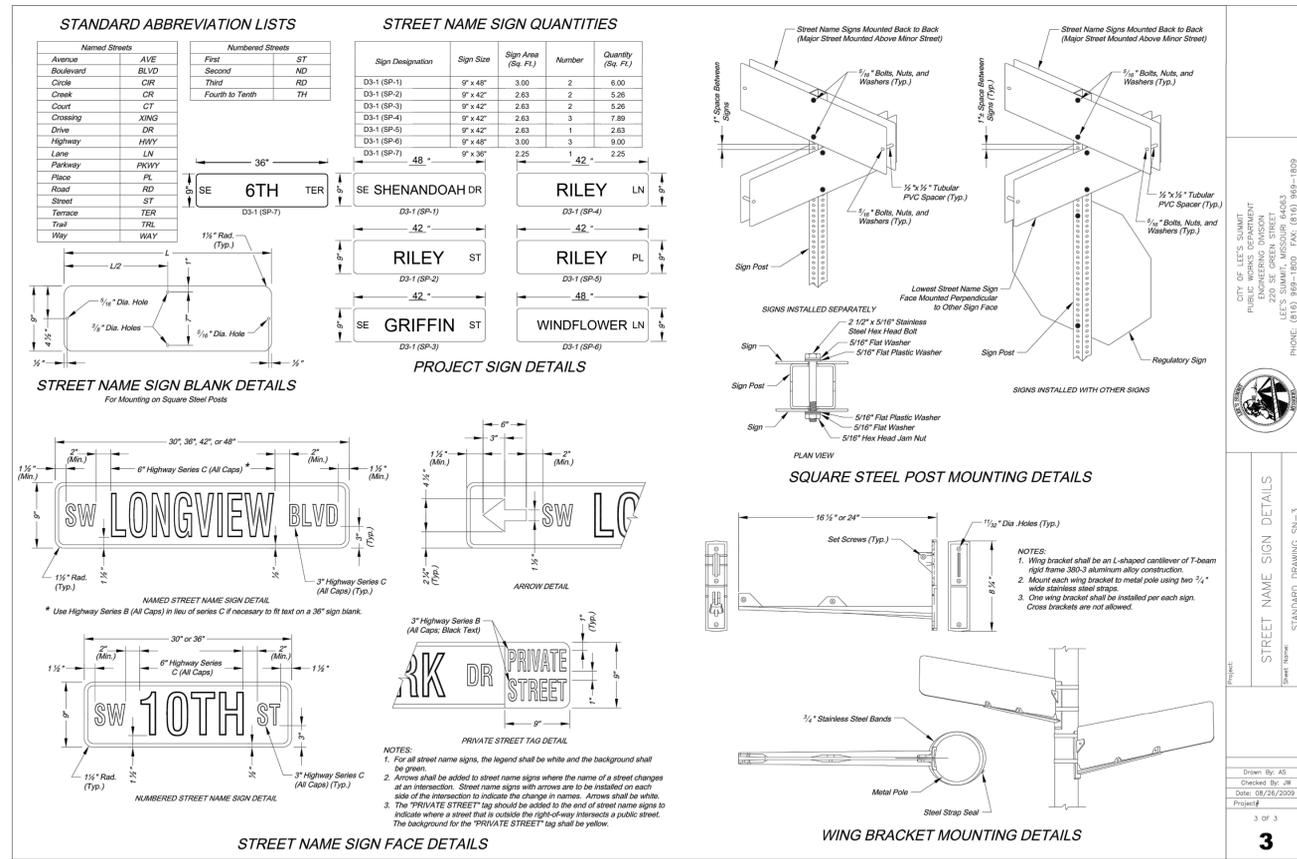

CITY OF LEE'S SUMMIT
PUBLIC WORKS DEPARTMENT
220 SE GREEN STREET
LEE'S SUMMIT, MISSOURI 64083
PHONE: (816) 899-1800 FAX: (816) 899-1809

Project: STREET NAME SIGN DETAILS
Sheet Name: STANDARD DRAWING SN-3
3 OF 3

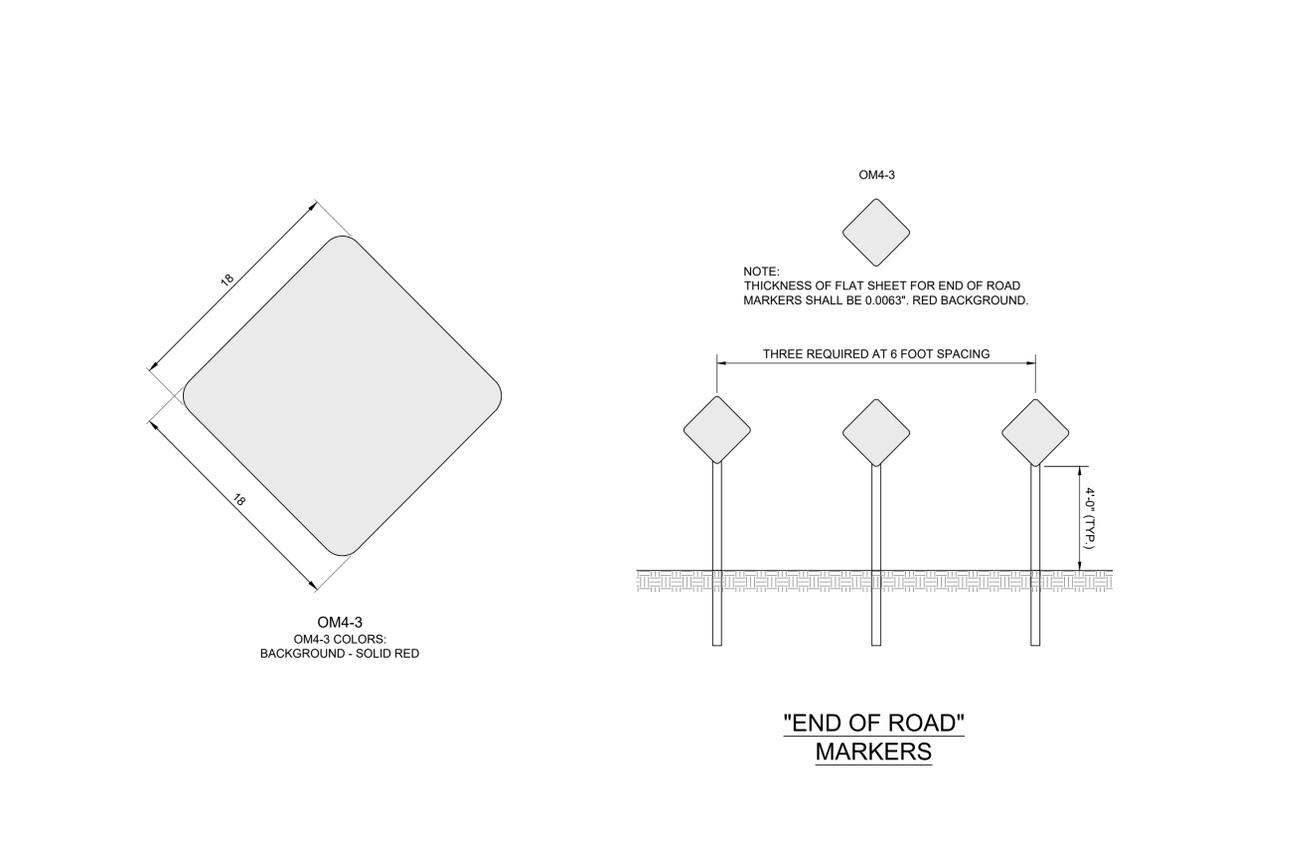

CITY OF LEE'S SUMMIT
PUBLIC WORKS DEPARTMENT
220 SE GREEN STREET
LEE'S SUMMIT, MISSOURI 64083
PHONE: (816) 899-1800 FAX: (816) 899-1809

Project: STREET NAME SIGN DETAILS
Sheet Name: STANDARD DRAWING SN-3
3 OF 3