2022/11/08 Date: Drawn by: SJB Checked by: **SCH** Revisions : **2023/01/03**



DALLENBACH · COLE





PROJECT TEAM

LAKEVIEW SELF STORAGE - LEE'S SUMMIT, MO

LAKEVIEW SELF STORAGE PROJECT NAME: BASE ALLOWABLE BUILDING AREA: 4101 NE PORT DRIVE PROJECT LOCATION: LEE'S SUMMIT, MISSOURI ACTUAL FLOOR AREAS: PROJECT OWNERSHIP: OCCUPANT LOAD FACTORS: ARCHITECT: HERNLY ASSOCIATES, INC. 1100 RHODE ISLAND ST. LAWRENCE, KANSAS 66044 OCCUPANT LOADS: P. 785-749-5806 F. 785-749-1515 GENERAL CONTRACTOR: STRICKLAND CONSTRUCTION 720 S. ROGERS ROAD, SUITE B OLATHE, KANSAS 66062 P. 913-764-7000 F. 913-768-8425 DEVELOPMENT SERVICES BUILDING INSPECTION DEPT: 220 SE GREEN LEE'S SUMMIT, MO 64063 EGRESS REQUIREMENTS: 816-969-1200 CODES/REGULATIONS UTILIZED: - 2018 International Building Code 2018 International Mechanical Code 2017 National Electrical Code 2018 Uniform Plumbing Code 2018 International Fire Code 2012 International Energy Conservation Code ICC/ANSI AIIT.I - 2009 Accessibility and Usability Code METAL STUDS, STEEL DECK/ CONCRETE TOPPING, CONSTRUCTION: METAL PANEL, MASONRY VENEER ACTUAL MAX. TRAVEL DISTANCE: TYPE II-B - FULLY SPRINKLED CONSTRUCTION TYPE: THREE FLOOR SELF STORAGE FACILITY W/ OFFICE SELF STORAGE - GROUP S-I OCCUPANCY GROUPS: OFFICE/RETAIL - GROUP B OCCUPANCY SEPARATIONS: NONE REQUIRED FIRE RESISTANCE RATINGS: STRUCTURAL FRAME = 0 BEARING WALLS = 0 PARTITIONS = 0 FLOOR CONSTRUCTION = O ROOF CONSTRUCTION = O CORRIDORS = 0 SHAFT CONSTRUCTION = I-HOUR SPECIAL INSPECTIONS REQUIRED: FIRE SAFETY: AUTOMATIC FIRE SPRINKLER THROUGHOUT -- NFPA I3 FIRE ALARM SYSTEM & SMOKE DETECTION -AS REQ. 2a-10bc (LOCATE PER LOCAL FIRE DEPT)
ALL EXTINGUISHERS IN PLAIN VIEW, MOUNTED W/ FIRE EXTINGUISHERS SIGNAGE ABOVE IF NEEDED. MUST COMPLY WITH IFC 906.3 AND MUST FOLLOW IFC 906 FOR TRAVEL DISTANCE (75' MIN.) EMERGENCY/EXIT LIGHTING -PER ELEC. DRAWINGS contradictory interpretations, reasonable professional efforts have been used PROVIDE SAFETY GLAZING IN DOORS AND FIXED SAFETY GLAZING to interpret applicable requirements. No warranty or guarantee is given that PANELS ADJACENT TO DOORS COMPLYING WITH 2003

IBC CHAPTER 24

3-STORY, 38'-2" (OK)

3-STORY, 75 FEET (FULLY SPRINKLED)


ALLOWABLE BUILDING HEIGHT:

CODE INFORMATION

ACTUAL BUILDING HEIGHT:

52,500 S.F. PER STORY (FULLY-SPRINKLED, MULTISTORY) IST FLOOR - GROUP S-I, B = 34,375 S.F. (OK) 2ND FLOOR - GROUP S-I = 33,284 S.F. (OK) 3RD FLOOR - GROUP S-I = 34,426 S.F. (OK) S-I STORAGE WAREHOUSE = 500 BUSINESS = 150 FIRST FLOOR SECOND FLOOR = 33,284/500 = 67 THIRD FLOOR = 34,426/500 RETAIL/OFFICE: FIRST FLOOR = 1200/150 = 211 TOTAL EXITS REQUIRED: 2 PER FLR. @ O.L. >1 AND <500 (100 OCC) EXITS PROVIDED: 2+ ALL FLOORS (OK) EGRESS WIDTH REQ: - 75 *O.*L. × *O.*I5" = II.25" EGRESS WIDTH PROVIDED: 176" (OK) - 67 O.L. × O.15" = 10.1" EGRESS WIDTH PROVIDED: 140" (OK) - 69 O.L. × O.20" = 13.8 EGRESS WIDTH PROVIDED: 72" (OK) MAX. ALLOWABLE TRAVEL DISTANCE: FIRST FLOOR = 191'-3" SECOND FLOOR = 147'-10" THIRD FLOOR = 207'-8" REV: 2023/01/03 MIN. PLUMBING FIXTURE REQ'S (WHOLE BLDG): TOTAL OCC (S-I & B): 2II : 106 MEN, 106 WOMEN MIN. PLUMBING FIXTURE REQ'S (WHOLE BLDG): FIXTURES REQUIRED FOR STORAGE & OFFICE OCC: = I FIX:50 MEN OCC. = 3 FIXTURE = 1 FIX:50 WOMEN OCC. = 3 FIXTURES = 1 SERVICE SINK FIXTURES PROVIDED: = 3 WC AND LAV FIXTURES FOR MEN (OK) = 3 WC AND LAV FIXTURES FOR WOMEN (OK) = I SERVICE SINK (OK) EXCAVATION AND FILLING VERIFICATION OF SOILS PLACEMENT OF REINFORCING STEEL TESTING OF REINFORCED CONCRETE BOLTS INSTALLED IN CONCRETE STRUCTURAL MASONRY This project has been designed by this office for compliance with applicable laws, codes and ordinances including the ADA Title III guidelines. Since the requirements of these regulations are subject to various and possibly


the project complies with all interpretations as they apply to the project.

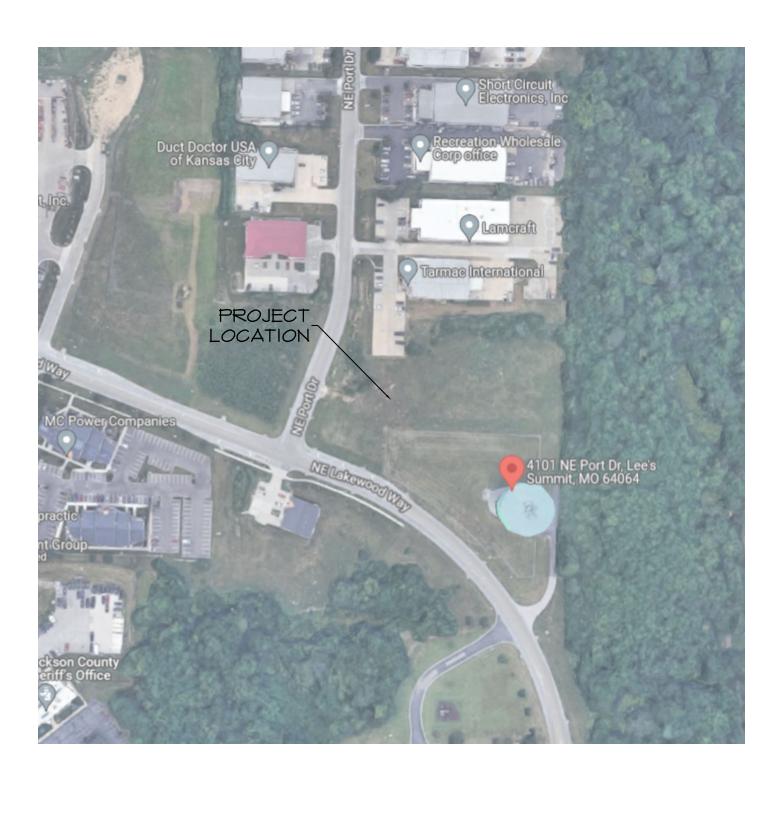

LOCATION MAP


ARCHITECTURAL SET REV: 2023/01/03

...CODE INFORMATION, LOCATION PLAN COVERCODE PLANS (1-3) ...FIRE RATED DETAILS, CODE DETAILS ..FIRST FLOOR PLAN ..SECOND FLOOR PLAN A2.3.. ..THIRD FLOOR PLAN ..PLAN DETAILS A2.5... ..PLAN DETAILS A2.6.. ..INTERIOR ELEVATIONS ..PLAN DETAILS A2.7.. ..ELEVATIONS A3.2.. ..ELEVATIONS ..WALL SECTIONS ...WALL SECTIONS ...WALL SECTIONS A4.3.. ..WALL SECTIONS A4.4.. ...WALL SECTIONS ...WALL SECTIONS A4.6.. ...WALL SECTIONS A4.8.. ...WALL SECTIONS A4.9.. .. WALL SECTIONS ...WALL SECTIONS A4.10.. ...WALL SECTIONS A4.12.. .. WALL SECTION DETAILS ..ROOF PLAN & ROOF DETAILS ...FINISH & DOOR SCHEDULES ..WINDOW SCHEDULE ...FOUNDATION PLAN F1.2. ..FOUNDATION DETAILS F1.3.. .FOUNDATION DETAILS

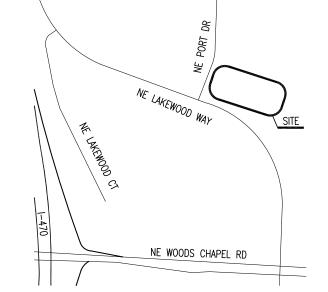



SHEET INDEX

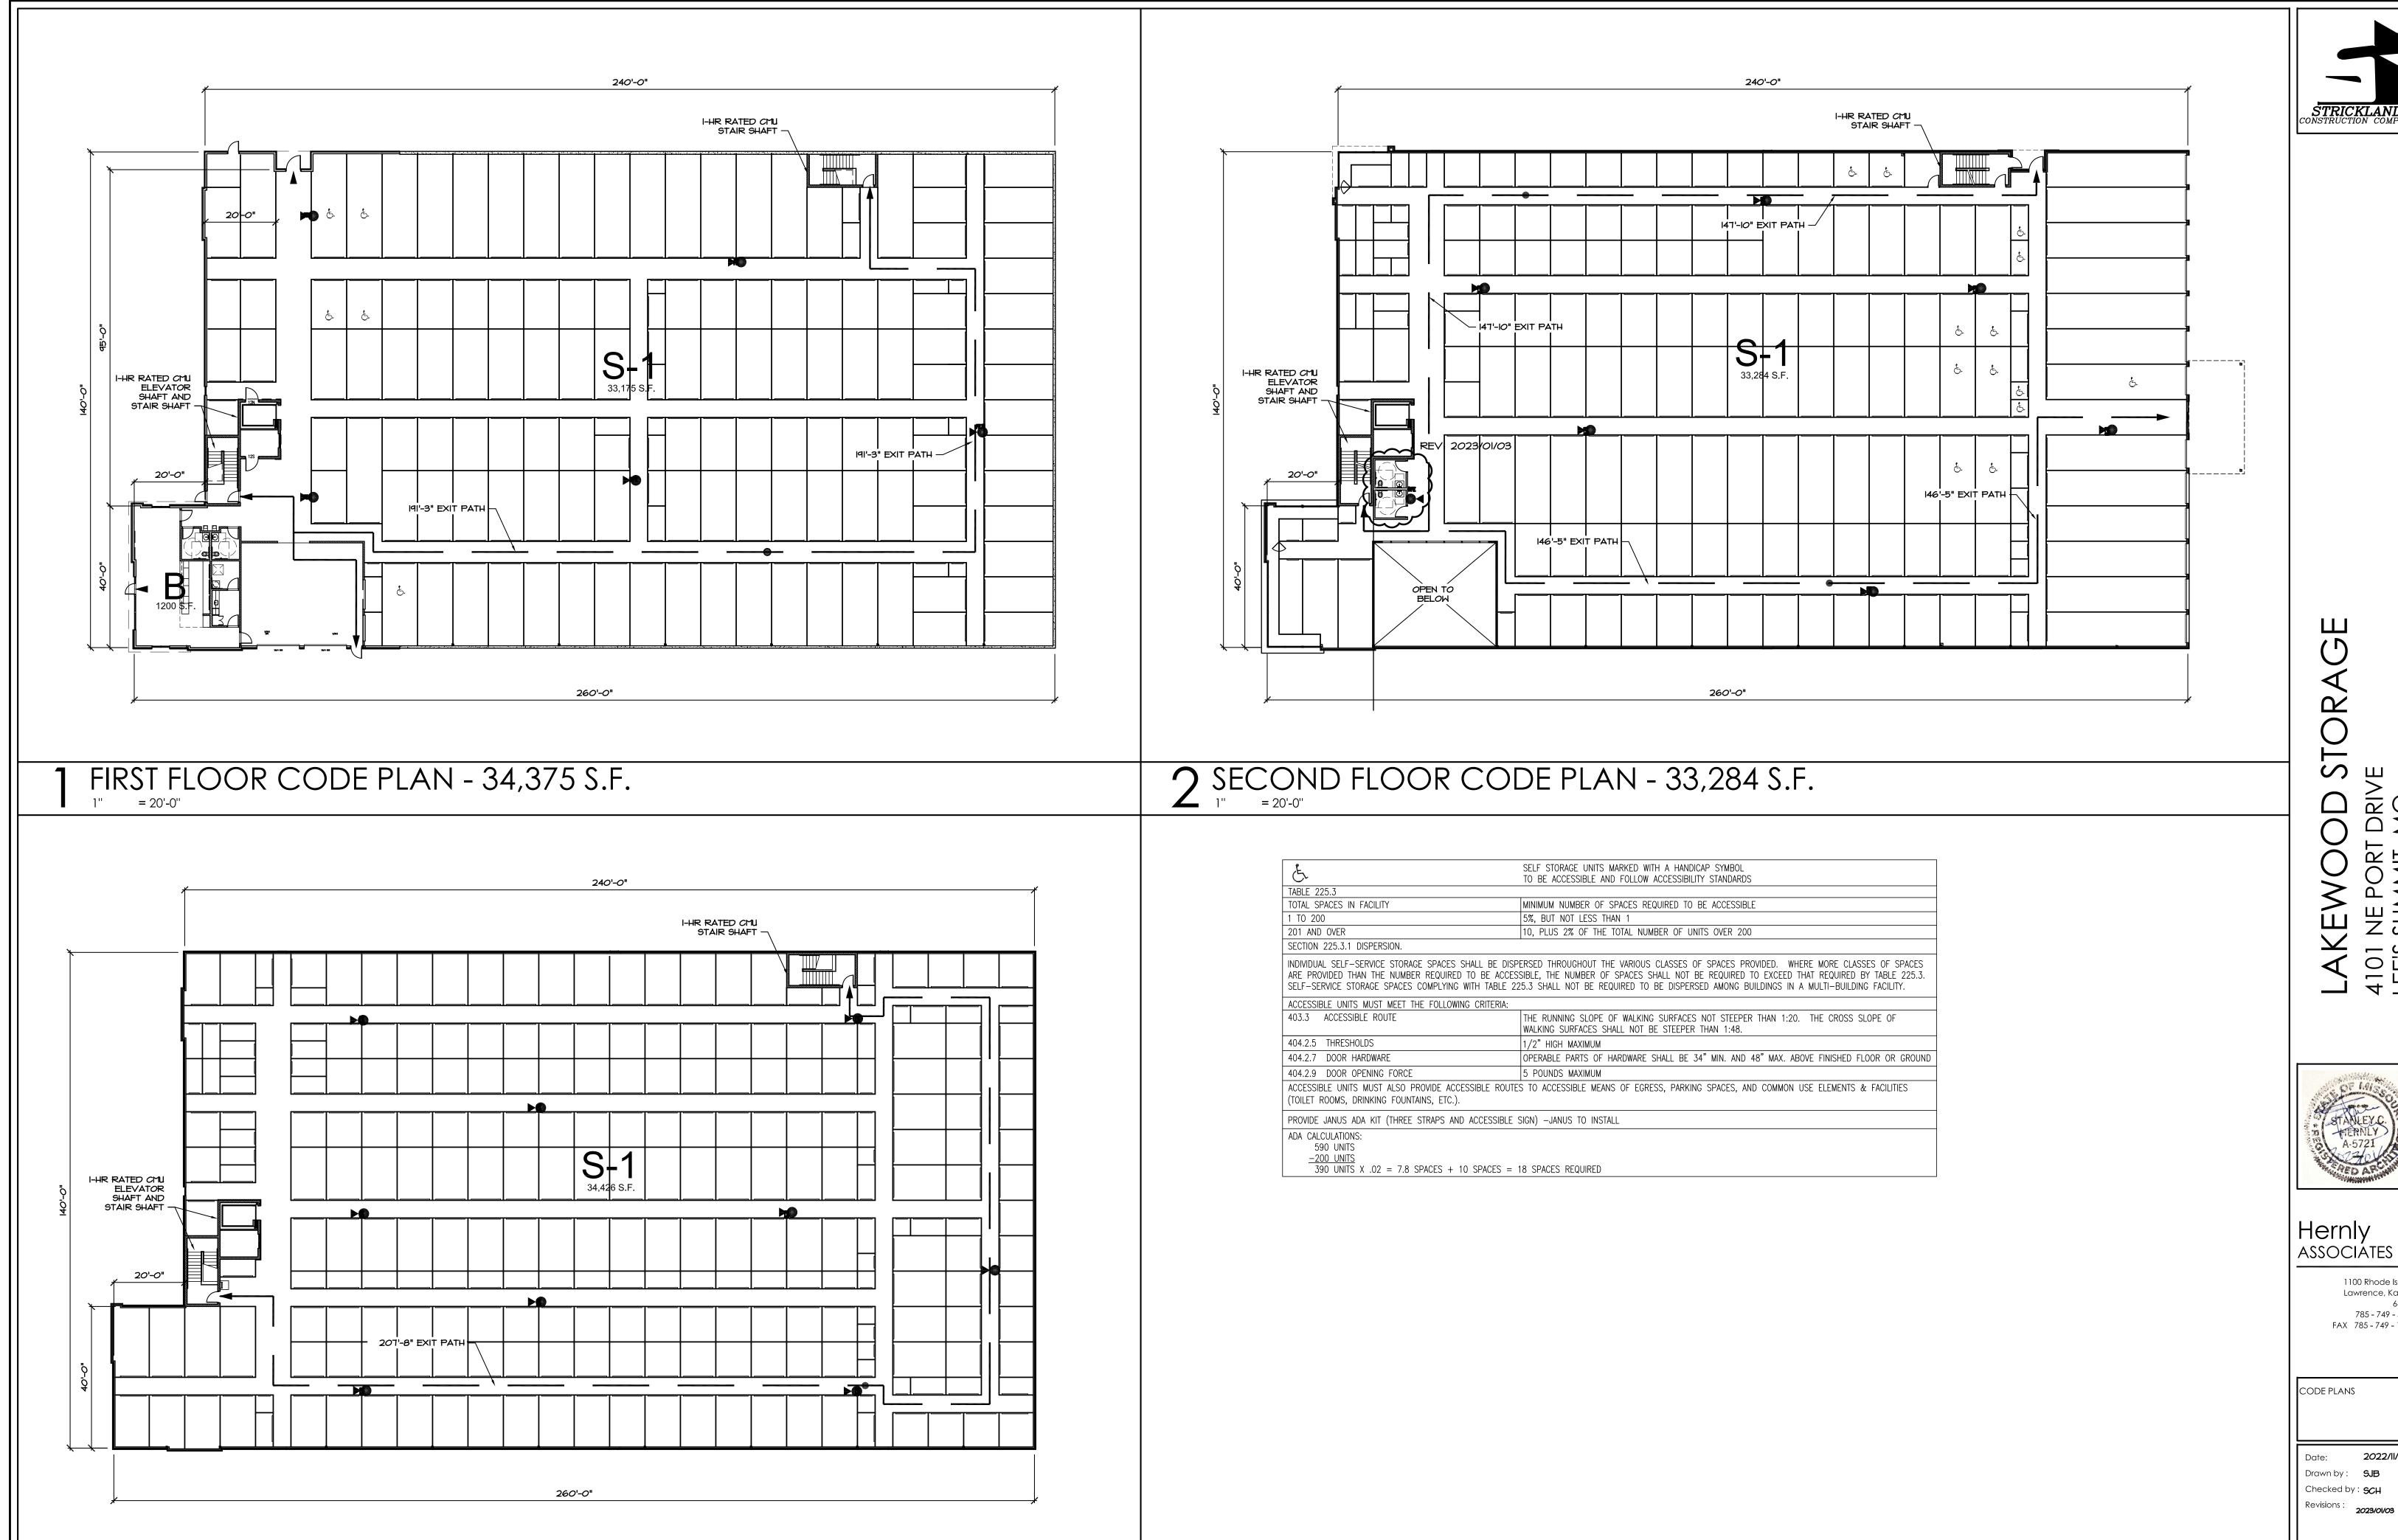


THIRD FLOOR CODE PLAN - 34,426 S.F.

410 LEE'

1100 Rhode Island Lawrence, Kansas 785 - 749 - 5806 FAX 785 - 749 - 1515

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60" MIN. DIA.

WHEELCHAIR

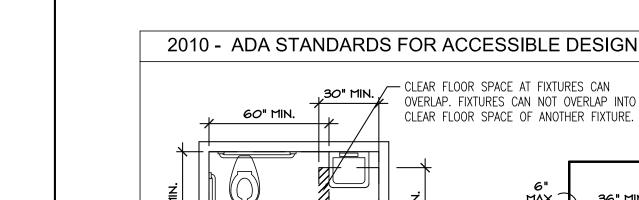TURNING RADIUS

TO HAVE 9" TOE

CLEARANCE AFF.

-30" X 48" WHEELCHAIR CLEAR FLOOR SPACE

- DOOR SWING CAN SWING

INTO REQUIRED TURN

SPACE BUT NOT CLEAR

FLOOR SPACE FOR FIXTURES.

-FLUSH VALVE SHALL

BE INSTALLED ON WIDE SIDE OF T/R OR STALL

BEARING WALL RATING: 3 HR. - NONBEARING WALL RATING: 3 HR.

CONCRETE MASONRY UNITS, MORTAR - UL DESIGN NO. U904


* Indicates such products shall bear the UL Certification Mark for jurisdictions employing the UL Certification.


- 1. Concrete Blocks* Various designs. Classification C-3 (3 hr.)
- 2. Mortar Blocks laid in full bed of mortar, nom. § in. thick, of not less than 2-1/4 and not more the 3-1/2 parts of clean sharp sand to 1 part Portland cement (proportioned by volume) and not
- 3. Portland Cement Stucco or Gypsum Plaster Add $\frac{1}{2}$ hr to Classification if used. Attached to concrete

more than 50 percent hydrated lime (by cement volume). Vertical joints staggered.


4. Loose Masonry Fill - If all core spaces are filled with loose dry expanded slag, expanded clay or shale (Rotary Kiln Process), water repellant vermiculite masonry fill insulation, or silicone treated perlite loose fill insulation add 1 hr to Classification.


STAIR/ELEV SHAFT WALL (1-HR REQUIRED)

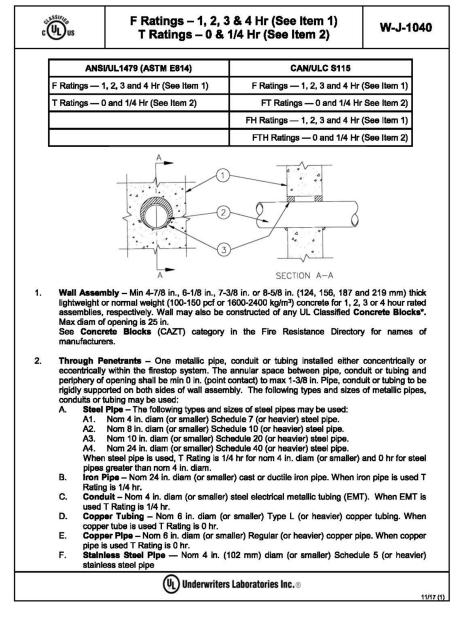


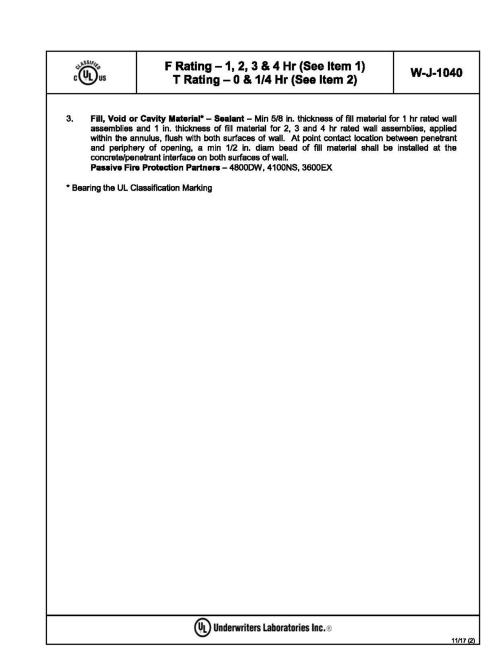

CMU PENETRATION

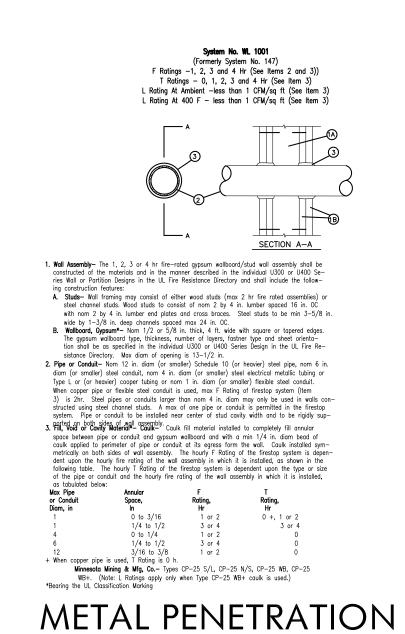

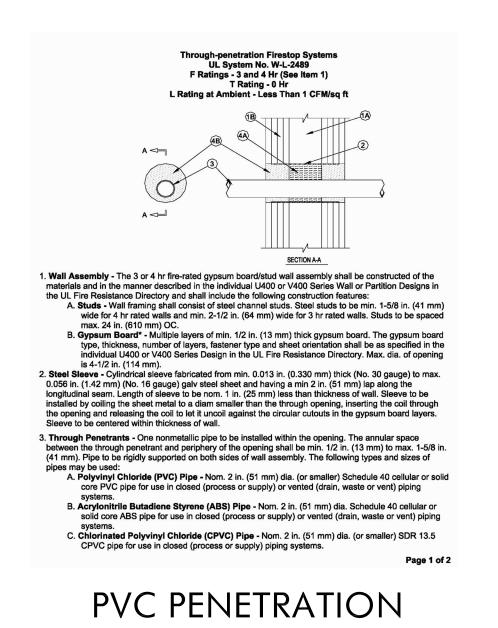

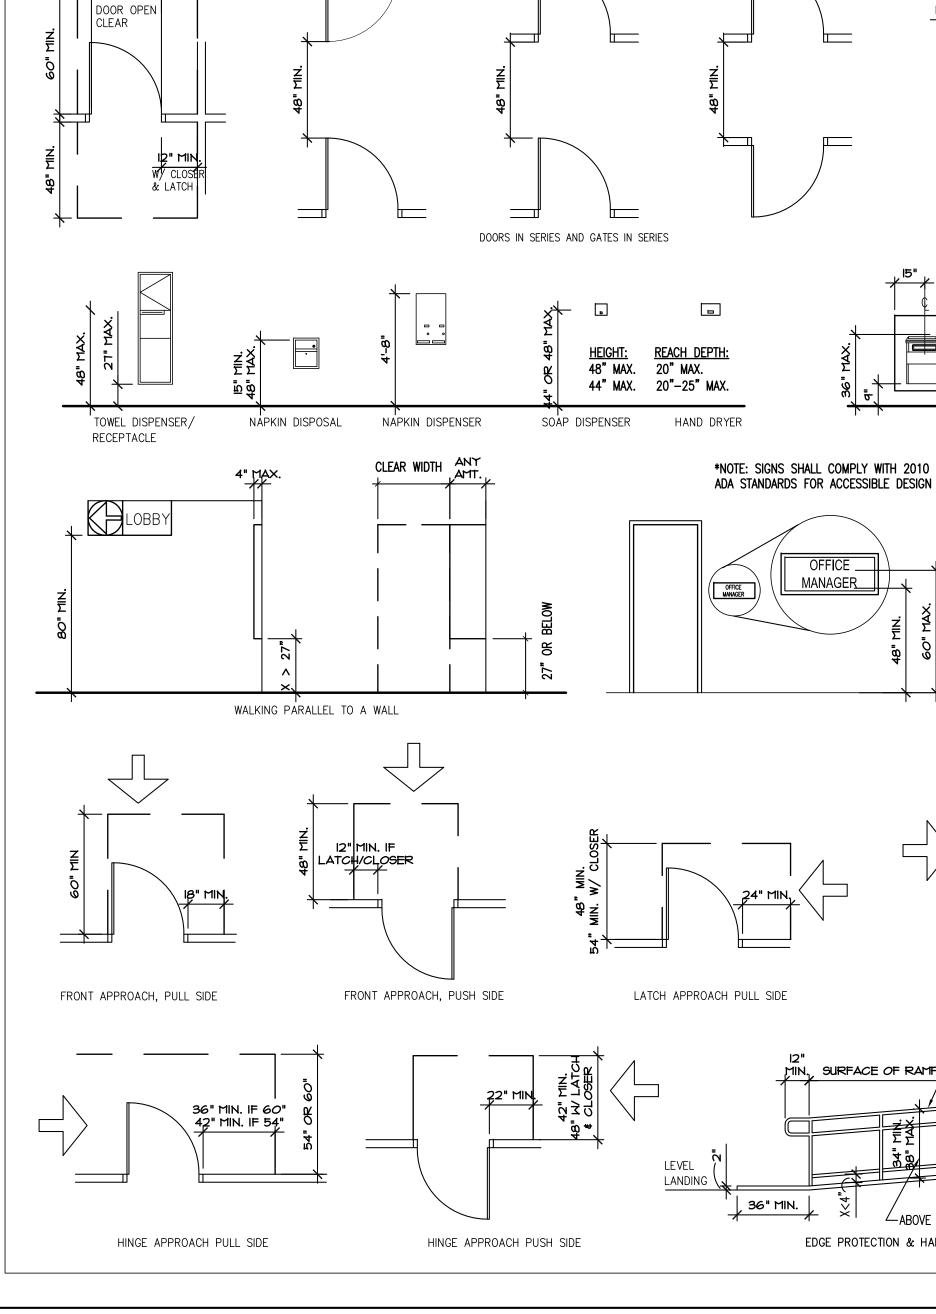

- FAUCETS SHALL BE OPERABLE W/ 1 HAND

AND SHALL NOT BE REQUIRE TIGHT GRASPING,

PINCHING, OR TWISTING OF THE WRIST. THE

FORCE REQUIRED TO ACTIVATE OPERABLE

- PROVIDE PIPE INSULATION

PARTS SHALL BE 5 POUNDS MAX.

TO HOT WATER & DRAIN LINES

- FLUSH VALVE SHALL

BE INSTALLED ON WIDE

SIDE OF T/R OR STALL

BE 7" MIN. & 9" MAX. IN FRONT

OF THE WATER CLOSET. MEASURE

KNEE CLEAR

CLEAR FLOOR SPACE AT LAVATORIES

39"-41"

TO THE CENTERLINE OF THE DISPENSER

— MAINTAIN 1

CLEARANCE AT

GRAB BARS

THE OUTLET OF THE DISPENSER SHALL BE 15"

OF A TYPE THAT CONTROLS DELIVERY OR THAT

DOES NOT ALLOW CONTINUOUS PAPER FLOW.

60" MIN.

T-SHAPED TURNING SPACE

(TO SPOUT)

ON TACTILE

LATCH APPROACH PUSH SIDE

SURFACE OF RAMP

EDGE PROTECTION & HANDRAIL EXTENSIONS

- CONTINUOUS HANDRAILS PROVIDED

' EDGE PROTECTION TO EXTEND TO END OF REQUIRED LANDING

ON BOTH SIDES OF RAMPS AT

SURFACES > 6" GROUND

LEVEL

LANDING


CHARACTERS

MIN. & 48" MAX. AFF. & SHALL NOT BE LOCATED BEHIND GRAB BARS. DISPENSERS SHALL NOT BE

ADA STANDARD DETAILS

FIRE RATED CONSTRUCTION DETAILS



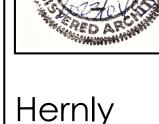


ASSOCIATES

1100 Rhode Island Lawrence, Kansas 785 - 749 - 5806 FAX 785 - 749 - 1515

1ST STORY PLAN

2022/11/08 Drawn by: SJB Checked by: **SCH**

2023/01/03

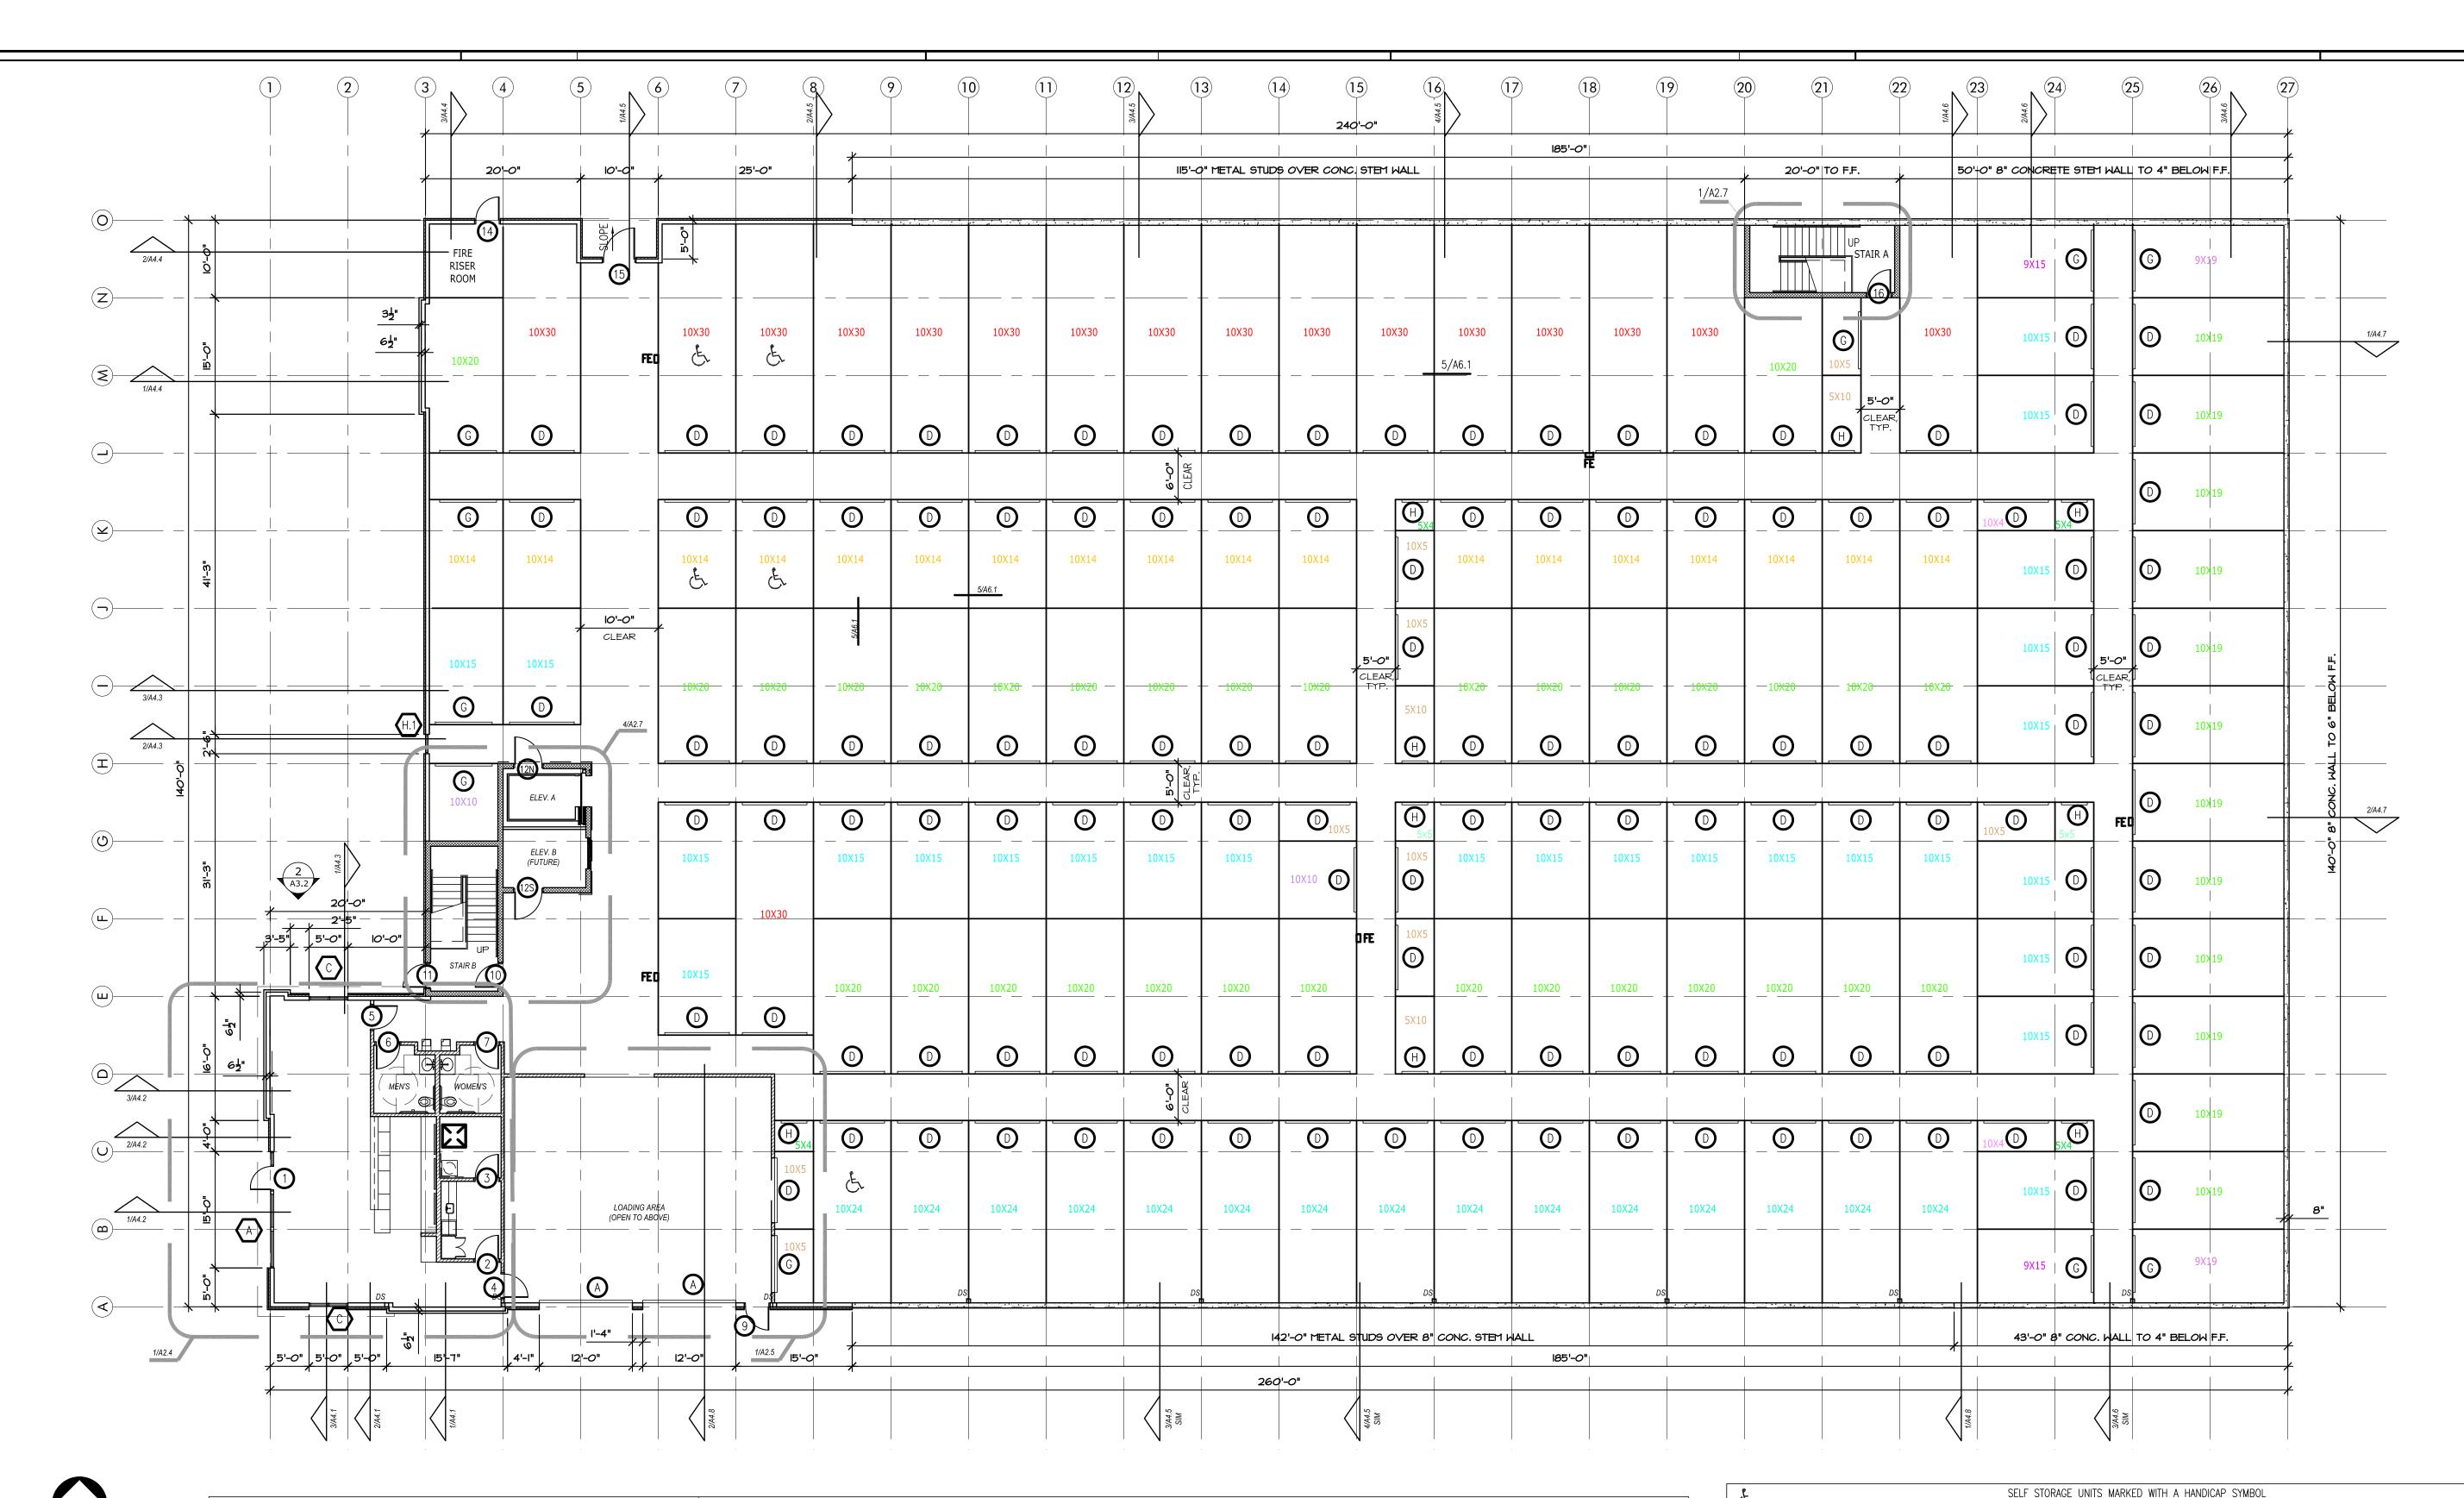

	FLOOR PLAN LEGEND		
PLAN NORTH		METAL PARTITION SYSTEM (CORRIDOR SIDE OF PARTITION EXCEPT WHERE NOTED OTHERWISE) HALLWAYS TO BE JANUS CORRUGATED METAL PARTITIONS TYPREFER DETAIL 5/A6.1	
		INSULATED METAL WALL PANEL -REF. ELEVATIONS SHEET FOR EXTENTS OF EXTERIOR FINISHES.	
		GYP. BD. ON METAL STUD FRAMING -REFER PARTITION TYPES, SHEET A6.1	
		1-HOUR FIRE-RATED WALL @ STAIRS, ELEVATOR, AND FIRE RISER ROOM	

8" CONCRETE STEM WALL

REFER TO DETAIL SHEET 4/A6.1

, INSULATED METAL PARTITION SYSTEM

GENERAL NOTES (TYPICAL ALL SHEETS)

. INTERIOR AND EXTERIOR STORAGE UNIT SIGNAGE TO BE APPROVED BY OWNER. SIGNAGE TO BE

PROVIDED AND INSTALLED BY GENERAL CONTRACTOR.

2. GENERAL CONTRACTOR TO COORDINATE ALL FOUNDATION PENETRATIONS WITH STRUCTURAL ENGINEER.

3. ROOF PANELS TO BE 60 MIL TPO ROOF TO MEET LOCAL WIND LOAD REQUIREMENTS ENGINEERED BY METAL BUILDING MANUFACTURER.

4. GENERAL CONTRACTOR/TPO ROOFING SUBCONTRACTOR TO SIZE/SPACE INTERNAL ROOF DRAINS AS REQUIRED TO MEET LOCAL REQUIREMENTS. SECONDARY ROOF DRAINS TO BE PROVIDED. GENERAL CONTRACTOR TO COORDINATE CONNECTION TO UNDERGROUND STORM DRAIN.

5. GENERAL CONTRACTOR IS TO SUBMIT ALL SAMPLES OF PRODUCTS, ETC. TO OWNER FOR APPROVAL/ SELECTION OF ALL COLORS, FINISHES, ETC. PRIOR TO PURCHASE AND INSTALLATION

. ALL EXTERIOR WALL DIMENSIONS ARE TO FOUNDATION (INCL. LUG) UNLESS NOTED OTHERWISE. 3RD FLOOR EXTERIOR WALL DIMENSIONS ARE TO FINISH MATERIAL. ALL INTERIOR DIMENSIONS ARE TO OUTER FACE OF MATERIAL USED UNLESS NOTED OTHERWISE.

7. NOT USED.

8. PROVIDE & INSTALL FIRE EXTINGUISHERS (FE) WALL CABINETS. RECESS CABINETS @ RECESSED, FLUSH WITH WALL AT ALL INTERIOR APPLICATIONS. MOUNT TO PIERS, 48" A.F.F. IN HEAVY DUTY OUTDOORS FIRE EXTINGUISHER CABINET AT ALL EXTERIOR LOCATE ONE CLASS 2-A FIRE EXTINGUISHER SO THAT MAX. TRAVEL DISTANCE IS 75 W/ A MINIMUM OF 1 FOR EVERY 11,250 S.F. PER TABLE 906.3(1) OF THE 2015 IN FIRE CODE OR AS DIRECTED BY LOCAL AUTHORITIES HAVING JURISDICTION. (KEYED ON FLOOR PLANS) FURR OUT WALL AT FE LOCATIONS W/ 6" METAL STUDS AND METAL WALL PANEL EACH SIDE.

9. FLOOR FINISH CONCRETE TO BE POLISHED CONCRETE IN CORRIDORS ONLY. (EXCLUDING STORAGE UNITS)

10. BUILDING MUST COMPLY W/ LOCAL AMERICAN W/ DISABILITIES ACT -REF. SHEET A2.6

11. FURR OUT WALL IN ELECTRICAL ROOMS TO RECESS ELECTRICAL PANEL.

12. ALL INTERIOR CMU TO BE PAINTED SW PRO CLASSIC B31 SERIES PAINT EXCLUDING INSIDE OF INDIVIDUAL STORAGE UNITS. ALL CMU INSIDE INDIVIDUAL STORAGE UNITS NOT TO BE PAINTED OR SEALED.

13. FIRE RISER ROOM TO HAVE 1—HR FIRE—RATED WALLS AND CEILING. REFER UL FIRE—RATED - ASSEMBLES, SHEET A1.3

14. GENERAL CONTRACTOR TO COORDINATE STANDPIPE/FIRE SPRINKLER DESIGN WITH ROOM SIZE AND

		TO BE ACCESSIBLE AND FOLLOW ACCESSIBILITY STANDARDS	
	TABLE 225.3		
@ 48" A.F.F.	TOTAL SPACES IN FACILITY	MINIMUM NUMBER OF SPACES REQUIRED TO BE ACCESSIBLE	
	1 TO 200	5%, BUT NOT LESS THAN 1	
R APPLICATIONS. '5 L.F.	201 AND OVER	10, PLUS 2% OF THE TOTAL NUMBER OF UNITS OVER 200	
INTERNATIONAL	SECTION 225.3.1 DISPERSION.		
ON FLOOD DLANC)			

INDIVIDUAL SELF-SERVICE STORAGE SPACES SHALL BE DISPERSED THROUGHOUT THE VARIOUS CLASSES OF SPACES PROVIDED. WHERE MORE CLASSES OF SPACES ARE PROVIDED THAN THE NUMBER REQUIRED TO BE ACCESSIBLE, THE NUMBER OF SPACES SHALL NOT BE REQUIRED TO EXCEED THAT REQUIRED BY TABLE 225.3. SELF-SERVICE STORAGE SPACES COMPLYING WITH TABLE 225.3 SHALL NOT BE REQUIRED TO BE DISPERSED AMONG BUILDINGS IN A MULTI-BUILDING FACILITY.

ACCESSIBLE UNITS MUST MEET THE FOLLOWING CRITERIA: 403.3 ACCESSIBLE ROUTE THE RUNNING SLOPE OF WALKING SURFACES NOT STEEPER THAN 1:20. THE CROSS SLOPE OF WALKING SURFACES SHALL NOT BE STEEPER THAN 1:48. 404.2.5 THRESHOLDS

/2" HIGH MAXIMUM 404.2.7 DOOR HARDWARE OPERABLE PARTS OF HARDWARE SHALL BE 34" MIN. AND 48" MAX. ABOVE FINISHED FLOOR OR GROUND 404.2.9 DOOR OPENING FORCE 5 POUNDS MAXIMUM ACCESSIBLE UNITS MUST ALSO PROVIDE ACCESSIBLE ROUTES TO ACCESSIBLE MEANS OF EGRESS, PARKING SPACES, AND COMMON USE ELEMENTS & FACILITIES

(TOILET ROOMS, DRINKING FOUNTAINS, ETC.). PROVIDE JANUS ADA KIT (THREE STRAPS AND ACCESSIBLE SIGN) -JANUS TO INSTALL

ADA CALCULATIONS: 590 UNITS

 $\frac{-200 \text{ UNITS}}{390 \text{ UNITS}}$ X .02 = 7.8 SPACES + 10 SPACES = 18 SPACES REQUIRED

FIRST STORY PLAN

3/32" = 1'-0"








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2ND STORY PLAN

2022/11/08

Drawn by: SJB Checked by : **SCH** Revisions: 2023/01/03

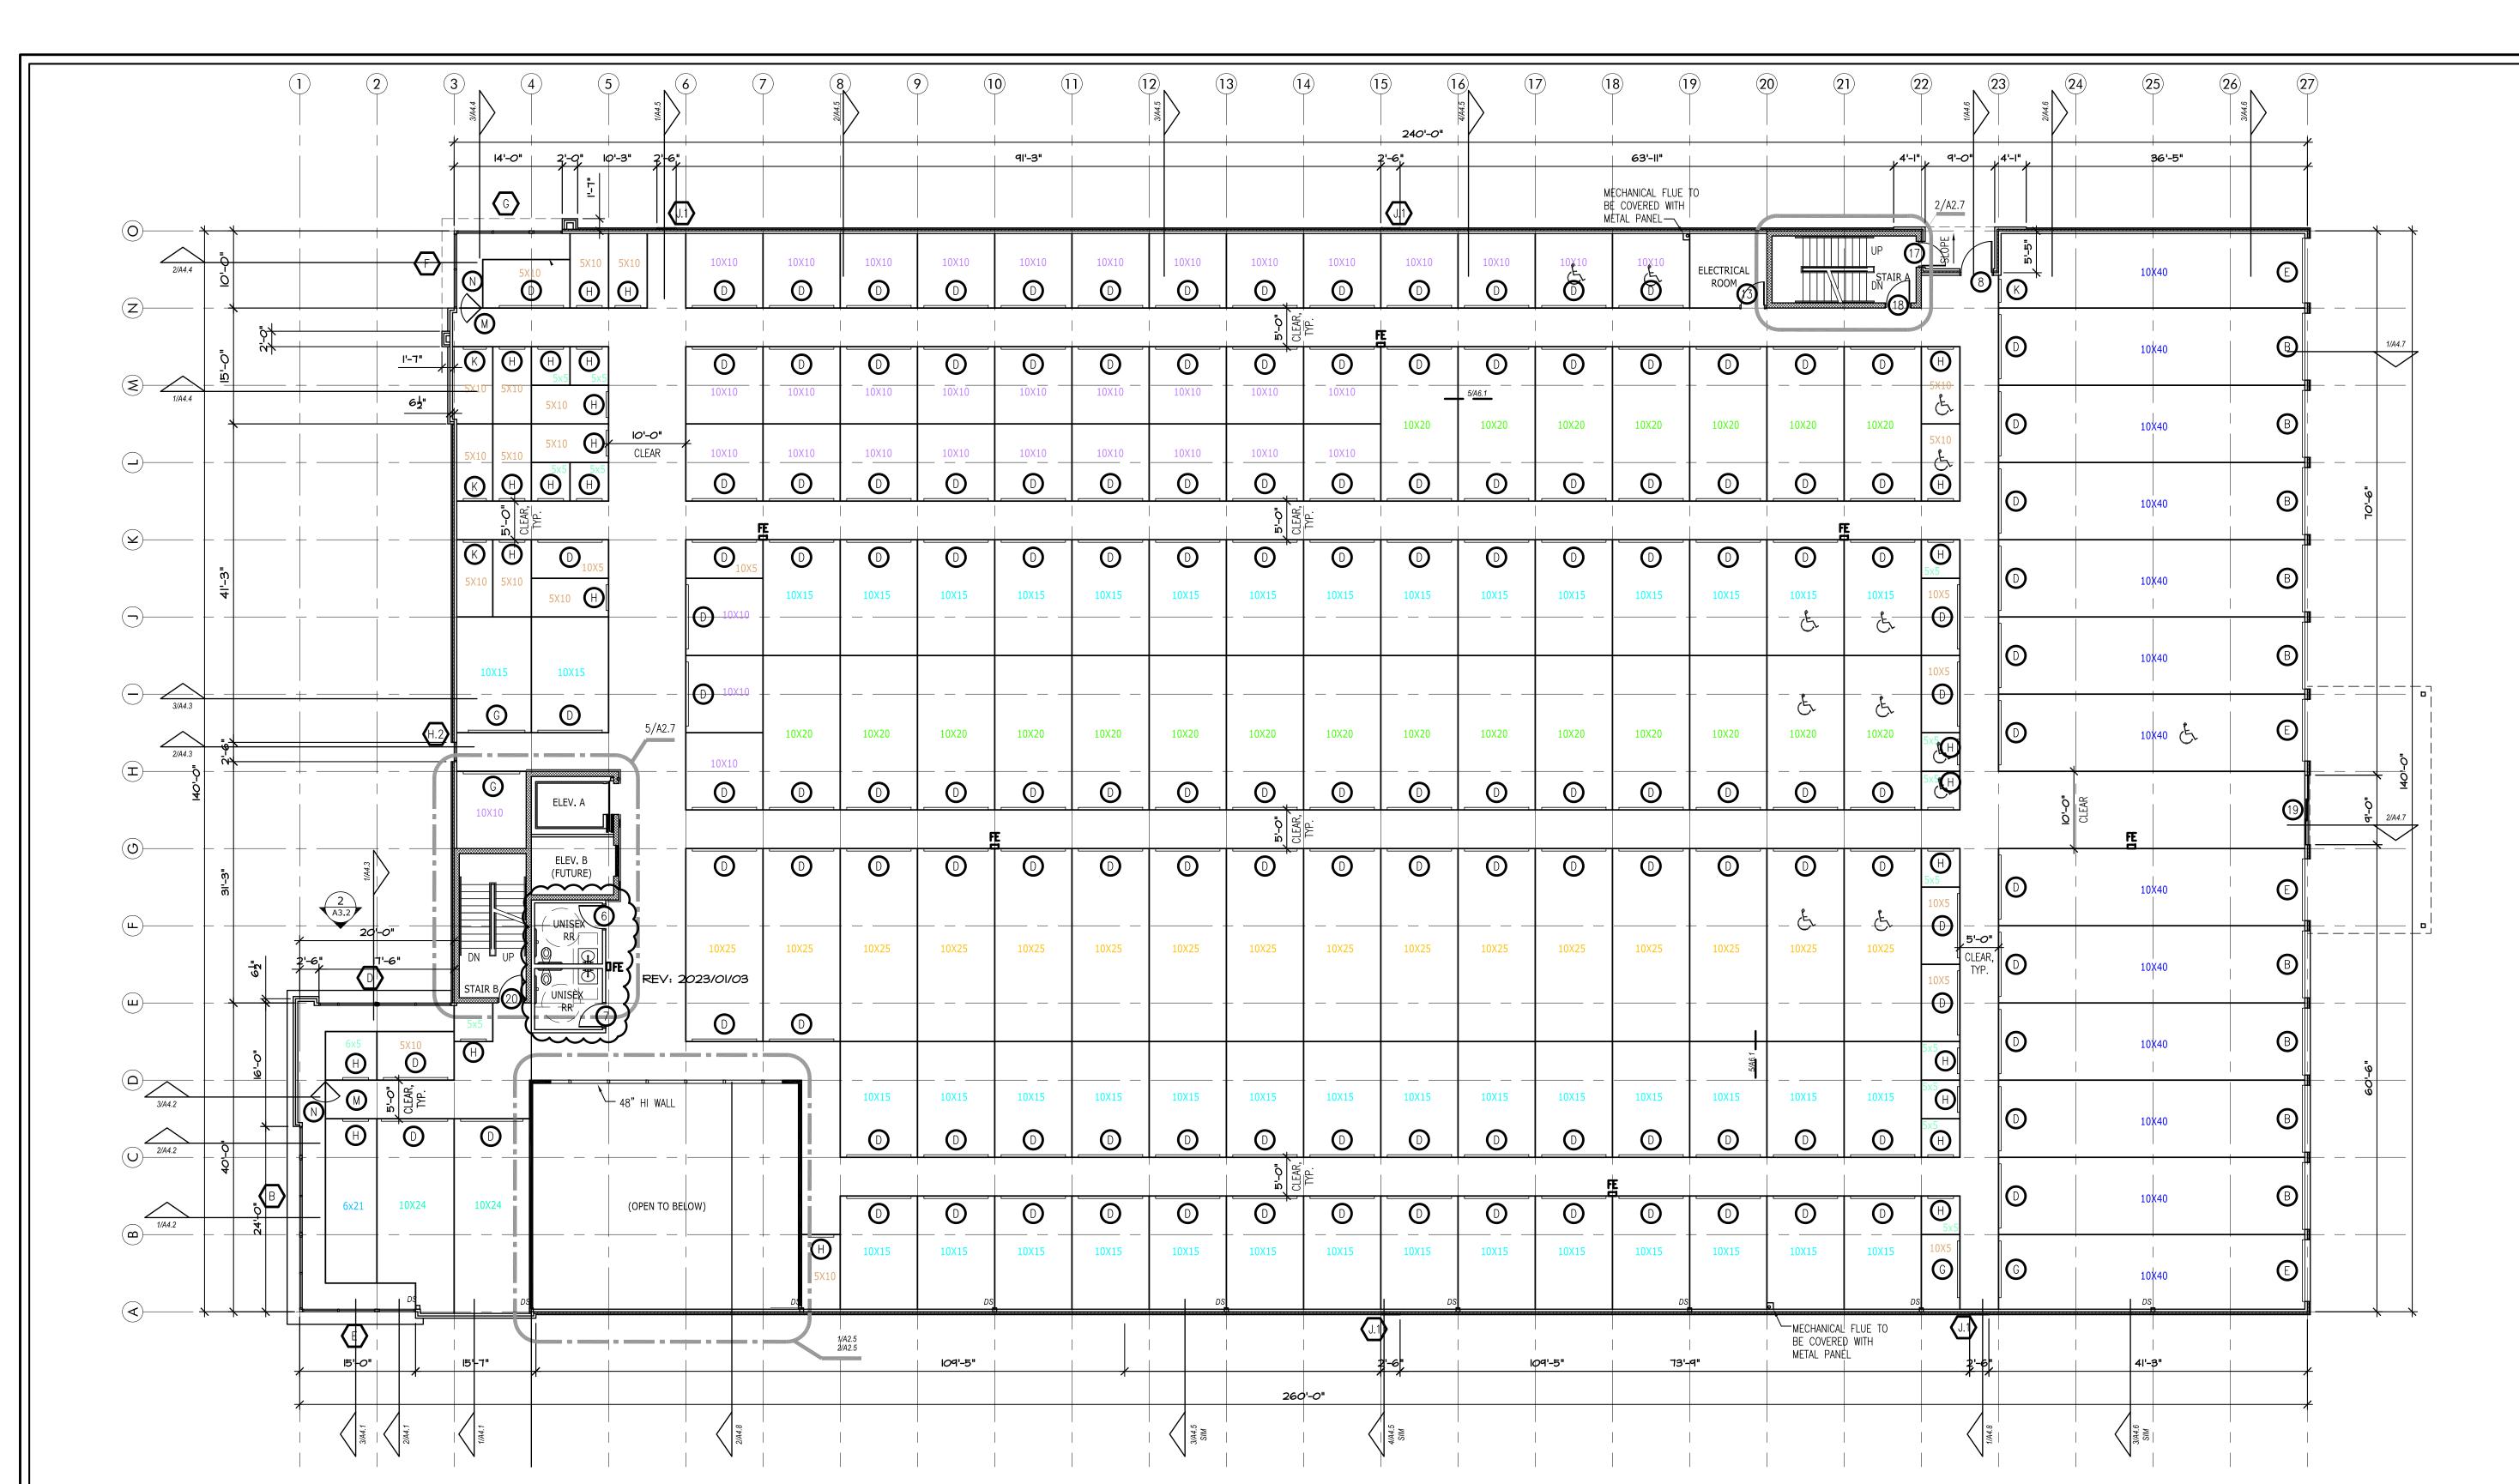

	METAL PARTITION SYSTEM (CORRIDOR SIDE OF PARTITION EXCEPT WHERE NOTED OTHERWISE) HALLWAYS TO BE JANUS CORRUGATED METAL PARTITIONS TYPREFER DETAIL 5/A6.1
	INSULATED METAL WALL PANEL -REF. ELEVATIONS SHEET FOR EXTENTS OF EXTERIOR FINISHES.
	GYP. BD. ON METAL STUD FRAMING -REFER PARTITION TYPES, SHEET A6.1
	1-HOUR FIRE-RATED WALL @ STAIRS, ELEVATOR, AND FIRE RISER ROOM
44.4.4.4.	8" CONCRETE STEM WALL
	INSULATED METAL PARTITION SYSTEM REFER TO DETAIL SHEET 4/A6.1

GENERAL NOTES (TYPICAL ALL SHEETS) 1. INTERIOR AND EXTERIOR STORAGE UNIT SIGNAGE TO BE APPROVED BY OWNER. SIGNAGE TO BE

PROVIDED AND INSTALLED BY GENERAL CONTRACTOR.

2. GENERAL CONTRACTOR TO COORDINATE ALL FOUNDATION PENETRATIONS WITH STRUCTURAL ENGINEER. 3. ROOF PANELS TO BE 60 MIL TPO ROOF TO MEET LOCAL WIND LOAD REQUIREMENTS ENGINEERED BY METAL BUILDING MANUFACTURER.

- 4. GENERAL CONTRACTOR/TPO ROOFING SUBCONTRACTOR TO SIZE/SPACE INTERNAL ROOF DRAINS AS REQUIRED TO MEET LOCAL REQUIREMENTS. SECONDARY ROOF DRAINS TO BE PROVIDED. GENERAL CONTRACTOR TO COORDINATE CONNECTION TO UNDERGROUND STORM DRAIN.
- 5. GENERAL CONTRACTOR IS TO SUBMIT ALL SAMPLES OF PRODUCTS, ETC. TO OWNER FOR APPROVAL/ SELECTION OF ALL COLORS, FINISHES, ETC. PRIOR TO PURCHASE AND INSTALLATION
- 6. ALL EXTERIOR WALL DIMENSIONS ARE TO FOUNDATION (INCL. LUG) UNLESS NOTED OTHERWISE. 3RD FLOOR EXTERIOR WALL DIMENSIONS ARE TO FINISH MATERIAL. ALL INTERIOR DIMENSIONS ARE TO OUTER FACE OF MATERIAL USED UNLESS NOTED OTHERWISE.
- 7. NOT USED.
- 8. PROVIDE & INSTALL FIRE EXTINGUISHERS (FE) WALL CABINETS. RECESS CABINETS @ 48" A.F.F.
- 9. FLOOR FINISH CONCRETE TO BE POLISHED CONCRETE IN CORRIDORS ONLY. (EXCLUDING STORAGE UNITS)
- 10. BUILDING MUST COMPLY W/ LOCAL AMERICAN W/ DISABILITIES ACT -REF. SHEET A2.6
- 12. ALL INTERIOR CMU TO BE PAINTED SW PRO CLASSIC B31 SERIES PAINT EXCLUDING INSIDE OF INDIVIDUAL STORAGE UNITS. ALL CMU INSIDE INDIVIDUAL STORAGE UNITS NOT TO BE

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1/ A MINIMUM OF 1 FOR EVERY 11,250 S.F. PER TABLE 906.3(1) OF THE 2015 INTERNATIONAL	
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URR OUT WALL AT FE LOCATIONS W/ 6" METAL STUDS AND METAL WALL PANEL EACH SIDE.	

11. FURR OUT WALL IN ELECTRICAL ROOMS TO RECESS ELECTRICAL PANEL.

PAINTED OR SEALED.

13. FIRE RISER ROOM TO HAVE 1—HR FIRE—RATED WALLS AND CEILING. REFER UL FIRE—RATED — ASSEMBLES, SHEET A1.3

14. GENERAL CONTRACTOR TO COORDINATE STANDPIPE/FIRE SPRINKLER DESIGN WITH ROOM SIZE AND

CONFIGURATION.

SECOND STORY PLAN 3/32'' = 1'-0''

FLOOR PLAN LEGEND

PLAN NORTH

 $\frac{-200 \text{ UNITS}}{390 \text{ UNITS}} \times .02 = 7.8 \text{ SPACES} + 10 \text{ SPACES} = 18 \text{ SPACES} \text{ REQUIRED}$

ADA CALCULATIONS: 590 UNITS

5

1 TO 200

201 AND OVER

TOTAL SPACES IN FACILITY

SECTION 225.3.1 DISPERSION.

403.3 ACCESSIBLE ROUTE

404.2.5 THRESHOLDS

404.2.7 DOOR HARDWARE

404.2.9 DOOR OPENING FORCE

(TOILET ROOMS, DRINKING FOUNTAINS, ETC.).

ACCESSIBLE UNITS MUST MEET THE FOLLOWING CRITERIA:

PROVIDE JANUS ADA KIT (THREE STRAPS AND ACCESSIBLE SIGN) -JANUS TO INSTALL

SELF STORAGE UNITS MARKED WITH A HANDICAP SYMBOL

TO BE ACCESSIBLE AND FOLLOW ACCESSIBILITY STANDARDS

MINIMUM NUMBER OF SPACES REQUIRED TO BE ACCESSIBLE

10, PLUS 2% OF THE TOTAL NUMBER OF UNITS OVER 200

WALKING SURFACES SHALL NOT BE STEEPER THAN 1:48.

THE RUNNING SLOPE OF WALKING SURFACES NOT STEEPER THAN 1:20. THE CROSS SLOPE OF

OPERABLE PARTS OF HARDWARE SHALL BE 34" MIN. AND 48" MAX. ABOVE FINISHED FLOOR OR GROUND


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ACCESSIBLE UNITS MUST ALSO PROVIDE ACCESSIBLE ROUTES TO ACCESSIBLE MEANS OF EGRESS, PARKING SPACES, AND COMMON USE ELEMENTS & FACILITIES

5%, BUT NOT LESS THAN 1

5 POUNDS MAXIMUM



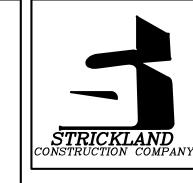

ASSOCIATES

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3RD STORY PLAN

2022/11/08 Drawn by: SJB Checked by: **SCH** Revisions: 2023/01/03

26'-7" 91'-3" 73'-9" 41'-3" **(D** $|\overline{\mathbb{Q}}|$ 10X10 10X10 $|\mathbb{C}| \oplus |$ **D D (** (D) **D D**10 LADDER -REF. IA/AI.3 10X10 5x5 (H) **D (D** (U) 2/A4.2 **D** 10X15 10X15 10X15 10X15 10X15 10X15 10X15 ['] ו5'–ד" 260'-0"



	METAL PARTITION SYSTEM (CORRIDOR SIDE OF PARTITION EXCEPT WHERE NOTED OTHERWISE) HALLWAYS TO BE JANUS CORRUGATED METAL PARTITIONS TYPREFER DETAIL 5/A6.1
	INSULATED METAL WALL PANEL -REF. ELEVATIONS SHEET FOR EXTENTS OF EXTERIOR FINISHES.
	GYP. BD. ON METAL STUD FRAMING -REFER PARTITION TYPES, SHEET A6.1
	1-HOUR FIRE-RATED WALL @ STAIRS, ELEVATOR, AND FIRE RISER ROOM
44.4.4.	8" CONCRETE STEM WALL
-	INSULATED METAL PARTITION SYSTEM REFER TO DETAIL SHEET 4/A6.1

FLOOR PLAN LEGEND

GENERAL NOTES (TYPICAL ALL SHEETS)

OUTER FACE OF MATERIAL USED UNLESS NOTED OTHERWISE.

- 1. INTERIOR AND EXTERIOR STORAGE UNIT SIGNAGE TO BE APPROVED BY OWNER. SIGNAGE TO BE PROVIDED AND INSTALLED BY GENERAL CONTRACTOR.
- 2. GENERAL CONTRACTOR TO COORDINATE ALL FOUNDATION PENETRATIONS WITH STRUCTURAL ENGINEER.
- 3. ROOF PANELS TO BE 60 MIL TPO ROOF TO MEET LOCAL WIND LOAD REQUIREMENTS ENGINEERED BY METAL BUILDING MANUFACTURER.
- 4. GENERAL CONTRACTOR/TPO ROOFING SUBCONTRACTOR TO SIZE/SPACE INTERNAL ROOF DRAINS AS REQUIRED TO MEET LOCAL REQUIREMENTS. SECONDARY ROOF DRAINS TO BE PROVIDED. GENERAL CONTRACTOR TO COORDINATE CONNECTION TO UNDERGROUND STORM DRAIN.
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- 6. ALL EXTERIOR WALL DIMENSIONS ARE TO FOUNDATION (INCL. LUG) UNLESS NOTED OTHERWISE. 3RD FLOOR EXTERIOR WALL DIMENSIONS ARE TO FINISH MATERIAL. ALL INTERIOR DIMENSIONS ARE TO
- 7. NOT USED.

- 8. PROVIDE & INSTALL FIRE EXTINGUISHERS (FE) WALL CABINETS. RECESS CABINETS @ 48" A.F.F. RECESSED, FLUSH WITH WALL AT ALL INTERIOR APPLICATIONS. MOUNT TO PIERS, 48" A.F.F. IN HEAVY DUTY OUTDOORS FIRE EXTINGUISHER CABINET AT ALL EXTERIOR APPLICATIONS. LOCATE ONE CLASS 2-A FIRE EXTINGUISHER SO THAT MAX. TRAVEL DISTANCE IS 75 L.F.
- W/ A MINIMUM OF 1 FOR EVERY 11,250 S.F. PER TABLE 906.3(1) OF THE 2015 INTERNATIONAL FIRE CODE OR AS DIRECTED BY LOCAL AUTHORITIES HAVING JURISDICTION. (KEYED ON FLOOR PLANS) FURR OUT WALL AT FE LOCATIONS W/ 6" METAL STUDS AND METAL WALL PANEL EACH SIDE.
- 9. FLOOR FINISH CONCRETE TO BE POLISHED CONCRETE IN CORRIDORS ONLY.
- 10. BUILDING MUST COMPLY W/ LOCAL AMERICAN W/ DISABILITIES ACT -REF. SHEET A2.6
- 12. ALL INTERIOR CMU TO BE PAINTED SW PRO CLASSIC B31 SERIES PAINT EXCLUDING INSIDE OF INDIVIDUAL STORAGE UNITS. ALL CMU INSIDE INDIVIDUAL STORAGE UNITS NOT TO BE
- 13. FIRE RISER ROOM TO HAVE 1—HR FIRE—RATED WALLS AND CEILING. REFER UL FIRE—RATED
- 14. GENERAL CONTRACTOR TO COORDINATE STANDPIPE/FIRE SPRINKLER DESIGN WITH ROOM SIZE AND
- (EXCLUDING STORAGE UNITS) 11. FURR OUT WALL IN ELECTRICAL ROOMS TO RECESS ELECTRICAL PANEL.

ADA CALCULATIONS:


590 UNITS


 $\frac{-200 \text{ UNITS}}{390 \text{ UNITS}}$ X .02 = 7.8 SPACES + 10 SPACES = 18 SPACES REQUIRED

- PAINTED OR SEALED.
- ASSEMBLES, SHEET A1.3

(5.	TO BE ACCESSIBLE AND FOLLOW ACCESSIBILITY STANDARDS			
TABLE 225.3				
TOTAL SPACES IN FACILITY	MINIMUM NUMBER OF SPACES REQUIRED TO BE ACCESSIBLE			
1 TO 200	5%, BUT NOT LESS THAN 1			
201 AND OVER	10, PLUS 2% OF THE TOTAL NUMBER OF UNITS OVER 200			
SECTION 225.3.1 DISPERSION.	SECTION 225.3.1 DISPERSION.			
INDIVIDUAL SELF—SERVICE STORAGE SPACES SHALL BE DISPERSED THROUGHOUT THE VARIOUS CLASSES OF SPACES PROVIDED. WHERE MORE CLASSES OF SPACES ARE PROVIDED THAN THE NUMBER REQUIRED TO BE ACCESSIBLE, THE NUMBER OF SPACES SHALL NOT BE REQUIRED TO EXCEED THAT REQUIRED BY TABLE 225.3. SELF—SERVICE STORAGE SPACES COMPLYING WITH TABLE 225.3 SHALL NOT BE REQUIRED TO BE DISPERSED AMONG BUILDINGS IN A MULTI—BUILDING FACILITY.				
ACCESSIBLE UNITS MUST MEET THE FOLLOWING CRITERIA:				
403.3 ACCESSIBLE ROUTE	THE RUNNING SLOPE OF WALKING SURFACES NOT STEEPER THAN 1:20. THE CROSS SLOPE OF WALKING SURFACES SHALL NOT BE STEEPER THAN 1:48.			
404.2.5 THRESHOLDS	1/2" HIGH MAXIMUM			
404.2.7 DOOR HARDWARE	OPERABLE PARTS OF HARDWARE SHALL BE 34" MIN. AND 48" MAX. ABOVE FINISHED FLOOR OR GROUND			
404.2.9 DOOR OPENING FORCE	5 POUNDS MAXIMUM			
ACCESSIBLE UNITS MUST ALSO PROVIDE ACCESSIBLE ROUT (TOILET ROOMS, DRINKING FOUNTAINS, ETC.).	ES TO ACCESSIBLE MEANS OF EGRESS, PARKING SPACES, AND COMMON USE ELEMENTS & FACILITIES			
PROVIDE JANUS ADA KIT (THREE STRAPS AND ACCESSIBLE SIGN) -JANUS TO INSTALL				

SELF STORAGE UNITS MARKED WITH A HANDICAP SYMBOL

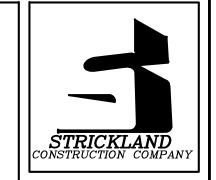

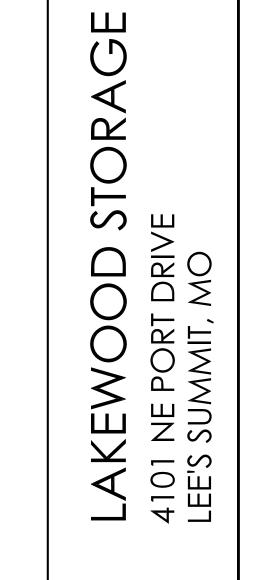





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PLAN DETAILS


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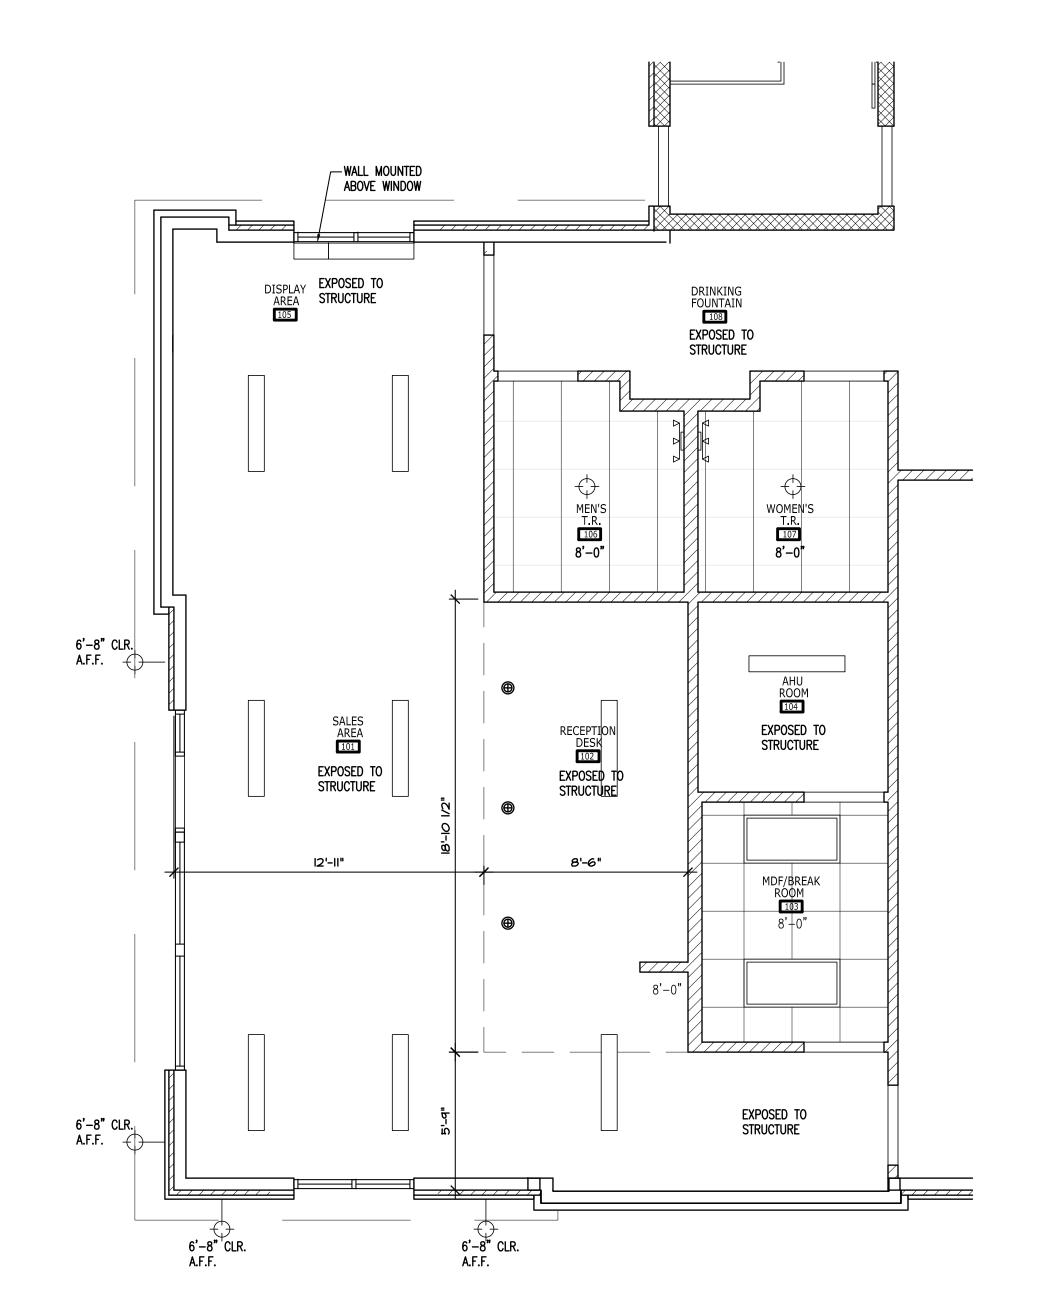
Revisions: 2023/01/03

A2.4





ENLARGED	FLOOR PLAN LEGEND	
	METAL PARTITION SYSTEM (CORRIDOR SIDE OF PARTITION EXCEPT WHERE NOTED OTHERWISE) HALLWAYS TO BE JANUS CORRUGATED METAL PARTITIONS TYPREFER CORRUGATED HALLWAY SYSTEM A6.1	
	METAL STUD WALL FRAMING	
	INTERIOR METAL STUD WALL FRAMING -REFER PARTITION TYPES SHEET A6.1	
	4" STRIPES PAINTED ON PAVING @ 2'-0" O.C. COLOR: SAFETY YELLOW	
GENERAL N	IOTES	
1. REFERENCE SHEET A6.1 FOR PARTITION TYPES (P-#)		
2. BUILDING MUST COMPLY W/ LOCAL AMERICAN W/ DISABILITIES ACT -REF. SHEET A2.6		

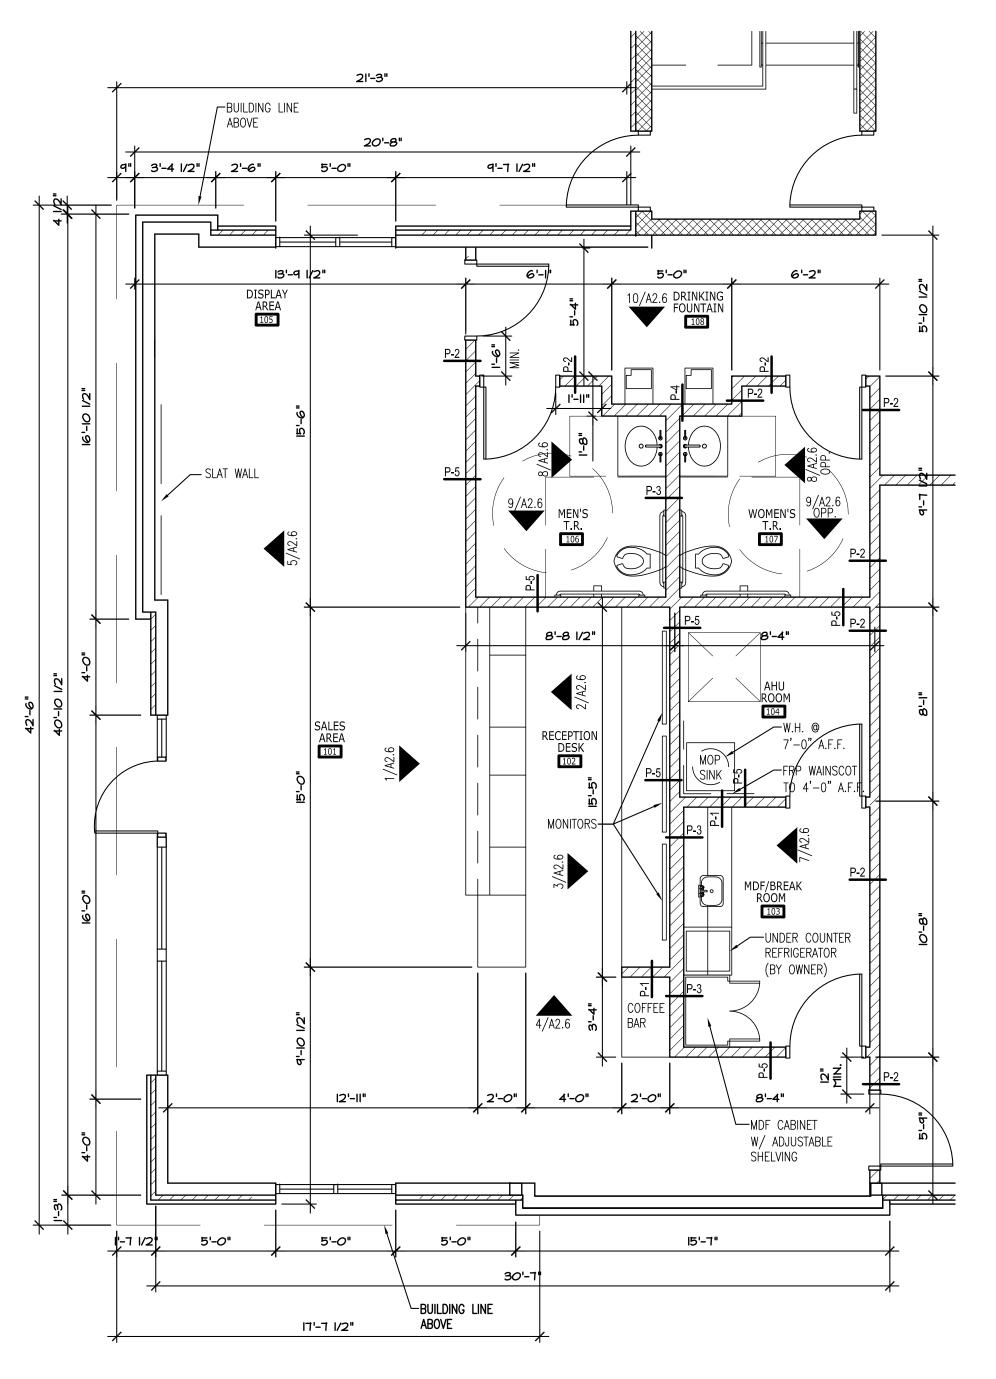




REFLECTE	SUSPENDED PAINTED GYP. BD. CEILING		EXTERIOR WALL SCONCE -WALL MOUNTED
	2' X 2' OPEN GRID CEILING	ΔΔΔ	VANITY LIGHT
	4' LED LIGHT	⊕	PENDANT LIGHT
	2' X 4' LED LIGHT -RECESSED	0	LARGE PENDANT LIGHT
\Diamond	RECESSED LIGHT		MEP DIFFUSER
NOTES: 1. REFER MEP FOR FIXTURE SPECIFICATIONS. 2. COORDINATE LIGHT FIXTURES AND MECHANICAL SUPPLY/RETURN PRIOR TO INSTALLATION. 3. PAINT UNDERSIDE OF FLOOR DECK, EXPOSED STRUCTURE AND DUCTS IN OFFICE WHERE VISIBLE. (CALL OUT PT COLOR ON A7.1)			





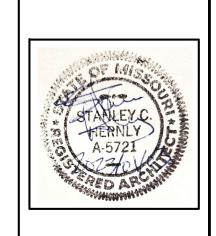


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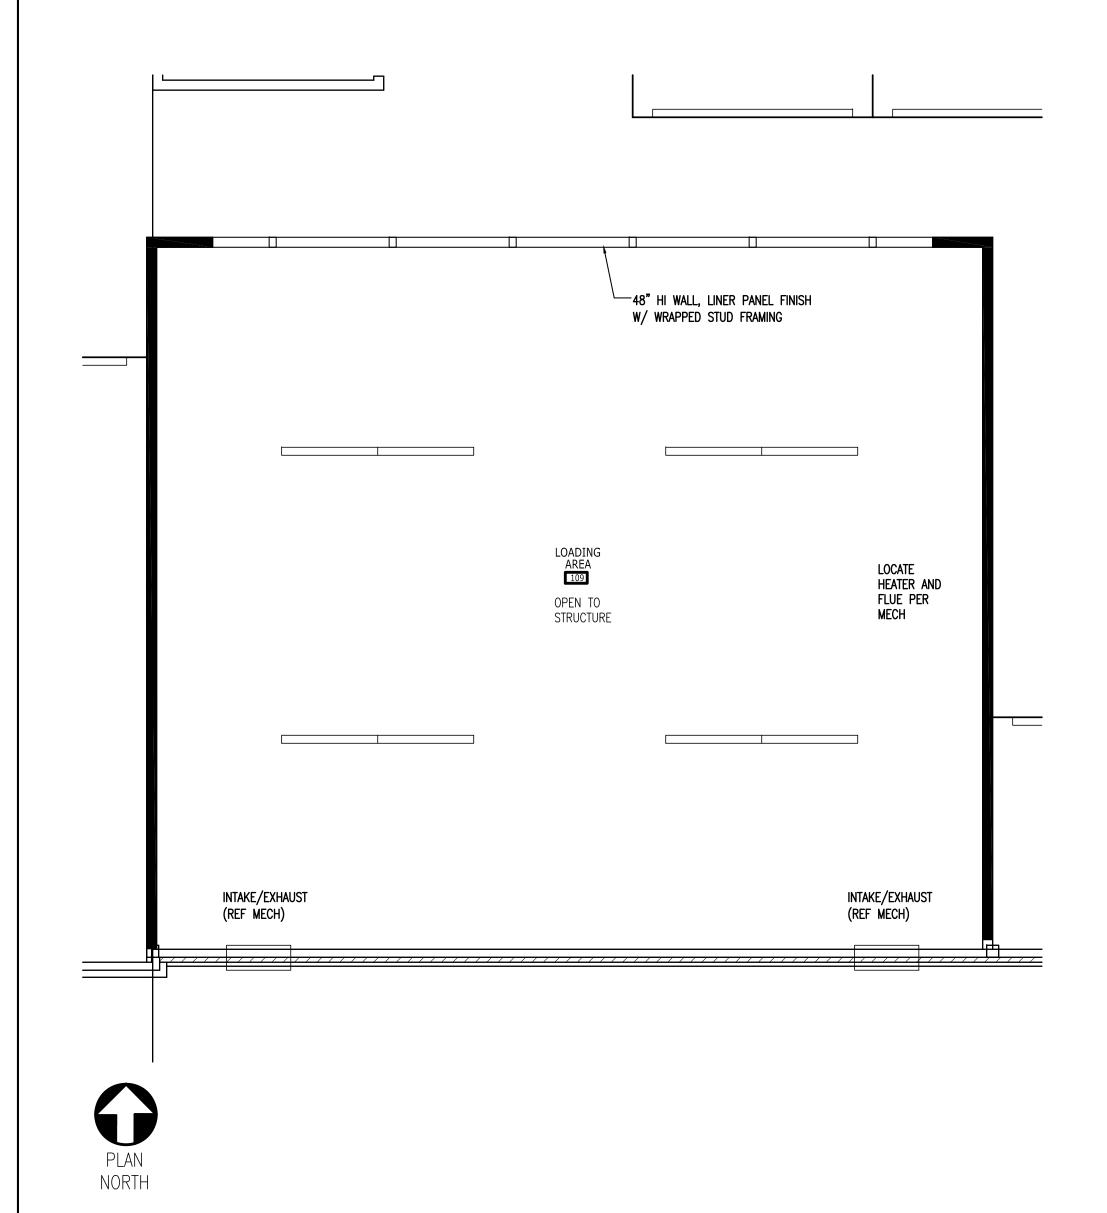
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PLAN DETAILS

Date: 2022/I
Drawn by: SJB
Checked by: SCH
Revisions: 2023/01/03



ENLARGED	FLOOR PLAN LEGEND	
	METAL PARTITION SYSTEM (CORRIDOR SIDE OF PARTITION EXCEPT WHERE NOTED OTHERWISE) HALLWAYS TO BE JANUS CORRUGATED METAL PARTITIONS TYPREFER CORRUGATED HALLWAY SYSTEM A6.1	
///////////////////////////////////////	METAL STUD WALL FRAMING	
	INTERIOR METAL STUD WALL FRAMING -REFER PARTITION TYPES SHEET A6.1	
	4" STRIPES PAINTED ON PAVING @ 2'-0" O.C. COLOR: SAFETY YELLOW	
GENERAL N	IOTES	
1. REFERENCE SHEET A6.1 FOR PARTITION TYPES (P-#)		
2. BUILDING MUST COMPLY W/ LOCAL AMERICAN W/ DISABILITIES ACT -REF. SHEET A2.6		

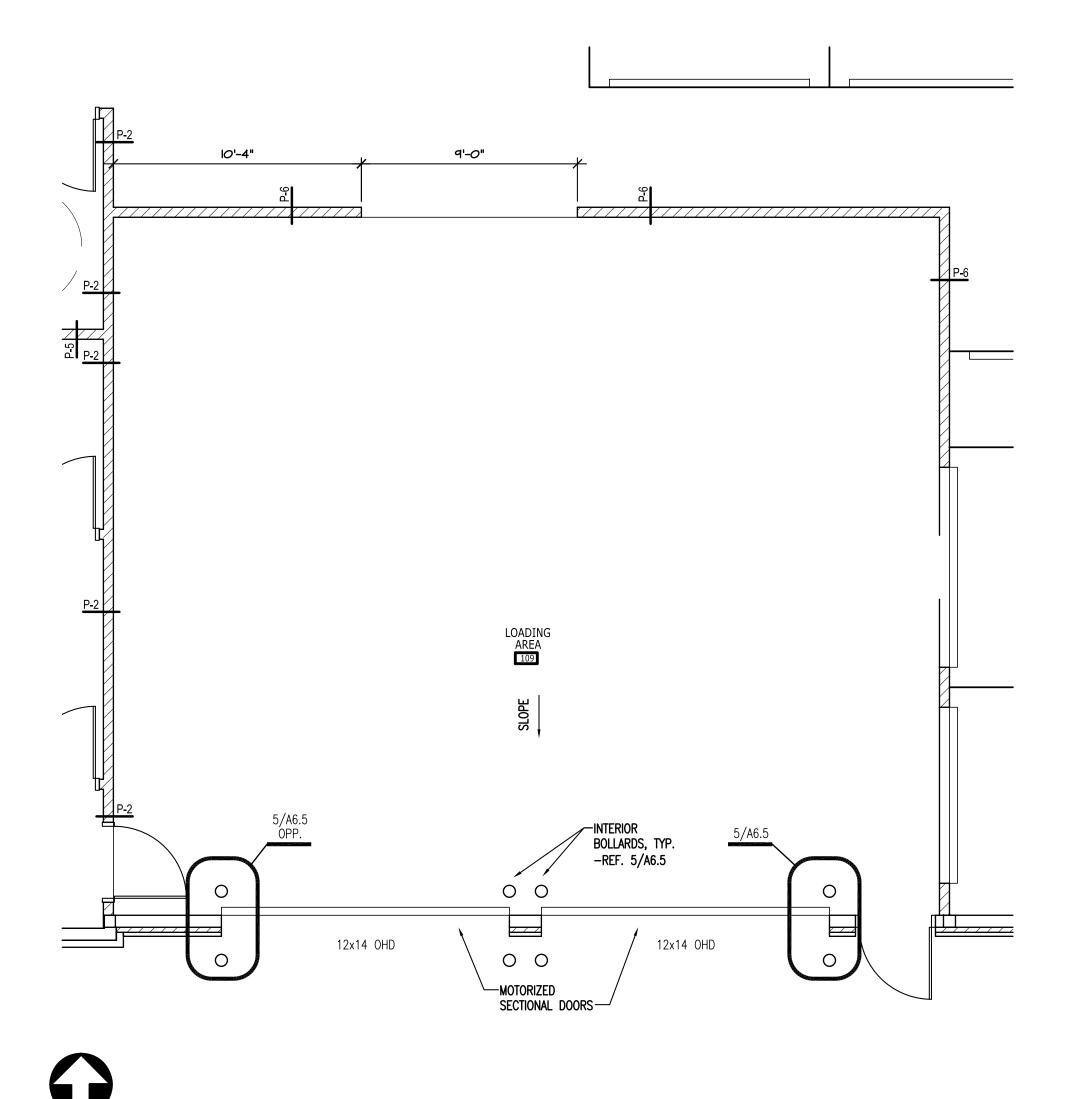

REFLECTED CEILING PLAN LEGEND				
	SUSPENDED PAINTED GYP. BD. CEILING		EXTERIOR WALL SCONCE —WALL MOUNTED	
	2' X 2' OPEN GRID CEILING	<u> </u>	VANITY LIGHT	
	4' LED LIGHT	@	PENDANT LIGHT	
	2' X 4' LED LIGHT -RECESSED	0	LARGE PENDANT LIGHT	
RECESSED LIGHT MEP DIFFUSER				
NOTES: 1. REFER MEP FOR FIXTURE SPECIFICATIONS. 2. COORDINATE LIGHT FIXTURES AND MECHANICAL SUPPLY/RETURN PRIOR TO INSTALLATION. 3. PAINT UNDERSIDE OF FLOOR DECK, EXPOSED STRUCTURE AND DUCTS IN OFFICE WHERE VISIBLE. (CALL OUT PT COLOR ON A7.1)				

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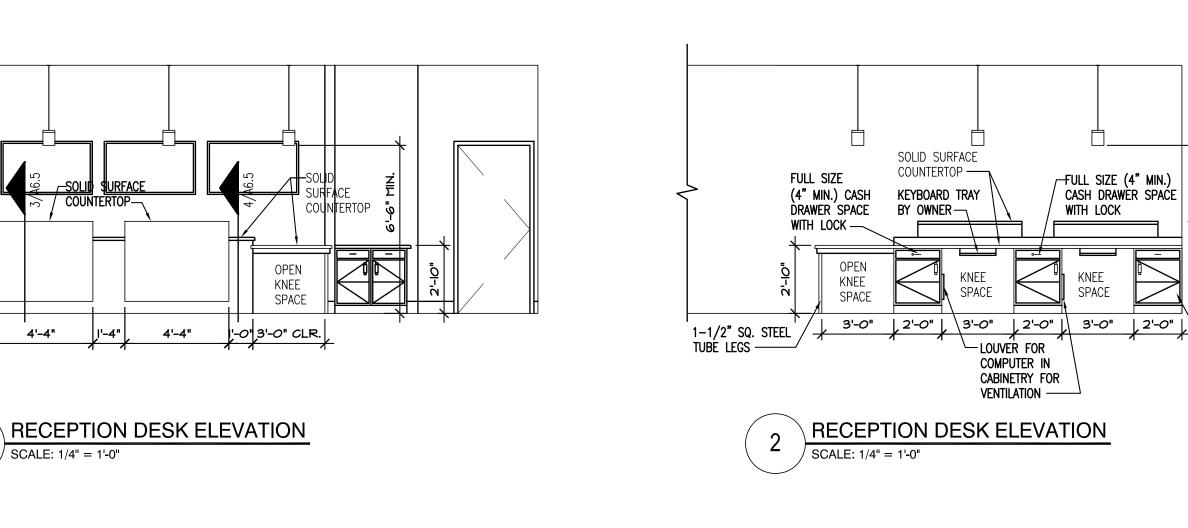
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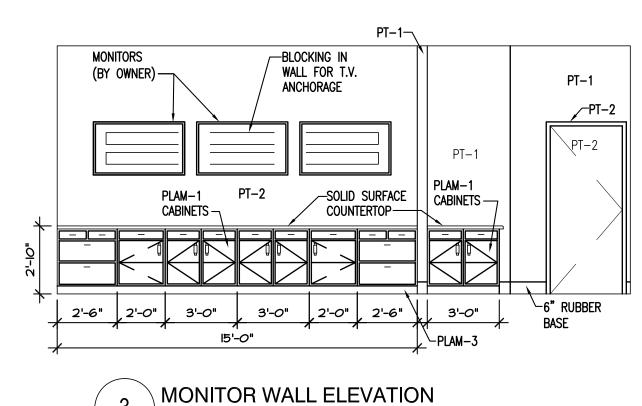
4101 LEE'S


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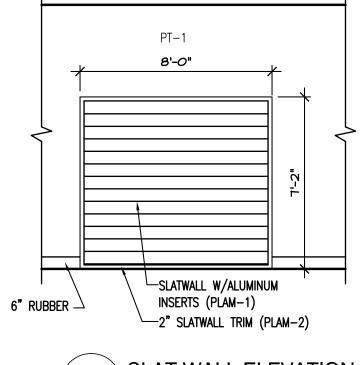
INTERIOR ELEVATIONS

2022/11/08 Drawn by: SJB Checked by: **SCH** Revisions : 2023/01/03







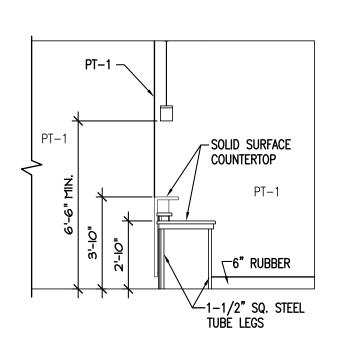

RECEPTION DESK ELEVATION SCALE: 1/4" = 1'-0"


SLAT WALL ELEVATION SCALE: 1/4" = 1'-0"

3'-4"


3'-6"



SCALE: 1/4" = 1'-0"

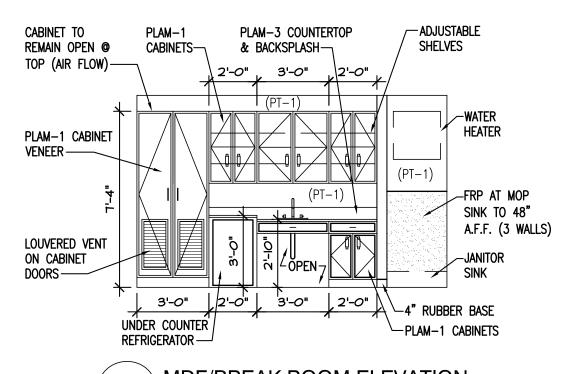

\ MDF/BREAK ROOM ELEVATION SCALE: 1/4" = 1'-0"

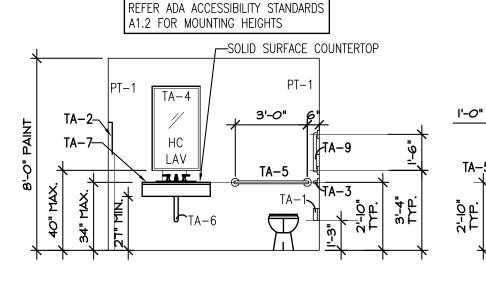

TOILET ROOM ELEVATION

SCALE: 1/4" = 1'-0"

TOILET ROOM ELEVATION SCALE: 1/4" = 1'-0"

HEIGHT

19" CL

48" MAX.

34" CL

40"

34" CL

N/A

48" MAX.

44" MAX.

40" CL

TOILET ACCESSORIES

TA-1 TOILET TISSUE DISPENSER

TA-3 42" HORIZONTAL GRAB BAR

TA-5 36" HORIZONTAL GRAB BAR

TA-6 | LAVATORY PIPING INSULATION

TA-7 | FEMININE NAPKIN DISPOSAL

TA-9 18" VERTICAL GRAB BAR

1. FOR CONTROLS OR REACH, HEIGHT IS MAX.

2. FOR MIRRORS, HEIGHT IS TO BOTTOM OF REFLECTIVE EDGE.

5. BLOCKING FOR ACCESSORIES BY GENERAL CONTRACTOR

6. SOAP DISPENSER TO BE INSTALLED OVER COUNTERTOP

3. FOR GRAB BARS, HEIGHT IS TO CENTER OF HORIZONTAL BAR.

4. ALL DESIGN MUST COMPLY W/ LOCAL AMERICAN'S W/DISABILITIES ACT

TA-8 | SOAP DISPENSER


- REF. SHEET A2.6

MARK ITEM

TA-4 MIRROR

NOTES


TA-2 HAND DRYERS

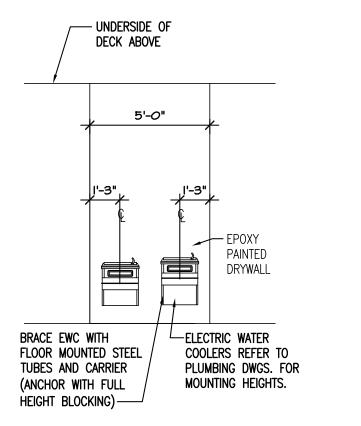


DRINKING FOUNTAIN ELEVATION SCALE: 1/4" = 1'-0"

INTERIOR ELEVATIONS

1/4" = 1'-0"

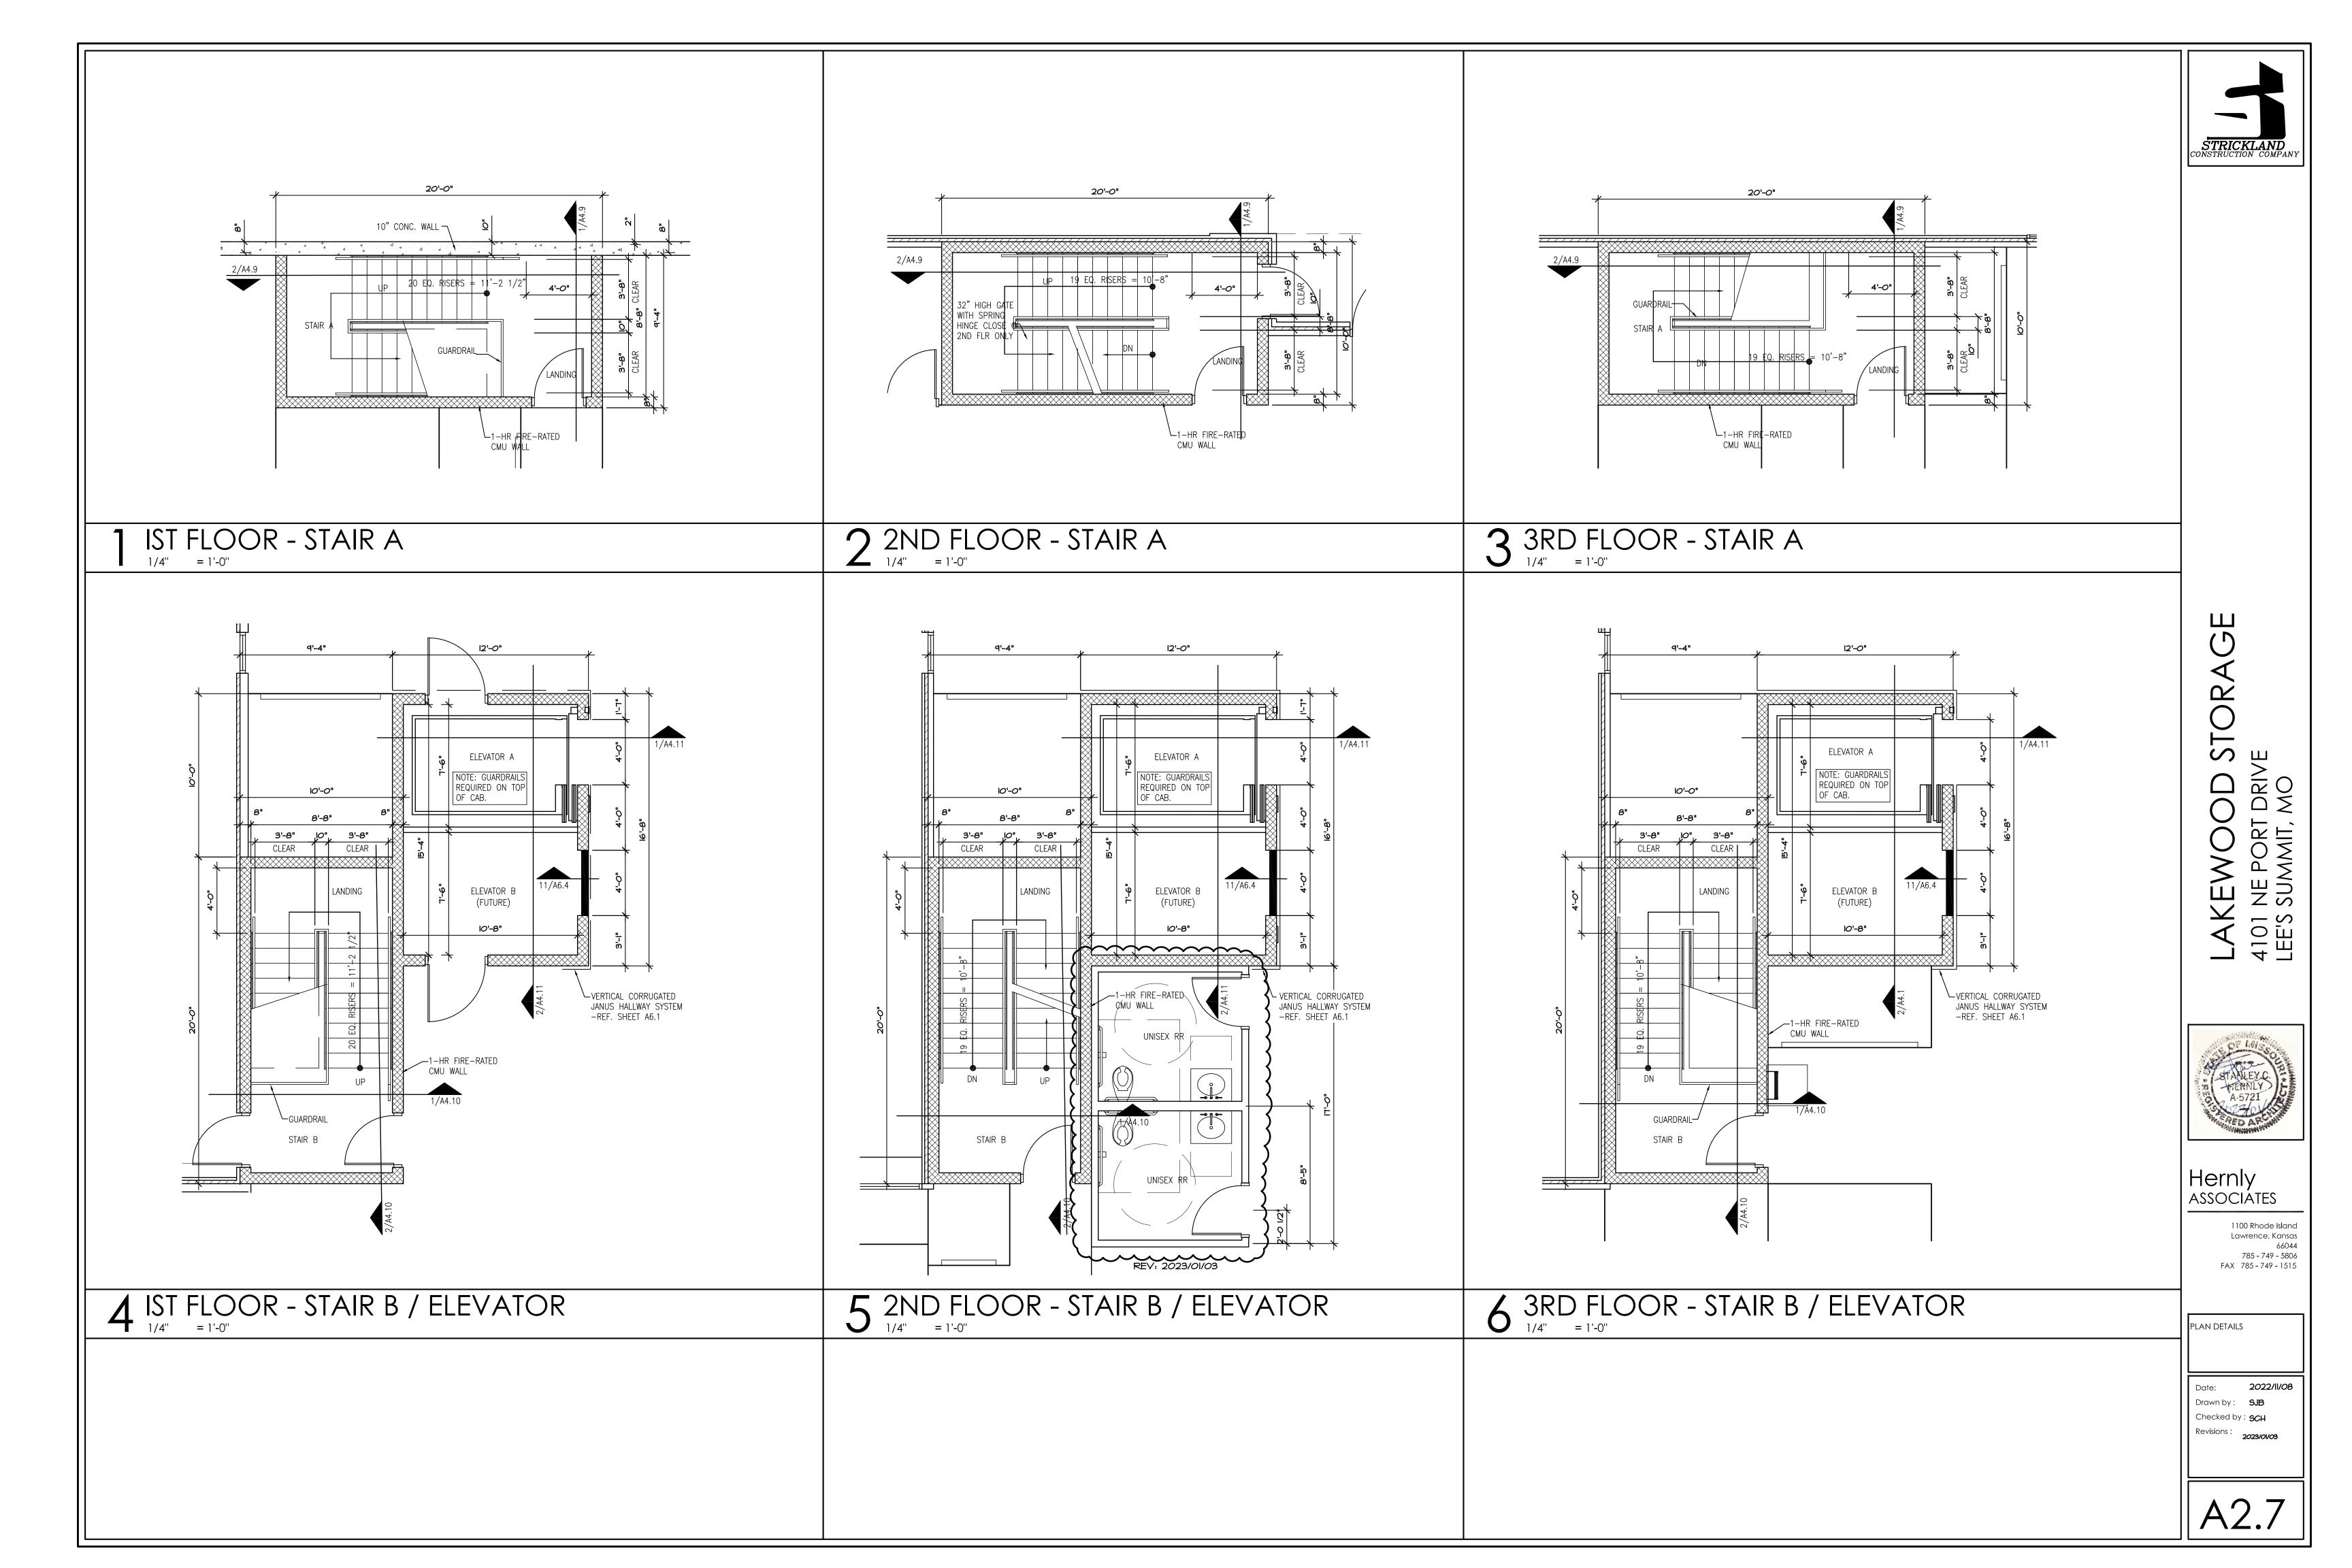

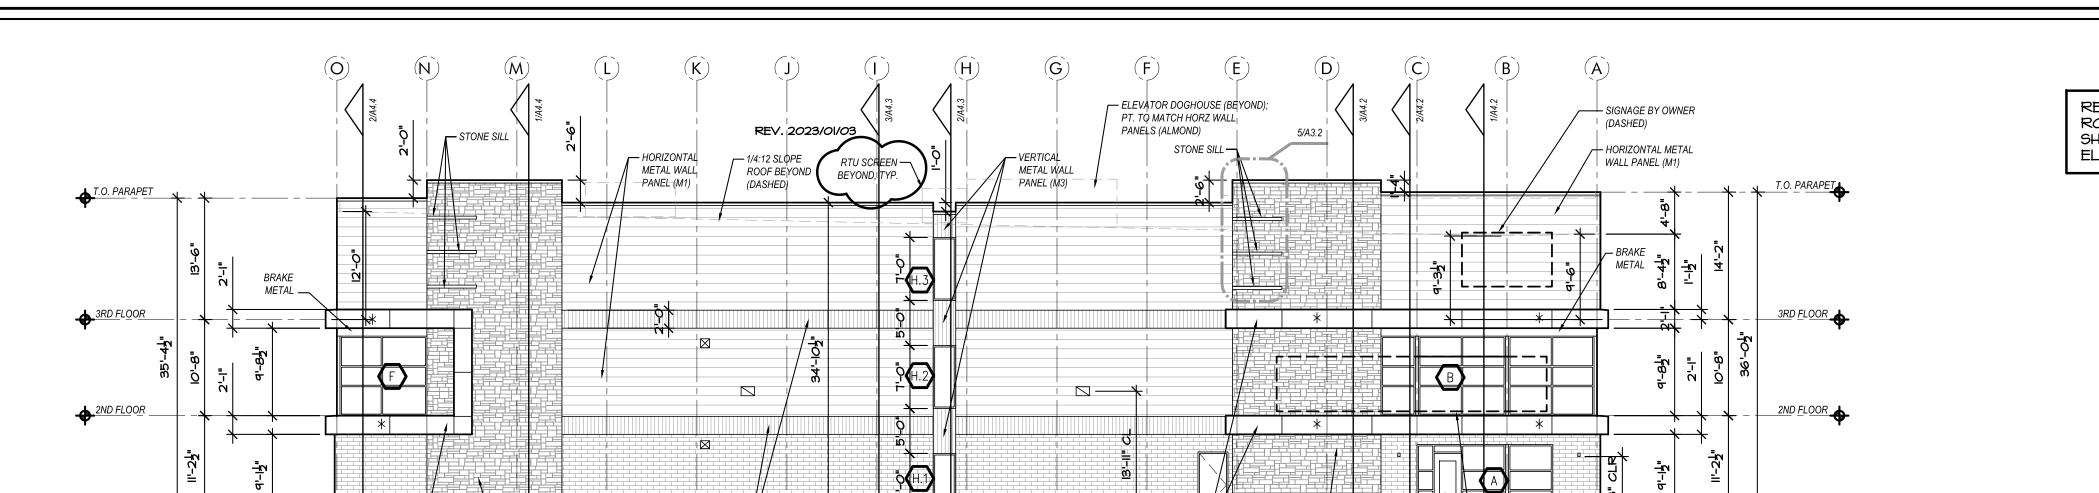

ACM —

CULTURED STONE VENEER

OFFICE ENTRY —

PANEL

∟ | |BRICK

RAINSCREEN

WALL PANEL

VERTICAL METAL

BAND (M2)

REV. 2023/01/03 ROOFTOP UNIT SCREENS SHOWN ON BUILDING ELEVATIONS




WEST ELEVATION 3/32" = 1'-0"

1ST FLOOR

ACM J

└─ CULTURED

STONE VENEER

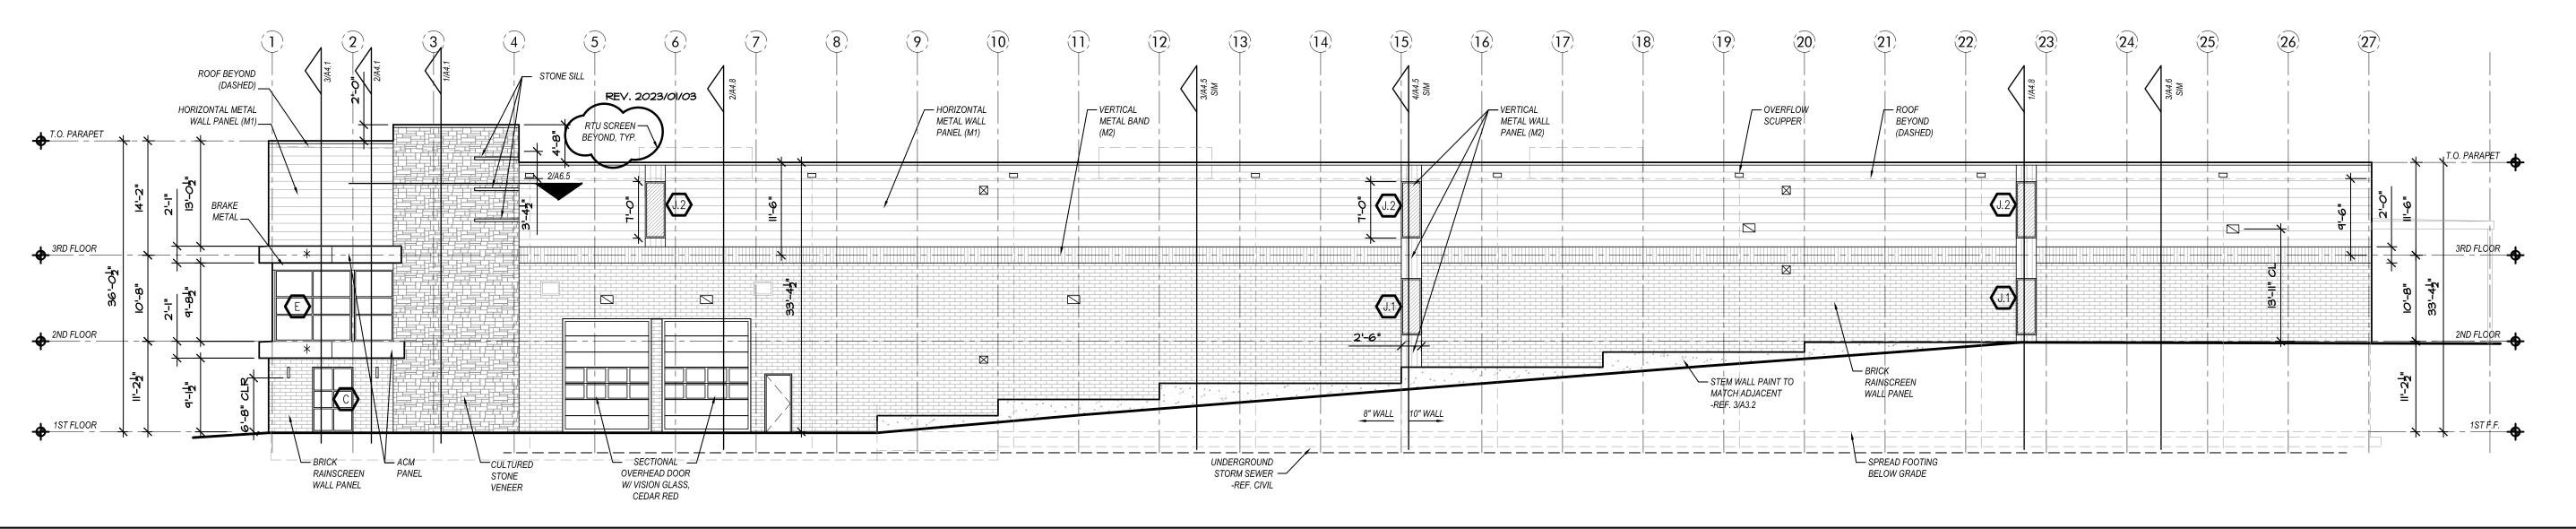


— SIGNAGE BY OWNER

RAINSCREEN

(DASHED BEHIND

GLAZING)

2 SOUTH ELEVATION 3/32" = 1'-0"

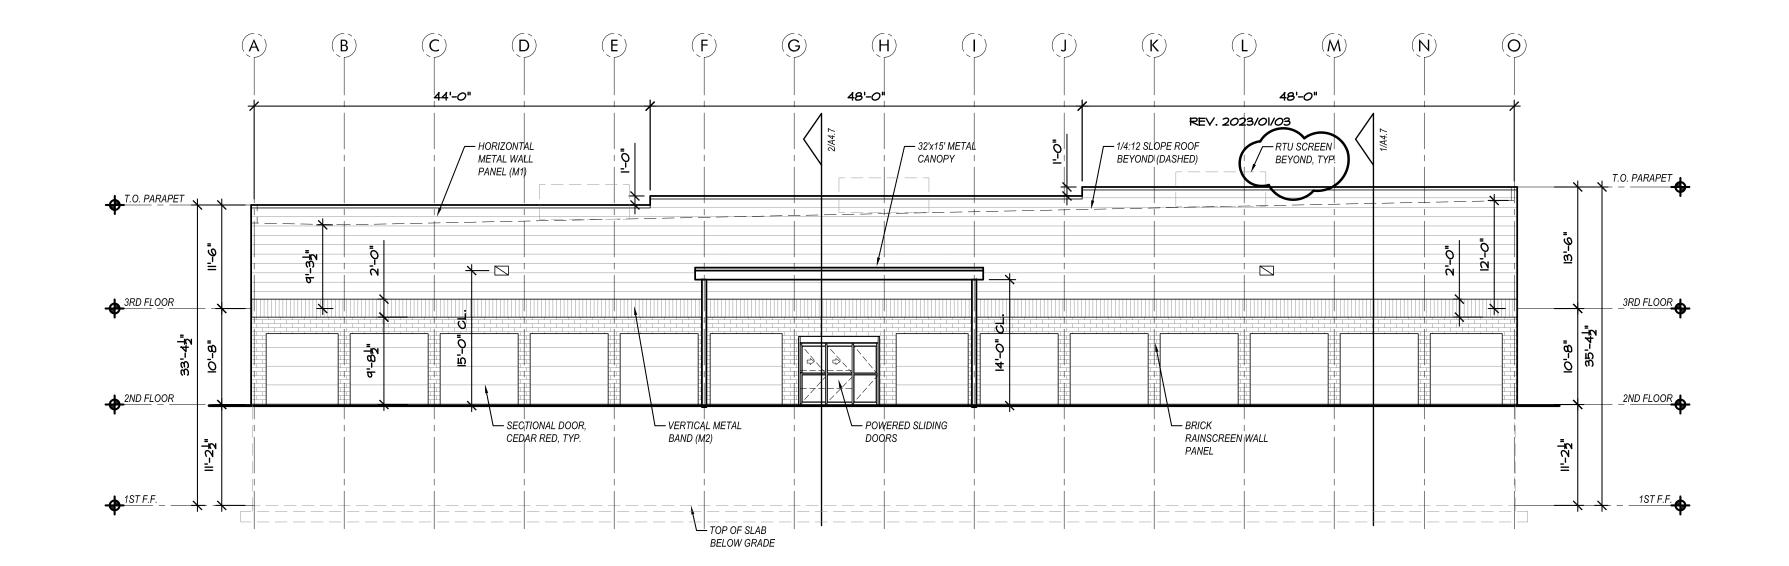

//// SPANDREL	GLASS	
//// SI ANDINEL	OLASS	

ELEVATION	LEGEND	NOTES
	HORIZONTAL METAL WALL PANEL (M1)	MBCI SIGNATURE 300, 'ALMOND'
	VERTICAL METAL BAND (M2)	MBCI SIGNATURE 200 PBD, 'SOLAR WHITE'
*	ACM — ALUMINUM COMPOSITE MATERIAL PANEL	
	BRICK RAINSCREEN WALL PANEL (NICHIHA)	SIM. TO ACME BRICK, MENAWA
	CULTURED STONE VENEER	SIM. TO COBRASTONE, ANTIQUE LEUDERS, 4", 5", 8"
	EXTERIOR ROLL UP DOORS	SIM. TO JANUS, CEDAR RED
	EXTERIOR LIGHT FIXTURE -REF. MEP	
	OVERFLOW SCUPPER -REF. 12/A6.3	
\boxtimes	OUTSIDE AIR LOCATIONS -REF. MEP	
ELEVATION	NOTES	
	COPING, TRIM, AND FLASHING TO MATCH COLOR CENT MATERIAL.	

- 2. ROOF MATERIAL TO BE TPO ROOF SYSTEM SLOPED
 AT 1/4" FT WITH INTERNAL ROOF DRAINS TO CONNECT
 TO UNDERGROUND SEWER
- 3. OVERFLOW SCUPPERS TO BE 2" ABOVE LOWEST POINT OF ROOF.
- -. PAINT MAN DOOR TO MATCH ADJACENT MATERIAL UNLESS NOTED OTHERWISE.
- GENERAL CONTRACTOR/SIGNAGE COMPANY TO PROVIDE ANCHORAGE, BLOCKING, & WATERPROOFING FOR
- MAX PARAPET HEIGHT TO BE 2'-6" WITHOUT STRUCTURAL SUPPORT.

PE MISSE
STANLEYC
A-5721
A ED AR WHITE

S III

NE PORT SUMMIT,

4101 LEE'S

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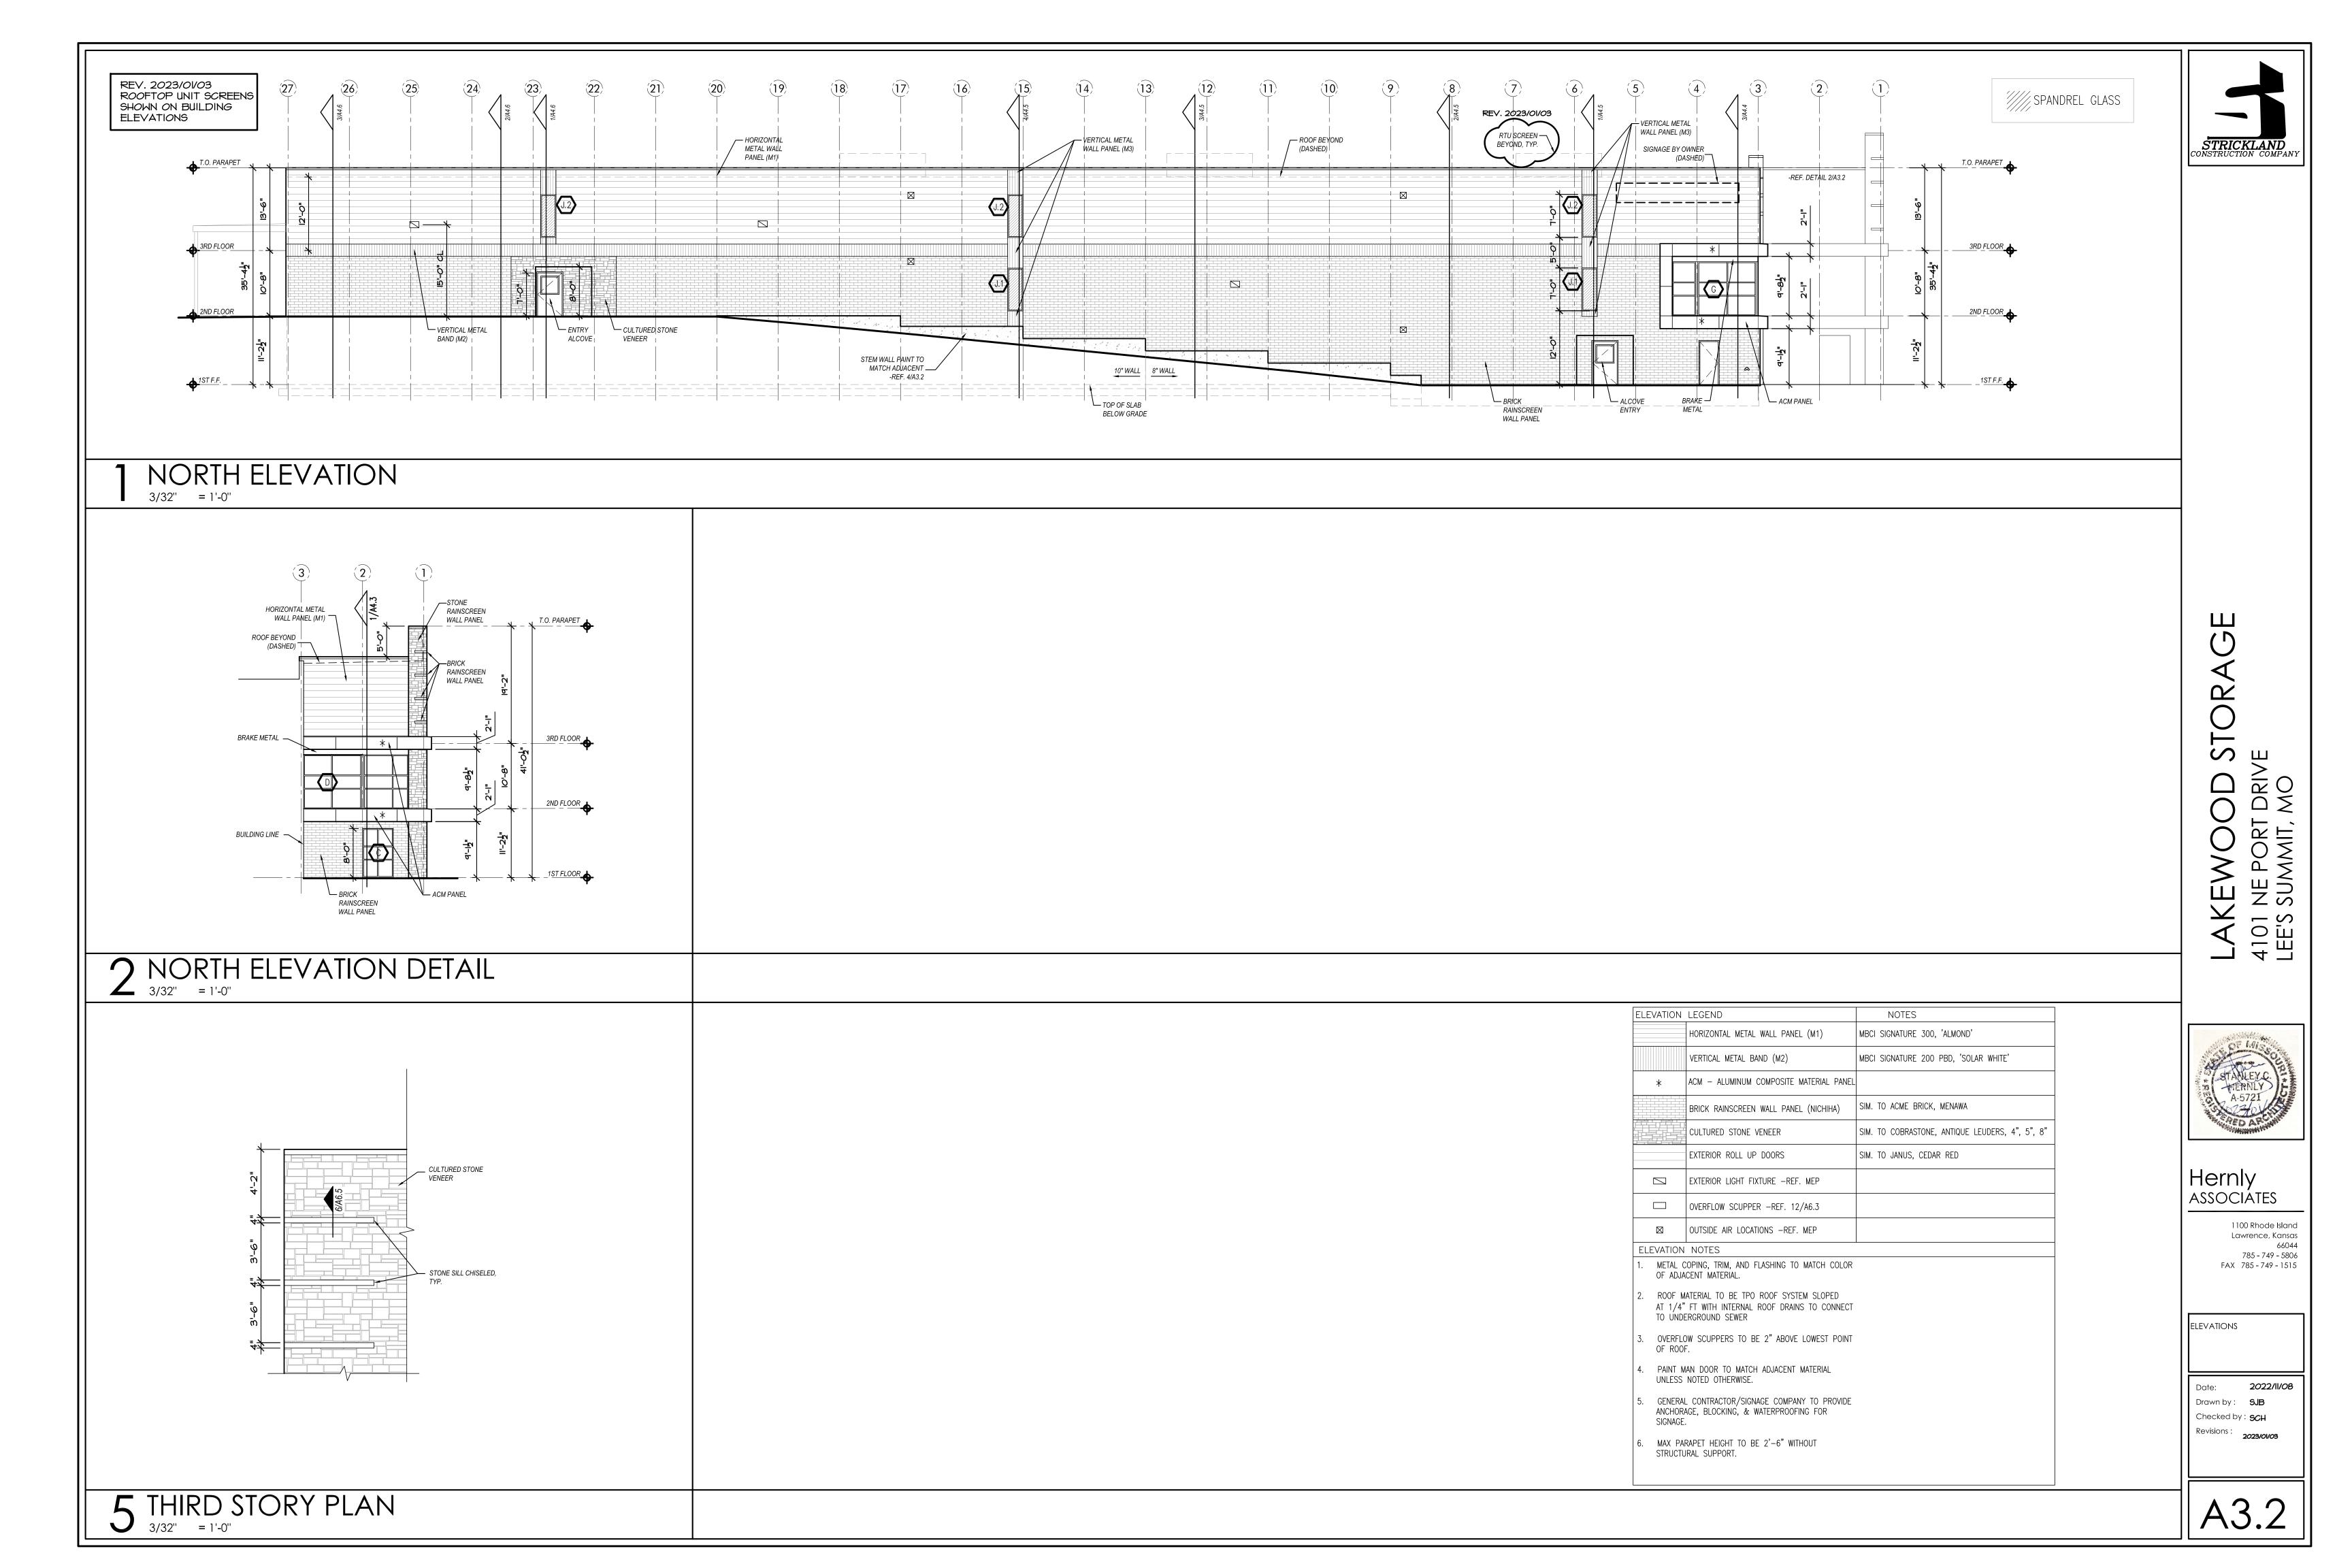
ELEVATIONS


Date: 2022/II/08
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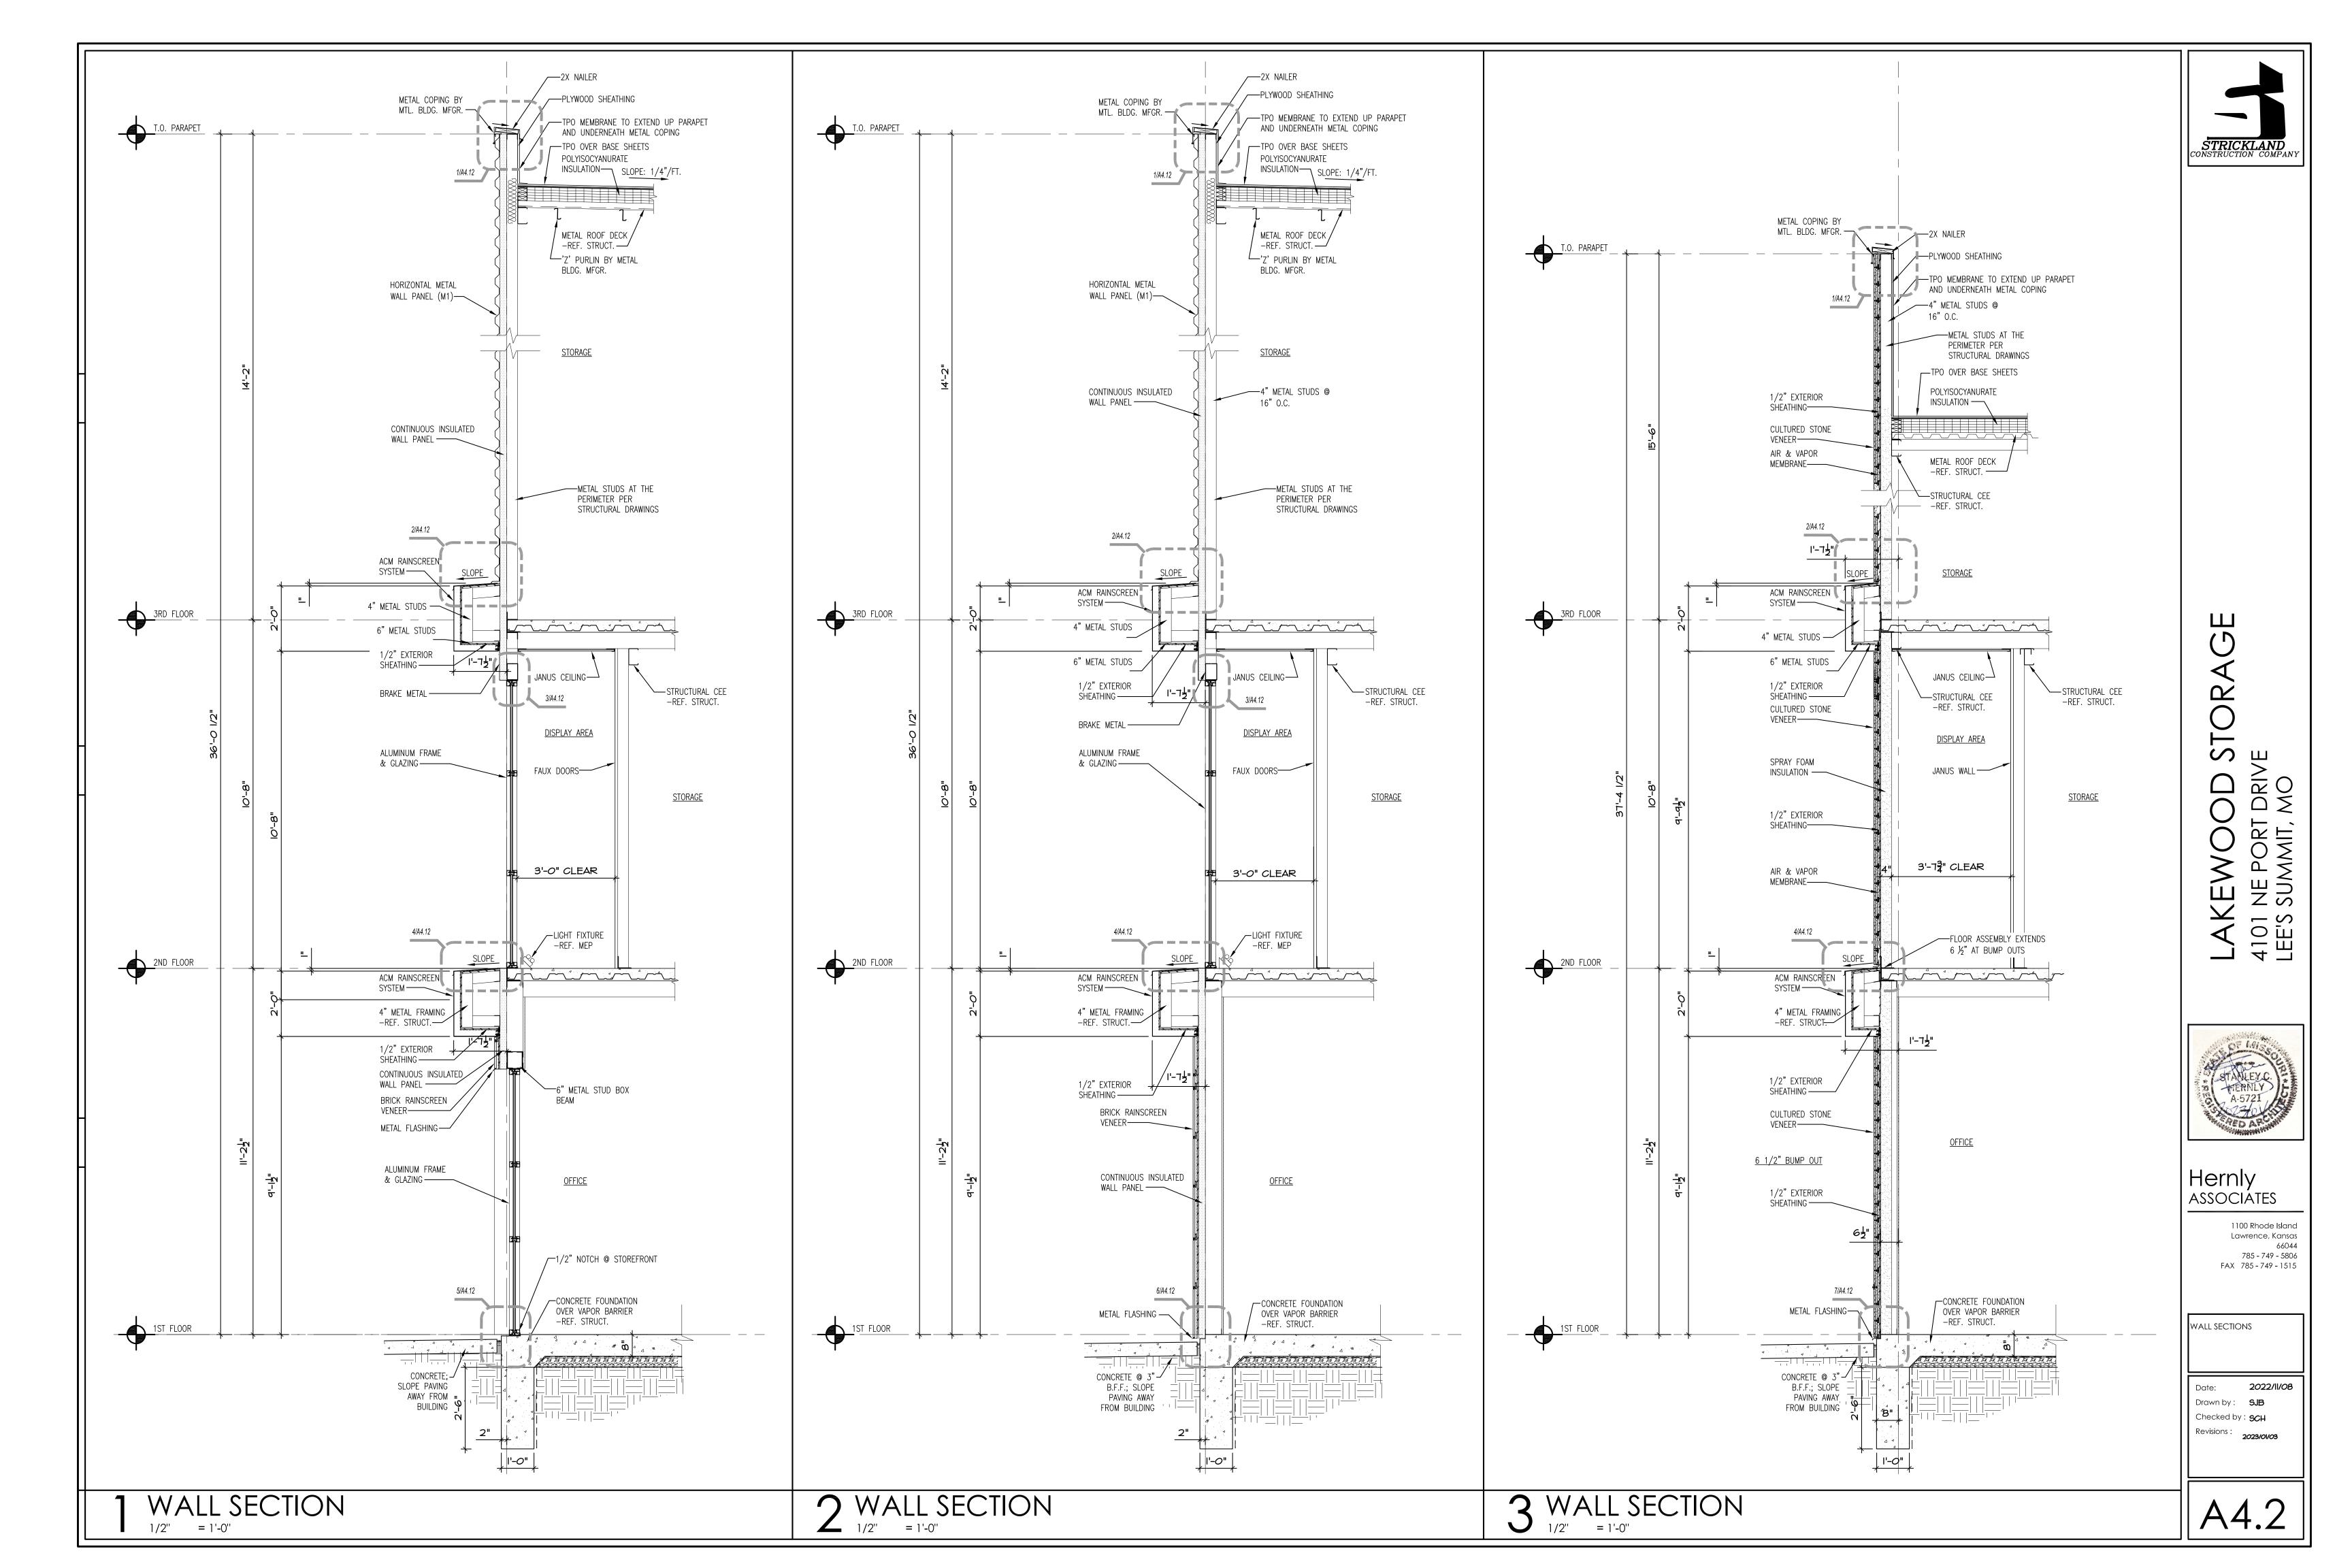
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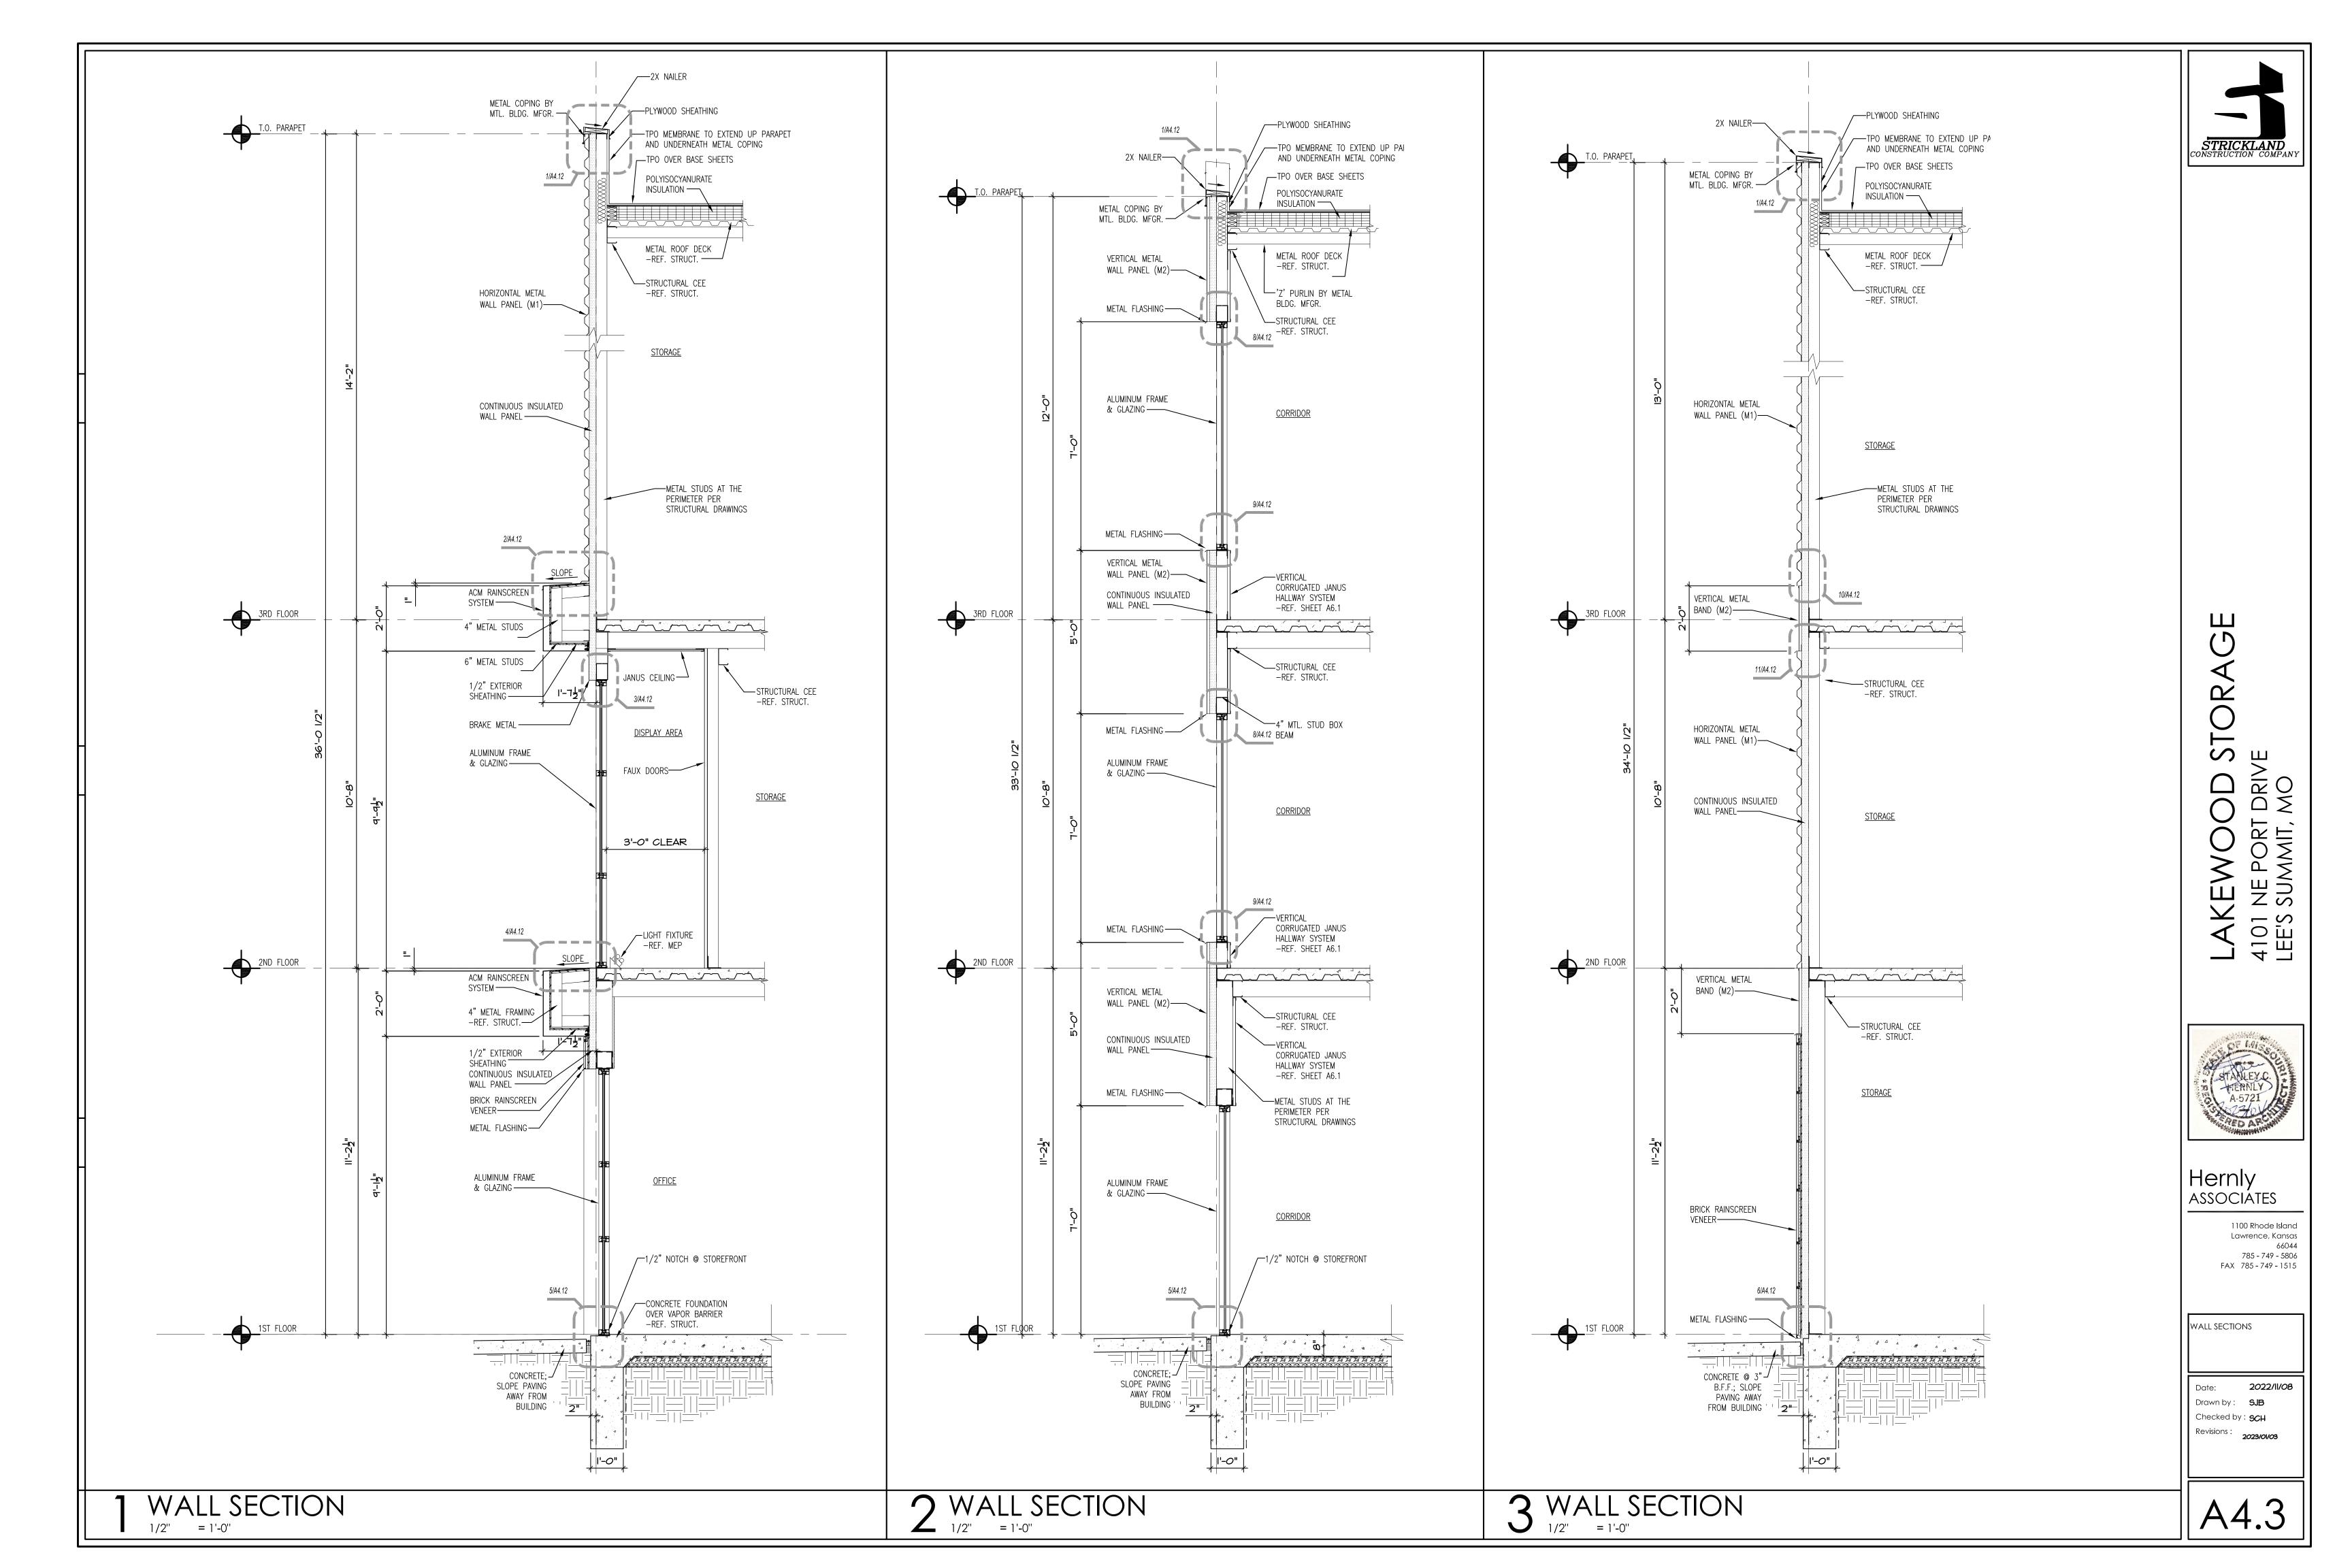
3 EAST ELEVATION
3/32" = 1'-0"


A3.1










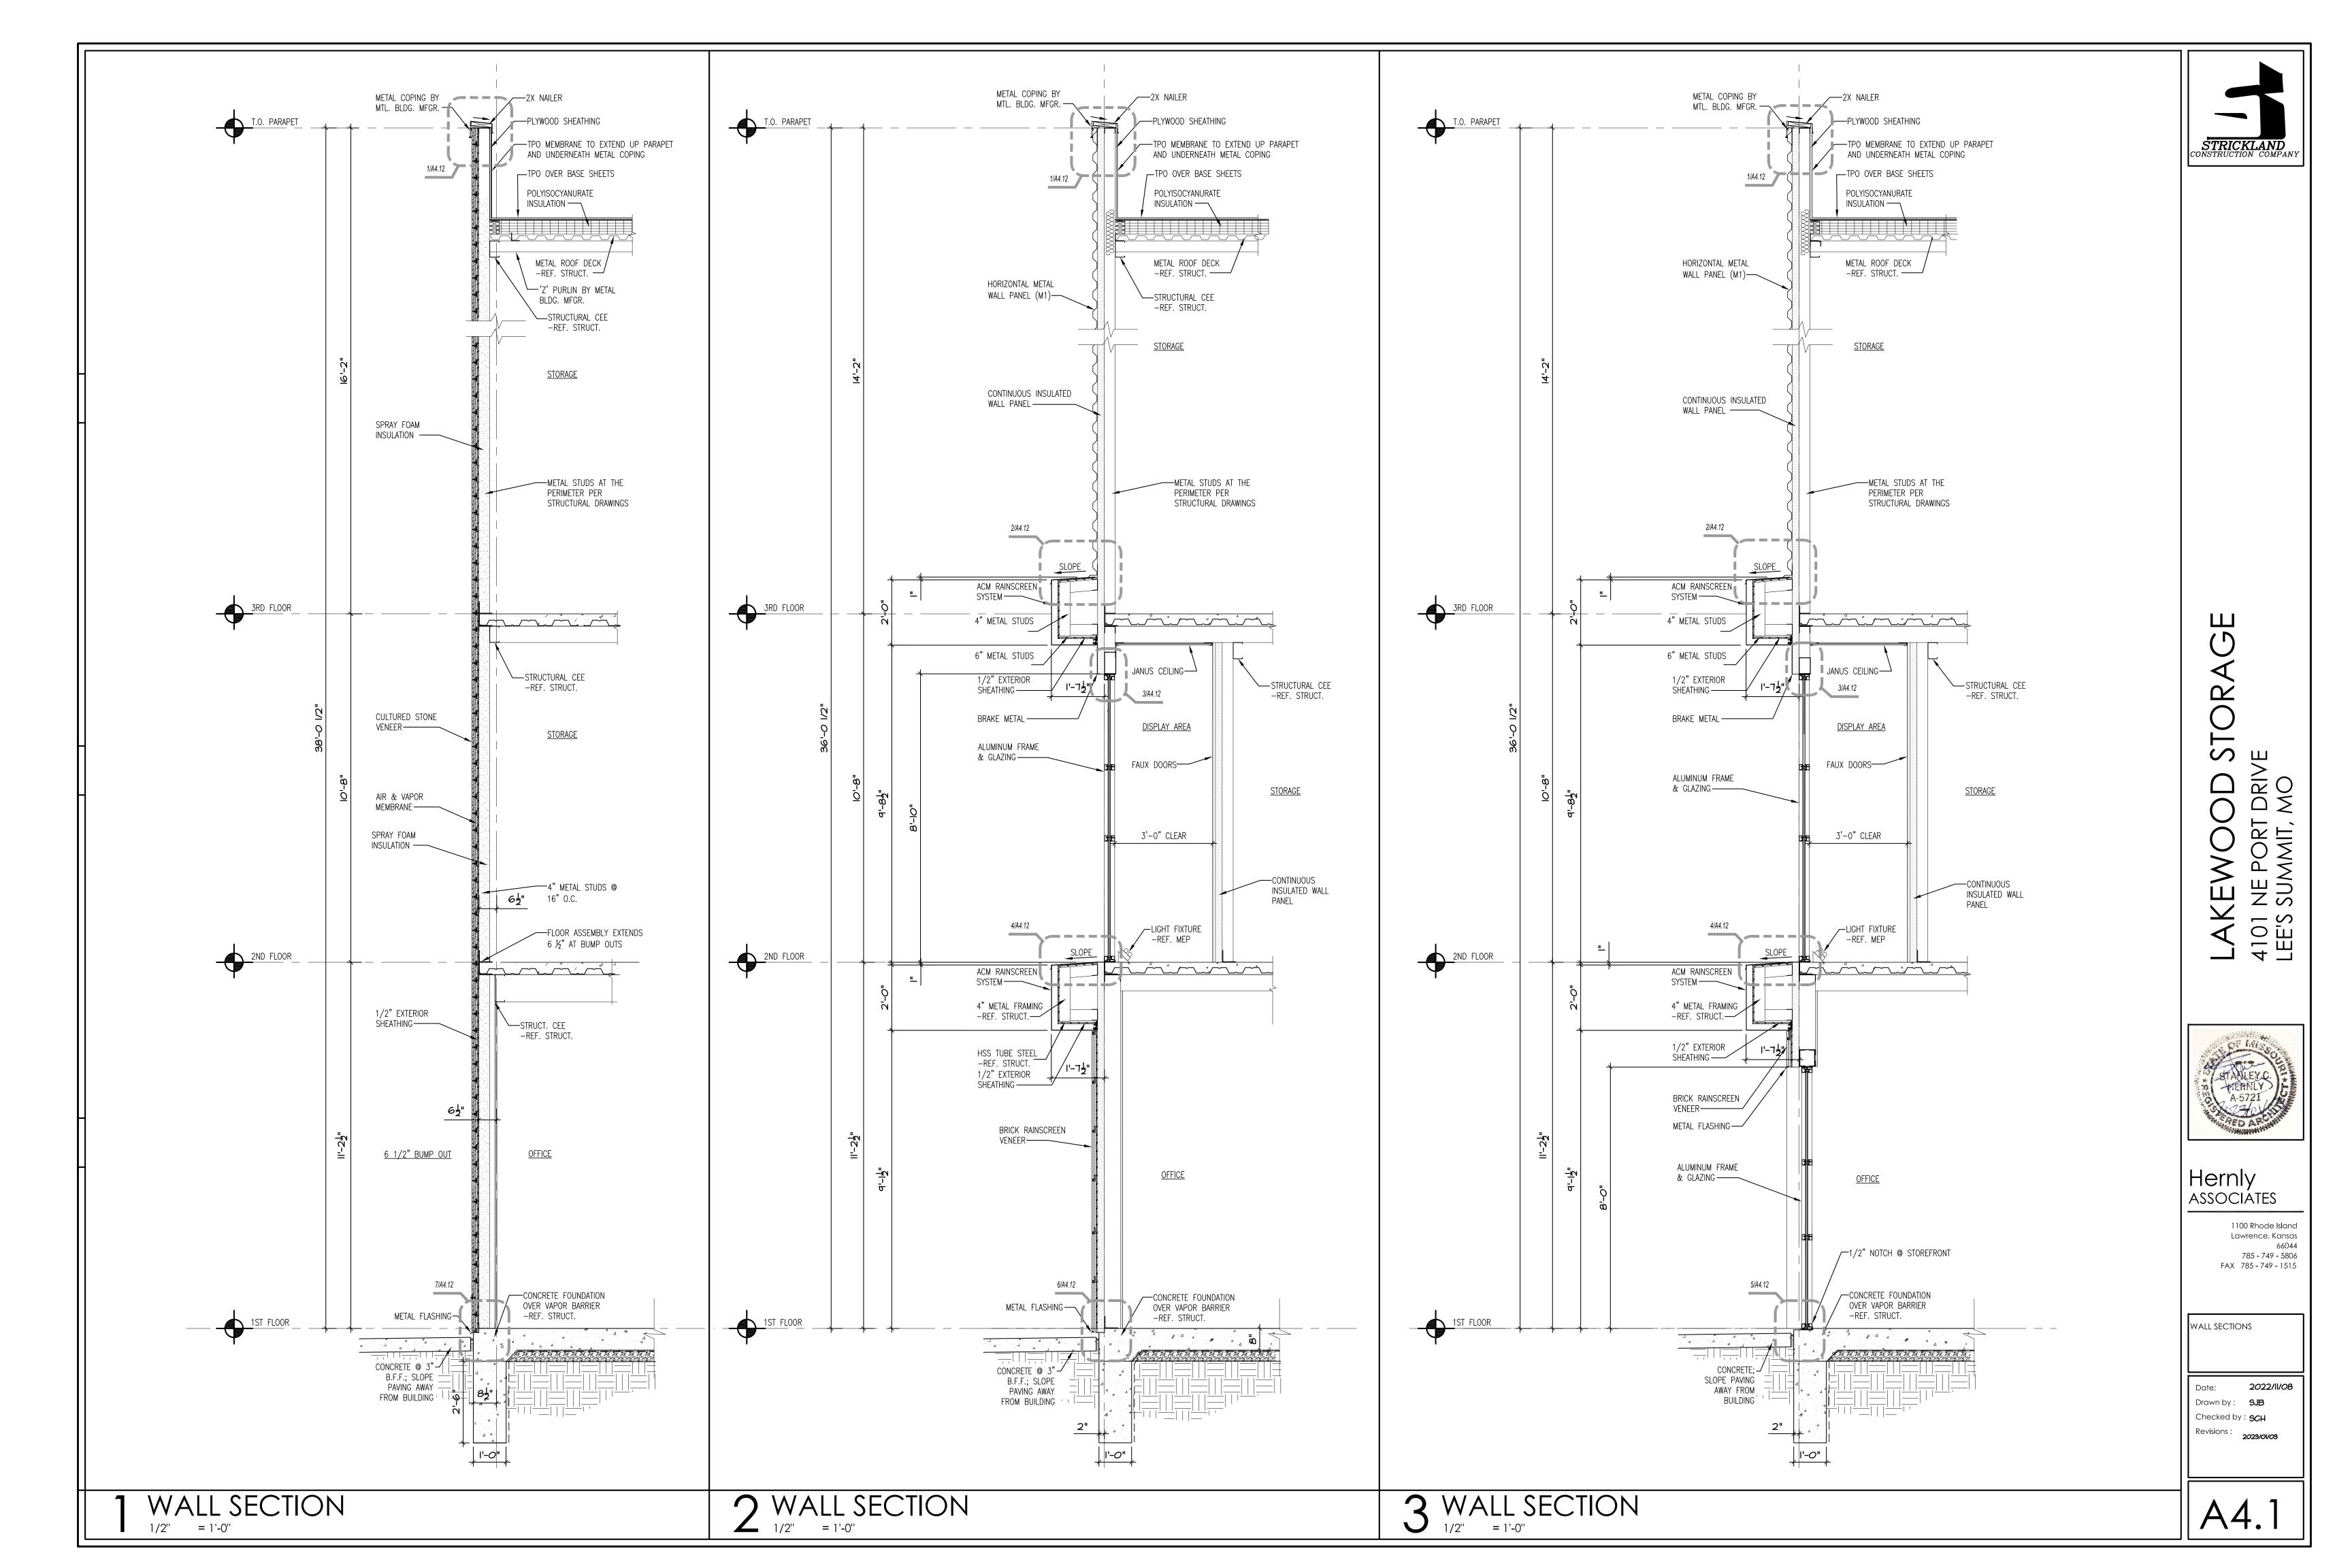


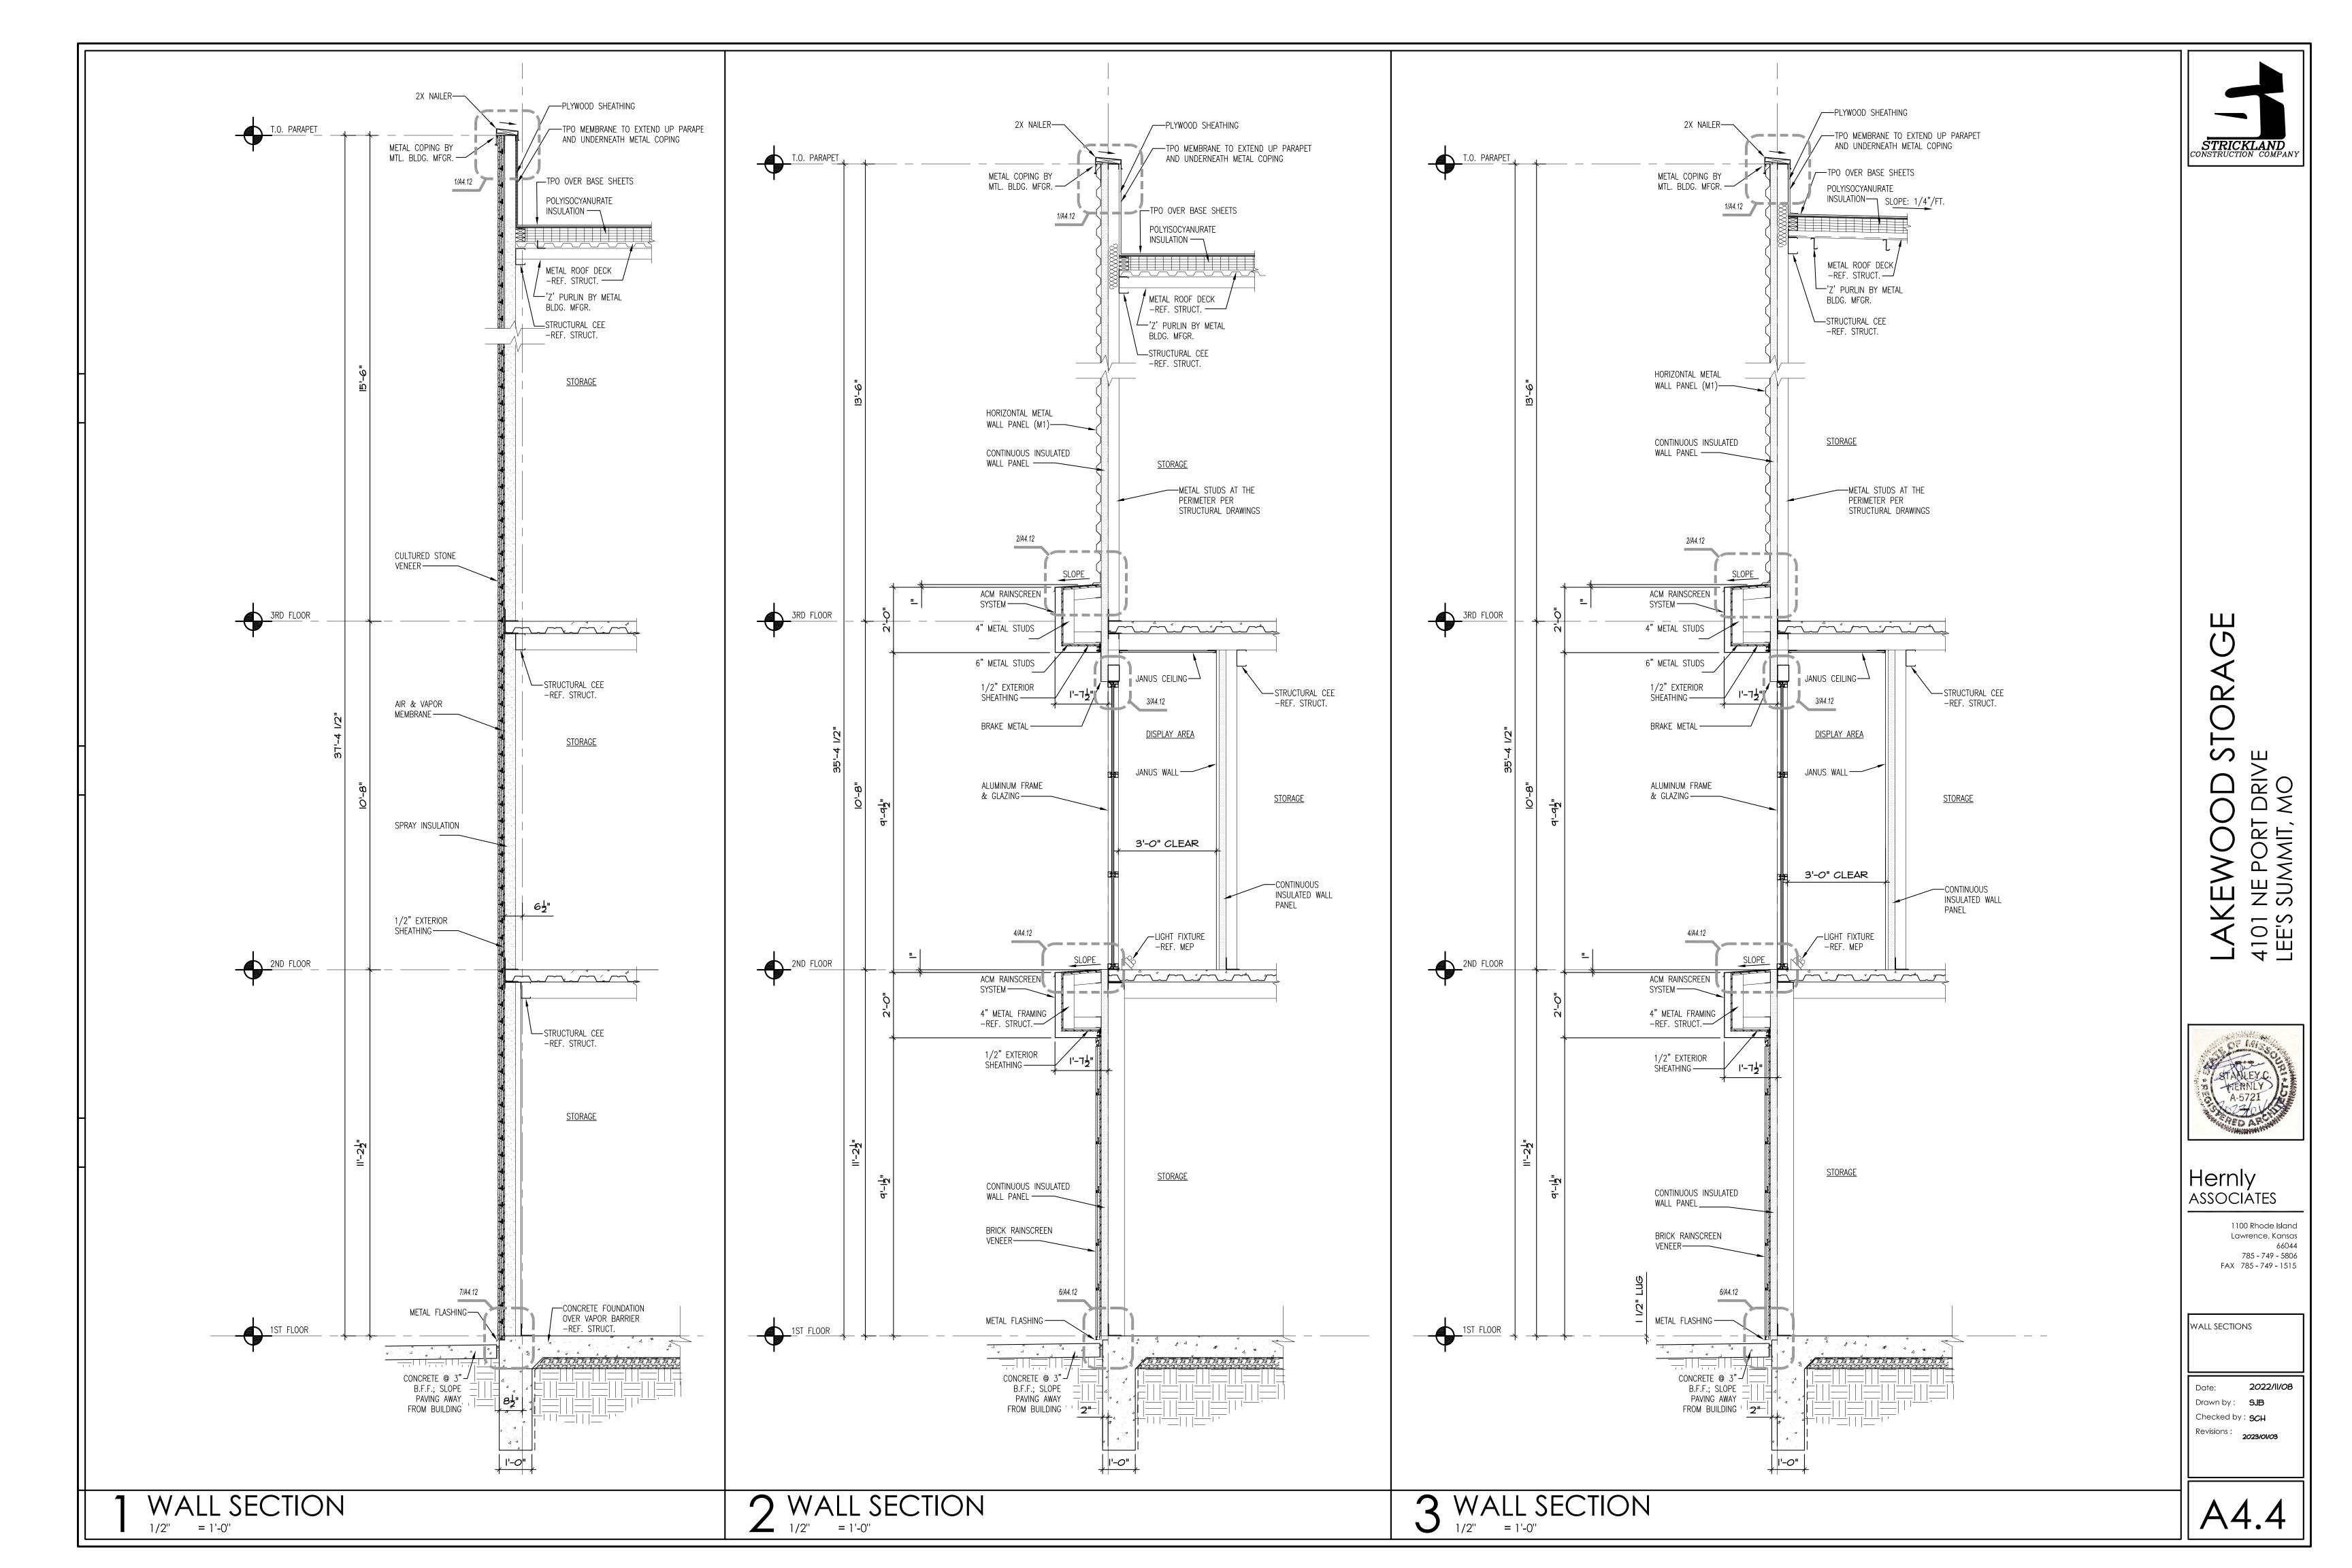

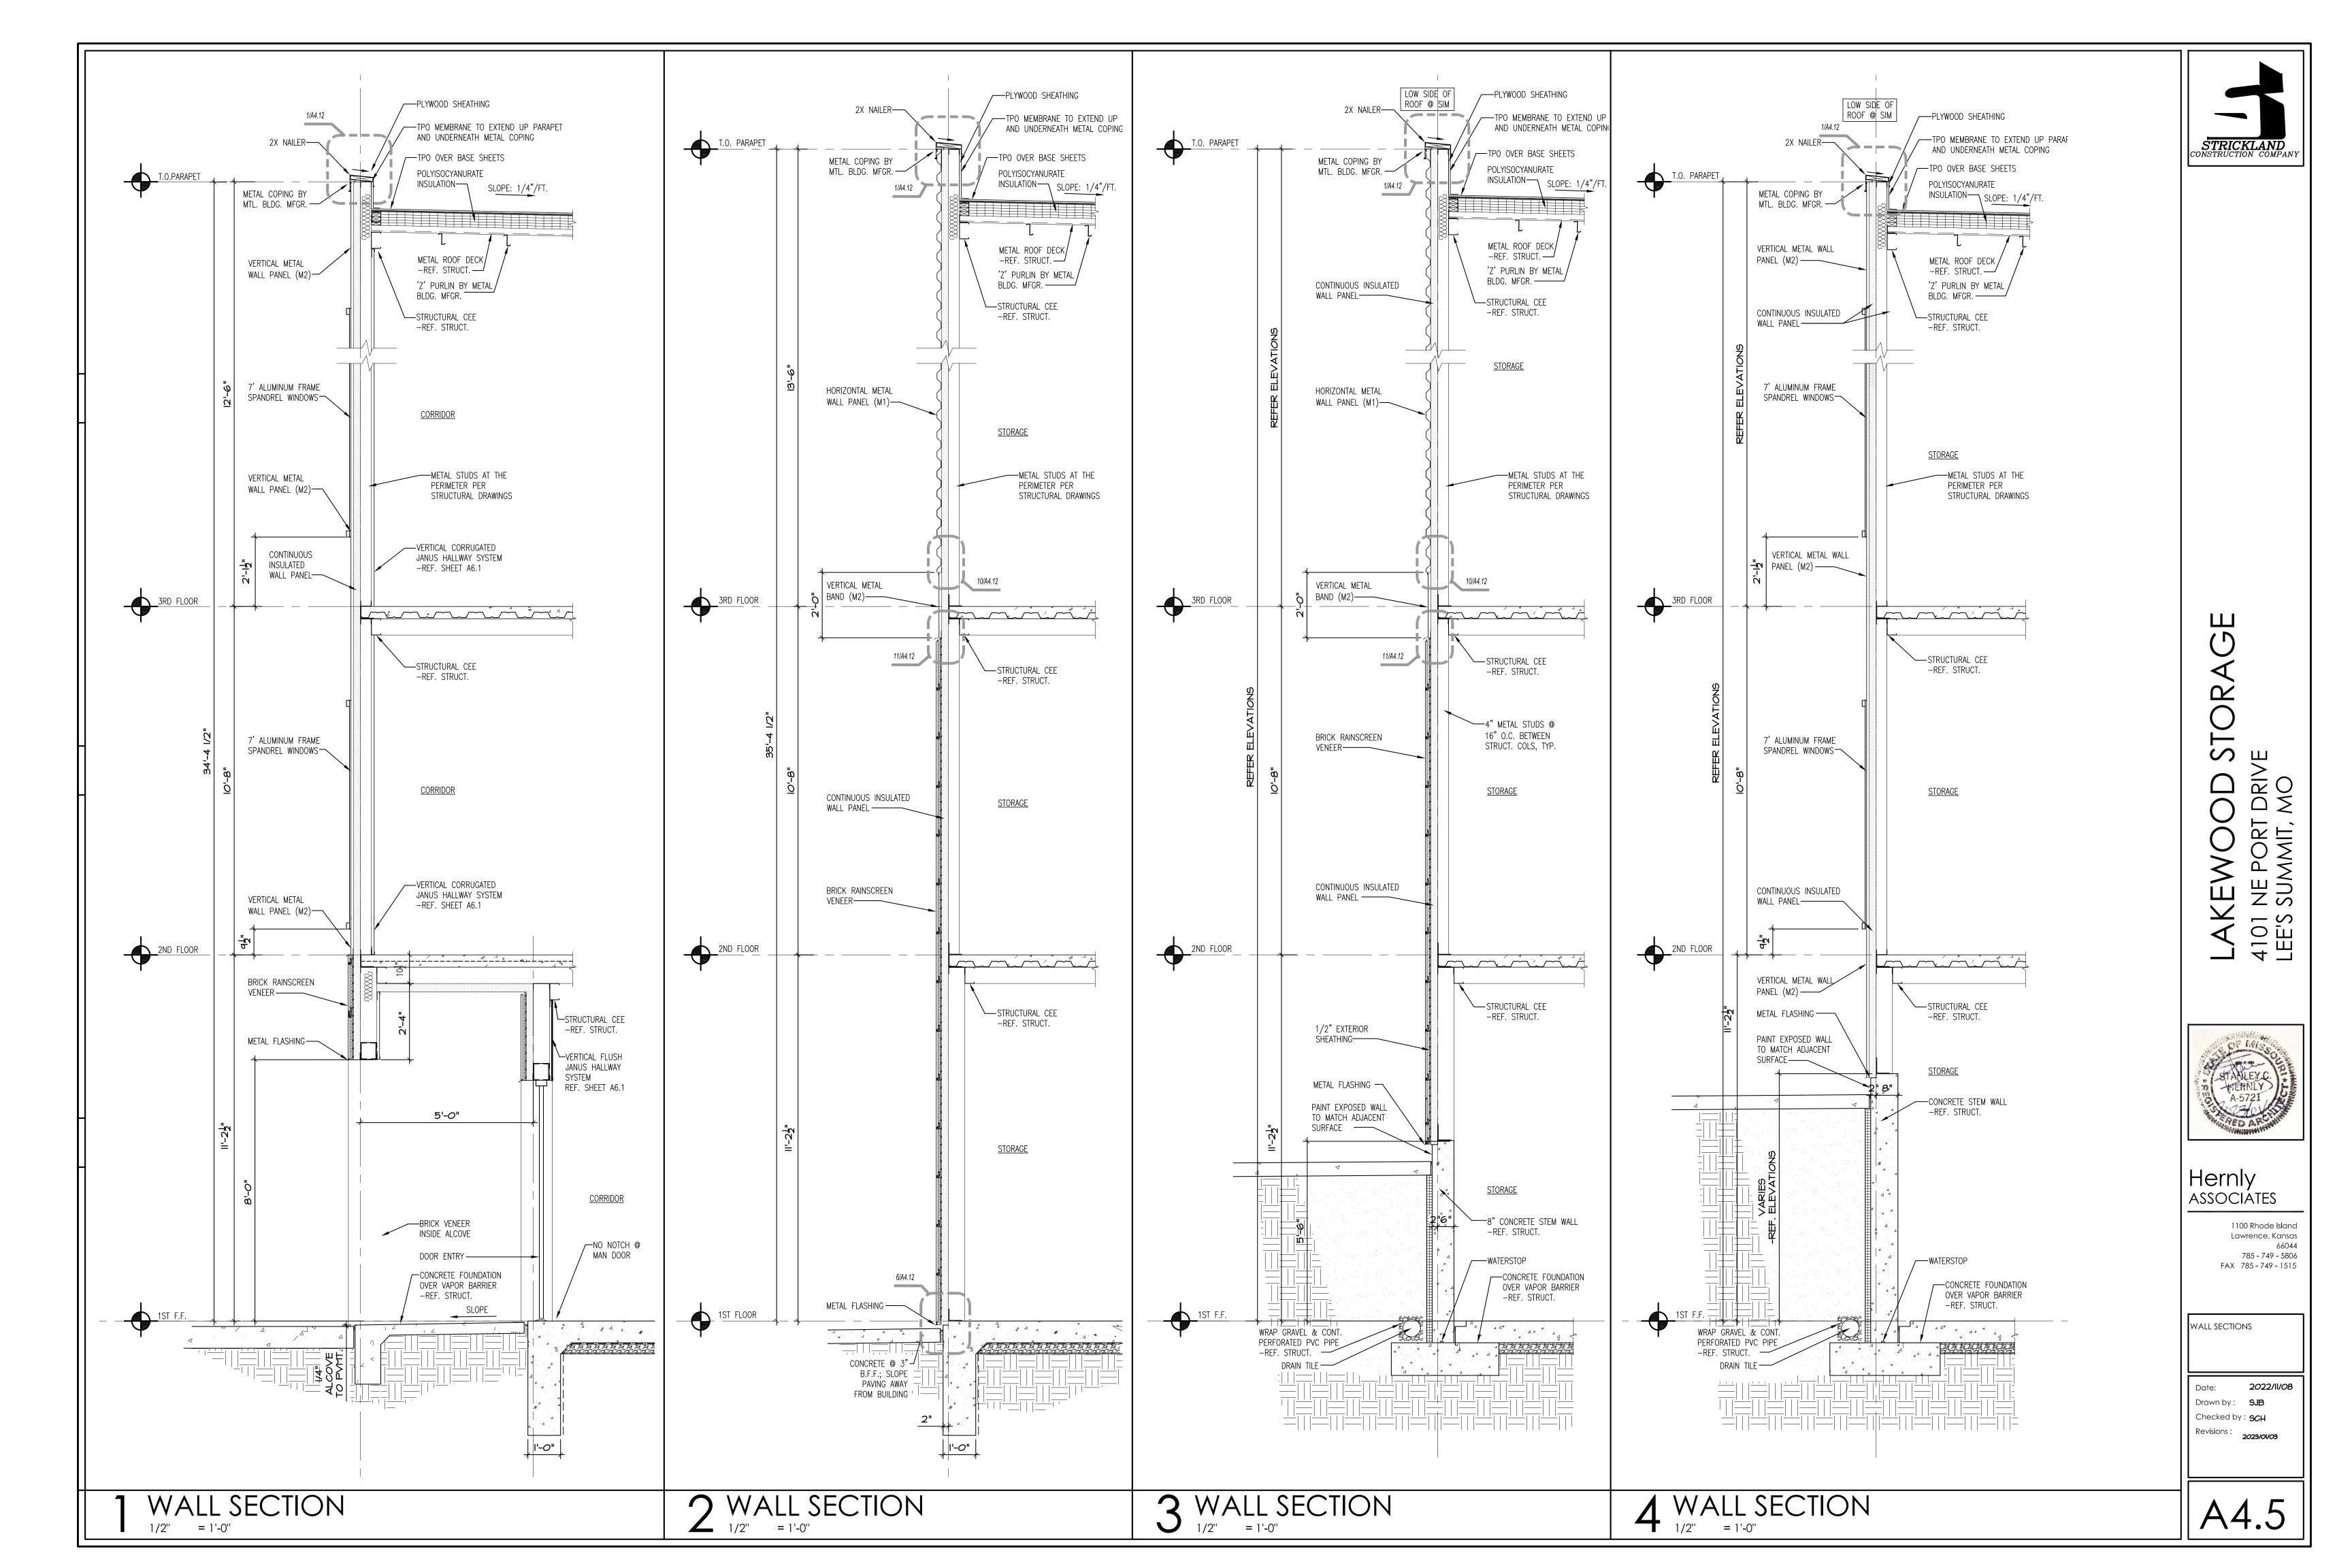

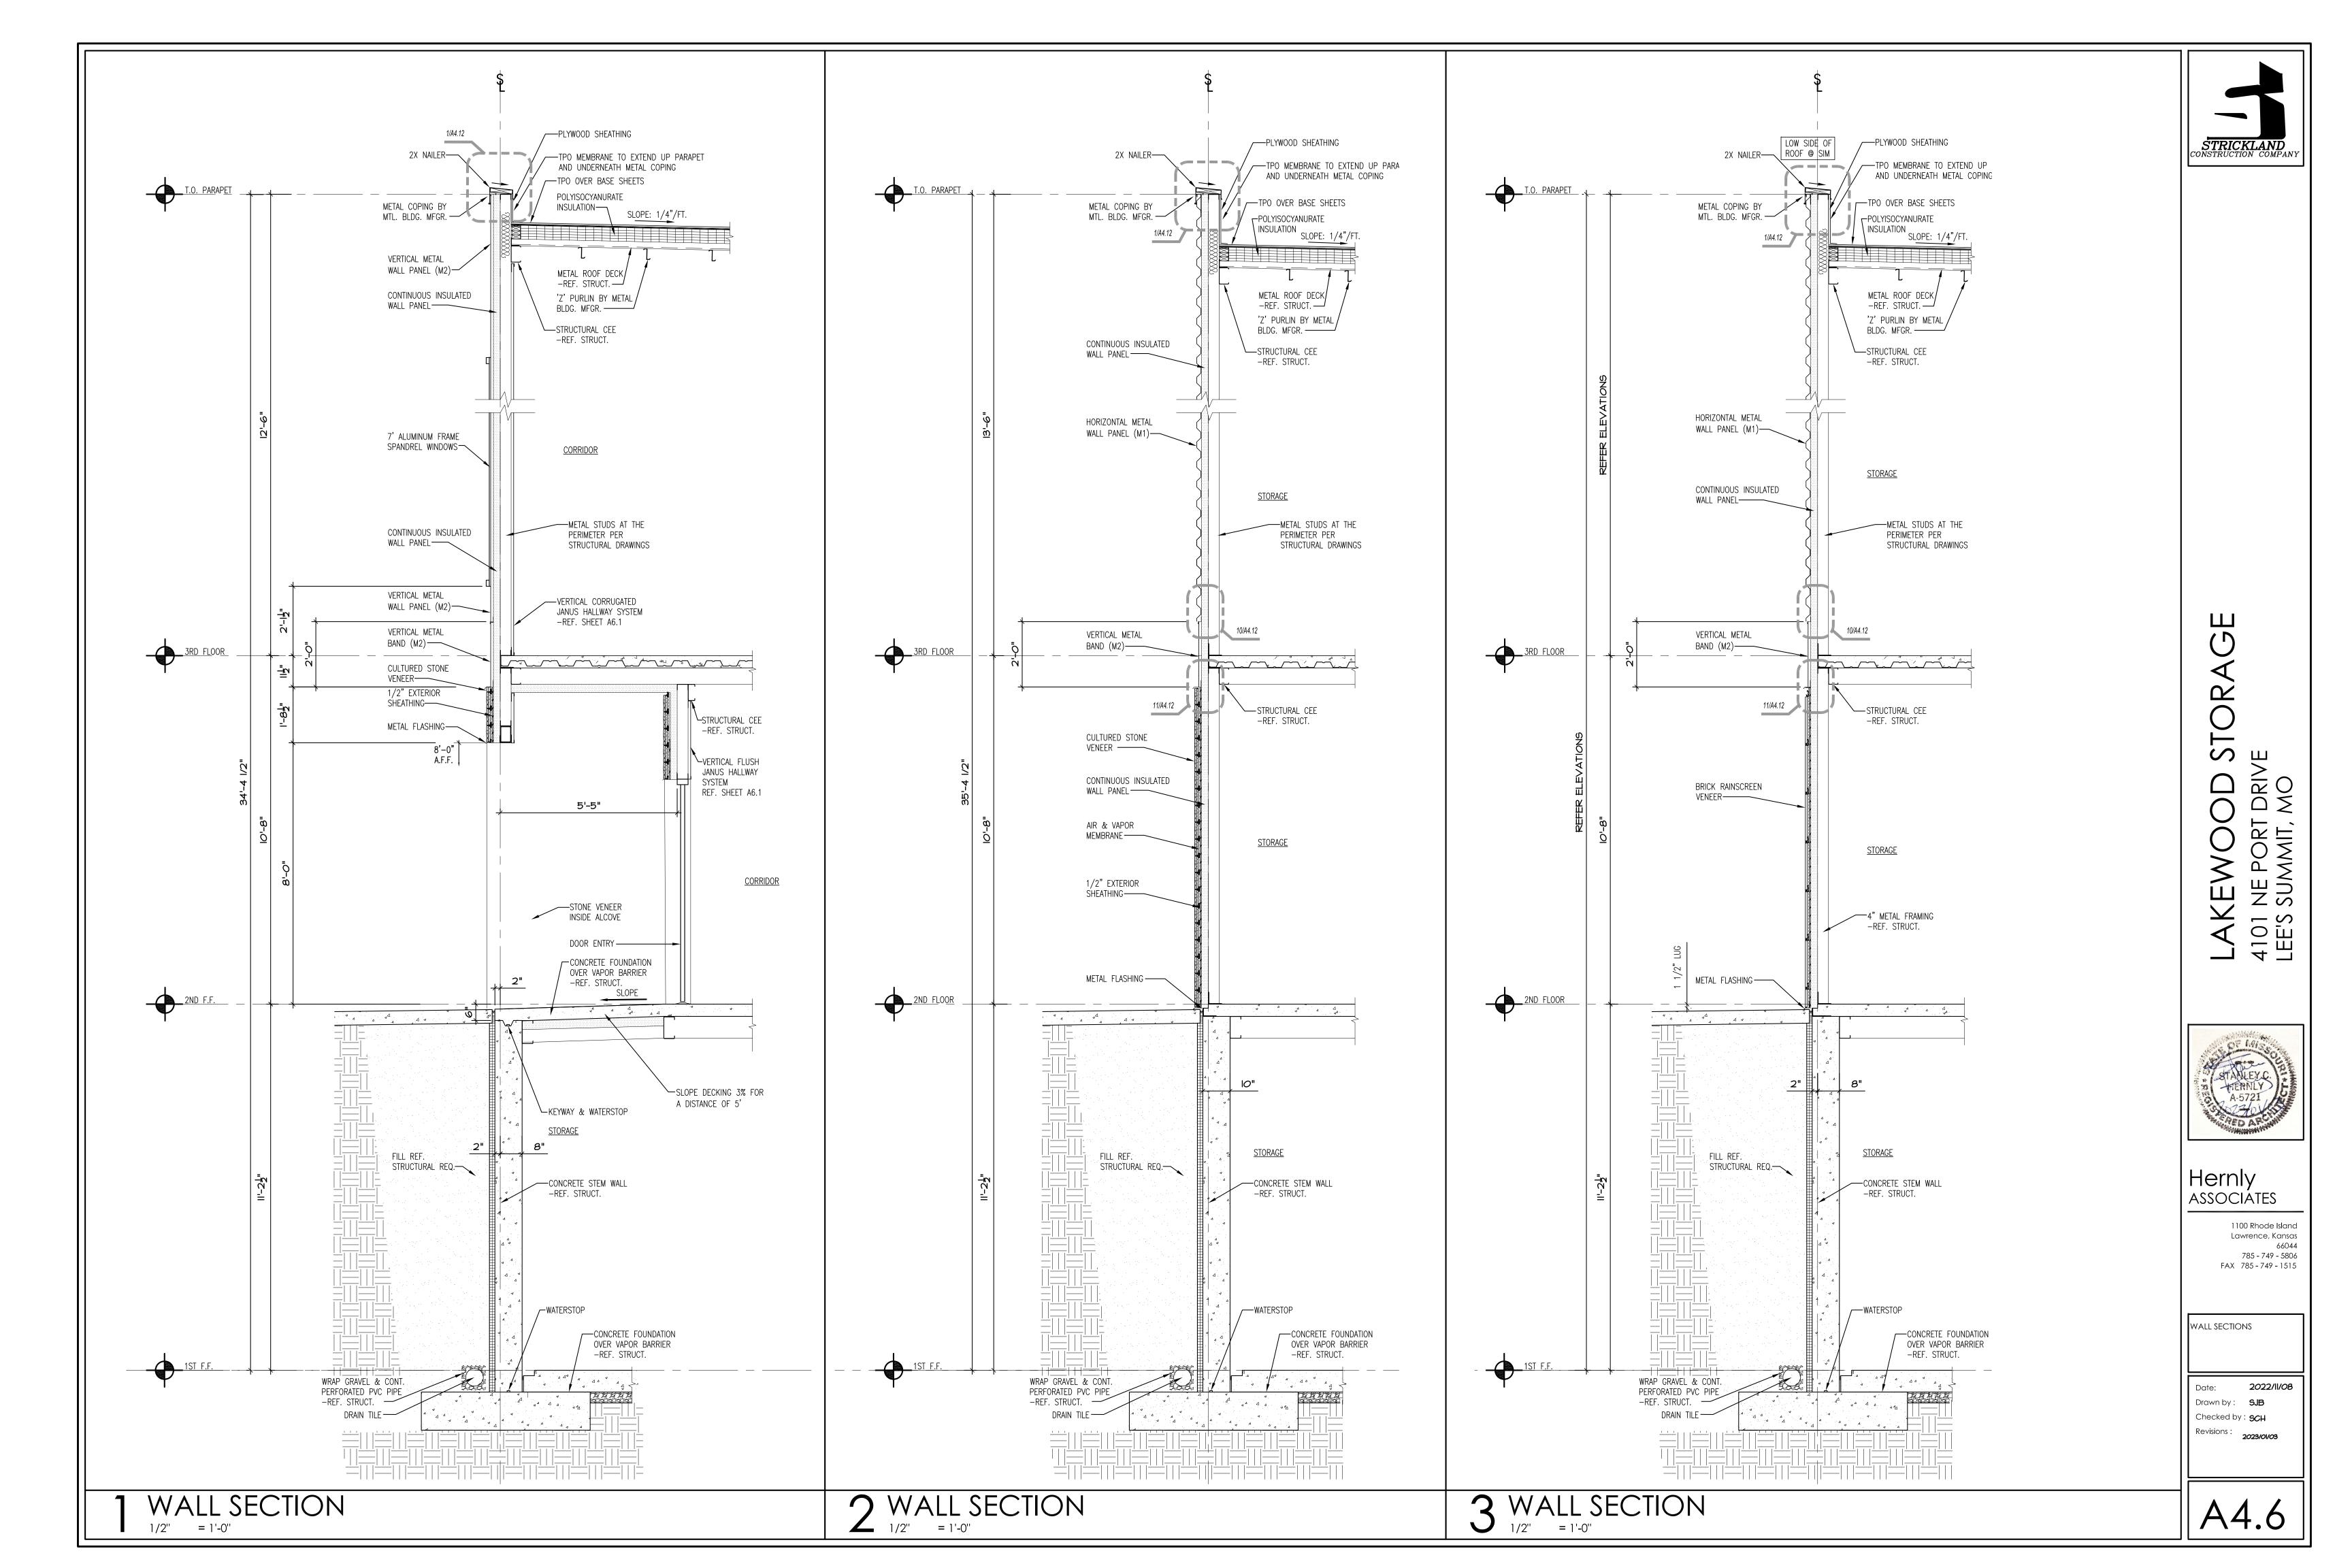

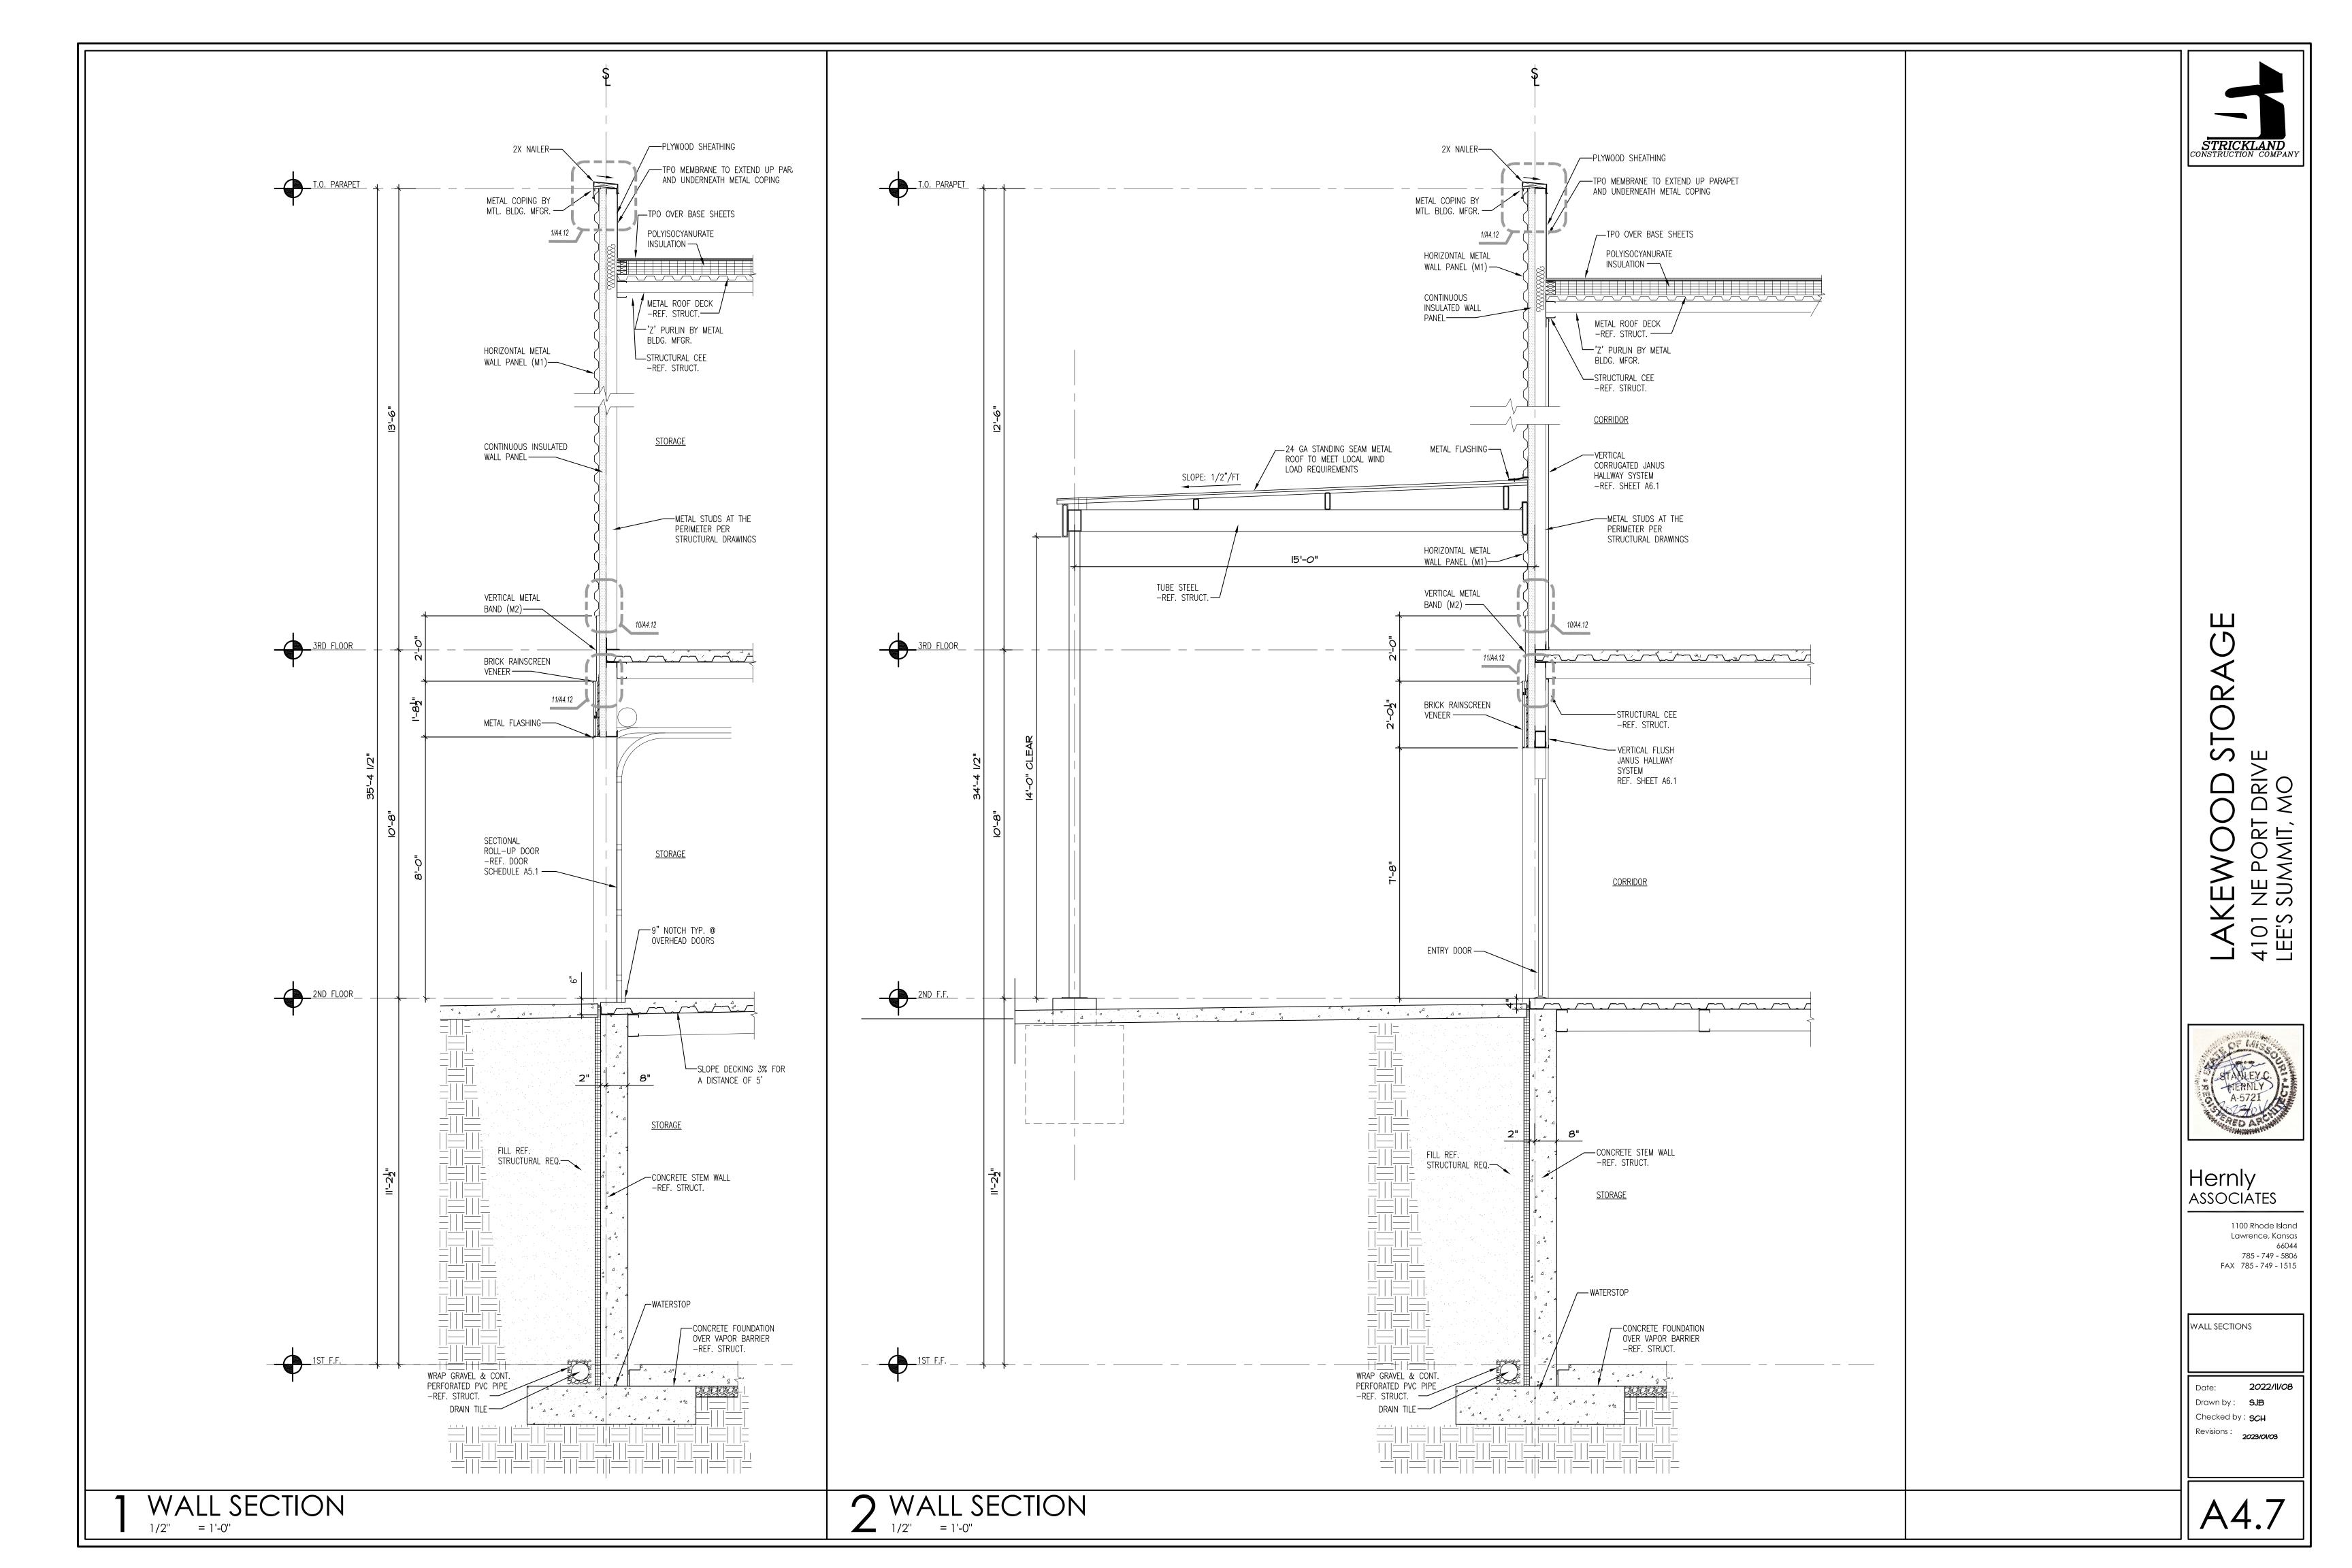

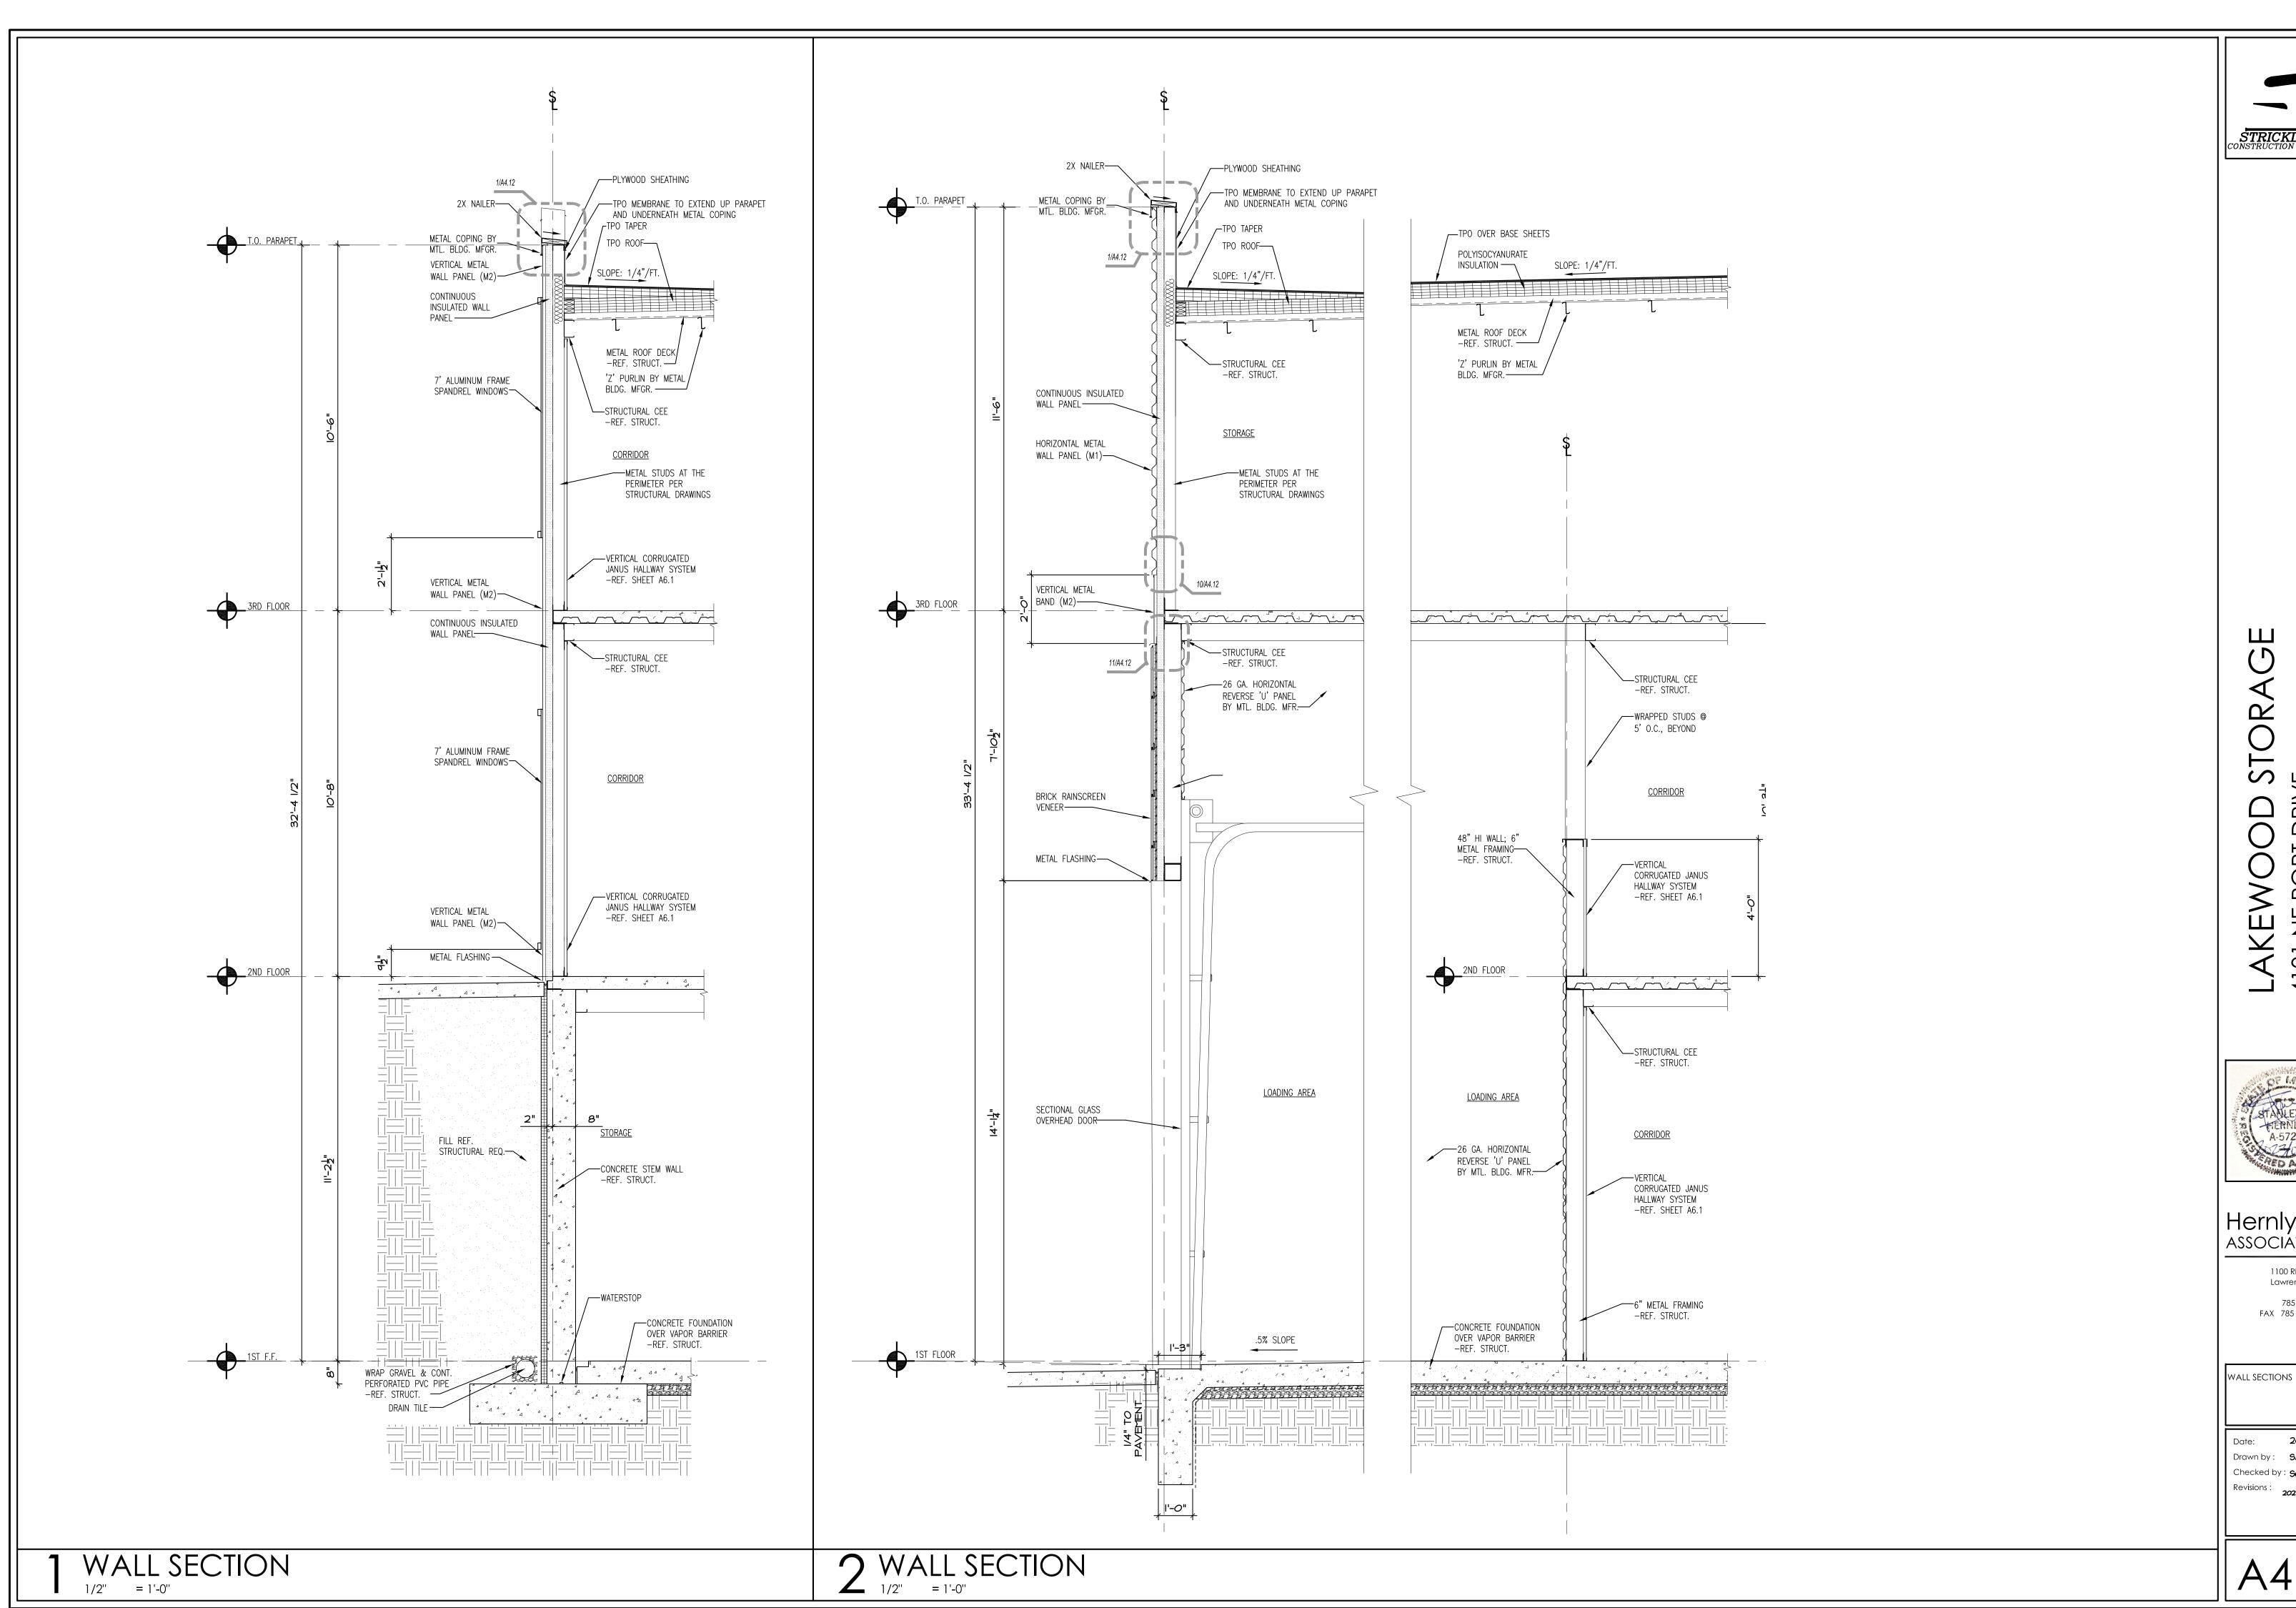



S m NE PORT SUMMIT, 4101 LEE'S


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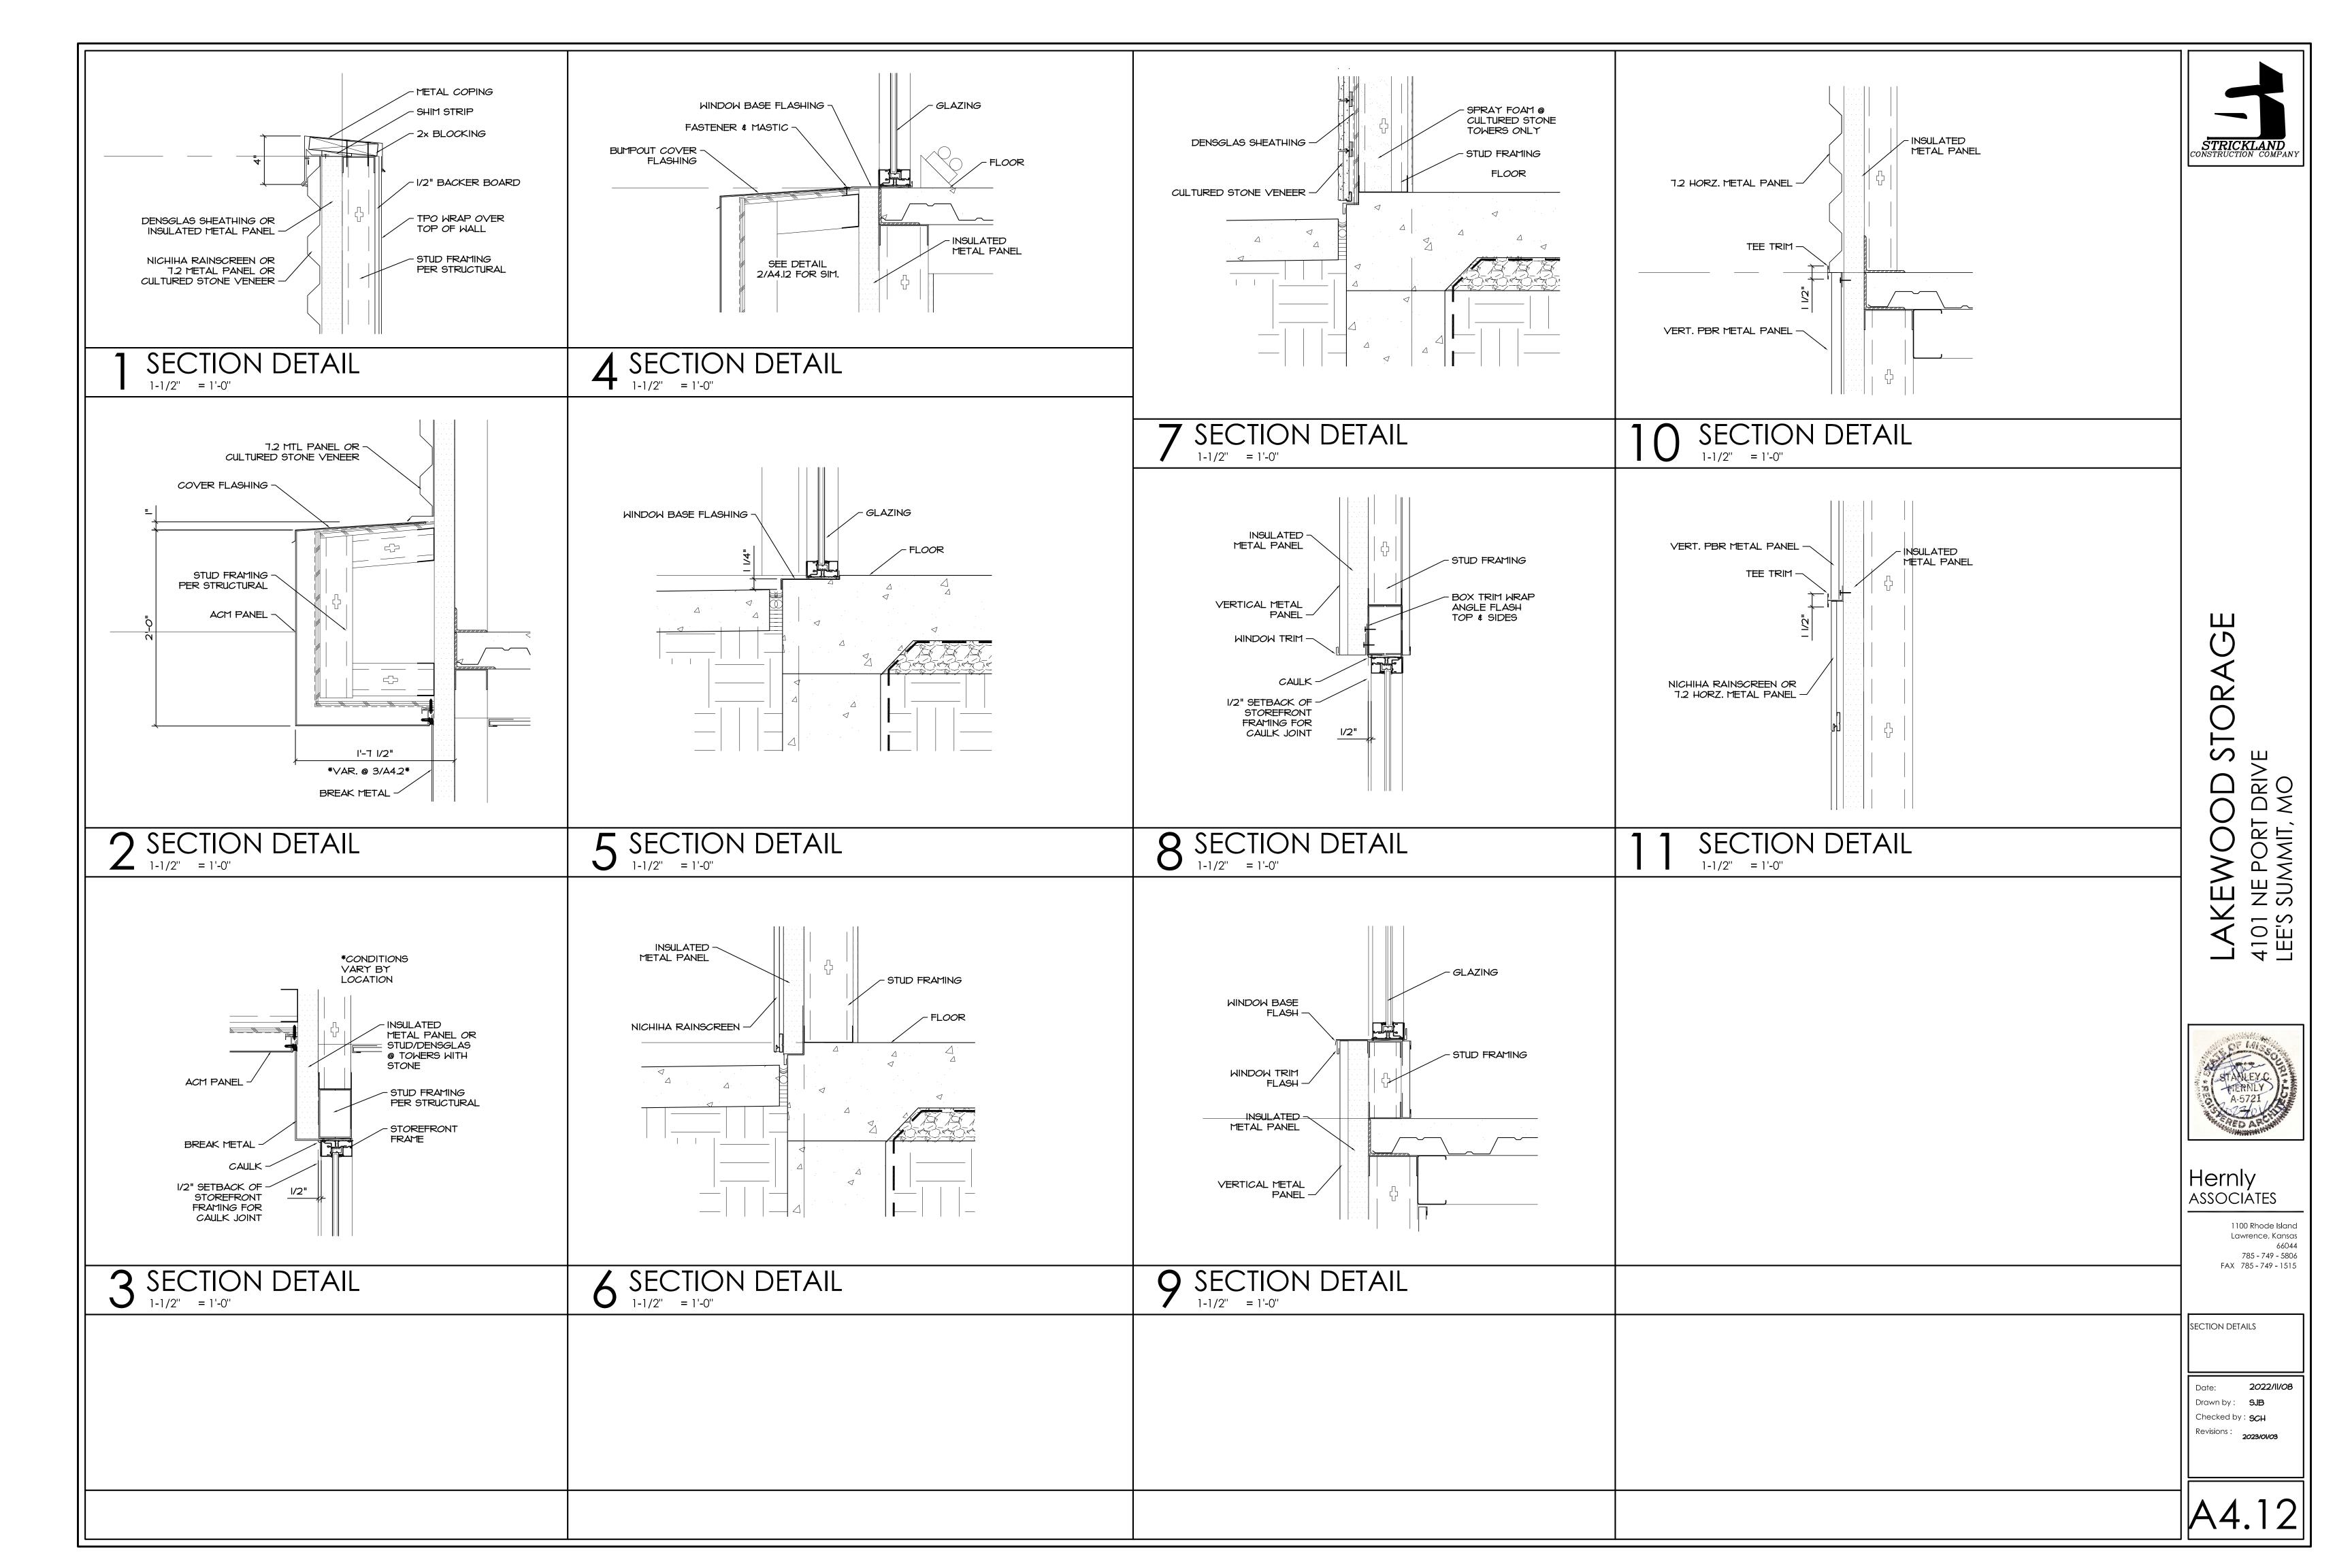
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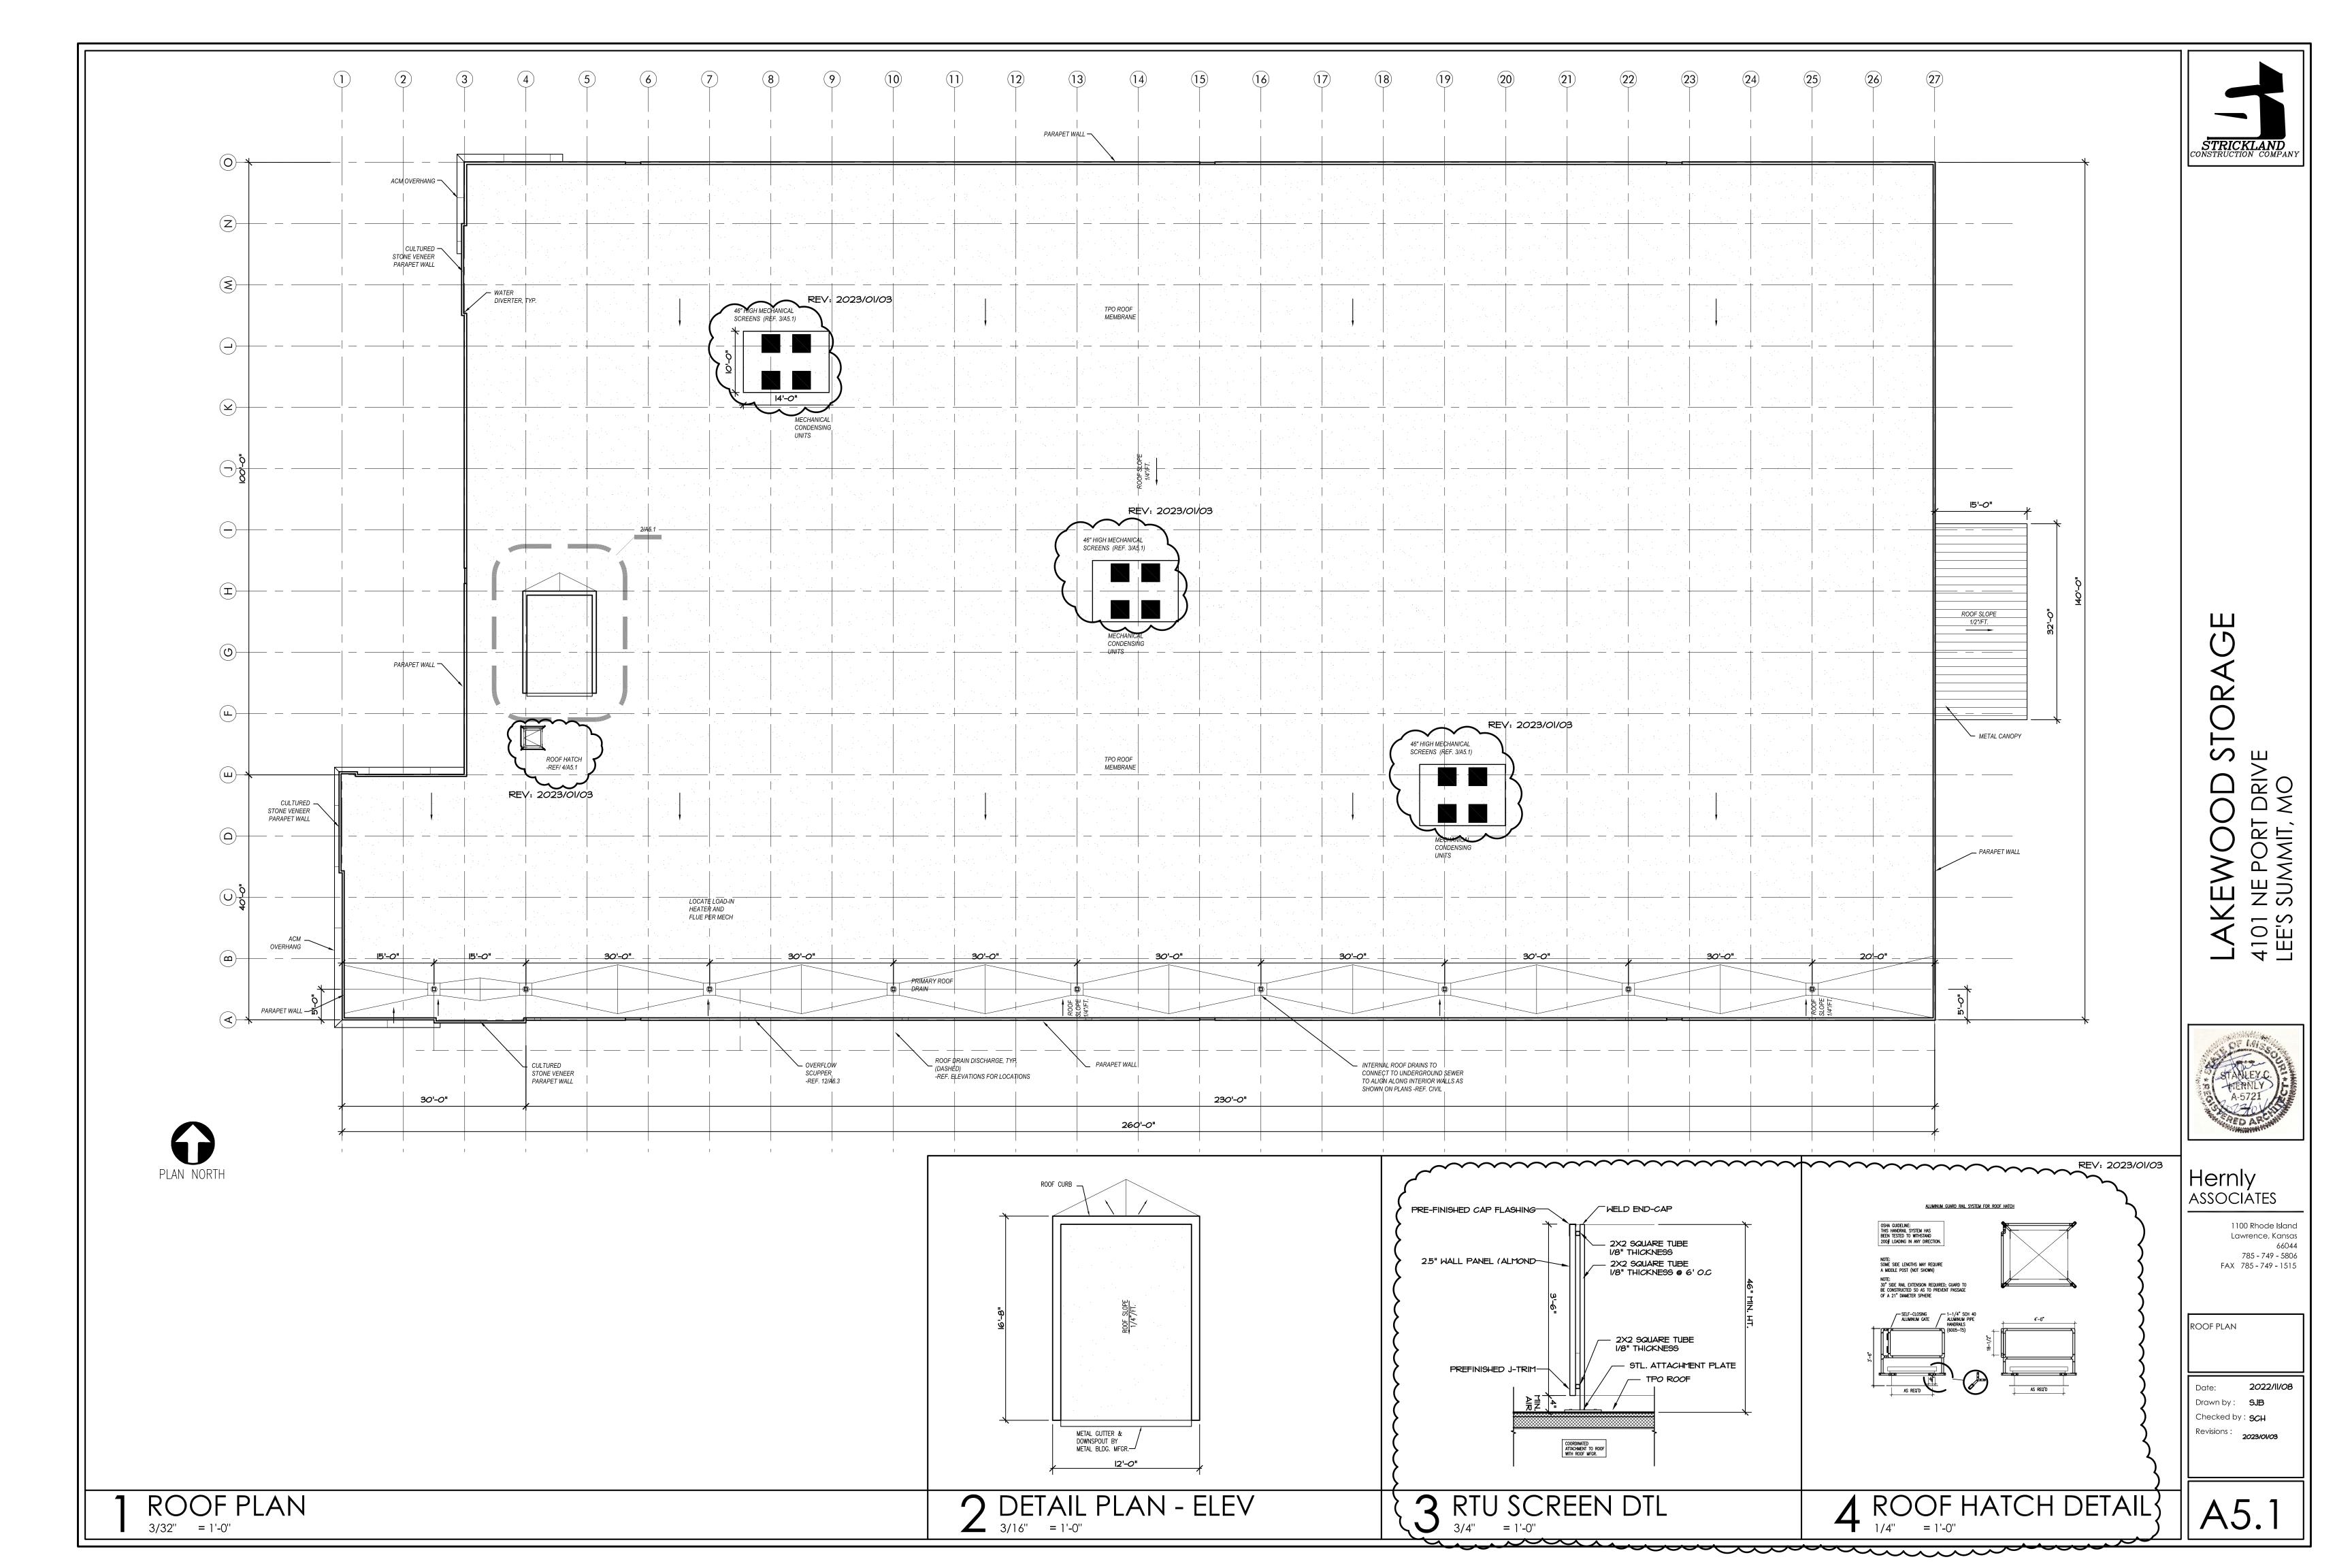
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17,28

17,28

17

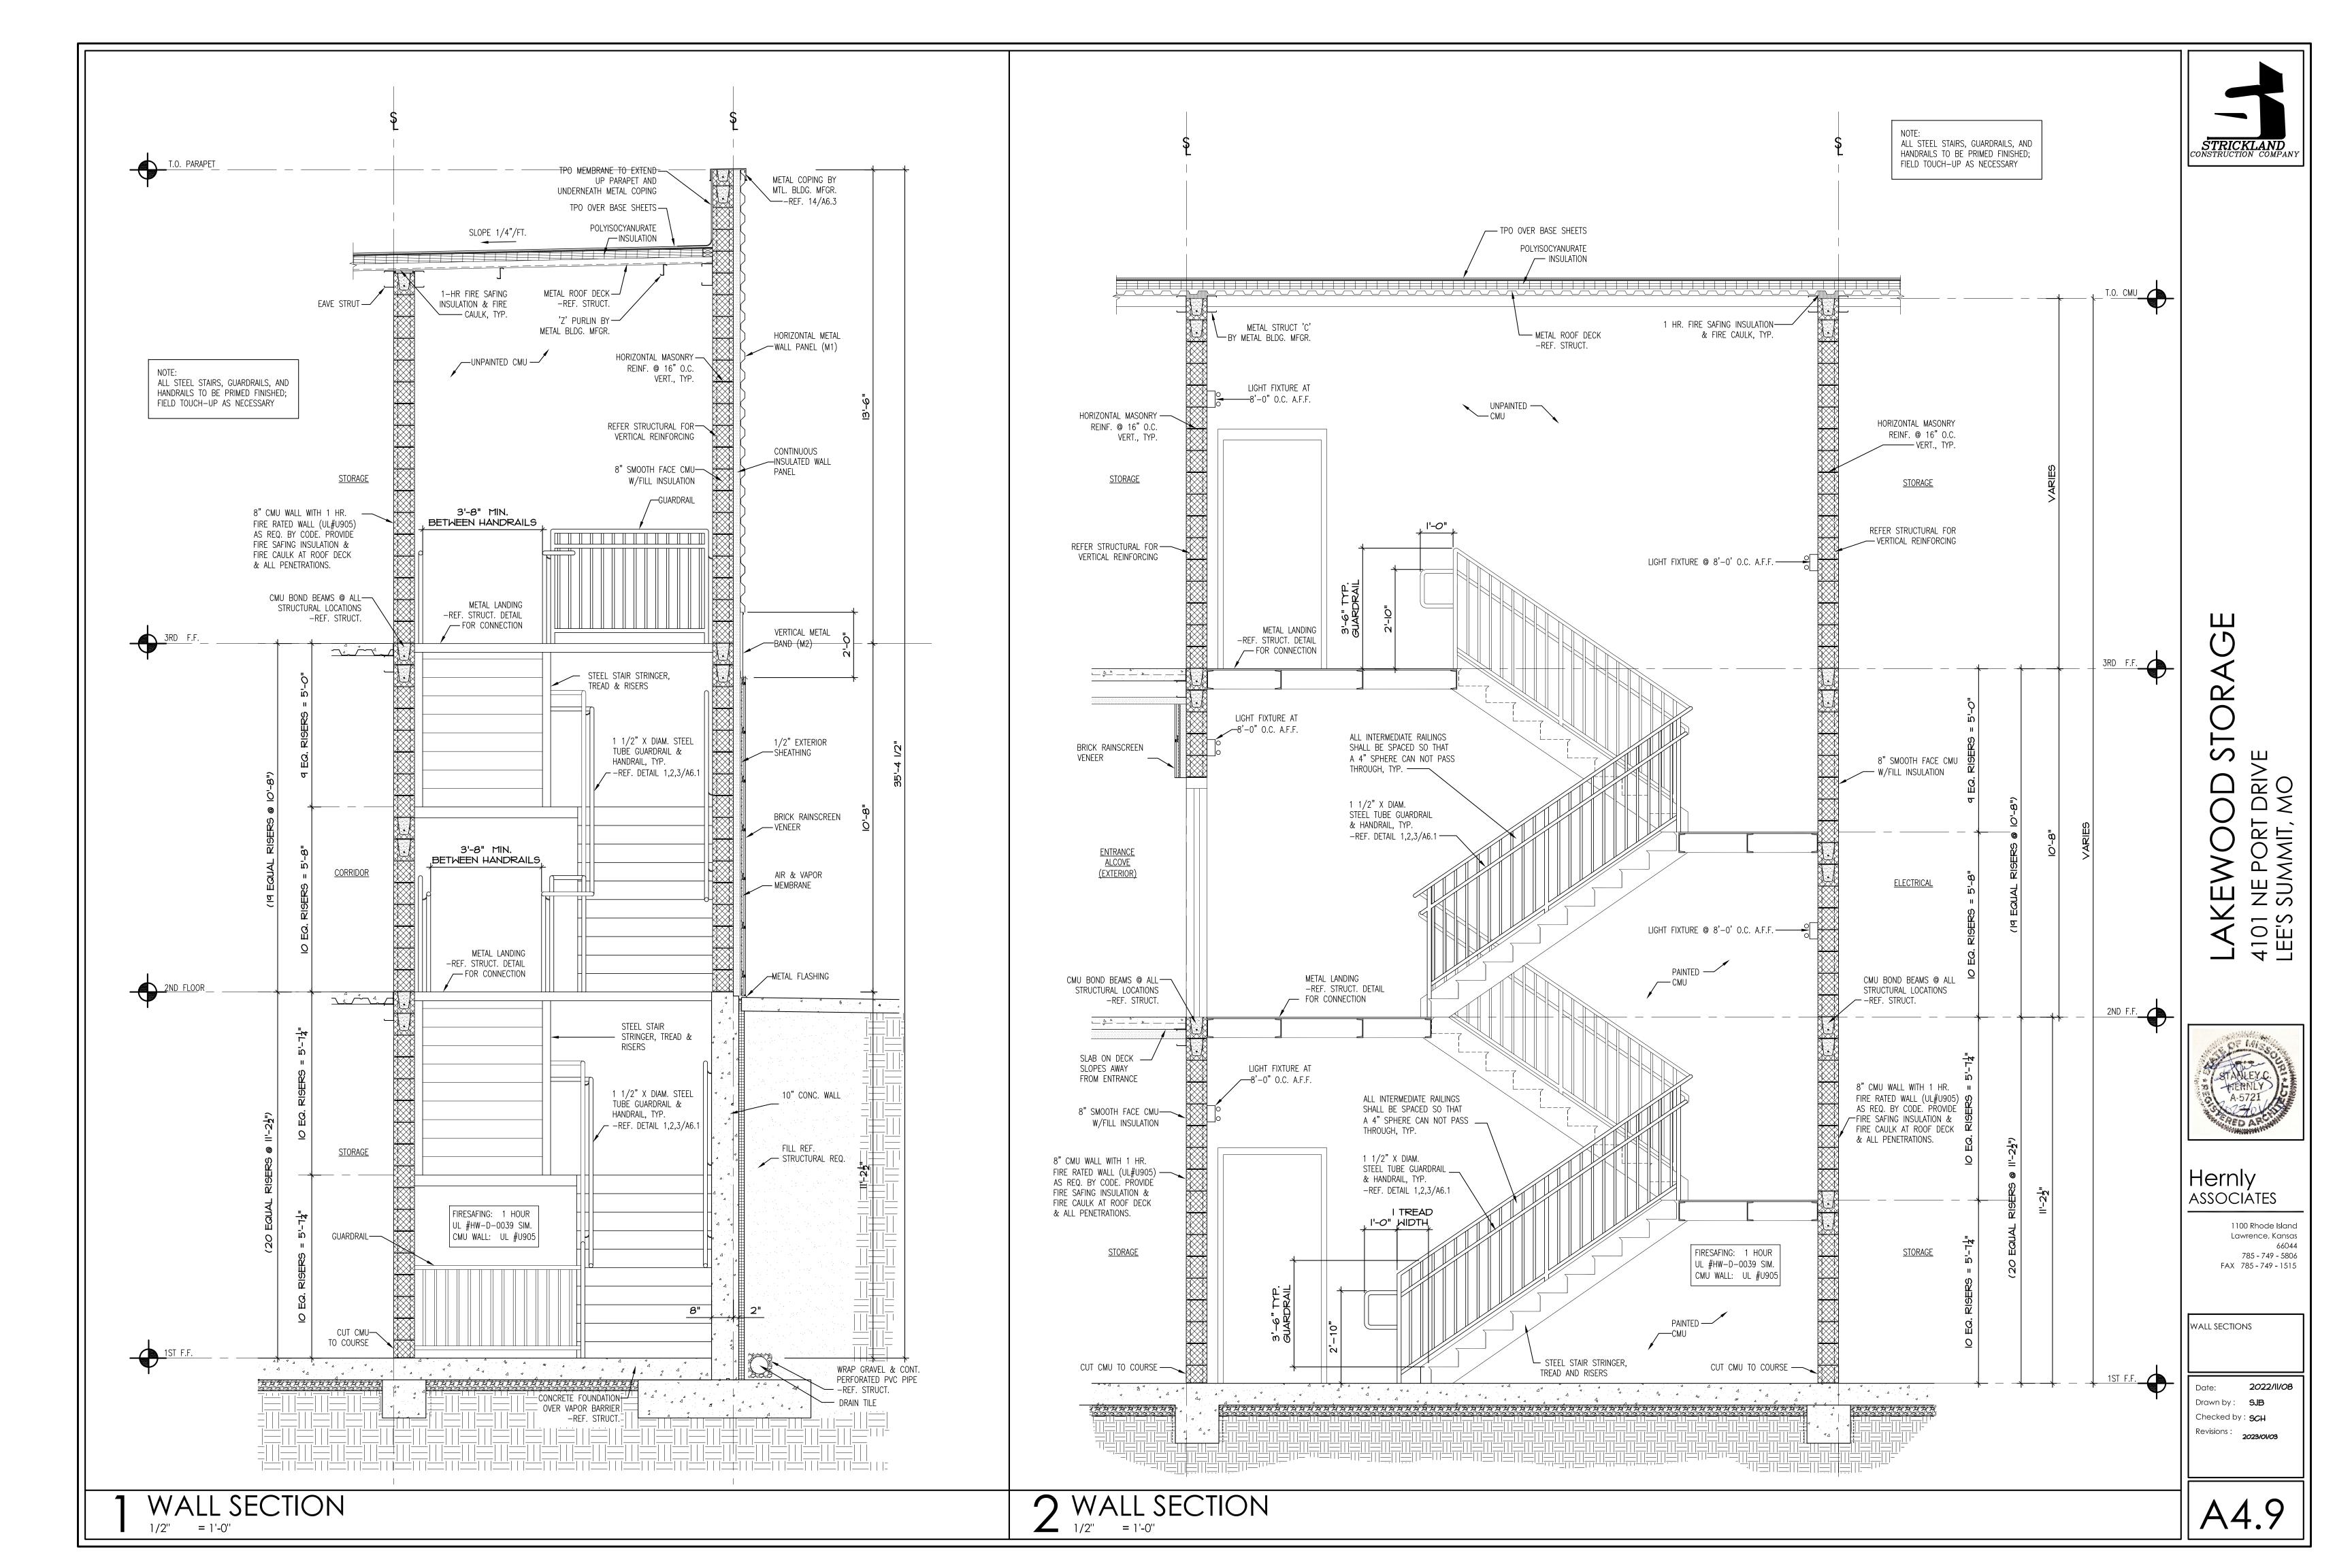17,28

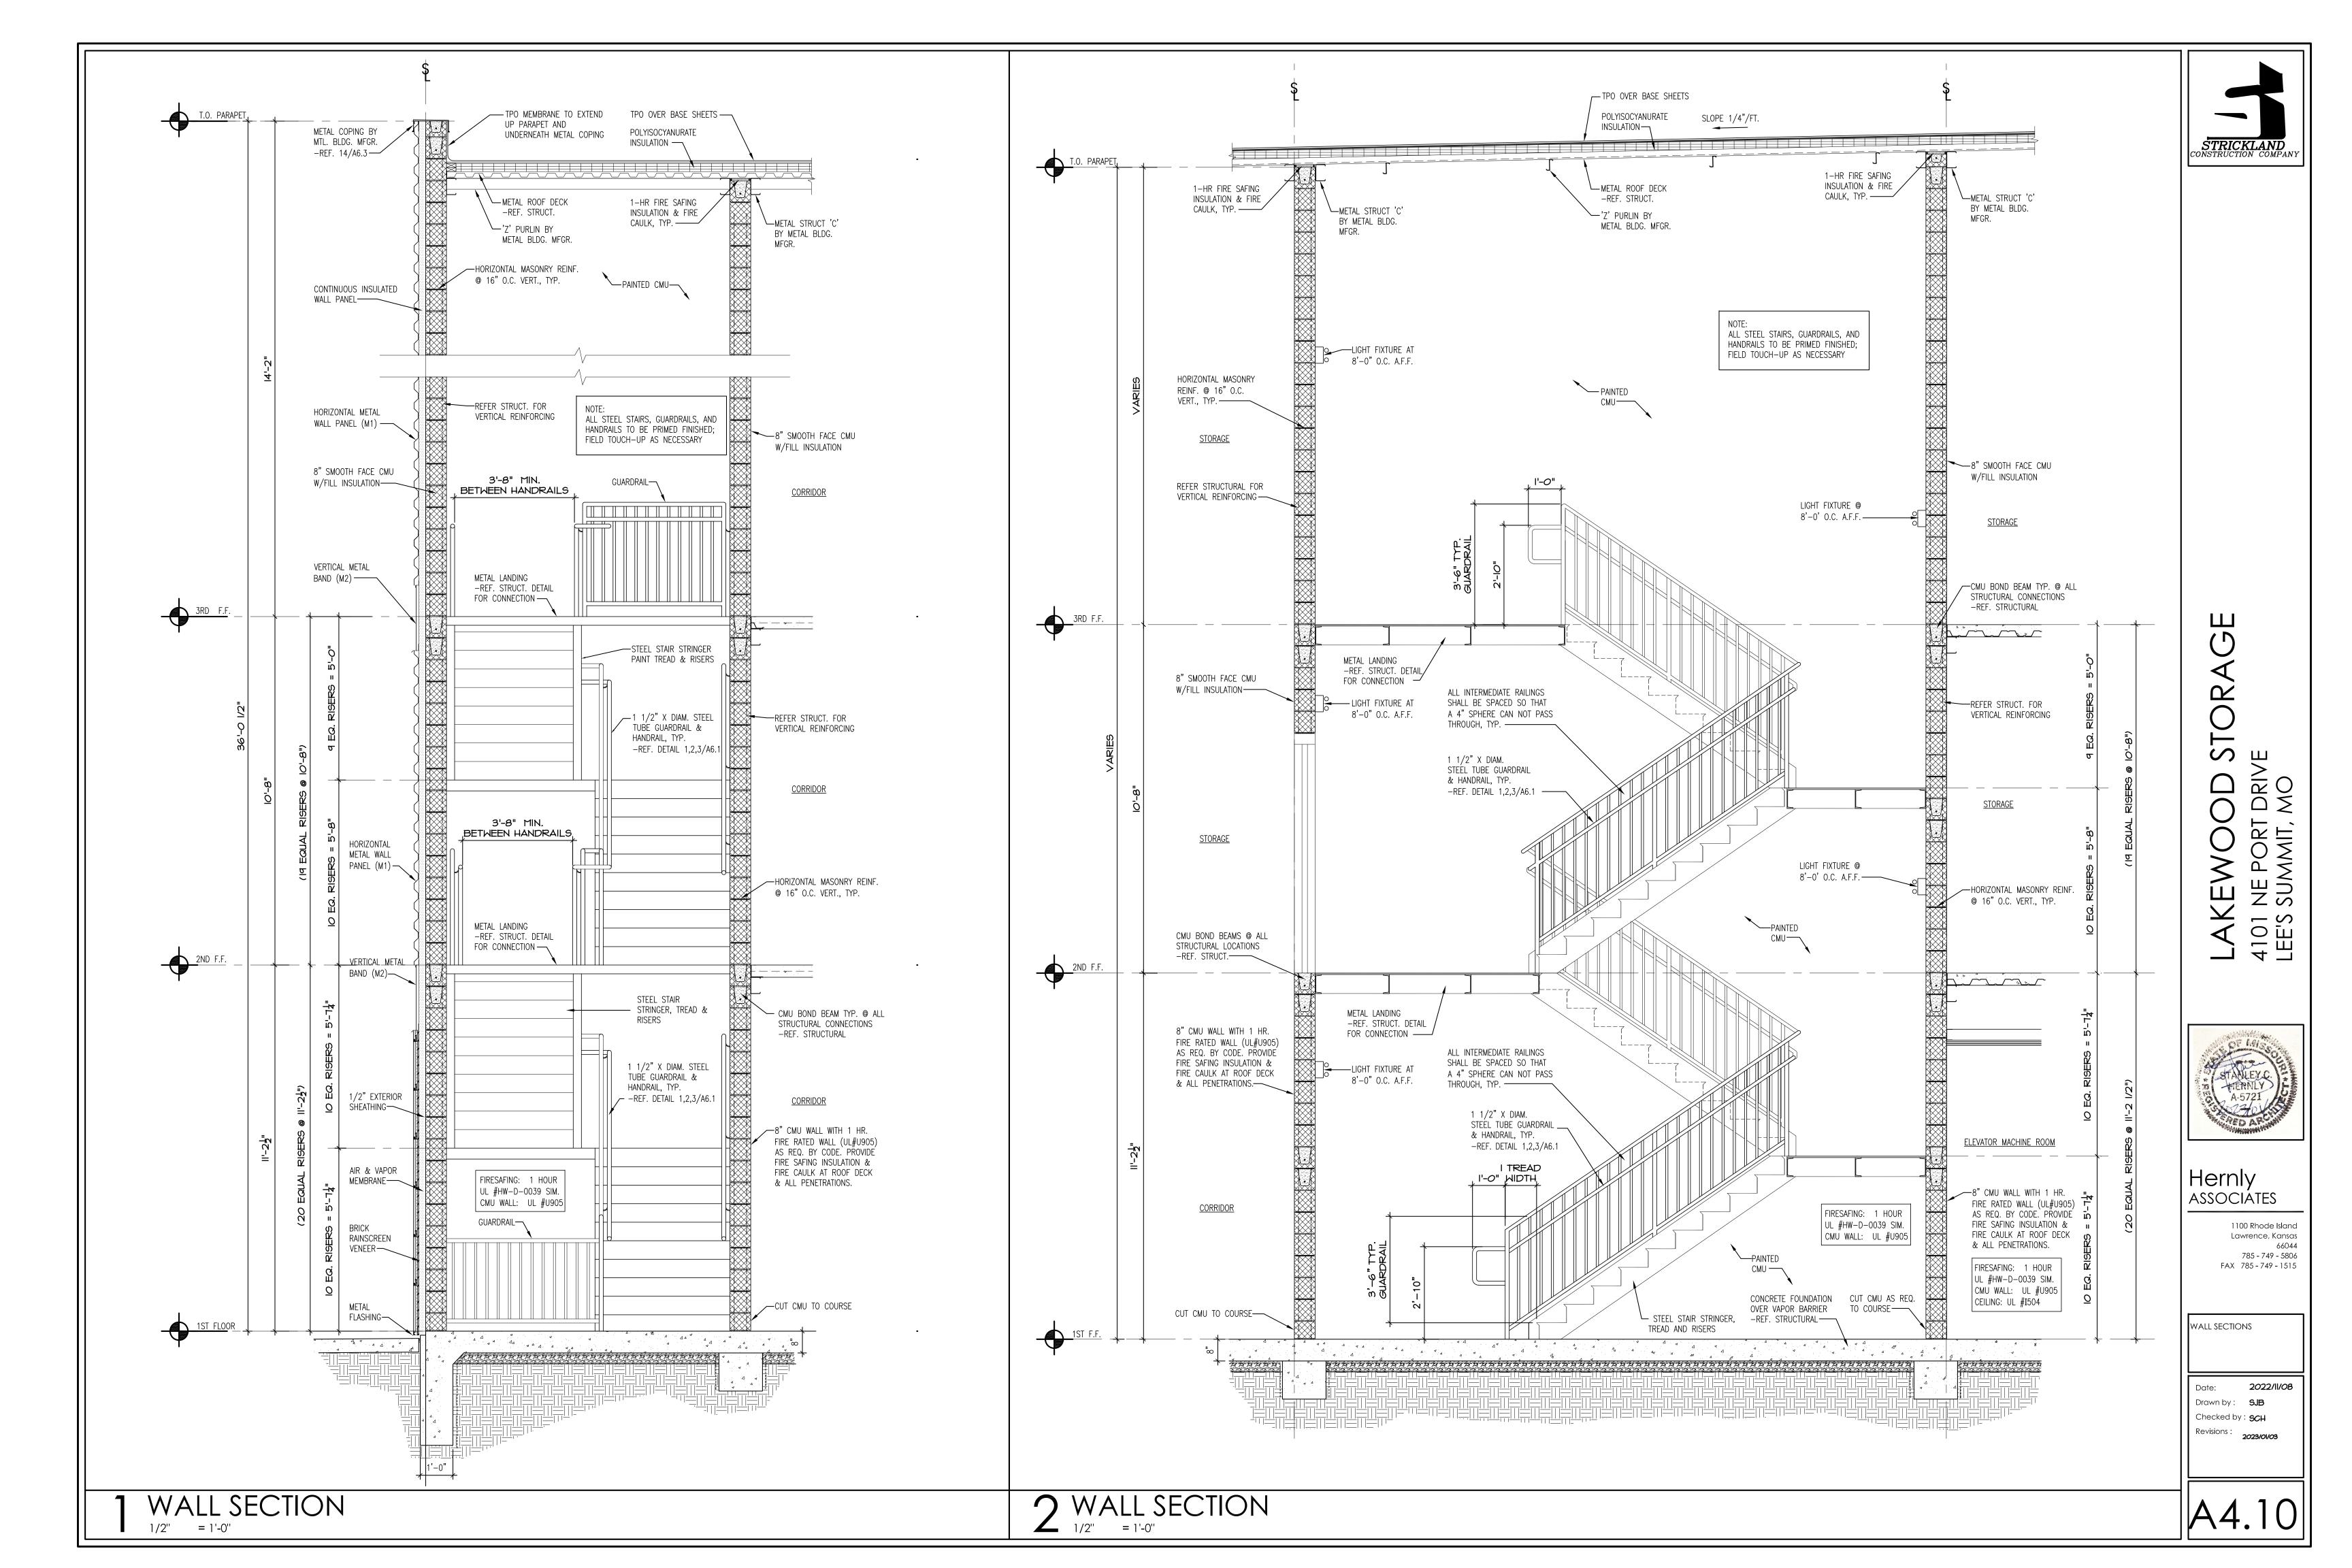17

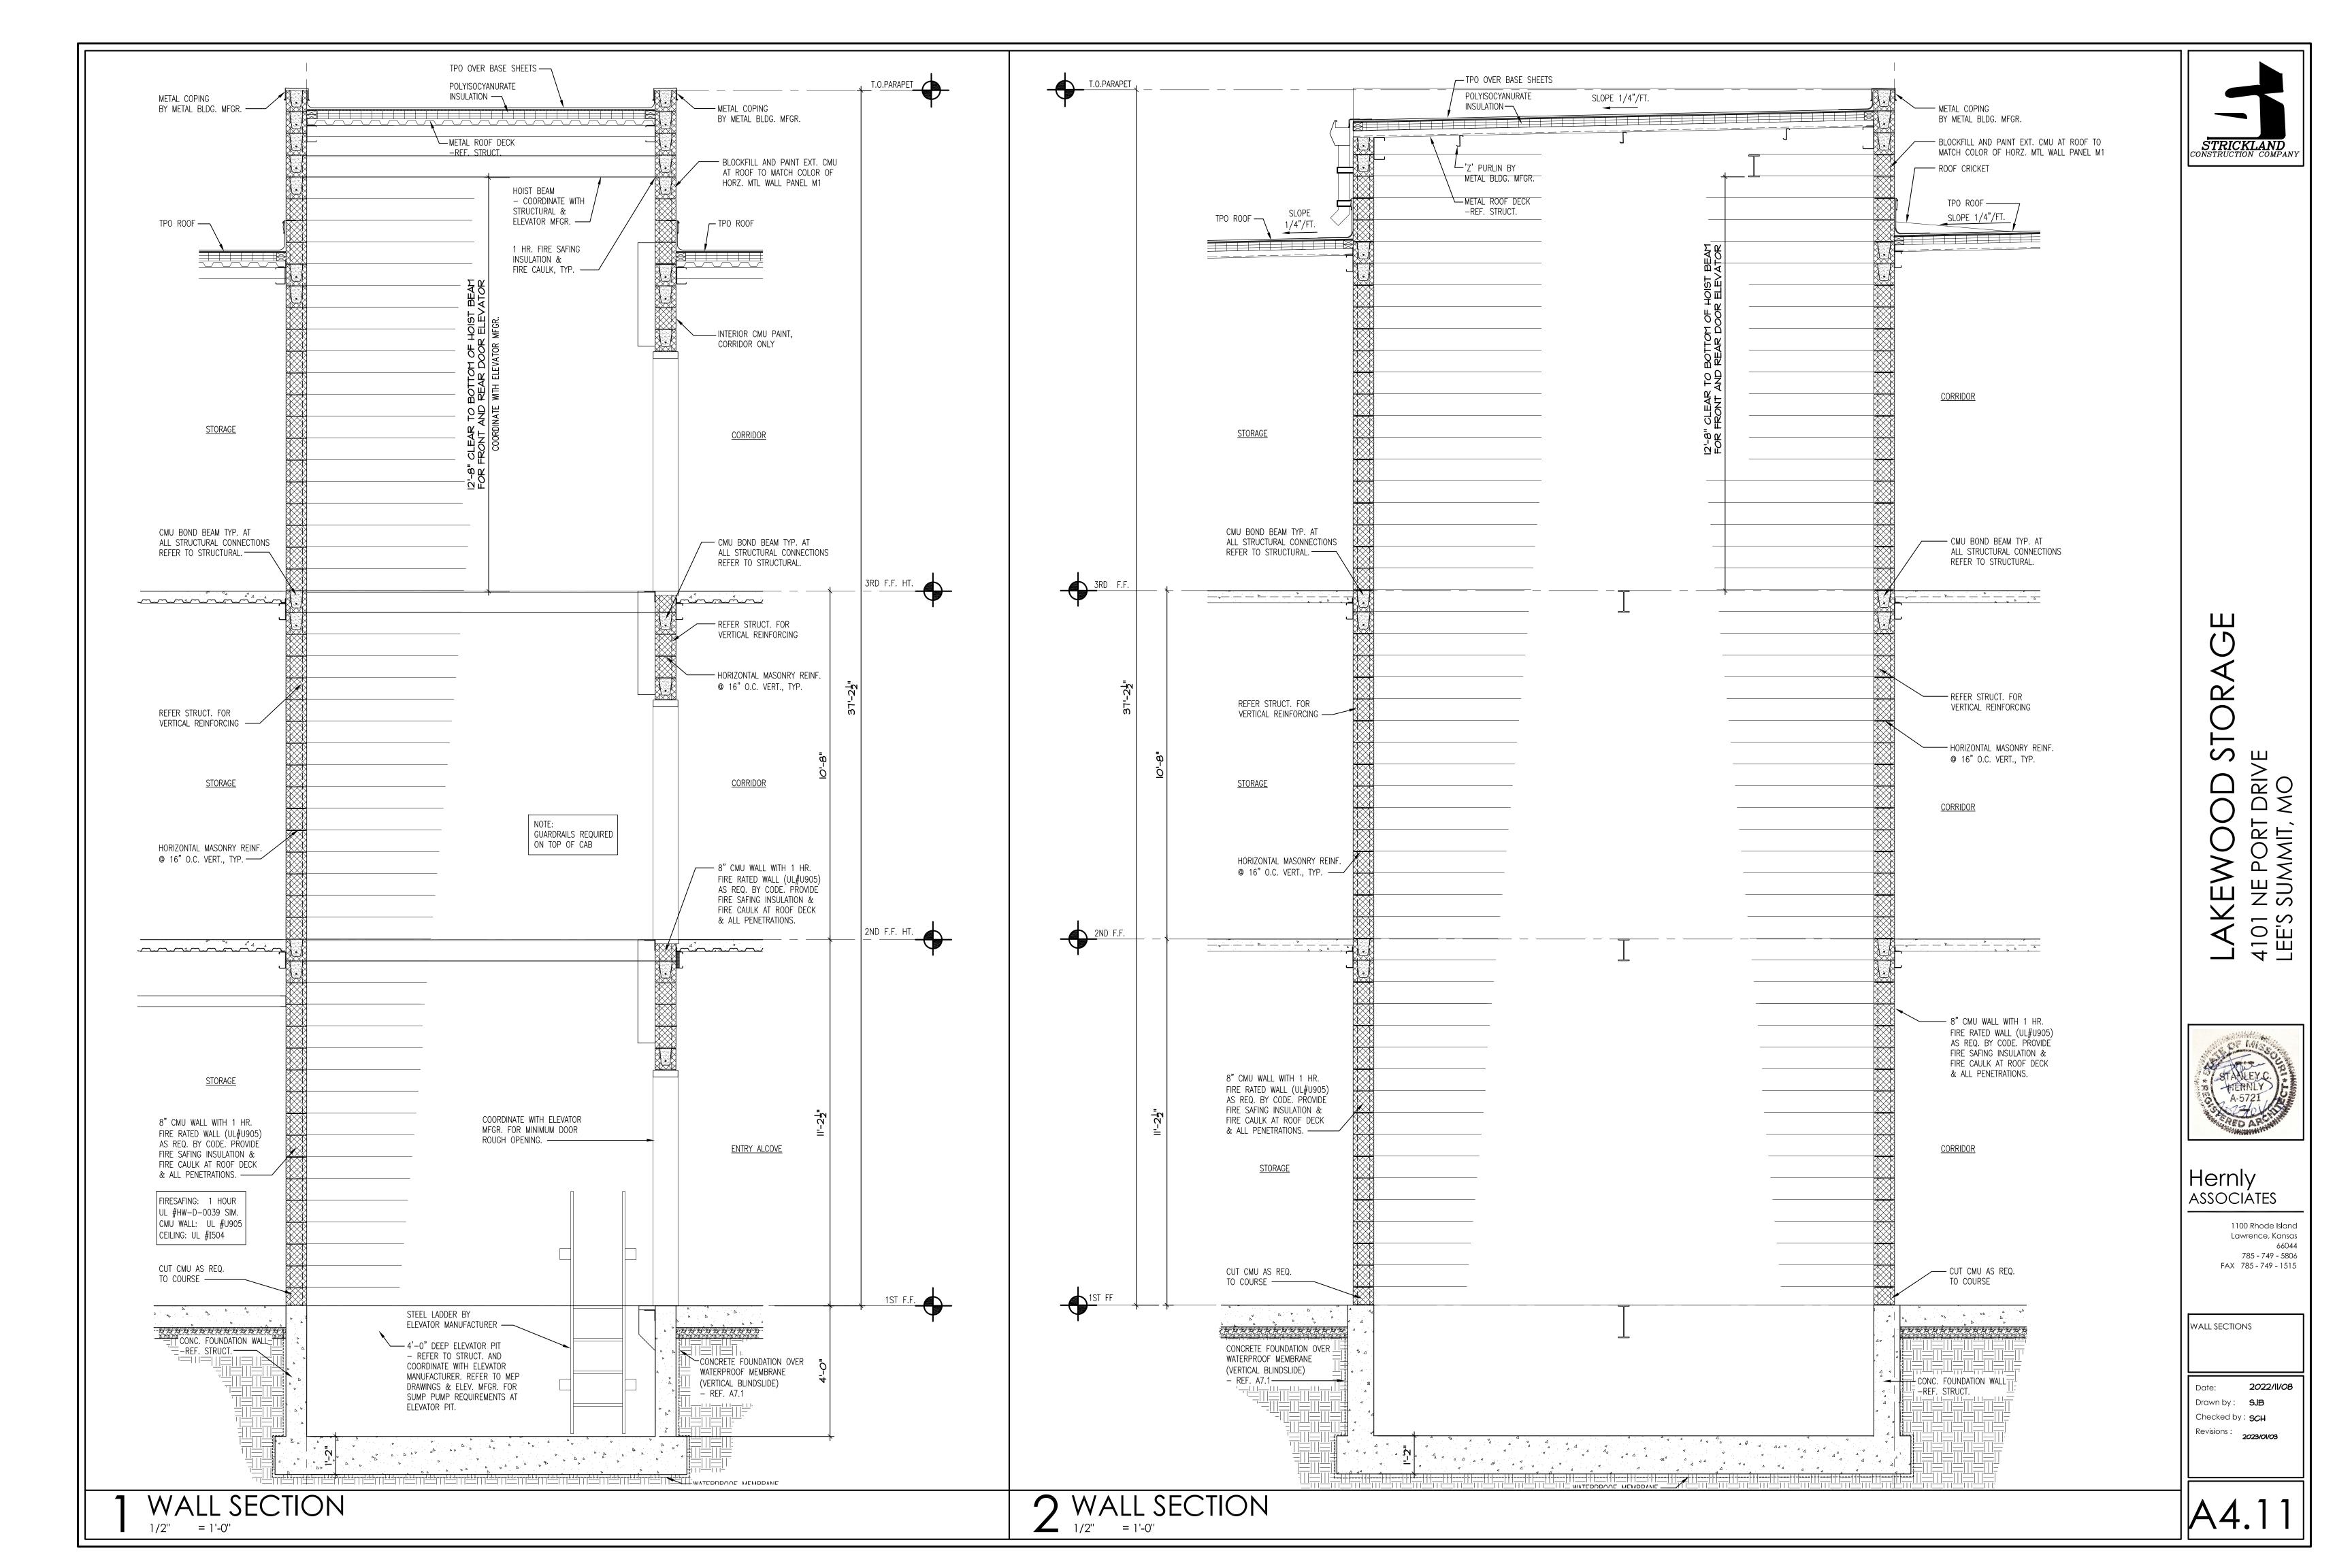9,17

17

17,29

11,15,20

7,10,11,20

11,15,20

11,15,20

11,14,20,24

11,14,20,24

1,2,3,5,8,9,11,15,16,17,18,23

1,2,3,4,10,11,12,13,16,19,24

1,2,3,8,10,11,12,16,19,24

1,2,3,8,10,11,12,16,19,24

1,2,6,10,11,19,24

2,3,8,10,11,12,16,20

2,3,8,10,11,12,16,20

2,3,8,10,11,12,16,20

2,3,8,10,11,12,16,20

1,2,6,10,11,19,24

3,13,19,21,22,27

1,2,6,10,11,19,24

1,2,6,10,11,19,24

1,2,6,10,11,19,24

1,2,24,25

17: COLOR: REF. SHEET A7.1 18: DOOR SIGNAGE @ ENTRY

IDENTIFYING ROOMS

21: STANLEY ACCESS CONTROL

16: DOOR SWEEP

(REF. NOTE 9) 19: DOOR SIGNAGE @ EXITS (REF. NOTE 11) 20: DOOR SIGNAGE @

(REF. NOTE 12)

1,2,3,4,10,11,12,13,16,19,24

1,2,3,8,10,11,12,16,19,24

1,2,3,8,10,11,12,16,19,24





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SCHEDULES


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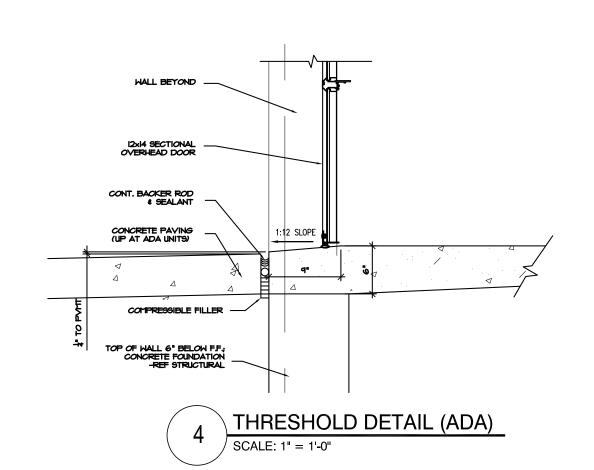
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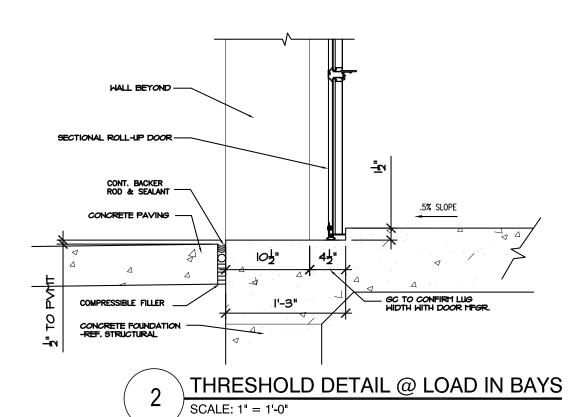


/ SCALE: 1 1/2" = 1'-0"



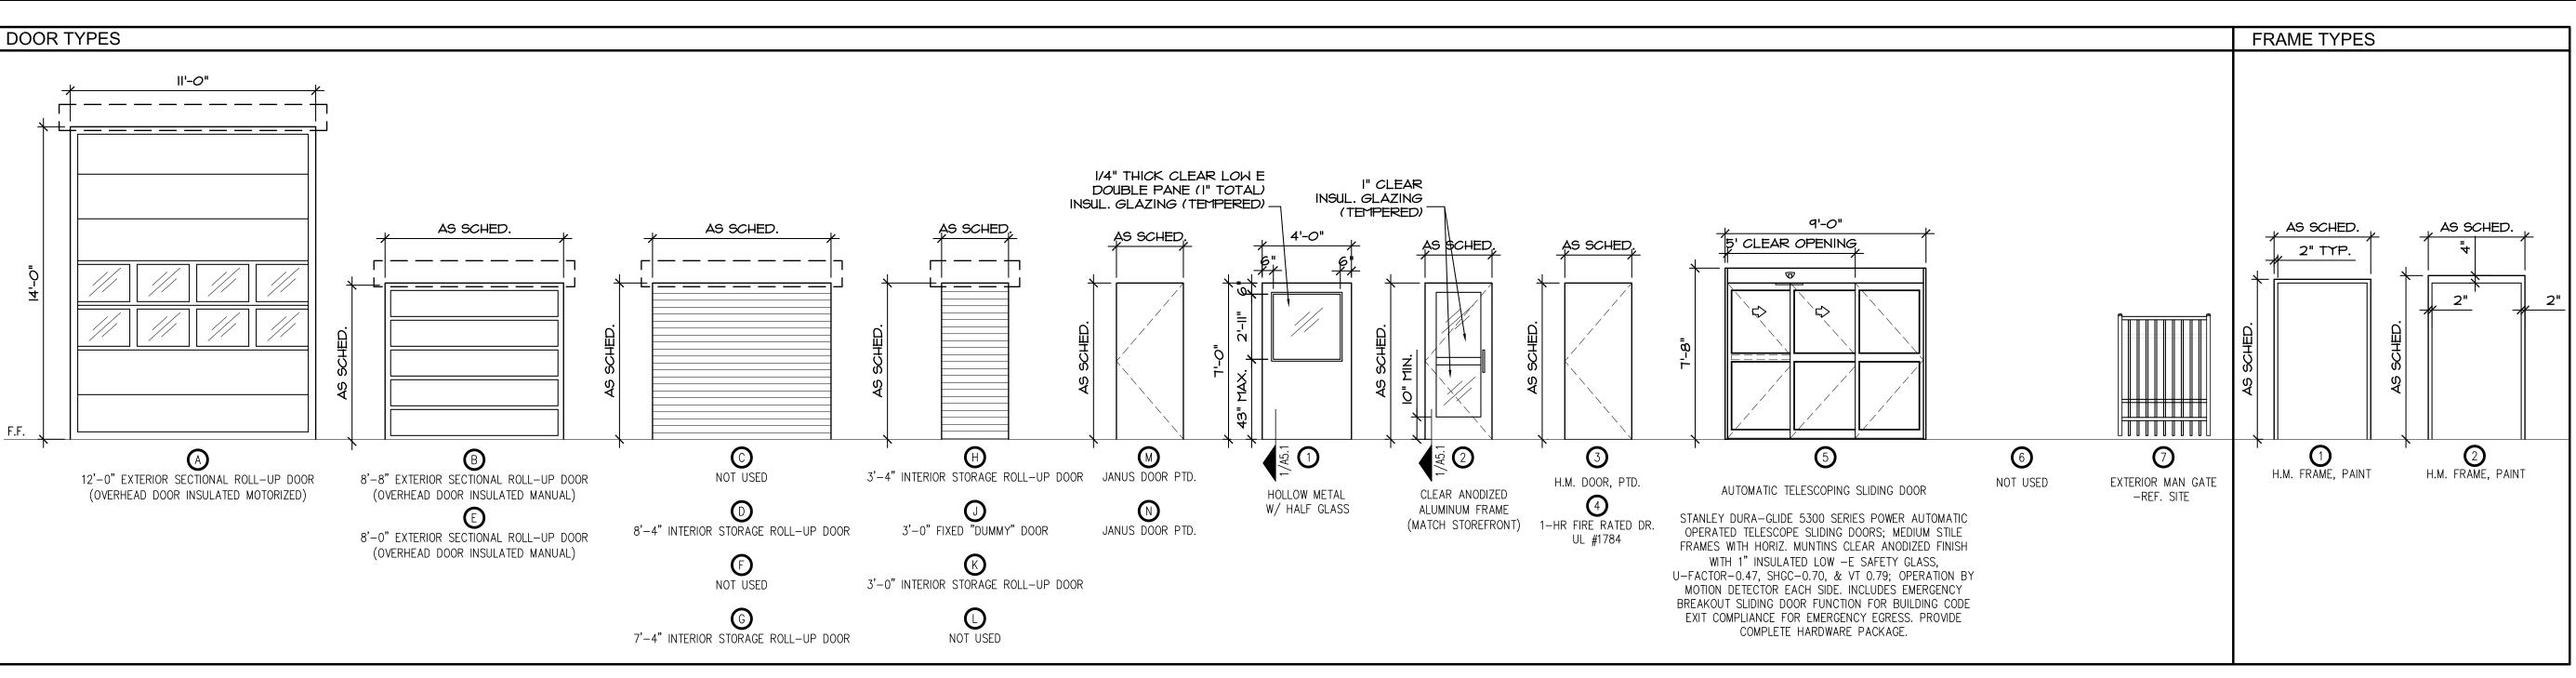

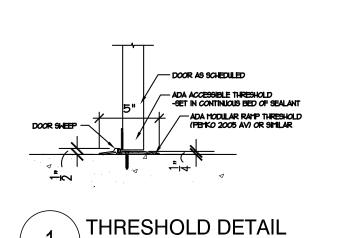SCALE: 1" = 1'-0"

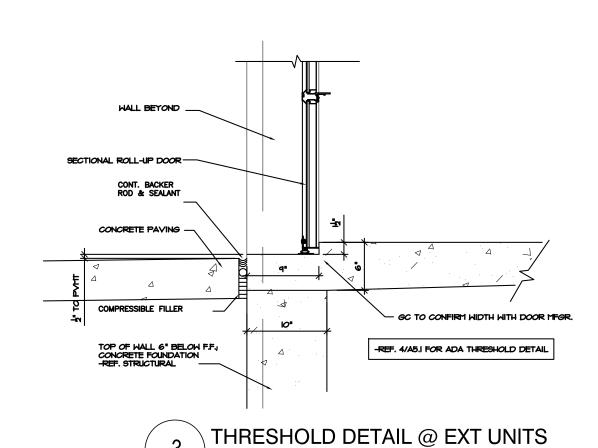

FINISH SCHEDULE											
		FLOOR		WALLS				CEILING		KEYED	
FIRST FLOOR		MATERIAL	BASE	NORTH	SOUTH	EAST	WEST	HEIGHT	TYPE	NOTES	
	101	SALES AREA	SC	RUBBER	PT-1	PT-1	-	PT-1	-	ES	-
	102	RECEPTION DESK	SC	RUBBER	PT-1	PT-1	PT-1/PT-2	-	1	ES	-
	103	MDF / BREAK ROOM	SC	RUBBER	PT-1	PT-1	PT-1	PT-1	8'-0"	LAY-IN	
빙	104	AHU ROOM	SC	-	PT-1	PT-1	PT-1	PT-1	-	ES	
FFI	105	DISPLAY AREA	SC	RUBBER	PT-1	PT-1	PT-1	PT-1	-	ES	2
ō	106	MENS T.R.	PFT	-	PT - 3	PT-3	PT - 3	PT-3	8'-0"	LAY-IN	1
	107	WOMENS T.R.	PFT	-	PT-3	PT-3	PT-3	PT-3	8'-0"	LAY-IN	1
	108	DRINKING FOUNTAIN	SC	ī	JANUS	JANUS	JANUS	JANUS	=	ES	-
	109	LOADING AREA	sc	-	JANUS	JANUS	JANUS	JANUS	-	ES	-
KEYED NOTES: 1. SMOOTH, HARD, NON-ABSORBANT FINISH REQ'D UP TO 48" (EPOXY PAINT TYP. @ ALL RESTROOMS) 2. DUMMY DOORS PER FLOOR PLANS. GENERAL NOTES: A. GENERAL CONTRACTOR TO SUBMIT ALL LEGEND: ES EXPOSED STRUCTURE GRID 2X2 CEILING GRID ONLY GYP 5/8" TYPE 'X' GYPSUM BOARD JANUS JANUS WALL SYSTEM LAY-IN 2x2 LAY-IN ACOUSTICAL CEILING PT-1 INTERIOR OFFICE PAINT											

PT-2

PT-3

WD

RUBBER

RUBBER WALL BASE

SEALED CONCRETE

PAINTED WOOD BASE

EPOXY PAINT

INTERIOR OFFICE PAINT - ACCENT

I" INSULATED ALUM. STOREFRONT 9" 4" 9 POINT HEEL BEAD SEALANT F.F.
TT Z Z Z Z Z Z Z Z Z Z Z Z Z Z Z Z Z Z
STOREFRONT DETAIL

SCALE: 1 1/2" = 1'-0"

FINISH SELECTIONS TO OWNER AND

3. REF. SHEET A7.1 FOR SPECIFICATIONS.

C. GENERAL CONTRACTOR TO PROVIDE ALLOWANCE

FOR CERAMIC TILE IN ROOMS 101-105 AS AN

ARCHITECT FOR APPROVAL PRIOR

TO ORDERING

ALTERNATE

D	OOR	NOTES	
			_

- I: DOOR HARDWARE TO BE APPROVED BY OWNER BASED ON SUBCONTRACTOR SUBMITTAL.
- 2: CONTRACTOR TO COORDINATE DOOR HARDWARE AND FRAMES WITH SECURITY EQUIPMENT AND MAGNETIC HOLD OPEN DEVICES.
- 3: PROVIDE MIN. INTERIOR & EXTERIOR ACCESSIBLE HARDWARE, THRESHOLDS, SIGNAGE, ETC. TO COMPLY W/ ADA ACCESSIBILITY STANDARDS. REFERENCE FLOOR PLANS FOR LOCATIONS.
- 4: NOT USED
- 5: NOT USED
- 6: STORAGE ROLL-UP DOORS-PROVIDE ALUM. HANDLES W/ SLIDE BAR LATCH TO FRAME, CONTINUOUS ALUM. BOTTOM PULL BAR, WEATHER SEALS (EXTERIOR) AND REMOVABLE CYLINDER LOCK W/ EMERGENCY OVERRIDE LATCH OPERATOR TO OPERATOR.
- 7: GLAZING IN ALL EXTERIOR DOORS TO BE INSULATED LOW-E GLAZING W/ 1/4" DOUBLE PANES W/ 1/2" AIR SPACE (1" TOTAL) (TEMPERED).
- 8. THRESHOLDS $1\frac{1}{2}$ " LUGS NOT REQUIRED AT ALCOVE ENTRIES.
- 9. READILY VISIBLE DURABLE SIGN POSTED ON THE EGRESS SIDE ON OR ADJACENT TO THE DOOR STATING: "THIS DOOR TO REMAIN UNLOCKED WHEN BUILDING IS OCCUPIED" -REF. SHEET A2.6 FOR INSTALLATION INSTRUCTIONS.
- 10. FIRE RATED DOORS TO BE SELF CLOSING OR AUTOMATIC CLOSING.
- 11. READILY VISIBLE DURABLE SIGN POSTED ON EGRESS SIDE ADJACENT TO DOOR STATING: "EXIT" IN TACTILE LETTERS (BRAILLE -REF SHE
- 12. READILY VISIBLE DOOR STATING "R BRAILLE - REF. SH
- 13. ROLL UP DOORS
- 14. CONSTRUCTION KEYING BY OWNE
- 15. 3'-0" CLEAR MAN MESH AT GATE AI OF EITHER SIDE REQUIREMENTS.
- 16. SLIDING DOOR C ADJACENT.
- 17. DOORS TO COMP
- 18. DOORS TO COM

)			4
OOR STATING: "EXIT" IN TACTILE LETTERS & HEET A2.6 FOR INSTALLATION INSTRUCTIONS.	STAIR B - 1ST FLR	10	3'-0"	7'-0"	
E DURABLE SIGN POSTED ON ENTRY SIDE OF	STAIR B - EXIT	11	3'-0"	7'-0"	
ROOM NAME" IN TACTILE LETTERS AND	ELEV. ACCESS	(12N)	3'-0"	7'-0"	
HEET A2.6 FOR INSTALLATION INSTRUCTIONS.	ELEV. ACCESS	(12S)	3'-0"	7'-0"	
S TO MEET LOCAL WIND LOAD REQUIREMENTS.	ELECTRICAL ROOM	13	3'-0"	7'-0"	
I CORES TO REMAIN - REKEYING/MASTER	FIRE RISER ROOM	14)	6'-0" PR	7'-0"	
NER	ALCOVE ENTRY	15)	4'-0"	7'-0"	
I GATE - ORNAMENTAL IRON APPLIED METAL SECURITY AND ADJACENT FENCE PANEL EXTEND FULL LENGTH	STAIR A - 1ST FLR	16	3'-0"	7'-0"	
OF LOCKSET. LEVER HARDWARE PER ADA	STAIR A - EXIT	17	3'-0"	7'-0"	
b.	STAIR A	18	3'-0"	7'-0"	
OPENING TO BE ON SAME SIDE AS MAN DOOR	SLIDING DOOR	19	9'-0"	7'-8"	
APLY WITH ENERGY CODES SHOWN ON SHEET A7.1.	STAIR B - 2ND FLR	20	3'-0"	7'-0"	
	STAIR A - 3RD FLR	21)	3'-0"	7'-0"	
MPLY WITH LOCAL WIND LOAD CAPACITY.	STAIR B - 3RD FLR	22	3'-0"	7'-0"	
	MAN GATE	23	3'-0"	6'-0"	
		DEM	ADKC		

WAN GATE	٩	0-0	0-0	
		ARKS:: ANIC HA	RDWARE	=

LOCATION

MDF ROOM

AHU ROOM

OFFICE ENTRY

OFFICE / LOADING

OFFICE / STORAGE

TOILET ROOM

TOILET ROOM

LOADING EXIT

ALCOVE ENTRY

2: DOOR CLOSER
3: WEATHER STRIPPING
/ THRESHOLD
-REF. DETAIL 1/A5.1
4: MAGNETIC HOLD OPEN

DOORS W/ 15 MINUTE TIMER 5: DEADBOLT 6: FIRE RATED - 1-HR

STORAGE DOOR SCHEDULE

11'-0" 14'-0" EXT. SECT.

(B) 8'-8" 8'-0" EXT. SECT.

(M) 3'-0" 7'-0" JANUS SWING

N 3'-0" 7'-0" JANUS SWING

7'-0"

7'-0"

7'-0"

7'-0"

DOOR SCHEDULE

3'-0" 7'-0"

(2) 3'-0" 7'-0"

3'-0"

3'-0"

3'-0"

3'-0"

4'-0" 7'-0"

3'-0" 7'-0"

MARK WIDTH HEIGHT DOOR TYPE FRAME TYPE REMARKS

NOT USED

NOT USED

NOT USED

MARK WIDTH HEIGHT DOOR TYPE FRAME TYPE REMARKS

3

3

5R

4

4

STFT

7'-0" INT. ROLL-UF

8'-0" EXT. SECT.

7'-0" INT. ROLL-UF

7'-0" INT. ROLL-UP

7'-0" DUMMY DOOR


7'-0" INT. ROLL-UF

- (REF. NOTE 10) 7: VENTED AT AHU LOCATIONS 8: DRIP FLASHING
- 9: FIXED "DUMMY DOORS
- 12: INSULATED 13: KEY PAD 14: TR LOCKSET
- 10: STORAGE LOCKSET 11: DOOR STOP
- 15: OFFICE LOCKSET
- (PANIC BAR & ELECTRIC LOCK) 22: STANLEY TIMER
 - 23: MAIL-SLOT 24: KICKPLATE ON PUSH SIDE 25: MAN GATE KEYSET 26: NOT USED 27: RIGHT HAND OPENING 28: INSULATED SECTIONAL ROLL-UP

29: CLASP ON LATCH PUSH SIDE

30: LEFT HAND OPENING

- 1. VERIFY ALL ROUGH OPENING DIMENSIONS IN RELATION
 TO STRUCTURAL DRAWINGS. FRAME SIZES TO BE
 ADJUSTED AS NECESSARY FOR PROPER SHIM, FLASHING,
 AND THERMAL EXPANSION.
- 2. SAFETY (TEMPERED) GLAZING IS REQUIRED IN AN INDIVIDUAL FIXED OR OPERABLE PANEL ADJACENT TO A DOOR WHERE THE NEAREST EXPOSED EDGE OF THE GLAZING IS WITHIN A 24-INCH ARC OF EITHER VERTICAL EDGE OF THE DOOR IN A CLOSED POSITION AND WHERE THE BOTTOM EXPOSED EDGE OF THE GLAZING IS LESS THAN 60 INCHES ABOVE THE WALKING SURFACE (IBC 2406.3.6).
- 3. STOREFRONT INSULATED LOW-E GLAZING TO BE 1/4" DOUBLE PANES WITH 1/2" AIR SPACE(1" TOTAL)(TEMPERED).
- 4. EXTERIOR INSULATED LOW-E GLAZING TO BE 1/4" DOUBLE PANES WITH 1/2" AIR SPACE (1" TOTAL) (TEMPERED).
- 5. FLASH AND WEATHERSTRIP ALL EXTERIOR WINDOWS TO PROVIDE WATER RESISTANT ASSEMBLY.
- 6. WINDOW DIMENSION @ FIRST FINISHED FLOOR IS FROM LUG TO SILL.
- 7. WINDOW AND DOOR DIMENSIONS ARE ROUGH OPENINGS. DOORS, FRAMES, WINDOWS, ETC. ARE TO BE SIZED TO ALLOW SHIMS AND TOLERANCES TO MEET INDUSTRY STANDARDS AND THERMAL EXPOSION (DEFINE IN SHOP DRAWINGS).
- 8. STOREFRONTS TO BE ANODIZED ALUMINUM.

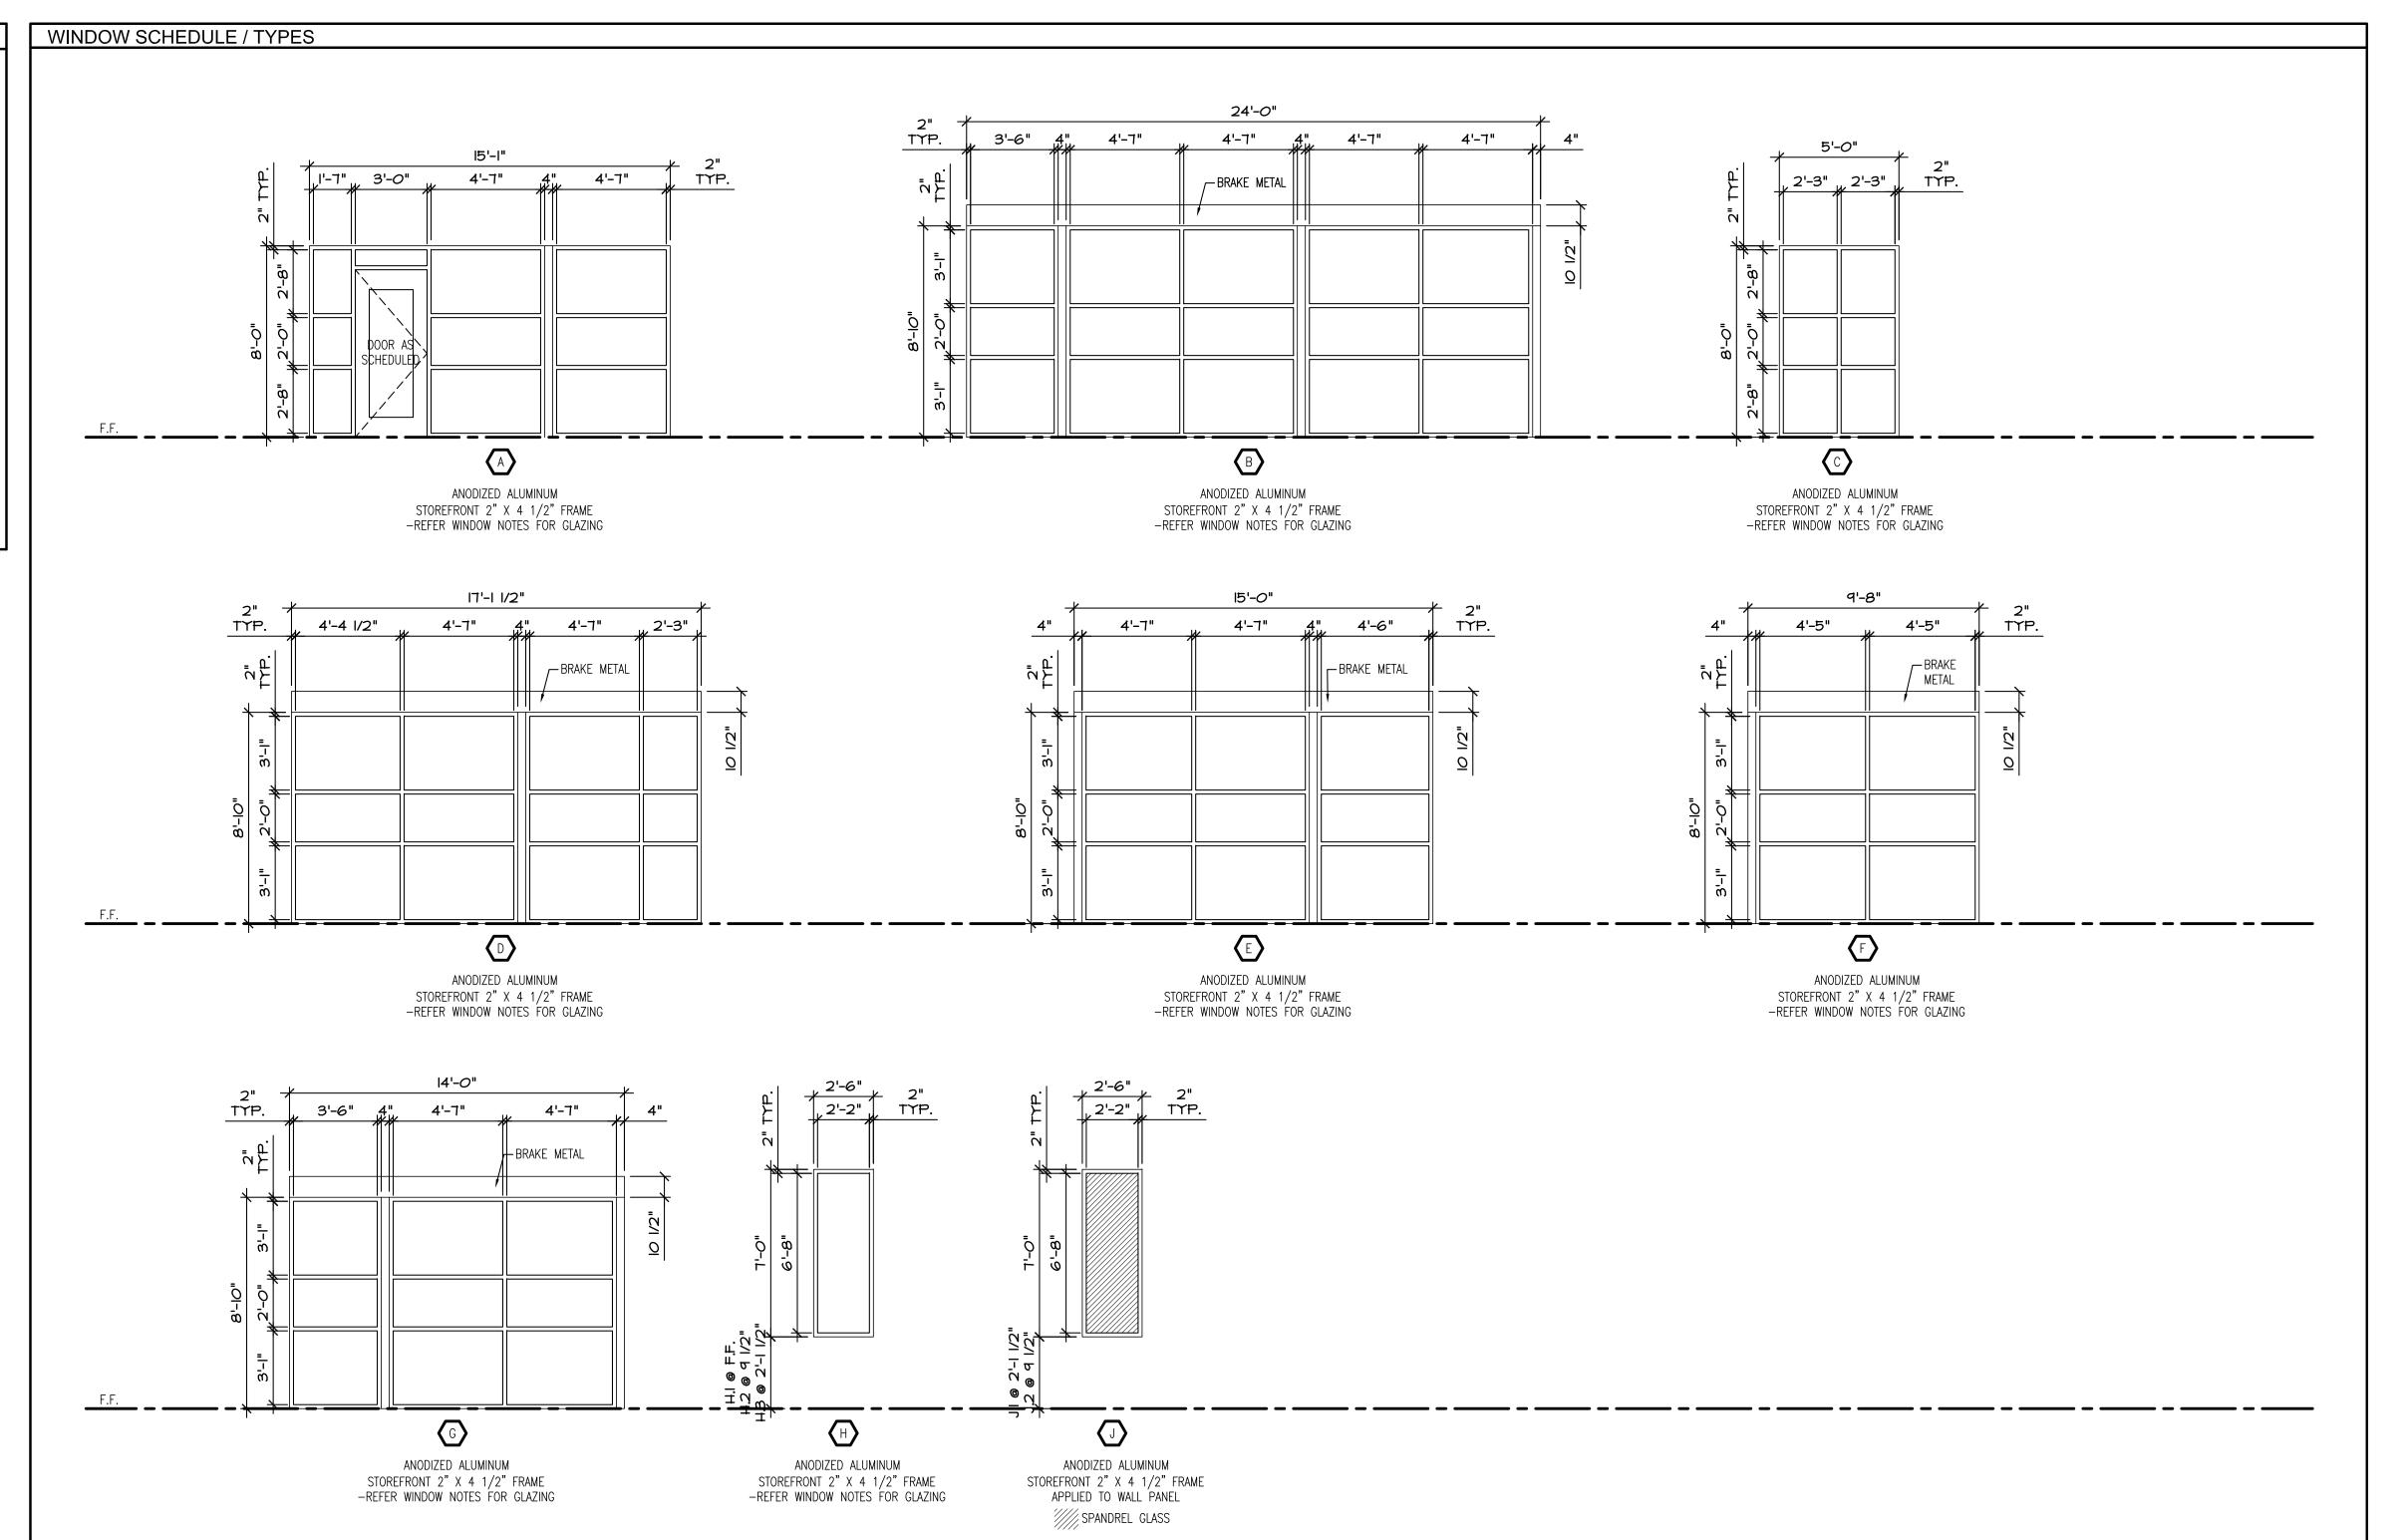



LAKEWOOD STORAGE
4101 NE PORT DRIVE
LEE'S SUMMIT, MO




Hernly ASSOCIATES

> 1100 Rhode Island Lawrence, Kansas 66044 785 - 749 - 5806 FAX 785 - 749 - 1515

SCHEDULES

Date: 2022/II/08
Drawn by: SJB
Checked by: SCH
Revisions:

A6.2

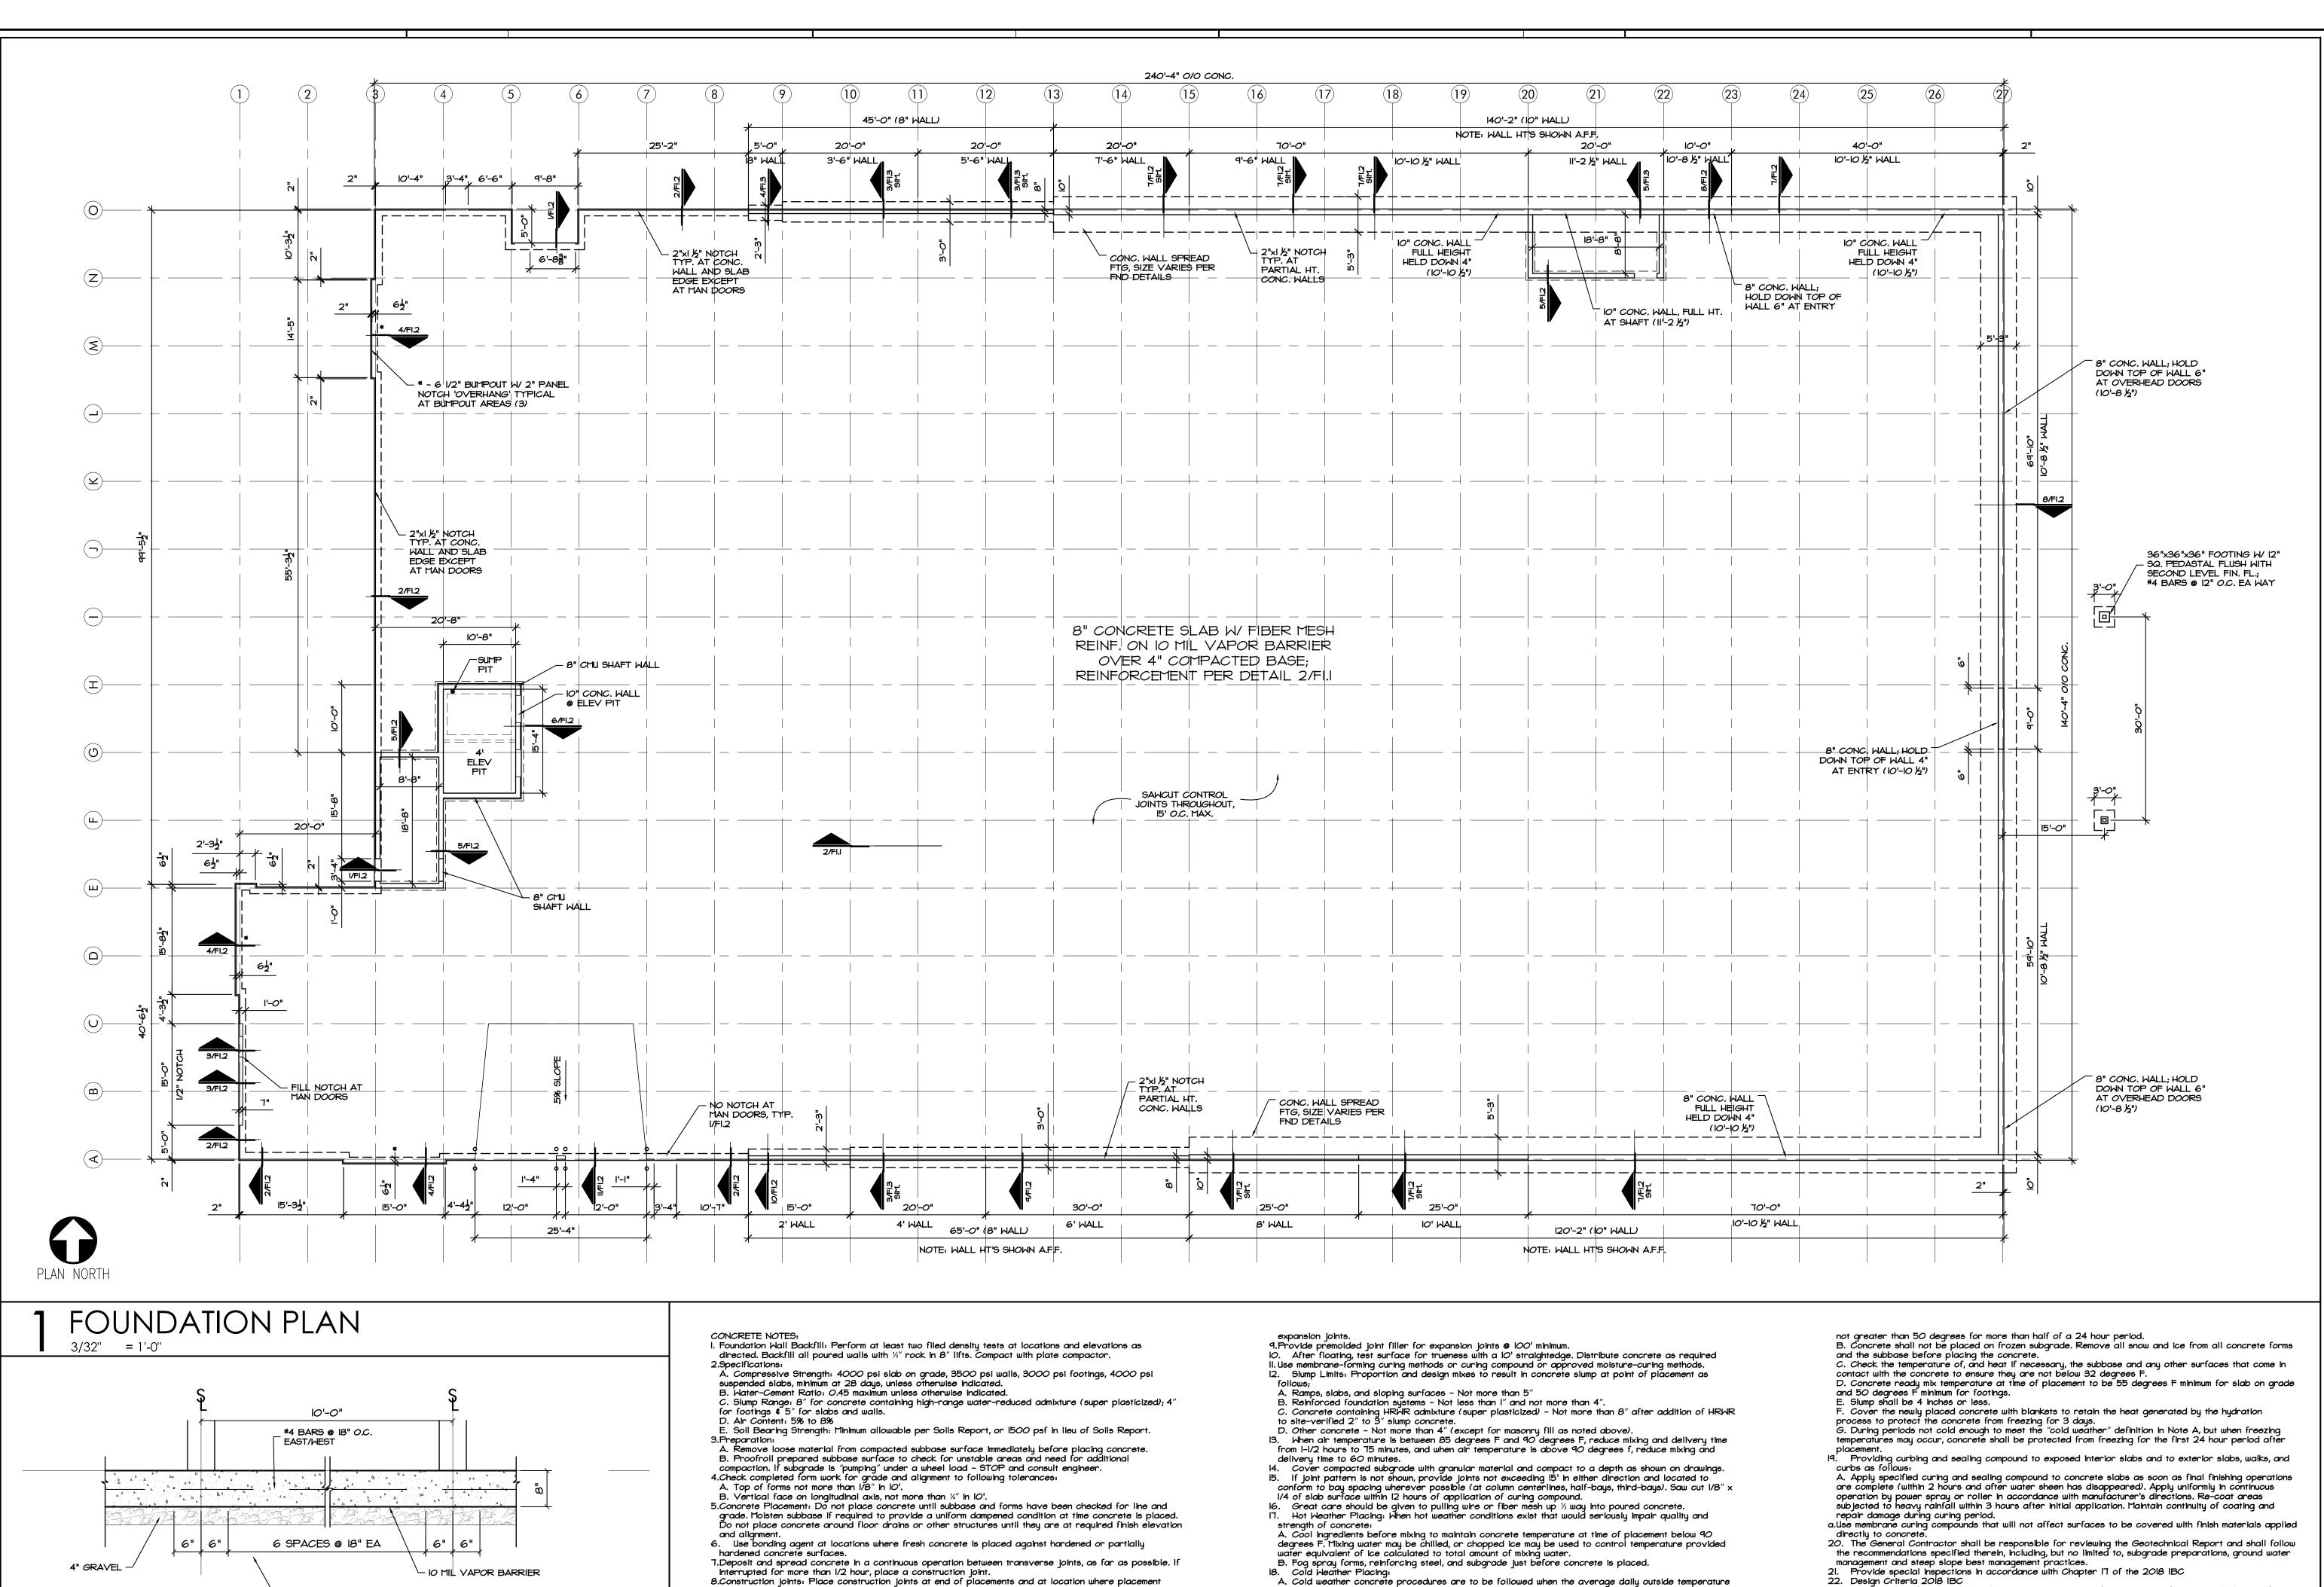

(average over 24 hour period) is below 40 degree for three consecutive days, and the temperature is

operations are stopped for a period of more than 1/2 hour, except where such placements terminate at


FOUNDATION NOTES

- #4 BARS SPACING NORTH/SOUTH

? SLAB REINFORECEMENT DETAIL

STRICKLAND

LAKEWOOD STORAGE
4101 NE PORT DRIVE
LEE'S SUMMIT, MO

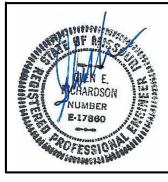

Hernly ASSOCIATES


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FOUNDATION PLAN CONC NOTES

Date: 2022/II/08
Drawn by: SJB
Checked by: SCH
Revisions: 2023/01/03

F1 1

23. Design values for allowable soil pressure are 2,000 psf at continuous footings and 2,500 psf at

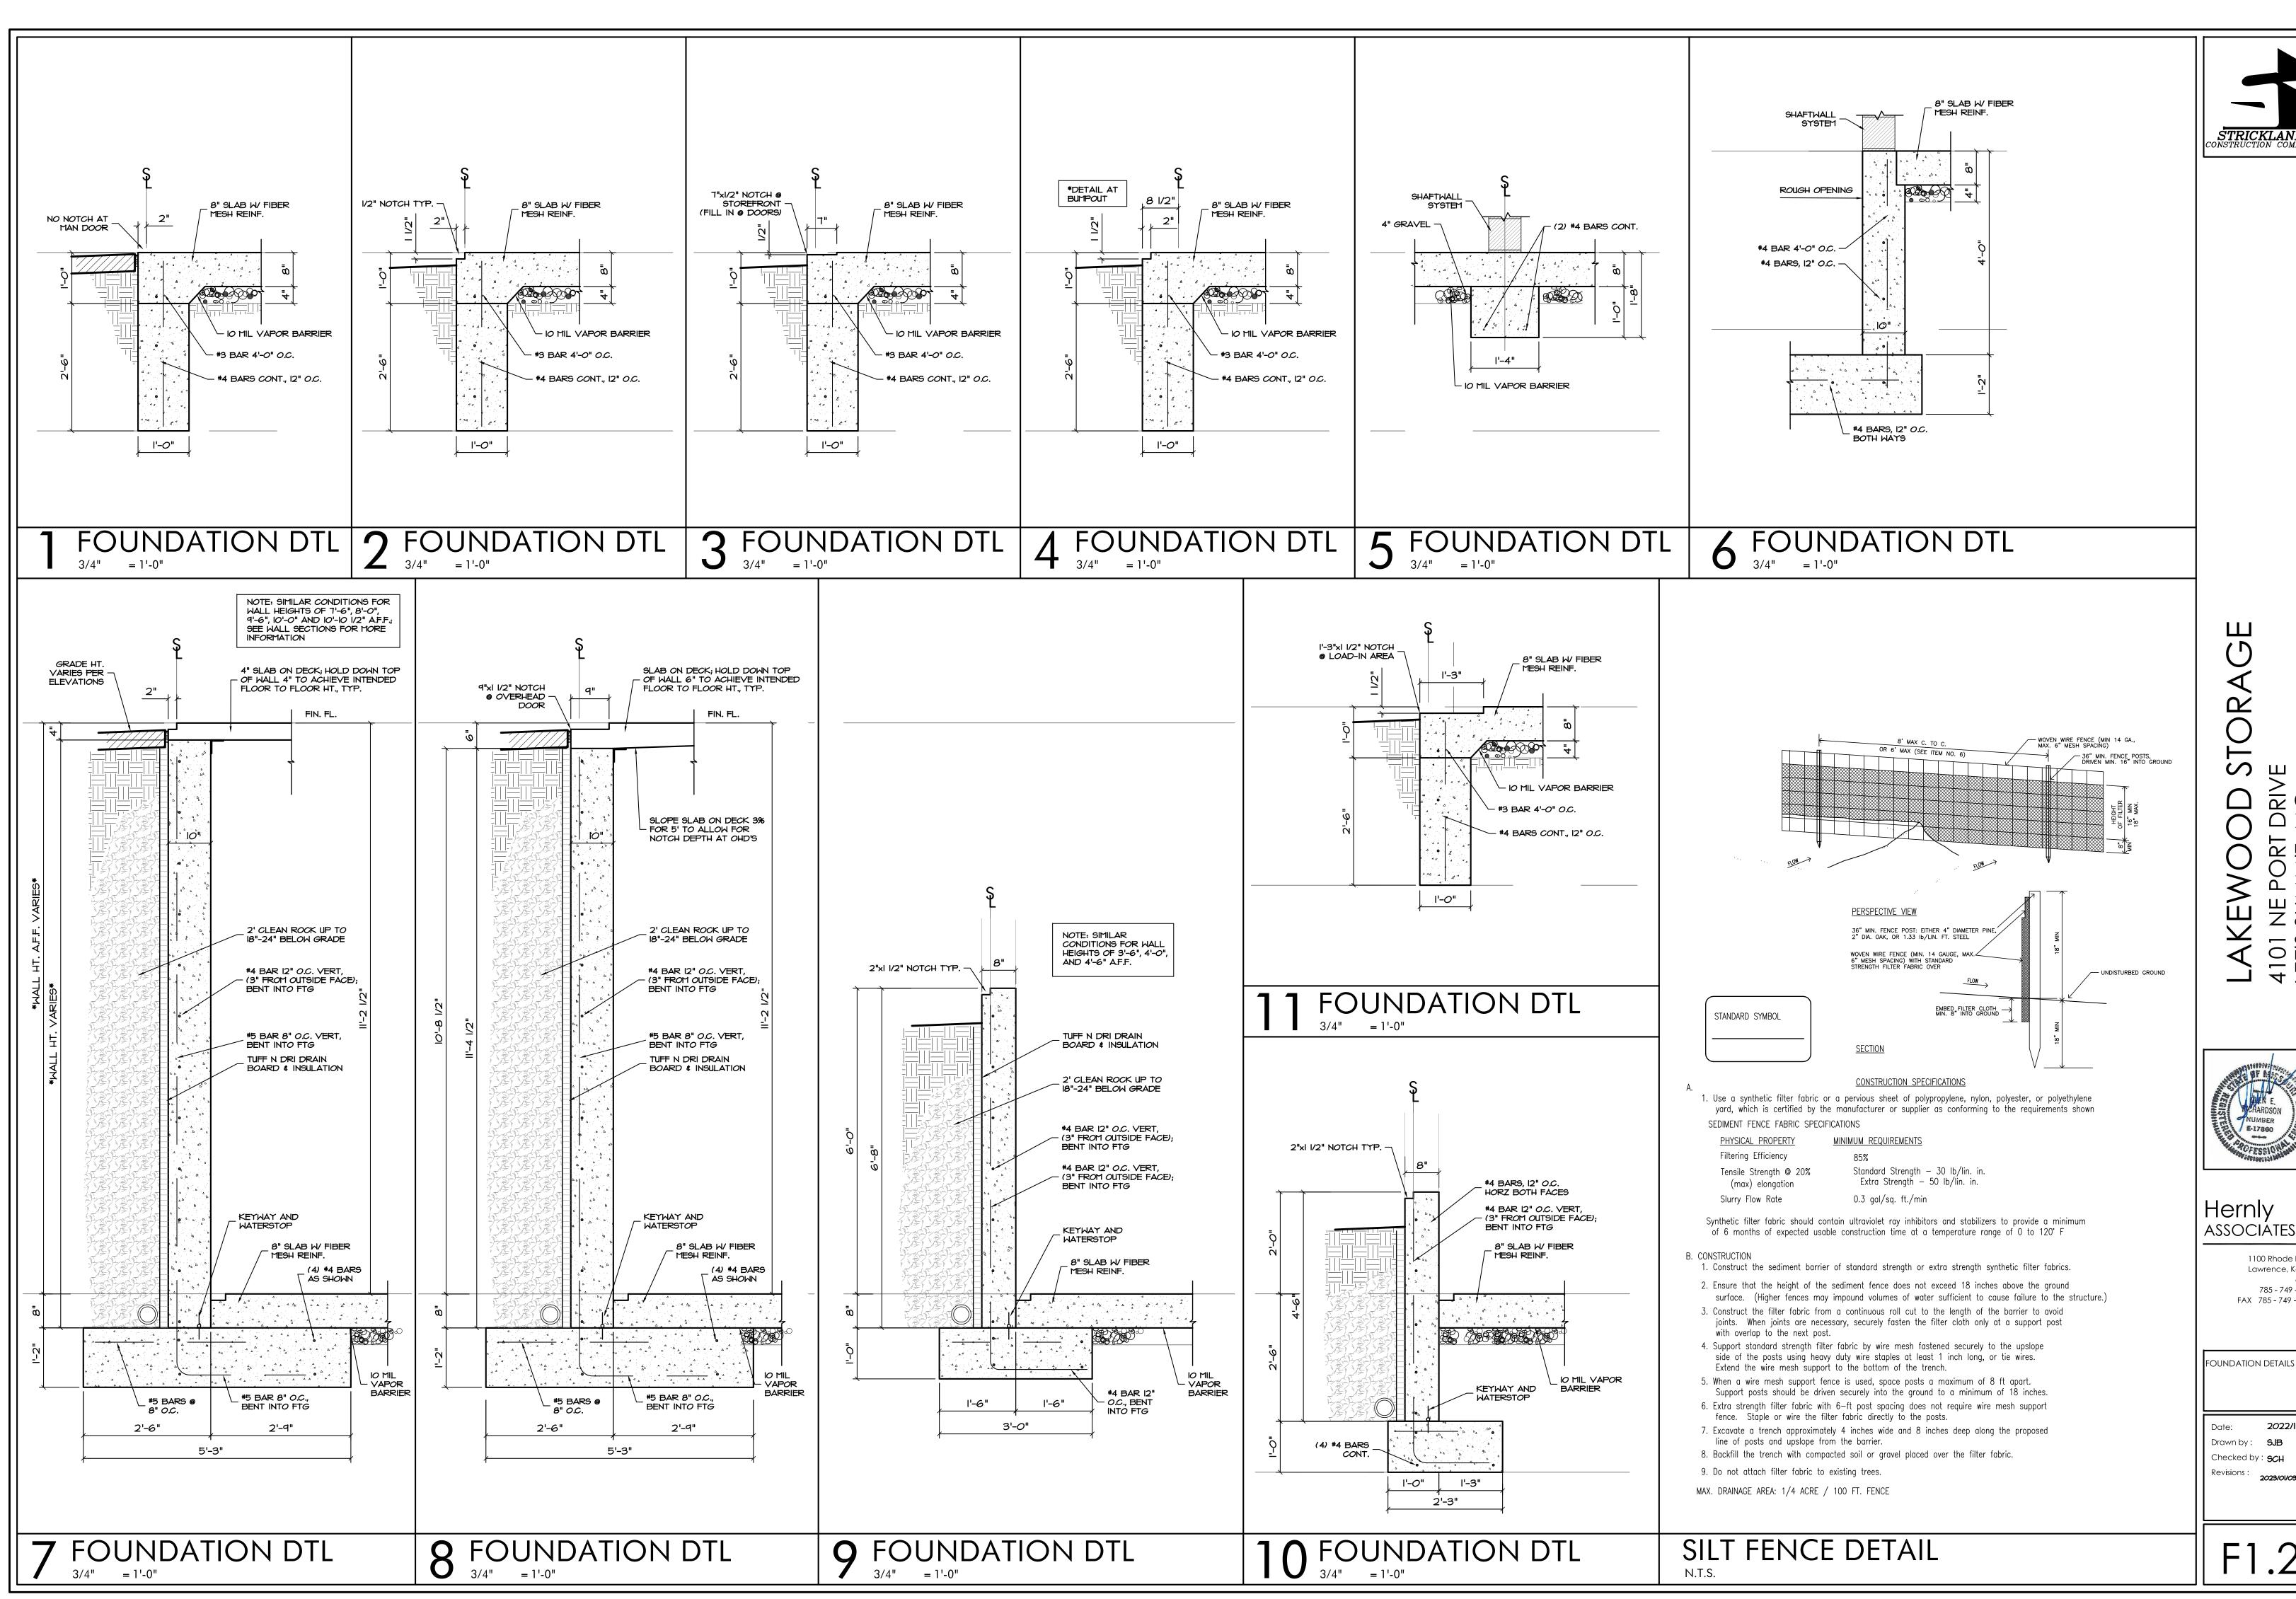

OR_ MIT ОШ – Ш

1100 Rhode Island Lawrence, Kansas

> 785 - 749 - 5806 FAX 785 - 749 - 1515

FOUNDATION DETAILS

2022/11/08 Drawn by: **SJB** Checked by: **SCH**

2023/01/03

