

BOLAND ARCHITECTS

1710 Wyandotte Kansas City, MO 64108 T: 816.763.9600

ACI/Boland, Inc. Kansas City | St. Louis Licensee's Certificate of Authority Number: Missouri: #000958

CIVIL CONSULTANT

7101 College Blvd., Suite 400 Overland Park, KS 66210

STRUCTURAL CONSULTANT

Bob D. Campbell & Co. 4338 Belleview Kansas City, MO 64111

MEP CONSULTANT

Branch Pattern 1508 Grand Boulevard Kansas City, MO 64108 (816) 531-2121

> nandoah Drive , MO 64063 SMC 1950 Lee's

Job Number Drawn By Checked By

10/21/22

Number Date Description
1 11/18/22 City Comments

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SITE PLAN



GRADING NOTES

- 1. Contractor shall obtain a copy of the <u>Geotechnical Services Report</u> for the project and be familiar with the existing conditions and recommendations contained in the report if such a report has been prepared.
- Contractor is responsible for any over excavation of existing unsuitable soils will be required under building and pavement areas. Contractor shall perform over excavation of unsuitable soils as a part of this work.
- 3. Contractor shall obtain soils suitable as structural fill from off-site sources. All borrow materials must be tested and approved by the Geotechnical Engineer prior to importing the soils to the project site.
- 4. Contractor shall operate under the terms and permits included in the Stormwater Pollution Prevention Plan (SWPPP) prepared for this project and permitted through the State of Missouri. Contractor shall employ a qualified person to conduct regular inspections of the site erosion control measures and document such inspections in the SWPPP document maintained by the Contractor.
- 5. All topsoil, vegetation, root structures, and deleterious materials shall be stripped from the ground surface prior to the placement of embankments. Contractor shall obtain the on-site geotechnical representative's acceptance of the existing ground surface materials and the proposed fill material prior to the placement of fill.
- 6. All proposed contour lines and spot elevations shown are finish ground elevations. Contractor shall account for pavement depths, building pads, topsoil, etc when grading the site.
- 7. All disturbed areas that are not to be paved (green spaces) shall be finish graded with a minimum of six inches of topsoil.
- 8. All excavation and embankments shall comply with the recommendations provided by the geotechnical engineer.
- 9. Prior to placing any concrete or asphalt pavement the contractor shall perform a proof roll of the pavement sub-grade with a fully loaded tandem axle dump truck. The proof roll shall be conducted in the presence of the on-site geotechnical representative. Areas that display rutting or pumping that are unsatisfactory to the geotechnical representative shall be re-worked and a follow-up proof roll shall be conducted prior to acceptance of the sub-grade for paving. The contractor may, at its own expense, stabilize the sub-grade using Class C fly ash or quicklime, as approved by the geotechnical engineer.
- 10. Finished grades shall not be steeper than 3:1.
- 11. All grading work shall be considered unclassified. No additional payments shall be made for rock excavation. Contractor shall satisfy himself as to any rock excavation required to accomplish the improvements shown hereon.
- 12. A 2.0% maximum cross slope shall be maintained on all pedestrian sidewalks and paths.

GRADING LEGEND

980 FINISH GRADE MAJOR CONTOURS


982 FINISH GRADE MINOR CONTOURS

EXISTING GRADE MAJOR CONTOURS

EXISTING GRADE MINOR CONTOURS

PROPERTY LINE

R/W RIGHT-OF-WAY LINE

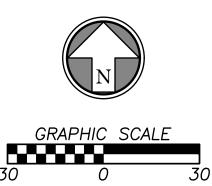



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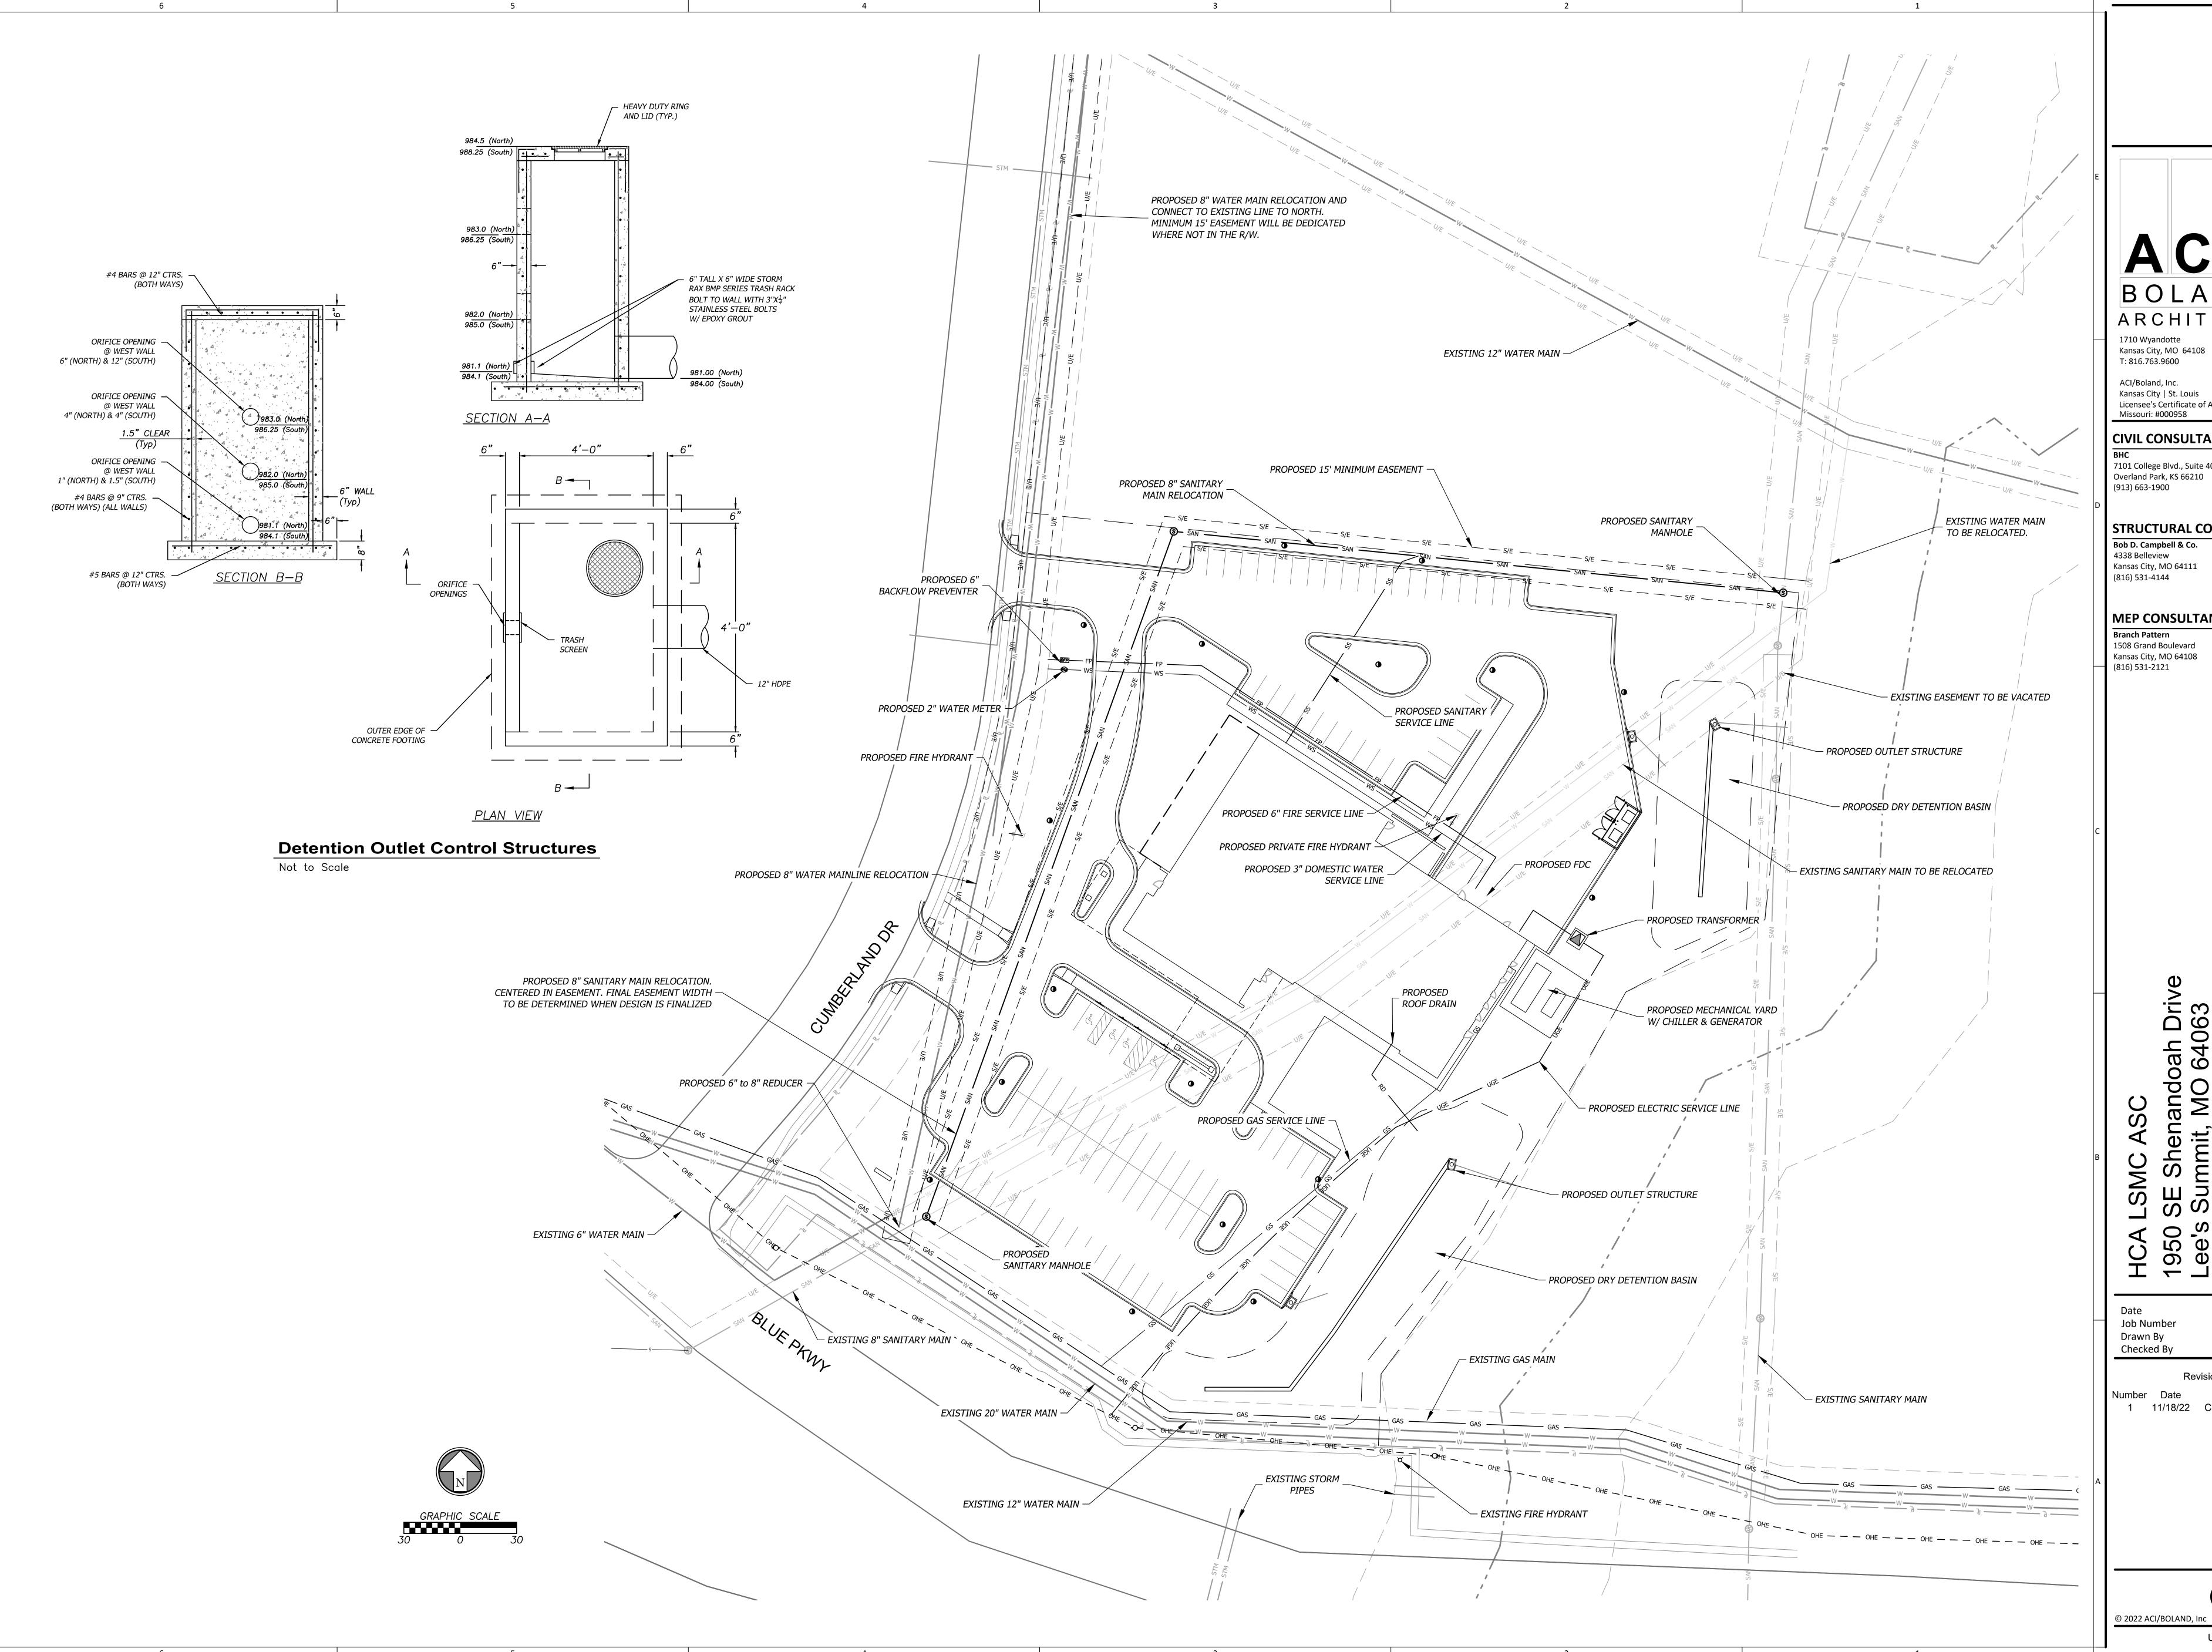
Date 10/21/22
Job Number 34660
Drawn By TS
Checked By EB

Revision

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GRADING PLAN



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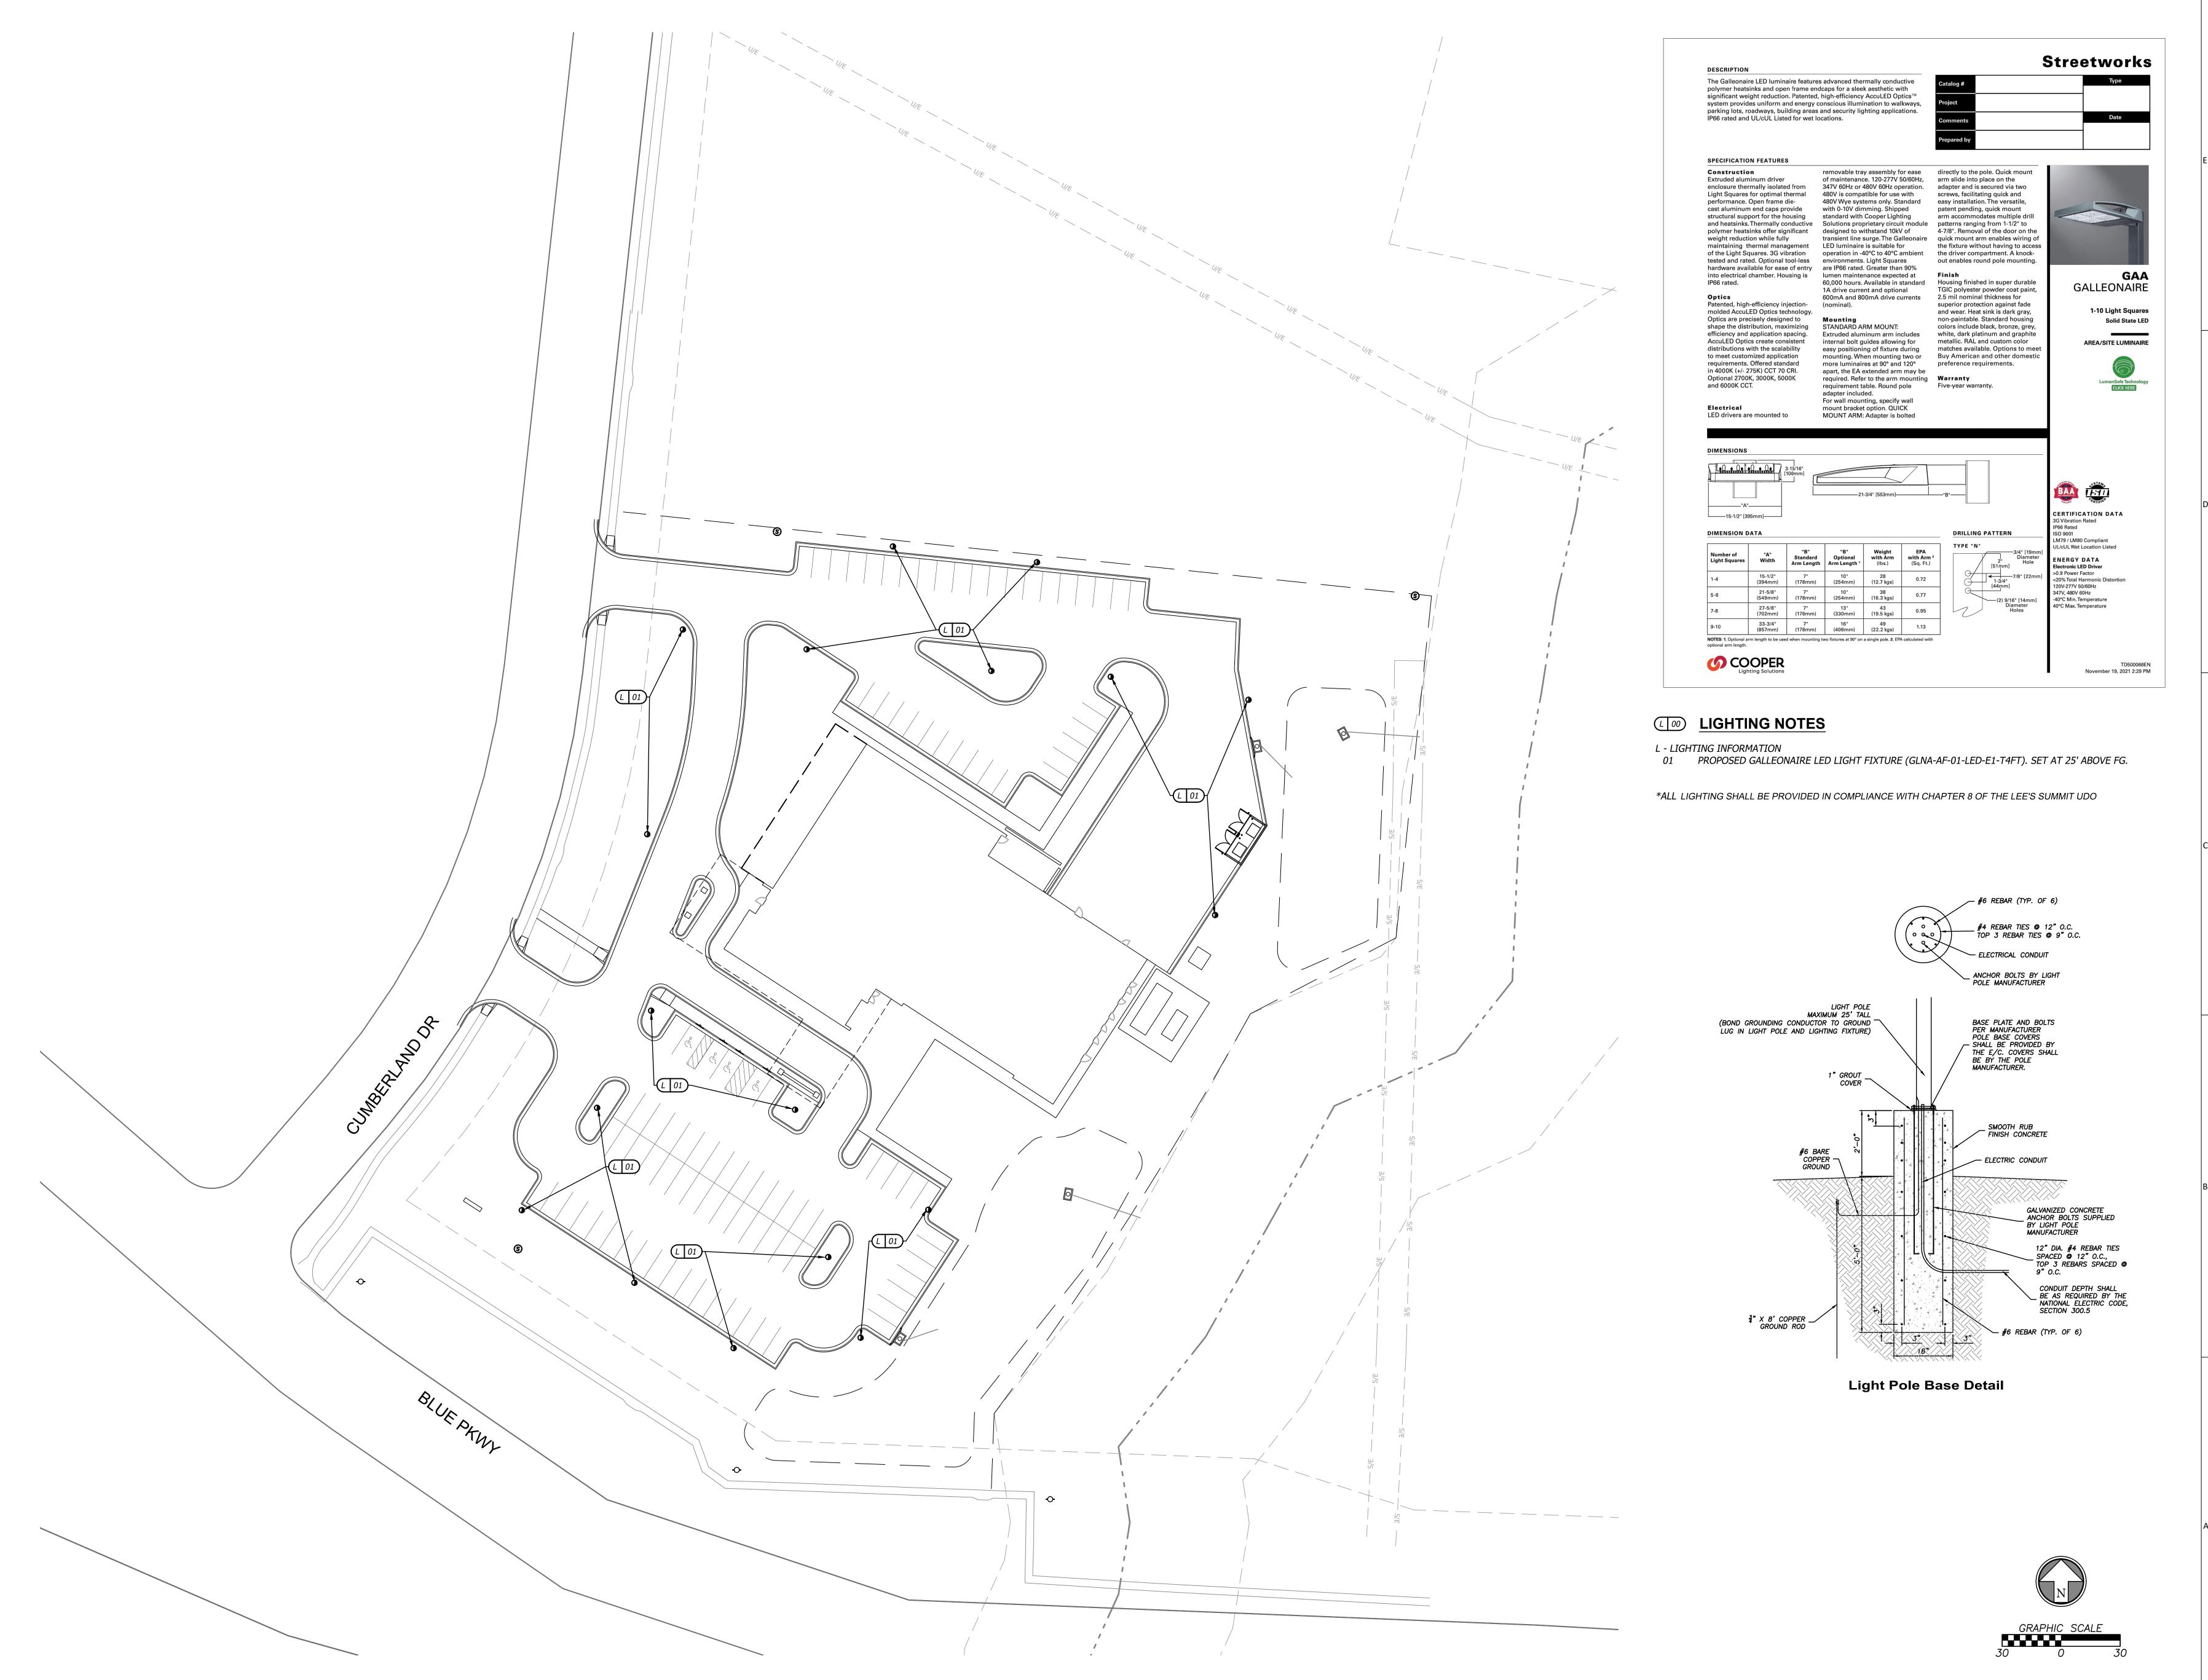
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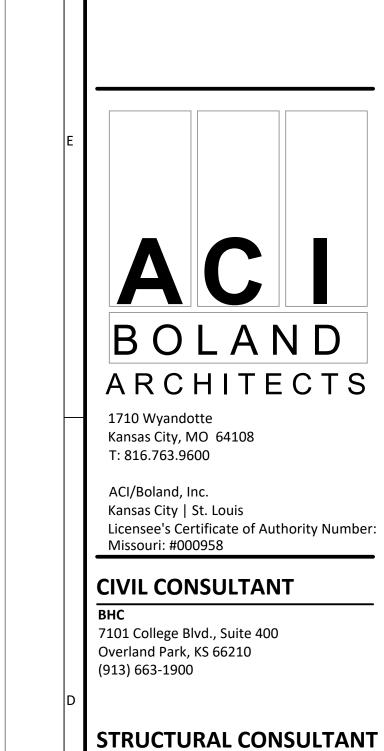
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UTILITY PLAN





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LIGHTING PLAN

- 1. Irrigation plan to not interfere with any proposed improvements shown.
- psi. Minimum operating pressure for spray heads shall be 30 psi and minimum operating pressure for drip zones shall be 40 psi.
- 3. The contractor shall be responsible for providing uninterrupted, 110 v electrical service to the controller and for all hook-ups. All exposed low voltage wire shall be enclosed in a conduit.
- curbs and walks, grouped valves to be equally spaced.
- 5. Install all mainlines to 1% minimum slope to drain valves located at low points of main system.
- in owner approved locations.

phase of development

2. Irrigation system design to be based on available

4. Place valve boxes 12" minimum from and parallel to

6. Irrigation controller and rain sensor shall be located

PLANT SCHEDULE

	1 27 (111 00112					
	TREES	QTY	BOTANICAL / COMMON NAME	CONT	CAL	HEIGH
		14	Liriodendron tulipifera / Tulip Poplar	B & B	3" cal	
کر	• 5	9	Quercus imbricaria / Shingle Oak	B & B	3" cal	
	الله الله الله الله الله الله الله الله	6	Tilia americana 'Lincoln' / Lincoln American Linden	B & B	3" cal	
	ORNAMENTAL TREE	QTY	BOTANICAL / COMMON NAME	CONT	CAL	HEIGH
		9	Malus x `Prairifire` / Prairifire Crab Apple	В&В	3" cal	
	EVERGREEN TREE	<u>QTY</u>	BOTANICAL / COMMON NAME	CONT	CAL	HEIGH
		6	Abies concolor / White Fir	B & B		8`H
	SHRUBS	QTY	BOTANICAL / COMMON NAME	SPEC	<u>HEIGHT</u>	
	\otimes	43	Cornus sericea 'Farrow' TM / Arctic Fire Red Twig Dogwood	5 gal	18"- 24" H	
	•	24	Itea virginica 'Merlot' / Merlot Sweetspire	5 gal	24"-36" H	
	\bigcirc	32	Rhus aromatica `Gro-Low` / Gro-Low Fragrant Sumac	2 gal	12"-18" H	
	EVERGREEN SHRUB	QTY	BOTANICAL / COMMON NAME	SPEC	<u>HEIGHT</u>	
	M. O. M.	45	Pinus mugo 'Pumilio' / Dwarf Mugo Pine	5 gal	24"- 30" H	
		39	Thuja occidentalis 'Golden Globe' / Golden Globe Arborvitae	5 gal	24"- 30" H	
	GROUND COVERS	<u>QTY</u>	BOTANICAL / COMMON NAME	SPEC		
	\ \ \ \ \ \ \ \ \ \ \ \ \ \ \ \ \ \ \	73,134 sf	Festuca arundinacea `Watersaver Blend` / Watersaving Blend of Tall Fescue	sod		

MULCH SCHEDULE



WOOD MULCH Double Ground Hardwood Mulch 3"

LEGEND

980	PROPOSED FINISH GRADE MAJOR CONTOUR
982 ———	PROPOSED FINISH GRADE MINOR CONTOUR
980	EXISTING GRADE MAJOR CONTOUR
982 _	EXISTING GRADE MINOR CONTOUR
SIM	PROPOSED STORM SEWER LIN
RD	PROPOSED ROOF LINE DRAIN
	PROPERTY LINE
R/W	RIGHT-OF-WAY LINE

SITE DATA

	Quantity	Required	Provided
Street Frontage			
SE Cumberland Dr	351.2		
1 tree / 30 LF of street		11.71	12
1 shrub / 20 LF of street		17.56	24
Open Yard			
site area (without bldg footprint)	152,945		
1 tree / 5,000 SF of lot		30.59	32
2 shrubs / 5,000 SF of lot		61.18	114
Perimeter Parking Landscape			
continuous 2.5' ht screen: min 12 shrubs / 40 LF		Υ	Υ
Island/Interior Landscape			
parking area (SF)	79,841.00		
landscape min 5% of parking area		3,992.05	7,190.80
trees/landscape in islands		Υ	Υ
groundcover on all interior areas		Υ	Υ

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LANDSCAPE PLAN

- The Contractor shall verify and coordinate all final grades with the Landscape Architect and or
- design team prior to completion. 2. Location and placement of all plant material shall be coordinated with the Landscape Architect
- prior to installation. 3. Location of all utilities are approximate, the Contractor shall field verify locations prior to
- commencement of construction operations. 4. Refer to Civil Drawings for all grading and
- berming, erosion control, storm drainage, utilities and site layout. 5. The Contractor shall arrange and conduct a pre-construction meeting onsite with Landscape Architect prior to work.
- 6. Plant quantities are for information only, drawing shall prevail if conflict occurs. Contractor is responsible for calculating own quantities and bid accordingly.
- 7. The Contractor is to notify Landscape Architect after staking is complete and before plant pits are excavated.
- Tree locations in areas adjacent to drives, walks, walls and light fixtures may be field adjusted as approved by Landscape Architect.
- 9. The Contractor shall report subsurface soil or drainage problems to the Landscape Architect.

and material availability. All changes or substitutions must be approved by the City of

11. Aluminum landscape edging to be used on all landscape beds adjoining turf areas as noted on landscape plans.

Lee's Summit and the Landscape Architect.

12. Landscape Contractor shall be responsible for

watering all plant material until the time that a permanent water source is ready. 13. The Contractor shall show proof of procurement, sources, quantities, and varieties for all shrubs, perennials, ornamental grasses, and annuals

within 21 days following the award of the

contract.

14. Contractor shall provide full maintenance for newly landscaped areas for a period of 30 days after the date of final acceptance. At the end of the maintenance period, a healthy, well-rooted, even-colored, viable turf and landscaped area must be established. The landscaped areas shall be free of weeds, open joints, bare areas, and

15. Landscape Contractor shall provide rock mulch sample to owner for approval.

surface irregularities.


PREFINISHED METAL PANEL AHU SCREEN WALL

PREFINISHED METAL PANEL AHU SCREEN WALL - METAL PANEL CLADDING - PREFINISHED METAL CANOPY ALUMINUM FRAMED STOREFONT SYSTEM METAL PANEL CLADDING - PREFINISHED METAL CANOPY ALUMINUM FRAMED STOREFONT SYSTEM -- MASONRY VENEER WAINSCOT ---- VARIATED DEPTH STUCCO FINISH

C1 EXTERIOR ELEVATION - EAST 1/8" = 1'-0"



B1 EXTERIOR ELEVATION - NORTH 1/8" = 1'-0"

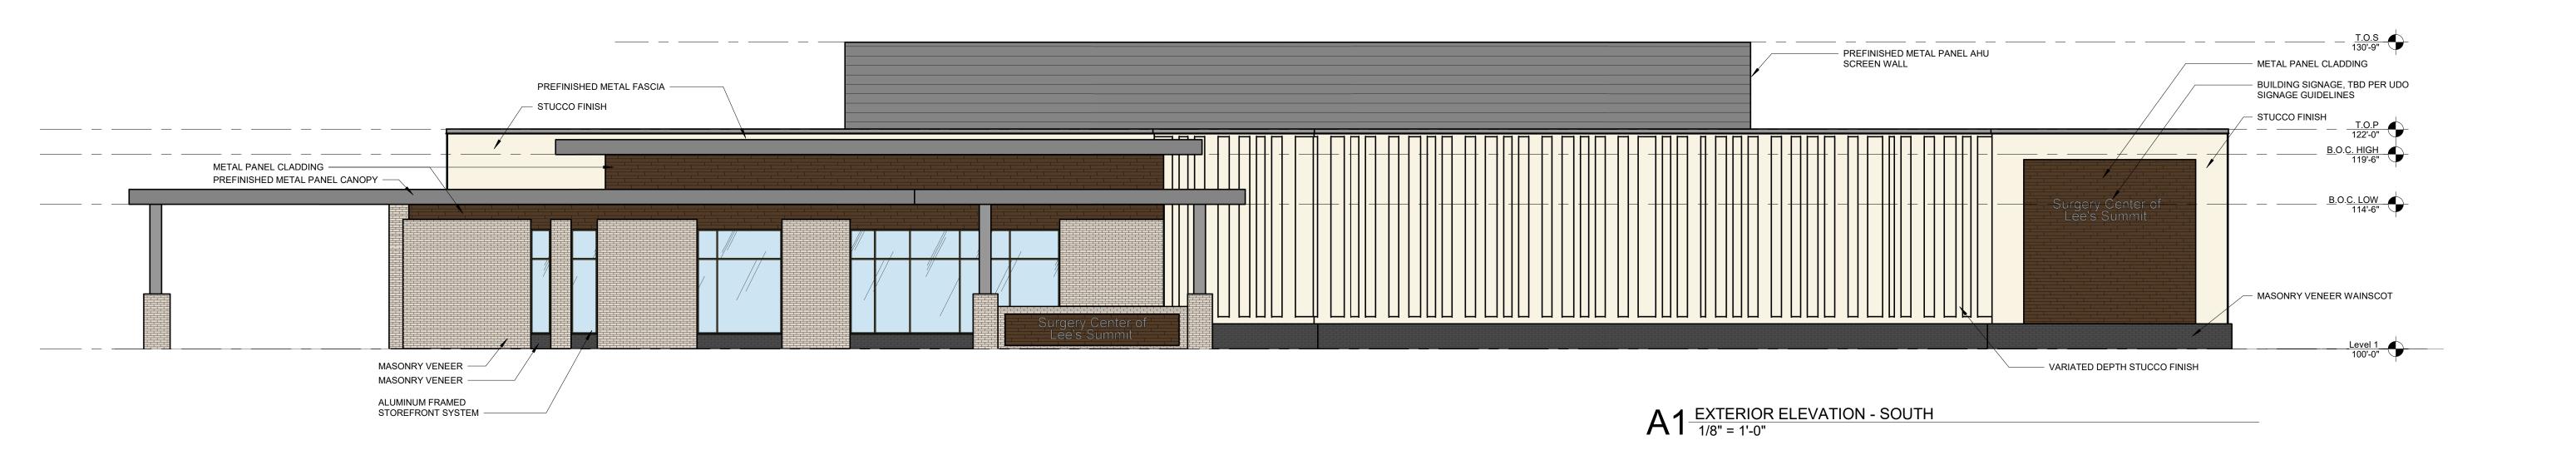

PRELIMINARY, NOT FOR CONSTRUCTION, RECORDING PURPOSES, OR **IMPLEMENTATION**

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Project Issue 3-22030 Job Number Drawn By Checked By

Author Checker

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EXTERIOR ELEVATIONS