

AN ORDINANCE APPROVING A PRELIMINARY DEVELOPMENT PLAN ON LAND LOCATED AT 3511 SW MARKET STREET IN DISTRICT CP-2, ALL IN ACCORDANCE WITH THE PROVISIONS OF UNIFIED DEVELOPMENT ORDINANCE, CHAPTER 33, OF THE CODE OF ORDINANCES FOR THE CITY OF LEE'S SUMMIT, MISSOURI.

WHEREAS, Application #PL2022-296 submitted by Lee's Summit Retail Partners, LLC, requesting approval of a preliminary development plan in District CP-2 (Planned Community Commercial District) on land located at 3511 SW Market St. was referred to the Planning Commission to hold a public hearing; and,

WHEREAS, after due public notice in the manner prescribed by law, the Planning Commission held a public hearing for the consideration of the preliminary development plan on October 13, 2022, and rendered a report to the City Council recommending that the preliminary development plan be approved; and,

WHEREAS, after due public notice in the manner prescribed by law, the City Council held a public hearing on November 1, 2022, and rendered a decision to approve the preliminary development plan for said property.

NOW, THEREFORE, BE IT ORDAINED BY THE COUNCIL OF THE CITY OF LEE'S SUMMIT, MISSOURI, as follows:

SECTION 1. That a preliminary development plan is hereby approved in District CP-2 on the following described property:

LOT 2, MARKET STREET CENTER, A SUBDIVISION OF LAND IN THE CITY OF LEE'S SUMMIT, JACKSON COUNTY, MISSOURI

SECTION 2. That the following conditions of approval apply:

1. Development shall be in accordance with the preliminary development plan dated September 13, 2022.

SECTION 3. Development shall be in accordance with the preliminary development plan dated September 13, 2022., as conditioned above and appended hereto as Attachment A.

SECTION 4. Nonseverability. That all provisions of this ordinance are so essentially and inseparably connected with, and so dependent upon, each other that no such provision would be enacted without all others. If a court of competent jurisdiction enters a final judgment on the merits that is not subject to appeal and that declares any provision or part of this ordinance void, unconstitutional, or unenforceable, then this ordinance, in its collective entirety, is invalid and shall have no legal effect as of the date of such judgment.

SECTION 5. That failure to comply with all of the provisions contained in this ordinance shall constitute violations of both this ordinance and the City's Unified Development Ordinance, enacted by Ordinance No. 5209 and amended from time to time.

SECTION 6. That this ordinance shall be in full force and effect from and after the date of its passage and adoption, and approval by the Mayor.

PASSED by the City Council of the City of Lee's Summit, Missouri, this 8th day of November, 2022.

ATTEST:

Trisha Fowler Arcuri
City Clerk Trisha Fowler Arcuri



W.A. Baird
Mayor William A. Baird

APPROVED by the Mayor of said city this 16th day of November, 2022.

ATTEST:

Trisha Fowler Arcuri
City Clerk Trisha Fowler Arcuri

W.A. Baird
Mayor William A. Baird

APPROVED AS TO FORM:

Brian W. Head
City Attorney Brian W. Head





SITE GRADING NOTES:

MAY-MARSH COOT

UTILITY NOTES. INDICATIONS OF UTILITIES ARE AS SHOWN.
INDIVIDUAL UNDERGROUND LOCATIONS SHOWN AS FURNISHED BY THEIR
LESSORS ARE APPROXIMATE AND SHOULD BE VERIFIED IN
THE FIELD. THE TIME OF CONSTRUCTION FOR ACTUAL
FIELD LOCATIONS OF UNDERGROUND UTILITIES CALL B.I.

Now what's below.
Call before you dig.

Westlake ACE Hardware

101

Lee's Summit, Missouri 6408
3511 SW Market Street

PHILIPS INSTRUMENTS, INC.
Optical Detectors
Optical Sensors
CMOS Sensors
Fiber Optics

GRADING
PLAN

sheet number
C2
drawing type
PUP

Protects

This site plan illustrates the layout of Market Street Commons, Lots 1-3, and surrounding areas. The plan shows the following key features:

- Market Street Commons (Lots 1-3):** Located along Market Street, this area includes several buildings and open land plots. Plot A (4.00 ac) is labeled as previously approved and under construction. Plot B (0.60 ac) is labeled as under construction.
- Proposed Improvements:** A large rectangular building footprint is shown for a "HOME IMPROVEMENT CENTER" with a size of 11,200 SF and a fee of \$100,000. This building is situated on Plot C (2.30 ac).
- Existing Deletion Basin:** An existing basin is located on Plot D (0.60 ac), which is described as a "DRAIN CENTER".
- Proposed Retaining Wall:** A retaining wall is planned along the southern boundary of Plot C, with dimensions of 17' x 8' and a thickness of 12" (17' x 8' x 12").
- Utilities:** Utility notes indicate visual indications of utilities are shown, including gas, water, sewer, and electric lines.
- Lot 1:** Includes a proposed drainage wall and dimensions 11' x 20' x 14'.
- Lot 2:** Includes dimensions 11' x 20' x 14'.
- Lot 3:** Includes dimensions 11' x 20' x 14'.

The plan also includes contour lines, property boundaries, and various labels such as "TRACT A", "TRACT B", "LOT 1", "LOT 2", "LOT 3", "MARKET ST.", "SW MARKET ST.", and "E MARKET ST.". A legend in the bottom right corner provides additional information about symbols used in the map.

davidson



Lee's Summit, Missouri 64082
3511 SW Market Street

a new store for

Westlake ACE Hardware

ENLARGED GRADING PLAN

C2.1
drawing number
22-1145




Call before you dig.

FLOOD NOTE:
THIS DRAWING IS NOT A FLOOD INSURANCE RATE MAP PREPARED BY THE FEDERAL EMERGENCY MANAGEMENT AGENCY OR THE STATE OF MISSOURI. IT IS A GRADE PLAN PREPARED BY THE OWNER, DAVIDSON PLANNING, INC., FOR THE PURPOSE OF DETERMINING THE FLOOD INSURANCE RATES FOR THE PROPOSED CONSTRUCTION. THIS DRAWING IS NOT A FLOOD INSURANCE RATE MAP AS DEFINED IN THE NATIONAL FLOOD INSURANCE ACT OF 1968. IT IS NOT A FLOOD INSURANCE RATE MAP AS DEFINED IN THE FEDERAL EMERGENCY MANAGEMENT AGENCY'S REGULATIONS. IT IS NOT A FLOOD INSURANCE RATE MAP AS DEFINED IN THE STATE OF MISSOURI'S FLOOD INSURANCE REGULATIONS. IT IS NOT A FLOOD INSURANCE RATE MAP AS DEFINED IN THE STATE OF MISSOURI'S FLOOD INSURANCE REGULATIONS.

BENCHMARK:

WATER LEVEL = MEAN SEA LEVEL ON GROUND SURFACE
1. Elevation of 7' cut in center, surface at southwest corner of
proposed property.
2. 30' " cut in southwest corner of block of land adjacent
to property to the north at northeast corner of subject property.
ELEVATION = 30'

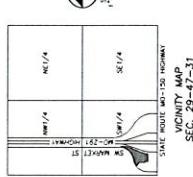

LEGEND

10'-0"	GRADE LINE
10'-0"	LO. LINE
-10'-0"	HIGH FLOOD
7'-0"	CENTER CUTTER
20'-0"	LEVEL GROOVES
30'-0"	PROPOSED GROOVES
40'-0"	PROPOSED SPOT ELEVATION
50'-0"	UP & CUTTER
50'-0"	SC. LINE
50'-0"	MEAN SEA LEVEL
50'-0"	LOW FLOOD
50'-0"	UP FROM MEAN SEA LEVEL
50'-0"	TOP OF CUTTER
50'-0"	TOP OF SPOT ELEVATION
50'-0"	TOP OF GROOVES
50'-0"	TOP OF WALL
50'-0"	TOP OF RETAINING WALL
50'-0"	EXISTING STREAM BANK
50'-0"	PROPOSED STREAM BANK
50'-0"	PROPOSED SPOT CUTTER
50'-0"	PROPOSED SPOT CUTTER & GROOVES
50'-0"	PROPOSED SPOT CUTTER & GROOVES, WALL

SCALE: 1" = 20'

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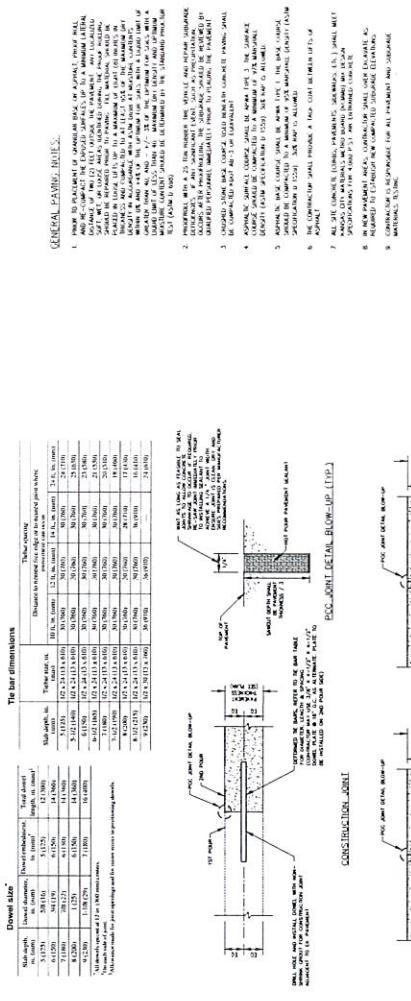
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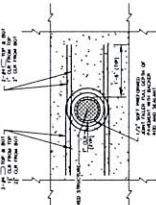
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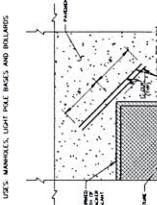


CONTRACTION JOINT (Dimpled)

CONCRETE JOINT DETAILS



TYPICAL BOND FIELD



TYPICAL BOND FIELD



CURB JOINT

ISOLATION JOINT DETAILS

SIDEWALK AT CURB DETAIL

CONCRETE SIDEWALK JOINT DETAILS

SCALE: 1/8"

NOTE:

1. USE CONCRETE MATERIALS WITH 3000 psi C.S. MAX.

2. 4000 psi C.S. AND ENTHALTED CONCRETE FOR ALL PAVING SURFACES.

3. CONTRACTOR IS RESPONSIBLE FOR ALL PAVING AND SURFACE MATERIALS.

4. D.C. 3000.

5. CONTRACTOR IS RESPONSIBLE FOR ALL PAVING AND SURFACE MATERIALS.

6. D.C. 3000.

7. ALL SIDEWALKS, CURBS, PARAPETS, WALLS, ETC., SHALL MEET REQUIREMENTS OF THE APPROPRIATE SECTION OF THE STANDARDS OF PRACTICE FOR CONCRETE CONSTRUCTION.

8. REFERRED TO STANDARDS FOR CONCRETE CONSTRUCTION.

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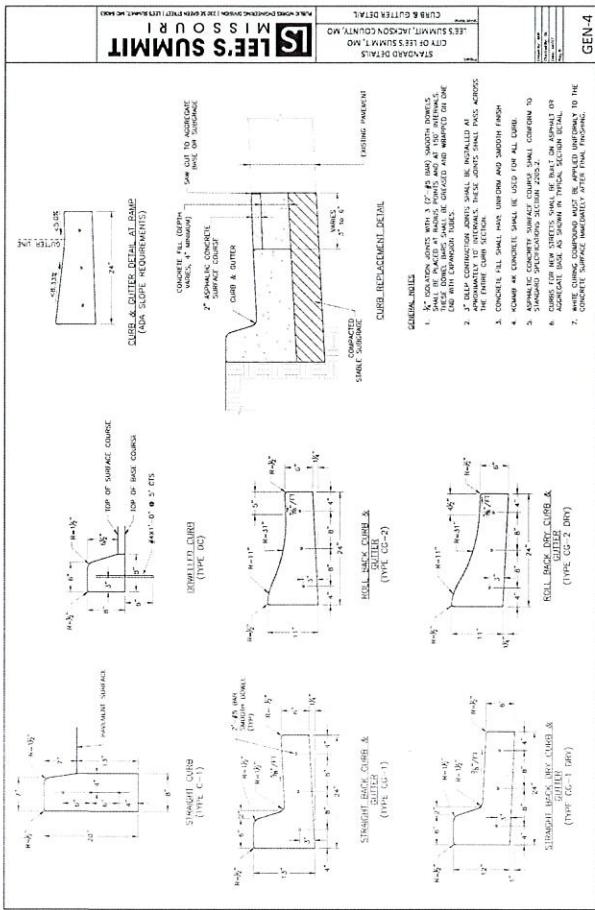
Westlake ACE Hardware

for

STANDARD DETAILS

C4.2
short run

PDP
DRAFT
Proposed changes



FFS
coupling
backbone
superpos

cat stone **cat stone cap** - Midwest Cat Stone, color 1A
cat stone **sheathing** **anodized aluminum frame**, color **clear**
glass, 1st insulated clear glass with low E coating and argon fill

Westlake ACE Hardware


Lee's Summit, Missouri 64082

a new store for


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A3-1


PDP drawing type

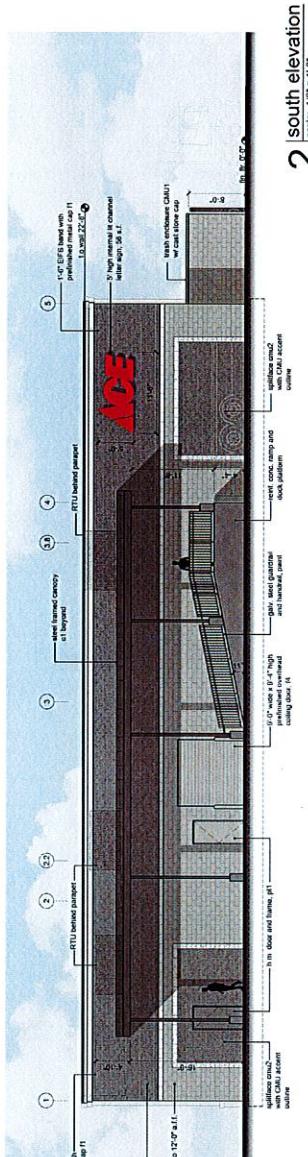


2 south elevation

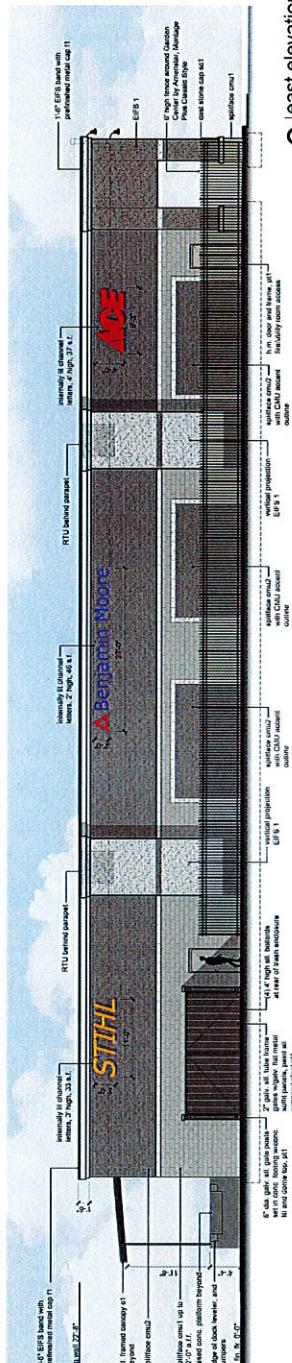

east elevation

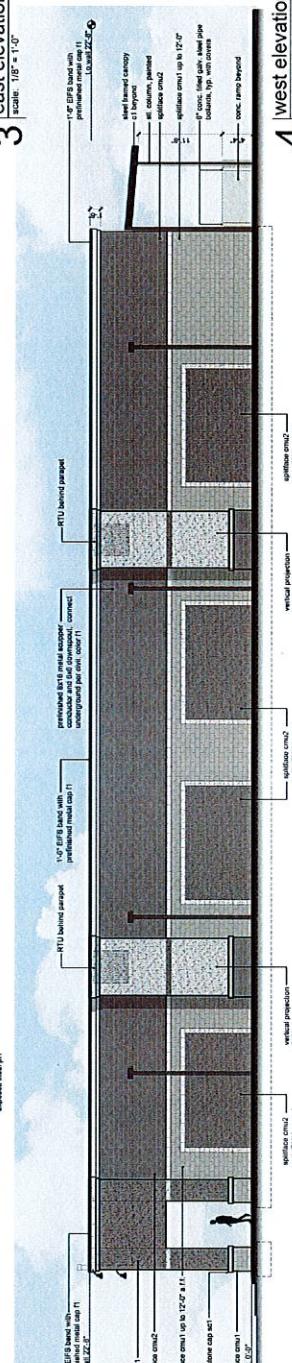

scale: $1/8'' \approx 1'-0''$

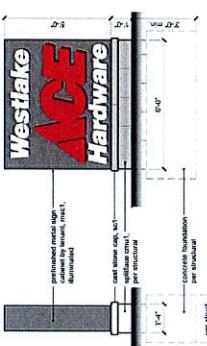


monument sign elevation

a new store for

PDP
09.12.2022

sheet number
A3

PDP drawing type

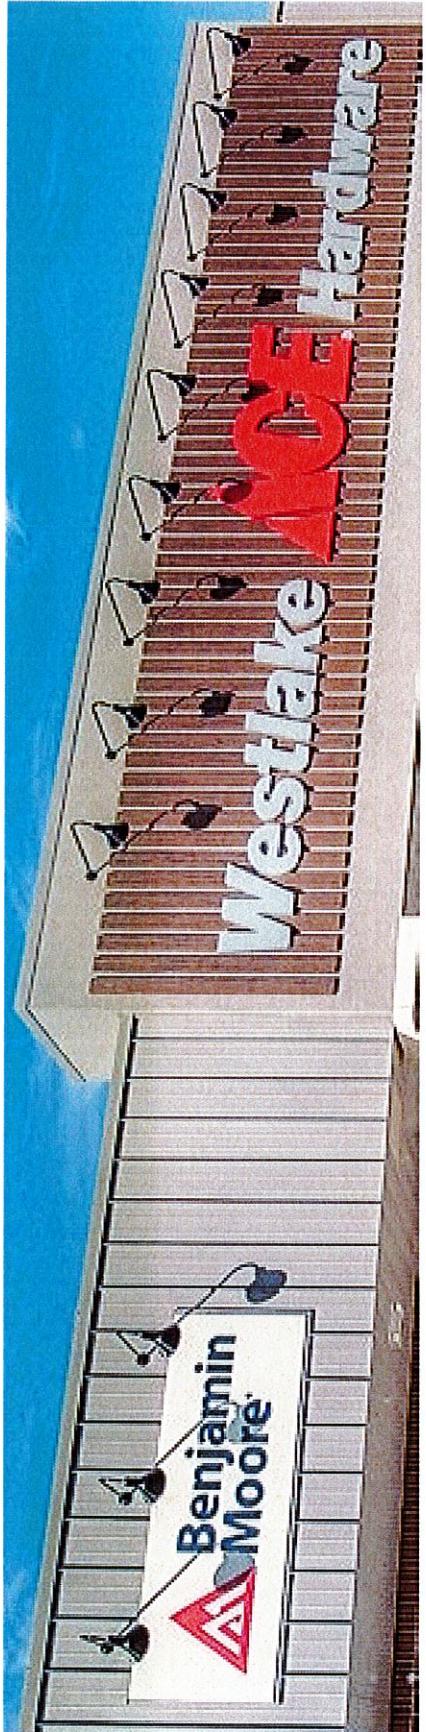


Example of standing seam metal fascia

TECHNICAL INFORMATION SHEET

UNA-CLAD™ UC-14

Item Description

Standing Seam Panel For Architectural Metal Roofing

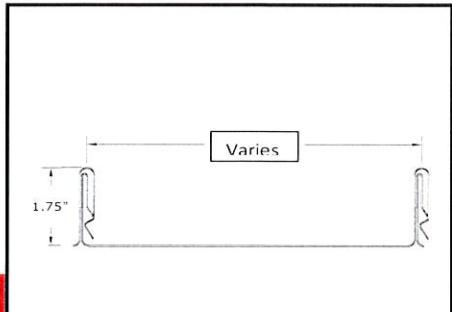

Product Information

Description:

Firestone UNA-CLAD UC-14 Roofing Panel is a factory formed continuous interlocking, concealed clip, architectural standing seam metal roof panel with a proven seam design that snaps together for ease of installation. An optional thermally-applied pre-assembly in-seam sealant is available. The minimum slope requirement for a Firestone Red Shield™ Warranty is 3:12. For warranty requirements for slopes between 3:12 and 1:12, please contact your Building Systems Advisor.

Method of Application:

1. Firestone UC-14 panels must be installed in a sequential order.
2. Application of a Firestone underlayment prior to panel installation is recommended.
3. A smooth, solid substrate of plywood, OBS, or a rigid insulation board mechanically attached to a steel deck is recommended for the Firestone UC-14 metal roof panel.

***NOTE:** Install assembly according to Firestone Metal Design and Application Guides found on the Firestone website. Follow approved installation details.*

Storage:

- Firestone metal panels should be stored in a well ventilated, dry place where no moisture can contact them. Moisture (From rain, snow, condensation, etc.) trapped between layers of material may cause water stains or white rust, which can affect the service life of the material and will detract from the appearance.
- If outdoor storage cannot be avoided, protect the panels with a ventilated canvas or waterproof paper cover. Do not use plastic, which can cause condensation. Keep the material off the ground in an inclined position with an insulator such as wood. Protective film may degrade or become brittle with long term exposure to direct sunlight.

Precautions:

- Oil canning is not a cause for rejection. Heavier gauges, narrower widths, striations, and embossing minimize oil canning.
- Firestone recommends a minimum bend radius of 2T. Anything less than a 2T bend radius can cause crazing to the material.
- Sealant for end laps and lap joints shall be non-drying, non-toxic, and non-shrinking with a serviceable temperature of -60 to 212 °F (-51 to 100 °C).
- Quality, long-life butyl sealants work best as a gasket sandwiched between two pieces of metal. Non-acetic cured silicone color matching sealants are recommended when voids must be filled. Sealants are not a substitute for proper assembly and workmanship.
- Exercise caution when lifting, moving, transporting, storing or handling Firestone metal to avoid possible physical damage.
- Refer to Safety Data Sheets (SDS) for safety information.
- Immediately remove protective film after installation.

TECHNICAL INFORMATION SHEET



UNA-CLAD™ UC-14

Manufacturing Location:

Anoka, MN



MIAMI-DADE COUNTY
APPROVED

Product Data

Tapered Panels:	No
Radius Panels:	No
Stiffening Ribs:	Optional
Striations:	Optional
Sealant:	Optional In-Seam, Thermally Applied
Standard Panel Surface:	Smooth
Optional Panel Surface:	Stucco Embossed
Clip:	UC-14 Clip

Product Size

Panel Width: Optimal Panel Width:	8" (203.2 mm) – 24" (609.6 mm) 18" (457.2 mm)
Seam Height:	1.75" (44.5 mm)
Minimum Panel Length: Maximum Panel Length:	36" (914.4 mm) 600" (15.24 m)

Technical Information

Up lift Resistance: Air Infiltration: Uniform Static Air Pressure :	UL 580 Class 90 ASTM E 1680 ASTM E 1592
Water Penetration: Fire Rating: Hail Impact Rating: Miami-Dade County & Florida Building Code:	ASTM E 1646 UL Class A Rated Assemblies, UL 263 and UL 790 Class 4, UL 2218 Approved

NOTE: Testing is not applicable for all combinations of substrates, materials, and dimensions. All construction assemblies must be installed in accordance with the tested assembly. Please refer to the Metal Code Approval Guide on the Firestone website for tested assemblies and code listings.

Please contact your Building Systems Advisor for warranty requirements and additional information.




Metal Systems Color Availability


UNA-CLAD™ METAL PANEL COLOR SELECTION GUIDE




Stone White

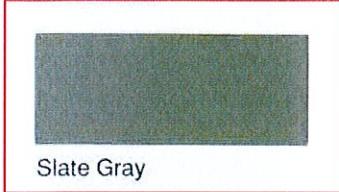


Slate Gray

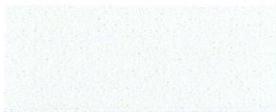


Bone White

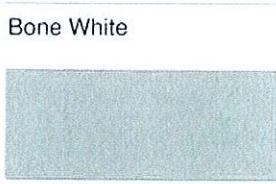

Cityscape

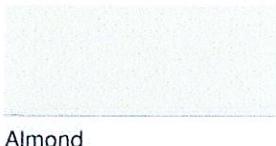

Almond

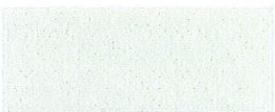

Sandstone



Sierra Tan



Medium Bronze



Dark Bronze



Charcoal Gray



Extra Dark Bronze

Matte Black



Brandywine



Colonial Red



Terra Cotta



Mansard Brown



Regal Red



Award Blue



Sky Blue



Electric Blue



Regal Blue



Teal



Patina Green



Dark Ivy



Sherwood Green



Hartford Green



Hemlock Green



Tropical Patina



Silver Metallic



Classic Copper



Champagne Metallic

Firestone
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Colors shown are as close to actual painted steel as allowed by the printing process. Contact your local sales rep for actual metal samples.