





# LAKEVIEW SELF STORAGE - LEE'S SUMMIT, MO


PROJECT TEAM

PROJECT NAME: ————————————————————————————————————	— 4101 NE PORT DRIVE LEE'S SUMMIT, MISSOURI
PROJECT OWNERSHIP:	
ARCHITECT:	HERNLY ASSOCIATES, INC.  IIOO RHODE ISLAND ST.  LAWRENCE, KANSAS 66044  P. 785-749-5806  F. 785-749-1515
GENERAL CONTRACTOR:	— STRICKLAND CONSTRUCTION T20 S. ROGERS ROAD, SUITE B OLATHE, KANSAS 66062 P. 913-764-7000 F. 913-768-8425
BUILDING INSPECTION DEPT:	DEVELOPMENT SERVICES 220 SE GREEN LEE'S SUMMIT, MO 64063 816-969-1200
CODES/REGULATIONS UTILIZED: —————	2018 International Building Code 2018 International Mechanical Code 2017 National Electrical Code 2018 Uniform Plumbing Code 2018 International Fire Code 2012 International Energy Conservation Code 10C/ANSI All7.1 - 2009 Accessibility and Usability Code
CONSTRUCTION:	METAL STUDS, STEEL DECK/ CONCRETE TOPPING, METAL PANEL, MASONRY VENEER
CONSTRUCTION TYPE:	TYPE II-B - FULLY SPRINKLED THREE FLOOR SELF STORAGE FACILITY W/ OFFICE
OCCUPANCY GROUPS:	— SELF STORAGE - GROUP S-I OFFICE/RETAIL - GROUP B
OCCUPANCY SEPARATIONS:	- NONE REQUIRED
FIRE RESISTANCE RATINGS:	STRUCTURAL FRAME = 0 BEARING WALLS = 0 PARTITIONS = 0 FLOOR CONSTRUCTION = 0 ROOF CONSTRUCTION = 0 CORRIDORS = 0 SHAFT CONSTRUCTION = I-HOUR

FIRE ALARM SYSTEM & SMOKE DETECTION — AS REQ. 2a-IObc (LOCATE PER LOCAL FIRE DEPT)
ALL EXTINGUISHERS IN PLAIN VIEW, MOUNTED W/ FIRE EXTINGUISHERS SIGNAGE ABOVE IF NEEDED. MUST COMPLY WITH IFC 906.3 AND MUST FOLLOW IFC 906 FOR TRAVEL DISTANCE (75' MIN) EMERGENCY/EXIT LIGHTING -PER ELEC. DRAWINGS PROVIDE SAFETY GLAZING IN DOORS AND FIXED PANELS ADJACENT TO DOORS COMPLYING WITH 2003

ALLOWABLE BUILDING HEIGHT: 3-STORY, 75 FEET (FULLY SPRINKLED) ACTUAL BUILDING HEIGHT: BASE ALLOWABLE BUILDING AREA: 52,500 S.F. PER STORY (FULLY-SPRINKLED, MULTISTORY) ACTUAL FLOOR AREAS: PROPOSED FLOOR AREA: IST FLOOR - GROUP S-1, B = 34,375 S.F. (OK) 2ND FLOOR - GROUP S-1 = 33,284 S.F. (OK) 3RD FLOOR - GROUP S-I = 34,426 S.F. (OK) S-I STORAGE WAREHOUSE = 500 BUSINESS = 150 OCCUPANT LOAD FACTORS: STORAGE: = 67 FIRST FLOOR = 33,I75/5*00* SECOND FLOOR = 33,284/500 THIRD FLOOR = 34,426/500 = 67 = 69 RETAIL/OFFICE: FIRST FLOOR = I200/I50 = 8 = 211 TOTAL EGRESS REQUIREMENTS: EXITS REQUIRED: 2 PER FLR. @ O.L. >1 AND <500 (100 OCC) EXITS PROVIDED: 2+ ALL FLOORS (OK) EGRESS WIDTH REQ: - 75 *O.*L. x *O.*I5" = II.25" EGRESS WIDTH PROVIDED: 176" (OK) - 67 O.L. × O.15" = 10.1" EGRESS WIDTH PROVIDED: 140" (OK) - 69 O.L. x O.20" = 13.8 EGRESS WIDTH PROVIDED: 72" (OK) MAX. ALLOWABLE TRAVEL DISTANCE: ----- = 250 FEET ACTUAL MAX. TRAVEL DISTANCE: FIRST FLOOR = 191'-3" = 147'-10" = 207'-8" SECOND FLOOR THIRD FLOOR This project has been designed by this office for compliance with applicable laws, codes and ordinances including the ADA Title III guidelines. Since the requirements of these regulations are subject to various and possibly contradictory interpretations, reasonable professional efforts have been used

to interpret applicable requirements. No warranty or guarantee is given that the project complies with all interpretations as they apply to the project.

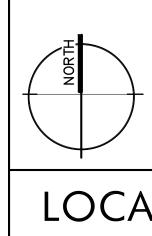

## LOCATION MAP

#### ARCHITECTURAL SET

COVER	CODE INFORMATION, LOCATION F	LAN
A1.1	CODE PLANS (1-3)	
A1.2	FIRE RATED DETAILS, CODE DETA	ILS
A2.1	FIRST FLOOR PLAN	
A2.2	SECOND FLOOR PLAN	
A2.3	THIRD FLOOR PLAN	
A2.4	PLAN DETAILS	
A2.5	PLAN DETAILS	
A2.6	INTERIOR ELEVATIONS	
A2.7	PLAN DETAILS	
A3.1	ELEVATIONS	
A3.2	ELEVATIONS	
A4.1	WALL SECTIONS	
A4.2	WALL SECTIONS	
A4.3	WALL SECTIONS	
A4.4	WALL SECTIONS	
A4.5	WALL SECTIONS	
A4.6	WALL SECTIONS	
A4.7	WALL SECTIONS	
A4.8	WALL SECTIONS	
A4.9	WALL SECTIONS	
A4.10	WALL SECTIONS	, \
A4.11	WALL SECTIONS	
A5.1	ROOF PLAN & ROOF DETAILS	$\parallel \parallel \parallel$
F1.1	FOUNDATION PLAN	
F1.2	FOUNDATION DETAILS	



LOCATION MAP


CODE INFORMATION

AUTOMATIC FIRE SPRINKLER THROUGHOUT - NFPA 13

FIRE SAFETY:

SAFETY GLAZING

SHEET INDEX

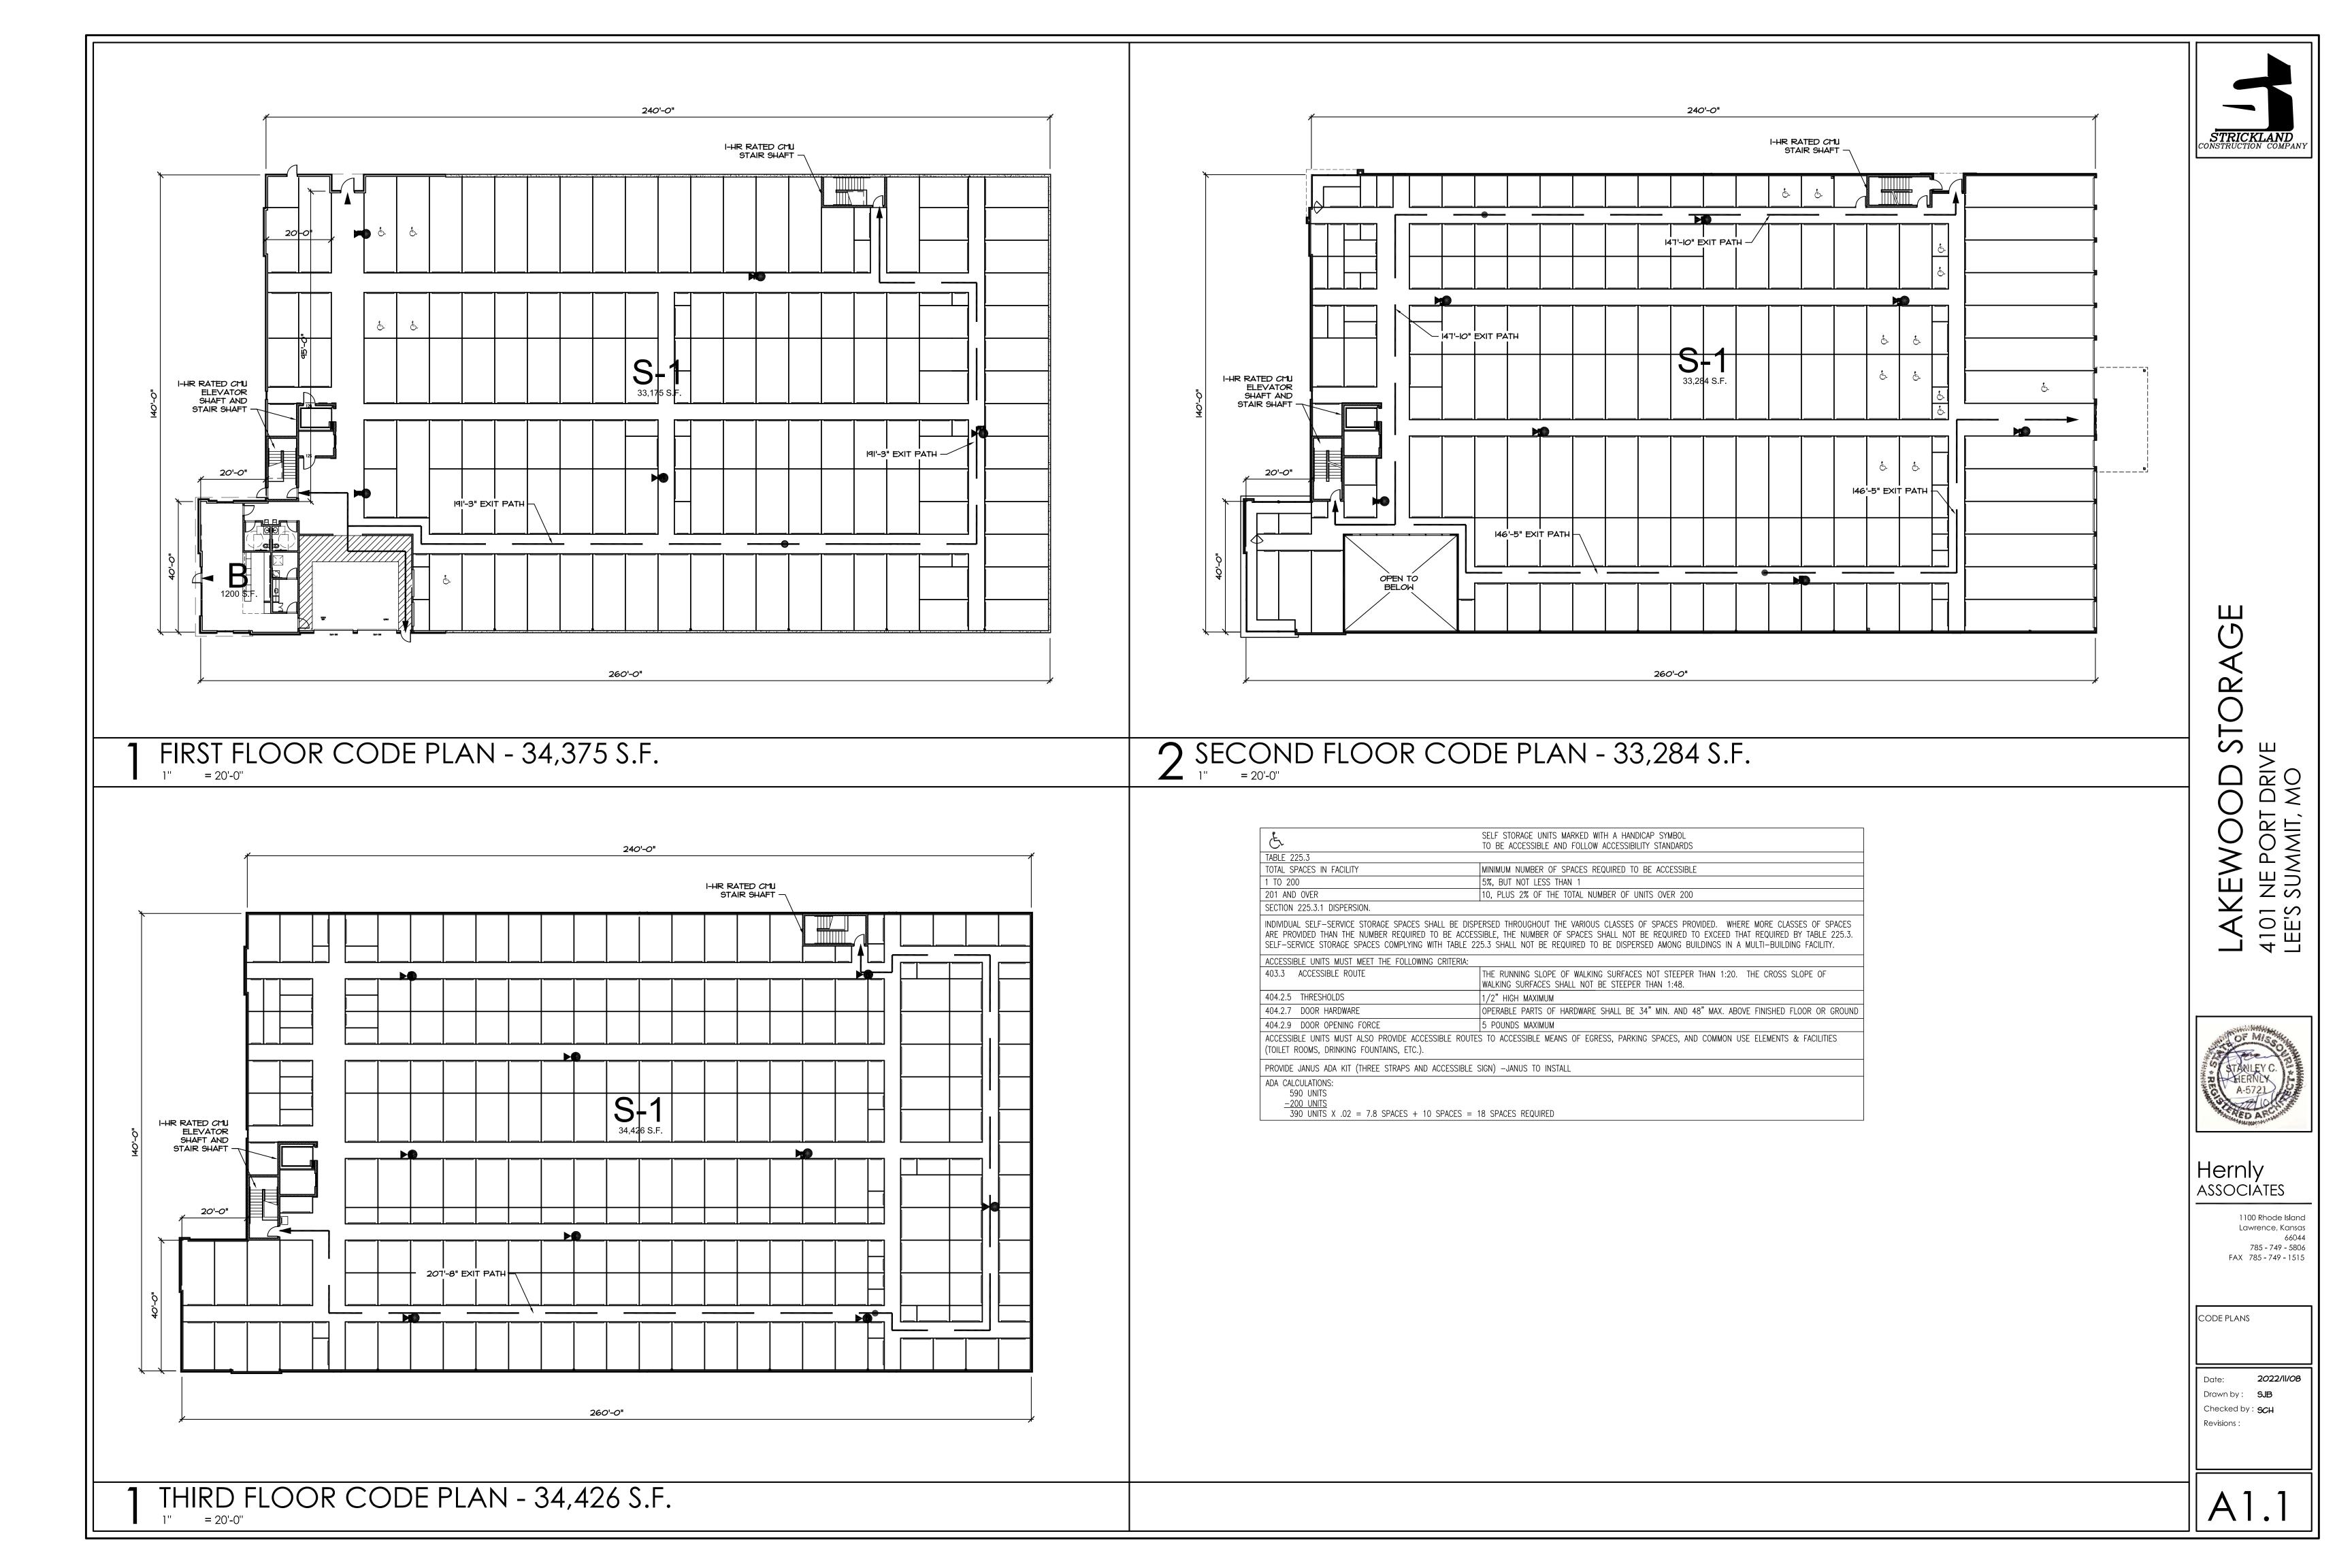


CODE PLANS

Date: 2022/II/08
Drawn by: SJB
Checked by: SCH
Revisions:

A1.2


CONCRETE MASONRY UNITS, MORTAR - UL DESIGN NO. U904
BEARING WALL RATING: 3 HR. - NONBEARING WALL RATING: 3 HR.

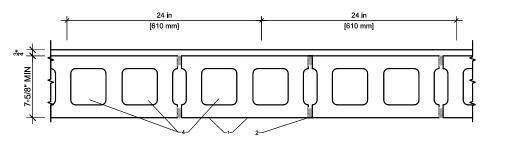


\* Indicates such products shall bear the UL Certification Mark for jurisdictions employing the UL Certification.


- 1. Concrete Blocks\* Various designs. Classification C-3 (3 hr.)
- Mortar Blocks laid in full bed of mortar, nom. <sup>3</sup>/<sub>8</sub> in. thick, of not less than 2-1/4 and not more the 3-1/2 parts of clean sharp sand to 1 part Portland cement (proportioned by volume) and not more than 50 percent hydrated lime (by cement volume). Vertical joints staggered.
- 3. Portland Cement Stucco or Gypsum Plaster Add ½ hr to Classification if used. Attached to concrete
- 4. Loose Masonry Fill If all core spaces are filled with loose dry expanded slag, expanded clay or shale (Rotary Kiln Process), water repellant vermiculite masonry fill insulation, or silicone treated perite loose fill insulation add 1 hr to Classification.


# STAIR/ELEV SHAFT WALL (1-HR REQUIRED)

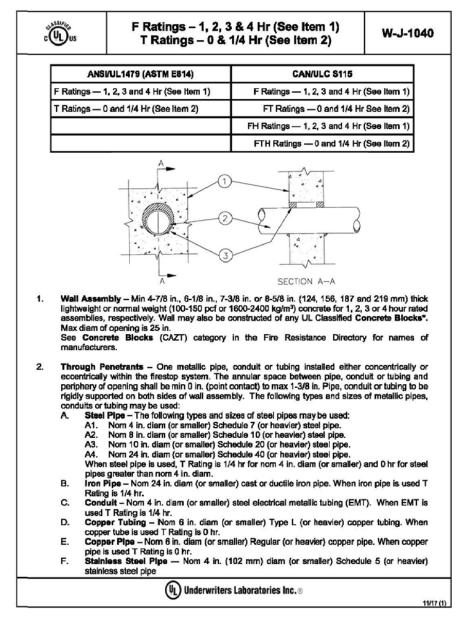


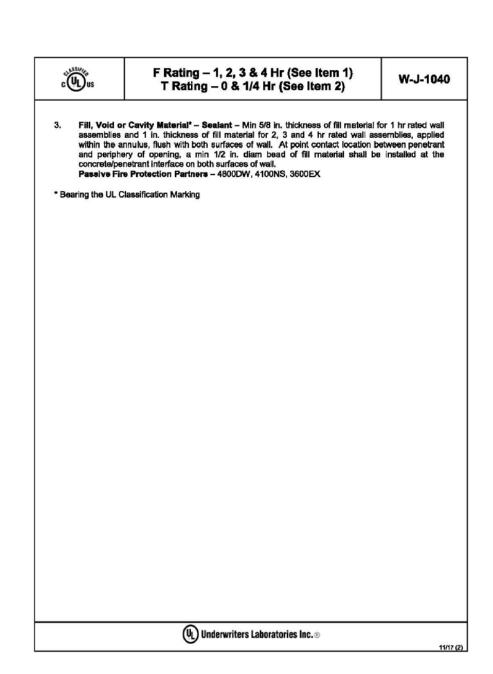


### CMU PENETRATION

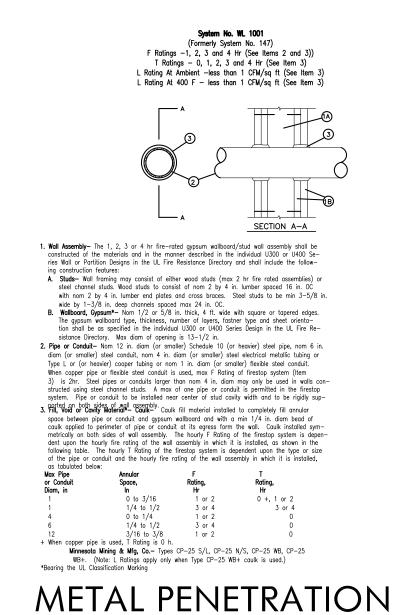


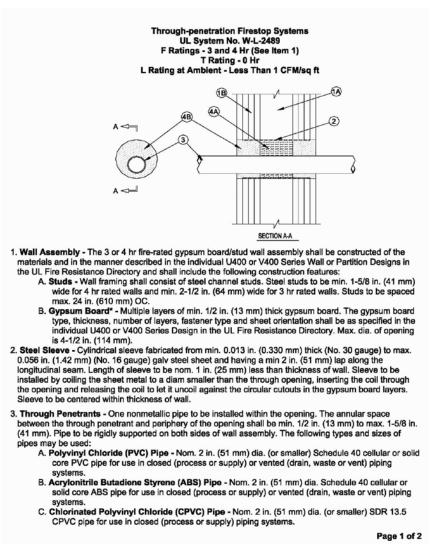

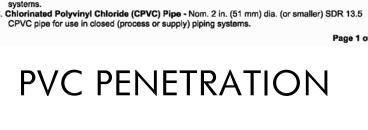


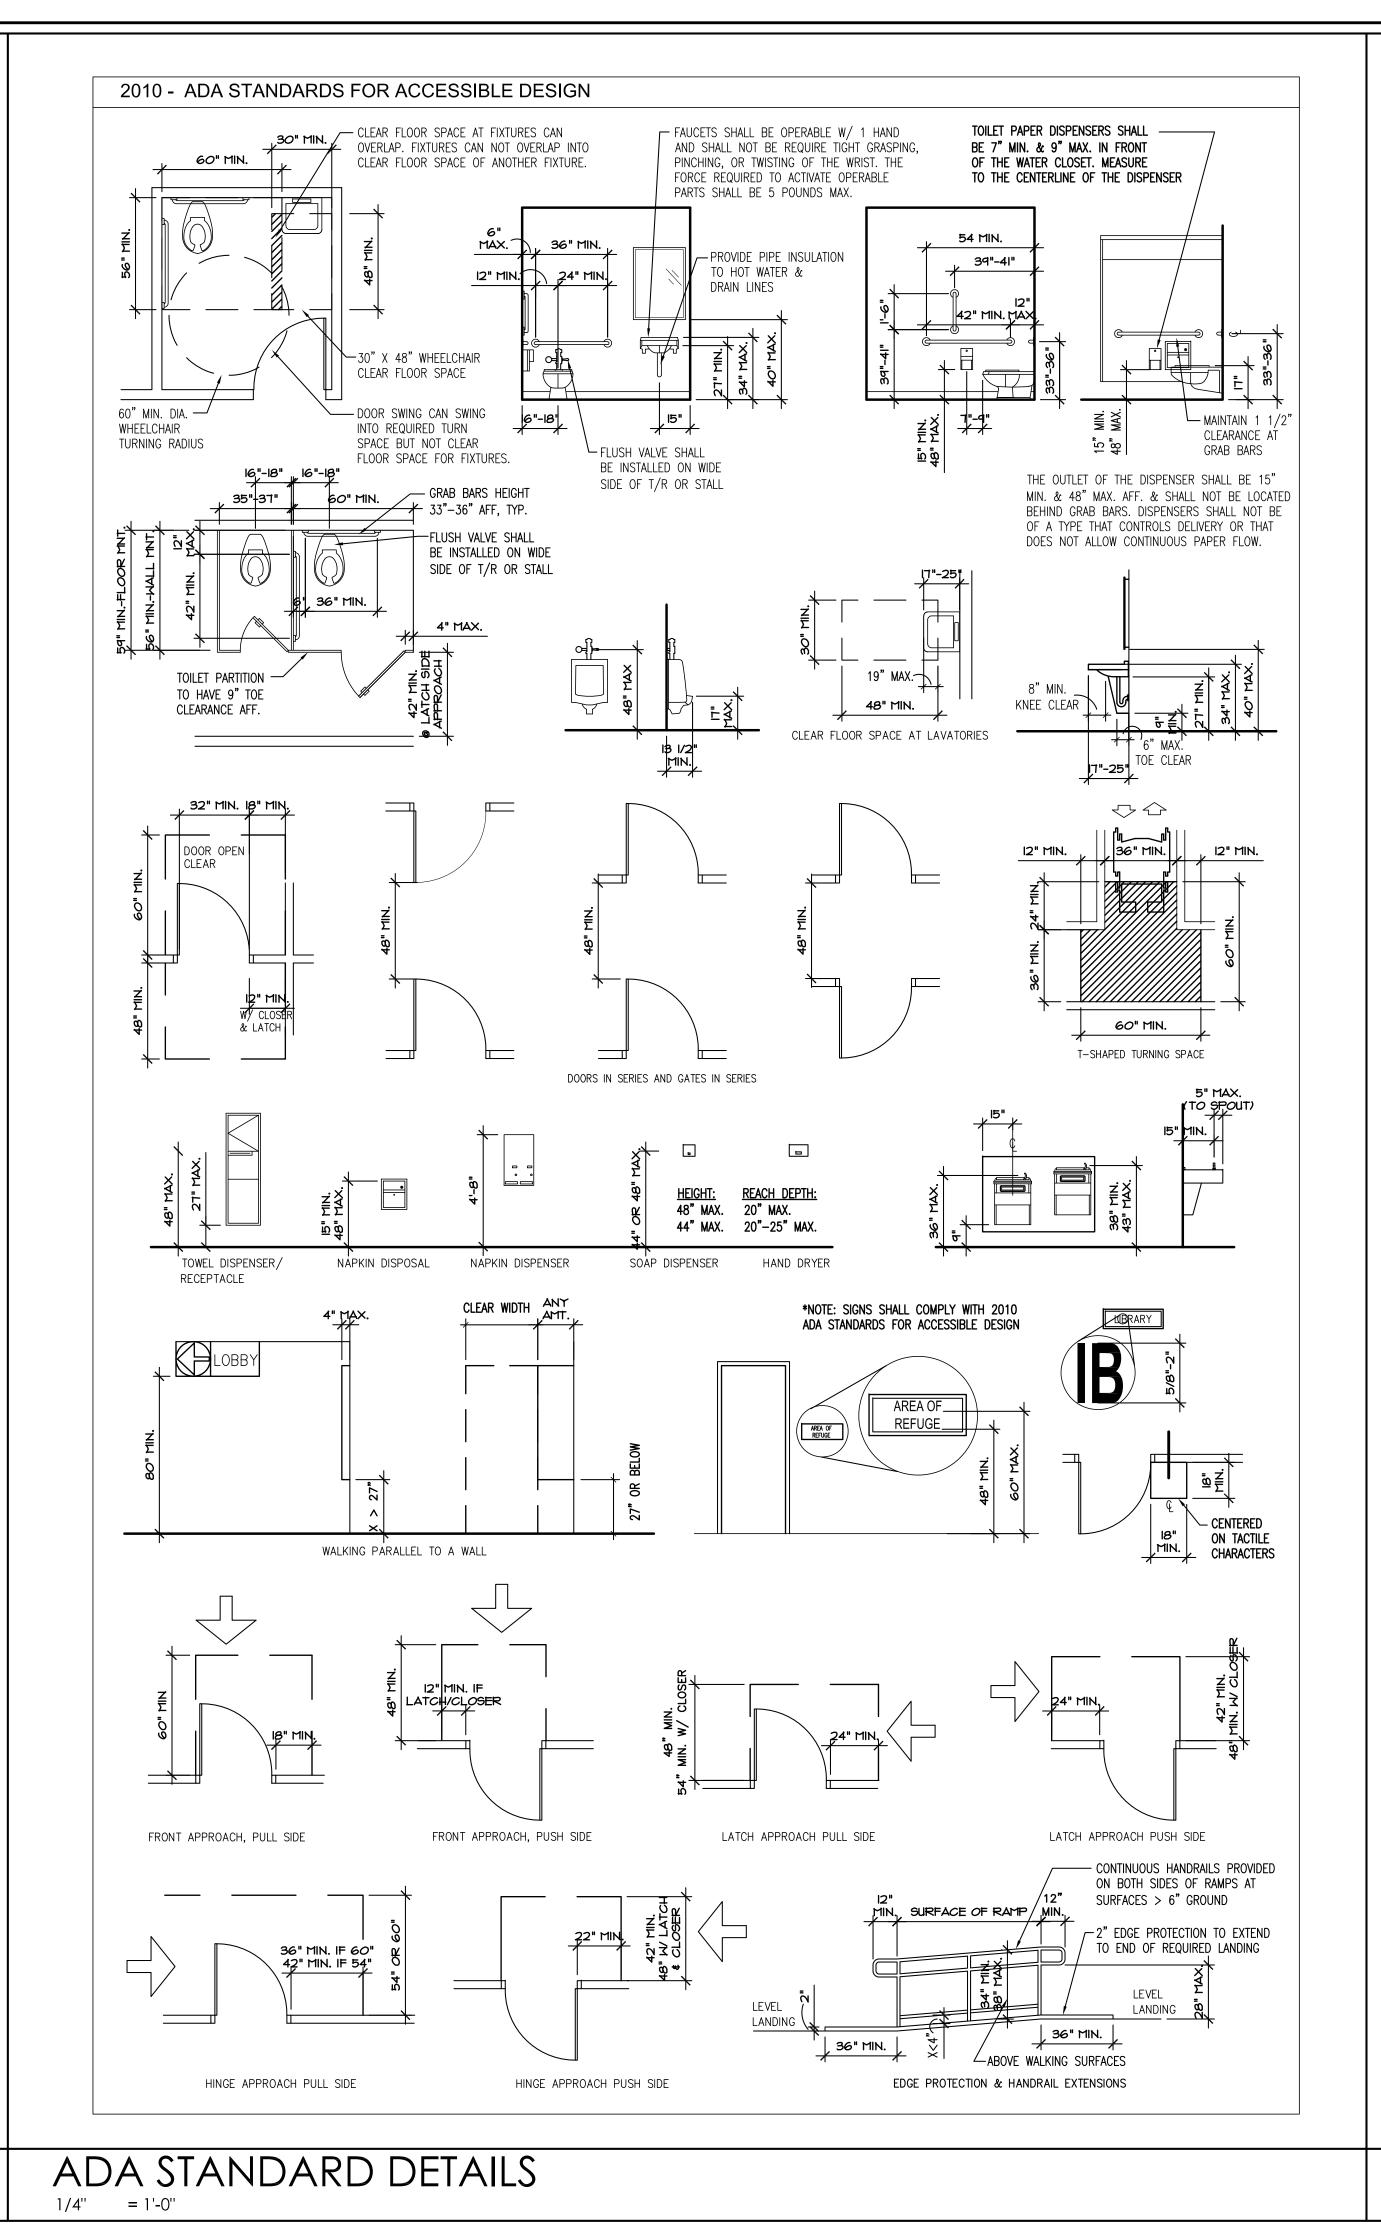

FIRE RATED CONSTRUCTION DETAILS

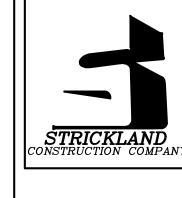



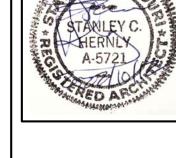

Hernly ASSOCIÁTES

TO BE ACCESSIBLE AND FOLLOW ACCESSIBILITY STANDARDS

MINIMUM NUMBER OF SPACES REQUIRED TO BE ACCESSIBLE

10, PLUS 2% OF THE TOTAL NUMBER OF UNITS OVER 200

WALKING SURFACES SHALL NOT BE STEEPER THAN 1:48.

THE RUNNING SLOPE OF WALKING SURFACES NOT STEEPER THAN 1:20. THE CROSS SLOPE OF

OPERABLE PARTS OF HARDWARE SHALL BE 34" MIN. AND 48" MAX. ABOVE FINISHED FLOOR OR GROUND

INDIVIDUAL SELF-SERVICE STORAGE SPACES SHALL BE DISPERSED THROUGHOUT THE VARIOUS CLASSES OF SPACES PROVIDED. WHERE MORE CLASSES OF SPACES

ARE PROVIDED THAN THE NUMBER REQUIRED TO BE ACCESSIBLE, THE NUMBER OF SPACES SHALL NOT BE REQUIRED TO EXCEED THAT REQUIRED BY TABLE 225.3.

SELF-SERVICE STORAGE SPACES COMPLYING WITH TABLE 225.3 SHALL NOT BE REQUIRED TO BE DISPERSED AMONG BUILDINGS IN A MULTI-BUILDING FACILITY.

ACCESSIBLE UNITS MUST ALSO PROVIDE ACCESSIBLE ROUTES TO ACCESSIBLE MEANS OF EGRESS, PARKING SPACES, AND COMMON USE ELEMENTS & FACILITIES

5%, BUT NOT LESS THAN 1

1/2" HIGH MAXIMUM


5 POUNDS MAXIMUM


1100 Rhode Island Lawrence, Kansas 785 - 749 - 5806 FAX 785 - 749 - 1515

1ST STORY PLAN

2022/11/08

Date: Drawn by: SJB Checked by: **SCH** Revisions:

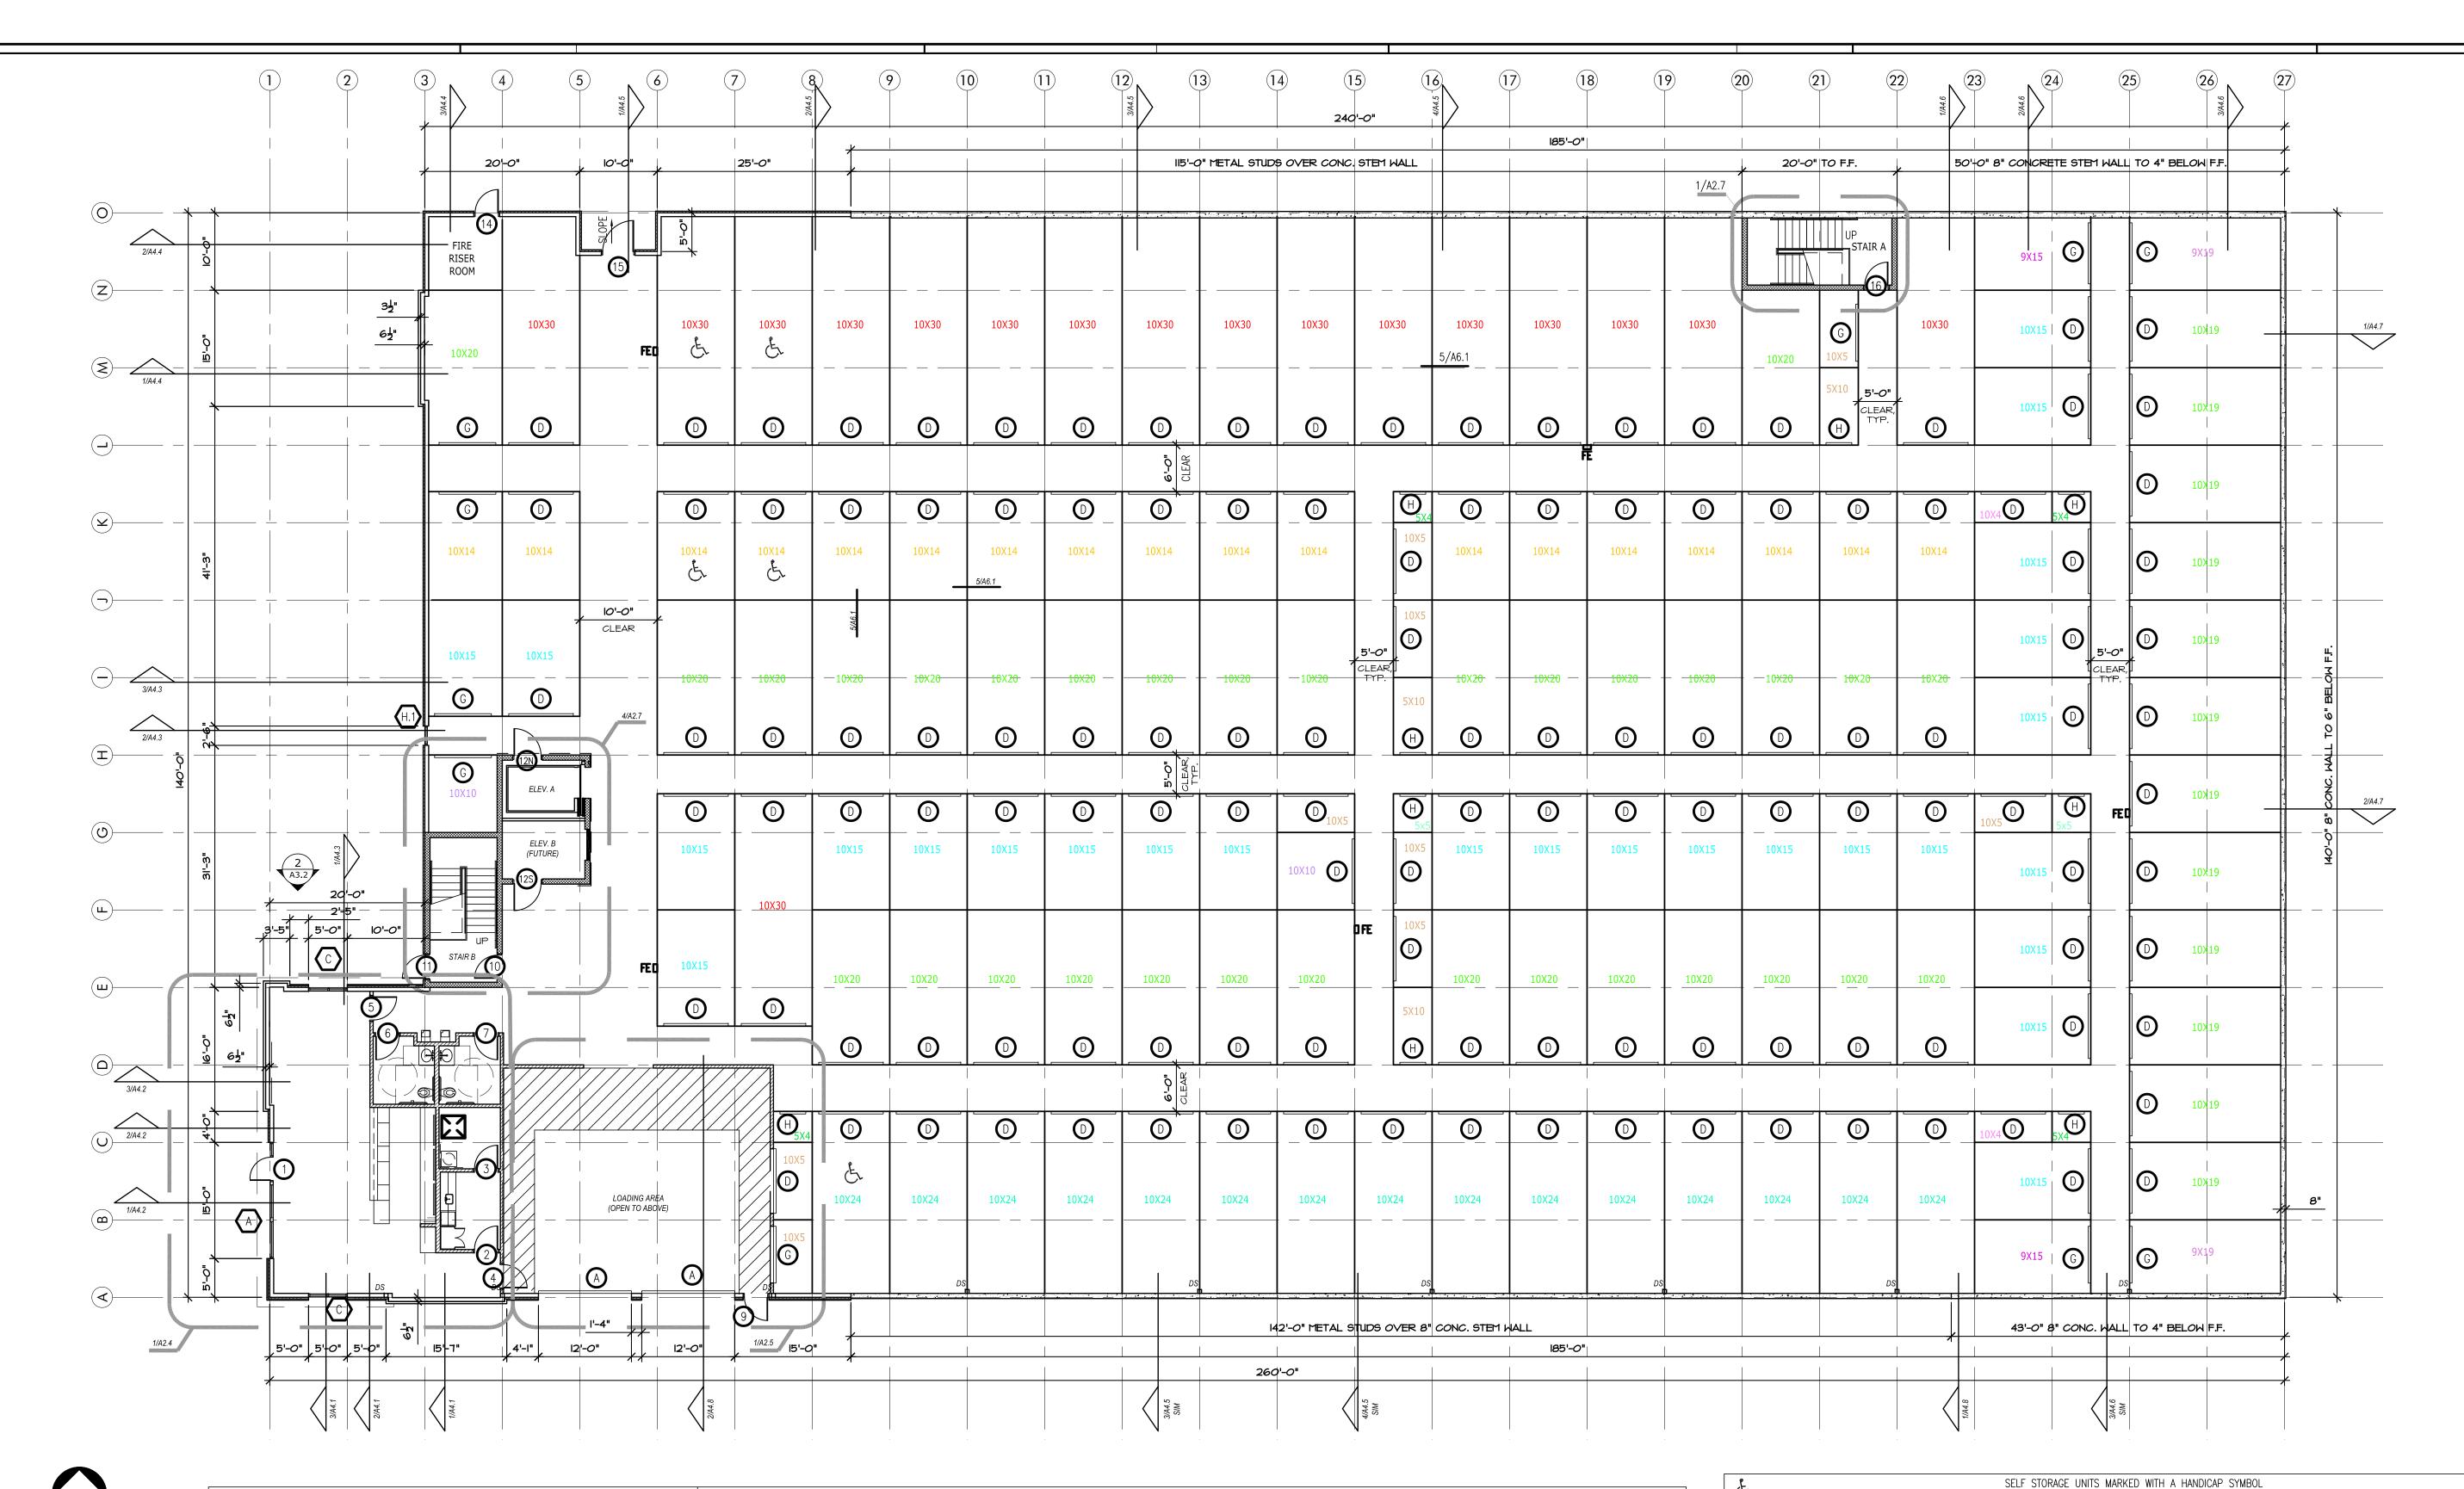

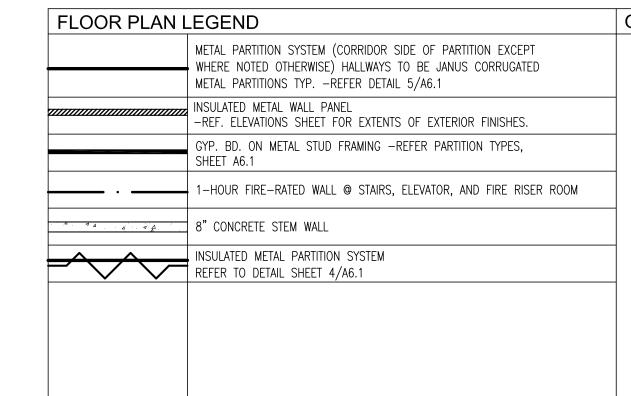

PLAN NORTH

#### GENERAL NOTES (TYPICAL ALL SHEETS)

PROVIDED AND INSTALLED BY GENERAL CONTRACTOR.

. INTERIOR AND EXTERIOR STORAGE UNIT SIGNAGE TO BE APPROVED BY OWNER. SIGNAGE TO BE

2. GENERAL CONTRACTOR TO COORDINATE ALL FOUNDATION PENETRATIONS WITH STRUCTURAL ENGINEER.

3. ROOF PANELS TO BE 60 MIL TPO ROOF TO MEET LOCAL WIND LOAD REQUIREMENTS ENGINEERED BY METAL BUILDING MANUFACTURER.

4. GENERAL CONTRACTOR/TPO ROOFING SUBCONTRACTOR TO SIZE/SPACE INTERNAL ROOF DRAINS AS REQUIRED TO MEET LOCAL REQUIREMENTS. SECONDARY ROOF DRAINS TO BE PROVIDED. GENERAL CONTRACTOR TO COORDINATE CONNECTION TO UNDERGROUND STORM DRAIN.

5. GENERAL CONTRACTOR IS TO SUBMIT ALL SAMPLES OF PRODUCTS, ETC. TO OWNER FOR APPROVAL/ SELECTION OF ALL COLORS, FINISHES, ETC. PRIOR TO PURCHASE AND INSTALLATION

6. ALL EXTERIOR WALL DIMENSIONS ARE TO FOUNDATION (INCL. LUG) UNLESS NOTED OTHERWISE. 3RD FLOOR EXTERIOR WALL DIMENSIONS ARE TO FINISH MATERIAL. ALL INTERIOR DIMENSIONS ARE TO OUTER FACE OF MATERIAL USED UNLESS NOTED OTHERWISE.

7. NOT USED.

- 10. BUILDING MUST COMPLY W/ LOCAL AMERICAN W/ DISABILITIES ACT -REF. SHEET A2.6
- 11. FURR OUT WALL IN ELECTRICAL ROOMS TO RECESS ELECTRICAL PANEL.
- 12. ALL INTERIOR CMU TO BE PAINTED SW PRO CLASSIC B31 SERIES PAINT EXCLUDING INSIDE OF INDIVIDUAL STORAGE UNITS. ALL CMU INSIDE INDIVIDUAL STORAGE UNITS NOT TO BE
- 13. FIRE RISER ROOM TO HAVE 1—HR FIRE—RATED WALLS AND CEILING. REFER UL FIRE—RATED - ASSEMBLES, SHEET A1.3
- 14. GENERAL CONTRACTOR TO COORDINATE STANDPIPE/FIRE SPRINKLER DESIGN WITH ROOM SIZE AND

PROVIDE & INSTALL FIRE EXTINGUISHERS (FE) WALL CABINETS. RECESS CABINETS @ 48" A.F.F. RECESSED, FLUSH WITH WALL AT ALL INTERIOR APPLICATIONS. MOUNT TO PIERS,	
48" A.F.F. IN HEAVY DUTY OUTDOORS FIRE EXTINGUISHER CABINET AT ALL EXTERIOR APPLICATIONS. LOCATE ONE CLASS 2-A FIRE EXTINGUISHER SO THAT MAX. TRAVEL DISTANCE IS 75 L.F.	
W/ A MINIMUM OF 1 FOR EVERY 11,250 S.F. PER TABLE 906.3(1) OF THE 2015 INTERNATIONAL	
FIRE CODE OR AS DIRECTED BY LOCAL AUTHORITIES HAVING JURISDICTION. (KEYED ON FLOOR PLANS)	
FURR OUT WALL AT FE LOCATIONS W/ 6" METAL STUDS AND METAL WALL PANEL EACH SIDE.	

TABLE 225.3

1 TO 200

201 AND OVER

TOTAL SPACES IN FACILITY

SECTION 225.3.1 DISPERSION.

403.3 ACCESSIBLE ROUTE

404.2.5 THRESHOLDS

ADA CALCULATIONS:

590 UNITS

404.2.7 DOOR HARDWARE

404.2.9 DOOR OPENING FORCE

(TOILET ROOMS, DRINKING FOUNTAINS, ETC.).

ACCESSIBLE UNITS MUST MEET THE FOLLOWING CRITERIA:

PROVIDE JANUS ADA KIT (THREE STRAPS AND ACCESSIBLE SIGN) -JANUS TO INSTALL


390 UNITS X .02 = 7.8 SPACES + 10 SPACES = 18 SPACES REQUIRED

9. FLOOR FINISH CONCRETE TO BE POLISHED CONCRETE IN CORRIDORS ONLY. (EXCLUDING STORAGE UNITS)


PAINTED OR SEALED.

CONFIGURATION.

FIRST STORY PLAN

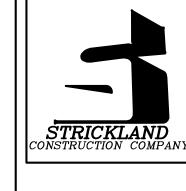



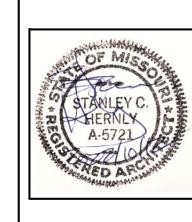


Hernly ASSOCIATES


> 1100 Rhode Island Lawrence, Kansas 785 - 749 - 5806 FAX 785 - 749 - 1515

2ND STORY PLAN

2022/11/08

Date: Drawn by: SJB Checked by: **SCH** Revisions :

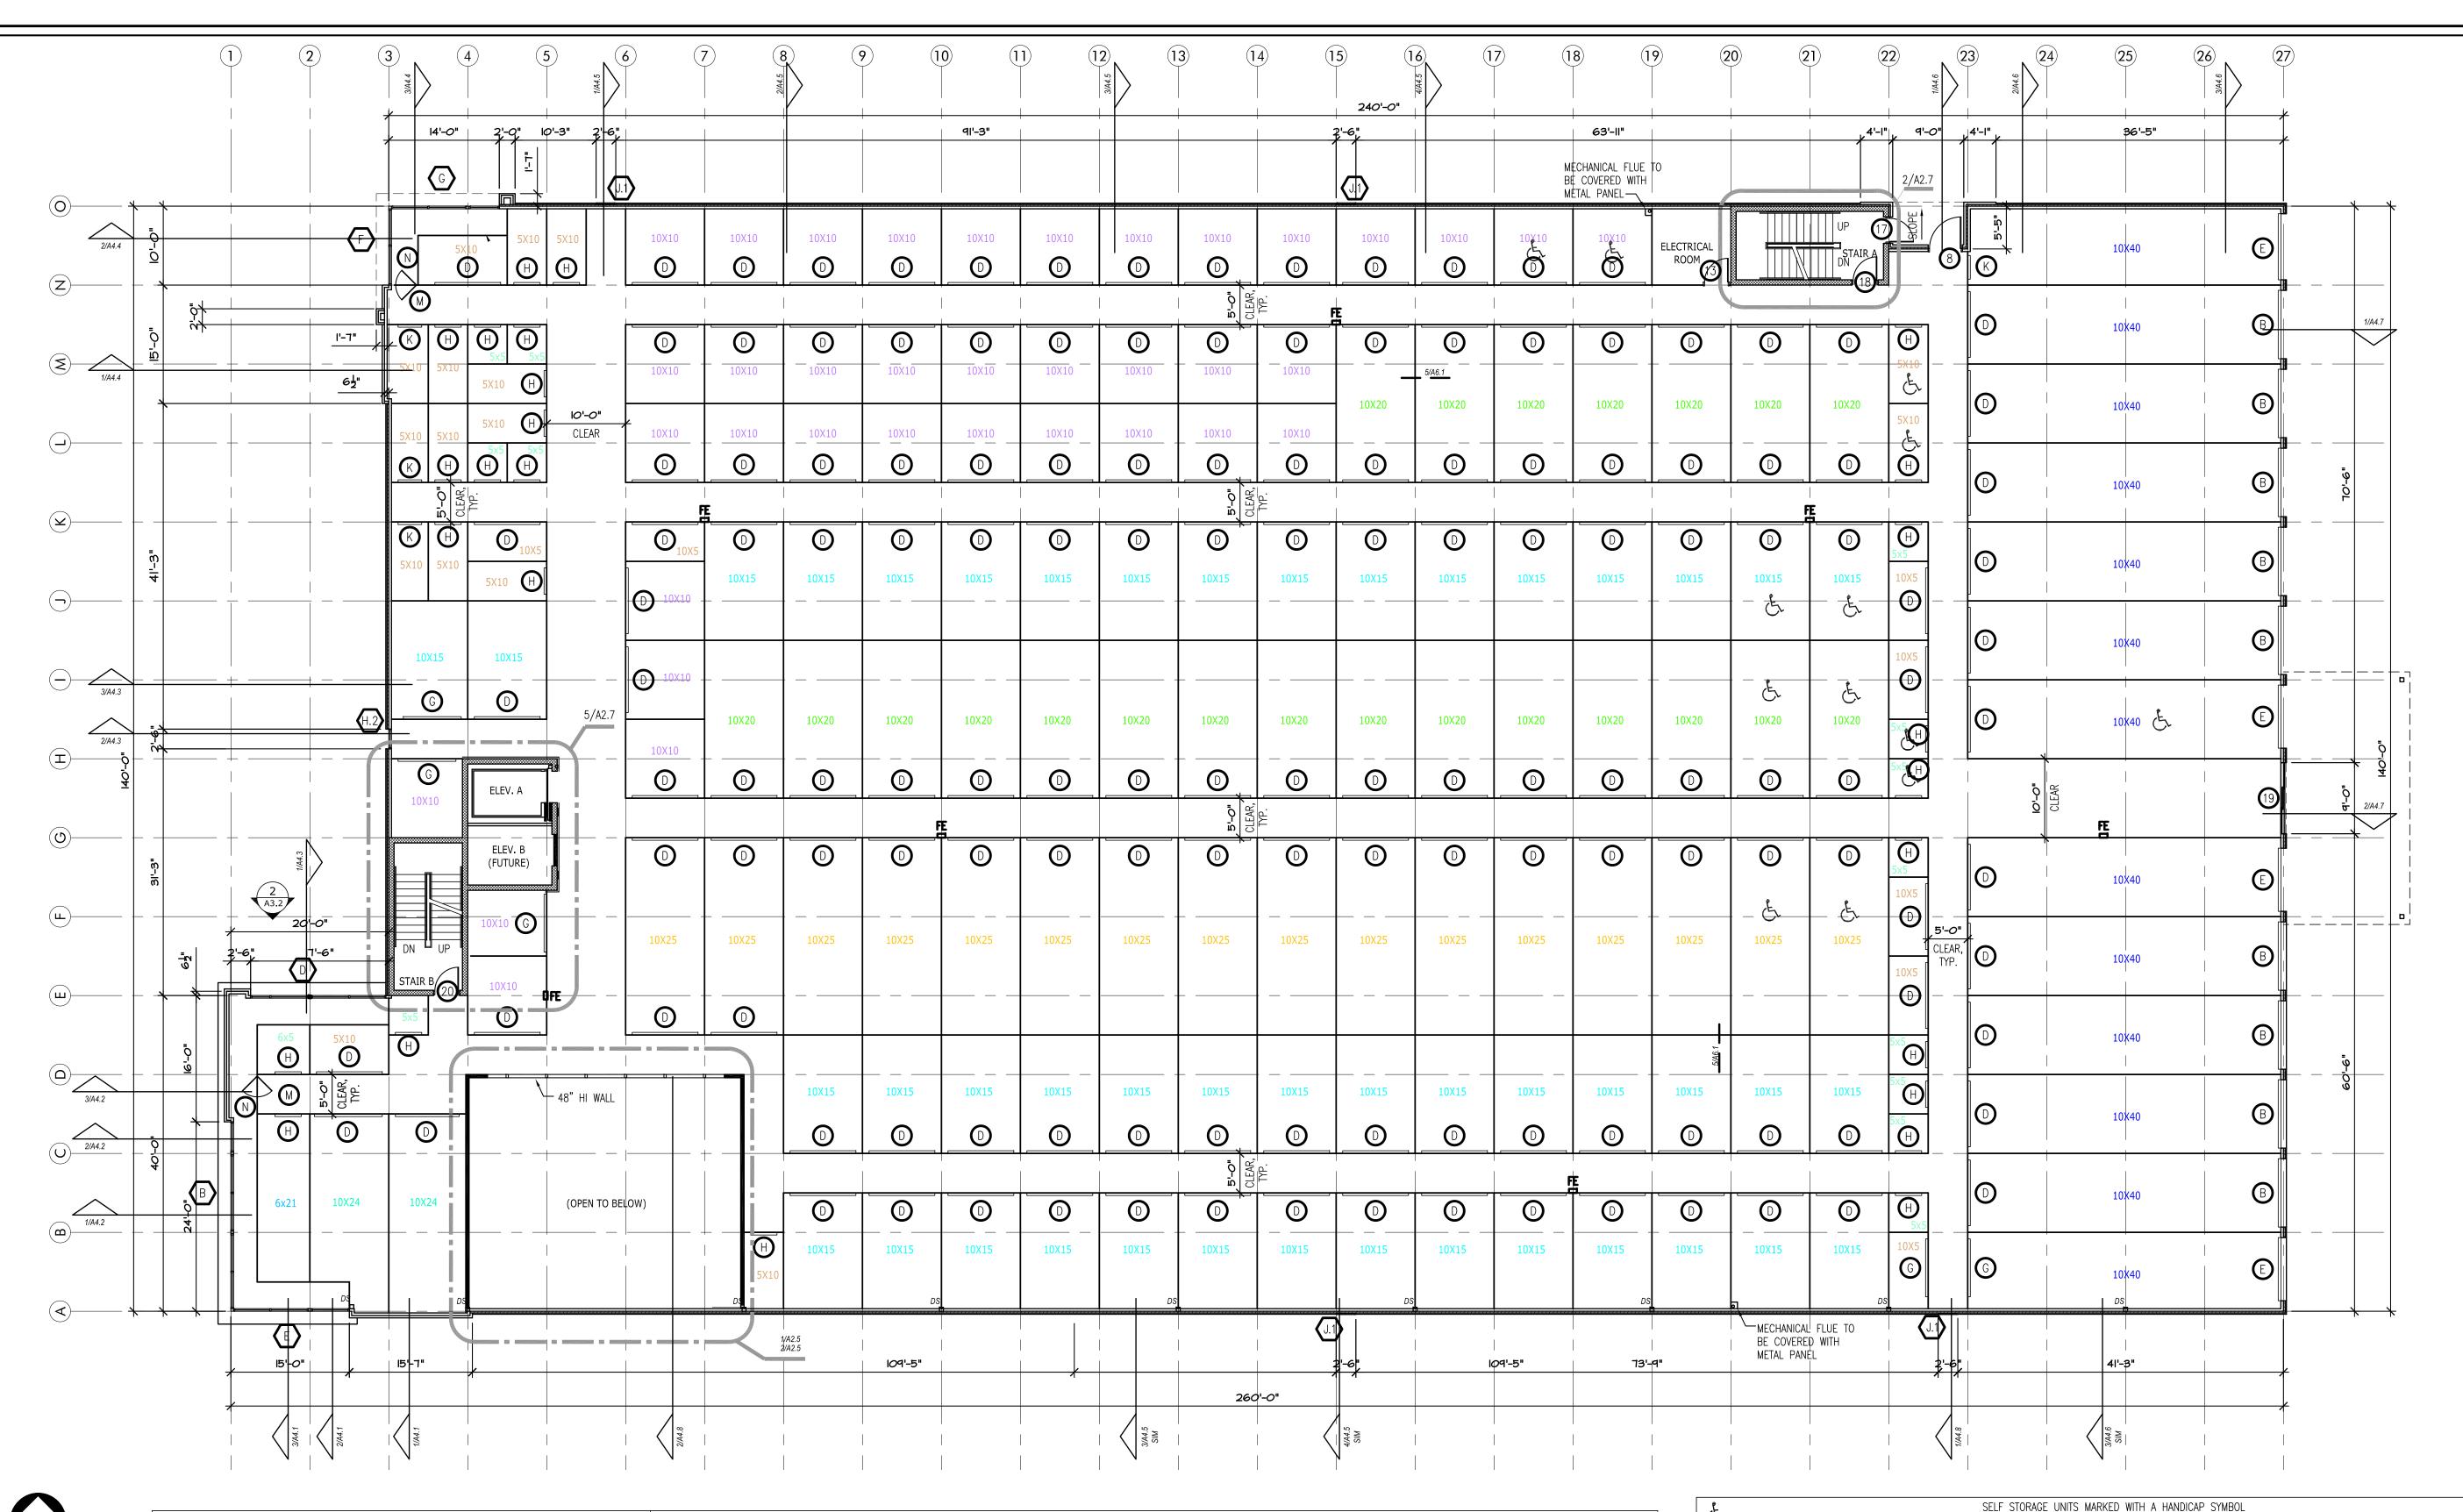

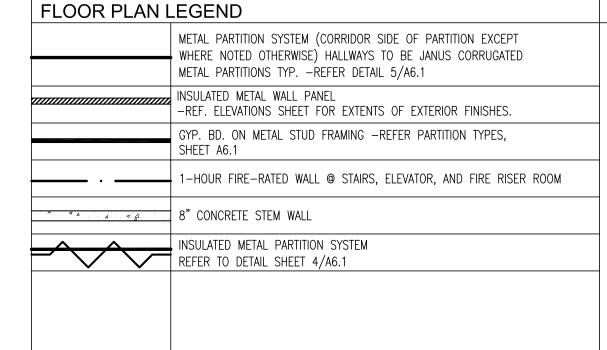

#### GENERAL NOTES (TYPICAL ALL SHEETS)

. INTERIOR AND EXTERIOR STORAGE UNIT SIGNAGE TO BE APPROVED BY OWNER. SIGNAGE TO BE

PROVIDED AND INSTALLED BY GENERAL CONTRACTOR.

2. GENERAL CONTRACTOR TO COORDINATE ALL FOUNDATION PENETRATIONS WITH STRUCTURAL ENGINEER.

3. ROOF PANELS TO BE 60 MIL TPO ROOF TO MEET LOCAL WIND LOAD REQUIREMENTS ENGINEERED

BY METAL BUILDING MANUFACTURER. 4. GENERAL CONTRACTOR/TPO ROOFING SUBCONTRACTOR TO SIZE/SPACE INTERNAL ROOF DRAINS AS

REQUIRED TO MEET LOCAL REQUIREMENTS. SECONDARY ROOF DRAINS TO BE PROVIDED. GENERAL

CONTRACTOR TO COORDINATE CONNECTION TO UNDERGROUND STORM DRAIN. 5. GENERAL CONTRACTOR IS TO SUBMIT ALL SAMPLES OF PRODUCTS, ETC. TO OWNER FOR APPROVAL/

SELECTION OF ALL COLORS, FINISHES, ETC. PRIOR TO PURCHASE AND INSTALLATION

6. ALL EXTERIOR WALL DIMENSIONS ARE TO FOUNDATION (INCL. LUG) UNLESS NOTED OTHERWISE. 3RD FLOOR EXTERIOR WALL DIMENSIONS ARE TO FINISH MATERIAL. ALL INTERIOR DIMENSIONS ARE TO OUTER FACE OF MATERIAL USED UNLESS NOTED OTHERWISE.

7. NOT USED.

- 8. PROVIDE & INSTALL FIRE EXTINGUISHERS (FE) WALL CABINETS. RECESS CABINETS @ 48" A.F.F. RECESSED, FLUSH WITH WALL AT ALL INTERIOR APPLICATIONS. MOUNT TO PIERS, 48" A.F.F. IN HEAVY DUTY OUTDOORS FIRE EXTINGUISHER CABINET AT ALL EXTERIOR APPLICATIONS. LOCATE ONE CLASS 2-A FIRE EXTINGUISHER SO THAT MAX. TRAVEL DISTANCE IS 75 L.F. W/ A MINIMUM OF 1 FOR EVERY 11,250 S.F. PER TABLE 906.3(1) OF THE 2015 INTERNATIONAL FIRE CODE OR AS DIRECTED BY LOCAL AUTHORITIES HAVING JURISDICTION. (KEYED ON FLOOR PLANS) FURR OUT WALL AT FE LOCATIONS W/ 6" METAL STUDS AND METAL WALL PANEL EACH SIDE.
- 9. FLOOR FINISH CONCRETE TO BE POLISHED CONCRETE IN CORRIDORS ONLY.

11. FURR OUT WALL IN ELECTRICAL ROOMS TO RECESS ELECTRICAL PANEL.

(EXCLUDING STORAGE UNITS)

- 10. BUILDING MUST COMPLY W/ LOCAL AMERICAN W/ DISABILITIES ACT -REF. SHEET A2.6
- 12. ALL INTERIOR CMU TO BE PAINTED SW PRO CLASSIC B31 SERIES PAINT EXCLUDING INSIDE OF INDIVIDUAL STORAGE UNITS. ALL CMU INSIDE INDIVIDUAL STORAGE UNITS NOT TO BE
- 13. FIRE RISER ROOM TO HAVE 1—HR FIRE—RATED WALLS AND CEILING. REFER UL FIRE—RATED — ASSEMBLES, SHEET A1.3
- 14. GENERAL CONTRACTOR TO COORDINATE STANDPIPE/FIRE SPRINKLER DESIGN WITH ROOM SIZE AND CONFIGURATION.


5	TO BE ACCESSIBLE AND FOLLOW ACCESSIBILITY STANDARDS					
TABLE 225.3						
TOTAL SPACES IN FACILITY	MINIMUM NUMBER OF SPACES REQUIRED TO BE ACCESSIBLE					
1 TO 200	5%, BUT NOT LESS THAN 1					
201 AND OVER	10, PLUS 2% OF THE TOTAL NUMBER OF UNITS OVER 200					
SECTION 225.3.1 DISPERSION.						
ARE PROVIDED THAN THE NUMBER REQUIRED TO BE ACCES SELF—SERVICE STORAGE SPACES COMPLYING WITH TABLE 22	ERSED THROUGHOUT THE VARIOUS CLASSES OF SPACES PROVIDED. WHERE MORE CLASSES OF SPACES SIBLE, THE NUMBER OF SPACES SHALL NOT BE REQUIRED TO EXCEED THAT REQUIRED BY TABLE 225.3. 25.3 SHALL NOT BE REQUIRED TO BE DISPERSED AMONG BUILDINGS IN A MULTI-BUILDING FACILITY.					
ACCESSIBLE UNITS MUST MEET THE FOLLOWING CRITERIA:						
403.3 ACCESSIBLE ROUTE	THE RUNNING SLOPE OF WALKING SURFACES NOT STEEPER THAN 1:20. THE CROSS SLOPE OF WALKING SURFACES SHALL NOT BE STEEPER THAN 1:48.					
404.2.5 THRESHOLDS	1/2" HIGH MAXIMUM					
404.2.7 DOOR HARDWARE	OPERABLE PARTS OF HARDWARE SHALL BE 34" MIN. AND 48" MAX. ABOVE FINISHED FLOOR OR GROUND					
404.2.9 DOOR OPENING FORCE	5 POUNDS MAXIMUM					
ACCESSIBLE UNITS MUST ALSO PROVIDE ACCESSIBLE ROUTE (TOILET ROOMS, DRINKING FOUNTAINS, ETC.).	S TO ACCESSIBLE MEANS OF EGRESS, PARKING SPACES, AND COMMON USE ELEMENTS & FACILITIES					
PROVIDE JANUS ADA KIT (THREE STRAPS AND ACCESSIBLE	SIGN) -JANUS TO INSTALL					
ADA CALCULATIONS:						

390 UNITS X .02 = 7.8 SPACES + 10 SPACES = 18 SPACES REQUIRED

PLAN NORTH





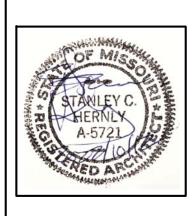

ASSOCIÁTES

1100 Rhode Island Lawrence, Kansas 785 - 749 - 5806 FAX 785 - 749 - 1515

3RD STORY PLAN

2022/11/08

Date: Drawn by: SJB Checked by: **SCH** Revisions :

	1 2	3)44.4	4 5	1/44.5	7)	8	9 (1	0 (1	1) (1	2) (1   3,4,5   2,4,5   3,4,5   3,4,5	3 (1		240'-4"	4/44.5	(17)			0 (2	(21)	22)	23 (24) (9 † 8 )	(25)	26 27 9,44%	
			26'-"	2' 6" \ \ \ \ \ \ \ \ \ \ \ \ \ \ \ \ \ \				91'-3"					2'-6" J2			   	<b>3/A2.7</b>			2	J.2	41'-8"		N
Z/A4.4		10X15	10X15 G	5'+O" . 10VE	10X15	10X15	10X15	5/A6.1 10X15	10X15 ————————————————————————————————————	10X15	10X15	10X15	10X15	10X15	10X15	10X15	10X15	1074	STAIR A	5x5	10X 10 D	10X10 10X10 D	10X10 G	
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3/A4.3		10X10	5X10 H			10X15						10X15			10X15	 10X15			10X15		YP. 10X15	10X10 D	D 10X10	
2/A4.3 	<u> </u>	(H.3) (G)		6/A2.7 D	<u></u>	<u></u>	<u></u>				<u></u>	5'-o"		<u></u>	0	<u></u>	0	<u> </u>	0	5X10 H	10X1 <sub>5</sub>	10X10 D	D 10X10	— — <u>— — — — — — — — — — — — — — — — — </u>
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	2'-6"	DN	ROOF HATCH LADDER -REF. IA/AI.3	© <sup>10x5</sup>	D TOXS	(D)10X5	<b>O</b> 10X5	<b>D</b> 10X5	<b>O</b> 10X5	<b>O</b> 10X5	(D)10X5	D 10X5	er.	D 10X5	D <sup>10X5</sup>	© <sup>10X5</sup>	<b>D</b> 10X5	<b>D</b> <sup>10X5</sup>	(D)10X5		D 10X15	10X10 D	D 10X10	
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		-1	r'   	1 1   					 	 	   260 		*1	 			 	 	 		1			

PLAN NORTH

	METAL PARTITION SYSTEM (CORRIDOR SIDE OF PARTITION EXCEPT WHERE NOTED OTHERWISE) HALLWAYS TO BE JANUS CORRUGATED METAL PARTITIONS TYPREFER DETAIL 5/A6.1	I. INTERIOR AND EXTERIOR STORAGE UNIT SIGNAGE TO BE APPROVED BY OWNER. SIGNAGE TO BE PROVIDED AND INSTALLED BY GENERAL CONTRACTOR.      SENERAL CONTRACTOR TO COORDINATE ALL FOUNDATION PENETRATIONS WITH STRUCTURAL ENGINEER.	8. PROVIDE & INSTALL FIRE EXTINGU RECESSED, FLUSH WITH WALL AT 48" A.F.F. IN HEAVY DUTY OUTDO
	-REF. ELEVATIONS SHEET FOR EXTENTS OF EXTERIOR FINISHES.  GYP. BD. ON METAL STUD FRAMING -REFER PARTITION TYPES,	3. ROOF PANELS TO BE 60 MIL TPO ROOF TO MEET LOCAL WIND LOAD REQUIREMENTS ENGINEERED BY METAL BUILDING MANUFACTURER.	LOCATE ONE CLASS 2-A FIRE EX W/ A MINIMUM OF 1 FOR EVERY FIRE CODE OR AS DIRECTED BY FURR OUT WALL AT FE LOCATION
	SHEET A6.1  1-HOUR FIRE-RATED WALL @ STAIRS, ELEVATOR, AND FIRE RISER ROOM	4. GENERAL CONTRACTOR/TPO ROOFING SUBCONTRACTOR TO SIZE/SPACE INTERNAL ROOF DRAINS AS REQUIRED TO MEET LOCAL REQUIREMENTS. SECONDARY ROOF DRAINS TO BE PROVIDED. GENERAL CONTRACTOR TO COORDINATE CONNECTION TO UNDERGROUND STORM DRAIN.	FLOOR FINISH CONCRETE TO BE F     (EXCLUDING STORAGE UNITS)
44.44	8" CONCRETE STEM WALL INSULATED METAL PARTITION SYSTEM	5. GENERAL CONTRACTOR IS TO SUBMIT ALL SAMPLES OF PRODUCTS, ETC. TO OWNER FOR APPROVAL/ SELECTION OF ALL COLORS, FINISHES, ETC. PRIOR TO PURCHASE AND INSTALLATION	10. BUILDING MUST COMPLY W/ LOC
	REFER TO DETAIL SHEET 4/A6.1	6. ALL EXTERIOR WALL DIMENSIONS ARE TO FOUNDATION (INCL. LUG) UNLESS NOTED OTHERWISE. 3RD FLOOR EXTERIOR WALL DIMENSIONS ARE TO FINISH MATERIAL. ALL INTERIOR DIMENSIONS ARE TO OUTER FACE OF MATERIAL USED UNLESS NOTED OTHERWISE.	12. ALL INTERIOR CMU TO BE PAINTE INSIDE OF INDIVIDUAL STORAGE U PAINTED OR SEALED.
		7. NOT USED.	13. FIRE RISER ROOM TO HAVE 1—H ——ASSEMBLES, SHEET A1.3
			14. GENERAL CONTRACTOR TO COORD

GENERAL NOTES (TYPICAL ALL SHEETS)

- PROVIDE & INSTALL FIRE EXTINGUISHERS (FE) WALL CABINETS. RECESS CABINETS @ 48" A.F.F. RECESSED, FLUSH WITH WALL AT ALL INTERIOR APPLICATIONS. MOUNT TO PIERS, 48" A.F.F. IN HEAVY DUTY OUTDOORS FIRE EXTINGUISHER CABINET AT ALL EXTERIOR APPLICATIONS. LOCATE ONE CLASS 2—A FIRE EXTINGUISHER SO THAT MAX. TRAVEL DISTANCE IS 75 L.F. W/ A MINIMUM OF 1 FOR EVERY 11,250 S.F. PER TABLE 906.3(1) OF THE 2015 INTERNATIONAL FIRE CODE OR AS DIRECTED BY LOCAL AUTHORITIES HAVING JURISDICTION. (KEYED ON FLOOR PLANS) FURR OUT WALL AT FE LOCATIONS W/ 6" METAL STUDS AND METAL WALL PANEL EACH SIDE.
- FLOOR FINISH CONCRETE TO BE POLISHED CONCRETE IN CORRIDORS ONLY.
- . BUILDING MUST COMPLY W/ LOCAL AMERICAN W/ DISABILITIES ACT -REF. SHEET A2.6 . FURR OUT WALL IN ELECTRICAL ROOMS TO RECESS ELECTRICAL PANEL.
- 2. ALL INTERIOR CMU TO BE PAINTED SW PRO CLASSIC B31 SERIES PAINT EXCLUDING INSIDE OF INDIVIDUAL STORAGE UNITS. ALL CMU INSIDE INDIVIDUAL STORAGE UNITS NOT TO BE PAINTED OR SEALED.
- 3. FIRE RISER ROOM TO HAVE 1—HR FIRE—RATED WALLS AND CEILING. REFER UL FIRE—RATED
  —ASSEMBLES, SHEET A1.3
- . GENERAL CONTRACTOR TO COORDINATE STANDPIPE/FIRE SPRINKLER DESIGN WITH ROOM SIZE AND CONFIGURATION.


TABLE 223.3							
TOTAL SPACES IN FACILITY	MINIMUM NUMBER OF SPACES REQUIRED TO BE ACCESSIBLE						
1 TO 200	5%, BUT NOT LESS THAN 1						
201 AND OVER	10, PLUS 2% OF THE TOTAL NUMBER OF UNITS OVER 200						
SECTION 225.3.1 DISPERSION.							
INDIVIDUAL SELF-SERVICE STORAGE SPACES SHALL BE DISPERSED THROUGHOUT THE VARIOUS CLASSES OF SPACES PROVIDED. WHERE MORE CLASSES OF SPACES ARE PROVIDED THAN THE NUMBER REQUIRED TO BE ACCESSIBLE, THE NUMBER OF SPACES SHALL NOT BE REQUIRED TO EXCEED THAT REQUIRED BY TABLE 225.3. SELF-SERVICE STORAGE SPACES COMPLYING WITH TABLE 225.3 SHALL NOT BE REQUIRED TO BE DISPERSED AMONG BUILDINGS IN A MULTI-BUILDING FACILITY.							
ACCESSIBLE UNITS MUST MEET THE FOLLOWING CRITERIA:							
403.3 ACCESSIBLE ROUTE	THE RUNNING SLOPE OF WALKING SURFACES NOT STEEPER THAN 1:20. THE CROSS SLOPE OF WALKING SURFACES SHALL NOT BE STEEPER THAN 1:48.						
404.2.5 THRESHOLDS	1/2" HIGH MAXIMUM						
404.2.7 DOOR HARDWARE	OPERABLE PARTS OF HARDWARE SHALL BE 34" MIN. AND 48" MAX. ABOVE FINISHED FLOOR OR GROUN						
404.2.9 DOOR OPENING FORCE	5 POUNDS MAXIMUM						
ACCESSIBLE UNITS MUST ALSO PROVIDE ACCESSIBLE ROUTES TO ACCESSIBLE MEANS OF EGRESS, PARKING SPACES, AND COMMON USE ELEMENTS & FACILITIES (TOILET ROOMS, DRINKING FOUNTAINS, ETC.).							
PROVIDE JANUS ADA KIT (THREE STRAPS AND ACCESSIBLE	SIGN) —JANUS TO INSTALL						
ADA CALCULATIONS: 590 UNITS -200 UNITS 390 UNITS X .02 = 7.8 SPACES + 10 SPACES =	18 SPACES REQUIRED						

SELF STORAGE UNITS MARKED WITH A HANDICAP SYMBOL TO BE ACCESSIBLE AND FOLLOW ACCESSIBILITY STANDARDS

FLOOR PLAN LEGEND





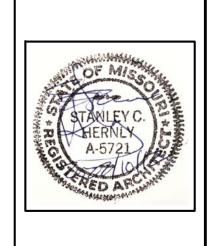



1100 Rhode Island Lawrence, Kansas 66044 785 - 749 - 5806 FAX 785 - 749 - 1515

PLAN DETAILS


Date: 2022/II/08
Drawn by: SJB
Checked by: SCH
Revisions:

A2.4

-WALL MOUNTED ABOVE WINDOW DISPLAY EXPOSED TO STRUCTURE DRINKING
FOUNTAIN
108
EXPOSED TO
STRUCTURE WOMEN'S T.R. 107 8'-0" MEN'S T.R. 106 8'-0" 6'-8" CLR. A.F.F. SALES AREA 101 RECEPTION
DESK
102
EXPOSED TO
STRUCTURE EXPOSED TO STRUCTURE 12'-11" 8'-6" MDF/BREAK ROФM 103 8'+0" EXPOSED TO STRUCTURE 6'-8" CLR. A.F.F. 6'-8" CLR. A.F.F. 6'-8" CLR. A.F.F.




	SUSPENDED PAINTED GYP. BD. CEILING	<b></b>	EXTERIOR WALL SCONCE -WALL MOUNTED
	2' X 2' OPEN GRID CEILING	<u>Δ                                    </u>	VANITY LIGHT
	4' LED LIGHT	•	PENDANT LIGHT
	2' X 4' LED LIGHT -RECESSED	0	LARGE PENDANT LIGHT
$\phi$	RECESSED LIGHT		MEP DIFFUSER
2. COORDINATE LIGH	FIXTURE SPECIFICATIONS.  HT FIXTURES AND MECHANICAL SUPPLY/RETURE OF FLOOR DECK, EXPOSED STRUCTURE AND DLOR ON A7.1)	RN PRIOR TO INSTALLATION D DUCTS IN OFFICE WHERI	I. E VISIBLE.

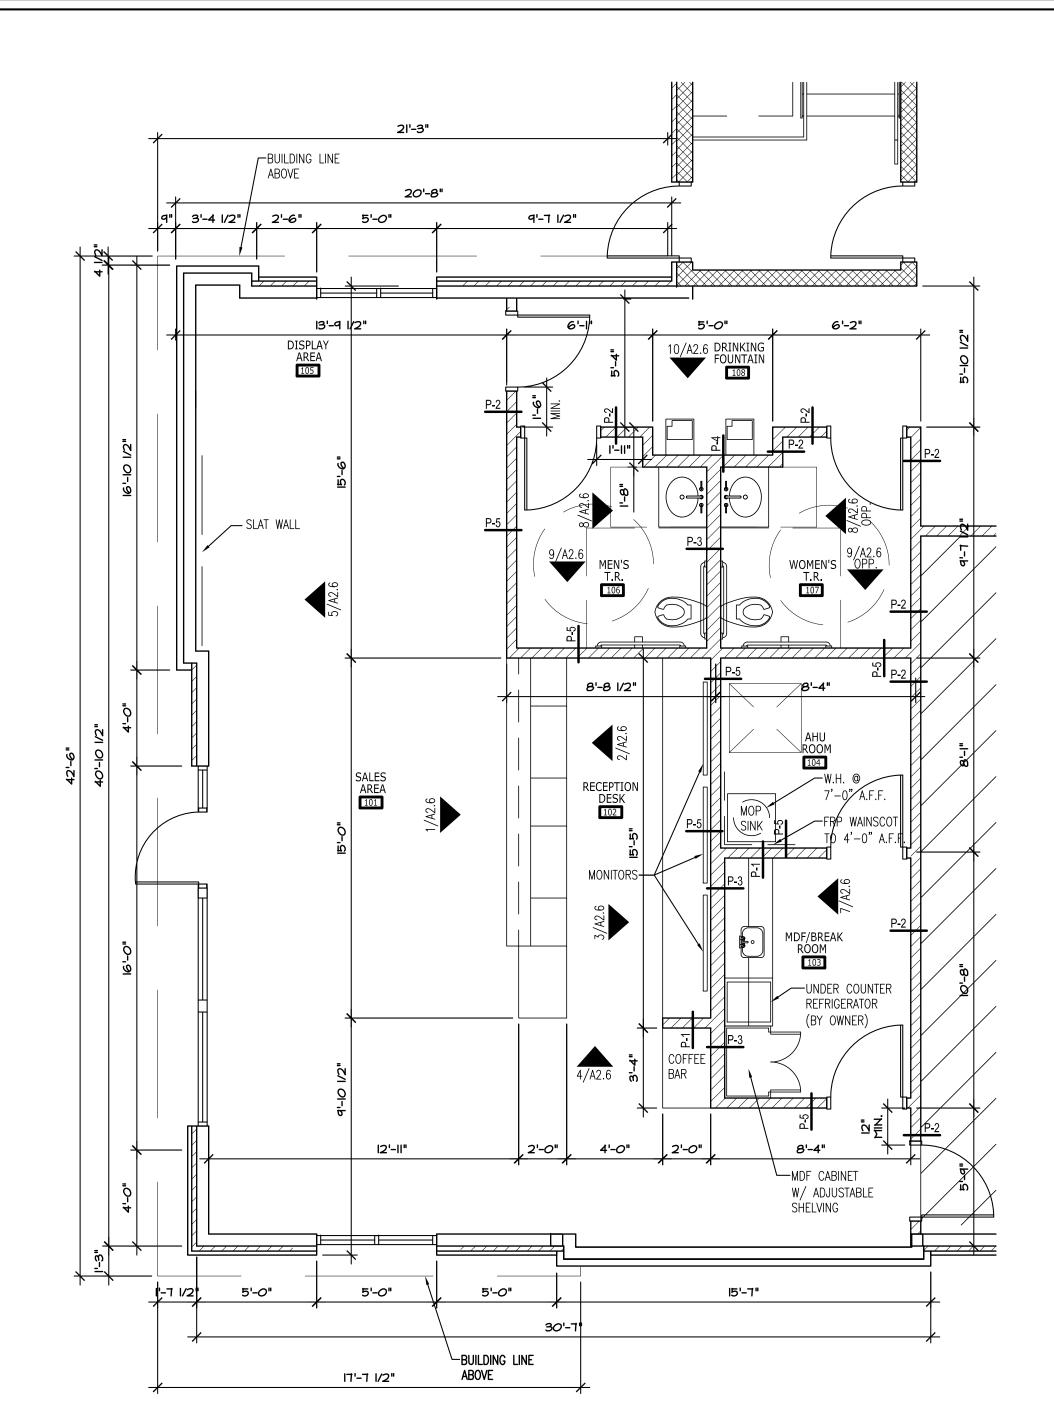



<b>ENLARGED</b>	FLOOR PLAN LEGEND
	METAL PARTITION SYSTEM (CORRIDOR SIDE OF PARTITION EXCEPT WHERE NOTED OTHERWISE) HALLWAYS TO BE JANUS CORRUGATED METAL PARTITIONS TYPREFER CORRUGATED HALLWAY SYSTEM A6.1
	METAL STUD WALL FRAMING
	INTERIOR METAL STUD WALL FRAMING -REFER PARTITION TYPES SHEET A6.1
	4" STRIPES PAINTED ON PAVING @ 2'-0" O.C. COLOR: SAFETY YELLOW
GENERAL N	IOTES
1. REFERENCE SHE	ET A6.1 FOR PARTITION TYPES (P-#)
2. BUILDING MUST	COMPLY W/ LOCAL AMERICAN W/ DISABILITIES ACT -REF. SHEET A2.6



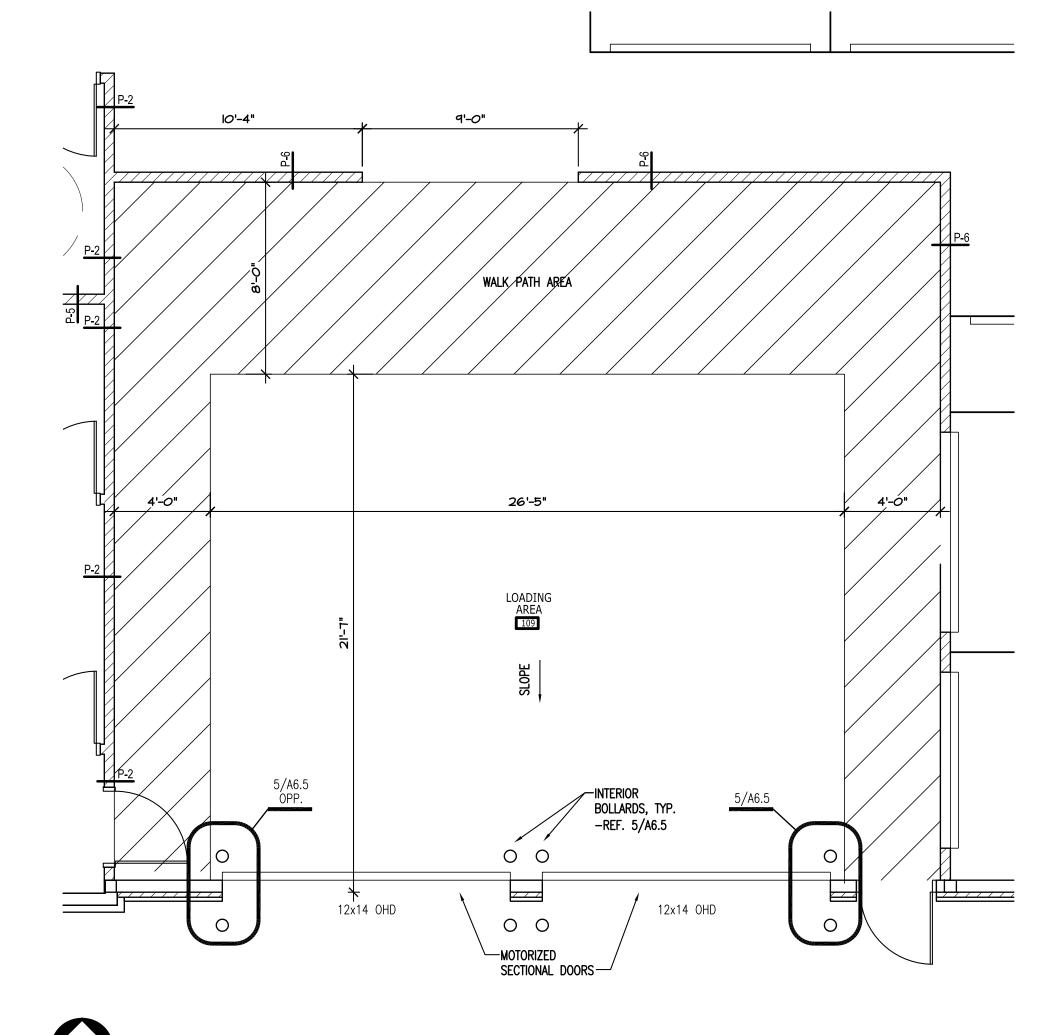

ENLARGED FLOOR PLAN LEGEND

METAL PARTITION SYSTEM (CORRIDOR SIDE OF PARTITION EXCEPT WHERE NOTED OTHERWISE)
HALLWAYS TO BE JANUS CORRUGATED METAL PARTITIONS TYP. -REFER CORRUGATED HALLWAY
SYSTEM A6.1


METAL STUD WALL FRAMING

INTERIOR METAL STUD WALL FRAMING -REFER PARTITION TYPES SHEET A6.1

4" STRIPES PAINTED ON PAVING © 2'-0" O.C. COLOR: SAFETY YELLOW


GENERAL NOTES

1. REFERENCE SHEET A6.1 FOR PARTITION TYPES (P-#)
2. BUILDING MUST COMPLY W/ LOCAL AMERICAN W/ DISABILITIES ACT -REF. SHEET A2.6

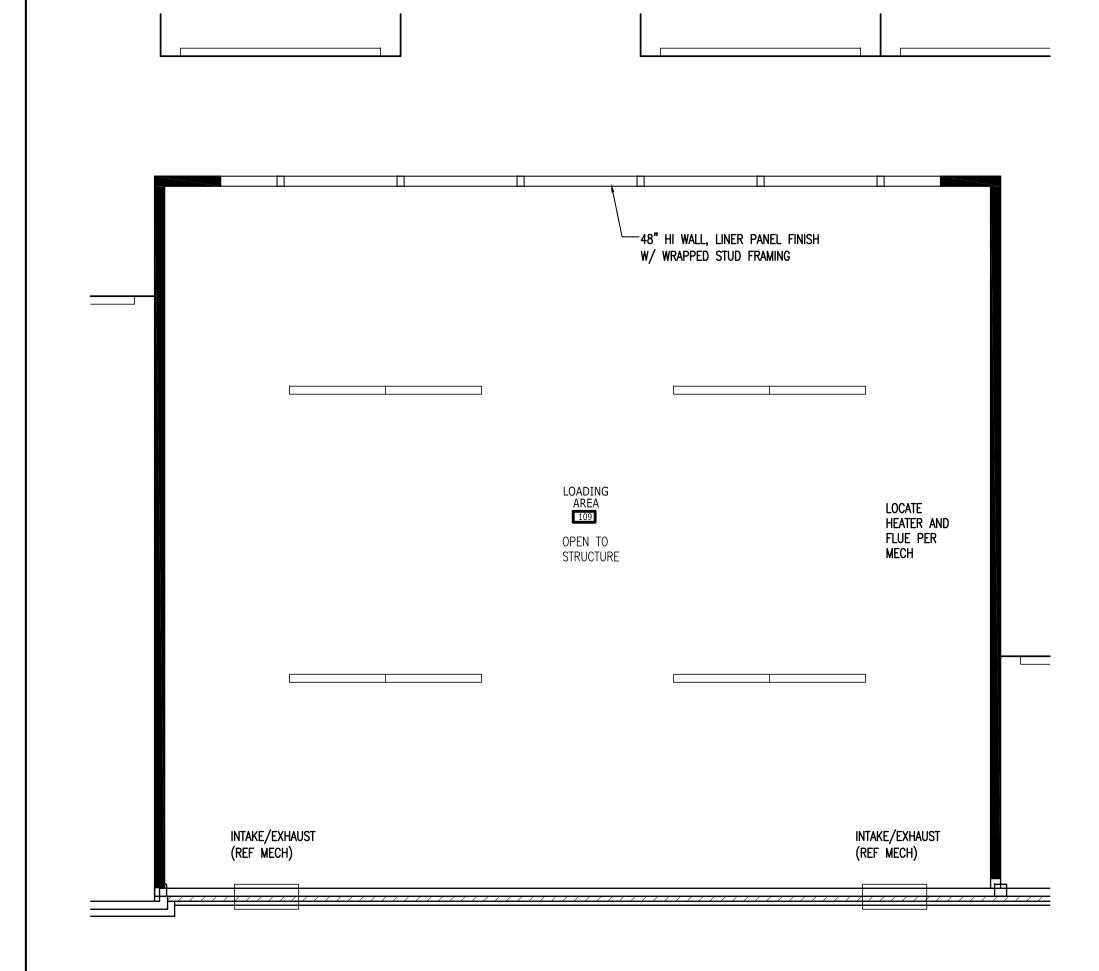



REFLECTE	CEILING PLAN LEGEND								
	SUSPENDED PAINTED GYP. BD. CEILING	$\phi$	EXTERIOR WALL SCONCE -WALL MOUNTED						
	2' X 2' OPEN GRID CEILING	<u> </u>	VANITY LIGHT						
	4' LED LIGHT	•	PENDANT LIGHT						
	2' X 4' LED LIGHT -RECESSED	0	LARGE PENDANT LIGHT						
ф	RECESSED LIGHT		MEP DIFFUSER						
NOTES:  1. REFER MEP FOR FIXTURE SPECIFICATIONS.  2. COORDINATE LIGHT FIXTURES AND MECHANICAL SUPPLY/RETURN PRIOR TO INSTALLATION.  3. PAINT UNDERSIDE OF FLOOR DECK, EXPOSED STRUCTURE AND DUCTS IN OFFICE WHERE VISIBLE.  (CALL OUT PT COLOR ON A7.1)									

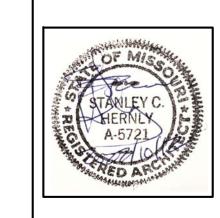

4101 LEE'S


Hernly ASSOCIATES

> 1100 Rhode Island Lawrence, Kansas 66044 785 - 749 - 5806 FAX 785 - 749 - 1515

PLAN DETAILS

Date: 2022/II/08
Drawn by: SJB
Checked by: SCH
Revisions:

A2.5

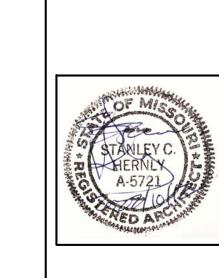

NE PORT SUMMIT,


410 LEE'




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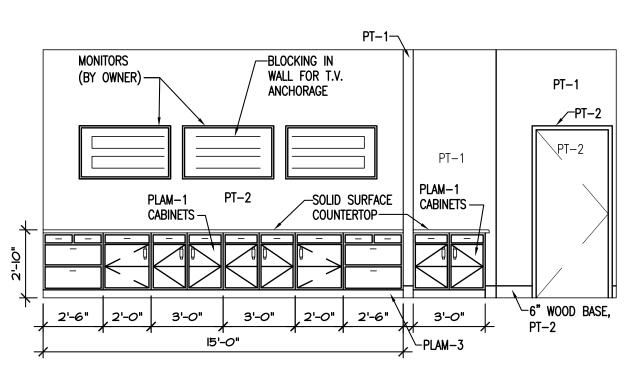
INTERIOR ELEVATIONS

2022/11/08 Date: Drawn by: SJB Checked by : **SCH** Revisions :

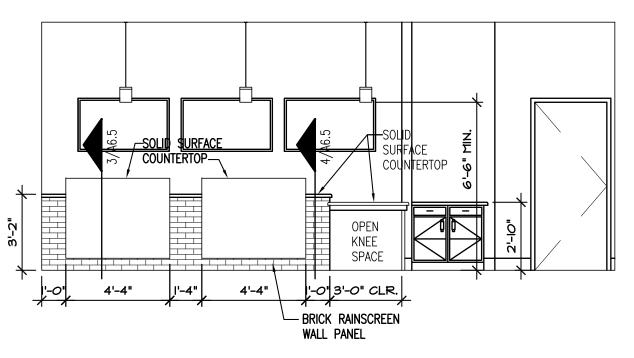


RECEPTION DESK ELEVATION




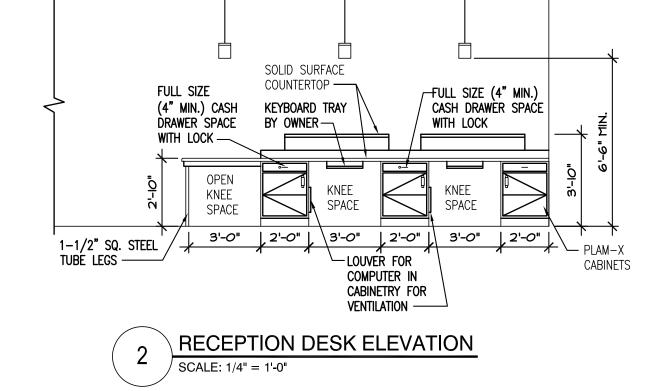


MONITOR WALL ELEVATION

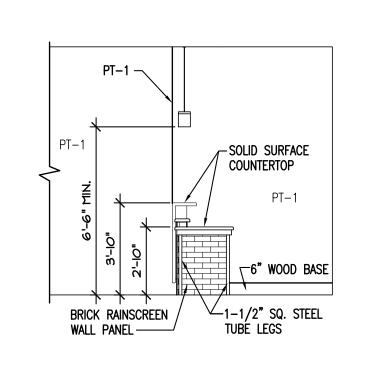


RECEPTION DESK ELEVATION

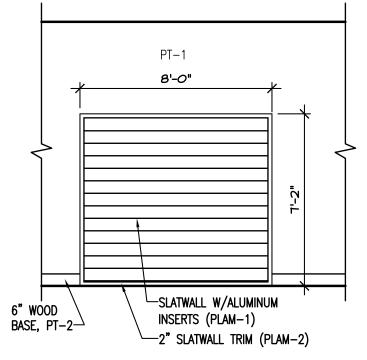

SLAT WALL ELEVATION SCALE: 1/4" = 1'-0"

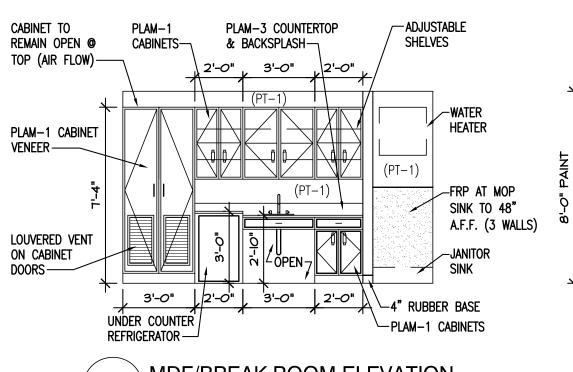

MDF/BREAK ROOM ELEVATION SCALE: 1/4" = 1'-0"

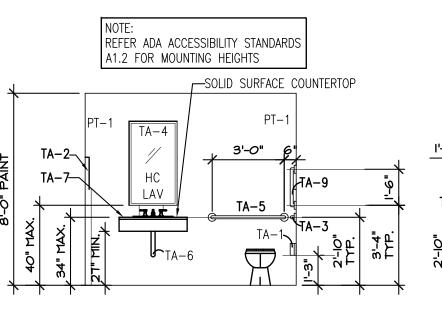

TOILET ROOM ELEVATION

SCALE: 1/4" = 1'-0"



HEIGHT

19" CL

48" MAX.

34" CL

40"

34" CL

N/A

48" MAX.

44" MAX.

40" CL

TOILET ACCESSORIES

TA-1 TOILET TISSUE DISPENSER

TA-3 42" HORIZONTAL GRAB BAR

TA-5 36" HORIZONTAL GRAB BAR


TA-6 | LAVATORY PIPING INSULATION

6. SOAP DISPENSER TO BE INSTALLED OVER COUNTERTOP

MARK ITEM

TA-4 MIRROR


TA-2 HAND DRYERS

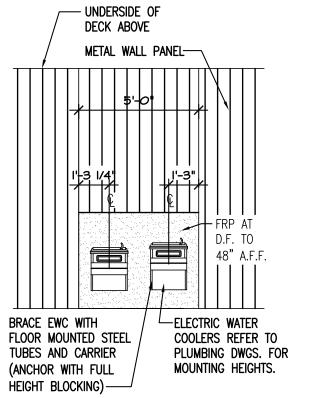


DRINKING FOUNTAIN ELEVATION SCALE: 1/4" = 1'-0"

TA-7 | FEMININE NAPKIN DISPOSAL TA-8 | SOAP DISPENSER TA-9 18" VERTICAL GRAB BAR NOTES 1. FOR CONTROLS OR REACH, HEIGHT IS MAX. 2. FOR MIRRORS, HEIGHT IS TO BOTTOM OF REFLECTIVE EDGE. 3. FOR GRAB BARS, HEIGHT IS TO CENTER OF HORIZONTAL BAR. 4. ALL DESIGN MUST COMPLY W/ LOCAL AMERICAN'S W/DISABILITIES ACT - REF. SHEET A2.6
5. BLOCKING FOR ACCESSORIES BY GENERAL CONTRACTOR

INTERIOR ELEVATIONS 1/4" = 1'-0"

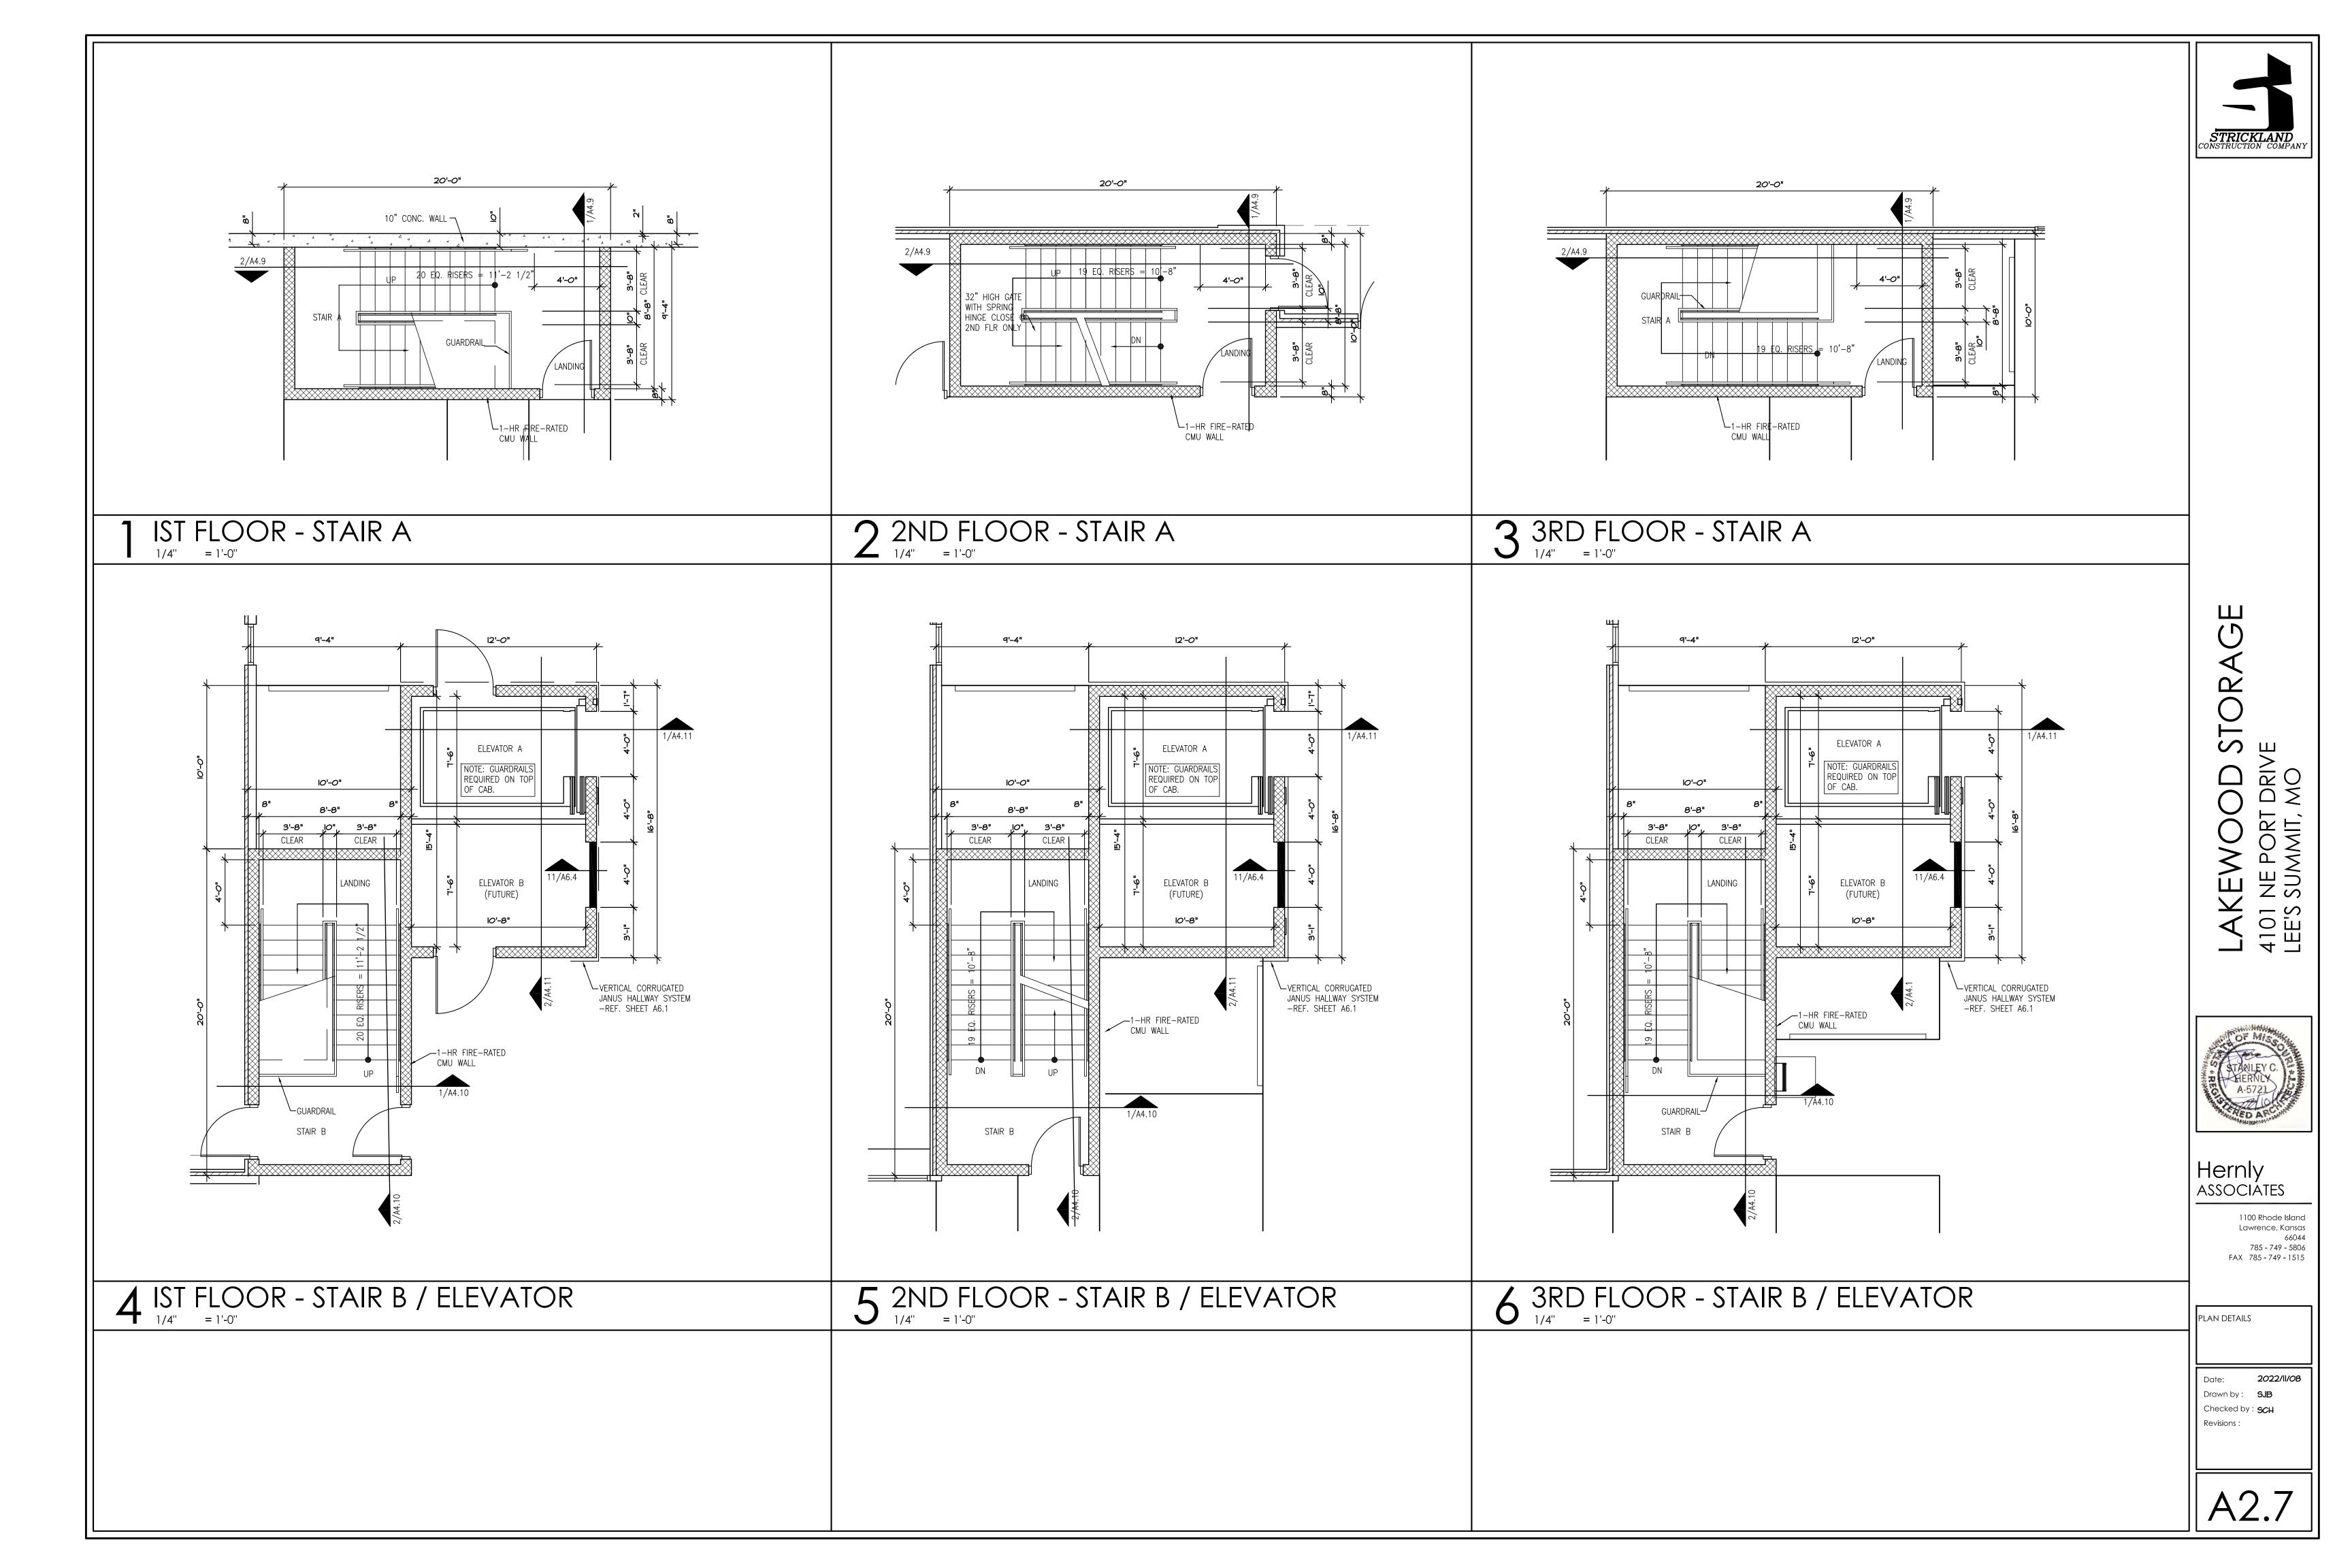


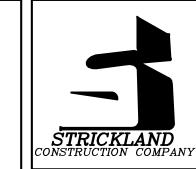


#### HORIZONTAL METAL WALL PANEL (M1) — HORIZONTAL METAL WALL PANEL (M1) 7/4:12 SLOPE ROOF BEYOND (DASHED) METAL WALL PANEL (M3) T.O. PARAPET 3RD FLOOR 2ND FLOOR \_ 2ND FLOOR ACM PANEL BRICK RAINSCREEN WALL PANEL CULTURED STONE VENEER VERTICAL METAL BAND (M2) SIGNAGE BY OWNER (DASHED BEHIND BRICK RAINSCREEN WALL PANEL OFFICE ENTRY — CULTURED STONE VENEER

## WEST ELEVATION

3/32" = 1'-0"

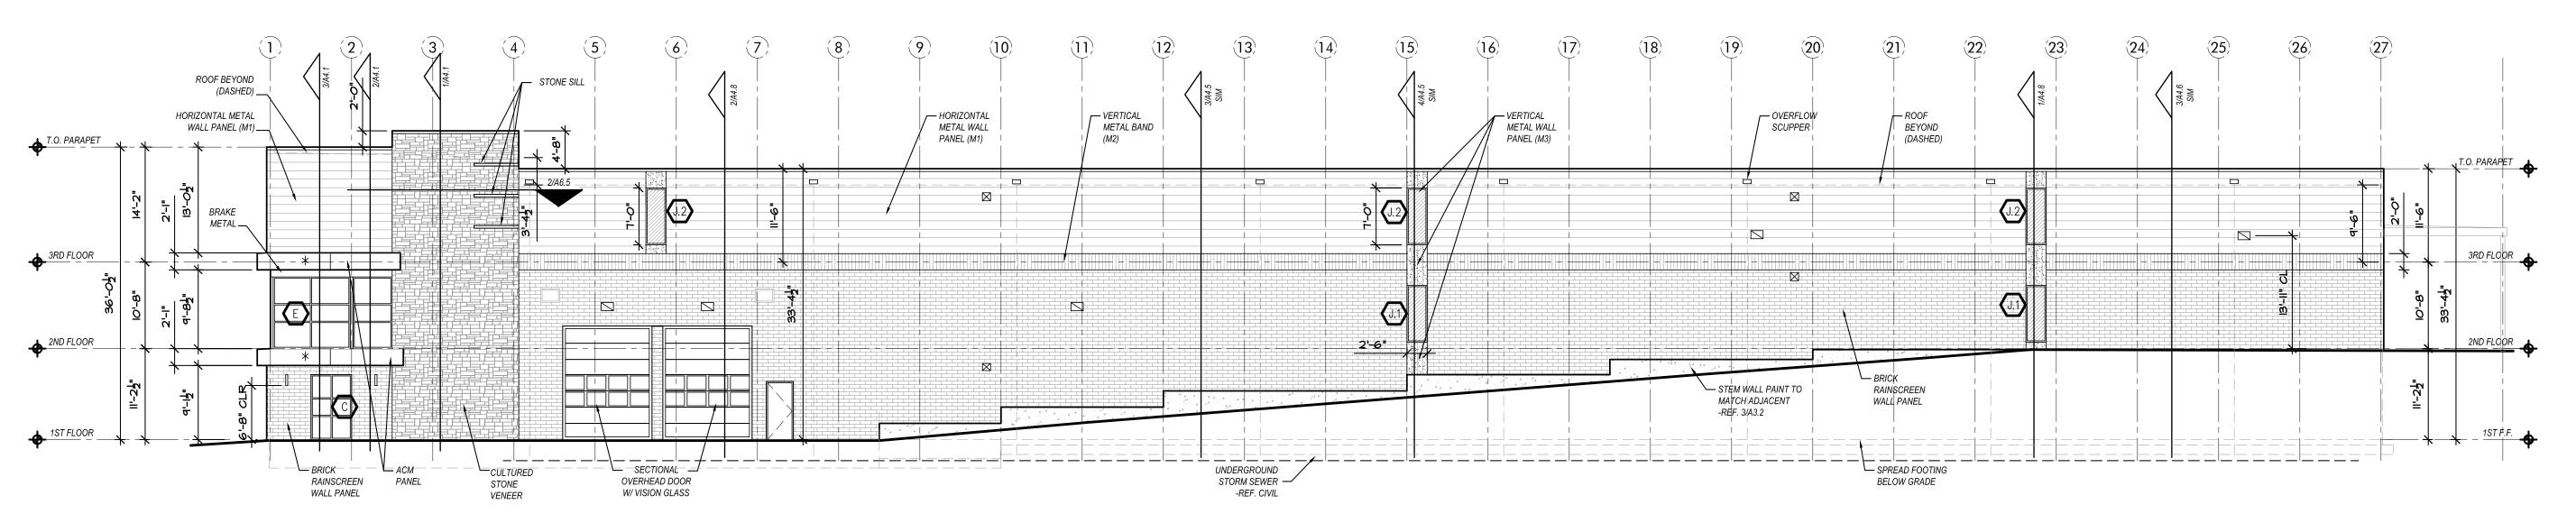


# 2 SOUTH ELEVATION 3/32" = 1'-0"

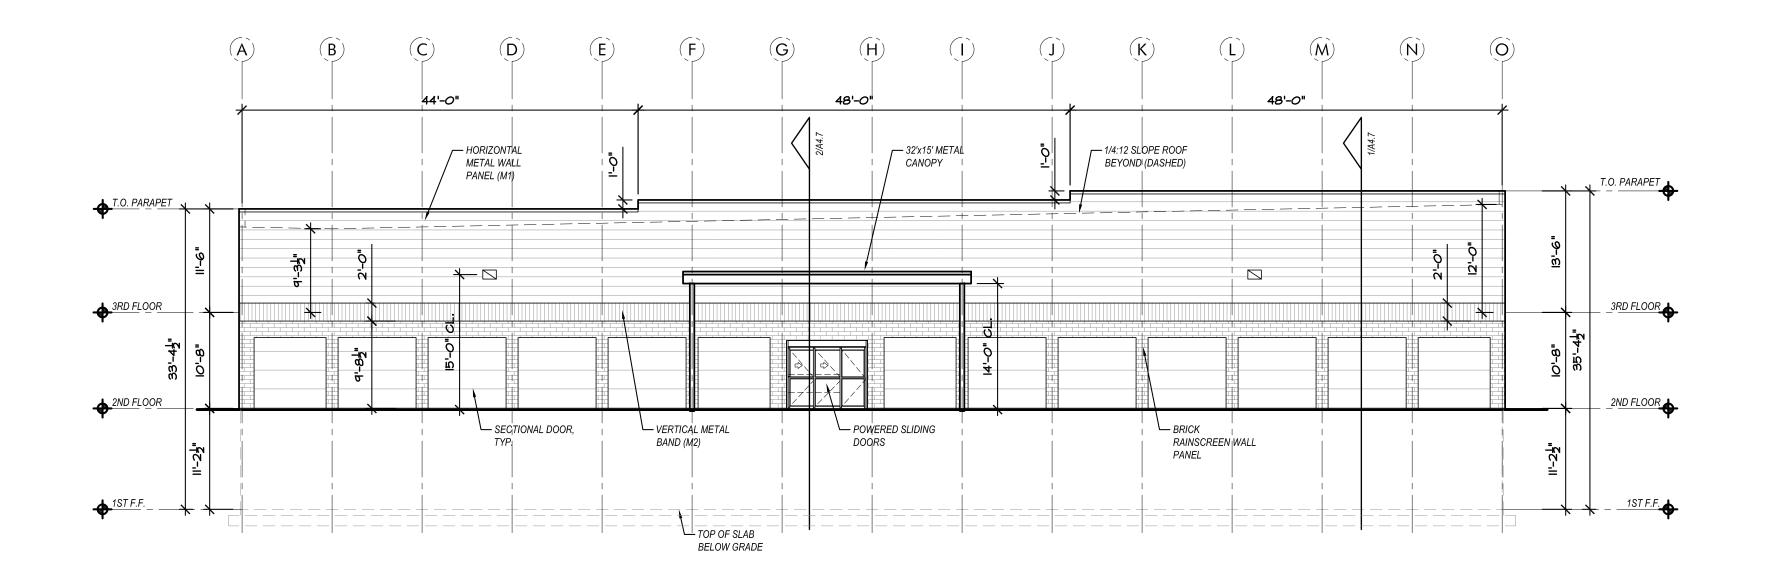

SPANDREL GLASS

ELEVATION	LEGEND
	HORIZONTAL METAL WALL PANEL (M1)
	VERTICAL METAL BAND (M2)
	VERTICAL METAL WALL PANEL (M3)
*	ACM — ALUMINUM COMPOSITE MATERIAL PANEL
	BRICK RAINSCREEN WALL PANEL (NICHIHA)
	CULTURED STONE VENEER
	EXTERIOR LIGHT FIXTURE -REF. MEP
	OVERFLOW SCUPPER -REF. 12/A6.3
$\boxtimes$	OUTSIDE AIR LOCATIONS -REF. MEP
ELEVATION	NOTES
	OPING, TRIM, AND FLASHING TO MATCH COLOR CENT MATERIAL.

- ROOF MATERIAL TO BE TPO ROOF SYSTEM SLOPED AT 1/4" FT WITH INTERNAL ROOF DRAINS TO CONNECT
- TO UNDERGROUND SEWER
- OVERFLOW SCUPPERS TO BE 2" ABOVE LOWEST POINT OF ROOF.
- REFER SHEET A7.1 FOR EXTERIOR PAINT COLORS.
- PAINT MAN DOOR TO MATCH ADJACENT MATERIAL UNLESS NOTED OTHERWISE.
- GENERAL CONTRACTOR/SIGNAGE COMPANY TO PROVIDE ANCHORAGE, BLOCKING, & WATERPROOFING FOR
- MAX PARAPET HEIGHT TO BE 2'-6" WITHOUT STRUCTURAL SUPPORT.

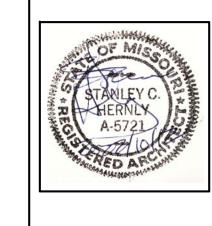

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NE PORT SUMMIT,

4101 LEE'S


Hernly ASSOCIÁTES


> 1100 Rhode Island Lawrence, Kansas 785 - 749 - 5806 FAX 785 - 749 - 1515


ELEVATIONS


2022/11/08 Date: Drawn by: SJB Checked by: **5CH** Revisions :


3 EAST ELEVATION
3/32" = 1'-0"

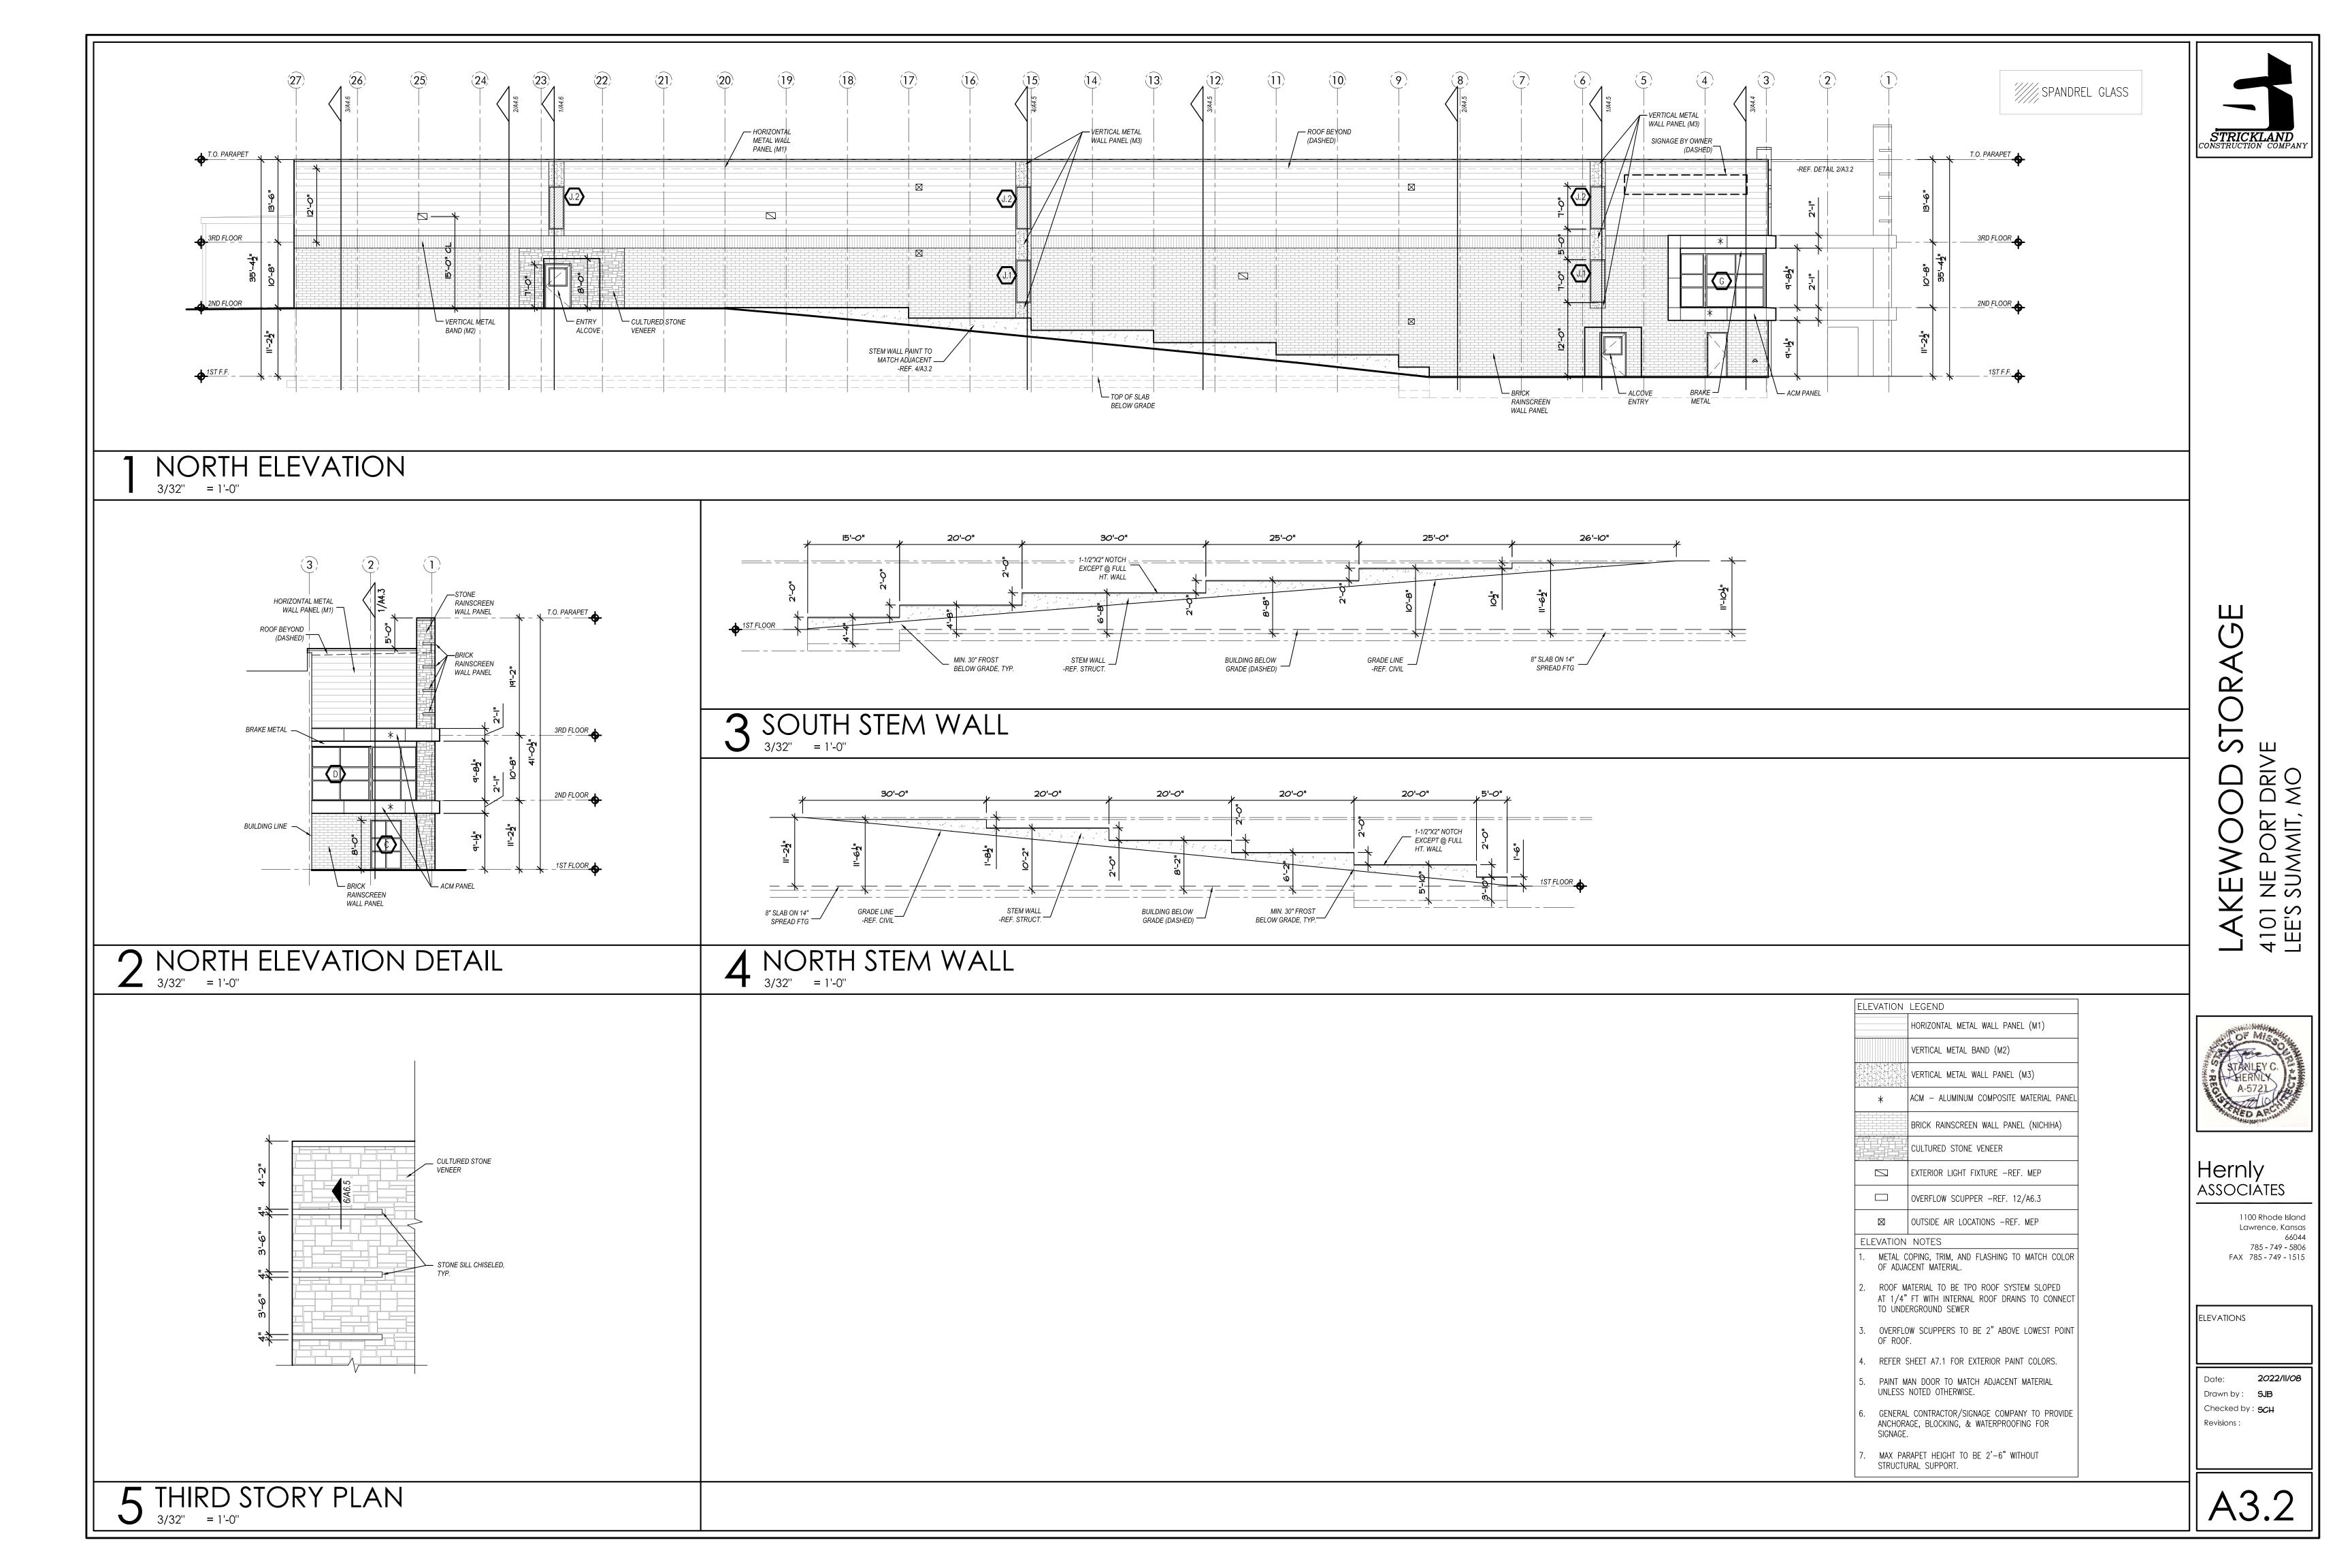


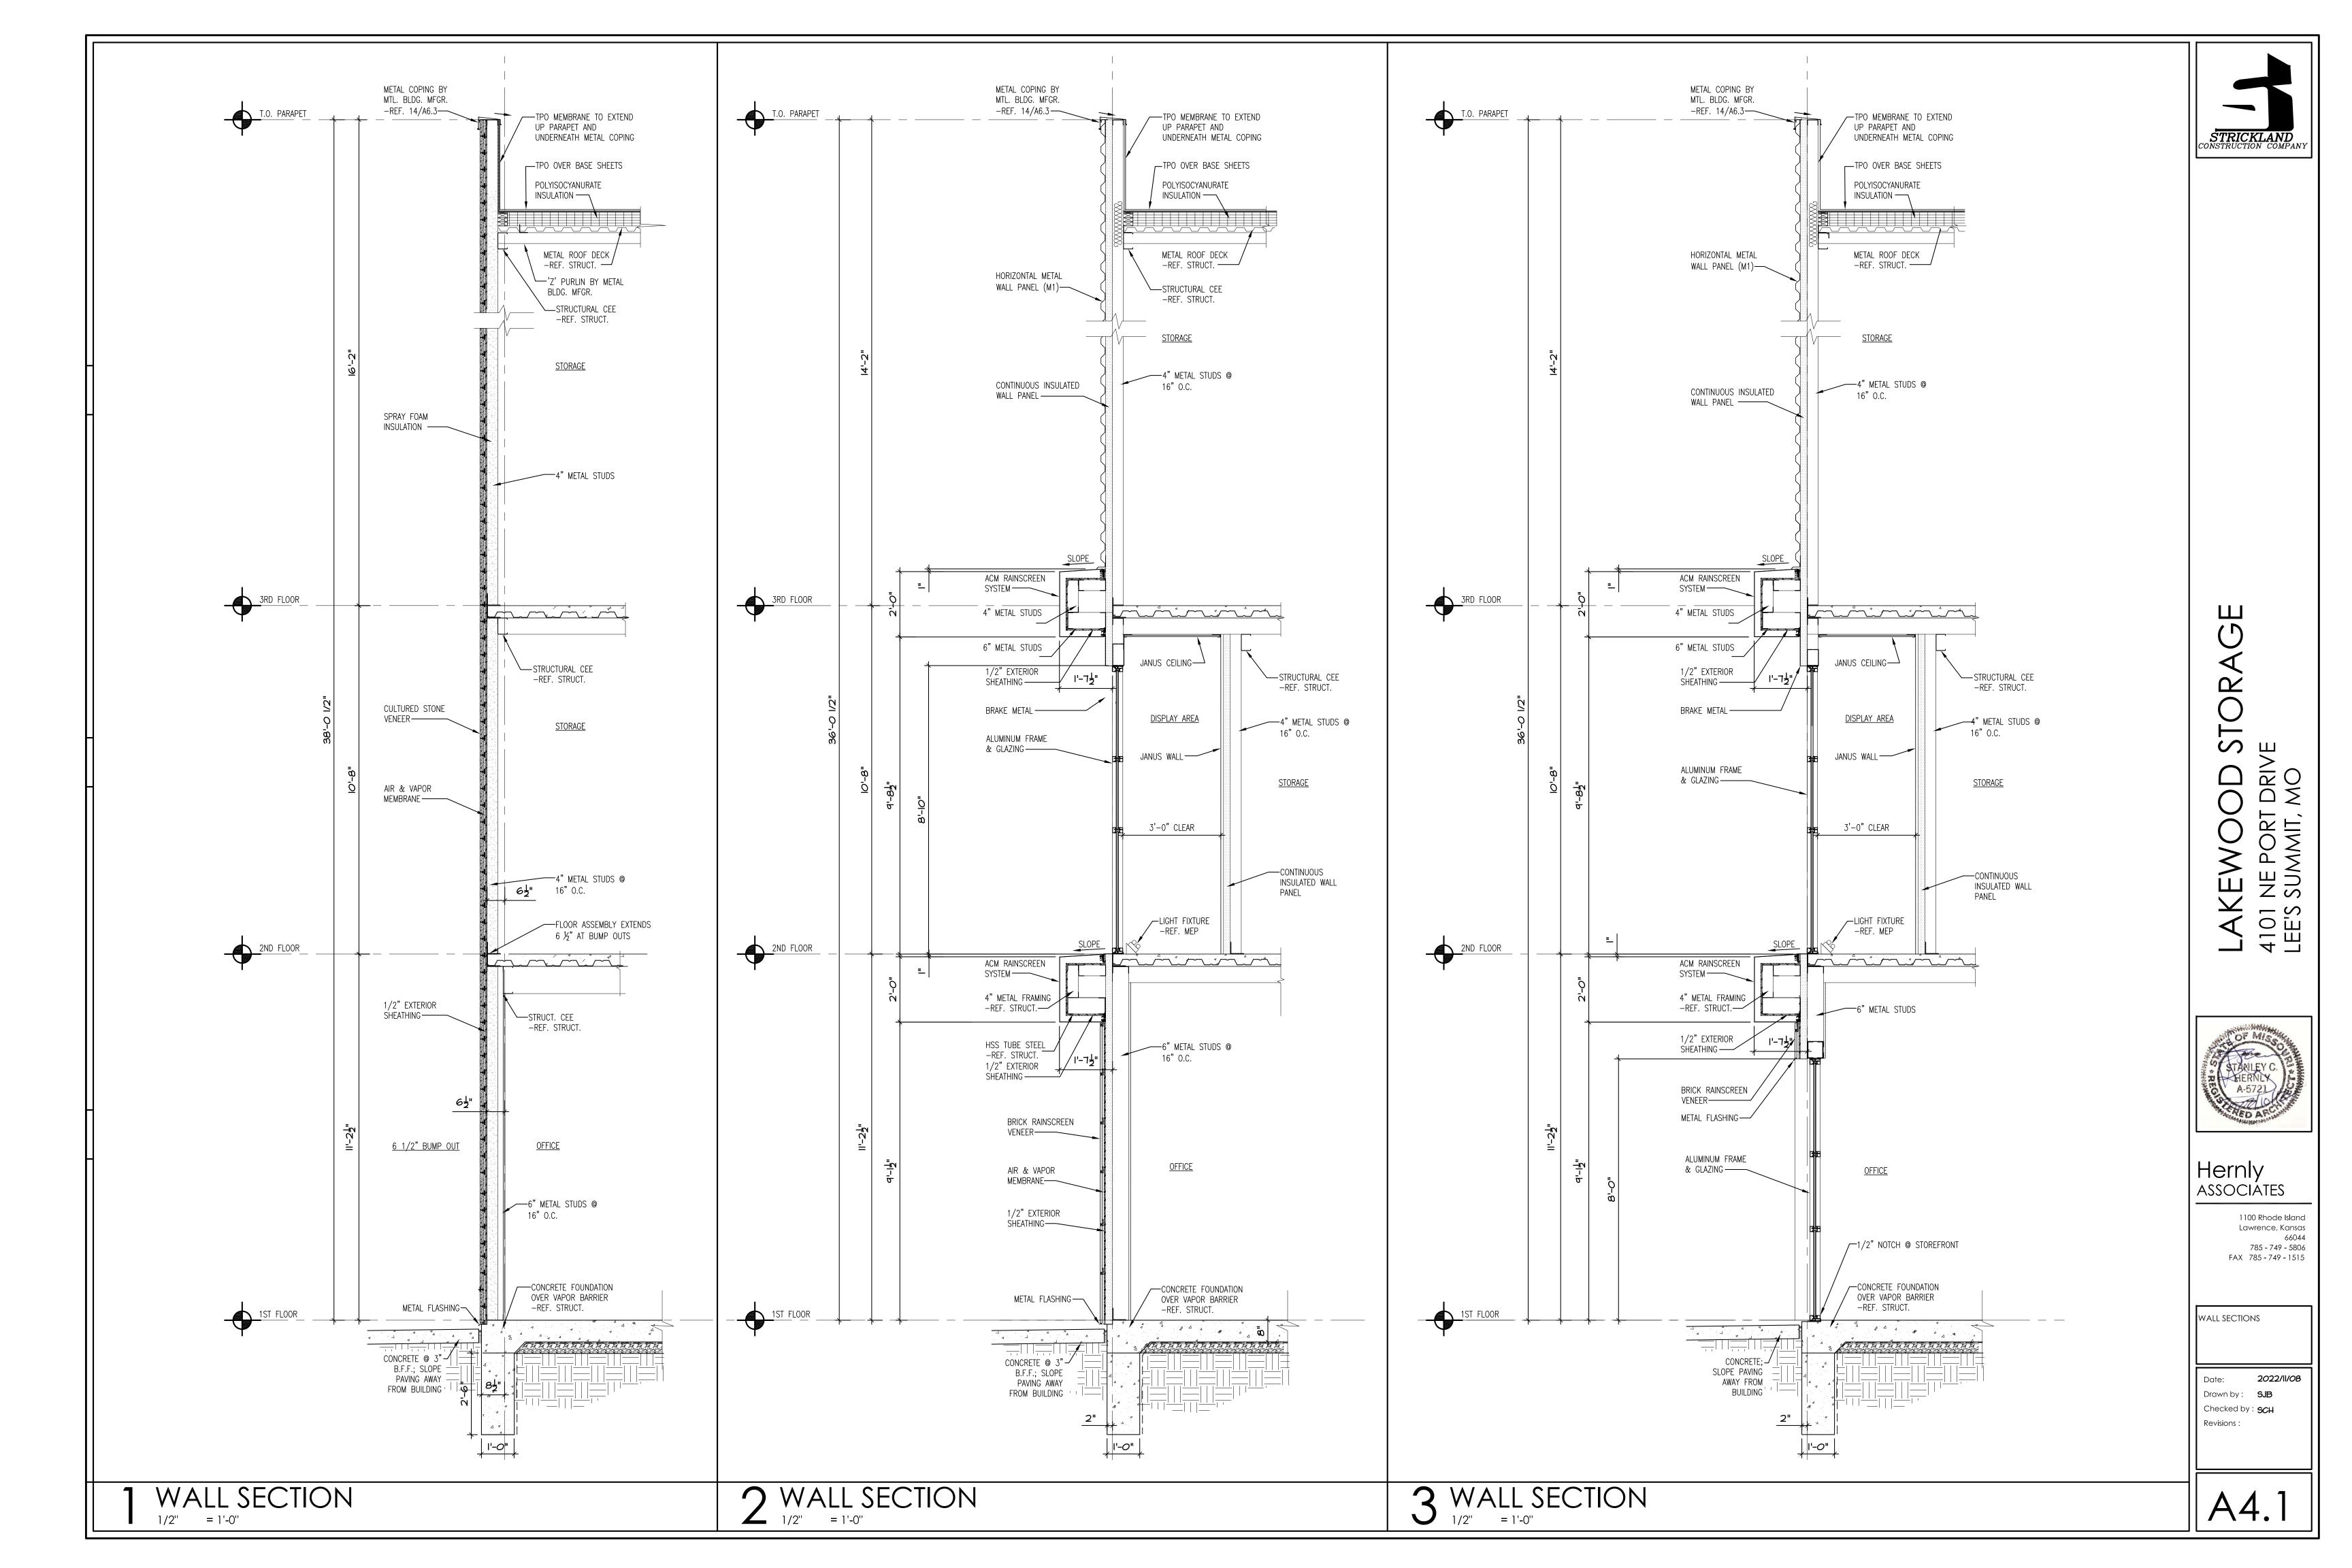


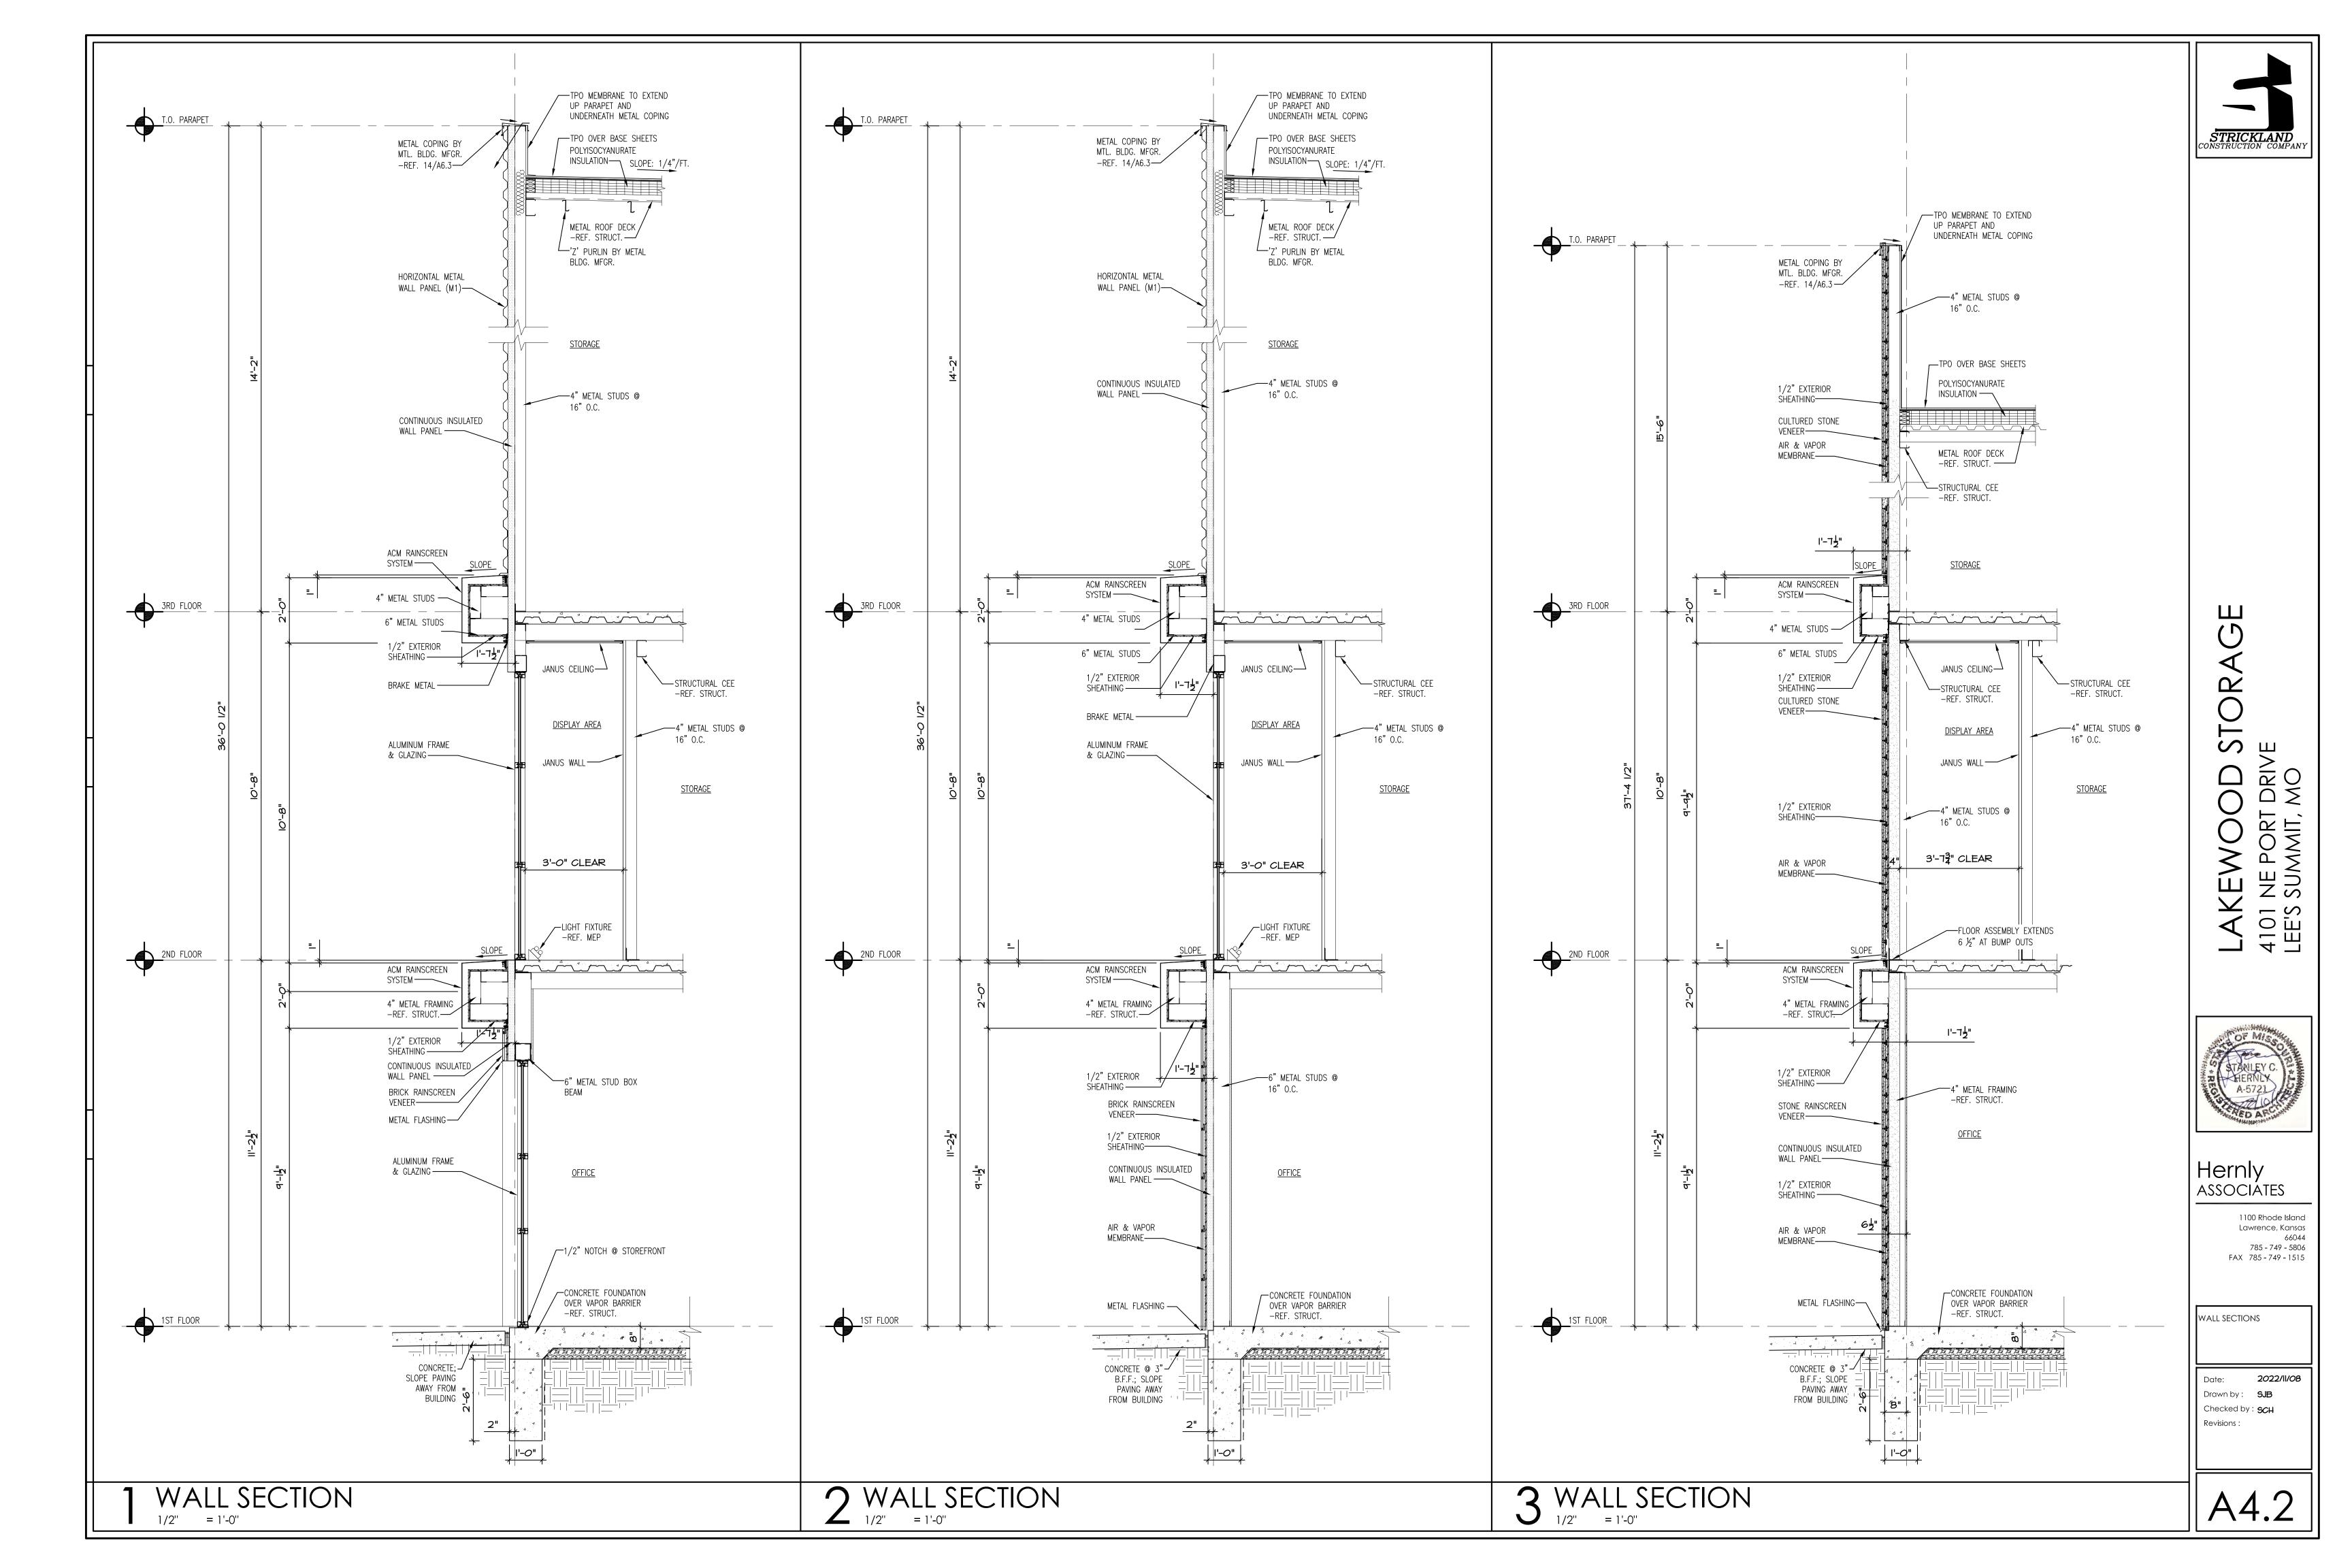


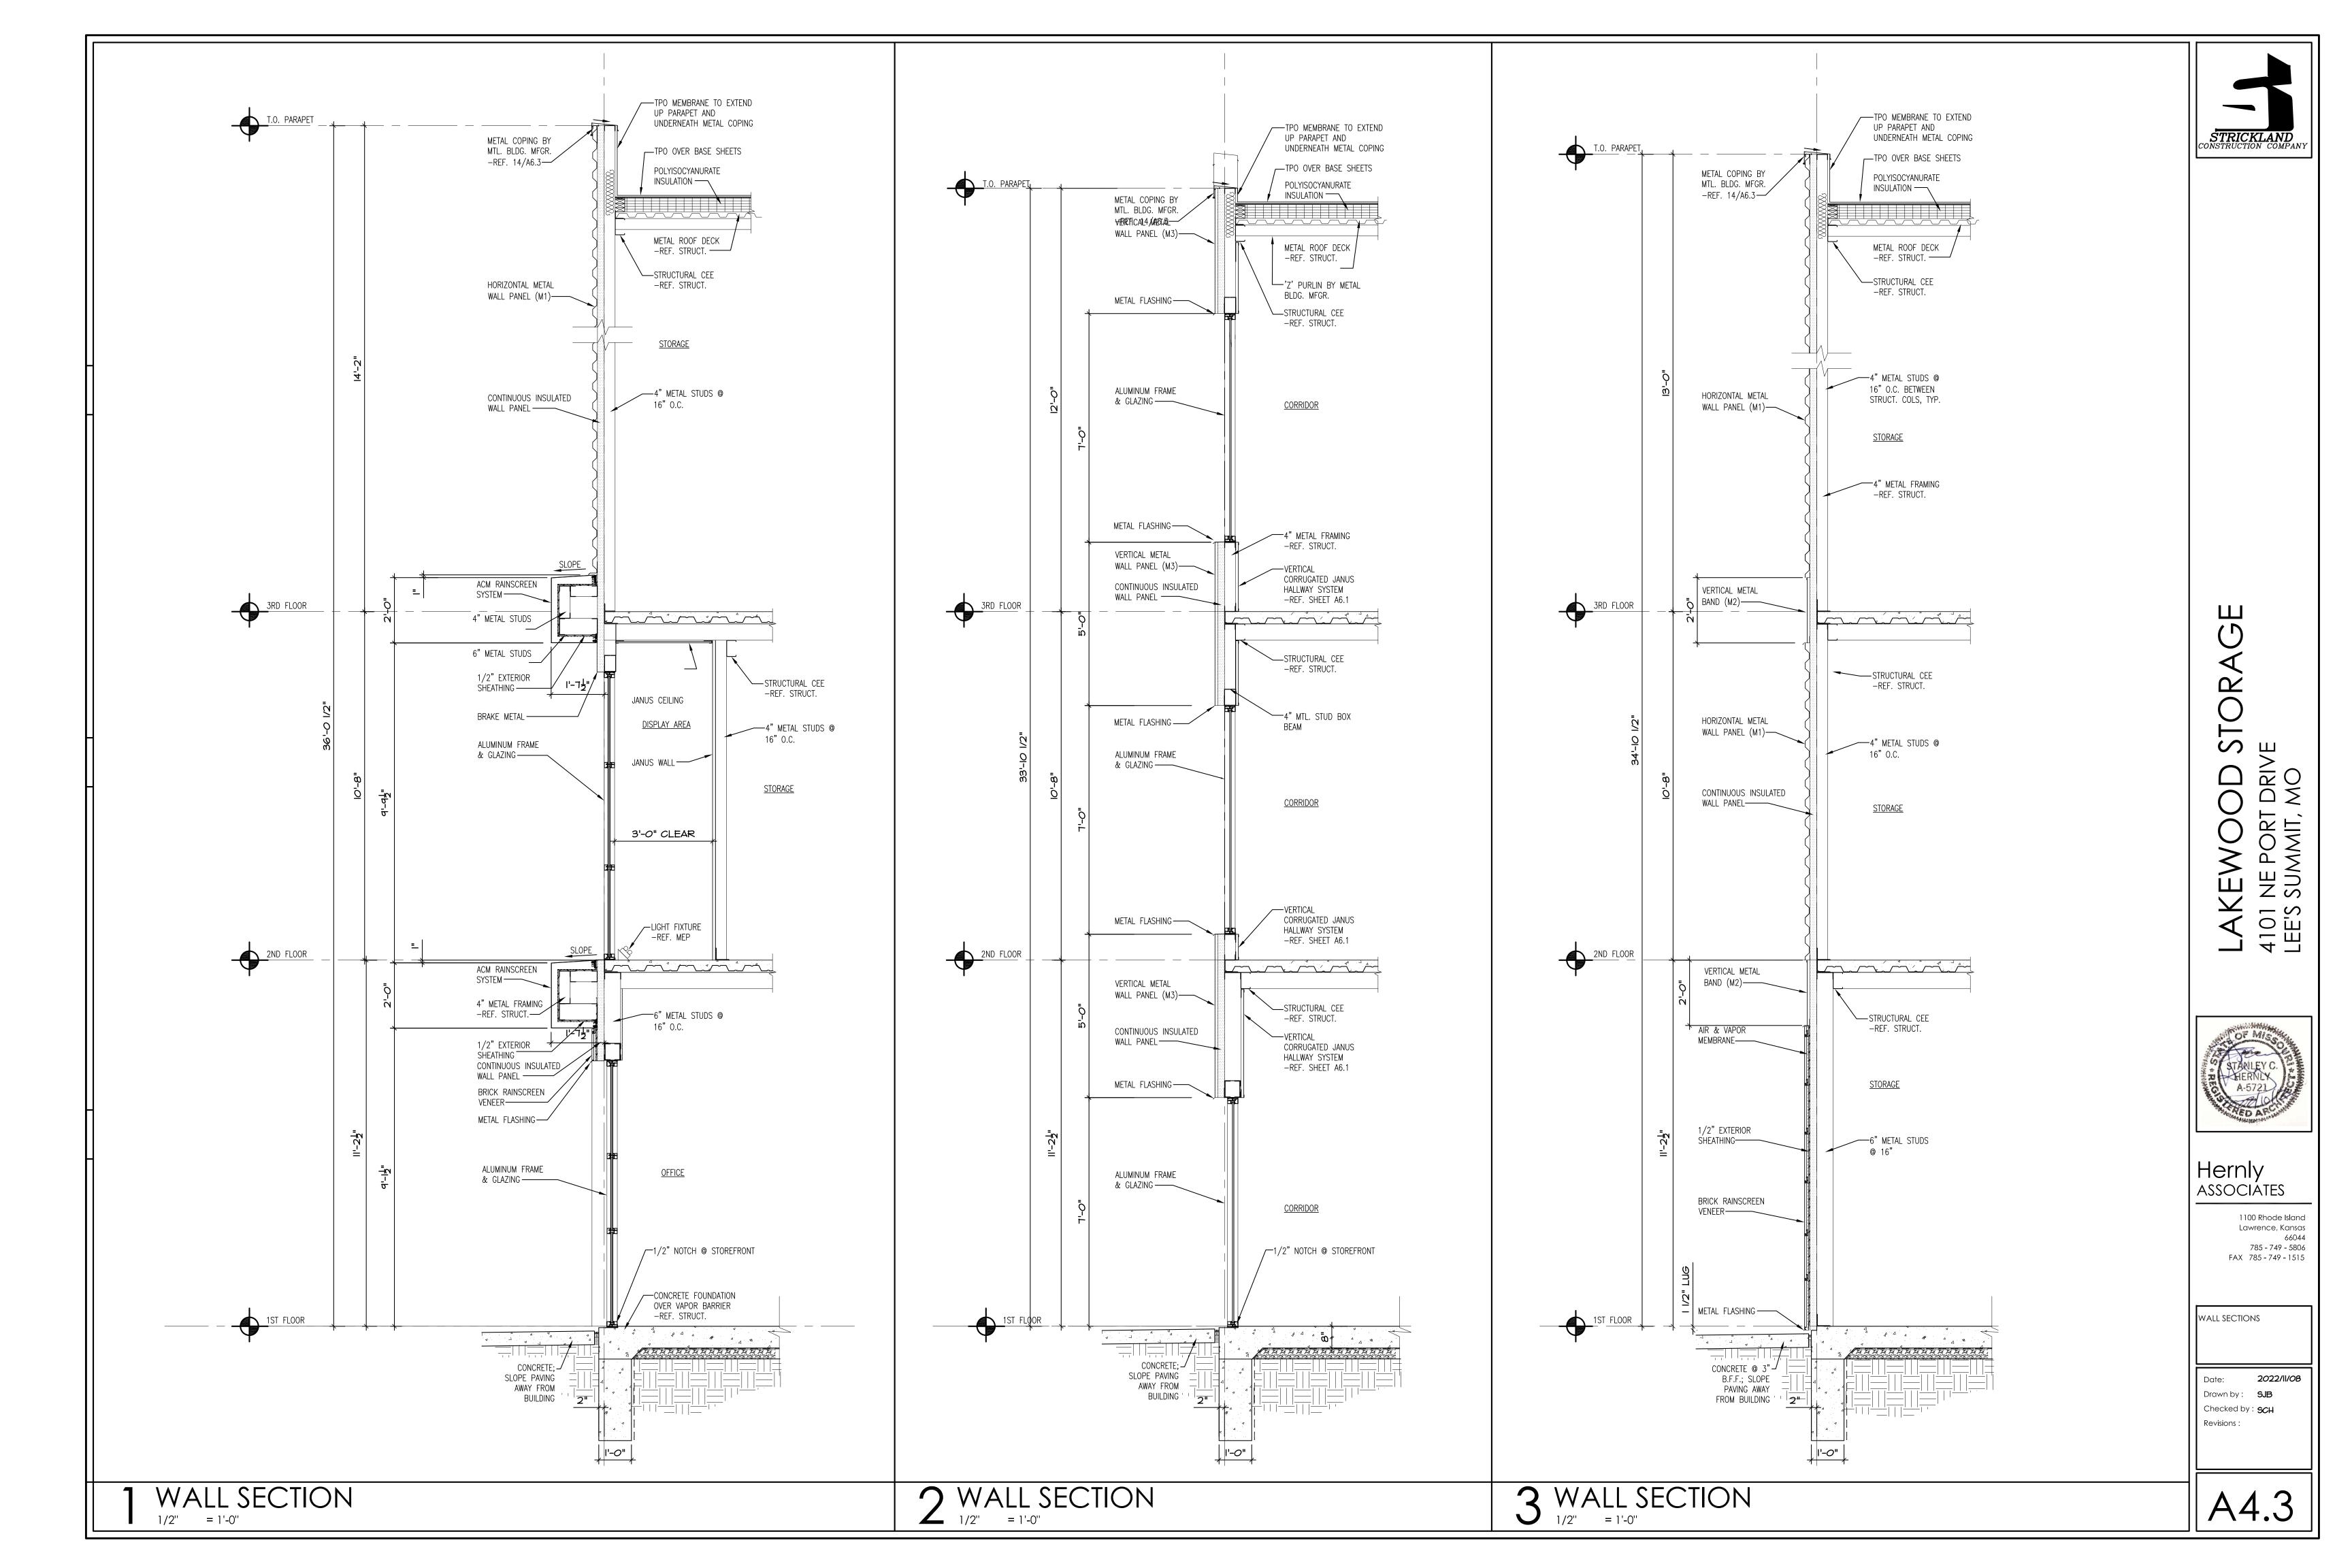


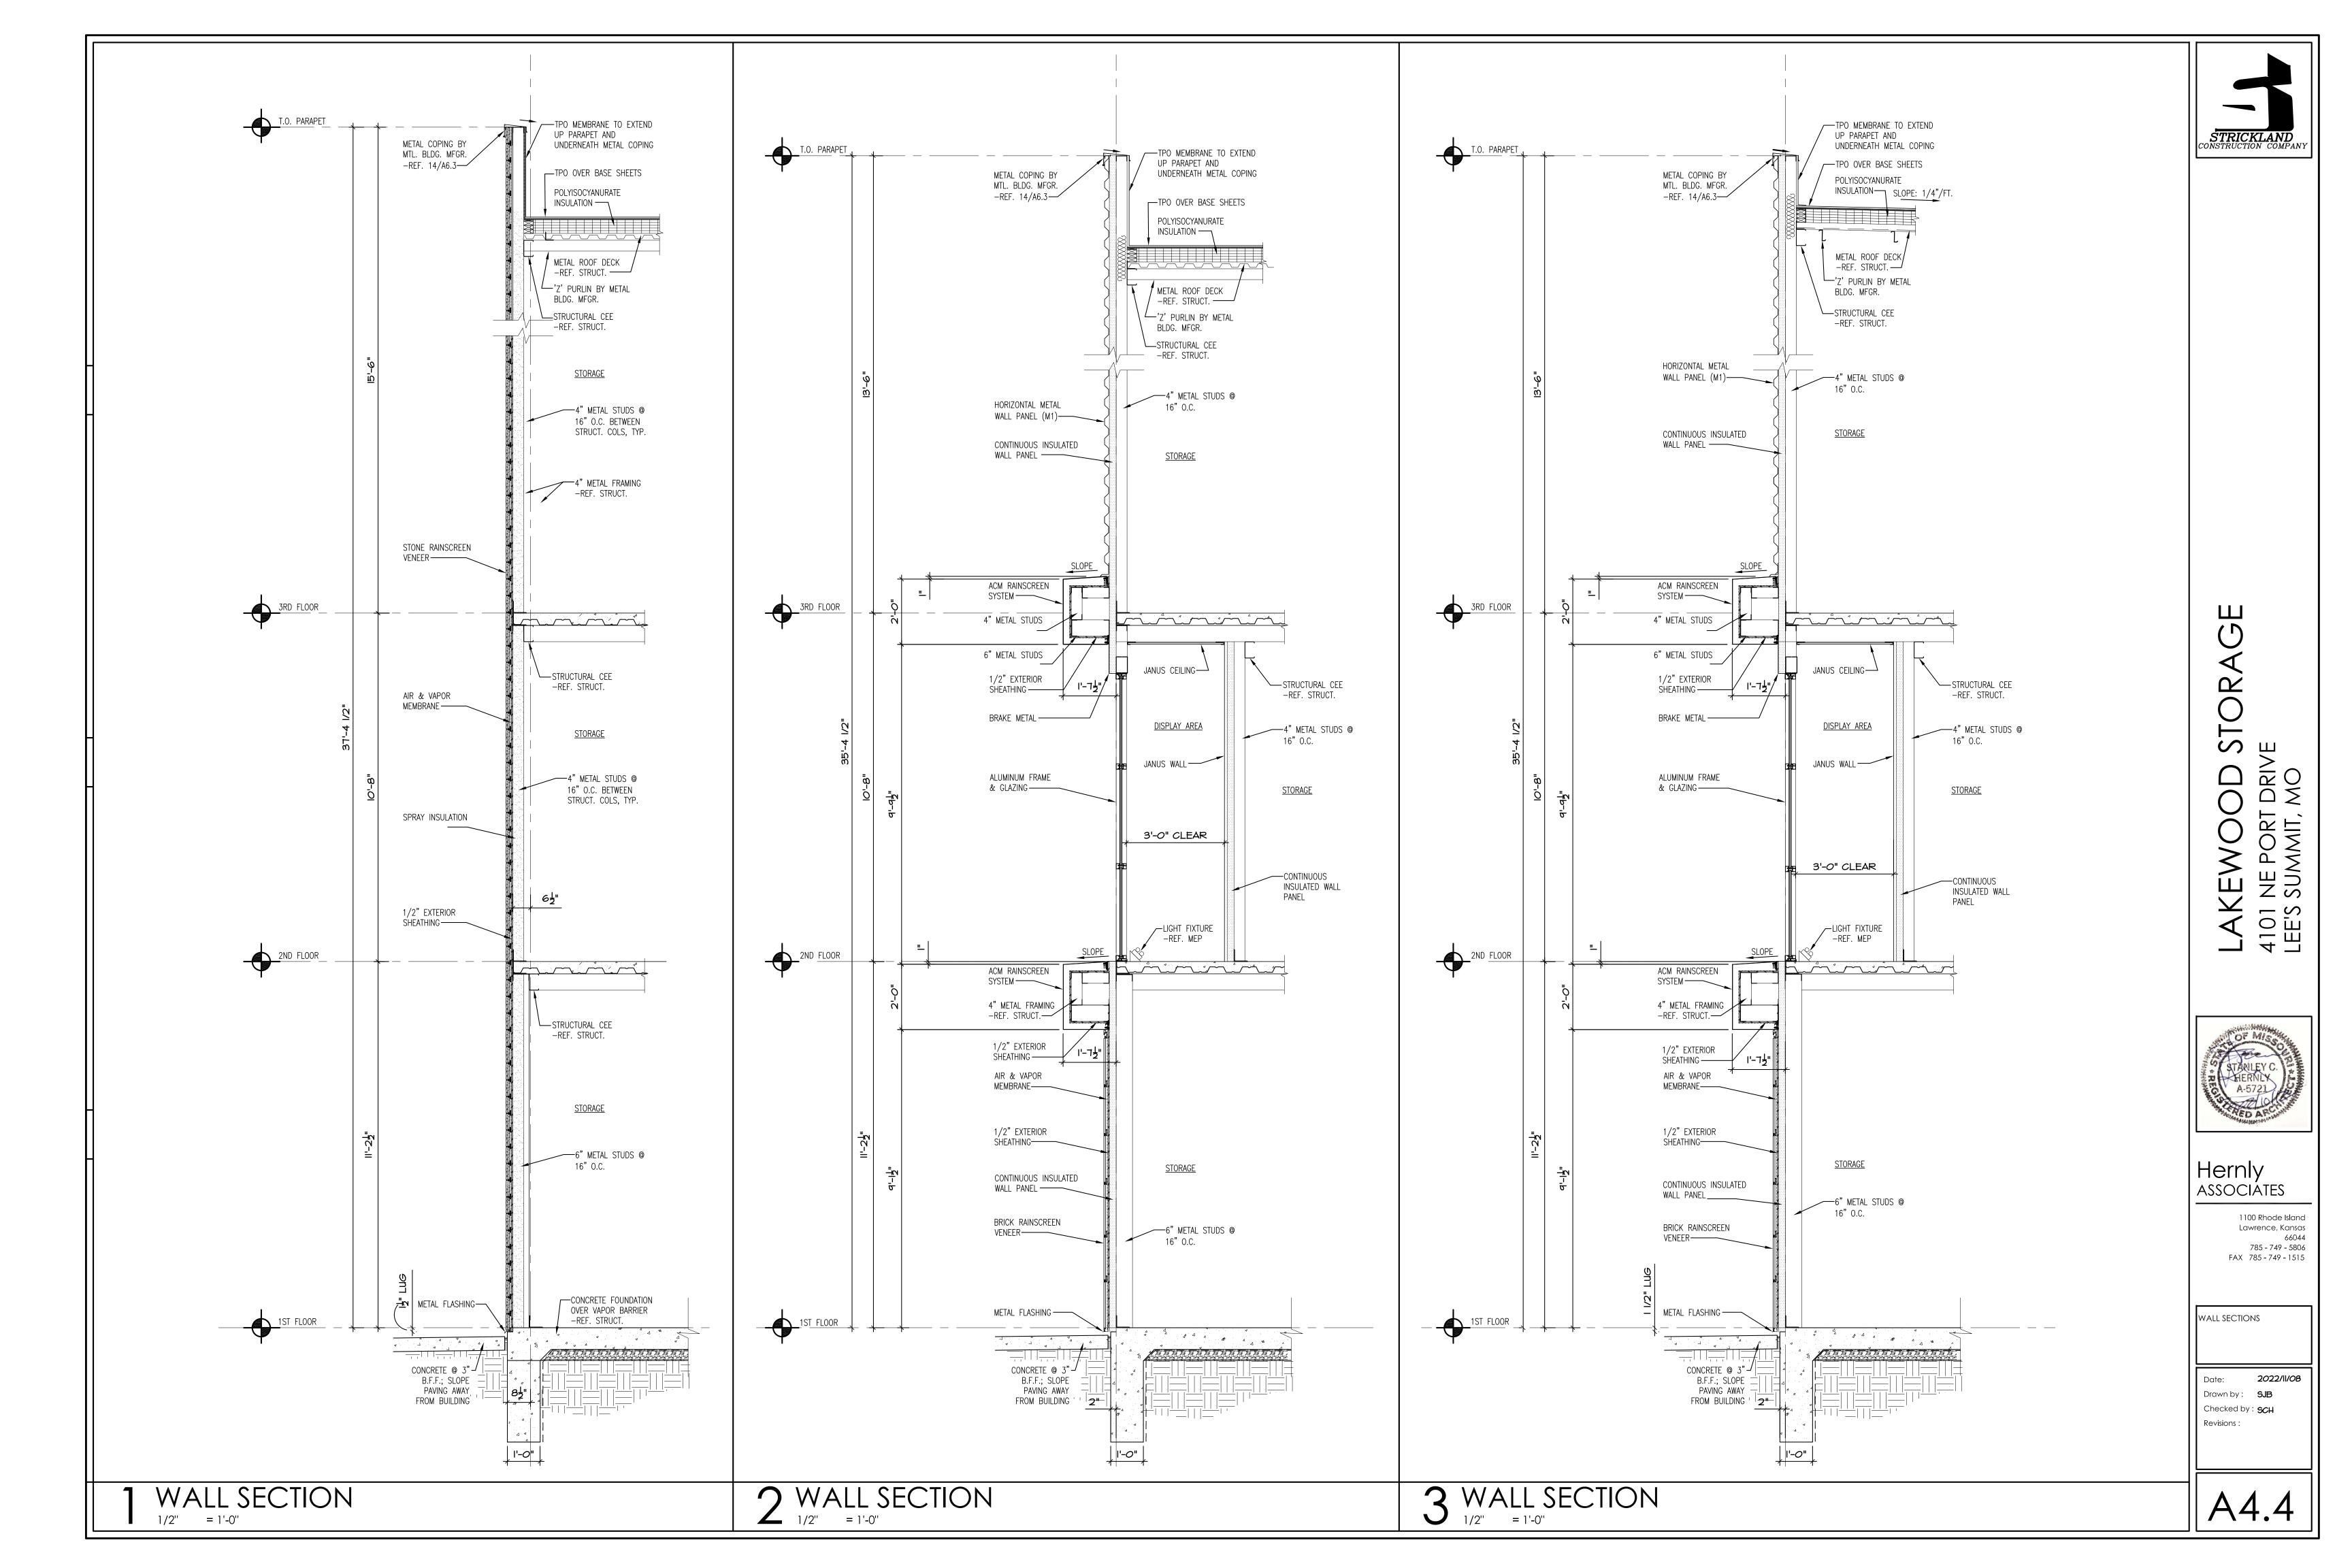


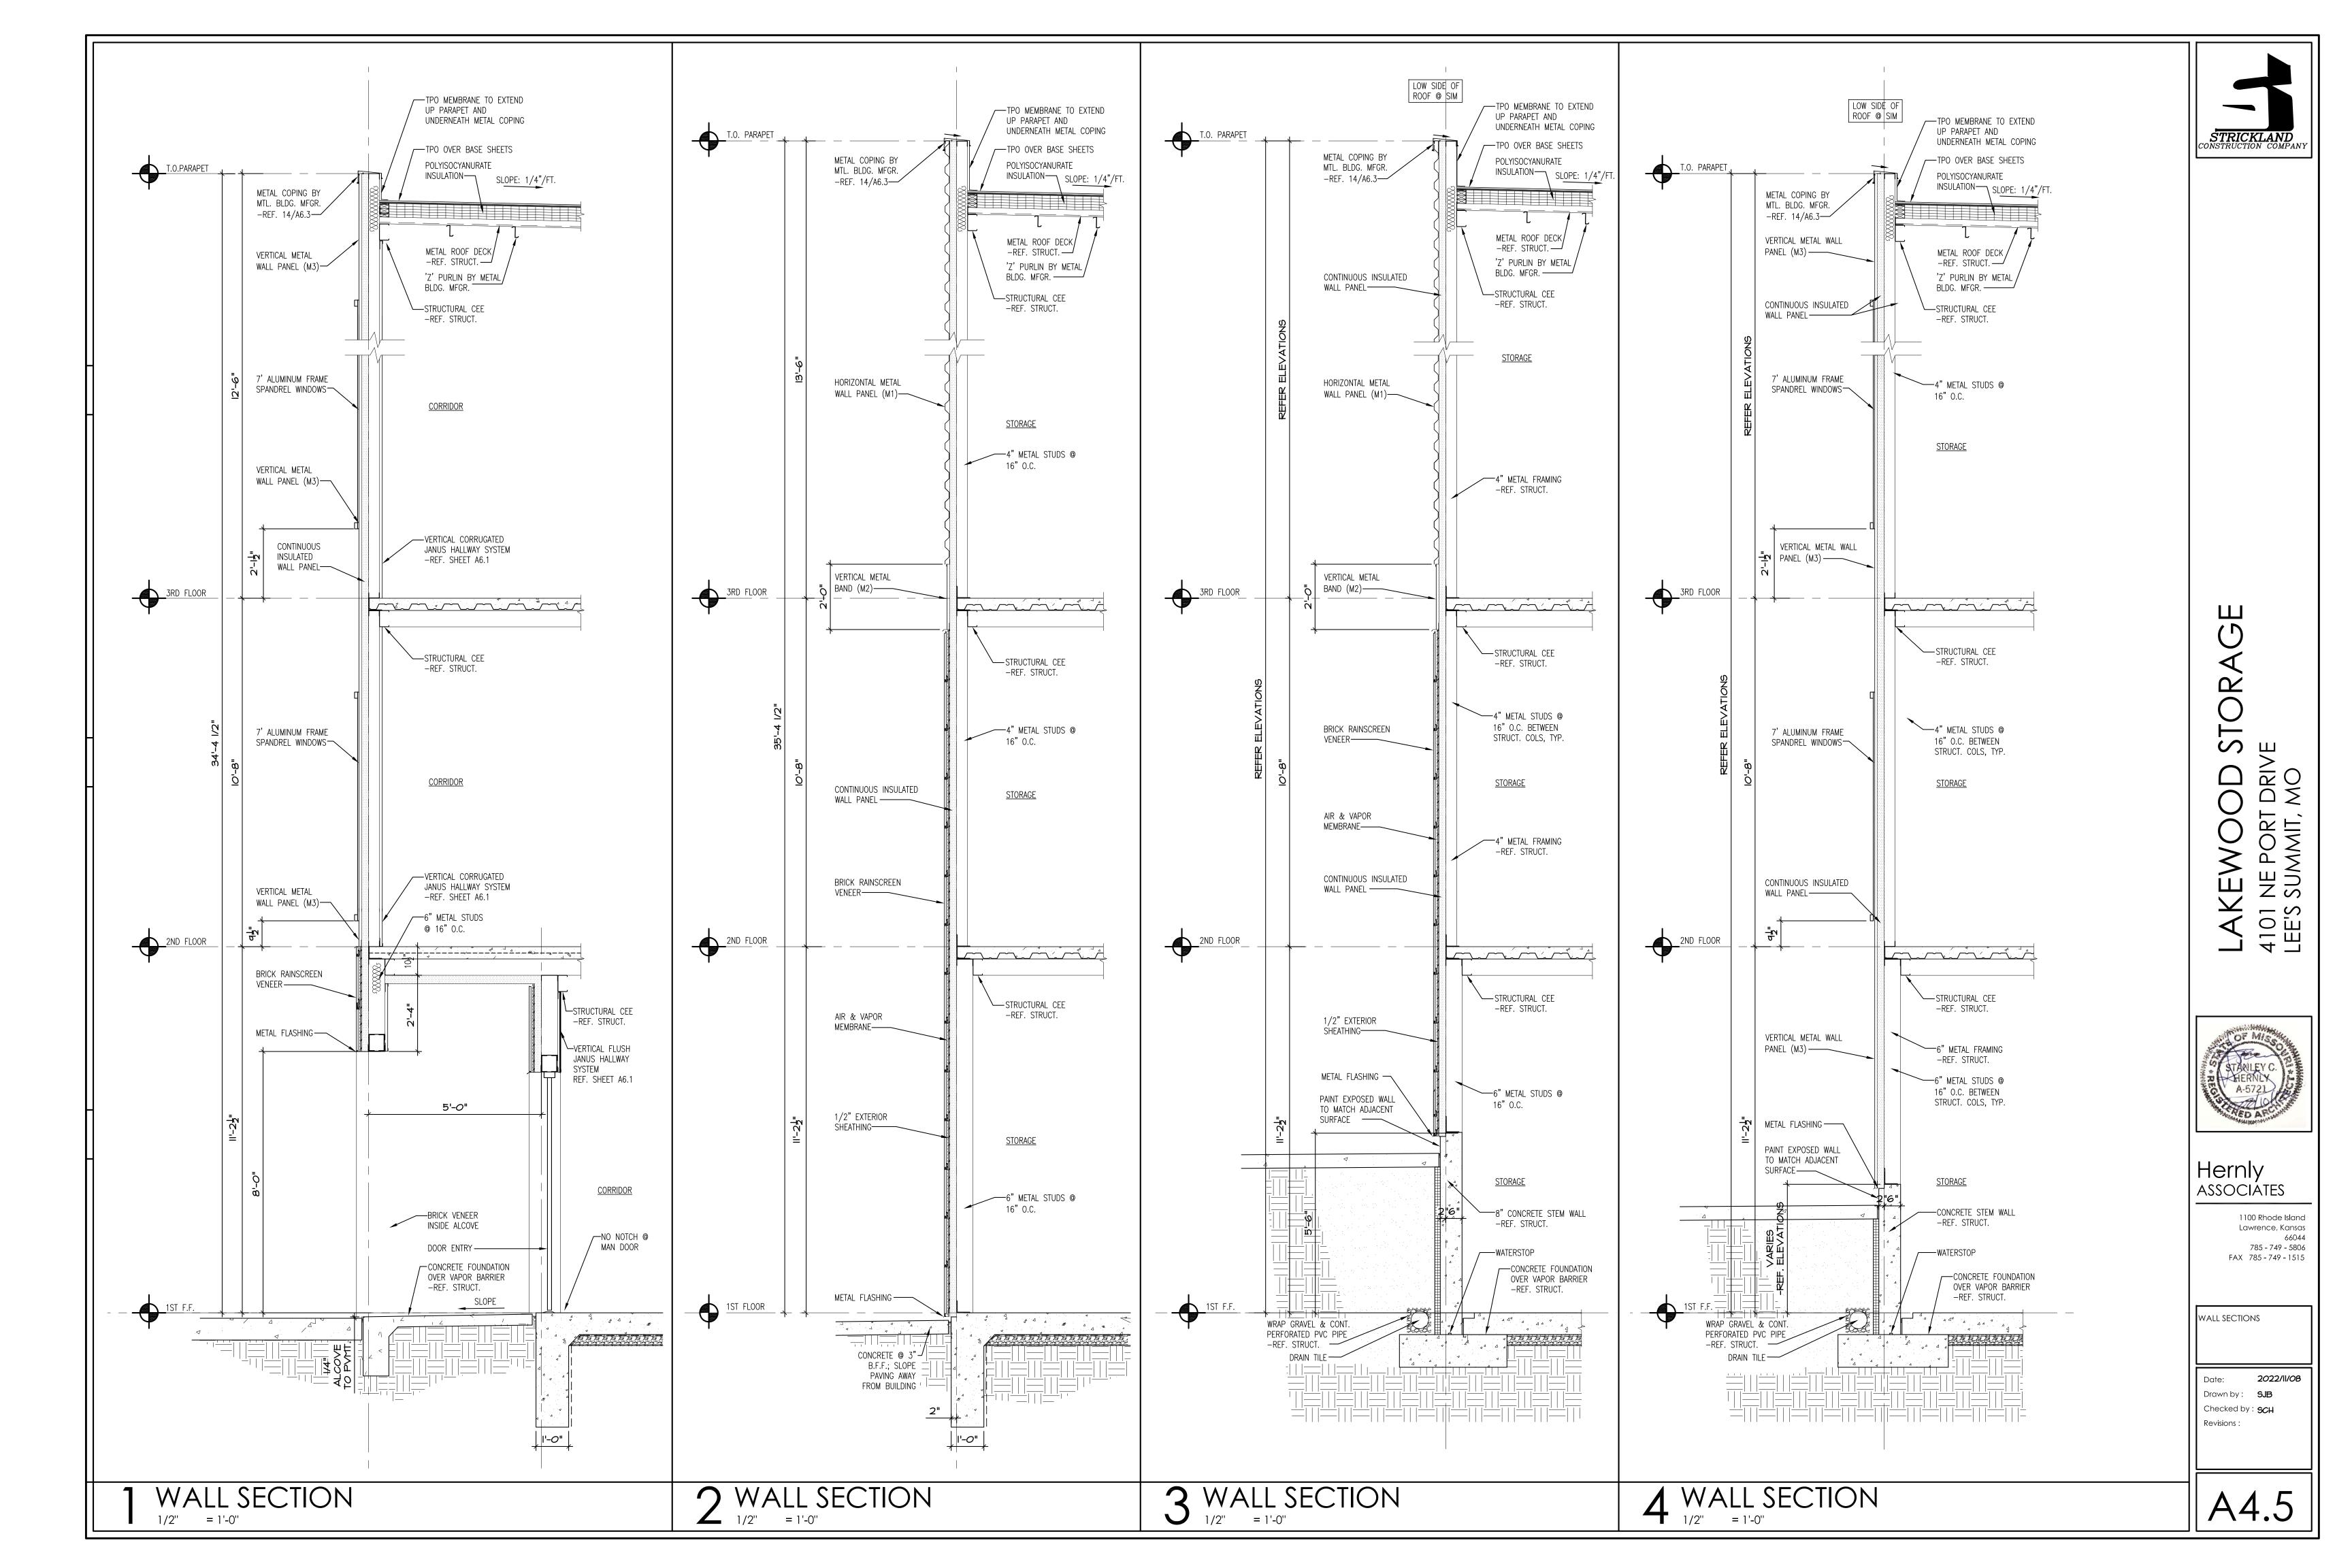


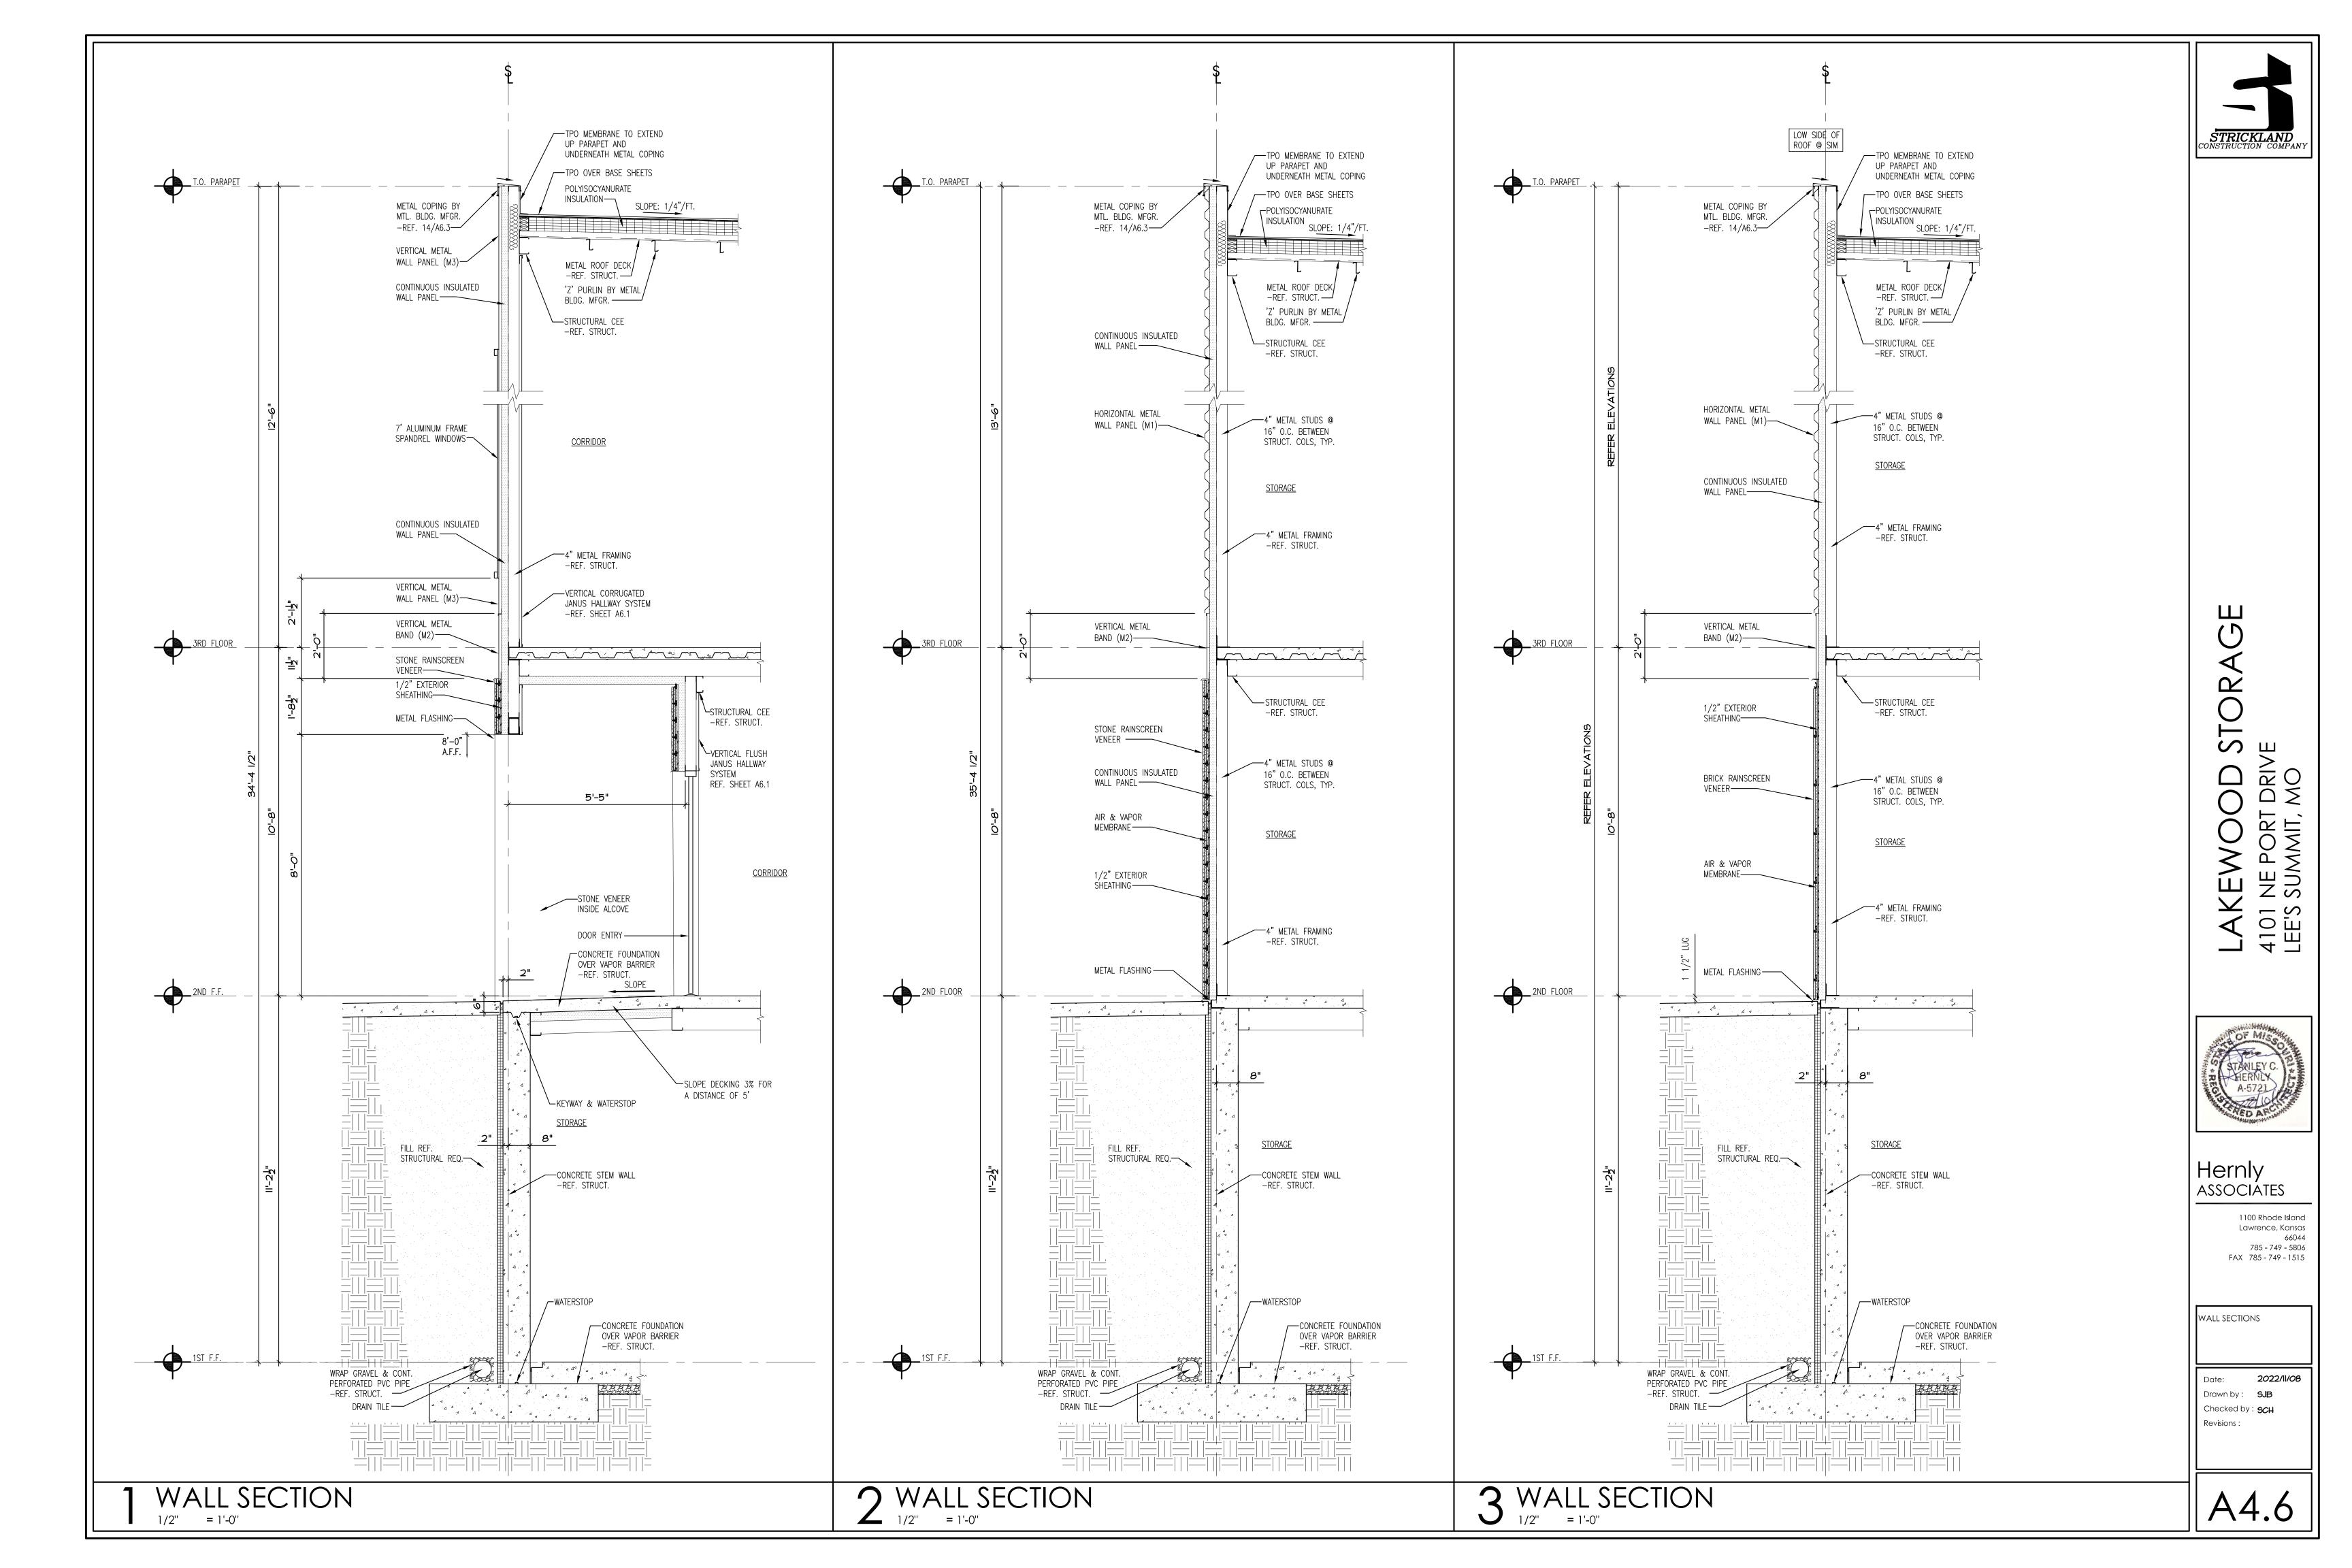


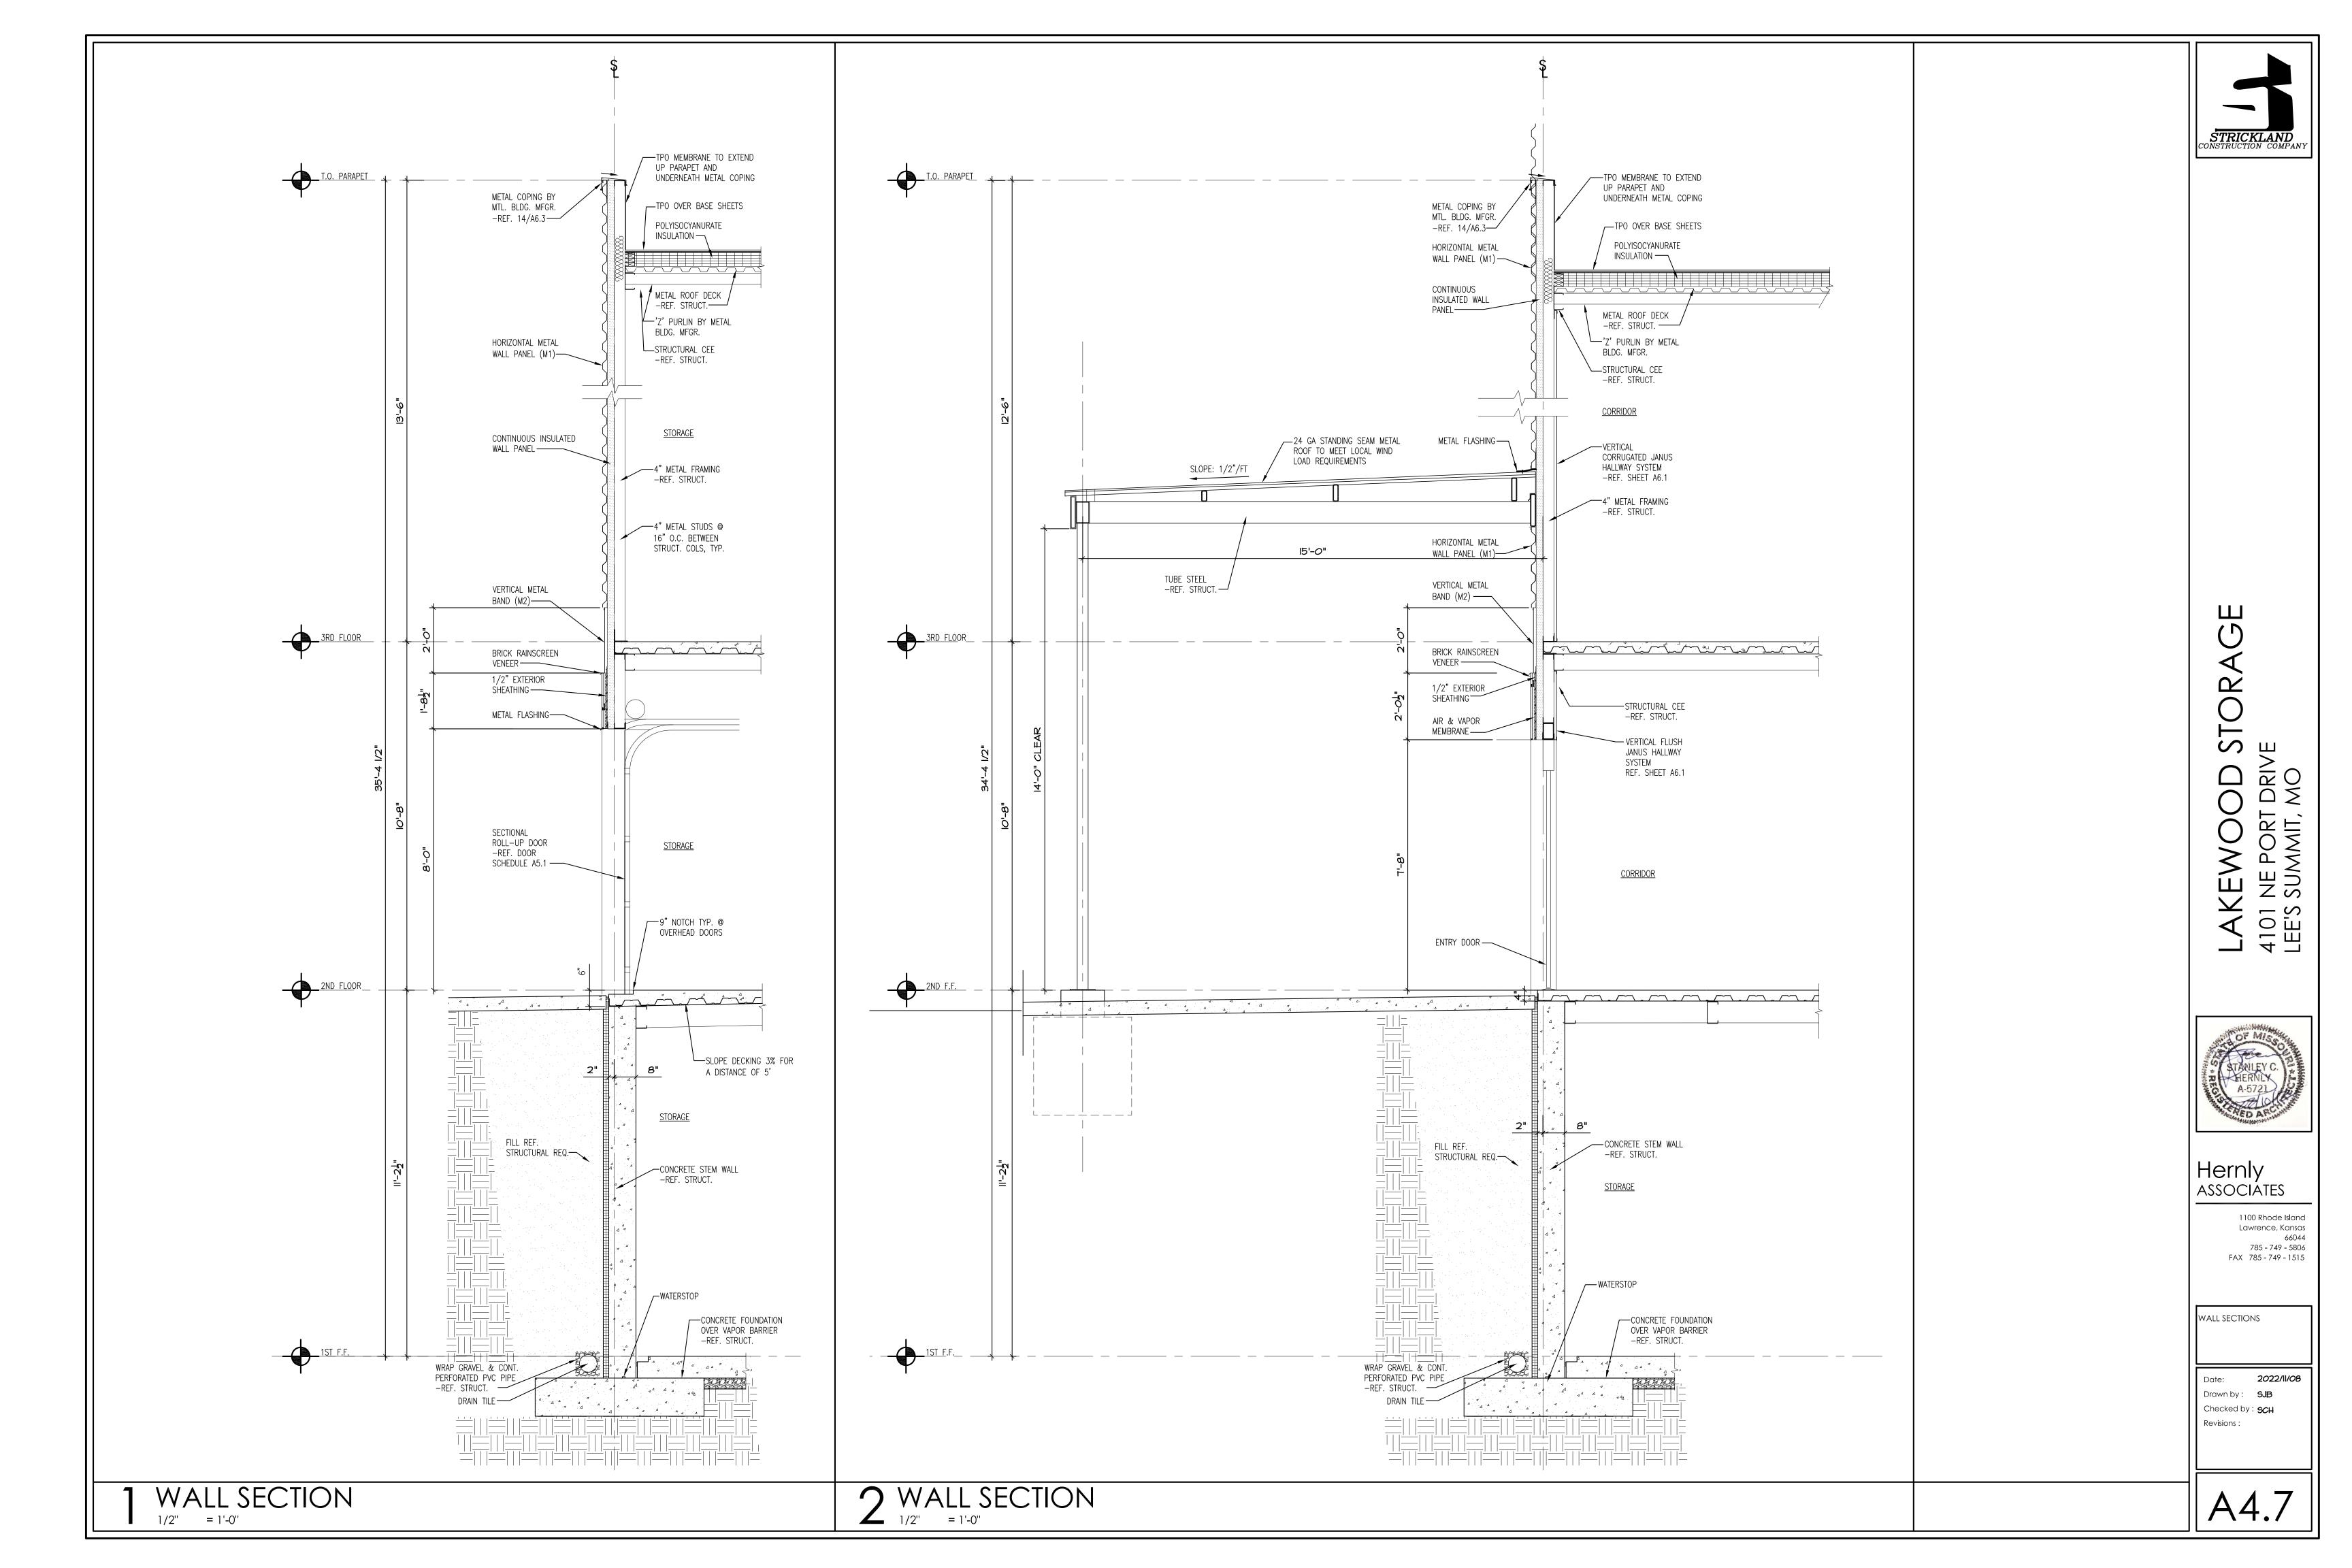


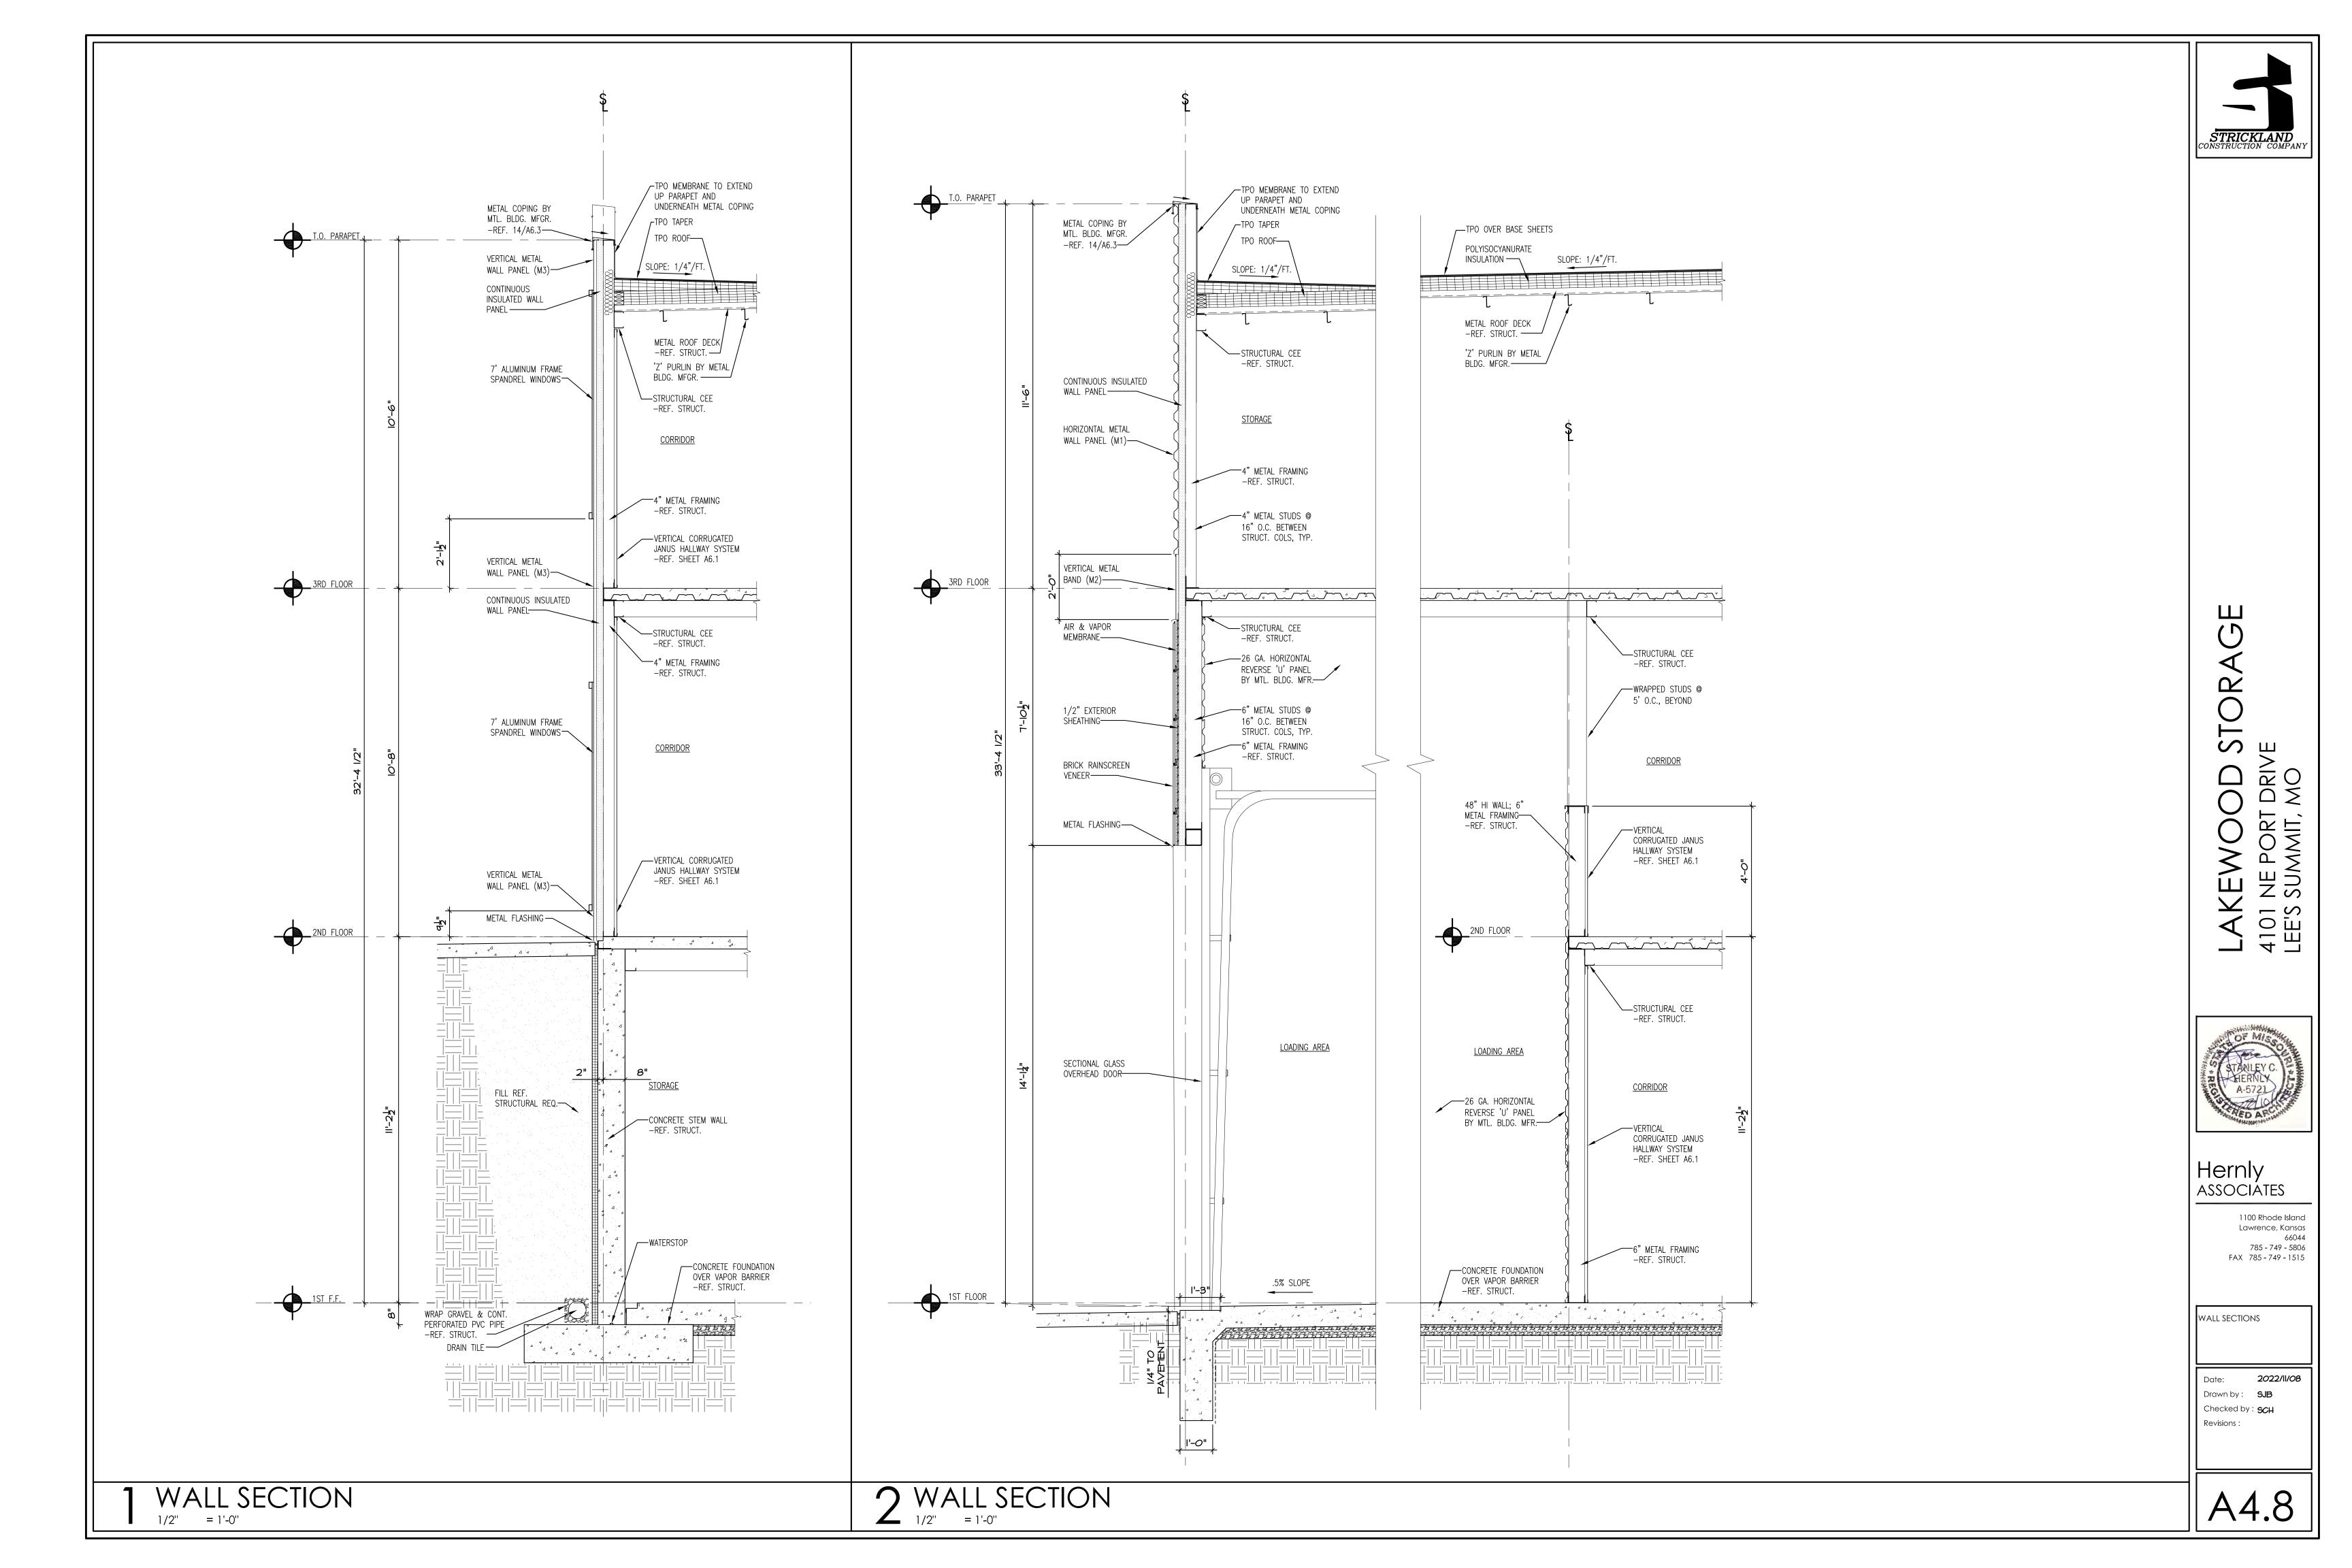

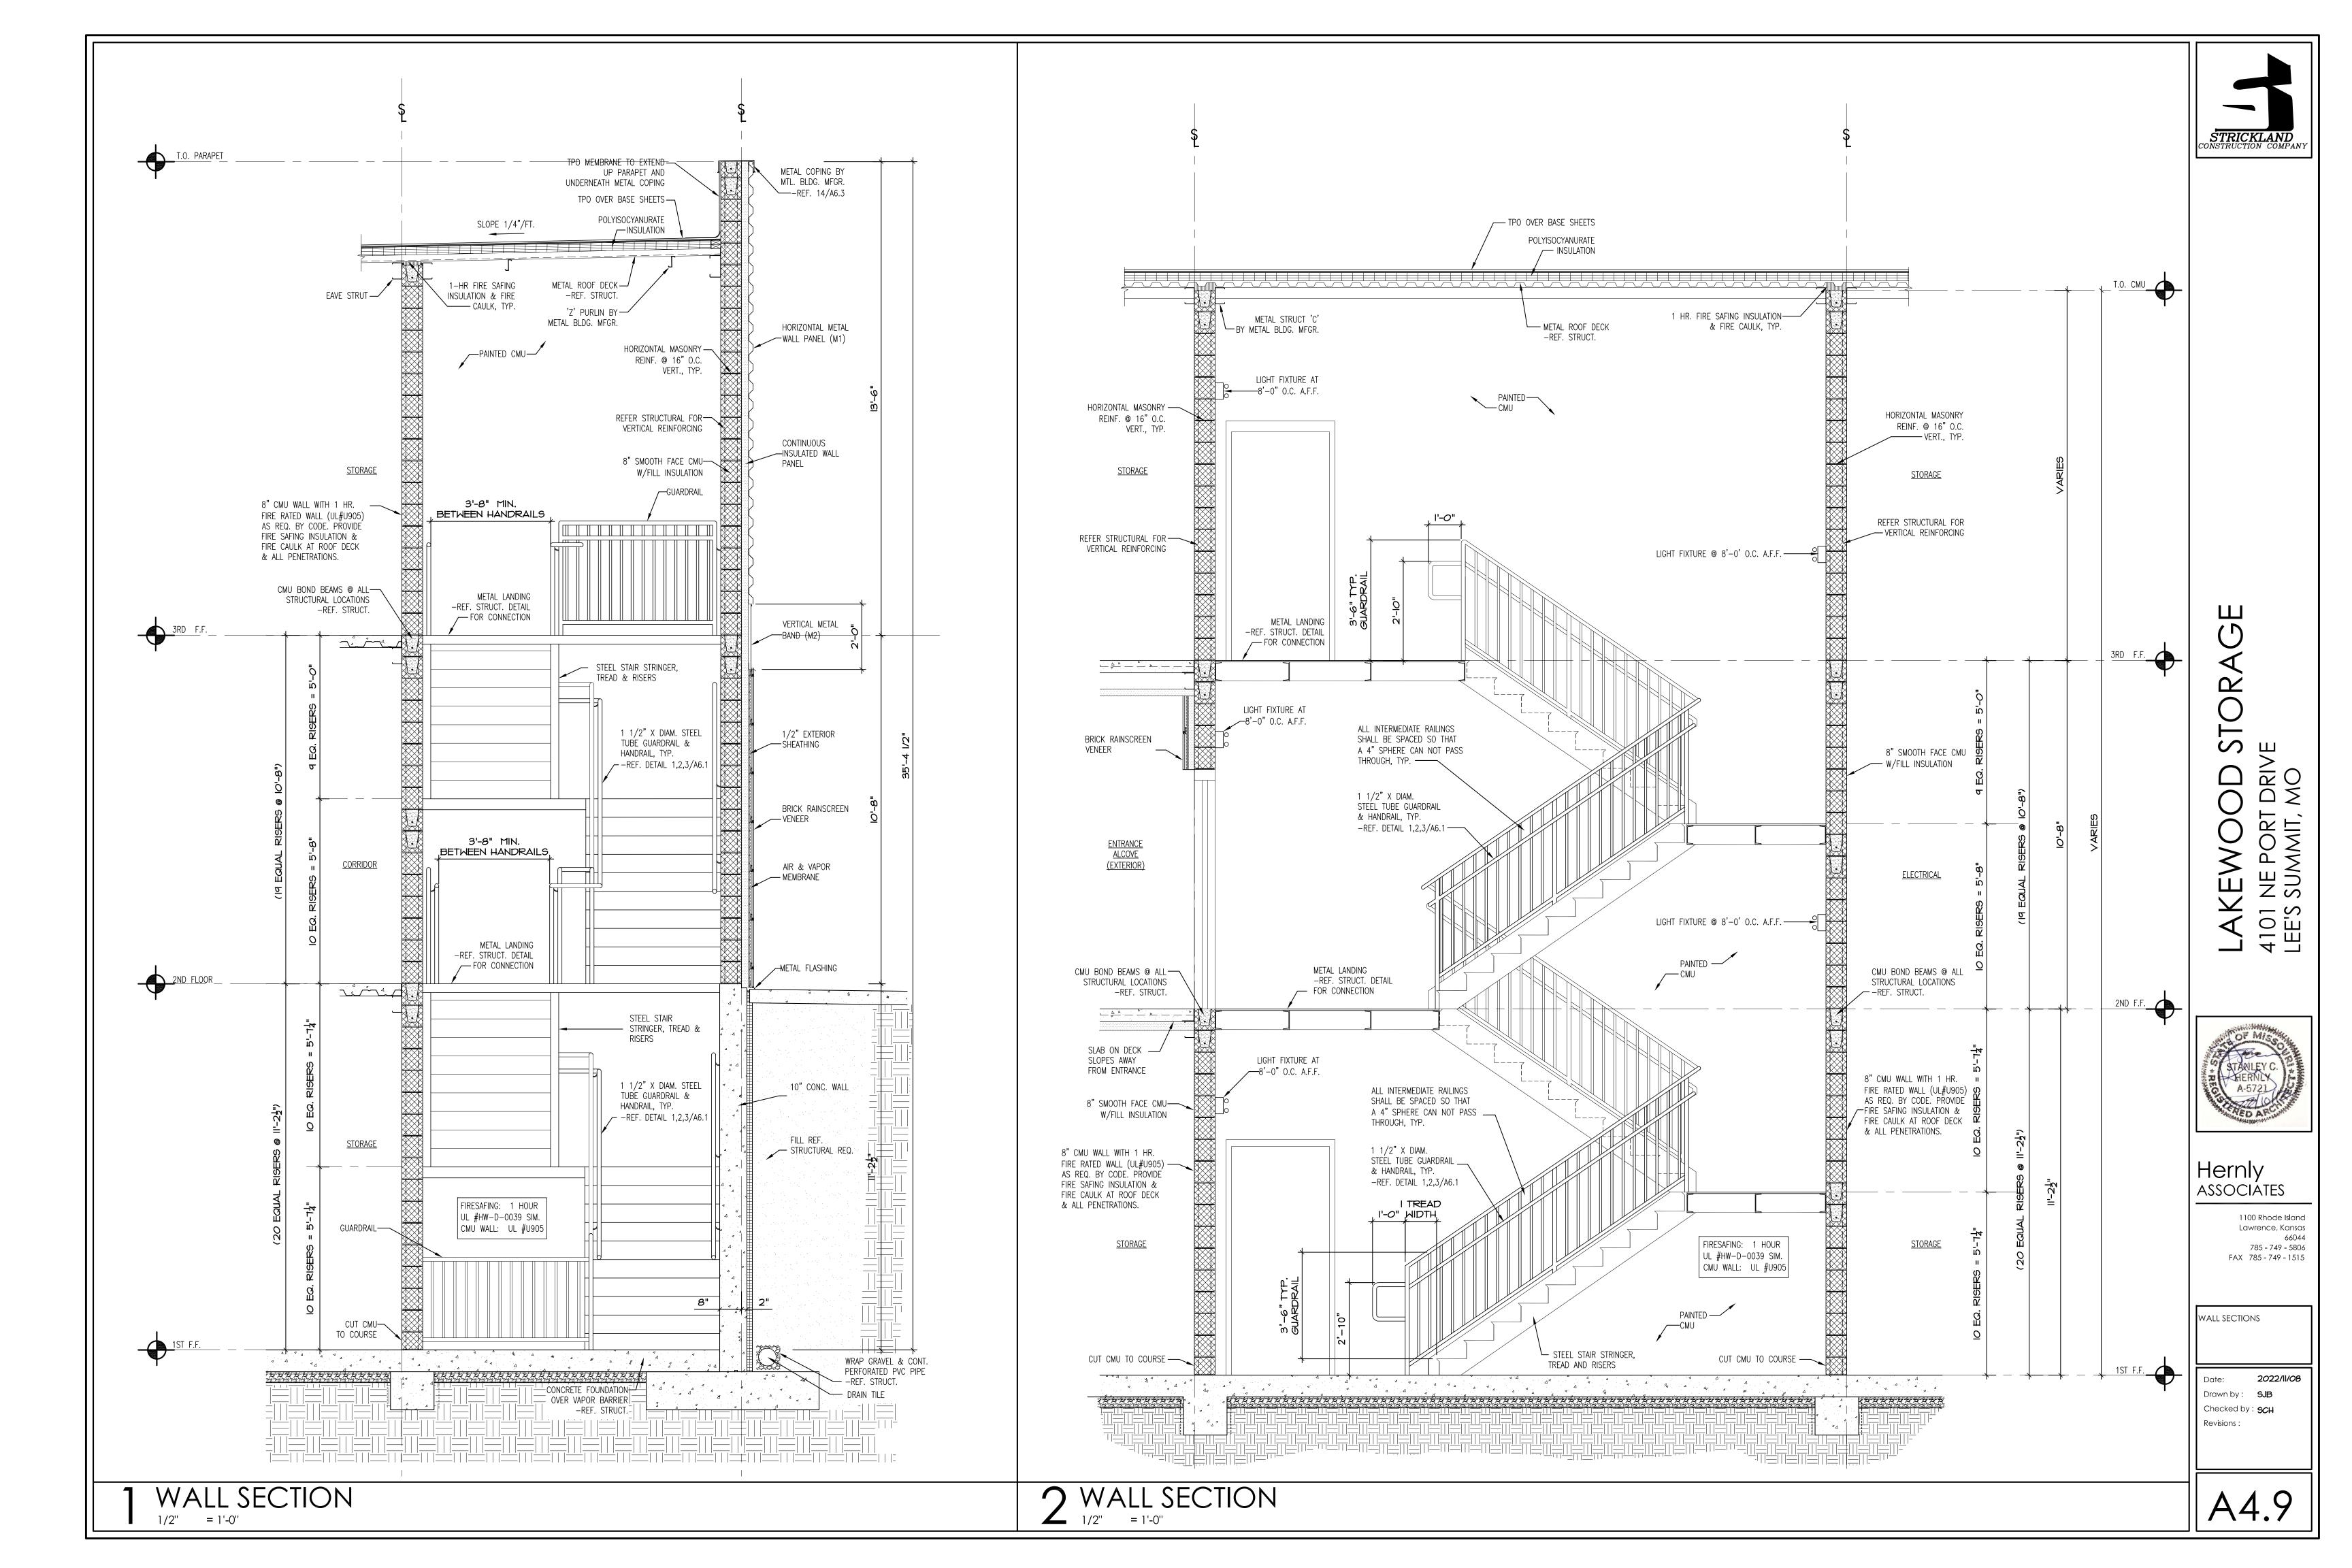

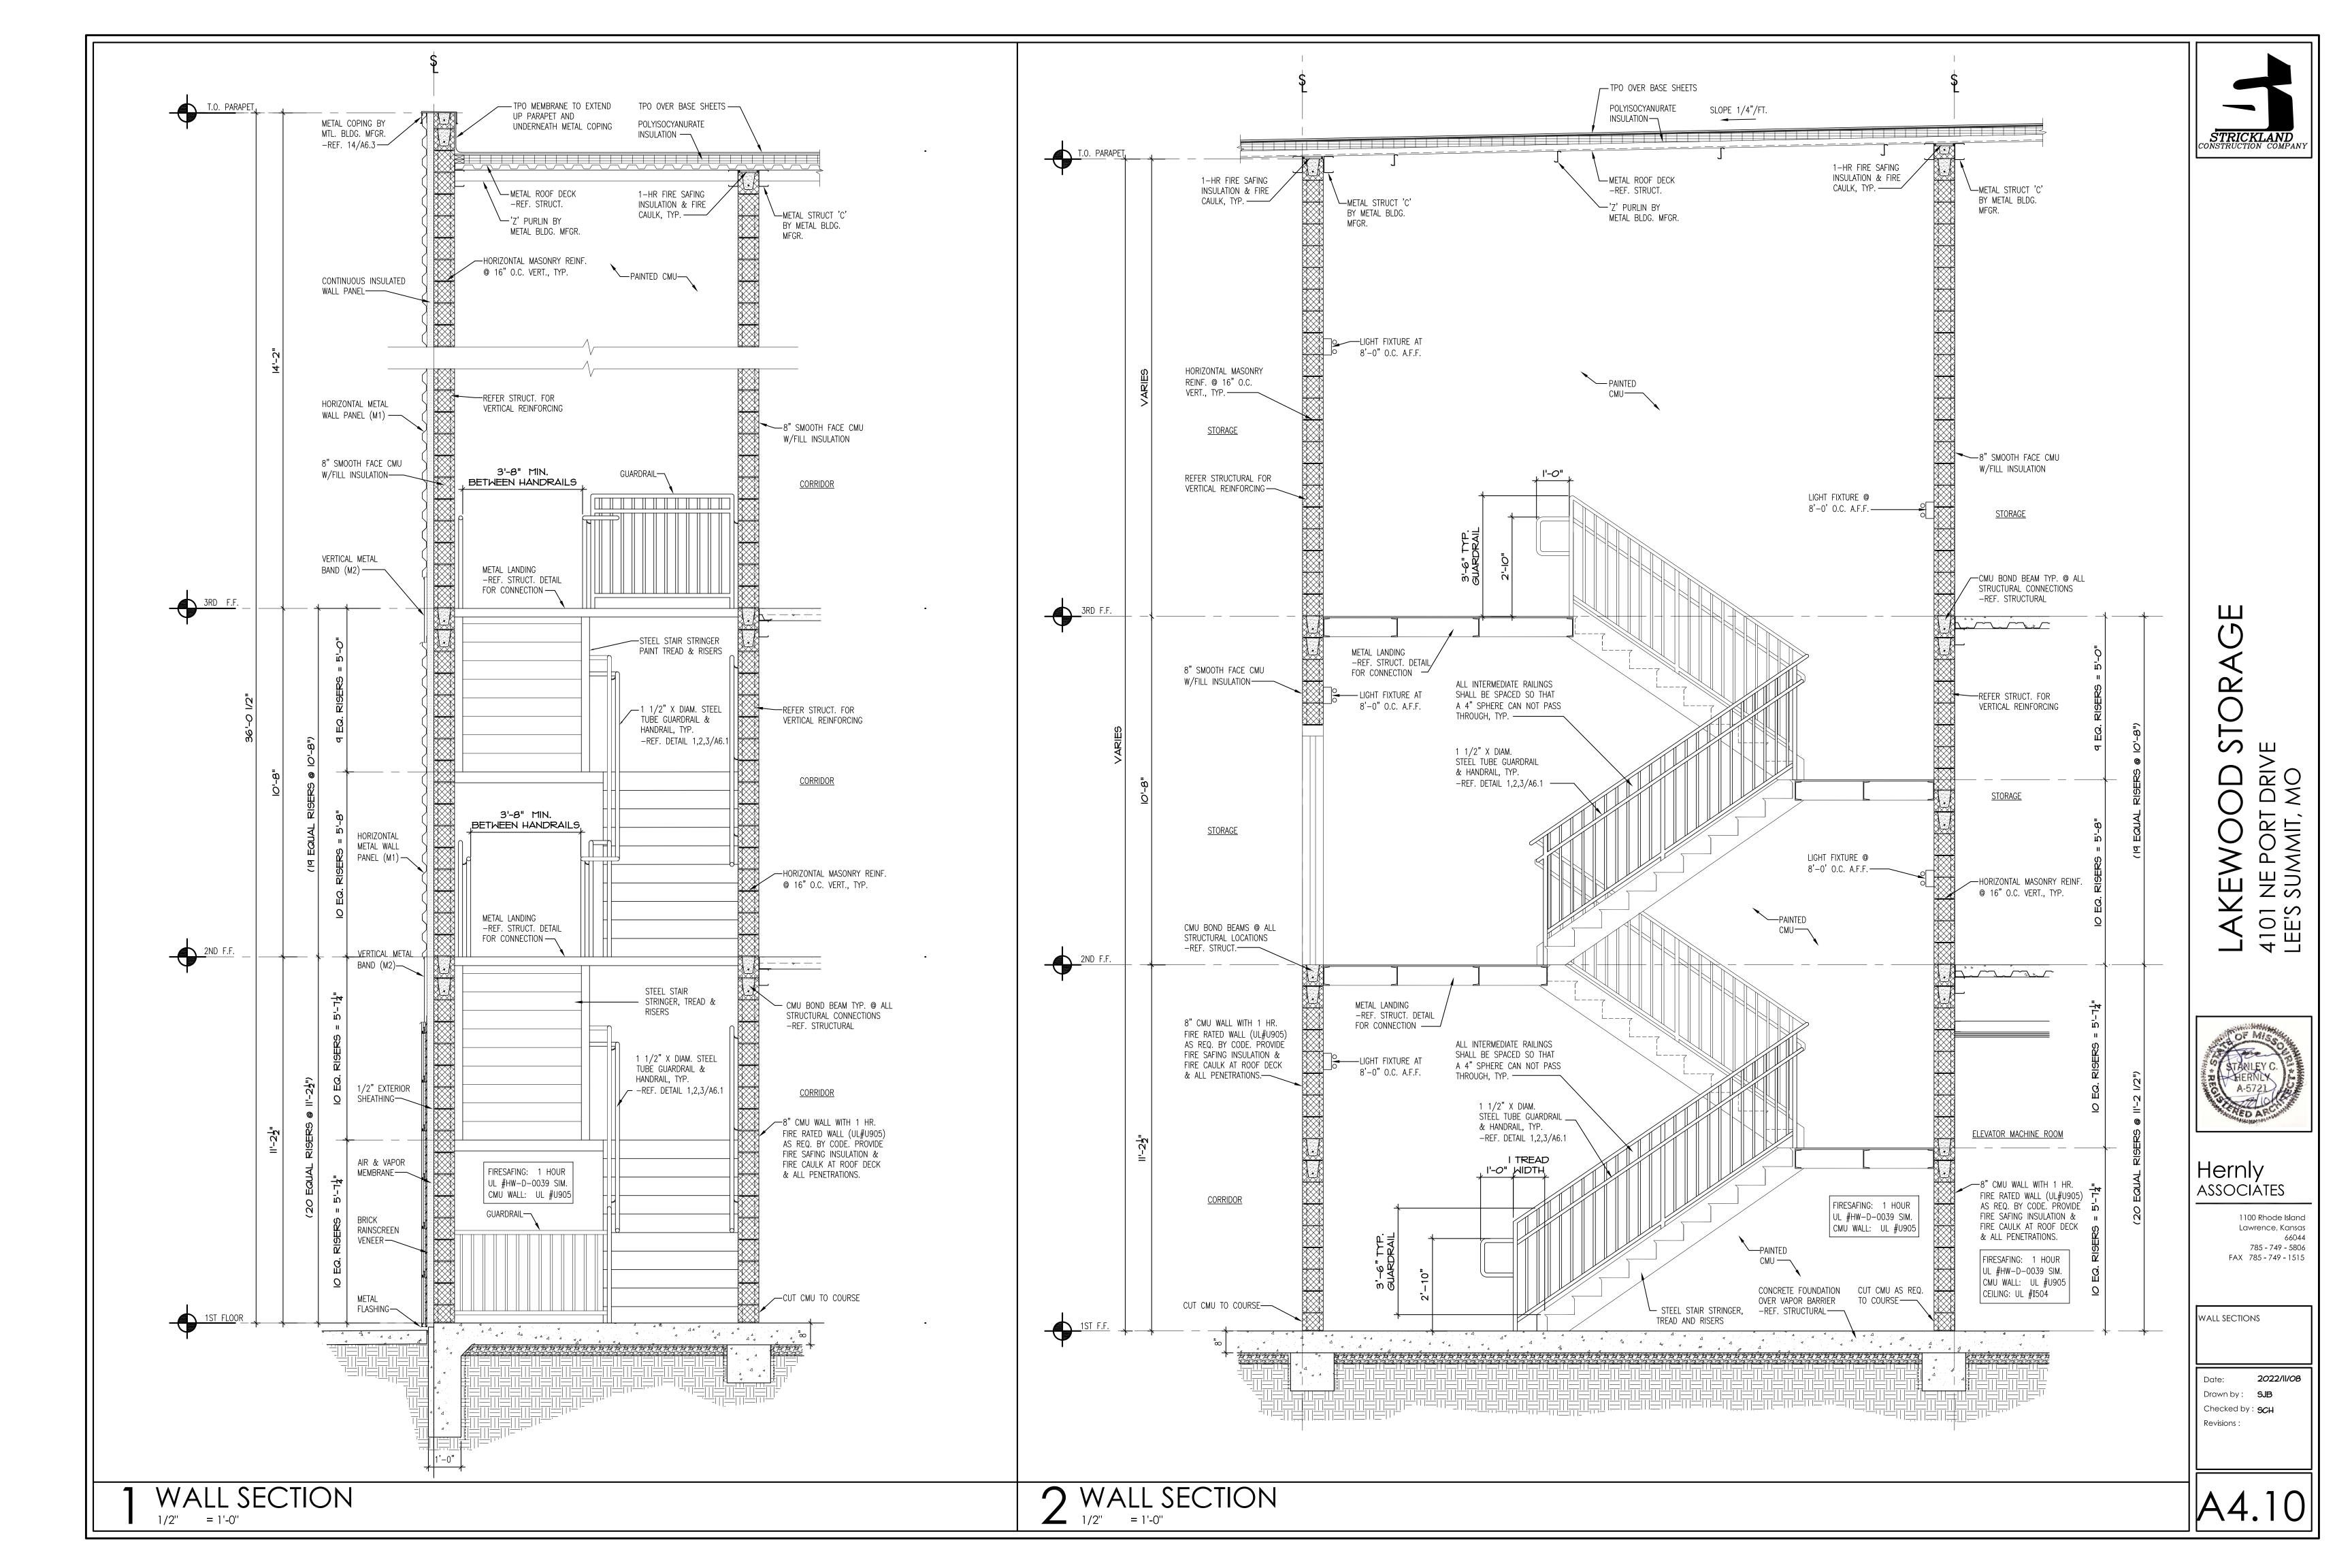

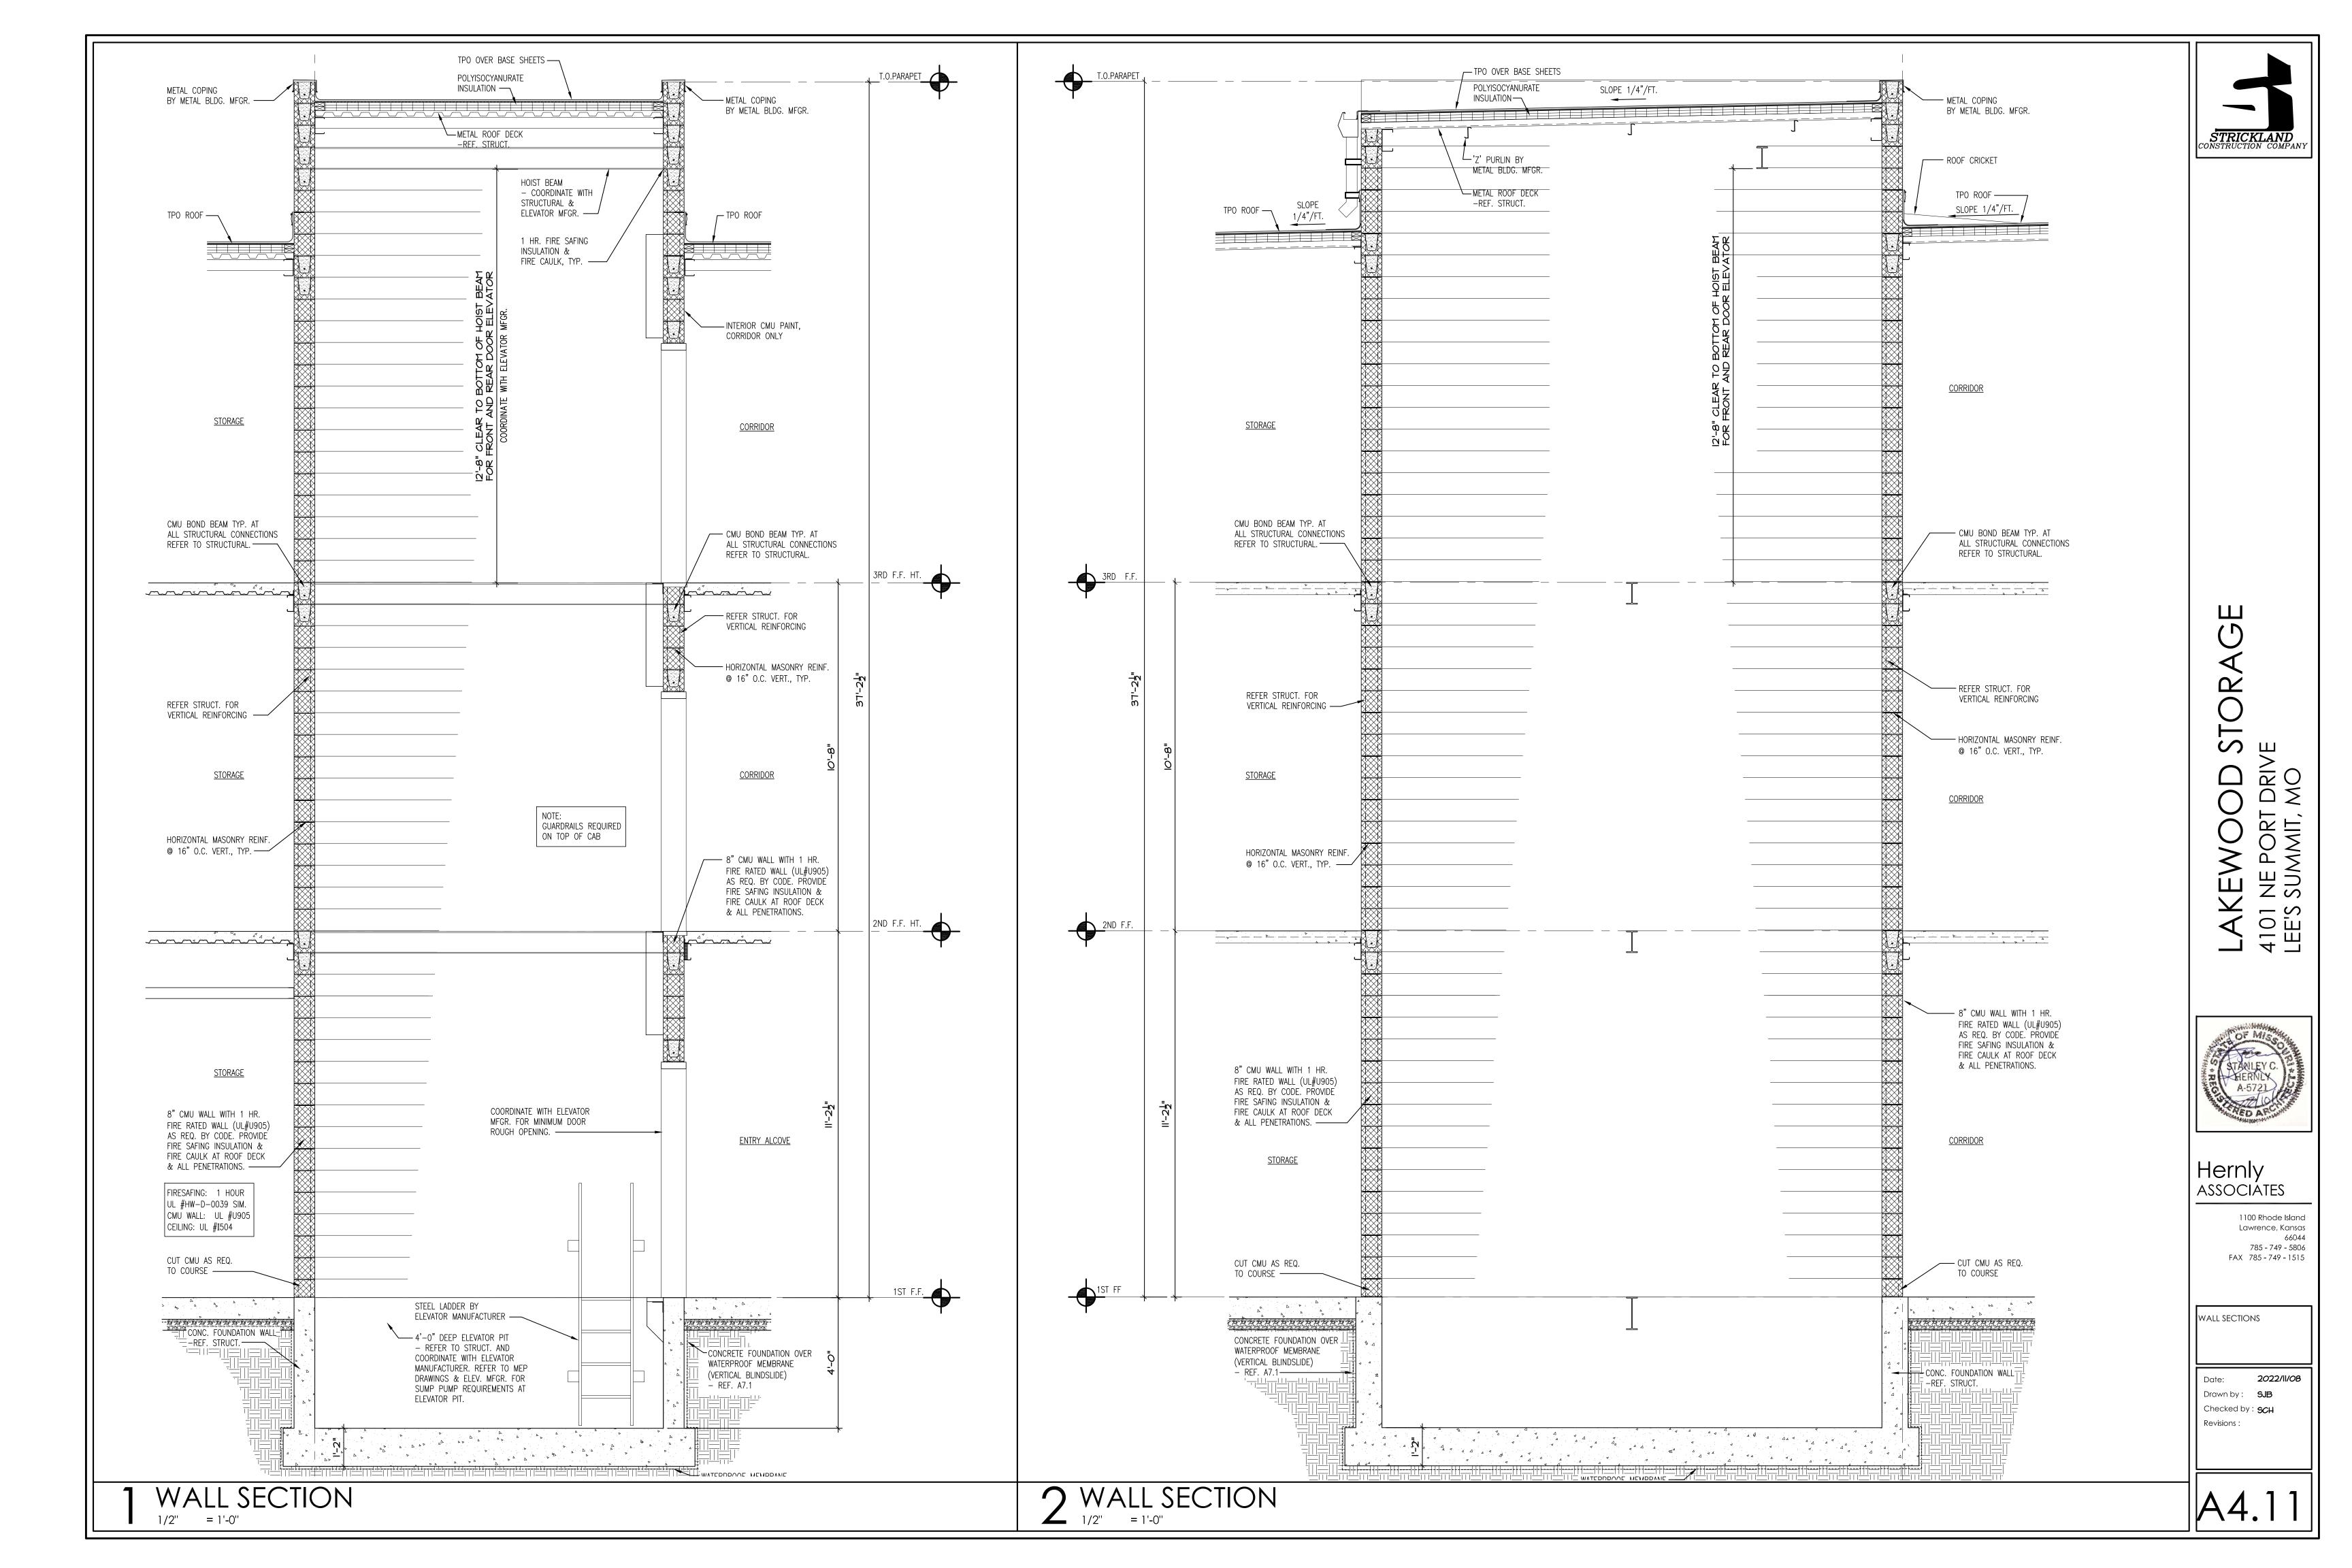

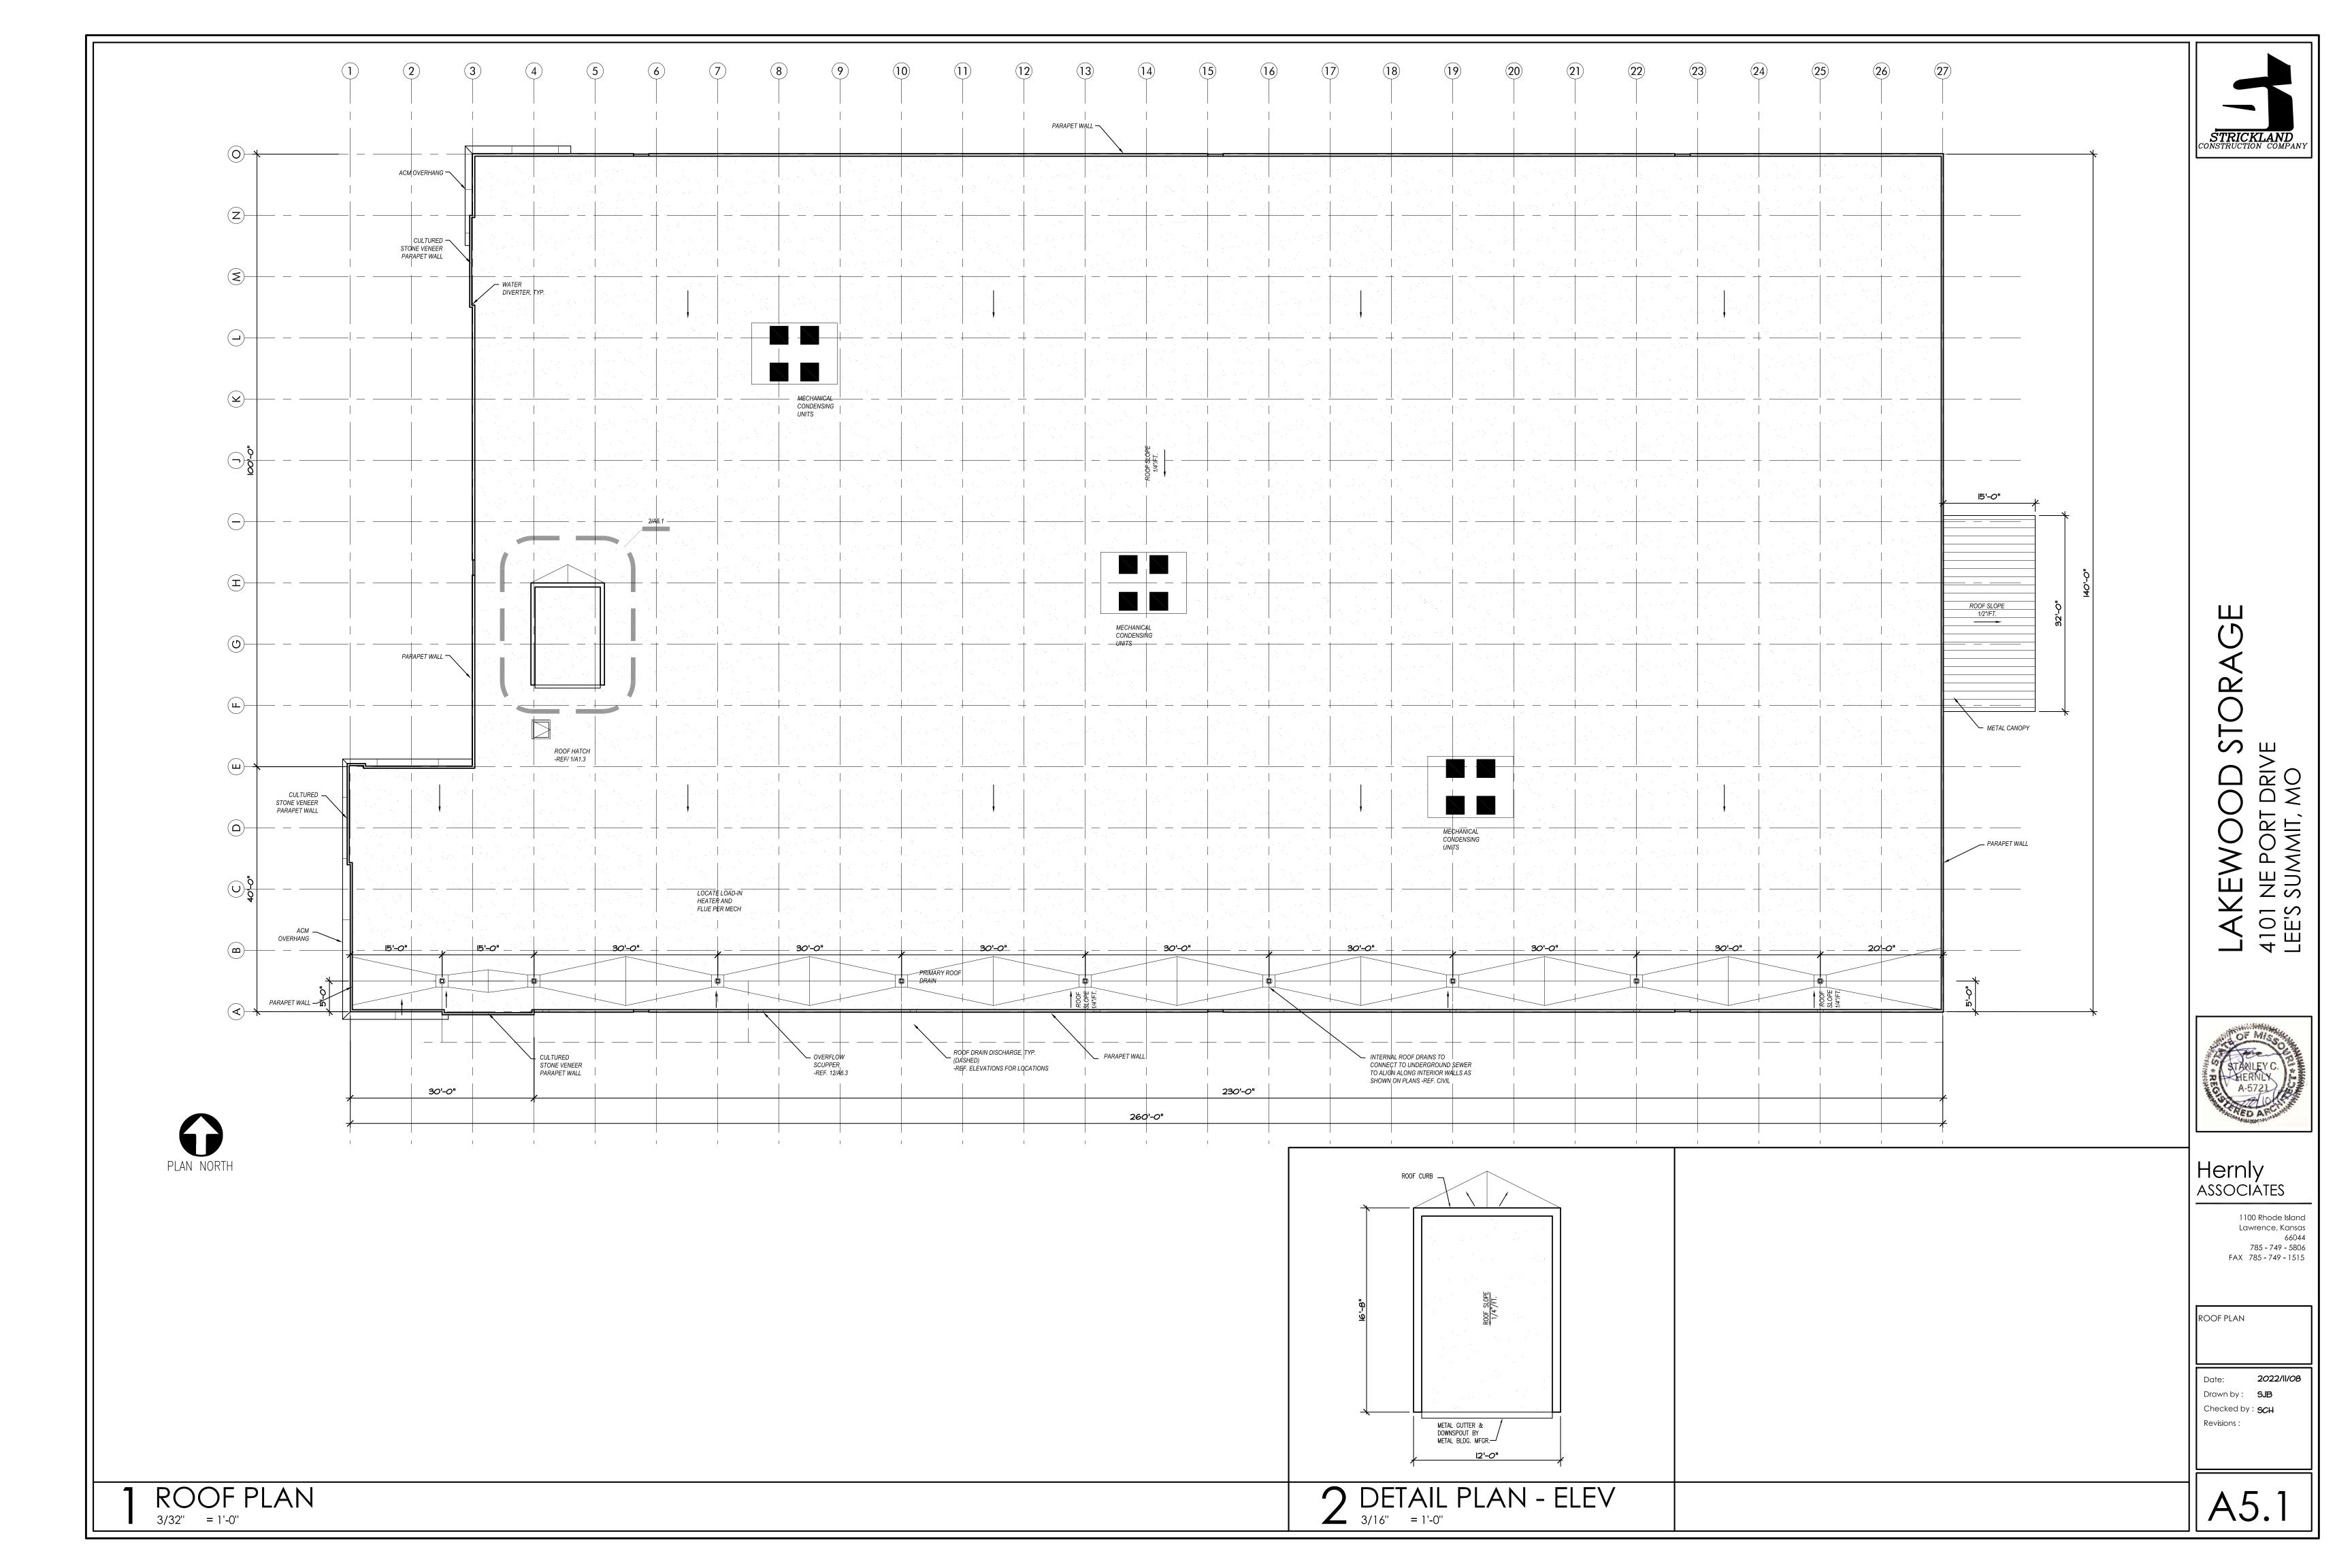



Lawrence, Kansas

785 - 749 - 5806

2022/11/08


FAX 785 - 749 - 1515 PLAN DETAILS


Date:

19: DOOR SIGNAGE @ EXITS


21: STANLEY ACCESS CONTROL Drawn by: SJB Checked by: **SCH** Revisions :

A6.

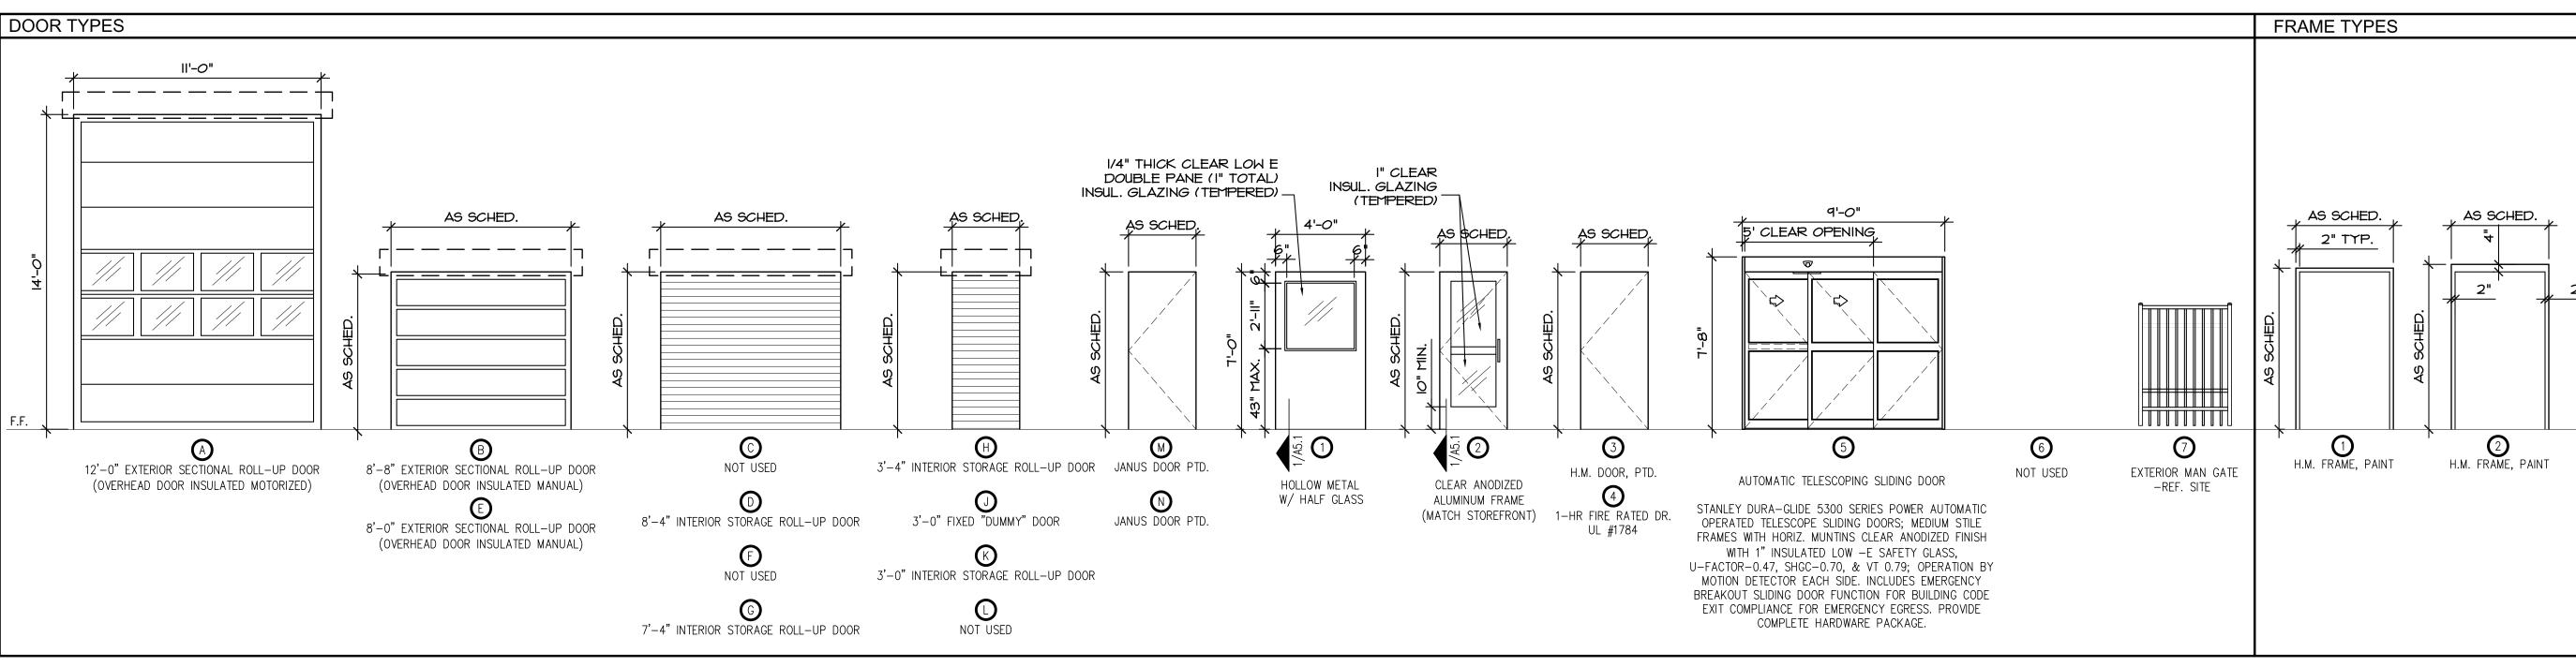


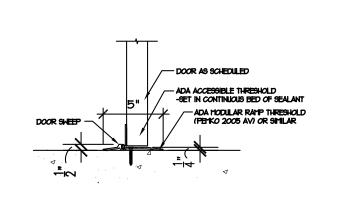


# THRESHOLD DETAIL

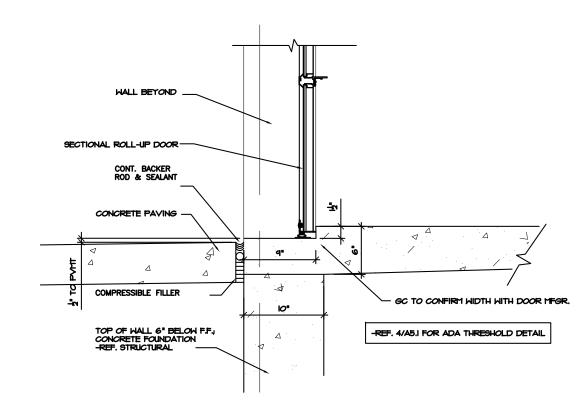

#### THRESHOLD DETAIL @ EXT UNITS SCALE: 1" = 1'-0"

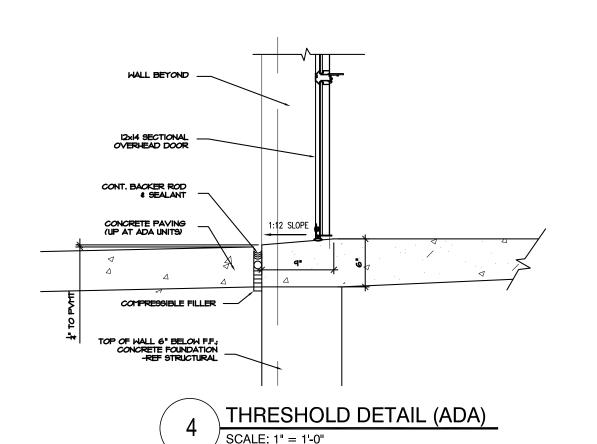

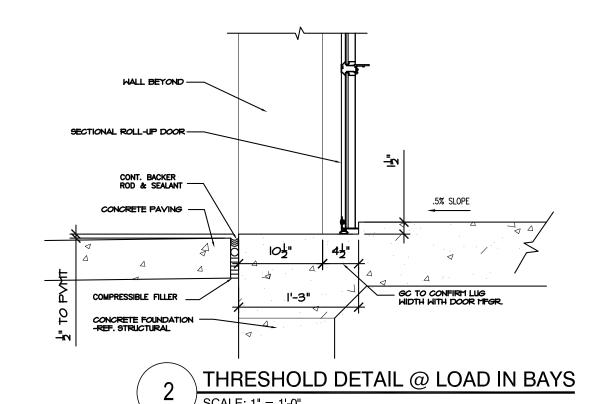

F	INIS	SH SCHEDULE									
			FLO	OR		WALLS	CEIL	KEYED			
	FIF	RST FLOOR	MATERIAL	BASE	NORTH	SOUTH	EAST	WEST	HEIGHT	TYPE	NOTES
	101	SALES AREA	PC	WD	PT-1	PT-1	-	PT-1	-	ES	-
	102	RECEPTION DESK	PC	WD	PT-1	PT-1	PT-1/PT-2	-	-	ES	-
	103	MDF / BREAK ROOM	PC	RUBBER	PT-1	PT-1	PT-1	PT-1	8'-0"	LAY-IN	
빙	104	AHU ROOM	PC	-	PT-1	PT-1	PT-1	PT-1	8'-0"	LAY-IN	
圧	105	DISPLAY AREA	PC	WD	PT-1	PT-1	PT-1	PT-1	-	ES	2
0	106	MENS T.R.	PFT	-	PT-3	PT-3	PT-3	PT-3	8'-0"	LAY-IN	1
	107	WOMENS T.R.	PFT	-	PT-3	PT-3	PT-3	PT-3	8'-0"	LAY-IN	1
	108	DRINKING FOUNTAIN	PC	-	JANUS	JANUS	JANUS	JANUS	-	ES	-
	109	LOADING AREA	SLT	-	JANUS	JANUS	JANUS	JANUS	_	ES	-

WD

SLT

I. SMOOTH, HARD, NON-ABSORBANT FINISH REQ'D UP TO 48" (EPOXY PAINT TYP. @ ALL RESTROOMS) 2. DUMMY DOORS PER FLOOR PLANS. **GENERAL NOTES:** A. GENERAL CONTRACTOR TO SUBMIT ALL

FINISH SELECTIONS TO OWNER AND ARCHITECT FOR APPROVAL PRIOR TO ORDERING B. REF. SHEET A7.1 FOR SPECIFICATIONS. C. GENERAL CONTRACTOR TO PROVIDE ALLOWANCE FOR CERAMIC TILE IN ROOMS 101-105 AS AN

ALTERNATE

EXPOSED STRUCTURE GRID 2X2 CEILING GRID ONLY GYP 5/8" TYPE 'X' GYPSUM BOARD JANUS WALL SYSTEM JANUS 2x2 LAY-IN ACOUSTICAL CEILING LAY-IN POLISHED CONCRETE PORCELAIN FLOOR TILE PT-1 INTERIOR OFFICE PAINT INTERIOR OFFICE PAINT - ACCENT PT-2 PT-3 **EPOXY PAINT** RUBBER RUBBER WALL BASE

PAINTED WOOD BASE

SEALANT WITH TRAFFIC COATING

STOREFRONT DETAIL

#### DOOR NOTES

- BE APPROVED BY OWNER BASED ON SUBCONTRACTOR SUBMITTAL.
- 2: CONTRACTOR TO COORDINATE DOOR HARDWARE AND FRAMES WITH SECURITY EQUIPMENT AND MAGNETIC HOLD OPEN DEVICES.
- 3: PROVIDE MIN. INTERIOR & EXTERIOR ACCESSIBLE HARDWARE, THRESHOLDS, SIGNAGE, ETC. TO COMPLY W/ ADA ACCESSIBILITY STANDARDS. REFERENCE FLOOR
- 4: NOT USED
- 5: NOT USED
- 6: STORAGE ROLL-UP DOORS-PROVIDE ALUM. HANDLES W/ SLIDE BAR LATCH TO FRAME, CONTINUOUS ALUM. BOTTOM PULL BAR, WEATHER SEALS (EXTERIOR) AND REMOVABLE CYLINDER LOCK W/ EMERGENCY OVERRIDE LATCH
- : GLAZING IN ALL EXTERIOR DOORS TO BE INSULATED LOW-E GLAZING W/ 1/4" DOUBLE PANES W/ 1/2" AIR SPACE
- 9. READILY VISIBLE DURABLE SIGN POSTED ON THE EGRESS SIDE ON OR ADJACENT TO THE DOOR STATING: "THIS DOOR TO REMAIN UNLOCKED WHEN BUILDING IS OCCUPIED"
- DOOR STATING "ROOM NAME" IN TACTILE LETTERS AND BRAILLE - REF. SHEET A2.6 FOR INSTALLATION INSTRUCTIONS.
- 13. ROLL UP DOORS TO MEET LOCAL WIND LOAD REQUIREMENTS.
- 14. CONSTRUCTION CORES TO REMAIN REKEYING/MASTER
- 15. 3'-0" CLEAR MAN GATE ORNAMENTAL IRON APPLIED METAL SECURITY MESH AT GATE AND ADJACENT FENCE PANEL EXTEND FULL LENGTH OF EITHER SIDE OF LOCKSET. LEVER HARDWARE PER ADA REQUIREMENTS.
- 16. SLIDING DOOR OPENING TO BE ON SAME SIDE AS MAN DOOR ADJACENT.
- 17. DOORS TO COMPLY WITH ENERGY CODES SHOWN ON SHEET A7.1.
- 18. DOORS TO COM

_	_	_			_	•	_			
1:	D	00	DR	HA	١RI	D۱	NΑ	RE	TC	)
1:	D	OC	DR	HA	١RI	D۱	NΑ	RΕ	TC	

- PLANS FOR LOCATIONS.
- OPERATOR TO OPERATOR.
- (1" TOTAL) (TEMPERED).
- 8. THRESHOLDS  $1\frac{1}{2}$ " LUGS NOT REQUIRED AT ALCOVE ENTRIES.
- -REF. SHEET A2.6 FOR INSTALLATION INSTRUCTIONS.
- 10. FIRE RATED DOORS TO BE SELF CLOSING OR AUTOMATIC CLOSING.
- 11. READILY VISIBLE DURABLE SIGN POSTED ON EGRESS SIDE ADJACENT TO DOOR STATING: "EXIT" IN TACTILE LETTERS & BRAILLE -REF SHEET A2.6 FOR INSTALLATION INSTRUCTIONS.
- 12. READILY VISIBLE DURABLE SIGN POSTED ON ENTRY SIDE OF
- KEYING BY OWNER

MPLY WITH LOCAL WIND LOAD CAPACITY.	

LOCATION	MARK	WIDTH	HEIGHT	DOOR TYPE	FRAME TYPE	REMARKS
OFFICE ENTRY	1	3'-0"	7'-0"	2	STFT	1,2,3,5,8,9,11,15,16,17,18,23
MDF ROOM	2	3'-0"	7'-0"	3	1	11,15,20
AHU ROOM	3	3'-0"	7'-0"	3	1	7,10,11,20
OFFICE / LOADING	4	3'-0"	7'-0"	1	1	11,15,20
OFFICE / STORAGE	(5)	3'-0"	7'-0"	3	1	11,15,20
TOILET ROOM	6	3'-0"	7'-0"	3	1	11,14,20,24
TOILET ROOM	7	3'-0"	7'-0"	3	1	11,14,20,24
ALCOVE ENTRY	8	4'-0"	7'-0"	1	1	1,2,3,4,10,11,12,13,16,19,24
LOADING EXIT	9	3'-0"	7'-0"	1	1	1,2,3,8,10,11,12,16,19,24
STAIR B - 1ST FLR	10	3'-0"	7'-0"	4	1	1,2,6,10,11,19,24
STAIR B - EXIT	11)	3'-0"	7'-0"	4	1	1,2,3,8,10,11,12,16,19,24
ELEV. ACCESS	(12N)	3'-0"	7'-0"	3	1	2,3,8,10,11,12,16,20
ELEV. ACCESS	128	3'-0"	7'-0"	3	1	2,3,8,10,11,12,16,20
ELECTRICAL ROOM	13	3'-0"	7'-0"	3	1	2,3,8,10,11,12,16,20
FIRE RISER ROOM	14)	6'-0" PR	7'-0"	3	1	2,3,8,10,11,12,16,20
ALCOVE ENTRY	(15)	4'-0"	7'-0"	1	1	1,2,3,4,10,11,12,13,16,19,24
STAIR A - 1ST FLR	16	3'-0"	7'-0"	4	2	1,2,6,10,11,19,24
STAIR A - EXIT	17)	3'-0"	7'-0"	3	2	1,2,3,8,10,11,12,16,19,24
STAIR A	18	3'-0"	7'-0"	3	2	1,2,3,8,10,11,12,16,19,24
SLIDING DOOR	19	9'-0"	7'-8"	5R	-	3,13,19,21,22,27
STAIR B - 2ND FLR	20	3'-0"	7'-0"	4	2	1,2,6,10,11,19,24
STAIR A - 3RD FLR	21)	3'-0"	7'-0"	4	2	1,2,6,10,11,19,24
STAIR B - 3RD FLR	22	3'-0"	7'-0"	4	2	1,2,6,10,11,19,24
MAN GATE	23	3'-0"	6'-0"	7	-	1,2,24,25
		ARKS:: ANIC HA	RDWARE	<u> </u>	16: DOOR	SWEEP

STORAGE DOOR SCHEDULE

8'-8" 8'-0" EXT. SECT.

14'-0" EXT. SECT.

7'-0" INT. ROLL-UP

8'-0" EXT. SECT.

7'-0" INT. ROLL-UP

7'-0" INT. ROLL-UP

7'-0" DUMMY DOOF

7'-0" INT. ROLL-UP

(M) 3'-0" 7'-0" JANUS SWING

(N) 3'-0" 7'-0" JANUS SWING

DOOR SCHEDULE

NOT USED

NOT USED

NOT USED

FRAME TYPE REMARKS

17,28

17,28

17

17,28

17

17

9,17

17

MARK WIDTH HEIGHT DOOR TYPE

	1: PANIC HARDWARE
ı	2: DOOR CLOSER
	3: WEATHER STRIPPING
ı	/ THRESHOLD
	-REF. DETAIL 1/A5.1
ı	4: MAGNETIC HOLD OPEN

- DOORS W/ 15 MINUTE TIMER 5: DEADBOLT 6: FIRE RATED - 1-HR (REF. NOTE 10)
- 7: VENTED AT AHU LOCATIONS 8: DRIP FLASHING 9: FIXED "DUMMY DOORS 10: STORAGE LOCKSET 11: DOOR STOP 12: INSULATED
- 13: KEY PAD 14: TR LOCKSET 15: OFFICE LOCKSET
- (PANIC BAR & ELECTRIC LOCK) 22: STANLEY TIMER 23: MAIL-SLOT 24: KICKPLATE ON PUSH SIDE 25: MAN GATE KEYSET 26: NOT USED 27: RIGHT HAND OPENING 28: INSULATED SECTIONAL ROLL-UP

17: COLOR: REF. SHEET A7.1 18: DOOR SIGNAGE @ ENTRY

> IDENTIFYING ROOMS (REF. NOTE 12)

(REF. NOTE 9)

(REF. NOTE 11)

20: DOOR SIGNAGE @

29: CLASP ON LATCH PUSH SIDE 30: LEFT HAND OPENING

PLAN DETAILS

Date: 2022/II/08
Drawn by: SJB
Checked by: 9CH
Revisions:

A6.2

WINDOW NOTES

1. VERIFY ALL ROUGH OPENING DIMENSIONS IN RELATION
TO STRUCTURAL DRAWINGS. FRAME SIZES TO BE
ADJUSTED AS NECESSARY FOR PROPER SHIM, FLASHING,

AND THERMAL EXPANSION.

2. SAFETY (TEMPERED) GLAZING IS REQUIRED IN AN INDIVIDUAL FIXED OR OPERABLE PANEL ADJACENT TO A DOOR WHERE THE NEAREST EXPOSED EDGE OF THE GLAZING IS WITHIN A 24-INCH ARC OF EITHER VERTICAL EDGE OF THE DOOR IN A CLOSED POSITION AND WHERE THE BOTTOM EXPOSED EDGE OF THE GLAZING IS LESS THAN 60 INCHES ABOVE THE WALKING SURFACE (IBC 2406.3.6).

3. STOREFRONT INSULATED LOW-E GLAZING TO BE 1/4"
DOUBLE PANES WITH 1/2" AIR SPACE(1" TOTAL)(TEMPERED).


4. EXTERIOR INSULATED LOW-E GLAZING TO BE 1/4" DOUBLE PANES WITH 1/2" AIR SPACE (1" TOTAL) (TEMPERED).


5. FLASH AND WEATHERSTRIP ALL EXTERIOR WINDOWS TO PROVIDE WATER RESISTANT ASSEMBLY.

6. WINDOW DIMENSION @ FIRST FINISHED FLOOR IS FROM LUG TO SILL.

7. WINDOW AND DOOR DIMENSIONS ARE ROUGH OPENINGS. DOORS, FRAMES, WINDOWS, ETC. ARE TO BE SIZED TO ALLOW SHIMS AND TOLERANCES TO MEET INDUSTRY STANDARDS AND THERMAL EXPOSION (DEFINE IN SHOP DRAWINGS).

8. STOREFRONTS TO BE ANODIZED ALUMINUM.

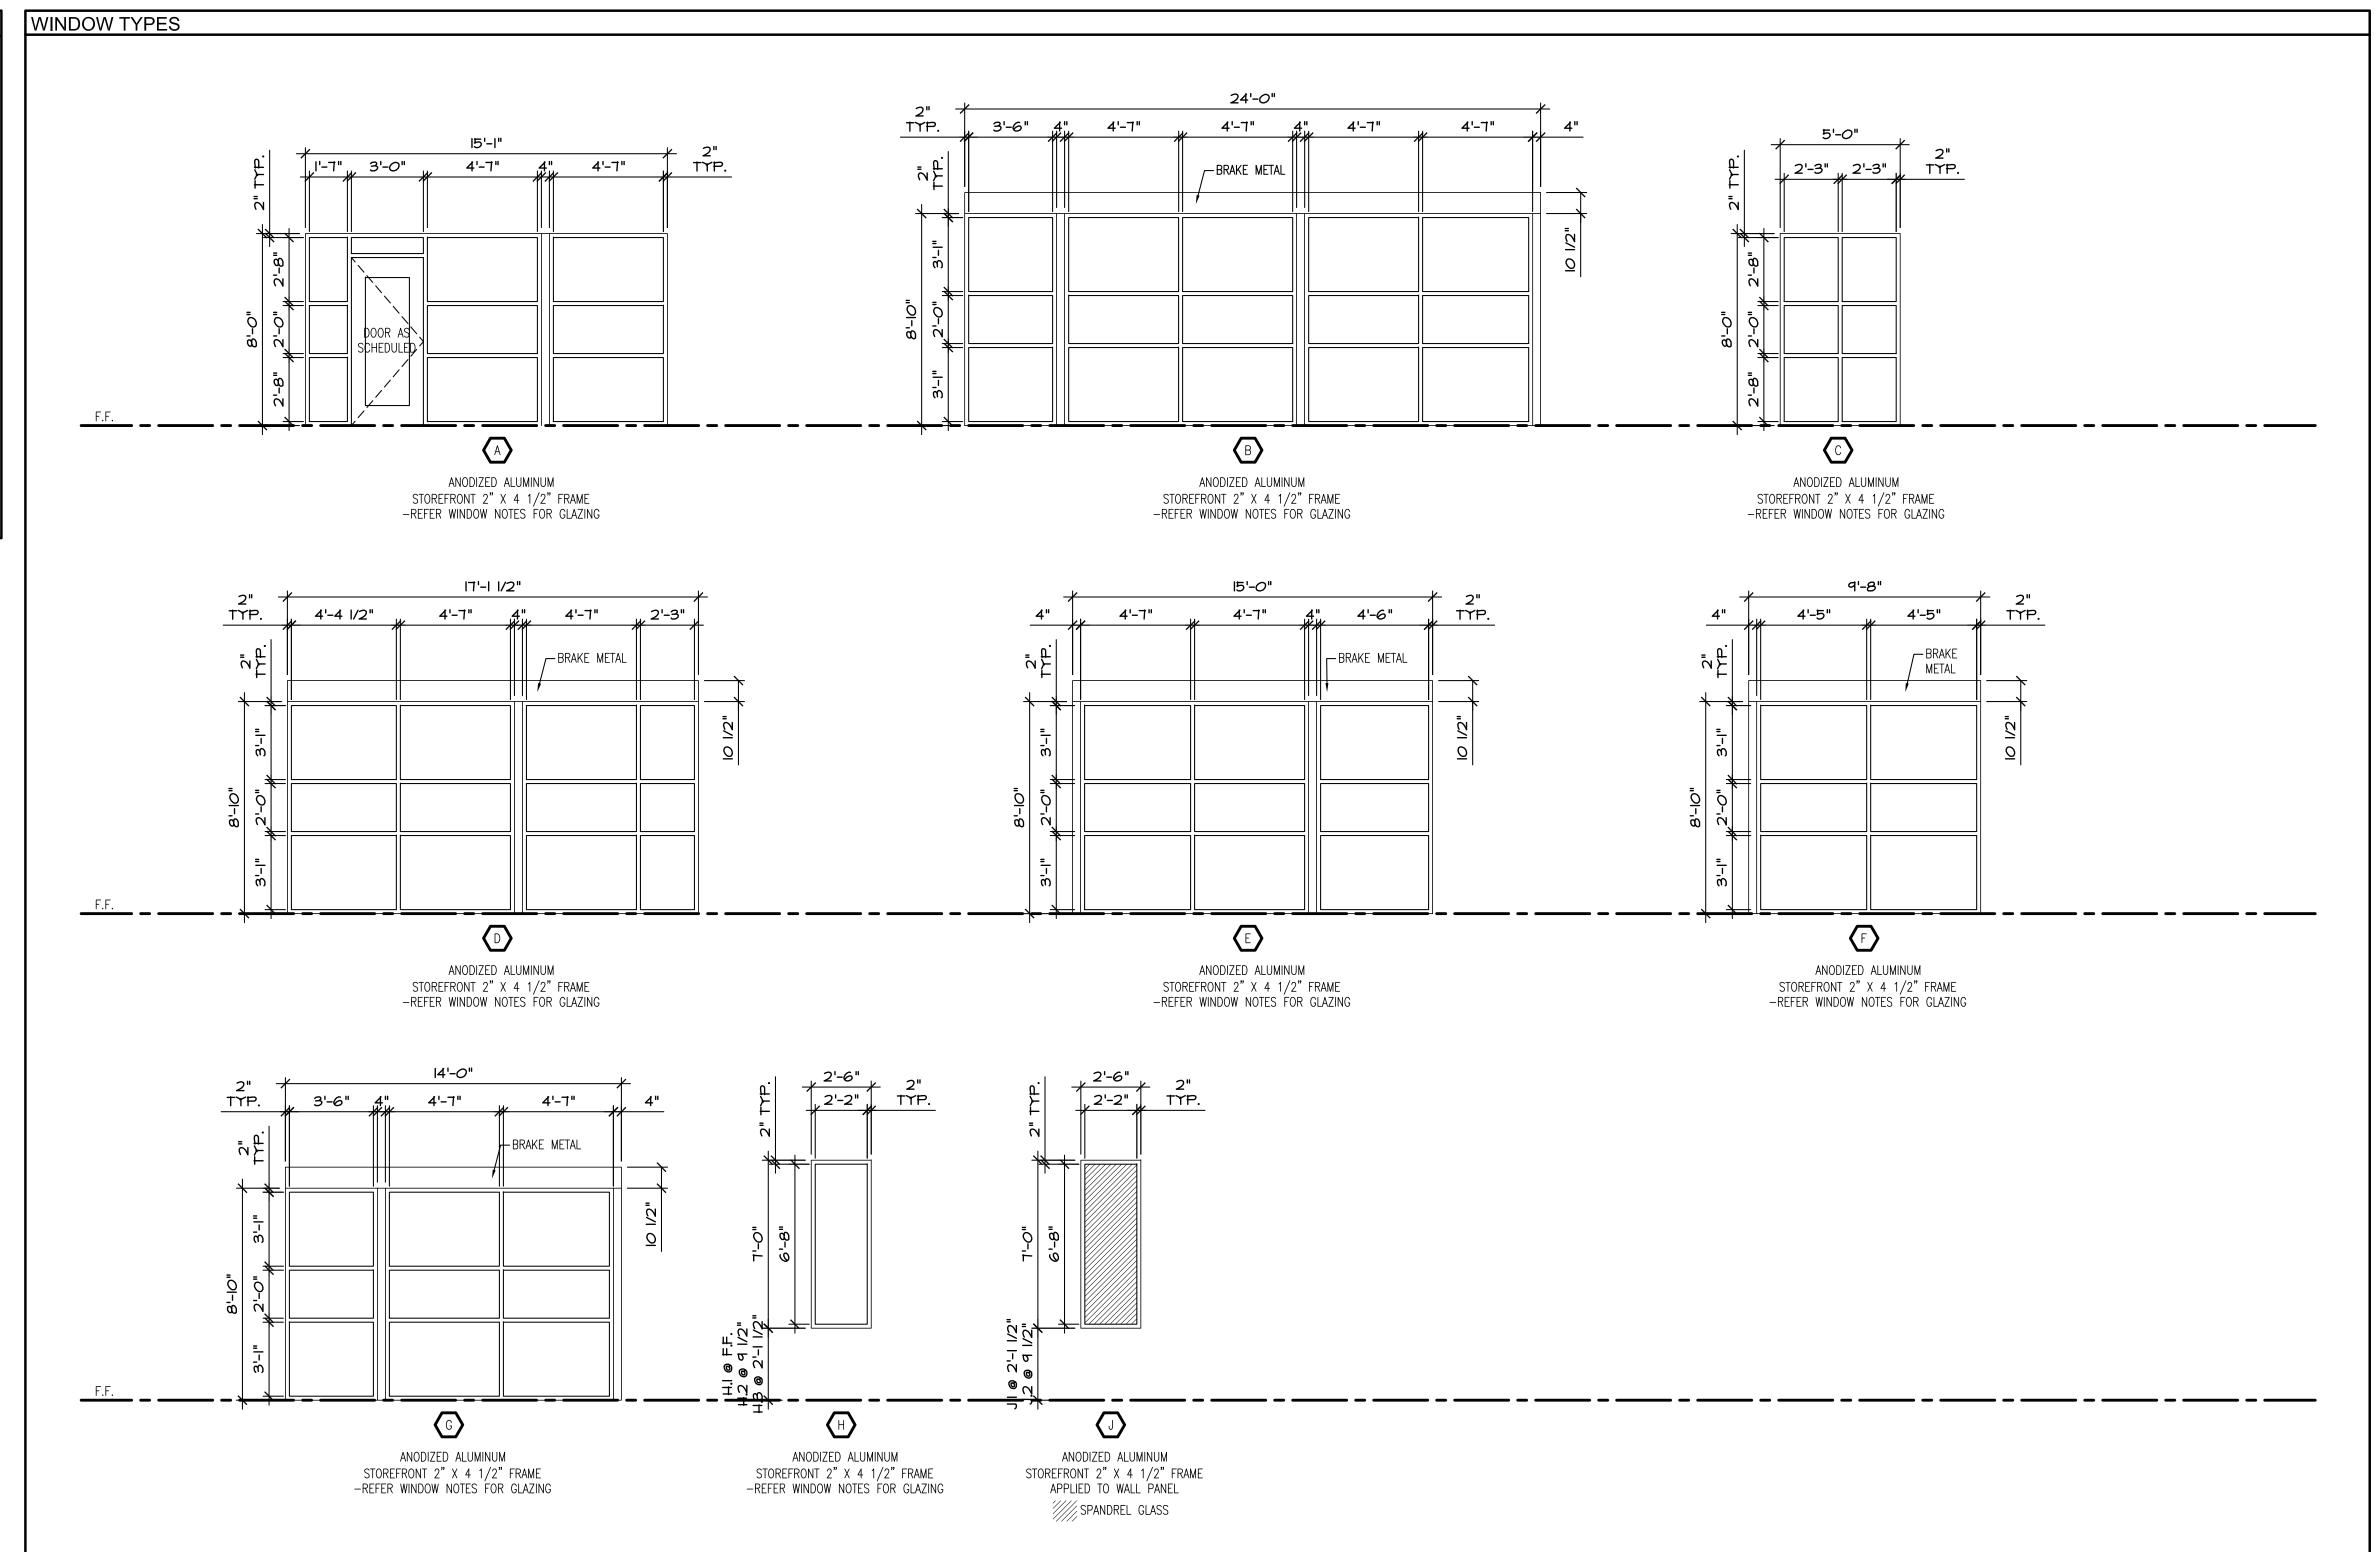

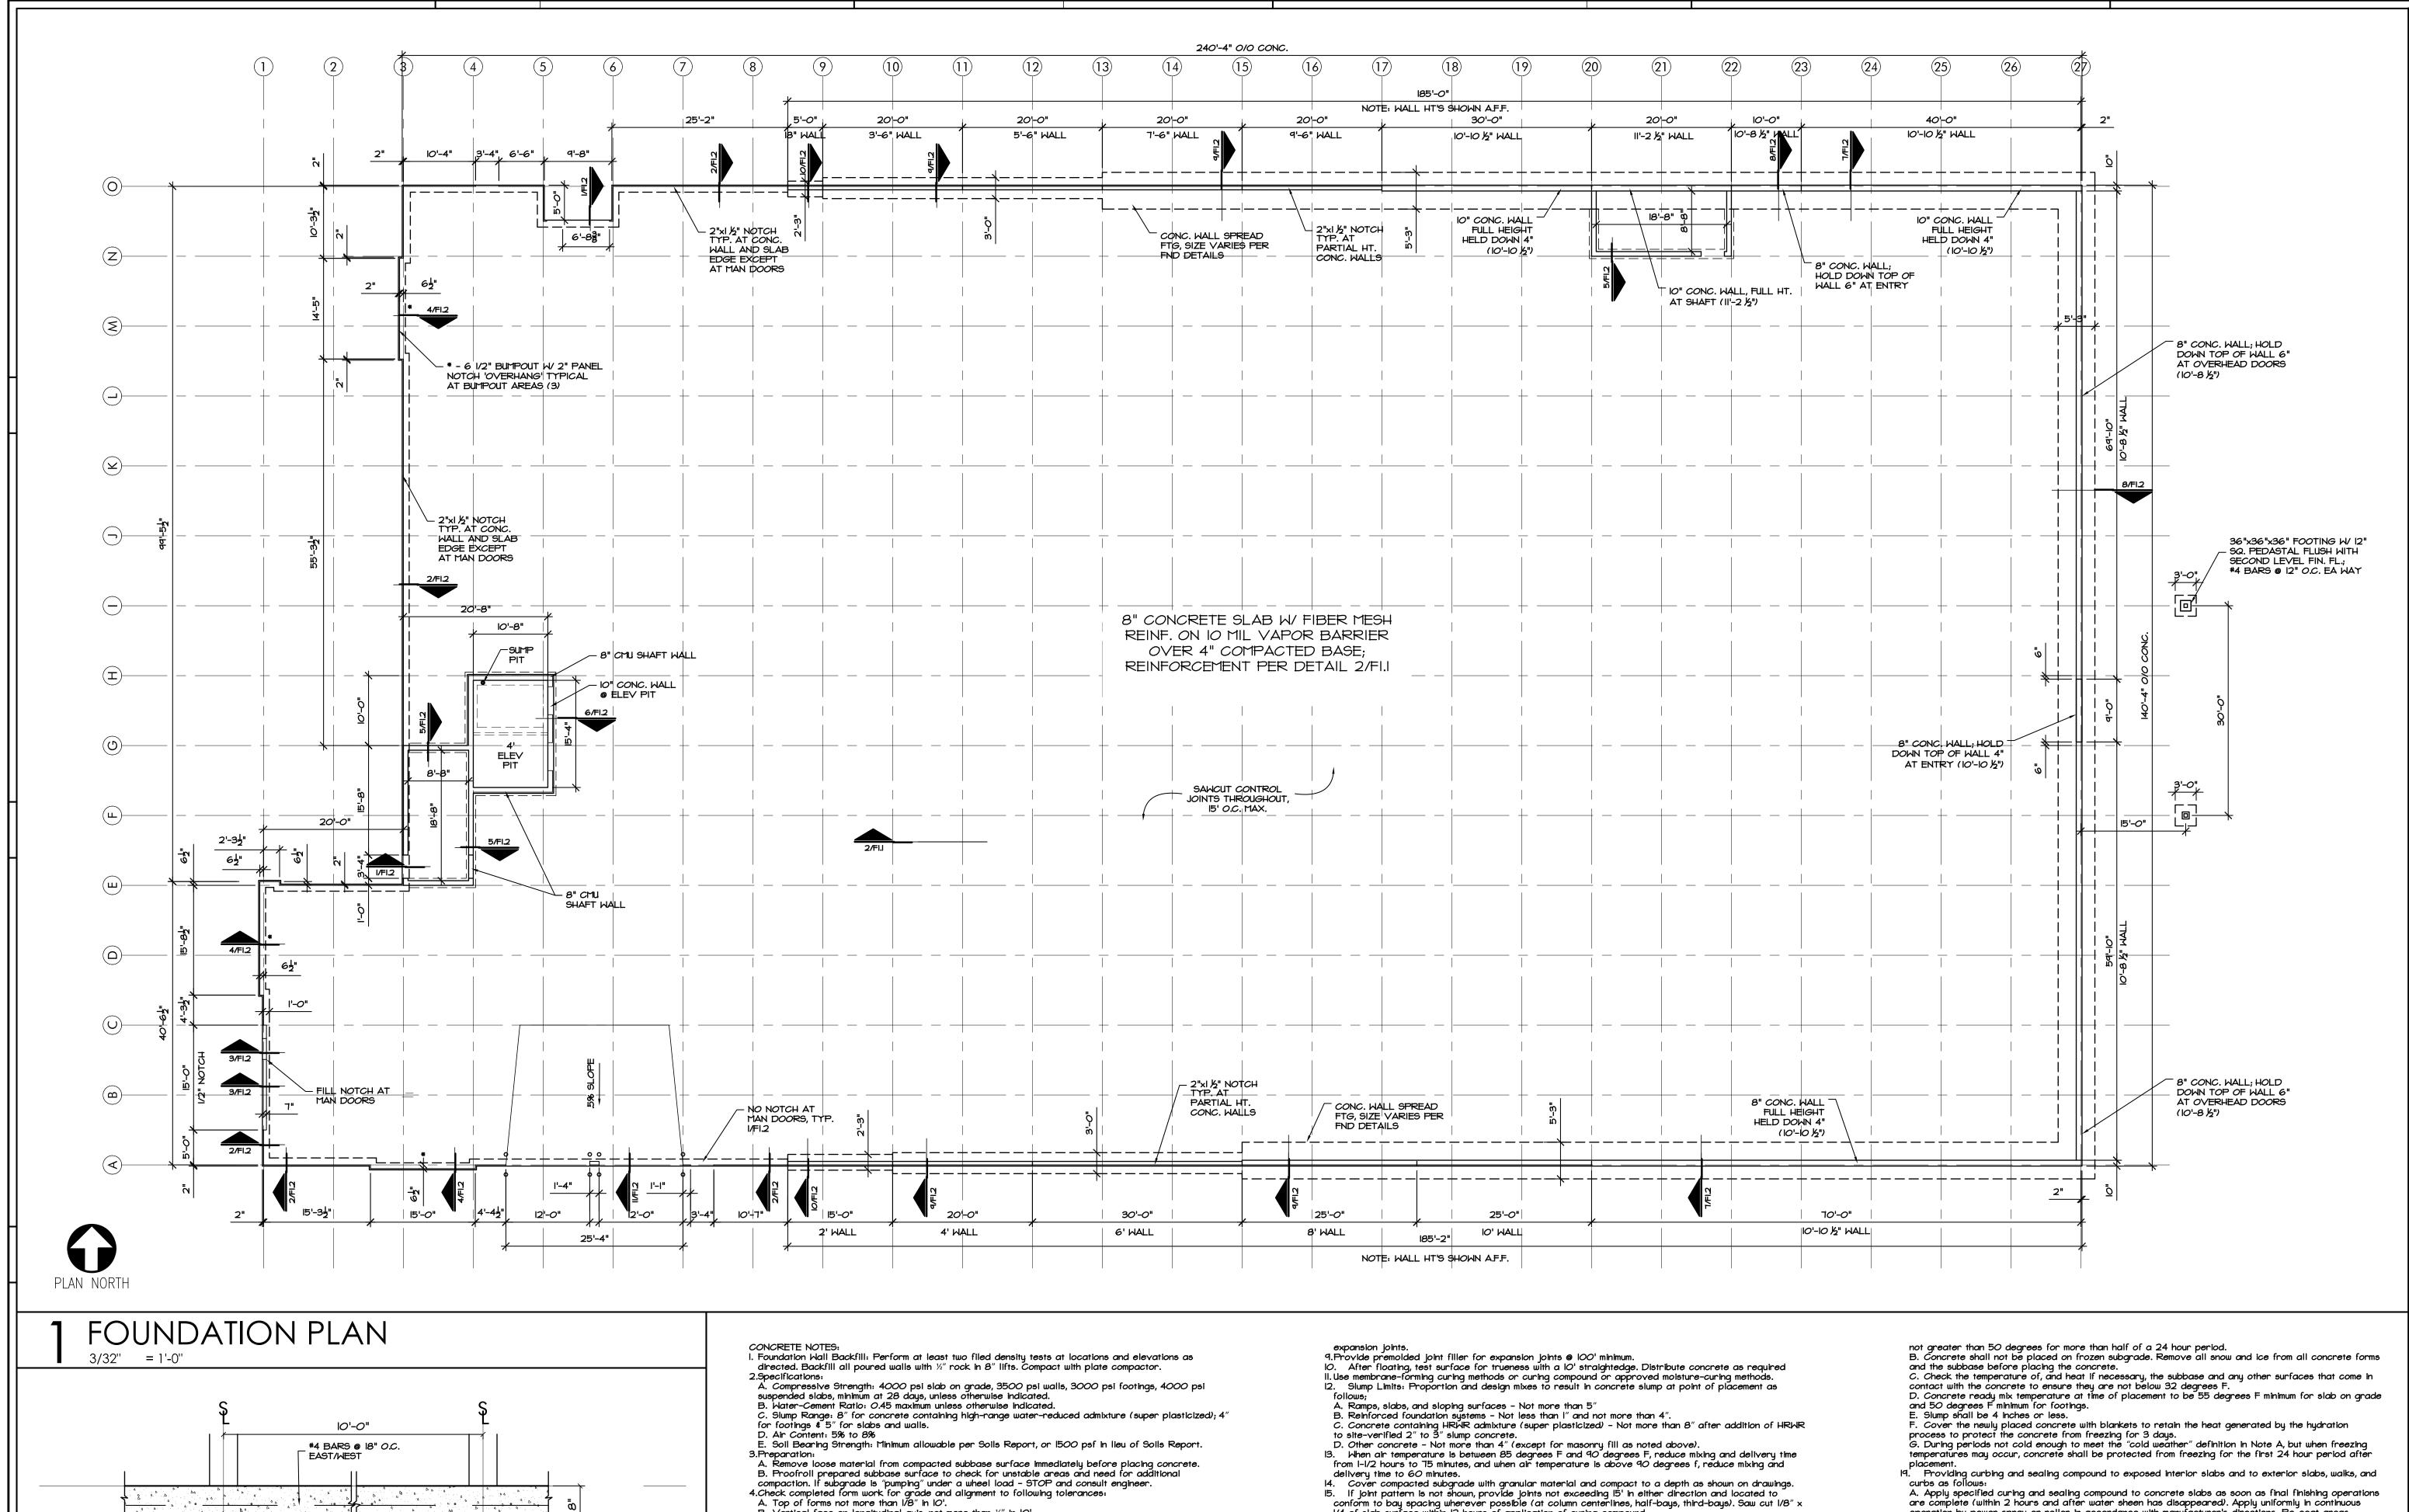

1/4 of slab surface within 12 hours of application of curing compound.

water equivalent of ice calculated to total amount of mixing water.

strength of concrete:

16. Great care should be given to pulling wire or fiber mesh up  $\frac{1}{2}$  way into poured concrete. 17. Hot Weather Placing: When hot weather conditions exist that would seriously impair quality and

B. Fog spray forms, reinforcing steel, and subgrade just before concrete is placed.

A. Cool ingredients before mixing to maintain concrete temperature at time of placement below 90 degrees F. Mixing water may be chilled, or chopped ice may be used to control temperature provided

A. Cold weather concrete procedures are to be followed when the average daily outside temperature

(average over 24 hour period) is below 40 degree for three consecutive days, and the temperature is

B. Vertical face on longitudinal axis, not more than  $\frac{1}{4}$ " in  $\frac{1}{2}$ ".

interrupted for more than 1/2 hour, place a construction joint.

FOUNDATION NOTES

6 SPACES @ 18" EA

SLAB REINFORECEMENT DETAIL

- #4 BARS SPACING NORTH/SOUTH

– 10 MIL VAPOR BARRIER

4" GRAVEL

5.Concrete Placement: Do not place concrete until subbase and forms have been checked for line and

and alignment.
6. Use bonding agent at locations where fresh concrete is placed against hardened or partially

grade. Moisten subbase if required to provide a uniform dampened condition at time concrete is placed.

7.Deposit and spread concrete in a continuous operation between transverse joints, as far as possible. If

operations are stopped for a period of more than 1/2 hour, except where such placements terminate at

8. Construction joints: Place construction joints at end of placements and at location where placement

Do not place concrete around floor drains or other structures until they are at required finish elevation

<u>8</u> 0 NE POR SUMMIT, 

### Hernly ASSOCIÁTES

1100 Rhode Island Lawrence, Kansas 785 - 749 - 5806 FAX 785 - 749 - 1515

FOUNDATION PLAN CONC NOTES

2022/11/08 Date:

operation by power spray or roller in accordance with manufacturer's directions. Re-coat areas

management and steep slope best management practices.

21. Provide special inspections in accordance with Chapter 17 of the 2018 IBC

directly to concrete.

spread footings.

22. Design Criteria 2018 IBC

subjected to heavy rainfall within 3 hours after initial application. Maintain continuity of coating and

repair damage during curing period.

a. Use membrane curing compounds that will not affect surfaces to be covered with finish materials applied

20. The General Contractor shall be responsible for reviewing the Geotechnical Report and shall follow the recommendations specified therein, including, but no limited to, subgrade preparations, ground water

23. Design values for allowable soil pressure are 2,000 psf at continuous footings and 2,500 psf at

Drawn by: SJB Checked by: **SCH** Revisions :

