4301 Indian Creek Parkway Overland Park, KS 66207 phone: 813.451.8390

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www.davidsonae.com

ENGINEERING

PHELPS ENGINEERING, INC. 1270 N. Winchester

Olathe, Kansas 66061

Fax (913) 393-1166

www.phelpsengineering.com

(913) 393-1155

<u>UTILITY NOTES:</u>
VISUAL INDICATIONS OF UTILITIES ARE AS SHOWN. UNDERGROUND LOCATIONS SHOWN, AS FURNISHED BY THEIR LESSORS, ARE APPROXIMATE AND SHOULD BE VERIFIED IN THE FIELD AT THE TIME OF CONSTRUCTION. FOR ACTUAL FIELD LOCATIONS OF UNDERGROUND UTILITIES CALL 811.

Know what's below.

Call before you dig.

 $AREA = \pm 2.5822 ACRES / \pm 112,481.21 SQ.FT.$

BUILDING & LOT DATA

Home Improvement

Parking Required:

Total Provided Parking

Building Footprint
FAR / Building Coverage

Home Improvement (4 / 1,000 S.F.)
Total Required Parking

Standard Parking Provided
Accessible Parking Spaces Provided

Parking Lot, Aisles, and Drives Area

NW1/4

Parking Lot Landscape Islands, Strips, Planting Areas 8,000 SF (17%)

NE1/4

SE1/4

STANDARD DUTY ASPHALT PAVEMENT

PROPOSED BUILDING

CONCRETE PAVEMENT

CONCRETE SIDEWALK

STATE ROUTE MO-150 HIGHWAY

VICINITY MAP

SEC. 29-47-31

LEGEND

PL PROPERTY LINE

2' CURB & GUTTER

_____ B/L ____ BUILDING SETBACK LINE

_____ P/S ____ PARKING SETBACK LINE

- - LL - LOT LINE -R/W-- RIGHT-OF-WAY 61 Spaces

1"=2000'

1. All construction materials and procedures on this project shall conform to the latest revision of the following

A) City ordinances & O.S.H.A. Regulations.

3. The contractor will be responsible for securing all permits, bonds and insurance required by the contract documents, City of Lee's Summit, Missouri, and all other governing agencies (including local, county, state and

4. The contractor is responsible for coordination of his and his sub—contractor's work. The contractor shall assume all responsibility for protecting and maintaining his work during the construction period and between the various

5. The demolition and removal(or relocation) of existing pavement, curbs, structures, utilities, and all other features necessary to construct the proposed improvements, shall be performed by the contractor. All waste material removed during construction shall be disposed off the project site. The contractor shall be responsible for all permits for hauling and disposing of waste material. The disposal of waste material shall be in accordance with

prior to the start of construction. Notify the engineer of any discrepancies.

SITE DIMENSION NOTES:

1. BUILDING TIES SHOWN ARE TO THE OUTSIDE FACE OF PROPOSED WALLS. THE SUBCONTRACTOR SHALL REFER TO HE ARCHITECTURAL PLANS FOR SPECIFIC DIMENSIONS AND LAYOUT INFORMATION FOR THE BUILDINGS.

2. ALL DIMENSIONS SHOWN FOR THE PARKING LOT AND CURBS ARE MEASURED FORM BACK OF CURB TO BACK OF

2. HANDICAP PAVEMENT MARKINGS AND SIGNS SHALL CONFORM TO ALL FEDERAL (AMERICANS WITH DISABILITIES ACT)

3. TRAFFIC CONTROL DEVICES AND PAVEMENT MARKINGS SHALL CONFORM TO THE REQUIREMENTS OF THE "MANUAL OF UNIFORM TRAFFIC CONTROL DEVICES".

4. STOP SIGNS SHALL BE PROVIDED AT ALL LOCATIONS AS SHOWN ON PLANS AND SHALL CONFORM TO THE "MANUAL OF UNIFORM TRAFFIC CONTROL DEVICES". SIGNS SHALL BE 18" X 12", 18 GAUGE STEEL AND SHALL BE ENGINEER GRADE REFLECTIVE.

ACCORDING TO THE MISSOURI DEPARTMENT OF NATURAL RESOURCES STATE OIL & GAS COUNCIL WELLS, LOCATED

THE CONTRACTOR SHALL CONTACT THE CITY'S DEVELOPMENT SERVICES ENGINEERING INSPECTION TO SCHEDULE A PRE-CONSTRUCTION MEETING WITH A FIELD ENGINEERING INSPECTOR PRIOR TO ANY LAND DISTURBANCE WORK AT

FIRE ACCESS ROAD NOTE:

ALL FIRE ACCESS LANES SHALL BE HEAVY DUTY ASPHALT CAPABLE OF SUPPORTING 75,000-POUNDS.



LEGAL DESCRIPTION:

LOT 2, MARKET STREET CENTER, A SUBDIVISION OF LAND IN THE CITY OF LEE'S SUMMIT, JACKSON COUNTY, MISSOURI.

SITE PLAN NOTES:

governing requirements, incorporated herein by reference:

B) The City of Lee's Summit Technical Specifications and Municipal Code.

2. The contractor shall have one (1) signed copy of the plans (approved by the City) and one (1) copy of the appropriate Design and Construction Standards and Specifications at the job site at all times.

federal authorities) having jurisdiction over the work proposed by these construction documents. The cost for all permits, bonds and insurance shall be the contractors responsibility and shall be included in the bid for the work.

trades/sub-contractors constructing the work.

all local, state and federal regulations.

6. Contractor shall be responsible for all relocations, including but not limited to, all utilities, storm drainage, sanitary sewer services, signs, traffic signals & poles, etc. as required. All work shall be in accordance with governing authorities specifications and shall be approved by such. All cost shall be included in base bid.

7. All existing utilities indicated on the drawings are according to the best information available to the Engineer; however, all utilities actually existing may not be shown. The contractor shall be responsible for contacting all utility companies for an exact field location of each utility prior to any construction. All underground utilities shall be protected at the contractor's expense. All utilities, shown and unshown, damaged through the negligence of the contractor shall be repaired or replaced by the contractor at his expense.

8. The contractor will be responsible for all damage to existing utilities, pavement, fences, structures and other features not designated for removal. The contractor shall repair all damages at his expense.

9. The contractor shall verify the flow lines of all existing storm or sanitary sewer connections and utility crossings

10. <u>SAFETY NOTICE TO CONTRACTOR:</u> In accordance with generally accepted construction practices, the contractor shall be solely and completely responsible for conditions of the job site, including safety of all persons and property during performance of the work. This requirement will apply continuously and not be limited to normal working hours. Any construction observation by the engineer of the contractor's performance is not intended to include review of the adequacy of the contractor's safety measures, in, on or near the construction site.

11. Refer to the building plans for site lighting electrical requirements, including conduits, pole bases, pull boxes, etc.

PAVEMENT MARKING AND SIGNAGE NOTES:

1. PARKING STALL MARKING STRIPES SHALL BE FOUR INCH (4") WIDE WHITE STRIPES. DIRECTIONAL ARROW AND HANDICAP STALL MARKINGS SHALL BE FURNISHED AT LOCATIONS SHOWN ON PLANS.

AND STATE LAWS AND REGULATIONS.

5. TRAFFIC CONTROL AND PAVEMENT MARKINGS SHALL BE PAINTED WITH A WHITE SHERWIN WILLIAMS S-W TRAFFIC MARKING SERIES B-29Y2 OR APPROVED EQUAL. THE PAVEMENT MARKING SHALL BE APPLIED IN ACCORDANCE WITH MANUFACTURERS RECOMMENDATIONS. APPLY ON A CLEAN, DRY SURFACE AND AT A SURFACE TEMPERATURE OF NOT LESS THAN 70°F AND THE AMBIENT AIR TEMPERATURE SHALL NOT BE LESS THAN 60°F AND RISING. TWO COATS SHALL BE APPLIED.


ZONING:

THIS PROPERTY IS ZONED CP-2, DEFINED AS PLANNED COMMUNITY COMMERCIAL DISTRICT.

OIL-GAS WELLS:

AT www.dnr.mo.gov/geology/geosrv/oilandgas.htm, THERE ARE NO OIL OR GAS WELLS ON THE PROPERTY SHOWN

PRE-CONSTRUCTION MEETING NOTE:

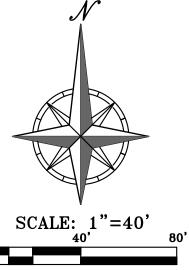

SITE PLAN sheet number

dete

drawn by

revisions

09-13-22


COMMENTS

REVISED PER PLANNING

checked by

drawing type PDP


project number

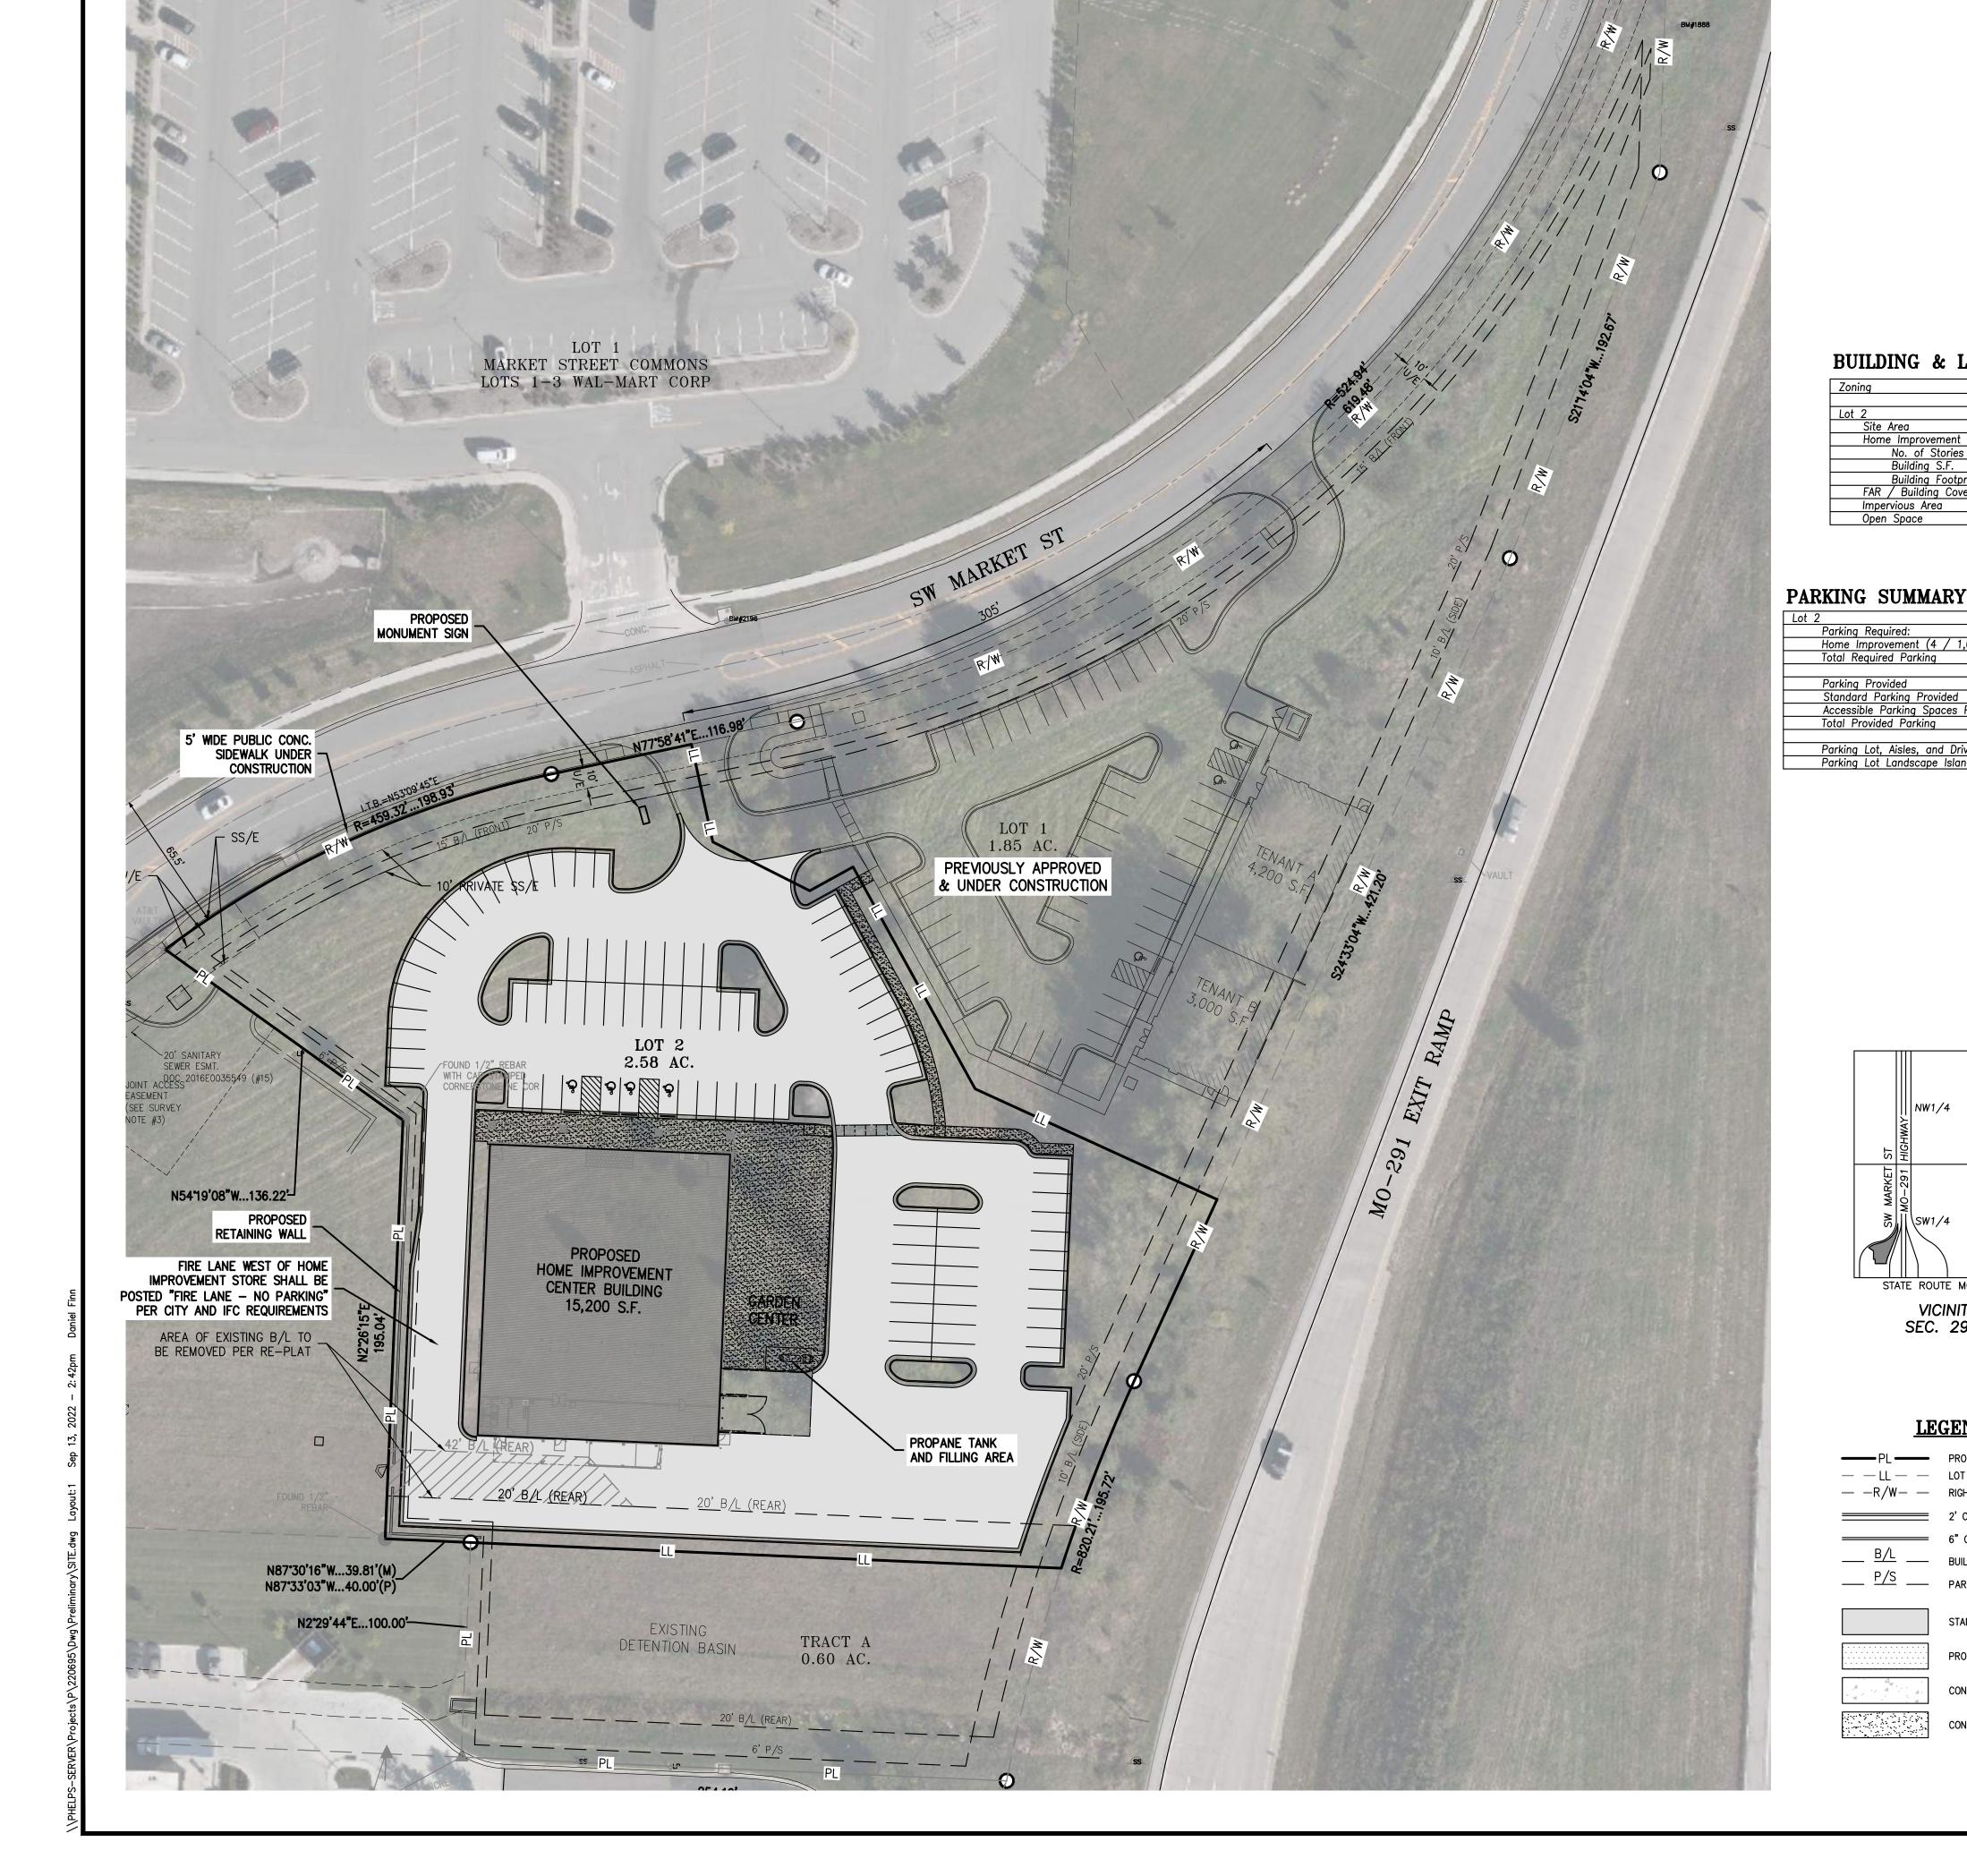


LOT 2 MARKET STREET COMMONS

LOTS 1-3

WAL-MART CORP

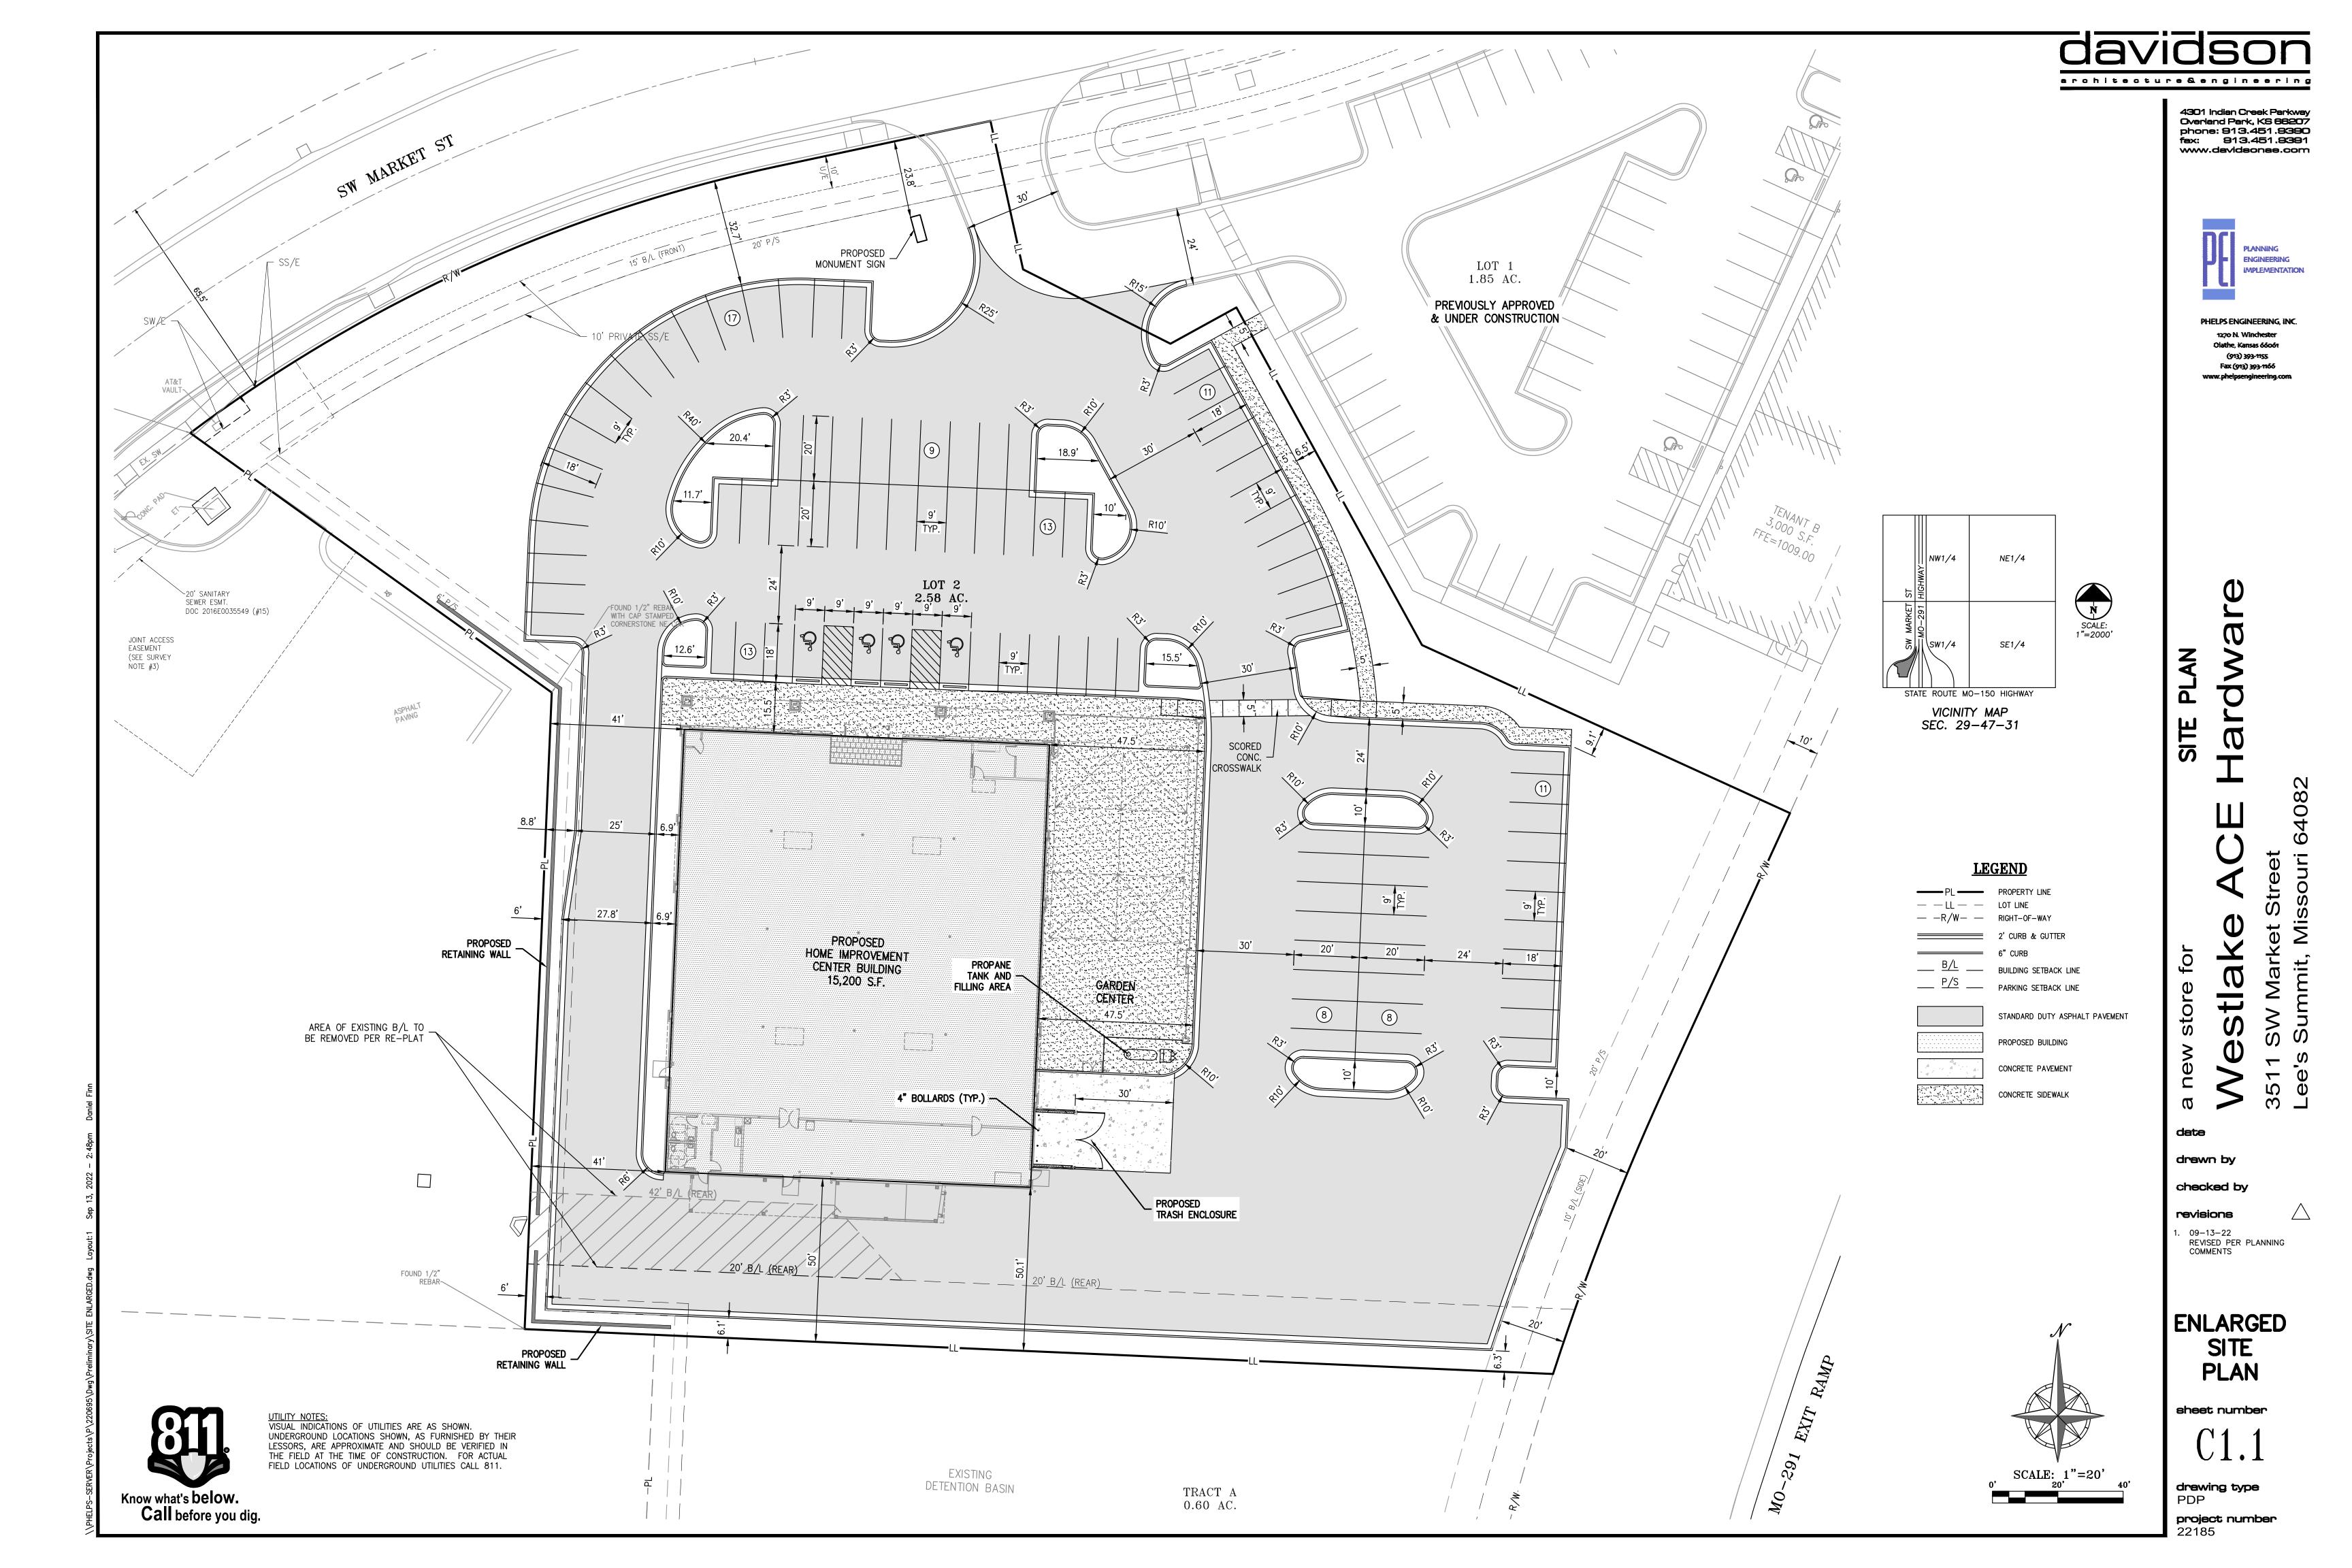

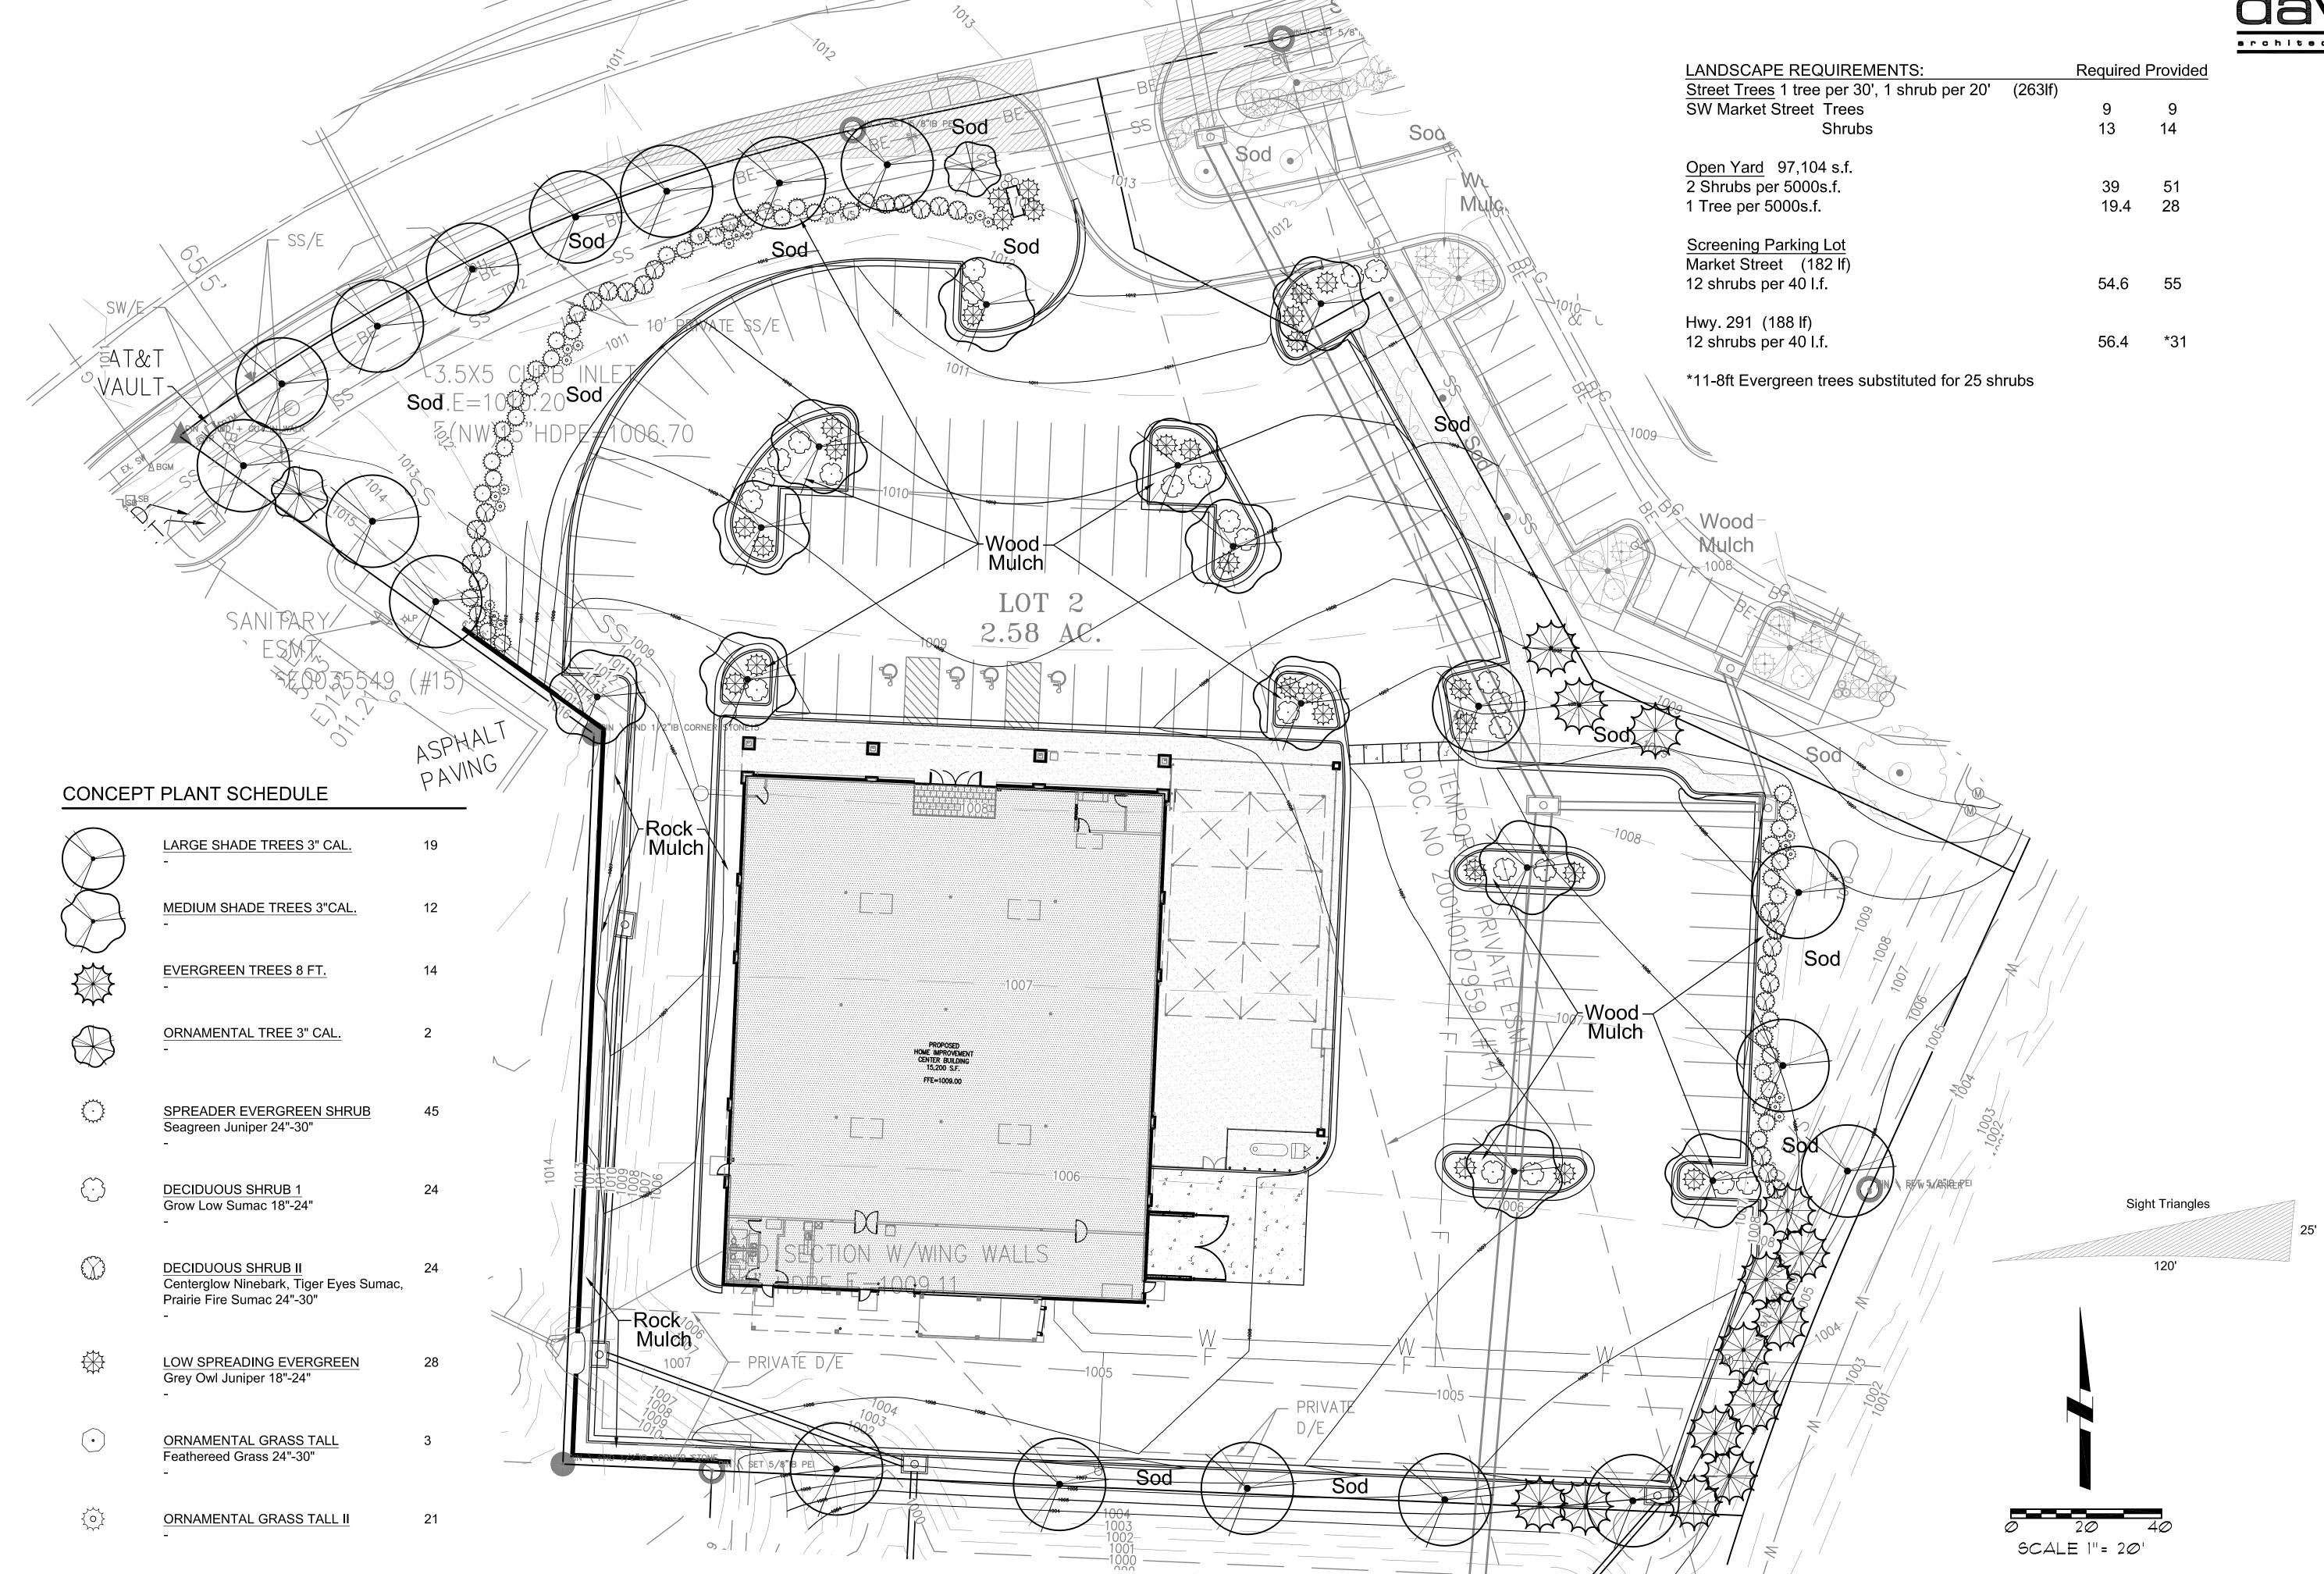

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09/08/2022

checked by

revisions

sheet number

Oppermann LandDesign, LLC

Land Planning 🍁 Landscape Architecture

22 Debra Lane peteoppermann56@gmail.com New Windsor, New York 12553 913.522.5598

drawing type
Preliminary Development
Landscape Plan
project number

Utilities shown on plan are diagramatic and some may be missing. Before starting any construction call appropriate locating service. In Missouri call 1-800-DIG-RITE (344-7483) to have utilities located.


EIFS2 2" drainable EIFS system, faux wood grain planks, fine finish, base color: SW6076 Turkish Coffee, with SW6258 Tricorn Black for wood grain accent. Planks are 7 1/2" wide x 8' long, raised 2", with 3 1/2" spacing between EIFS3 2" drainable EIFS system, Dryvit fine finish, color: light gray

exterior hollow metal doors, frames, trash enclosure gates:
pt1 Pro Industrial High Performance Epoxy, semi-gloss, (1 coat primer, 2 coats paint to cover), color: gray to match building

galvanized, with polyethylene covers on all customer facing bollards. Reliance, color: Foundary

Gray with red reflective stripes steel framed canopy with standing seam roofing, paint steel to match building

6' high fence by Ameristar, Montage Plus Classic Style, with 2 1/2" sq. vertical posts spaced 8' o.c. typical, set in 36" deep conc. footings per manufacturer's instructions. Intermediate pickets are 3/4" sq. spaced approx. 4" o.c. and horizontal rails are 1 1/2", Black finish.

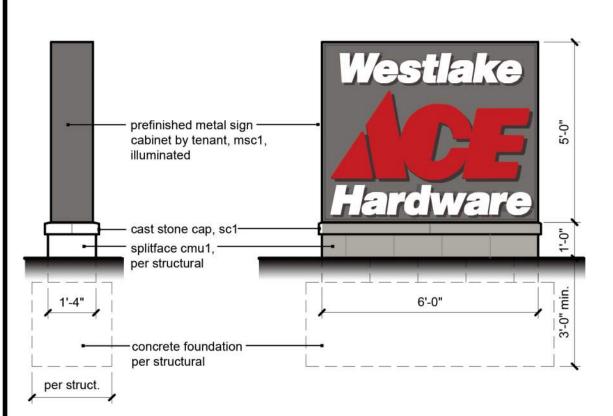

5 monument sign elevation scale: 1/2" = 1'-0"

proposed signage:

North elevation (main facade): Facade area: 2,527 s.f.

Total sign area: 222 s.f. "Westlake ACE Hardware", surface mounted letters, illuminated by

surface mounted lighting, 6' "A" max. height, 134 s.f. area Sign 2

"STIHL", surface mounted letters, illuminated by surface mounted lighting, 44 s.f. area

"Benjamin Moore" surface mounted letters, illuminated by surface mounted lighting, 44 s.f. area

Facade area:

East elevation:

3,018 s.f. Total sign area: 116 s.f.

"ACE" internally lit, channel letters, 4' high, 37 s.f. area "Benjamin Moore" internally lit, channel letters, 2' high, 46 s.f. area "Stihl" internally lit, channel letters, 3' high, 33 s.f. area

South elevation: Facade area: 2,333 s.f.


Total sign area: 58 s.f.


Sign 7 "ACE" internally lit, channel letters, 5' high, 58 s.f.


Westlake is asking for signage variance to allow 4 additional building signs. All signage on elevations are below 10% of facade area.





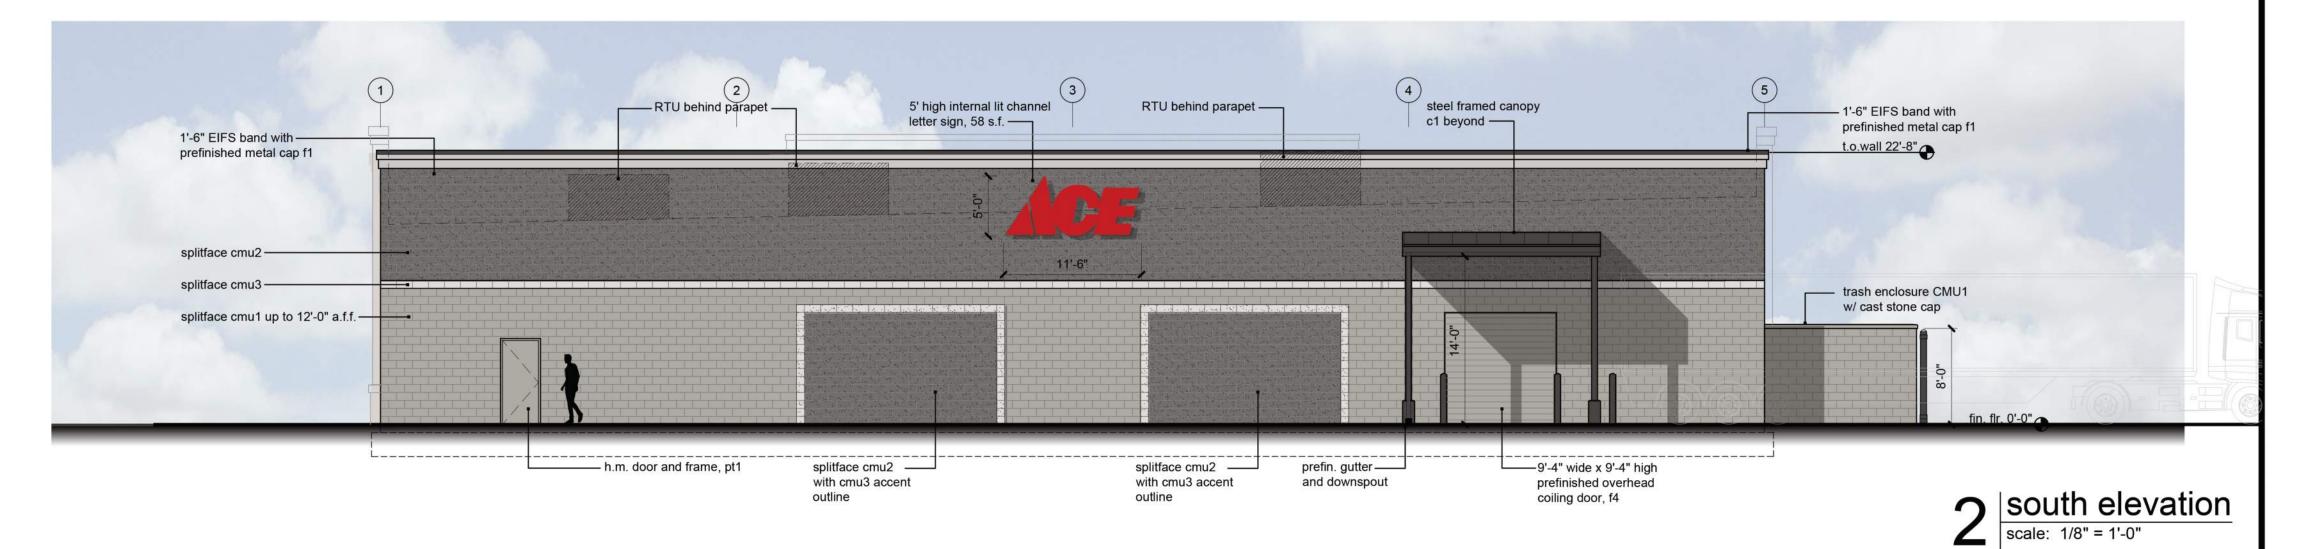

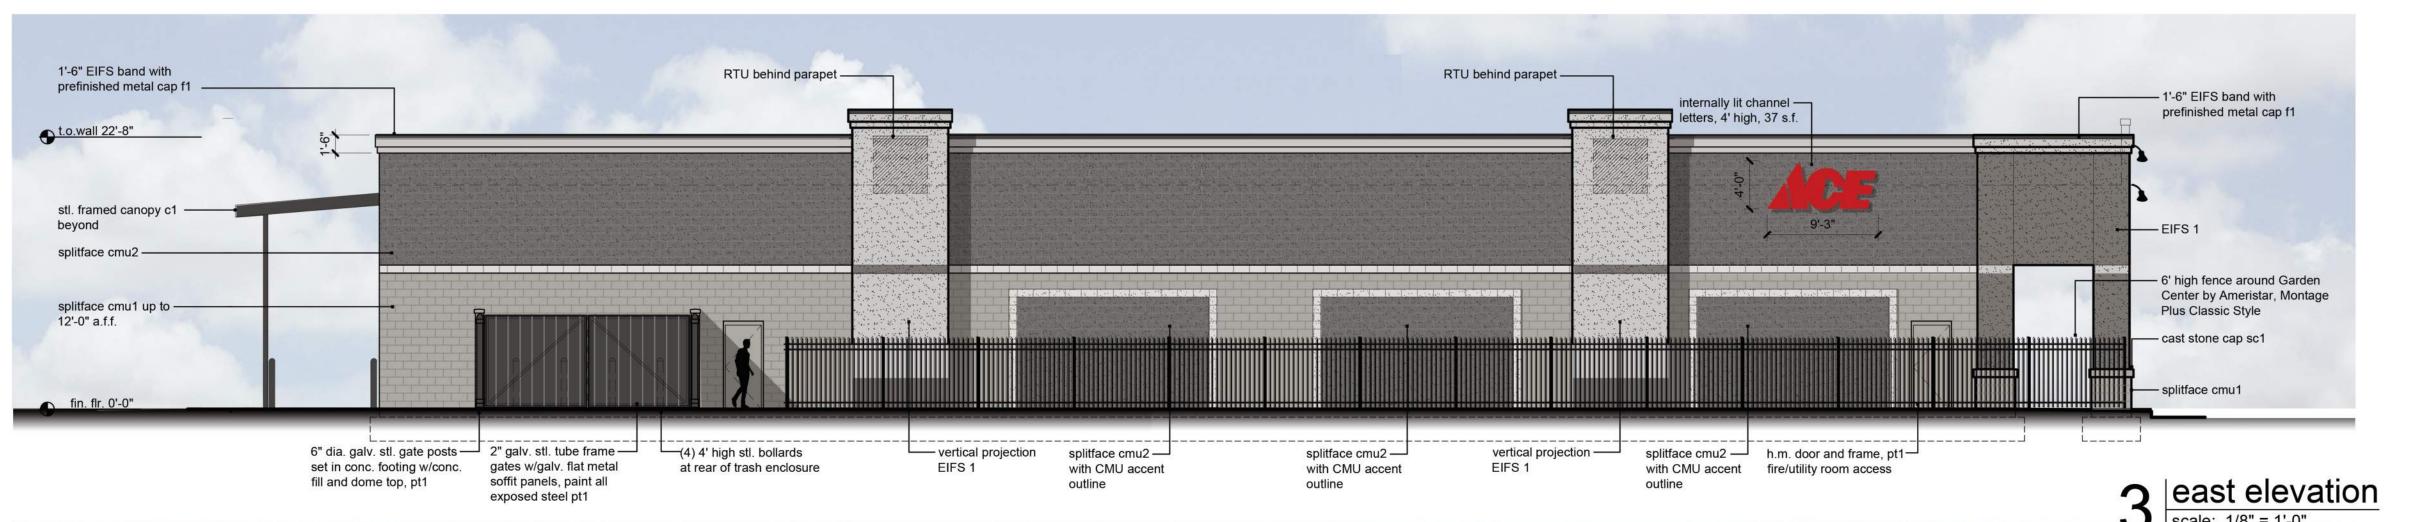

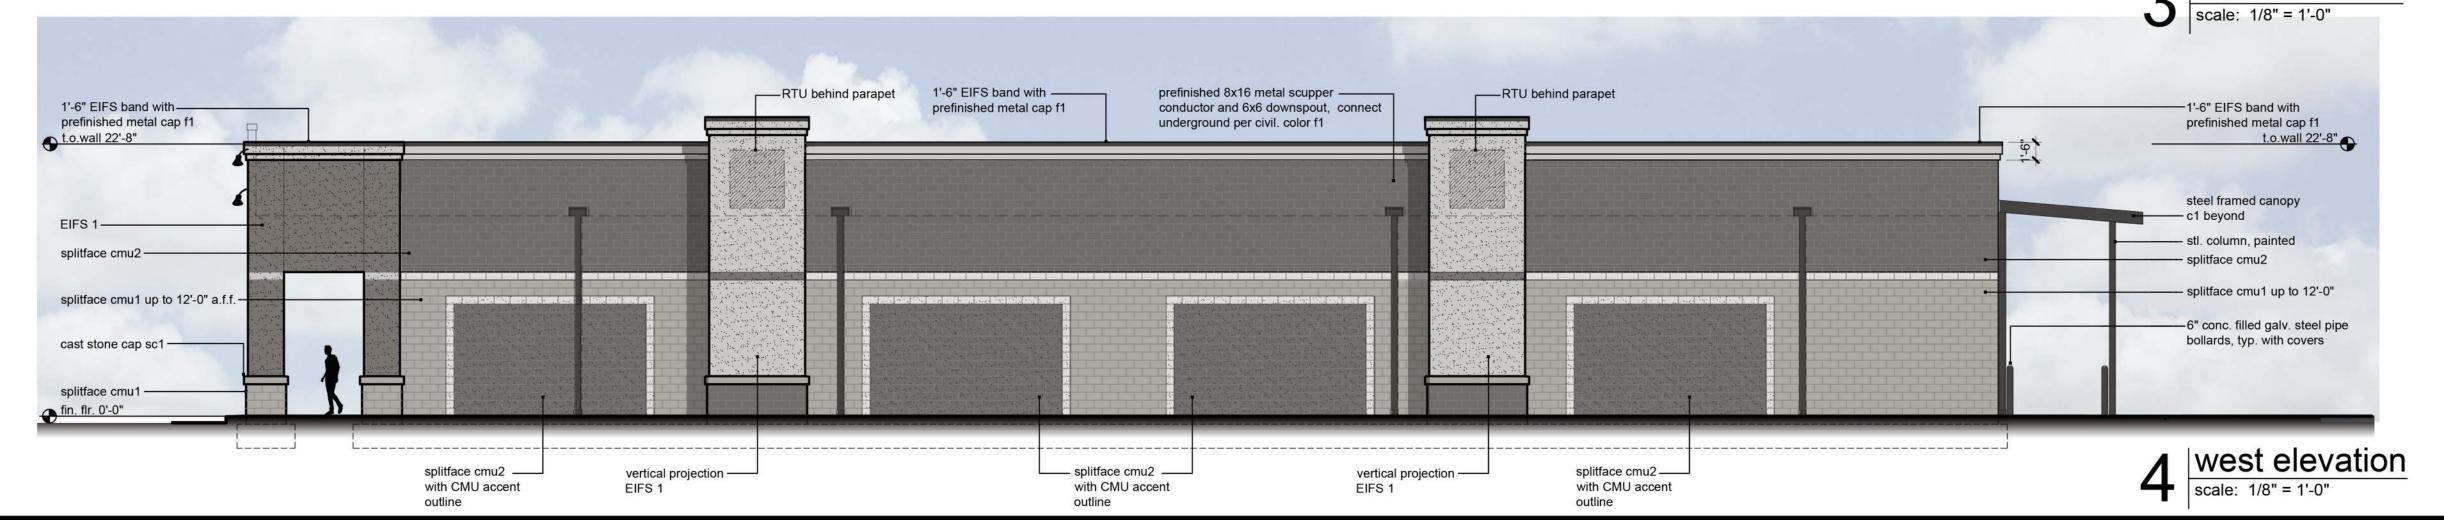

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date 08.12.2022 drawn by DAE checked by DAE

revisions

09.12.2022

PDP

sheet number

drawing type

PDP project number 22185