LEE'S SUMMIT FIRE STATION NO. 4 5031 NORTHEAST LAKEWOOD WAY LEE'S SUMMIT, MISSOURI 64064

FINAL DEVELOPMENT PLAN

CONSULTANT:



KANSAS CITY, MISSOURI 64114 derick.holmes@glmv.com

PARCEL INFORMATION:

ADDRESS: 5031 NORTHEAST LAKEWOOD WAY LEE'S SUMMIT, MO 64064

LEGAL DESCRIPTION ALL OF LOT 6-A, EXECUTIVE LAKES

CENTER LOTS 6-A AND 8-B, A SUBDIVISION IN THE SE 1/4 OF SECTION 5- T 48 N - R 31 W, LEE'S SUMMIT, JACKSON COUNTY, MISSOURI

FEMA FLOODPLAIN THE SUBJECT PROPERTY IS LOCATED IN

ZONE X, AREAS DETERMINED TO BE **OUTSIDE THE 0.2% ANNUAL CHANCE** FLOODPLAIN, AS SHOWN ON FLOOD INSURANCE RATE MAP (FIRM) 29095C0313G, EFFECTIVE JANUARY 20, 2017.

OIL AND GAS WELLS NO EVIDENCE OF OIL OR GAS WELLS WERE


FOUND ON LOT 6-A AND THE PORTION OF LOT 7 PROPOSED TO BE REPLATTED AS EVIDENCED BY THE FOLLOWING SOURCES 1. ATLAS/NSPS LAND SURVEY PERFORMED BY J&J SURVEYING LLC, DATED **DECEMBER 7, 2021.** 2. MISSOURI SPATIAL DATA INFORMATION SERVICE (FEBRUARY 20, 2022), MO 2018 STATE PERMITTED OIL AND GAS WELLS.

RETRIEVED FROM HTTP://DATA-MSDIS.OPENDATA.ARCGIS.COM/DATASETS


CP-2, PLANNED COMMUNITY COMMERCIAL ZONING

LAND USE SCHEDULE				
TOTAL FLOOR AREA	12,189 SF			
NUMBER OF DWELLING UNITS	8			
LAND AREA	1.17 ACRES			
REQUIRED PARKING	DIRECTED BY FIRE CHIEF			
PROPOSED PARKING	15 SPACES			
IMPERVIOUS COVERAGE	32,464 SF (.75 ACRES)			
FLOOR AREA RATIO (FAR)	0.24			
PERMITTED LAND USE	FIRE STATION - MUNICIPAL = CONDITIONAL			
DWELLING UNITS PER ACRE WITH COMMON AREA	6.84			
DWELLING UNITS PER ACRE WITHOUT COMMON AREA	6.84			


VICINITY MAP

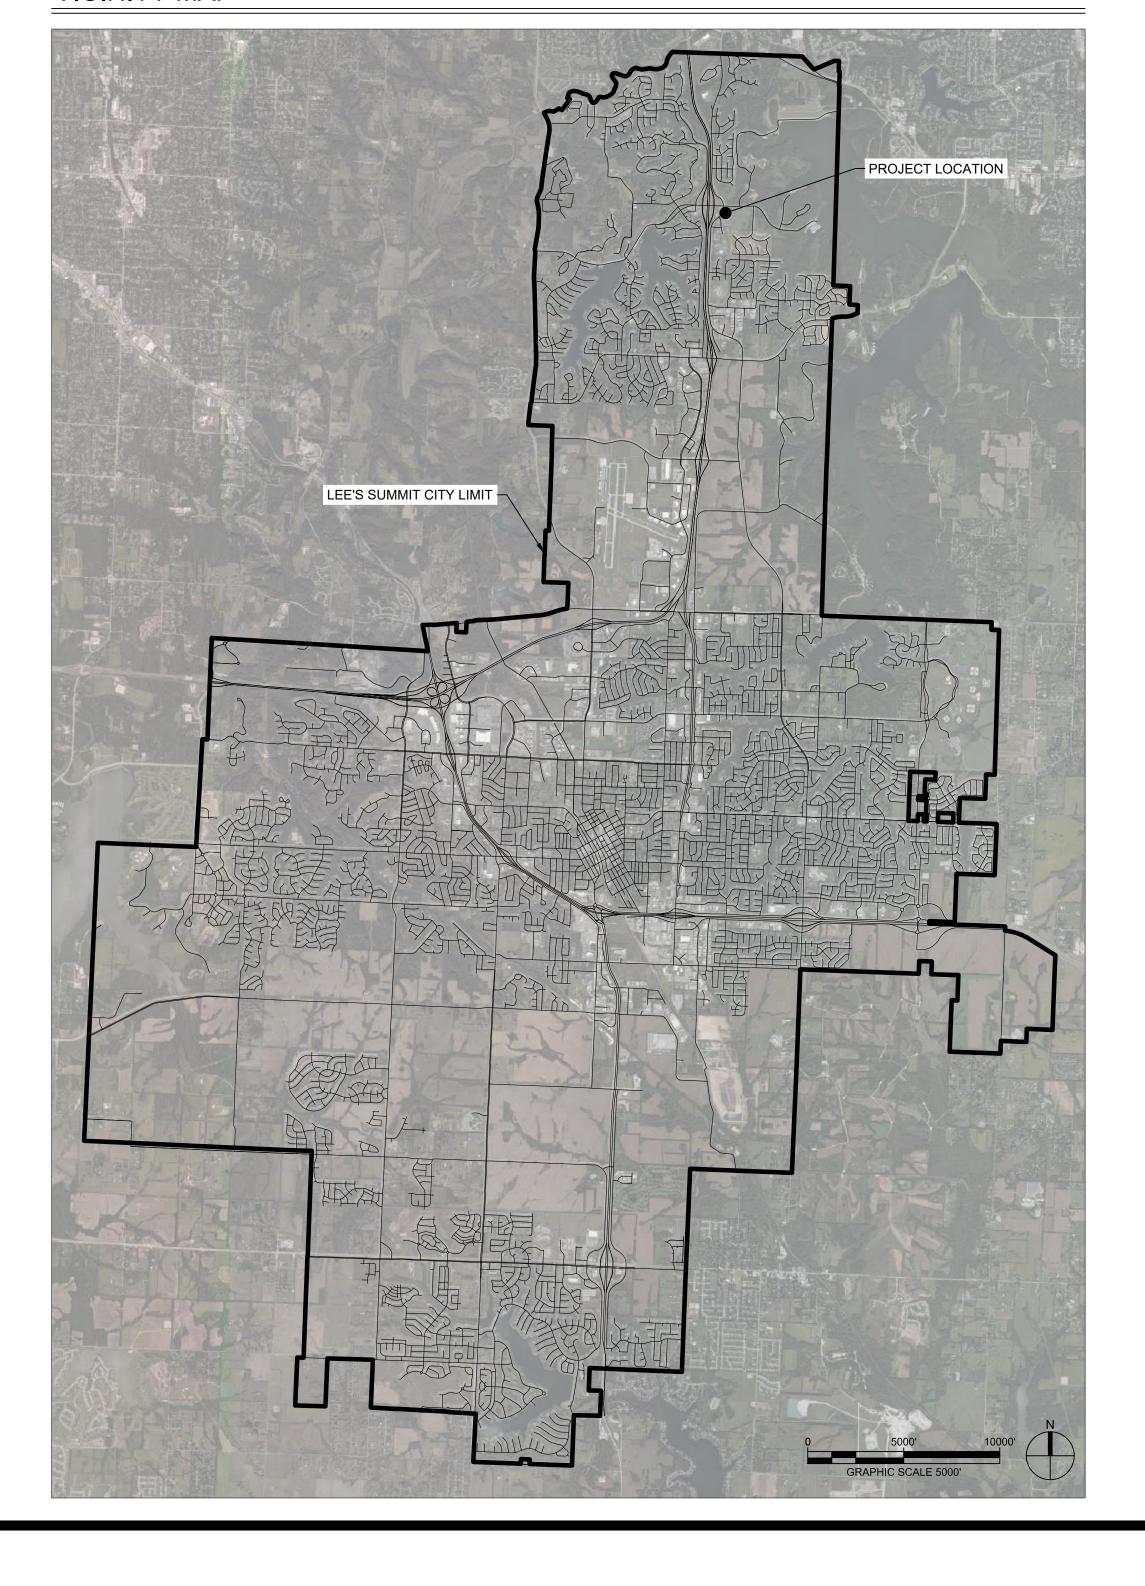


SITE LOCATION MAP

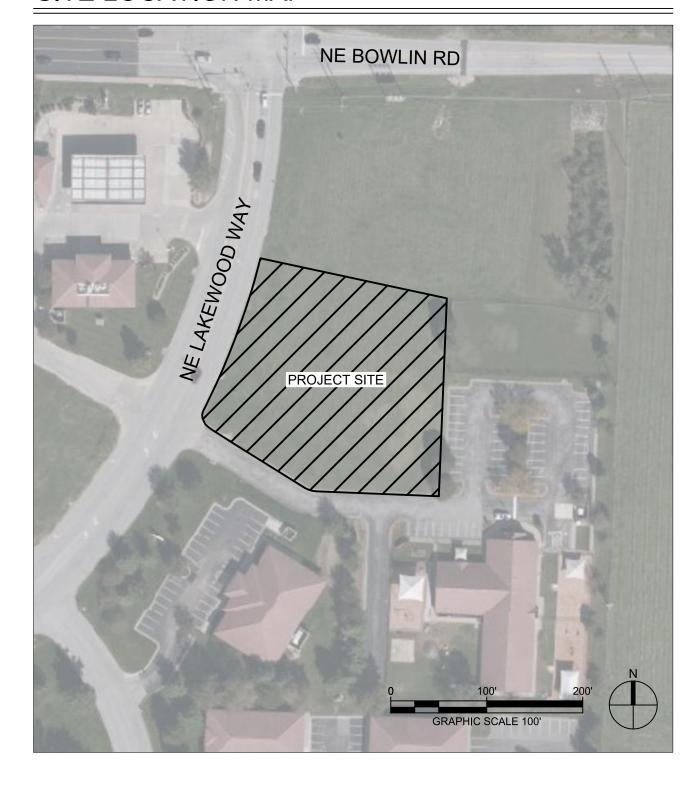


SHEET NO.	SHEET NAME			
C-001	COVER SHEET			
GS001	ALTA/NSPS LAND TITLE SURVEY			
A-101	FIRST FLOOR PLAN			
A-102	SECOND FLOOR PLAN			
A-201	BUILDING ELEVATIONS			
A-202	BUILDING ELEVATIONS			
C-100	SITE PLAN			
C-101	LAYOUT PLAN			
C-102	DEMOLITION PLAN			
C-103	EROSION CONTROL PLAN			
C-104	GRADING & DRAINAGE PLAN			
C-105	UTILITY PLAN			
C-220	PUBLIC WATER PLAN & PROFILES			
C-230	PUBLIC STORMWATER PROFILES			
C-231	PRIVATE STORMWATER PROFILES			
C-240	PUBLIC SANITARY SEWER PLAN & PROFILES			
C-400	GRADING ENLARGEMENTS			
C-500	SITE DETAILS			
C-501	SITE DETAILS			
C-502	SITE DETAILS			
C-503	SITE DETAILS			
C-510	EROSION CONTROL DETAILS			
C-511	EROSION CONTROL DETAILS			
C-520	WATER DETAILS			
C-521	WATER DETAILS			
C-530	STORMWATER DETAILS			
C-531	STORMWATER DETAILS			
C-532	STORMWATER DETAILS			
C-540	SANITARY SEWER DETAILS			
ME001	MPE SITE PLAN			
ME002	SITE LIGHTING PHOTOMETRIC PLAN			
L-100	LANDSCAPE SCHEDULE			
L-101	LANDSCAPE PLAN			

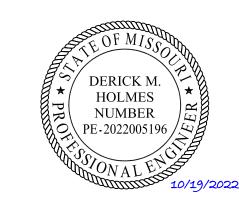

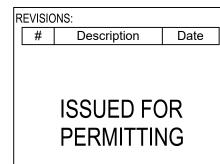

PROJECT NO: 18225R2100 10.19.2022 **COVER**

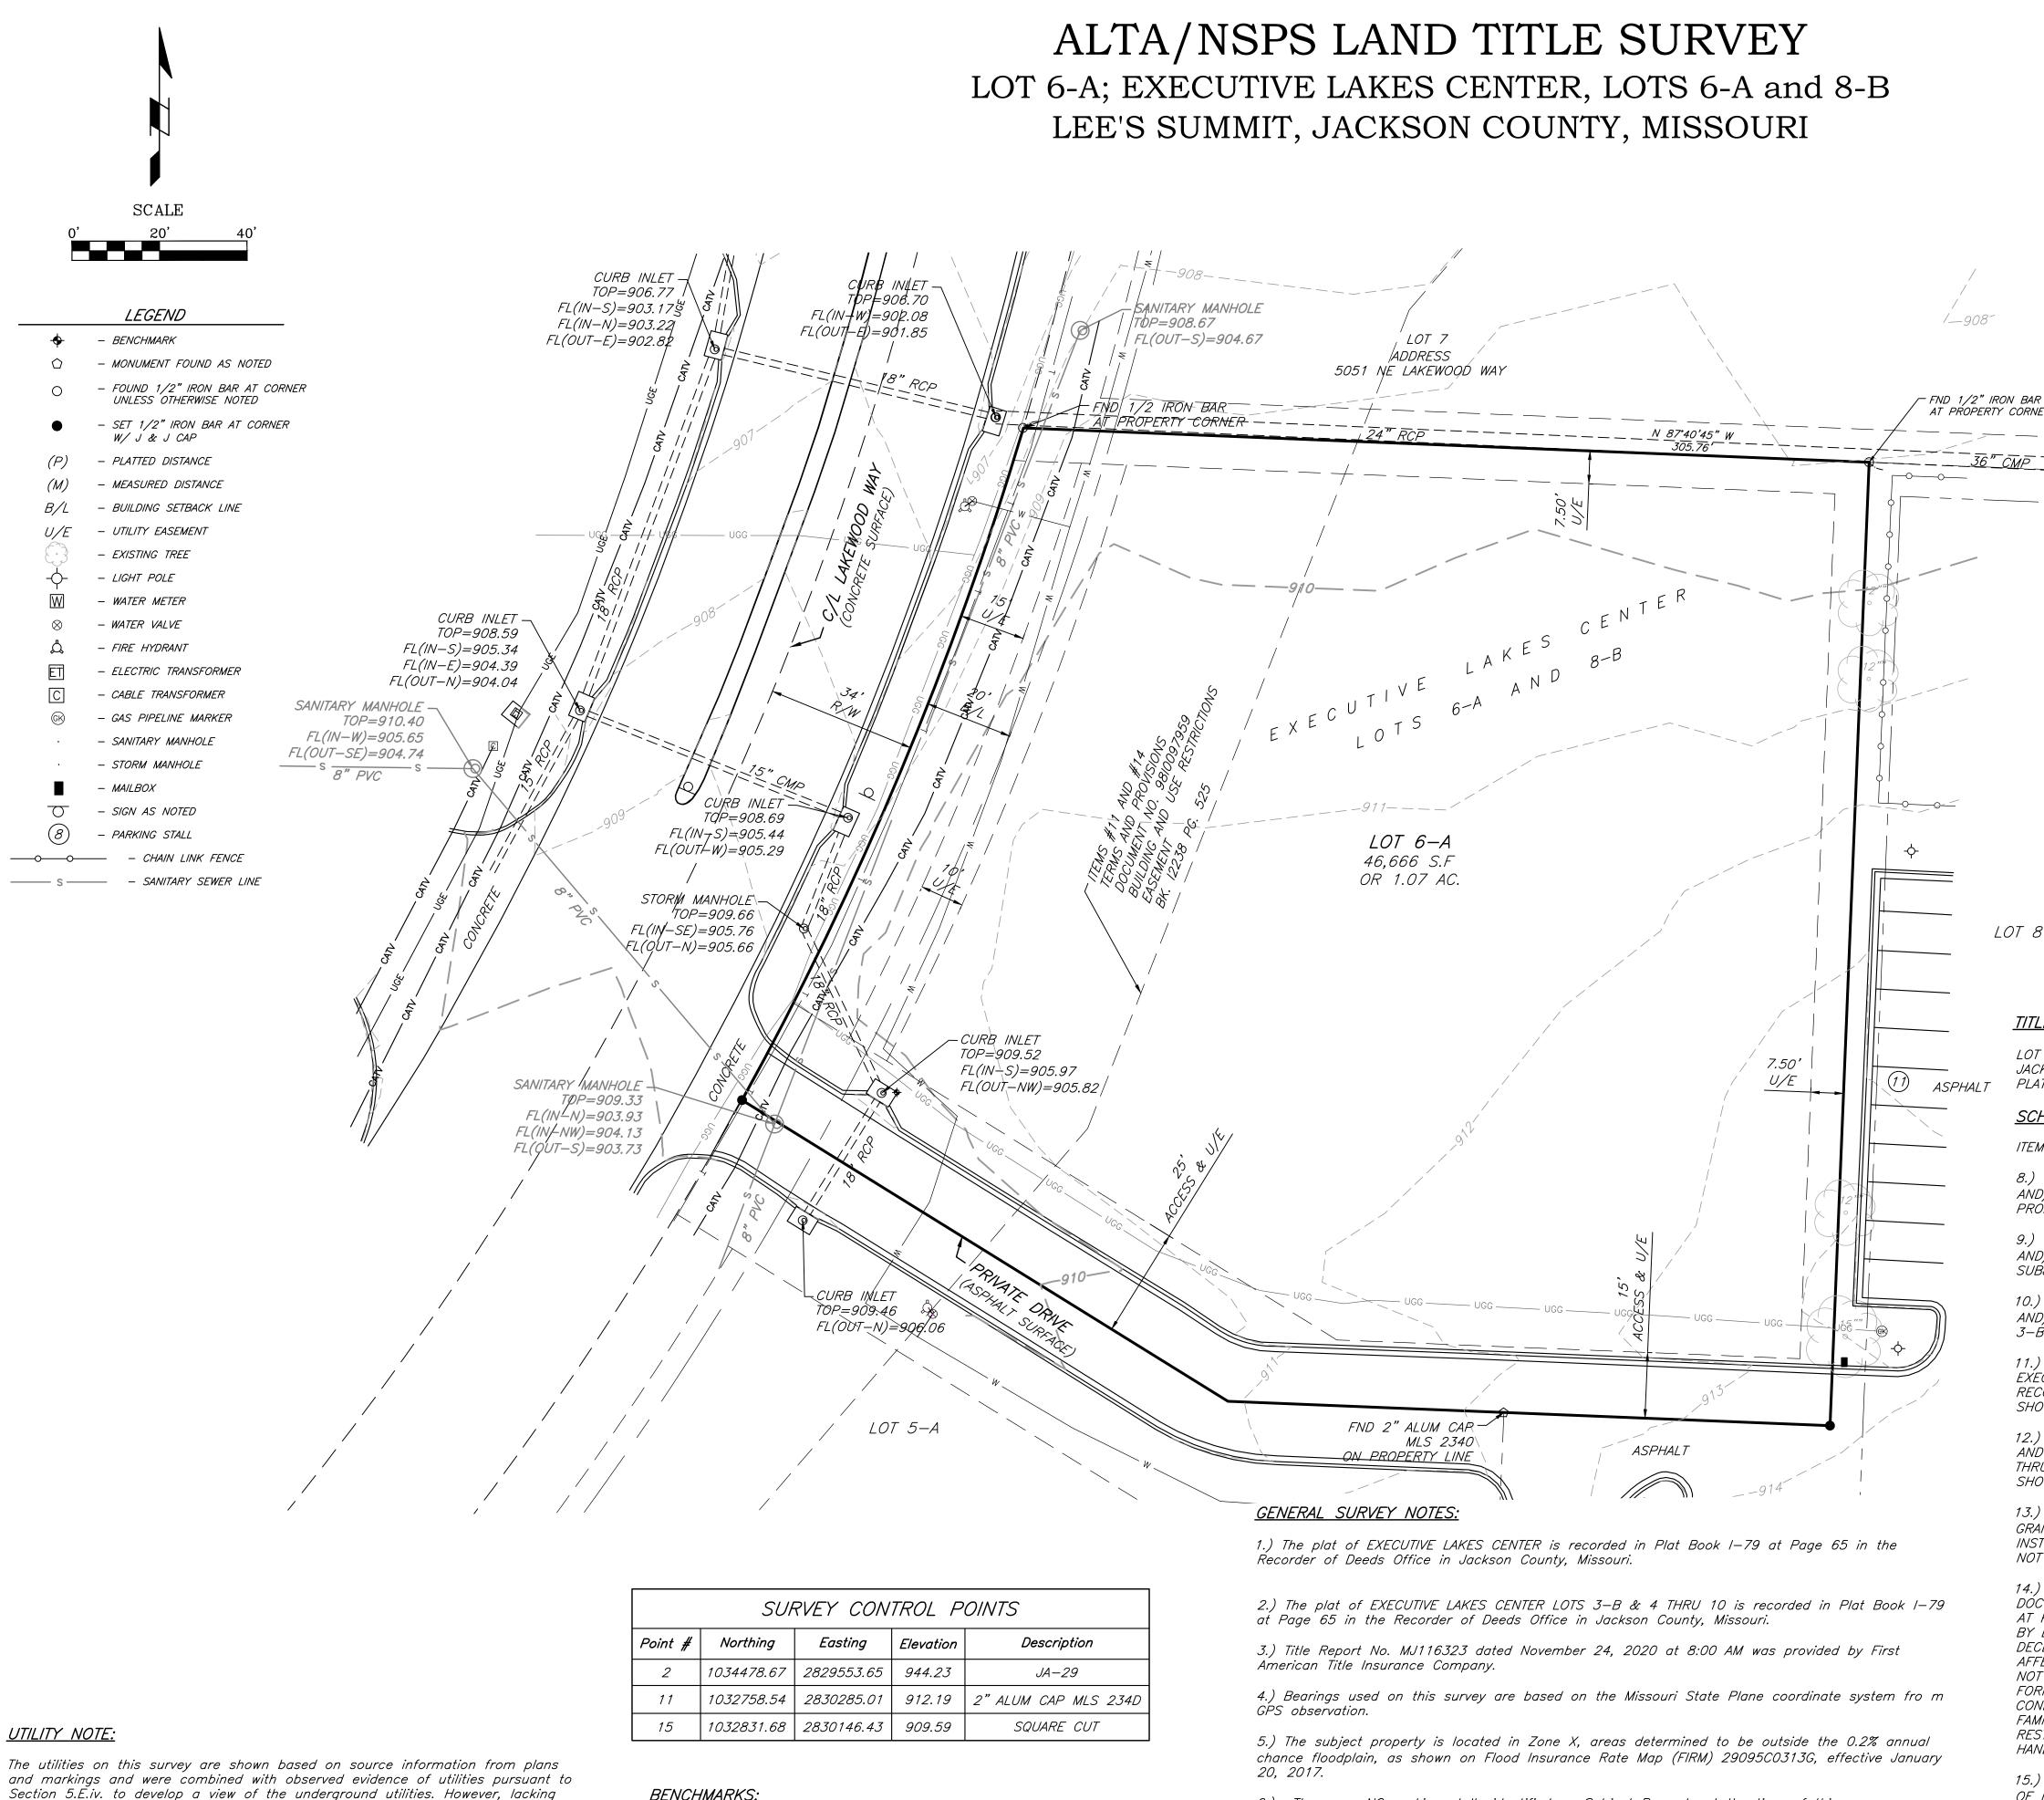

PROJECT LOCATION SE 1/4 VICINITY MAP SEC. 5-48-31

9229 Ward Parkway Kansas City, Mo 64114

<u>PROPERTY ADDRESS:</u>

5031 NE Lakewood Way Lee's Summit, Mo 64064

All of Lot 6-A, EXECUTIVE LAKES CENTER Lots 6-A and 8-B, a subdivision in the SE 1/4 of Section 5- T 48 N - R 31 W, Lee's Summit, Jackson County,

S 87°40'45" E

LOT 6A, EXECUTIVE LAKES CENTER LOTS 6A AND 8B, A SUBDIVISION IN LEE'S SUMMIT, JACKSON COUNTY, MISSOURI, ACCORDING TO THE RECORDED PLAT THEREOF; FILED IN PLAT BOOK 79 AT PAGE 65.

SCHEDULE B - PART II NOTES:

ITEMS 1 - 7, AND 17 - 20 ARE NON SURVEY RELATED ITEMS.

8.) TERMS, PROVISIONS, EASEMENTS, SET-BACK LINES AND FEATURES ALL AS SHOWN AND/OR NOTED ON THE COMMISSIONER'S PLAT OF BOWLIN ESTATE. AFFECTS SUBJECT PROPERTY AND IS BLANKET IN NATURE

9.) TERMS, PROVISIONS, EASEMENTS, SET-BACK LINES AND FEATURES ALL AS SHOWN AND/OR NOTED ON THE RECORDED PLAT OF EXECUTIVE LAKES CENTER. AFFECTS SUBJECT PROPERTY, NO DOCUMENT PROVIDED.

10.) TERMS, PROVISIONS, EASEMENTS, SET-BACK LINES AND FEATURES ALL AS SHOWN AND/OR NOTED ON THE RECORDED PLAT OF EXECUTIVE LAKES CENTER LOTS 3-A & 3-B THRU 10. AFFECTS SUBJECT PROPERTY.

11.) TERMS AND PROVISIONS OF ORDINANCE NO. 4703 ACCEPTING FINAL PLAT OF EXECUTIVE LAKES CENTER, LOTS 3-B & 4 THRU 10 AS SHOWN BY INSTRUMENT RECORDED AS DOCUMENT NO. 9810097959. AFFECTS THE SUBJECT PROPERTY AND IS SHOWN HEREON. 12.) TERMS, PROVISIONS, EASEMENTS, SET-BACK LINES AND FEATURES ALL AS SHOWN

AND OR NOTED ON THE RECORDED PLAT OF EXECUTIVE LAKES CENTER LOTS 3-B & 4 THRU 10 AS AFFECTED BY ORDINANCE NO. 4925 VACATING AN UTILITY EASEMENT AS SHOWN AND DESCRIBED THEREIN. DOES NOT AFFECT THE SUBJECT PROPERTY.

13.) THE EFFECTS, IF ANY, OF THE TERMS AND PROVISIONS OF THE UTILITY EASEMENT GRANTED TO CITY OF LEE'S SUMMIT, A MUNICIPAL CORPORATION AS SHOWN BY INSTRUMENT RECORDED AS DOCUMENT NO. 97-14003 IN 12952 AT PAGE 1654. DOES NOT AFFECT THE SUBJECT PROPERTY.

14.) BUILDING AND USE RESTRICTIONS CREATED BY THE INSTRUMENT RECORDED AS DOCUMENT NO. 198126317 IN BOOK 13177 AT PAGE 329. AND 1103647 IN BOOK 12238 AT PAGE 525. AFFECTS THE SUBJECT PROPERTY AND IS SHOWN ON. AND AMENDED BY DOCUMENT NO. 98190271 IN BOOK 13310 AT PAGE 1665. AND AS AFFECTED BY DECLARATION OF ANNEXATION RECORDED AS DOCUMENT NO. 200010010475. DOES NOT AFFECT THE SUBJECT PROPERTY. AND AMENDED BY DOCUMENT NO. 2000126140. DOES NOT AFFECT THE SUBJECT PROPERTY. A VIOLATION OF WHICH WOULD NOT CAUSE A FORFEITURE OR REVERSION OF TITLE. NOTE, THIS EXCEPTION OMITS ANY COVENANT, CONDITION OR RESTRICTION BASED ON RACE, COLOR, RELIGION, SEX, HANDICAP, FAMILIAL STATUS OR NATIONAL ORIGIN, UNLESS AND ONLY TO THE EXTENT THAT RESTRICTION IS NOT IN VIOLATION OF STATE OR FEDERAL LAW OR RELATES TO A HANDICAP, BUT DOES NOT DISCRIMINATE AGAINST HANDICAPPED PEOPLE.

15.) TERMS AND PROVISIONS OF DEVELOPMENT AGREEMENT BY AND BETWEEN THE CITY OF LEE'S SUMMIT, MISSOURI AND LAKEWOOD DEVELOPMENT, L.P. AND FOUR BAR COMPANY, G.P. FILED JANUARY 13, 1999 AS DOCUMENT NO. 99/3356. AFFECTS THE SUBJECT PROPERTY AND IS BLANKET IN NATURE.

16.) TERMS AND PROVISIONS OF THE DEVELOPMENT AGREEMENT BY AND BETWEEN CITY OF LEE'S SUMMIT, MISSOURI, A MUNICIPAL CORPORATION AND LAKEWOOD DEVELOPMENT, L.P. AS SHOWN BY INSTRUMENT RECORDED AS DOCUMENT NO. 200010029662. DOES NOT AFFECT THE SUBJECT PROPERTY.

BENCHMARKS:

excavation, the exact location of underground features cannot be accurately,

other similar utility locate requests from surveyors may be ignored or result in

an incomplete response, in which case the surveyor shall note on the plat or

utilities. Where additional or more detailed information is required, the client is

completely, and reliably depicted. In addition, in some jurisdictions, 811 or

map how this affected the surveyor's assessment of the location of the

advised that excavation and/or a private utility locate request may be

necessary.

STATION JA-29: Alum Disk Located about 5.5 miles North of Lee's Summit and between I-470 and the East outer Road of North Bound ramp #14

ELEVATION = 944.23

7.) Under Ground Utilities are shown as located by Missouri one call ticket No. 211930316 dated


9.) This Property is Zoned CP-2, Planned Community Commercial.

observed in the process of conducting the fieldwork

8.) There were no Wetland Delineations marked, at the time of survey.

10.) There was no evidence of Earth moving work, building construction, or building additions

6.) There are NO parking stalls identified on Subject Property at the time of this survey.

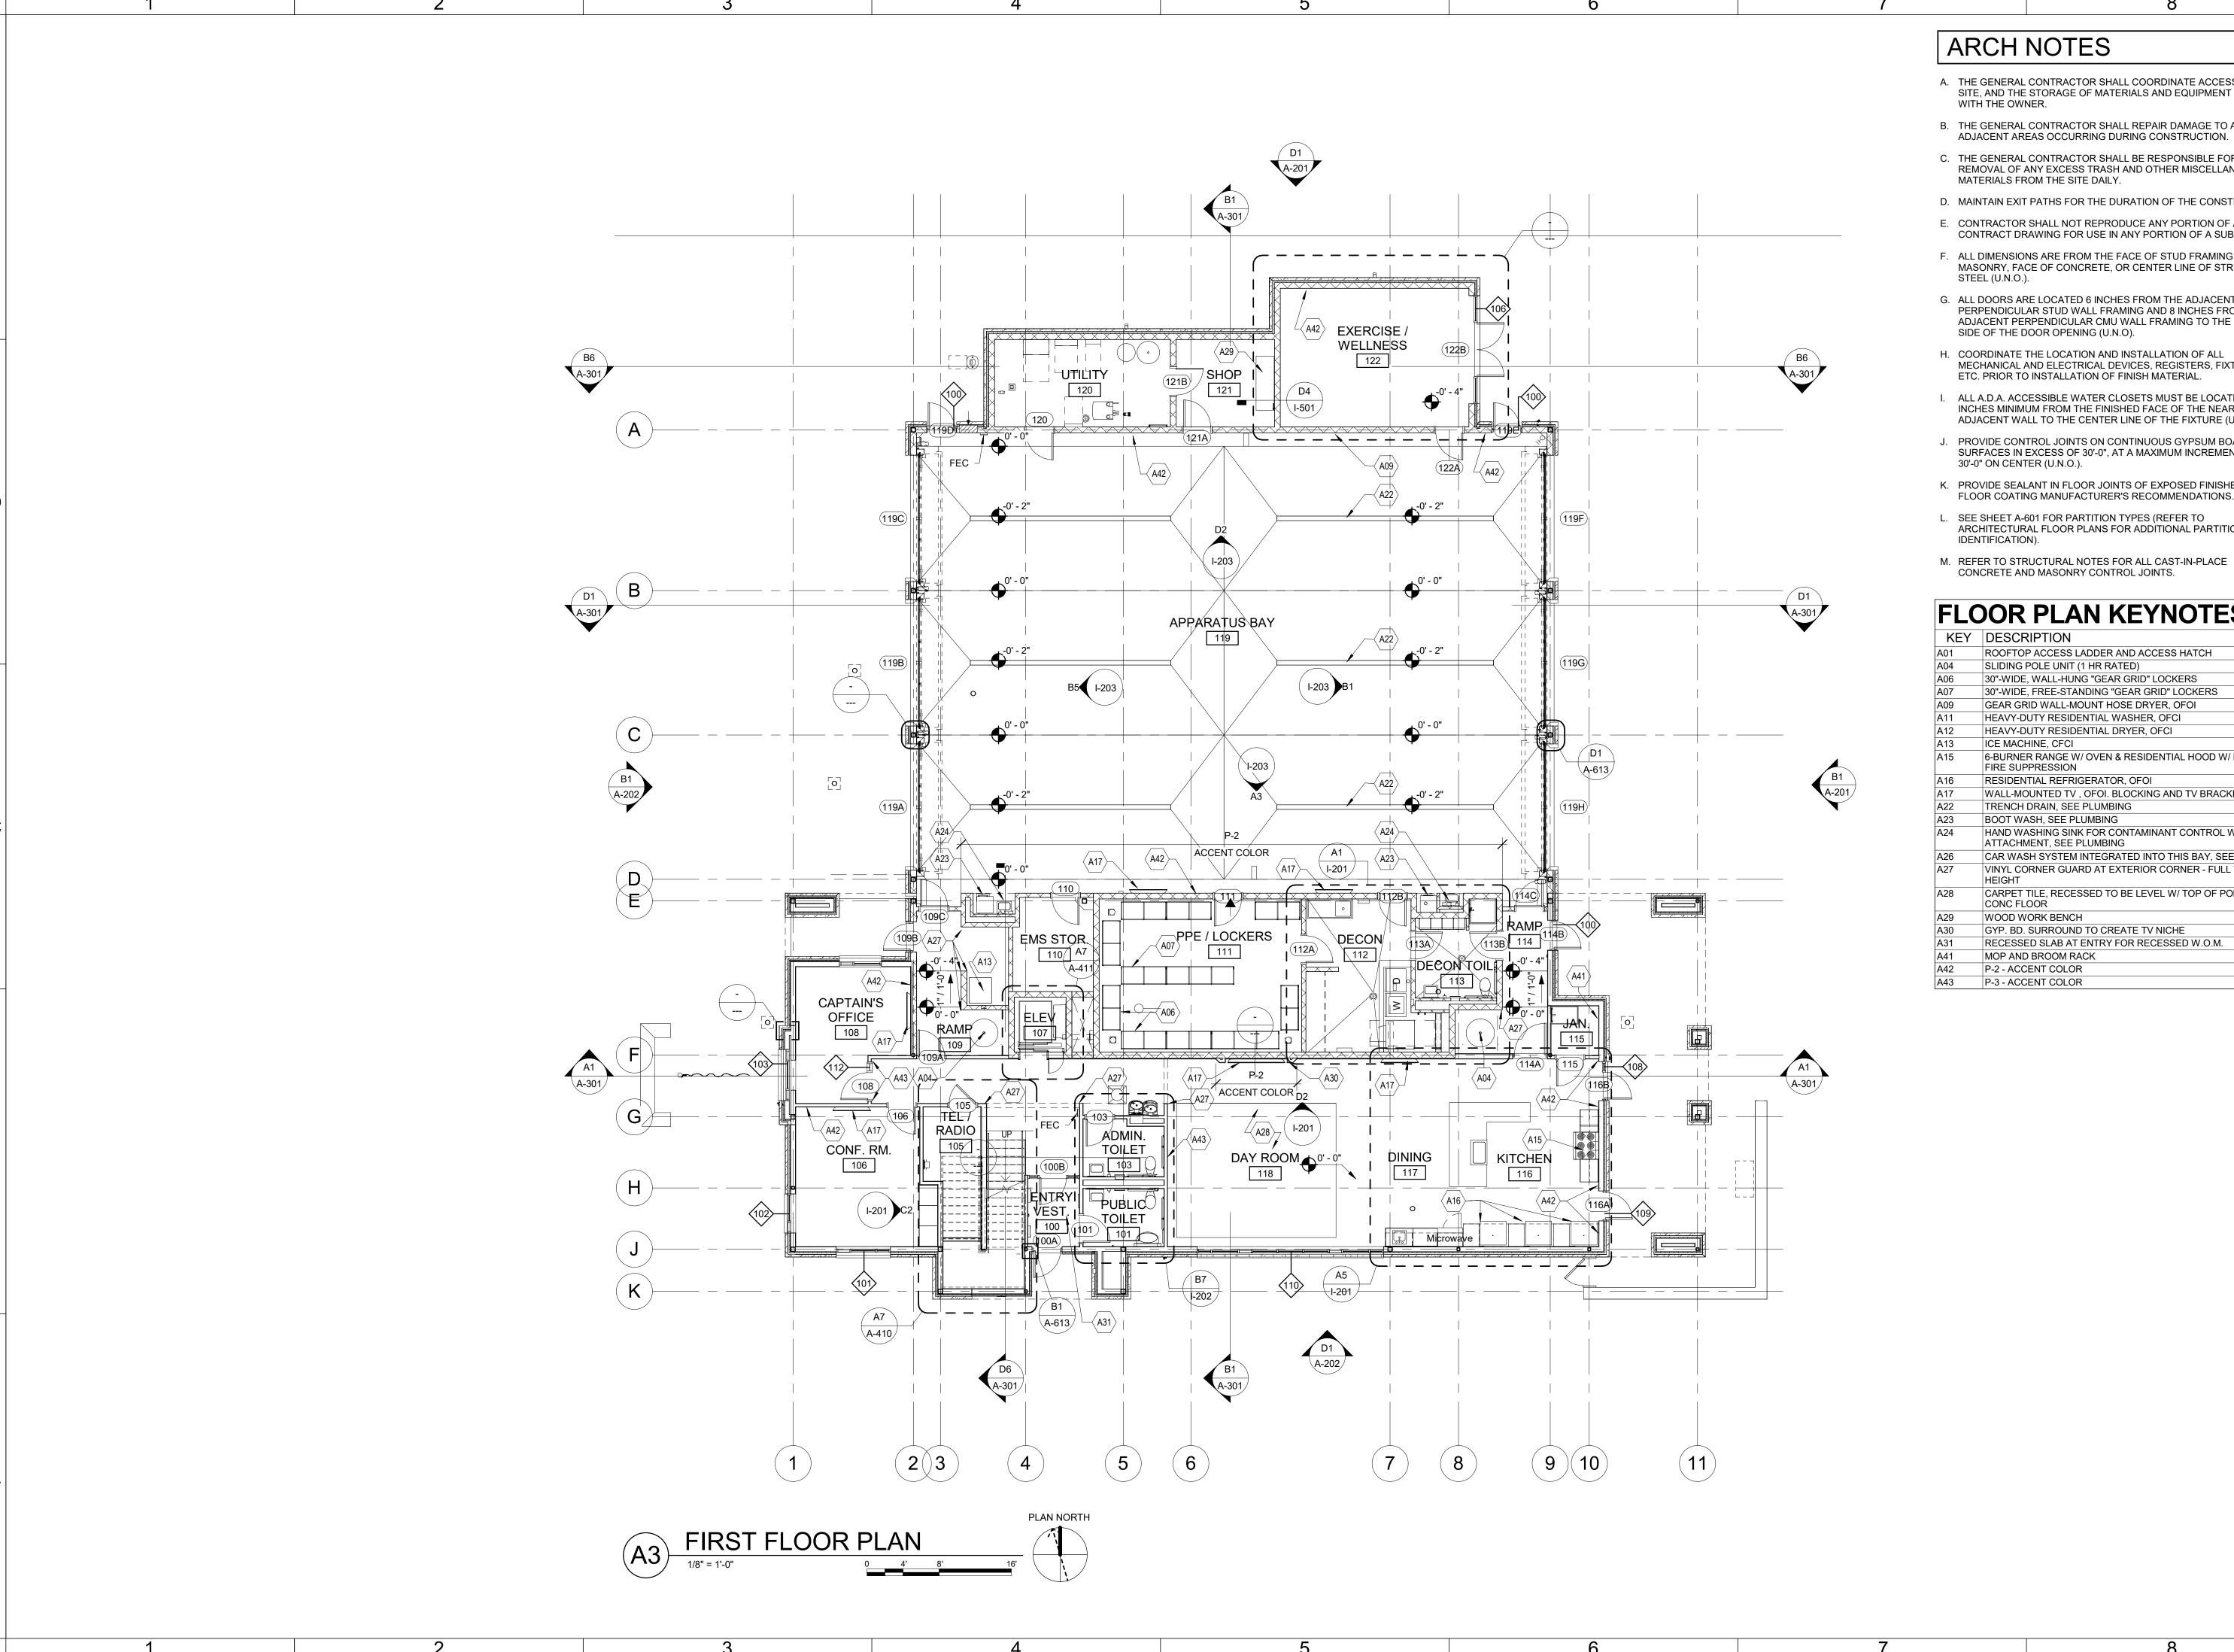

ARCH NOTES

- A. THE GENERAL CONTRACTOR SHALL COORDINATE ACCESS TO THE SITE, AND THE STORAGE OF MATERIALS AND EQUIPMENT ON SITE WITH THE OWNER.
- B. THE GENERAL CONTRACTOR SHALL REPAIR DAMAGE TO ANY
- C. THE GENERAL CONTRACTOR SHALL BE RESPONSIBLE FOR THE REMOVAL OF ANY EXCESS TRASH AND OTHER MISCELLANEOUS
- D. MAINTAIN EXIT PATHS FOR THE DURATION OF THE CONSTRUCTION.
- E. CONTRACTOR SHALL NOT REPRODUCE ANY PORTION OF A CONTRACT DRAWING FOR USE IN ANY PORTION OF A SUBMITTAL
- F. ALL DIMENSIONS ARE FROM THE FACE OF STUD FRAMING, FACE OF MASONRY, FACE OF CONCRETE, OR CENTER LINE OF STRUCTURAL
- G. ALL DOORS ARE LOCATED 6 INCHES FROM THE ADJACENT PERPENDICULAR STUD WALL FRAMING AND 8 INCHES FROM THE ADJACENT PERPENDICULAR CMU WALL FRAMING TO THE HINGE SIDE OF THE DOOR OPENING (U.N.O).
- H. COORDINATE THE LOCATION AND INSTALLATION OF ALL MECHANICAL AND ELECTRICAL DEVICES, REGISTERS, FIXTURES, ETC. PRIOR TO INSTALLATION OF FINISH MATERIAL.
- I. ALL A.D.A. ACCESSIBLE WATER CLOSETS MUST BE LOCATED 18 INCHES MINIMUM FROM THE FINISHED FACE OF THE NEAREST ADJACENT WALL TO THE CENTER LINE OF THE FIXTURE (U.N.O.).
- PROVIDE CONTROL JOINTS ON CONTINUOUS GYPSUM BOARD SURFACES IN EXCESS OF 30'-0", AT A MAXIMUM INCREMENT OF 30'-0" ON CENTER (U.N.O.).
- K. PROVIDE SEALANT IN FLOOR JOINTS OF EXPOSED FINISHES PER FLOOR COATING MANUFACTURER'S RECOMMENDATIONS.
- L. SEE SHEET A-601 FOR PARTITION TYPES (REFER TO ARCHITECTURAL FLOOR PLANS FOR ADDITIONAL PARTITION IDENTIFICATION).
- M. REFER TO STRUCTURAL NOTES FOR ALL CAST-IN-PLACE CONCRETE AND MASONRY CONTROL JOINTS.

EI OOD DI ANI KEVNOTES

KEY	DESCRIPTION
A01	ROOFTOP ACCESS LADDER AND ACCESS HATCH
A04	SLIDING POLE UNIT (1 HR RATED)
A06	30"-WIDE, WALL-HUNG "GEAR GRID" LOCKERS
A07	30"-WIDE, FREE-STANDING "GEAR GRID" LOCKERS
A09	GEAR GRID WALL-MOUNT HOSE DRYER, OFOI
A11	HEAVY-DUTY RESIDENTIAL WASHER, OFCI
A12	HEAVY-DUTY RESIDENTIAL DRYER, OFCI
A13	ICE MACHINE, CFCI
A15	6-BURNER RANGE W/ OVEN & RESIDENTIAL HOOD W/ INTEGRAL FIRE SUPPRESSION
A16	RESIDENTIAL REFRIGERATOR, OFOI
A17	WALL-MOUNTED TV , OFOI. BLOCKING AND TV BRACKET, CFCI
A22	TRENCH DRAIN, SEE PLUMBING
A23	BOOT WASH, SEE PLUMBING
A24	HAND WASHING SINK FOR CONTAMINANT CONTROL W/ EYEWASH ATTACHMENT, SEE PLUMBING
A26	CAR WASH SYSTEM INTEGRATED INTO THIS BAY, SEE PLUMBING
A27	VINYL CORNER GUARD AT EXTERIOR CORNER - FULL WALL HEIGHT
A28	CARPET TILE, RECESSED TO BE LEVEL W/ TOP OF POLISHED CONC FLOOR
A29	WOOD WORK BENCH
A30	GYP. BD. SURROUND TO CREATE TV NICHE
A31	RECESSED SLAB AT ENTRY FOR RECESSED W.O.M.
A41	MOP AND BROOM RACK
A42	P-2 - ACCENT COLOR
A43	P-3 - ACCENT COLOR



GLMVArchitecture 9229 WARD PARKWAY

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SUITE # 210

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(816) 444-3144 MECH., ELECT. & PLMG. ENGINEERS HOSS & BROWN ENGINEERS MISSOURI COA #01022 15902 MIDLAND DRIVE SHAWNEE, KS 66217

(913) 362.9090 SECURITY & IT ENGINEERS HENDERSON ENGINEERS MISSOURI COA #000556 1801 MAIN STREET, SUITE 300

KANSAS CITY, MO 64108 (816) 663-8700

REVISIONS: # Description




PAUL J. MICHELL - ARCHITECT MO# A-2009021701

PROJECT NO: 18225R21001 DATE: 10.19.2022 DRAWN BY:

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FIRST FLOOR



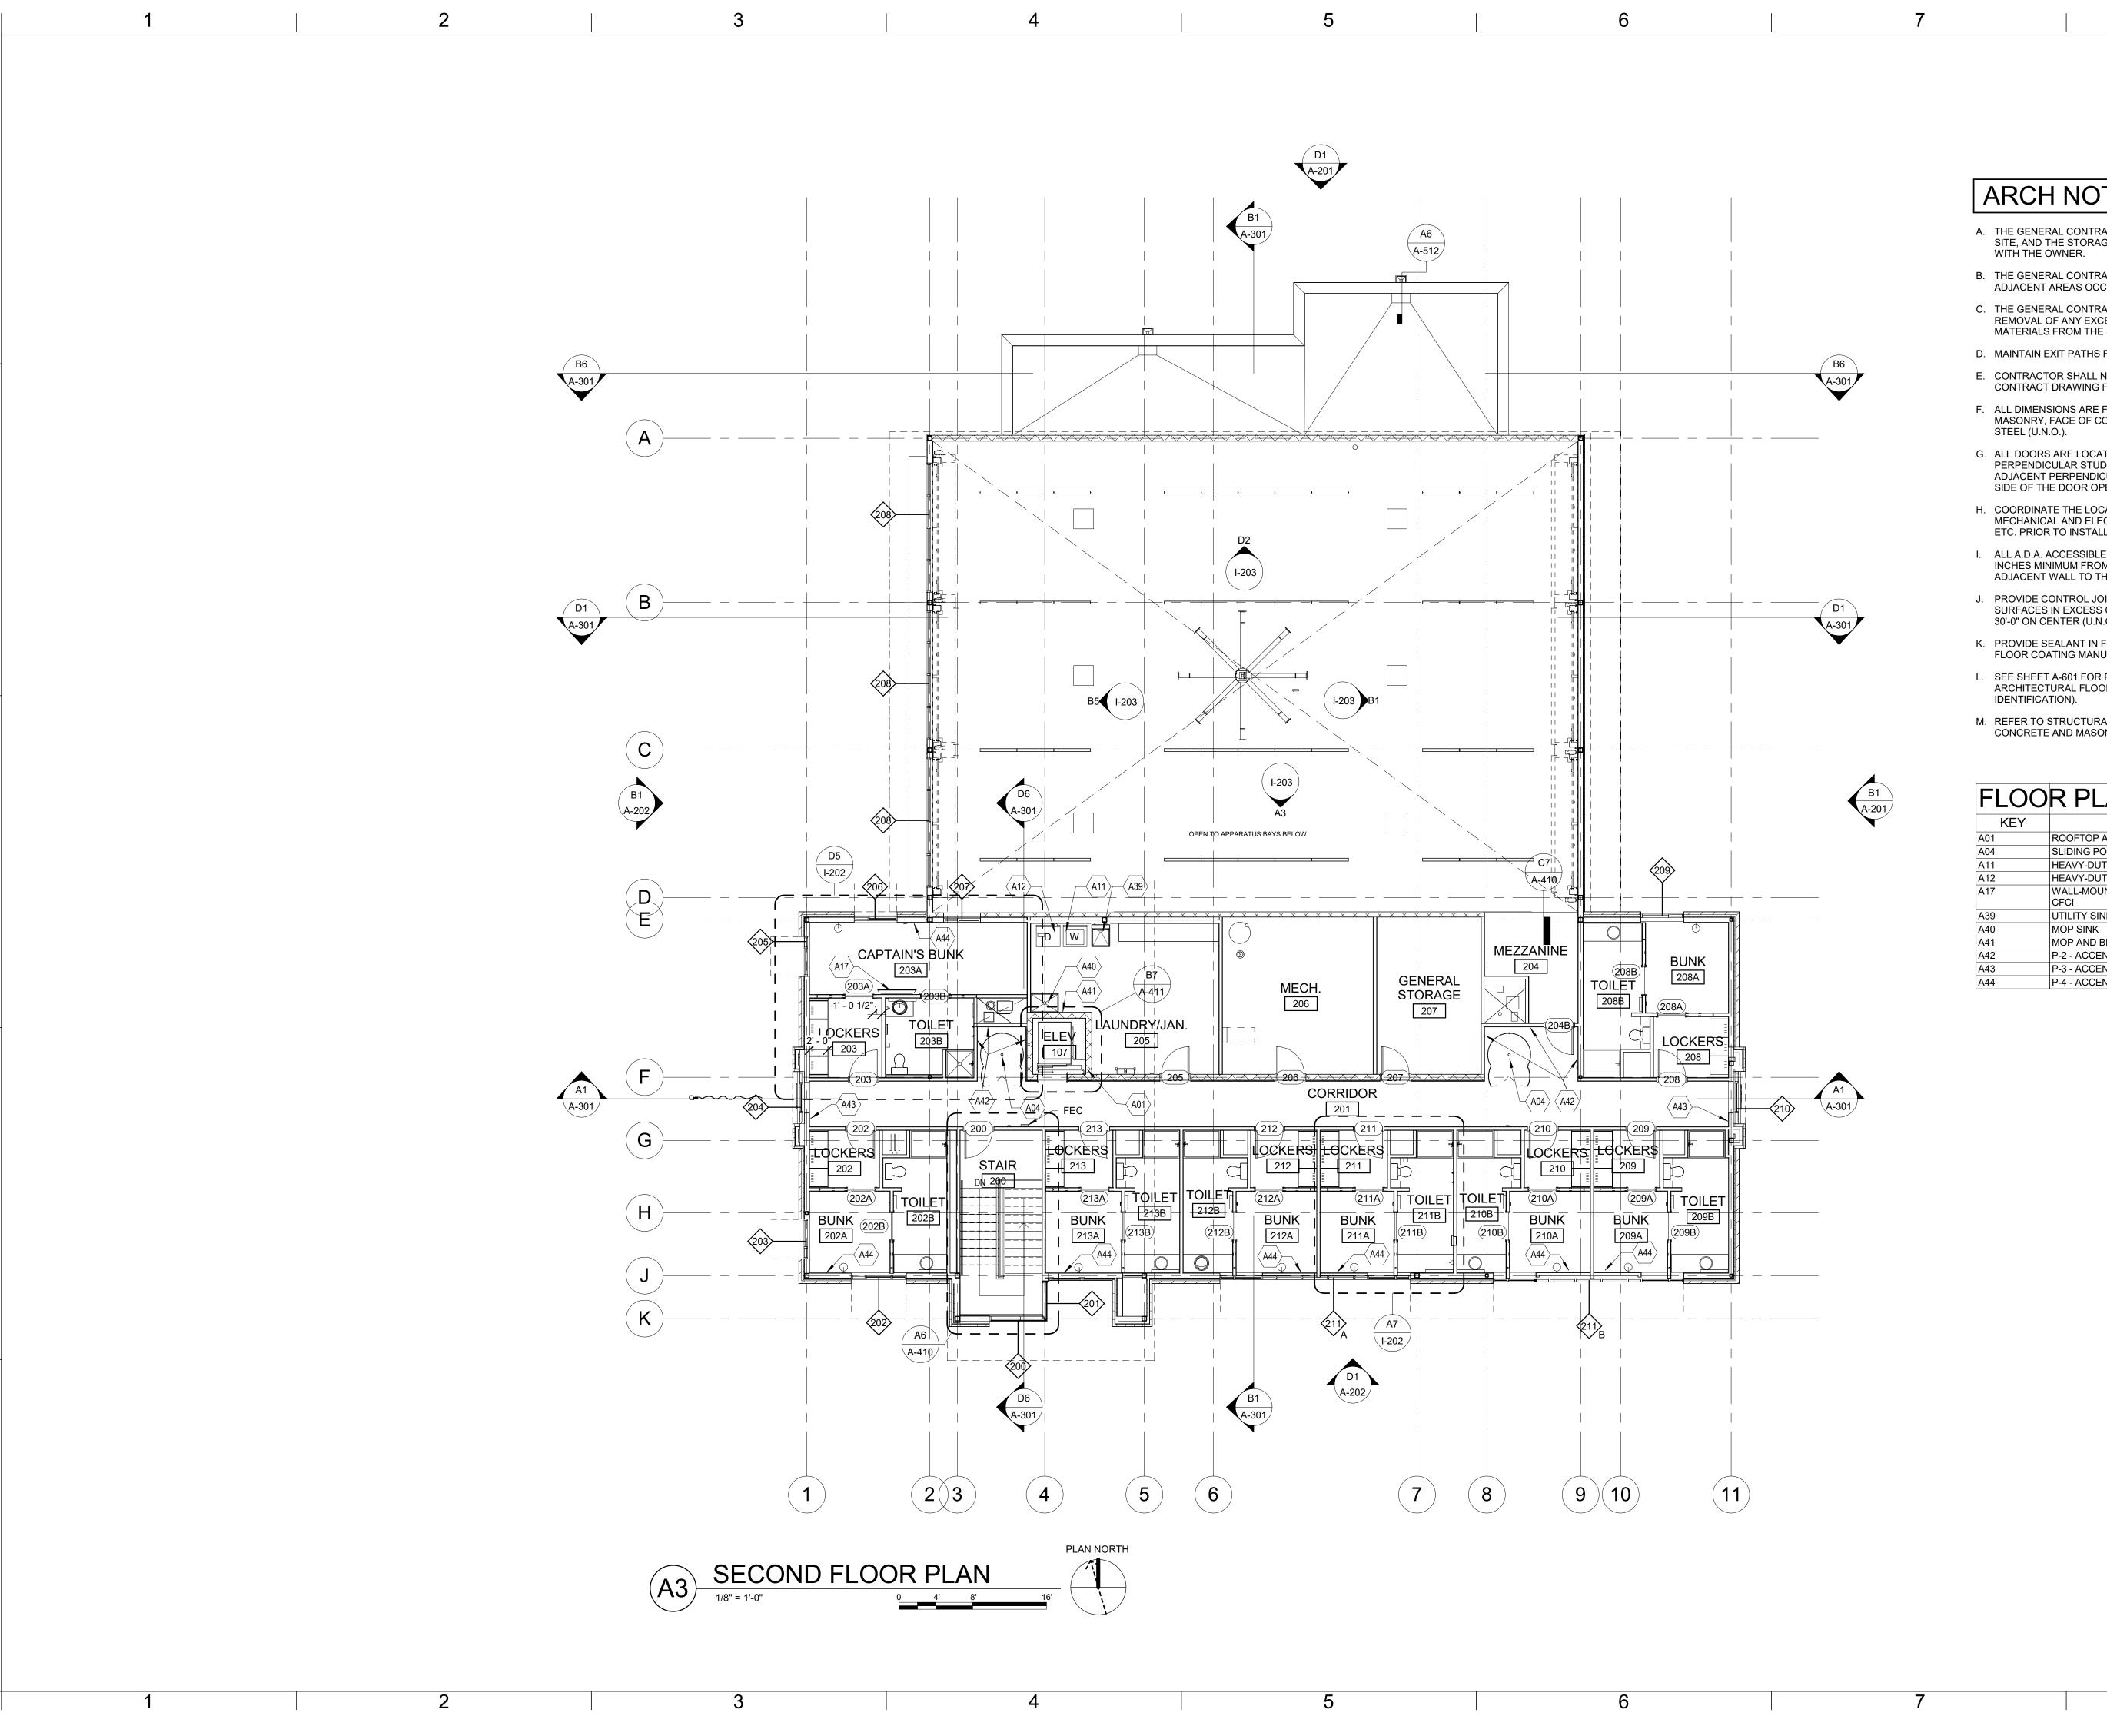

ARCH NOTES

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FLOOR PLAN KEYNOTES.

KEY	EY DESCRIPTION				
A01	ROOFTOP ACCESS LADDER AND ACCESS HATCH				
A04	SLIDING POLE UNIT (1 HR RATED)				
A11	HEAVY-DUTY RESIDENTIAL WASHER, OFCI				
A12	HEAVY-DUTY RESIDENTIAL DRYER, OFCI				
A17	WALL-MOUNTED TV , OFOI. BLOCKING AND TV BRACKET, CFCI				
A39	UTILITY SINK				
A40	MOP SINK				
A41	MOP AND BROOM RACK				
A42	P-2 - ACCENT COLOR				
A43	P-3 - ACCENT COLOR				
A44	P-4 - ACCENT COLOR				

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- SEE SHEET A-601 FOR PARTITION TYPES (REFER TO ARCHITECTURAL FLOOR PLANS FOR ADDITIONAL PARTITION

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A44	P-4 - ACCENT COLOR

Description

REVISIONS:

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SECURITY & IT ENGINEERS

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MISSOURI COA #01022

15902 MIDLAND DRIVE

SHAWNEE, KS 66217 (913) 362.9090

MECH., ELECT. & PLMG. ENGINEERS

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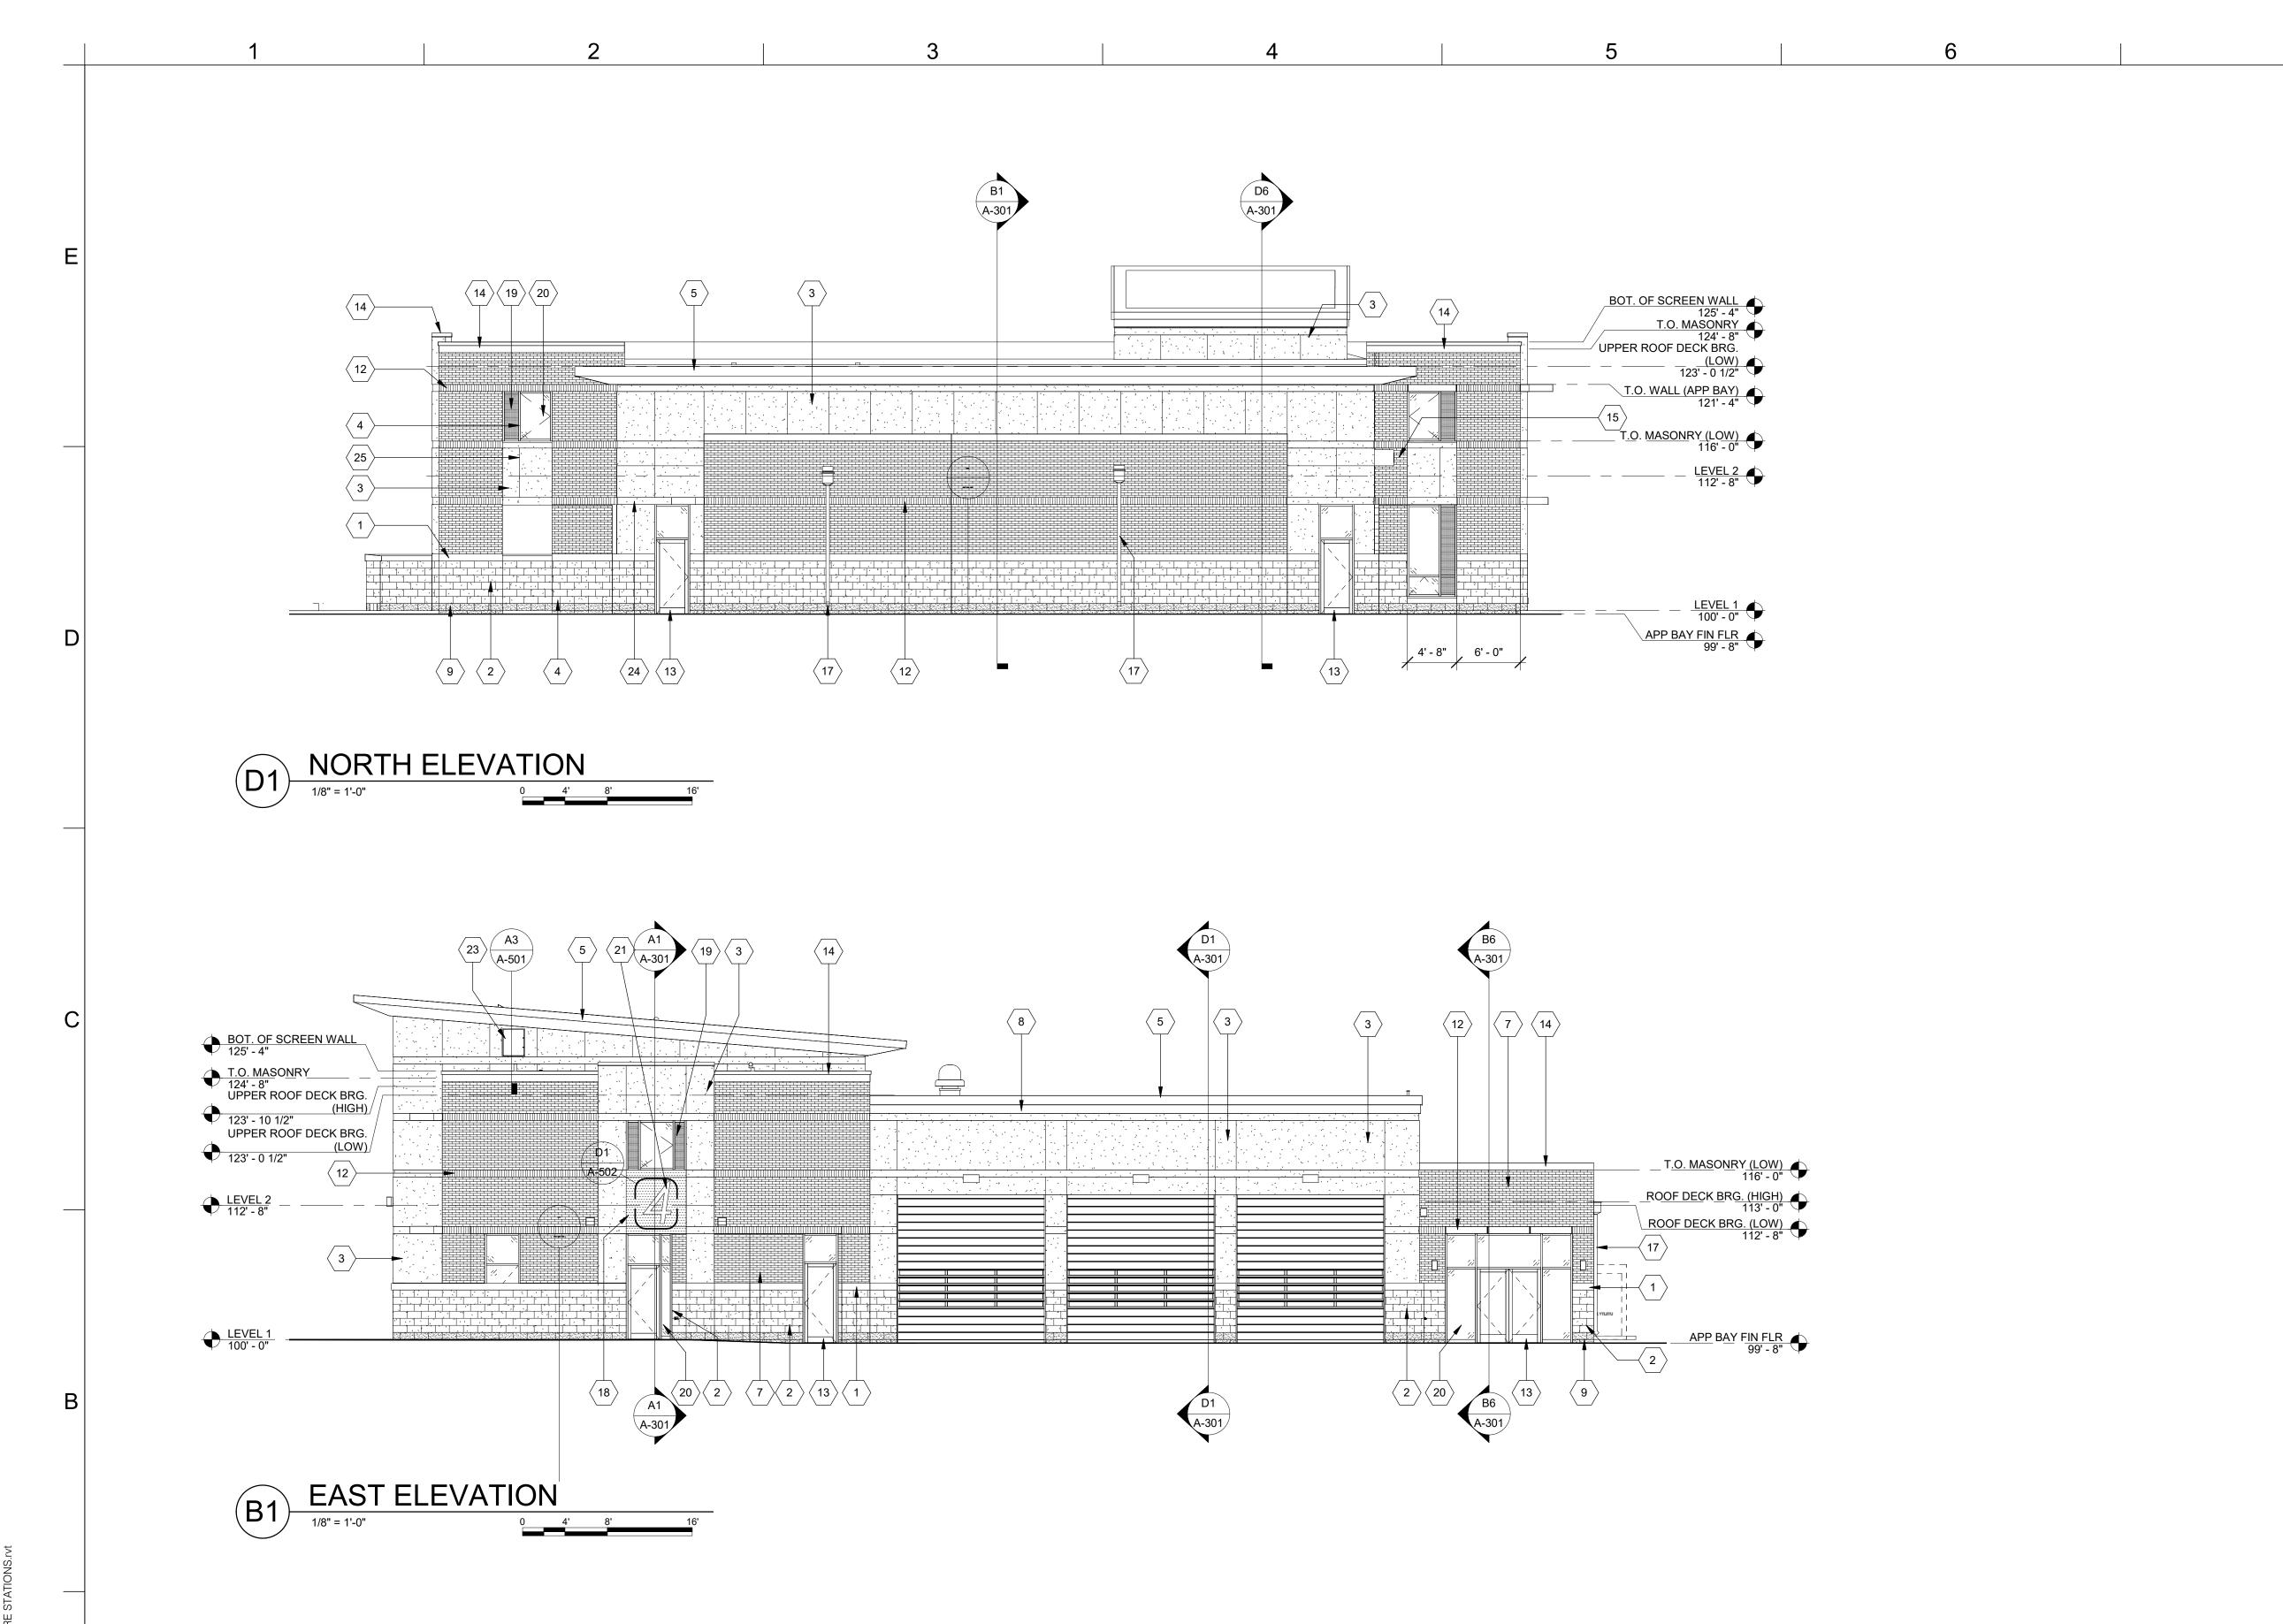
PAUL J. MICHELL - ARCHITECT MO# A-2009021701

PROJECT NO: 18225R21001 DATE: 10.19.2022 DRAWN BY:

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A-102



BUILDING ELEVATION... KEY DESCRIPTION 1 CAST STONE MASONRY SILL 2 ANCHORED STONE MASONRY VENEER (TYPE 1) 3 EIFS 4 PRE-FINISHED ALUMINUM-FRAMED STOREFRONT 5 PRE-FINISHED SHEET METAL FASCIA 6 PRE-FINISHED ALUMINUM-FRAMED STOREFRONT 7 4" MASONRY VENEER (COMMON BOND) 8 PRE-FINISHED SHEET METAL SOFFIT PANELS 9 ANCHORED STONE MASONRY VENEER (TYPE 2) 12 4" MASONRY VENEER (SOLDIER) 13 PRE-FINISHED ALUMINUM-FRAMED ENTRANCE FGMA ARCHITECTS 14 PRE-FINISHED SHEET METAL PARAPET CAP 15 PRE-FINISHED SHEET METAL CANOPY 16 3/8" FIBER-CEMENT PANEL GAP (TYP.) 17 PRE-FINISHED SHEET METAL CONDUCTOR HEAD & DOWNSPOUT 18 PRE-FINISHED METAL PLATE WALL PANELS 19 METAL-FACED INSULATED WINDOW PANEL 20 1" INSULATED GLASS UNIT 21 BACKLIT PIN-MOUNTED PRE-FINISHED METAL SIGNAGE

22 WALL HYDRANT (RE: PLMG)

24 1/2" DEEP EIFS RECESS

27 1/2" METAL PANEL REVEAL

23 24"x30" METAL ACCESS DOOR

25 3/4" DEEP V-GROOVE EIFS REVEAL

26 BACK-LIT STAINLESS STEEL POST-MOUNTED FIRE DEPARTMENT

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STRUCTURAL ENGINEER

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SECURITY & IT ENGINEERS HENDERSON ENGINEERS MISSOURI COA #000556 1801 MAIN STREET, SUITE 300 KANSAS CITY, MO 64108 (816) 663-8700

EAST LAKEWOOD IT, MISSOURI 6406 FIRE STATION #4
CITY OF LEE'S SUMMIT

REVISIONS: # Description Date




PAUL J. MICHELL - ARCHITECT MO# A-2009021701

PROJECT NO: 18225R21001 DATE: 10.19.2022 DRAWN BY: CHK'D BY:

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BUILDING **ELEVATIONS**

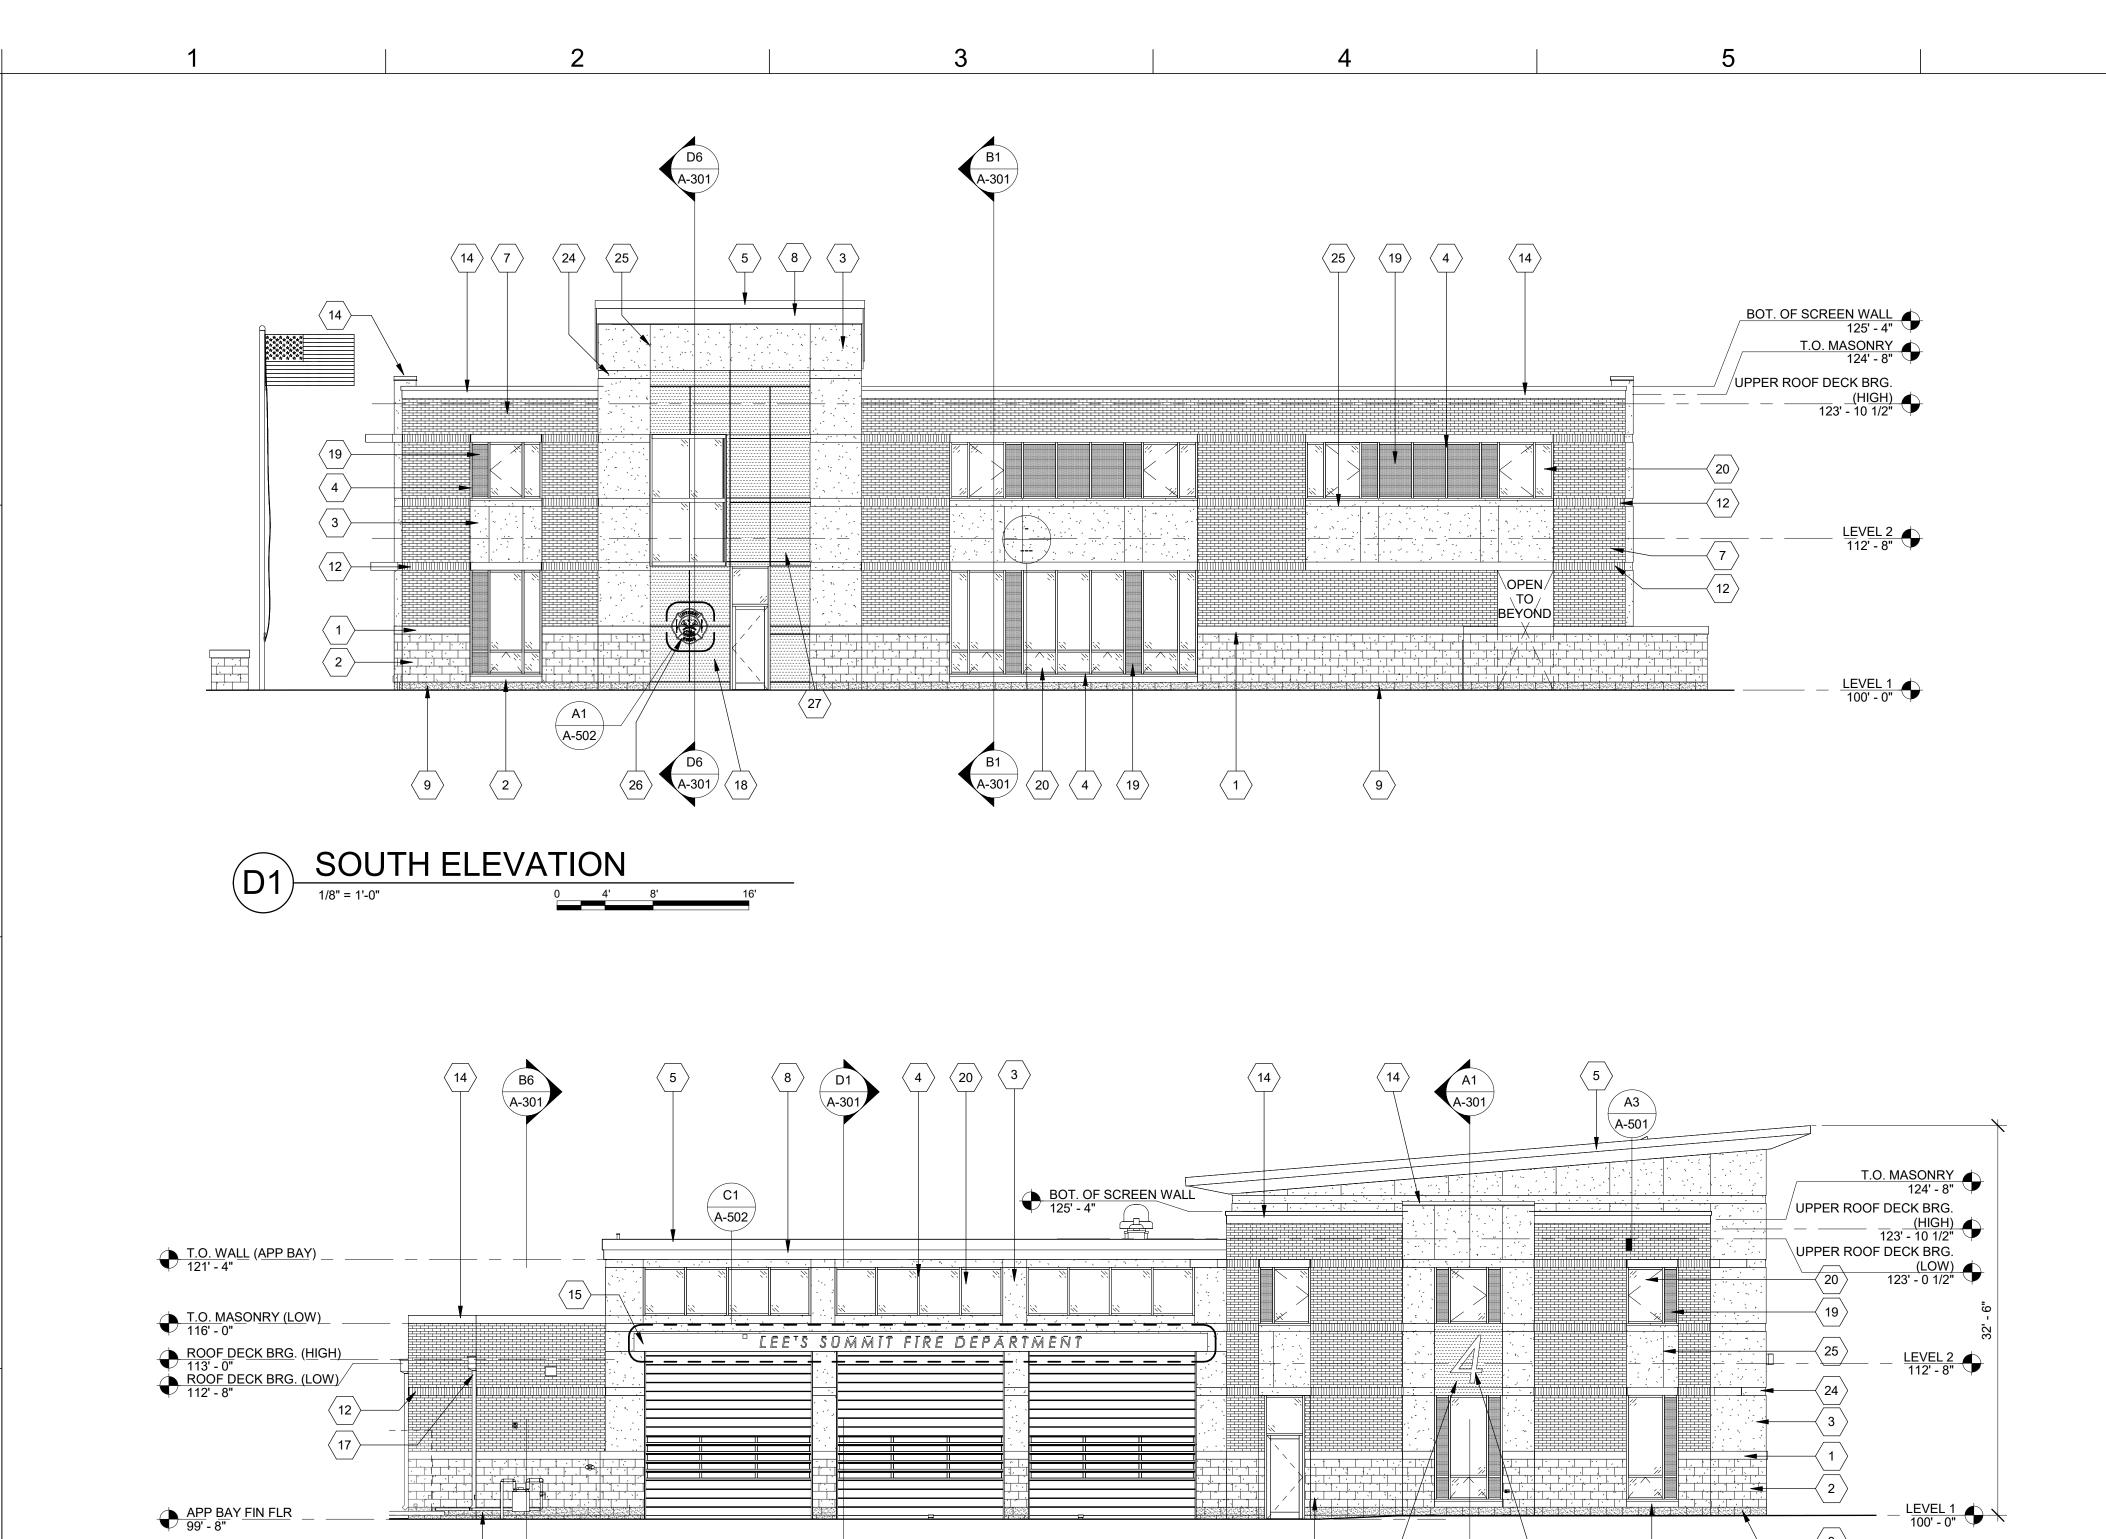

PAYFINFLR

9

A301

WEST ELEVATION

BUILDING ELEVATION...

KEY DESCRIPTION

1 CAST STONE MASONRY SILL
2 ANCHORED STONE MASONRY VENEER (TYPE 1)

3 EIFS
4 PRE-FINISHED ALUMINUM-FRAMED STOREFRONT
5 PRE-FINISHED SHEET METAL FASCIA

5 PRE-FINISHED SHEET METAL FASCIA
6 PRE-FINISHED ALUMINUM-FRAMED STOREFRONT
7 4" MASONRY VENEER (COMMON BOND)

8 PRE-FINISHED SHEET METAL SOFFIT PANELS
9 ANCHORED STONE MASONRY VENEER (TYPE 2)
12 4" MASONRY VENEER (SOLDIER)
13 PRE-FINISHED ALUMINUM-FRAMED ENTRANCE

14 PRE-FINISHED SHEET METAL PARAPET CAP
15 PRE-FINISHED SHEET METAL CANOPY
16 3/8" FIBER-CEMENT PANEL GAP (TYP.)

17 PRE-FINISHED SHEET METAL CONDUCTOR HEAD & DOWNSPOUT

18 PRE-FINISHED METAL PLATE WALL PANELS

19 METAL-FACED INSULATED WINDOW PANEL
20 1" INSULATED GLASS UNIT
21 PACKLIT DIN MOUNTED DRE FINISHED METAL SIG

26 BACK-LIT STAINLESS STEEL POST-MOUNTED FIRE DEPARTMENT

21 BACKLIT PIN-MOUNTED PRE-FINISHED METAL SIGNAGE
22 WALL HYDRANT (RE: PLMG)
23 24"x30" METAL ACCESS DOOR

24 1/2" DEEP EIFS RECESS
25 3/4" DEEP V-GROOVE EIFS REVEAL

CREST
27 1/2" METAL PANEL REVEAL

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SHAWNEE, KS 66217
(913) 362.9090

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KANSAS CITY, MO 64108
(816) 663-8700

FIRE STATION #4
CITY OF LEE'S SUMMIT
5031 NORTHEAST LAKEWOOD W
LEE'S SUMMIT, MISSOURI 64064

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PAUL J. MICHELL - ARCHITECT MO# A-2009021701

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 PROJECT NO:
 18225R21001

 DATE:
 10.19.2022

 DRAWN BY:
 JSP

 CHK'D BY:
 GLW

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BUILDING ELEVATIONS

A-202



- 1. PRIOR TO STARTING CONSTRUCTION THE CONTRACTOR SHALL BE RESPONSIBLE TO MAKE SURE THAT ALL REQUIRED PERMITS AND APPROVALS HAVE BEEN OBTAINED. NO CONSTRUCTION OR FABRICATION SHALL BEGIN UNTIL THE CONTRACTOR HAS RECEIVED AND THOROUGHLY REVIEWED ALL PLANS AND OTHER DOCUMENTS
- 2. ALL WORK SHALL BE PERFORMED IN ACCORDANCE WITH THESE PLANS, SPECIFICATIONS, AND THE REQUIREMENTS
- 4. ALL EXISTING CONDITIONS, DIMENSIONS, AND GRADES SHOWN ON THE PLANS SHALL BE FIELD VERIFIED BY THE CONTRACTOR PRIOR TO CONSTRUCTION. CONTRACTOR SHALL NOTIFY THE CONSTRUCTION MANAGER IF ANY DISCREPANCIES EXIST, PRIOR TO PROCEEDING WITH CONSTRUCTION, FOR NECESSARY PLAN OR GRADE CHANGES. NO EXTRA COMPENSATION SHALL BE PAID TO THE CONTRACTOR FOR WORK HAVING TO BE REDONE DUE TO

LEGEND

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FIRE STATIC CITY OF LEE'S SUN

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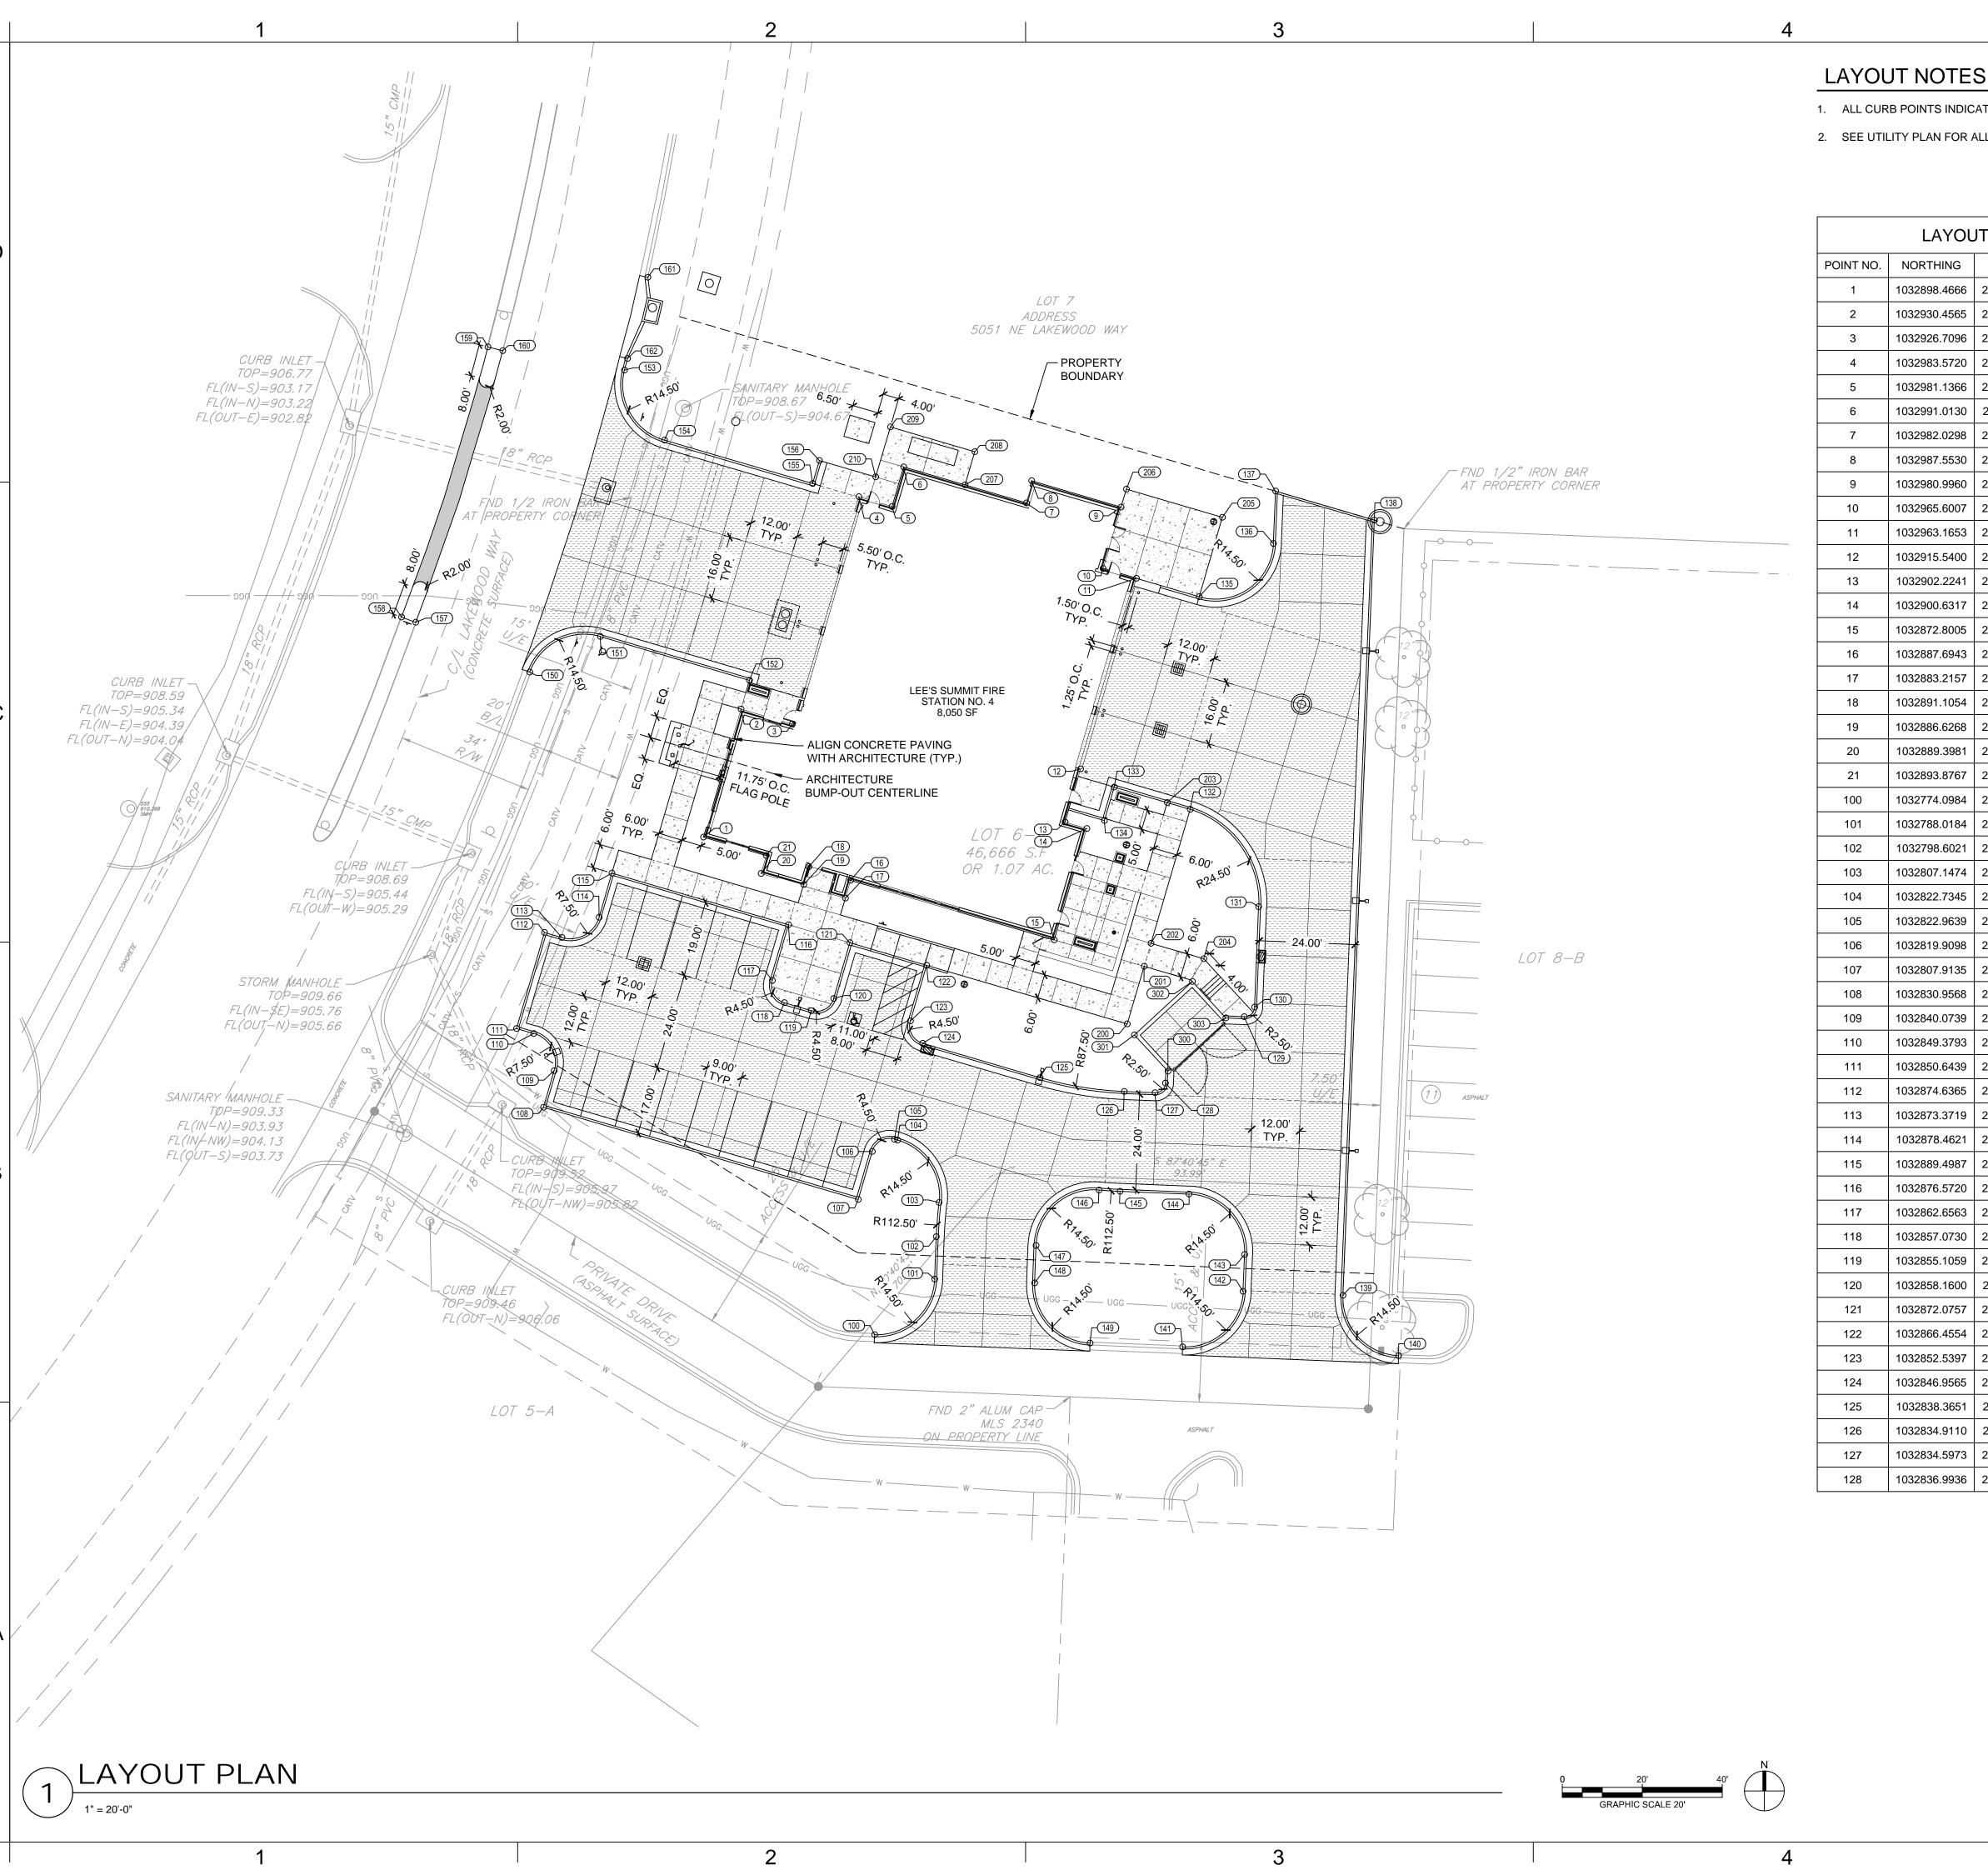
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PROJECT NO: 18225R21001 DATE: 10.19.2022

MO# PE-2022005196

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- 1. ALL CURB POINTS INDICATE BACK OF CURB UNLESS OTHERWISE NOTED.
- 2. SEE UTILITY PLAN FOR ALL UTILITY LOCATIONS AND LAYOUT.

LAYOUT TABLE						
POINT NO.	NORTHING	EASTING	DESCRIPTION			
1	1032898.4666	2830193.3865	BLDG			
2	1032930.4565	2830202.7537	BLDG			
3	1032926.7096	2830215.5497	BLDG			
4	1032983.5720	2830232.1999	BLDG			
5	1032981.1366	2830240.5173	BLDG			
6	1032991.0130	2830243.4111	BLDG			
7	1032982.0298	2830274.0899	BLDG			
8	1032987.5530	2830275.3924	BLDG			
9	1032980.9960	2830297.7855	BLDG			
10	1032965.6007	2830293.2776	BLDG			
11	1032963.1653	2830301.5950	BLDG			
12	1032915.5400	2830287.6496	BLDG			
13	1032902.2241	2830283.7505	BLDG			
14	1032900.6317	2830289.1889	BLDG			
15	1032872.8005	2830281.0396	BLDG			
16	1032887.6943	2830230.1753	BLDG			
17	1032883.2157	2830228.8639	BLDG			
18	1032891.1054	2830219.7122	BLDG			
19	1032886.6268	2830218.4008	BLDG			
20	1032889.3981	2830207.7504	BLDG			
21	1032893.8767	2830209.0618	BLDG			
100	1032774.0984	2830236.1407	CURB			
101	1032788.0184	2830251.1687	CURB			
102	1032798.6021	2830251.5850	CURB			
103	1032807.1474	2830252.2480	CURB			
104	1032822.7345	2830241.9193	CURB			
105	1032822.9639	2830241.1359	CURB			
106	1032819.9098	2830235.5527	CURB			
107	1032807.9135	2830232.0400	CURB			
108	1032830.9568	2830153.3443	CURB			
109	1032840.0739	2830156.0140	CURB			
110	1032849.3793	2830150.9238	CURB			
111	1032850.6439	2830146.6052	CURB			
112	1032874.6365	2830153.6305	CURB			
113	1032873.3719	2830157.9492	CURB			
114	1032878.4621	2830167.2546	CURB			
115	1032889.4987	2830170.4863	CURB			
116	1032876.5720	2830214.6326	CURB			
117	1032862.6563	2830210.5579	CURB			
118	1032857.0730	2830213.6120	CURB			
119	1032855.1059	2830220.3299	CURB			
120	1032858.1600	2830225.9131	CURB			
121	1032872.0757	2830229.9879	CURB			
122	1032866.4554	2830249.1819	CURB			
123	1032852.5397	2830245.1072	CURB			
124	1032846.9565	2830248.1613	CURB			
125	1032838.3651	2830277.5021	CURB			
126	1032834.9110	2830298.5431	CURB			
127	1032834.5973	2830306.2742	CURB			
	1032836.9936	2830308.8735	CURB			

LAYOUT TABLE					
POINT NO.	NORTHING	EASTING	DESCRIPTIO		
129	1032853.6174	2830328.5631	CURB		
130	1032856.0141	2830331.1625	CURB		
131	1032881.0650	2830332.1775	CURB		
132	1032905.4284	2830315.0476	CURB		
133	1032910.9977	2830296.0450	CURB		
134	1032902.6403	2830293.5978	CURB		
135	1032958.5666	2830317.3002	CURB		
136	1032971.8943	2830335.8630	CURB		
137	1032984.9734	2830336.3938	CURB		
138	1032977.7330	2830361.1205	CURB		
139	1032783.9463	2830353.2567	CURB		
140	1032768.8692	2830367.1848	CURB		
141	1032771.0685	2830313.1866	CURB		
142	1032784.9680	2830328.2776	CURB		
143	1032794.1568	2830328.6505	CURB		
144	1032809.2328	2830314.7503	CURB		
145	1032809.9316	2830297.5294	CURB		
146	1032810.2684	2830292.2719	CURB		
147	1032796.3937	2830276.5175	CURB		
148	1032787.0774	2830276.1510	CURB		
149	1032772.0204	2830290.0301	CURB		
150	1032939.7241	2830149.9055	CURB		
151	1032948.6137	2830167.5813	CURB		
152	1032937.6942	2830204.8730	CURB		
153	1033015.1953	2830173.6316	CURB		
154	1032997.7133	2830183.6113	CURB		
155	1032986.8644	2830220.6601	CURB		
156	1032992.6225	2830222.3462	CURB		
157	1032952.1542	2830121.4178	CURB		
158	1032953.4743	2830117.8512	CURB		
159	1033021.0271	2830139.4536	CURB		
160	1033020.0818	2830143.1406	CURB		
161	1033038.4377	2830179.4824	CURB		
162	1033018.1107	2830174.3714	CURB		
200	1032851.7697	2830299.3356	PAVE		
201	1032866.2054	2830303.5626	PAVE		
202	1032871.9637	2830305.2487	PAVE		
203	1032907.1191	2830309.2908	PAVE		
204	1032868.0874	2830318.4867	PAVE		
205	1032978.4404	2830323.1196	PAVE		
206	1032976.4404	2830299.0969	PAVE		
207	1032985.4745	2830258.7664	PAVE		
208	1032994.8341	2830261.2018	PAVE		
209	1033001.0165	2830240.0884	PAVE		
210	1032988.5004	2830236.4235	PAVE		
300	1032839.9703	2830309.4952	WALL		
301	1032849.0374	2830301.1351	WALL		
302	1032862.3710	2830315.5962	WALL		
303	1032853.3039	2830323.9563	WALL		



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LAYOUT PLAN

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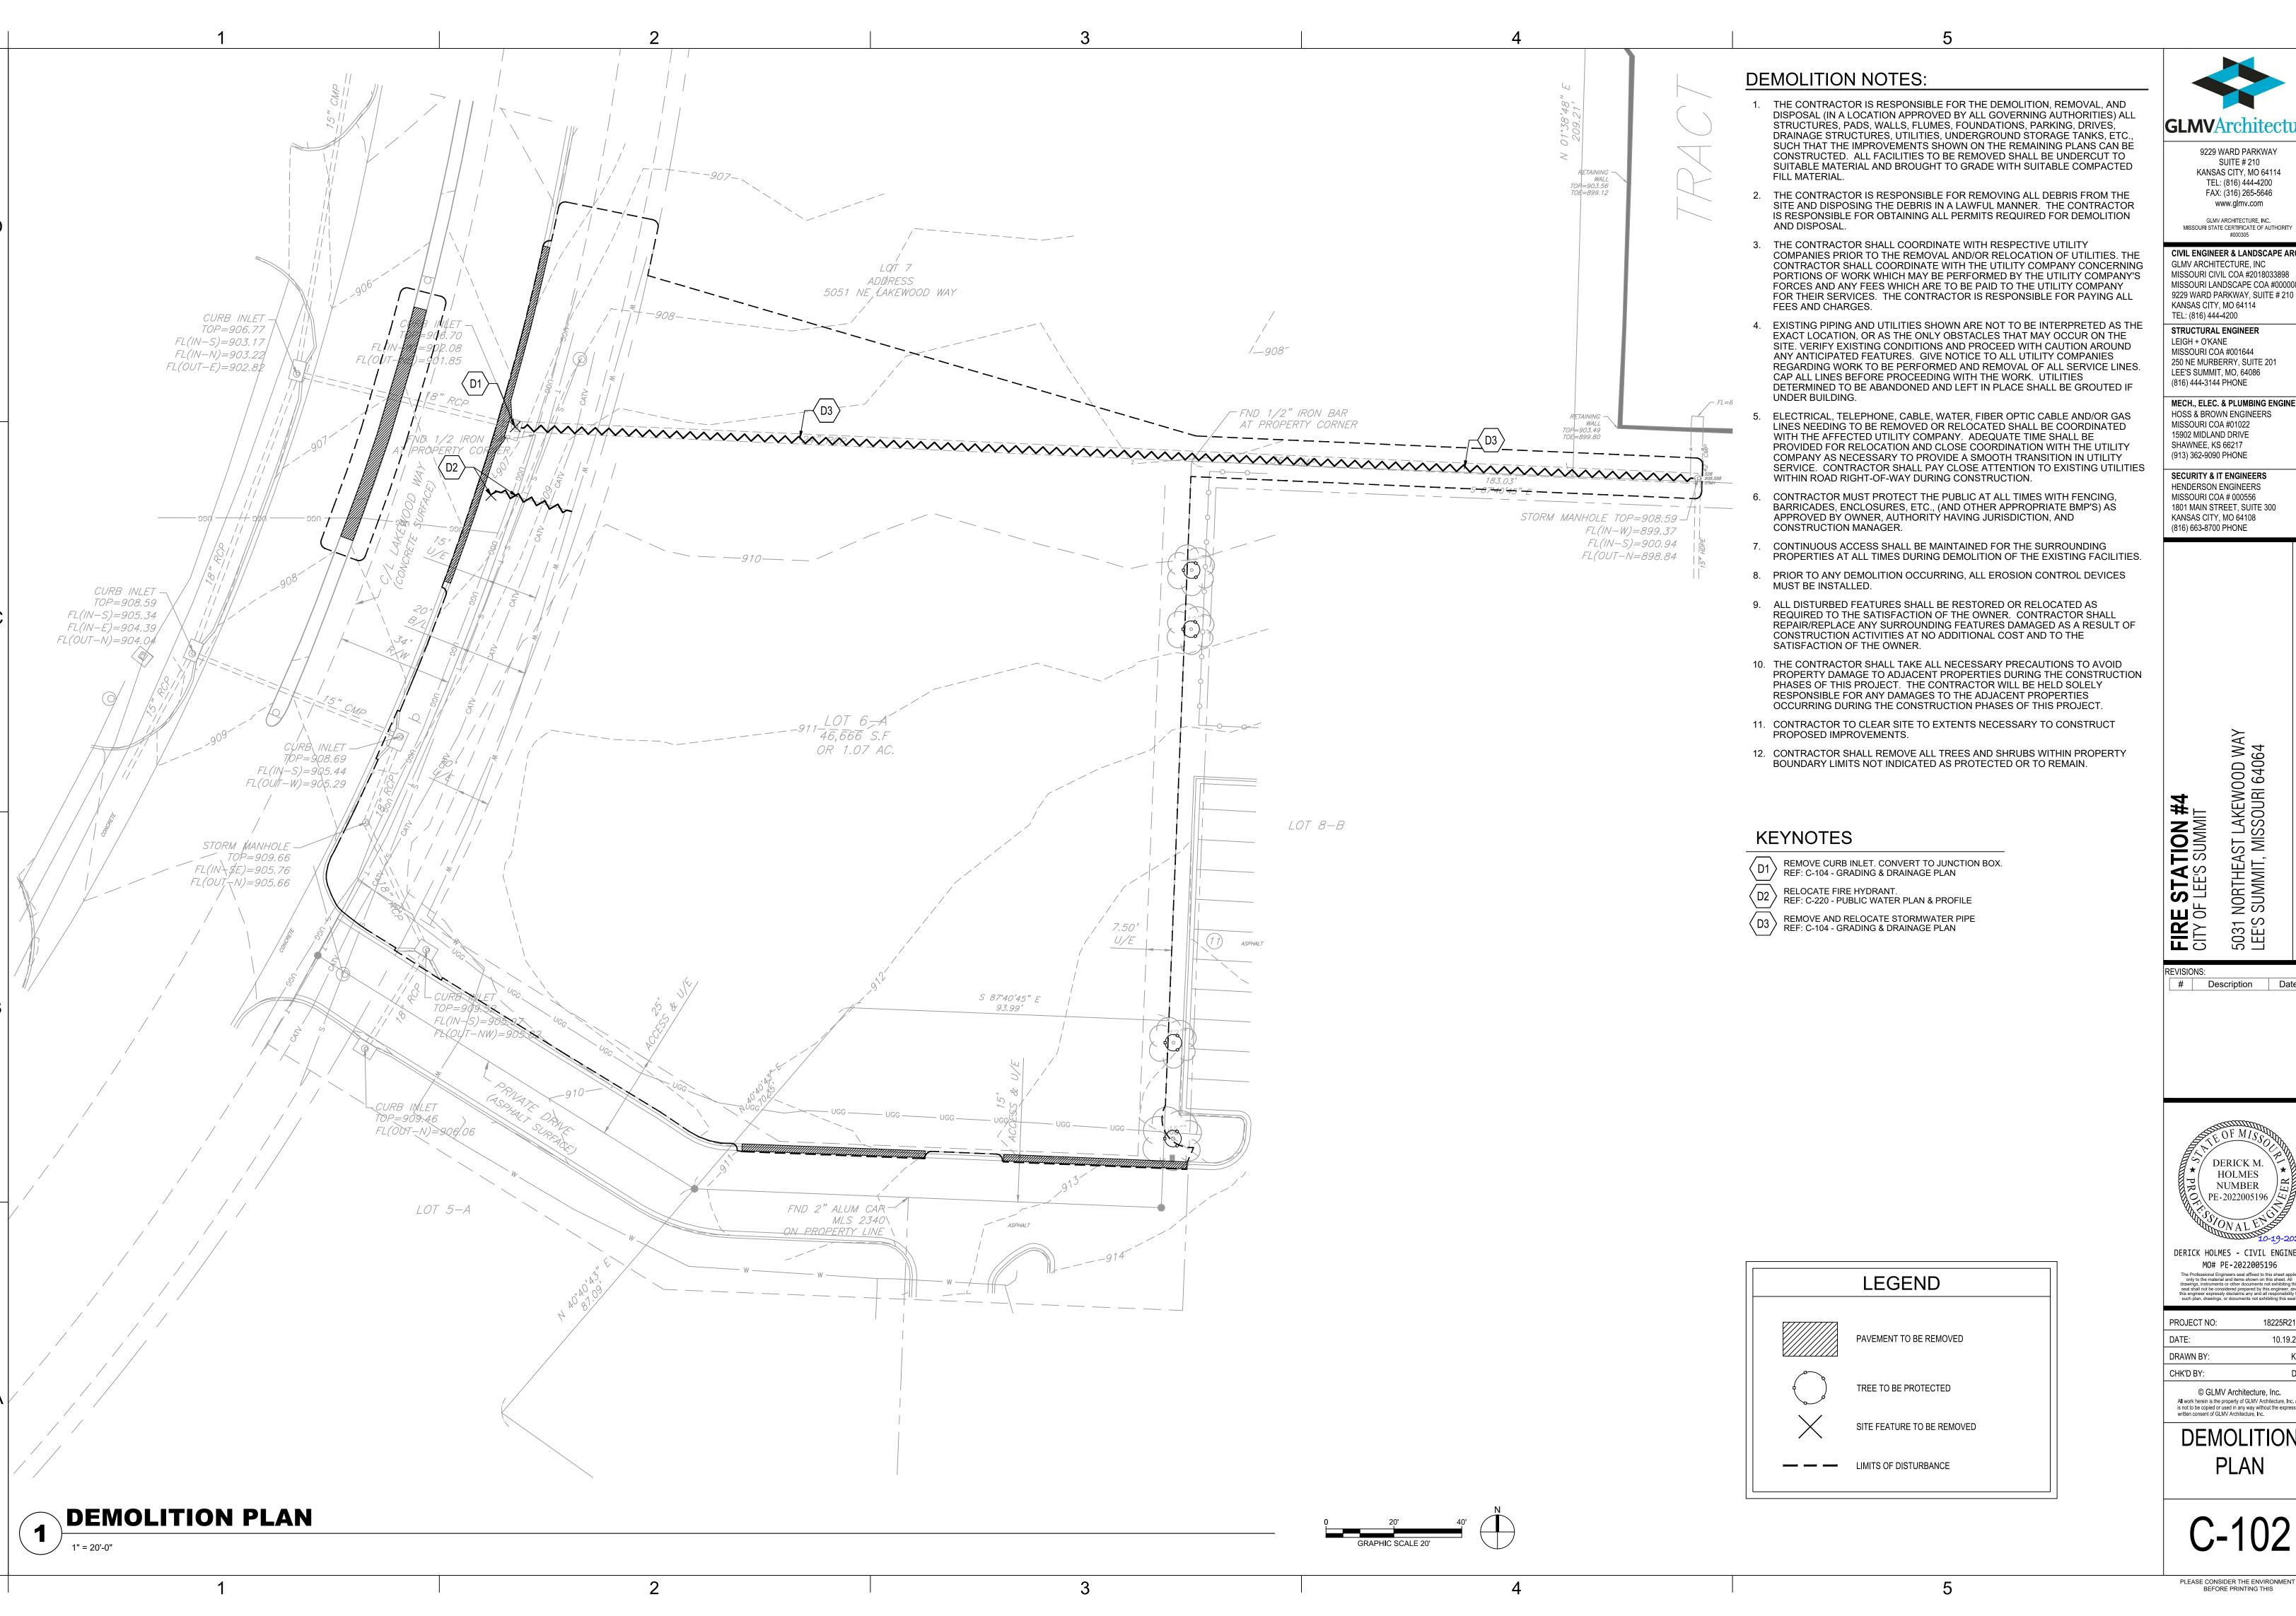
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5031 NORTHEAST LEE'S SUMMIT, M

Description

HOLMES NUMBER

DERICK HOLMES - CIVIL ENGINEER MO# PE-2022005196

18225R21001 10.19.2022

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DEMOLITION **PLAN**

GENERAL EROSION AND SEDIMENT CONTROL NOTES:

THIS SHEET OUTLINES MINIMUM STORMWATER PRACTICES TO BE FOLLOWED BY THE CONTRACTOR DURING ALL PHASES OF CONSTRUCTION OF THE PROJECT. THE CONTRACTOR WILL BE RESPONSIBLE FOR PREVENTION OF SOIL OR SEDIMENT LOSS FROM THE CONSTRUCTION SITE. THE CONTRACTOR SHALL SUBMIT A SITE-SPECIFIC SEDIMENT AND EROSION CONTROL SCHEDULE. THESE NOTES ARE TO BE USED AS A GUIDELINE ONLY. THE PROJECT IS NOT CONSIDERED COMPLETE UNTIL ALL PERMANENT EROSION AND SEDIMENT CONTROLS AND STORMWATER MANAGEMENT PRACTICES ARE IN PLACE TO THE SATISFACTION OF THE OWNER AND ENGINEER. ALL TEMPORARY PRACTICES MUST BE PROPERLY REMOVED.

IN ACCORDANCE WITH LOCAL AND STATE REGULATIONS PURSUANT TO THE GENERAL NPDES PERMIT FOR CONSTRUCTION STORMWATER, A STORMWATER POLLUTION PREVENTION PLAN (SWPPP) HAS BEEN DEVELOPED FOR THIS SITE. THE PLAN WAS DEVELOPED TO MINIMIZE THE EFFECTS OF SOIL EROSION AND RESULTING SEDIMENT LOSS. PREVENTION WILL BE PROVIDED THROUGH THE USE OF PROPER CONSTRUCTION TECHNIQUES. THESE TECHNIQUES WILL INCLUDE BOTH TEMPORARY AND PERMANENT MANAGEMENT PRACTICES. TO PREVENT EROSION AND SEDIMENT FROM LEAVING THE CONSTRUCTION SITE. THE FOLLOWING STEPS SHALL BE TAKEN DURING CONSTRUCTION:

- 1. PRIOR TO STARTING ANY SOIL DISTURBING ACTIVITIES, THE CONTRACTOR SHALL INSTALL PERIMETER EROSION AND SEDIMENT CONTROL MEASURES AND GRAVEL CONSTRUCTION ENTRANCES.
- 2. THE RECOMMENDED SEQUENCE OF CONSTRUCTION ACTIVITIES AND OF THE INSTALLATION AND REMOVAL OF **EROSION AND SEDIMENT CONTROL MEASURES IS AS FOLLOWS:**
- 2.1. INSTALL TEMPORARY GRAVEL CONSTRUCTION ENTRANCES
- 2.2. INSTALL TEMPORARY PERIMETER SILT FENCE
- 2.3. INSTALL TEMPORARY EXISTING CURB INLET PROTECTION
- 2.5. INSTALL PROTECTION FOR NEWLY INSTALLED CURB INLETS, AREA INLETS, AND JUNCTION BOXES
- 2.6. INSTALL EROSION AND SEDIMENT CONTROL BLANKETS
- 2.7. SEED, FERTILIZE, AND MULCH ALL SLOPES AND DISTURBED AREAS 2.8. REMOVE TEMPORARY PRACTICES, PERIMETER CONTROLS, AND SITE CLEANUP.
- EROSION AND SEDIMENT CONTROL DEVICES SHALL BE CONSTRUCTED IN ACCORDANCE WITH THE KANSAS CITY METRO CHAPTER OF THE AMERICAN PUBLIC WORKS ASSOCIATION. INSTALL SILT FENCE AT INDICATED LOCATIONS AND OTHER LOCATIONS AS DIRECTED BY THE ENGINEER TO CONTROL SOIL EROSION. SILT FENCE SHALL BE KEPT IN
- CONSTRUCTION ENTRANCE SHALL BE MAINTAINED BY THE CONTRACTOR IN A CONDITION THAT WILL PREVENT TRACKING OR FLOWING OF SEDIMENT ONTO PUBLIC RIGHT-OF-WAYS AND PAVED STREETS. THIS MAY INCLUDE PERIODIC TOP DRESSING WITH ADDITIONAL CRUSHED STONE AS CONDITIONS WARRANT. REPAIR OF ENTRANCE(S) AND CLEANING OF RIGHT-OF-WAYS AND PAVED STREETS THAT HAVE BEEN SOILED BY CONSTRUCTION ACTIVITIES SHALL BE THE CONTRACTOR'S RESPONSIBILITY.
- DURING ALL SOIL DISTURBING ACTIVITIES, THE CONTRACTOR SHALL TAKE APPROPRIATE STEPS USING ACCEPTED CONSTRUCTION METHODS TO MINIMIZE THE TIME OF EXPOSURE OF UNPROTECTED SOIL AND OTHER CONSTRUCTION MATERIALS TO RAINFALL. PARTICULAR CARE MUST BE EXERCISED WHEN DEALING WITH STOCKPILES OF TOPSOIL OR FILL MATERIALS AND WITH SOIL ON SLOPES.
- 6. SOIL STOCKPILED FOR MORE THAN 7 DAYS WILL HAVE SILT FENCE PLACED ON THE DOWNHILL SIDE TO TRAP
- 7. NO GROUND SHALL BE LEFT DISTURBED FOR MORE THAN 14 DAYS OF NON-ACTIVITY WITHOUT BEING TEMPORARILY MULCHED AND/OR SEEDED.
- 8. EROSION CONTROLS SHALL BE INSPECTED AND MAINTAINED BY THE CONTRACTOR NOT LESS THAN WEEKLY AND WITHIN 24 HOURS AFTER A RAINFALL EVENT OF 0.5 INCHES OR MORE. MAINTENANCE SHALL INCLUDE BUT NOT BE LIMITED TO SEDIMENT REMOVAL AND SILT FENCE REPAIR AND/OR REPLACEMENT.
- 9. WHENEVER DIRT, ROCK, OR OTHER MATERIALS ARE EXPORTED FOR PLACEMENT IN AREAS OFF THE PRIMARY CONSTRUCTION SITE. THE CONTRACTOR IS RESPONSIBLE FOR DETERMINING THAT ALL JURISDICTIONAL AUTHORITY REQUIREMENTS ARE MET. PRIOR TO THE REMOVAL OF ANY MATERIALS FROM THE SITE THE CONTRACTOR WILL FURNISH THE ENGINEER WITH A WRITTEN AGREEMENT, SIGNED BY EACH LANDOWNER WHO WILL RECEIVE EXPORTED MATERIALS, STATING THAT THE RECEIVING SITE WILL BE PROPERLY PERMITTED, WHEN REQUIRED.
- 10. CONTRACTOR SHALL BE RESPONSIBLE FOR ALL COSTS AND EXPENSES OF PROVIDING EROSION AND SEDIMENT CONTROL MEASURES.
- 11. CONTRACTOR SHALL KEEP A WRITTEN LOG OF WHEN CONSTRUCTION ACTIVITIES BEGIN, EROSION AND SEDIMENT CONTROLS ARE INSTALLED, INSPECTED, AND REPAIRED. COPIES OF LOG SHALL BE FURNISHED TO THE ENGINEER.
- 12. EROSION AND SEDIMENT CONTROL MEASURES SHALL BE REMOVED UPON STABILIZATION OF DISTURBED AREAS.

EROSION CONTROL KEYNOTES

E1 SILT FENCE REF: 3 / C-510

E2 AREA INLET AND JUNCTION BOX PROTECTION REF: 1 / C-511

E3 CONCRETE WASHOUT REF: 1 / C-510

E4 CURB INLET PROTECTION REF: 4 / C-510

REF: 2 / C-510

E5 CONSTRUCTION ENTRANCE REF: 1 / C-510

⟨E6⟩ TEMPORARY EROSION CONTROL BLANKET

 \langle E7 angle LIMITS OF DISTURBANCE



CURB INLET PROTECTION

CONSTRUCTION ENTRANCE

TEMPORARY EROSION CONTROL BLANKET

EROSION CONTROL PLAN

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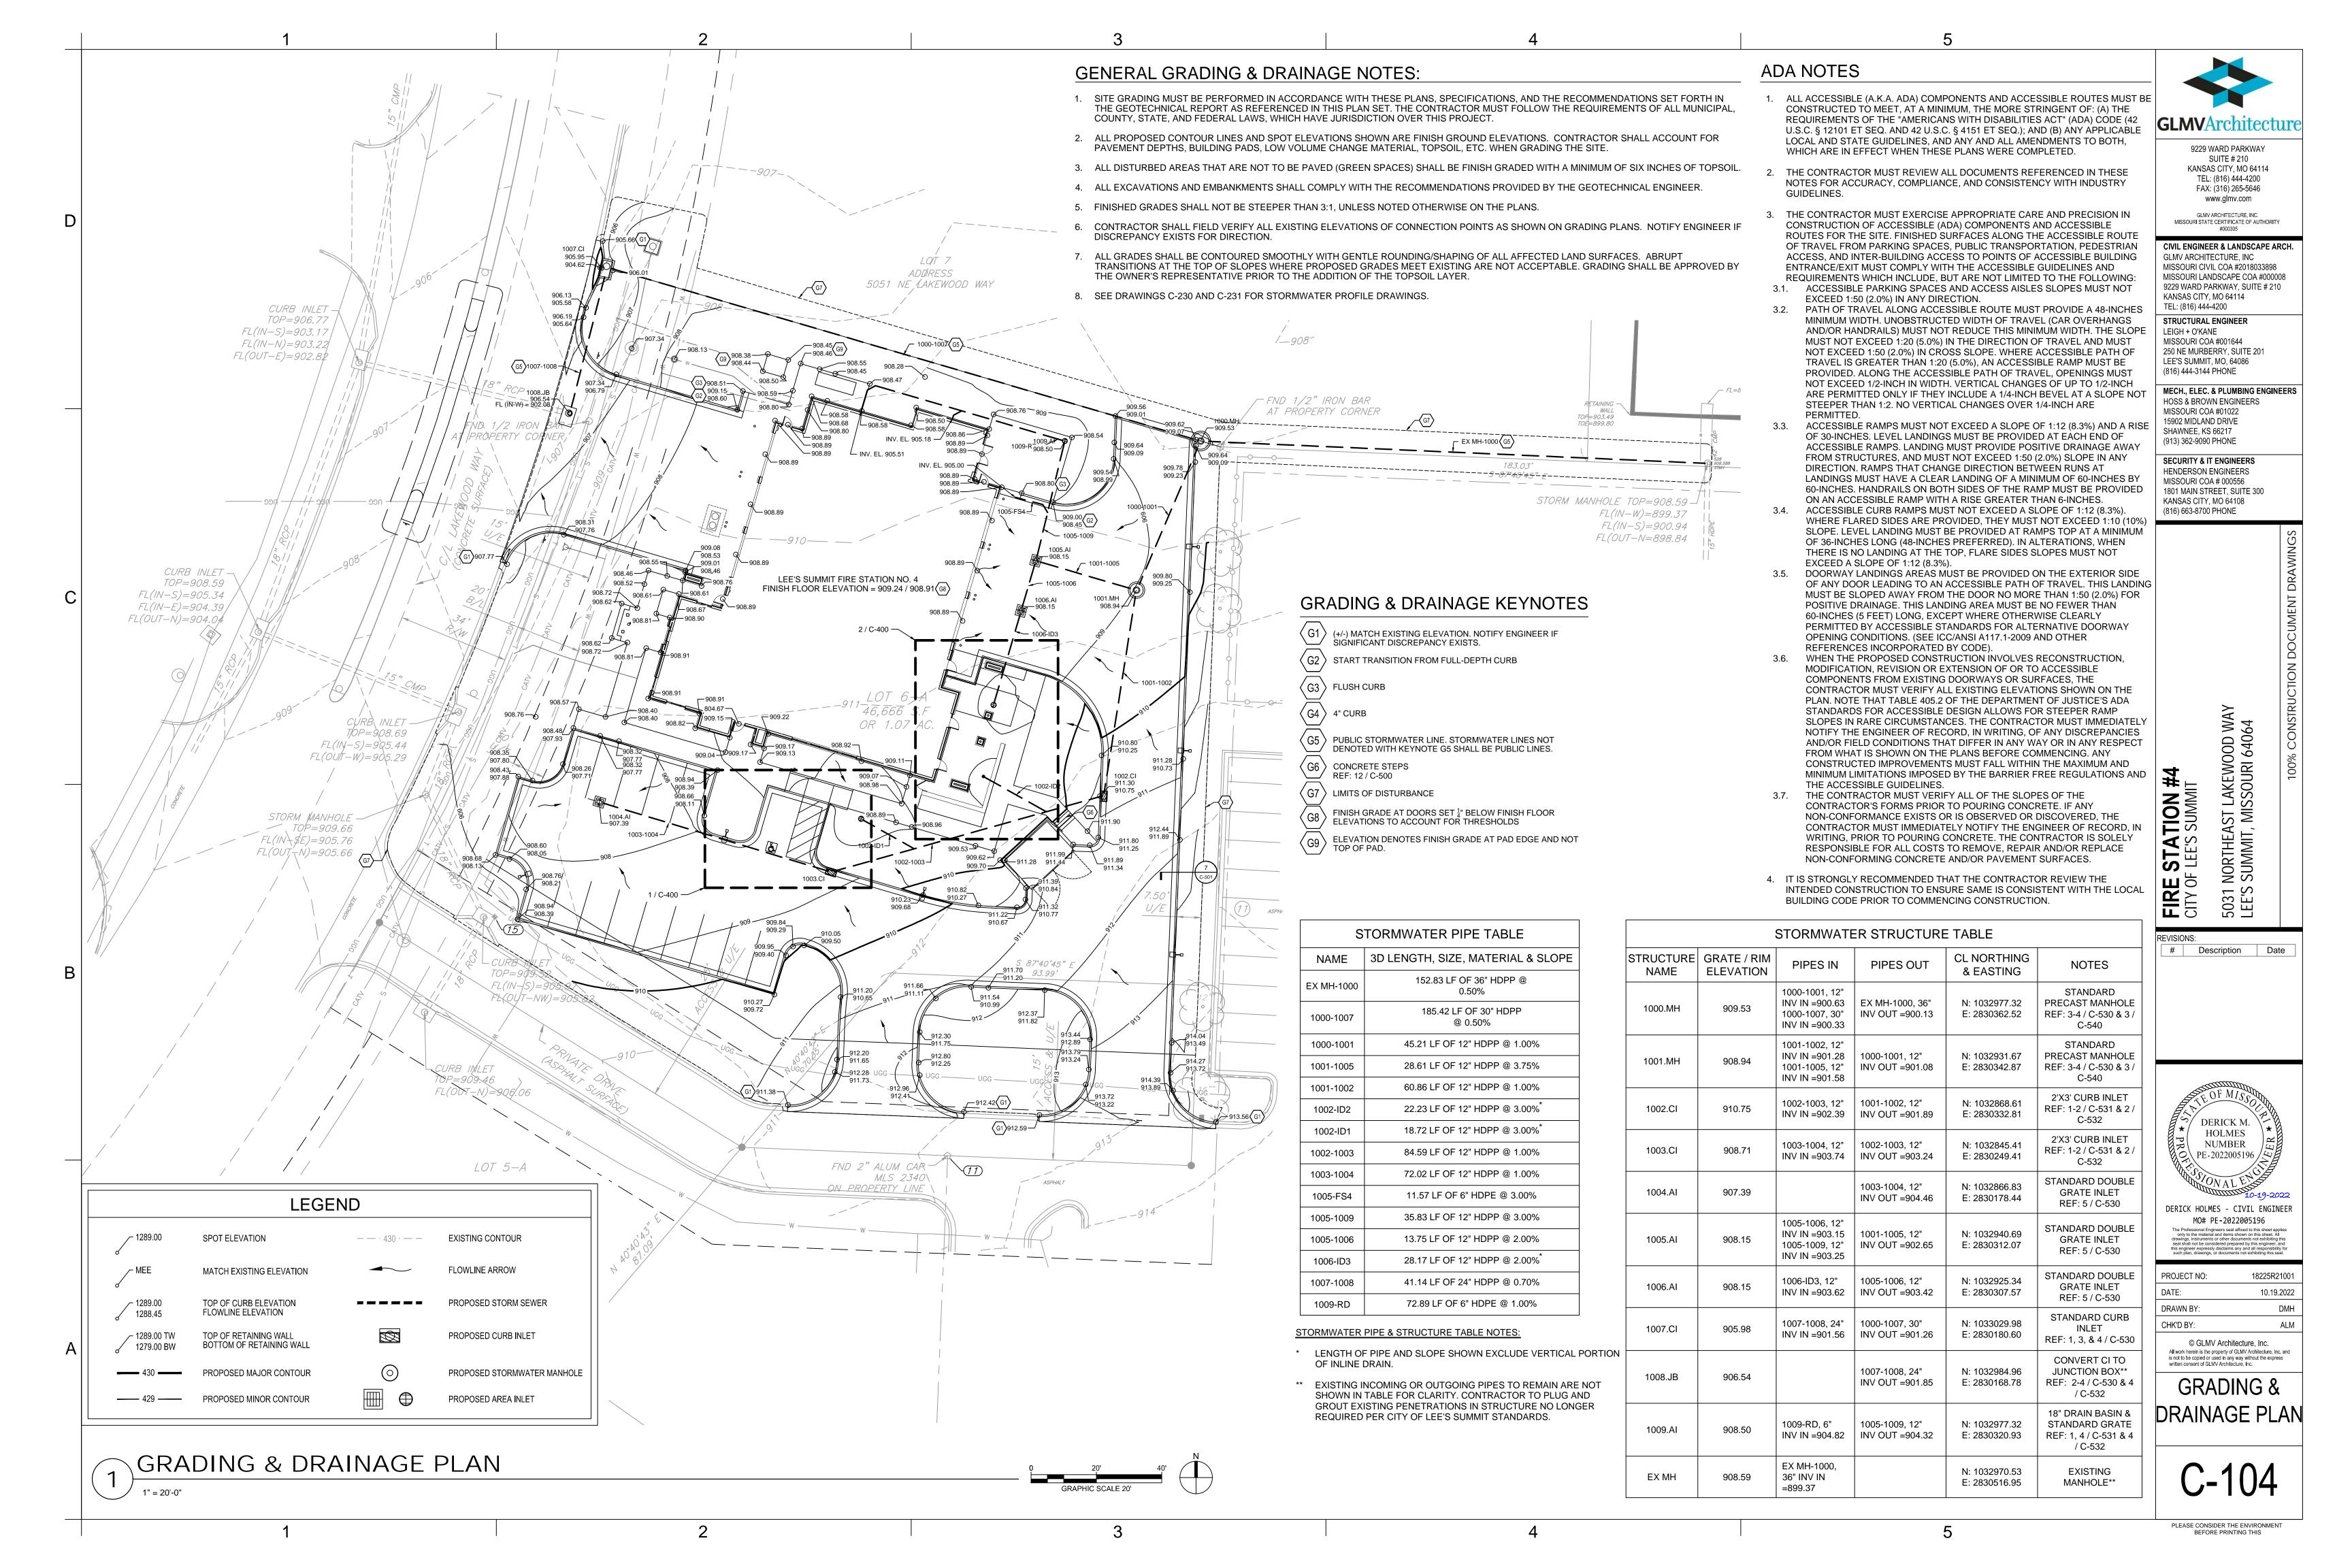
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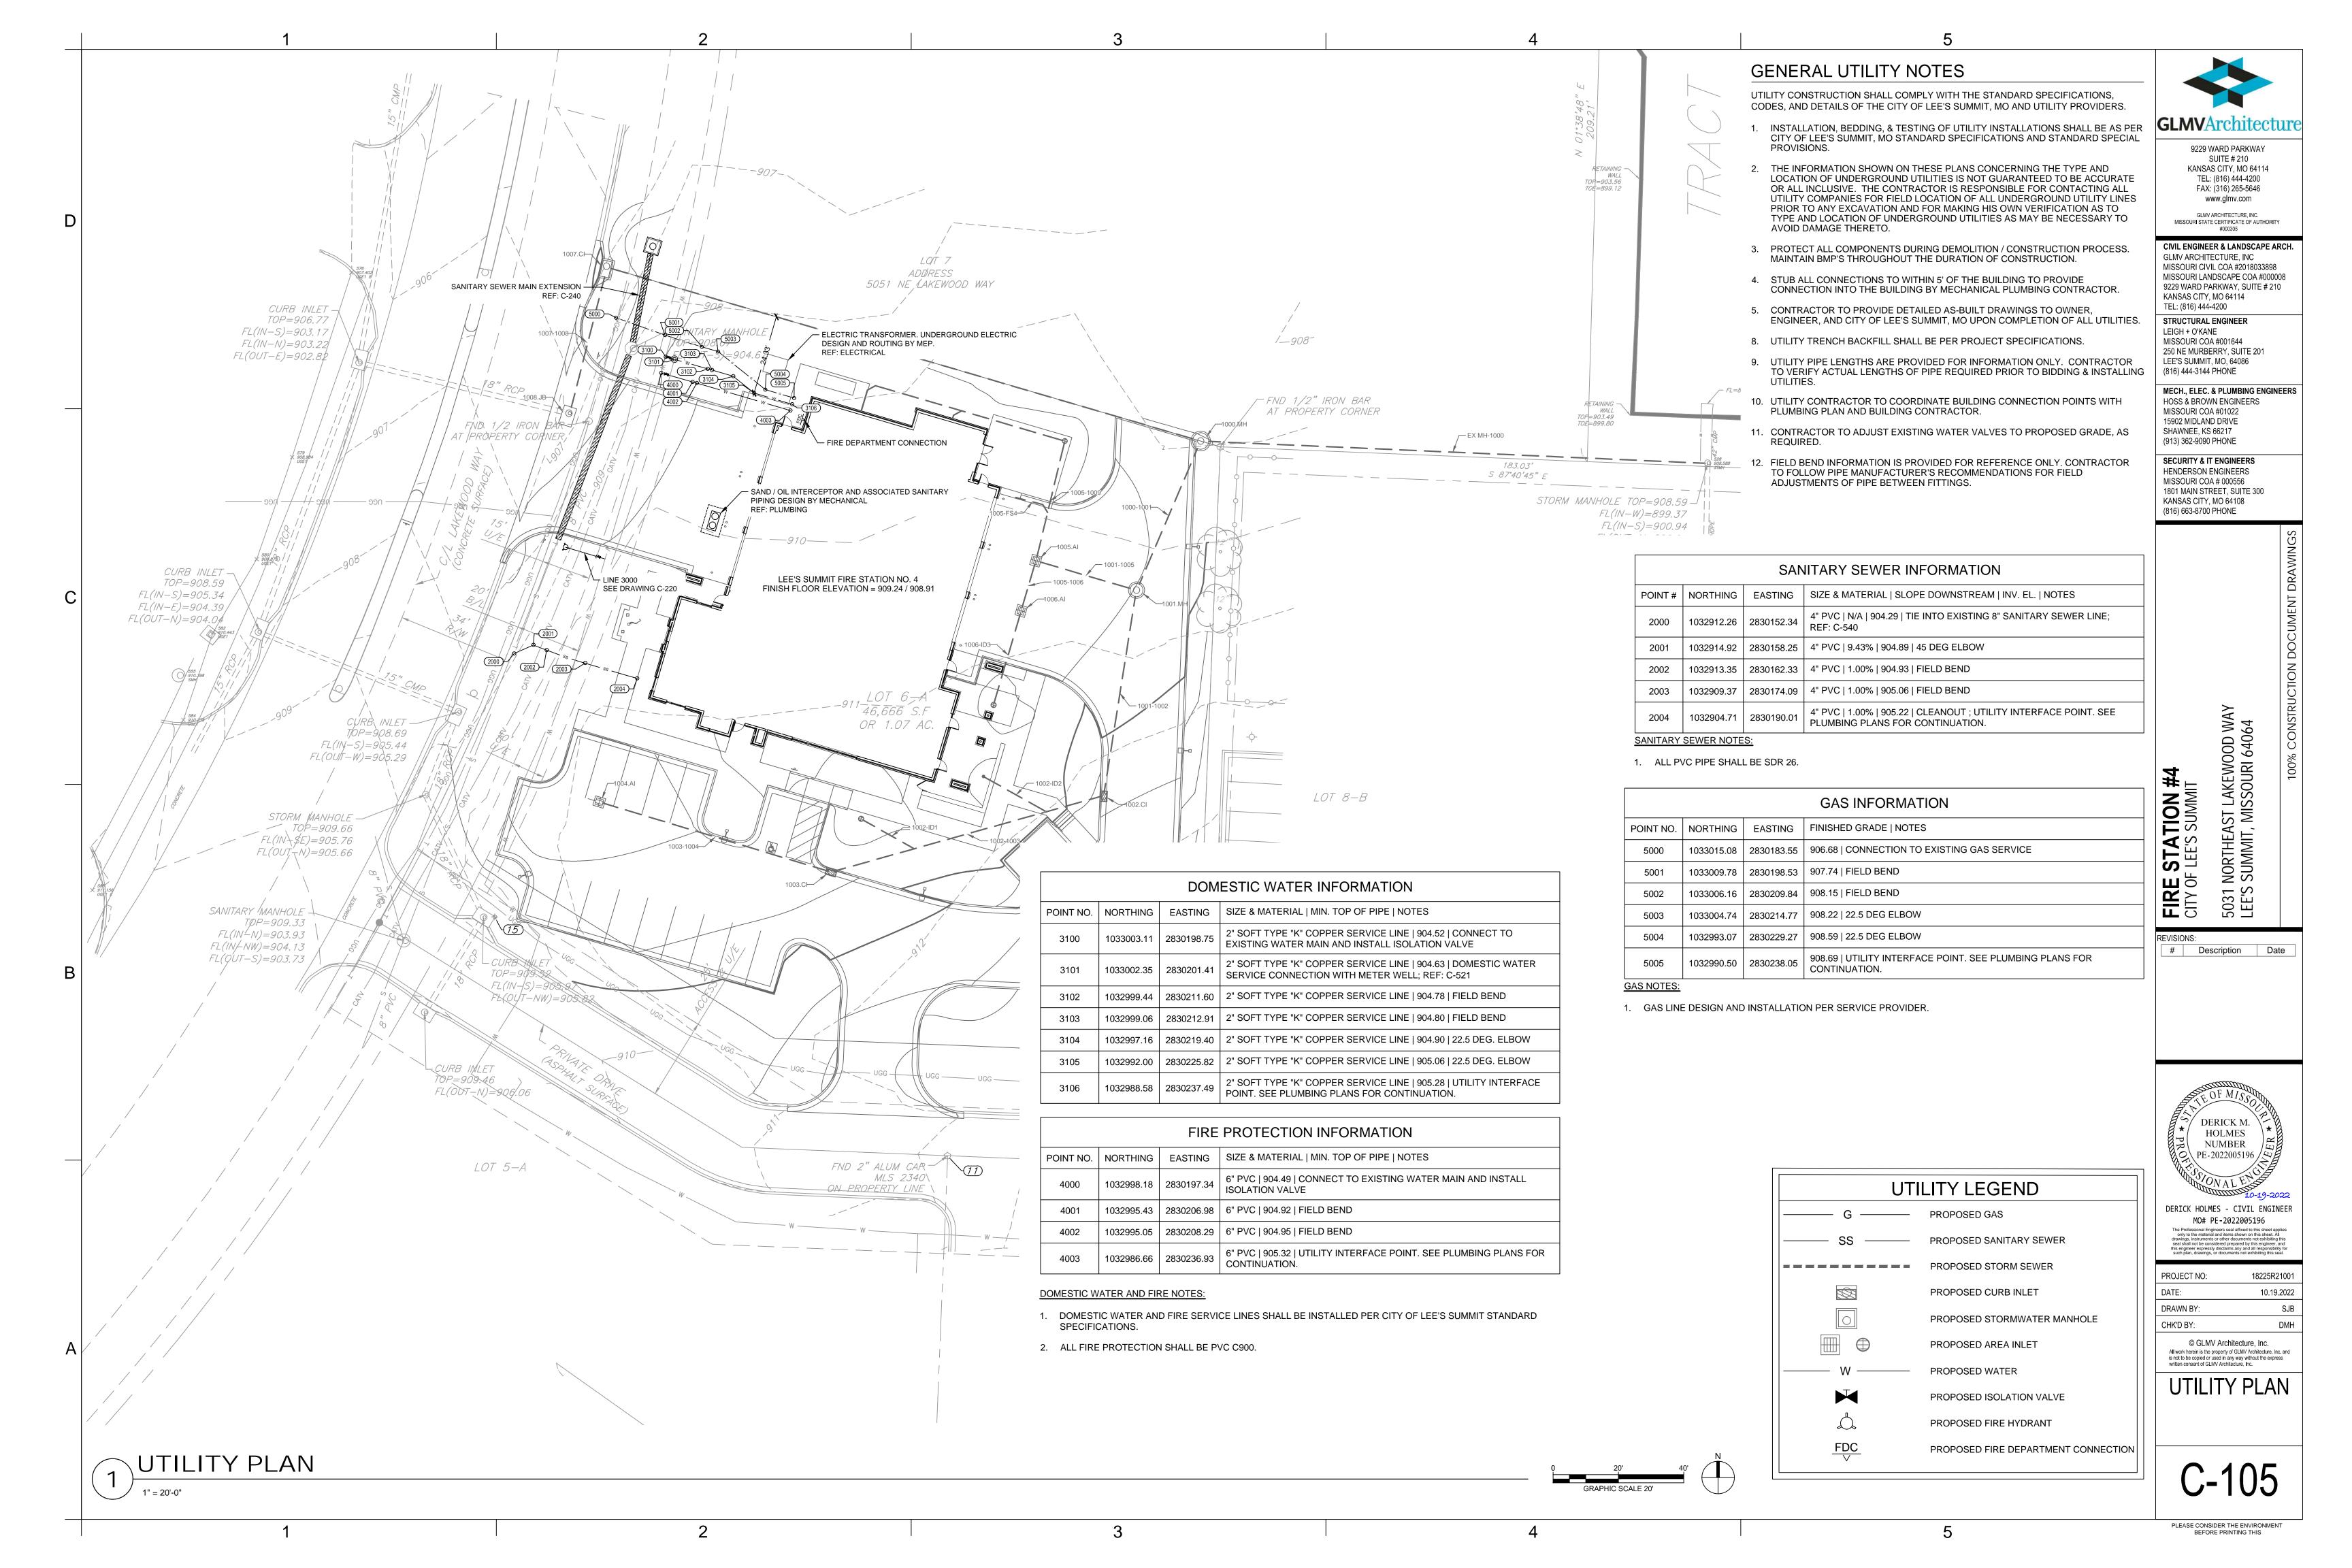
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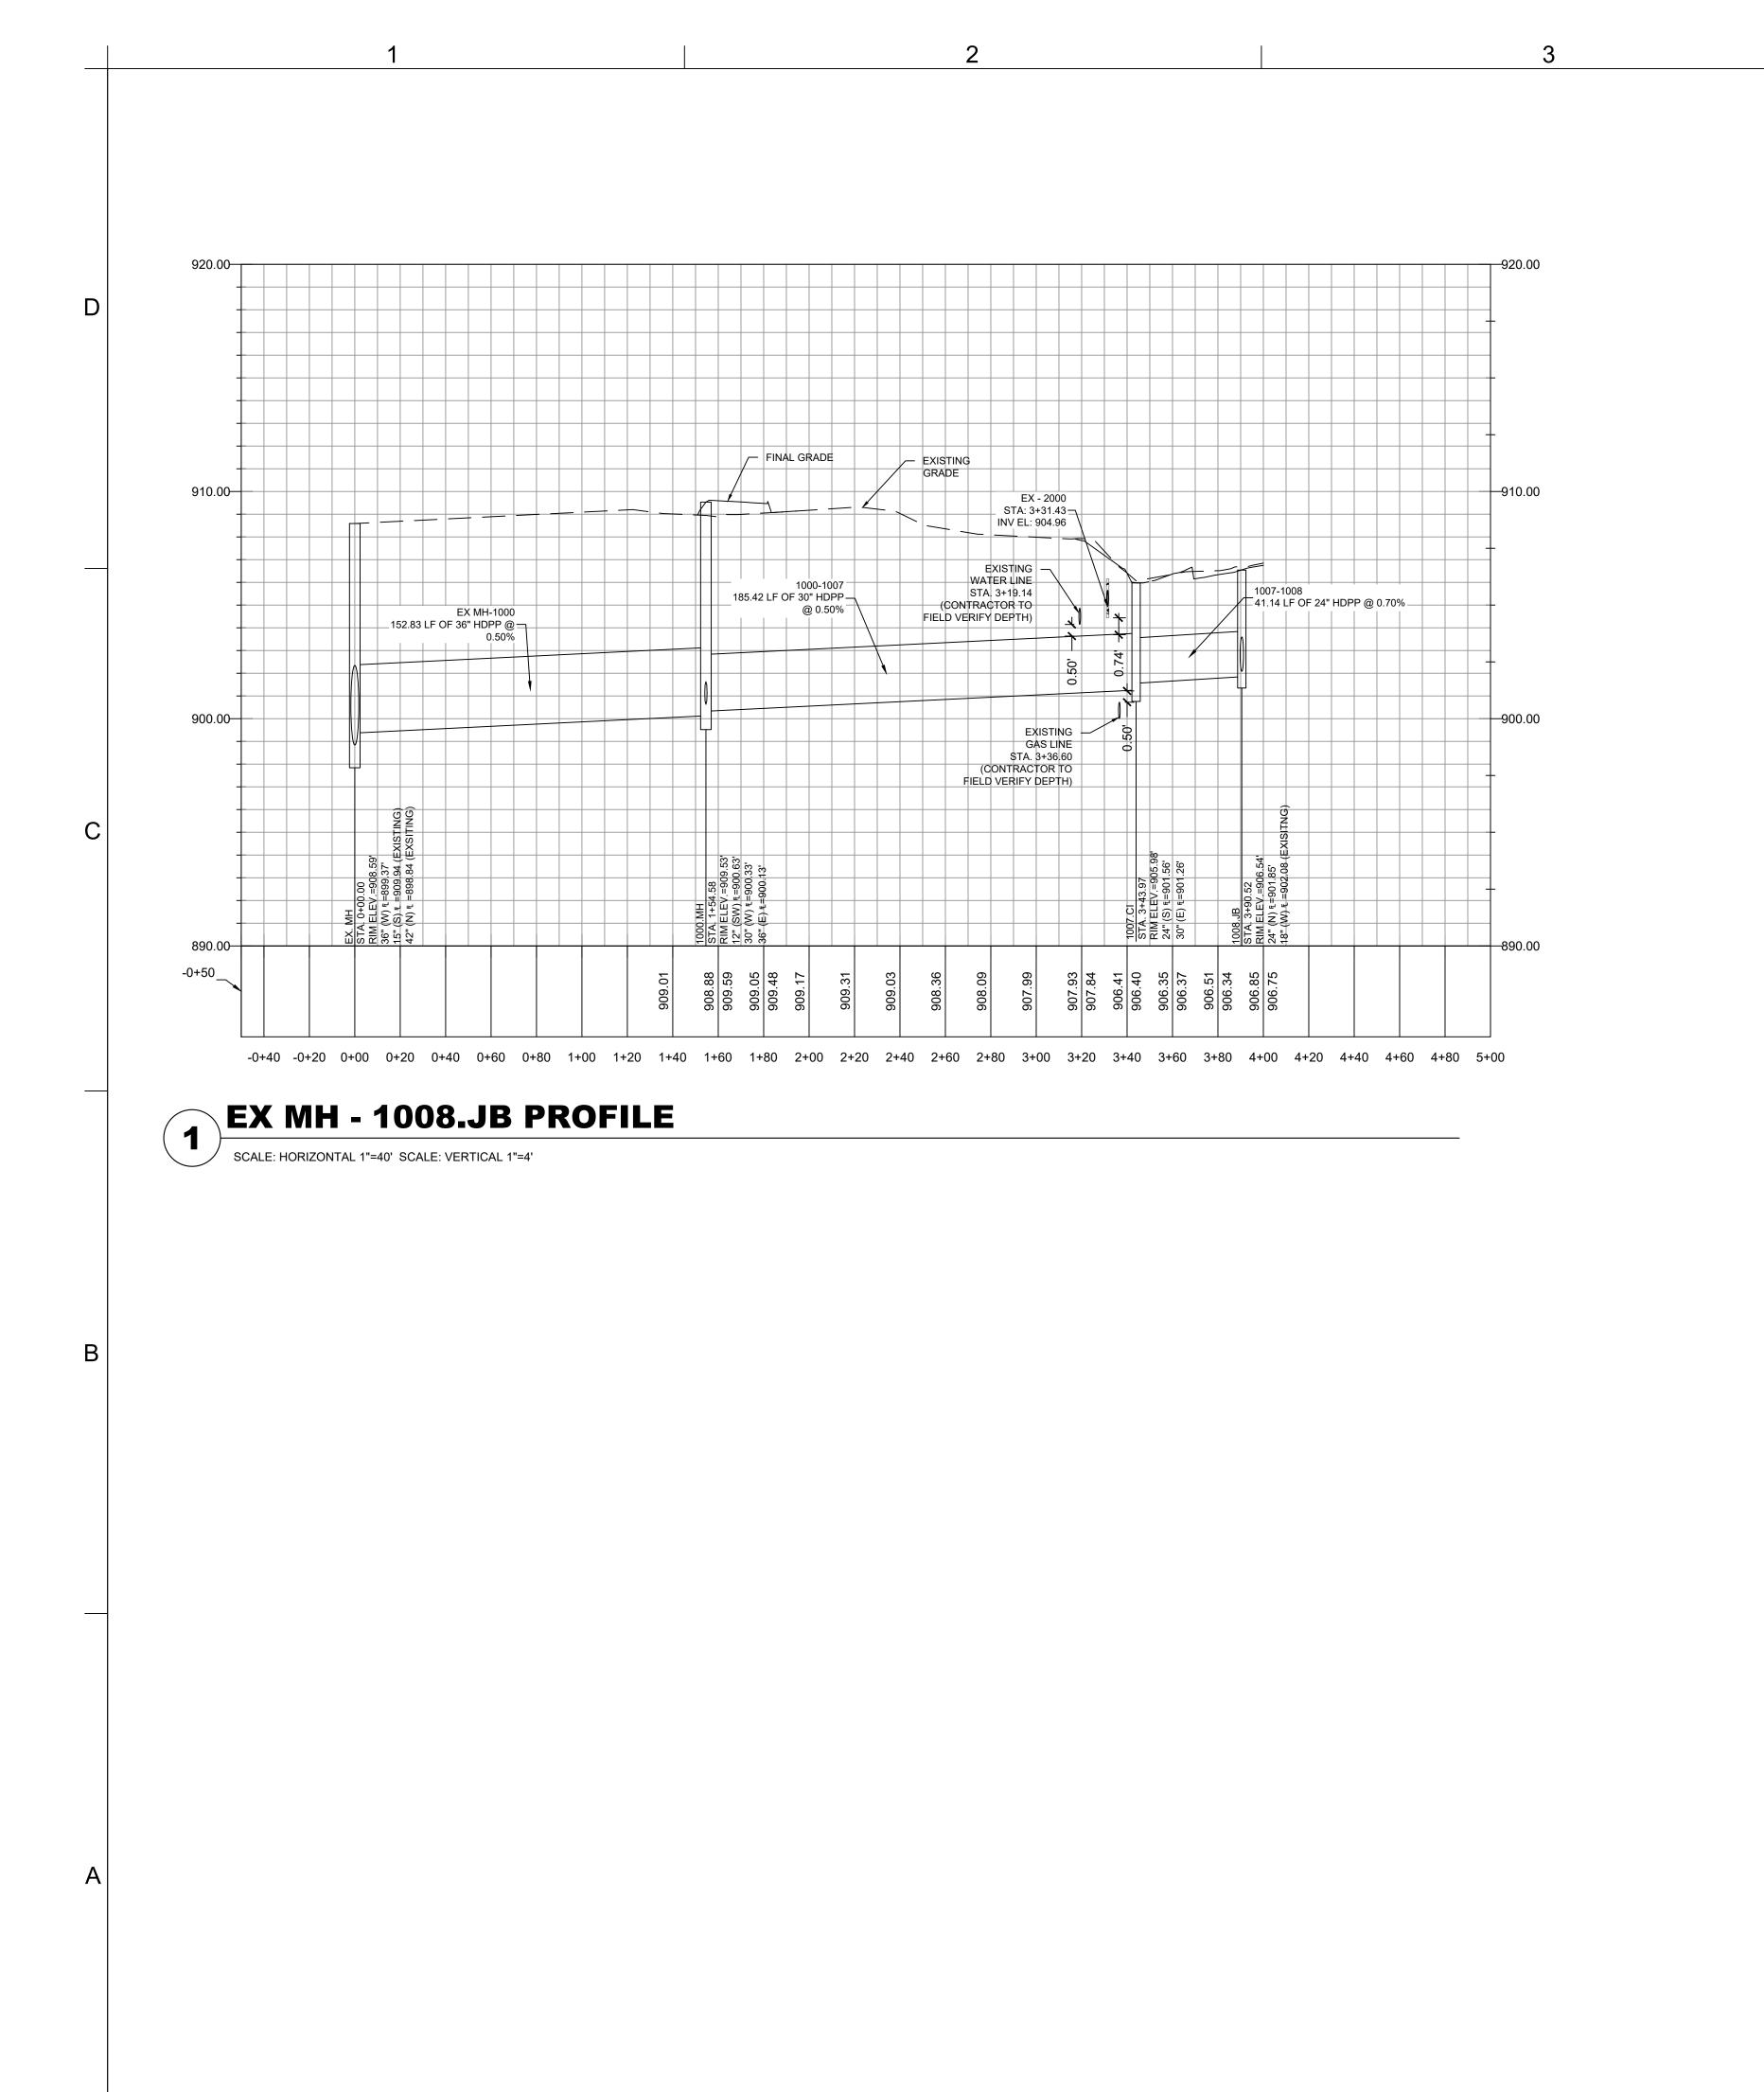
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GENERAL NOTES:

- 1. SEE DRAWING C-104 FOR GENERAL NOTES APPLICABLE TO THIS DRAWING.
- 2. ALL STORMWATER STRUCTURES AND PIPES SHOWN ON THIS DRAWING ARE PUBLIC, UNLESS NOTED OTHERWISE.



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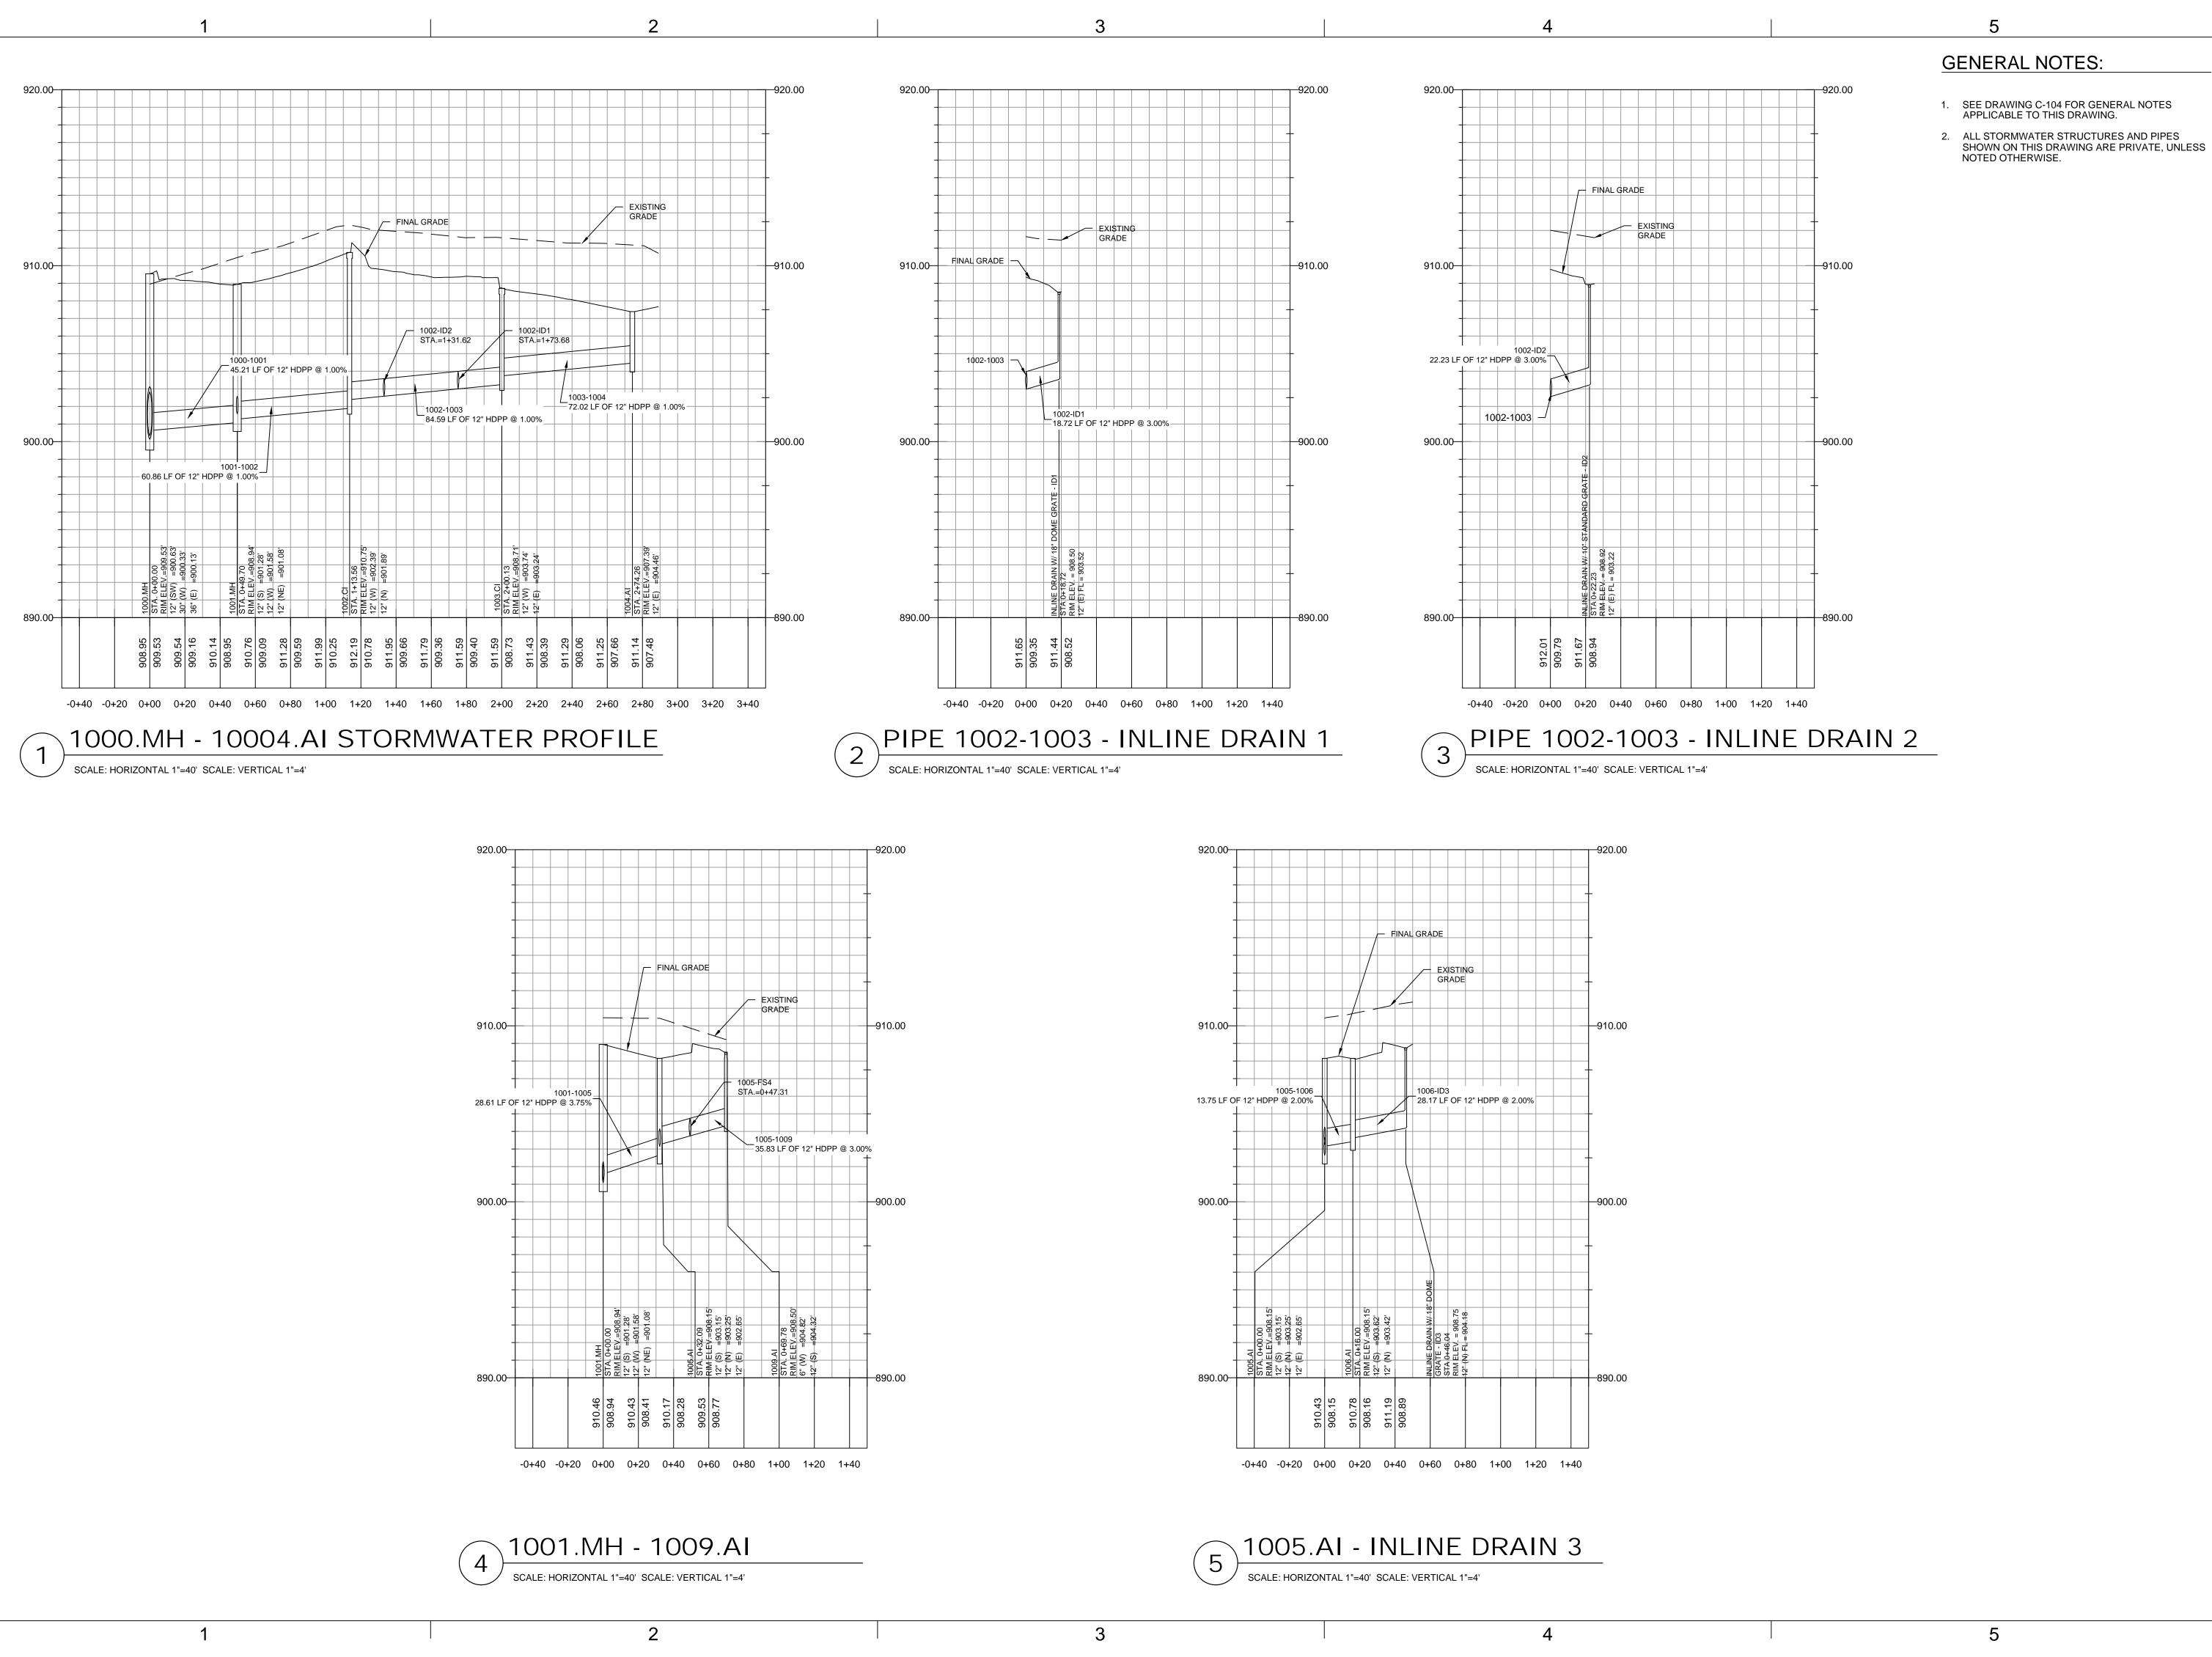
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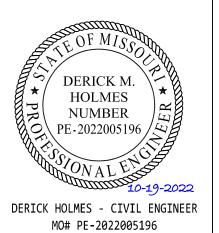
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GENERAL NOTES: 1. SEE DRAWING C-105 FOR GENERAL NOTES APPLICABLE TO THIS DRAWING. 2. ADJUST EXISTING MH RIM ELEVATION TO NEW PROPOSED GRADE. 3. INSTALL STANDARD SHALLOW PRECAST MANHOLE. REF: 4 / C-540 TEL: (816) 444-4200 HOSS & BROWN ENGINEERS MISSOURI COA #01022 15902 MIDLAND DRIVE SHAWNEE, KS 66217 EX SS MH 1 EX SS MH 2 -PI: 1+94.20 / SS MH 2000 -LEE'S SUMMIT FIRE STATION NO. 4 FIRE STATION # | Le x EXISTING 18" RCP STA 0+34.81 INV EL: 905.78 REVISIONS: 910.00 910.00 SEE NOTE 2 EXISTING GRADE EX - 2000 27.92 L.F 8" PVC @ 0.50% PROPOSED _ CONCRETE ENCASEMENT PROPOSED -4" BLDG. CONNECTION STA 0+94.12 PROPOSED GAS LINE REF: C-105 _ REF: C-105 900.00 900.00 1000-1007 PROPOSED _ CONCRETE ENCASEMENT _ STA 1+31.66 STA: 2+15.49 INV EL: 901.20 REF: 2 / C-540 -890.00 -0+20 0+00 0+20 0+40 0+60 0+80 1+00 1+20 1+40 1+60 1+80 2+00 2+20 2+40 SANITARY SEWER MAIN PLAN & PROFILE SCALE: HORIZONTAL 1"= 40' SCALE: VERTICAL 1"= 4'

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STRUCTURAL ENGINEER LEIGH + O'KANE MISSOURI COA #001644 250 NE MURBERRY, SUITE 201

LEE'S SUMMIT, MO, 64086 (816) 444-3144 PHONE MECH., ELEC. & PLUMBING ENGINEERS

(913) 362-9090 PHONE SECURITY & IT ENGINEERS HENDERSON ENGINEERS

MISSOURI COA # 000556 1801 MAIN STREET, SUITE 300 KANSAS CITY, MO 64108 (816) 663-8700 PHONE

Description Date

DERICK M. HOLMES NUMBER PE-2022005196


DERICK HOLMES - CIVIL ENGINEER MO# PE-2022005196

PROJECT NO:	18225R21001
DATE:	10.19.2022
DRAWN BY:	HFL
CHK'D BY:	DMH

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MISSOURI COA #001644 250 NE MURBERRY, SUITE 201

MECH., ELEC. & PLUMBING ENGINEERS

SECURITY & IT ENGINEERS 1801 MAIN STREET, SUITE 300

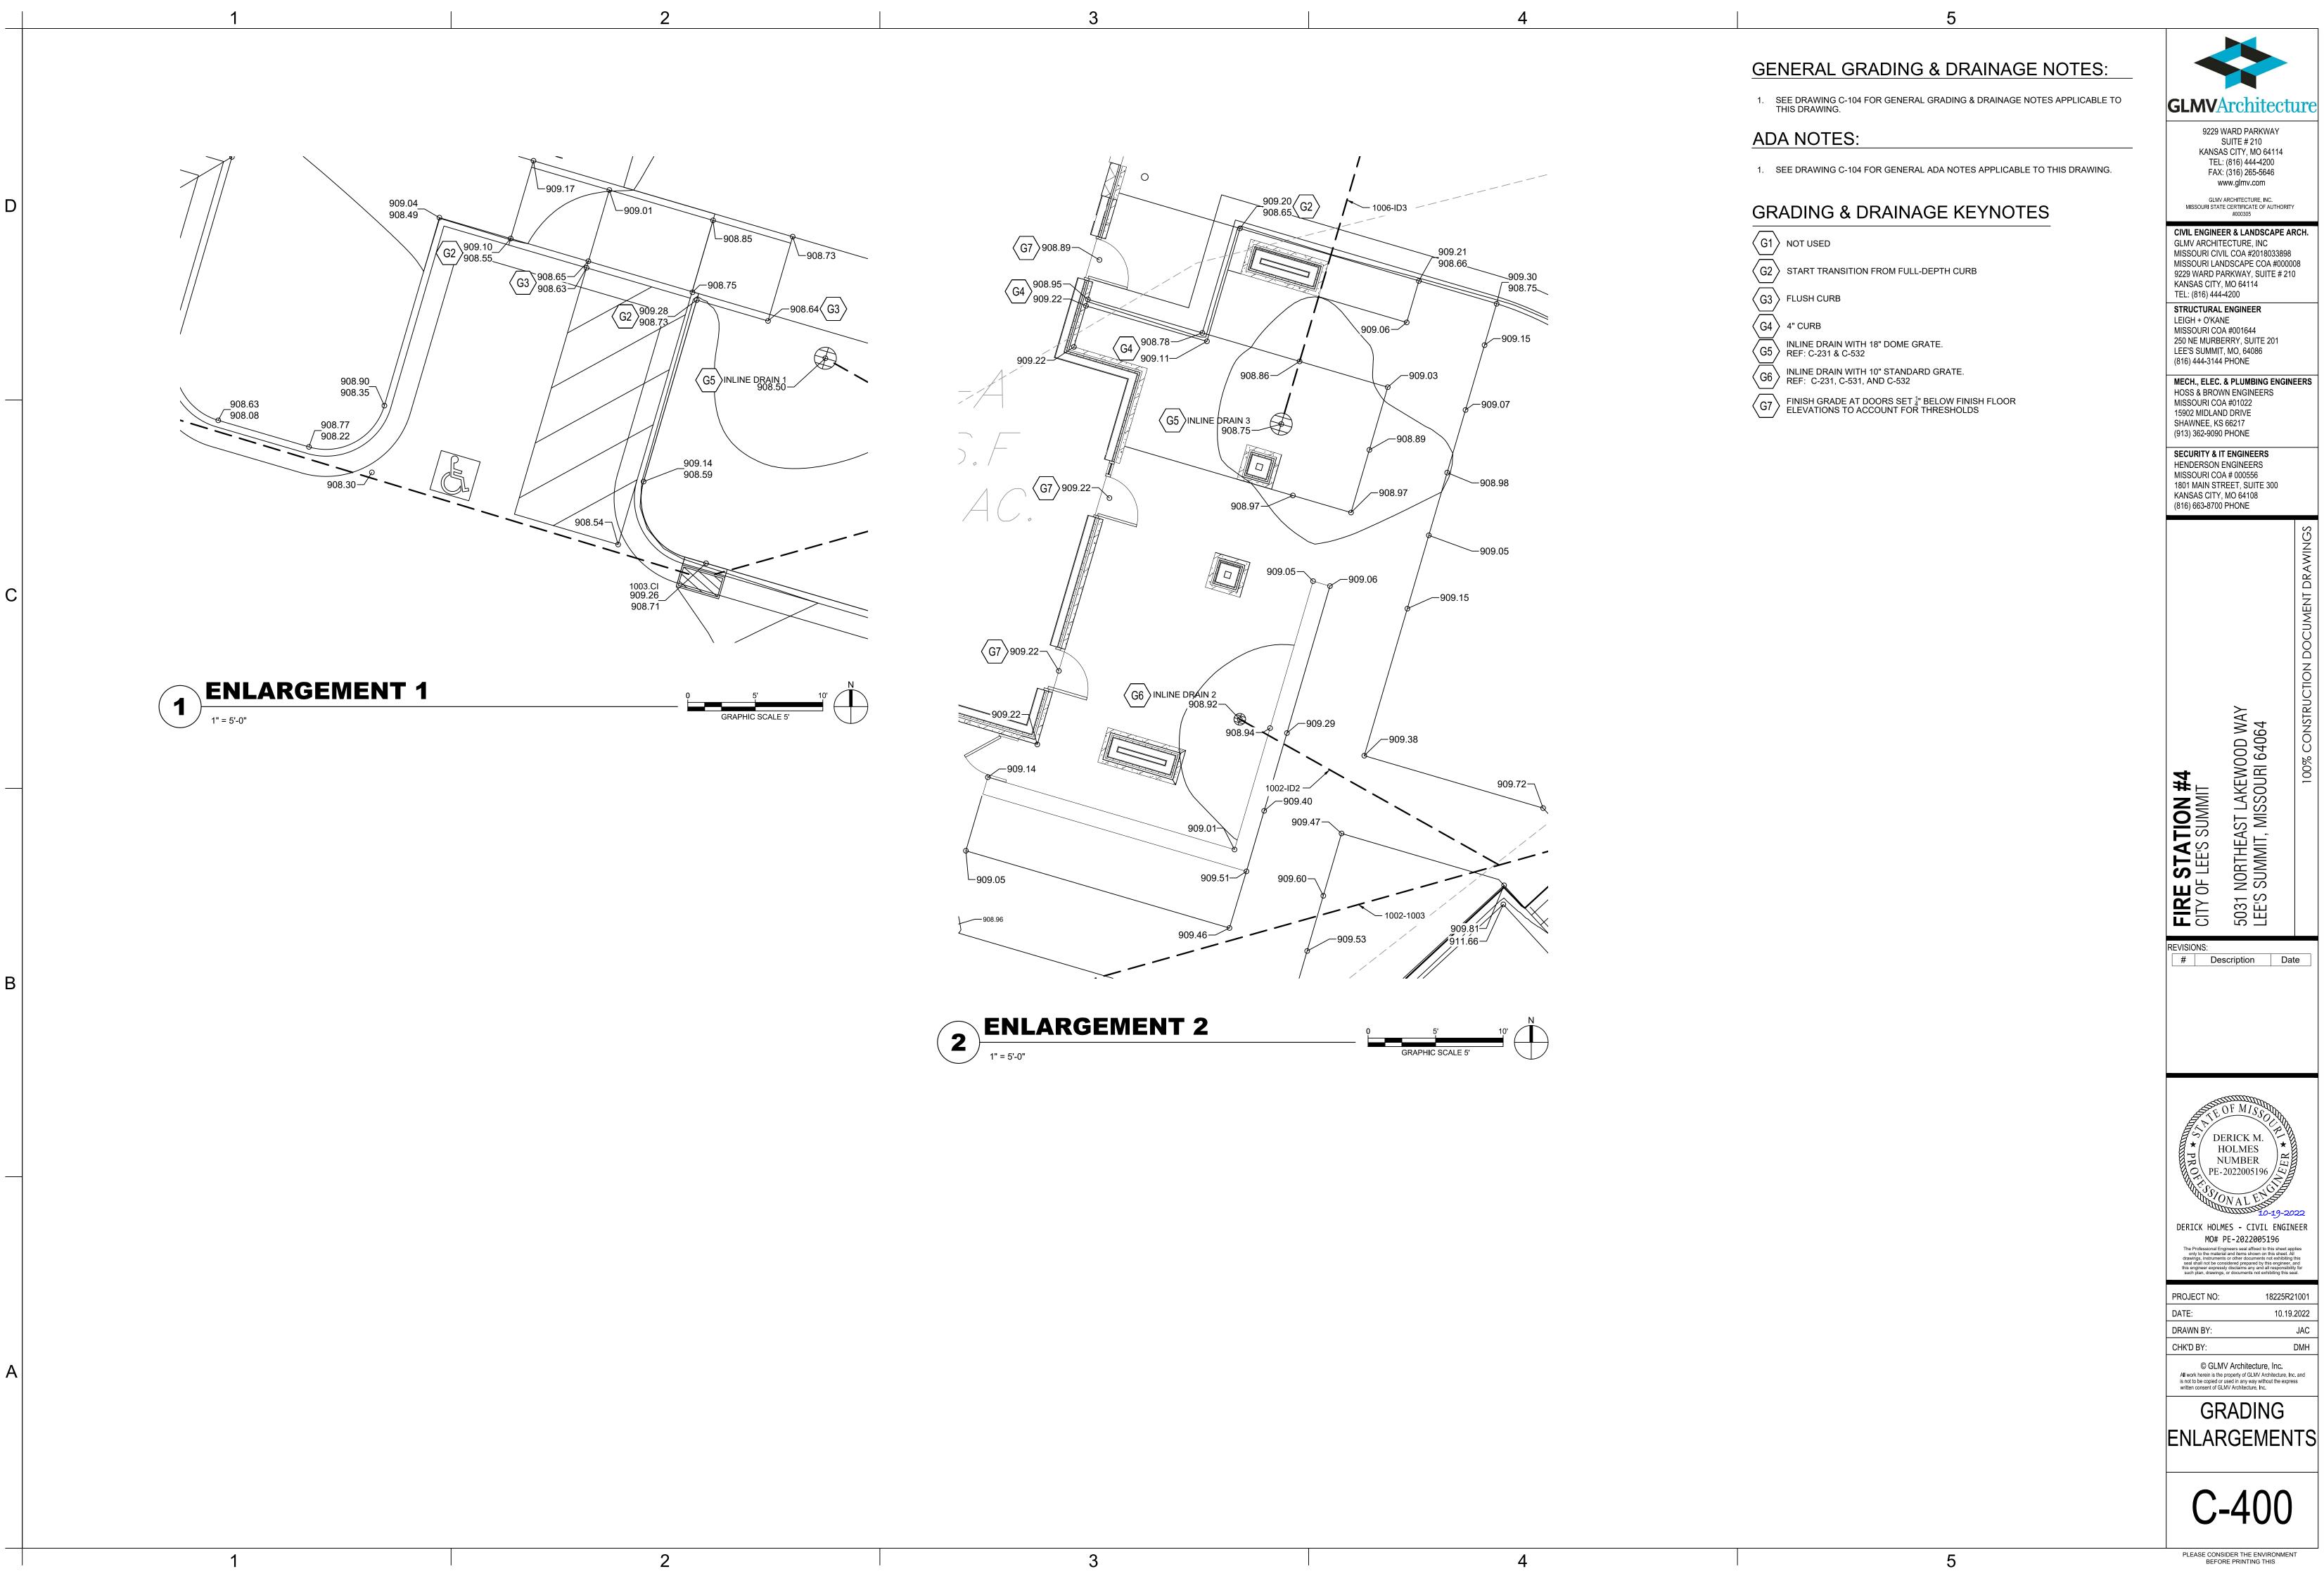Description Date


DERICK HOLMES - CIVIL ENGINEER MO# PE-2022005196


18225R21001 10.19.2022 DMH


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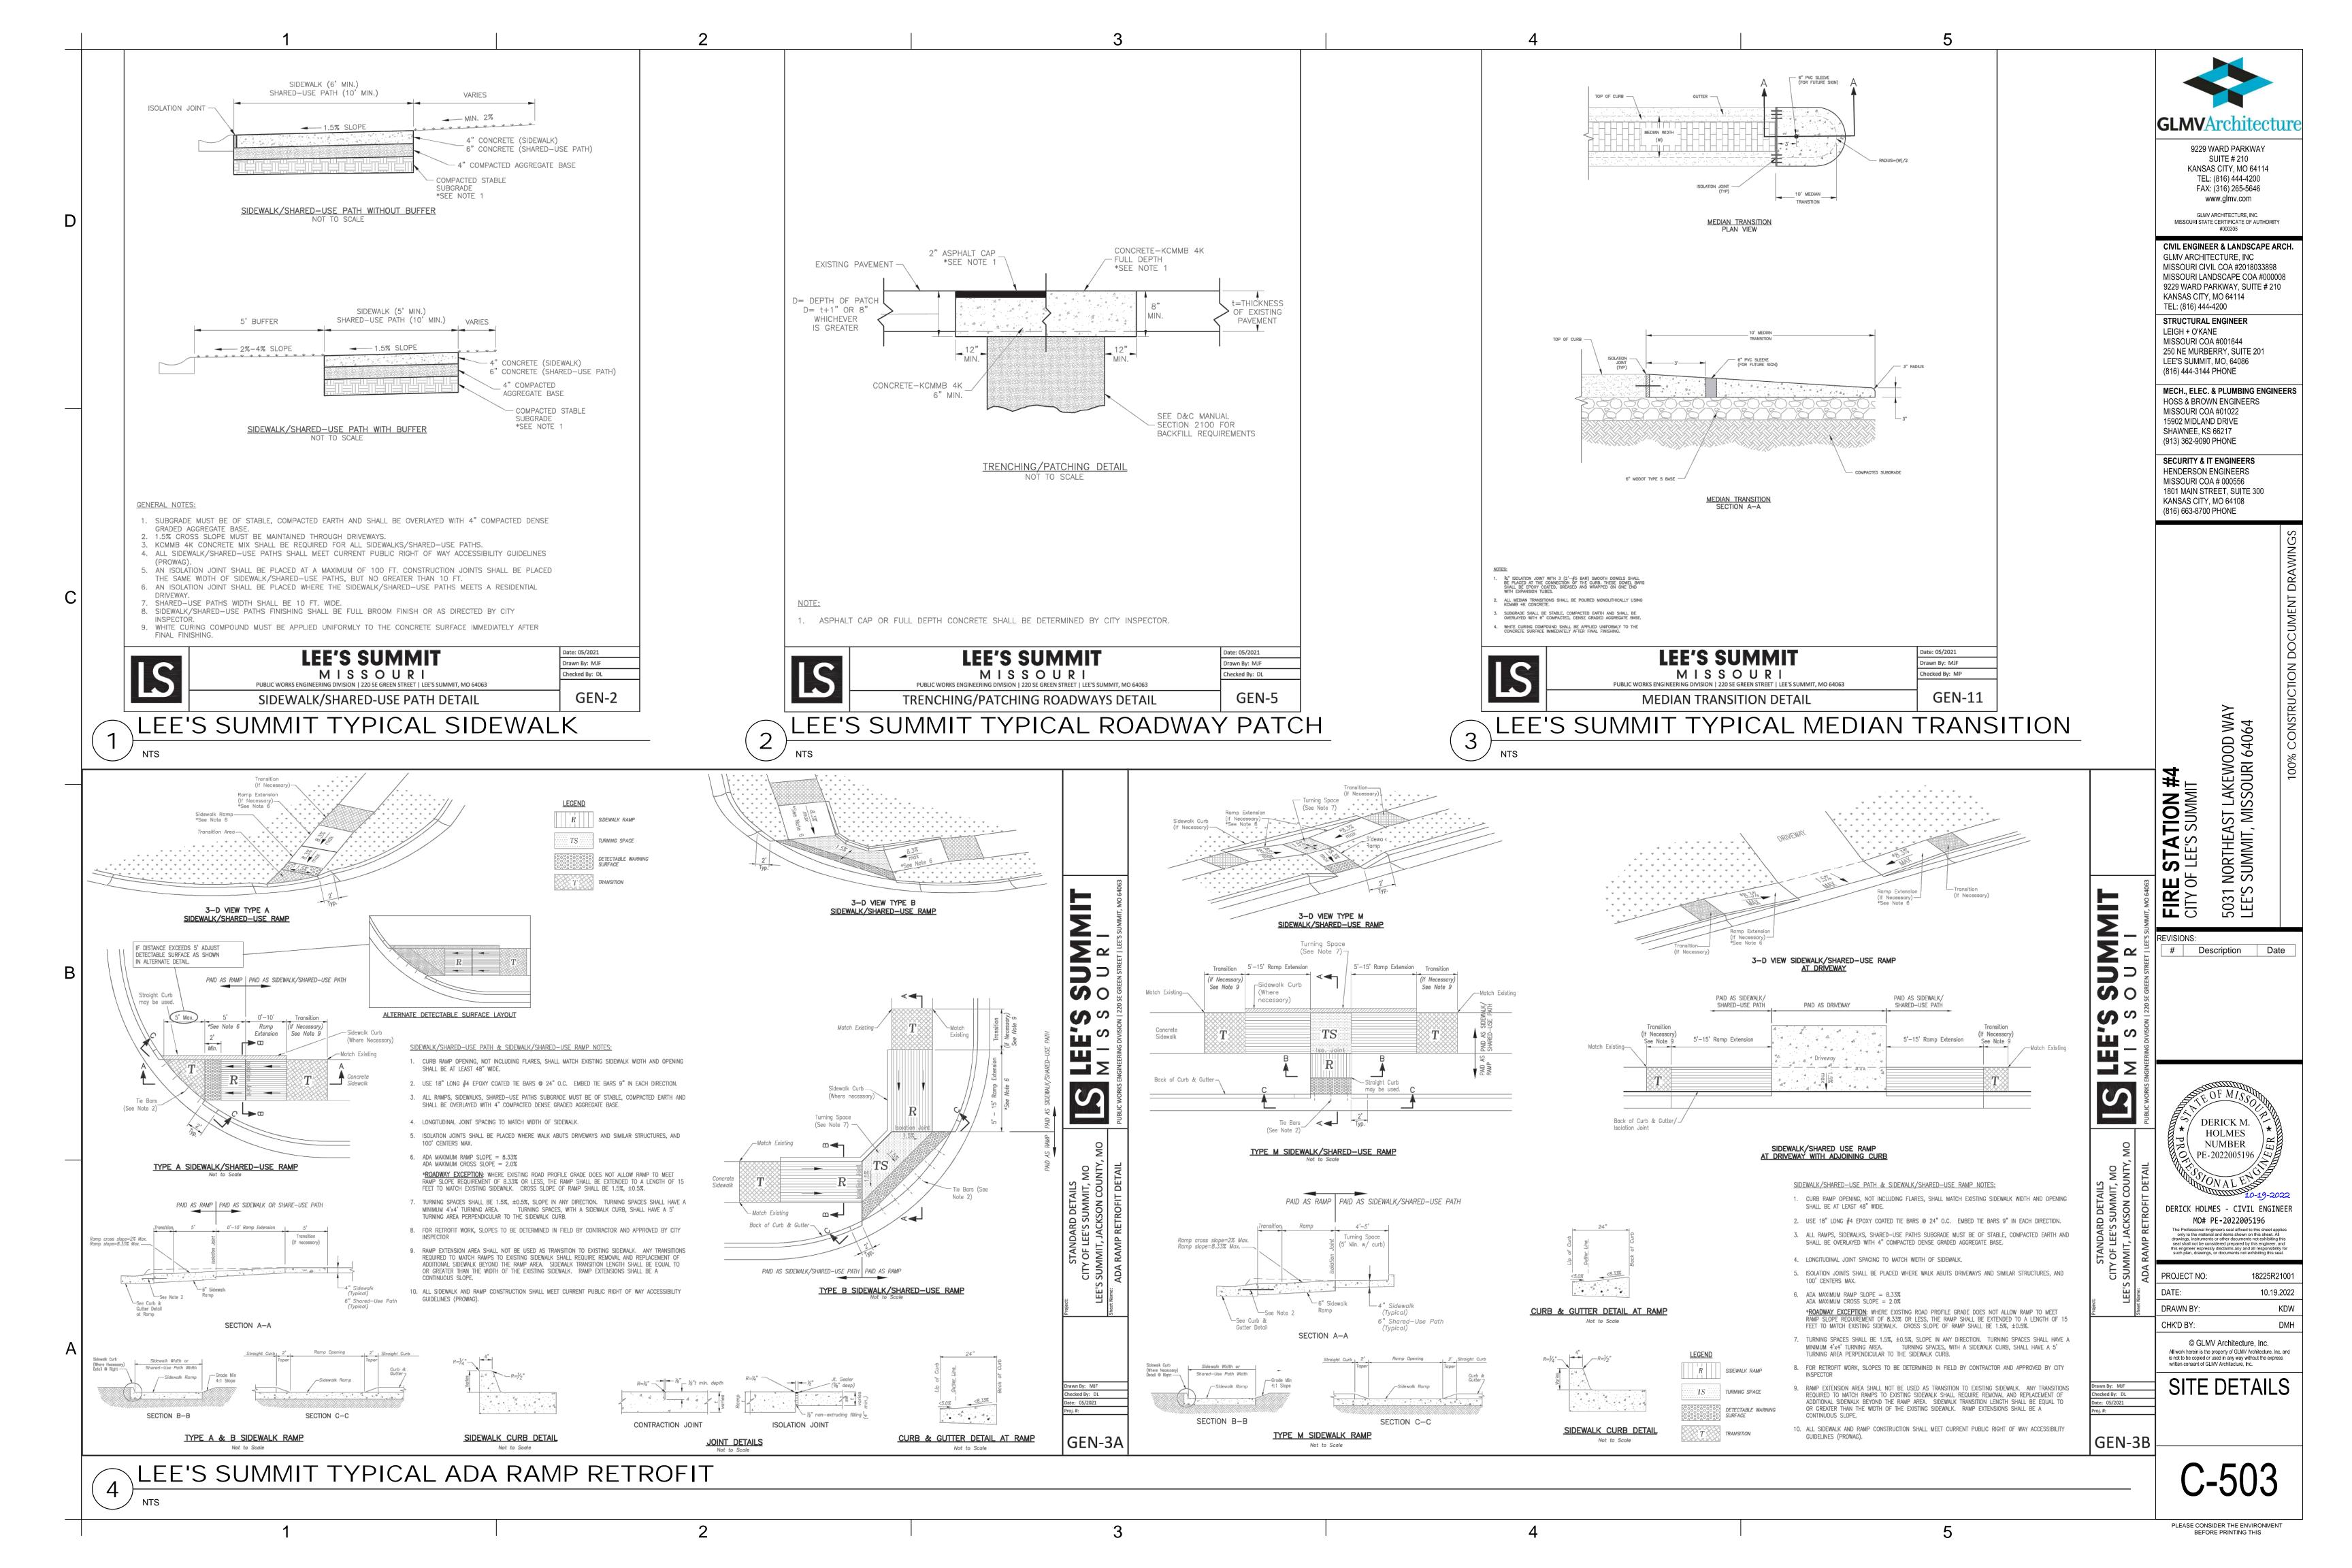
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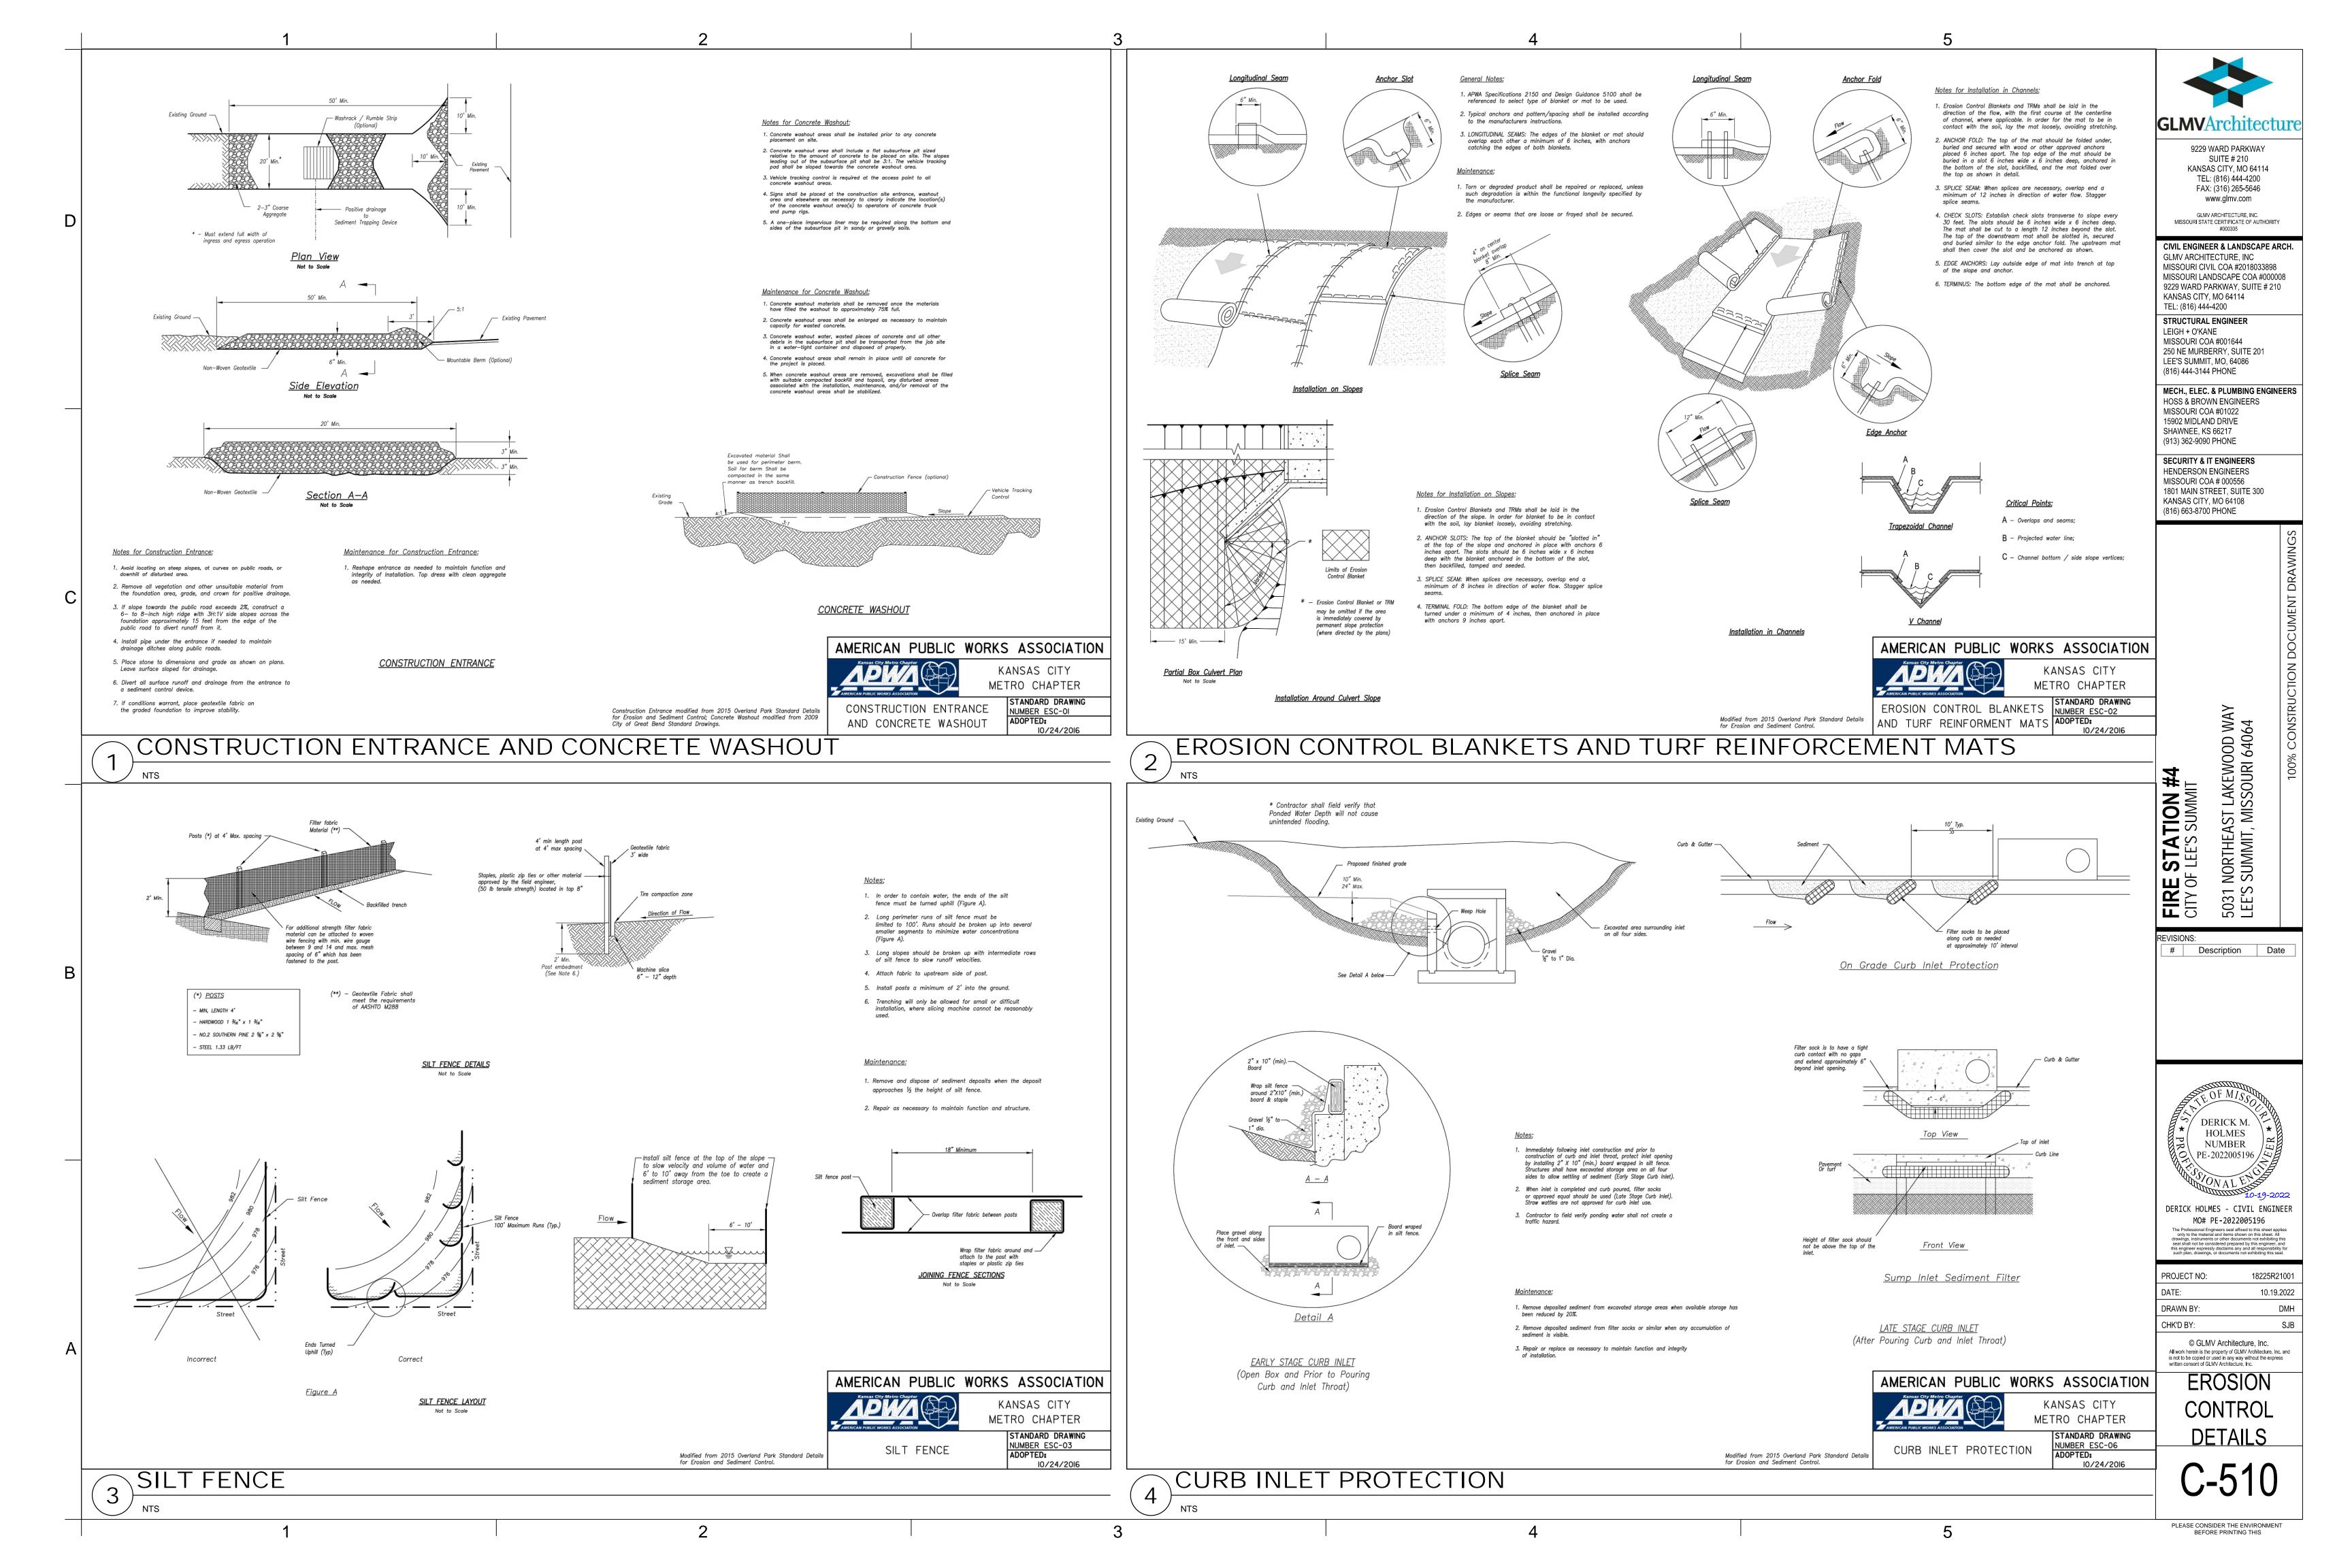
GRADING






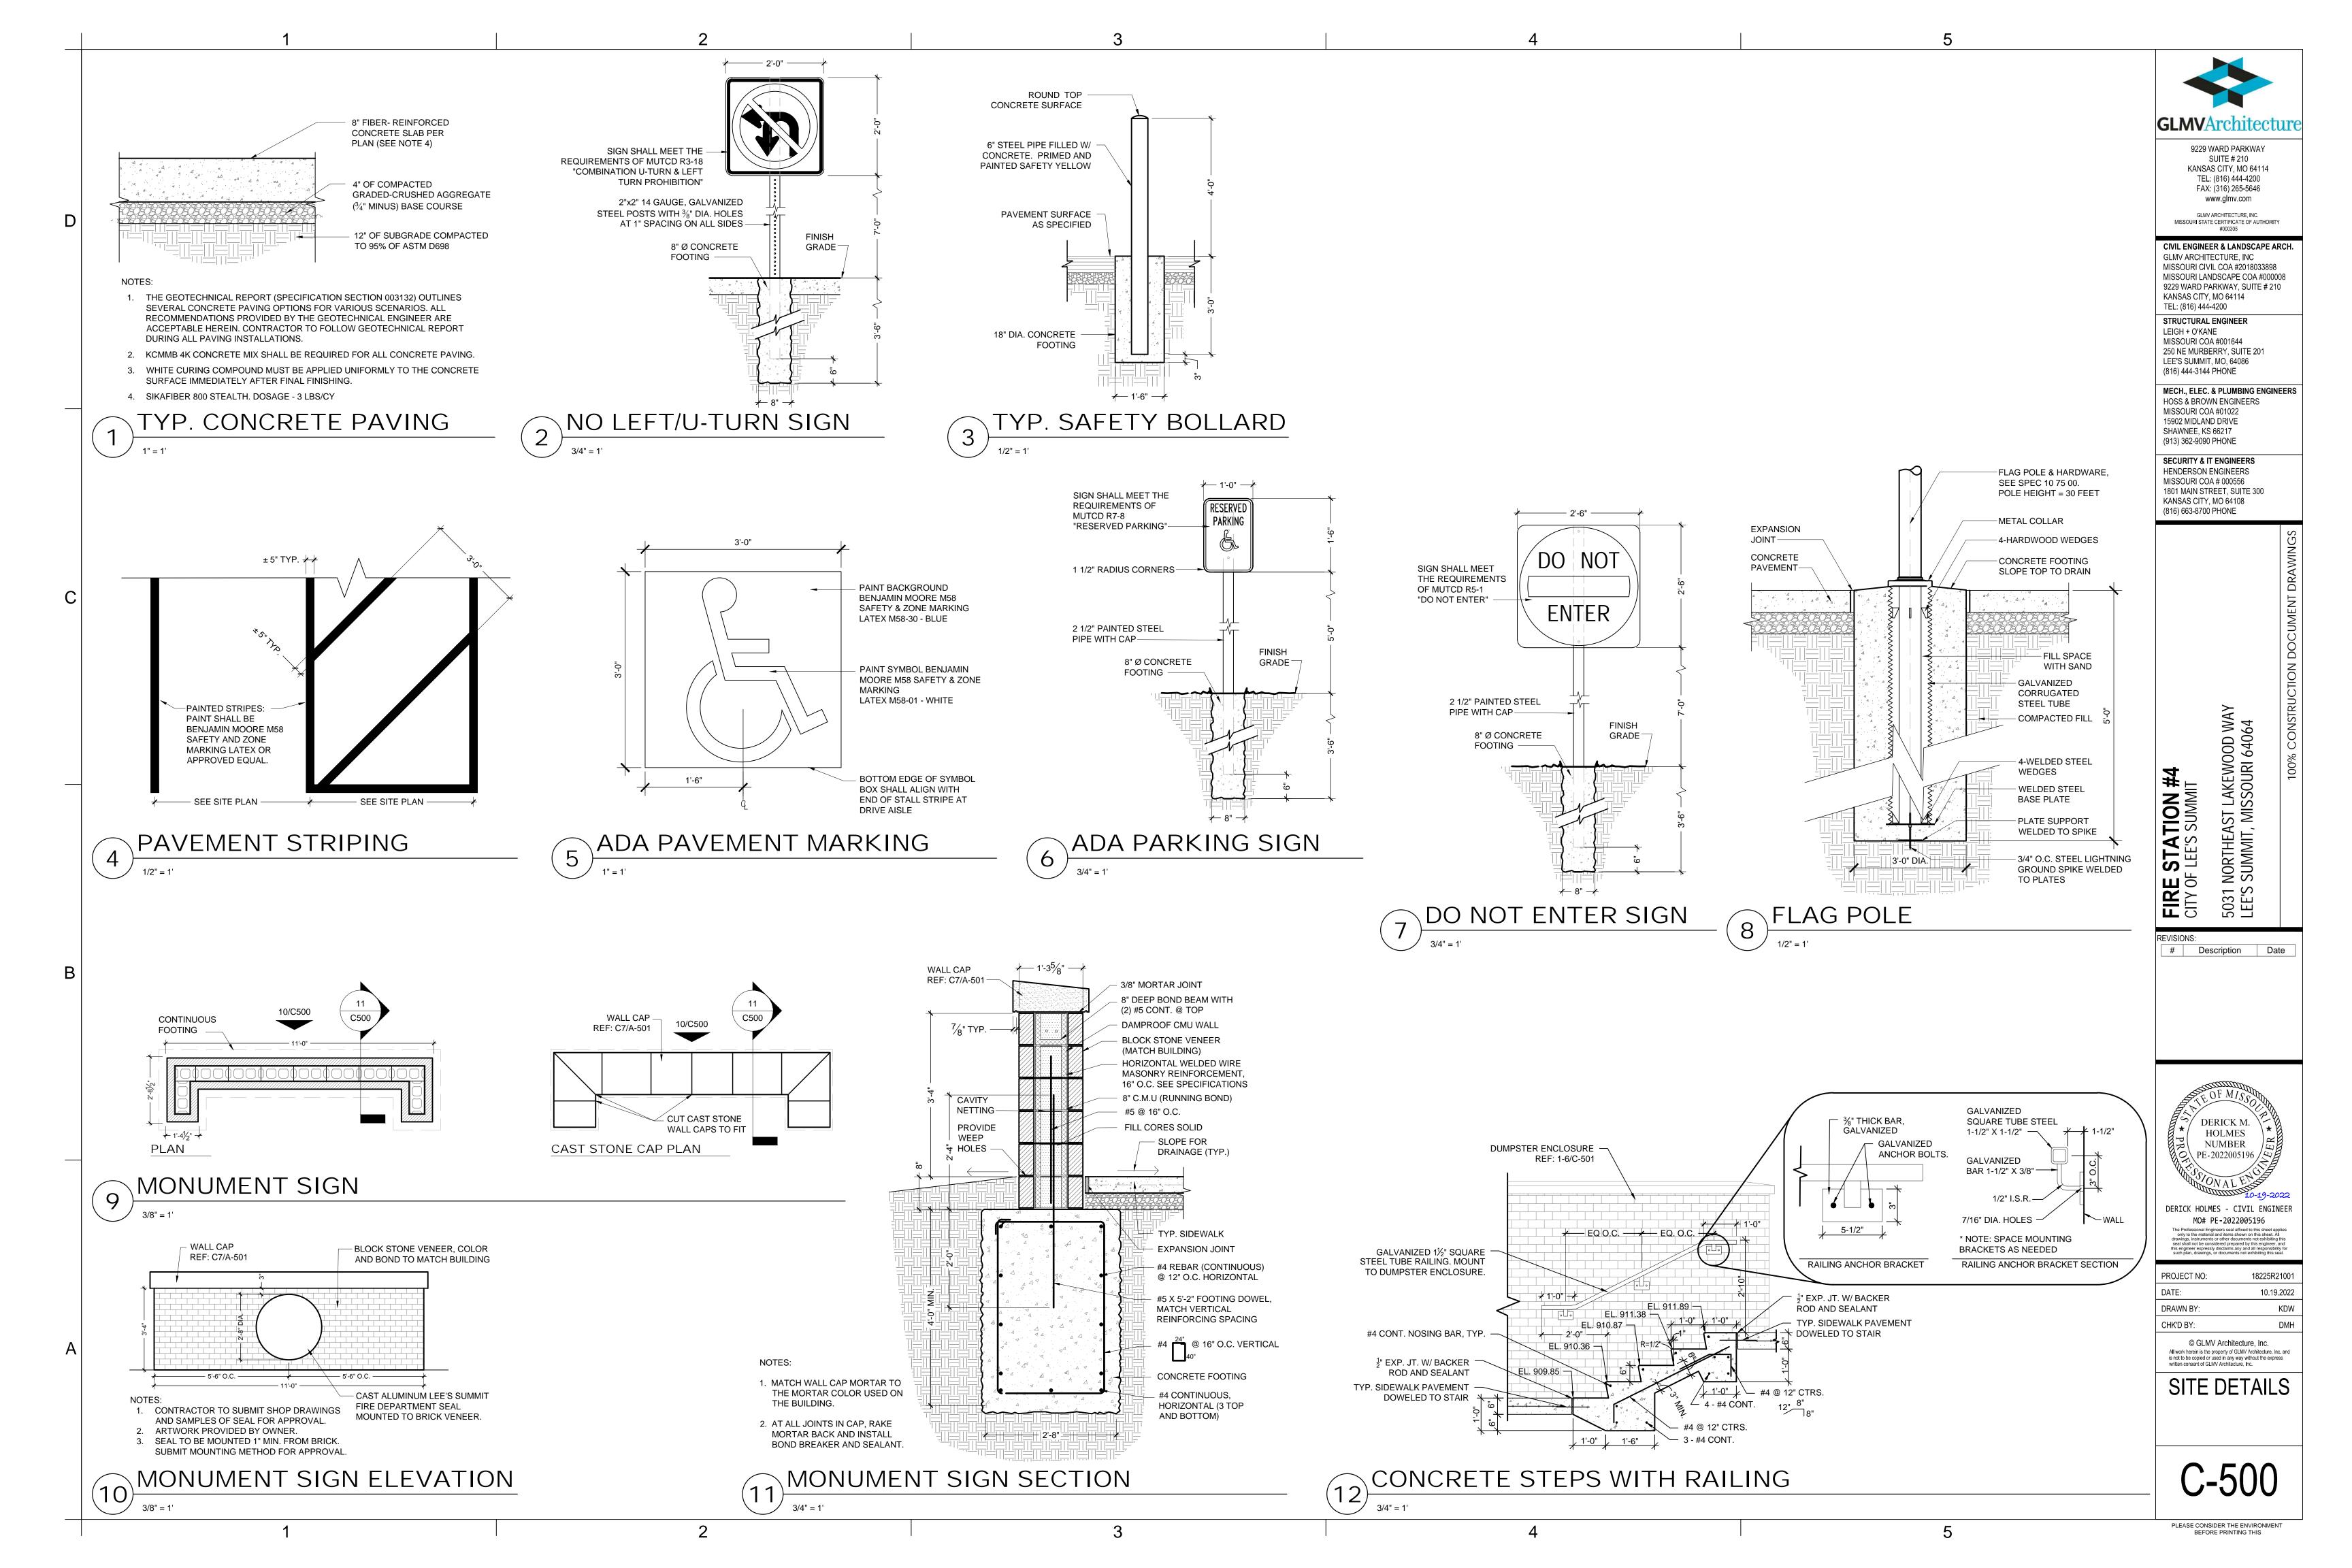

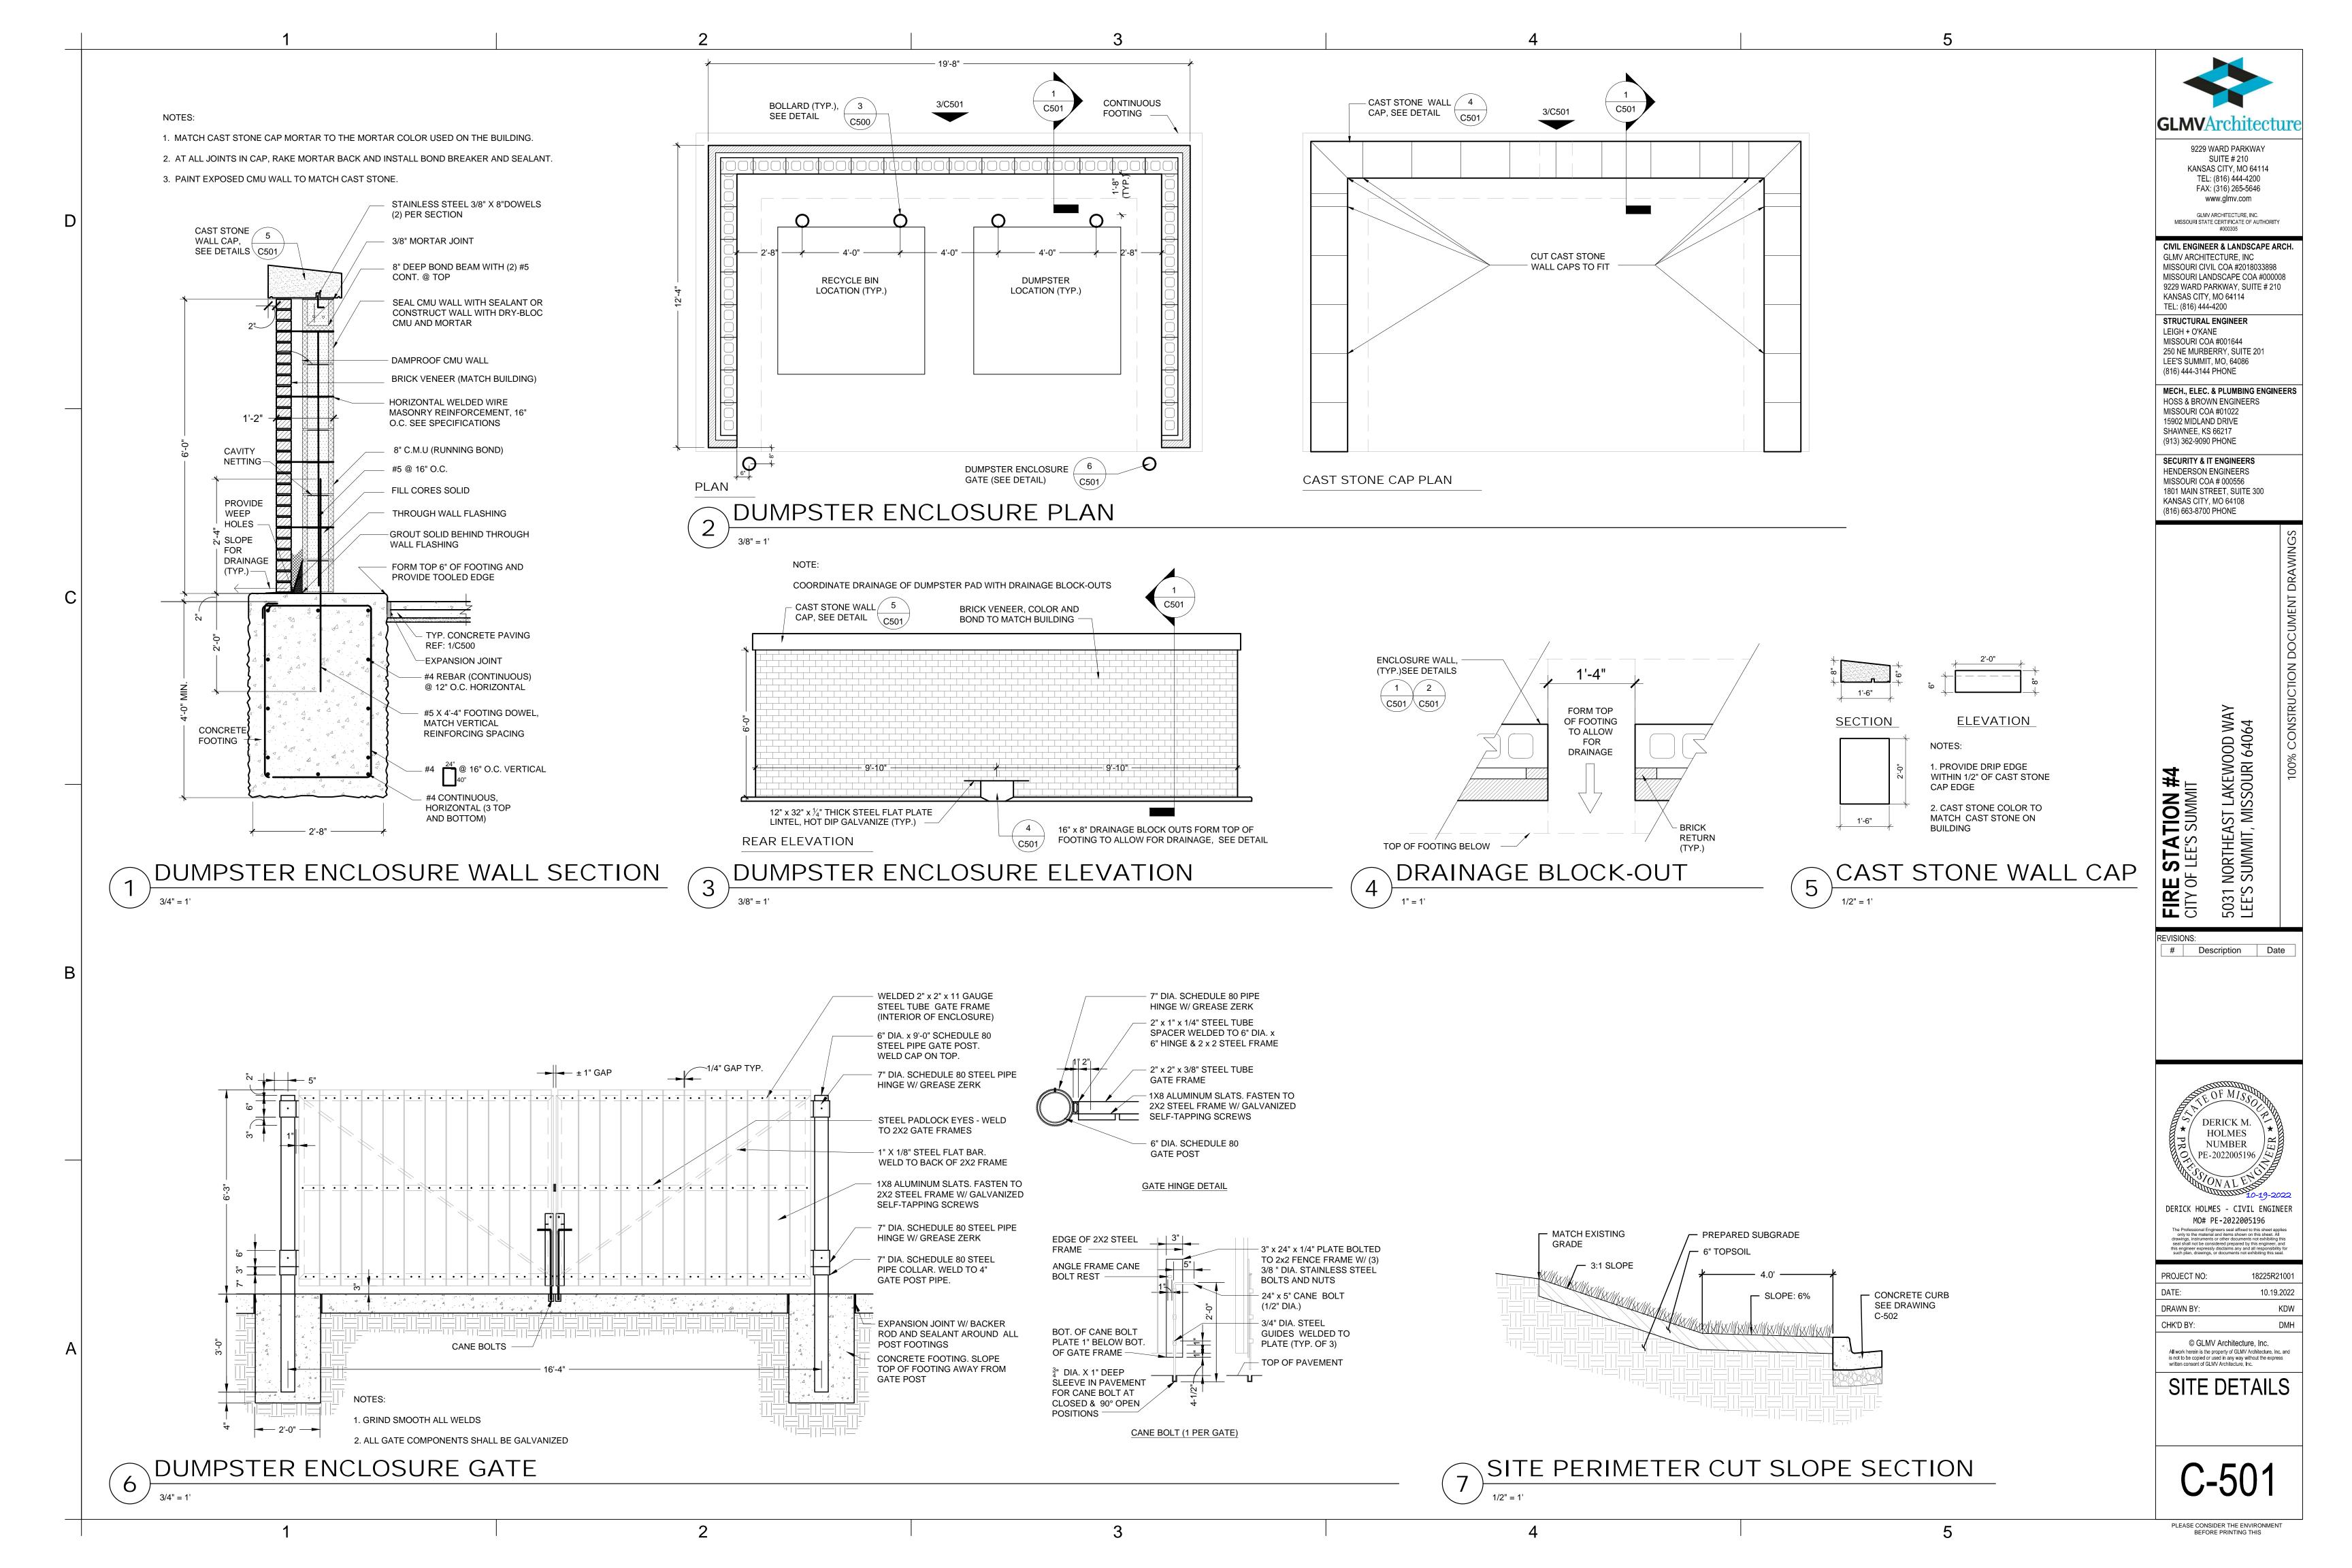

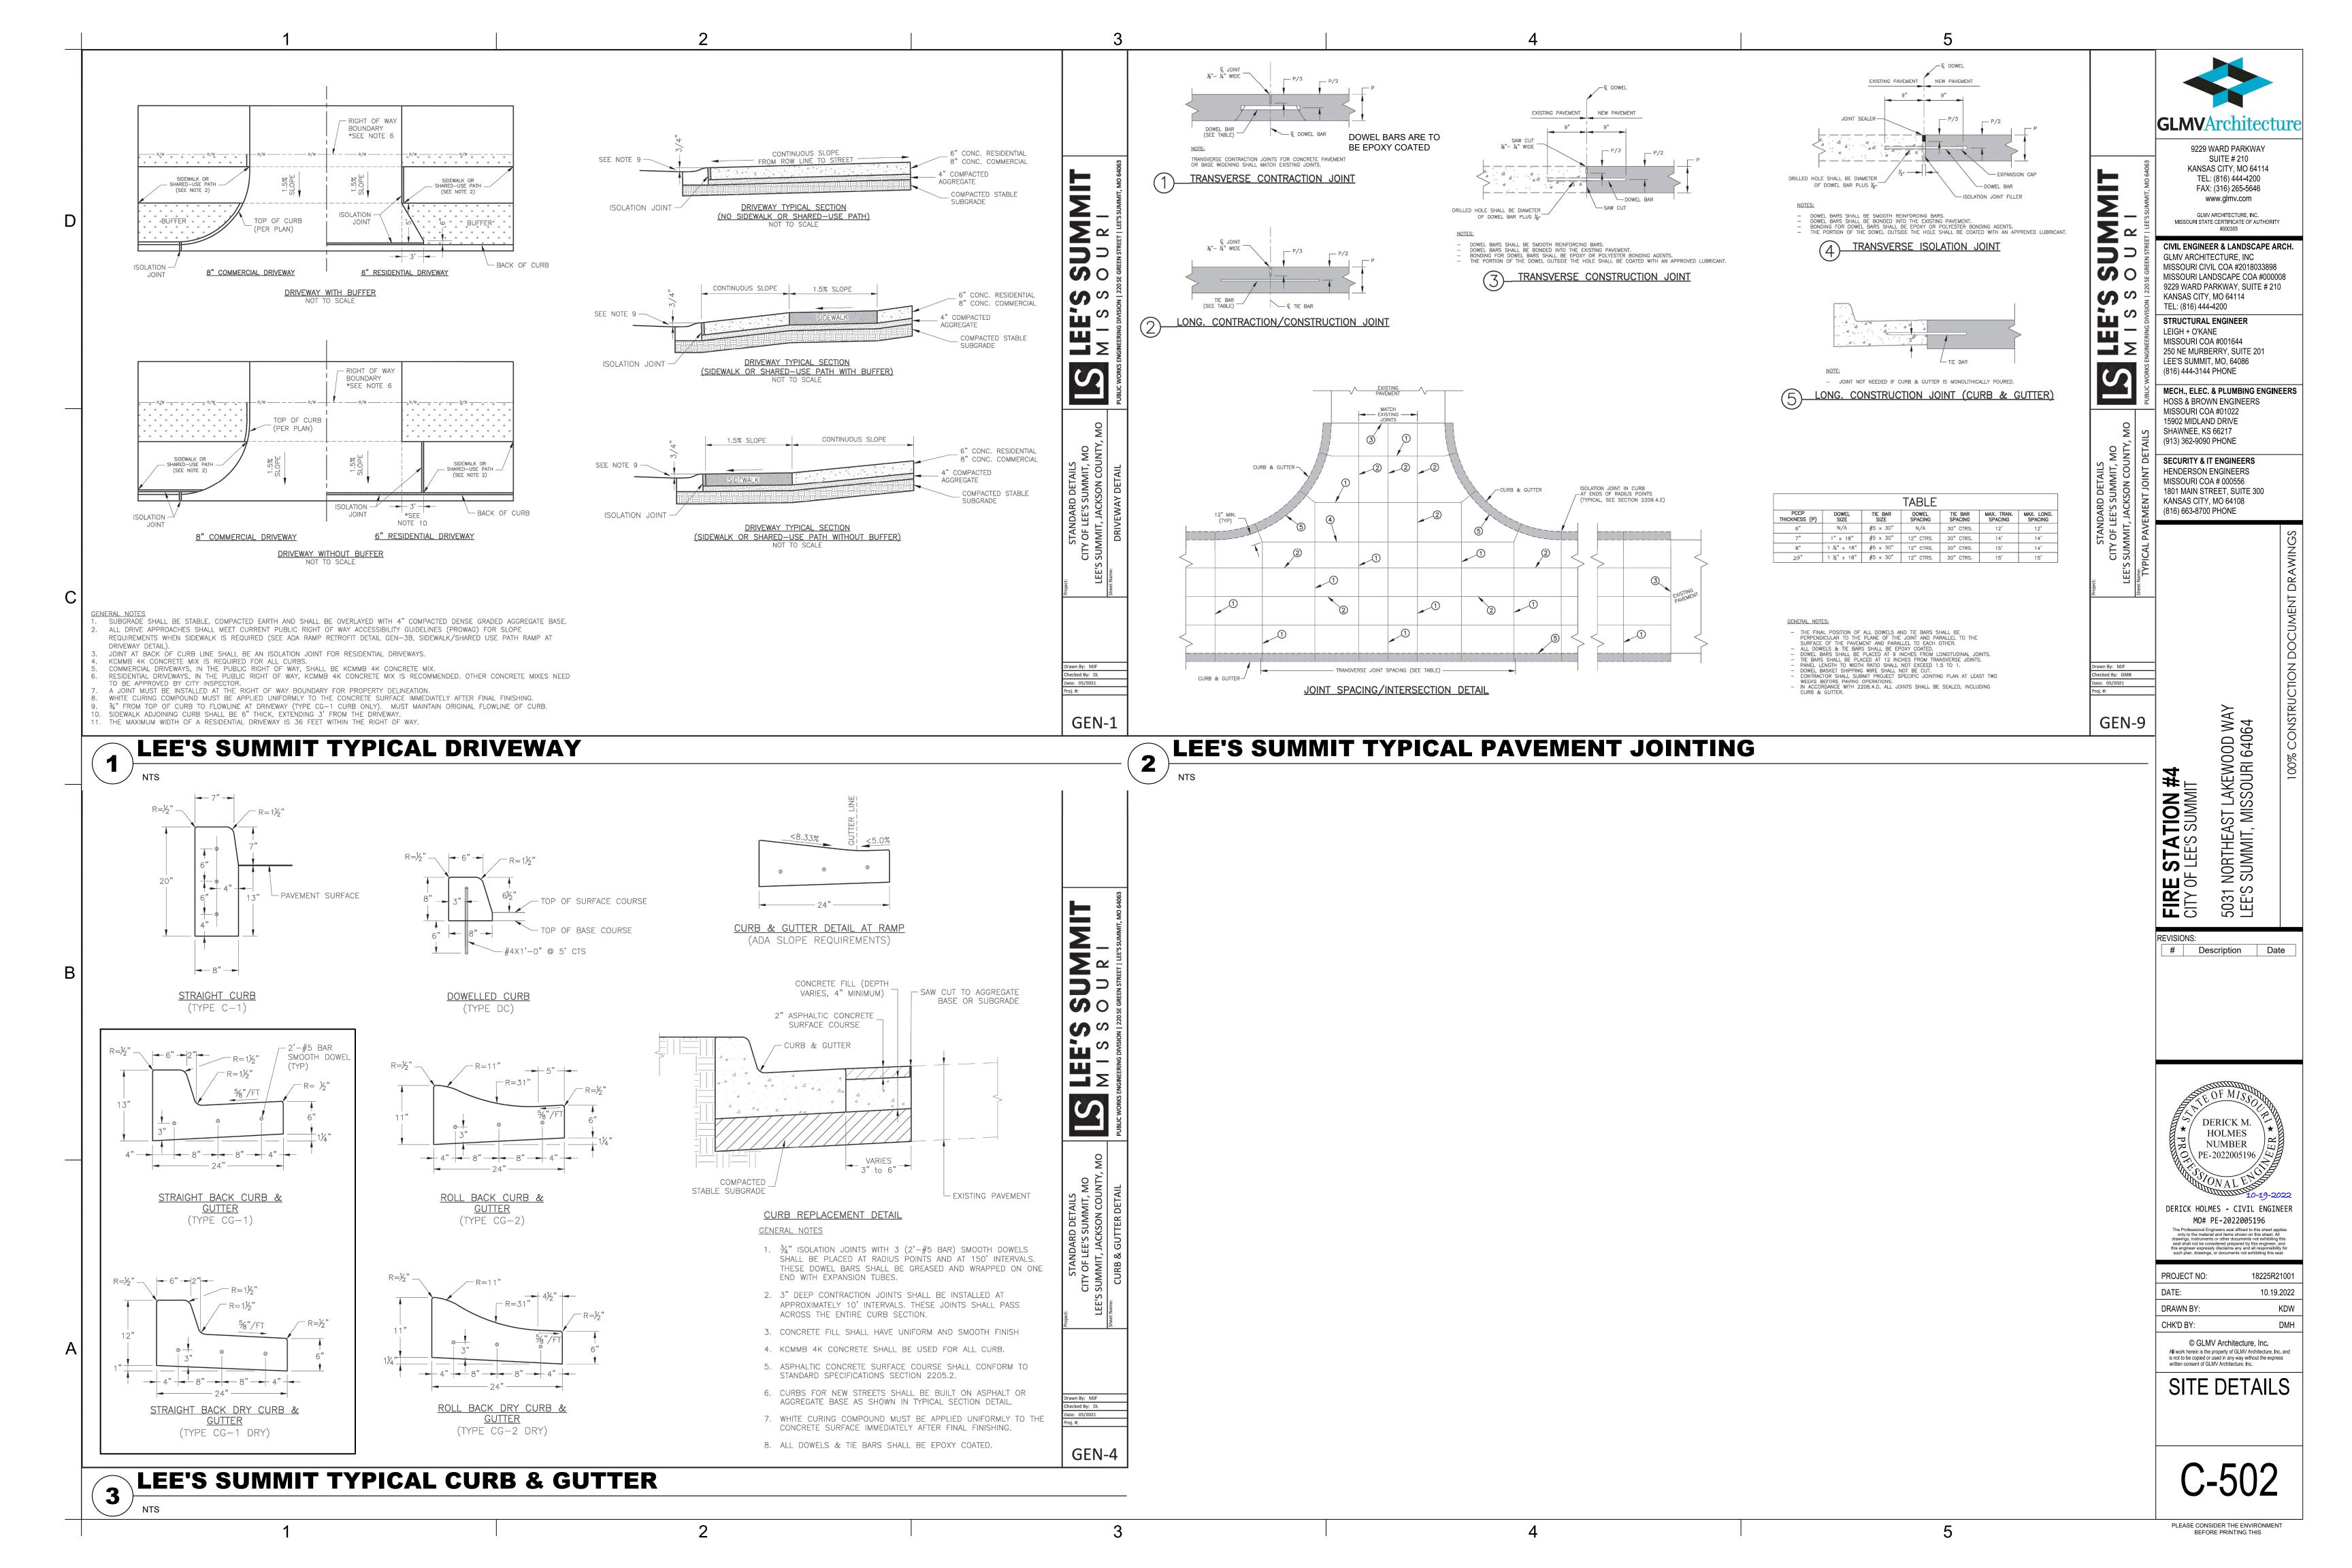

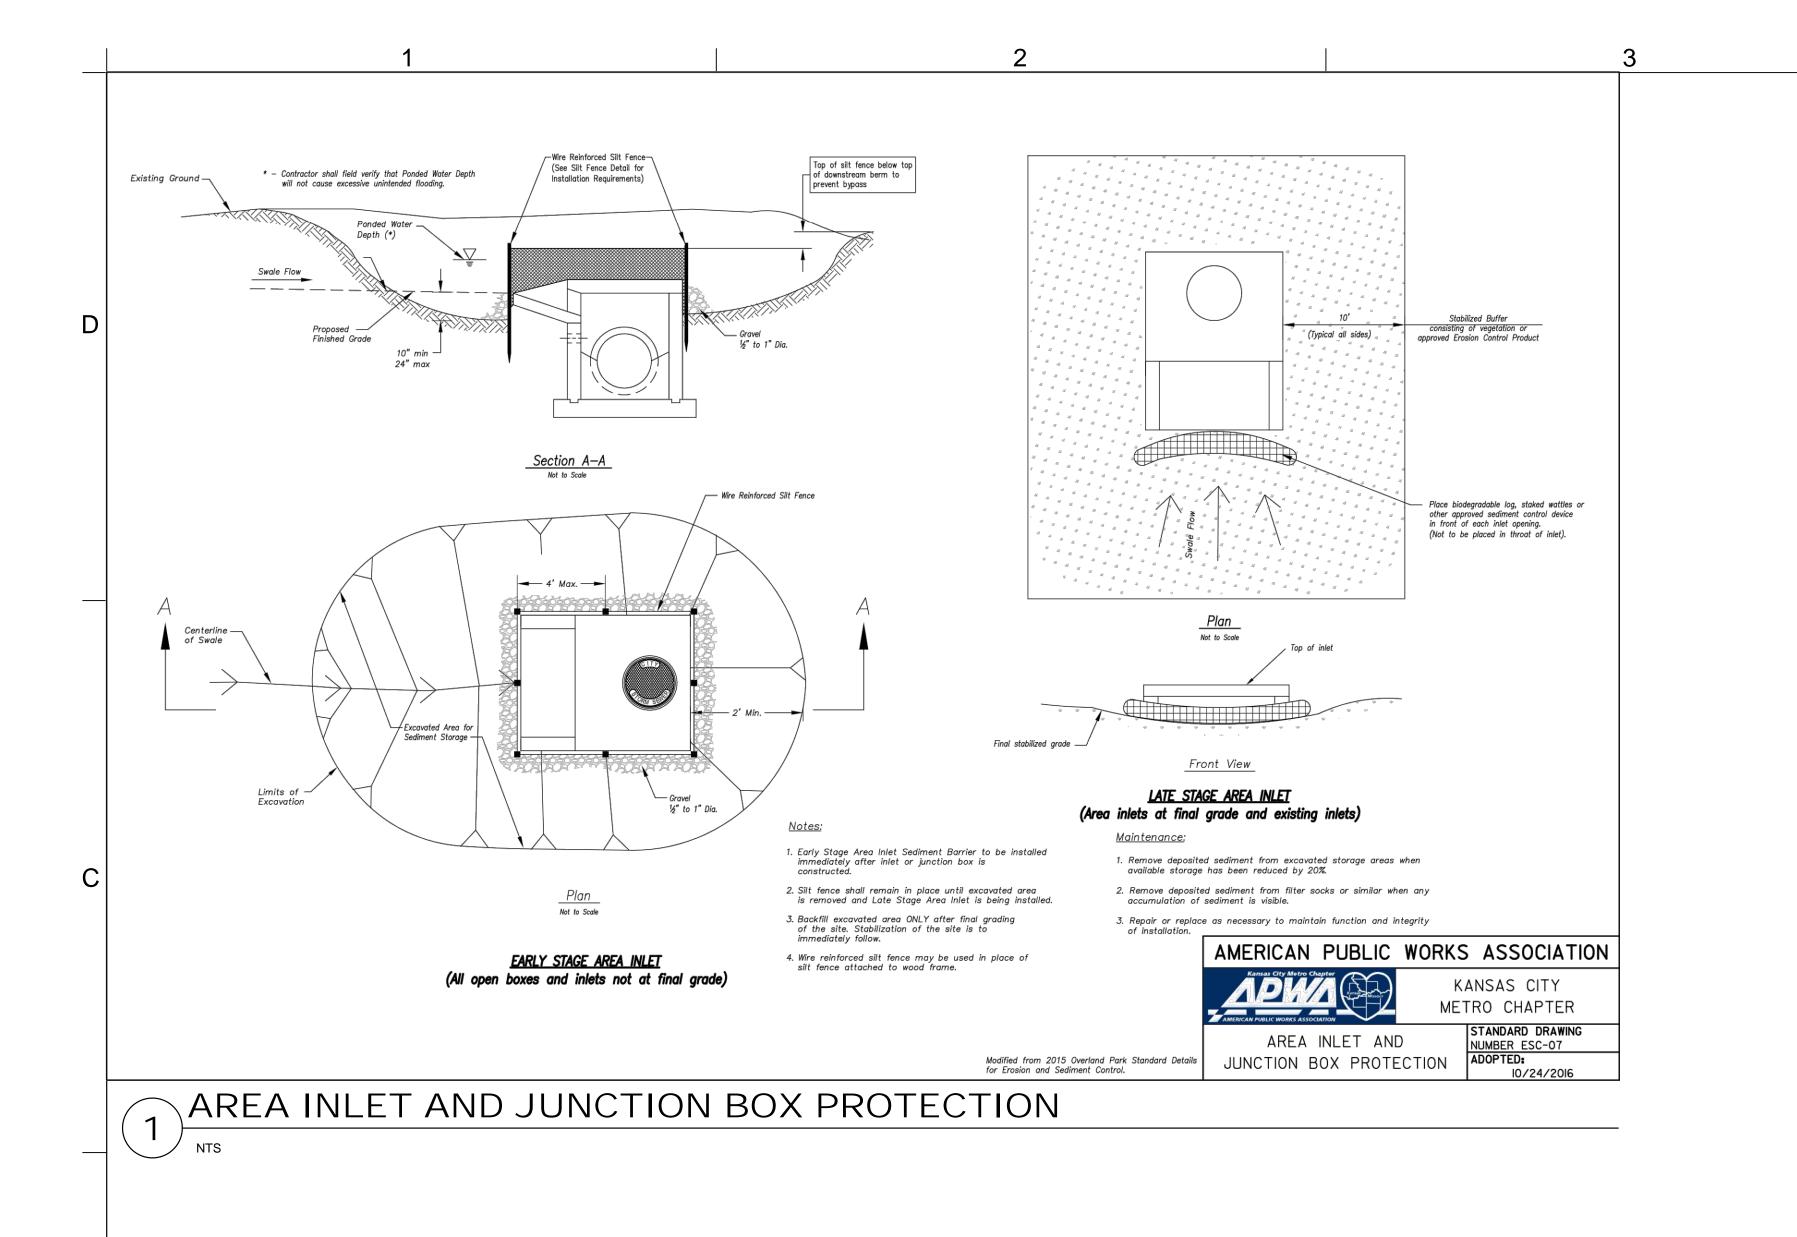

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LEIGH + O'KANE
MISSOURI COA #001644
250 NE MURBERRY, SUITE 201
LEE'S SUMMIT, MO, 64086

MISSOURI COA #01022

15902 MIDLAND DRIVE SHAWNEE, KS 66217

LEE'S SUMMIT, MO, 64086 (816) 444-3144 PHONE

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(913) 362-9090 PHONE

SECURITY & IT ENGINEERS
HENDERSON ENGINEERS
MISSOURI COA # 000556
1801 MAIN STREET, SUITE 300

KANSAS CITY, MO 64108

(816) 663-8700 PHONE

MENT DRAWINGS

રા 64064

FIRE STATION #4
CITY OF LEE'S SUMMIT
5031 NORTHEAST LAKEWO
LEE'S SUMMIT, MISSOURI

REVISIONS:
Description Date

DERICK M.

HOLMES

NUMBER

PE-2022005196

DERICK HOLMES - CIVIL ENGINEER

MO# PE-2022005196

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 18225R21001

 DATE:
 10.19.2022

 DRAWN BY:
 DMH


 CHK'D BY:
 SJB


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EROSION CONTROL DETAILS

C-511



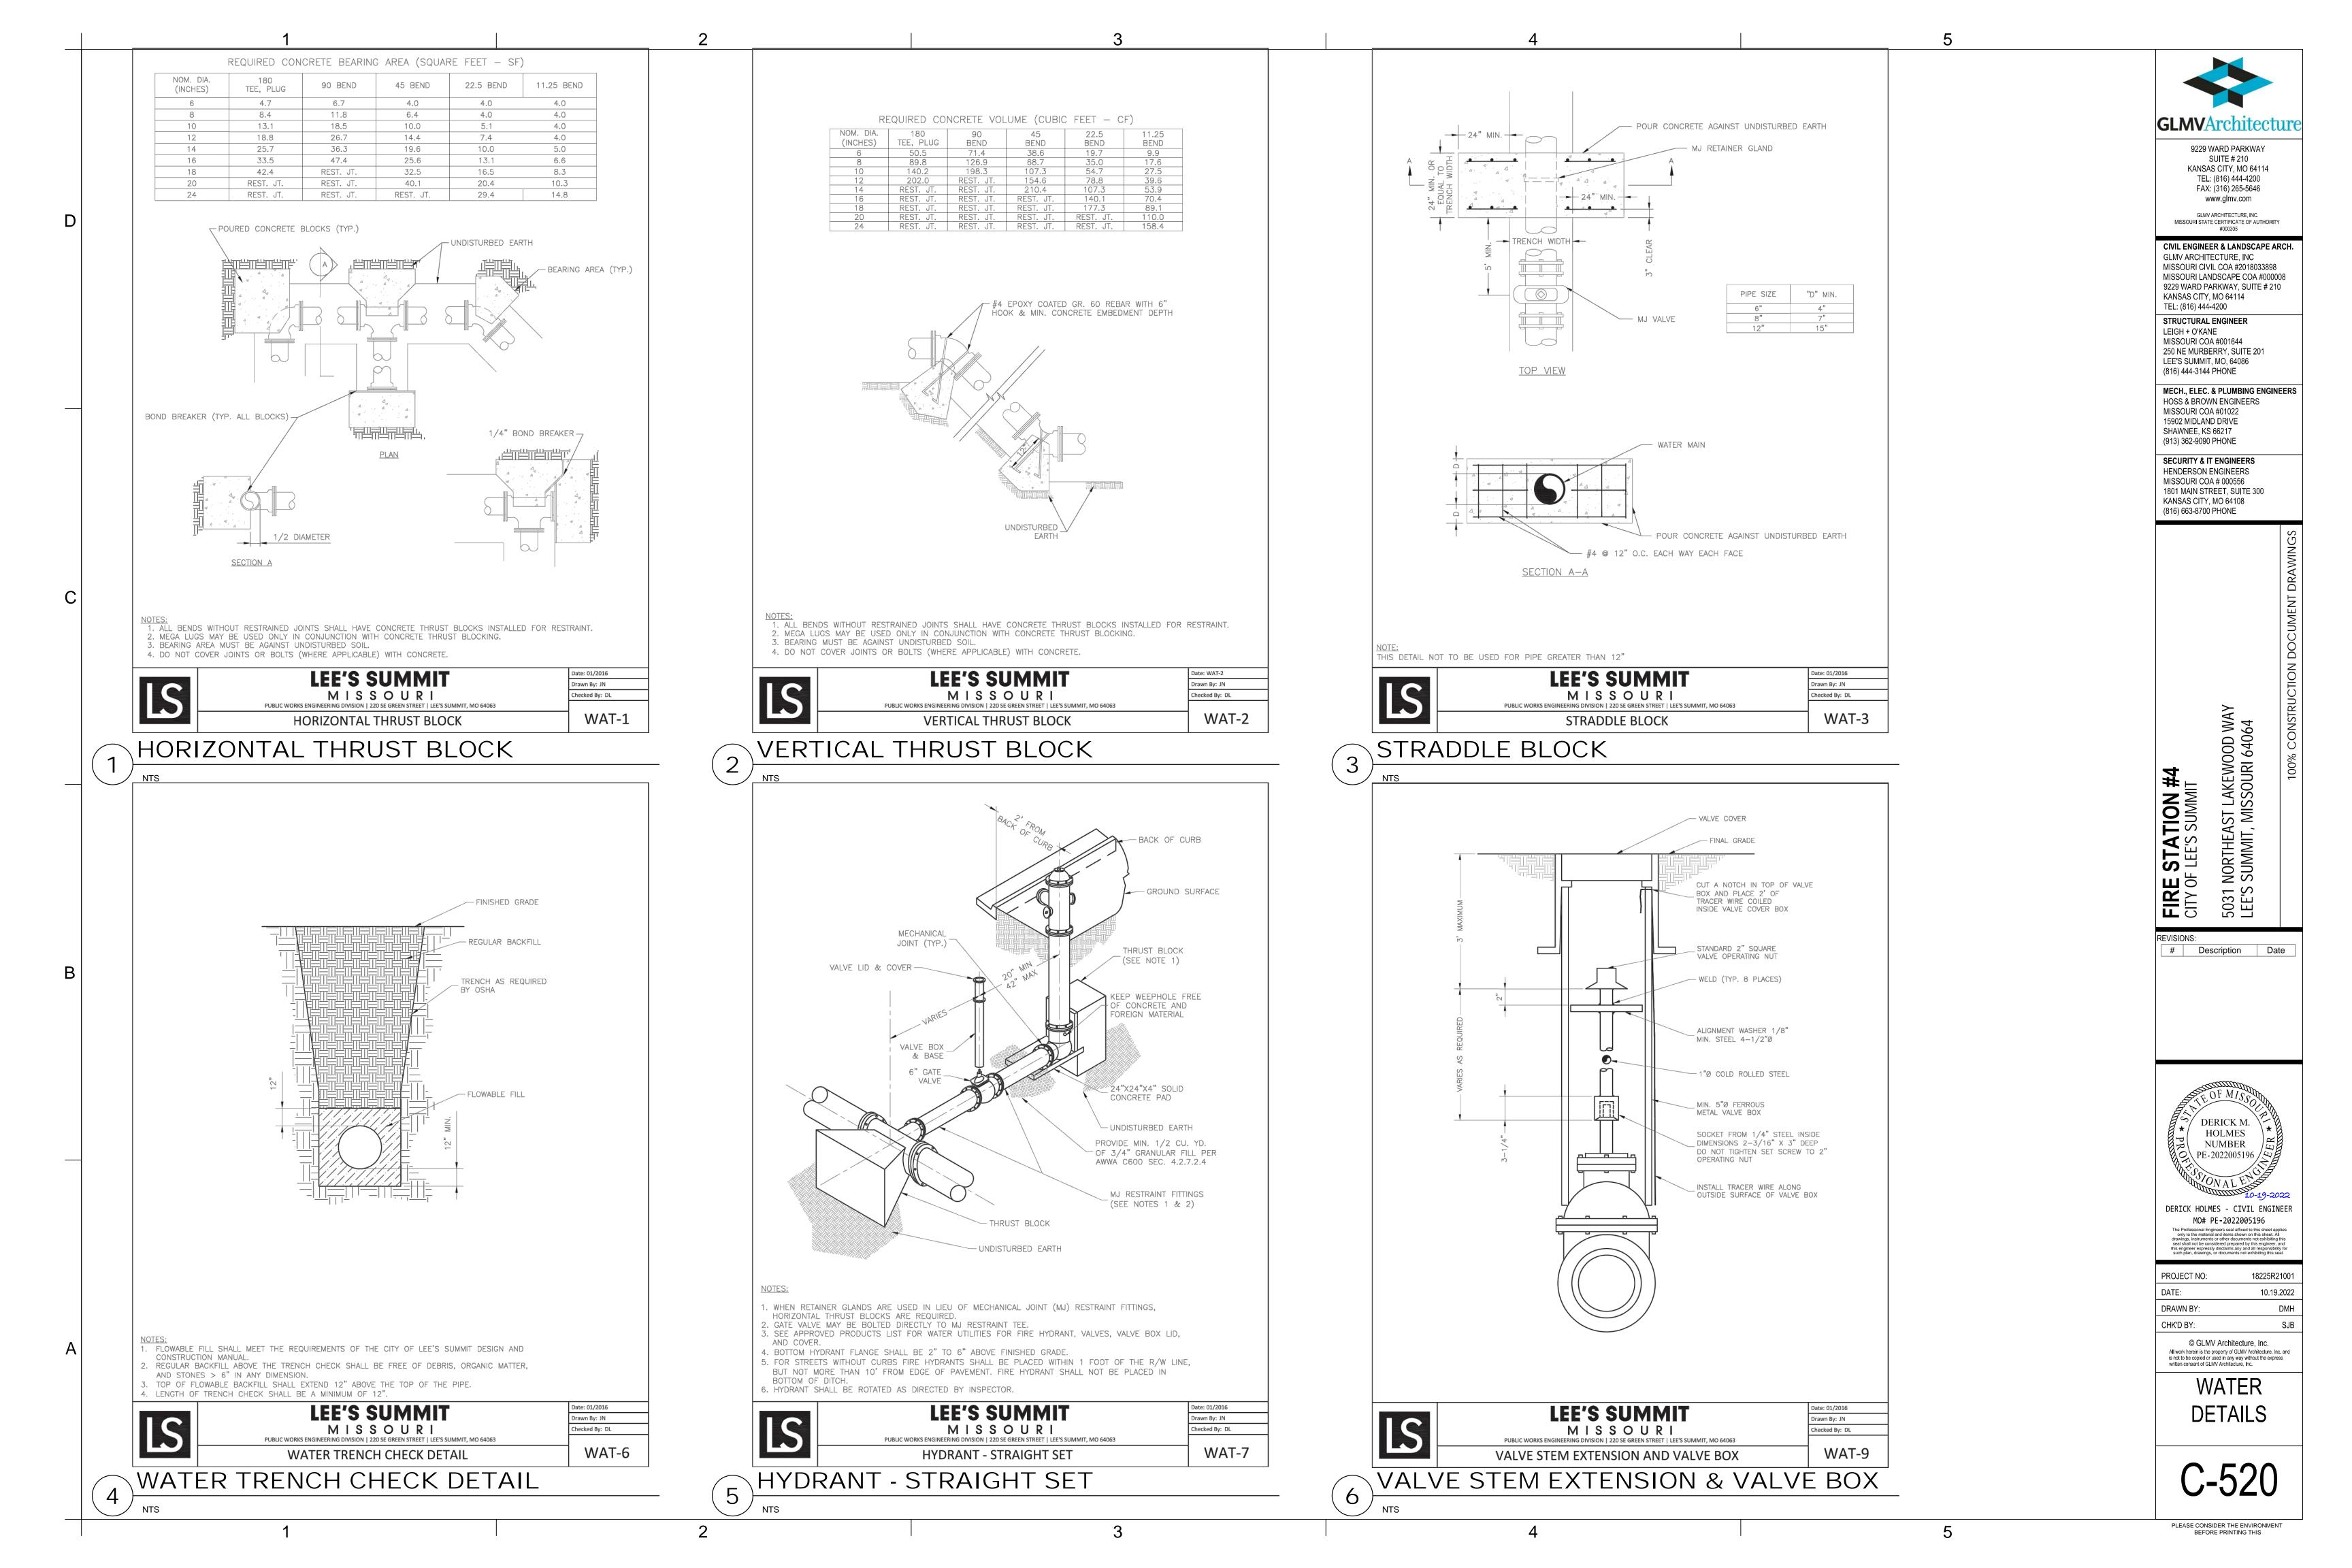

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9229 WARD PARKWAY, SUITE # 210
KANSAS CITY, MO 64114
TEL: (816) 444 4200

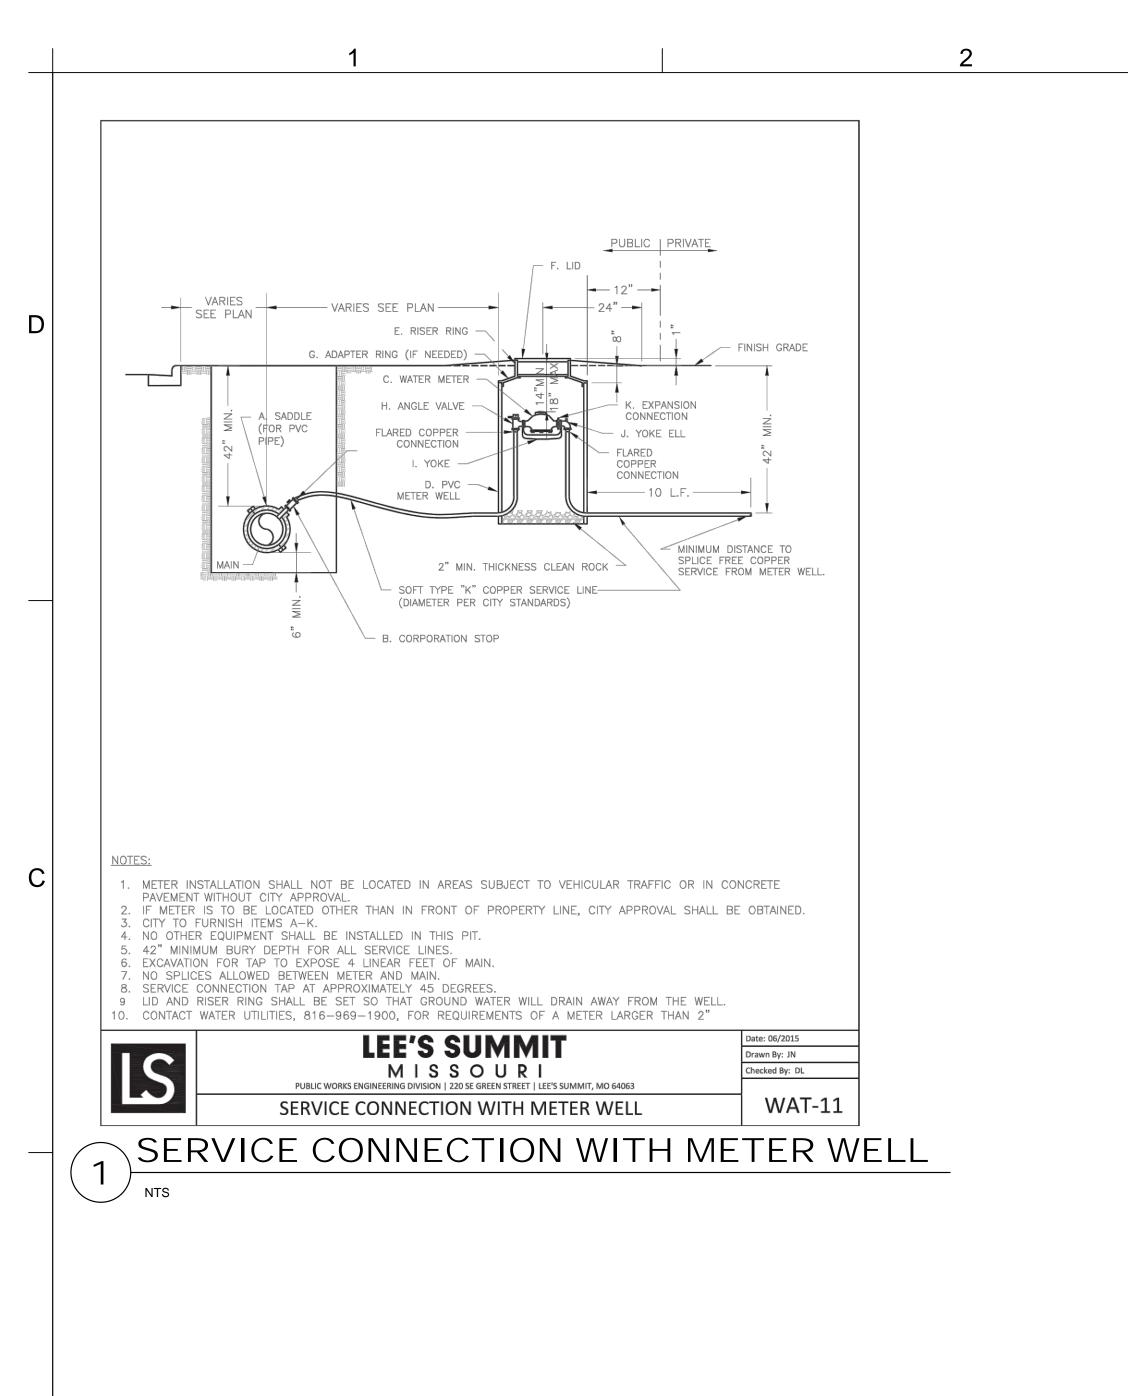TEL: (816) 444-4200

STRUCTURAL ENGINEER

LEIGH + O'KANE

MISSOURI COA #001644

250 NE MURBERRY, SUITE 201

LEE'S SUMMIT, MO, 64086
(816) 444-3144 PHONE

MECH., ELEC. & PLUMBING ENGINEERS
HOSS & BROWN ENGINEERS

MISSOURI COA #01022 15902 MIDLAND DRIVE SHAWNEE, KS 66217

(913) 362-9090 PHONE

SECURITY & IT ENGINEERS

HENDERSON ENGINEERS
MISSOURI COA # 000556

1801 MAIN STREET, SUITE 300

KANSAS CITY, MO 64108 (816) 663-8700 PHONE

ORAWINGS

KEWOOD WAY OURI 64064

FIRE STATION #4
CITY OF LEE'S SUMMIT
5031 NORTHEAST LAKEWC
LEE'S SUMMIT, MISSOURI

REVISIONS:
Description Date

DERICK M.
HOLMES
NUMBER
PE-2022005196

DERICK HOLMES - CIVIL ENGINEER
MO# PE-2022005196

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 DMH

 CHK'D BY:
 SJB

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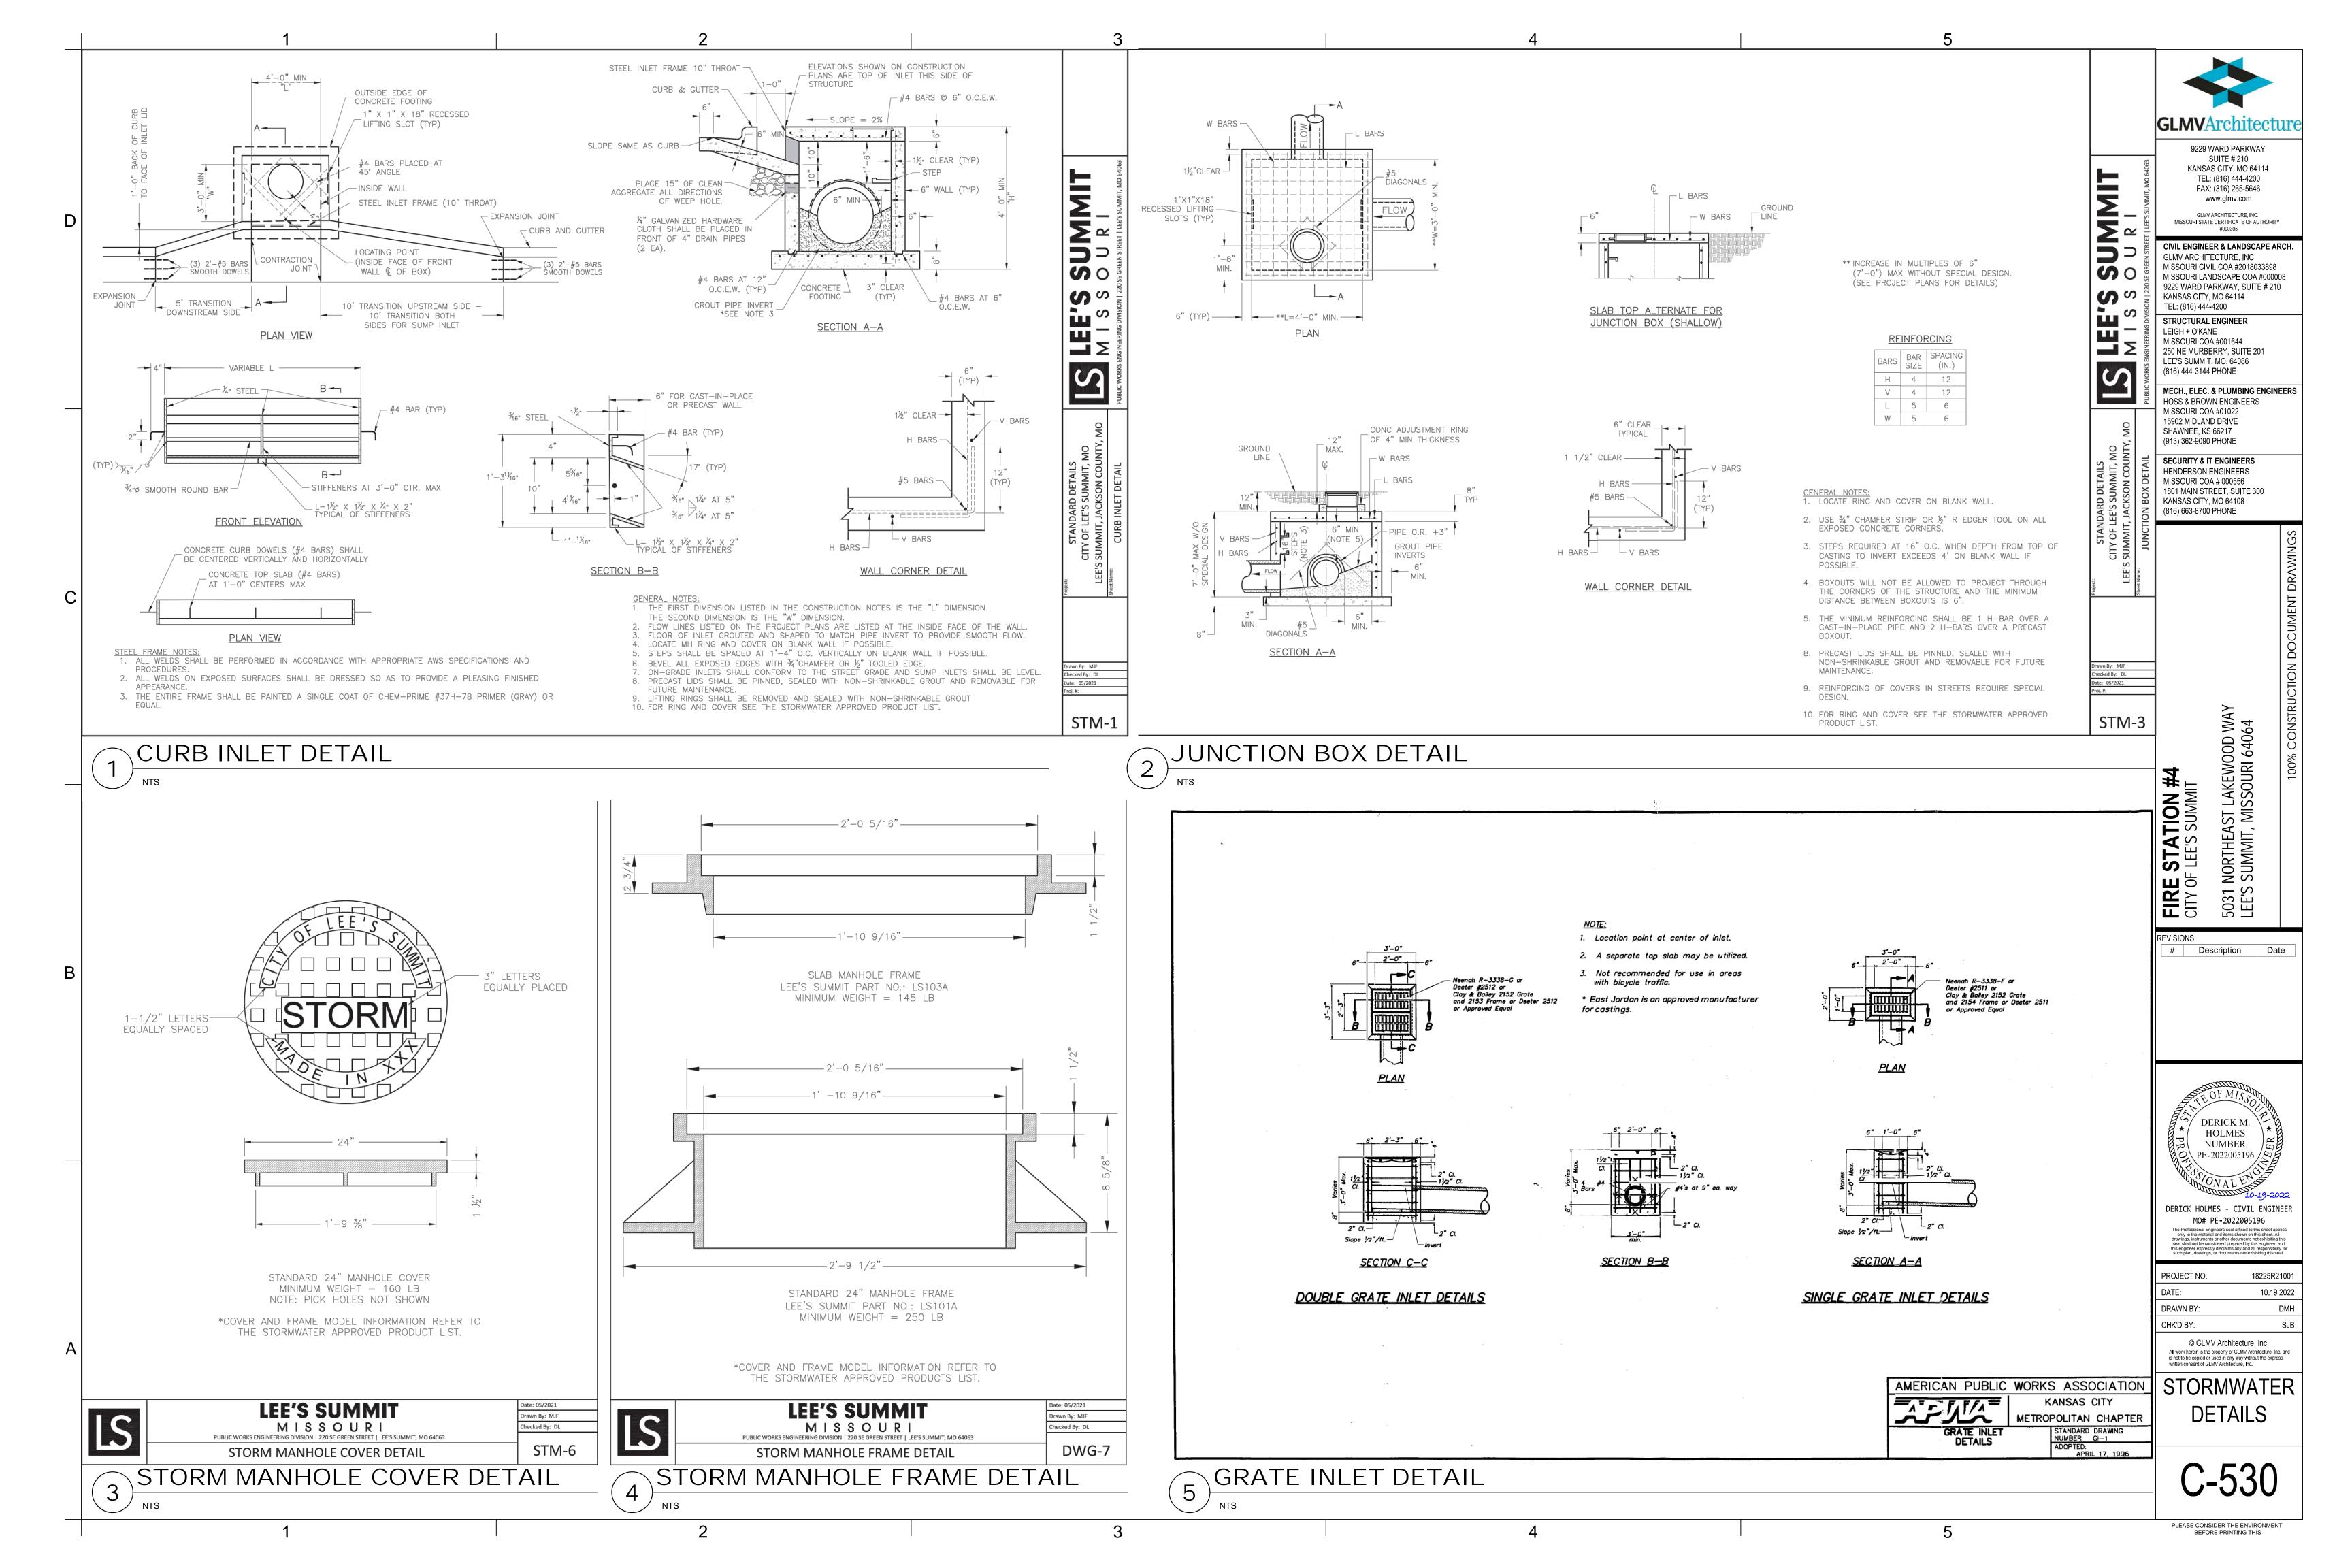
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WATER DETAILS

C-521

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3



Section 2721

Engineered Surface Drainage Products

PVC surface drainage inlets shall include the drain basin type as indicated on the contract drawing and referenced within the contract specifications. The ductile iron grates for each of these fittings are to be considered an integral part of the surface drainage inlet and shall be furnished by the same manufacturer. The surface drainage inlets shall be as manufactured by Nyloplast a division of Advanced Drainage Systems, Inc., or prior approved equal.

MATERIALS

The drain basins required for this contract shall be manufactured from PVC pipe stock, utilizing a thermoforming process to reform the pipe stock to the specified configuration. The drainage pipe connection stubs shall be manufactured from PVC pipe stock and formed to provide a watertight connection with the specified pipe system. This joint tightness shall conform to ASTM D3212 for joints for drain and sewer plastic pipe using flexible elastomeric seals. The flexible elastomeric seals shall conform to ASTM F477. The pipe bell spigot shall be joined to the main body of the drain basin or catch basin. The raw material used to manufacture the pipe stock that is used to manufacture the main body and pipe stubs of the surface drainage inlets shall conform to ASTM D1784 cell class 12454.

The grates and frames furnished for all surface drainage inlets shall be ductile iron for structure sizes 8", 10", 12", 15", 18", 24", 30" and 36" and shall be made specifically for each basin so as to provide a round bottom flange that closely matches the diameter of the surface drainage inlet. Grates for drain basins shall be capable of supporting various wheel loads as specified by Nyloplast. 12" and 15" square grates will be hinged to the frame using pins. Ductile iron used in the manufacture of the castings shall conform to ASTM A536 grade 70-50-05. Grates and covers shall be provided painted black.

The specified PVC surface drainage inlet shall be installed using conventional flexible pipe backfill materials and procedures. The backfill material shall be crushed stone or other granular material meeting the requirements of class 1, class 2, or class 3 material as defined in ASTM D2321. Bedding and backfill for surface drainage inlets shall be well placed and compacted uniformly in accordance with ASTM D2321. The drain basin body will be cut at the time of the final grade. No brick, stone or concrete block will be required to set the grate to the final grade height. For load rated installations, a concrete slab shall be poured under and around the grate and frame. The concrete slab must be designed taking into consideration local soil conditions, traffic loading, and other applicable design factors. For other installation considerations such as migration of fines, ground water, and soft foundations refer to ASTM D2321 guidelines.

THIS PRINT DISCLOSES SUBJECT MATTER IN WHICH	DRAWN BY	CJA	MATERIAL					$\overline{}$	3130 VERONA AVE	
NYLOPLAST HAS PROPRIETARY RIGHTS. THE RECEIPT			l				1 ((200)	BUFORD, GA 30518	
OR POSSESSION OF THIS PRINT DOES NOT CONFER,	DATE	3-10-00	l						PHN (770) 932-2443	
TRANSFER, OR LICENSE THE USE OF THE DESIGN OR							NV	oblast	FAX (770) 932-2490	
TECHNICAL INFORMATION SHOWN HEREIN	REVISED B	Y NMH	PROJECT N	O./NAME			בעיב	Picci	www.nyloplast-us.co	ì
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DWG SIZE A SCALE 1:1 SHEET 1 OF 1 DWG NO. 7001-110-011 REV J

8 IN - 36 IN DRAIN BASIN SPECIFICATIONS

JUSTICE, 28 CFR PART 36.

1099CGSF APPROX. DRAIN AREA = 37.35 SQ IN APPROX. WEIGHT = 15.40 LBS DIMENSIONS ARE FOR REFERENCE ONLY 3130 VERONA AVE BUFORD, GA 30518 ACTUAL DIMENSIONS MAY VARY NYLOPLAST HAS PROPRIETARY RIGHTS. THE RECEIPT DIMENSIONS ARE IN INCHES PHN (770) 932-2443 OR POSSESSION OF THIS PRINT DOES NOT CONFER. GRATE HAS LIGHT DUTY RATING ANSFER, OR LICENSE THE USE OF THE DESIGN OR FAX (770) 932-2490 QUALITY: MATERIALS SHALL CONFORM TO ASTM A536 GRADE 70-50-05 TECHNICAL INFORMATION SHOWN HEREIN PAINT: CASTINGS ARE FURNISHED WITH A BLACK PAINT PRODUCTION OF THIS PRINT OR ANY INFORMATION NTAINED HEREIN, OR MANUFACTURE OF ANY SIZE OF OPENING MEETS REQUIREMENTS OF AMERICAN DISABILITY ACT AS STATED IN FEDERAL REGISTER PART III, DEPARTMENT OF

10" STANDARD GRATE ASSEMBLY - TYPE B

S FORBIDDEN, EXCEPT BY SPECIFIC WRITTEN

7001-110-540

DWG SIZE A SCALE 1:5 SHEET 1 OF 1 DWG NO.

OR POSSESSION OF THIS PRINT DOES NOT CONFER, DIMENSIONS ARE IN INCHES Nyloplast FAX (770) 932-2490 www.nyloplast-us.c ANSFER, OR LICENSE THE USE OF THE DESIGN OR GRATE MEETS H-20 LOAD RATING CHNICAL INFORMATION SHOWN HEREIN QUALITY: MATERIALS SHALL CONFORM TO ASTM A536 GRADE 70-50-05 ODLICTION OF THIS PRINT OR ANY INFORMATION PAINT: CASTINGS ARE FURNISHED WITH A BLACK PAINT ONTAINED HEREIN, OR MANUFACTURE OF ANY LOCKING DEVICE AVAILABLE UPON REQUEST SEE DRAWING NO. IS FORBIDDEN, EXCEPT BY SPECIFIC WRITTEN PERMISSION FROM NYLOPLAST. @22010 DWG SIZE A SCALE 1:10 SHEET 1 OF 1 DWG NO.

NYLOPLAST 24" DRAIN BASIN: 2824AG _ _X (1, 2) INTEGRATED DUCTILE IRON FRAME & GRATE TO MATCH BASIN O.D. 18" MIN WIDTH GUIDELINE 8" MIN THICKNESS GUIDELINE MINIMUM PIPE BURIAL DEPTH PER PIPE MANUFACTURER (3) VARIABLE INVERT HEIGHTS RECOMMENDATION AVAILABLE (ACCORDING TO TRAFFIC LOADS: CONCRETE SLAB DIMENSIONS ARE FOR (MIN. MANUFACTURING (5) ADAPTER ANGLES PLANS/TAKE OFF) GUIDELINE PURPOSES ONLY. ACTUAL CONCRETE SLAB MUST BE REQ. SAME AS MIN. SUMP) DESIGNED TAKING INTO CONSIDERATION LOCAL SOIL CONDITIONS, VARIABLE 0° - 360° TRAFFIC LOADING, & OTHER APPLICABLE DESIGN FACTORS. SEE DRAWING NO. 7001-110-111 FOR NON TRAFFIC INSTALLATION. (3) VARIABLE SUMP DEPTH ACCORDING TO PLANS (6" MIN. BASED ON MANUFACTURING REQ.) (4) VARIOUS TYPES OF INLET & OUTLET ADAPTERS AVAILABLE: 4" - 24" FOR CORRUGATED HDPE (ADS N-12/HANCOR DUAL WALL, ADS/HANCOR SINGLE WALL), N-12 HP, PVC SEWER (EX: SDR 35), PVC DWV (EX: SCH 40), PVC C900/C905, CORRUGATED & RIBBED PVC THE BACKFILL MATERIAL SHALL BE CRUSHED STONE OR OTHER GRANULAR MATERIAL MEETING THE REQUIREMENTS OF CLASS I. WATERTIGHT JOINT CLASS II, OR CLASS III MATERIAL AS DEFINED IN ASTM D2321. (CORRUGATED HDPE SHOWN) BEDDING & BACKFILL FOR SURFACE DRAINAGE INLETS SHALL BE PLACED & COMPACTED UNIFORMLY IN ACCORDANCE WITH ASTM D2321. - GRATES/SOLID COVER SHALL BE DUCTILE IRON PER ASTM A536 GRADE 70-50-05. HIS PRINT DISCLOSES SUBJECT MATTER IN WHICH - FRAMES SHALL BE DUCTILE IRON PER ASTM A536 GRADE 70-50-05. NYLOPLAST HAS PROPRIETARY RIGHTS. THE RECEIPT BUFORD, GA 30518 - DRAIN BASIN TO BE CUSTOM MANUFACTURED ACCORDING TO PLAN DETAILS. POSSESSION OF THIS PRINT DOES NOT CONFER. PHN (770) 932-2443 RISERS ARE NEEDED FOR BASINS OVER 84" DUE TO SHIPPING RESTRICTIONS. Nyloplast FAX (770) 932-2490 ANSFER, OR LICENSE THE USE OF THE DESIGN OR SEE DRAWING NO. 7001-110-065. TECHNICAL INFORMATION SHOWN HEREIN - DRAINAGE CONNECTION STUB JOINT TIGHTNESS SHALL CONFORM TO DDUCTION OF THIS PRINT OR ANY INFORMATION ASTM D3212 FOR CORRUGATED HDPE (ADS N-12/HANCOR DUAL WALL), N-12 HP NTAINED HEREIN, OR MANUFACTURE OF ANY 24 IN DRAIN BASIN QUICK SPEC INSTALLATION DETAIL

24" DRAIN BASIN QUICK SPEC INSTALLATION DETAIL

DWG SIZE A SCALE 1:40 SHEET 1 OF 1 DWG NO.

7001-110-192 REV E

PHN (770) 932-2443

18 IN STANDARD GRATE ASSEMBLY - TYPE C

RTICLE HEREFROM, FOR THE DISCLOSURE TO OTHERS

S FORBIDDEN, EXCEPT BY SPECIFIC WRITTEN

- ADAPTERS CAN BE MOUNTED ON ANY ANGLE 0° TO 360°. TO DETERMINE MINIMUM

ANGLE BETWEEN ADAPTERS SEE DRAWING NO. 7001-110-012.

APPROX, DRAIN AREA = 116.72 SQ IN APPROX. WEIGHT WITH FRAME = 68.50 LBS DIMENSIONS ARE FOR REFERENCE ONLY THIS PRINT DISCLOSES SUBJECT MATTER IN WHICH ACTUAL DIMENSIONS MAY VARY BUFORD, GA 30518 NYLOPLAST HAS PROPRIETARY RIGHTS. THE RECEIPT

18" STANDARD GRATE ASSEMBLY-TYPE C

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STRUCTURAL ENGINEER LEIGH + O'KANE MISSOURI COA #001644

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HOSS & BROWN ENGINEERS

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HENDERSON ENGINEERS MISSOURI COA # 000556 1801 MAIN STREET, SUITE 300 KANSAS CITY, MO 64108 (816) 663-8700 PHONE

REVISIONS: # Description


HOLMES NUMBER DERICK HOLMES - CIVIL ENGINEER

PROJECT NO: 18225R21001 DATE: 10.19.2022 DRAWN BY: CHK'D BY:

MO# PE-2022005196

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STORMWATER DETAILS

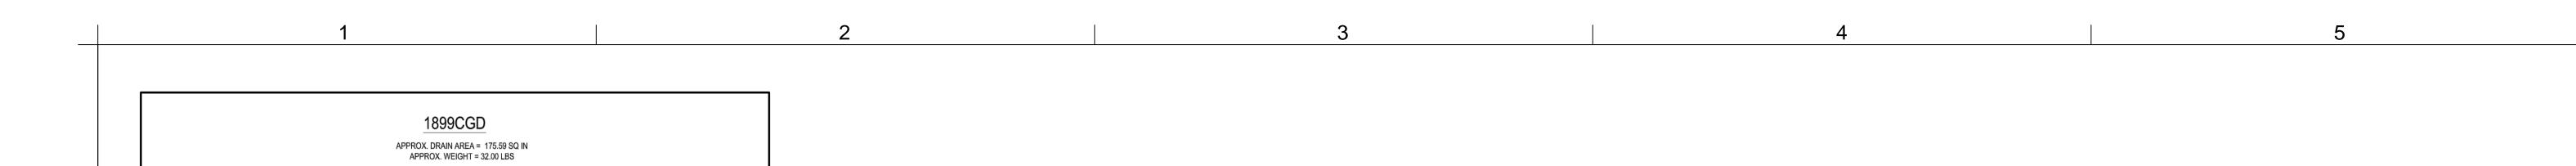

3099CGRDF & 3099CGRFH

APPROX. GRATE DRAIN AREA = 232.87 SQ IN

*APPROX. WEIGHT WITH FRAME & HOOD = 344.00 LBS

ADJUSTMENT SLOTS

24.25 27.25

2' X 3' CURB INLET

16 X SLOT Ø 1.00 THRU

DIAGONAL GRATE

3099CGRDF

2' X 3' CURB INLET

FRAME & HOOD



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KANSAS CITY, MO 64108 (816) 663-8700 PHONE

BUFORD, GA 30518

PHN (770) 932-2443

Nyloplast FAX (770) 932-2490 www.nyloplast-us.com

12 IN INLINE DRAIN QUICK SPEC INSTALLATION DETAIL

7003-110-025 REV E

REVISIONS: # Description

DERICK M. HOLMES NUMBER PE 2022005196 /

PROJECT NO: 18225R21001 DATE: 10.19.2022


DERICK HOLMES - CIVIL ENGINEER

MO# PE-2022005196

DRAWN BY: CHK'D BY:

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STORMWATER DETAILS

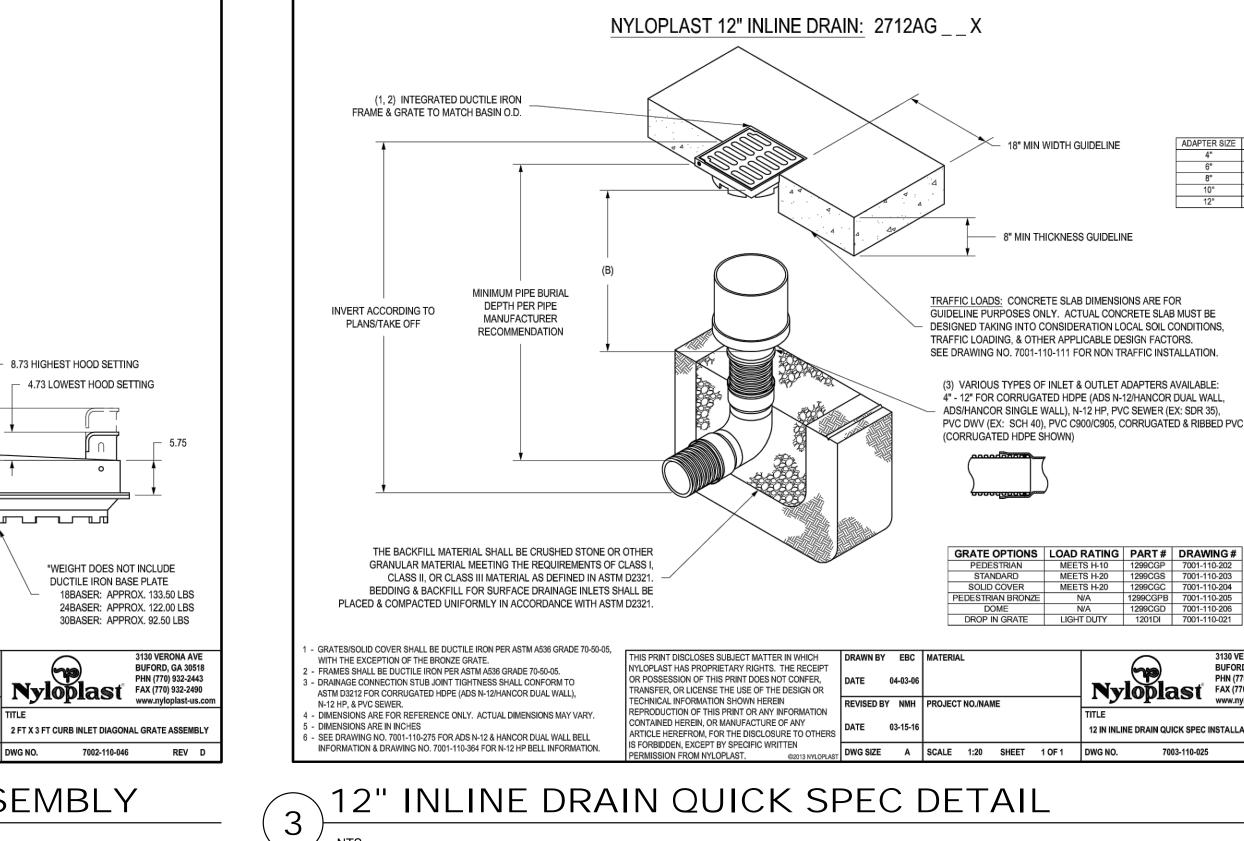

DIMENSIONS ARE FOR REFERENCE ONLY TOP OF BASE PLATE TO TOP OF DRAIN BASIN ACTUAL DIMENSIONS MAY VARY DIMENSIONS ARE IN INCHES 24BASER: 2.83 GRATE MEETS H-20 LOAD RATING 30BASER: .44 QUALITY: MATERIALS SHALL CONFORM TO ASTM A536 GRADE 70-50-05 PAINT: CASTINGS ARE FURNISHED WITH A BLACK PAINT LOCKING DEVICE AVAILABLE UPON REQUEST SEE DRAWING NO. 7002-110-057 THIS PRINT DISCLOSES SUBJECT MATTER IN WHICH NYLOPLAST HAS PROPRIETARY RIGHTS. THE RECEIPT SLOPE OF GRATE SURFACE IS 5.2% CURB INLET FRAME INSIDE VOLUME IS APPROX 2.73 CU FT APPROX. DRAIN AREA OF GRATE & HOOD Nyloplast FAX (770) 932-2490 TRANSFER, OR LICENSE THE USE OF THE DESIGN OR LOWEST SETTING = 369.54 SQ IN TECHNICAL INFORMATION SHOWN HEREIN LOWEST + 1" SETTING = 402.41 SQ IN REPRODUCTION OF THIS PRINT OR ANY INFORMATION LOWEST + 2" SETTING = 435.29 SQ IN CONTAINED HEREIN, OR MANUFACTURE OF ANY 2 FT X 3 FT CURB INLET DIAGONAL GRATE ASSEMBLY LOWEST + 3" SETTING = 468.16 SQ IN ARTICLE HEREFROM. FOR THE DISCLOSURE TO OTHERS S FORBIDDEN, EXCEPT BY SPECIFIC WRITTEN HIGHEST SETTING = 501.04 SQ IN DWG SIZE A SCALE 1:16 SHEET 1 OF 1 DWG NO.

2'x3' CURB INLET DIAGONAL GRATE ASSEMBLY

NYLOPLAST 18" DRAIN BASIN: 2818AG _ X (1, 2) INTEGRATED DUCTILE IRON FRAME & GRATE TO MATCH BASIN O.D. 18" MIN WIDTH GUIDELINE - 8" MIN THICKNESS GUIDELINE MINIMUM PIPE BURIAL DEPTH PER PIPE MANUFACTURER (3) VARIABLE INVERT HEIGHTS RECOMMENDATION AVAILABLE (ACCORDING TO (MIN. MANUFACTURING PLANS/TAKE OFF) TRAFFIC LOADS: CONCRETE SLAB DIMENSIONS ARE FOR ANGLES REQ. SAME AS MIN. SUMP) GUIDELINE PURPOSES ONLY. ACTUAL CONCRETE SLAB MUST BE DESIGNED TAKING INTO CONSIDERATION LOCAL SOIL CONDITIONS, ACCORDING TO PLANS TRAFFIC LOADING, & OTHER APPLICABLE DESIGN FACTORS. SEE DRAWING NO. 7001-110-111 FOR NON TRAFFIC INSTALLATION. (3) VARIABLE SUMP DEPTH ACCORDING TO PLANS (6" MIN. BASED ON (4) VARIOUS TYPES OF INLET & OUTLET ADAPTERS AVAILABLE: MANUFACTURING REQ.) 4" - 18" FOR CORRUGATED HDPE (ADS N-12/HANCOR DUAL WALL, ADS/HANCOR SINGLE WALL), N-12 HP, PVC SEWER (EX: SDR 35), PVC DWV (EX: SCH 40), PVC C900/C905, CORRUGATED & RIBBED PVC THE BACKFILL MATERIAL SHALL BE CRUSHED STONE OR OTHER GRANULAR MATERIAL MEETING THE REQUIREMENTS OF CLASS I, (CORRUGATED HDPE SHOWN) CLASS II, OR CLASS III MATERIAL AS DEFINED IN ASTM D2321. BEDDING & BACKFILL FOR SURFACE DRAINAGE INLETS SHALL BE PLACED & COMPACTED UNIFORMLY IN ACCORDANCE WITH ASTM D2321.
 GRATE OPTIONS
 LOAD RATING
 PART #
 DRAWING #

 PEDESTRIAN
 MEETS H-10
 1899CGP
 7001-110-212

 STANDARD
 MEETS H-20
 1899CGS
 7001-110-213

 SOLID COVER
 MEETS H-20
 1899CGC
 7001-110-214

 DOME
 N/A
 1899CGD
 7001-110-215

 DROP IN GRATE
 LIGHT DUTY
 1801DI
 7001-110-074
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REINFORCING

BARS SIZE SPACING

ALL REINFORCEMENT IS

TO BE EPOXY COATED

QUALITY: MATERIALS SHALL CONFORM TO ASTM A536 GRADE 70-50-05

18" DOME GRATE

CONCRETE ADJUSTMENT RING OR -

4" MINIMUM THCKNESS

W BARS -

PAINT: CASTINGS ARE FURNISHED WITH A BLACK PAINT

ACTUAL DIMENSIONS MAY VARY

DIMENSIONS ARE IN INCHES

18 IN DRAIN BASIN QUICK SPEC INSTALLATION DETAIL

BUFORD, GA 30518

FAX (770) 932-2490

7001-110-215

REF: 3 / C-530

REF: 1 / C-500

TYP. CONCRETE PAVING

- 12" LONG #4 BAR 12" O.C. EPOXY

TYP. 4 SIDES


GROUT INTO EXISTING STRUCTURE.


PLEASE CONSIDER THE ENVIRONMENT


DUCTILE IRON

SHEET 1 OF 1 DWG NO.

A SCALE 1:6

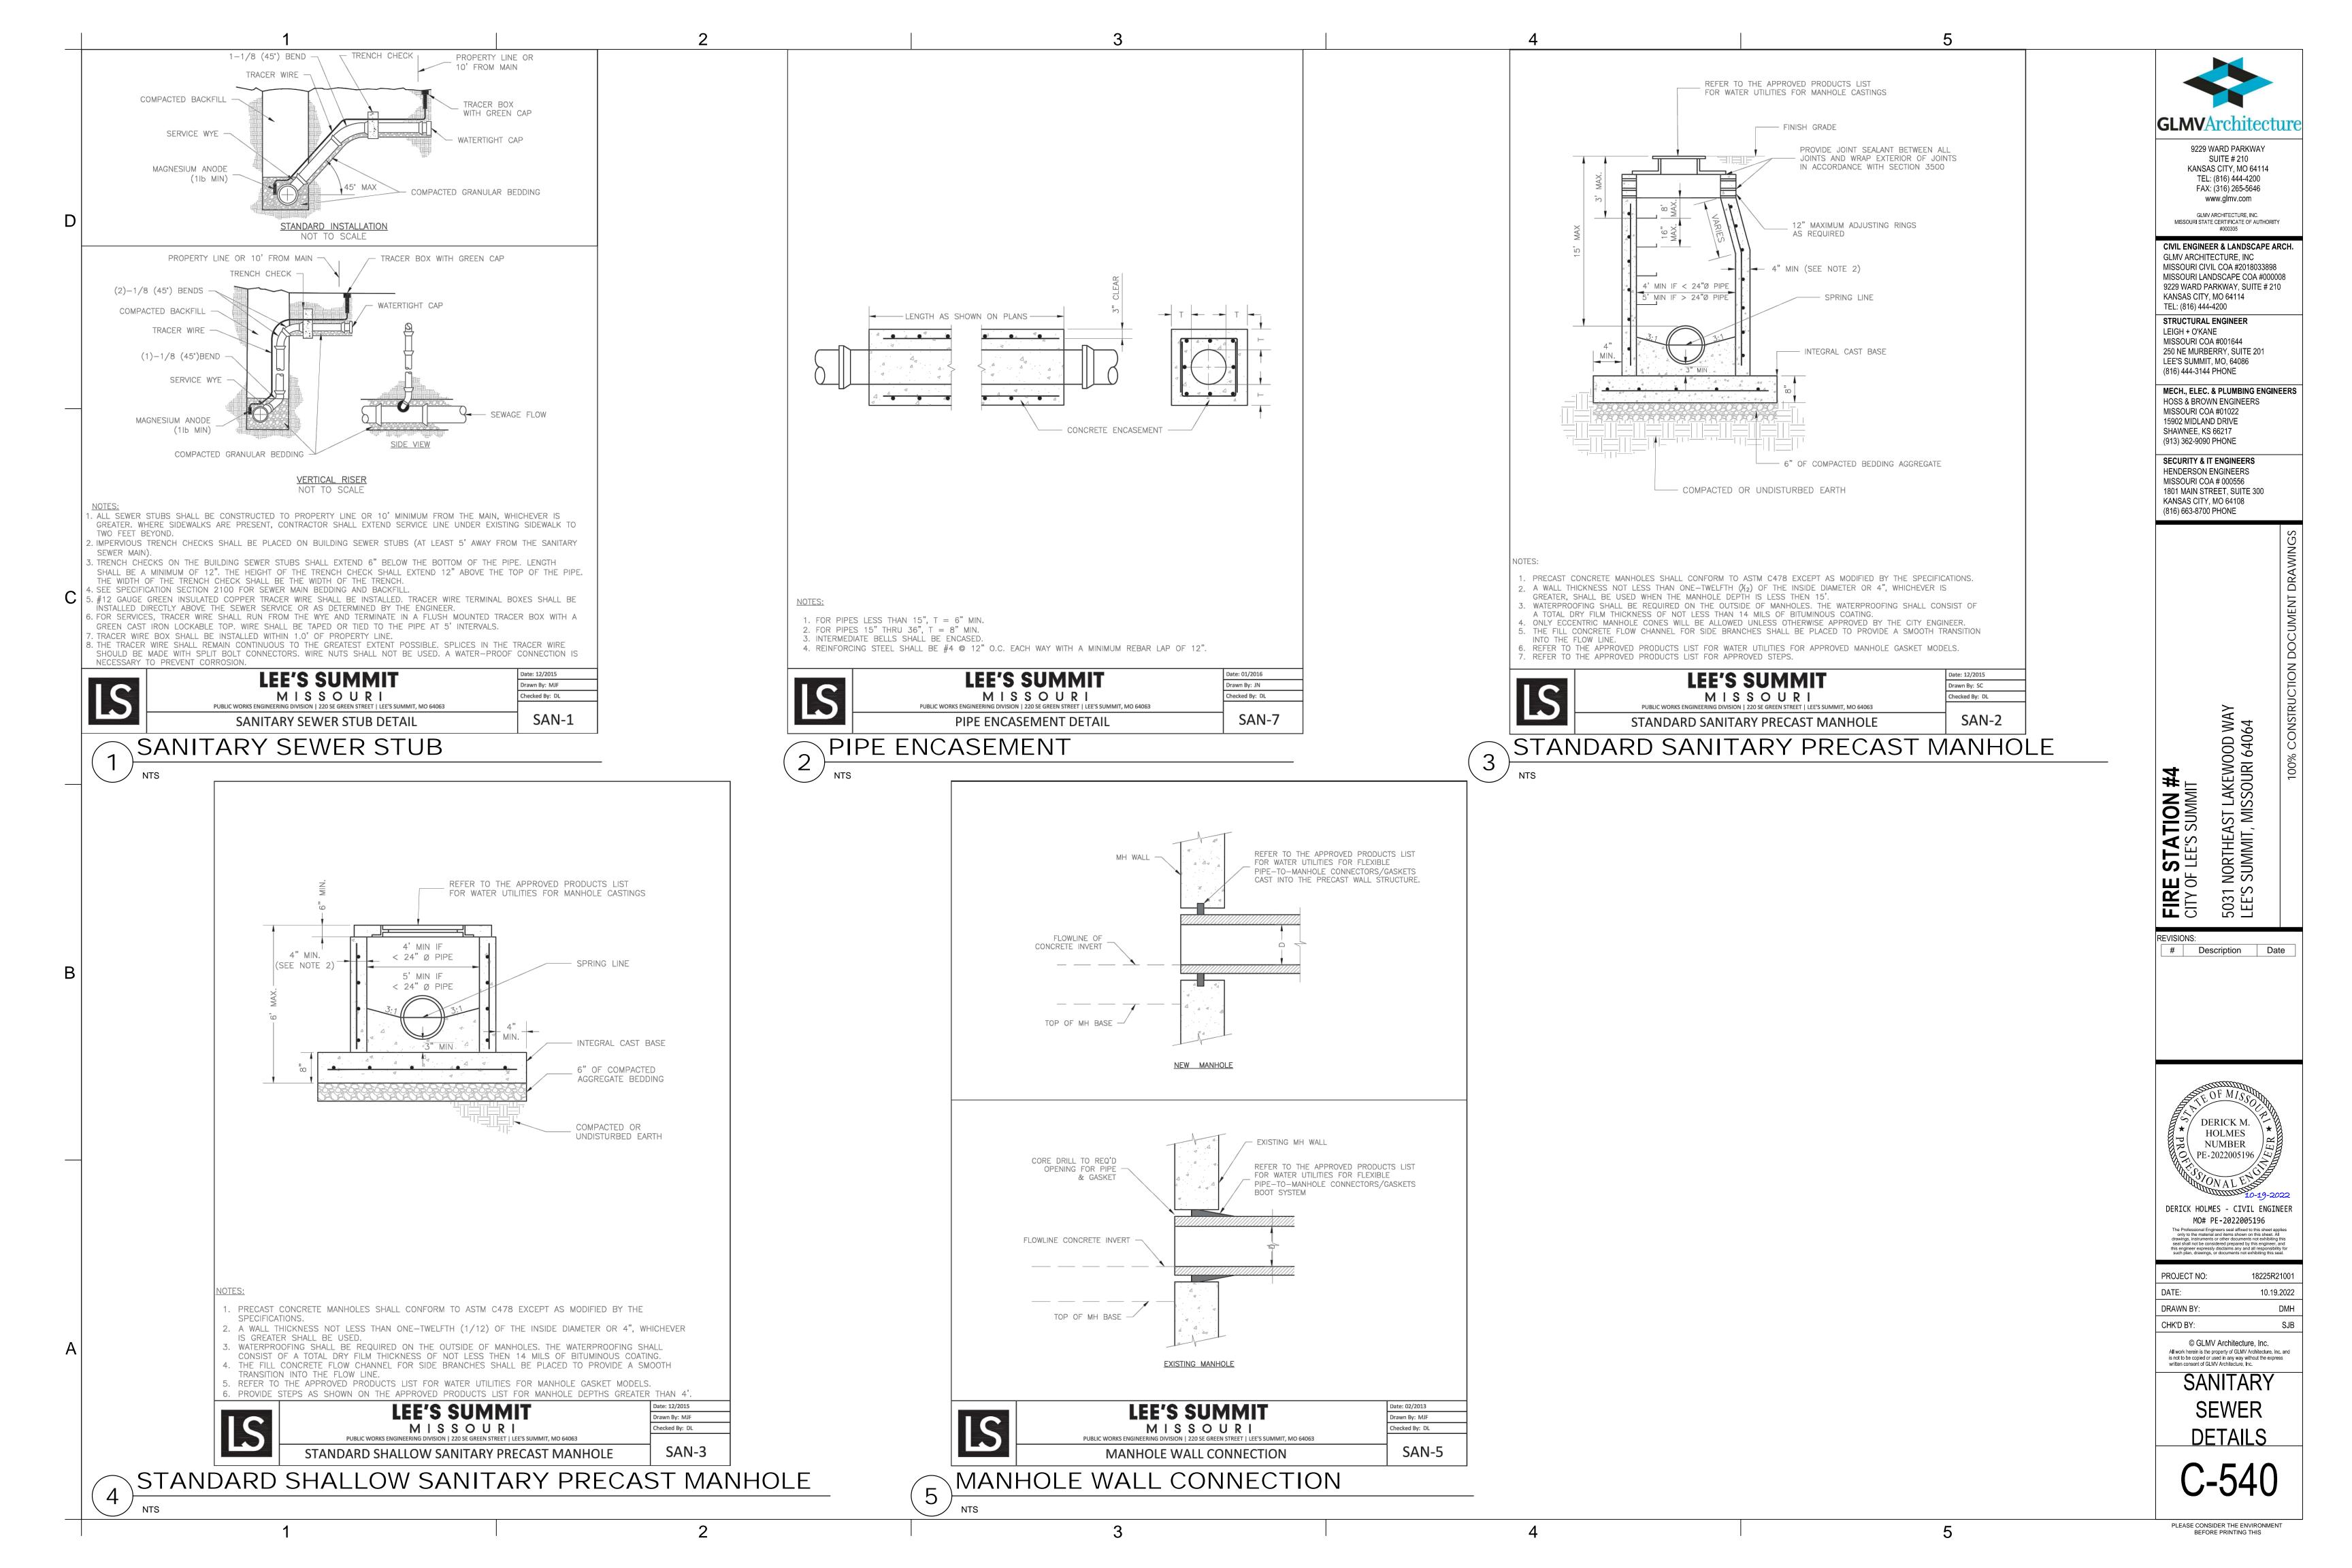

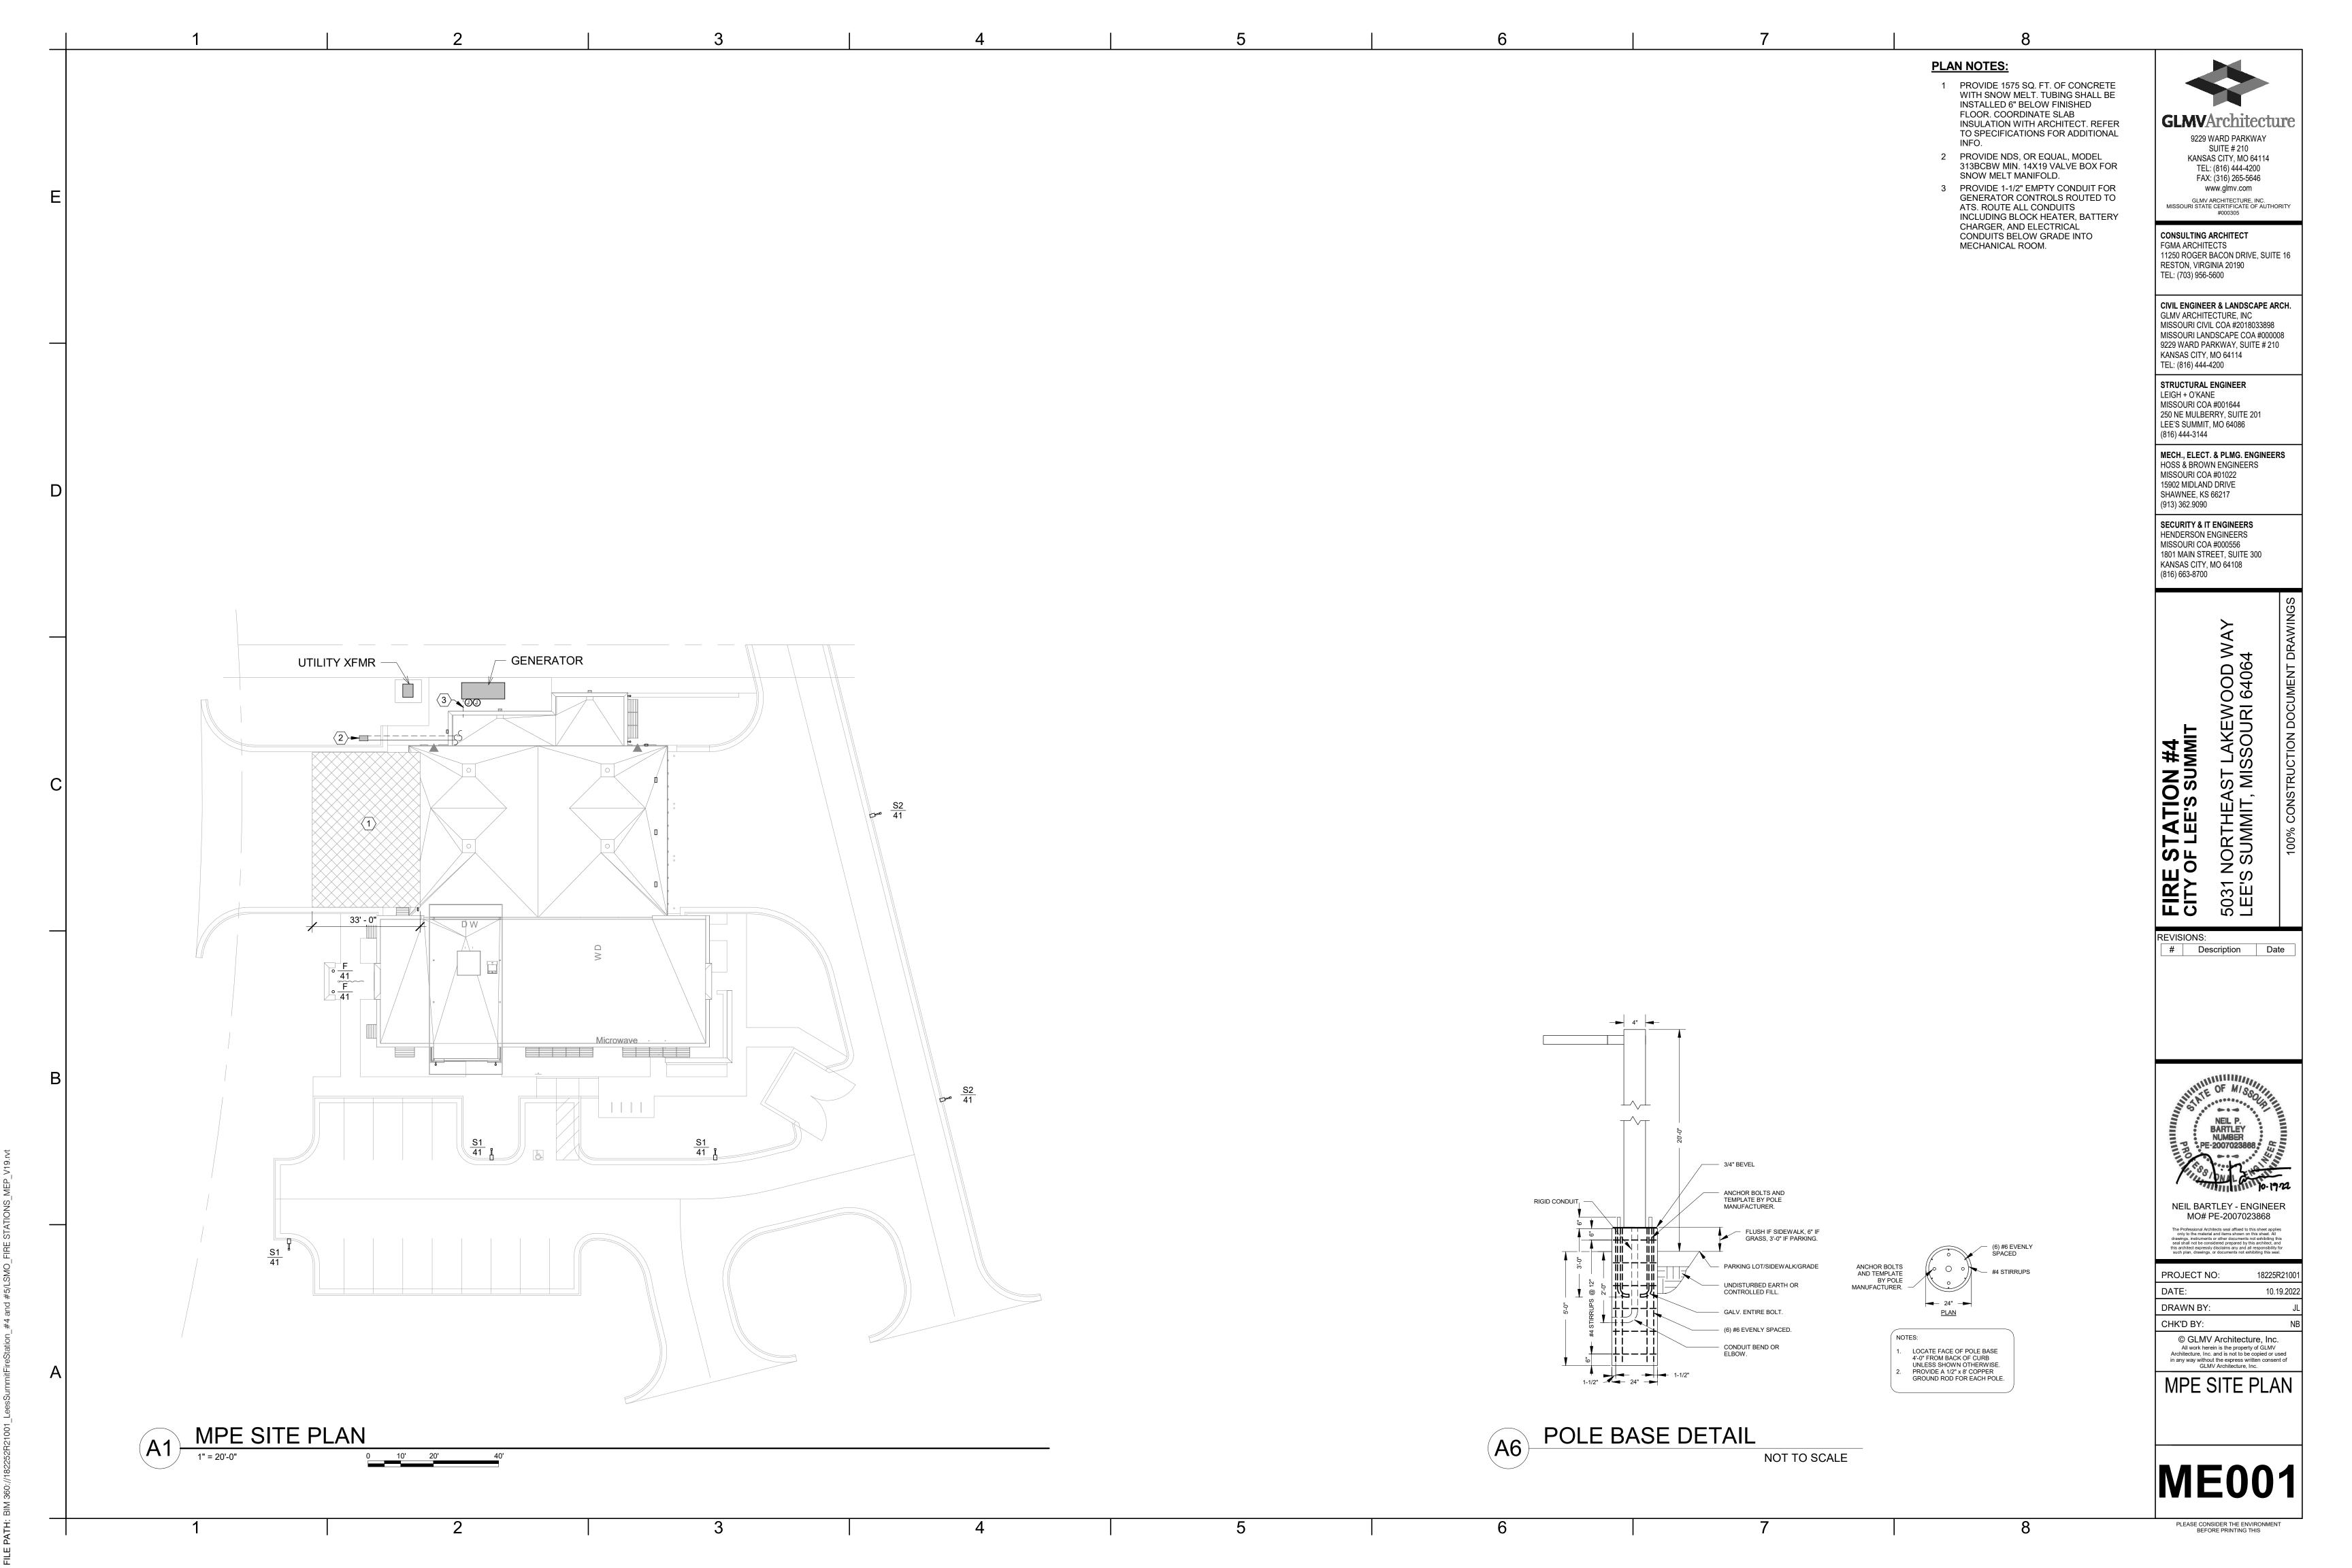

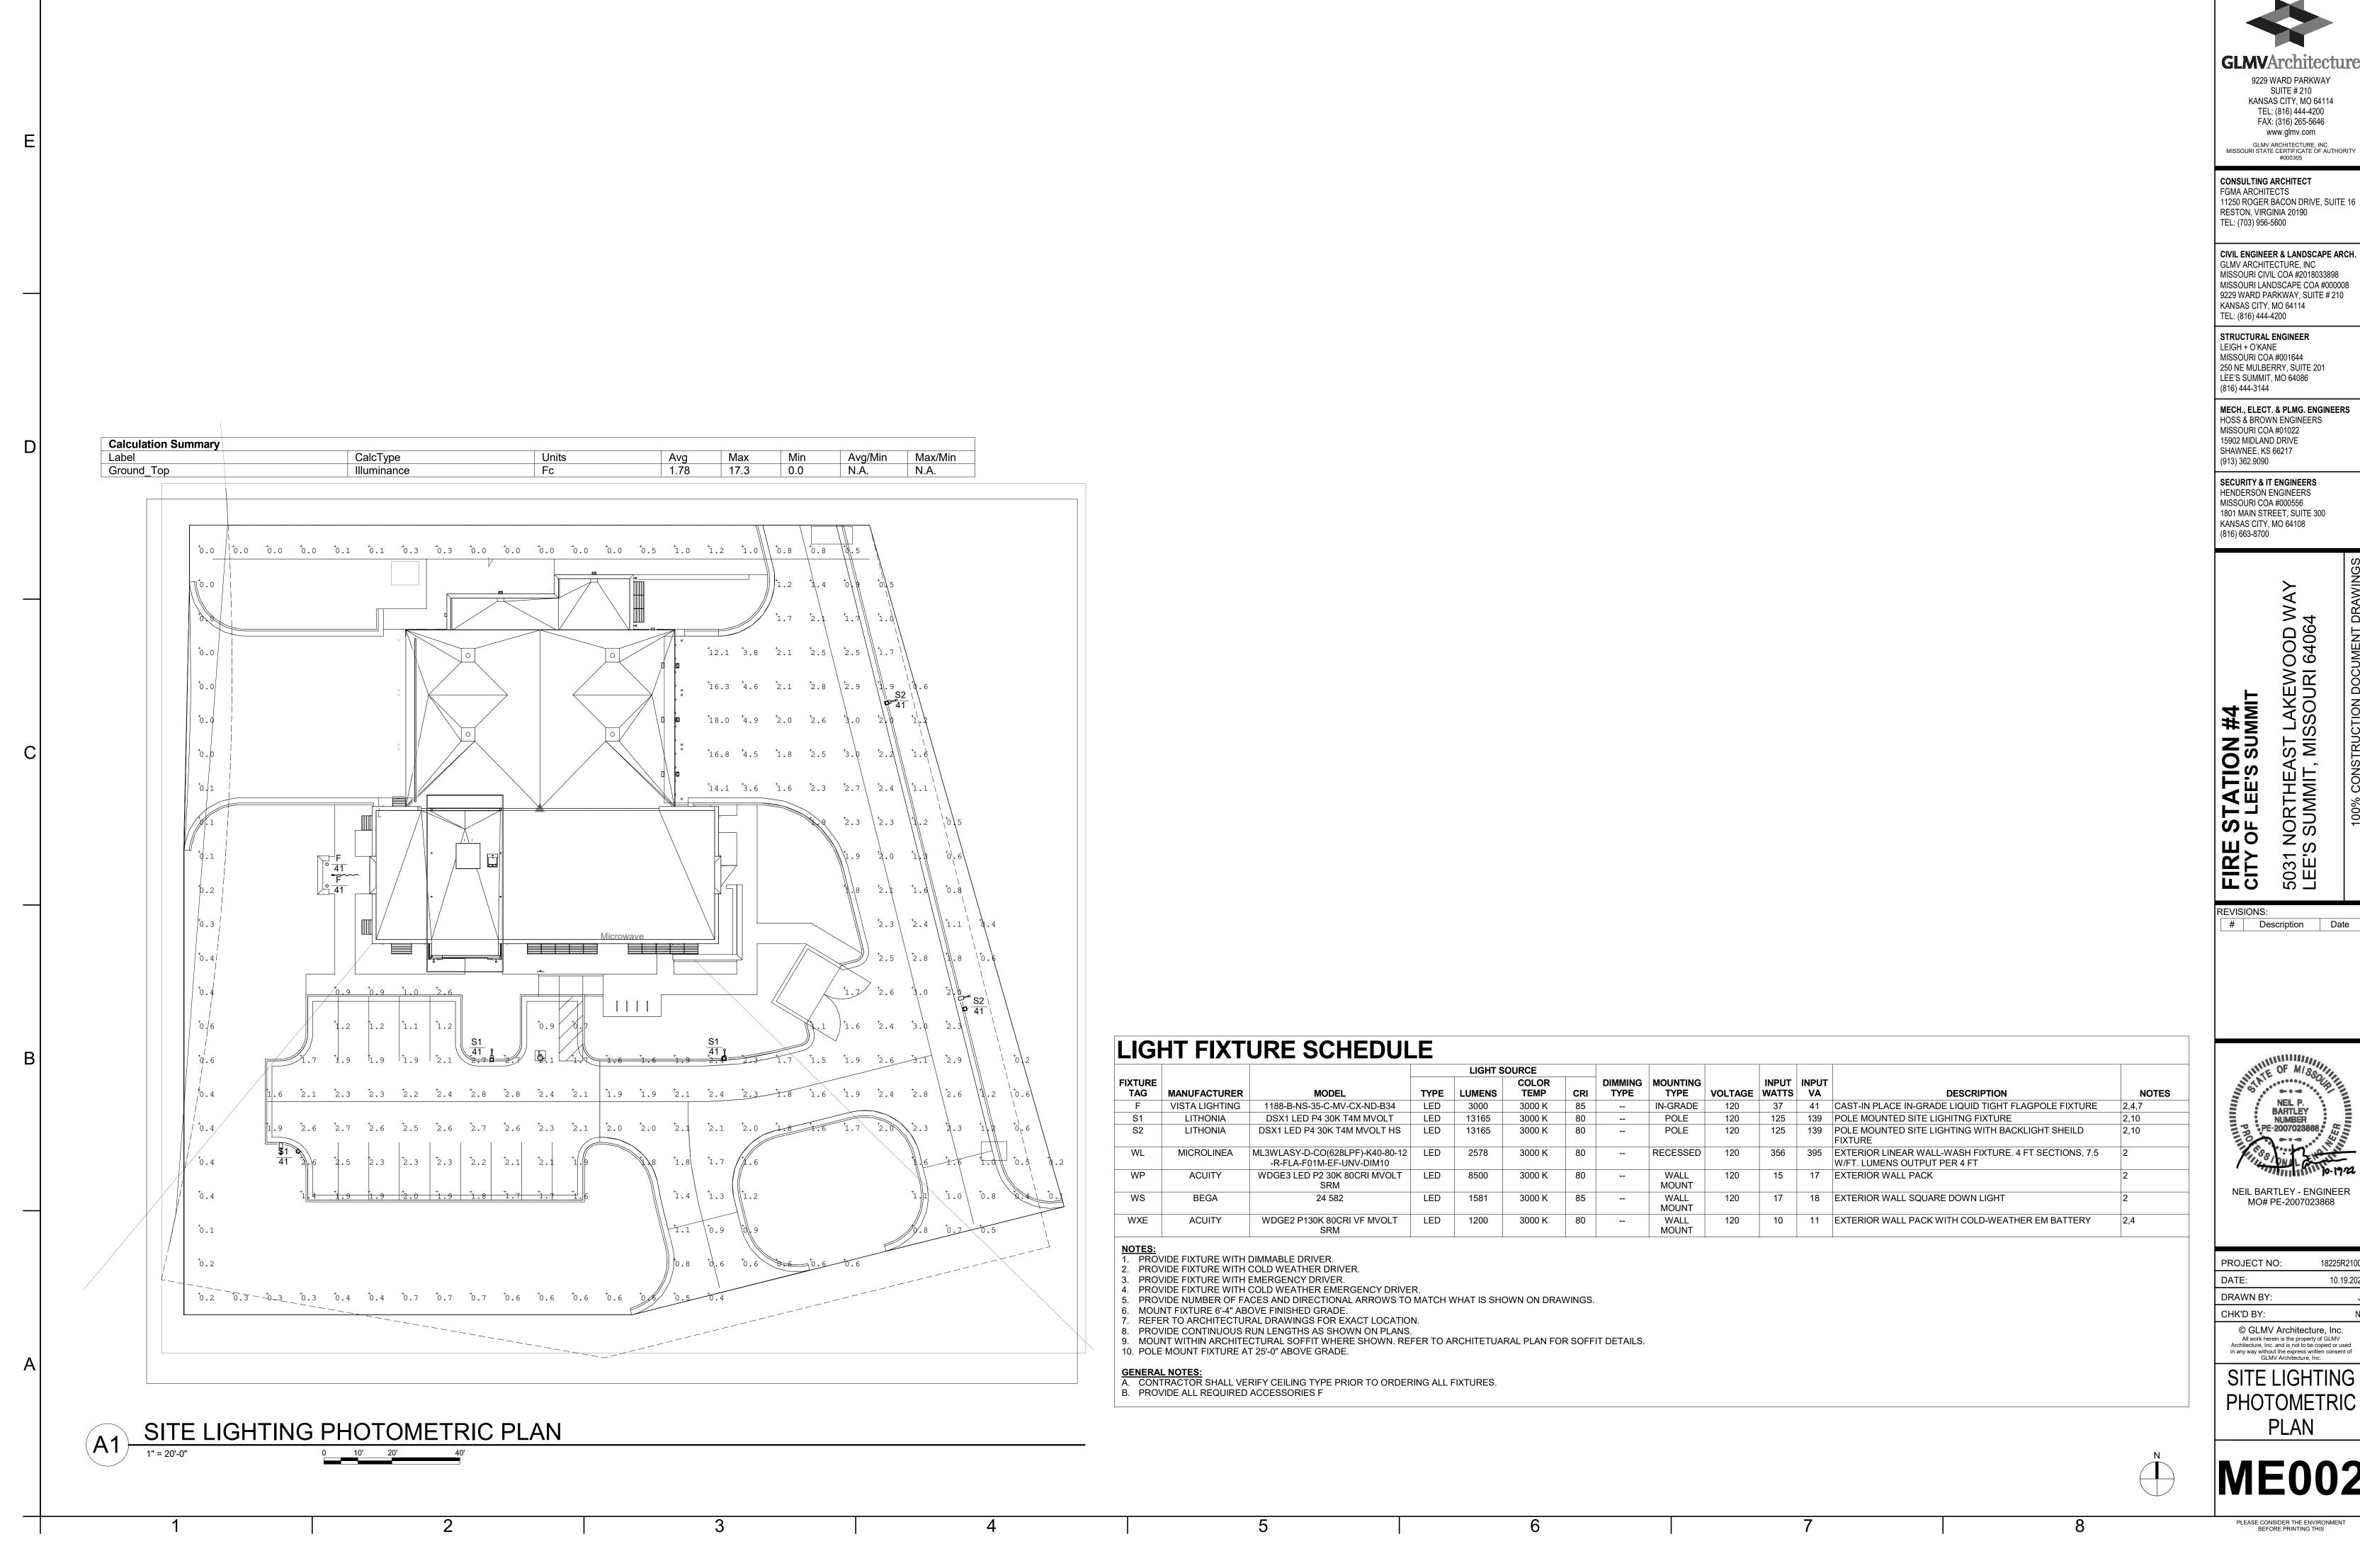



	PROJECT NO: 1	8225R21001
	DATE:	10.19.2022
	DRAWN BY:	JL
	CHK'D BY:	NB
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PLAN DETAIL FOR POSITIONING. DO NOT ALLOW STAKE TO PIERCE ROOTBALL. NOTCH STAKE FOR WIRE. POLYPROPYLENE TREE STRAP AT 2/3 TREE HEIGHT WITH NO. 12 GA. GALVANIZED WIRE. PROVIDE SUFFICIENT TENSION TO SUPPORT TREE BUT DO NOT GIRDLE TOP OF ROOTBALL AT 2" ABOVE FINISHED GRADE REMOVE TOP 1/3 OF BURLAP AND ROPE FROM BALL - 3" DEPTH HARDWOOD MULCH. KEEP 4" AWAY FROM TRUNK. NOTE: ALL TREES, EXISTING AND PROPOSED, IN TURF AREAS FINISHED GRADE / SHALL HAVE 5' DIAM. MULCH RING. THIS DIMENSION EQUALS 1/2 THE DIAMETER OF THE ROOTBALL AT THE CENTERLINE OF ROOTBALL. 1/2 BALL DIA. PLACE TREE IN PLANTING POSITION, BACK FILL 1/3RD OR DEPTH, THEN REMOVE ALL TWINE AND BURLAP FROM TOP OF ROOTBALL. WIRE BASKET TO REMAIN IN PLACE, BEND TOP LOOPS DOWN. EXPOSE ROOT FLARE AT BASE OF TRUNK. PLANTING SOIL BACKFILL UNDISTURBED SUBGRADE **PREVAILING** WINDS

2x2 SOUND HARDWOOD STAKE - SEE

NOTE: REMOVE STAKING MATERIAL AFTER FIRST GROWING SEASON

 $==\pm\pm$ VERTICAL AND DRIVEN 2'-0" MIN. INTO UNDISTURBED SOIL. PLACE STAKE ON WINDWARD SIDE OF TRUNK, I.E. IF PREVAILING WIND IS FROM THE N/NW, GALVANIZED WIRE TIE ASSEMBLY **EXISTING TREES**

TOP OF TREE PIT (VARIES) TREE PIT EQUALS 2X DIAM. OF ROOTBALL AT CENTERLINE OF ROOTBALL BOTTOM OF TREE PIT (VARIES)

ROOTBALL VARIES 2 X 2 SOUND HARDWOOD STAKE TO BE ANGLED APPROX. 30 DEGREES FROM

PLACE STAKE ON WEST SIDE OF TREE. POLYPROPYLENE TREE STRAP ABOVE LOWEST BRANCHES WITH NO. 12 GA.

5' DIAM. MULCH RING AROUND ALL TREES IN TURF AREAS INCLUDING

> 10. CONTRACTOR TO PROVIDE A 1-YEAR WARRANTY ON ALL INSTALLED PLANTINGS FROM POINT OF SUBSTANTIAL COMPLETION.

2. CONTRACTOR SHALL VERIFY ALL PLANT COUNTS, QUANTITIES AND AREAS

5. PLANTS CALLED OUT IN PLAN ARE CONSIDERED IN CLUSTERS EVEN IF NOT

7. CONTRACTOR SHALL BE RESPONSIBLE FOR DISEASE AND PEST CONTROL

NEEDED AND CONTACT THE LANDSCAPE ARCHITECT IF THERE ARE ANY

WHEN TEMPERATURES ARE ABOVE 90°F OR BELOW 40°F AT THE TIME OF

9. PLANT MATERIAL SHALL NOT BE DELIVERED TO THE SITE NOR INSTALLED

PLANTING AND FORECASTED FOR A PERIOD OF 2 WEEKS AFTER

8. CONTRACTOR TO VERIFY, WITH SOIL ANALYSIS, THE SOIL AMENDMENT

ATTACHED BY CONNECTING LINES. CALLOUTS HAVE TOTAL COUNTS NEEDED.

COMPLETION. MAINTENANCE WORK SHALL CONSIST OF APPLYING WATER,

ORDERING OR INSTALLING MATERIALS SPECIFIED.

QUANTITIES AND LABELS.

WEEDING, AND FERTILIZING.

INADEQUATE AMENITIES.

INSTALLATION.

DURING THE MAINTENANCE PERIOD.

3. SEE PLANT SCHEDULE FOR PLANT LEGEND AND QUANTITIES.

4. SYMBOLS INDICATED ON THE PLAN TAKE PRIORITY OVER WRITTEN

6. CONTRACTOR SHALL MAINTAIN THE LANDSCAPE UNTIL SUBSTANTIAL

AND REPORT ANY DISCREPANCIES TO THE LANDSCAPE ARCHITECT PRIOR TO

- 1. PRIOR TO COMMENCEMENT OF WORK, THE CONTRACTOR SHALL GIVE 48 ALL PLANT MATERIAL SHALL BE OF EXCELLENT QUALITY. FREE OF DISEASE AND HOURS ADVANCE NOTICE TO ALL COMPANIES/UTILITIES THAT HAVE FACILITIES INFESTATION, AND TRUE TO TYPE, VARIETY, SIZE SPECIFIED, AND FORM PER THE IN THE NEAR VICINITY OF THE CONSTRUCTION TO BE PERFORMED. AMERICAN STANDARD FOR NURSERY STOCK (ANSI Z60.1, CURRENT VERSION), PUBLISHED BY THE AMERICAN NURSERYMEN'S ASSOCIATION.
 - 2. PLANT MATERIAL SHALL BE PLANTED AND MAINTAINED TO ASNS SPECIFICATIONS.
 - 3. CONTRACTOR SHALL VERIFY ALL LANDSCAPE MATERIAL QUANTITIES AND SHALL REPORT ANY DISCREPANCIES IMMEDIATELY TO THE LANDSCAPE ARCHITECT.
 - 4. NO SUBSTITUTIONS FOR VARIETY OR CULTIVAR SHALL BE ACCEPTED WITHOUT FIRST OBTAINING WRITTEN APPROVAL FROM LANDSCAPE ARCHITECT.
 - 5. ALL TREES AND SHRUBS SHALL BE LAID OUT IN A UNIFORM AND CONSISTENT PATTERN, FOLLOWING THE LANDSCAPE PLAN ACCURATELY, PAYING ATTENTION TO EVEN SPACING IN THE ROW OR COVERAGE AREA OF THE INDIVIDUAL SPECIES AND HOW IT IS BEING USED.
 - 6. ALL PLANTING BEDS ABUTTING LAWN AREAS SHALL HAVE A CULTIVATED EDGE (SEE DETAIL, THIS SHEET).
 - 7. ALL PLANTINGS SHALL BE THOROUGHLY WATERED IN WITH A GARDEN HOSE, TWICE, THE SAME DAY AS INSTALLATION TO ELIMINATE AIR POCKETS IN THE BACKFILL.
 - 8. NO PLANTINGS SHALL BE PLACED CLOSER THAN 3' FROM THE BACK OF THE CURB TO ALLOW FOR VEHICLE BUMPER OVERHANG.
 - 9. PROPOSED TREES SHALL NOT BE PLACED OVER EXISTING OR PROPOSED UTILITY SERVICE LINES. IT IS THE CONTRACTOR'S RESPONSIBILITY TO UNDERSTAND UTILITY LOCATIONS AND HAVE THEM MARKED DURING TREE PLANTING OPERATIONS. IF UTILITY IS DAMAGED DURING PLANTING, CONTRACTOR IS RESPONSIBLE FOR NOTIFYING THE GENERAL CONTRACTOR AND OWNER OF UTILITY AND PAYING FOR REPAIR OF THE DAMAGED UTILITY.
 - 10. ALL PLANTING BEDS WILL HAVE 3-INCHES OF SHREDDED BROWN HARDWOOD MULCH UNLESS OTHERWISE SPECIFIED.

EVERGREEN TREE PLANTING

DECIDUOUS TREE PLANTING

PLANTING BED EDGING (NOT-REQUIRED IN PLANTING BEDS SURROUNDED BY PAVEMENT),

FINISH

GRADE

ROOT BALL

REF: 6/L-100


COMPACTED PLANTING SOIL

SHRUB PLANTING

MIXTURE ON WHICH TO

POSITION SHRUB

SECTION

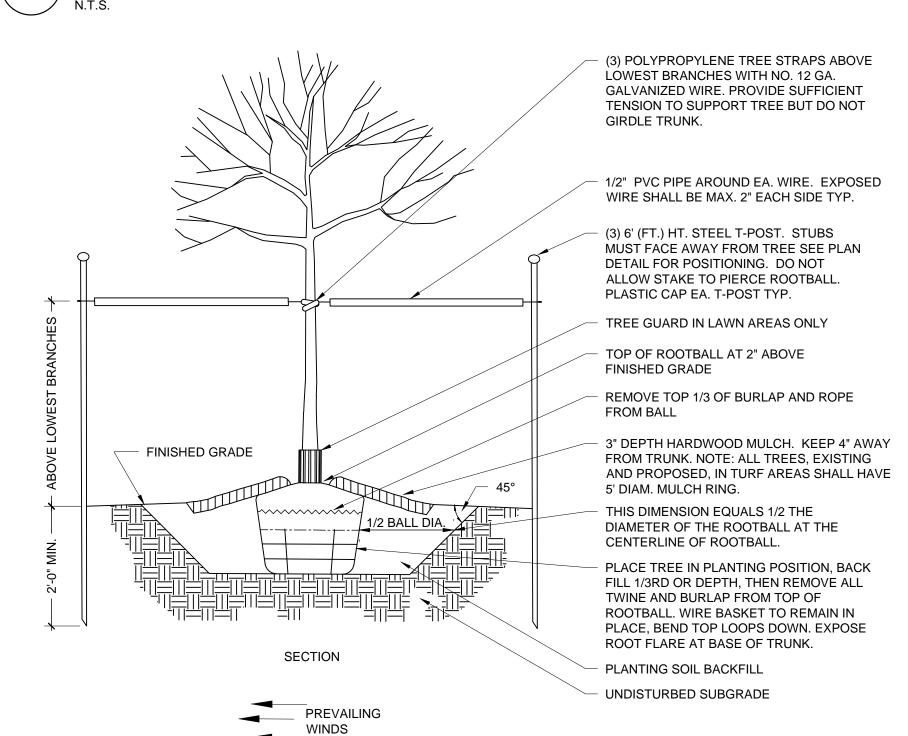

NOTE: PRUNE ALL BROKEN AND DAMAGED

(SEE SPECS)

PLANTING SOIL BACKFILL

PLANTING SOIL BACKFILL

3" DEPTH HARDWOOD MULCH

REMOVE TOP 1/3 OF BURLAP

REMOVE CONTAINER AND SLASH

SIDES OF ROOTBALL WITH (4) TO

AND ROPE FROM BALL OR

UNDISTURBED SUBGRADE


(5) 1" DEEP CUTS.

BRANCHES, AFTER PLANTING

EVERGREEN TREE STAKING

PREVAILING

WINDS

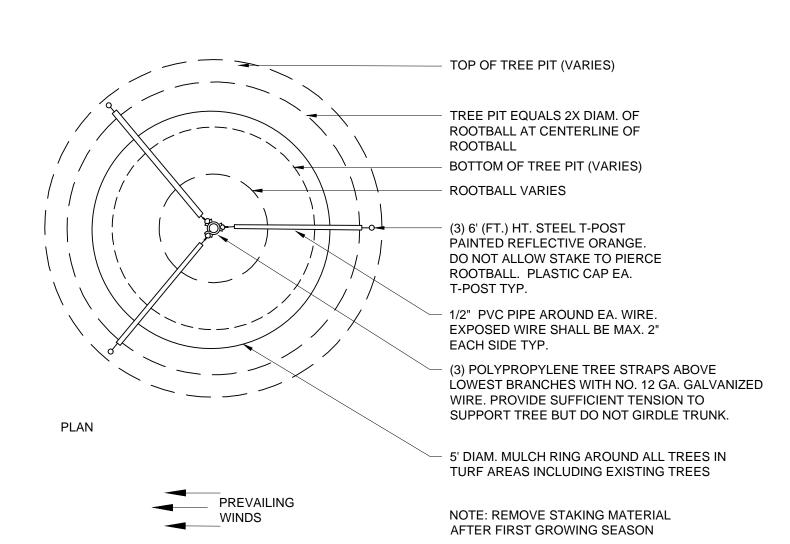

DECIDUOUS TREE STAKING

SPECIFIED MULCH CULTIVATED 12" PREPARED EDGE: 6" PLANTING SOIL **EXISTING** SUBGRADE

CULTIVATED EDGE

LANDSCAPE SCHEDULE

v v v

PLANT SCHEDULE

TREES	CODE	<u>QTY</u>	BOTANICAL NAME	COMMON NAME	CONT	SIZE
	MA	4	Malus x 'Adirondack'	Adirondack Crabapple	B & B	2.5"
•)	NW	7	Nyssa sylvatica `Wildfire`	Black Gum	B & B	2.5"
£	ZM	5	Zelkova serrata 'Musashino'	Musashino Sawleaf Zelkova	B & B	2.5"
CONIFERS	CODE	<u>QTY</u>	BOTANICAL NAME	COMMON NAME	CONT	SIZE
	РВ	2	Picea pungens `Baby Blue`	Baby Blue Colorado Spruce	6` Ht	
Manager Market	TS	18	Thuja occidentalis 'Smaragd'	Emerald Green Arborvitae	6` Ht	
SHRUBS	CODE	<u>QTY</u>	BOTANICAL NAME	COMMON NAME	CONT.	<u>SPACING</u>
5 5 5 5 5 5 5 5 5 5 5 5 5 5 5 5 5 5 5	Ca	17	Cornus sericea `Artic Fire`	Artic Fire Dogwood	5 gal	48" o.c.
$\langle \cdot \rangle$	Ec	10	Euonymus alatus `Compactus`	Compact Burning Bush	5 gal	72" o.c.
Some State of the	Но	43	Hemerocallis x 'Stella de Oro'	Stella de Oro Daylily	Quart	18" o.c.
**	Hf	17	Hosta x 'First Frost'	First Frost Hosta	2 gal	30" o.c.
\odot	II	10	Itea virginica `Little Henry` TM	Virginia Sweetspire	2 gal	36" o.c.
\odot	PI	6	Perovskia atriplicifolia `Little Spire` TM	Little Spire Russian Sage	2 gal	24" o.c.
\odot	Rr	19	Rosa x `Knockout` TM	Rose	2 gal	48" o.c.
GRASSES	CODE	<u>QTY</u>	BOTANICAL NAME	COMMON NAME	CONT.	<u>SPACING</u>
\odot	Ck	21	Calamagrostis x acutiflora `Karl Foerster`	Feather Reed Grass	3 gal.	36" o.c.
£;3	Fe	28	Festuca glauca `Elijah Blue`	Elijah Blue Fescue	1 gal.	18" o.c.
(+)	Sp	18	Schizachyrium scoparium `Prairie Munchkin`	Prairie Munchkin Little Bluestem	2 gal	24" o.c.
\odot	Sh	42	Sporobolus heterolepis	Prairie Dropseed	2 gal	30" o.c.
EVERGREEN	CODE	<u>QTY</u>	BOTANICAL NAME	COMMON NAME	CONT.	<u>SPACING</u>
	JI	19	Juniperus chinensis 'Gold Lace'	Gold Lace Juniper	5 gal	60" o.c.
\odot	Ja	8	Juniperus horizontalis `Andorra`	Andorra Juniper	2 gal	48" o.c.
SOD/SEED	CODE	<u>QTY</u>	BOTANICAL NAME	COMMON NAME	<u>TYPE</u>	
* * * * * * * * * * * * * * * * * * *	Fa	17,569 sf	Festuca arundinacea 90% Fescue, 10% Bluegrass Mix	Tall Fescue	sod	

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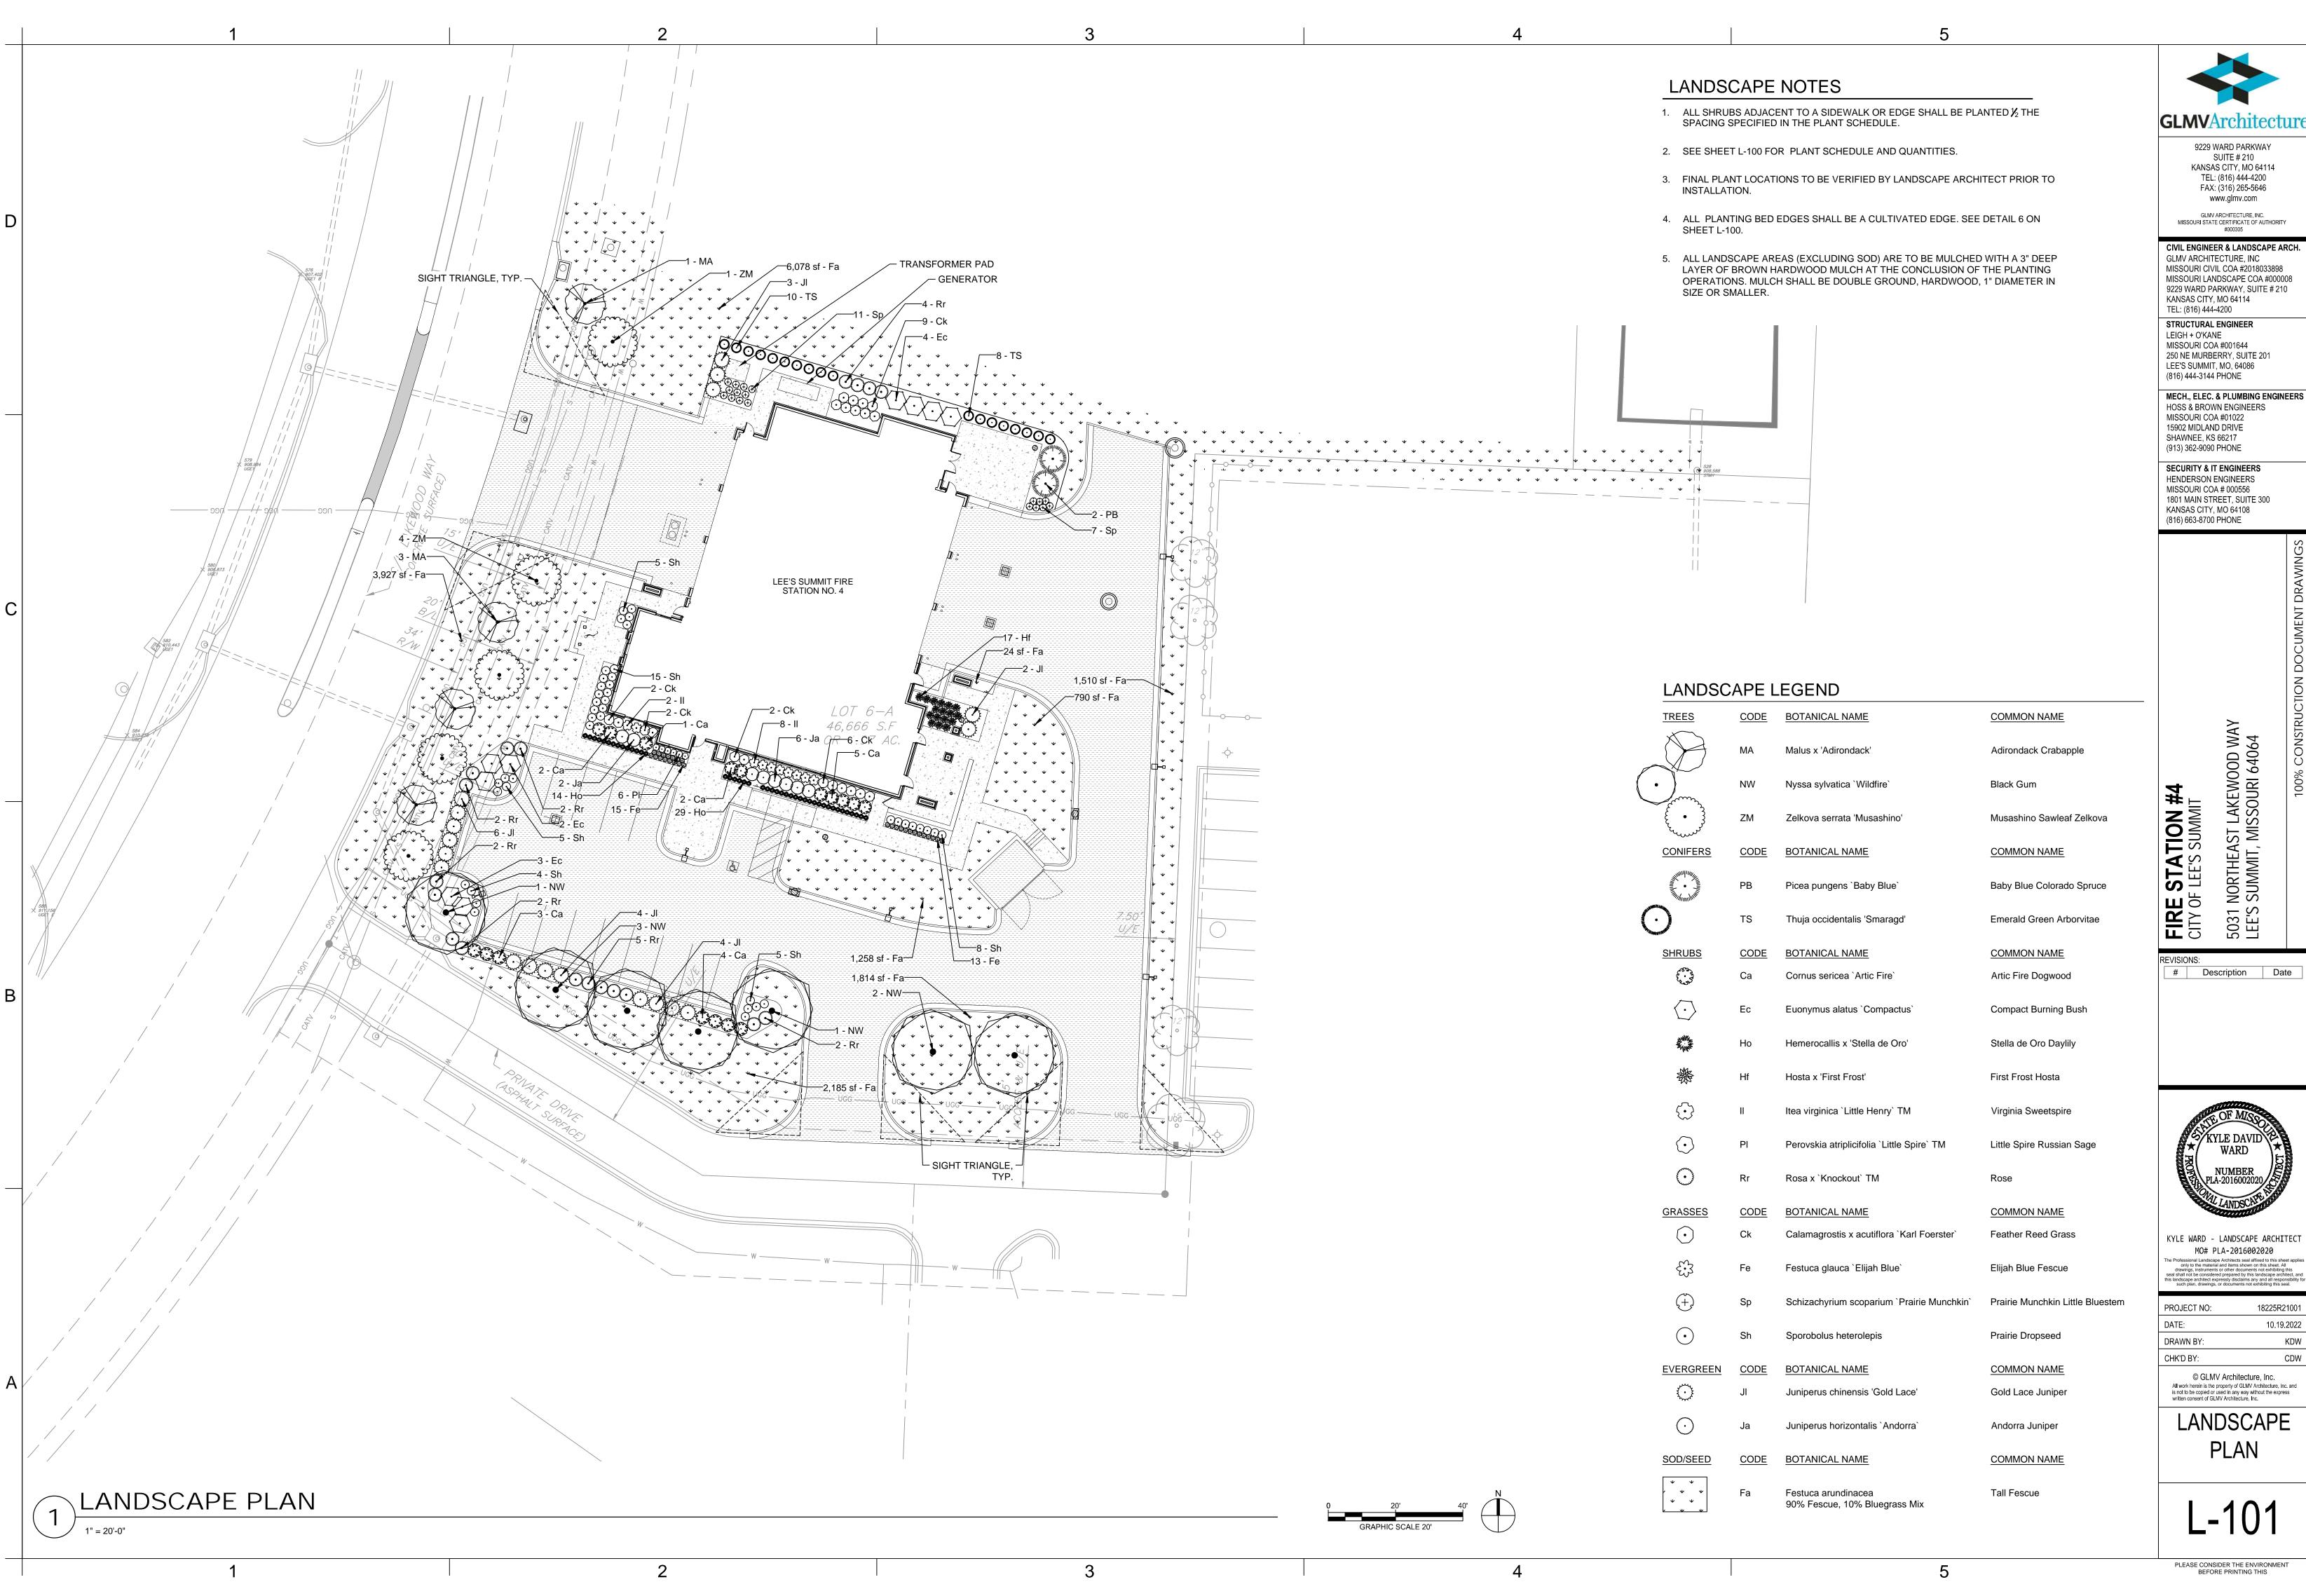
REVISIONS: # Description


KYLE WARD - LANDSCAPE ARCHITEC MO# PLA-2016002020

PROJECT NO: 18225R21001 DATE: 10.19.2022 DRAWN BY: KDW CHK'D BY: CDW

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LANDSCAPE SCHEDULE



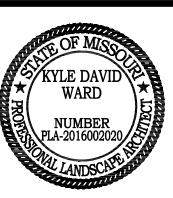

KYLE WARD - LANDSCAPE ARCHITECT

10.19.2022 KDW CDW