

# ARBORWALK WEST

## PRELIMINARY DEVELOPMENT PLAN

LEE'S SUMMIT, MO

### PROJECT CONTACTS

#### DEVELOPER:

CHRISTIE DEVELOPMENT ASSOCIATES LLC  
7217 W 110TH STREET  
OVERLAND PARK, KS 66210  
CONTACT: GARRETT FUGATE  
PHONE: 913.649.4500  
EMAIL: GARRET@CHRISTIEDEV.COM

#### CIVIL ENGINEER:

OLSSON  
1301 BURLINGTON, SUITE 100  
NORTH KANSAS CITY, MO 64116  
CONTACT: JULIE SELLERS  
PHONE: 816.442.6044  
EMAIL: JSELLERS@OLSSON.COM

#### SURVEYOR:

OLSSON  
1301 BURLINGTON, SUITE 100  
NORTH KANSAS CITY, MO 64116  
CONTACT: JASON ROUDEBUSH  
PHONE: 816.442.6059  
EMAIL: JROUDEBUSH@OLSSON.COM

#### LANDSCAPE ARCHITECT:

OLSSON  
1301 BURLINGTON, SUITE 100  
NORTH KANSAS CITY, MO 64116  
CONTACT: JACOB HODSON  
PHONE: 816.442.6030  
EMAIL: JHODSON@OLSSON.COM



VICINITY MAP

### PROPERTY DESCRIPTION:


#### TITLE COMMITMENT NO. 210232

PROPERTY DESCRIPTION PER CHICAGO TITLE INSURANCE COMPANY'S ALTA COMMITMENT FOR TITLE INSURANCE NO. 210232 UPDATE 7/15/2021, DATED JUNE 30, 2021 AT 08:00 AM.

#### TRACT 4:

ALL THAT PART OF THE SOUTHWEST QUARTER OF SECTION 25, TOWNSHIP 47, RANGE 32, IN LEE'S SUMMIT, JACKSON COUNTY, MISSOURI, LYING NORTH OF THE NORTH LINE OF MISSOURI HIGHWAY 150, AS PRESENTLY ESTABLISHED, LYING WEST OF THE WEST LINE OF SW ARBORIDGE DRIVE AS SHOWN ON THE PLAT OF ARBORWALK 4TH PLAT, A SUBDIVISION IN LEE'S SUMMIT, JACKSON COUNTY, MISSOURI, AND LYING SOUTH AND EAST OF LOT 1, HOLT SPIRIT CATHOLIC CHURCH - LOT 1, A SUBDIVISION IN LEE'S SUMMIT, JACKSON COUNTY, MISSOURI.

Sheet List Table	
Sheet Number	Sheet Title
C1.0	TITLE SHEET
C1.1	GENERAL NOTES
C2.0	EXISTING CONDITIONS
C3.0	SITE PLAN
C4.0	PRELIMINARY GRADING PLAN
C5.0	UTILITY PLAN
C6.0	DETAILS
L1.0	LANDSCAPE PLAN
E1.0	SITE LIGHTING PHOTOMETRICS PLAN
	ARCHITECTURAL ELEVATIONS

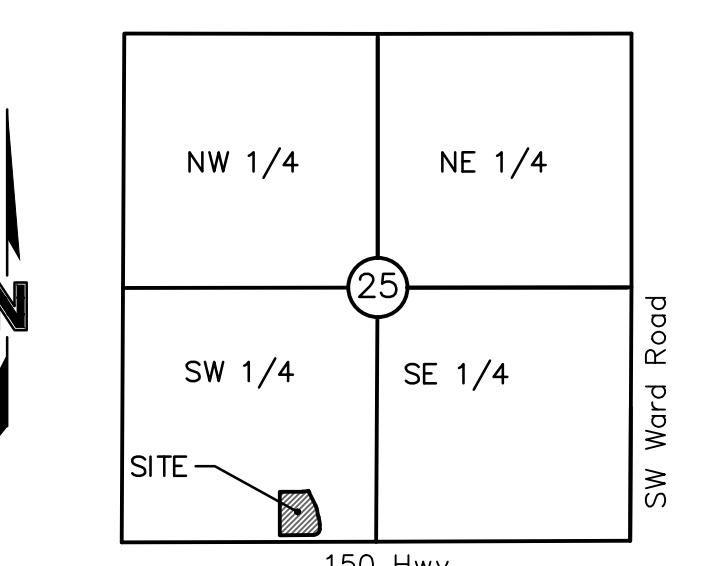

LOCATION MAP  
Sec. 25, Twp. 47 N., Rge. 32 W.  
(Not to Scale)

**Olsson**

Olsson - Civil Engineering  
Missouri Certificate of Authority #  
11301 Burlington Street 64116  
North Kansas City, MO 64116  
TEL 816.361.1177 www.olsson.com


<u>TITLE SHEET</u>	REV. NO.	DATE	REVISIONS DESCRIPTION	<u>REVISIONS</u>
<u>ARBORWALK WEST</u> <u>PRELIMINARY DEVELOPMENT PLAN</u>				
<u>LEE'S SUMMIT, MO</u>	2022			

drawn by: \_\_\_\_\_  
checked by: \_\_\_\_\_  
approved by: \_\_\_\_\_  
QA/CC by: \_\_\_\_\_  
project no.: B21-04054  
drawing no.: C\_TTL01\_B2104054  
date: \_\_\_\_\_

**SHEET**  
**C1.0**





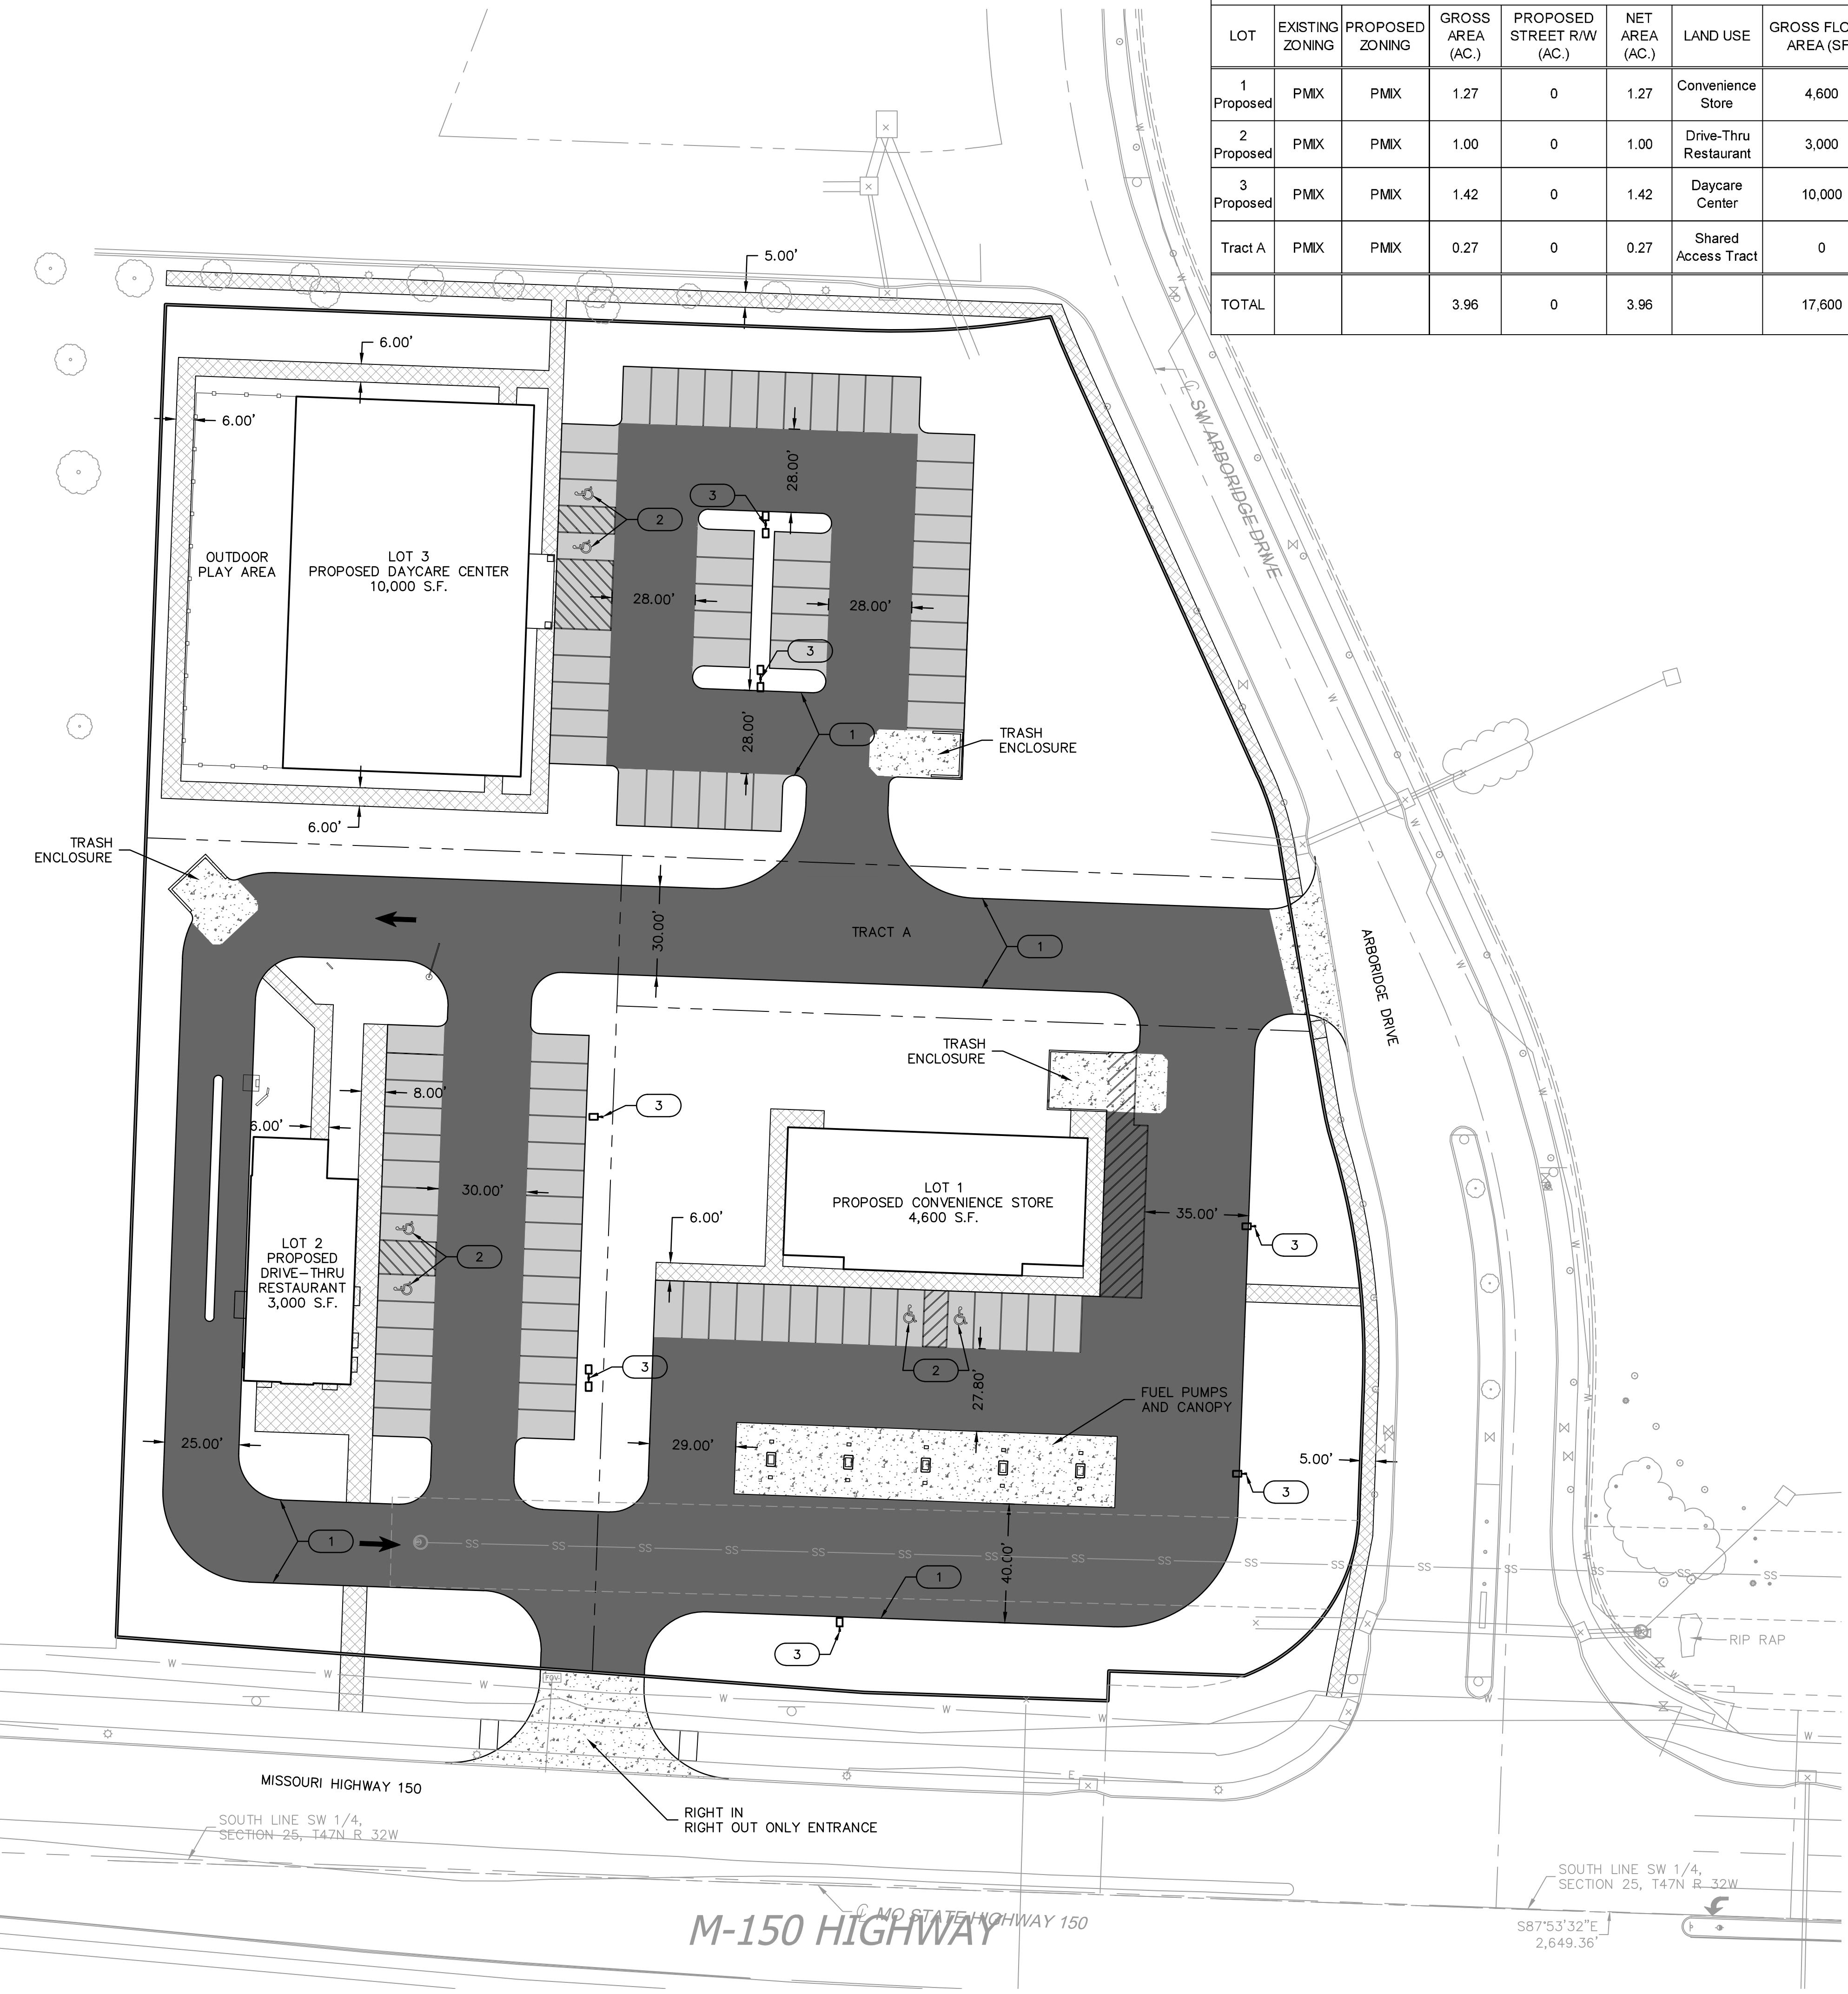

Site Development Data														
Lot	Existing Zoning	Proposed Zoning	Gross Area (Ac.)	Proposed Street R/W (Ac.)	Net Area (Ac.)	Land Use	Gross Floor Area (sf)	Building Coverage (sf)	F.A.R.	Parking Stalls Required			Open Space (sf / %)	
										Ratio	Required*	Provided		
1 Proposed	PMIX	PMIX	1.27	0	1.27	Convenience Store	4,600	4,600	0.08	5 spaces per 1,000 sq. ft. of gfa	25	Surface	16	23,454.70 SF 42.2%
2 Proposed	PMIX	PMIX	1.00	0	1.00	Drive-Thru Restaurant	3,000	3,000	0.07	14 spaces per 1,000 sq. ft. of gfa	42	Surface	29	16778.16 SF 38.5%
3 Proposed	PMIX	PMIX	1.42	0	1.42	Daycare Center	10,000	10,000	0.16	2.5 spaces per 1,000 sq. ft. of gfa	25	Surface	47	31,764.92 SF 51.3%
Tract A	PMIX	PMIX	0.27	0	0.27	Shared Access Tract	0	0	0.00	0	0	Surface	0	3,585.29 SF 31.0%
TOTAL			3.96	0	3.96		17,600	17,600	0.10		92		92	

## GENERAL NOTES:

1. EXISTING ZONING PMIX / PROPOSED ZONING PMIX
  2. EXISTING LAND USE: UNDEVELOPED
  3. NO OIL OR GAS WELLS ARE LOCATED ON THE PROPERTY. INFORMATION VERIFIED VIA MISSOURI DNR <https://dnr.mo.gov/geology/geosrv/oilandgas.htm>
  4. FEMA FLOODPLAIN ZONE: AREA OF MINIMAL FLOOD HAZARD, PER MAP 29095C0531G, EFF. 01/20/2017

DFVFI OPMENTAI NOTES

- DEVELOPMENTAL NOTES:

  1. ALL PROPOSED DRIVES SHALL BE 24' CLEAR WIDTH (28' BACK-OF-CURB TO BACK-OF-CURB)
  2. ALL PROPOSED PARKING SPACES SHALL MEET MINIMUM DIMENSIONS AS SPECIFIED IN LEE'S SUMMIT UDO SEC. 8.620.
  3. ALL INTERNAL PRIVATE SIDEWALKS SHALL BE 6' WIDTH OR GREATER. PUBLIC SIDEWALK ALONG SW ARBORIDGE DRIVE SHALL BE 5' IN WIDTH

CONSTRUCTION NOTES


- 1 TYPE CG-1 CONCRETE CURB AND GUTTER
  - 2 ACCESSIBLE PARKING AND RELATED CURB RAMP. SEE DETAILED ACCESSIBLE STALL AND AISLE DESIGN ON SHEET C6.0.
  - 3 LIGHT POLE  
(REFER TO SITE LIGHTING PLAN)

## LEGEND

-  INSTALL DRIVE AREA ASPHALT PAVEMENT PER SECTION ON SHEET C6.0
-  INSTALL PARKING AREA ASPHALT PAVEMENT PER SECTION ON SHEET C6.0
-  INSTALL HEAVY PCC PAVEMENT PER SECTION ON SHEET C6.0
-  INSTALL PCC SIDEWALK PAVEMENT PER SECTION ON SHEET C6.0

drawn by: \_\_\_\_\_  
checked by: \_\_\_\_\_  
approved by: \_\_\_\_\_  
QA/QC by: \_\_\_\_\_  
project no.: B21-04054  
drawing no.: C SIT01 B2104054  
date: \_\_\_\_\_

SHEET  
C3.0

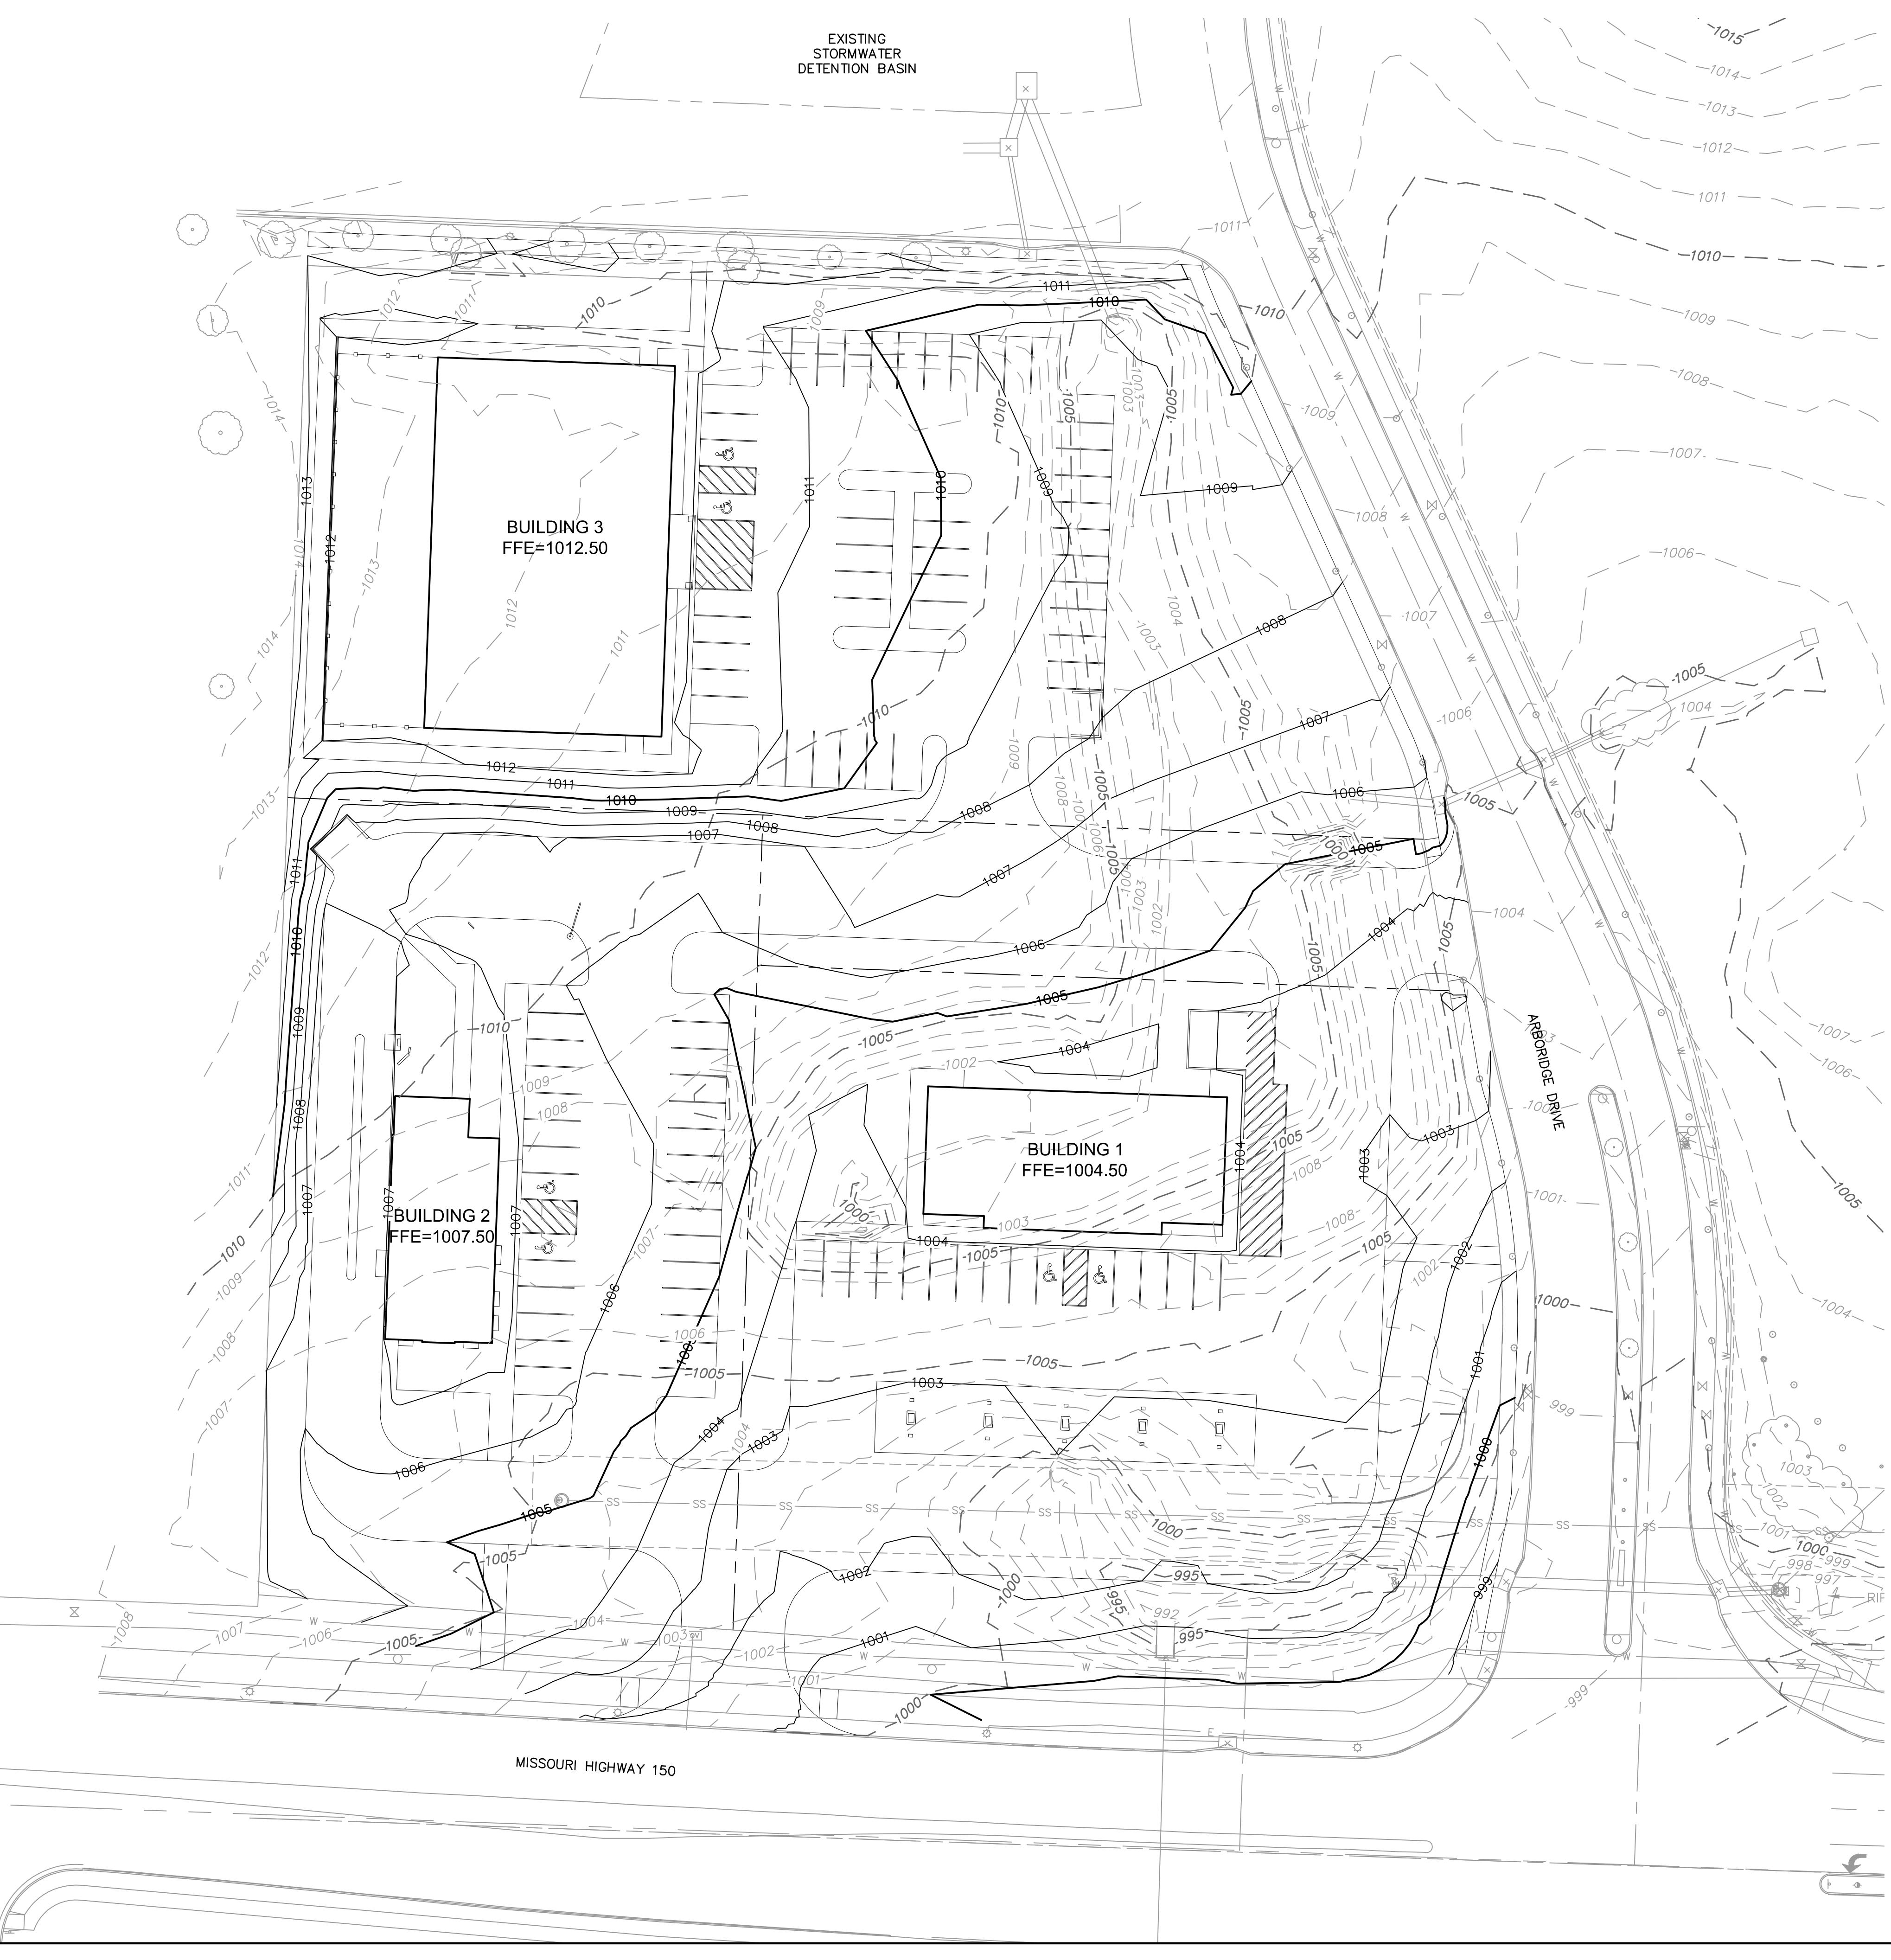

**Olsson**

Civil Engineering  
 Missouri Certificate of Authority #  
 1-301 Bullington Street 66416  
 North Kansas City, MO  
 TEL 816.361.1177 www.olsson.com

PRELIMINARY GRADING PLAN		REVISIONS	
REV. NO.	DATE	REVISIONS DESCRIPTION	BY
2022			


ARBORWALK WEST  
PRELIMINARY DEVELOPMENT PLAN

LEES SUMMIT, MO

drawn by: \_\_\_\_\_  
 checked by: \_\_\_\_\_  
 approved by: \_\_\_\_\_  
 OA/CC by: \_\_\_\_\_  
 project no.: B21-04054  
 drawing no.: C\_GRD01\_B2104054  
 date: \_\_\_\_\_

0' 15' 30' 60'  
SCALE IN FEET

SHEET C.4.0

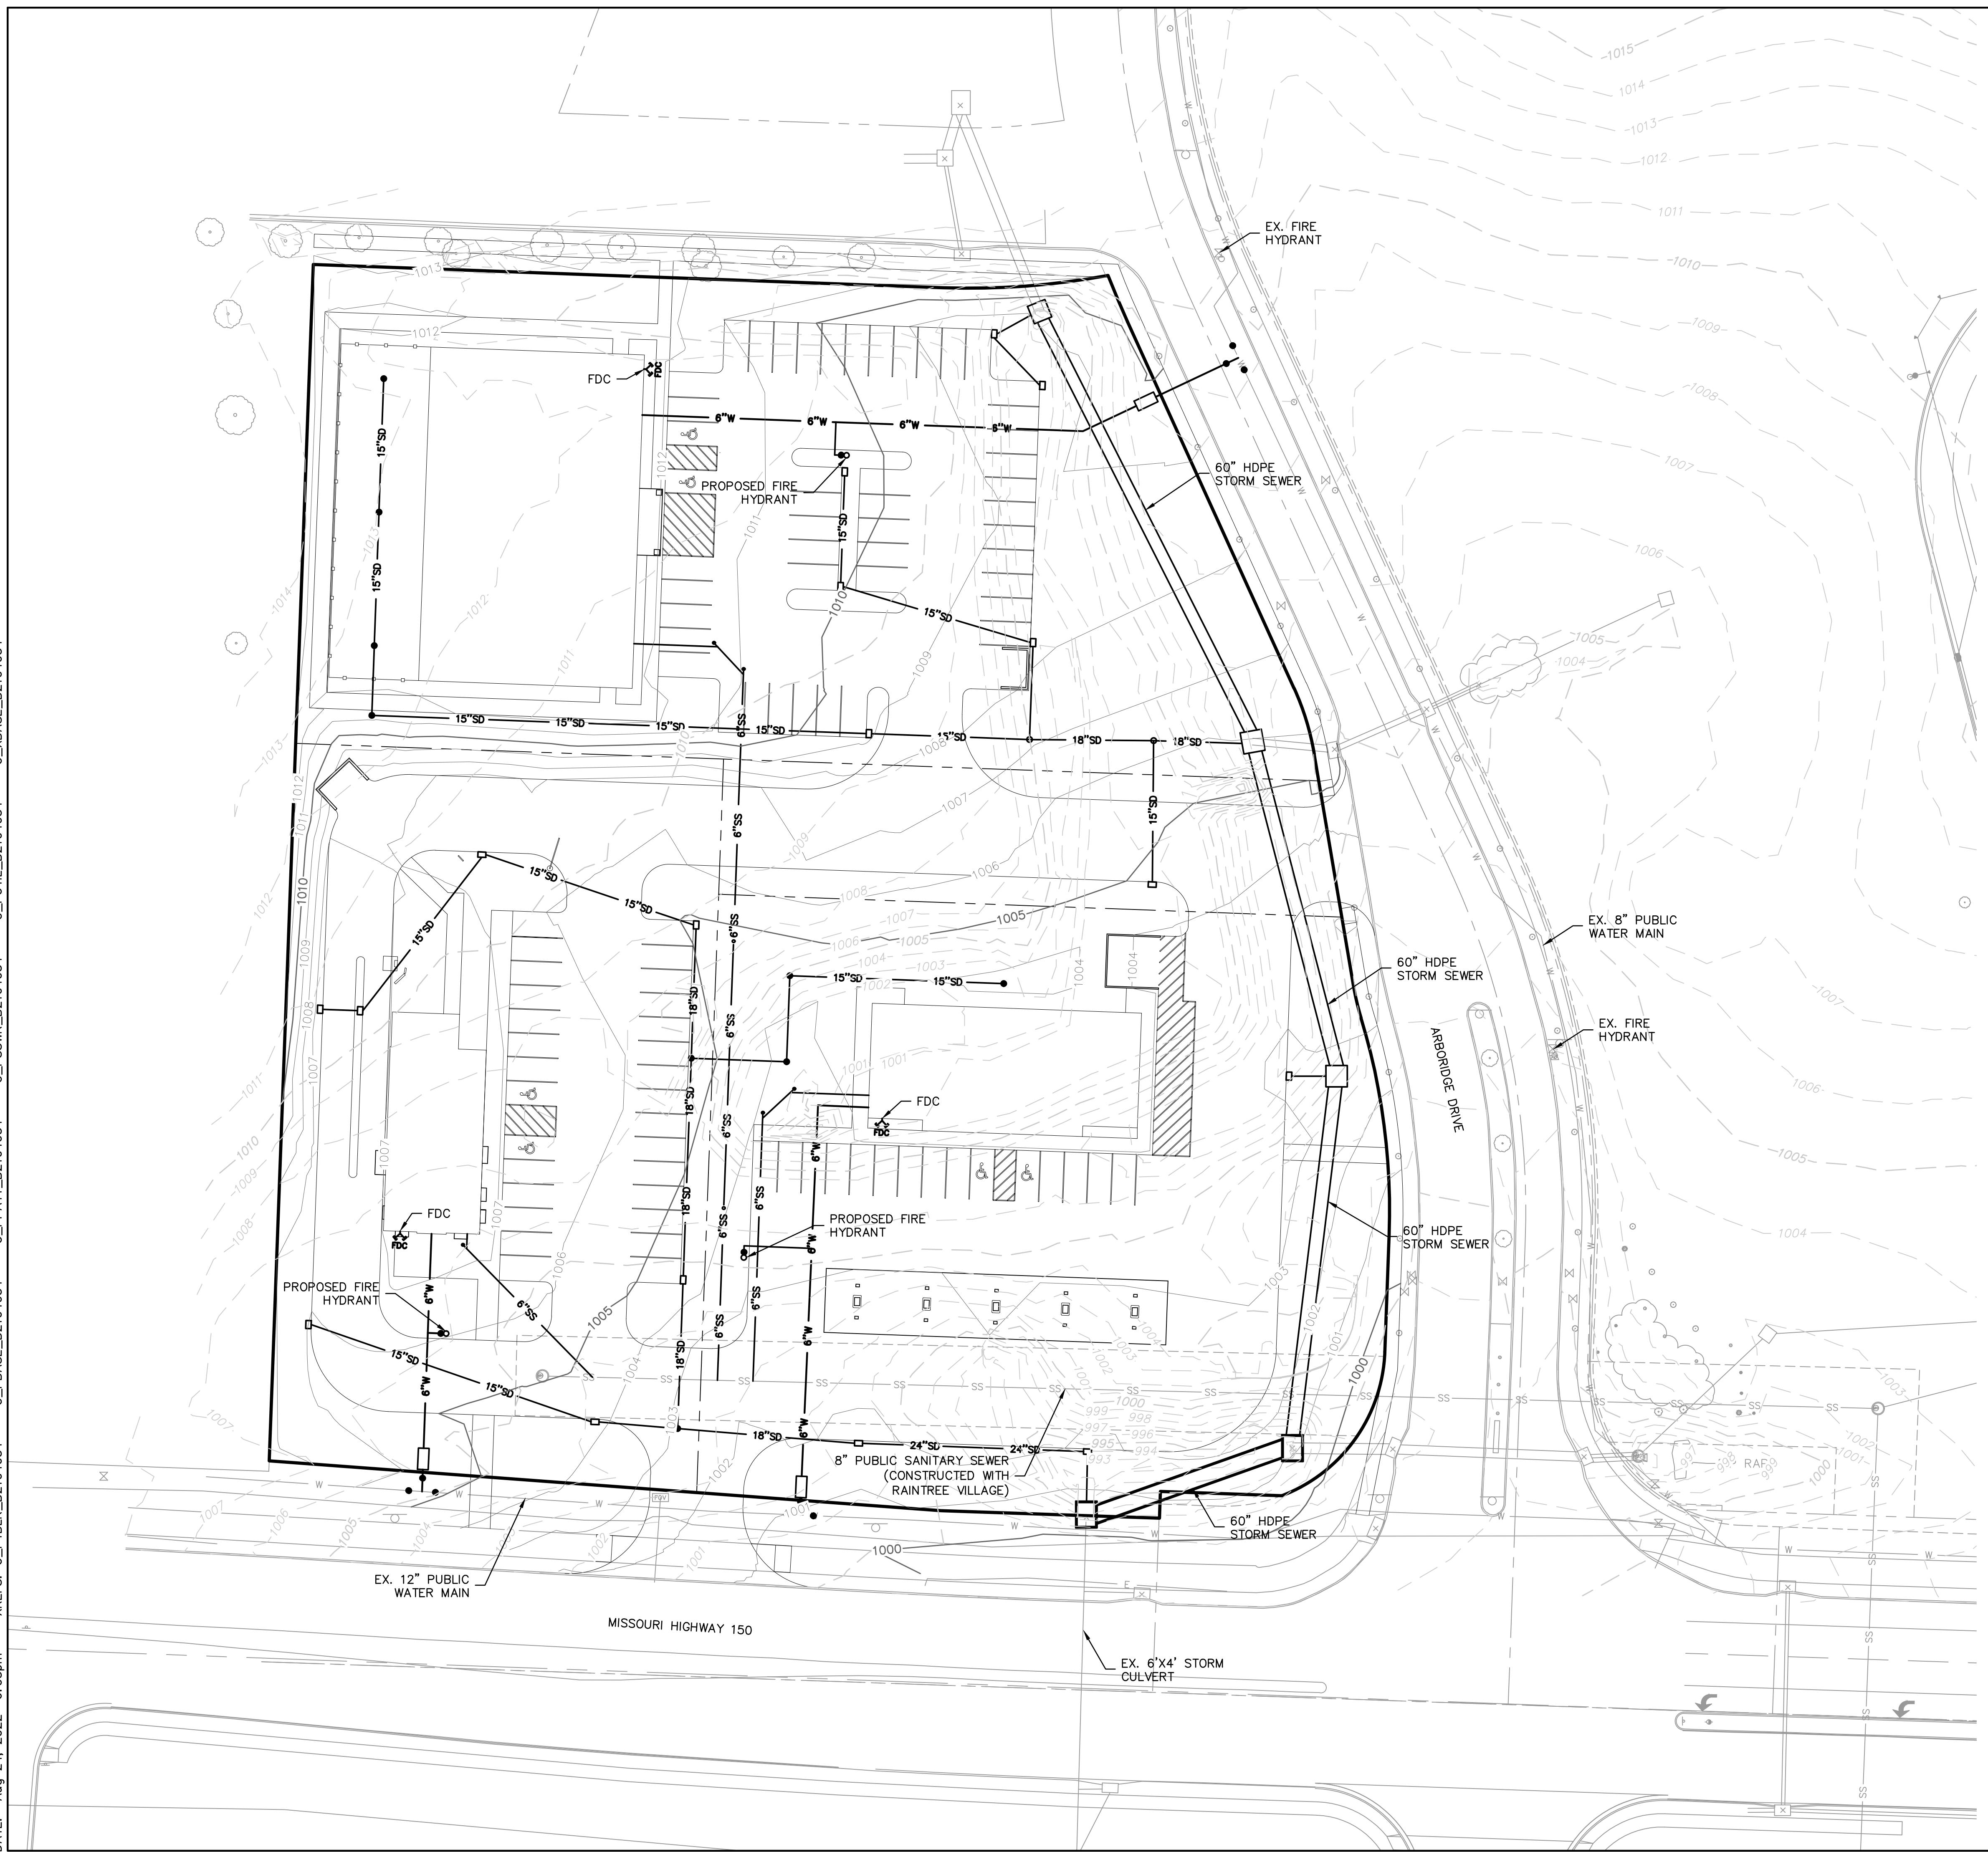

DWG: F:\2021\04001-04500\021-04054-B\40-Design\AutoCAD\Preliminary Plans\Sheets\GNCV\C\_UTL01\_B2104054.dwg  
DATE: Aug 24, 2022 6:05pm XREFS: C\_PTBLK\_B2104054 C\_PPATT\_B2104054 C\_PSSWR\_B2104054  
USER: mdiebolt C\_PUTIL\_B2104054 C\_XBASE\_B2104054

LEGEND
EXISTING SANITARY SEWER
PROPOSED SANITARY SEWER
EXISTING STORM SEWER
PROPOSED STORM SEWER
EXISTING WATER LINE
PROPOSED WATER LINE


Conson

Olsson - Civil Engineering  
Missouri Certificate of Authority #  
1301 Burlington Street  
North Kansas City, MO 64116  
TEL 816.361.1177  
[www.olsson.com](http://www.olsson.com)





DWG: F:\2021\04001-04500\021-04054-b\40-design\AutoCAD\preliminary plans\Sheets\MECH\E\_N SITE\_B2104054.dwg  
DATE: Aug 24, 2022 12:47pm XREFS: C\_PBASE\_B2104054 C\_XTOPO\_B2104054 C\_PLSCP\_B2104054  
USER: osmith E\_PHOTO\_B2104054 E\_PTBLK\_B2104054 E\_PBASE\_B2104054

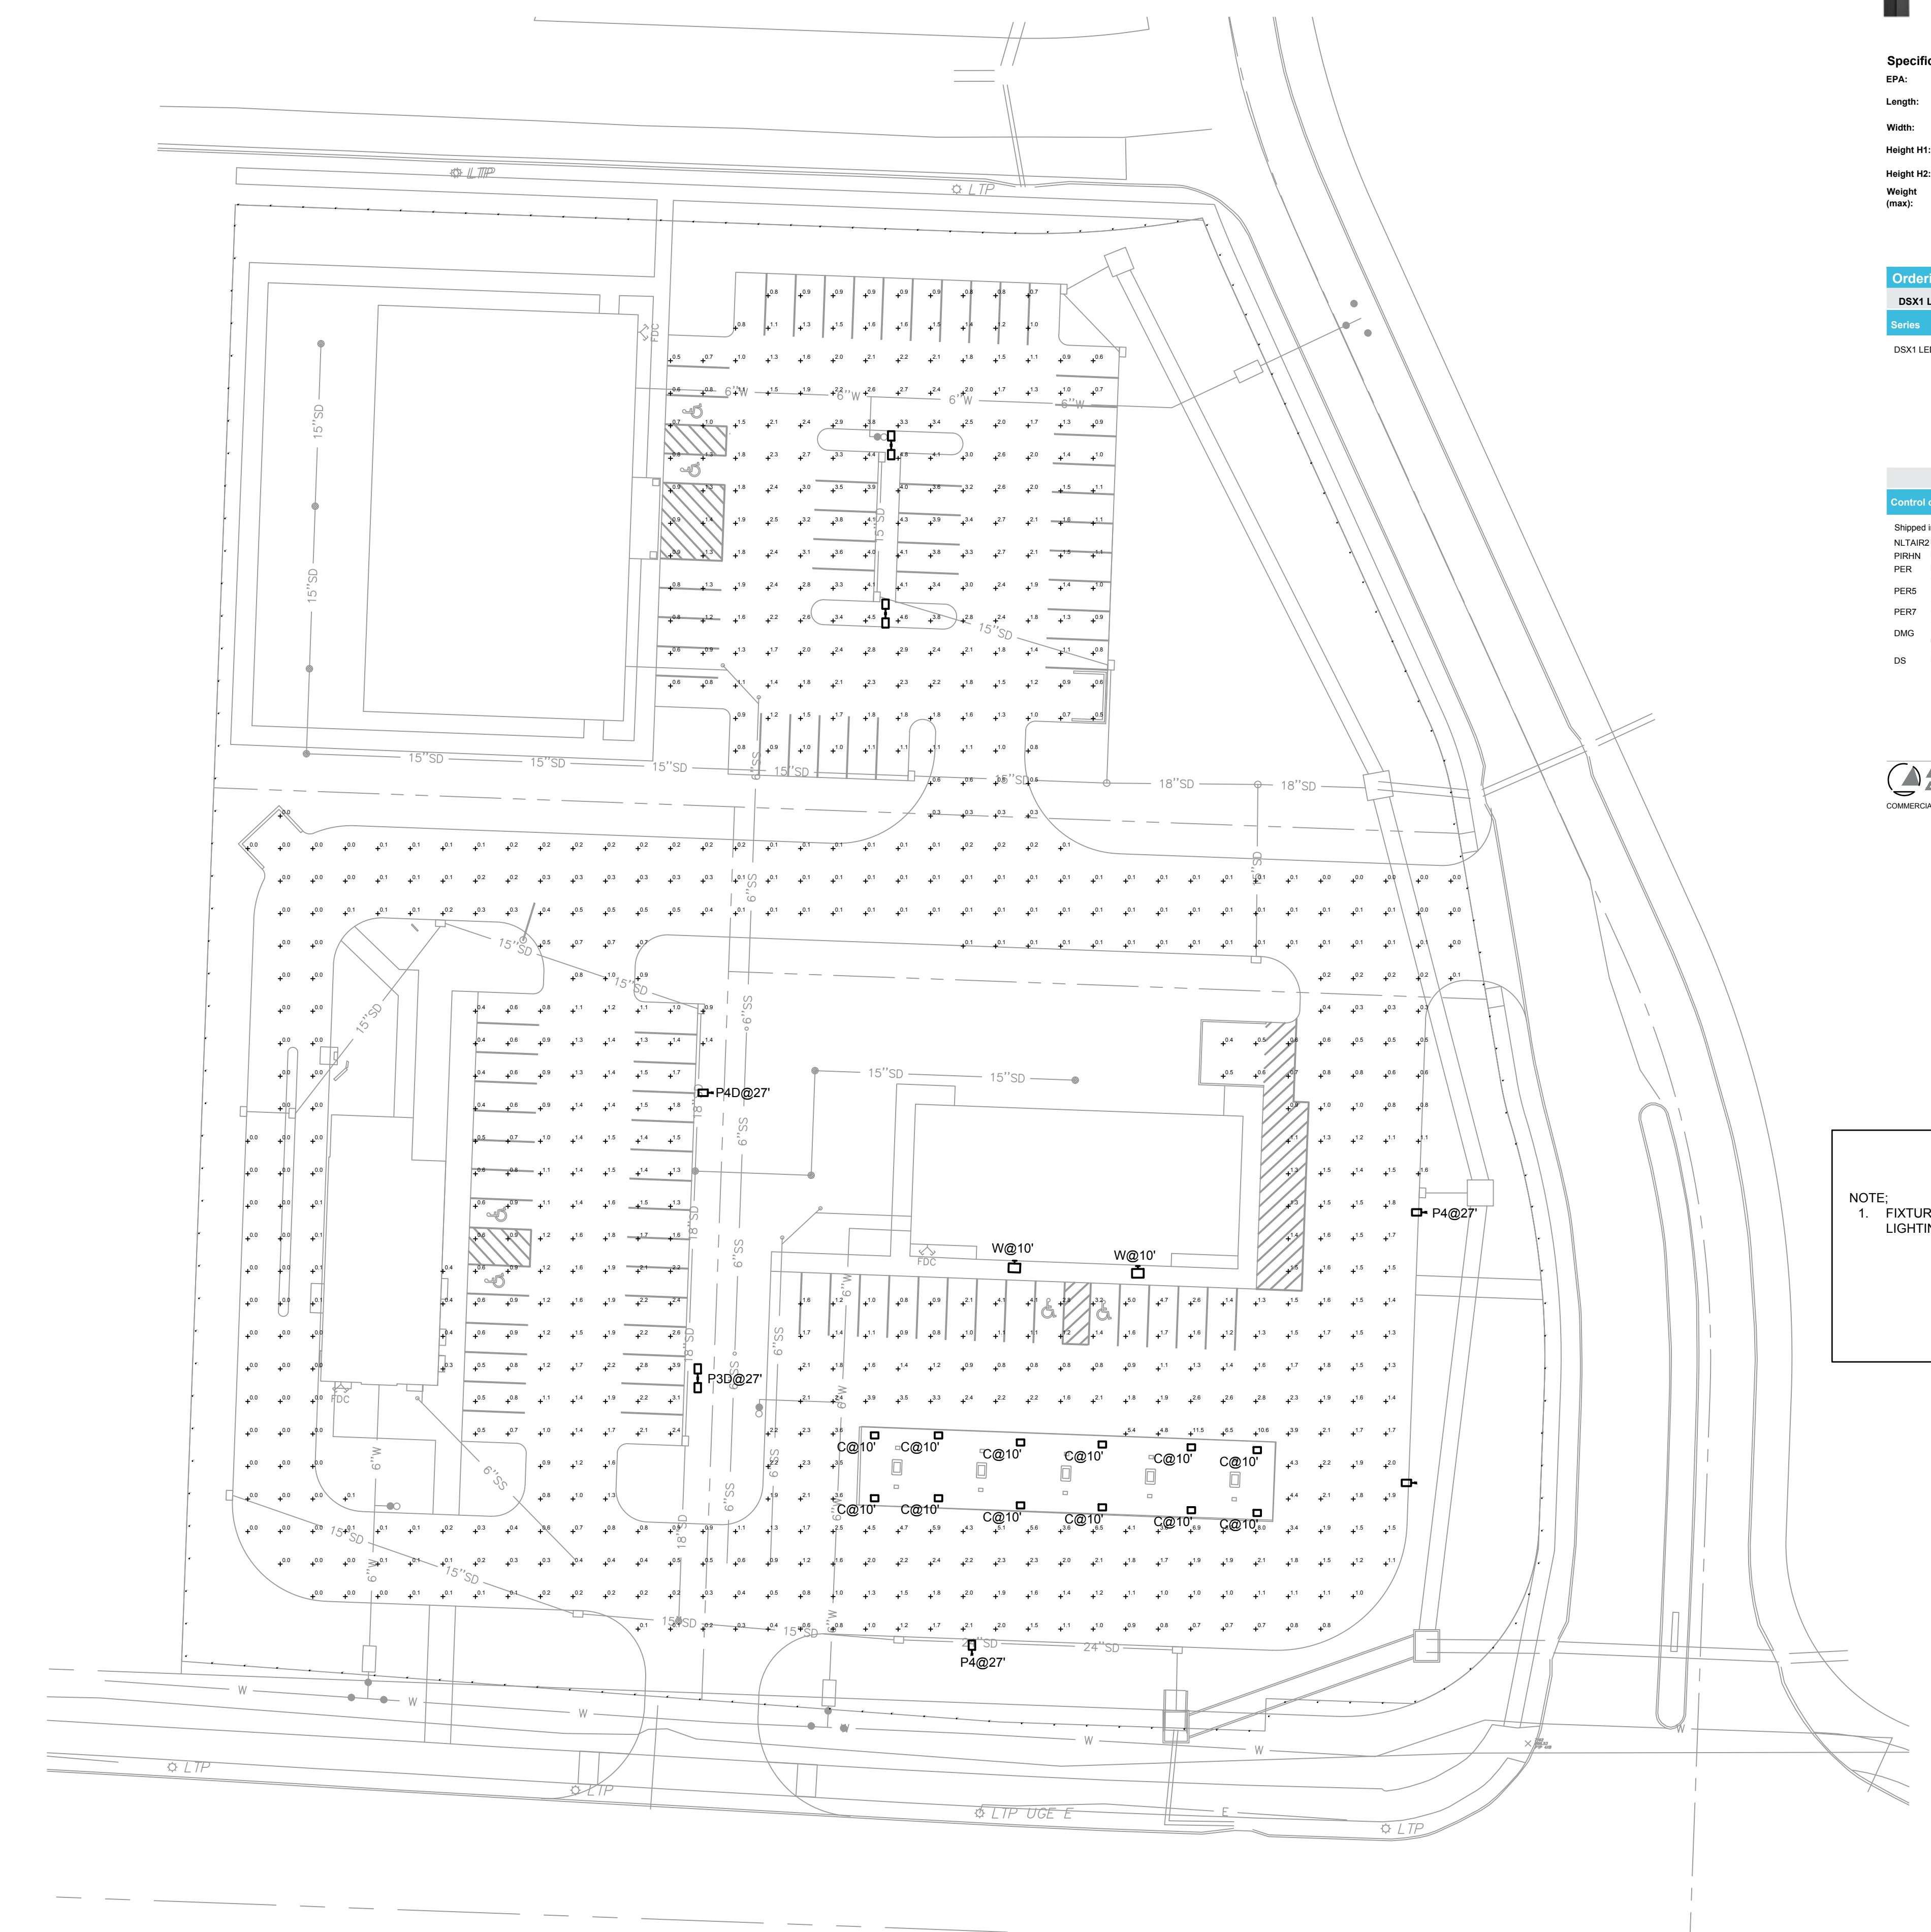



# SITE LIGHTING PHOTOMETRICS PLAN

---

SCALE: 1" = 30'-0"



# **D-Series Size 1**

## LED Area Luminaire




Type

Hit the Tab key or mouse over the page to see all interactive elements.

**Introduction**

The modern styling of the D-Series is striking yet unobtrusive - making a bold, progressive statement even as it blends seamlessly with its environment. The D-Series distills the benefits of the latest in LED technology into a high performance, high efficacy, long-life luminaire.

The outstanding photometric performance results in sites with excellent uniformity, greater pole spacing and lower power density. It is ideal for replacing up to 750W metal halide in pedestrian and area lighting applications with typical energy savings of 65% and expected service life of over 100,000 hours.

EXAMPLE: DSX1 LED P7 40K T3M MVOLT SPA NLTAIR2 PIRHN DDBXD

perature	Distribution	Voltage	Mounting	
00 K	T1S Type I short (Automotive)	T5VS Type V very short 3	MVOLT 5	<b>Shipped included</b>
00 K	T2S Type II short	T5S Type V short 3	XVOLT (277V-480V) 6,7,8	SPA Square pole mounting
00 K	T2M Type II medium	T5M Type V medium 3	RPA Round pole mounting 10	
	T3S Type III short	T5W Type V wide 3	WBA Wall bracket 3	
	T3M Type III medium	BLC Backlight control 4	SPUMBA Square pole universal mounting adaptor 1	
	T4M Type IV medium	LCCO Left corner cutoff 4	RPUMBA Round pole universal mounting adaptor 9	
	TFTM Forward throw medium	RCCO Right corner cutoff 4	Shipped separately	
		4277 9	KMA8 DDBXD U Mast arm mounting bracket adaptor (specify finish) 12	
		347 9		
		480 9		

**Introduction**  
The modern styling of the D-Series is striking yet unobtrusive - making a bold, progressive statement even as it blends seamlessly with its environment. The D-Series distills the benefits of the latest in LED technology into a high performance, high efficacy, long-life luminaire.

The outstanding photometric performance results in sites with excellent uniformity, greater pole spacing and lower power density. It is ideal for replacing up to 750W metal halide in pedestrian and area lighting applications with typical energy savings of 65% and expected service life of over 100,000 hours.

ON-SITE LIGHTING PHOTOMETRICS PLAN

# ARBORWALK WEST PRELIMINARY DEVELOPMENT PLAN

ION

1


One Lithonia  
© 2011-2012

Way • Conyers, Georgia 30012 • Phone: 1-800-705-SERV (7378) • [www.lithonia.com](http://www.lithonia.com)  
Acuity Brands Lighting, Inc. All rights reserved.

DSX1-LED  
Rev. 07/19/21  
Page 1 of 8

**NOTE:**

1. FIXTURE TYPE C AND W IS AN ESTIMATOIN OF BUILDING MOUNTED LIGHTING.

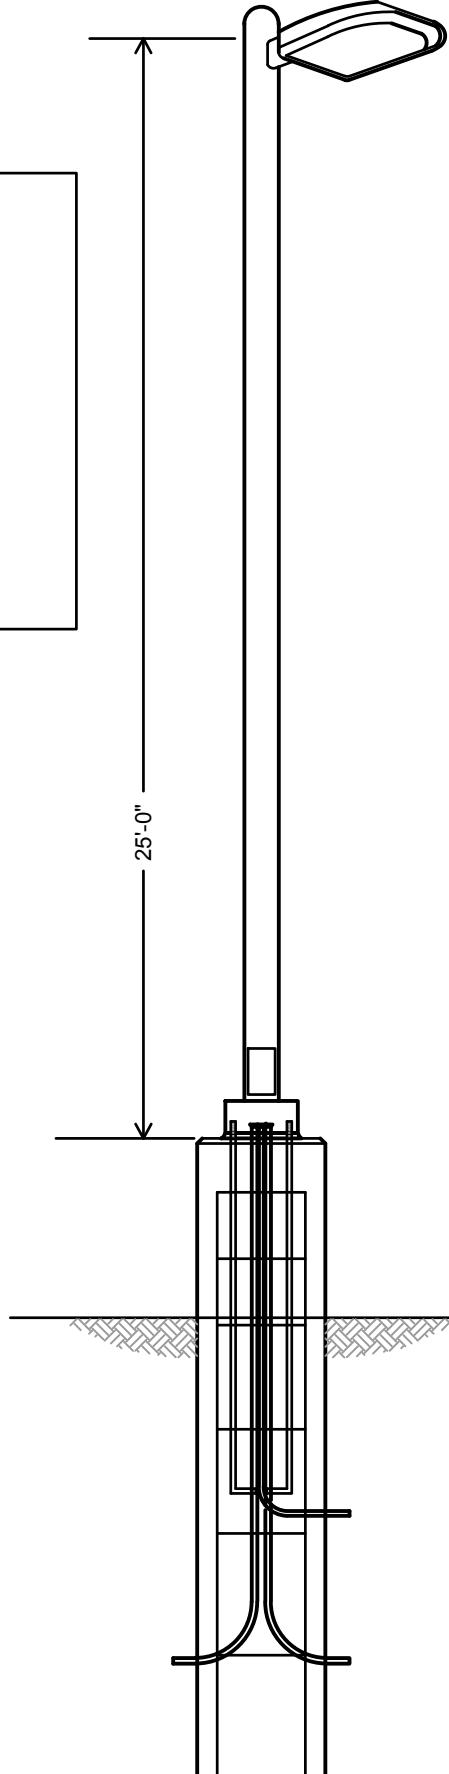


# LIGHT POLE DETAIL

<b>ETAIL</b>	drawn by: _____ SH
	checked by: _____ TD
	approved by: _____ TD
	QA/QC by: _____ TD
	project no.: _____ B21-04054
	drawing no.: E NSITE B2104054
	date: _____ 8/26/2022

SHEET  
E1.0


## General Notes

1. REVIEW AND COORDINATE WITH ALL DETAIL PAGES REFERENCED ON THIS PLAN, NOTIFY ARCHITECT AND OWNER OF DISCREPANCIES
  2. **RELATED DRAWING SHEETS:** REFER TO THE FOLLOWING:
    - AL-101: FOR BUILDING LOCATION ON SITE
    - AL-601: FOR INFORMATION RELATING TO SIGNAGE
    - A-101: PRIMARY FLOOR PLAN FOR CONSTRUCTION LAYOUT
    - A-121: ROOF PLAN/ROOF TOP EQUIPMENT
    - A-601: DOOR & WINDOW SCHEDULES AND NOTES
    - S-101: FOOTINGS AND FOUNDATIONS
    - S-102: ROOF TRUSSES
  3. **WORKING POINT:** THE WORKING POINT (**WP**) INDICATED ON THE DRAWINGS IS RELATIVE TO THE FACE OF SHEATHING ON THE EXTERIOR WALL AND IS A COMMON POINT OF REFERENCE WHERE EVER USED IN THESE DRAWINGS
  4. ALL VENT PENETRATIONS ON BACK OF BACKSIDE OF ROOF.

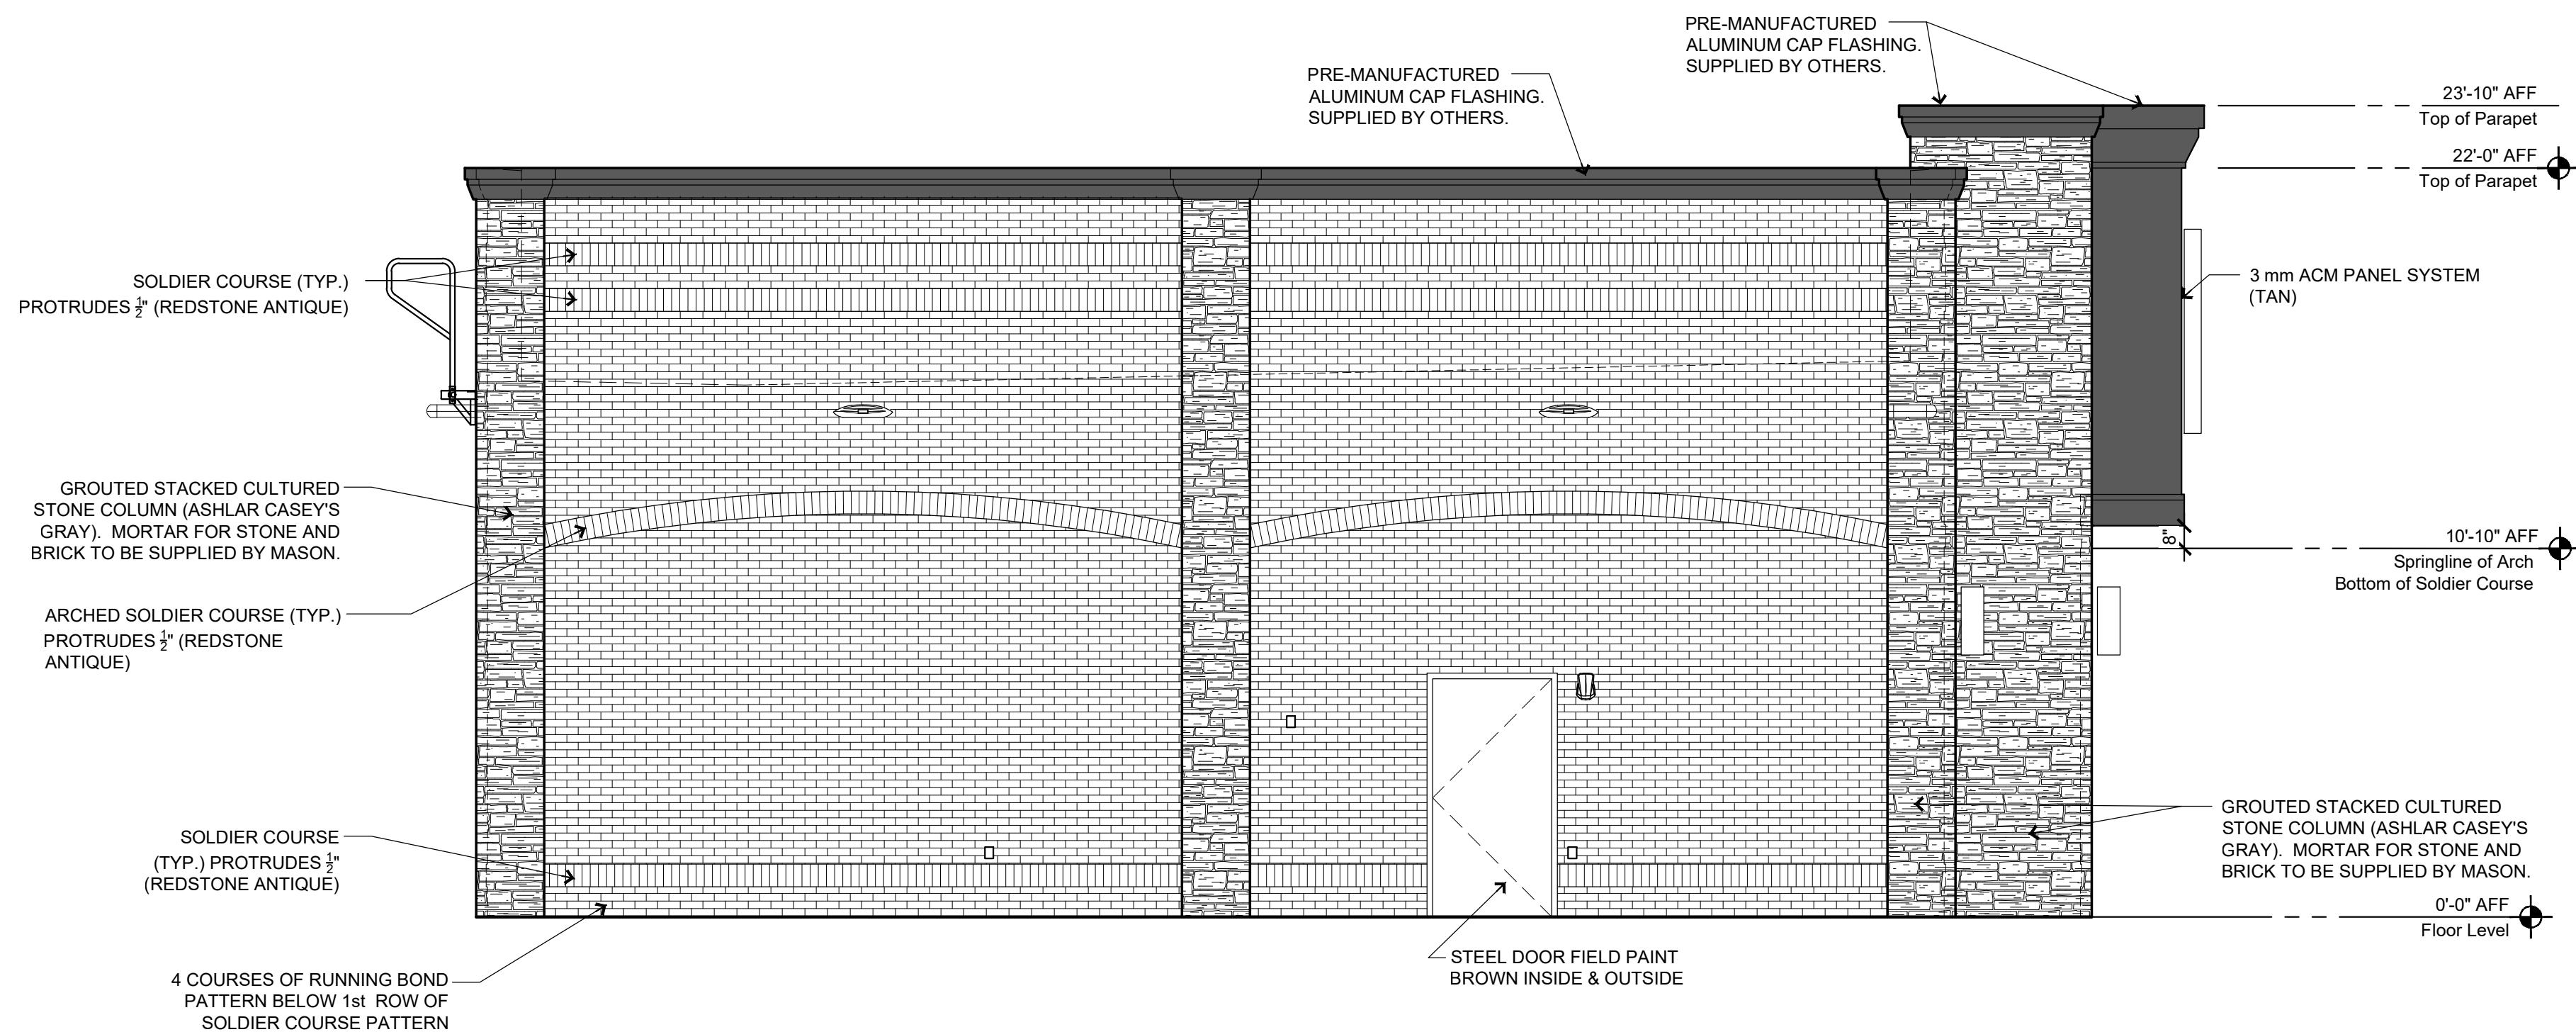

## 2 Exterior Elevation - Left Side of Building (Plan West)

**1/4"=1'-0"**

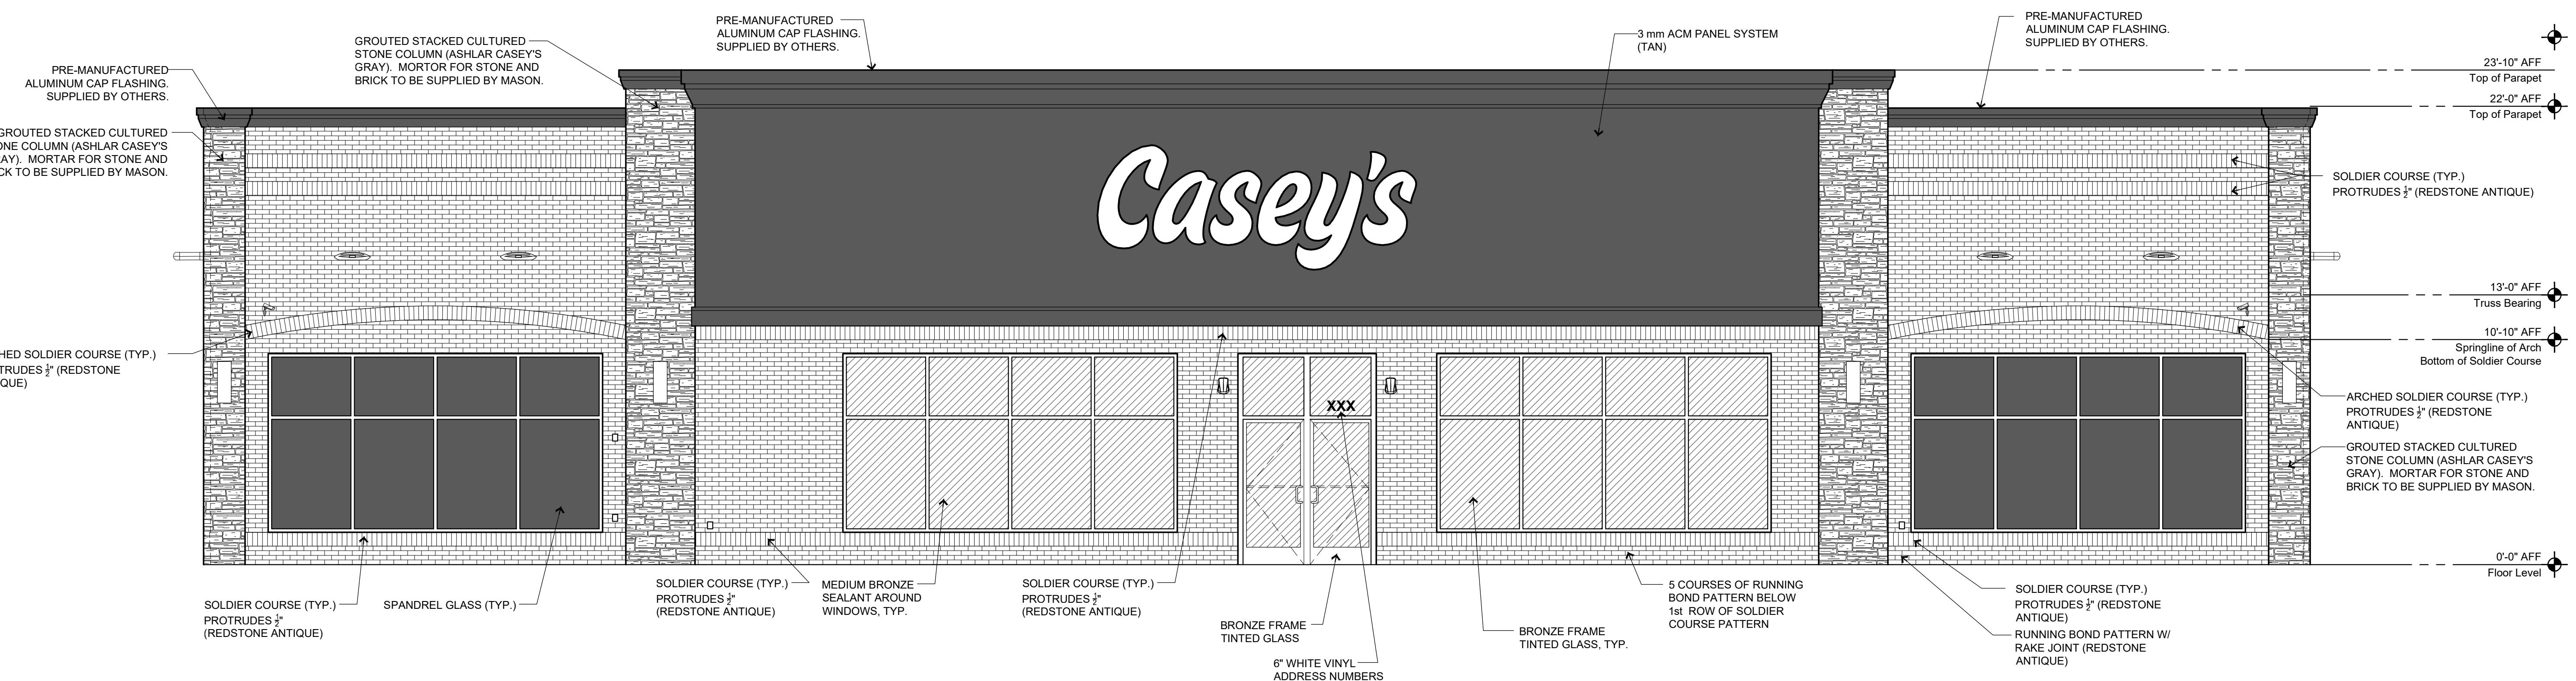

# 1 Exterior Elevation - Front of Building (Plan South)


1/4"=1'-0"

---

## GLAZING & DOOR CALCULATION


---

# Screening

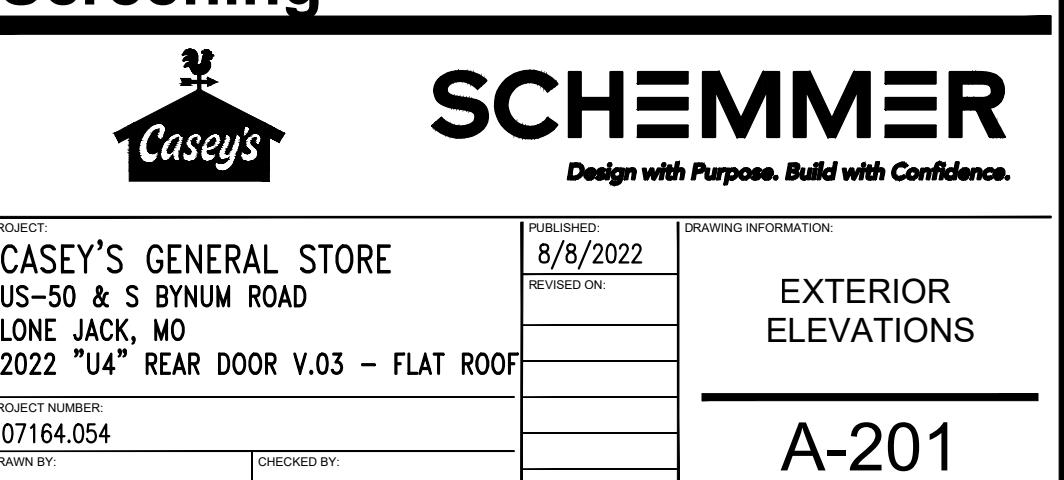

## General Notes

1. REVIEW AND COORDINATE WITH ALL DETAIL PAGES REFERENCED ON THIS PLAN, NOTIFY ARCHITECT AND OWNER OF DISCREPANCIES
2. RELATED DRAWING SHEETS- REFER TO THE FOLLOWING:  
AL-101: FOR BUILDING LOCATION ON SITE  
AL-601: FOR INFORMATION RELATING TO SIGNAGE  
A-101: PRIMARY FLOOR PLAN FOR CONSTRUCTION LAYOUT  
A-121: ROOF PLANOGRAPH TOP EQUIPMENT  
A-601: DOOR & WINDOW SCHEDULES AND NOTES  
S-101: FOOTINGS AND FOUNDATIONS  
S-102: ROOF TRUSSES
3. WORKING POINT: THE WORKING POINT (WP) INDICATED ON THE DRAWINGS IS RELATIVE TO THE FACE OF SHEATHING ON THE EXTERIOR WALL AND IS A COMMON POINT OF REFERENCE WHERE EVER USED IN THESE DRAWINGS
4. ALL VENT PENETRATIONS ON BACK OF BACKSIDE OF ROOF.


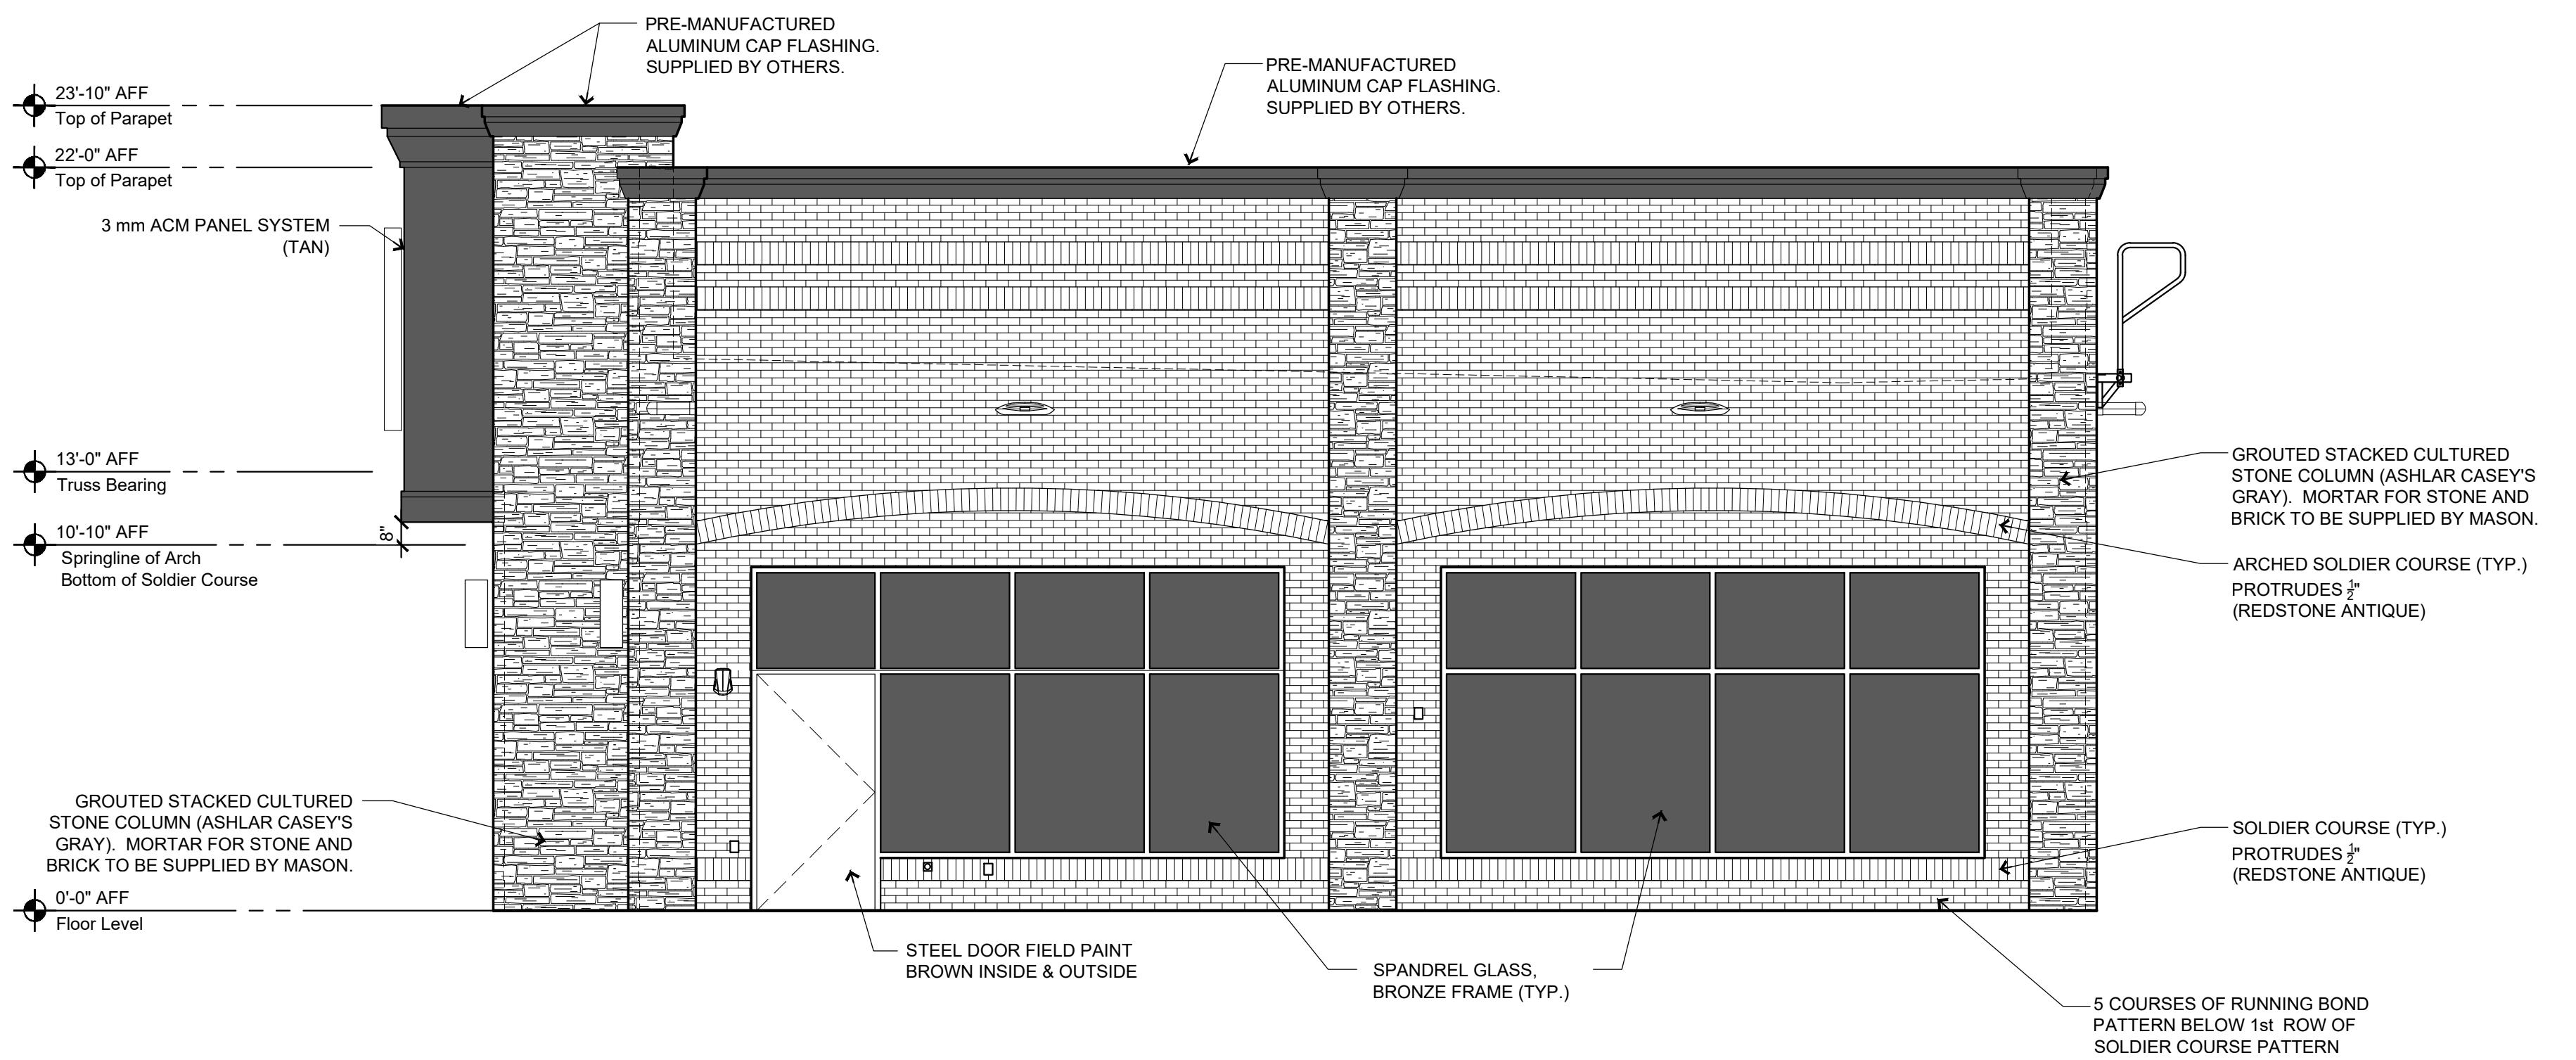


2 Exterior Elevation - Right Side of Building (Plan East)

1/4"=1'-0"

GLAZING & DOOR CALCULATION		
TOTAL FAÇADE SQUARE FOOTAGE:	1,103.49 SF	
25% GLAZING & DOOR REQUIREMENT:	275.87 SF	
GLAZING & DOORS ON ELEVATION:	280.68 SF	

3 Ladder Bracket  
1/2"=1'-0"

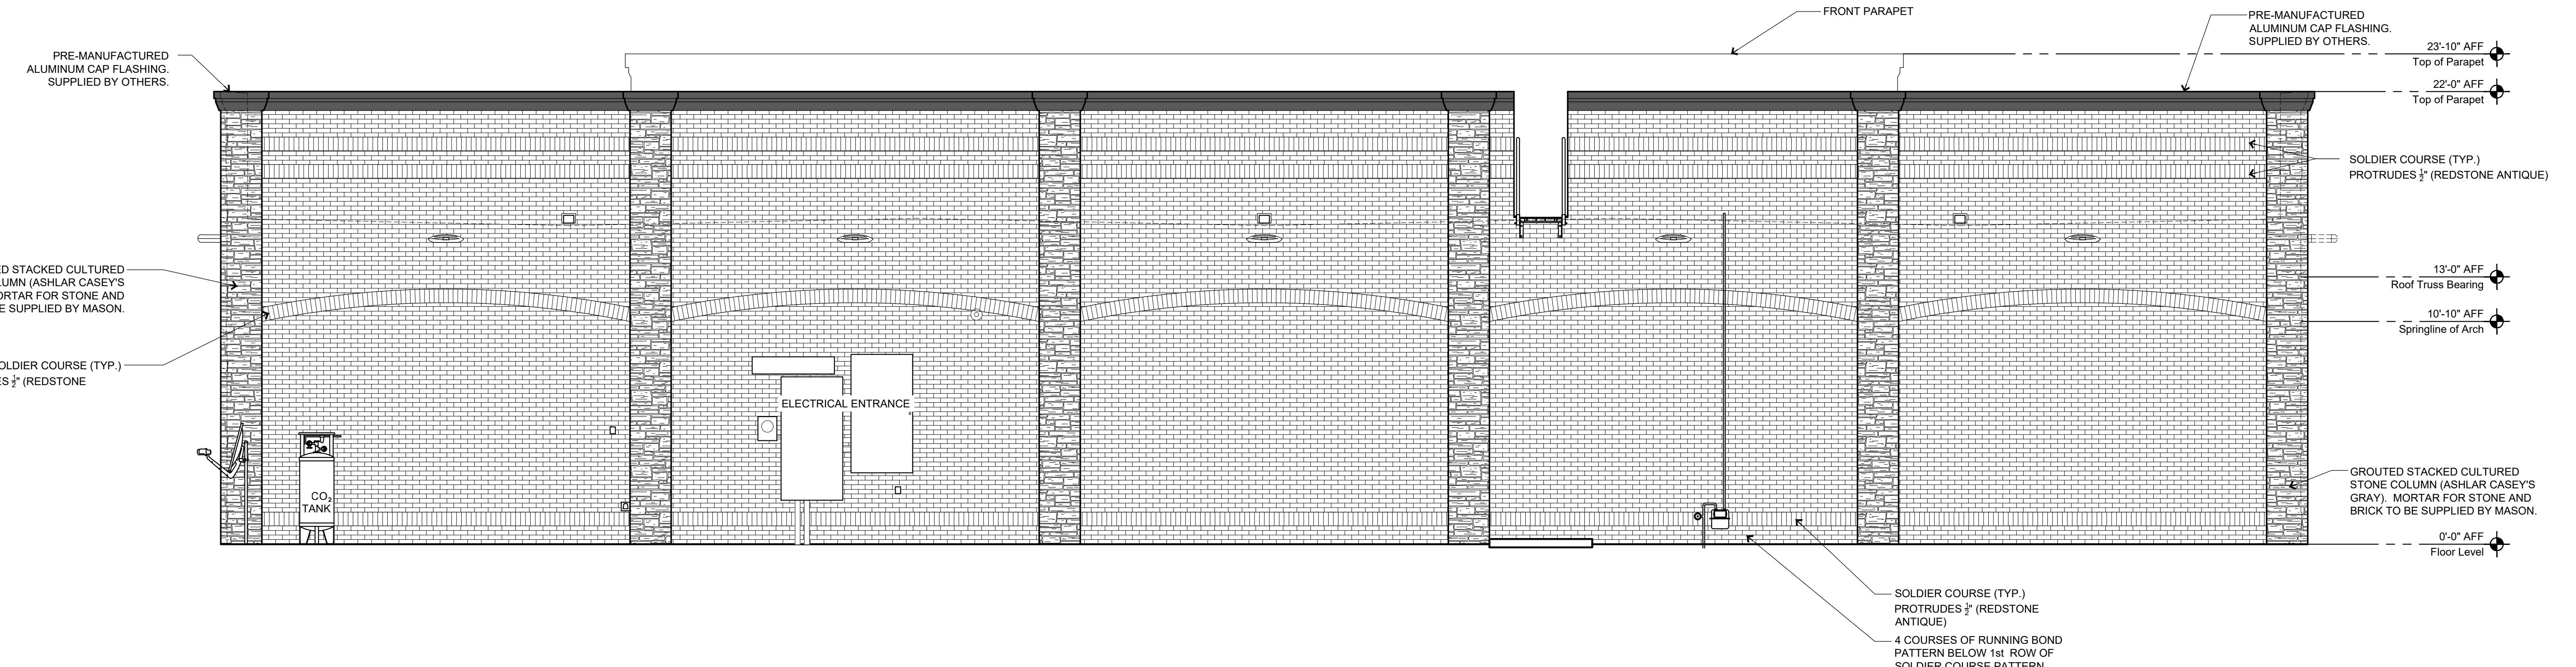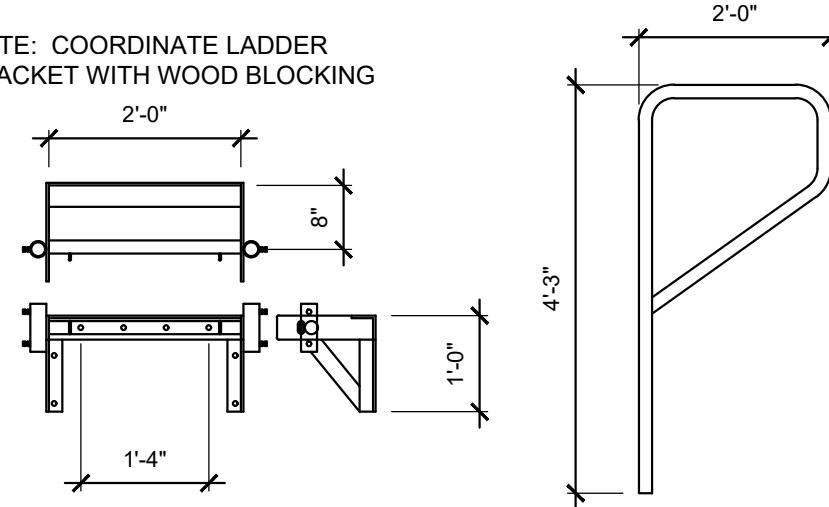


1 Exterior Elevation - Back of Building (Plan North)

1/4"=1'-0"

## Screening

SCHEMNER	
Design with Purpose. Build with Confidence.	
PROJECT:	CASEY'S GENERAL STORE MO-150 & ARBORIDGE DR LEE'S SUMMIT, MO 2022 "U4" STYLE V.03 - FLAT ROOF
PUBLISHED:	8/3/2022
REVISION:	
DRAWING INFORMATION	
EXTERIOR ELEVATIONS	
PROJECT NUMBER:	07164.057
DRAWN BY:	
CHECKED BY:	

A-202

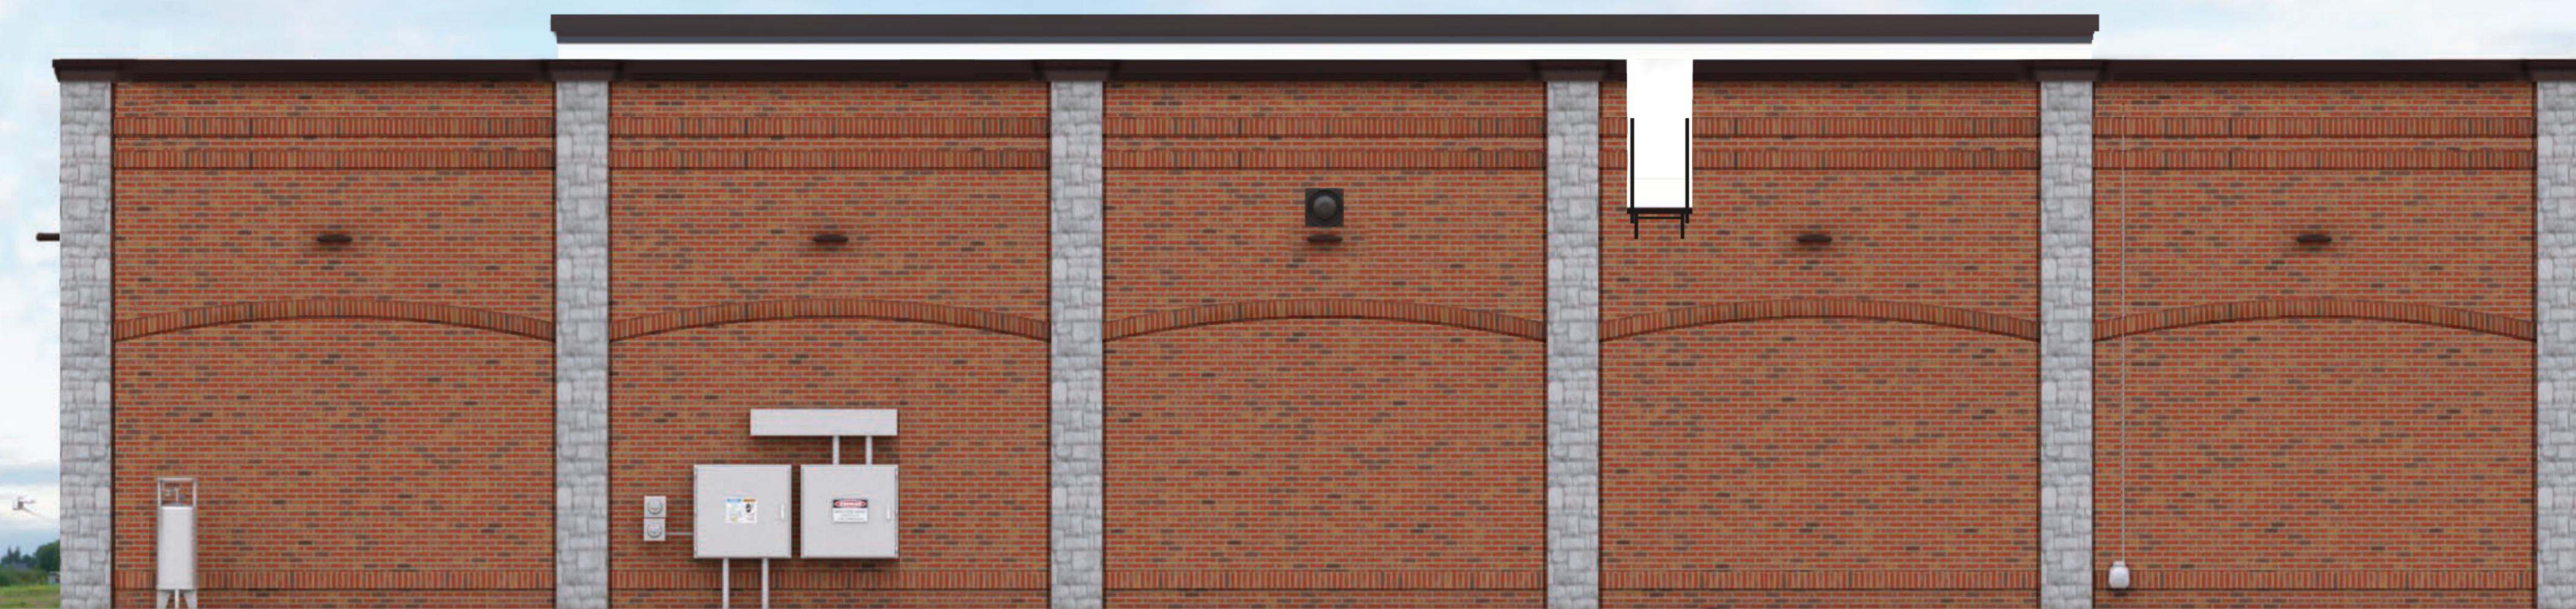

BACK ELEVATION



LEFT ELEVATION

LEE SUMMIT, MO




FRONT ELEVATION



RIGHT ELEVATION

LEE SUMMIT, MO

MATERIAL CALCULATION WEST ELEVATION			
BRICK	40%	428 SQ FT	
STUCCO	60%	630 SQ FT	
GLAZING	50%	76 - 6" LF	

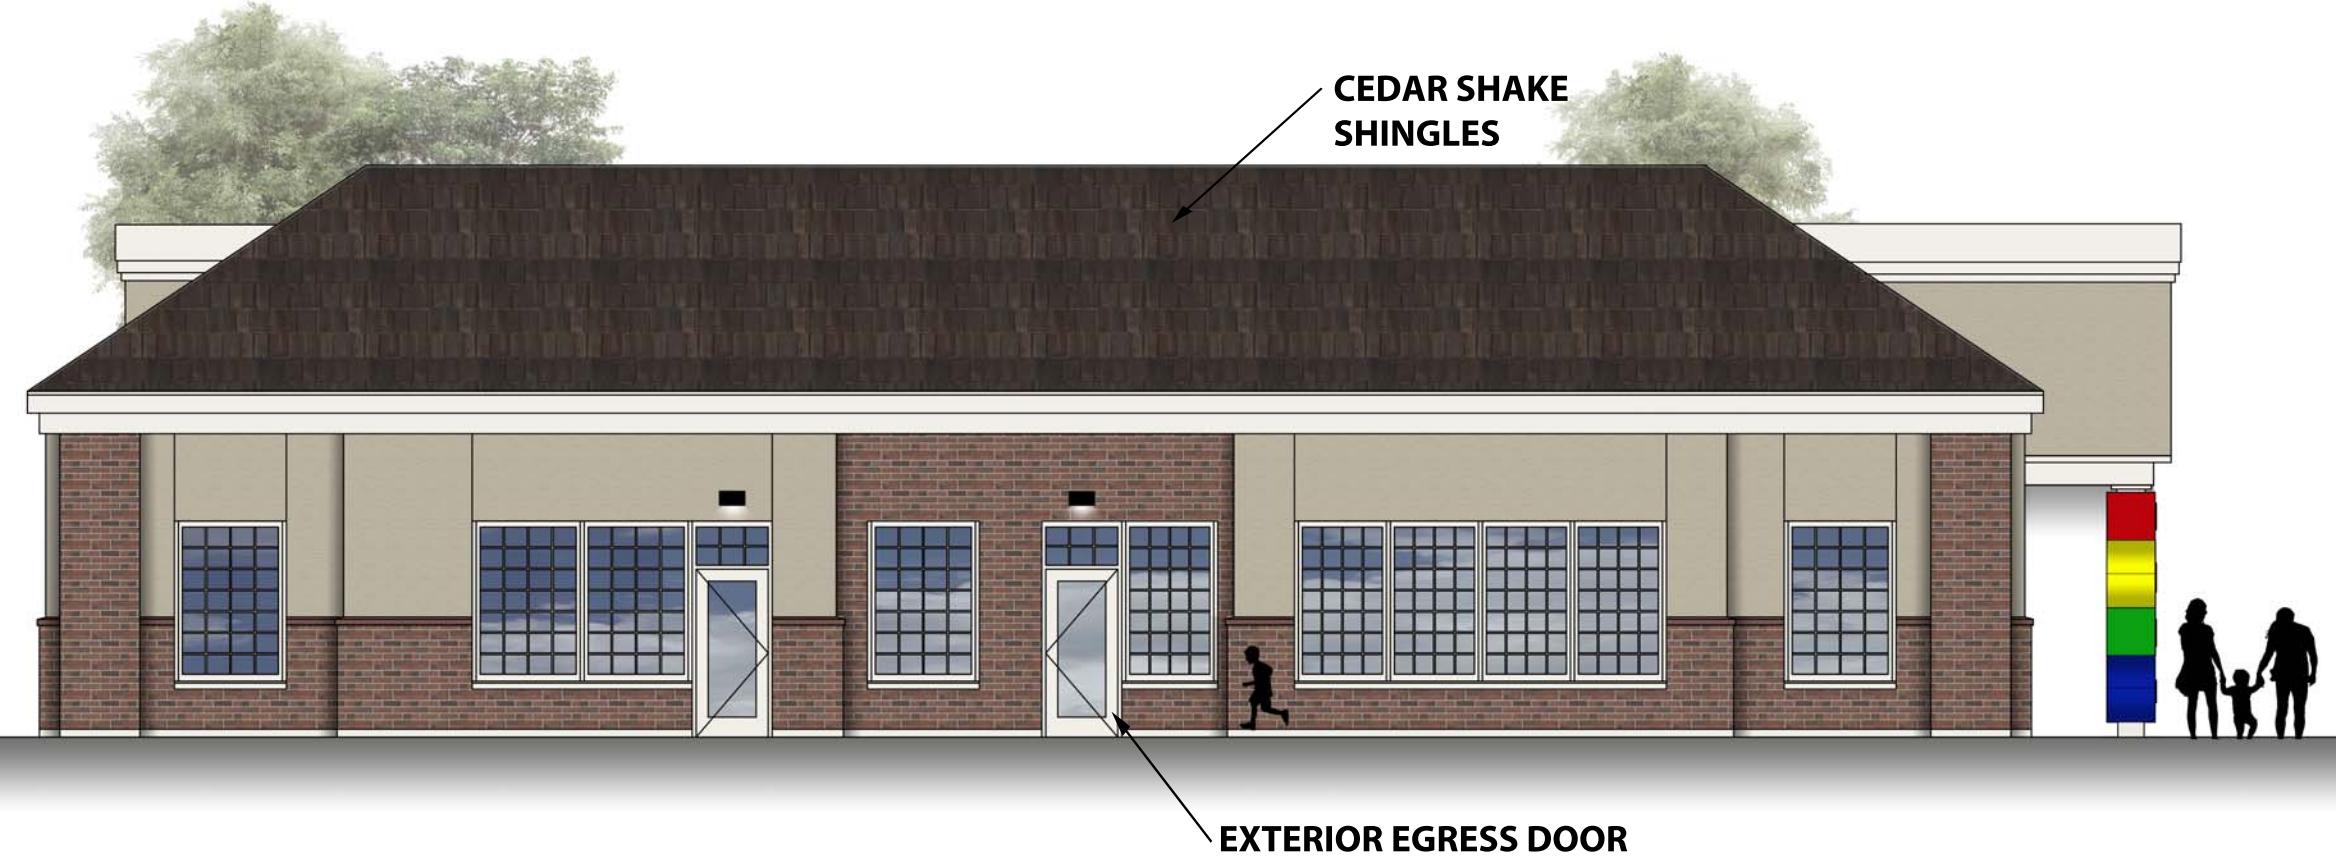

MATERIAL CALCULATION NORTH ELEVATION			
BRICK	54%	344 SQ FT	
STUCCO	46%	295 SQ FT	
GLAZING	54%	49'-0" LF	



MATERIAL CALCULATION SOUTH ELEVATION			
BRICK	55%	364 SQ FT	
STUCCO	45%	300 SQ FT	
GLAZING	50%	44'-0" LF	




MATERIAL CALCULATION EAST ELEVATION			
BRICK	45%	480 SQ FT	
STUCCO	55%	595 SQ FT	
GLAZING	50%	72'-6" LF	

TRASH ENCLOSURE

SCALE 1/4 = 1'-0"

7021 W. 121ST STREET, OVERLAND PARK, KS

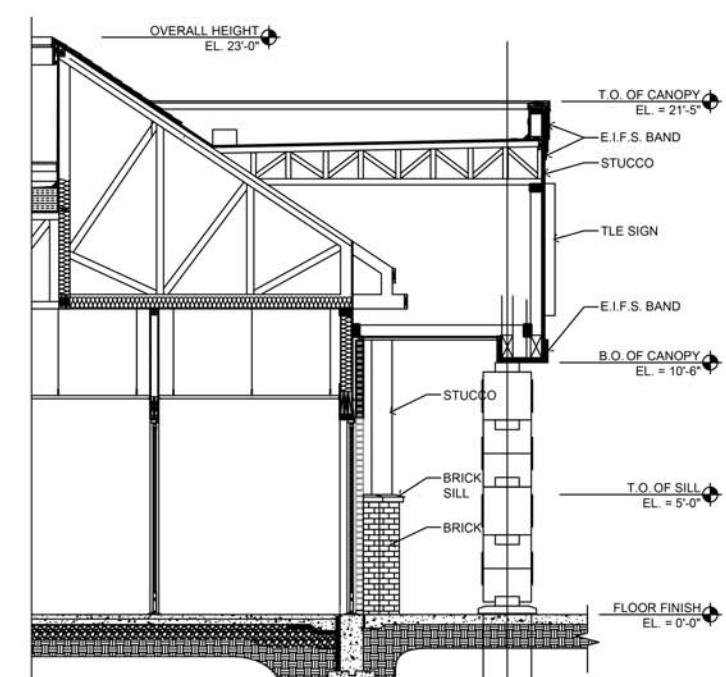

THE LEARNING EXPERIENCE

CASCO