EXISTING SANITARY MANHOLE PROPOSED SANITARY MANHOLE EXISTING AREA INLET EXISTING CURB INLET **EXISTING GRATE INLET EXISTING JUNCTION BOX** EXISTING STORM MANHOLE

CONNECT TO EXISTING WATER LINE

END OF LINE TEMPORARY FIRE HYDRANT ASSEMBLY

REMOVE AND RELOCATE TEMPORARY FIRE HYDRANT ASSEMBLY

FIRE HYDRANT ASSEMBLY

8" C-900 PVC


8" X 8" TEE

8" GATE VALVE

8 8" 11.25° PVC BEND

9 8" 22.5° PVC BEND

10 8" 45° PVC BEND

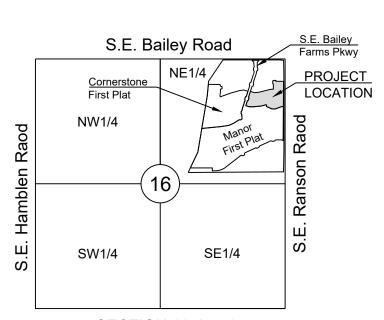

SECTION 16-47-31

LOCATION MAP SCALE 1" = 2000 BASIS OF BEARINGS MISSOURI COORDINATE **SYSTEM 1983**, **WEST ZONE**

UTILITY CONTACTS:

MISSOURI DEPARTMENT OF TRANSPORTATION (MODOT) 600 NE Colbern Road Lee's Summit, MO 64086

MISSOURI GAS ENERGY (MGE) Brent Jones

3025 SE Clover Drive Lee's Summit, MO 64082 (816) 399-9633 brent.jones@spireenergy.com

KANSAS CITY POWER & LIGHT COMPANY (KCP&L) Ron Dejarnette 1300 SE Hamblin Road Lee's Summit, MO 64081

Office: (816) 347-4316 Cell: (816) 810-5234 ron.dejarnette@kcpl.com

CITY OF LEES SUMMIT PUBLIC WORKS Dena Mezger

220 SE Green Street Lee's Summit, MO 64063 (816) 969-1800

Mark Manion or Marty Lope Kansas City, MO 64106 (816) 275-2341 or (816) 275-1550

COMCAST CABLE John Meadows 4700 Little Blue Parkway Independence, MO 64057 (816) 795-2257

CITY OF LEE'S SUMMIT WATER UTILITIES

Mark Schaufler 1200 SE Hamblen Road Lee's Summit, MO 64081 (816) 969-1900

SUMMARY OF QUANTITIES



QUANTITY

UNITS

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WATER LINE PLANS RETREAT AT BAILEY FARMS, FIRST PLAT

IN THE CITY OF LEE'S SUMMIT JACKSON COUNTY, MISSOURI

GENERAL NOTES

- ALL CONSTRUCTION TO FOLLOW THE CITY OF LEE'S SUMMIT DESIGN AND CONSTRUCTION MANUAL AS
- ALL WORKMANSHIP AND MATERIALS SHALL BE SUBJECT TO THE INSPECTION AND APPROVAL OF THE ENGINEERING DEPARTMENT OF THE CITY OF LEE'S SUMMIT, MISSOURI.
- LINEAL FOOT MEASUREMENTS SHOWN ON THE PLANS ARE HORIZONTAL MEASUREMENTS, NOT SLOPE

- EXCAVATION ON PUBLIC RIGHT OF WAY DO SO ONLY AFTER GIVING NOTICE TO, AND OBTAINING INFORMATION FROM, UTILITY COMPANIES. STATE LAW REQUIRES 48 HOURS ADVANCE NOTICE. THE CALL SYSTEM, INC.": 1-800-DIG-RITE. THIS PHONE NUMBER IS APPLICABLE ANYWHERE WITHIN THE STATE OF MISSOURI. PRIOR TO COMMENCEMENT OF WORK, THE CONTRACTOR SHALL NOTIFY ALL THOSE COMPANIES WHICH HAVE FACILITIES IN THE NEAR VICINITY OF THE CONSTRUCTION TO BE PERFORMED.
- THE CONTRACTOR SHALL PROTECT ALL MAJOR TREES FROM DAMAGE. NO TREE SHALL BE REMOVED
- WITHOUT PERMISSION OF THE OWNER, UNLESS SHOWN OTHERWISE. CLEARING AND GRUBBING OPERATIONS AND DISPOSAL OF ALL DEBRIS THEREFROM SHALL BE PERFORMED BY THE CONTRACTOR IN STRICT ACCORDANCE WITH ALL LOCAL CODES AND ORDINANCES.
- ALL WASTE MATERIAL RESULTING FROM THE PROJECT SHALL BE DISPOSED OF OFF-SITE BY THE CONTRACTOR, OR AS DIRECTED BY THE OWNER AT NO ADDITIONAL COST.
- 11. ALL EXCAVATIONS SHALL BE UNCLASSIFIED. NO SEPARATE PAYMENT WILL BE MADE FOR ROCK
- 12. THE CONTRACTOR SHALL CONTROL THE EROSION AND SILTATION DURING ALL PHASED OF CONSTRUCTION AND SHALL KEEP THE STREETS CLEAN OF MUD AND DEBRIS. 13. THE CONTRACTOR SHALL CONTACT DEVELOPMENT SERVICES INSPECTIONS AT: 816-969-1800 TO OBTAIN A
- DEVELOPMENT SERVICES CONSTRUCTION PERMIT. A MINIMUM 48 HOUR NOTICE SHALL BE GIVEN PRIOR TO 14. THE CONTRACTOR SHALL CONTACT THE RIGHT OF WAY INSPECTOR AT 816-969-1800 PRIOR TO ANY LAND
- DISTURBANCE ACTIVITIES WITHIN THE RIGHT OF WAY. THESE ACTIVITIES MAY REQUIRE A PERMIT. THE CONTRACTOR SHALL PROVIDE AND MAINTAIN ALL TRAFFIC HANDLING MEASURES NECESSARY TO ENSURE THAT THE GENERAL PUBLIC IS PROTECTED AT ALL TIMES. TRAFFIC CONTROL SHALL CONFORM TO
- THE MANUAL ON UNIFORM TRAFFIC CONTROL DEVICES (MUTCD-LATEST EDITION). ALL SANITARY SEWER LATERALS SHALL HAVE A TRENCH CHECK, CONSISTING OF FLOWABLE BACKFILL INSTALLED DURING CONSTRUCTION. TRENCH CHECK SHALL EXTEND TO BOTTOM OF TRENCH, TO WIDTH OF TRENCH, TO 12 INCHES ABOVE PIPE, FOR A MINIMUM LENGTH OF 12 INCHES. TRENCH CHECK SHALL BE

LOCATED AT LEAST 5 FEET FROM SANITARY MAIN.

EARTHWORK

- PRIOR TO EARTHWORK ACTIVITIES, PRE-DISTURBANCE EROSION AND SEDIMENT CONTROL DEVICES SHALI BE IN PLACE PER THE STORM WATER POLLUTION PREVENTION PLAN AND/OR THE EROSION AND SEDIMENT
- ALL BACKFILL MATERIAL SHALL BE PLACED IN MAXIMUM 6-INCH LIFTS AND COMPACTED TO 95-PERCENT OF MAXIMUM DENSITY AS DEFINED USING A STANDARD PROCTOR TEST (AASHTO T99/ASTM 698).
- BACKFILL MATERIALS SHALL NOT INCLUDE ORGANIC MATTER, DEBRIS OR TOPSOIL THE CONTRACTOR SHALL BE RESPONSIBLE FOR REDISTRIBUTING THE TOPSOIL OVER PROPOSED TURF AND
- LANDSCAPED AREAS TO A MINIMUM DEPTH OF 6-INCHES BELOW FINAL GRADE.
- ALL AREAS SHALL BE GRADED FOR POSITIVE DRAINAGE. UNLESS NOTED OTHERWISE THE FOLLOWING
- A. TURF AREAS 2.5% MINIMUM, 4H:1V MAXIMUM
- DEVICES SHALL BE PROPERLY MAINTAINED AND KEPT CLEAN OF SILT AND DEBRIS AND IN GOOD WORKING ORDER, ADDITIONAL EROSION AND SEDIMENT CONTROL MEASURES SHALL BE INSTALLED AS REQUIRED.


- EXISTING UTILITIES HAVE BEEN SHOWN TO THE GREATEST EXTENT POSSIBLE BASED UPON INFORMATION PROVIDED TO THE ENGINEER. THE CONTRACTOR IS RESPONSIBLE FOR CONTACTING THE RESPECTIVE UTILITY COMPANIES AND FIELD LOCATING UTILITIES PRIOR TO CONSTRUCTION AND IDENTIFYING ANY POTENTIAL CONFLICTS. ALL CONFLICTS SHALL IMMEDIATELY BE BROUGHT TO THE ATTENTION OF THE
- THE CONTRACTOR SHALL BE RESPONSIBLE FOR COORDINATING ANY REQUIRED UTILITY RELOCATIONS. UTILITIES DAMAGED THROUGH THE NEGLIGENCE OF THE CONTRACTOR SHALL BE REPAIRED AT THE
- CONTRACTOR SHALL VERIFY FLOW-LINES AND STRUCTURE TOPS PRIOR TO CONSTRUCTION, AND SHALL NOTIFY ENGINEER OF ANY DISCREPANCIES. PROVIDE SHOP DRAWINGS FOR ALL PRECAST AND MANUFACTURED UTILITY STRUCTURES FOR REVIEW BY THE ENGINEER PRIOR TO CONSTRUCTION OF THE
- 4. UTILITY SEPARATION: WATERLINES SHALL HAVE A MINIMUM OF 10 FEET HORIZONTAL AND 2 FEET VERTICAL SEPARATION FROM ALL SANITARY AND STORM SEWER LINES. IF MINIMUM SEPARATIONS CAN NOT BE
- 7. TRENCH SPOILS SHALL BE NEATLY PLACED ONSITE ADJACENT TO THE TRENCH, AND COMPACTED TO PREVENT SATURATION AND EXCESS SEDIMENT RUNOFF. UNSUITABLE MATERIALS, ROCK AND SHALE, ASPHALT, CONCRETE, TREES, BRUSH ETC. SHALL BE PROPERLY DISPOSED OF OFFSITE. MATERIALS MAY BE

- CONTROL PLAN PREPARED FOR THIS SITE.


- GRADES SHALL APPLY:

- OBTAINED, DUCTILE IRON PIPE, DIP, SHALL BE REQUIRED 10 FEET IN EACH DIRECTION OF THE CONFLICT ON
- 5. PAYMENT FOR TRENCHING, BACKFILLING, PIPE EMBEDMENT, FLOWABLE FILL, BACKFILL MATERIALS, CLEAN UP, SEEDING, SODDING AND ANY OTHER ITEMS NECESSARY FOR THE CONSTRUCTION OF THE UTILITY LINE
- SHALL BE INCLUDED IN THE CONTRACT PRICE FOR THE UTILITY INSTALLATION. 6. THE CONTRACTOR SHALL BE RESPONSIBLE FOR CONTACTING RESPECTIVE UTILITY COMPANIES 48-HOURS IN ADVANCE FOR THE INSPECTION OF ANY PROPOSED UTILITY MAIN EXTENSION OR SERVICE LINE OR SERVICE
- CONNECTION TO ANY EXISTING MAIN. WASTED ONSITE AT THE DIRECTION OF THE OWNER OR HIS APPOINTED REPRESENTATIVE.

Sheet List Table Sheet Number Sheet Title COVER SHEET GENERAL LAYOUT WATER LINE 8 PLAN AND PROFILE WATER LINE 10 PLAN AND PROFILE WATER LINE 12 PLAN AND PROFILE WATER LINE DETAILS

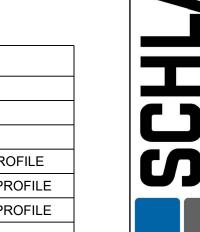

PREPARED BY

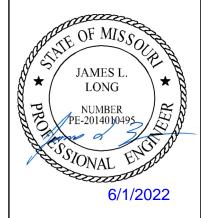

SCHLAGEL & ASSOCIATES, P./

APPROVED BY

CITY ENGINEER APPROVED FOR ONE YEAR FROM THIS DATE

OWNER/DEVELOPER

CLAYTON PROPERTIES GROUP, INC., DBA SUMMIT HOMES DBA SUMMIT HOMES BRADLEY KEMPF 120 SE 30TH STREET

LEE'S SUMMIT, MO 64082

p (816) 246-6700

MISSOURI GEOGRAPHIC REFERENCE SYSTEM **BENCHMARK:**

BM JA-45, IS A KC METRO ALUMINUM GRS DISK SET IN CONCRETE AND ABOUT 3 INCHES BELOW THE PAVEMENT ON THE SHOULDER OF SE RANSON ROAD. IT IS STAMPED JA45, 1987.

ELEV. = 1046.25


PROJECT BENCHMARK:

Brass Disk at the Northeast Corner of the Northeast One-Quarter of Section 16, Township 47 N, Range 31 W. Intersection of SE. Bailey Road and SE. Ranson

ELEV. = 939.19

COVER SHEET

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PREPARED BY:

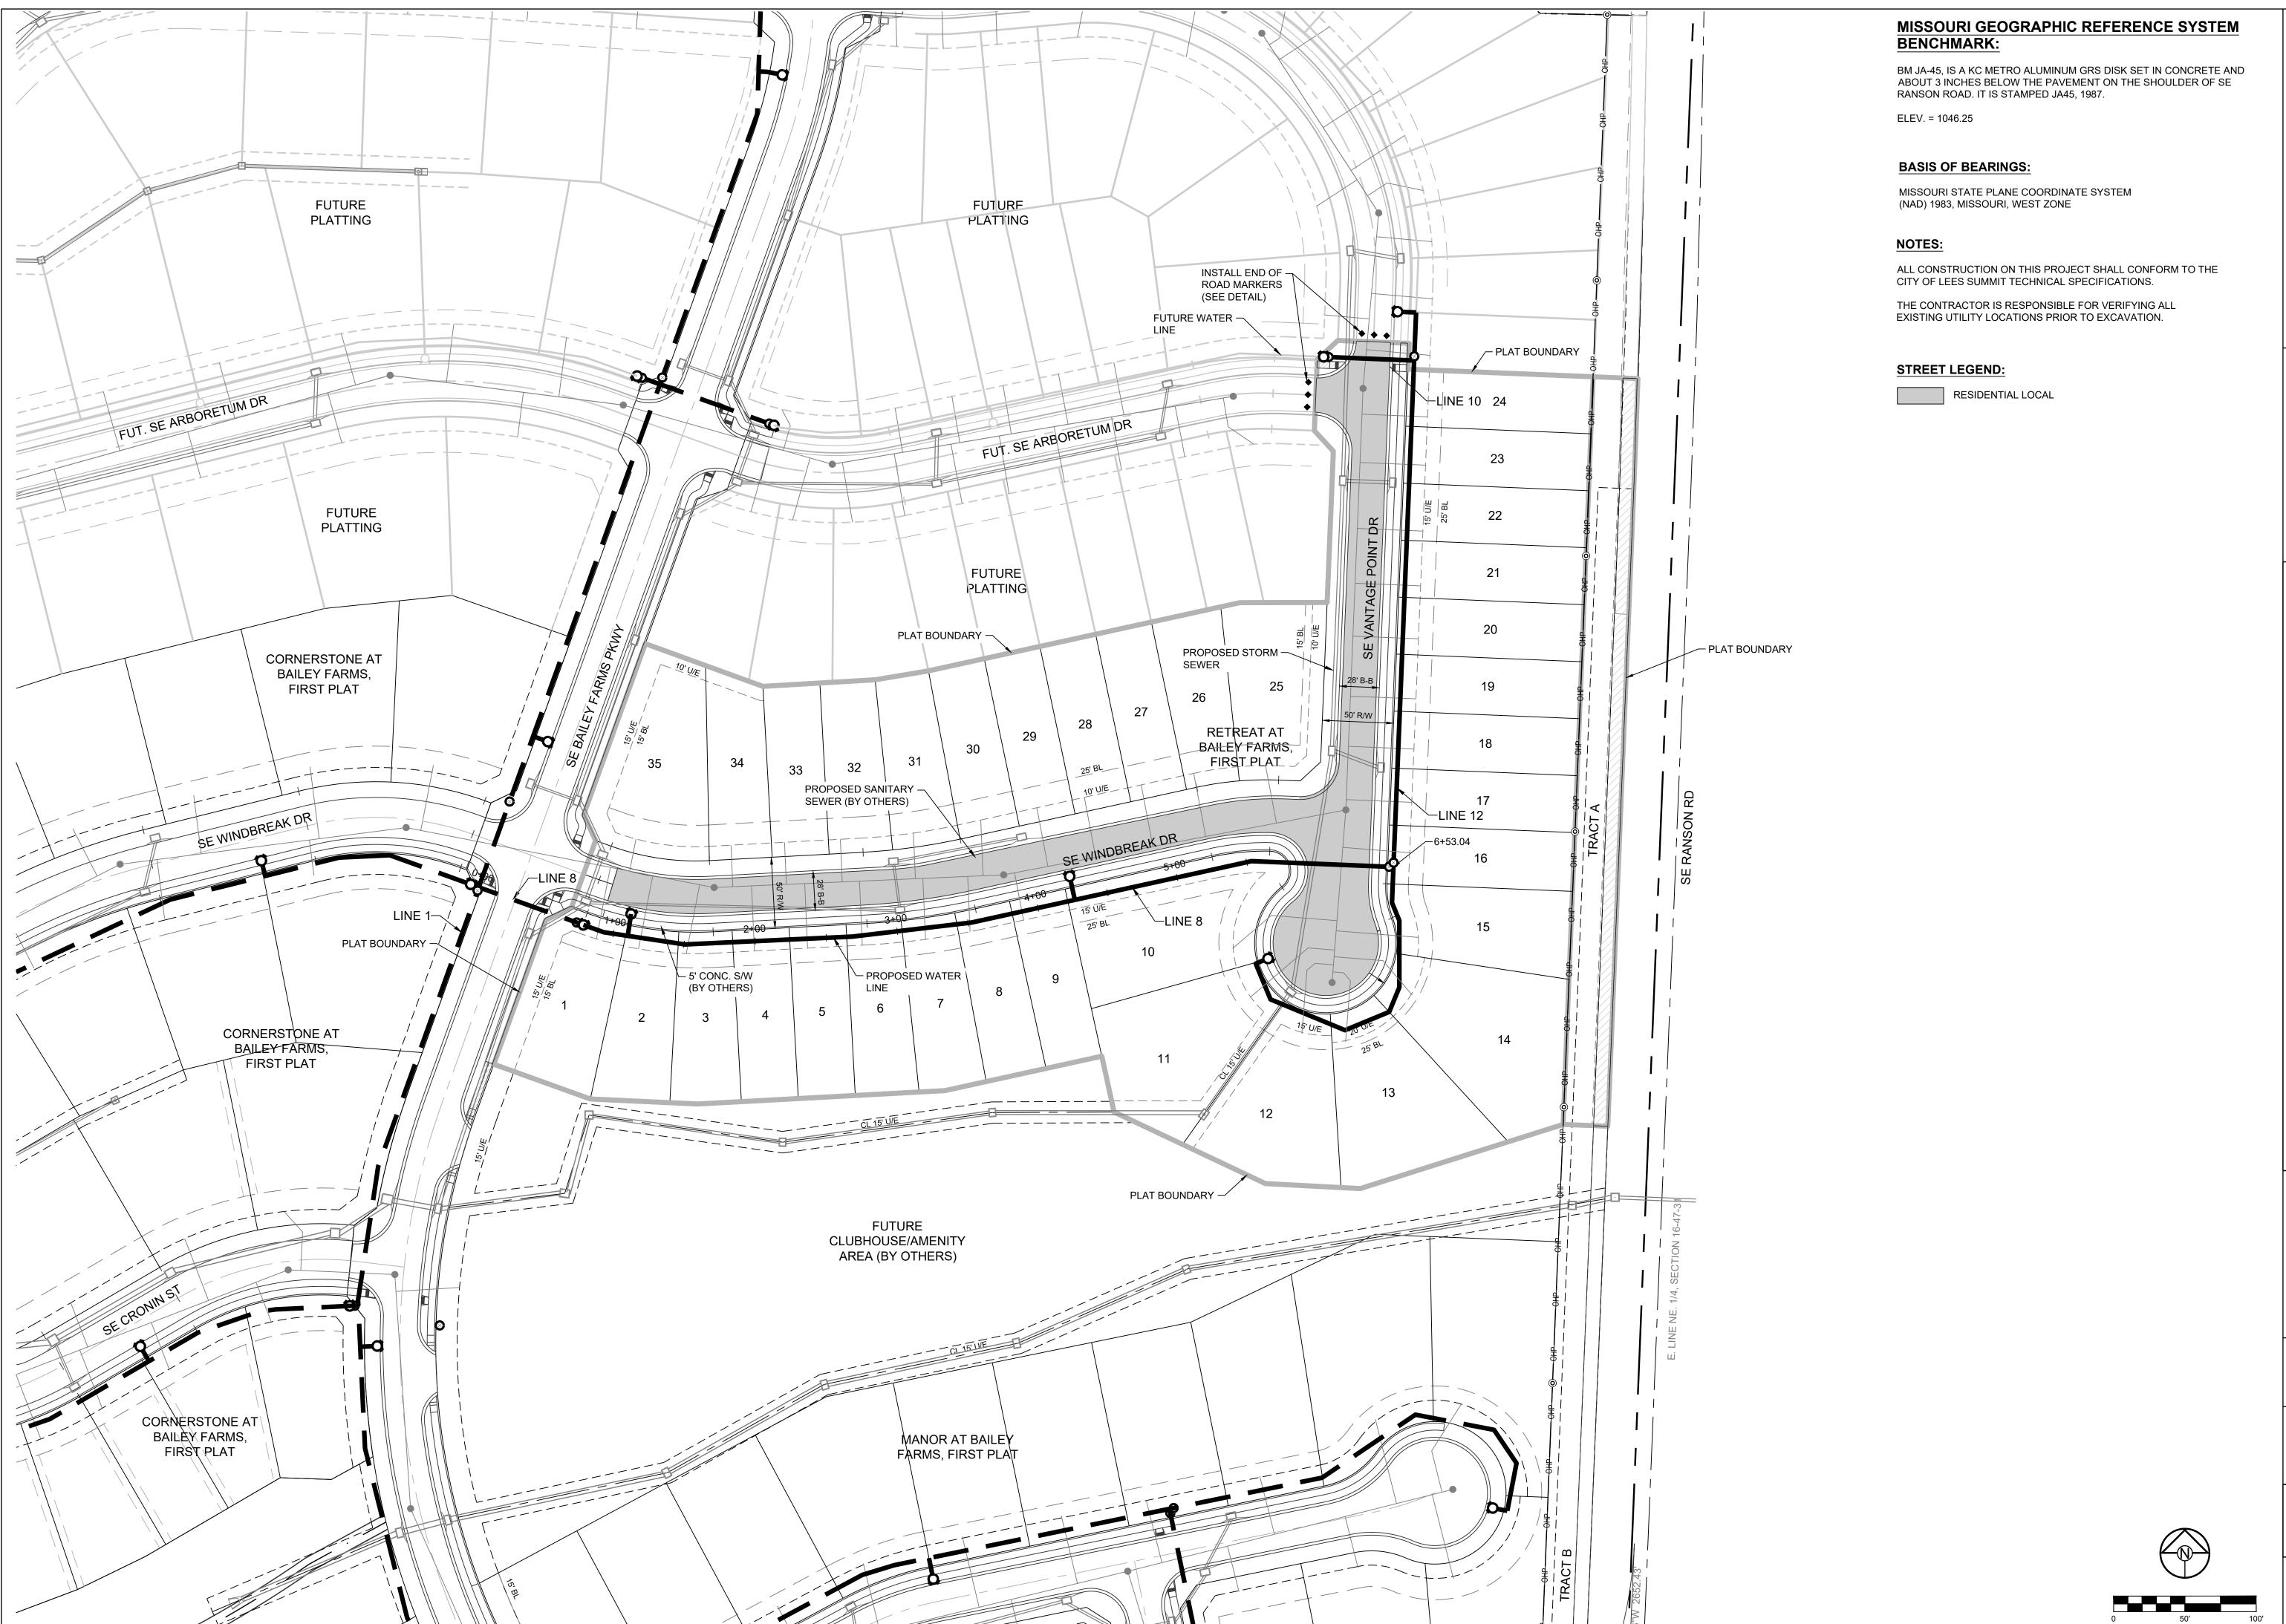

SCHLAGEL & ASSOCIATES, P.A.


ROAD

 \Box

GENERAL LAYOUT

SHEET

SCALE: 1" = 50'

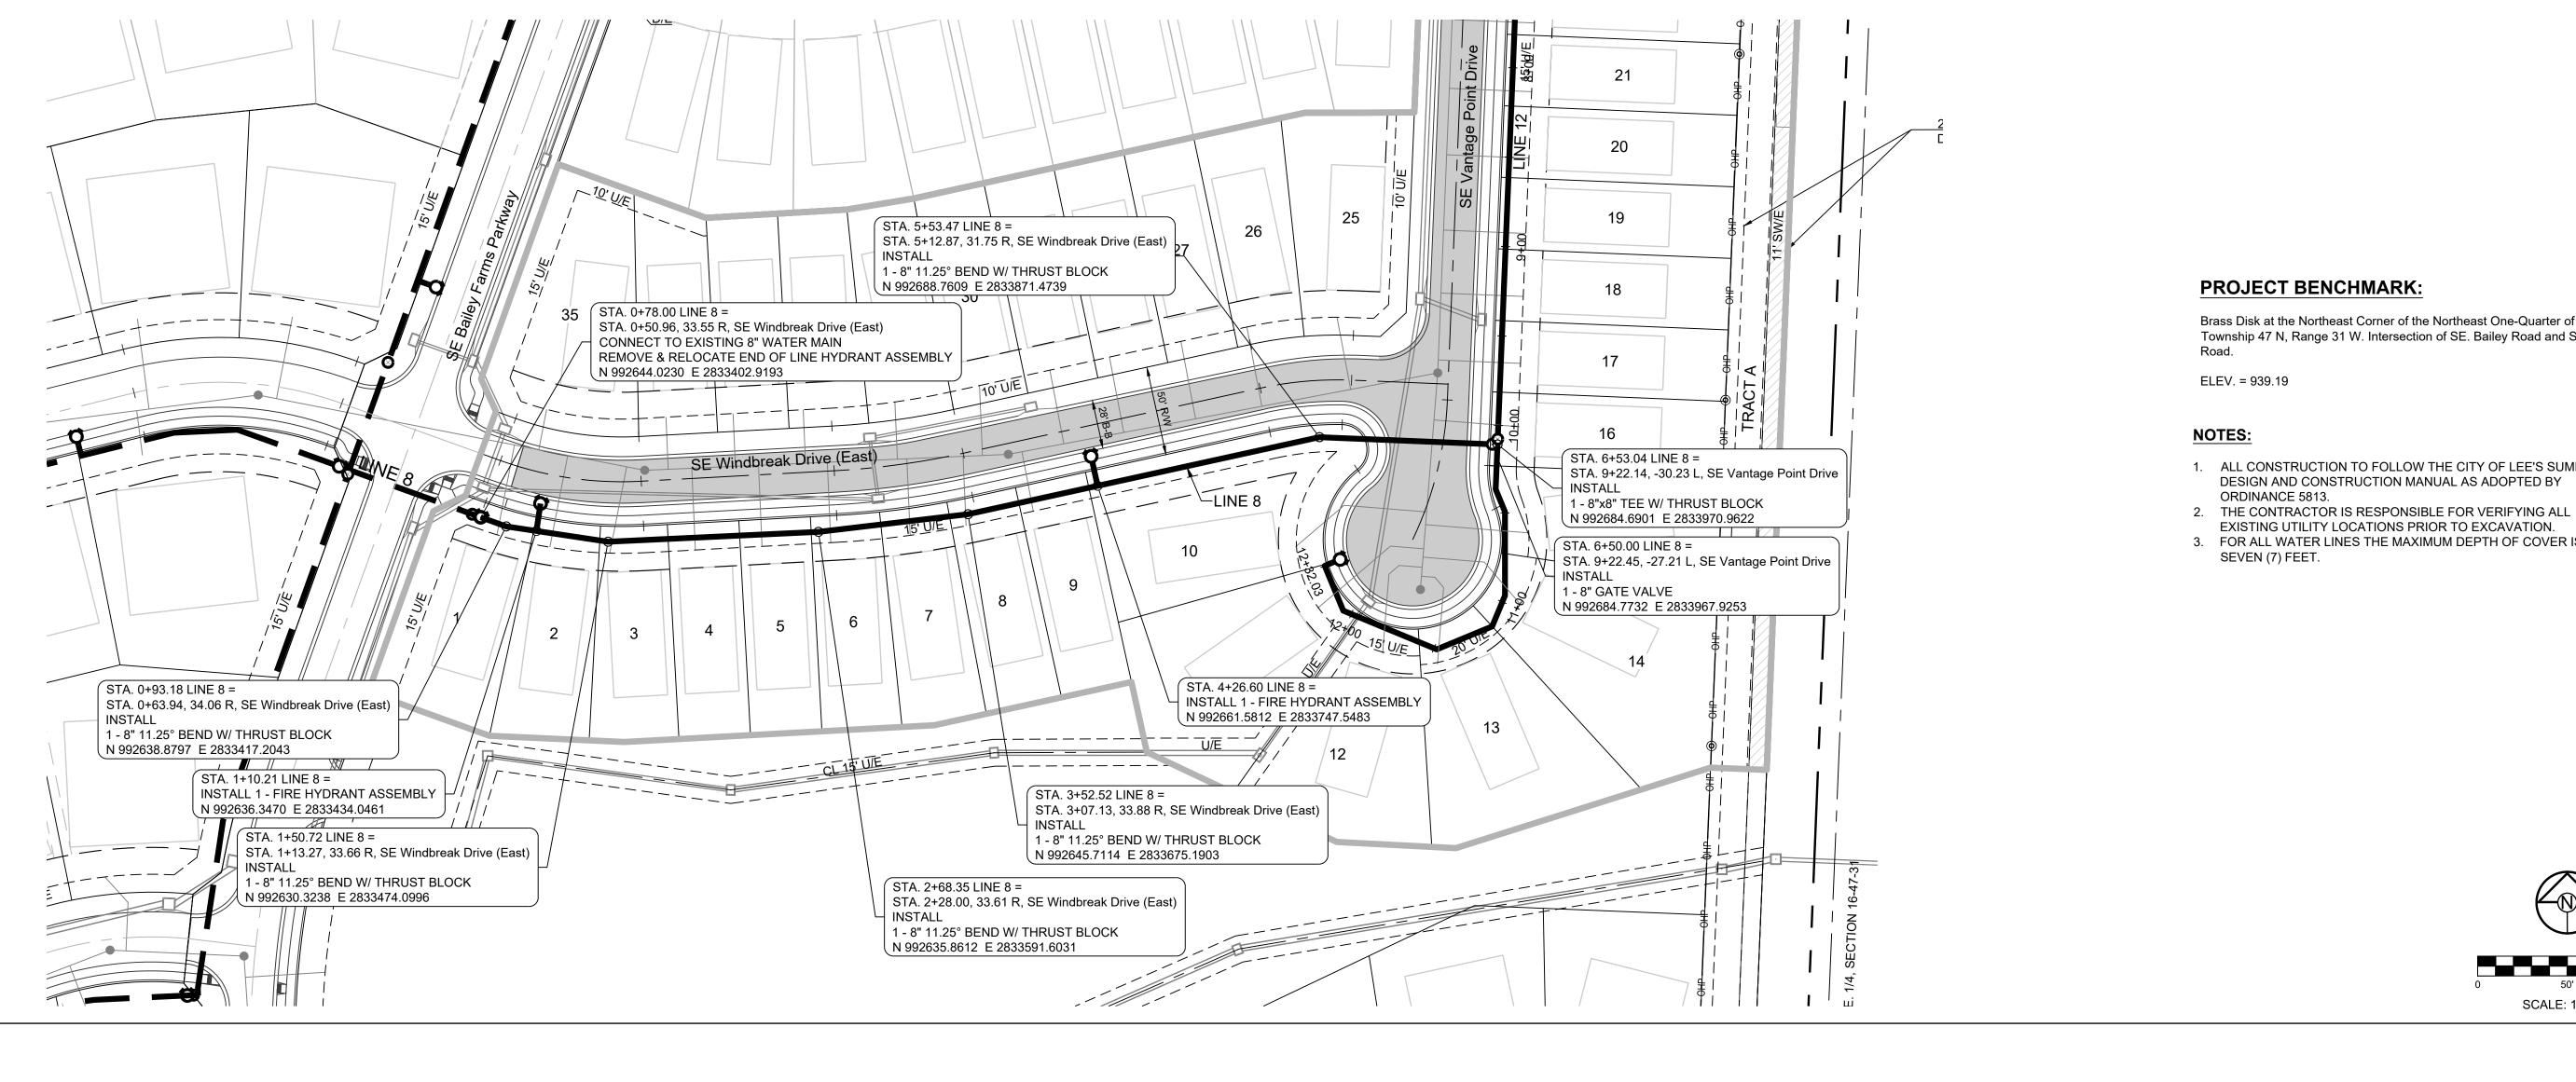

5+00

6+00

EXISTING GRADE

2+00

3+00

4+00

EXISTING 8" — WATER LINE

0+00

24" Storm__ FL=1013.82

1+00



Brass Disk at the Northeast Corner of the Northeast One-Quarter of Section 16, Township 47 N, Range 31 W. Intersection of SE. Bailey Road and SE. Ranson

- 1. ALL CONSTRUCTION TO FOLLOW THE CITY OF LEE'S SUMMIT DESIGN AND CONSTRUCTION MANUAL AS ADOPTED BY
- EXISTING UTILITY LOCATIONS PRIOR TO EXCAVATION.
- 3. FOR ALL WATER LINES THE MAXIMUM DEPTH OF COVER IS

JAMES L. LONG 6/1/2022 SCHLAGEL & ASSOCIATES, P.A.

PREPARED BY:

RETREAT AT BAILEY
WATER LI

SCALE: 1" = 50'

LINE 8 1" = 50' HORIZ. 1" = 10' VERT. 1060 1050 1040 PROPOSED GRADE -1030 1020 18" Storm__ FL=1019.02 PLACE MINIMUM 1.5 FEET
OF COMPACTED SOIL
ABOVE TOP OF PIPE
ELEVATION PRIOR TO
TRENCHING AND
INSTALLATION. CENTER SECTION OF PIPE OVER STORM STA. 6+17 8" Sanitary Sewer FL=1012.01 1010 1000 575 LF - 8" C-900 PVC PIPE


7+00

990

8+00

BAILE) LE

WATER LINE 8 PLAN AND PROFILE

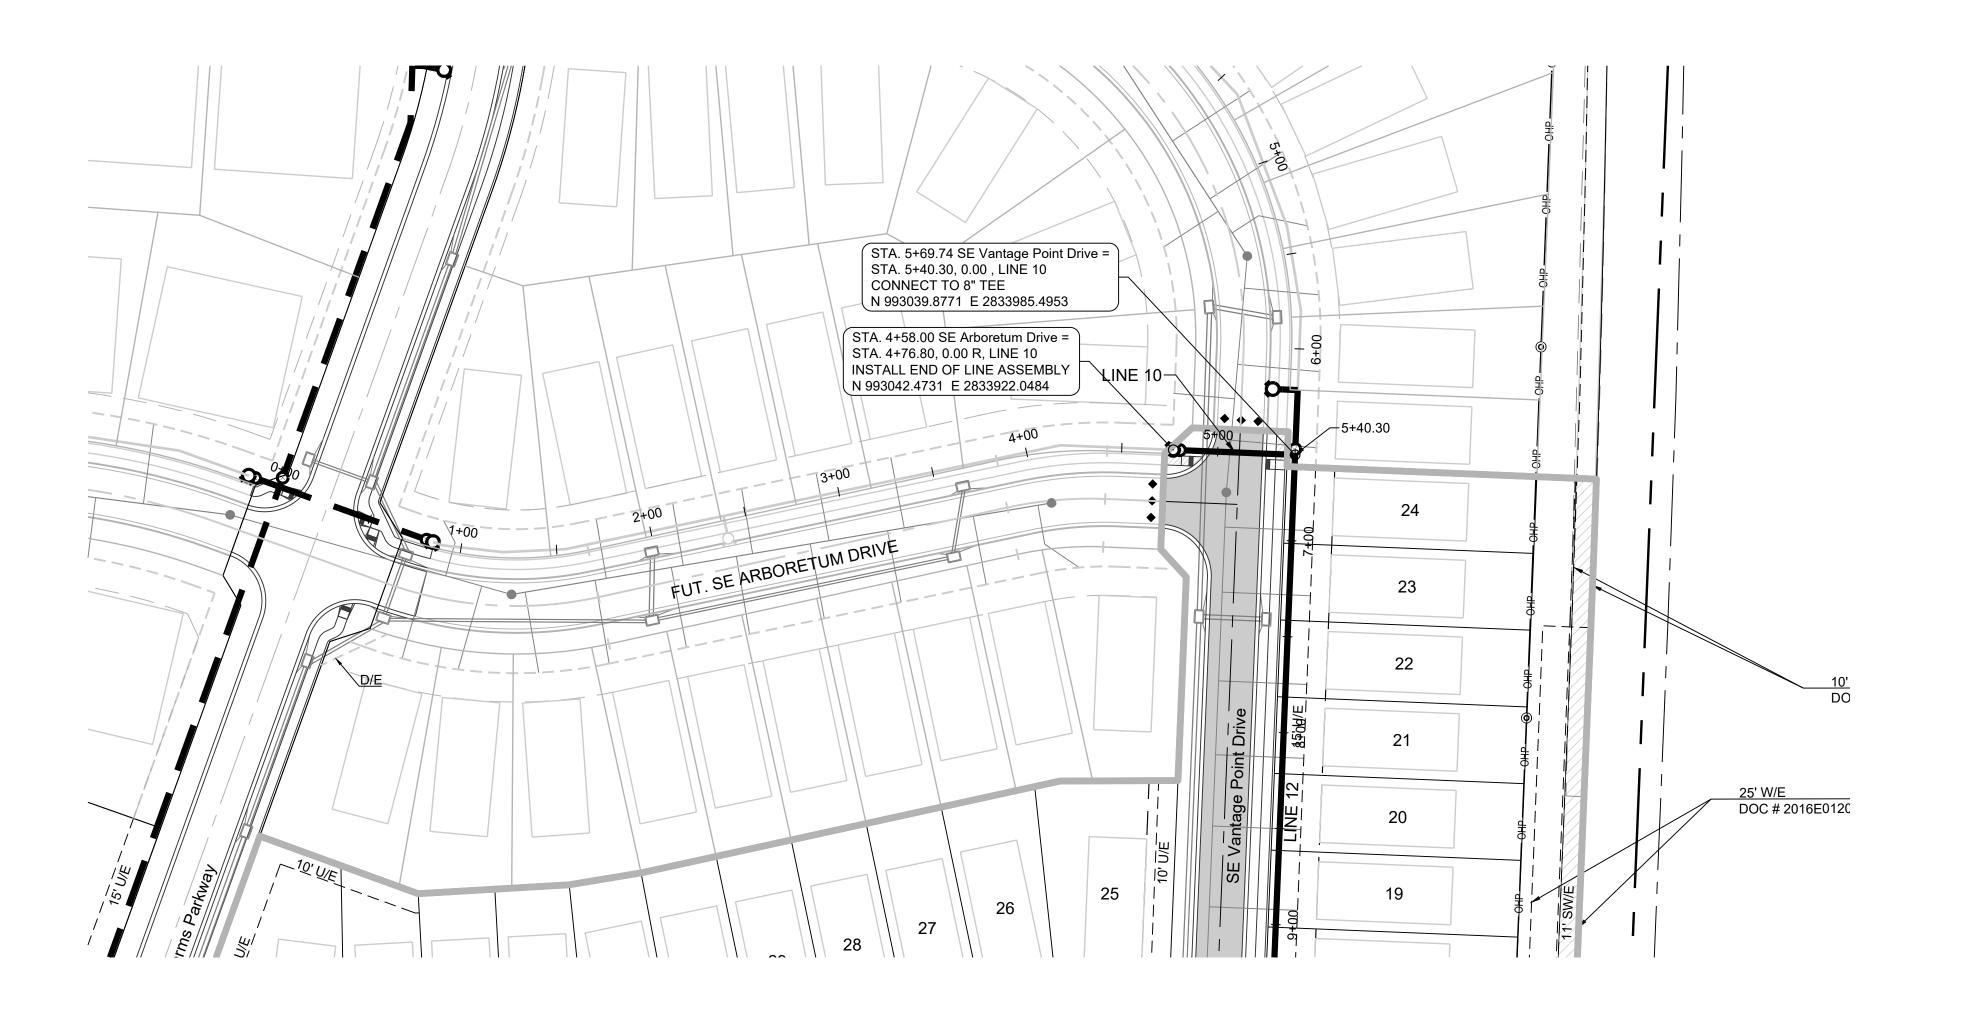

PROJECT BENCHMARK:

Brass Disk at the Northeast Corner of the Northeast One-Quarter of Section 16, Township 47 N, Range 31 W. Intersection of SE. Bailey Road and SE. Ranson Road.

ELEV. = 939.19

NOTES:

- 1. ALL CONSTRUCTION TO FOLLOW THE CITY OF LEE'S SUMMIT DESIGN AND CONSTRUCTION MANUAL AS ADOPTED BY ORDINANCE 5813.
- 2. THE CONTRACTOR IS RESPONSIBLE FOR VERIFYING ALL EXISTING UTILITY LOCATIONS PRIOR TO EXCAVATION.
- 3. FOR ALL WATER LINES THE MAXIMUM DEPTH OF COVER IS SEVEN (7) FEET.



SCALE: 1" = 50'

LINE 10 1" = 50' HORIZ. 1" = 10' VERT. 1060 STA. 4+77, LINE 10 = 1032.71 PROPOSED GRADE — 15" Storm FL=1029 25 STA. 5+06 -8" Sanitary Sewer FL=1025.49 CENTER SECTION OF — PIPE OVER STORM SEWER 64 LF - 8" C-900 PVC PIPE 5+00 6+00

ROAD RETREAT AT BAILEY
WATER LI BAILE) LE

PREPARED BY:

JAMES L.


LONG

SCHLAGEL & ASSOCIATES, P.A.

6/1/2022

WATER LINE 10 PLAN AND

PROFILE

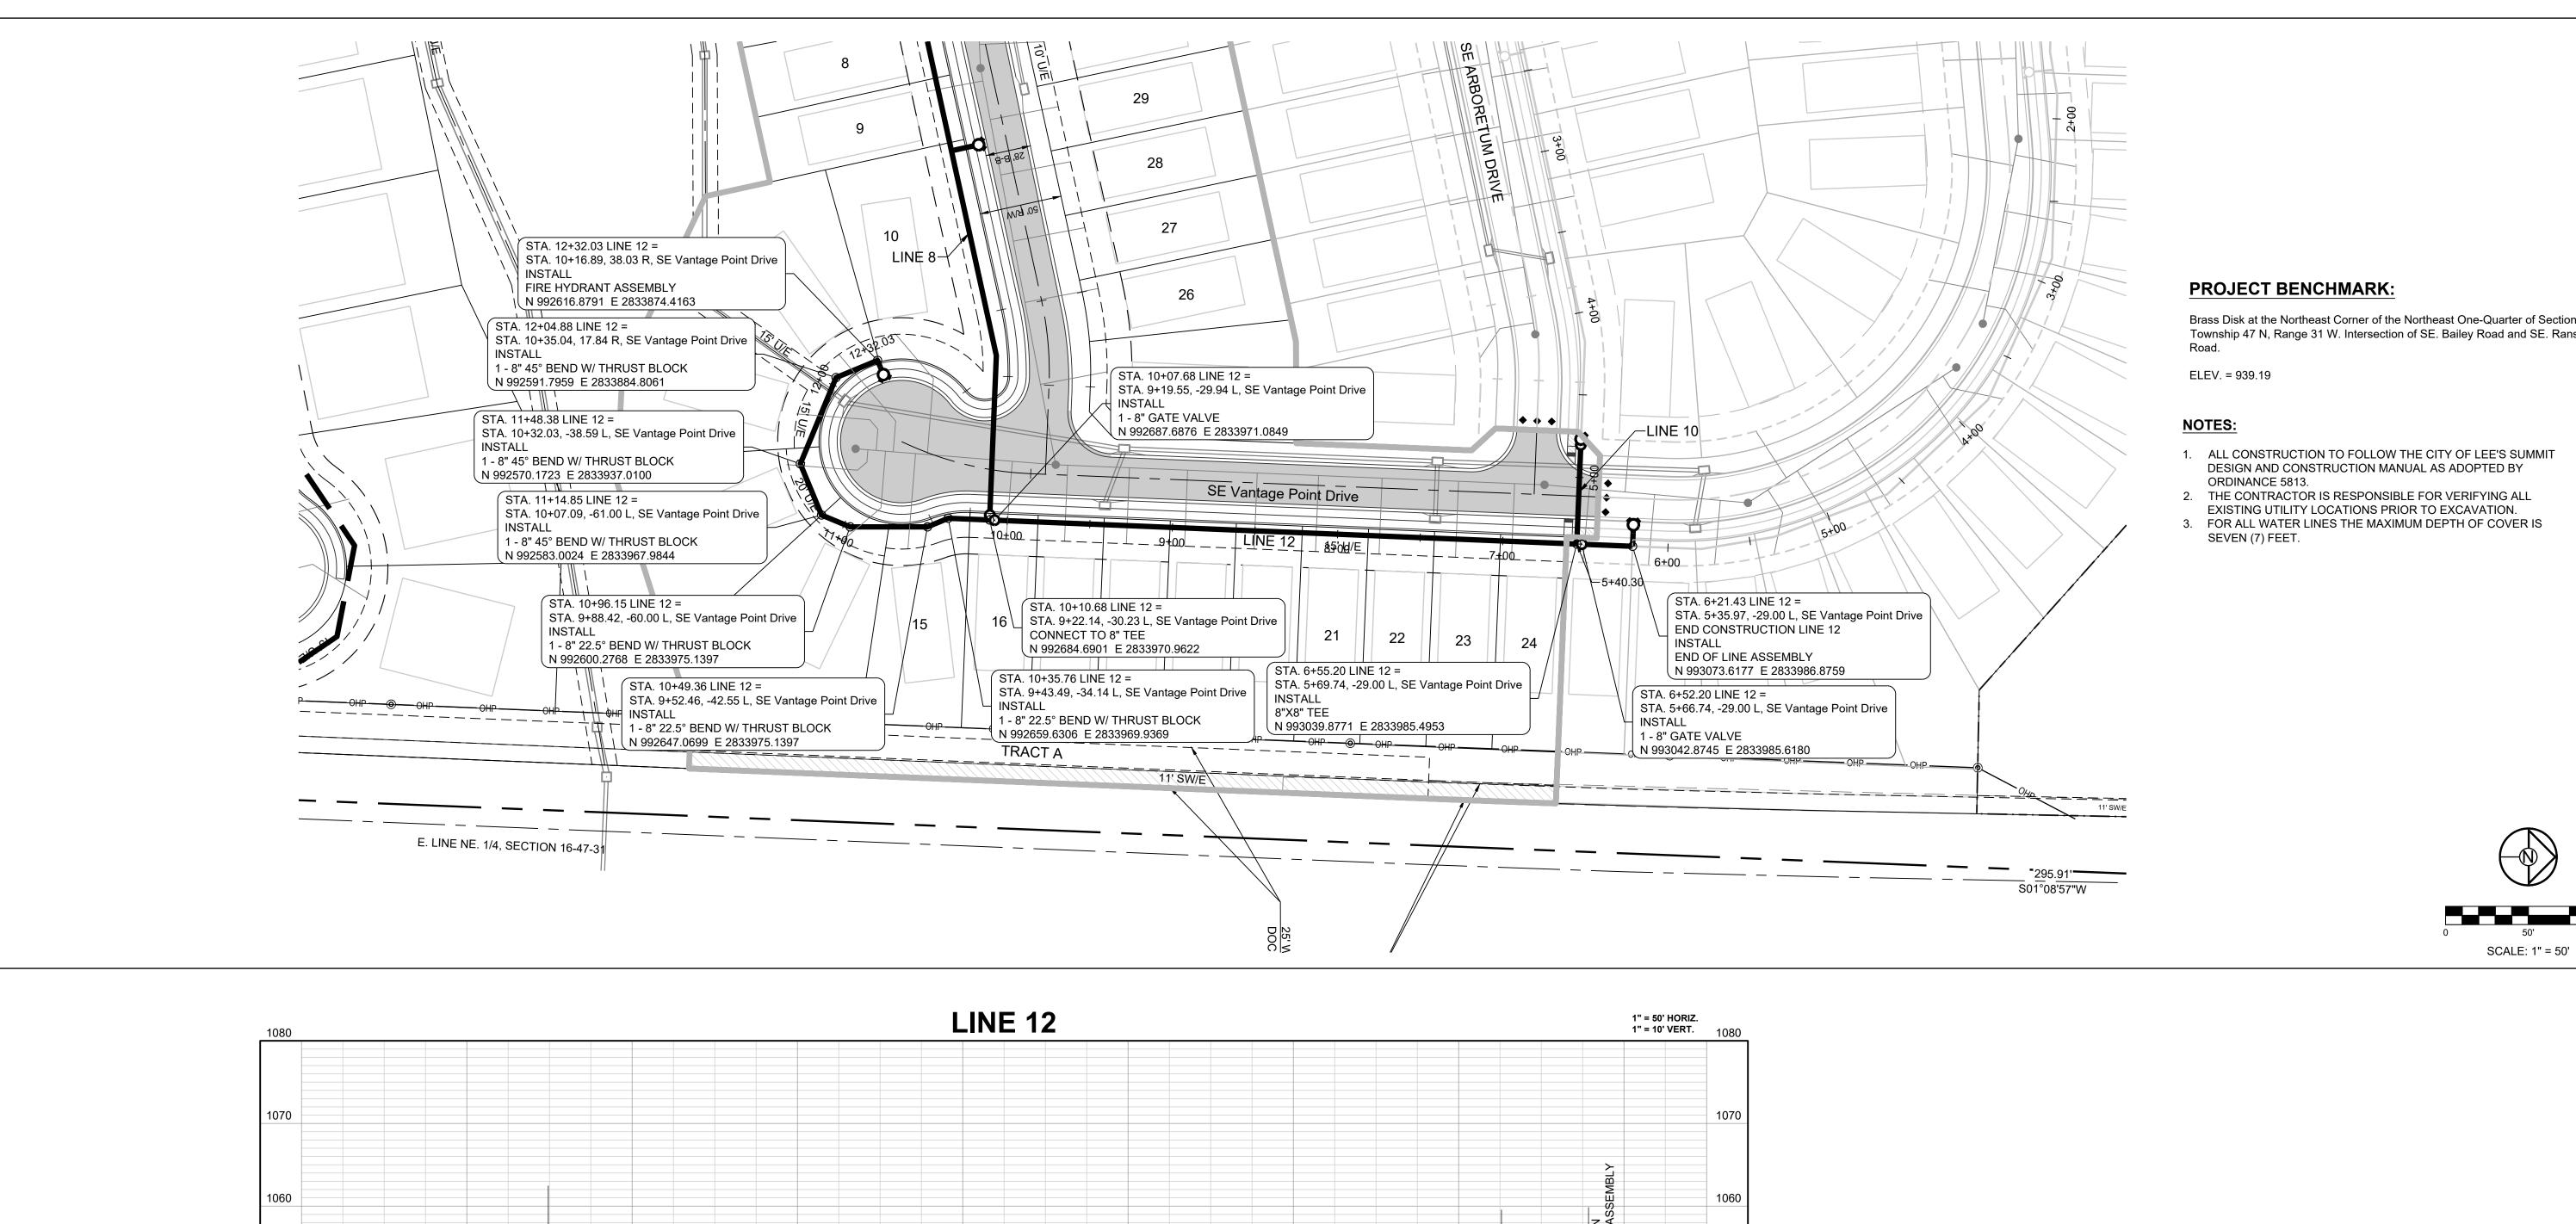

Brass Disk at the Northeast Corner of the Northeast One-Quarter of Section 16, Township 47 N, Range 31 W. Intersection of SE. Bailey Road and SE. Ranson

- 1. ALL CONSTRUCTION TO FOLLOW THE CITY OF LEE'S SUMMIT DESIGN AND CONSTRUCTION MANUAL AS ADOPTED BY

6/1/2022

PREPARED BY:


JAMES L.

LONG

SCHLAGEL & ASSOCIATES, P.A.

RETREAT Ω

WATER LINE 12 PLAN AND PROFILE

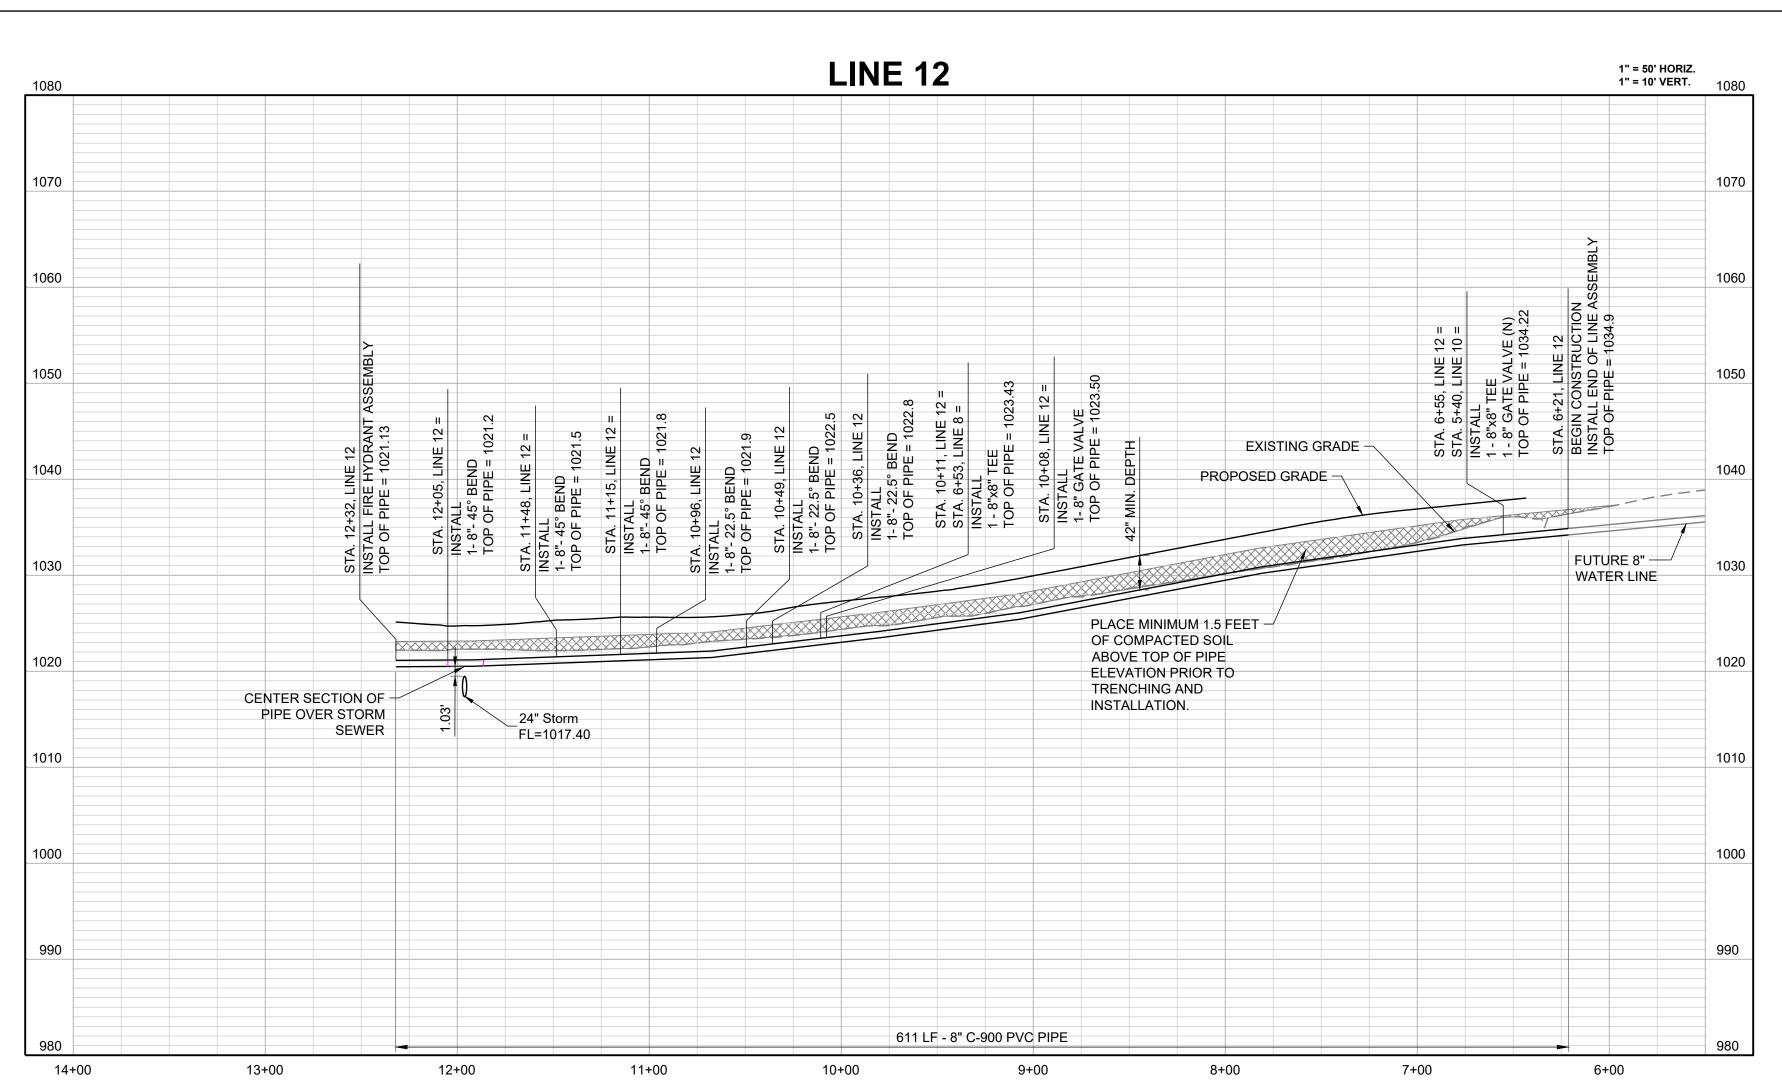

NOTES:

1. ALL PIPE SYSTEMS SHALL BE INSTALLED IN ACCORDANCE WITH ASTM D2321, "STANDARD PRACTICE FOR UNDERGROUND INSTALLATION OF THERMOPLASTIC PIPE FOR SEWERS AND OTHER GRAVITY FLOW APPLICATIONS", LATEST EDITION


2. MEASURES SHOULD BE TAKEN TO PREVENT MIGRATION OF NATIVE FINES INTO BACKFILL MATERIAL, WHEN REQUIRED.


3. FOUNDATION: WHERE THE TRENCH BOTTOM IS UNSTABLE, THE CONTRACTOR SHALL EXCAVATE TO A DEPTH REQUIRED BY THE ENGINEER AND REPLACE WITH SUITABLE MATERIAL AS SPECIFIED BY THE ENGINEER. AS AN ALTERNATIVE AND AT THE DISCRETION OF THE DESIGN ENGINEER, THE TRENCH BOTTOM MAY BE STABILIZED USING A GEOTEXTILE MATERIAL.


4. <u>BEDDING:</u> SUITABLE MATERIAL SHALL BE CLASS I, II OR III. THE CONTRACTOR SHALL PROVIDE DOCUMENTATION FOR MATERIAL SPECIFICATION TO ENGINEER. UNLESS OTHERWISE NOTED BY THE ENGINEER, MINIMUM BEDDING THICKNESS SHALL BE 4" (100mm) FOR 4"-24" (100mm-600mm); 6" (150mm) FOR 30"-60" (750mm-900mm).


5. INITIAL BACKFILL: SUITABLE MATERIAL SHALL BE CLASS I, II OR III IN THE PIPE ZONE EXTENDING NOT LESS THAN 6" ABOVE CROWN OF PIPE. THE CONTRACTOR SHALL PROVIDE DOCUMENTATION FOR MATERIAL SPECIFICATION TO ENGINEER. MATERIAL SHALL BE INSTALLED AS REQUIRED IN ASTM D2321, LATEST EDITION.


6. MINIMUM COVER: MINIMUM COVER, H, IN NON-TRAFFIC APPLICATIONS (GRASS OR LANDSCAPE AREAS) IS 12" FROM THE TOP OF PIPE TO GROUND SURFACE. ADDITIONAL COVER MAY BE REQUIRED TO PREVENT FLOATION. FOR TRAFFIC APPLICATIONS, MINIMUM COVER, H, IS 12" UP TO 48" DIAMETER PIPE AND 24" OF COVER FOR 54"-60" DIAMETER PIPE, MEASURED FROM TOP OF PIPE TO BOTTOM OF FLEXIBLE PAVEMENT OR TO TOP OF RIGID PAVEMENT.

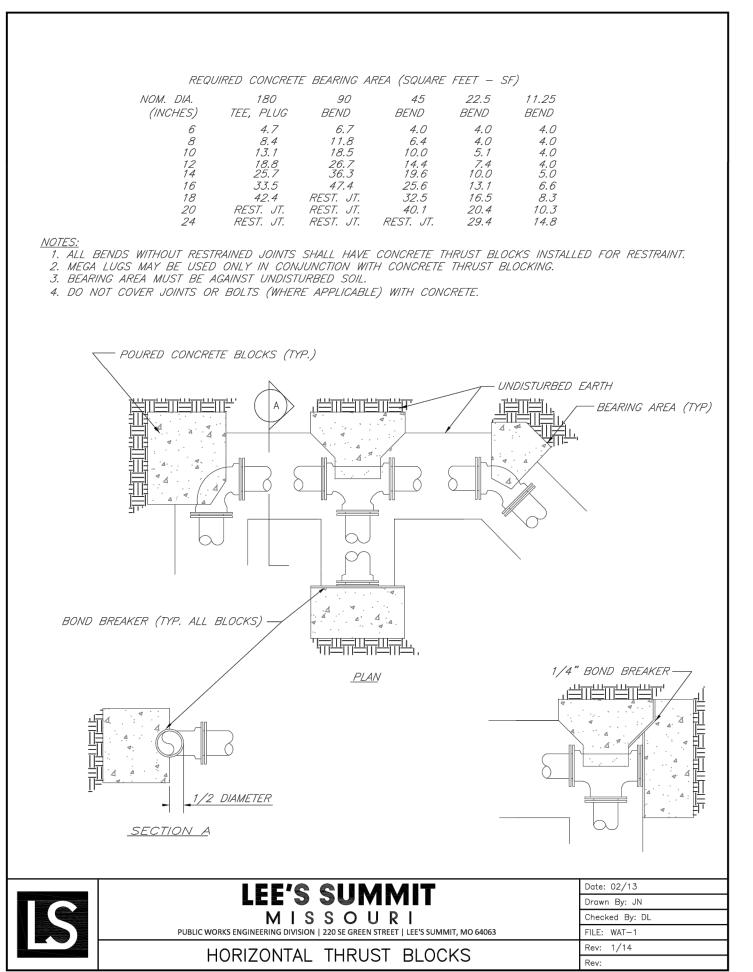


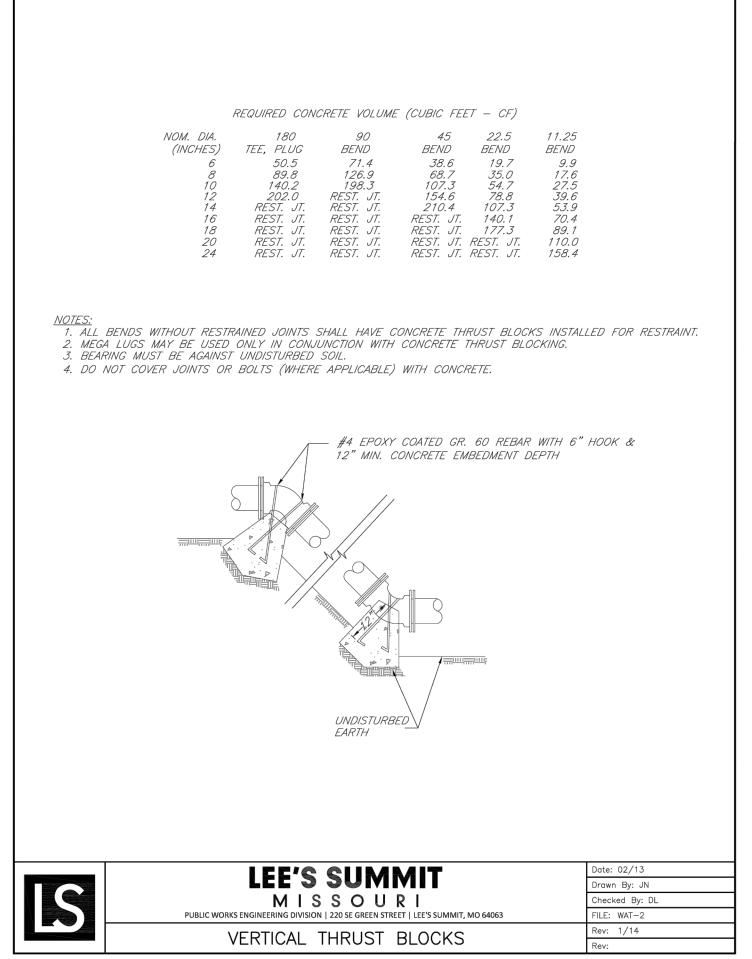

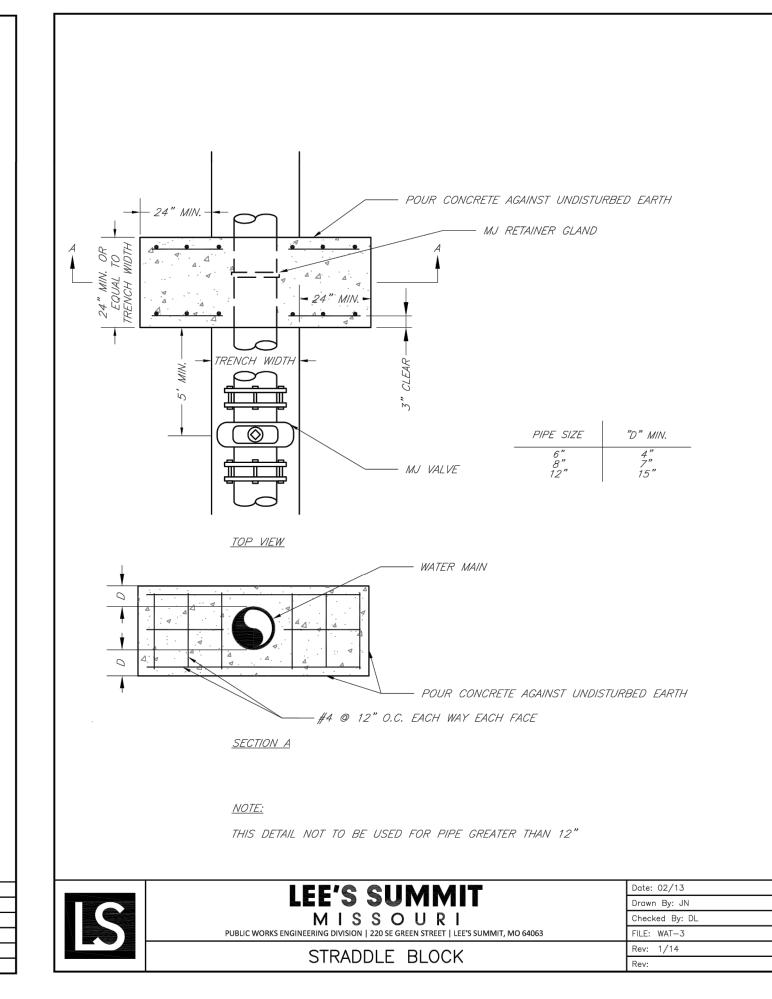


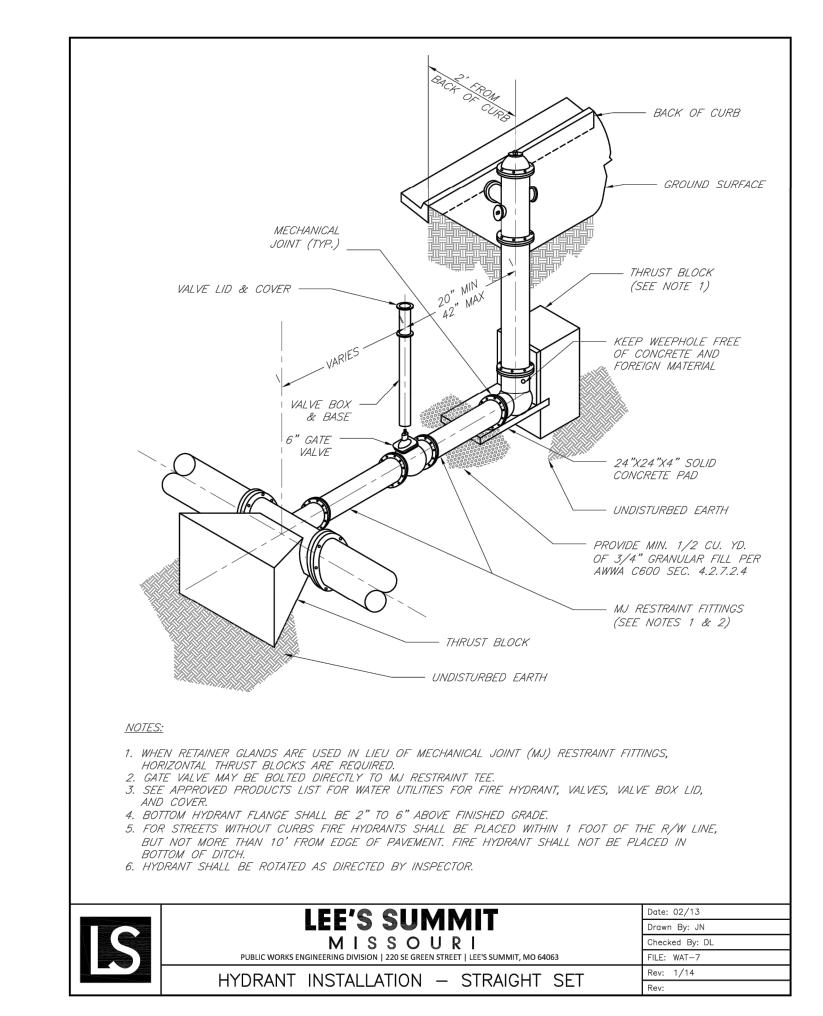

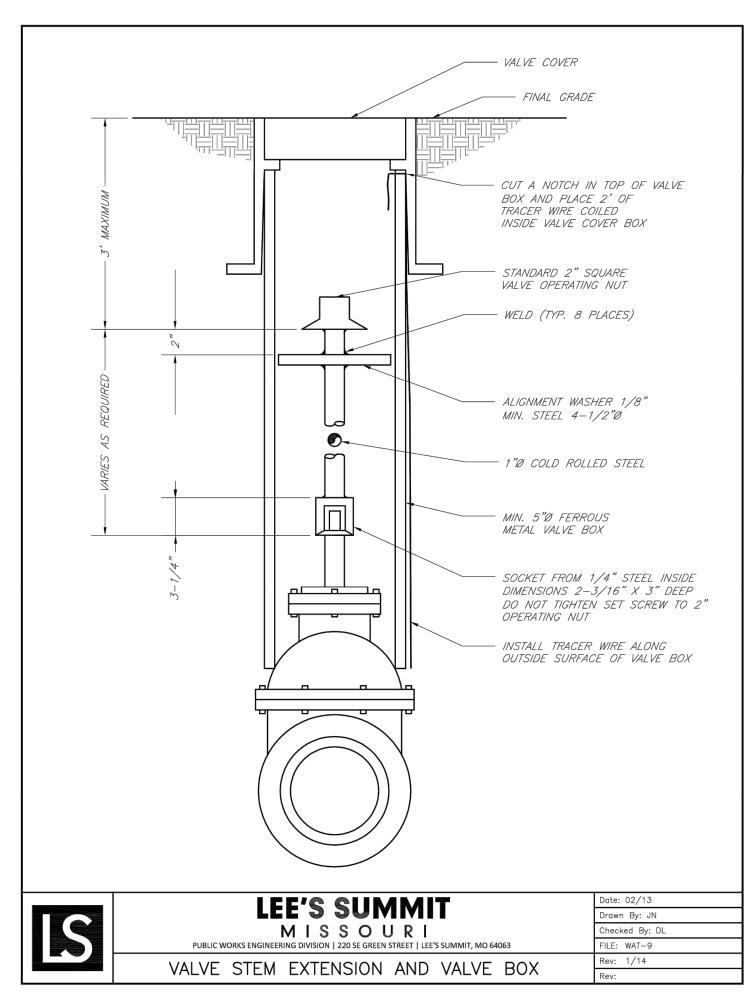

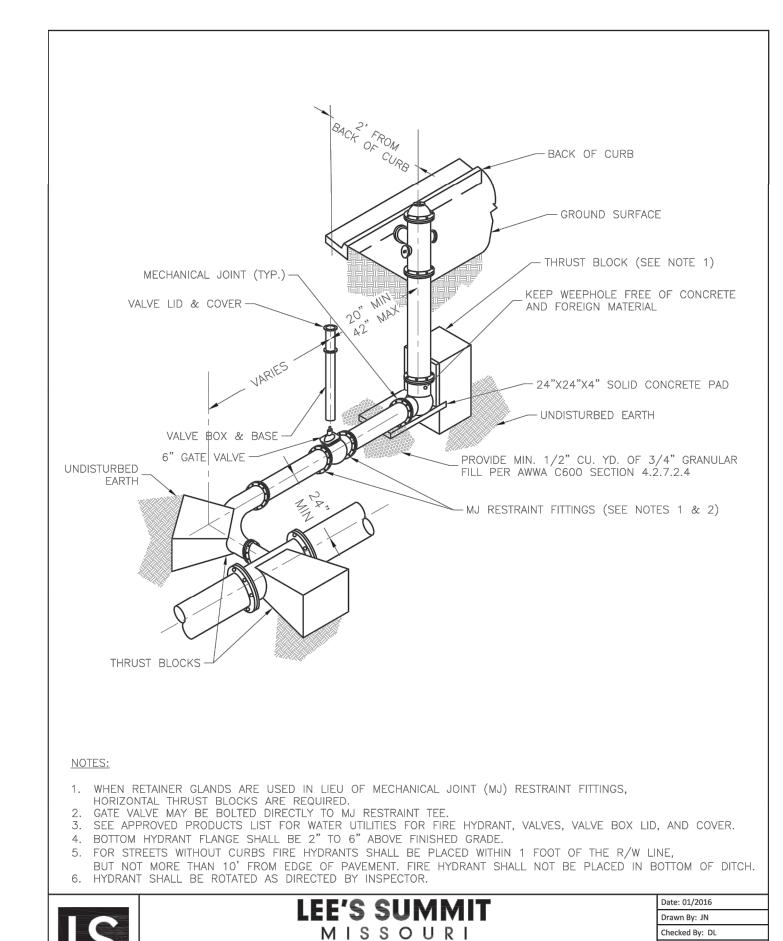

HYDRANT WITH 90 DEGREE BEND

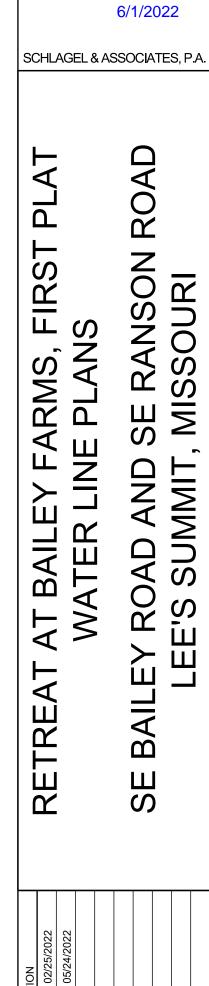

PREPARED BY:

JAMES L.

LONG

| DESCRIPTION | Per City Comments Dated 02/25/2022 | 2 05/31/2022 Per City Comments Dated 05/24/2022 | | | | | | | |
|---------------|------------------------------------|---|---------|-----|----------|----------|-----------|---------|----------|
| REVISION DATE | 1 04/20/2022 | 2 05/31/2022 | /3/ | 4 | \$ | ₩ | \forall | 8 | <u>6</u> |
| WN BY: | : a | 2 | KED BY: | JLL | REPARED. | 9/2022 | 312022 | NUMBER: | -133 |

WATER LINE
DETAILS

SHEET

WAT-8

6