



1 NORTH ELEVATION  
1/4" = 1'-0"

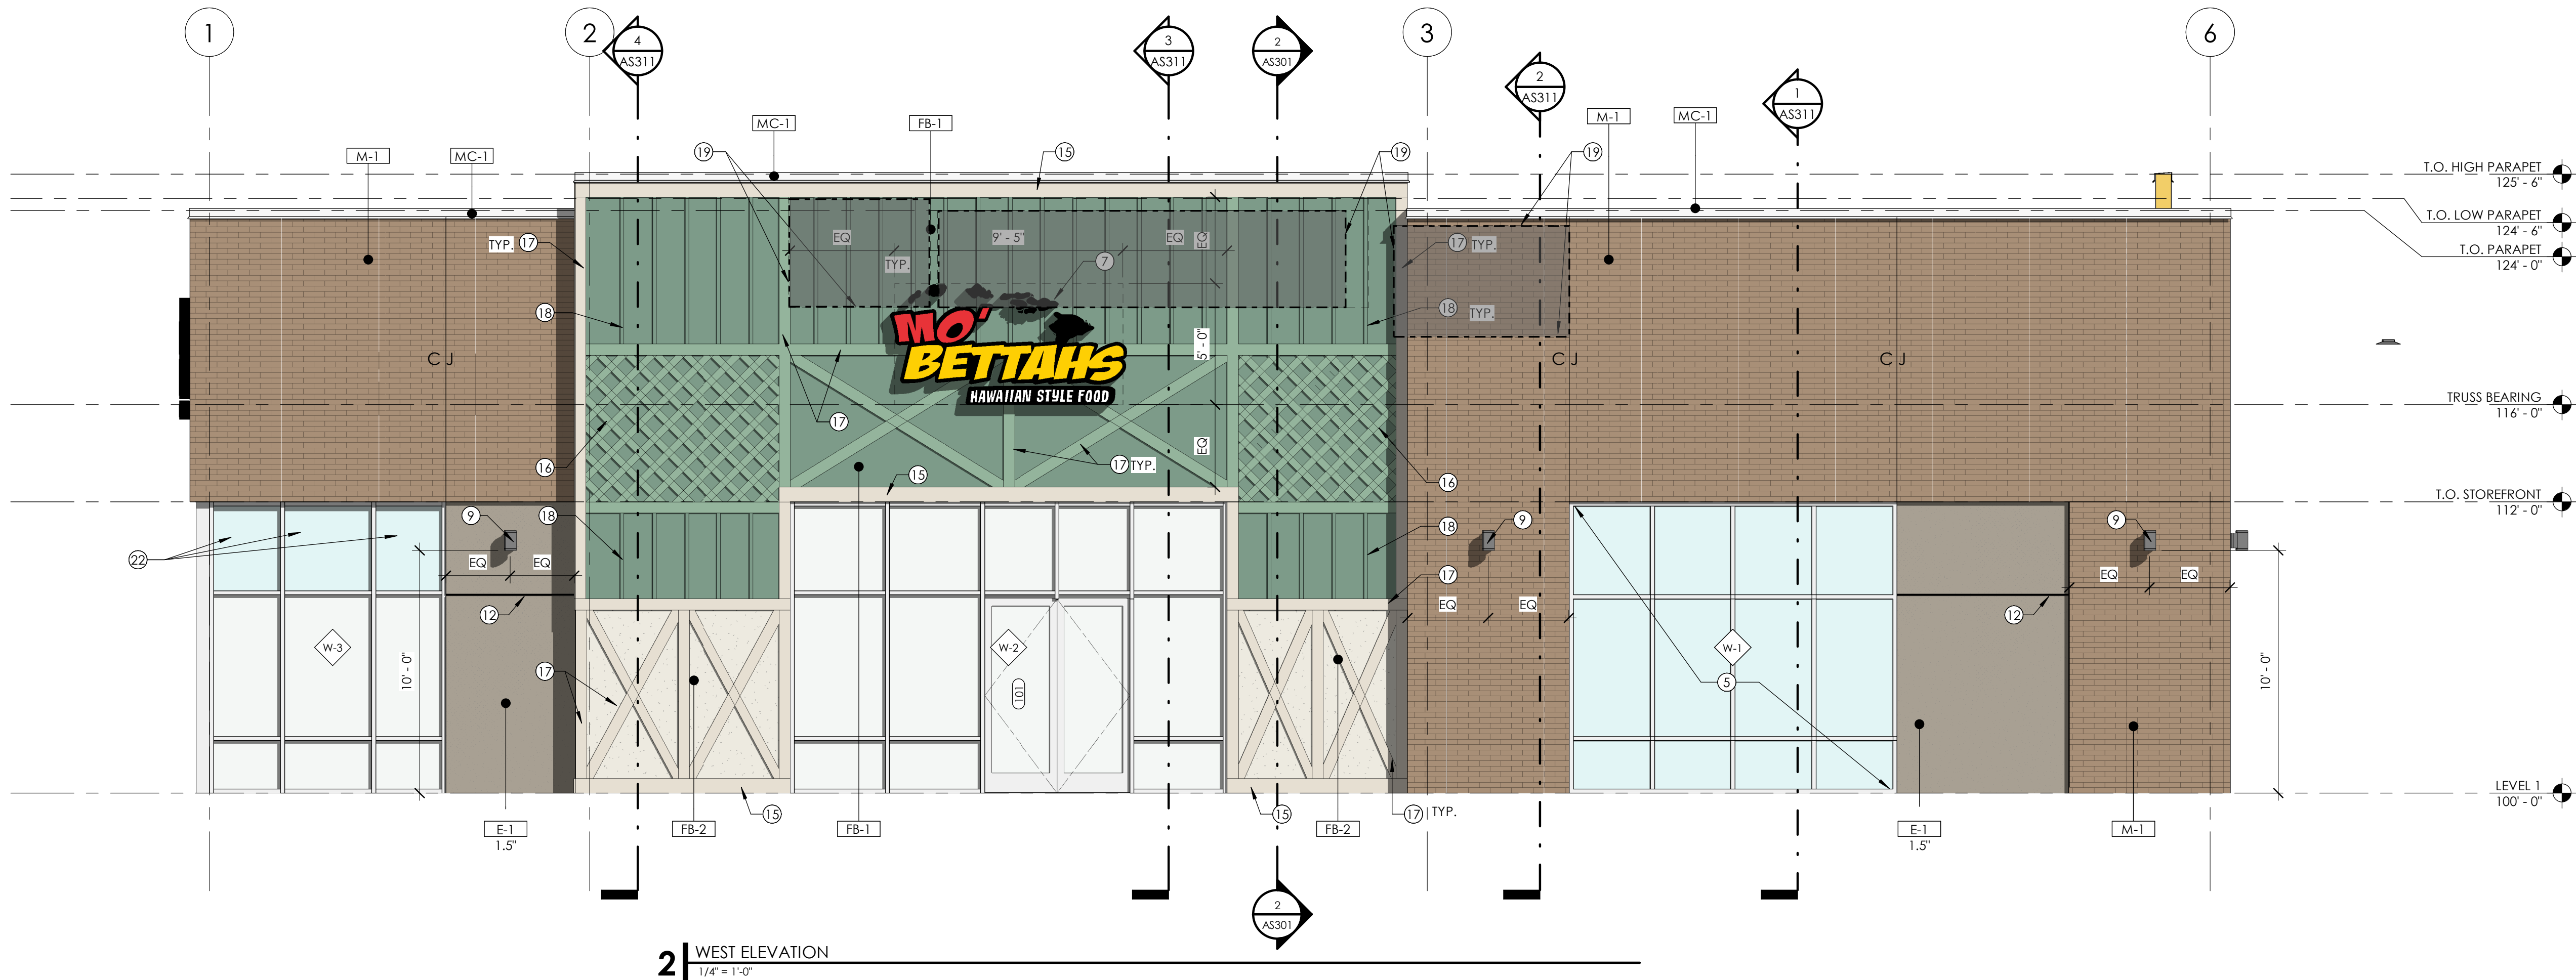

2 WEST ELEVATION  
1/4" = 1'-0"

MATERIAL SCHEDULE						
MARK	DESCRIPTION	MANUFACTURER	PATTERN	COLOR	SIZE	FINISH
AL-1	ALUMINUM STOREFRONT SYSTEM			EXTRA DARK BRONZE	2X4 1/2"	
E-1	EIFS	SHERWIN WILLIAMS		SW 7045 INTELLECTUAL GRAY		
EC-1	EXPOSED CONCRETE FOUNDATION WALL			NATURAL CONCRETE		
FB-1	FIBER CEMENT BOARD	SHERWIN WILLIAMS		SW 9041 PARISIAN PATINA		
FB-2	FIBER CEMENT BOARD	SHERWIN WILLIAMS		SW 7570 EGRET WHITE		
GL-1	1" INSULATED - LOW E - CLEAR GLASS	PPG SOLARBAN 60		CLEAR		
GL-1T	1" INSULATED - LOW E - TEMPERED CLEAR GLASS	PPG SOLARBAN 60		CLEAR		
GL-3	1" INSULATED - TINTED SPANDREL GLASS	PPG SOLARBAN 60		WARM GRAY		
GL-3T	1" INSULATED - TINTED TEMPERED SPANDREL GLASS	PPG SOLARBAN 60		WARM GRAY		
HSS	HOLLOW METAL STEEL			COLOR TO MATCH 7069 IRO ORE		
M-1	BRICK VENEER	AMCOR	1/2 STACKING BOND	TUMBLEWEED	4" X 16"	MASONRY
MC-1	PREFINISHED METAL CAP			COLOR TO MATCH 7069 IRO ORE		
P-2	PAINT	SHERWIN WILLIAMS		SW 7046 ANONYMOUS		
P-3	PAINT	SHERWIN WILLIAMS		COLOR TO MATCH 7069 IRO ORE		
P-4	PAINT	SHERWIN WILLIAMS		SW 9041 PARISIAN PATINA		

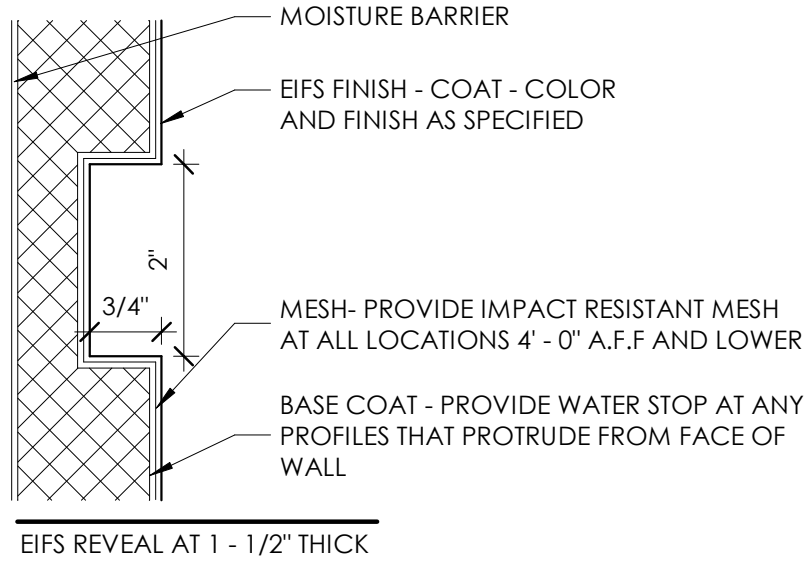


EIFS REVEAL AT 1 - 1/2" THICK.

#### EXTERIOR ELEVATION GENERAL NOTES

1. REFER TO THE MATERIAL AND FINISH SCHEDULES ON SHEET A201 FOR FURTHER INFORMATION.
2. CONTRACTOR TO LEAVE A 1/2" GAP BETWEEN ALL DISSIMILAR MATERIAL TYP. TO BE FILLED WITH BACKER ROD AND SEALANT, COLOR AS SELECTED.
3. ALL EXPOSED EXTERIOR STEEL TO BE PAINTED (I.E. LINTELS, ETC.).
4. CONTRACTOR TO PAINT ALL VENT PIPES, EXHAUST FANS AND OTHER ROOF EQUIPMENT AND PENETRATIONS THAT ARE VISIBLE FROM THE SURROUNDING BUILDING'S STREET FRONTAGE.
5. SEE ELECTRICAL DRAWINGS FOR EXTERIOR POWER LOCATIONS, LIGHTING, HORN STROBES, CARD READERS, ETC.
6. SEE PLUMBING DRAWINGS FOR DOWNSPOUT NOZZLE, HOSE BIB, AND FDC CONNECTION LOCATIONS, ETC.
7. ROOFTOP EQUIPMENT IS SHOWN DASHED.

#### KEYNOTES

- 1 HOSE BIB - COORDINATE WITH MECHANICAL
- 2 PROPOSED LOCATION OF GAS METER - COORDINATE WITH MECHANICAL
- 3 ELECTRICAL GEAR - COORDINATE WITH ELECTRICAL
- 4 LOCKABLE EXTERIOR ROOF ACCESS LADDER - SEE DETAILS
- 5 2 X 2 - 1/4" DEEP VENEER GLAZING FRAME
- 6 ROOF DRAINS - COORDINATE WITH MECHANICAL
- 7 NEW BUILDING SIGNAGE
- 8 WELDED STEEL CANOPY STRUCTURE (PAINTED) W/ PREFINISHED 1" CORRUGATED METAL ROOF (WAVE PANEL).
- 9 WALL MOUNTED LIGHTING - COORDINATE WITH ELECTRICAL
- 10 LIGHTING MOUNTED WITHIN CANOPY FRAMING - COORDINATE WITH ELECTRICAL
- 11 BRICK CONTROL JOINT - COORDINATE WITH STRUCTURAL
- 12 EIFS REVEAL - SEE DETAIL
- 13 DASHED LINE INDICATES EQUIPMENT ON ROOF BEYOND - COORDINATE WITH MECHANICAL
- 14 ALL FIBER BOARD TRIM TO BE 1X6 UNLESS NOTED OTHERWISE
- 15 1X8 FIBER BOARD TRIM
- 16 1X4 FIBER BOARD MESH TRIM @ 45° ANGLE WITH 10" O.C.
- 17 1X6 FIBER BOARD TRIM TYPICAL
- 18 VERTICAL 1.75" X 3/4" FIBER BOARD TRIM @ 16" O.C.
- 19 DASHED LINE INDICATES EQUIPMENT ON ROOF BEYOND - COORDINATE WITH MECHANICAL
- 20 STEEL TO BE PAINTED IRON ORE
- 21 CORRUGATED METAL ROOF; COLOR TO MATCH PARISIAN PATIAN
- 22 VENEER GLAZING PANEL

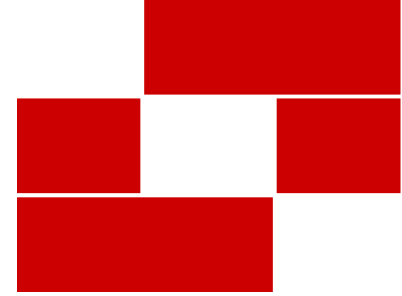

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sheet information:

revisions: 

num. description date

date: 01-17-2022

project number: MO-53LEE

project status: ISSUED FOR PERMIT

original drawing is 24" x 36"


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project information:

MO-53 LEE - LEE'S SUMMIT  
for:  
MOBETTAH'S (SHELL)  
NORTHWEST CHIPMAN ROAD &  
NORTHWEST WARD ROAD  
LEE'S SUMMIT, MO, USA

RELEASED FOR  
CONSTRUCTION  
As Noted on Plans Review  
Development Services Department  
Lee's Summit, Missouri  
05/31/2022

sheet number:

AS201

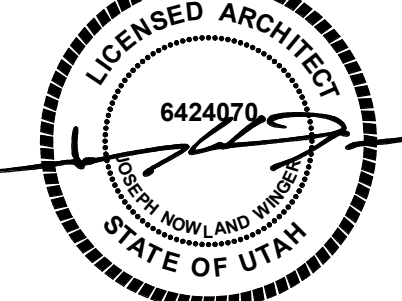EXTERIOR ELEVATIONS

sheet title:




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						PROVIDE PLASTER FINISH AT ALL EXPOSED CONCRETE FOUNDATION WALLS
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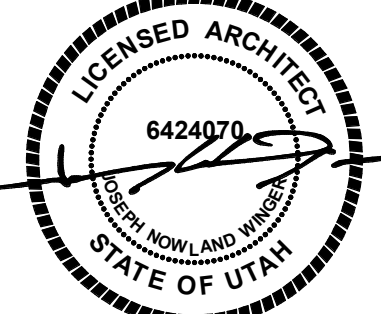
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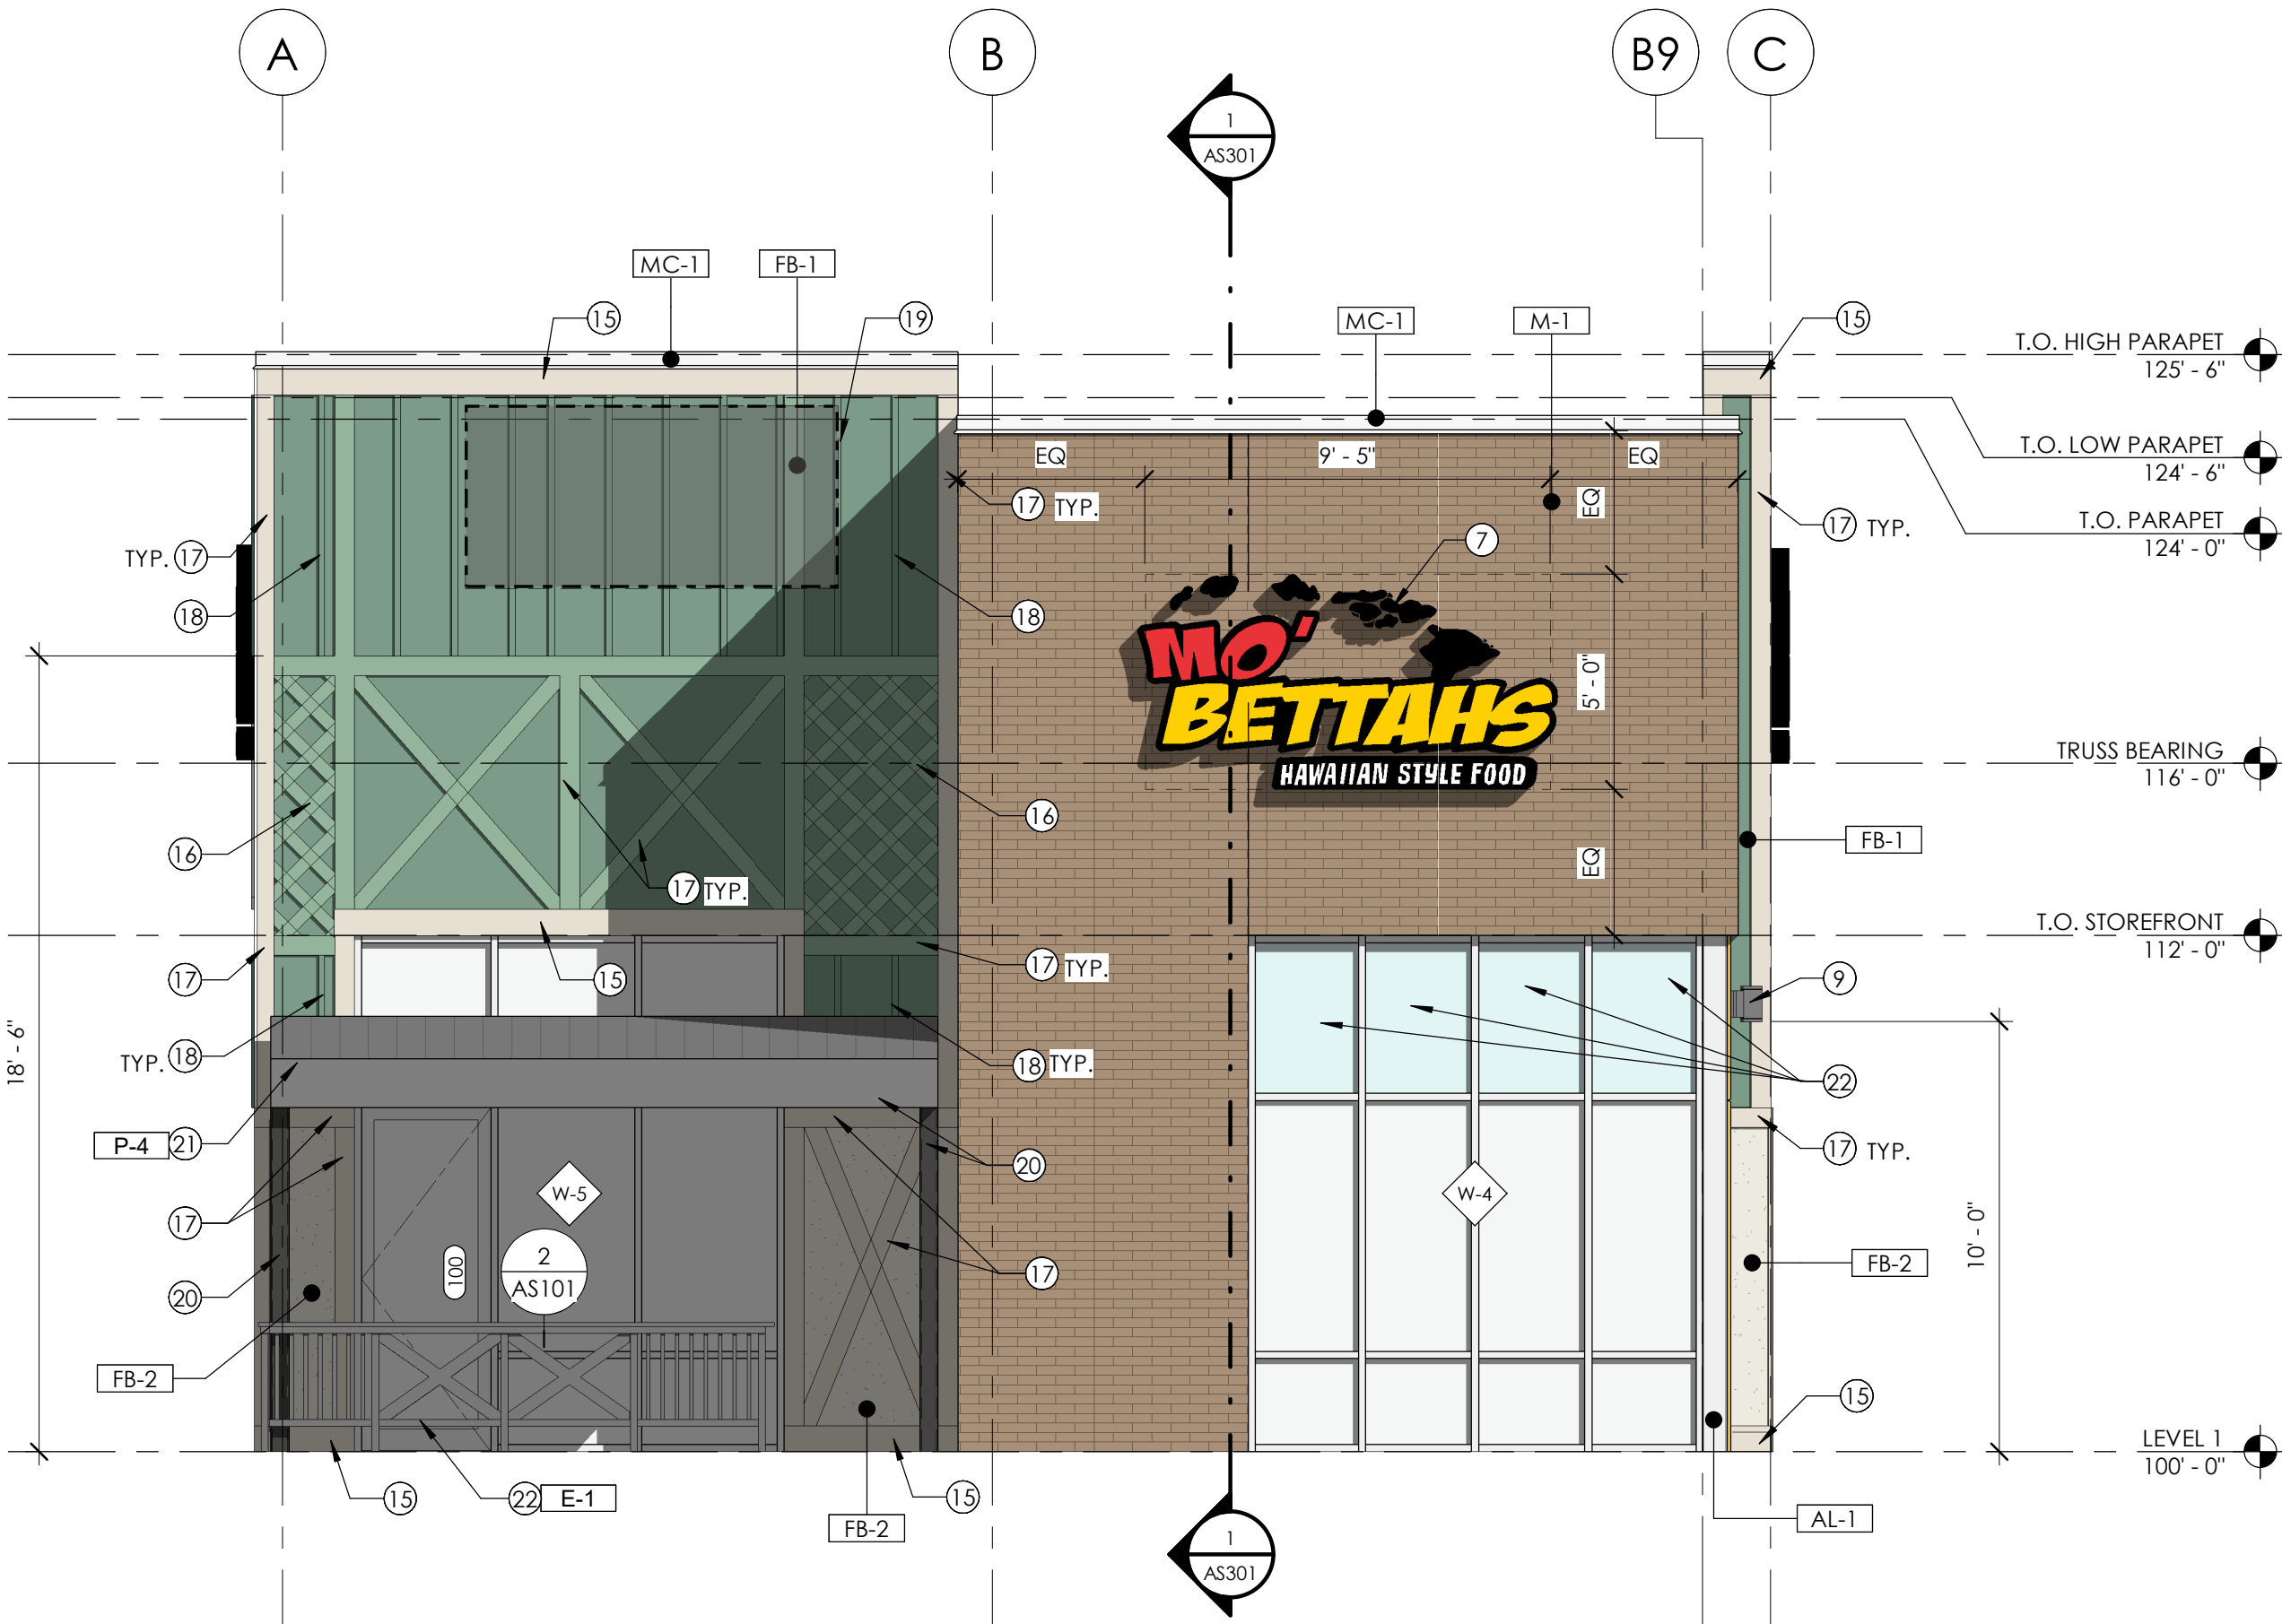
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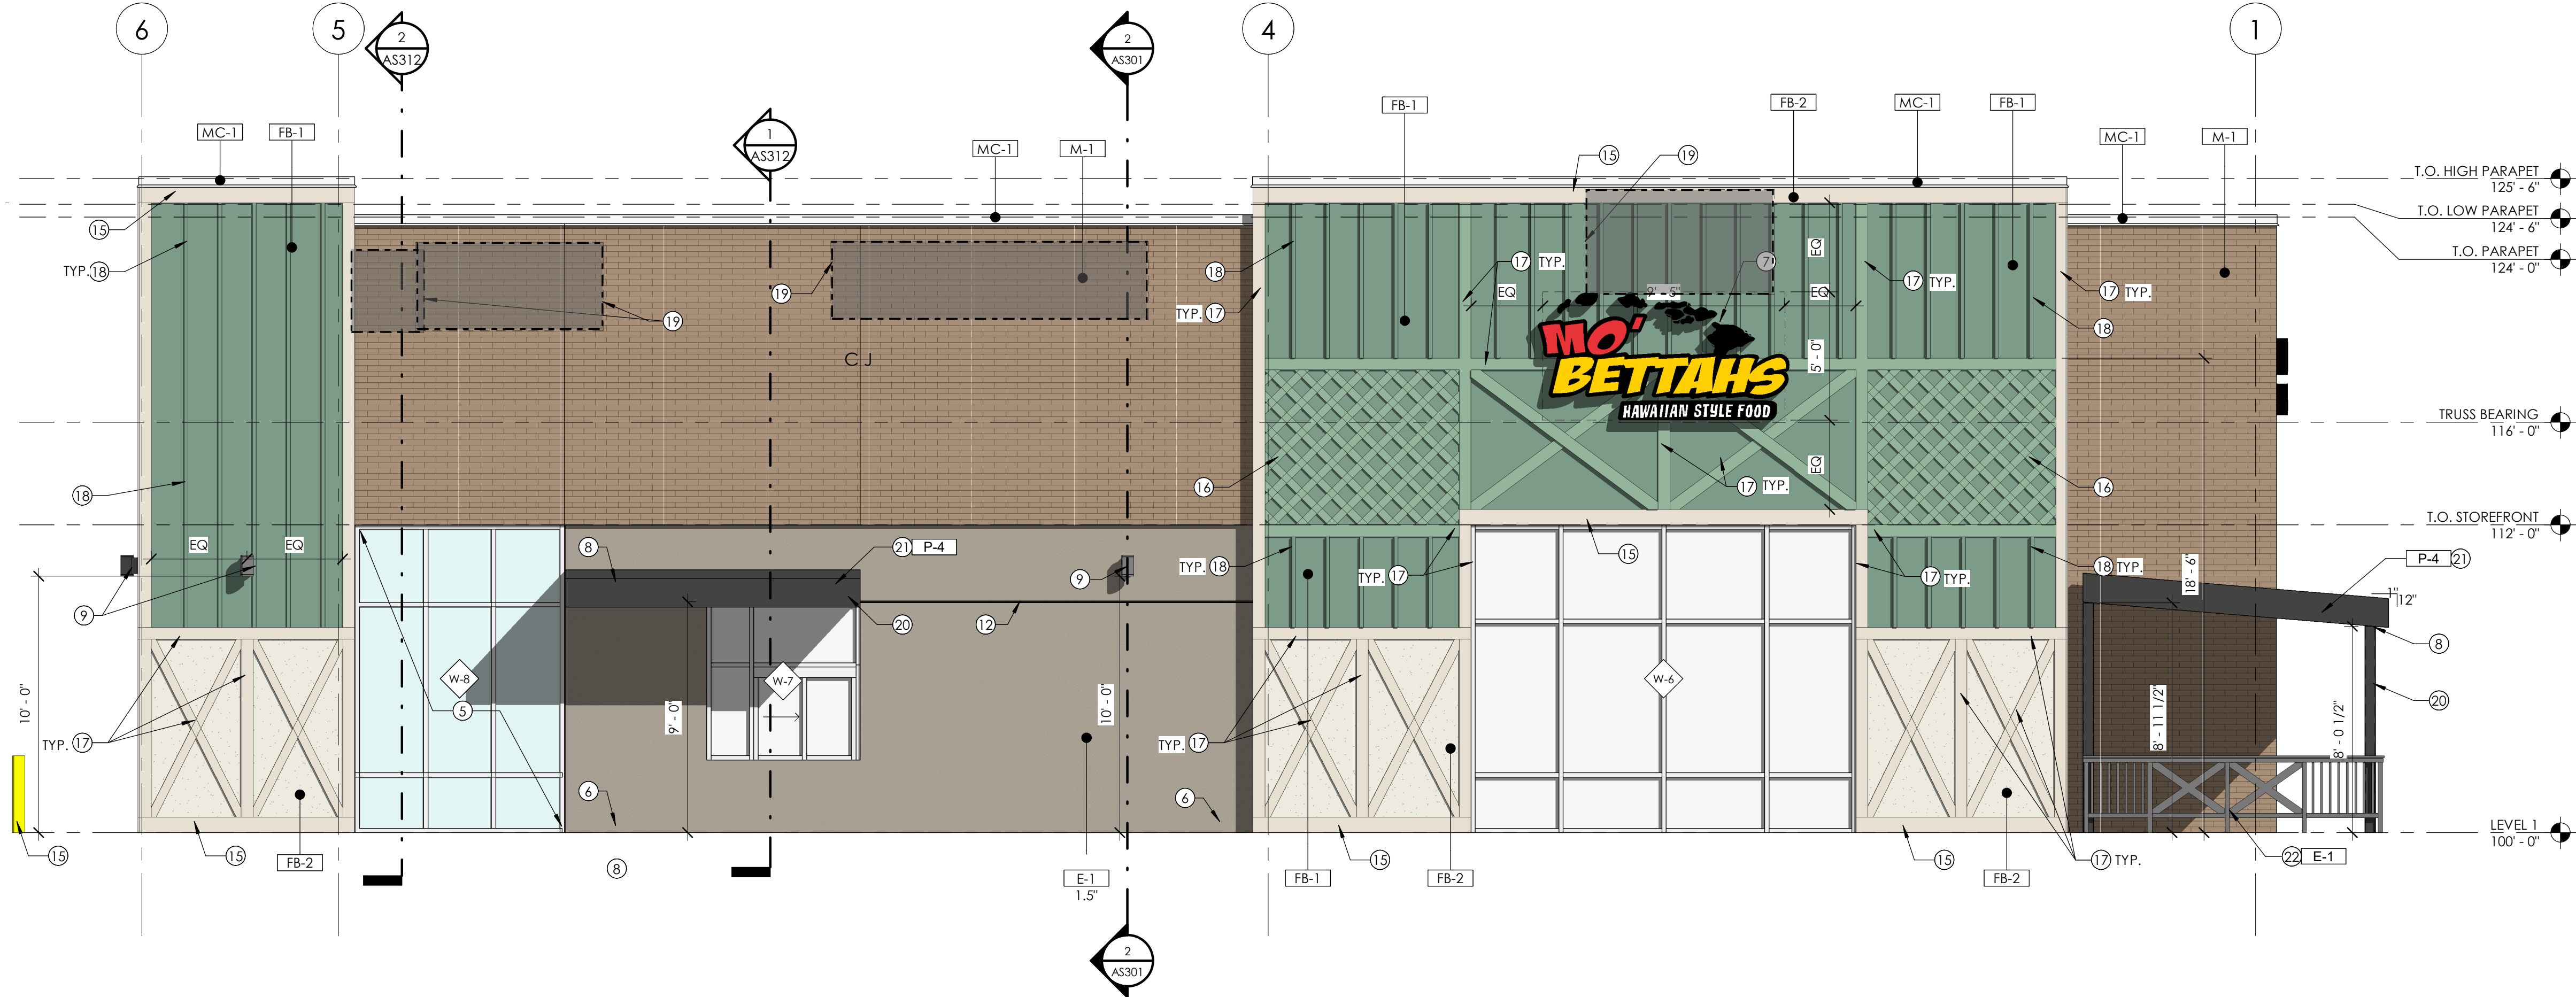
sheet number:

AS202

RELEASED FOR  
CONSTRUCTION  
As Noted/Means Review  
Development Services Department  
Lee's Summit, Missouri  
05/31/2022



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1/4" = 1'-0"

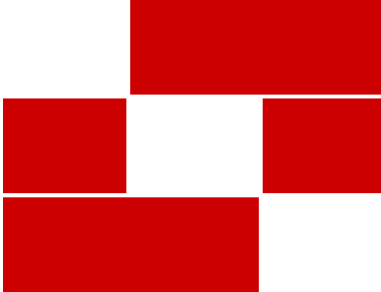

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1/4" = 1'-0"