

# **INDEX OF SHEETS**

### **GENERAL PLANS**

- COVER SHEET
- EXISTING CONDITIONS

### SITE PLANS

- SITE DIMENSION PLAN
- SITE GRADING PLAN

### STORM SEWER PLAN AND PROFILE

5. STORM SEWER PLAN AND PROFILE

# STORM DRAINAGE MAPS

- EXISITNG CONDITIONS DRAINAGE AREA MAP
- POST DEVELOPMENT DRAINAGE AREA MAP

### **EROSION CONTROL PLAN**

EROSION CONTROL PLAN

### SITE UTILITY PLAN

9. SITE UTILITY PLAN

## SITE DETAILS

10. MISCELLANEOUS SITE DETAILS

### SITE LANDSCAPE PLAN

11. LANDSCAPE PLAN

### SITE LIGHTING AND PHOTOMETRIC PLANS

### PROJECT BENCHMARKS:

#1 NORTHEAST CORNER EXISTING CURB INLET APPROX. 65 FEET WEST OF NW DONOVAN ROAD ON THE "SOUTH SIDE OF PRIVATE ROAD NORTH OF SUBJECT PROPERTY.

E: 2819988.72 TOP ELEV. 1000.51

TOP ELEV. 1005.47

#2 CENTER OF EXISTING STORM SEWER MANHOLE APPROX. 100 FEET NORTH OF NW CHIPMAN ROAD AND APPROX. 160 FEET WEST OF NW DONOVAN ROAD. SAID MANHOLE IS LOCATED ON SUBJECT PROPERTY. E: 2819958.44

### UTILITIES

City of Lee's Summit Public Works 220 SE Green Street Lee's Summit, MO 64063 (816) 969-1800

City of Lee's Summit Water and Sewer 1200 S.E. Hamblen Road Lee's Summit, MO 64081 (816) 969-1900

Spire Gas

Evergy 401 SE Bailey Road Lee's Summit, MO. 64081 (816) 347-4316


500 E. 8th Street Kansas City, MO 64106 (816) 275-2721 Contact: Mr. Craig Perkins

Missouri One-Call 1-800-344-7483

Lee's Summit Fire Department 207 S.E. Douglas Street Lee's Summit, MO 64063 (816) 969-7360

# 400 N.W. CHIPMAN ROAD

CITY OF LEE'S SUMMIT, JACKSON COUNTY, MISSOURI FINAL DEVELOPMENT PLANS MEDICAL OFFICE / DRIVE-THRU RESTAURANT

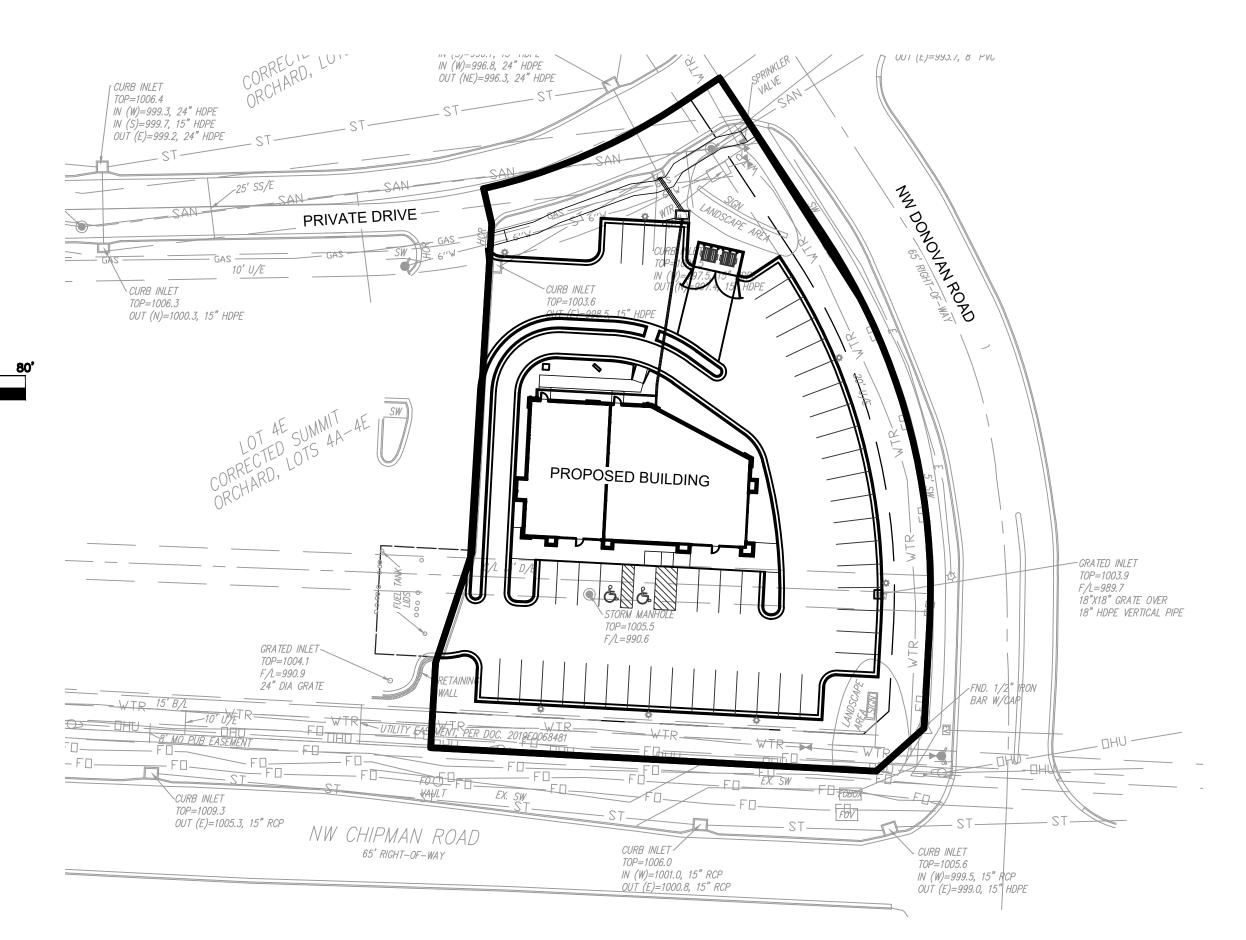

1. According to the F.E.MA. Flood Insurance Rate Map Number 29095C0417G, Revised January 20, 2017, this tract graphically lies in OTHER AREAS, ZONE X, defined as areas determined to be outside of 0.2% annual chance floodplain. No Base flood elevations have been determined.

### PROPERTY DESCRIPTION:

LOT 4E-2, SUMMIT ORCHARD MINOR PLAT, LOTS 4E-1 and 4E-2, a subdivision no in the City of Lee's Summit, Jackson County, Missouri. Containing 45,068 square feet or 1.035 acres, more or less.

### **GENERAL NOTES:**

- 1. The underground utilities shown herein have been plotted from available information and do not necessarily reflect the actual existence, or nonexistence, size, type, number, or locations of these or other utilities. The contractor shall be responsible for verifying the actual locations of all underground utilities, shown or not shown, and said utilities shall be located in the field prior to any grading, excavation, or construction of improvements. These provisions shall in now way absolve any party from complying with the "UNDERGROUND FACILITY SAFETY AND DAMAGE PREVENTION ACT". Chapter 319. RSMO.
- Gas, Water, and other Utilities shall not conflict with the depth or horizontal location of existing and proposed sanitary and storm sewers, including building laterals.
- Prior to submittal of construction bids, the Contractor shall be required to visit the site to verify existing
- The Contractor shall be responsible for notification and coordination with all Utility Companies.
- The Contractor shall notify the Engineer immediately of any discrepancies in the plans.
- All sidewalk shall be ADA compliant
- All curb shall be CG-1 unless otherwise noted.
- 8. There are no oil or gas wells located on the subject property as of October 23, 2019 as shown by the Missouri Geological Survey GEOSTRAT (Geosciences Technical Resource Assessment Tool).

FINAL DEVELOPMENT PLANS SHEE

22-011 Base DRAWING NO. 22-011 FDPs April 8, 2022 **VICINITY MAP** 22-011 SHEET OF

MED

**DEVELOPER** 

(951) 905-1543 **CONTACT - JULIE MARGETICH** 

(816) 703-7098 **CONTACT - KEVIN STERRETT** 

Know what's below. Call before you dig.

3025 S.E. Clover Drive Lee's Summit, MO 64082 (816) 400-3327Contact: Mr. Dorsey Troutman

Comcast Cable New Construction Hotline (866) 771-2281


COVENANT REAL ESTATE GROUP 2044 CALIFORNIA AVENUE CORONA, CA. 92881


Hg CONSULT, INC. 1411 NE TODD GEORGE RD. LEE'S SUMMIT, MISSOURI 64086


Prepared: April 1, 2022


NOT TO SCALE


**ENGINEER** 

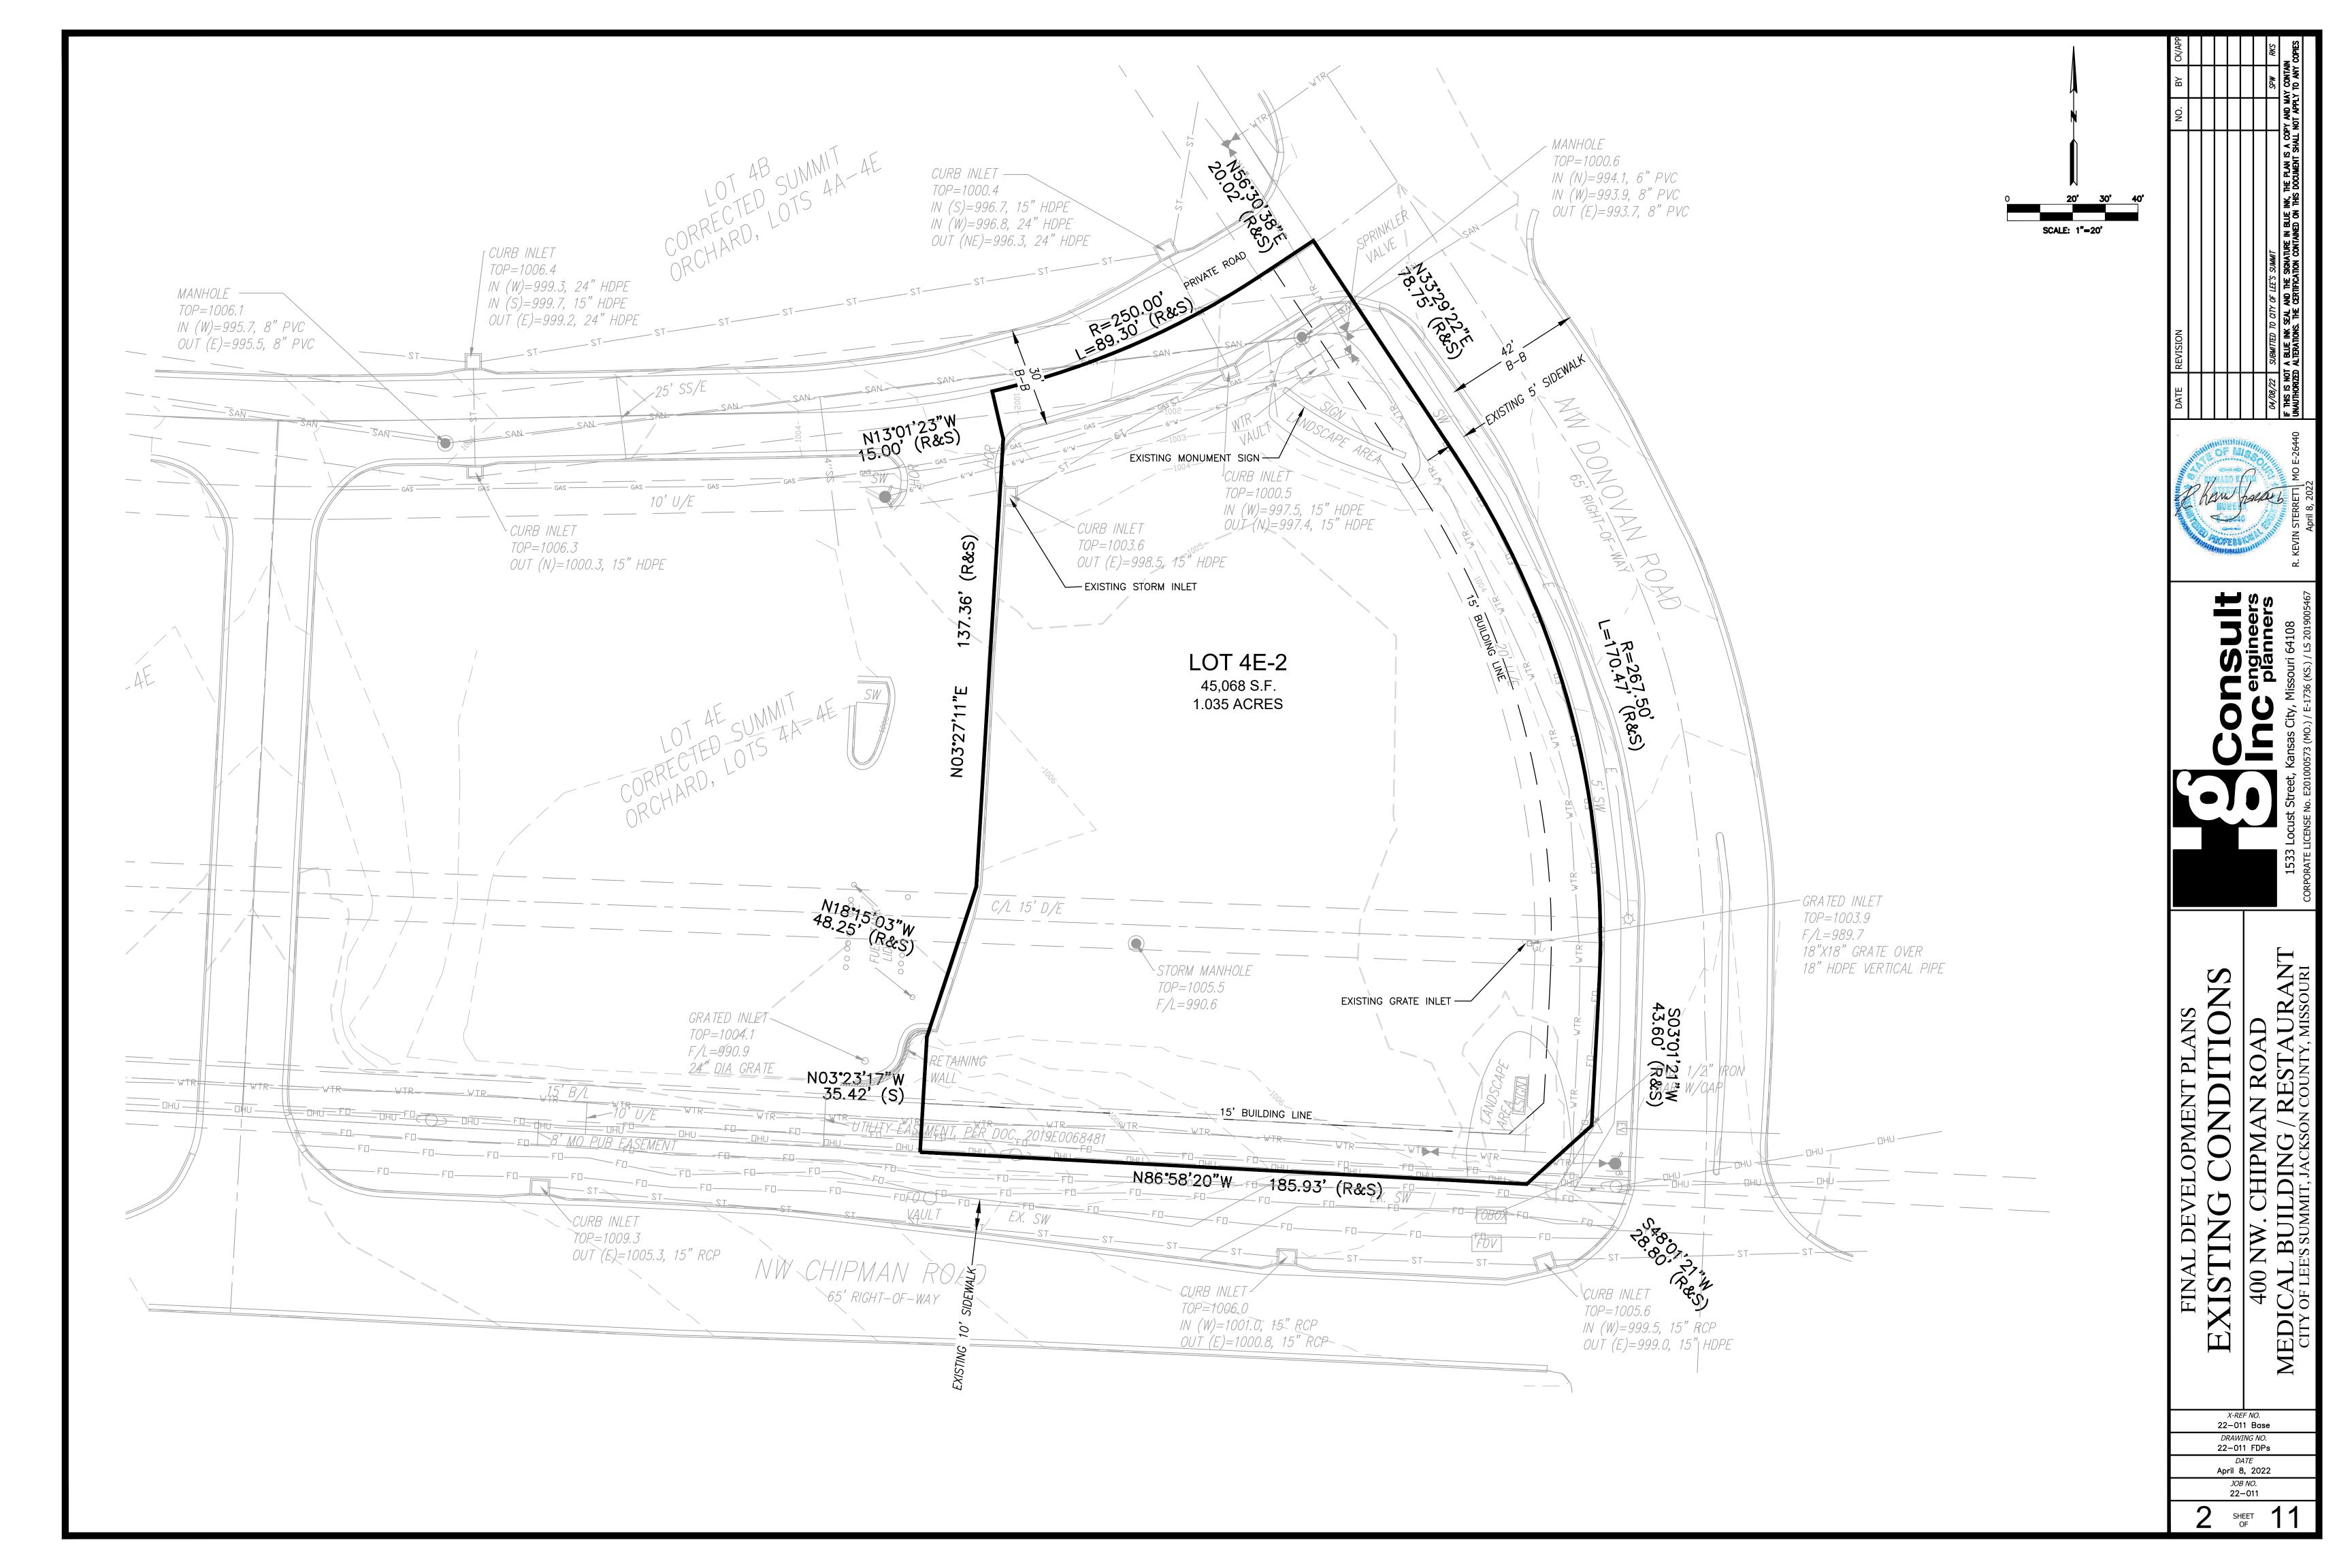


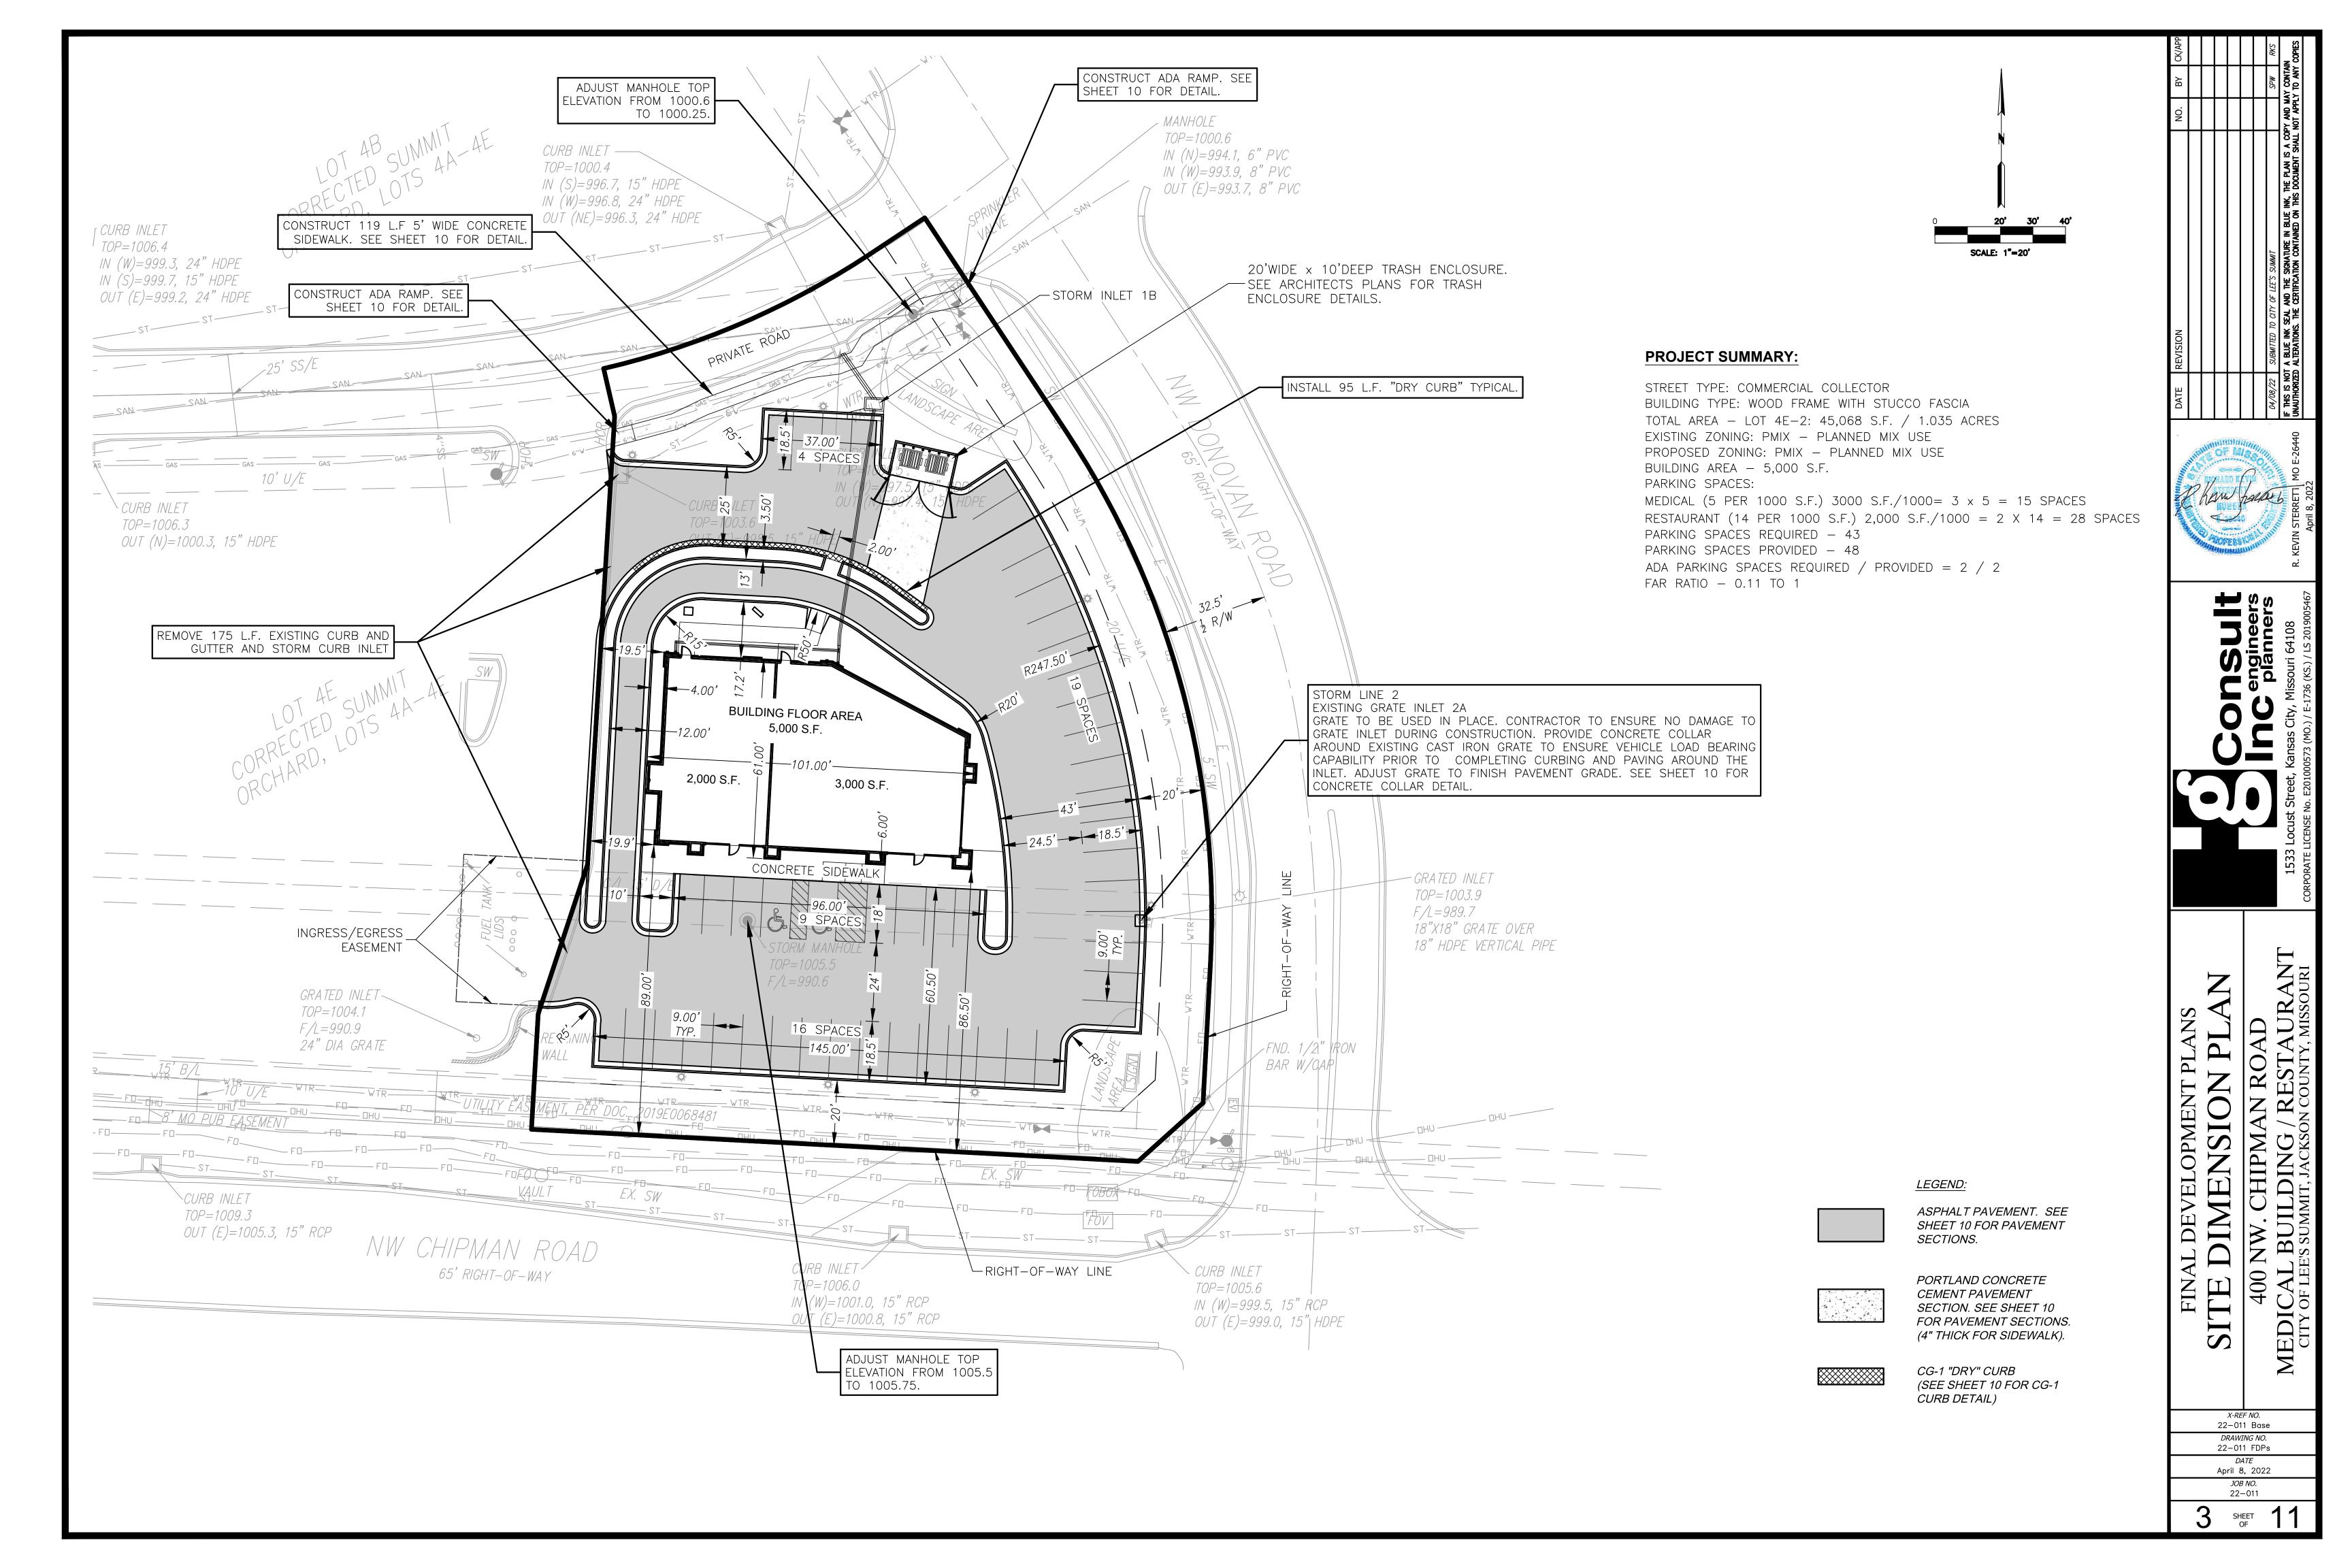


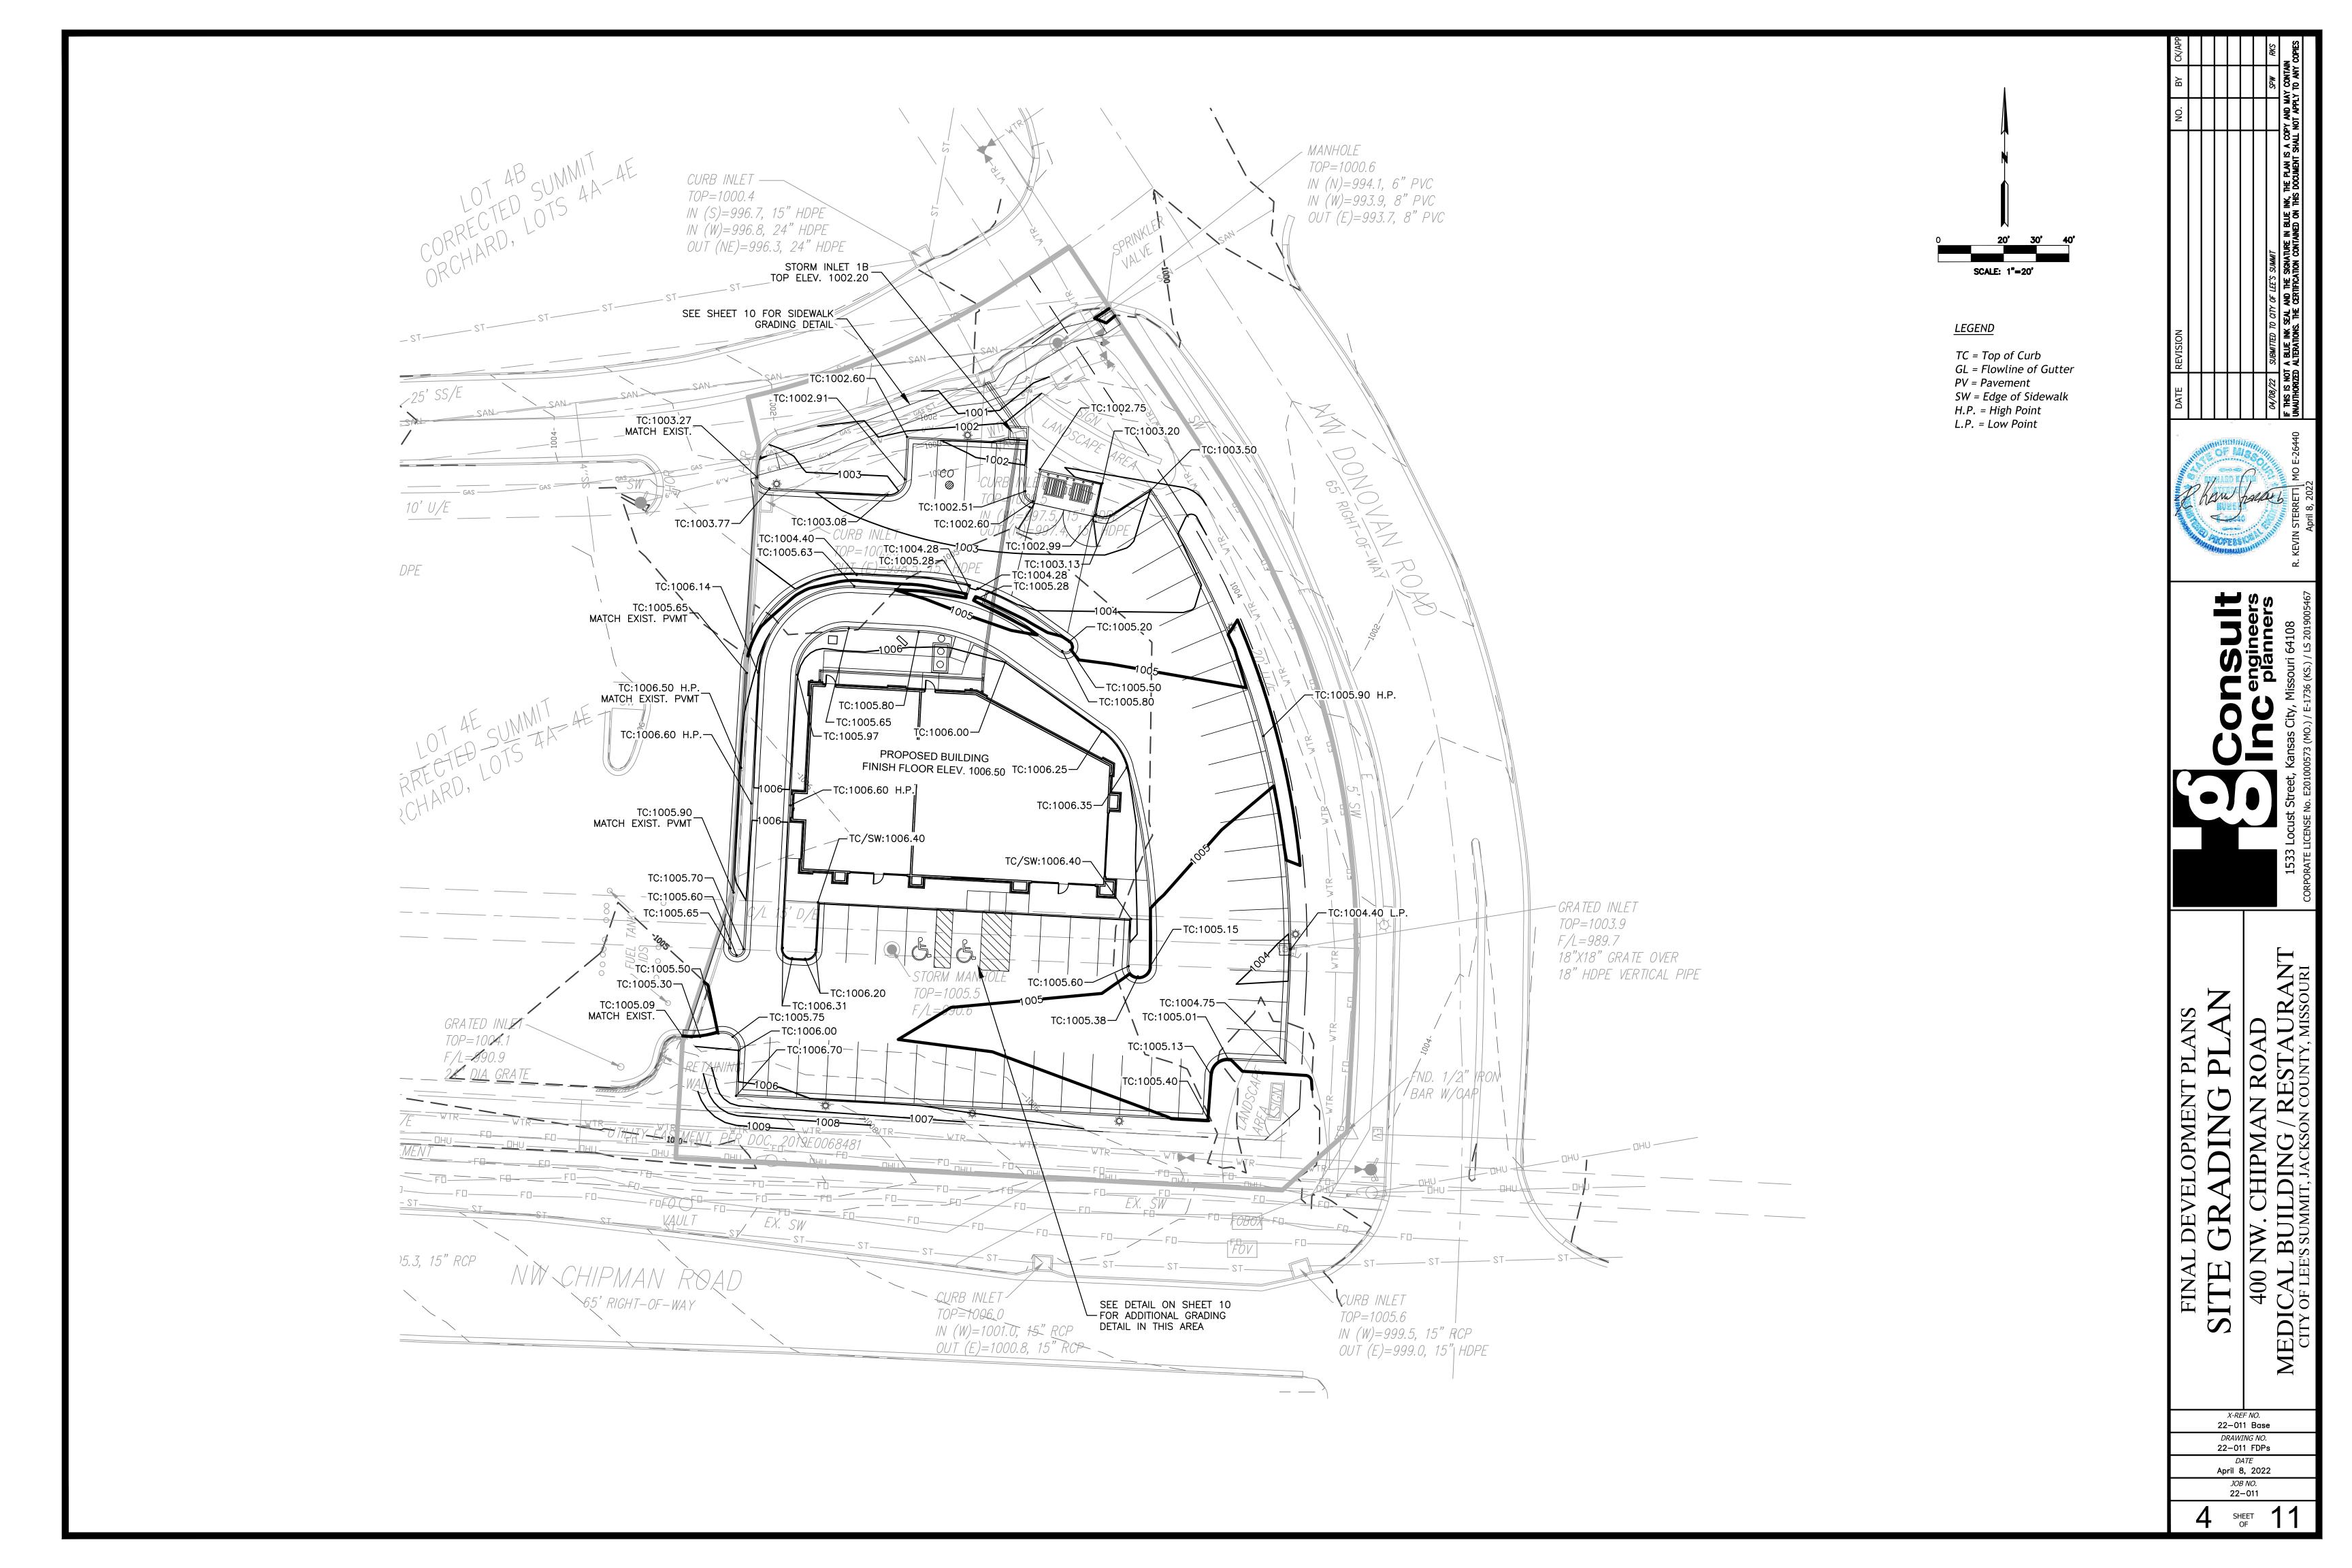

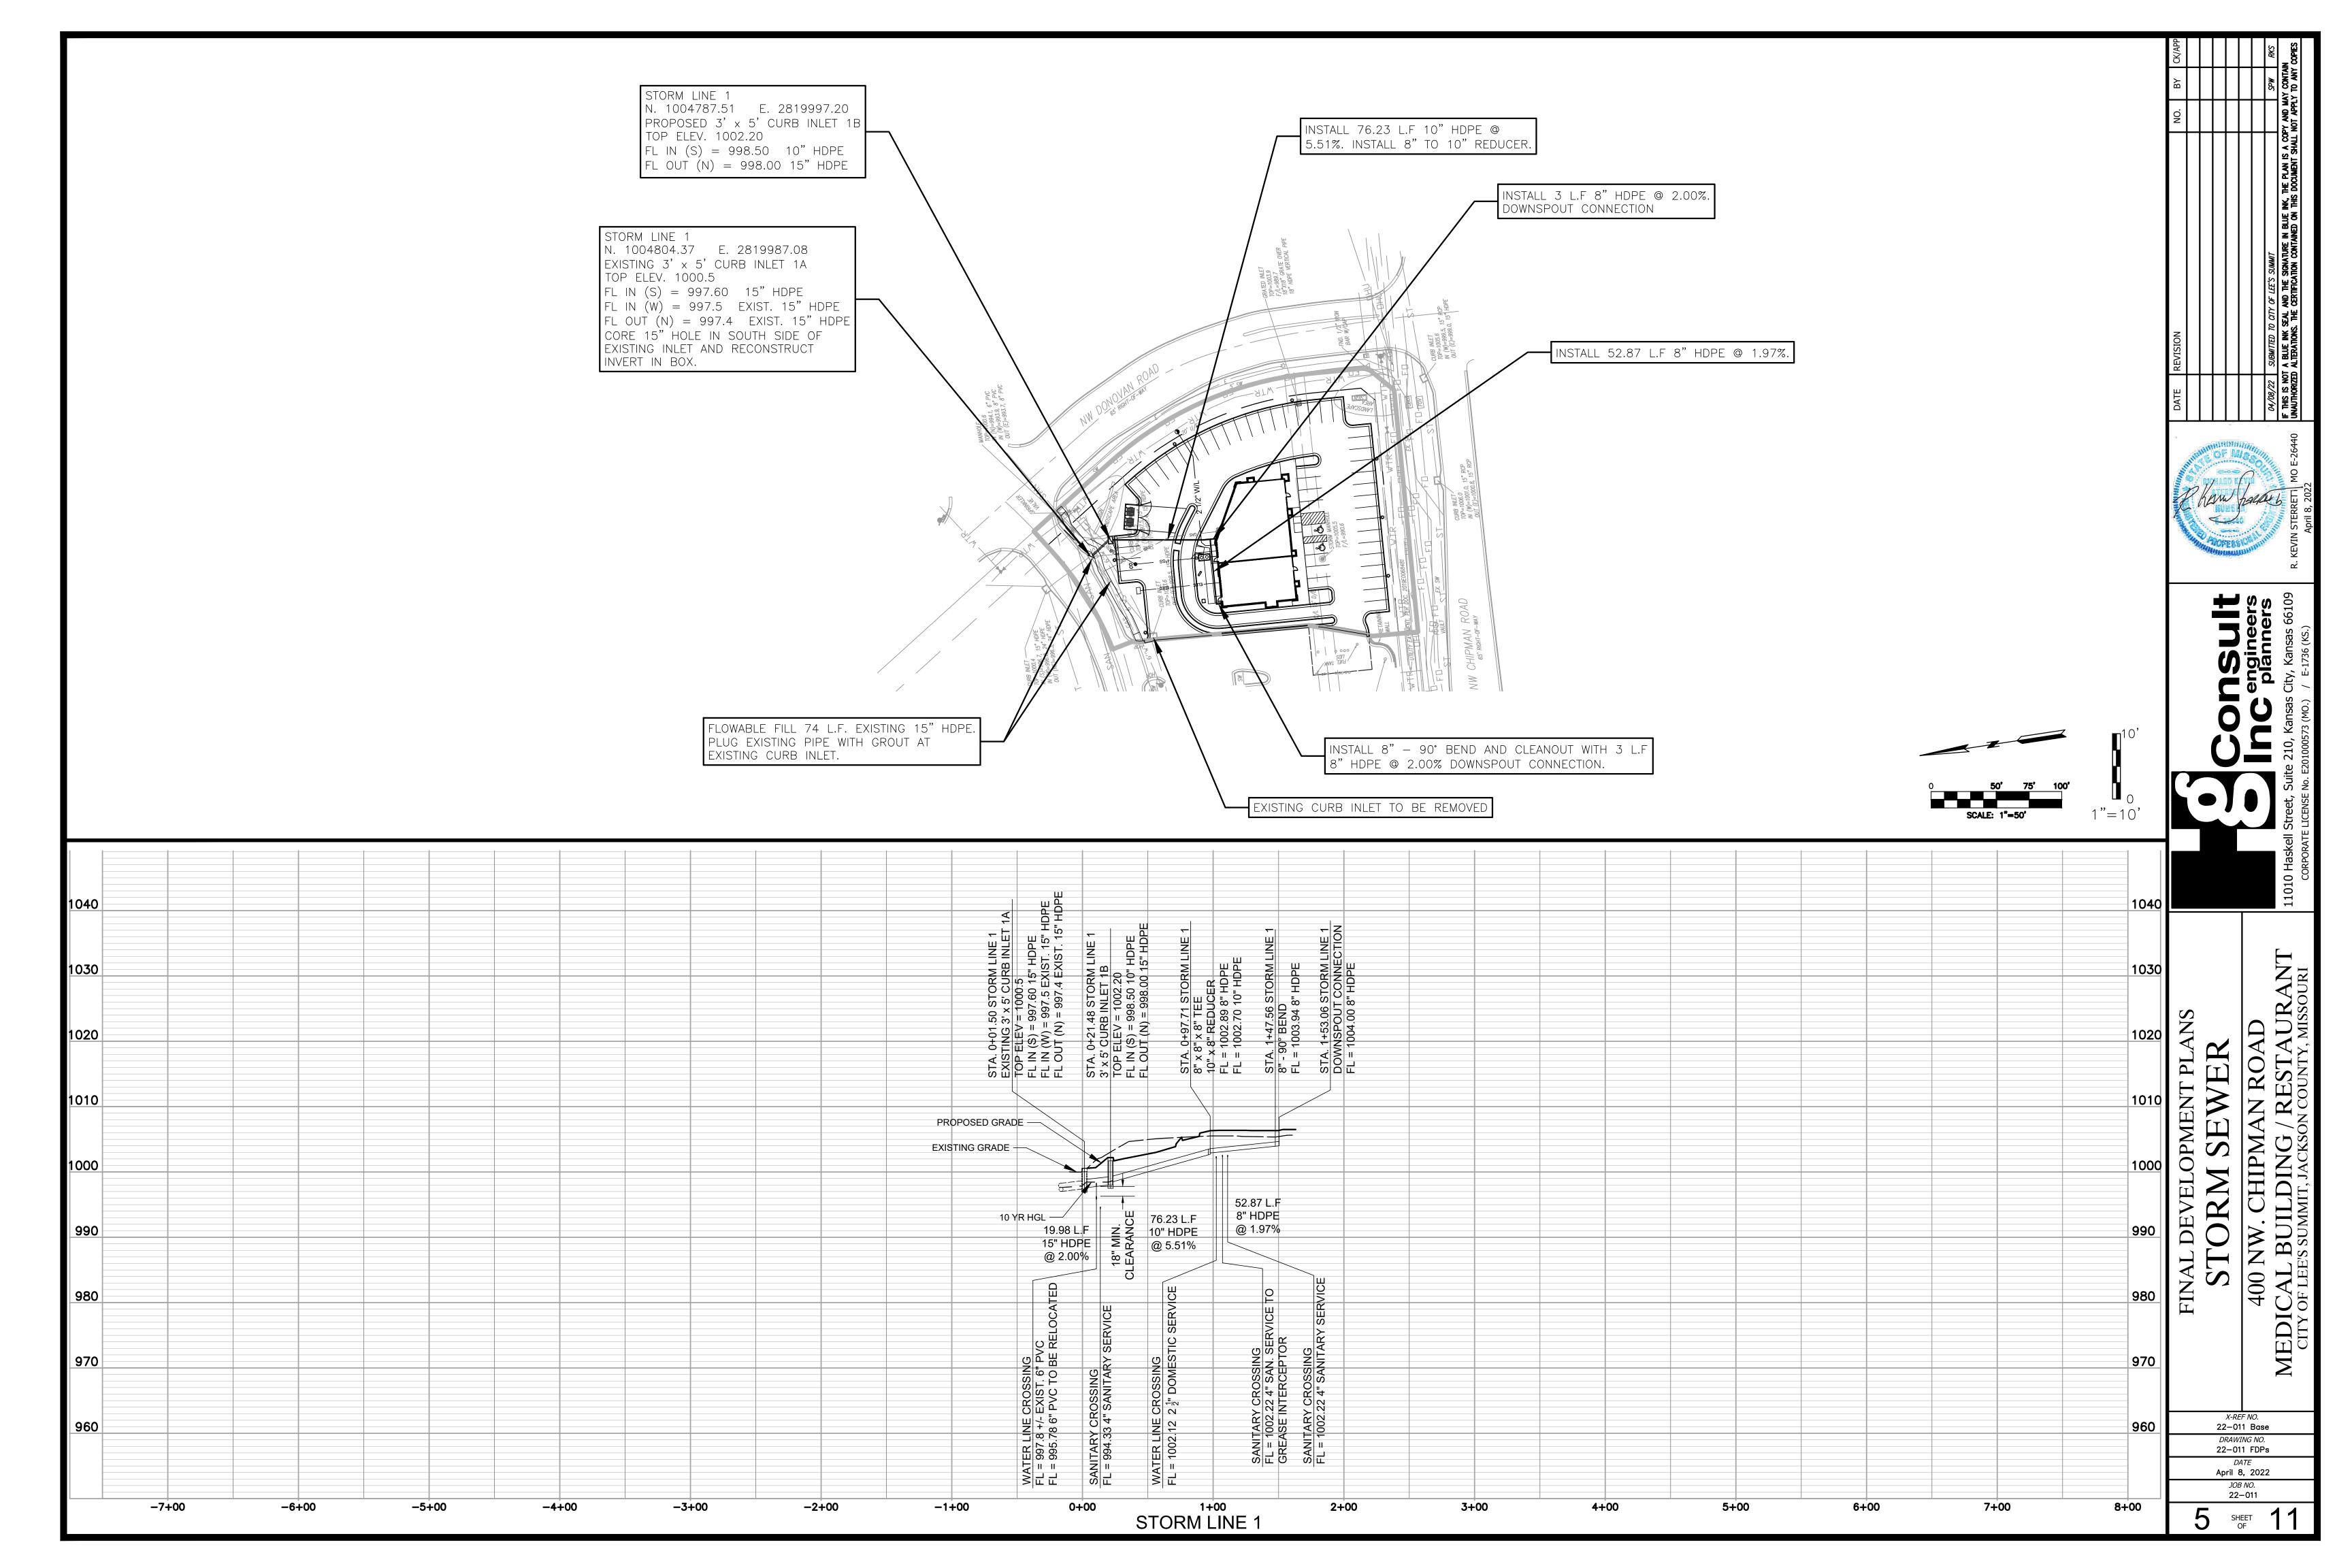

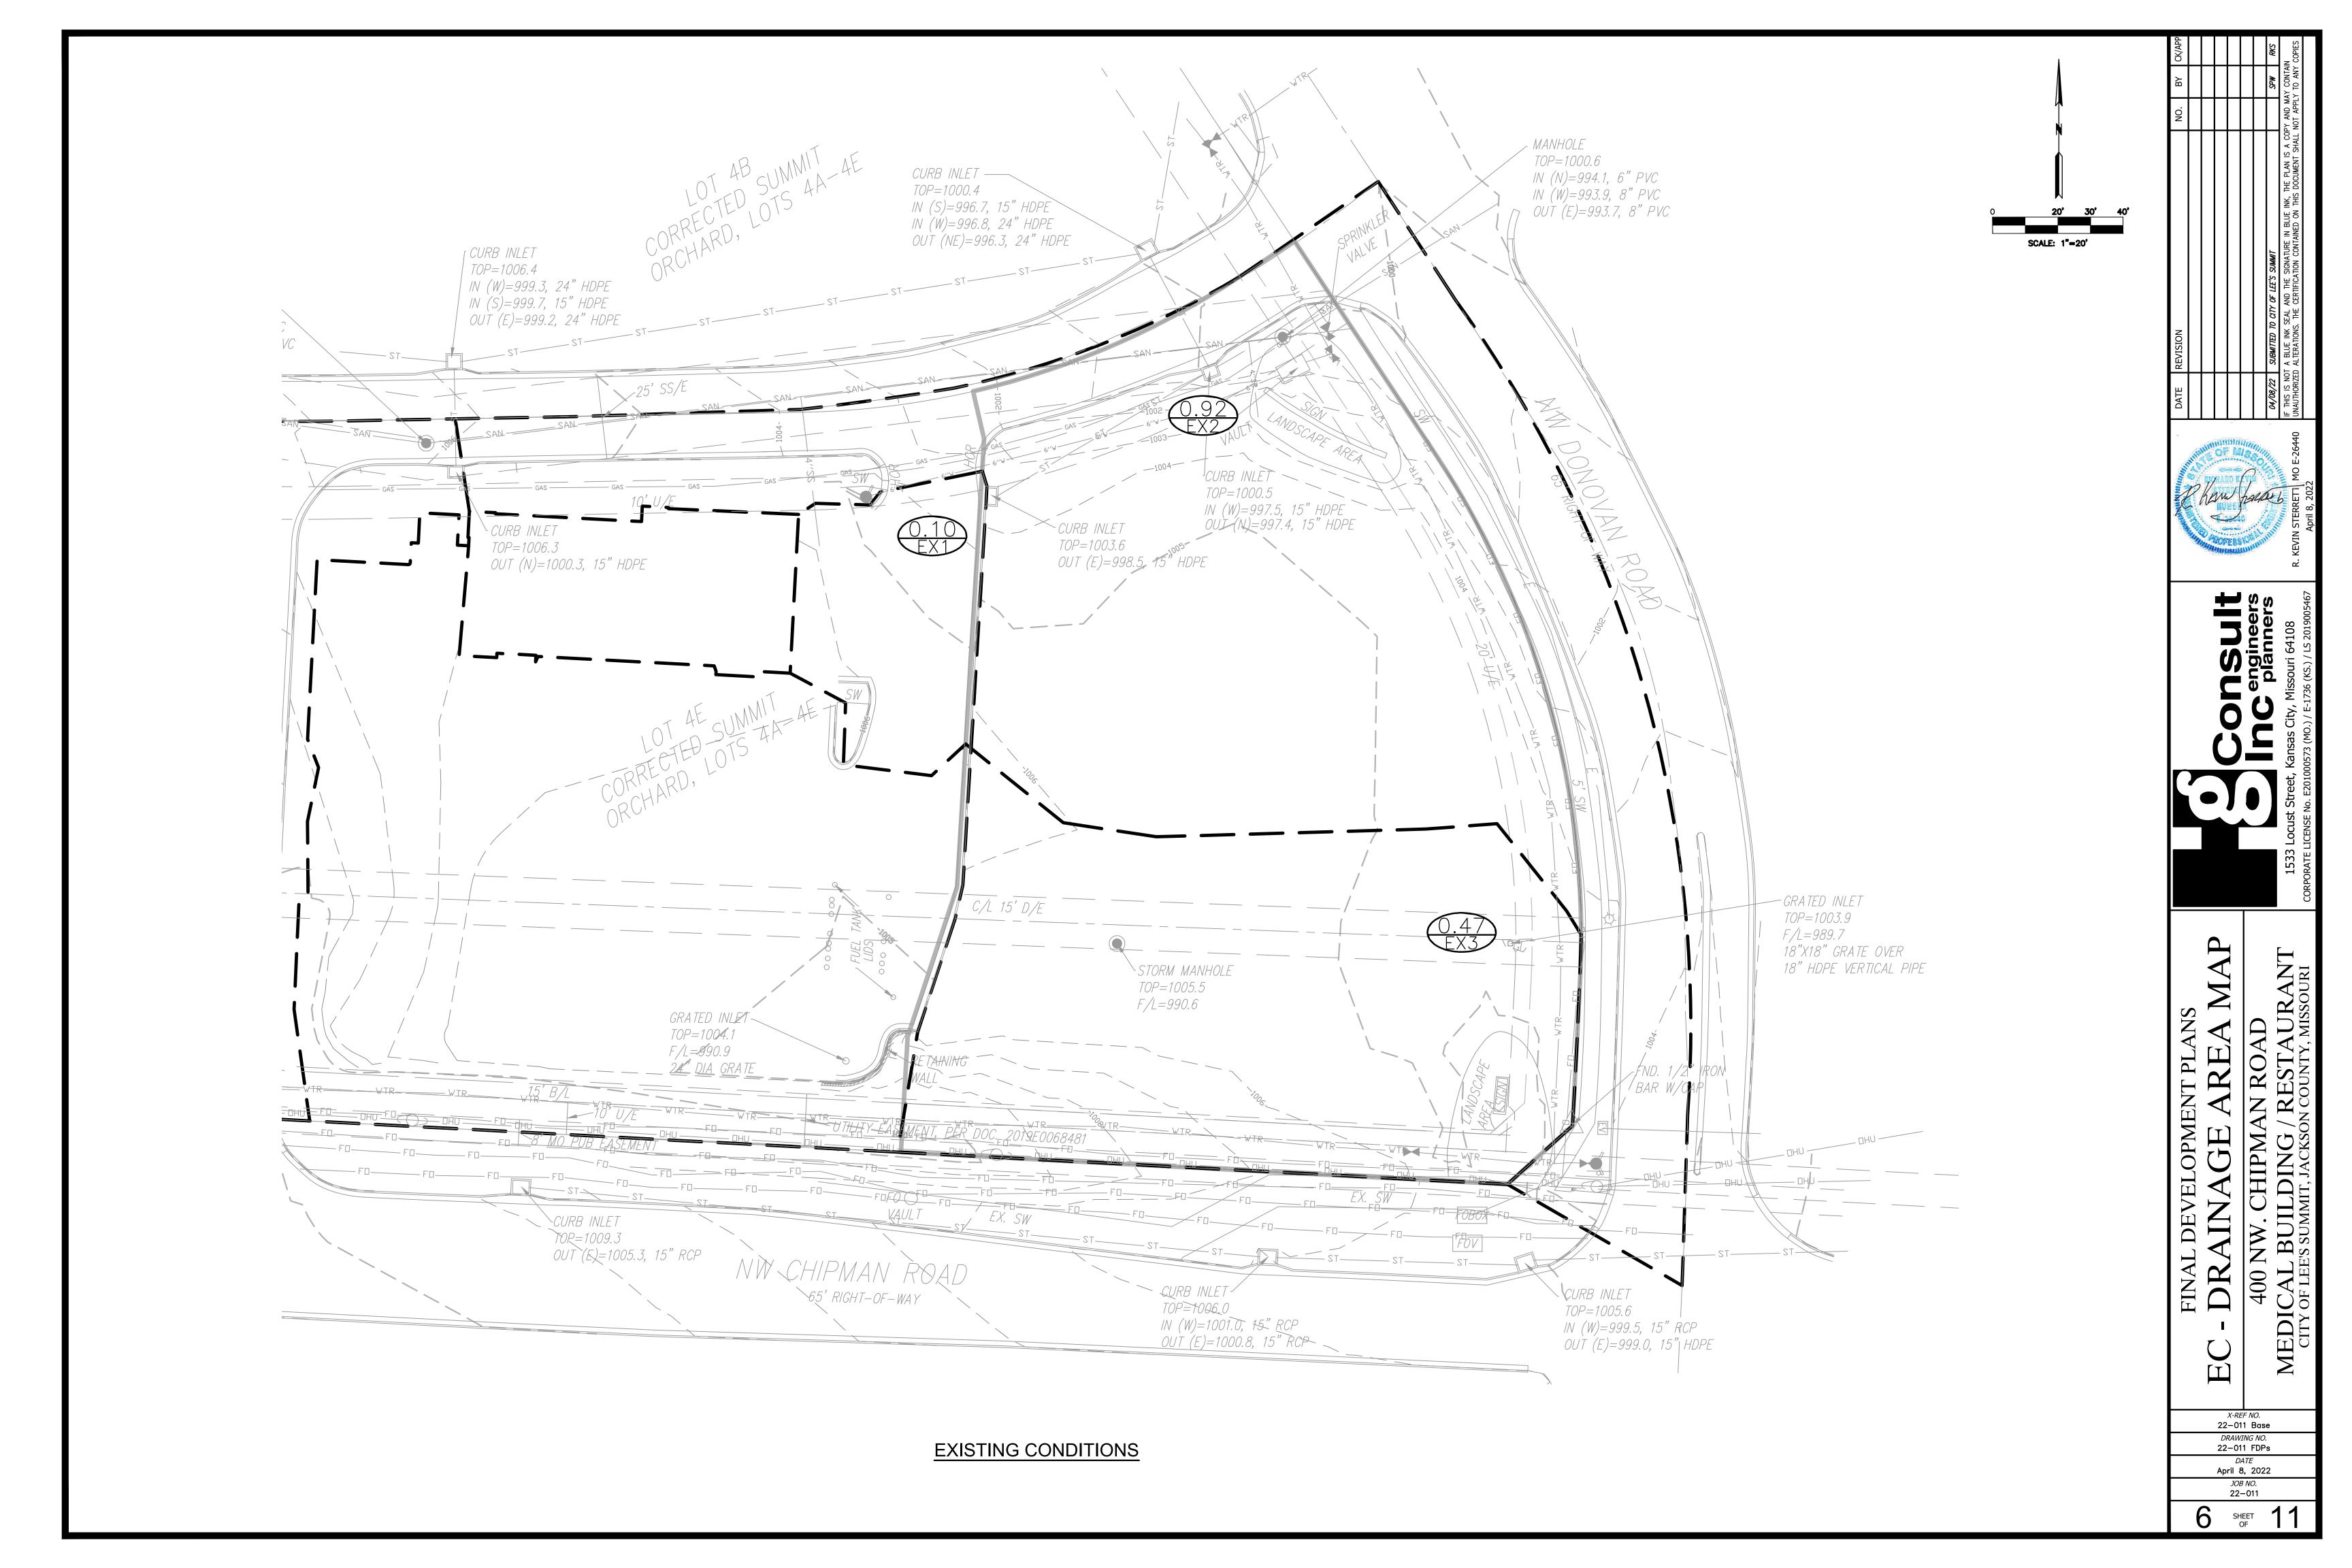

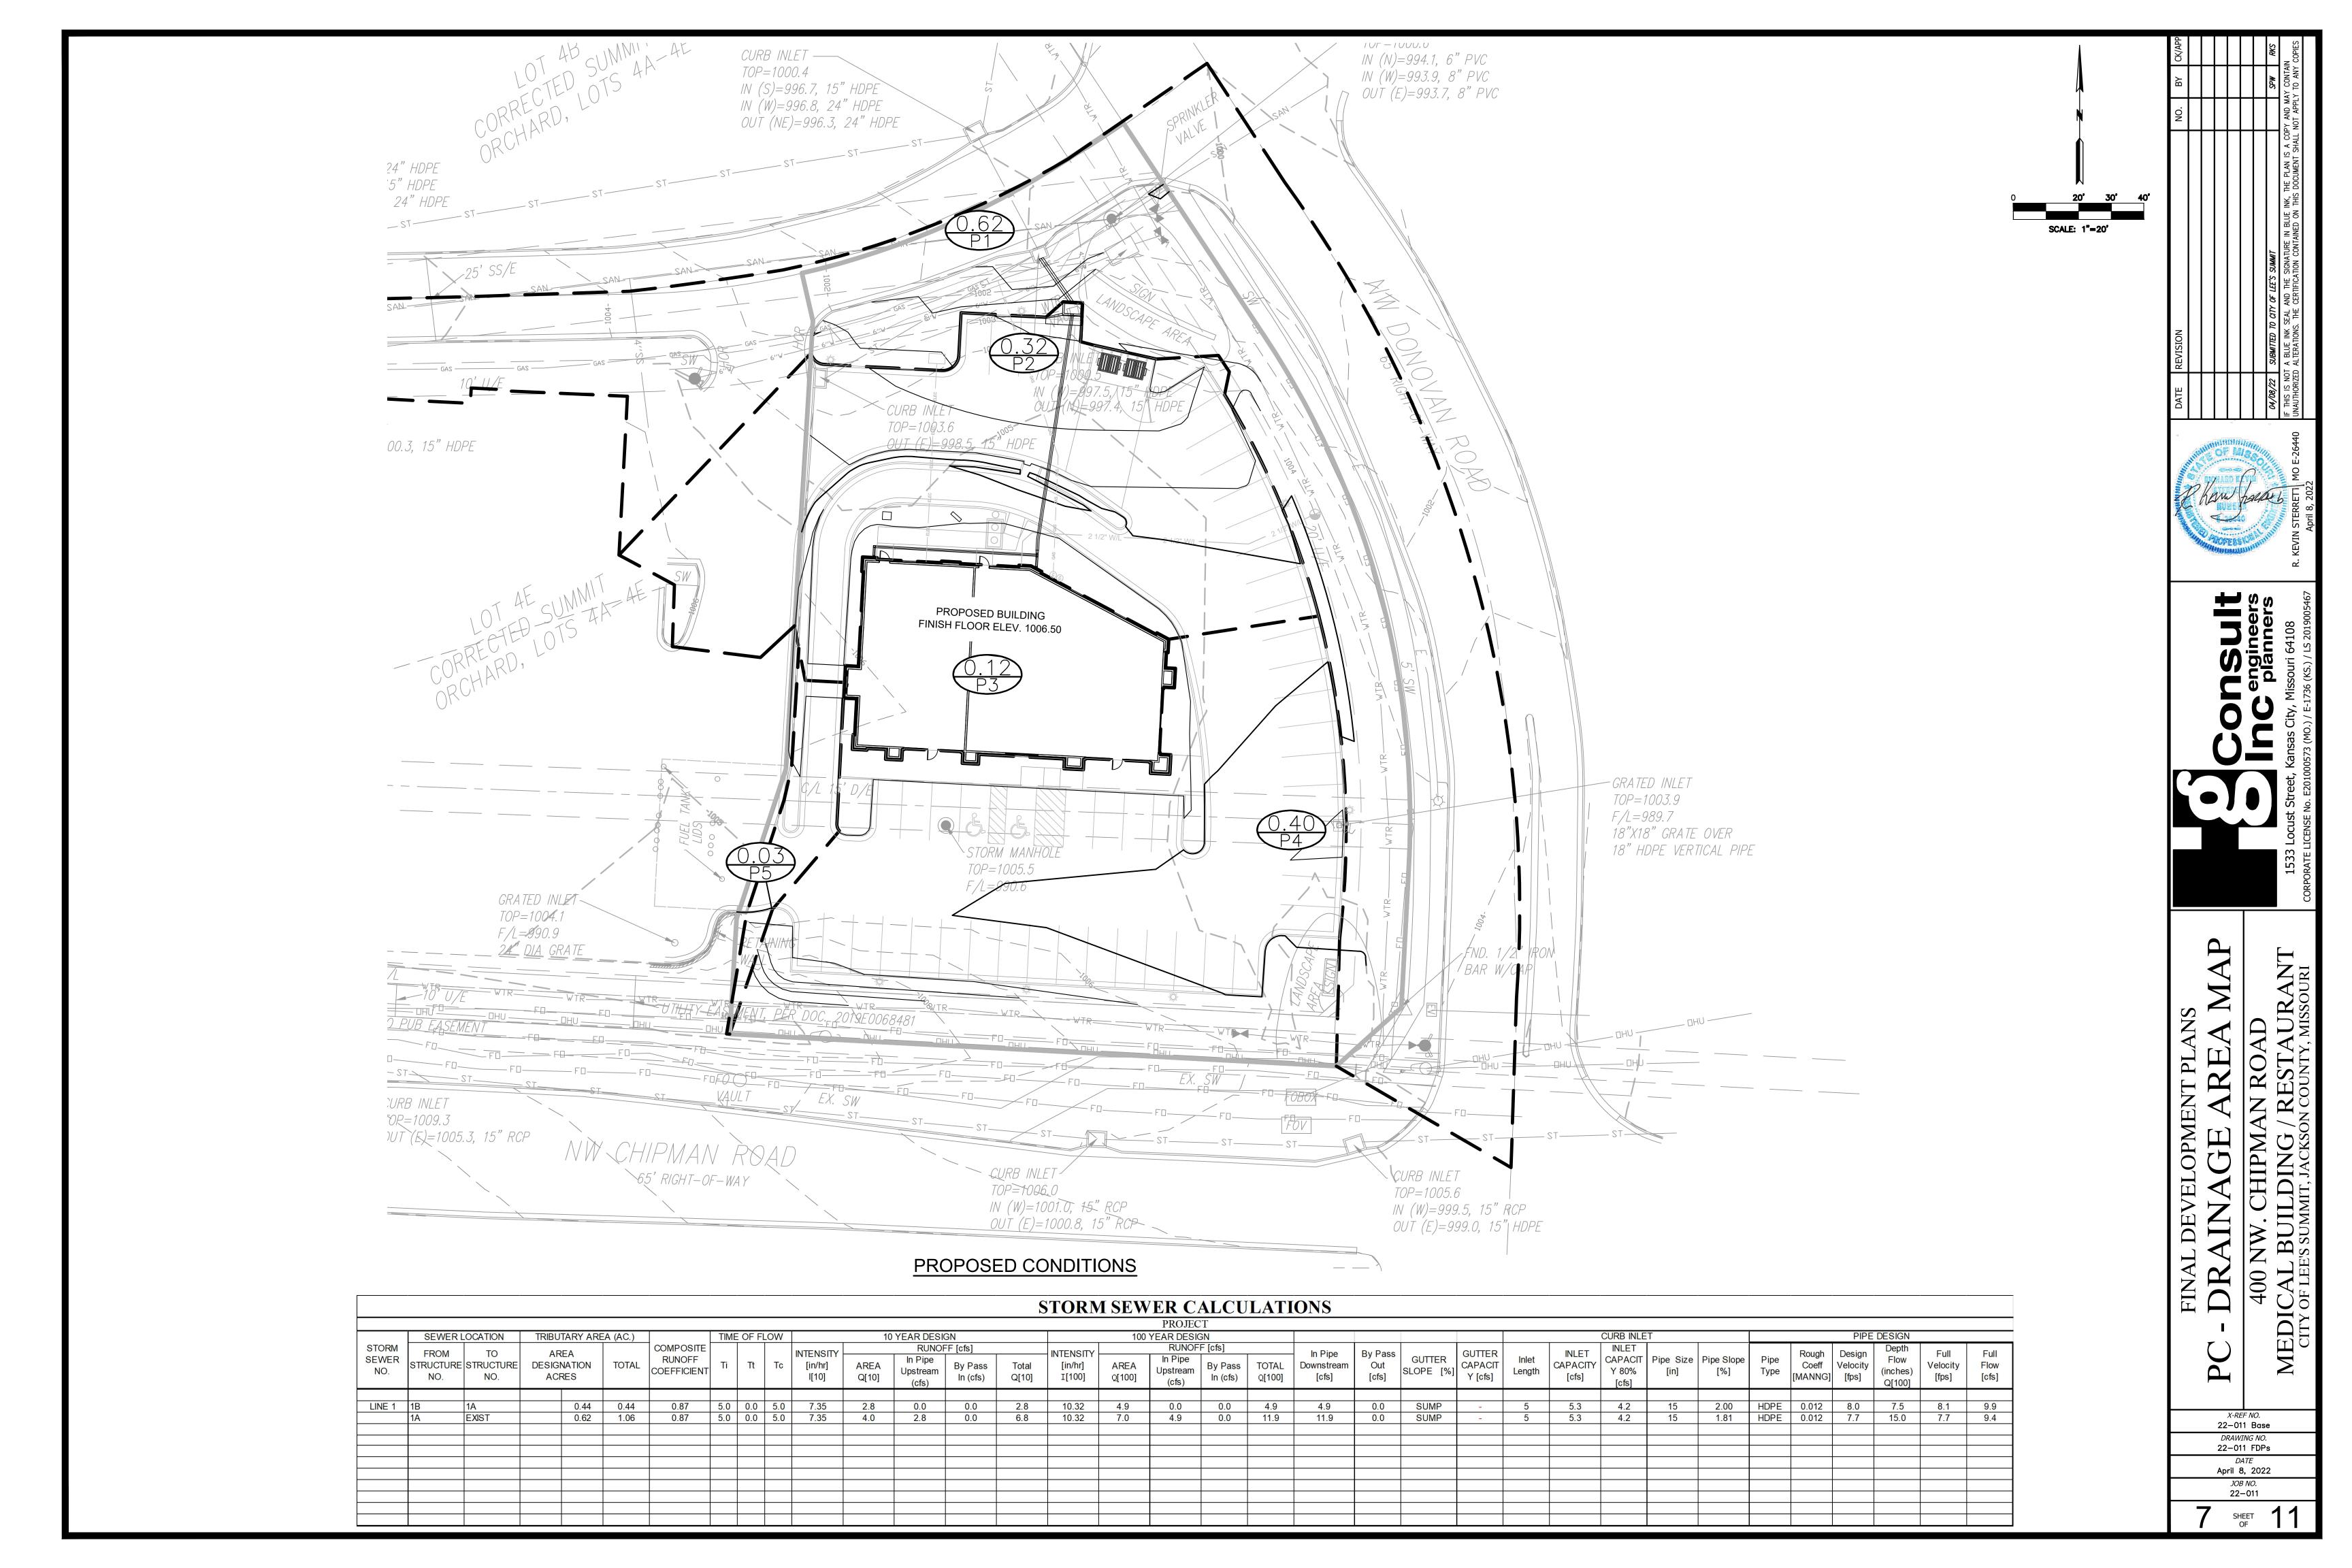

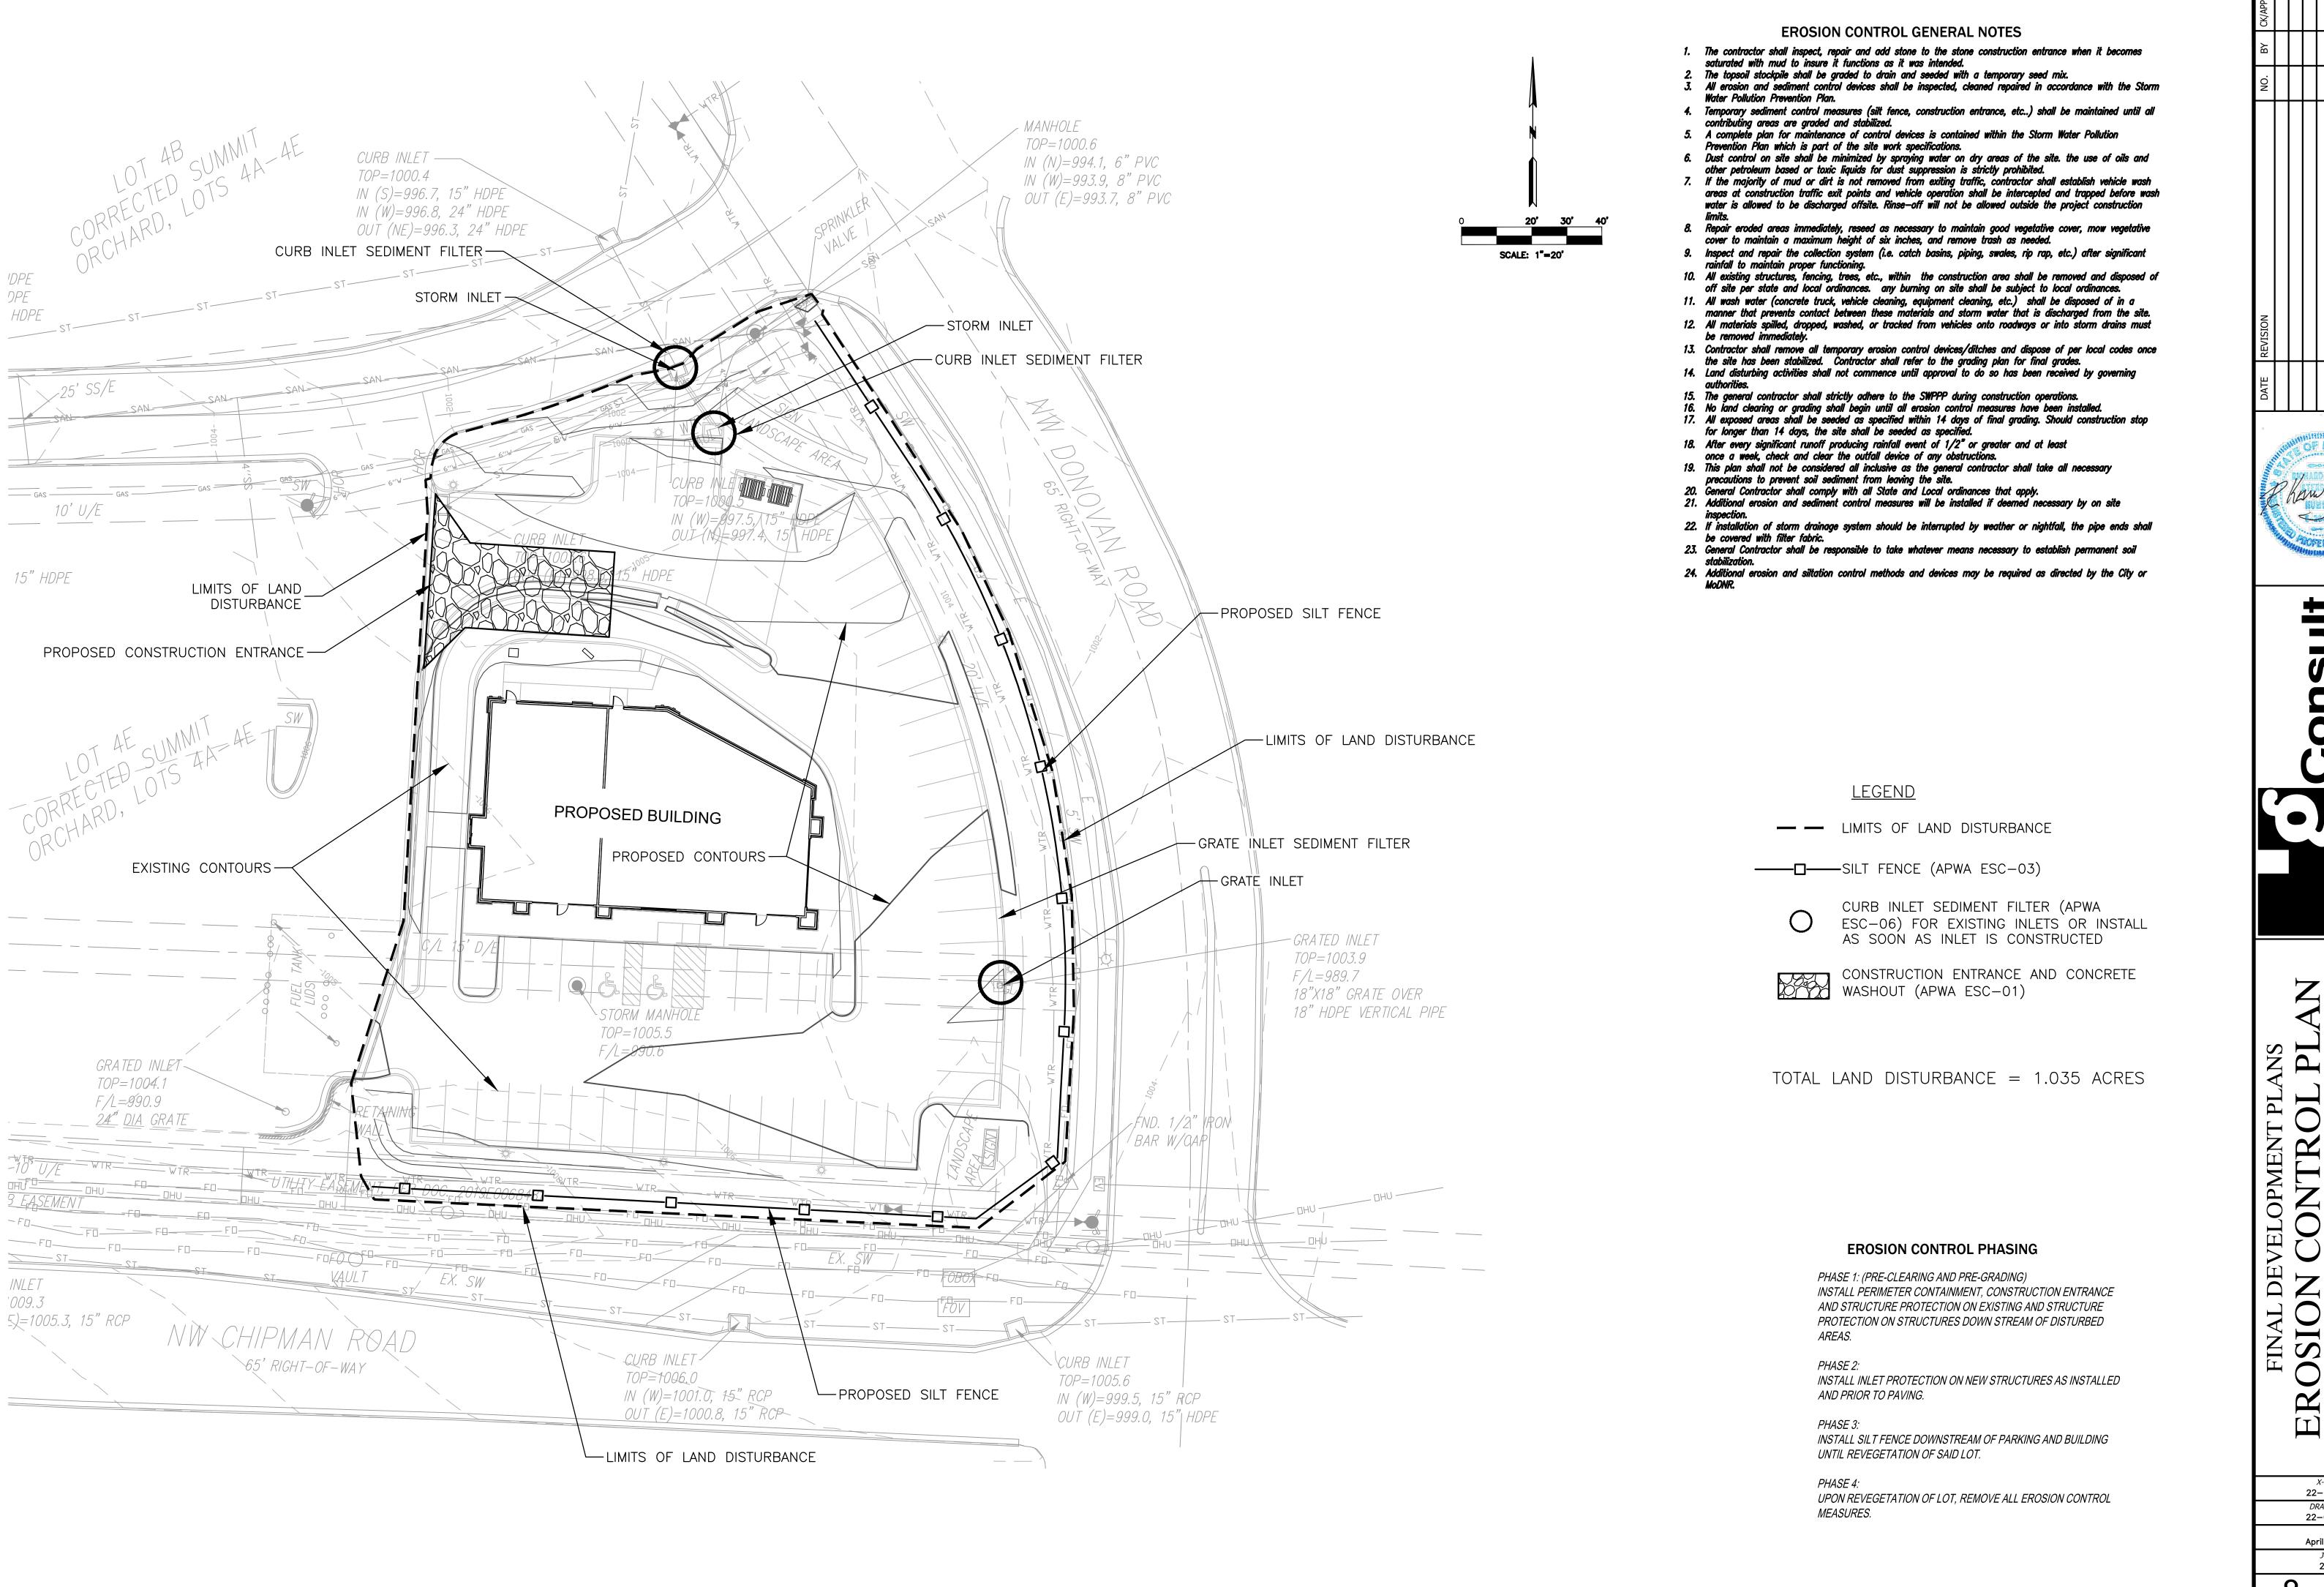


22-011 Base DRAWING NO. 22-011 FDPs


April 8, 2022


LT)

JOB NO. 22-011

8 SHEET OF

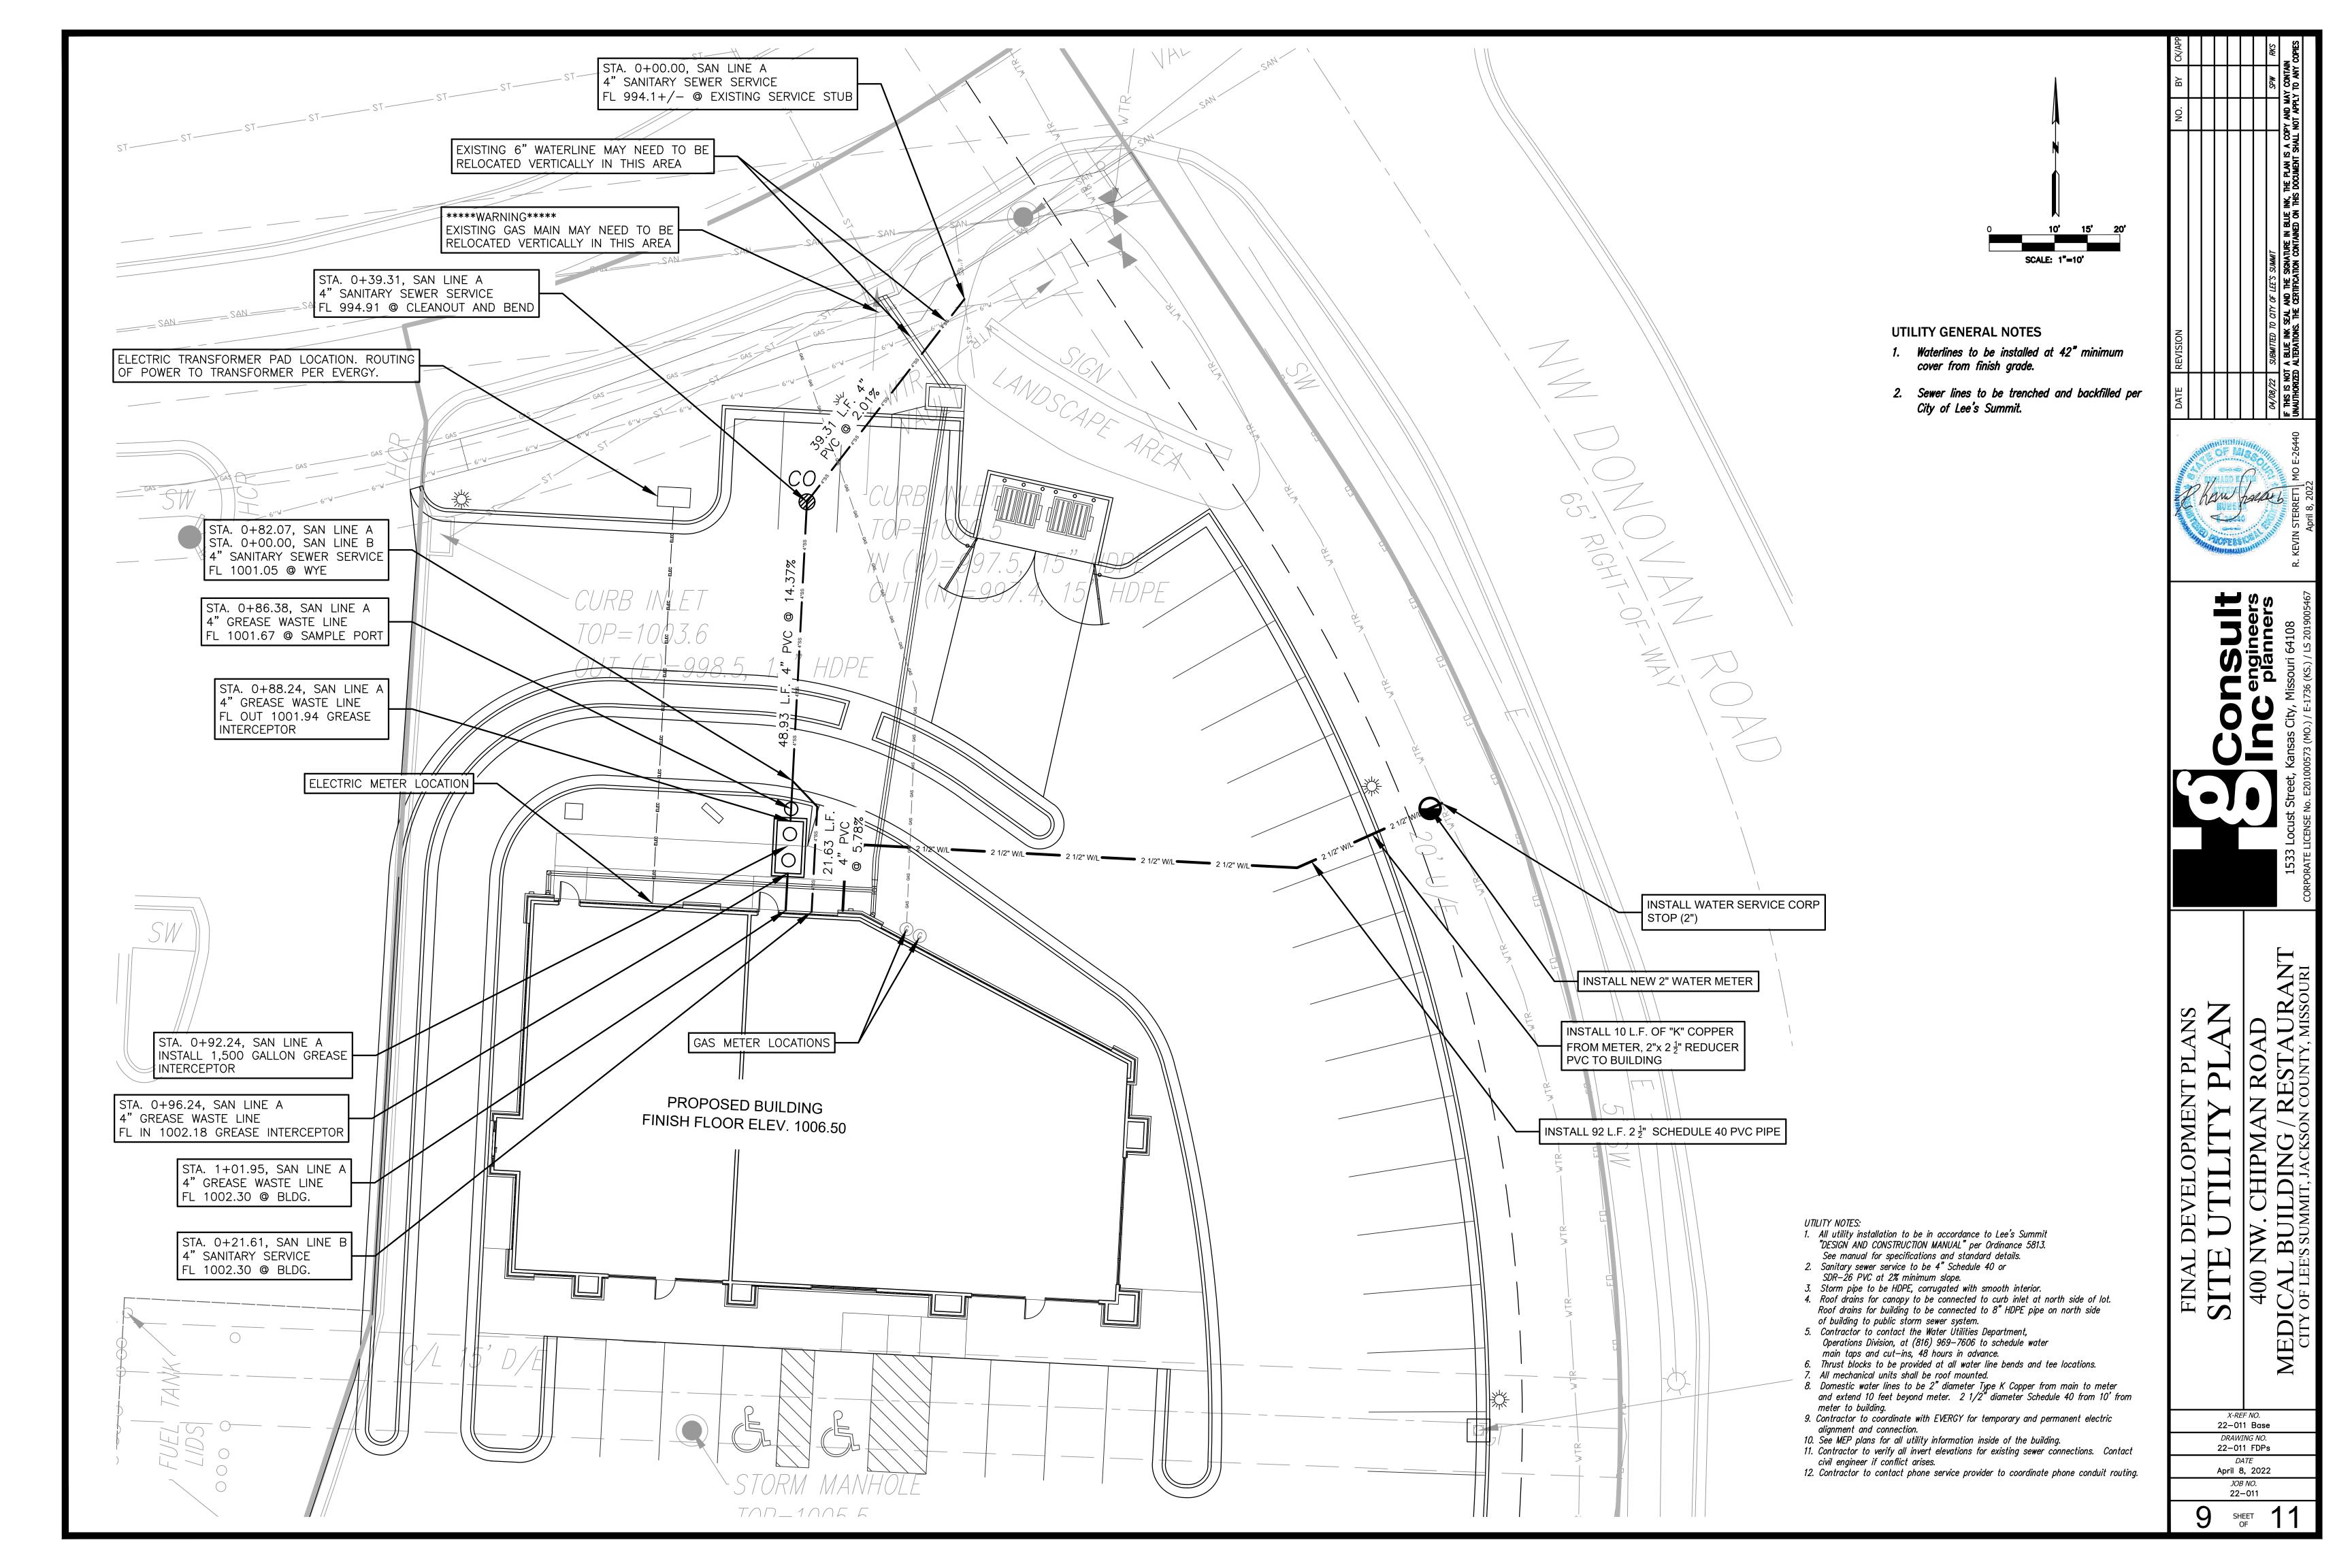

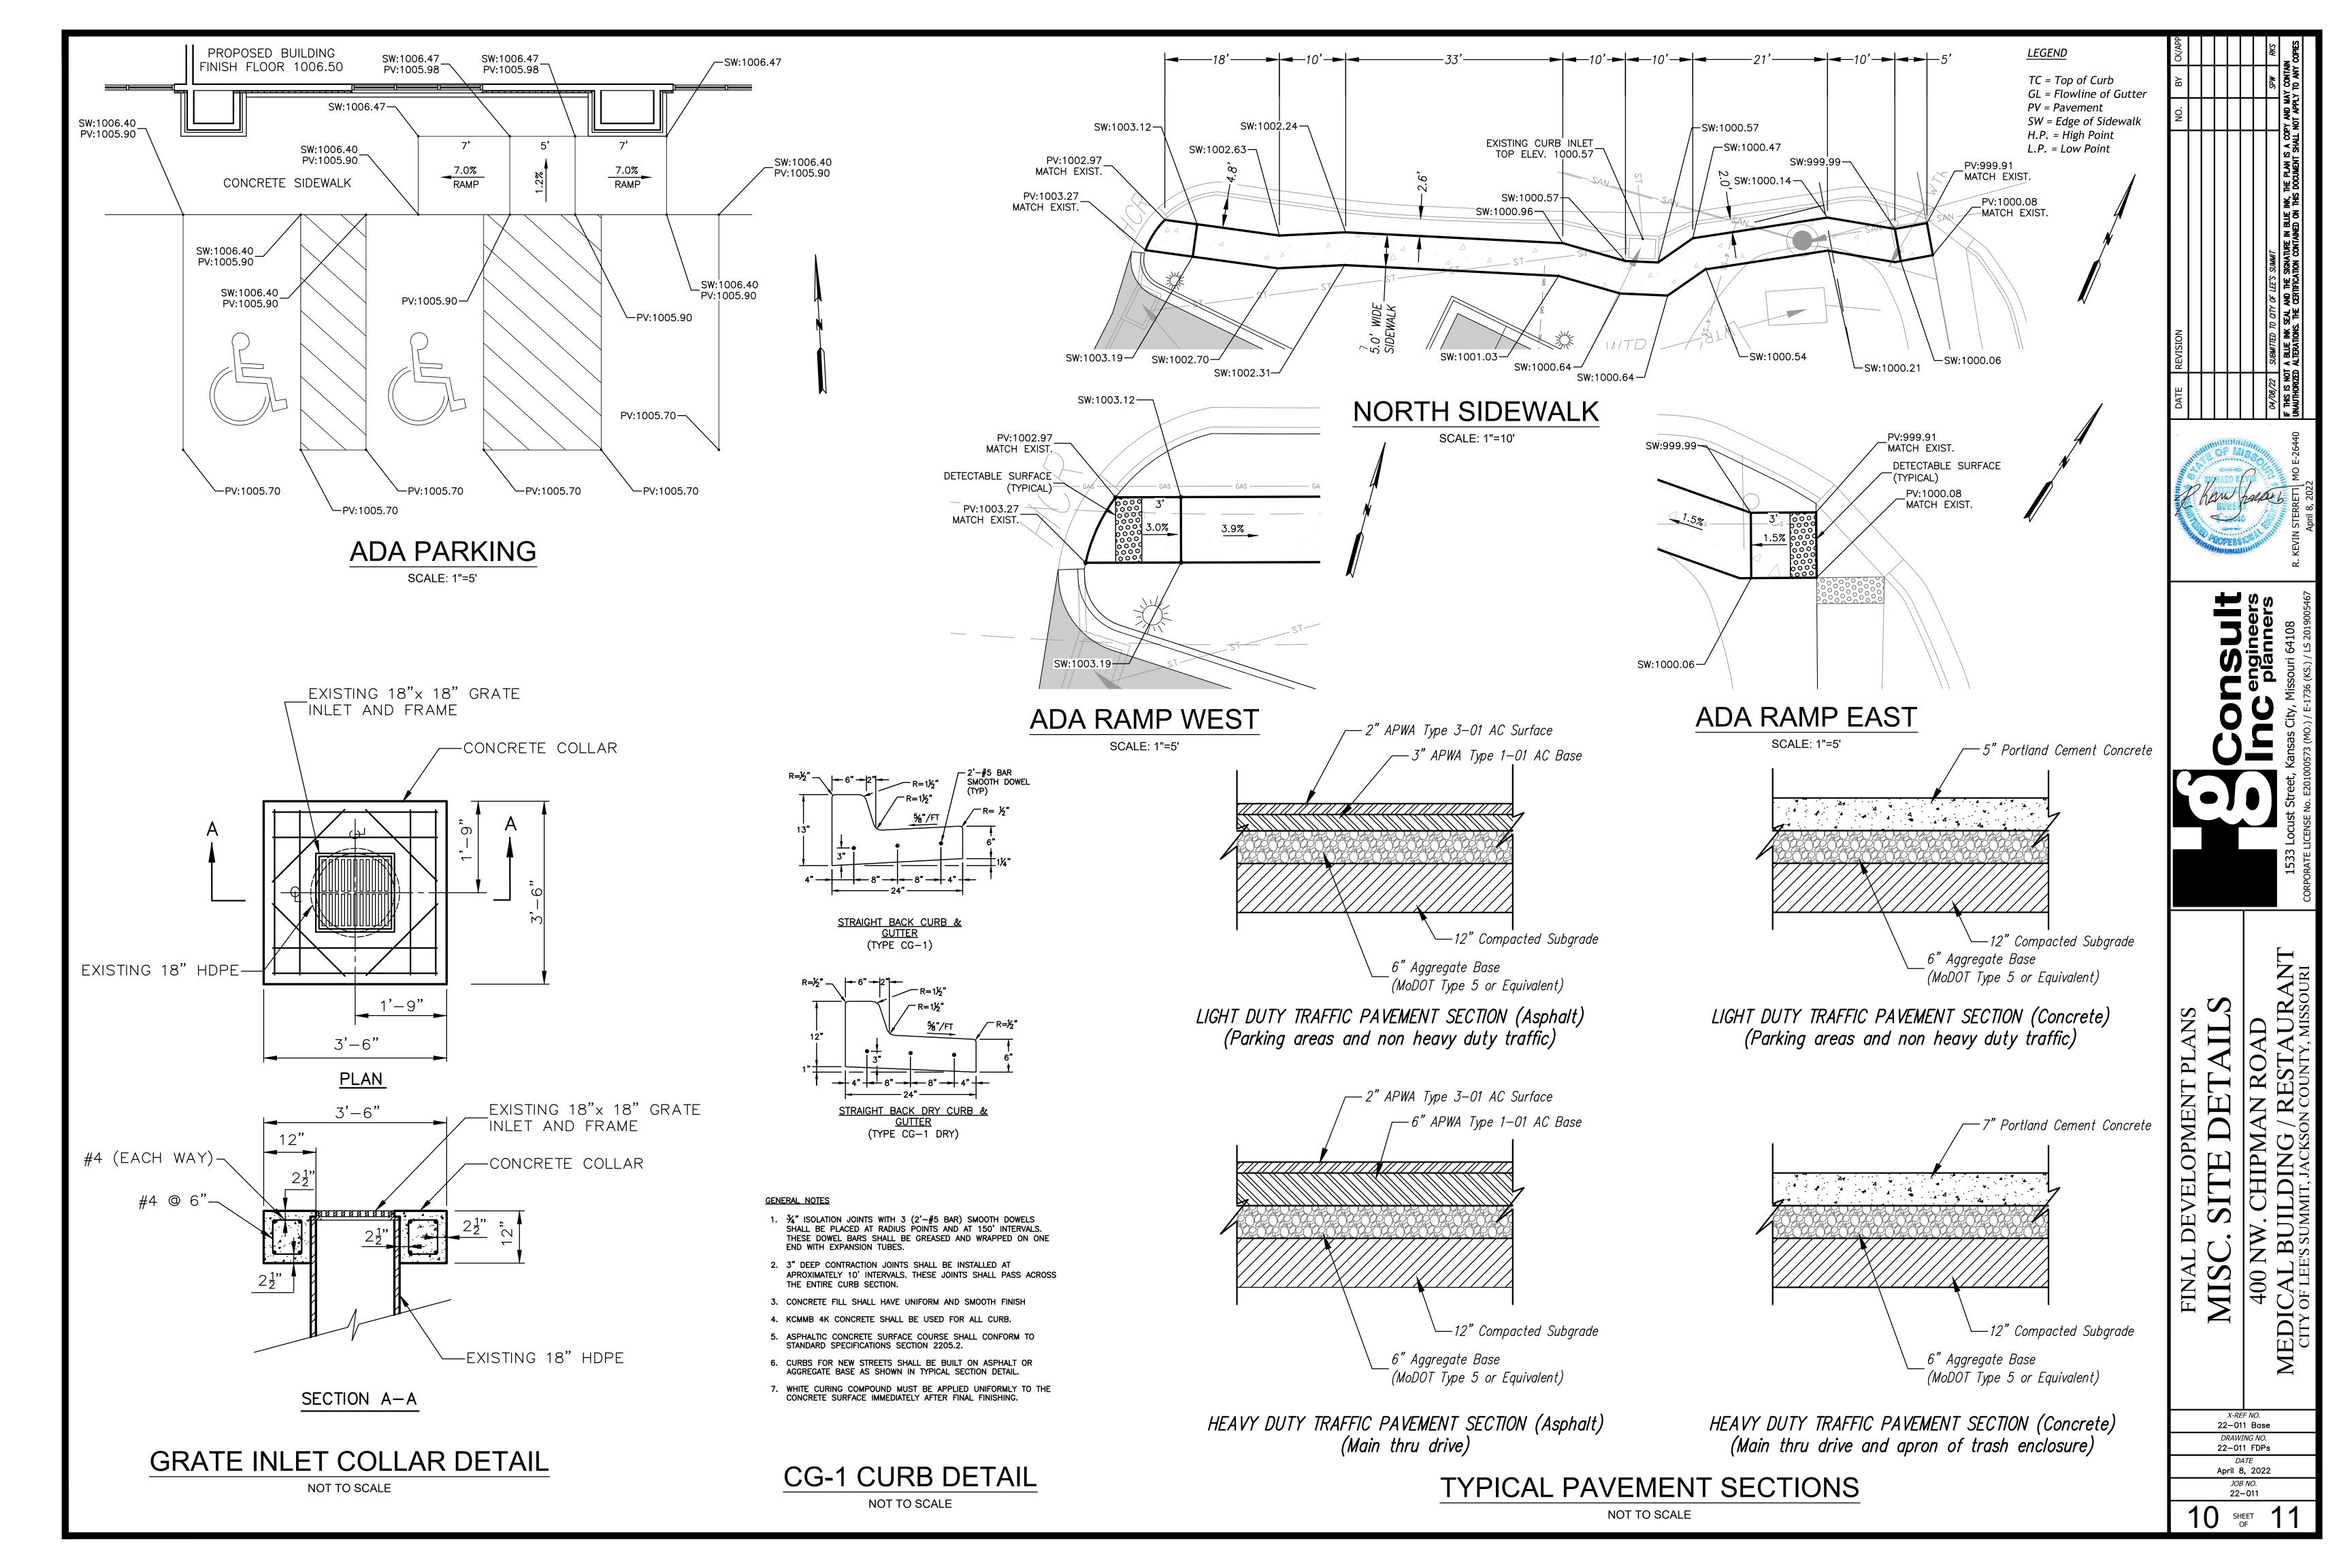

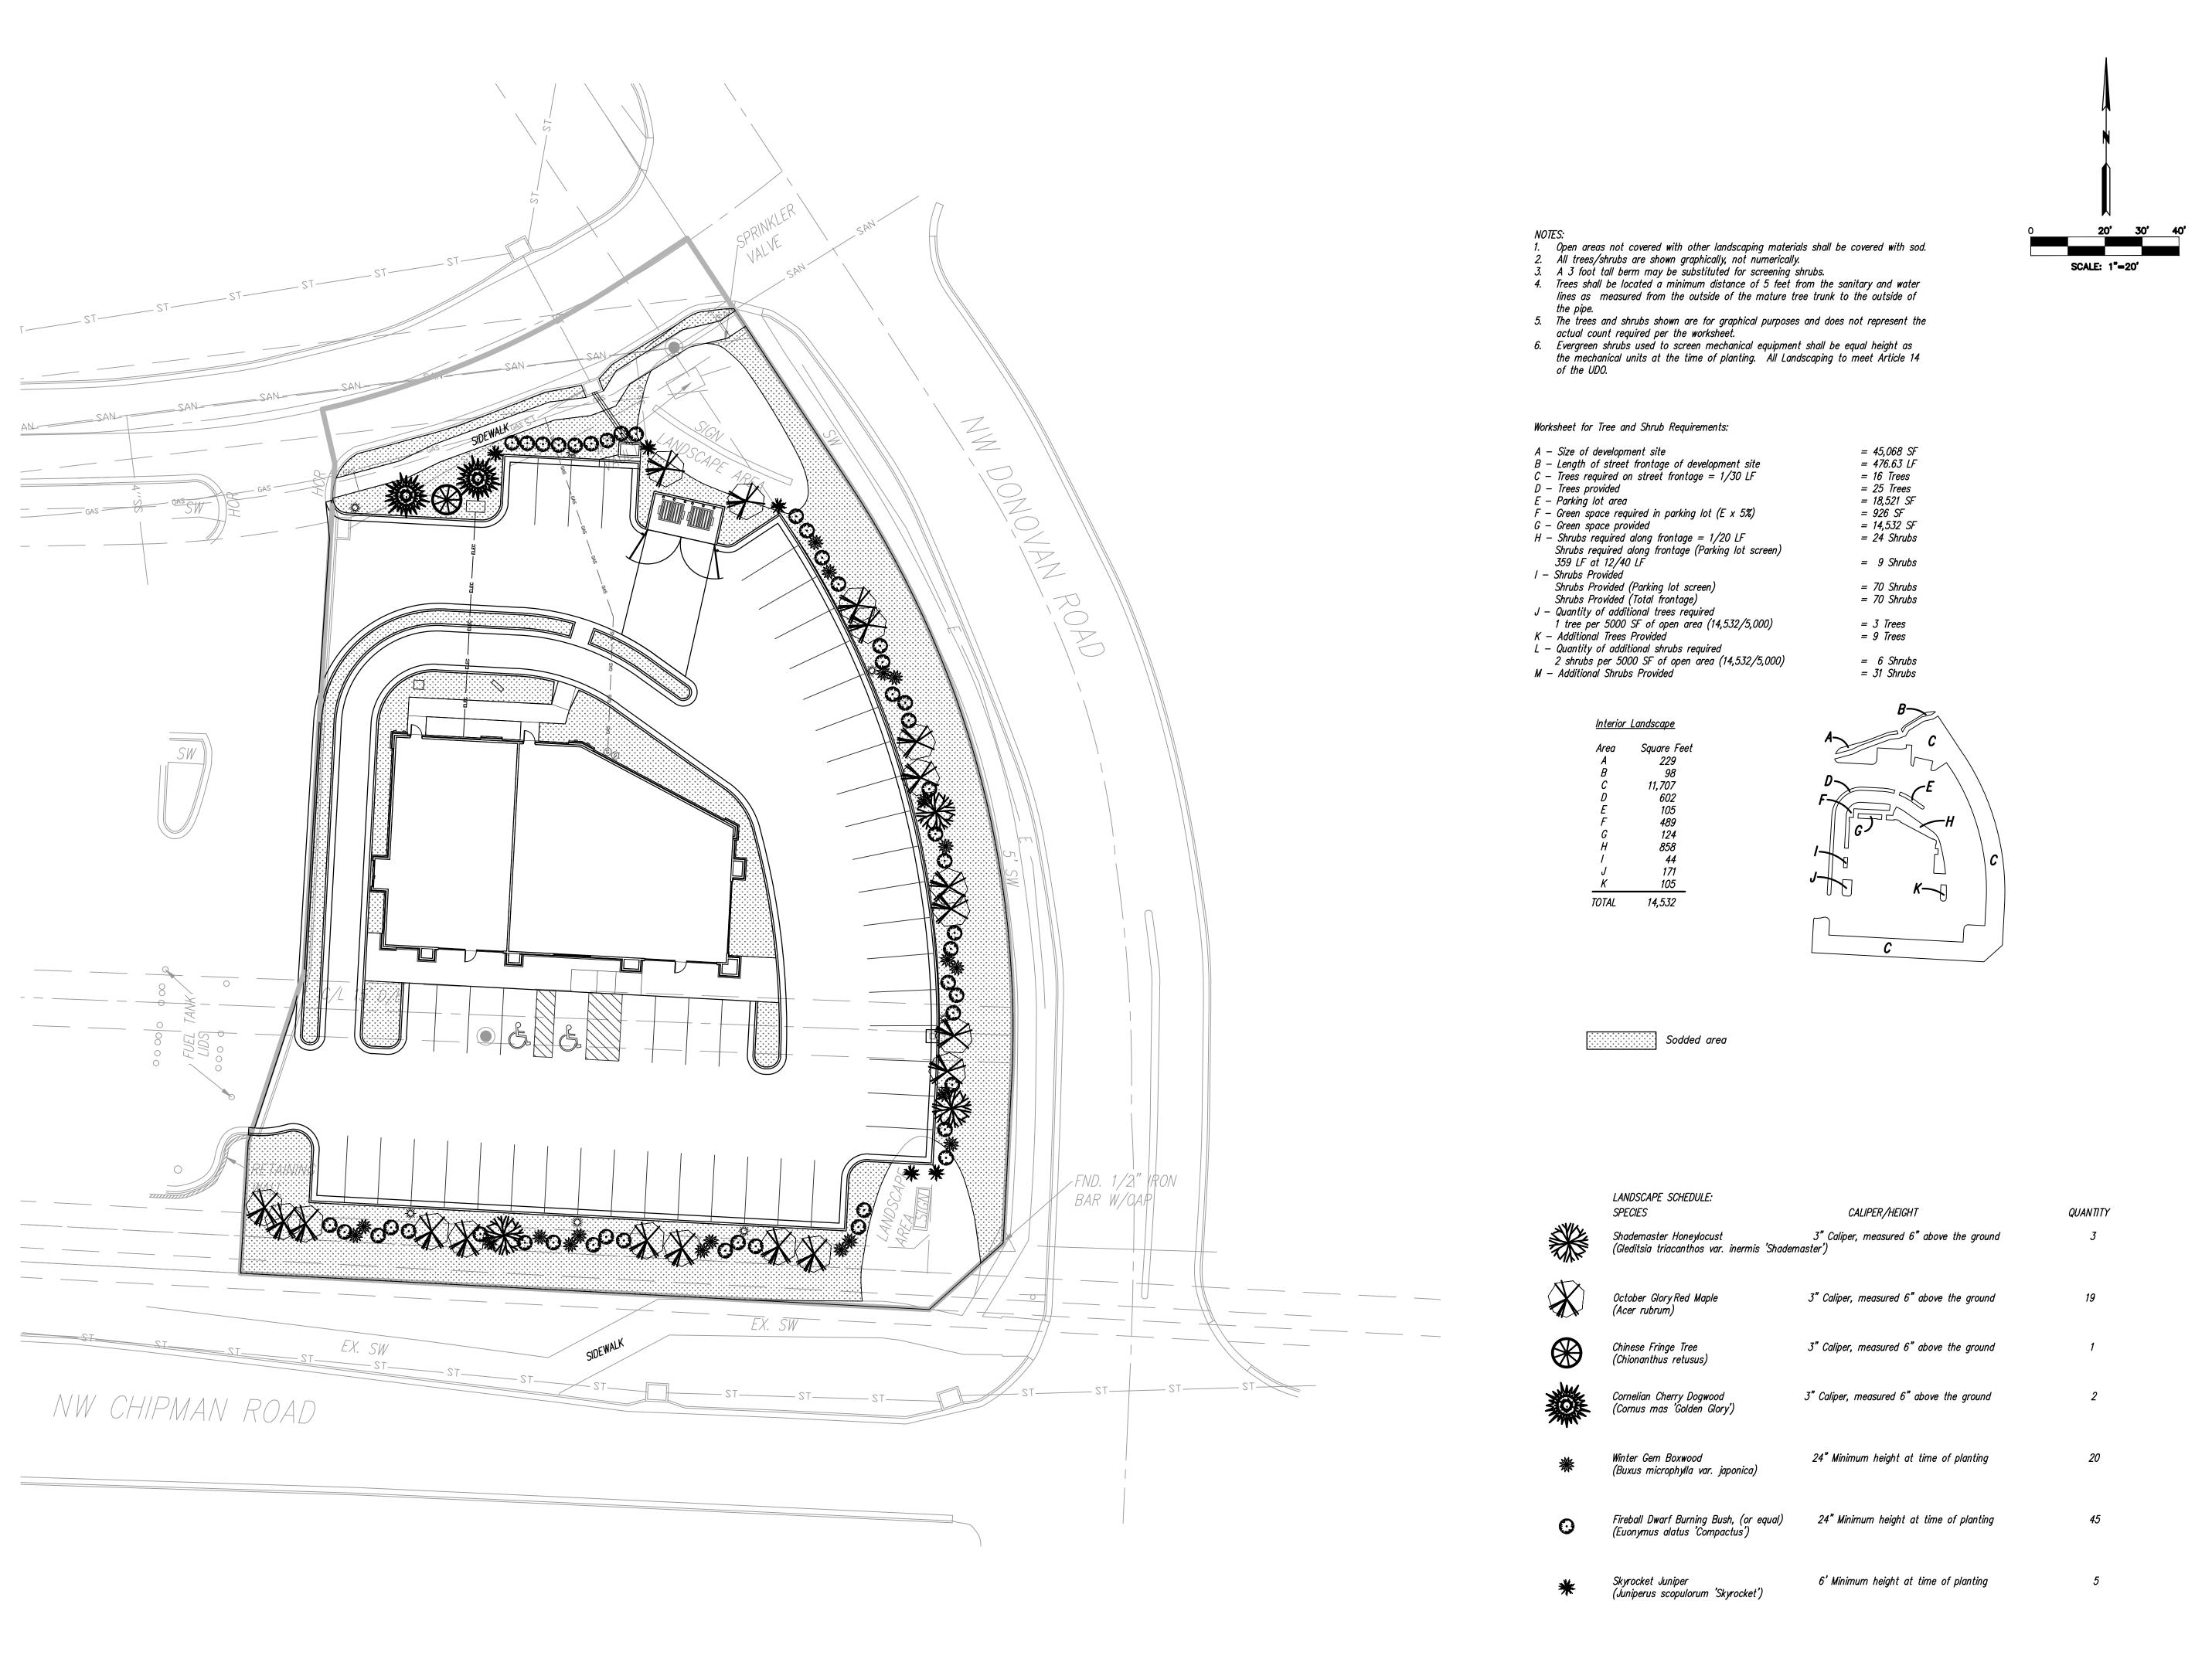


FINAL DEVELOPMENT PLANS
LANDSCAPE PLAN MEDICAL

> X-REF NO. 22-011 Base DRAWING NO. 22-011 FDPs *DATE* **April 8, 2022**

JOB NO. **22–011** 

11 SHEET 11

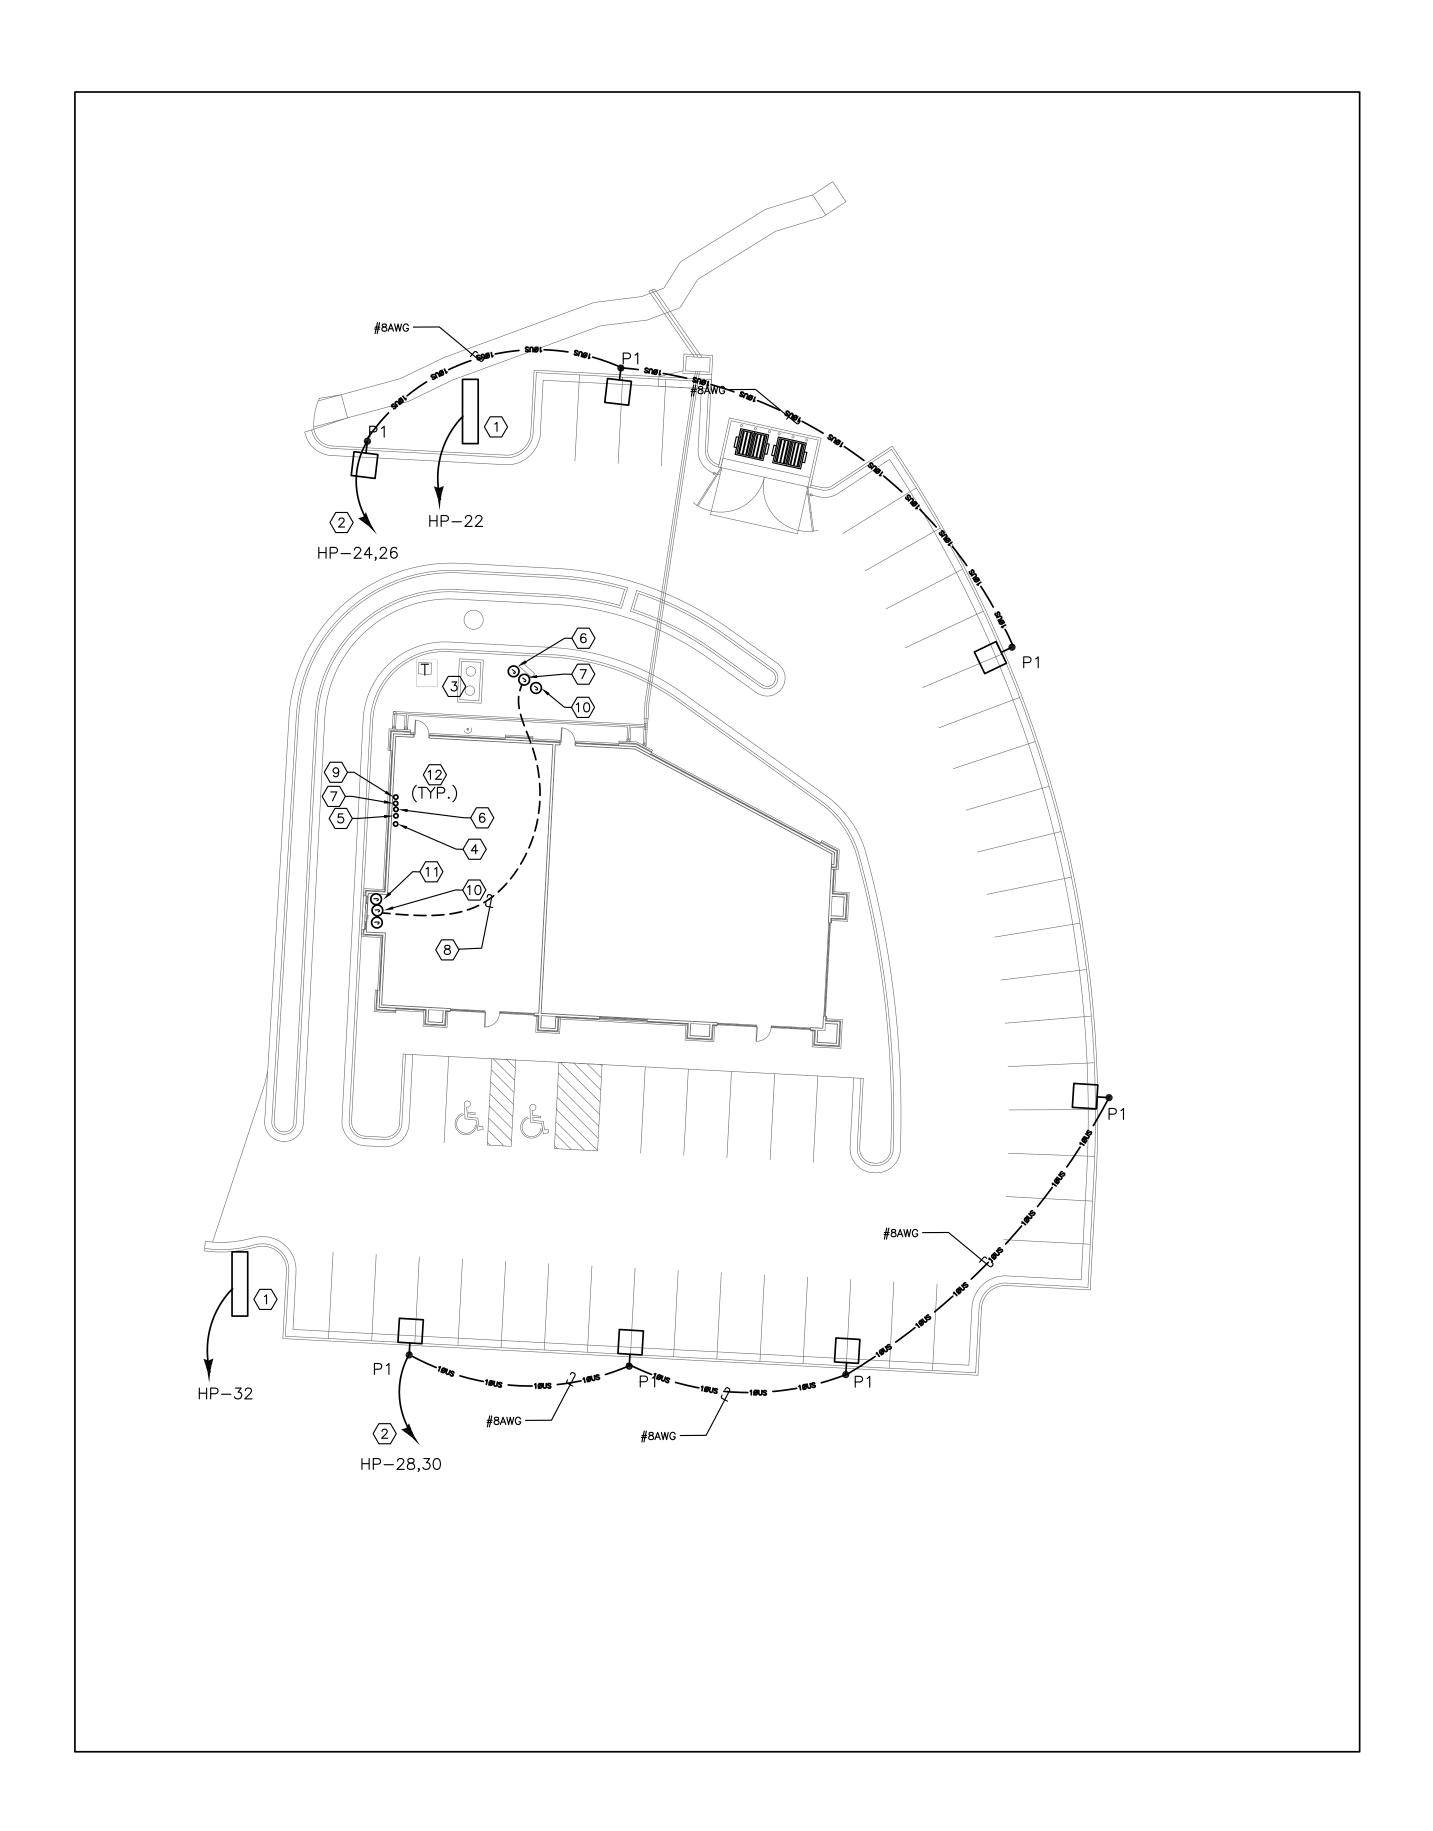

# ECTRICAL SITE PLAN **SCALE**: 1"=20'

### **GENERAL NOTES:**

- A. THE ELECTRICAL CONTRACTOR SHALL REFER TO CIVIL, ARCHITECTURAL, STRUCTURAL, MECHANICAL AND PLUMBING DRAWING FOR THE EXACT BUILDING AND ROOM LAYOUTS. ALL DIMENSIONS, SECTIONS, DETAILS, AND ELEVATIONS. POWER AND VOLTAGE REQUIREMENTS AND PHYSICAL SIZE OF ALL EQUIPMENT FURNISHED BY OTHER TRADES. COORDINATE AND ADJUST ELECTRICAL INSTALLATION ACCORDINGLY.
- B. REFER TO DRAWING E1.0 FOR LIGHTING FIXTURE SCHEDULE.
- C. UPPER CASE ALPHA CHARACTER INSIDE/ADJACENT TO LIGHT FIXTURE INDICATES LUMINAIRE TYPE.
- D. LOWER CASE ALPHA CHARACTER INSIDE/ADJACENT TO LUMINAIRE INDICATES ASSOCIATED SWITCH CONTROLLING LIGHTING BRANCH CIRCUIT.
- E. ALL PENETRATION THRU FIRE RATED WALL AND CEILING SHALL BE SEALED IN ACCORDANCE WITH NATIONAL ELECTRICAL CODE ARTICLE 300-21.
- F. COORDINATE WITH OWNER FOR APPROVAL OF LIGHTING FIXTURE PRIOR TO INSTALL.
- G. MINIMUM WIRE SIZE FOR PARKING LIGHTS IS #8AWG.

### **KEY NOTES:**

- POWER CONNECTION FOR FUTURE MONUMENT SIGN. FILED COORDINATE EXACT LOCATION. SIGNAGE POWER SHALL ROUTED THRU LIGHTING CONTACTOR AND CONTROL VIA TIME CLOCK AND PHOTO ELECTRIC CELL.
- PARKING LIGHT SHALL ROUTED THRU LIGHTING CONTACTOR AND CONTROL VIA TIME CLOCK AND PHOTO ELECTRIC CELL.
- (3) UTILITY TRANSFORMER. FIELD COORDINATE EXACT LOCATION.
- PROVIDE 1" CONDUIT FOR PRE-ORDER MENU BOARD TO FUTURE PANEL LOCATION. STUB UP AND CAP. VERIFY EXACT LOCATION WITH TENANT.
- 5 PROVIDE 1" CONDUIT FOR FUTURE PRE-MENU/MENU BOARD TO FUTURE PANEL LOCATION. STUB UP AND CAP. VERIFY EXACT LOCATION WITH TENANT.
- 6 PROVIDE 1" CONDUIT FOR FUTURE MENU BOARD TO FUTURE PANEL LOCATION. STUB UP AND CAP. VERIFY EXACT LOCATION WITH TENANT.
- 7 PROVIDE 1" CONDUIT FOR POWER TO OCS/SPEAKER POST TO FUTURE PANEL
- LOCATION. STUB UP AND CAP. VERIFY EXACT LOCATION WITH TENANT. 8 PROVIDE (2) 1" CONDUIT FROM OCS/SPEAKER POST TO DRIVE-THRU WINDOW.
- PROVIDE WP, J-BOX AND 1" CONDUIT FOR DIRECTIONAL SIGN TO FUTURE PANEL LOCATION. STUB UP AND CAP. VERIFY EXACT LOCATION WITH TENANT.
- PROVIDE 1" CONDUIT FOR DETECTOR LOOP SET. STUB UP AND CAP. VERIFY EXACT LOCATION WITH TENANT.
- PROVIDE WP, J-BOX AND 3/4" CONDUIT FOR DRIVE-THRU TRANSOMS, SIDELIGHTS AND EXTERIOR SHELF POWER TO FUTURE PANEL LOCATION. STUB UP AND CAP. VERIFY EXACT LOCATION WITH TENANT.
- STUB UP CONDUITS 6" A.F.F FINISH FLOOR. COORDINATE WITH ARCHITECT, OWNER AND OTHER TRADES PRIOR TO INSTALLATIONS.

1" NOMINAL GROUT

- FINISHED GRADE

\_ 3/4 " - NON FROST

SUSCEPTIBLE MATERIAL

(USE RIGID STEEL FROM FIXTURE BASE OUT 3'-0"

#4 REBAR HOOPS ÄT 12" O.C.

— CONCRETE BASE

EXOTHERMIC WELD

— 3/8 " x 8'-0" COPPER CLAD STEEL GROUND ROD

- CHAMFER ALL EXPOSED EDGES

MAINTAIN MIN. SPACING OF 2" BETWEEN REBAR SURFACE AND CONCRETE SURFACE

### PROJECT INFO

CLIENT:

COVENANT GROUP, LLC

PROJECT:

COVENANT GROUP - BUILDING SHELL - LEE'S SUMMIT, MO

ADDRESS:

400 NW CHIPMAN RD LEE'S SUMMIT, MO 64806

PROJECT NO:

### MAIN CONTACT

CHRISTOPHER CLARK, AIA, NCARB 7701 E KELLOGG DR, STE 630 WICHITA, KS 67207 (316) 302-4472 chris@clarkitecture.net

### **DEVELOPER**


Z

### SHEET INFO

ISSUE DATE: MM/DD/YY ISSUED FOR: INTERNAL REVIEW

ОШОК  $O \stackrel{\sim}{\sim} \stackrel{\sim}{\sim} 0$ 

REVISION SCHEDULE

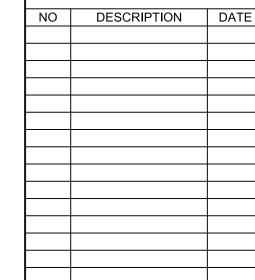

**PROFESSIONAL'S SEAL:** 04/06/2022

ELECTRICAL SITE PLAN

TYPICAL POLE BASE DETAIL E-6 SCALE:

DETAIL NOTES


AE MUST DETERMINE POLE BASE DEPTH.


SONO TUBE

GROUND STUD -

ANCHOR BOLTS -

DEPTH BY STRUCTURAL ENGINEER BELOW

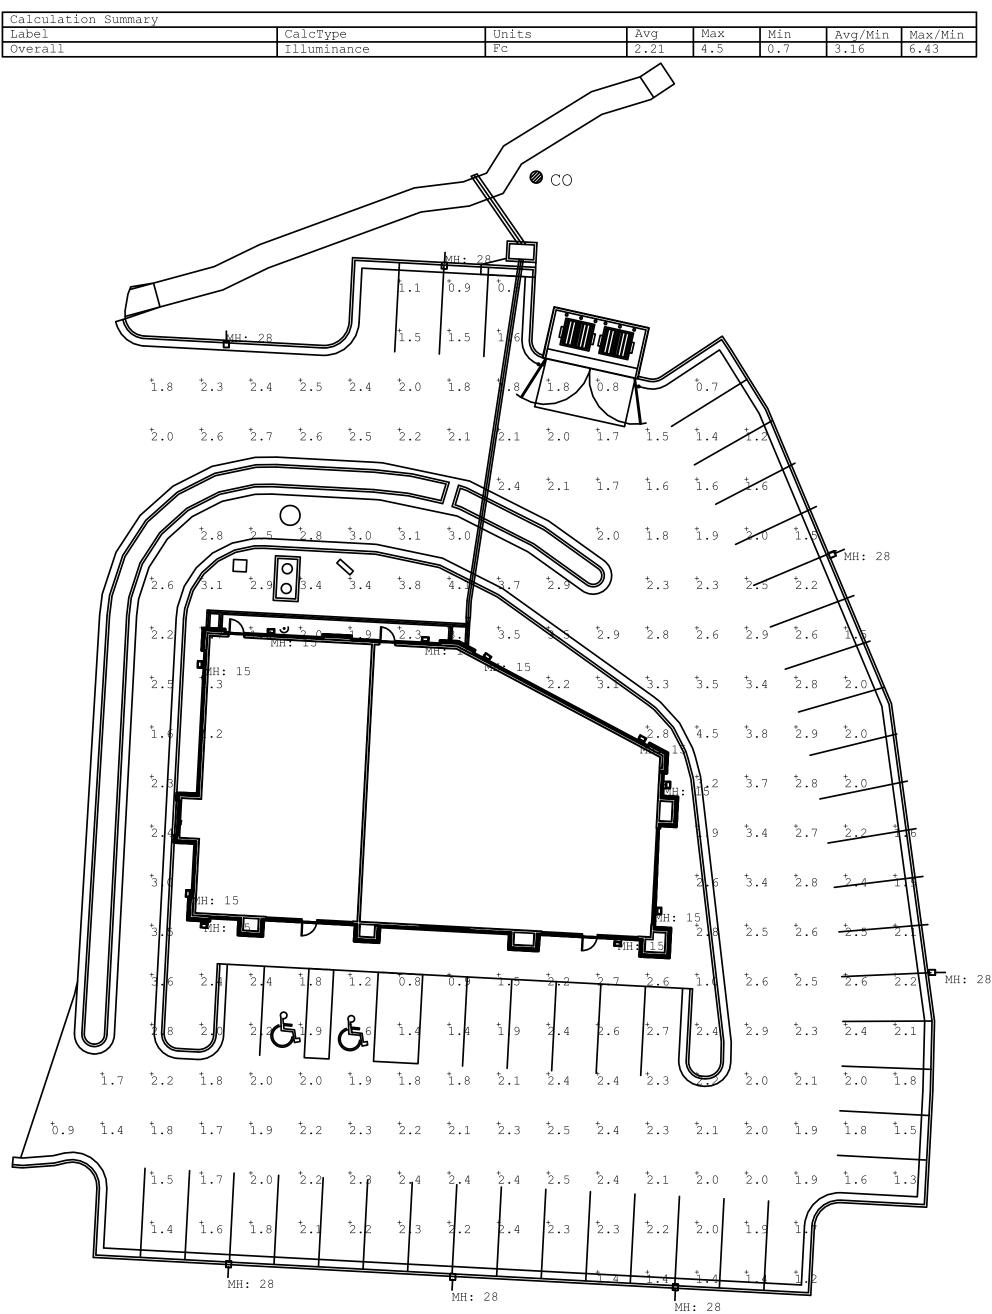

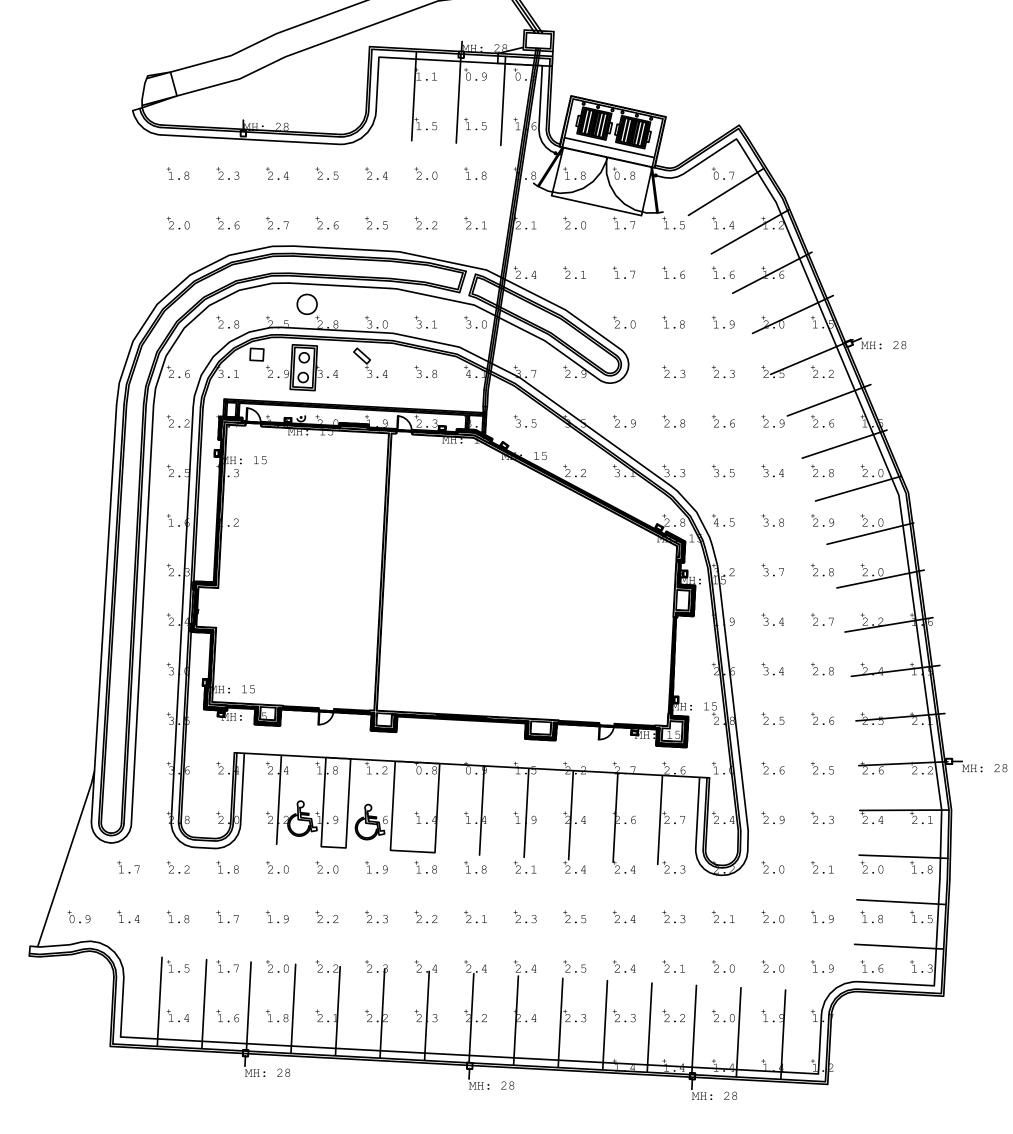



PROJECT INFORMATION

**APPLICATIONS** 

Parking Lots

Campuses APPROVALS

Educational/Business

C136.31-2010, Test Level 2. Suitable for wet locations.

or www.designlights.org/qpl

Project Name	Date
Catalog #	Туре

ETL Listed. Complies with UL 1598 and CSA C22.2 No. 250.0-08
3G Vibration Rated for Bridge/Overpass Applications per ANSI

IP 66 Optics and Housing.
Select models DLC Qualified. For a completed list of DLC Qualified products, please visit: http://www.xtralight.com/dlc

MODEL LUMENS WATTS EFFICACY

VNT-S 100\* 14735 109.1 135.0 LPW

Security Areas

 Mall & Retail Spaces Pedestrian Walkways

### **VIENTO SMALL**

AREA & SITE LED LUMINAIRE



 Outstanding photometric performance results in sites with excellent uniformity, optimal pole spacing and lower power

- Ootics are completely sealed against moisture and environmental contaminants (IP66).
- Low profile architectural design offers a contemporary appearance with excellent light output and is night sky friendly.
- Field serviceable luminaire utilizing Lumileds LED technology. Controls ready luminaire for independent operation or remote management.
- Operating temperature: -40°C to +40°C (-40°F to +104°F)
- Housing: One-piece die-cast aluminum has integral heat sink fins
   ELECTRICAL to optimize thermal management through conductive and
- convective cooling. The LED driver is mounted in direct contact with the casting to
- promote low operating temperature and long life. Housing and door are protected with a thermoset TGIC-polyester
- powder coat finish using a tightly controlled multi-stage process to a uniform 3 mil thickness (min). This finish provides superior protection from corrosion and maximum environmental

Powder coat finish in bronze, white or custom colors (consult factory).

- MOUNTING Integral arm with key hole slot facilitates quick and easy
- installation.
- Nut plate eliminates loose hardware in the pole and reduces installation labor.

 VNT-S 052\*
 7605
 52.7
 144.3 LPW

 VNT-S 072\*
 10775
 77.4
 139.2 LPW

\*Type V Optics 5000K. For more photometric information see page 3. Precision molded optics for superior uniformity, minimal light

- trespass and maximum pole spacing. Optical grade polymer is UV stabilized and impact resistant. IP66 rated LED light engines prevent dust and moisture from
- Distributions: Type II, Type III, Type IV and Type V. Types II, III,
- and IV available rotated right or left 90°, factory installed.
- Best in class Osram LEDs with 3000K, 4000K and 5000K CCT
- Zero uplight (UO) is night sky friendly, reduces wasted light. Lumen Maintenance: >100,000hrs L70 @ 25°C.

 Voltage: 120-277V 50/60Hz driver (standard); 347-480V 50/60Hz driver (optional).

- Class 2 electronic drivers are designed to have a power factor >90%, THD <20%, and an expected life of 100,000 hours with
- Surge Protection: 20kA standard.
- NEMA twist-lock receptacle available as an option.
- NOTE: Photocontrol or shorting cap required for operation
- (not included). Dimming: 0-10v dimmable driver standard.
- Passive Infrared (PIR) Photo/Motion Sensor option available. WARRANTY
- 10 year limited warranty.

www.xtralight.com • (800) 678-6960 • customerservice@xtralight.com tion is believed to be accurate at the time of publication. Please contact customer service or visit www.xtralight.com for the most updated product specifications. XtraLight" reserves the right to change specifications without notice. PROJECT INFO

CLIENT:

COVENANT GROUP, LLC

PROJECT:

COVENANT GROUP - BUILDING SHELL - LEE'S SUMMIT, MO

ADDRESS:

400 NW CHIPMAN RD LEE'S SUMMIT, MO 64806

PROJECT NO:

MAIN CONTACT

CHRISTOPHER CLARK, AIA, NCARB 7701 E KELLOGG DR, STE 630 WICHITA, KS 67207 (316) 302-4472 chris@clarkitecture.net

DEVELOPER

VENANT AL TATE OUP

ORHQ OHQR

SHEET INFO

ISSUED FOR: INTERNAL REVIEW

REVISION SCHEDULE

NO	DESCRIPTION	DATE

PROFESSIONAL'S SEAL:

SITE LIGHTING PHOTOMETRIC PLAN E-7

