



ATC SITE NAME: LEE S SUMMIT 1B

ATC SITE NUMBER: 36075

T-MOBILE SITE NUMBER: A5C0676A SITE ADDRESS: 2200 LOWENSTEIN

LEES SIMMIT, MISSOURI 64081-

1905



LOCATION MAP

T-MOBILE SPRINT KEEP ANTENNA AMENDMENT PLAN 56790EZ_SR_T CONFIGURATION

COMPLIANCE CODE	PROJECT SUMMARY	PROJECT DESCRIPTION		SHEET INDEX				
ALL WORK SHALL BE PERFORMED AND MATERIALS INSTALLED IN ACCORDANCE WITH THE CURRENT EDITIONS OF THE	SITE ADDRESS:	THE PROPOSED PROJECT INCLUDES MODIFYING GROUND BASED AND TOWER MOUNTED EQUIPMENT AS INDICATED PER BELOW:	SHEET NO:	DESCRIPTION:	REV:	DATE:	BY:	
FOLLOWING CODES AS ADOPTED BY THE LOCAL GOVERNMENT AUTHORITIES. NOTHING IN THESE PLANS IS	2200 LOWENSTEIN	TOWER WORK:	G-001	TITLE SHEET	0	03/24/2022	HEG	s
TO BE CONSTRUED TO PERMIT WORK NOT CONFORMING TO THESE CODES.	LEES SIMMIT, MISSOURI 64081-1905	REMOVE (6) ANTENNA(s), (9) RRU(s) AND (3) V-FRAME SECTOR FRAME INSTALL (6) ANTENNA(s), (6) RRH(s), (2) HCS 2.0, (2) 1.46" HYBRID	G-002	GENERAL NOTES	0	03/24/2022	HEG	П
INTERNATIONAL BUILDING CODE (IBC)	COUNTY: JACKSON	CABLE(S) AND (3) SFG23RHDX-12'-AP4 W/ RR-APEX4 SECTOR FRAME EXISTING (3) 1 1/4" HYBRID CABLE(S)TO REMAIN	C-101	DETAILED SITE PLAN & TOWER ELEVATION	0	03/24/2022	HEG	П
NATIONAL ELECTRIC CODE (NEC)	GEOGRAPHIC COORDINATES:	GROUND WORK:	C-102	GROUND DETAIL PLAN	0	03/24/2022	HEG	П
3. LOCAL BUILDING CODE 4. CITY/COUNTY ORDINANCES	LATITUDE: 38.93324444 LONGITUDE: -94.41758142	REMOVE (1) SPRINT PPC CABINET, (1) SPRINT SSC CABINET(S),	C-201	TOWER ELEVATION	0	03/24/2022	HEG	Н
4. CITT/COUNTY ORDINANCES	GROUND ELEVATION: 981' AMSL	(1) SPRINT BATTERY CABINET(S). INSTALL (1) DELTA HPL3 SSC(s), (1) DELTA LB3 BSU(s), (1) AVV BOX(s),	C-401	ANTENNA INFORMATION & SCHEDULE	0	03/24/2022	HEG	$\ \cdot\ $
		(2) WORK LIGHT(s),(2) HCS2.0(s), (2) ASIB W/ (1) ASIL, (3) ABIA, (3) ABIC W/ (2) ABIO, (1) FSMF, (2) AMIA, (1) VOLTAGE BOOSTER(s), (1) AMPLIFIER(s),						$\ \cdot \ $
		(1) GPS ANTENNA(s), (1) EMERSON PPC CABINET(s), (1) ICE BRIDGE(s)	C-501	CONSTRUCTION DETAILS	0	03/24/2022	HEG	
			C-502	CABLE AND MOUNTING DETAILS	0	03/24/2022	HEG	14
		PROJECT NOTES	C-503	LARGE BATTERY 3 CABINET MANUFACTURER DETAIL	0	03/24/2022	HEG	SE
	PROJECT TEAM	THE FACILITY IS UNMANNED.	C-504	HP-LARGE 3 POWER CABINET MANUFACTURER DETAIL	0	03/24/2022	HEG	M
	TOWER OWNER: APPLICANT:	 A TECHNICIAN WILL VISIT THE SITE APPROXIMATELY ONCE A MONTH FOR ROUTINE INSPECTION AND MAINTENANCE. 	E-501	GROUNDING DETAIL	0	03/24/2022	HEG	П
	AMERICAN TOWER T-MOBILE NORTHEAST LLC	 THE PROJECT WILL NOT RESULT IN ANY SIGNIFICANT LAND DISTURBANCE OR EFFECT OF STORM WATER DRAINAGE. 	E-601	ELECTRICAL ONE-LINE DIAGRAM	0	03/24/2022	HEG	П
	10 PRESIDENTIAL WAY 12050 BALTIMORE AVENUE WOBURN, MA 01801 BELTSVILLE, MD 20705		R-601	SUPPLEMENTAL				П
UTILITY COMPANIES	ENGINEER:	HANDICAP ACCESS IS NOT REQUIRED. THE PROJECT DEPICTED IN THESE PLANS QUALIFIES AS AN	R-602	SUPPLEMENTAL				П
POWER COMPANY: KANSAS CITY POWER & LIGHT CO./219330	ATC TOWER SERVICES, LLC	ELIGIBLE FACILITIES REQUEST ENTITLED TO EXPEDITED REVIEW UNDER 47 U.S.C. § 1455(A) AS A MODIFICATION OF AN	R-603	SUPPLEMENTAL				
CO./219330 PHONE: 888-471-5275	3500 REGENCY PKWY STE 100	EXISTING WIRELESS TOWER THAT INVOLVES THE	R-604	SUPPLEMENTAL				
TELEPHONE COMPANY: N/A	CARY, NC 27518	COLLOCATION, REMOVAL, AND/OR REPLACEMENT OF TRANSMISSION EQUIPMENT THAT IS NOT A SUBSTANTIAL						۱Ĕ
PHONE: N/A	PROPERTY OWNER:	CHANGE UNDER CFR § 1.61000 (B)(7).						Ħ
044	N/A 2200 LOWENSTEIN	PROJECT LOCATION DIRECTIONS						H
	LEES SIMMIT, MISSOURI 64081-	FROM DOWNTOWN KANSAS CITY, MO TAKE I-70 EAST TO I-435 SOUTH, TAKE RAMP ONTO I-470 [SR-291], AT EXIT 7A, TURN RIGHT						11
		ONTO RAMP, BEAR RIGHT (SOUTH) ONTO US-50 [SR-350] 0.4 MI,				<u> </u>		$\ \cdot\ $
Know what's below.		KEEP RIGHT ONTO RAMP, TURN RIGHT (WEST) ONTO NW CHIPMAN RD 0.9 MI, TURN RIGHT (NORTH) ONTO NW BLACKTWIG LN 0.3 MI,						1 [
Call before you dig.		TURN LEFT (NORTH-WEST) ONTO NW LOWENSTEIN DR 98 YDS, TURN RIGHT (NORTH-EAST) ONTO ACCESS ROAD(S), ARRIVE AT						11
Gair belote you dig.		SITE, SITE IS ON NORTH SIDE OF ROAD THRU ACCESS GATE						1 L





Wixom, Michigan 48393 PHONE: (248) 705-9212

REV.	DESCRIPTION	BY	DATE
A.	PRELIM	<u>HEG</u>	03/14/22
<u></u>	FINAL CD	HEG	03/24/22
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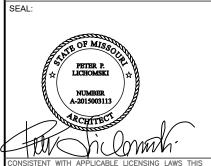
ATC SITE NUMBER:

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LEE S SUMMIT 1B

SITE ADDRESS: 2200 LOWENSTEIN LEES SIMMIT. MISSOURI 64081-1905



T··Mobile

		03/24/2022
	ATC JOB NO:	13958500
	CUSTOMER #:	A5C0676A

TITLE SHEET

G-001

GENERAL CONSTRUCTION NOTES:

- OWNER FURNISHED MATERIALS, T-MOBILE "THE COMPANY" WILL PROVIDE AND THE CONTRACTOR WILL INSTALL
- A. BTS EQUIPMENT FRAME (PLATFORM) AND ICEBRIDGE SHELTER (GROUND BUILD/CO-LOCATE ONLY)
- B. AC/TELCO INTERFACE BOX (PPC)
- C. ICE BRIDGE (CABLE TRAY WITH COVER) (GROUND BUILD/CO-LOCATE ONLY, GC TO FURNISH AND INSTALL FOR ROOFTOP INSTALLATION)
- TO FURNISH AND INSTALL
 D. TOWERS. MONOPOLES
- E. TOWER LIGHTING
- F. GENERATORS & LIQUID PROPANE TANK
- G. ANTENNA STANDARD BRACKETS, FRAMES AND PIPES FOR MOUNTING
- H. ANTENNAS (INSTALLED BY OTHERS)
- I. TRANSMISSION LINE
- J. TRANSMISSION LINE JUMPERS
- K. TRANSMISSION LINE CONNECTORS WITH WEATHERPROOFING KITS
- L. TRANSMISSION LINE GROUND KITS
- M. HANGERS
- N. HOISTING GRIPS
- O. BTS EQUIPMENT
- 2. THE CONTRACTOR IS RESPONSIBLE TO PROVIDE ALL OTHER MATERIALS FOR THE COMPLETE INSTALLATION OF THE SITE INCLUDING, BUT NOT LIMITED TO, SUCH MATERIALS AS FENCING, STRUCTURAL STEEL SUPPORTING SUB-FRAME FOR PLATFORM, ROOFING LABOR AND MATERIALS, GROUNDING RINGS, GROUNDING WIRES, COPPER-CLAD OR XIT CHEMICAL GROUND ROD(S), BUSS BARS, TRANSFORMERS AND DISCONNECT SWITCHES WHERE APPLICABLE, TEMPORARY ELECTRICAL POWER, CONDUIT, LANDSCAPING COMPOUND STONE, CRANES, CORE DRILLING, SLEEPERS AND RUBBER MATTING, REBAR, CONCRETE CAISSONS, PADS AND/OR AUGER MOUNTS, MISCELLANEOUS FASTENERS, CABLE TRAYS, NON-STANDARD ANTENNA FRAMES AND ALL OTHER MATERIAL AND LABOR REQUIRED TO COMPLETE THE JOB ACCORDING TO THE DRAWINGS AND SPECIFICATIONS. IT IS THE POSITION OF T-MOBILE TO APPLY FOR PERMITTING AND CONTRACTOR RESPONSIBLE FOR PICKUP AND PAYMENT OF REQUIRED PERMITS.
- ALL WORK SHALL CONFORM TO ALL CURRENT APPLICABLE FEDERAL, STATE, AND LOCAL CODES, INCLUDING ANSI/EIA/TIA-222, AND COMPLY WITH ATC CONSTRUCTION SPECIFICATIONS.
- 4. CONTRACTOR SHALL CONTACT LOCAL 811 FOR IDENTIFICATION OF UNDERGROUND
- CONTRACTOR SHALL BE RESPONSIBLE FOR COORDINATING ALL REQUIRED INSPECTIONS.
- ALL DIMENSIONS TO, OF, AND ON EXISTING BUILDINGS, DRAINAGE STRUCTURES, AND SITE IMPROVEMENTS SHALL BE VERIFIED IN FIELD BY CONTRACTOR WITH ALL DISCREPANCIES REPORTED TO THE ENGINEER.
- 7. DO NOT CHANGE SIZE OR SPACING OF STRUCTURAL ELEMENTS
- DETAILS SHOWN ARE TYPICAL; SIMILAR DETAILS APPLY TO SIMILAR CONDITIONS UNLESS OTHERWISE NOTED.
- THESE DRAWINGS DO NOT INCLUDE NECESSARY COMPONENTS FOR CONSTRUCTION
 SAFETY WHICH SHALL BE THE SOLE RESPONSIBILITY OF THE CONTRACTOR.
- CONTRACTOR SHALL BRACE STRUCTURES UNTIL ALL STRUCTURAL ELEMENTS NEEDED FOR STABILITY ARE INSTALLED. THESE ELEMENTS ARE AS FOLLOWS: LATERAL BRACING, ANCHOR BOLTS, ETC.
- 11. CONTRACTOR SHALL DETERMINE EXACT LOCATION OF EXISTING UTILITIES, GROUNDS DRAINS, DRAIN PIPES, VENTS, ETC. BEFORE COMMENCING WORK.
- 12. INCORRECTLY FABRICATED, DAMAGED, OR OTHERWISE MISFITTING OR NONCONFORMING MATERIALS OR CONDITIONS SHALL BE REPORTED TO THE T-MOBILE REP PRIOR TO REMEDIAL OR CORRECTIVE ACTION. ANY SUCH REMEDIAL ACTION SHALL REQUIRE WRITTEN APPROVAL BY THE T-MOBILE REP PRIOR TO PROCEEDING.
- 13. EACH CONTRACTOR SHALL COOPERATE WITH THE T-MOBILE REP, AND COORDINATE HIS WORK WITH THE WORK OF OTHERS.
- 14. CONTRACTOR SHALL REPAIR ANY DAMAGE CAUSED BY CONSTRUCTION OF THIS PROJECT TO MATCH EXISTING PRE-CONSTRUCTION CONDITIONS TO THE SATISFACTION OF THE T-MORILE CONSTRUCTION MANAGER
- 15. ALL CABLE/CONDUIT ENTRY/EXIT PORTS SHALL BE WEATHERPROOFED DURING INSTALLATION USING A SILICONE SEALANT.
- WHERE EXISTING CONDITIONS DO NOT MATCH THOSE SHOWN IN THIS PLAN SET, CONTRACTOR SHALL NOTIFY THE T-MOBILE REP AND ENGINEER OF RECORD IMMEDIATELY.
- 17. CONTRACTOR SHALL ENSURE ALL SUBCONTRACTORS ARE PROVIDED WITH A COMPLETE AND CURRENT SET OF DRAWINGS AND SPECIFICATIONS FOR THIS PROJECT.
- 18. CONTRACTOR SHALL REMOVE ALL RUBBISH AND DEBRIS FROM THE SITE AT THE END OF
- CONTRACTOR SHALL COORDINATE WORK SCHEDULE WITH AMERICAN TOWER CORPORATION (ATC), AND TAKE PRECAUTIONS TO MINIMIZE IMPACT AND DISRUPTION OF OTHER OCCUPANTS OF THE FACILITY.
- CONTRACTOR SHALL FURNISH T-MOBILE AND AMERICAN TOWER CORPORATION (ATC)
 WITH A PDF MARKED UP AS-BUILT SET OF DRAWINGS UPON COMPLETION OF WORK.
- PRIOR TO SUBMISSION OF BID, CONTRACTOR SHALL COORDINATE WITH T-MOBILE REP
 TO DETERMINE WHAT, IF ANY, ITEMS WILL BE PROVIDED. ALL ITEMS NOT PROVIDED
 SHALL BE PROVIDED AND INSTALLED BY THE CONTRACTOR. CONTRACTOR WILL INSTALL
 ALL ITEMS PROVIDED.

- 22. PRIOR TO SUBMISSION OF BID, CONTRACTOR SHALL COORDINATE WITH T-MOBILE REP TO DETERMINE IF ANY PERMITS WILL BE OBTAINED BY CONTRACTOR. ALL REQUIRED PERMITS NOT OBTAINED BY T-MOBILE MUST BE OBTAINED, AND PAID FOR, BY THE CONTRACTOR.
- 23. CONTRACTOR SHALL INSTALL ALL SITE SIGNAGE IN ACCORDANCE WITH T-MOBILE SPECIFICATIONS AND REQUIREMENTS.
- 24. CONTRACTOR SHALL SUBMIT ALL SHOP DRAWINGS TO T-MOBILE FOR REVIEW AND APPROVAL PRIOR TO FABRICATION.
- ALL EQUIPMENT SHALL BE INSTALLED ACCORDING TO MANUFACTURER'S SPECIFICATIONS AND LOCATED ACCORDING TO T-MOBILE SPECIFICATIONS, AND AS SHOWN IN THESE PLANS.
- 26. THE CONTRACTOR SHALL SUPERVISE AND DIRECT THE PROJECT DESCRIBED HEREIN. THE CONTRACTOR SHALL BE SOLELLY RESPONSIBLE FOR ALL THE CONSTRUCTION MEANS, METHODS, TECHNIQUES, SEQUENCES AND PROCEDURES AND FOR COORDINATING ALL PORTIONS OF THE WORK UNDER THE CONTRACT.
- CONTRACTOR SHALL NOTIFY T-MOBILE REP A MINIMUM OF 48 HOURS IN ADVANCE OF POURING CONCRETE OR BACKFILLING ANY UNDERGROUND UTILITIES, FOUNDATIONS OR SEALING ANY WALL, FLOOR OR ROOF PENETRATIONS FOR ENGINEERING REVIEW AND APPROVAL
- CONTRACTOR SHALL BE RESPONSIBLE FOR SITE SAFETY INCLUDING COMPLIANCE WITH ALL APPLICABLE OSHA STANDARDS AND RECOMMENDATIONS AND SHALL PROVIDE ALL NECESSARY SAFETY DEVICES INCLUDING PIPE AND PPM AND CONSTRUCTION DEVICES SUCH AS WELDING AND FIRE PREVENTION, TEMPORARY SHORING, SCAFFOLDING, TRENCH BOXES/SLOPING, BARRIERS, ETC.
- 29. THE CONTRACTOR SHALL PROTECT AT HIS OWN EXPENSE, ALL EXISTING FACILITIES AND SUCH OF HIS NEW WORK LIABLE TO INJURY DURING THE CONSTRUCTION PERIOD. ANY DAMAGE CAUSED BY NEGLECT ON THE PART OF THIS CONTRACTOR OR HIS REPRESENTATIVES, OR BY THE ELEMENTS DUE TO NEGLECT ON THE PART OF THIS CONTRACTOR OR HIS REPRESENTATIVES, EITHER TO THE EXISTING WORK, OR TO HIS WORK OR THE WORK OF ANY OTHER CONTRACTOR, SHALL BE REPAIRED AT HIS EXPENSE TO THE OWNER'S SATISFACTION.
- 30. ALL WORK SHALL BE INSTALLED IN A FIRST CLASS, NEAT AND WORKMANLIKE MANNER BY MECHANICS SKILLED IN THE TRADE INVOLVED. THE QUALITY OF WORKMANSHIP SHALL BE SUBJECT TO THE APPROVAL OF THE T-MOBILE REP. ANY WORK FOUND BY THE T-MOBILE REP TO BE OF INFERIOR QUALITY AND/OR WORKMANSHIP SHALL BE REPLACED AND/OR REWORKED AT CONTRACTOR EXPENSE UNTIL APPROVAL IS ORTAINED.
- 31. IN ORDER TO ESTABLISH STANDARDS OF QUALITY AND PERFORMANCE, ALL TYPES OF MATERIALS LISTED HEREINAFTER BY MANUFACTURER'S NAMES AND/OR MANUFACTURER'S CATALOG NUMBER SHALL BE PROVIDED BY THESE MANUFACTURERS AS SPECIFIED
- 32. T-MOBILE FURNISHED EQUIPMENT SHALL BE PICKED-UP AT THE T-MOBILE WAREHOUSE, NO LATER THAN 48HR AFTER BEING NOTIFIED INSURED, STORED, UNCRATE, PROTECTED AND INSTALLED BY THE CONTRACTOR WITH ALL APPURTENANCES REQUIRED TO PLACE THE EQUIPMENT IN OPERATION, READY FOR USE. THE CONTRACTOR SHALL BE RESPONSIBLE FOR THE EQUIPMENT AFTER PICKING IT UP.
- 33. T-MOBILE OR HIS ARCHITECT/ENGINEER RESERVES THE RIGHT TO REJECT ANY EQUIPMENT OR MATERIALS WHICH, IN HIS OWN OPINION ARE NOT IN COMPLIANCE WITH THE CONTRACT DOCUMENTS, EITHER BEFORE OR AFTER INSTALLATION AND THE EQUIPMENT SHALL BE REPLACED WITH EQUIPMENT CONFORMING TO THE REQUIREMENTS OF THE CONTRACT DOCUMENTS BY THE CONTRACTOR AT NO COST TO T-MOBILE OR THEIR ARCHITECT/ENGINEER.

SPECIAL CONSTRUCTION ANTENNA INSTALLATION NOTES:

- WORK INCLUDED:
 - A. ANTENNA AND COAXIAL CABLES ARE FURNISHED BY T-MOBILE UNDER A SEPARATE CONTRACT. THE CONTRACTOR SHALL ASSIST ANTENNA INSTALLATION CONTRACTOR IN TERMS OD COORDINATION AND SITE ACCESS. ERECTION SUBCONTRACTOR SHALL BE RESPONSIBLE FOR THE PROTECTION OF PERSONNEL AND
 - B. INSTALL ANTENNA AS INDICATE ON DRAWINGS AND T-MOBILE SPECIFICATIONS.
 - $\hbox{C.} \quad \hbox{INSTALL GALVANIZED STEEL ANTENNA MOUNTS AS INDICATED ON DRAWINGS}$
 - D. INSTALL FURNISHED GALVANIZED STEEL OR ALUMINUM WAVEGUIDE AND PROVIDE PRINTOUT OF THAT TEST.
 - E. CONTRACTOR SHALL PROVIDE FOUR (4) SETS OF SWEEP TESTS USING ANRITZU-PACKARD 8713B RF SCALAR NETWORK ANALYZER. SUBMIT FREQUENCY DOMAIN REFLECTOMETER(FDR) TESTS RESULTS TO THE PROJECT MANAGER. SWEEP TESTS SHALL BE AS PER ATTACHED RFS "MINIMUM FIELD TESTING RECOMMENDED FOR ANTENNA AND HELIAX COAXIAL CABLE SYSTEMS" DATED 10/5/93. TESTING SHALL BE PERFORMED BY AN INDEPENDENT TESTING SERVICE AND BE BOUND AND SUBMITTED WITHIN ONE WEEK OF WORK COMPLETION.
 - F. INSTALL COAXIAL CABLES AND TERMINATING BETWEEN ANTENNAS AND EQUIPMENT PER MANUFACTURER'S RECOMMENDATIONS. WEATHERPROOF ALL CONNECTIONS BETWEEN THE ANTENNA AND EQUIPMENT PER MANUFACTURER'S REQUIREMENTS. TERMINATE ALL COAXIAL CABLE THREE (3) FEET IN EXCESS OF ENTRY PORT LOCATION UNLESS OTHERWISE STATED.
 - G. ANTENNA AND COAXIAL CABLE GROUNDING:
- ALL EXTERIOR #6 GREED GROUND WIRE "DAISY CHAIN" CONNECTIONS ARE TO BE WEATHER SEALED WITH RFS CONNECTORS/SPLICE WEATHERPROOFING KIT #221213 OR FOLIAL
- 3. ALL COAXIAL CABLE GROUNDING KITS ARE TO BE INSTALLED ON STRAIGHT RUNS OF

COAXIAL CABLE (NOT WITHIN BENDS)

ALL DISCREPANCIES FROM WHAT IS SHOWN ON THESE
CONSTRUCTION DRAWINGS SHALL BE COMMUNICATED TO ATC
ENGINEERING IMMEDIATELY FOR CORRECTION OR RE-DESIGN.
FAILURE TO COMMUNICATE DIRECTLY WITH ATC ENGINEERING OR
ANY CHANGES FROM THE DESIGN CONDUCTED WITHOUT PRIOR
APPROVAL FROM ATC ENGINEERING SHALL BE THE SOLE
RESPONSIBILITY OF THE GENERAL CONTRACTOR.





Wixom, Michigan 48393
PHONE: (248) 705-9212

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<u> </u>	PRELIM	HEG	03/14/22
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ATC SITE NUMBER:

36075 ATC SITE NAME:

LEE S SUMMIT 1B

SITE ADDRESS: 2200 LOWENSTEIN LEES SIMMIT MISSOLIEI 64081-1905

SEAL:



CONSISTENT WITH APPLICABLE LICENSING LAWS THIS SEAL CERTIFIES THAT THE ARCHITECTURAL DESIGN WOR WAS PREPARED EITHER PERSONALLY BY ME OR UNDER MY IMMEDIATE AND DIRECT SUPERVISION AND CONTROL

T · · Mobile ·

DATE DRAWN: 03/24/2022 ATC JOB NO: 13958500 CUSTOMER #: A5C0676A

GENERAL NOTES

SHEET NUMBER:

G-002

SITE PLAN NOTES:

TRN

- THIS SITE PLAN REPRESENTS THE BEST PRESENT KNOWLEDGE AVAILABLE TO THE ENGINEER AT THE TIME OF THIS DESIGN. THE CONTRACTOR SHALL VISIT THE SITE PRIOR TO CONSTRUCTION AND VERIFY ALL EXISTING CONDITIONS RELATED TO THE SCOPE OF WORK FOR THIS PROJECT.
- 2. ICE BRIDGE, CABLE LADDER, COAX PORT, AND COAX CABLE ARE SHOWN FOR REFERENCE ONLY. CONTRACTOR SHALL CONFIRM THE EXACT LOCATION OF ALL PROPOSED AND EXISTING EQUIPMENT AND STRUCTURES DEPICTED ON THIS PLAN. BEFORE UTILIZING EXISTING CABLE SUPPORTS, COAX PORTS, INSTALLING NEW PORTS OR ANY OTHER EQUIPMENT, CONTRACTOR SHALL VERIFY ALL ASPECTS OF THE COMPONENTS MEET THE ATC SPECIFICATIONS.


LEGEND GROUNDING TEST WELL ⊗ AUTOMATIC TRANSFER SWITCH ATS **BOLLARD** CSC CELL SITE CABINET DISCONNECT ELECTRICAL FIBER GEN **GENERATOR** GENERATOR RECEPTACAL G HH, V HAND HOLE, VAULT ICE BRIDGE ΙB KENTROX BOX LC LIGHTING CONTROL METER РΒ PULL BOX PP POWER POLE TELCO

TRANSFORMER

CHAINLINK FENCE

PROPOSED CABLE LENGTH:

- ESTIMATED LENGTH OF PROPOSED CABLE IS 244'-5".
 ESTIMATED LENGTH OF CABLE WAS PROVIDED BY CUSTOMER OR CALCULATED BY ADDING THE RAD CENTER AND THE DISTANCE FROM EQUIPMENT LOCATION TO THE TOWER (ALONG THE ICE BRIDGE) AND A SAFETY FACTOR MEASUREMENT OF 15% (OF THE TWO PREVIOUS VALUES), CDS DEFER TO GREATEST CABLE LENGTH.
- 2. ROUTE PROPOSED CABLES ALONG SAME PATH AS EXISTING CABLES AND IN ACCORDANCE WITH STRUCTURAL ANALYSIS. IF ADEQUATE SPACE EXISTS, ROUTE CABLES THROUGH ENTRY PORT HOLE, UP INSIDE OF MONOPOLE, AND THROUGH EXIT PORT HOLE. IF ROUTING OUTSIDE THE MONOPOLE, ATTACH CABLES USING STAND-OFF ADAPTERS MOUNTED TO TOWER USING STAINLESS STEEL BANDING. ADEQUATELY SECURE CABLES USING EITHER APPROPRIATELY SIZED STAINLESS STEEL SNAP-INS OR MOUNTING HARDWARE AND BRACKETS AS SPECIFIED BY CABLE MANUFACTURER.

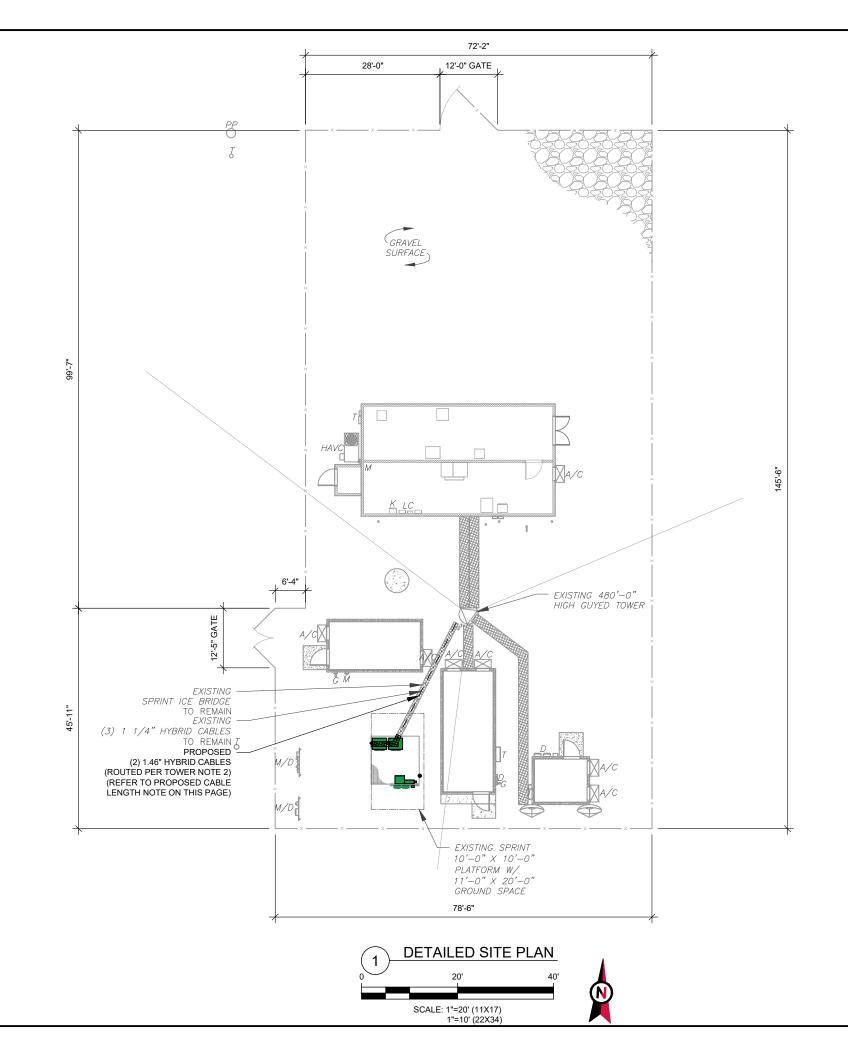





49030 Pontiac Trail, Suite 400 Wixom, Michigan 48393 PHONE: (248) 705-9212

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T··Mobile

DATE DRAWN:	03/24/2022
ATC JOB NO:	13958500
CUSTOMER #:	A5C0676A

DETAILED SITE PLAN

SHEET NUMBER:


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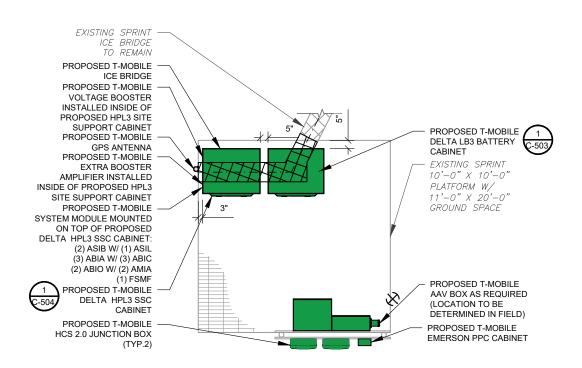
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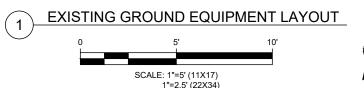
SITE PLAN NOTES:

- CONTRACTOR TO VERIFY THERE IS NO LIVE AAV FIBER RUNNING THROUGH EXISTING DEAD EQUIPMENT. IF SO, THIS WILL NEED TO BE RERUN THROUGH CONDUIT PRIOR TO REMOVING DEAD 2G (6201 CABS) EQUIPMENT.
- 2. REMOVE EXISTING 2G CABINETS, AND POWER / TELCO WHIPS ASSOCIATED WITH THE DEAD EQUIPMENT IF APPLICABLE.
- 3. ALL OPEN PORTS NEED TO BE SEALED / WEATHERPROOFED PROPERLY
- 4. ALL UNNEEDED / EXCESS EQUIPMENT AND GARBAGE TO BE REMOVED FROM EQUIPMENT AREA. DISPOSE OF MATERIALS PROPERLY OFF SITE.






MIN (2) PROPOSED T-MOBILE WORK LIGHTS - LOCATION TO BE DETERMINED IN FIELD

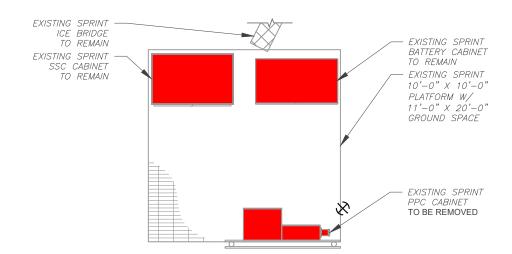






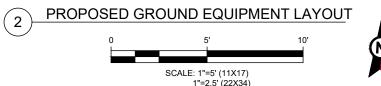



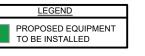





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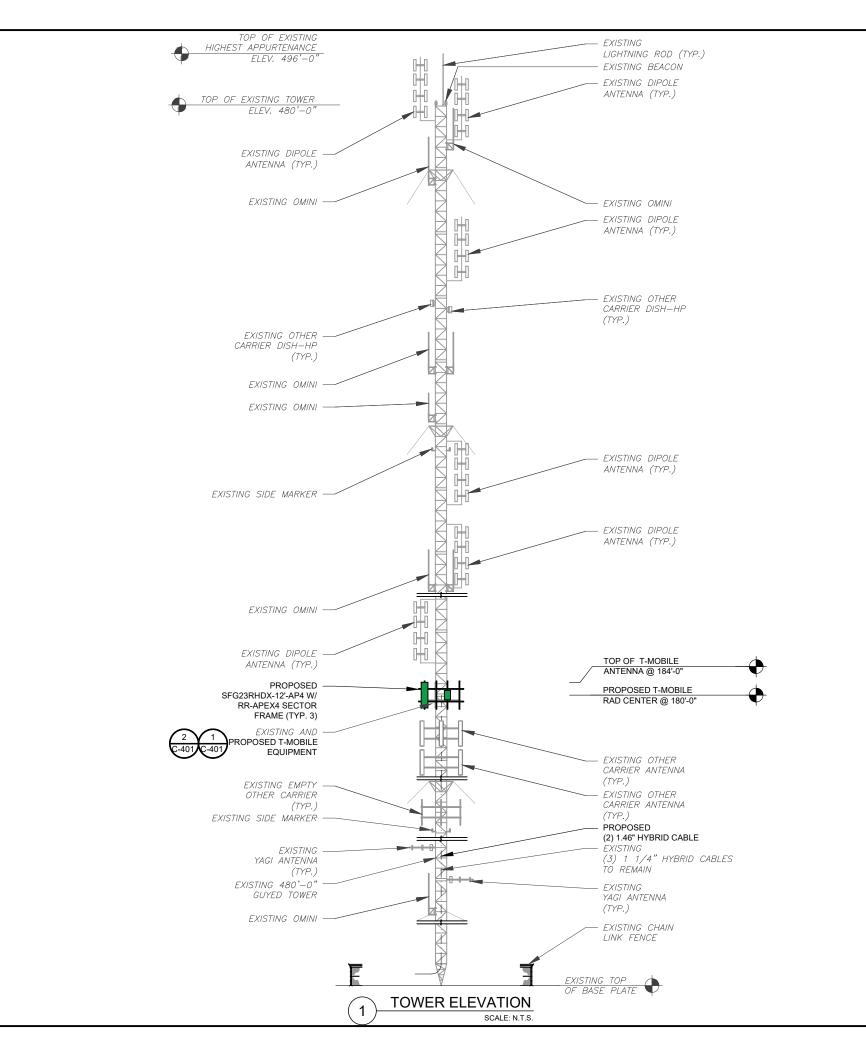
DATE DRAWN:	03/24/2022
ATC JOB NO:	13958500
CLISTOMER #	Δ5C0676Δ

DETAILED GROUND PLAN

SHEET NUMBER:

C-102

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NOTES: THIS DRAWING IS FOR EXHIBIT AND

PLEASE REFER TO STRUCTURAL

DOCUMENTS (PREPARED BY OTHERS) FOR PROJECT STRUCTURAL CALCULATION AND

NO WORK IS TO BE DONE WITHOUT

GC TO VERIFY ALL HEIGHTS AND

AZIMUTHS IN FIELD PRIOR TO CONSTRUCTION. GC SHALL NOTIFY P.M. AND

ARCHITECT/ENGINEER OF ANY DISCREPANCIES IMMEDIATELY.

STRUCTURAL/ DESIGN &

ANALYSIS SHALL BE PERFORMED

& APPROVED BY TOWER OWNER

CONTRACTOR TO THOROUGHLY

TYPES, ANTENNA HEIGHTS, AND CABLE ROUTING, ANY OTHER

DISCREPANCIES BETWEEN THE DRAWINGS, STRUCTURAL ANALYSIS, AND TOWER PLANS SHOULD BE BROUGHT TO THE ATTENTION OF THE PROJECT

MANAGER PRIOR TO BIDDING

IT IS THE CONTRACTOR'S RESPONSIBILITY TO

CONSTRUCTION MANAGER THAT THEY HAVE THE

APPURTENANCES, MOUNTS, AND ANTENNAS ARE

SHOWN BASED ON THE STRUCTURAL ANALYSIS.
ROUTE PROPOSED CABLES ALONG SAME PATH
AS EXISTING CABLES AND IN ACCORDANCE WITH

UTILIZE EXISTING CABLE SUPPORT STRUCTURES

MANUFACTURER. OTHERWISE, ATTACH CABLES

USING PROPOSED STAINLESS STEEL ADAPTERS

TOWER ELEVATIONS ARE MEASURED FROM TOP OF BASE PLATE TO MATCH STRUCTURAL ANALYSIS. ELEVATIONS DO NOT REFLECT TRUE

TO HORIZONTAL OR DIAGONAL TOWER MEMBERS

MOST RECENT VERSION OF THE STRUCTURAL

CONFIRM WITH THE AMERICAN TOWER

ANALYSIS BEFORE COMMENCING WORK.

STRUCTURAL ANALYSIS. WHERE POSSIBLE

APPROPRIATELY SIZED STAINLESS STEEL

SNAP-INS OR MOUNTING HARDWARE AND

AS PROVIDED FOR CARRIER TO ADEQUATELY

EXISTING AND PROPOSED TOWER

SECURE CABLES, USING EITHER

BRACKETS AS SPECIFIED BY CABLE

(DO NOT ATTACH TO TOWER LEG).

ABOVE GROUND LEVEL (A.G.L.)

AND INSTALLATION.

AND MANUFACTURER

STRUCTURAL ANALYSIS PERFORMED BY OTHERS.

REVIEW THE TOWER STRUCTURAL ANALYSIS FOR INFORMATION PERTAINING TO TOWER UPGRADES, MOUNTING

OTHERS)

(STRUCTURAL ANALYSIS BY

ANALYSIS PROVIDED BY OTHERS.

AN APPROVED STRUCTURAL

LAYOUT PURPOSES ONLY.

RESULTS.

SPECIAL NOTES:

49030 Pontiac Trail, Suite 400 Wixom, Michigan 48393 PHONE: (248) 705-9212

REV.	DESCRIPTION	BY	DATE
<u> </u>	PRELIM	HEG	03/14/22
<u>^</u>	FINAL CD	<u>HEG</u>	03/24/22
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ATC SITE NUMBER: 36075

ATC SITE NAME:

LEE S SUMMIT 1B

SITE ADDRESS: 2200 LOWENSTEIN LEES SIMMIT, MISSOURI 64081-1905

SEAL:

PETER P.
LICHOMSKI

NUMBER
A-2015003113

ARCHITECT

CONSISTENT WITH APPLICABLE LICENSING LAWS THIS SEAL CERTIFIES THAT THE ARCHITECTURAL DESIGN WORK WAS PREPARED EITHER PERSONALLY BY ME OR UNDER MY IMMEDIATE AND DIRECT SUPERVISION AND CONTROL.

T··Mobile·


DATE DRAWN: 03/24/2022
ATC JOB NO: 13958500
CUSTOMER #: A5C0676A


TOWER ELEVATION

C-201

REVISION

0

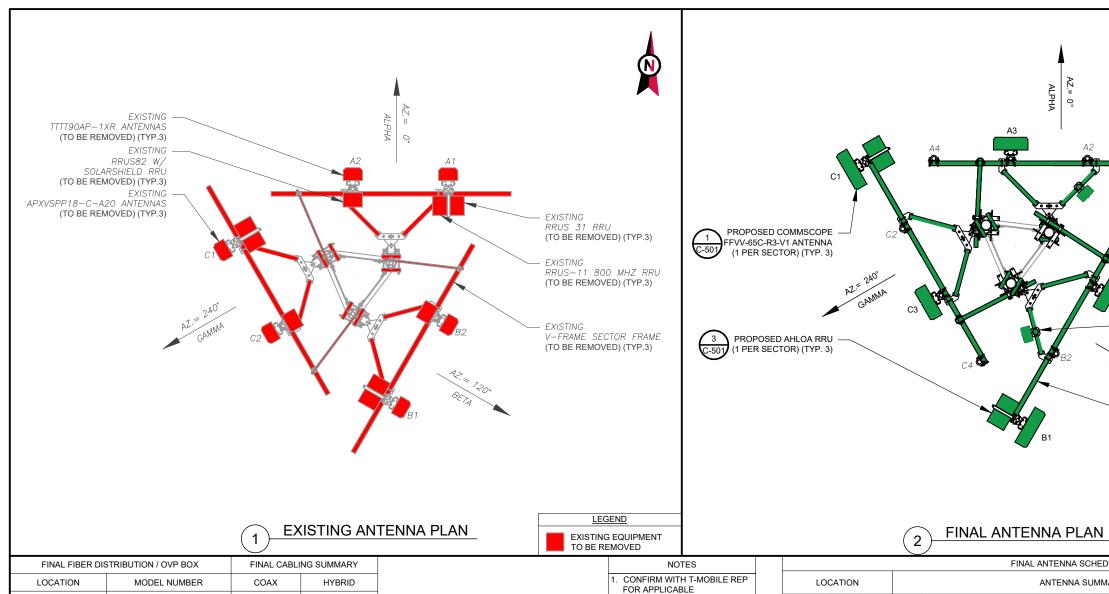

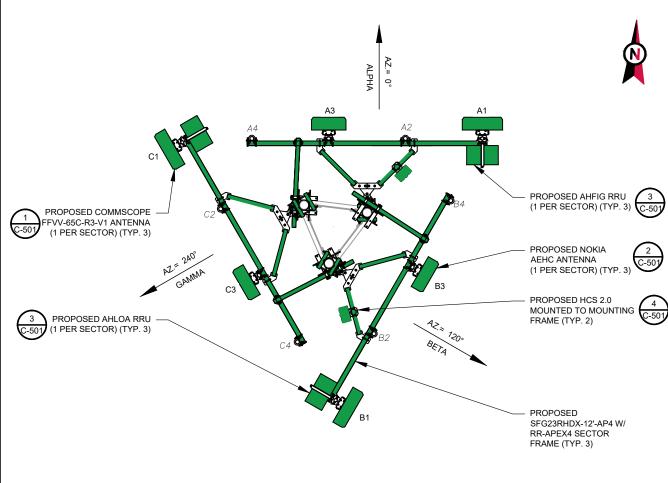

FINAL FIBER DIS	STRIBUTION / OVP BOX	FINAL CABLI	NG SUMMARY
LOCATION MODEL NUMBER		COAX	HYBRID
TOWER	(2) HELIAX FIBERFEED 12 RRU PENDANT	-	(2) 1.46"
GROUND	(2) HCS 2.0	-	(3) 1 1/4"

CABLE LENGTHS FOR JUMPERS JUNCTION BOX TO RRU: 15' RRU TO ANTENNA: 10'

1.	CONFIRM WITH T-MOBILE REP
	FOR APPLICABLE
	UPDATES/REVISIONS AND
	MOST RECENT RFDS FOR NSN
	CONFIGURATION (CONFIG). GC
	TO CAP ALL UNUSED PORTS.
2.	CONFIRM SPACING OF
	PROPOSED EQUIP DOES NOT
	CAUSE TOWER CONFLICTS
	NOR IMPEDE TOWER CLIMBING
	PEGS.

	FINAL ANTENNA SCHEDULE							
LOCATION		ANTENNA SU	ANTENNA SUMMARY			NON ANTENNA SUMMARY		
SECTOR	RAD	AZ	POS	ANTENNA	BAND	MECH. D-TILT	ELEC. D-TILT	ADDITIONAL TOWER MOUNTED EQUIPMENT
ALPHA	180'	0°	A1	COMMSCOPE FFVV-65C-R3-V1	L700/L600/N600/L2100/ L1900/G1900/LAWS3/ N2100/ N1900	0	6/6/3/3	NOKIA-AHLOA & NOKIA-AHFIG
ALPHA	-	-	A2	-	-	-	1	-
ALPHA	180'	0°	А3	NOKIA AEHC	L2500/N2500	0	4	-
ALPHA	-	-	A4	-	-	-	-	-
ВЕТА	180'	120°	B1	COMMSCOPE FFVV-65C-R3-V1	L700/L600/N600/L2100/ L1900/G1900/LAWS3/ N2100/ N1900	0	6/6/3/3	NOKIA-AHLOA & NOKIA-AHFIG
BETA	-	-	B2	-	-	-	,	-
BETA	180'	120°	В3	NOKIA AEHC	L2500/N2500	0	4	-
BETA	-	-	B4	-	-	-	-	-
GAMMA	180'	240°	C1	COMMSCOPE FFVV-65C-R3-V1	L700/L600/N600/L2100/ L1900/G1900/LAWS3/ N2100/ N1900	0	6/6/3/3	NOKIA-AHLOA & NOKIA-AHFIG
GAMMA	-	-	C2	-	-	-	-	-
GAMMA	180'	240°	C3	NOKIA AEHC	L2500/N2500	0	4	-
GAMMA	-	-	C4	-	-	-	_	-



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REV.	DESCRIPTION	BY DATE
<u> </u>	PRELIM	HEG 03/14/22
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ATC SITE NUMBER:

36075 ATC SITE NAME:

LEE S SUMMIT 1B

<u>LEGEND</u>

PROPOSED EQUIPMENT TO BE INSTALLED

SITE ADDRESS: 2200 LOWENSTEIN LEES SIMMIT, MISSOURI 64081-1905

CONSISTENT WITH APPLICABLE LICENSING LAWS THIS SEAL CERTIFIES THAT THE ARCHITECTURAL DESIGN WORK WAS PREPARED EITHER PERSONALLY BY ME OR UNDER MY IMMEDIATE AND DIRECT SUPERVISION AND CONTROL.

DATE DRAWN:	03/24/2022
ATC JOB NO:	13958500
CUSTOMER #	A5C0676A


RF SCHEDULE AND ANTENNA INSTALLATION

SHEET NUMBER:


C-401

REVISION: 0

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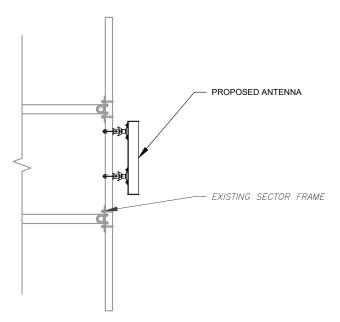


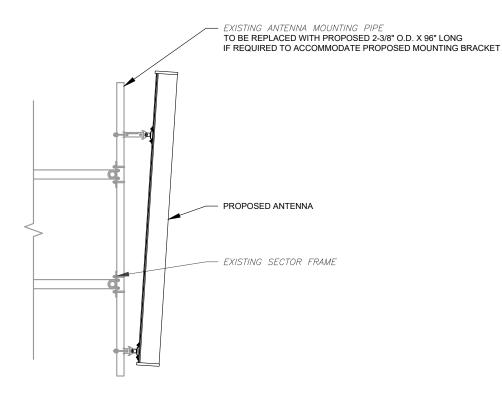PROPOSED ANTENNA MOUNTING DETAIL - TYPICAL
SCALE: N.T.S

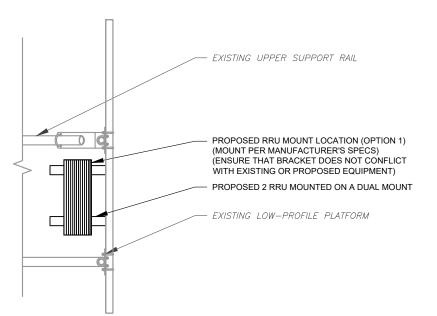


PROPOSED RRU MOUNTING DETAIL - TYPICAL

SCALE: N.T.S.



PROPOSED 5G ANTENNA MOUNTING DETAIL - TYPICAL

SCALE: N.T.S.

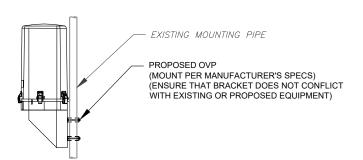

4 PROPOSED OVP MOUNTING
SCALE: N.T.S.





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REV.	DESCRIPTION	BY	DATE
A_	PRELIM	<u>HEG</u>	03/14/22
△_	FINAL CD	HEG	03/24/22
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ATC SITE NUMBER:

36075

ATC SITE NAME:

LEE S SUMMIT 1B

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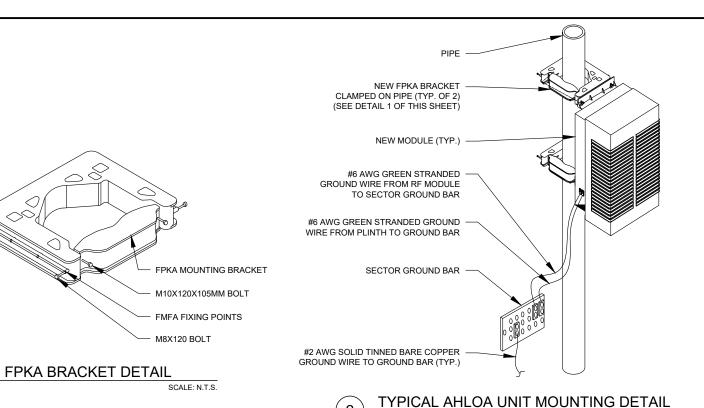
DATE DRAWN:	03/24/2022
ATC JOB NO:	13958500
CUSTOMER #:	A5C0676A

CONSTRUCTION DETAILS

SHEET NUMBER:

C-501

0



FRONT OF THE ANTENNA

ANTENNA #1 ANTENNA #2 ANTENNA #3 ANTENNA #4

EXAMPLE: COAX WITH FOUR BANDS OF RED TAPE WILL REPRESENT ALPHA

EXAMPLE: COAX WITH FOUR BANDS OF RED TAPE WILL REPRESENT ALPHA SECTOR AND THE 4TH PORT OF ANTENNA

SECTOR AND THE 4TH PORT OF ANTENNA

ANTENNA AND COAXIAL CABLE SCHEDULE

ID W/LABEL MAKER

ANTENNAS WILL BE LABELED (BACK OF ANTENNA VIEW) RIGHT

COAX/JUMPER LINES WILL BE IDENTIFIED BY SECTOR COLOR

AND BY NUMBER OF BANDS AROUND THE COAX/JUMPER

BLUE

YELLOW

WHITE

PURPLE

PINK

COAX COLOR CODING

SECTOR A

SECTOR B

SECTOR C

SECTOR D

SECTOR E

SECTOR F

FIBER ID

UNUSED COAX

MICROWAVE


DWE T-1'S + GPS

DOWNLINK CABLE

LMU

TO LEFT 1-X PORTS

- ALL ANTENNAS SHALL BE FURNISHED WITH DOWNTILT BRACKETS. CONTRACTOR SHALL COORDINATE REQUIRED MECHANICAL DOWNTILT FOR EACH ANTENNA WITH RF ENGINEER. ANTENNA DOWNTILT SHALL BE SET AND VERIFIED BY A SMART LEVEL.
- 2. CONTRACTOR SHALL INSTALL COLOR CODE RINGS ON EACH OF THE HYBRID CABLES AND JUMPER CABLES WITH UV RESISTANT TAPE. ALL CABLE SHALL BE MARKED AT TOP AND BOTTOM WITH 2" COLOR TAPE OR STENCIL TAG. COLOR TAPE MAY BE OBTAINED FROM GRAYBAR ELECTRONICS.

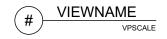

ROWN + SECTOR COLOR BANDS (1 & 2)





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REV	. DESCRIPTION	BY	DATE
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ATC SITE NUMBER:

36075

ATC SITE NAME:

LEE S SUMMIT 1B

SITE ADDRESS: 2200 LOWENSTEIN LEES SIMMIT. MISSOURI 64081-1905

SEAL:



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DATE DRAWN: 03/24/2022
ATC JOB NO: 13958500
CUSTOMER #: A5C0676A


CABLE AND MOUNTING DETAILS

SHEET NUMBER:

C-502

)2 | 0

REVISION

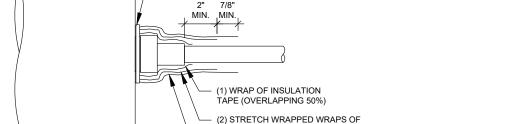

(OVERLAPPING 50%)

CABLE TIE


JUMPERS TO BE TORQUED TO 221.27 IN/LBS

RF JUMPER CONNECTION DETAIL

SCALE: N.T.S.

SELF AMALGAMATING TAPE (STRETCH 30%, OVERLAPPING 50%)

(3) WRAPS OF INSULATION TAPE

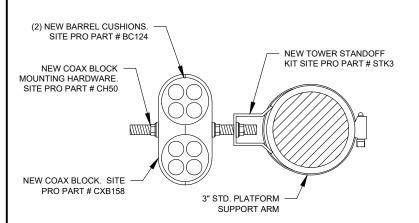

RF JUMPER MOUNTING DETAIL

SCALE: N.T.S.



Large Battery 3 Cabinet

Product Features

Compact design for battery strings:

- Direct air cooling solution
- Supports four strings of -48V VRLA batteries up to 210Ah
- 600A rated bus bar with 200A breaker per string
- · Bulk Input / Output with ability to daisy chain cabinets
- · Front to Front Air Flow
- · Corrosion resistant aluminum construction
- · Powder coated high gloss finish
- Designed to meet GR-487





Specifications

Vlodel	LB3 (Large Battery 3 Cabinet)	
1. General	a control of the control of the control of the control of the	
Construction	Aluminium enclosure	
Dimensions	30 x 72 x 35 in. (381 x 1829x 889mm),	
(W x H x D)	Depth with Door: 41.2 in. (1047mm)	
Weight	~540 lbs (~245kg) (without batteries)	
Internal rack dimension	4 battery trays to support up to 4 strings 210Ah batteries	
Mounting options	Pad-mount, plinth option	
Finish	Polyester Power Paint (Tan)	
Safety	UL Listed, IEC / EN 60950	
2. Environment		
Operating temperature	-40°C to +50°C (-40°F to +122°F) with solar load	
Protection class	IP55 designed to GR-487	
Acoustics	65dBA	
Humidity (relative)	95%, non-condensing (Max.)	
3. Thermal Managemer	nt	
Cooling Equipment:	Direct Air Cooling	
Heating Equipment:	Forced air heating (1) 1000W AC heaters	
4. Equipment		
	Knock-out plate on each upper side wall	
Cable entry	Additional knockouts each side	
Door latch	3 point latching, 5/16 nut driver tool, pad-locking capability	
Primary ground	10 double-hole 1/4"-20 threaded holes on 5/8" center ground bar	
Lifting Ears	4 Lifting Tabs	
Plinth	Optional 6" plinth available	
: IIIIII	AC Load Center:	
	30A heater breaker	
	Left or Right side AC entry options	
	AC Surge Protection (option)	
	DC Load Center:	
	600A bulk feed bus bar	
	(4) 200A bolt in battery breakers	
Standard equipment	(4) 2-hole lug landings, (2 output/2 input from second battery cabinet	
	Temp Probes	
	Battery Trays:	
	(4) battery trays	
	(4) -48V battery strings (210Ah max each)	
	Connection kit:	
	(1) DC 10A Breaker supplied (install onto HPL3 Power Cabinet)	
	LED interior cabinet light	
	(2) DC powered Axial fans with (1) F5 Filters	
Front Door:	Door intrusion alarm	
	(1) 1000W AC powered heaters	
5. Ordering information		
Cabinet	ESOF015-ECV04 Large Battery 3 (LB3) Cabinet	

*All specifications are subject to change without prior notice.





www.deltaww.com

LARGE BATTERY 3 CABINET MANUFACTURER DETAIL - FOR REFERENCE ONLY

SCALE: N.T.S.





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REV.	DESCRIPTION	BY	DATE
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ATC SITE NUMBER:

36075 ATC SITE NAME:

LEE S SUMMIT 1B

SITE ADDRESS: 2200 LOWENSTEIN LEES SIMMIT, MISSOURI 64081-1905

SEAL:



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DATE DRAWN: 03/24/2022
ATC JOB NO: 13958500
CUSTOMER #: A5C0676A

LARGE BATTERY 3
CABINET
MANUFACTURER DETAIL

SHEET NUMBER

C-503

U



HP-Large 3 Power Cabinet

Product Features

Compact design for equipment, power and battery:

- · 30RU supports 3 radios and transport equipment
- 600A @ -48V power system
- · Slimline high efficiency rectifier
- ORION Touch screen Controller
- Rear Access Hatch

Direct air cooling solution, 6000W capacity, 5°C delta T Easy slide-in filter replacement for Merv-13 or Gore filter connects with:

- · SB3, 2-string battery cabinet
- · LB3, 4-string battery cabinet
- V2, Expansion equipment and battery cabinet

Designed to GR-487 specifications

www.deltaww.com





Specifications

1.5	
Model	HP-Large 3 Power Cabinet
1. General	
Construction	Aluminum enclosure
Dimensions (Wx Hx D)	30 x 72 x 36 in. (762 x 1829 x 914 mm), Depth with door: 43 in. (1092 mm)
Weight	~551 lbs (~270kg) (without customer equipment or batteries)
Internal rack dimension	Total Equipment space, 30RU: Horizontal rack: 19" x 27RU Vertical rack: 19" x 3RU
	Power System space: 23" x 12RU
Mounting options	Pad-mount, plinth option
Finish	Polyester Powder Paint (Tan)
Safety	UL Listed, IEC/EN 60950
2. Environment	
Operating temperature	-40°C to +50°C (-40°F to +122°F) with solar load. IP55

Protection class		designed to GR-487	
Acoustics Humidity (relative)		5°C delta T: 70 dBA @ 6000W, 65dBA @5000W heat load 95%,non-condensing (Max.)	
Cooling	Equipment:	Direct Air Cooling, 6000W capacity, 5°C delta T (6) centrifugal redundant fans, (3) Merv-13 or optional GORE filters front door (3) Merv-13 filters Rear hatch	
Heating	Equipment:	Forced air, heating (2) 1000W AC heaters	

4. Equipment			
	Knock-out plate on e	each upper side wall	
Cable Entry	Additional knockouts	s each side	
	(1) 3" conduit hole w	ith hole plug	
Door latch	3 point latching, 5/16	nut driver tool, pad-locking capability	
Primary ground		0 threaded holes on 5/8" center ground bar	
Lifting Ears	4 Lifting Tabs		
Standard equipment		0V split phase, dual feed / (1) 200A + (1)100A 3V 3-phase, single feed / (1) 200A	
	AC Surge Protection GFCI Receptacle 12	for each breaker feed 0V	
	(6 form-C) Alarm Ter	rmination block	
	(1) Thermal Probe		
	605A/ 54V (336kW) redundant Power System with DIN rail distribution:		
	52 poles for load (: 16 poles for batter		
	(2) SB350 generat LVD over-ride swi		
	(2) SB175 Battery		
	(2) SB350 Battery		
From	2.7	entrifugal fans with (3) MERV-13 filters, (GORE option)	
	30	arm pressure switch	
	Door intrusion a		
	(2) 1000W AC po		
	LED interior cabi		
	r Hatch: Exhaust vent with	n (3) MERV-13 filters	
5. Ordering informati			
Cabinet	ESOA600-HCU01	HP-Large 3 600A Power / Equipment Cabinet	
Rectifier	ESR-48/60A A-T	48V / 56A 3000W, 96.4%, CAN communication	
Controller (Spare)	TPS1020028AU17	Orion TOUCH Controller	

37993318816900-S Plinth for V1/V2, HPL2, HPL3, LB2 and LB3 cabinets

Delta Group Website: www.deltaww.com Product Website: www.deltapowersolutions.com United States of America & Canada: Delta Electronics U.S. Inc. 2925 E. Plano Parkway Plano, TX (Texas) 75074 Sales and Support: Sales: DEUSTPS.Sales@deltaww.com Orders: DEUSTPS.Orders@deltaww.com Field Support: 1-877-DELTA-08 option 3 (877-335-8208 option 3) DEUSTPS.Support@deltaww.com Installation Services: DEUSTPS.Services@deltaww.com DEUSTPS.RMA@deltaww.com



Front Door and Rear Hatch Open

*All specifications are subject to change without prior notice



HP-LARGE 3 POWER CABINET MANUFACTURER DETAIL - FOR REFERENCE ONLY

Plinth, 6"

SCALE: N.T.S.

MANUFACTURER DETAIL SHEET NUMBER:

13958500

HP-LARGE 3 POWER CABINET

DATE DRAWN: 03/24/2022

CUSTOMER #: A5C0676A

ATC JOB NO:

AMERICAN TOWER®

Wixom, Michigan 48393

PHONE: (248) 705-9212

ATC SITE NUMBER: 36075 ATC SITE NAME: LEE S SUMMIT 1B SITE ADDRESS: 2200 LOWENSTEIN LEES SIMMIT. MISSOURI 64081-1905

WAS PREPARED FITHER PERSONALLY BY ME OR UNDER


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HEG 03/24/22

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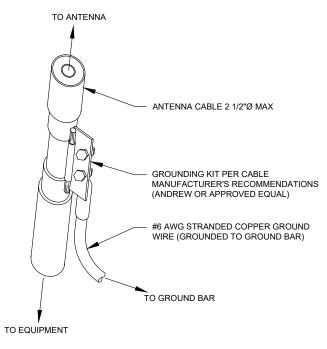
FINAL CD

C-504




- 1. THIS DETAIL IS INTENDED TO SHOW THE GENERAL GROUNDING REQUIREMENTS. SLIGHT ADJUSTMENTS MAY BE REQUIRED BASED ON EXISTING SITE CONDITIONS. THE CONTRACTOR SHALL MAKE FIELD ADJUSTMENTS AS NEEDED AND INFORM THE CONSTRUCTION MANAGER OF ANY CONFLICTS.
- SITE GROUNDING SHALL COMPLY WITH T-MOBILE GROUNDING STANDARDS, LATEST EDITION, AND COMPLY WITH T-MOBILE GROUNDING CHECKLIST, LATEST VERSION. WHEN NATIONAL AND LOCAL GROUNDING CODES ARE MORE STRINGENT THEY SHALL GOVERN.

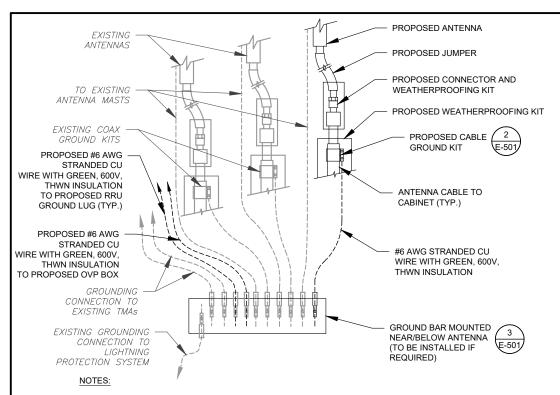



- GROUND KIT NOTES:


 1. DO NOT INSTALL CABLE GROUND KIT AT A BEND AND ALWAYS DIRECT GROUND WIRE DOWN TO GROUND BAR.
- 2. CONTRACTOR SHALL PROVIDE WEATHERPROOFING KIT (ANDREW PART NUMBER 221213) AND INSTALL/TAPE PER MANUFACTURER'S SPECIFICATIONS.

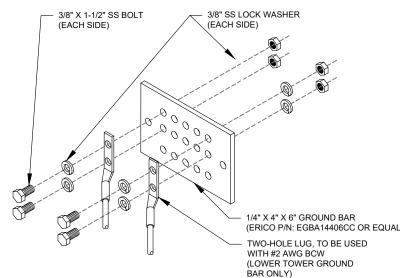

GROUND BAR NOTES:

- GROUND BAR KITS COME WITH ALL HARDWARE, NUTS, BOLTS, WASHERS, ETC. EXCEPT THE STRUCTURAL MOUNTING MEMBER(S).
- 2. GROUND BAR TO BE BONDED DIRECTLY TO TOWER.



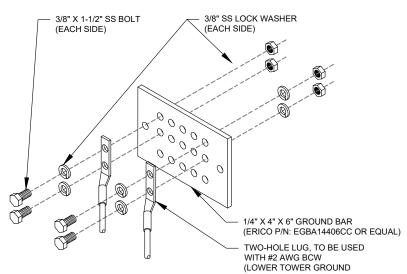

36075 ATC SITE NAME:

DESCRIPTION

FINAL CD

LEE S SUMMIT 1B

ATC SITE NUMBER:

AMERICAN TOWER®

49030 Pontiac Trail. Suite 400

Wixom, Michigan 48393


PHONE: (248) 705-9212

BY DATE

HEG 03/14/22

HEG 03/24/22

SITE ADDRESS: 2200 LOWENSTEIN LEES SIMMIT. MISSOURI 64081-1905

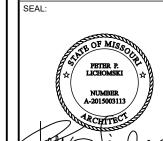

CONSISTENT WITH APPLICABLE LICENSING LAWS THIS SEAL CERTIFIES THAT THE ARCHITECTURAL DESIGN WOR WAS PREPARED FITHER PERSONALLY BY ME OR LINDER MY IMMEDIATE AND DIRECT SUPERVISION AND CONTRO

DATE DRAWN: 03/24/2022 ATC JOB NO: 13958500 CUSTOMER #: A5C0676A

GROUNDING DETAILS

SHEET NUMBER:


REVISION


E-501

ELECTRICAL NOTES:

- IT IS THE RESPONSIBILITY OF THE CONTRACTOR TO COORDINATE WITH THE T-MOBILE REPRESENTATIVE AND LOCAL UTILITY COMPANY FOR THE INSTALLATION OF CONDUITS, CONDUCTORS, BREAKERS, DISCONNECTS, OR ANY OTHER EQUIPMENT REQUIRED FOR ELECTRICAL SERVICE. ALL ELECTRICAL WORK SHALL BE PERFORMED IN ACCORDANCE WITH LATEST EDITION OF THE STATE AND NATIONAL CODES, ORDINANCES AND REGULATIONS APPLICABLE TO THIS PROJECT
- 2. ATC HAS NOT VERIFIED ANY EXISTING T-MOBILE GROUND EQUIPMENT OR ELECTRICAL LOADING. PROPOSED WORK BASED ON INSTALLATION CONFIGURATION PROVIDED BY T-MOBILE. CONTRACTOR TO VERIFY EXISTING T-MOBILE PANEL HAS SUFFICIENT SPACE FOR PROPOSED BREAKER. PROPOSED CABLE AND CONDUIT SHALL BE MINIMUM SIZE PER BELOW IN CHART.
- FOR SPECIFIC CABINET / ANCILLARY EQUIPMENT WIRING REQUIREMENTS, THE T-MOBILE CONTRACTOR SHOULD REFERENCE DESIGN DOCUMENTS PROVIDED BY T-MOBILE FOR THIS CURRENT PROJECT CONFIGURATION, IN ACCORDANCE WITH LOCAL JURISDICTION REQUIREMENTS & NEC STANDARDS & PRACTICES.

OCPD SIZE	WIRE SIZE	GROUND SIZE	CONDUIT SIZE
80A/2P	2#3 AWG	#8 AWG	1-1/4"
100/2P	2#2 AWG	#8 AWG	1-1/4"
125A/2P	2#1 AWG	#8 AWG	1-1/2"
150A/2P	2#1/0 AWG	#8 AWG	1-1/2"

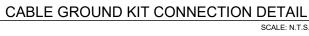

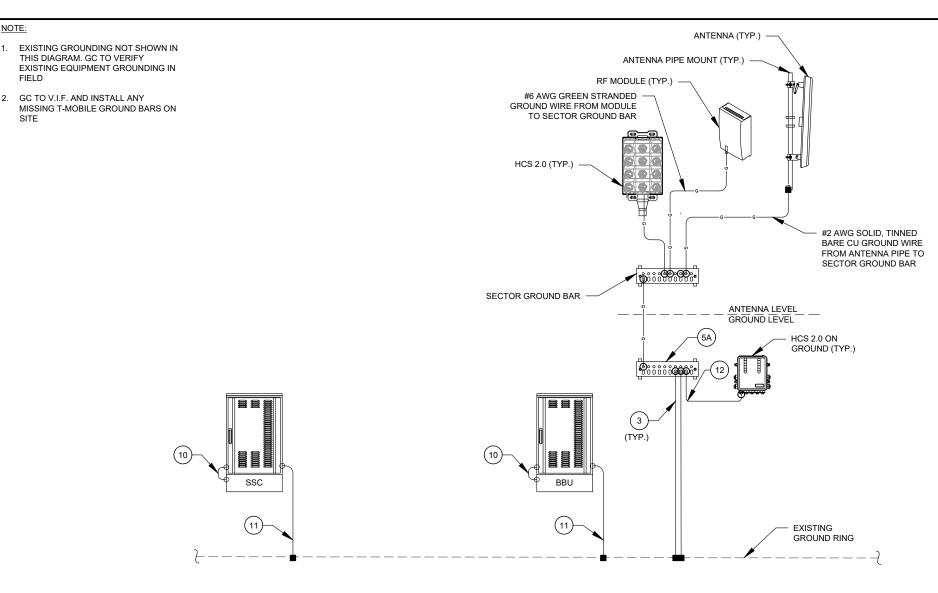


1 EQUIPMENT POWER, TELCO AND GROUNDING DIAGRAM
SCALE: N.T.S.

KEY NOTES:

- #2 SOLID, TINNED BARE COPPER GROUND WIRE FROM ICE BRIDGE TO ICE BRIDGE POST.
- (2) #2 SOLID, TINNED BARE COPPER GROUND WIRE, BOND ICE BRIDGE POST W/ VS TYPE CADWELD. (1 PER POST REQUIRED).
- 3 #2 SOLID, TINNED BARE COPPER GROUND WIRE FROM GROUND BAR TO GROUND RING (2 REQUIRED).
- #2 SOLID, TINNED BARE COPPER GROUND WIRE FROM NEW POST TO EXISTING GROUND RING
- 5 NEW GROUND BAR
- (5A) EXISTING GROUND BAR
- 6 #6 AWG GREEN STRANDED GROUND CU WIRE FROM NEW MODULES TO PLINTH
- 7 #2 AWG SOLID TINNED BARE GROUND CU WIRE FROM STEEL CUBE W/ MODULES TO GROUND RING
- (7A) #2 AWG SOLID TINNED BARE GROUND CU WIRE FROM MODULES PLINTH TO GROUND RING
- 8 #6 AWG GREEN STRANDED GROUND CU WIRE FROM MODULES TO PLINTH
- 9 #2 AWG SOLID TINNED BARE GROUND CU WIRE FROM MODULE'S PLINTH TO GROUND RING

- #6 AWG GREEN STRANDED GROUND CU WIRE FROM SSC TO SSC PLINTH
- #2 AWG SOLID TINNED BARE GROUND CU WIRE FROM SSC TO GROUND RING
- #2 AWG GREEN STRANDED CU GROUND WIRE FROM NEW COVP TO GROUND BAR
- #2 AWG GREEN STRANDED CU GROUND WIRE FROM NEW ALARM BOX TO GROUND BAR
- #6 AWG GREEN STRANDED CU GROUND WIRE FROM NEW HYBRID CABLE TO GROUND BAR
- #2 AWG GREEN STRANDED GROUND WIRE FROM NEW RF MODULE TO GROUND BAR
- #2 AWG SOLID, TINNED BARE CU GROUND WIRE FROM NEW GROUND BAR TO EXISTING GROUND RING/ROD
- #2 AWG SOLID, TINNED BARE CU GROUND WIRE FROM FCOA CABINET TO EXISTING GROUND RING/BAR
- #6 AWG SOLID, TINNED BARE CU GROUND WIRE FROM NEW DIPLEXER/TRIPLEXER TO EXISTING GROUND BAR
- #2 AWG SOLID TINNED BARE GROUND CU WIRE FROM BATTERY CABINET TO GROUND RING

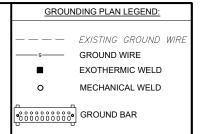





49030 Pontiac Trail, Suite 400 Wixom, Michigan 48393 PHONE: (248) 705-9212

REV.	DESCRIPTION	BY	DATE
<u> </u>	PRELIM	HEG	03/14/22
<u> </u>	FINAL CD	HEG	03/24/22
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ATC SITE NUMBER:

36075

ATC SITE NAME:

LEE S SUMMIT 1B

SITE ADDRESS: 2200 LOWENSTEIN LEES SIMMIT. MISSOURI 64081-1905

SEAL:



CONSISTENT WITH APPLICABLE LICENSING LAWS THIS SEAL CERTIFIES THAT THE ARCHITECTURAL DESIGN WORK WAS PREPARED EITHER PERSONALLY BY ME OR UNDER MY IMMEDIATE AND DIRECT SUPERVISION AND CONTROL.

T··Mobile

DATE DRAWN:	03/24/2022	
ATC JOB NO:	13958500	
CUSTOMER #:	A5C0676A	

ELECTRICAL ONE-LINE DIAGRAM

SHEET NUMBER:

E-601


1	CABINET CONFIGURATION
1)	SCALE: NOT TO SCALE

Section 3 - Proposed Template Images

56790EZ_SR_T.jpg

Configuration 56790EZ_SR_T

* For 5G and LTE Airscale BB dimensioning refer to Fiber Port matrices. (Alpha, Beta & Gamma)

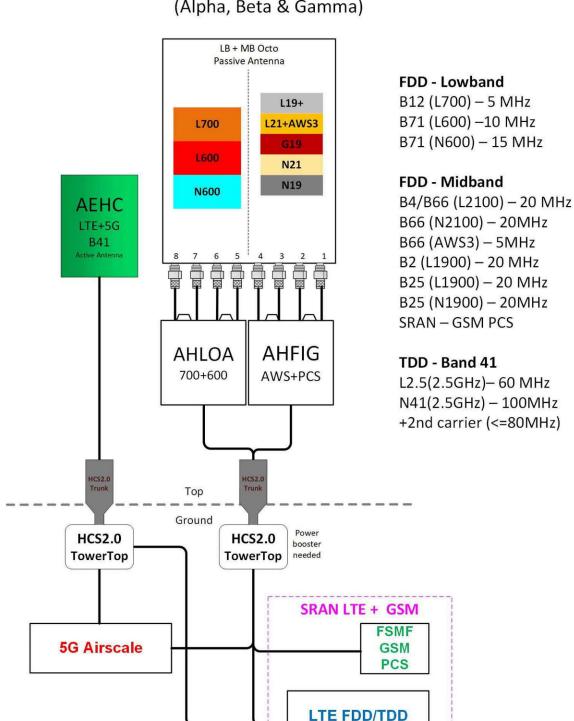

Airscale1

NOTE: THIS SHEET CREATED BY OTHERS AND PROVIDED


BY REQUEST OF CUSTOMER WITHOUT EDIT.

ANTENNA CONFIGURATION

SUPPLEMENTAL

R-601

0

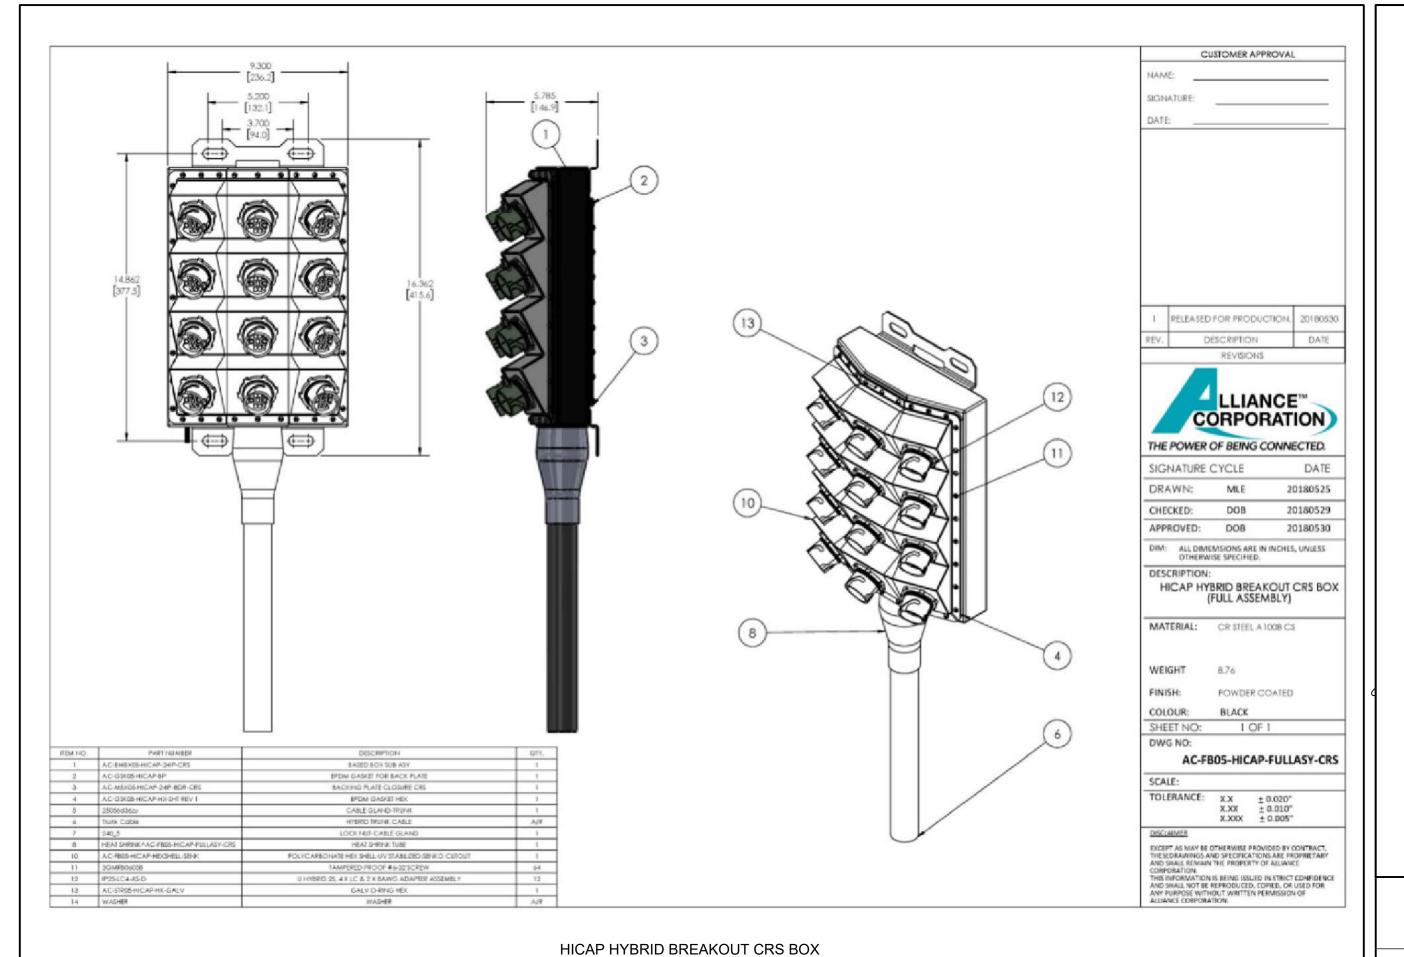

(FULL ASSEMBLY)


SUPPLEMENTAL

SHEET NUMBER:

REVISION:

R-602

MECHANICAL	JACKET COLOR	BLACK
	OUTER DIAMETER (IN)	1.46
	MIN BENDING RADIUS(IN), MULTIPLE BENDS, LOADED	29.2
	MIN BENDING RADIUS(IN), MULTIPLE BENDS, UNLOADED	14.6
	MIN BENDING RADIUS(IN), SINGLE BEND, UNLOADED	10.22
	MIN BENDING RADIUS(IN), FURCATION	1.2
	ARMOR	CORRUGATED COPPER
	WEIGHT(lib/kft)	1610
	COMPRESSION(Ib/IN)	250
	TENSILE LOAD, LONG TERM(Ibf)	180
	TENSILE LOAD, SHORT TERM(Ibf)	600
ELECTRICAL	CONDUCTOR MATERIAL	COPPER
	CONDUCTOR CONSTRUCTION	STRAND
	CONDUCTOR COLOR	BLUE/BLACK
	RESISTIVITY(nΩ @20°C)	16.78 nohm-M
	CONDUCTORS, QTY	12
	CONDUCTOR SIZE(AWG)	6
	EMI SHIELD	YES
	UL RATING	ULTC-OF-ER
OPTICAL	FIBER TYPE	SINGLE MODE (G.657.A)
	FIBERS, QTY	48
	ATTENUATION(dB/km), MAX, 1550/1285-1330 nm	0.5
	DISPERSION, MAX, 1550/1285-1330 nm	18 ps/3.5 ps
	RETURN LOSS(dB)	>50
	INSERTION LOSS(dB), POST ENVIRONMENTAL	REDUCTION < 0.65
	RETURN LOSS(dB), POST ENVIRONMENTAL	REDUCTION < 5
	CUTOFF WAVELENGTH(nm)	1260
	PIGTAIL TERMINATION	LC PAIR, STRAIGHT
ENVIRON	OPERATING TEMP("F)	-40 TO +167
	STORAGE TEMP("F)	-40 TO +167
	UV	IEC 60068-2-5
	THERMAL CYCLE	IEC 60068-2-14
	VIBRATION	IEC 60068-2-64
	IMPACT(ft lb)	4.4 NM PER ICEA696

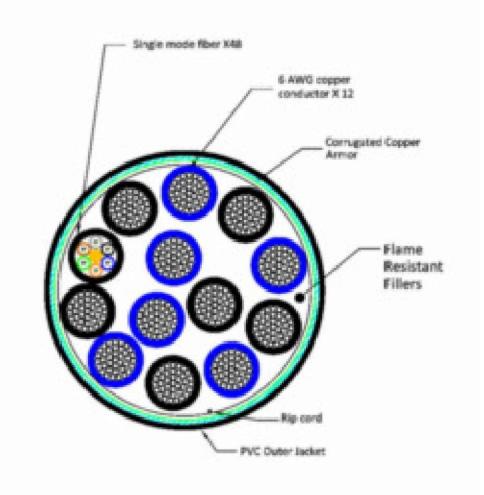

NOTE: CABLE CROSS-SECTION NOT DRAWN TO SCALE

SUPPLEMENTAL


SHEET NUMBER:

REVISION:

0

R-603

SFG23-12-4-96

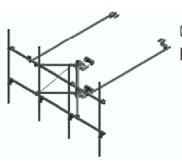

G23 High Capacity Sector Frame, 12.5 ft face, includes four 96 in pipes; For patents, see www.cs-pat.com

OBSOLETE

Product Classification

Product Type High capacity Tower sector frame

General Specifications

Application 4G LTE antenna/radio mount

Angle 60°, 203.2 mm (8 in) | Straight or tapered legs up to 203.2 mm (8 in) OD Mounting

Patent Number Patent pending

Pipe, quantity

Non-tapered | Tapered **Tower Taper**

Dimensions

Height 2,438.4 mm | 96 in Face Width 3.81 m | 12.5 ft 2,438.4 mm | 96 in Pipe Length Mounting Diameter, maximum 218.44 mm | 8.6 in Mounting Diameter, minimum 38.1 mm | 1.5 in 60.96 mm | 2.4 in **Pipe Outer Diameter** Stand-off Distance 1,226.82 mm | 48.3 in

Material Specifications

Material Type Hot dip galvanized steel

Mechanical Specifications

SUPPLEMENTAL

REVISION:

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SHEET NUMBER:

R-604