NEQ HIGHWAY 150 AND SW HOLLYWOOD DRIVE LEE'S SUMMIT, MO 64802 JACKSON COUNTY PROTOTYPE 20-M PRELIMINARY DEVELOPMENT PLAN

LEGEND

EXISTING	PROPOSED
——— P/L ———	
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	HP HP

DESCRIPTION CONSTRUCTION LIMITS PROPERTY LINE EASEMENT FENCE LIGHT POLE UNDERGROUND ELECTRIC LINE ELECTRICAL STRUCTURE UNDERGROUND **TELECOMMUNICATION** LINE GAS LINE GAS METER WATER LINE WATER STRUCTURE FIRE HYDRANT SANITARY LINE SANITARY STRUCTURE SANITARY GREASE TRAP STORM LINE STORM STRUCTURE ROOFDRAIN / UNDERDRAIN CONTOUR TOP OF CURB TOP OF PAVEMENT FINISHED GRADE SPOT ELEVATION GRADE SLOPE MAJOR FLOOD ROUTING

HIGH POINT

SEEDING/LANDSCAPE AREA

CONCRETE

STRUCTURAL CONCRETE

CONCRETE PAVEMENT

ROCK AREA

HEAVY DUTY ASPHALT PAVEMENT





OWNER

WHATABURGER 300 CONCORD PLAZA DR. SAN ANTONIO, TX 78216 PHONE: (210) 476-6842 CONTACT: ALYSSIA LESTER EMAIL: alester@wbhq.com

SURVEYOR

YOUNG - HOBBS AND ASSOCIATES 1202 CROSSLAND AVE. CLARKSVILLE, TN 37040 PHONE: (931) 645-2524 CONTACT: DAVE R. HOBBS

VICINITY MAP

ENGINEER

ms consultants, inc. 2221 SCHROCK ROAD COLUMBUS, OHIO 43229 PHONE: (614) 898-7100 CONTACT: IAN AULTMAN EMAIL: iaultman@msconsultants.com

GEOTECHNICAL ENGINEER

TERRACON CONSULTANTS, INC. 4765 WEST JUNCTION STREET SPRINGFIELD, MISSOURI 65802 PHONE: (417) 864-5100 CONTACT: TY G. ALEXANDER, P.E.

BENCHMARK

TBM 1: 1/2 IRON NORTHING: 2822704.4825 EASTING: 978325.3390 ELEVATION = 1022.68

TBM 2: 1/2 IRON NORTHING: 2822484.7625 EASTING: 978055.2866 ELEVATION = 1019.71

BASIS OF BEARINGS: MO (C) STATE PLANE COORDINATE SYSTEM SPC (2402 MO C)

FLOOD INFORMATION

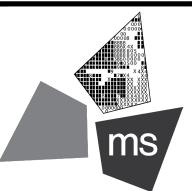
THIS PROPERTY IS LOCATED WITHIN AN AREA HAVING ZONE DESIGNATIONS OF "X" BY THE FEDERAL EMERGENCY MANAGEMENT AGENCY, ON FLOOD INSURANCE RATE MAP NO. 29095C0532G, WITH A MAP EFFECTIVE DATE OF JANUARY 1ST, 2017, IN JACKSON COUNTY, STATE OF MISSOURI, WHICH IS THE CURRENT FLOOD INSURANCE RATE MAP FOR THE COMMUNITY IN WHICH SAID PROPERTY IS SITUATED. REVISION/DATE/DESCRIPTION

SIR UPDATES	09/13/21
60% SET	01/24/22
PDP APPLICATION	02/24/22
RESPONSE TO CITY	03/29/22

NOTICE

THIS ARCHITECTURAL AND ENGI-NEERING DRAWING IS GIVEN IN CONFIDENCE AND SHALL BE USED ONLY PURSUANT TO THE AGREE-MENT WITH THE ARCHITECT. NO OTHER USE, DISSEMINATION, OR DUPLICATION MAY BE MADE WITHOUT PRIOR WRITTEN CONSEN OF THE ARCHITECT. ALL COMMON LAW RIGHTS OF COPYRIGHT AND OTHERWISE ARE HEREBY SPECIFI-CALLY RESERVED.





ms consultants, inc. engineers, architects, planners 2221 Schrock Road Columbus, Ohio 43229-1547 phone 614.898.7100 fax 614.898.7570

PROJECT

PROPOSED PT20M BUILDING

NEQ HWY 150 & SW HOLLYWOOD DR. LEE'S SUMMIT, MO 64082

SHEET TITLE

COVER SHEET

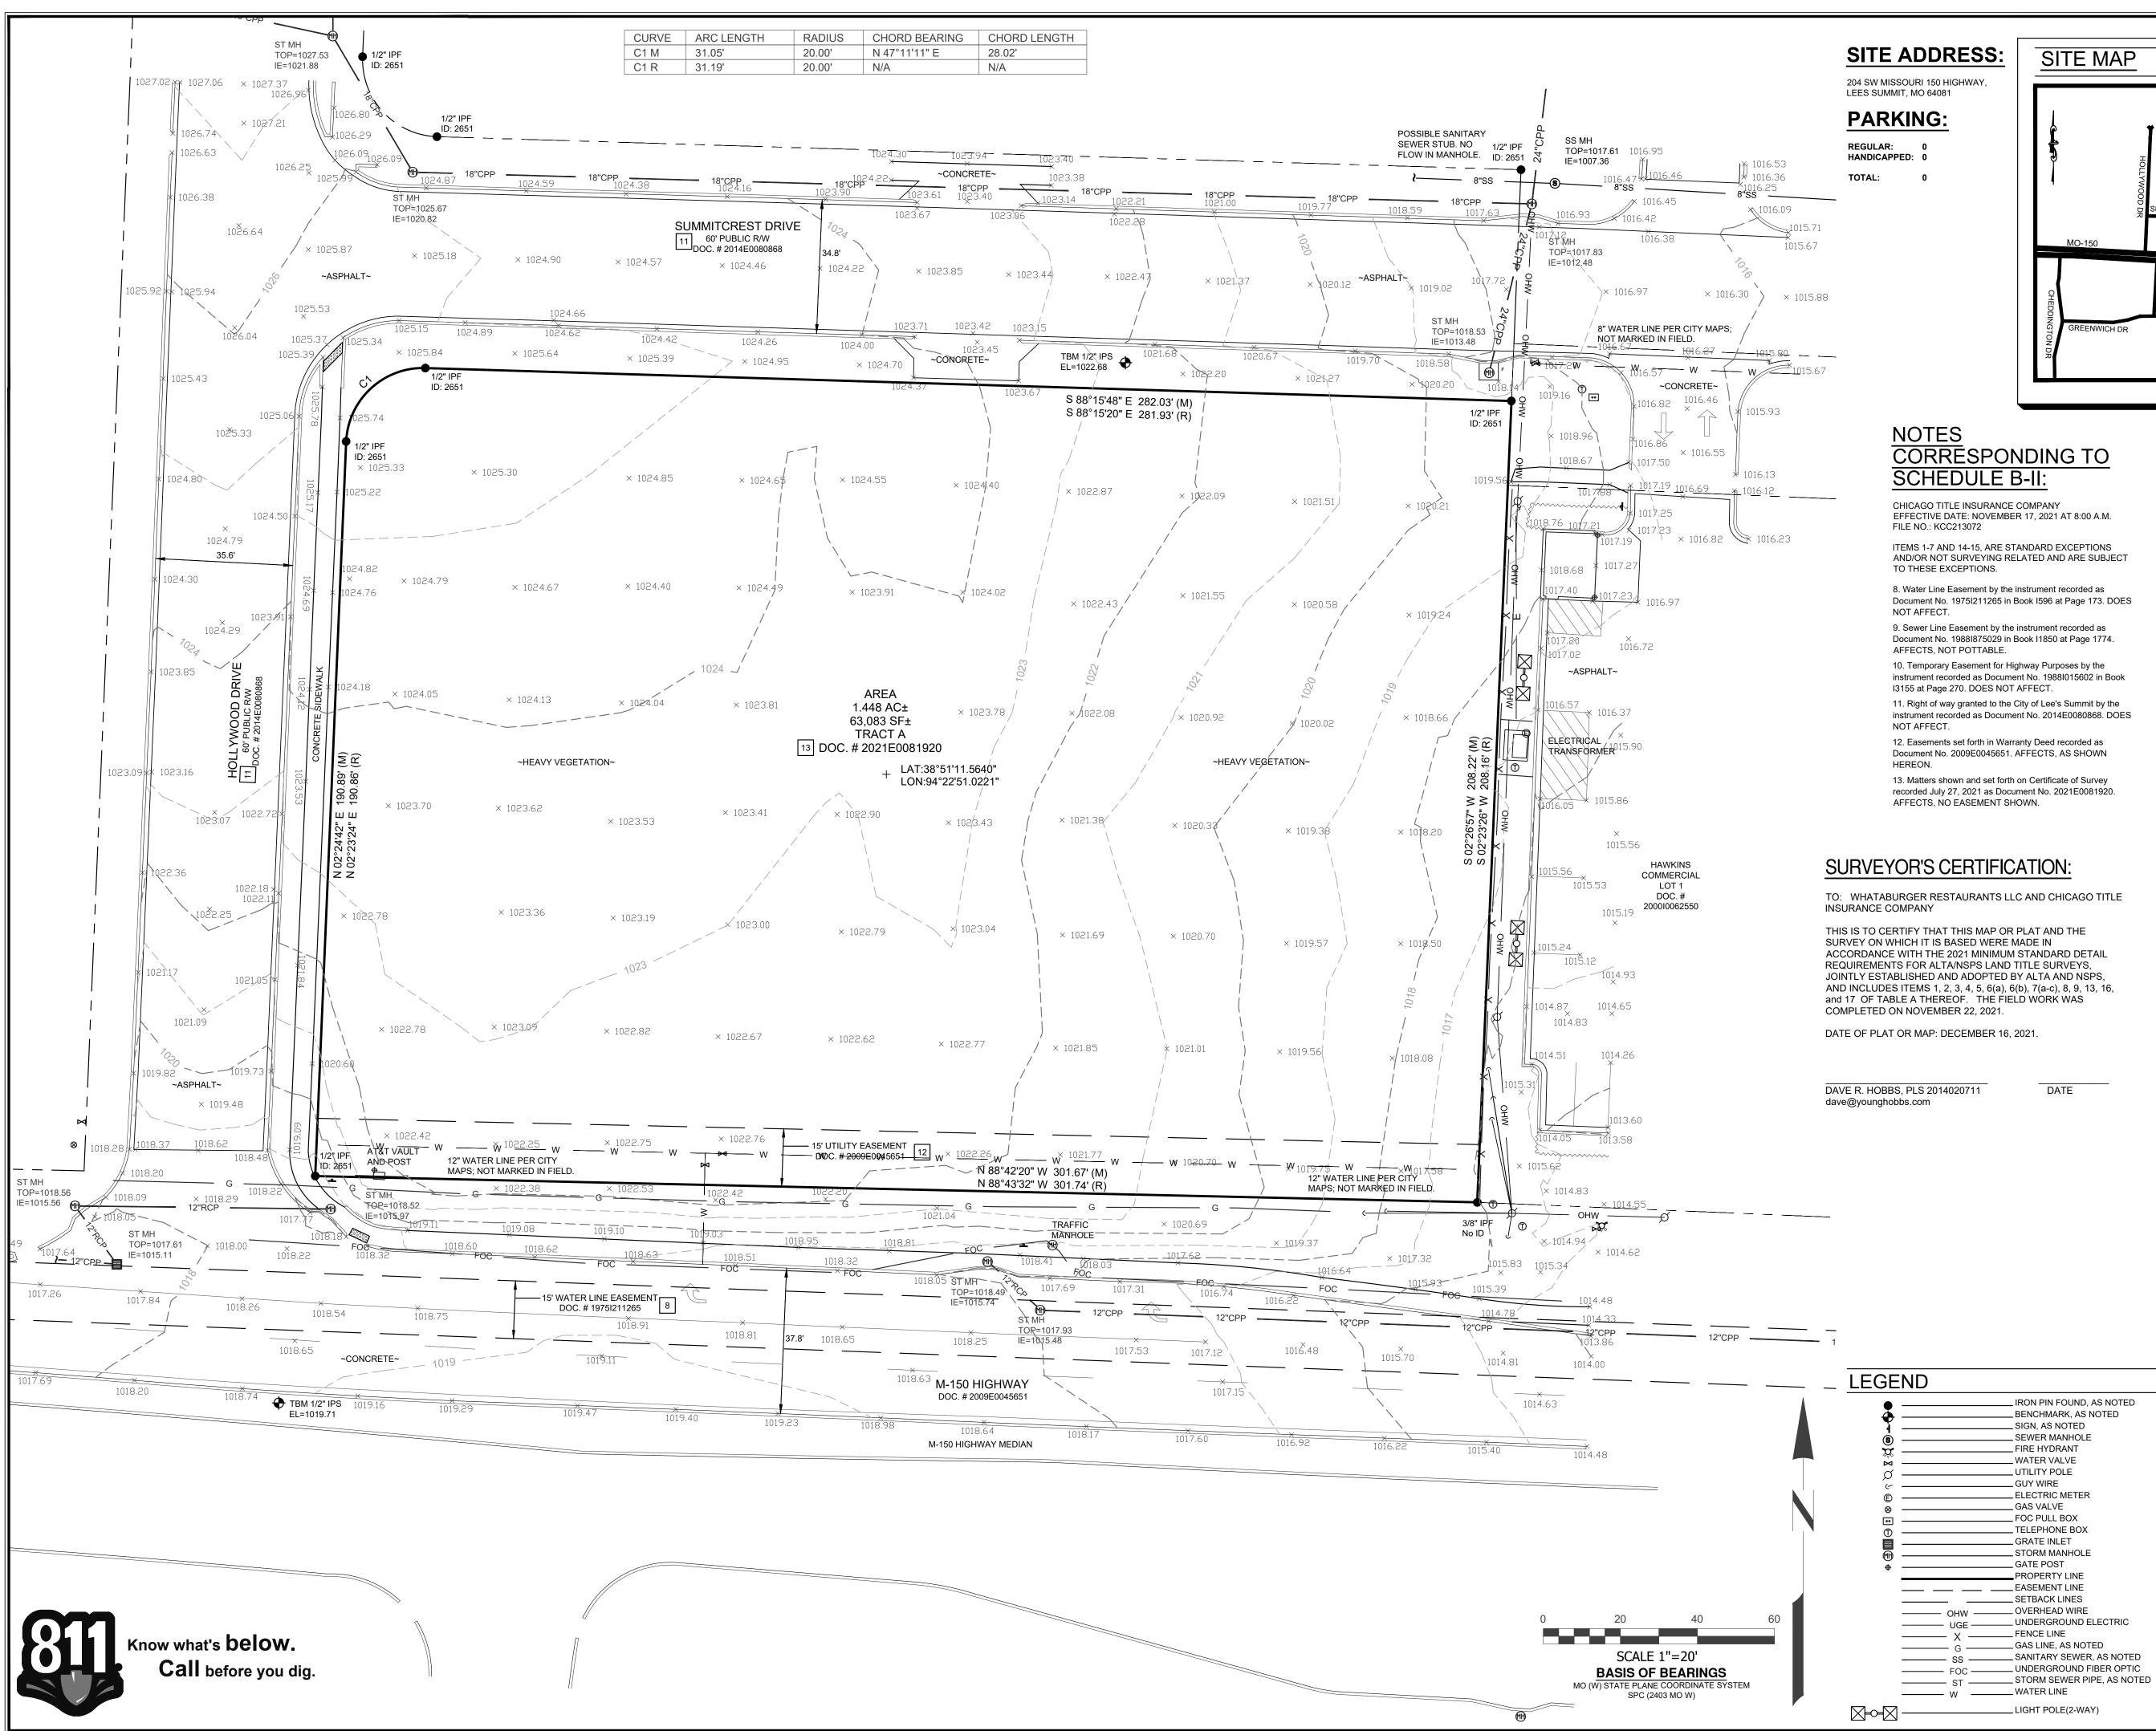
DRAWN BY:	TDB
CHECKED BY:	PJK
PROJECT NO:	40497-21

DRAWING

C-1.0

SHEET INDE	EX
COVER SHEET	C-1.0
SURVEY	1 OF 1
SITE DEMOLITION PLAN	C-2.0
SITE DIMENSION PLAN	C-3.0
SITE ZONING PLAN	C-3.1
CONCRETE JOINTING PLAN	C-4.0
SITE GRADING AND DRAINAGE PLAN	C-5.0
SITE UTILITY PLAN	C-6.0
SITE DETAILS	C-7.0
SITE DETAILS	C-7.1
SITE DETAILS	C-7.2
SITE DETAILS	C-7.3
SITE DETAILS	C-7.4
SITE DETAILS	C-7.5
SITE DETAILS	C-7.6
FIRE PROTECTION PLAN	C-8.0
LANDSCAPE PLAN	L-1.0
IRRIGATION PLAN	I-1.0
PHOTOMETRIC PLAN	PH-1.0

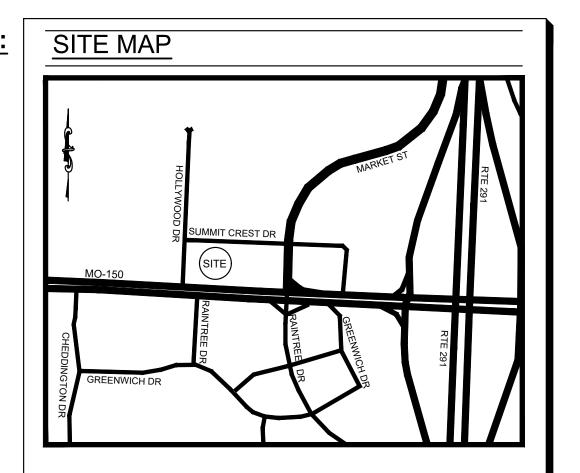




SITE ADDRESS:

204 SW MISSOURI 150 HIGHWAY,

0



NOTES **CORRESPONDING TO** SCHEDULE B-II:

CHICAGO TITLE INSURANCE COMPANY

- EFFECTIVE DATE: NOVEMBER 17, 2021 AT 8:00 A.M. FILE NO.: KCC213072
- ITEMS 1-7 AND 14-15, ARE STANDARD EXCEPTIONS AND/OR NOT SURVEYING RELATED AND ARE SUBJECT
- TO THESE EXCEPTIONS. 8. Water Line Easement by the instrument recorded as Document No. 1975I211265 in Book I596 at Page 173. DOES
- NOT AFFECT. 9. Sewer Line Easement by the instrument recorded as
- Document No. 1988/875029 in Book 11850 at Page 1774.
- AFFECTS, NOT POTTABLE. 10. Temporary Easement for Highway Purposes by the
- instrument recorded as Document No. 1988/015602 in Book I3155 at Page 270. DOES NOT AFFECT. 11. Right of way granted to the City of Lee's Summit by the
- instrument recorded as Document No. 2014E0080868. DOES NOT AFFECT.
- 12. Easements set forth in Warranty Deed recorded as Document No. 2009E0045651. AFFECTS, AS SHOWN HEREON.
- 13. Matters shown and set forth on Certificate of Survey recorded July 27, 2021 as Document No. 2021E0081920. AFFECTS, NO EASEMENT SHOWN.

SURVEYOR'S CERTIFICATION:

TO: WHATABURGER RESTAURANTS LLC AND CHICAGO TITLE

THIS IS TO CERTIFY THAT THIS MAP OR PLAT AND THE SURVEY ON WHICH IT IS BASED WERE MADE IN ACCORDANCE WITH THE 2021 MINIMUM STANDARD DETAIL REQUIREMENTS FOR ALTA/NSPS LAND TITLE SURVEYS, JOINTLY ESTABLISHED AND ADOPTED BY ALTA AND NSPS, AND INCLUDES ITEMS 1, 2, 3, 4, 5, 6(a), 6(b), 7(a-c), 8, 9, 13, 16, and 17 OF TABLE A THEREOF. THE FIELD WORK WAS COMPLETED ON NOVEMBER 22, 2021.

DATE

_ IRON PIN FOUND, AS NOTED

_ BENCHMARK, AS NOTED

_SIGN, AS NOTED

_ SEWER MANHOLE

_ELECTRIC METER

_ FIRE HYDRANT

___ WATER VALVE

UTILITY POLE

__GUY WIRE

__GAS VALVE

__FOC PULL BOX

__ TELEPHONE BOX __ GRATE INLET

_ STORM MANHOLE

PROPERTY LINE

__ UNDERGROUND ELECTRIC

__GATE POST

___ FENCE LINE

______ SETBACK LINES ------ OHW ------- OVERHEAD WIRE

_____ GAS LINE, AS NOTED

_____ X ___

DATE OF PLAT OR MAP: DECEMBER 16, 2021.

TABLE A NOTES:

- ITEM 2: ADDRESS SHOWN IS PER TITLE COMMITMENT NO. KCC213072.
- THIS PROPERTY IS LOCATED WITHIN AN AREA ITEM 3: HAVING ZONE DESIGNATIONS OF "X" BY THE FEDERAL EMERGENCY MANAGEMENT AGENCY, ON FLOOD INSURANCE RATE MAP NO.29095C0532G, WITH A MAP REVISED DATE OF JANUARY 20, 2017, IN JACKSON COUNTY, STATE OF MISSOURI, WHICH IS THE CURRENT FLOOD INSURANCE RATE MAP FOR THE COMMUNITY IN WHICH SAID PROPERTY IS SITUATED.
- ITEM 5: CONTOURS WERE DERIVED FROM RANDOM SHOTS AND CROSS SECTIONS AND ARE SHOWN AT ONE FOOT INTERVALS. ELEVATIONS SHOWN HEREON ARE BASED ON GPS OBSERVATIONS TOGETHER WITH AN OPUS SOLUTION, DATED 11/22/2021 (NAVD88,GEOID18).
- ITEM 6A: NO ZONING REPORT PROVIDED TO THIS SURVEYOR. THERE WAS NO EVIDENCE OF RECENT EARTH ITEM 16: MOVING, BUILDING CONSTRUCTION, OR BUILDING ADDITIONS OBSERVED IN THE PROCESS OF CONDUCTING THE FIELDWORK.
- THERE WAS NO EVIDENCE OF RECENT CHANGES IN ITEM 17: STREET RIGHT OF WAY LINES. THERE WAS NO EVIDENCE OF RECENT OR STREET SIDEWALK CONSTRUCTION OR REPAIRS OBSERVED IN THE PROCESS OF CONDUCTING THE FIELDWORK.

LAND DESCRIPTION AS SURVEYED

PART OF THE SOUTHEAST QUARTER OF THE SOUTHEAST QUARTER OF SECTION 30, TOWNSHIP 47 NORTH, RANGE 31 WEST, OF THE FIFTH PRINCIPAL MERIDIAN, LEE'S SUMMIT, JACKSON COUNTY, MISSOURI, DESCRIBED AS FOLLOWS:

BEING ALL OF TRACT "A", ON THE CERTIFICATE OF SURVEY, RECORDED JULY 27, 2021 AS DOCUMENT NO. 2021E0081920 IN THE CITY OF LEE'S SUMMIT, JACKSON COUNTY, MISSOURI, ALSO DESCRIBED AS FOLLOWS:

BEGINNING AT A 1/2" IRON PIN FOUND (ID: 2651) AT THE RIGHT OF WAY LINE INTERSECTION OF 150 HIGHWAY AND HOLLYWOOD DRIVE; THENCE WITH THE EAST RIGHT OF WAY LINE OF SAID HOLLYWOOD DRIVE N 02°24'42" E A DISTANCE OF 190.89 FEET TO A 1/2" IRON PIN FOUND (ID: 2651); THENCE WITH THE RIGHT OF WAY LINE INTERSECTION OF SAID HOLLYWOOD DRIVE AND SUMMITCREST DRIVE WITH A CURVE TURNING TO THE RIGHT WITH AN ARC LENGTH OF 31.05 FEET WITH A RADIUS OF 20.00 FEET WITH A CHORD BEARING OF N 47°11'11" E, WITH A CHORD LENGTH OF 28.02 FEET TO A 1/2" IRON PIN FOUND (ID: 2651); THENCE WITH THE SOUTH RIGHT OF WAY LINE OF SAID SUMMITCREST DRIVE S 88°15'48" E A DISTANCE OF 282.03 FEET TO A 1/2" IRON PIN FOUND (ID: 2651); THENCE LEAVING SAID RIGHT OF WAY LINE WITH THE WEST LINE OF HAWKINS COMMERCIAL LOT 1, RECORDED IN DOCUMENT NO. 2000I0062550 S 02°26'57" W A DISTANCE OF 208.22 FEET TO A 3/8" IRON PIN FOUND IN THE NORTH RIGHT OF WAY LINE OF SAID 150 HIGHWAY; THENCE WITH SAID NORTH RIGHT OF WAY LINE N 88°42'20" W A DISTANCE OF 301.67 FEET TO THE POINT OF BEGINNING, HAVING AN AREA OF 63,083 SQUARE FEET, 1.448 ACRES, MORE OR LESS.

SURVEY NOTES:

INFORMATION REGARDING THE PRESENCE, SIZE AND LOCATION OF UNDERGROUND UTILITIES IS SHOWN HEREON. THIS INFORMATION HAS BEEN SHOWN BASED ON THE LOCATION ABOVE GROUND APPURTENANCES, AVAILABLE DESIGN PLANS AND FLAGS AND PAINT PLACED BY THE UNDERGROUND PROTECTION SERVICE. NO CERTIFICATION IS MADE AS TO THE ACCURACY OF THOROUGHNESS OF THE INFORMATION CONCERNING UNDERGROUND UTILITIES AND STRUCTURES SHOWN HEREON. (MISSOURI ONE CALL 1-800-DIG-RITE). THIS SURVEY WAS PERFORMED WITHOUT THE BENEFIT OF A PRIVATE UTILITY LOCATE.

CONTACT PROPER AUTHORITIES BEFORE BUILDING NEAR UTILITY LINES, FOR EASEMENT WIDTH AND RESTRICTIONS. UTILITIES ARE APPROXIMATE AND SHOULD BE VERIFIED PRIOR TO ANY CONSTRUCTION.

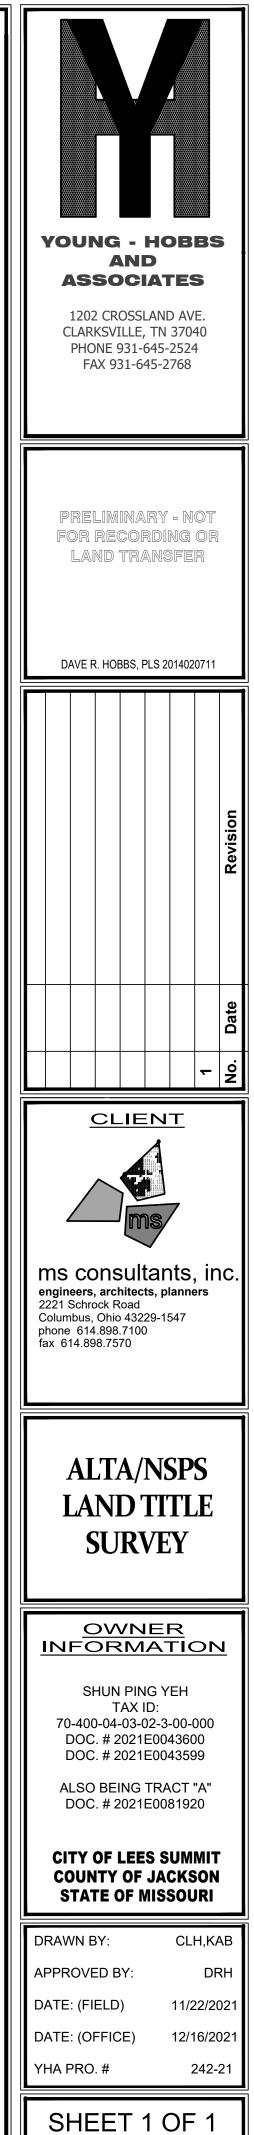
UNLESS STATED OTHERWISE, ANY MONUMENT REFERRED TO HEREIN AS AN "IRON PIN SET" IS A SET 5/8" DIAMETER REBAR, WITH AN YELLOW PLASTIC CAP STAMPED "YOUNG-HOBBS"

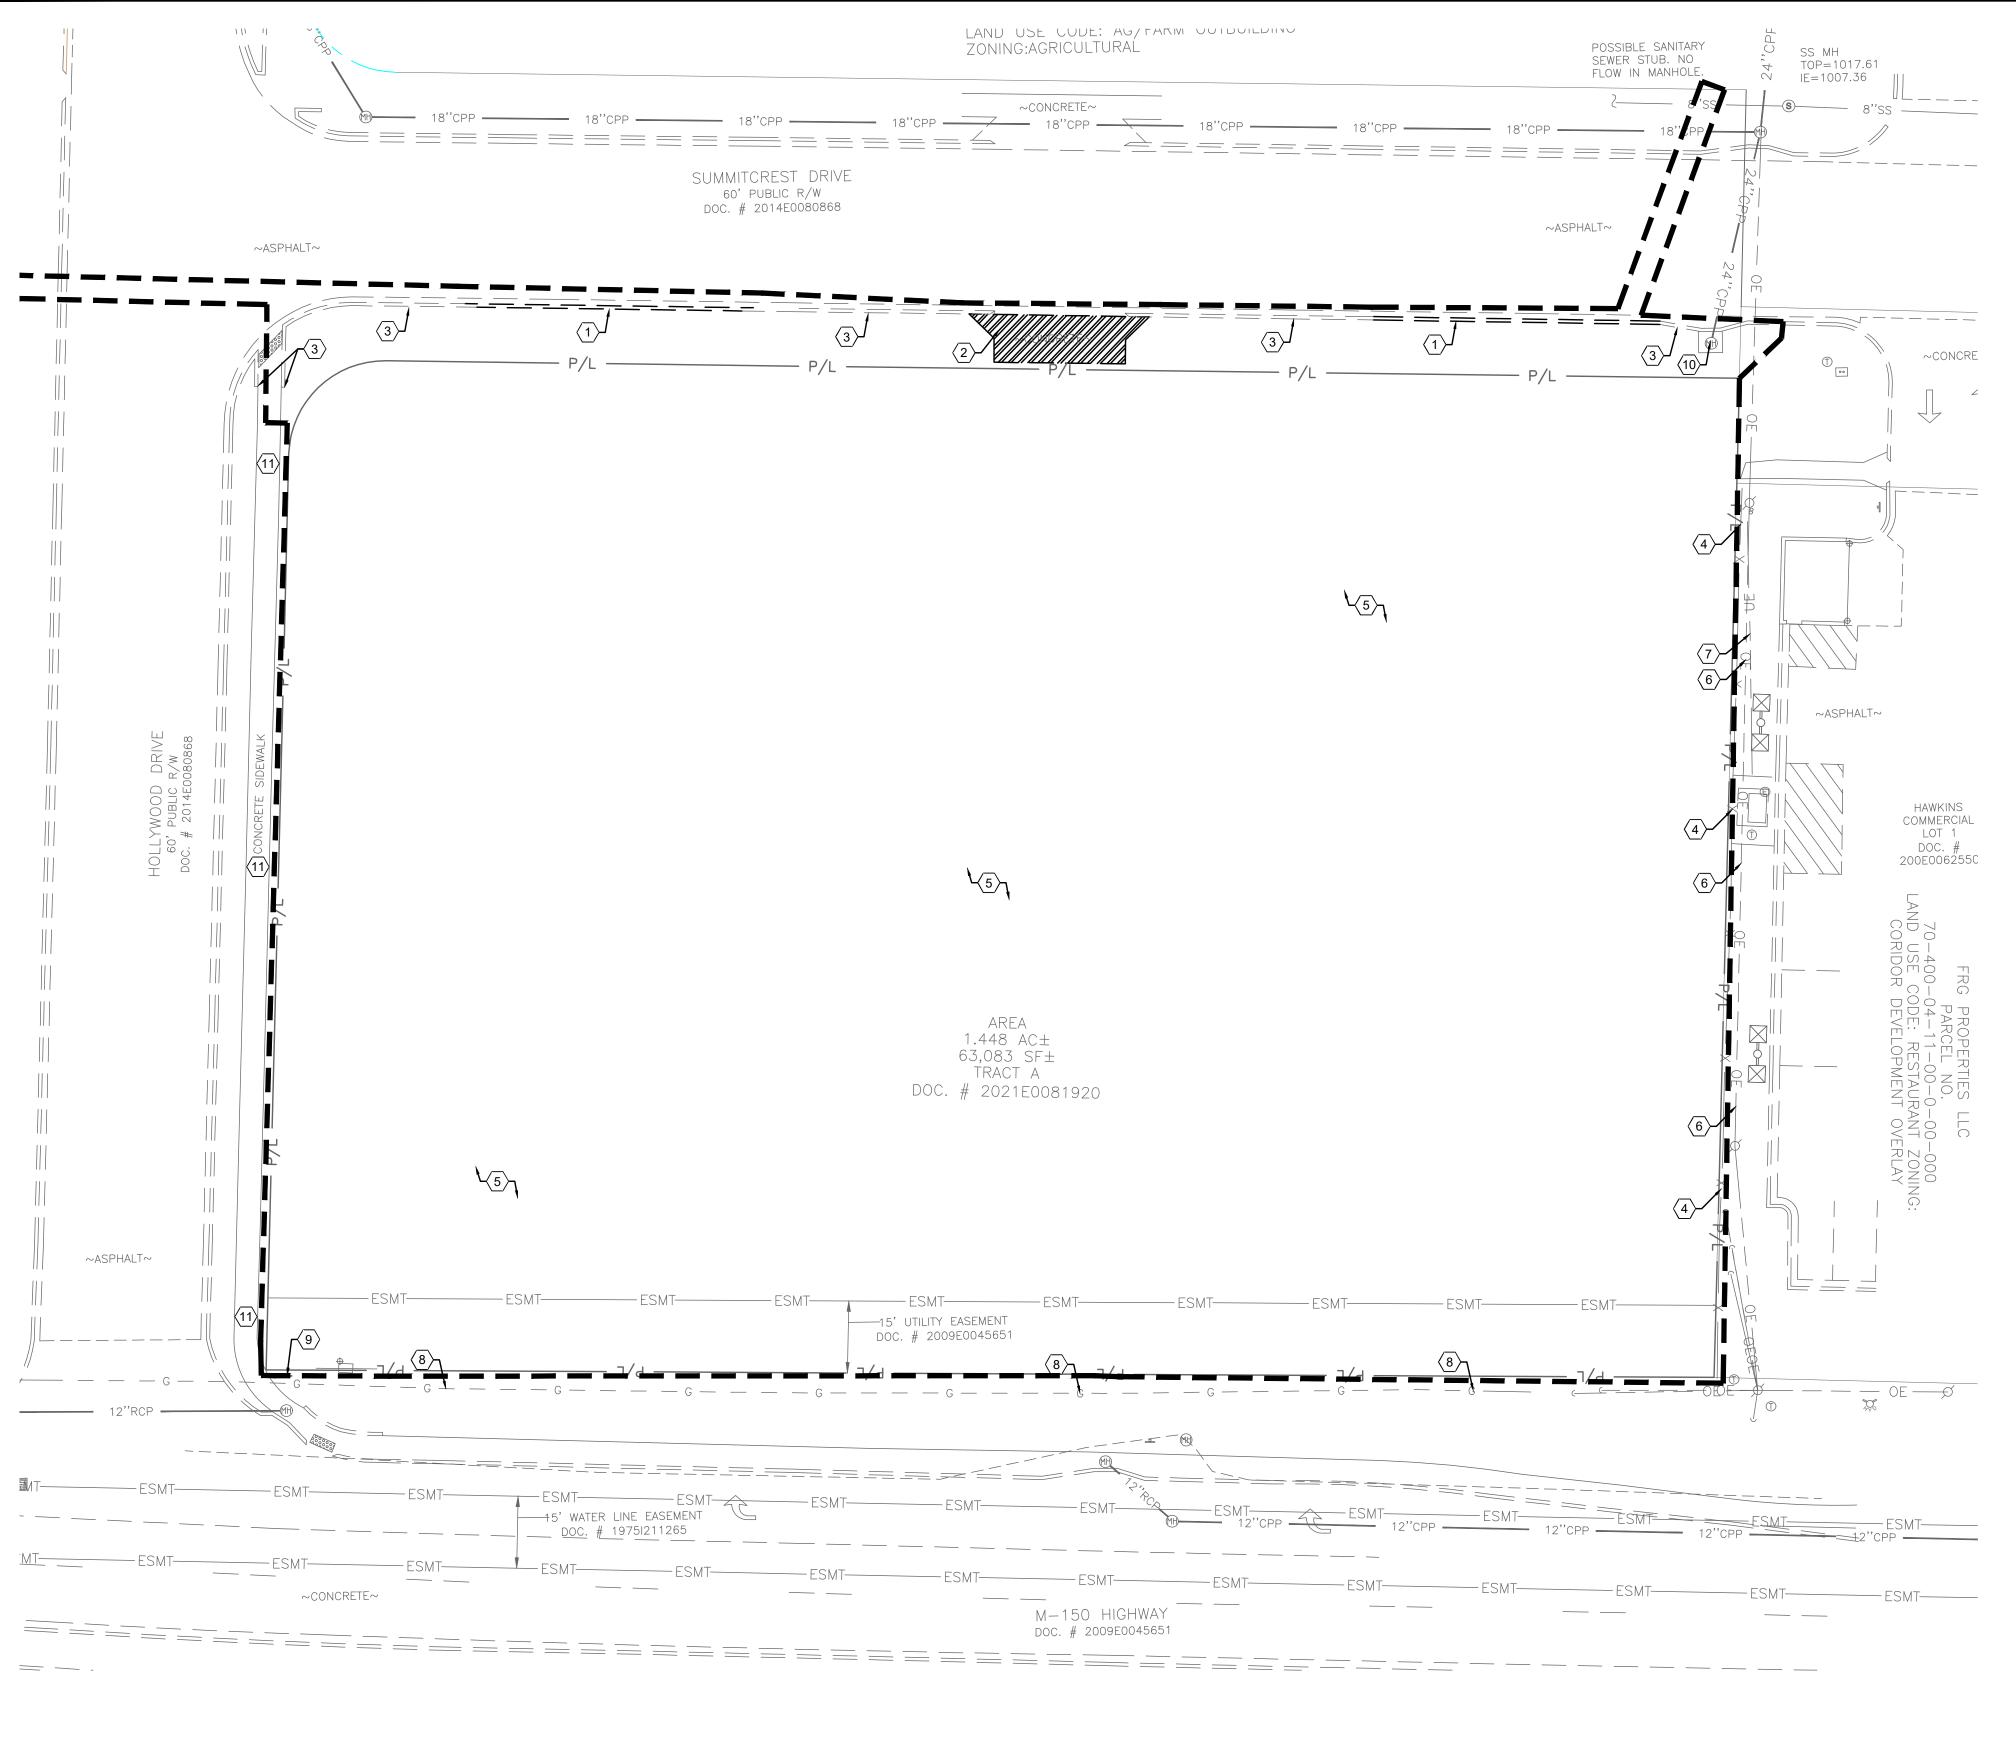
THIS SURVEY HAS BEEN PREPARED FOR THE EXCLUSIVE USE OF THE PERSON OR ENTITIES NAMED HERON. NO EXPRESS OR IMPLIED WARRANTIES WITH RESPECT TO THE INFORMATION SHOWN HEREON IS TO BE EXTENDED TO ANY PERSONS OR ENTITIES OTHER THAN THOSE SHOWN HEREON.

THERE WERE NO BUILDINGS ON THE SUBJECT PROPERTY AT THE TIME OF THE SURVEY.

LIST OF ENCROACHMENTS: NONE, THE OWNERSHIP OF CURB, UTILITIES, FENCES, AND/OR PERIMETER WALLS SHOWN HEREON ARE NOT KNOWN AND THUS ARE NOT LISTED AS ENCROACHMENTS. CURB, UTILITIES, FENCES, AND/OR PERIMETER WALLS ARE SHOWN IN THEIR RELATIVE POSITION TO THE BOUNDARY.

I DO HEREBY STATE THAT THIS IS A TRUE, COMPLETE AND CORRECT SURVEY OF THE DESCRIBED REAL PROPERTY SITUATED IN THE COUNTY OF GREENE, MISSOURI AND THAT THIS SURVEY WAS EXECUTED IN ACCORDANCE WITH THE CURRENT MISSOURI MINIMUM STANDARDS FOR PROPERTY SURVEYS (URBAN SURVEY 1:20,000)





GENERAL NOTES:

- AVENUE CLARKSVILLE, TN 37040.
- TIMING.
- CONSTRUCTION ACTIVITIES.

KEYED NOTES:

- $\langle 1 \rangle$ EXISTING CURB TO BE REMOVED AND DISPOSED OF.
- $\langle 2 \rangle$ EXISTING CONCRETE TO BE REMOVED AND DISPOSED OF.
- $\langle 3 \rangle$ EXISTING CURB TO REMAIN.
- $\langle \overline{4} \rangle$ EXISTING WOODEN FENCE TO REMAIN.
- $\langle 5 \rangle$ EXISTING VEGETATION TO BE REMOVED AND DISPOSED OF.
- $\langle 6 \rangle$ EXISTING OVERHEAD ELECTRIC LINE TO REMAIN DURING CONSTRUCTION.
- $\langle 7 \rangle$
- $\langle 8 \rangle$ PROTECT EXISTING GAS LINE TO REMAIN DURING CONSTRUCTION.
- $\langle 9 \rangle$ EXISTING SIGN TO REMAIN.
- (10) EXISTING STORM MANHOLE TO REMAIN.
- (11) EXISTING CONCRETE SIDEWALK TO REMAIN.

LEGEND

EXISTING	DESCRIPTION
UE	UNDERGROUND ELECTRIC LI
	UNDERGROUND TELECOMMUNICATION LINE
G	GAS LINE
— — — SAN —	SANITARY SEWER
ST	STORM SEWER
	WATER MAIN
——— P/L ———	PROPERTY LINE
	CONSTRUCTION LIMITS
ESMT	EASEMENT
	CONCRETE REMOVAL
	STORM STRUCTURE
\bowtie	WATER STRUCTURE
Хф.	FIRE HYDRANT
	LIGHT POLE
¤	TRAFFIC POLE
MH	TRAFFIC MANHOLE

A. ALL EXISTING CONDITIONS, TOPOGRAPHY, UTILITIES AND PROPERTY INFORMATION ARE TAKEN FROM A SURVEY OF LAND SITUATED IN THE CITY OF LEE'S SUMMIT, COUNTY OF JACKSON AND STATE OF MISSOURI, BY SURVEYOR: YOUNG-HOBBS AND ASSOCIATES, 1202 CROSSLAND

B. AT START OF PROJECT AND PRIOR TO DEMOLITION OF EXISTING CONDITIONS, CONTRACTOR SHALL BE IN CONTACT WITH ADJACENT PROPERTY OWNERS, CITY REPRESENTATIVE, UTILITY REPRESENTATIVES AND OWNER REPRESENTATIVE TO COORDINATE DEMOLITION

C. CONTRACTOR TO REMOVE AND DISPOSE OF ALL DEBRIS AND OTHER MATERIALS RESULTING FROM DEMOLITION AND CONSTRUCTION OPERATIONS. DISPOSAL WILL BE IN ACCORDANCE WITH ALL LOCAL, STATE AND FEDERAL REGULATIONS GOVERNING SUCH OPERATIONS. D. CONTRACTOR SHALL TAKE ALL PRECAUTIONS NECESSARY TO AVOID DAMAGE TO ADJACENT PROPERTIES DURING CONSTRUCTION PHASES OF THIS PROJECT. CONTRACTOR WILL BE SOLELY RESPONSIBLE FOR DAMAGE TO NEIGHBORING PROPERTIES OCCURRING AS A RESULT OF

E. ALL EXISTING UTILITIES ARE SHOWN HEREIN AS REFERENCE ONLY AND ARE BASED ON RECORD OF THE VARIOUS UTILITY COMPANIES, A FIELD SURVEY AND EXISTING PLANS. CONTRACTOR IS RESPONSIBLE FOR DETERMINING THE EXACT LOCATIONS OF ALL UTILITIES PRIOR TO DEMOLITION ACTIVITIES. CONTRACTOR IS RESPONSIBLE FOR ANY DAMAGE TO UTILITIES DURING CONSTRUCTION.

F. THE CONTRACTOR SHALL NOTIFY ALL UTILITY COMPANIES 48 HOURS BEFORE CONSTRUCTION IS TO START, TO VERIFY IF ANY UTILITIES ARE PRESENT ON SITE. ALL VERIFICATIONS (LOCATION, SIZE AND DEPTH) SHALL BE MADE BY THE APPROPRIATE UTILITY COMPANIES. WHEN EXCAVATION IS AROUND OR OVER EXISTING UTILITIES, THE CONTRACTOR MUST NOTIFY THE UTILITY SO A REPRESENTATIVE OF THAT UTILITY COMPANY CAN BE PRESENT TO INSTRUCT AND OBSERVE DURING CONSTRUCTION.

G. CONTRACTOR SHALL CONFINE ALL STOCKPILING OF DEMOLITION MATERIALS TO WITHIN THE LIMITS OF THE SUBJECT PROPERTY.

H. CONTRACTOR SHALL INSTALL EROSION CONTROL MEASURES PRIOR TO DEMOLITION. SEE SHEETS C-10.0 AND C-10.1 FOR NOTES AND DETAILS.

EXISTING UNDERGROUND ELECTRIC LINE TO REMAIN DURING CONSTRUCTION.

RGROUND ELECTRIC LINE RGROUND

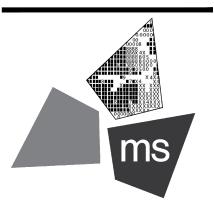
REVISION/DATE/DESCRIPTION

SIR UPDATES	09/13/21
60% SET	01/24/22
PDP APPLICATION TO CITY	02/24/22
RESPONSE TO CITY COMMENTS I	03/29/22

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ms consultants, inc. engineers, architects, planners 2221 Schrock Road Columbus, Ohio 43229-1547 phone 614.898.7100 fax 614.898.7570

PROJECT

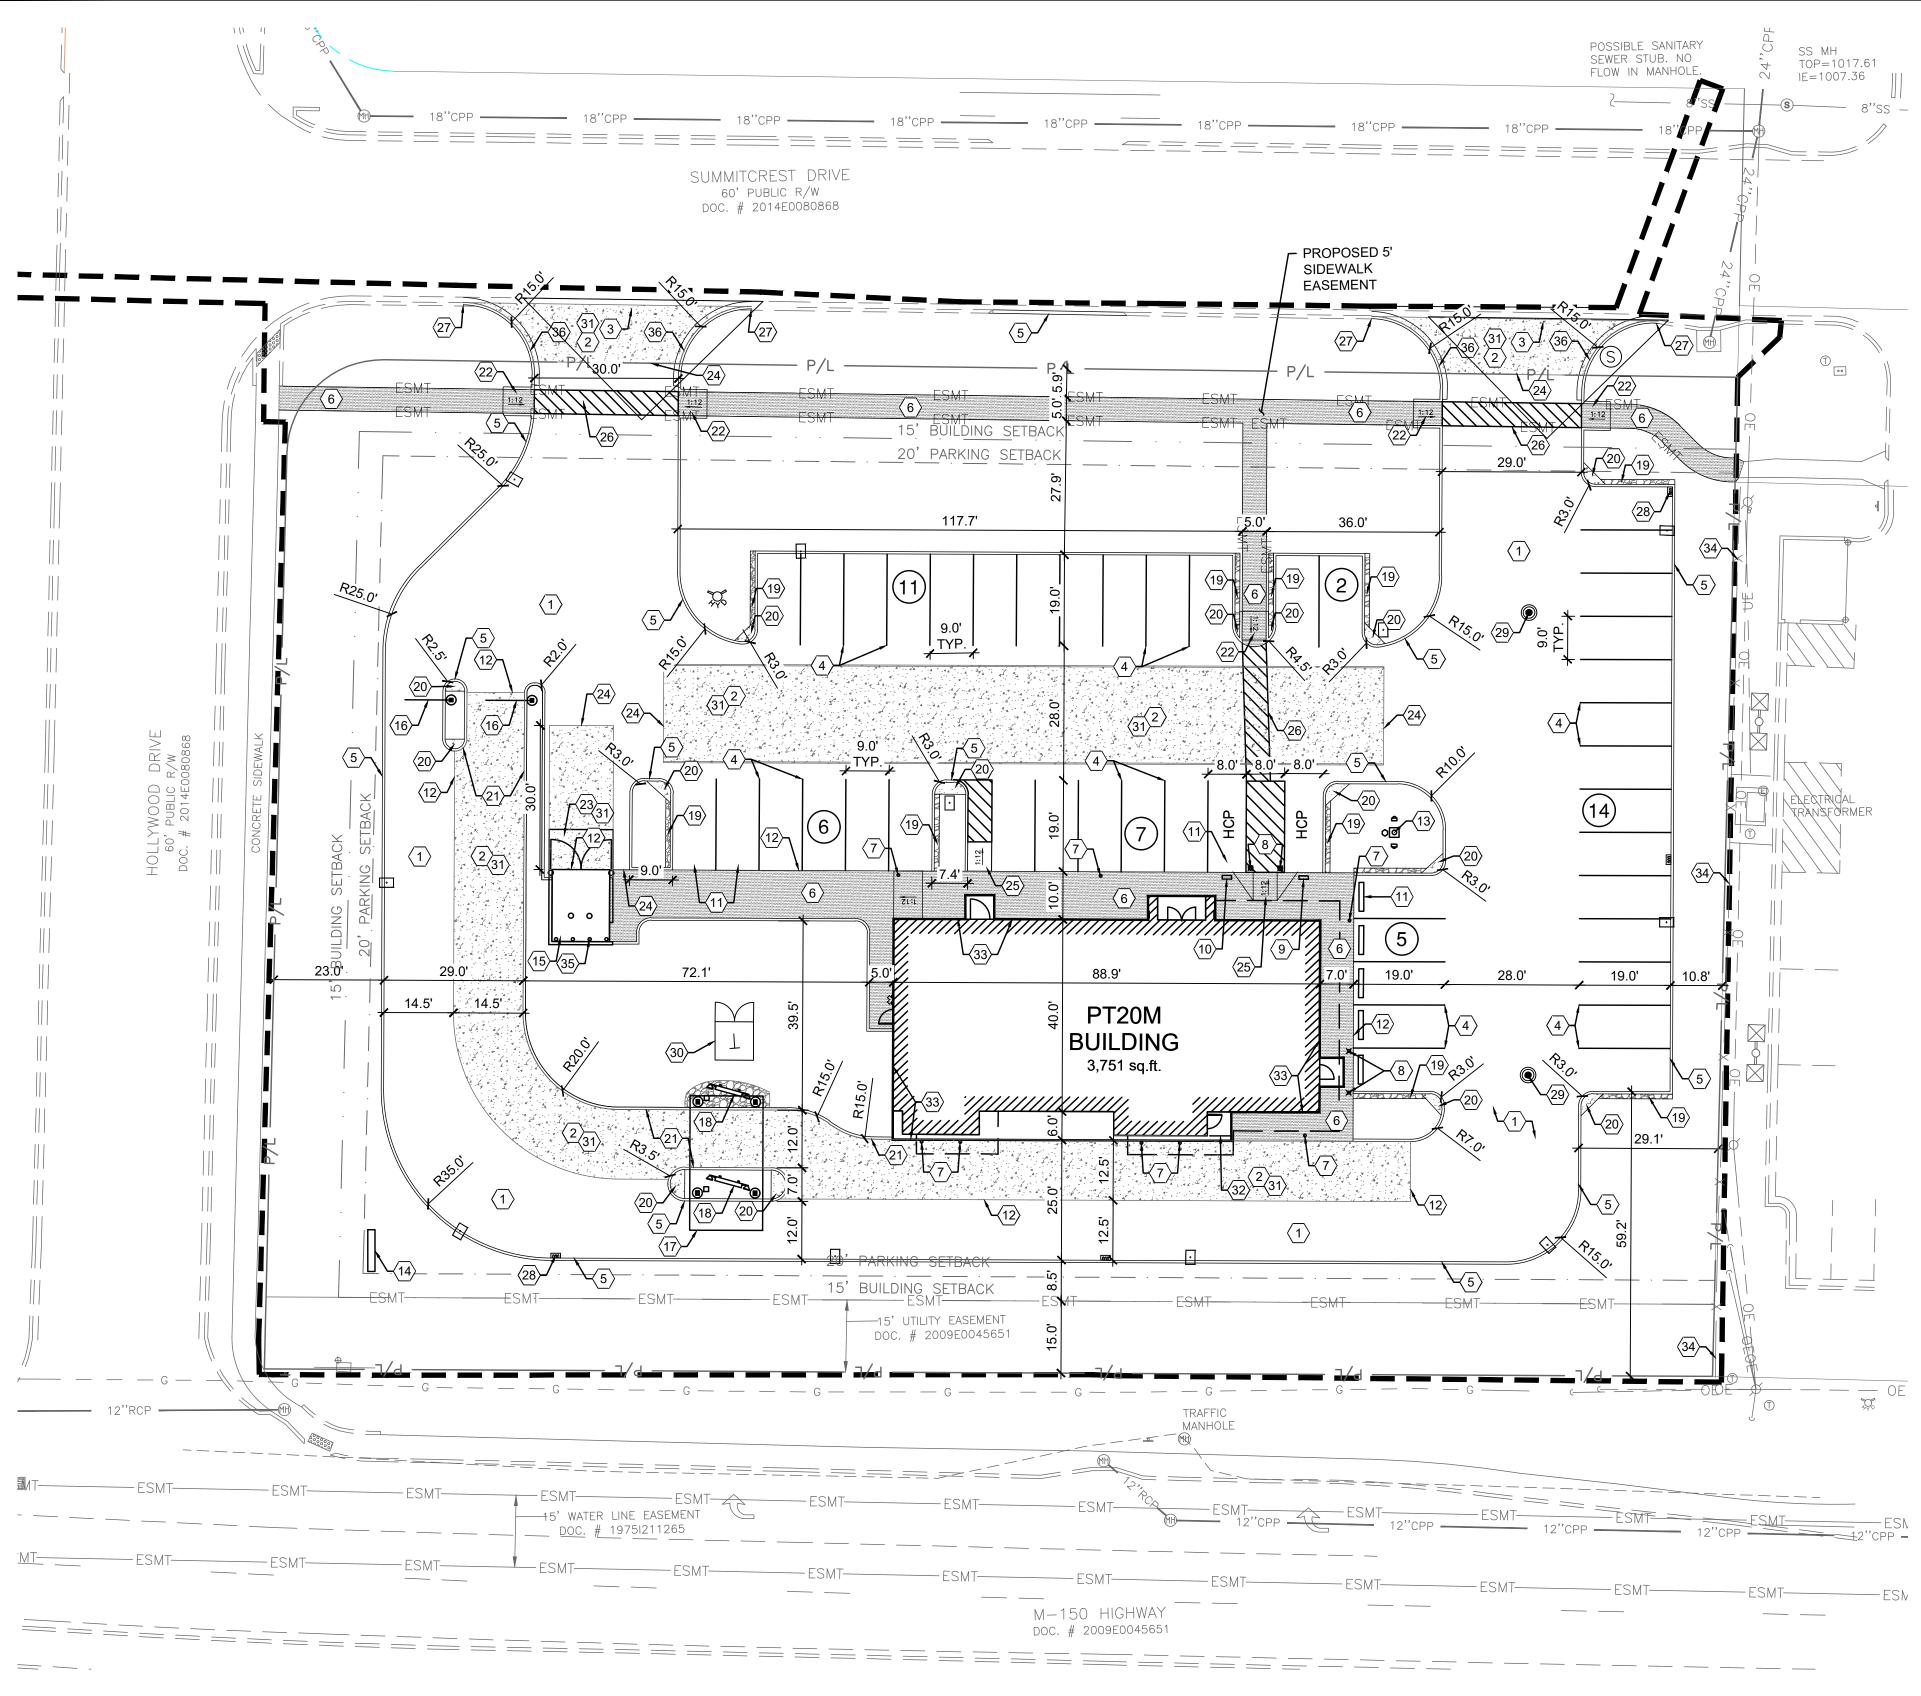
PROPOSED PT20M BUILDING

NEQ HWY 150 & SW HOLLYWOOD DR. LEE'S SUMMIT, MO 64082

SHEET TITLE

SITE DEMOLITION PLAN

DRAWN BY:	TDB
CHECKED BY:	PJK
PROJECT NO:	40497-21



LAND DESCRIPTION: **AS SURVEYED**

PART OF THE SOUTHEAST QUARTER OF THE SOUTHEAST QUARTER OF SECTION 30, TOWNSHIP 47 NORTH, RANGE 31 WEST, OF THE FIFTH PRINCIPAL MERIDIAN, LEE'S SUMMIT, JACKSON COUNTY, MISSOURI, DESCRIBED AS FOLLOWS:

BEING ALL OF TRACT "A", AS SHOWN ON THE CERTIFICATE OF SURVEY, RECORDED JULY 27, 2021 AS DOCUMENT NO. 2021E0081920 IN THE CITY OF LEE'S SUMMIT, JACKSON COUNTY, MISSOURI, ALSO DESCRIBED AS FOLLOWS:

BEGINNING AT A 1/2" IRON PIN FOUND (ID: 2651) AT THE RIGHT OF WAY LINE INTERSECTION OF 150 HIGHWAY AND HOLLYWOOD DRIVE; THENCE WITH THE EAST RIGHT OF WAY LINE OF SAID HOLLYWOOD DRIVE N 02°24'42" E A DISTANCE OF 190.89 FEET TO A 1/2" IRON PIN FOUND (ID: 2651); THENCE WITH THE RIGHT OF WAY LINE INTERSECTION OF SAID HOLLYWOOD DRIVE AND SUMMITCREST DRIVE WITH A CURVE TURNING TO THE RIGHT WITH AN ARC LENGTH OF 31.05 FEET WITH A RADIUS OF 20.00 FEET WITH A CHORD BEARING OF N 47°11'11" E, WITH A CHORD LENGTH OF 28.02 FEET TO A 1/2" IRON PIN FOUND (ID: 2651); THENCE WITH THE SOUTH RIGHT OF WAY LINE OF SAID SUMMITCREST DRIVE S 88°15'48" E A DISTANCE OF 282.03 FEET TO A 1/2" IRON PIN FOUND (ID: 2651); THENCE LEAVING SAID RIGHT OF WAY LINE WITH THE WEST LINE OF HAWKINS COMMERCIAL LOT 1, RECORDED IN DOCUMENT NO. 200E006255 S 02°26'57" W A DISTANCE OF 208.22 FEET TO A 3/8" IRON PIN FOUND IN THE NORTH RIGHT OF WAY LINE OF SAID 150 HIGHWAY; THENCE WITH SAID NORTH RIGHT OF WAY LINE N 88°42'20" W A DISTANCE OF 301.67 FEET TO THE POINT OF BEGINNING, HAVING AN AREA OF 63,083 SQUARE FEET, 1.448 ACRES, MORE OR LESS.

SITE DATA		PHASING PLAN				
	00 FT			PROJECT PHASE	BP DESCRIPTION	DATE
	SQ. FT.	ACRES	PERCENT		PREPARTE SITE FOR	
TOTAL BUILDING FLOOR AREA	3751	0.09	5.95		CONSTRUCTION	CTION ABLISHING SEPTEMBER-22 ETER
TOTAL SITE AREA	63083	1.45	100.0	A-PRE-CONSTRUCTION	INCLUDING ESTABLISHING	
LIMITS OF DISTURBANCE	68942	1.58	109.2	A-I RE-CONCILCOTION	E&S PERIMETER	
EXISTING PERVIOUS	62787	1.44	99.5	7	CONTROLS	
EXISTING IMPERVIOUS	296	0.01	0.5		TOP SOIL STOCK PILE	
TOTAL PROPOSED PERVIOUS	24129	0.55	38.2		PROTECTION, SITE	SEPTEMBER-22
TOTAL PROPOSED IMPERVIOUS	38954	0.89	61.8	B-PHASE I CONSTRUCTION	CLEARING, TEMPORARY	
EXISTING ZONING IS AG-AGRICULTURAL			SEEDING, GENERAL SITE	DECEMBER-22		
PROPOSED ZONING IS CP-2 PLAN	INED COMMU	JNITY COMM	IERCIAL		PREP	
FLOOR AREA RATION = 0.059 SF				C-PHASE II CONSTRUCTION	CONSTRUCT BUILDING ASPHALT PAVING, STORM STRUCTURE INSTALLATIONS	DECEMBER-22 JANUARY-23
				D-FINAL STABILIZATION	PERMANENT SEEDING	JUNE-23

LEGEND FEATURE

DESCRIPTION	
CONCRETE SIDEWALK	
IEAVY DUTY ASPHALT PAVEMENT	
EAVY DUTY CONCRETE PAVEMENT	EXIST
CONSTRUCTION LIMITS	\ge

SCALE: 1"=20'

37040 FOR ANY DAMAGE TO THEM DURING CONSTRUCTION.

GENERAL NOTES:

- CONSTRUCTION PHASES OF THIS PROJECT.
- REFER TO ARCHITECTURAL DRAWINGS FOR BUILDING DIMENSIONS AND ADDITIONAL INFORMATION. F.
- OR LOCAL REQUIREMENTS, WHICHEVER HAS JURISDICTION.
- BEEN PLANTED.

KEYED NOTES:

- (1) PROPOSED HEAVY DUTY ASPHALT PAVEMENT, SEE DETAIL ON SHEET C-7.0.
- $\langle 2 \rangle$ (3)
- $\langle 4 \rangle$ DETAILS OR SPECIFICATIONS.
- $\langle 5 \rangle$ PROPOSED 6" CONCRETE CURB. SEE DETAIL ON SHEET C-7.0.
- $\langle 6 \rangle$ PROPOSED CONCRETE SIDEWALK. SEE DETAIL ON SHEET C-7.0.
- $\langle 7 \rangle$
- $\langle 8 \rangle$
- $\langle 9 \rangle$
- REQUIREMENTS, SEE DETAIL ON SHEET C-7.0.
- (10) CONTRACTOR TO MEET LOCAL REQUIREMENTS, SEE DETAIL ON SHEET C-7.0.
- (11)
- $\langle 12 \rangle$
- (13) AND STRUCTURAL PLANS FOR DETAILS.
- (14)

(15)

(17)

(19)

 $\langle 22 \rangle$

25

 $\langle 26 \rangle$

27

(28)

(29)

(33)

(34)

(36)

- (18)
- $\langle 20 \rangle$ PROPOSED CONCRETE ISLAND NOSE. SEE DETAIL ON SHEET L-1.0.
- (21) PROPOSED 6" MONOLITHIC CURB. SEE DETAIL ON SHEET C-7.1.
- PROPOSED ADA SIDEWALK RAMP. SEE DETAIL ON SHEET C-7.1.

CONCRETE DUMPSTER ENCLOSURE APRON. TRASH ENCLOSURE AREA SHALL BE IMPROVED WITH A PORTLAND CEMENT CONCRETE PAD AND PORTLAND CEMENT CONCRETE APPROACH 30 FEET IN LENGTH, MEASURED FROM THE ENCLOSURE OPENING. THE PAD AND APPROACH SHALL BE IMPROVED WITH A MINIMUM 6" OF FULL DEPTH UNREINFORCED PORTLAND CEMENT CONCRETE CONSTRUCTED ON A SUB-GRADE OF 4" OF GRANULAR BASE COURSE. SEE DETAIL ON SHEET C-7.0.

- PROPOSED CONCRETE TO BE FLUSH WITH PROPOSED ASPHALT PAVEMENT.
- PROPOSED CURB RAMP. SEE DETAIL ON SHEET C-7.0.
- PROPOSED SIDEWALK CROSSING. SEE DETAIL ON SHEET C-7.2.
- CONNECT PROPOSED CURB TO EXISTING CURB.
- PROPOSED STORM INLET. SEE SHEETS C-5.0 AND C-7.5 FOR DETAILS.
- (30)
- (31) (32)

 - PROPOSED STRUCTURAL FOUNDATION.

EXISTING WOODEN FENCE TO REMAIN. TRASH ENCLOSURE SHALL BE PROTECTED THROUGH INSTALLATION OF 4" BOLLARDS (TYP. OF 4) ALONG THE REAR WALL OF THE TRASH ENCLOSURE. SEE ARCHITECTURAL AND STRUCTURAL PLANS FOR DETAILS. TYPE A CURB AND GUTTER PER MODOT STANDARD DRAWING 609.00P. SEE DETAIL ON SHEET C-7.1.

	ESMT
	ESMT
EXISTING	PROPOSED
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A. ALL EXISTING CONDITIONS, TOPOGRAPHY, UTILITIES AND PROPERTY INFORMATION ARE TAKEN FROM A SURVEY OF LAND SITUATED IN THE CITY OF LEE'S SUMMIT, COUNTY OF JACKSON AND STATE OF MISSOURI, BY SURVEYOR: YOUNG-HOBBS AND ASSOCIATES, 1202 CROSSLAND AVENUE CLARKSVILLE, TN

CONTRACTOR IS RESPONSIBLE FOR LOCATING AND VERIFYING ALL EXISTING UNDERGROUND UTILITIES PRIOR TO CONSTRUCTION, AND IS RESPONSIBLE

PROVIDE SMOOTH TRANSITION FROM NEWLY PAVED AREAS TO EXISTING PAVED AREAS AS NECESSARY. THE EXISTING EDGE OF PAVEMENT SHALL BE FREE OF ALL LOOSE DEBRIS AT ALL AREAS WHERE PROPOSED PAVEMENT MEETS EXISTING PAVEMENT. THE EDGE OF EXISTING ASPHALT PAVEMENT SHALL BE PROPERLY SEALED WITH A TACK COAT MATERIAL IN ALL AREAS WHERE NEW ASPHALT PAVEMENT IS INDICATED TO JOIN EXISTING. D. ALL DIMENSIONS TO FACE OF CURB AND/OR EDGE OF PAVEMENT UNLESS OTHERWISE NOTED.

CONTRACTOR SHALL BE SOLELY RESPONSIBLE FOR AND TAKE ALL PRECAUTIONS NECESSARY TO AVOID DAMAGE TO ADJACENT PROPERTIES DURING THE

G. ALL CONSTRUCTION METHODS AND MATERIALS MUST CONFORM TO CURRENT STANDARDS AND SPECIFICATIONS OF THE FEDERAL, STATE, COUNTY, CITY

H. ALL EXCAVATED AREAS TO BE SEEDED AND/OR SODDED AFTER FINISH GRADING UNLESS OTHERWISE NOTED. ALL NEWLY SEEDED/SODDED AREAS SHALL HAVE A MINIMUM OF 4" OF TOPSOIL. HOLD SOIL DOWN 1" FROM PAVEMENT ELEVATION. CONTRACTOR TO SUPPLY STRAW MULCH WHERE GRASS SEED HAS

I. ALL RADII ARE 3.0 FEET UNLESS OTHERWISE SHOWN. ALL RADII INDICATED ON PLANS SHALL BE CONSTRUCTED AS CIRCULAR ARCS. J. THERE ARE NO OIL AND GAS WELLS (ACTIVE/INACTIVE/CAPPED) PER THE MISSOURI DEPARTMENT OF NATURAL RESOURCES MAPPING.

PROPOSED HEAVY DUTY CONCRETE PAVEMENT, SEE DETAIL ON SHEET C-7.0.

PROPOSED ASPHALT PAVEMENT TO BE FLUSH WITH EXISTING ASPHALT PAVEMENT

PROPOSED PAINTED PARKING STRIPING (TYPICAL). ALL PARKING STRIPES ARE TO BE 4" PAINTED WHITE, UNLESS OTHERWISE NOTED ON THE PLANS,

PROPOSED BOLLARD, TYP. OF 8. SEE ARCHITECTURAL AND STRUCTURAL PLANS FOR DETAILS.

PROPOSED ILLUMINATED BOLLARD, TYP. OF 4. SEE ARCHITECTURAL AND STRUCTURAL PLANS FOR DETAILS.

GENERAL CONTRACTOR TO PROVIDE AND INSTALL (1) POLE-MOUNTED ADA PARKING SIGNS. SIGNS PROVIDED BY CONTRACTOR TO MEET LOCAL

GENERAL CONTRACTOR TO PROVIDE AND INSTALL (1) POLE-MOUNTED ADA PARKING SIGN WITH "VAN ACCESSIBLE" SIGN. SIGNS PROVIDED BY

PROPOSED PRE-CAST CONCRETE WHEEL STOP (TYP. OF 54) SEE DETAIL ON SHEET C-7.0.

CONCRETE TO BE FLUSH WITH ADJACENT ASPHALT PAVEMENT. SEE DETAIL ON SHEET C-7.1.

FLAGPOLE WITH GROUND-MOUNTED LIGHTS, UNITEDFLAG AND BANNER, GARRISON TYPE OR OWNER APPROVED EQUAL, 30' HIGH, 5" BUTT ALUMINUM WITH 14 GAUGE ALUMINUM BALL FINIAL. INCLUDE ALUMINUM ROLLER AND SLEEVE. HARDWARE TO INCLUDE STATIONARY STRUCK, NYLON FLAGSNAPS, AND HALYARDS. ENTIRE ASSEMBLY (INCLUDING FOUNDATION) TO CONFORM TO APPLICABLE CODES, INCLUDING WIND LOADS. SEE ARCHITECTURAL

PROPOSED 35' HT POLE SIGN, CONTRACTOR TO COORDINATE WITH OWNER. SEE ELECTRICAL PLANS AND SIGNAGE PACKAGE FOR DETAILS.

PROPOSED DUMPSTER ENCLOSURE AND CONCRETE PAD. SEE THE STRUCTURAL AND ARCHITECTURAL SHEETS FOR DETAILS.

PROPOSED HEADACHE BAR. SEE ARCHITECTURAL PLANS FOR DETAILS.

PROPOSED MENU BOARD CANOPY. SEE ARCHITECTURAL PLANS FOR DETAILS.

PROPOSED EXTERIOR MENU BOARD. SEE ARCHITECTURAL PLANS FOR DETAILS.

PROPOSED 1' WIDE CRUSHED GRANITE STRIP. SEE DETAIL ON SHEET L-1.0.

PROPOSED STORM MANHOLE/JUNCTION BOX. SEE SHEETS C-5.0, C-7.5, AND C-7.6 FOR DETAILS.

PROPOSED ELECTRIC TRANSFORMER. COORDINATE DETAILS AND LOCATION WITH UTILITY OWNER AND ELECTRICAL PLANS. SEE SHEET C-6.0.

CONTRACTOR TO ADD BLACK COLORING TO CONCRETE PAVEMENT THAT IS ADJACENT TO ASPHALT TO MATCH ASPHALT COLORING.

PROPOSED HAND RAIL. SEE ARCHITECTURAL SHEETS FOR DETAILS.

BUILDING SETBACK LINE

---- PARKING SETBACK LINE

PROPOSED SIDEWALK EASEMENT

EXISTING EASEMENT

LIGHT POLE

FIRE HYDRANT

PARKING DATA REQUIRED PROVIDED STANDARD 43 53 HANDICAP 3 2 τοται 56 45 *14 PARKING SPACE REQUIRED PER 1000 S.F. OF THE GROSS BUILDING FLOOR AREA (3,751 SF OF DINING AREA) **1 ADA SPACE PER 25 STANDARD SPACES ***FEWER SPACES ALLOWABLE IF EVIDENCE OF SUCCESS ON SIMILAR PROJECTS CAN BE PROVIDED.

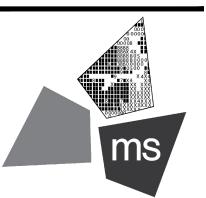
REVISION/DATE/DESCRIPTION

SIR UPDATES	09/13/21
60% SET	01/24/22
PDP APPLICATION TO CITY	02/24/22
RESPONSE TO CITY COMMENTS I	03/29/22

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PROJECT

PROPOSED PT20M BUILDING

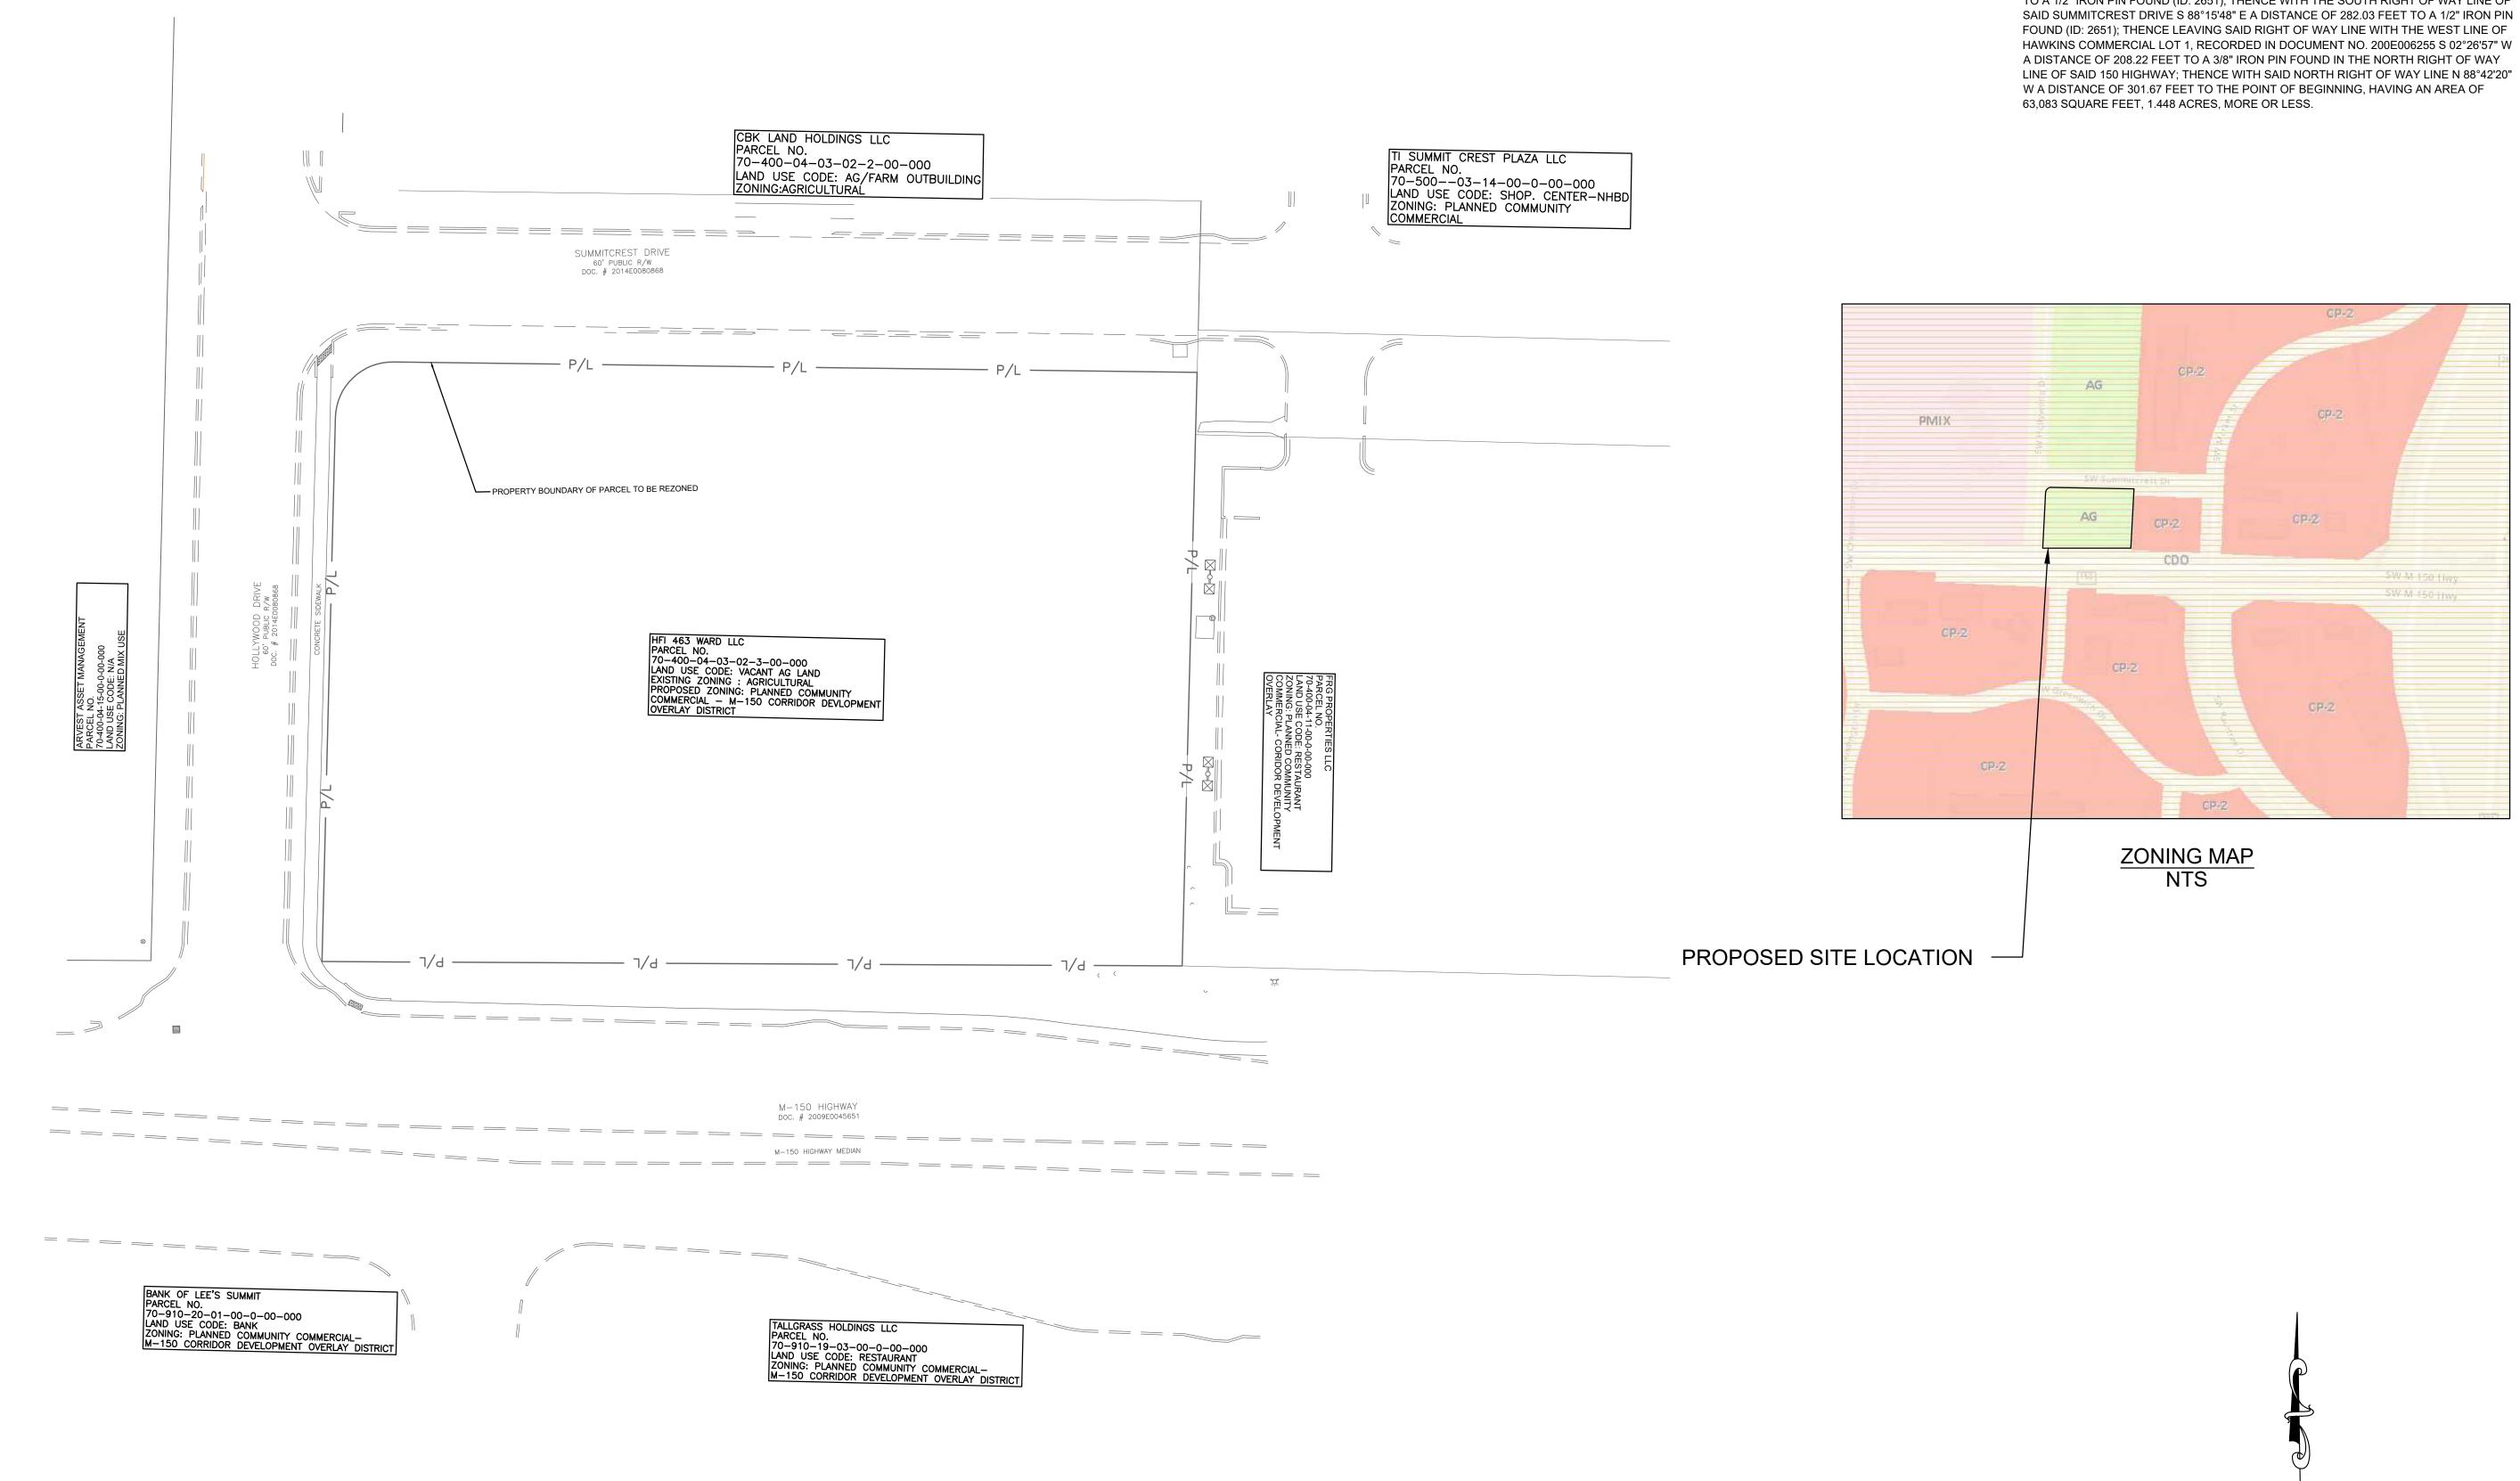
NEQ HWY 150 & SW HOLLYWOOD DR. LEE'S SUMMIT, MO 64082

SHEET TITLE

SITE DIMENSION PLAN

DRAWN BY:	TDB
CHECKED BY:	PJK
PROJECT NO:	40497-21

C-3.0



LAND DESCRIPTION: AS SURVEYED

PART OF THE SOUTHEAST QUARTER OF THE SOUTHEAST QUARTER OF SECTION 30, TOWNSHIP 47 NORTH, RANGE 31 WEST, OF THE FIFTH PRINCIPAL MERIDIAN, LEE'S SUMMIT, JACKSON COUNTY, MISSOURI, DESCRIBED AS FOLLOWS:

BEING ALL OF TRACT "A", AS SHOWN ON THE CERTIFICATE OF SURVEY, RECORDED JULY 27, 2021 AS DOCUMENT NO. 2021E0081920 IN THE CITY OF LEE'S SUMMIT, JACKSON COUNTY, MISSOURI, ALSO DESCRIBED AS FOLLOWS:

BEGINNING AT A 1/2" IRON PIN FOUND (ID: 2651) AT THE RIGHT OF WAY LINE INTERSECTION OF 150 HIGHWAY AND HOLLYWOOD DRIVE; THENCE WITH THE EAST RIGHT OF WAY LINE OF SAID HOLLYWOOD DRIVE N 02°24'42" E A DISTANCE OF 190.89 FEET TO A 1/2" IRON PIN FOUND (ID: 2651); THENCE WITH THE RIGHT OF WAY LINE INTERSECTION OF SAID HOLLYWOOD DRIVE AND SUMMITCREST DRIVE WITH A CURVE TURNING TO THE RIGHT WITH AN ARC LENGTH OF 31.05 FEET WITH A RADIUS OF 20.00 FEET WITH A CHORD BEARING OF N 47°11'11" E, WITH A CHORD LENGTH OF 28.02 FEET TO A 1/2" IRON PIN FOUND (ID: 2651); THENCE WITH THE SOUTH RIGHT OF WAY LINE OF

> 0 15 30 45 60 SCALE: 1"=30'

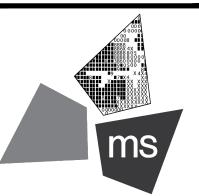
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PROJECT

PROPOSED PT20M BUILDING

NEQ HWY 150 & SW HOLLYWOOD DR. LEE'S SUMMIT, MO 64082

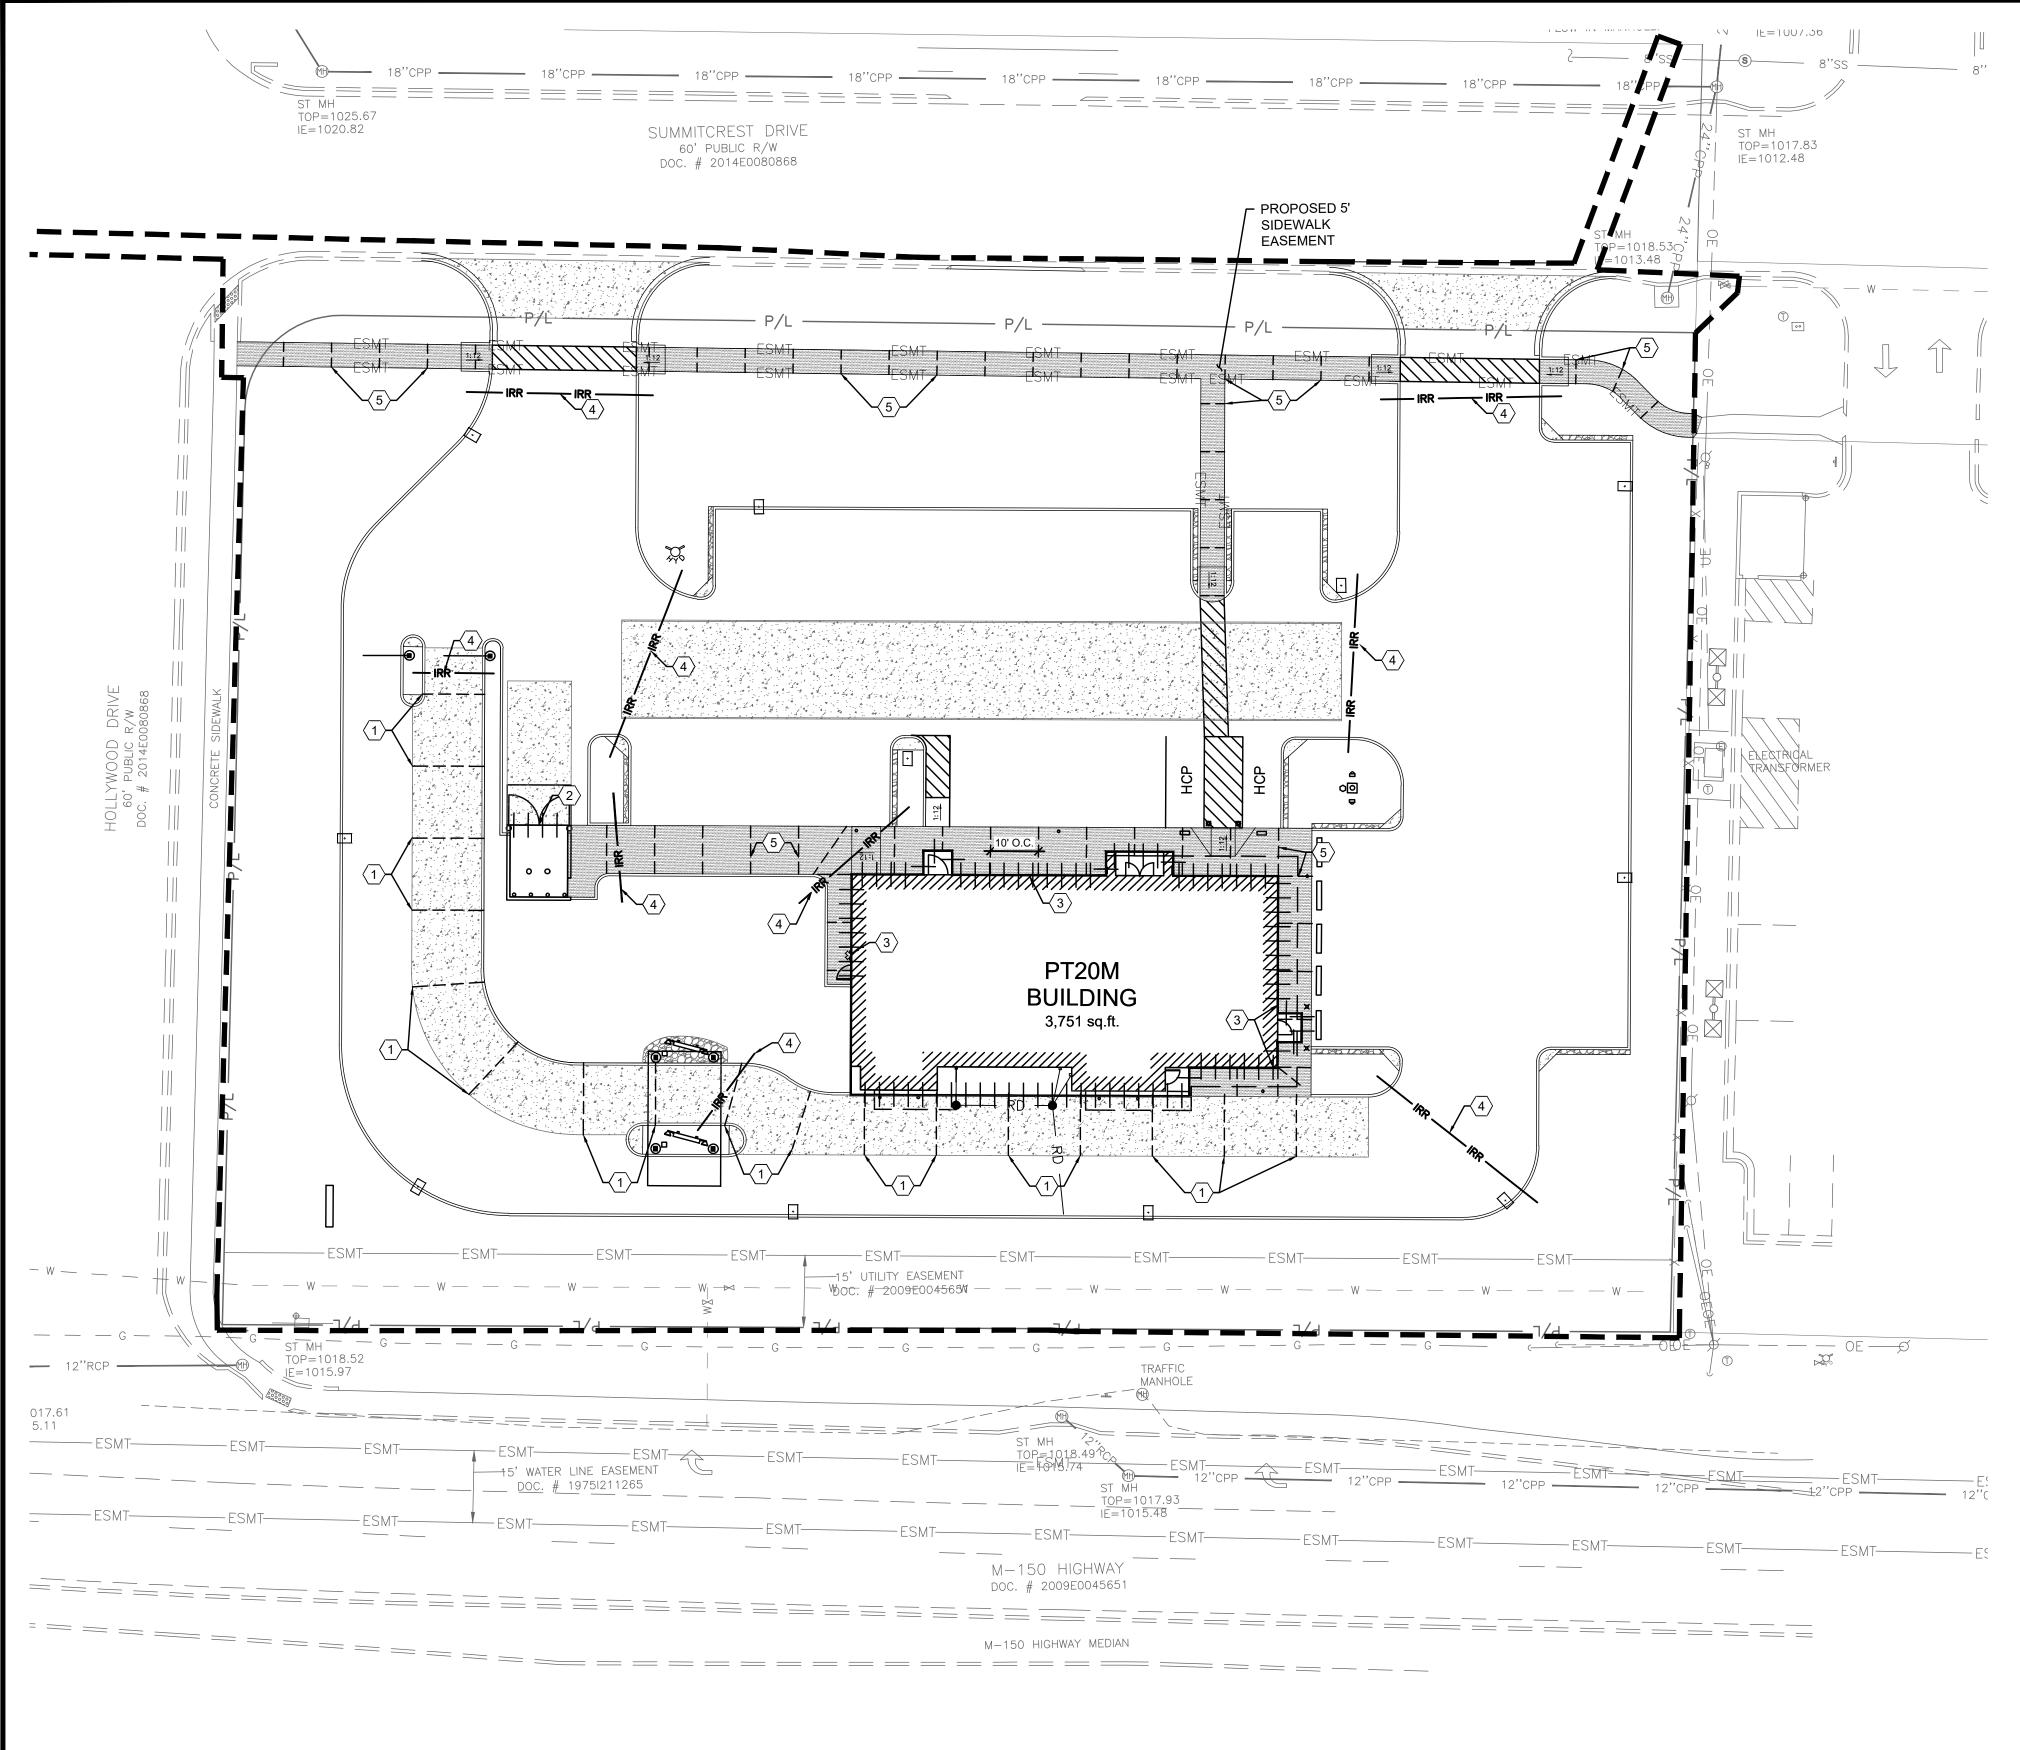
SHEET TITLE

SITE ZONING PLAN

DRAWN BY:	TDB
CHECKED BY:	PJK
PROJECT NO:	40497-21

DRAWING

C-3.1



REVISION/DATE/DESCRIPTION

GENERAL NOTES:

- A. PAVEMENT SPECIFICATION AND RECOMMENDATIONS TO BE TAKEN FROM GEOTECHNICAL REPORT.
- B. PORTLAND CEMENT CONCRETE SHALL HAVE A MINIMUM 28-DAY COMPRESSIVE STRENGTH OF 4,000 PSI.
- C. MAXIMUM CONTROL JOINT SPACING SHALL NOT EXCEED 15 FEET.
- D. EXPANSION JOINTS SHALL BE USED WHEREVER THE PAVEMENT WILL ABUT A STRUCTURAL ELEMENT SUBJECT TO DIFFERENT MAGNITUDE OF MOVEMENT (E.G., LIGHT POLES, RETAINING WALLS, EXISTING PAVEMENT, STAIRWAYS, ENTRYWAY PIERS, BUILDING WALLS, MANHOLES, ETC.)
- E. EXPANSION JOINTS SHALL BE SEALED PER DETAILS ON SHEET C-7.0 TO MINIMIZE MOISTURE INFILTRATION INTO SUBGRADE SOILS AND RESULTANT CONCRETE DETERIORATION AT THE JOINTS.
- F. SLEEVES SHOWN ARE FOR IRRIGATION ONLY. ADDITIONAL SLEEVES MAY BE REQUIRED FOR OTHER FRANCHISE UTILITIES. CONTRACTOR SHALL COORDINATE LOCATION AND SUPPLY ADDITIONAL SLEEVES REQUIRED FOR ELECTRICAL AND TELECOMMUNICATION SERVICES.
- G. ALL CONCRETE JOINTS SHALL RUN CONTINUOUSLY THROUGH CURBS.

KEYED NOTES:

- (1) SAWED CONSTRUCTION JOINT REQUIRED, TYPICAL. SEE DETAIL ON SHEET C-7.0.
- DOWELED EXPANSION JOINT REQUIRED, TYPICAL. SEE DETAIL ON SHEET C-7.0. $\langle 2 \rangle$
- EXPANSION JOINT REQUIRED WHERE CONCRETE OR CURB ABUTS BUILDING FOUNDATION, STORM STRUCTURE, FLUME, OR SIDEWALK OPENING. SEE DETAIL ON SHEET C-7.0. $\langle 3 \rangle$
- $\langle 4 \rangle$ SCHEDULE 40 PVC IRRIGATION SLEEVE, SEE SHEET I-1.0 FOR MORE INFORMATION.
- $\langle 5 \rangle$ INSTALL CONTRACTION JOINTS 10' ON CENTER AS SHOWN ON DETAIL C ON SHEET C-7.0 (TYP).

LEGEND

DESCRIPTION

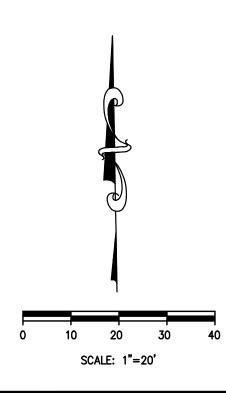
---- CONTRACTION JOINT

CONCRETE SIDEWALK

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HEAVY DUTY ASPHALT PAVEMENT

HEAVY DUTY CONCRETE PAVEMENT



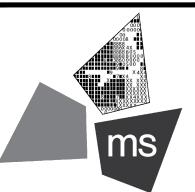


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PROJECT

PROPOSED PT20M BUILDING

NEQ HWY 150 & SW HOLLYWOOD DR. LEE'S SUMMIT, MO 64082

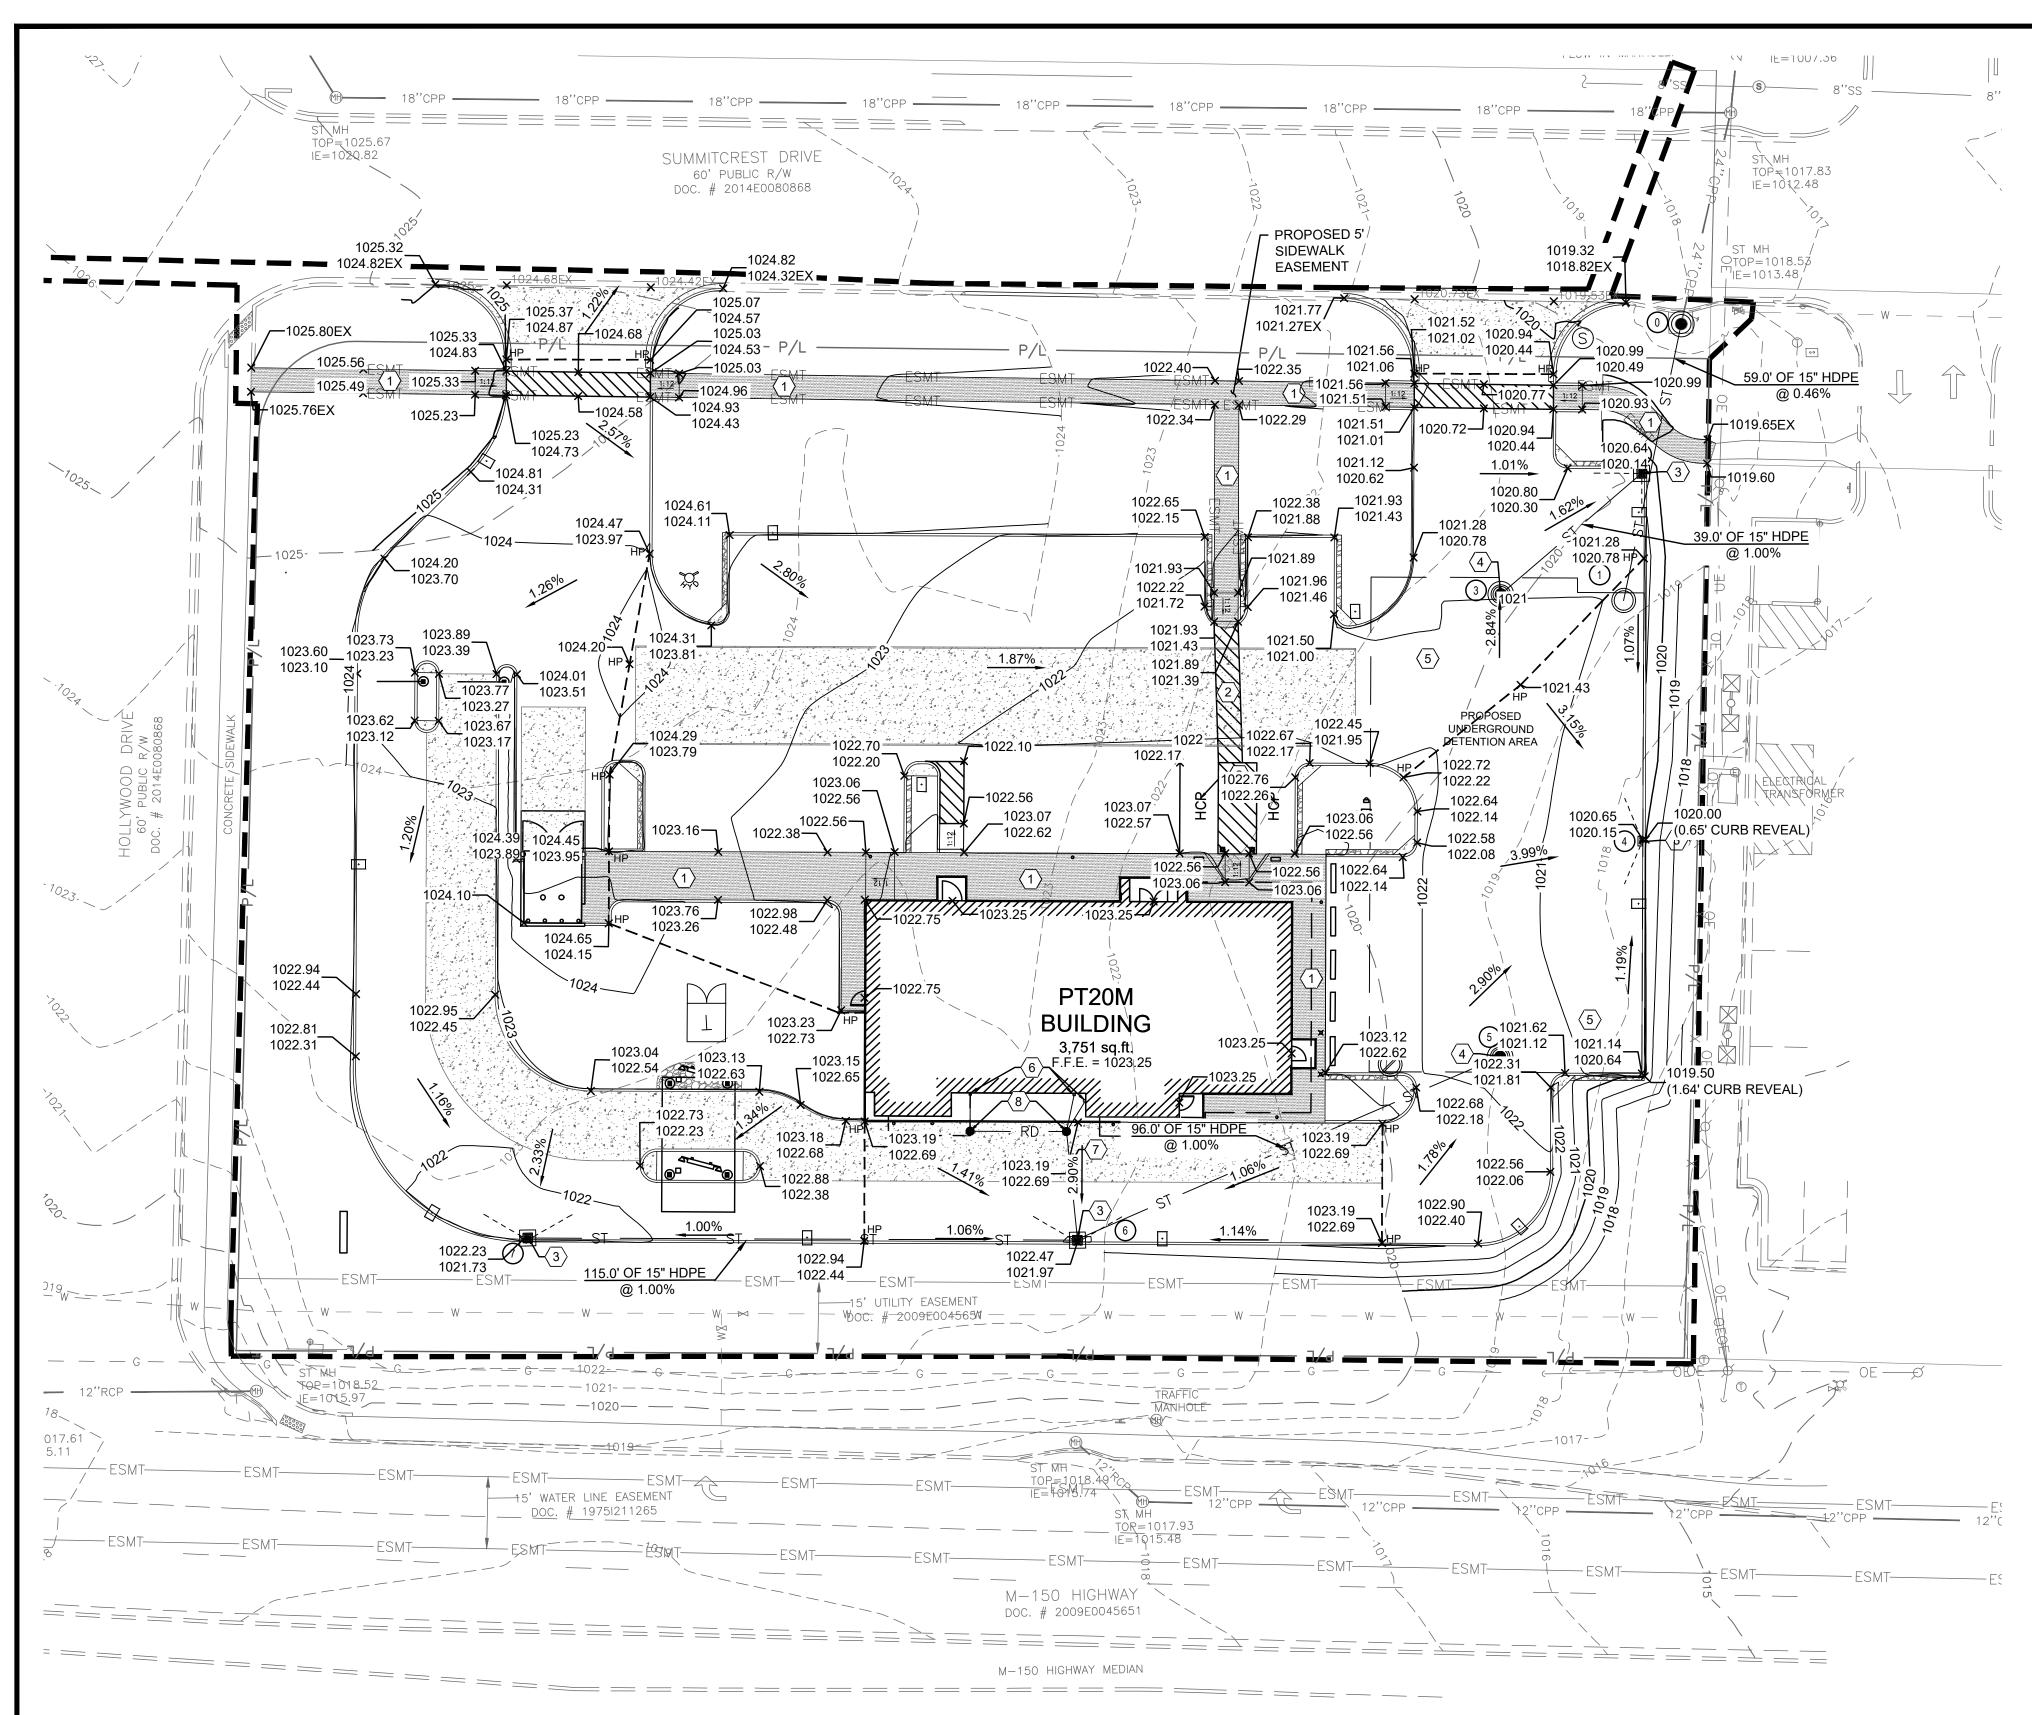
SHEET TITLE

CONCRETE JOINTING PLAN

DRAWN BY:	TDB
CHECKED BY:	PJK
PROJECT NO:	40497-21

DRAWING

C-4.0



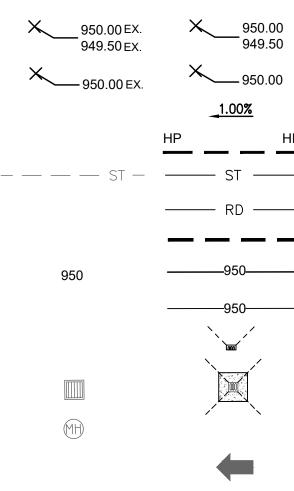
GENERAL NOTES:

- CLARKSVILLE, TN 37040.
- CITY OR LOCAL REQUIREMENTS, WHICHEVER HAS JURISDICTION.
- D. CONTRACTOR IS RESPONSIBLE FOR LOCATING AND VERIFYING ALL EXISTING UNDERGROUND UTILITIES PRIOR TO CONSTRUCTION.

- PRESENT TO INSTRUCT AND OBSERVE DURING CONSTRUCTION.
- ORIGINAL CONDITION AT NO ADDITIONAL COST TO THE OWNER OR CITY.
- ALL EXISTING UTILITIES ARE TAKEN FROM SURVEY AND DO NOT NECESSARILY REPRESENT ALL UNDERGROUND UTILITIES ADJACENT TO OR UPON PREMISES SHOWN ON PLAN.

KEYED NOTES:

- $\langle 1 \rangle$
- $\langle 2 \rangle$
- $\langle 3 \rangle$
- $\langle 4 \rangle$
- $\langle 5 \rangle$ SEE DETAILS ON SHEET C-7.5.
- $\langle 6 \rangle$ PROPOSED DOWNSPOUT COLLECTOR SYSTEM.
- $\langle 7 \rangle$ A MINIMUM SLOPE OF 1.00% ON ALL ROOF DRAIN PIPES.
- $\langle 8 \rangle$



A. ALL EXISTING CONDITIONS, TOPOGRAPHY, UTILITIES AND PROPERTY INFORMATION ARE TAKEN FROM A SURVEY OF LAND SITUATED IN THE CITY OF LEE'S SUMMIT, COUNTY OF JACKSON AND STATE OF MISSOURI, BY SURVEYOR: YOUNG-HOBBS AND ASSOCIATES, 1202 CROSSLAND AVENUE

ALL CONSTRUCTION METHODS AND MATERIAL MUST CONFORM TO CURRENT STANDARDS AND SPECIFICATIONS OF THE FEDERAL, STATE, COUNTY,

C. ALL PROPOSED SPOT ELEVATIONS SHOWN ARE TOP OF CURB AND FINAL GRADE ELEVATIONS UNLESS OTHERWISE NOTED.

E. CONTRACTOR TO VERIFY ALL EXISTING GRADES AND CONTACT ENGINEER PRIOR TO BEGINNING WORK IF DISCREPANCY IS FOUND. CONTRACTOR TO VERIFY ASSUMED FINISHED FLOOR ELEVATION PRIOR TO BEGINNING WORK.

F. THE EXCAVATING CONTRACTOR MUST TAKE PARTICULAR CARE WHEN EXCAVATING IN AND AROUND EXISTING UTILITY LINES AND EQUIPMENT. VERIFY COVER REQUIREMENTS BY UTILITY CONTRACTORS AND/OR UTILITY COMPANIES SO AS TO NOT CAUSE DAMAGE.

THE CONTRACTOR SHALL NOTIFY ALL UTILITY COMPANIES 48 HOURS BEFORE CONSTRUCTION IS TO START, TO VERIFY IF ANY UTILITIES ARE PRESENT ON SITE. ALL VERIFICATIONS (LOCATION, SIZE AND DEPTH) SHALL BE MADE BY THE APPROPRIATE UTILITY COMPANIES. WHEN EXCAVATION IS AROUND OR OVER EXISTING UTILITIES, THE CONTRACTOR MUST NOTIFY THE UTILITY SO A REPRESENTATIVE OF THAT UTILITY COMPANY CAN BE

ALL WORK SHALL BE PERFORMED FROM PRIVATE PROPERTY. ALL TRAFFIC LANES MUST REMAIN OPEN AT ALL TIMES.

CONTRACTOR IS RESPONSIBLE FOR ANY DAMAGE TO THE EXISTING UTILITIES DURING CONSTRUCTION AND ALL DAMAGE SHALL BE REPAIRED TO

J. CONTRACTOR SHALL INSTALL AND BACKFILL STRUCTURES AND TRENCHES PER DETAILS ON SHEET C-7.1.

L. ALL STORM CONDUITS ARE ADS N-12 SMOOTH INTERIOR HDPE PIPE OR APPROVED EQUAL, UNLESS OTHERWISE NOTED.

CONTRACTOR TO MAINTAIN 2.00% MAX CROSS SLOPE ON SIDEWALK.

CONTRACTOR TO MAINTAIN MAX 2.00% SLOPE IN ALL DIRECTIONS IN HANDICAP ACCESSIBLE AREA.

PROPOSED CURB INLET AND FINGER DRAIN. SEE DETAILS ON SHEETS C-7.1 AND C-7.5.

PROPOSED STORM MANHOLE/JUNCTION BOX. SEE DETAILS ON SHEET C-7.5 AND C-7.6.

PROPOSED UNDERGROUND DETENTION SYSTEM, ADS STORMTECH MC-3500 CHAMBER SYSTEM, 19665 CF

6" STORM LINE FROM ROOF DRAIN TO CONNECT TO PROPOSED STORM SYSTEM. CONTRACTOR TO MAINTAIN

PROPOSED STORM CLEANOUT. SEE DETAIL ON SHEET C-7.1 FOR DETAILS.

STORM STRUCTURE DATA

EXISTING STORM MANHOLE BIM = 1018 53 RIM = 1018.53 EX: 24" INV. (NE) = 1013.48 PR: 15" INV (SW) = 1013.48

- PROPOSED OUTLET CONTROL STRUCTURE RIM = 1020.84 PR: 15" INV (NW) = 1013.75
- PROPOSED CURB INLET 2 RIM = 1020.16 PR: 15" INV (NW) = 1014.14
- (3) PROPOSED STORM MANHOLE RIM = 1020.97 PR: 15" INV (NE) = 1013.75
- PROPOSED CURB INLET 4 RIM = 1020.17
- 5 PROPOSED STORM MANHOLE RIM = 1021.49 PR: 15" INV (SE) = 1013.75
- 6 PROPOSED CURB INLET RIM = 1021.71 PR: 15" INV (NE) = 1014.71
- PROPOSED CURB INLET RIM = 1021.75 PR: 15" INV (E) = 1015.85



10 20 30 40

SCALE: 1"=20'

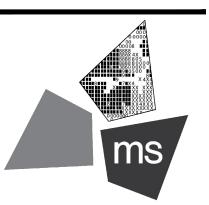
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PROJECT

PROPOSED PT20M BUILDING

NEQ HWY 150 & SW HOLLYWOOD DR. LEE'S SUMMIT, MO 64082

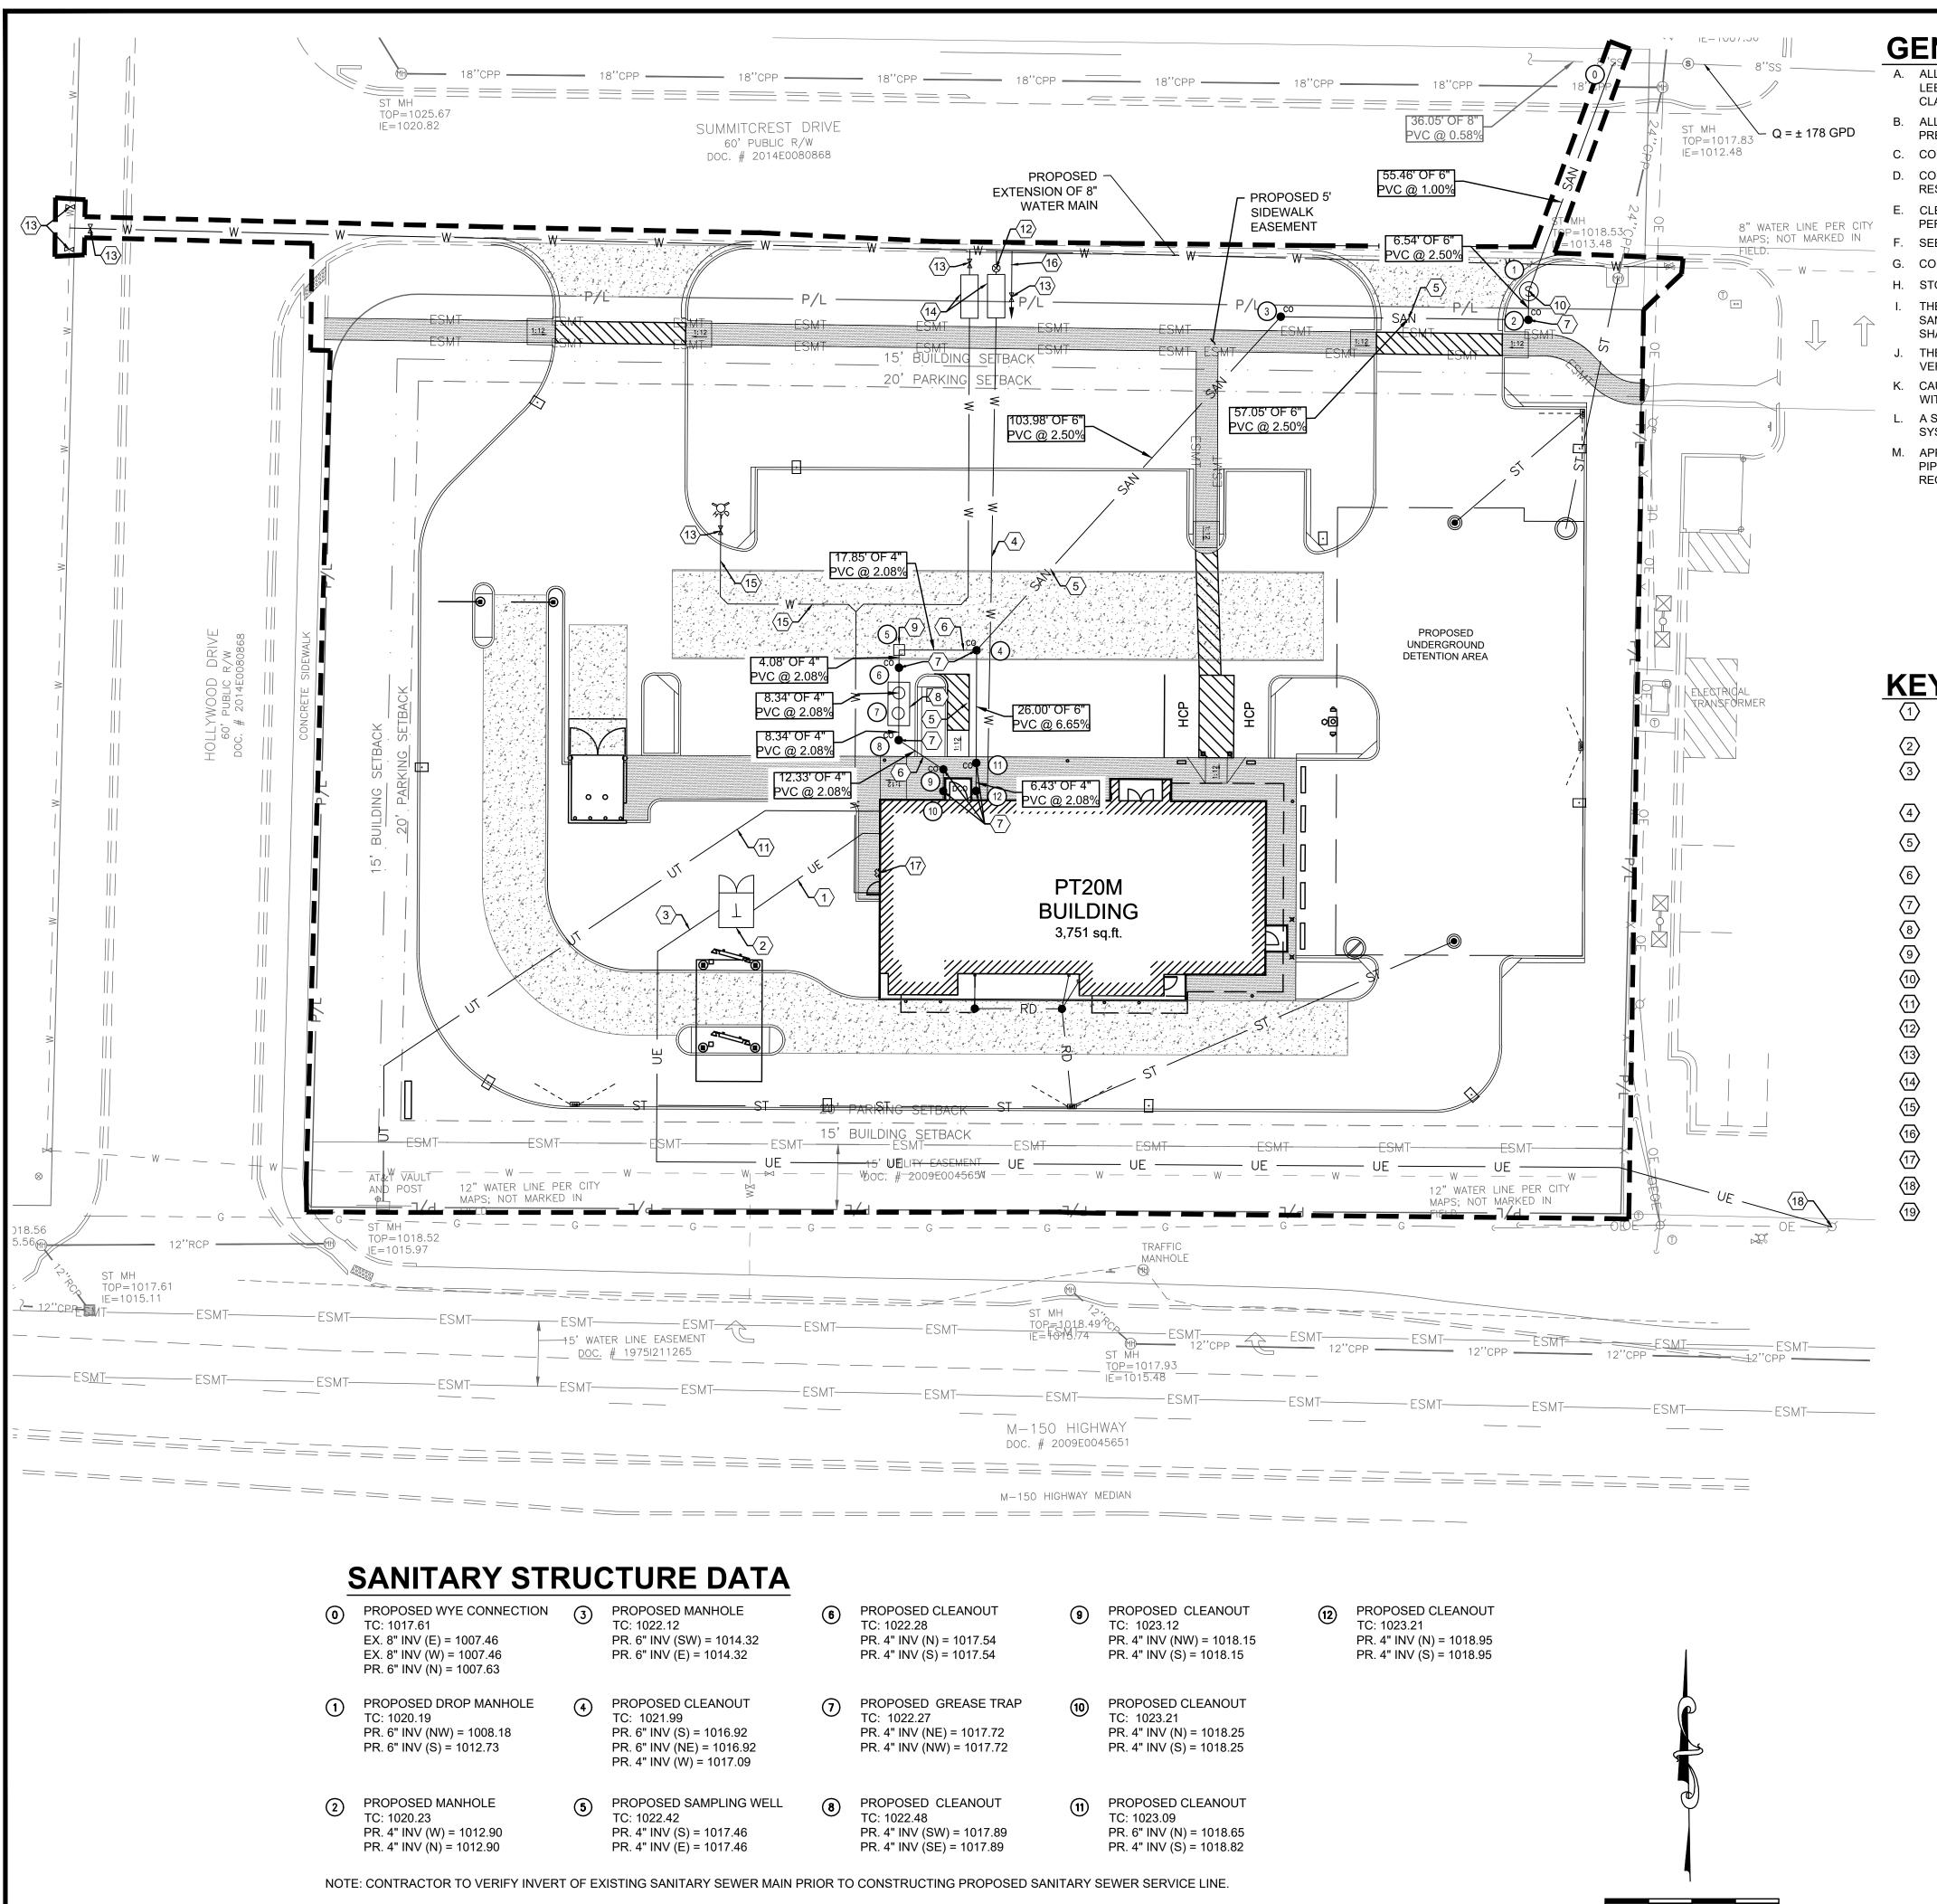
SHEET TITLE

SITE GRADING AND DRAINAGE PLAN

DRAWN BY:	TDB
CHECKED BY:	PJK
PROJECT NO:	40497-21

DRAWING

C-5.0



GENERAL NOTES:

- CLARKSVILLE, TN 37040.
- PREMISES SHOWN ON PLAN.
- - PER DETAIL ON SHEET C-7.1.
 - F. SEE PLUMBING PLANS FOR CONTINUATION OF UTILITY LINES INTO BUILDING.

 - SHALL BE AT LEAST 18 INCHES ABOVE THE TOP OF THE SEWER.

 - WITH UTILITY OWNER.
 - SYSTEM, IF REQUIRED BY THE CITY ENGINEER.
 - REQUIRED BY THE CITY ENGINEER.

KEYED NOTES:

- PROPOSED ELECTRIC TRANSFORMER. COORDINATE DETAILS AND LOCATION WITH UTILITY OWNER AND ELECTRICAL PLANS. 36" OF COVER OF SEWER LINES. 36" OF COVER OF SEWER LINES. MONITORING WELL, SEE PLUMBING PLANS FOR DETAILS PROPOSED DOMESTIC WATER METER PER CITY OF LEE'S SUMMIT STANDARD DRAWING WAT-11. SEE SHEET C-7.2. PROPOSED WATER VALVE PER LOCAL REGULATIONS AND DETAILS. PROPOSED 6" FIRE SERVICE LINE.
- PROPOSED FIRE DEPARTMENT CONNECTION.

LEGEND EXISTING — — — ST — - - - SAN -(S)

- _____W____ Ø — — — UE —
- _____
- 0 10 20 30
 - SCALE: 1"=20'

A. ALL EXISTING CONDITIONS, TOPOGRAPHY, UTILITIES AND PROPERTY INFORMATION ARE TAKEN FROM A SURVEY OF LAND SITUATED IN THE CITY OF LEE'S SUMMIT, COUNTY OF JACKSON AND STATE OF MISSOURI, BY SURVEYOR: YOUNG-HOBBS AND ASSOCIATES, 1202 CROSSLAND AVENUE

B. ALL EXISTING UTILITIES, ARE TAKEN FROM SURVEY AND DO NOT NECESSARILY REPRESENT ALL UNDERGROUND UTILITIES ADJACENT TO OR UPON

C. CONTRACTOR RESPONSIBLE FOR MAINTAINING A MIN. COVER OF 42" OVER PROPOSED WATER SERVICE.

D. CONTRACTOR IS RESPONSIBLE FOR LOCATING AND VERIFYING ALL EXISTING UNDERGROUND UTILITIES PRIOR TO CONSTRUCTION, AND IS RESPONSIBLE FOR ANY DAMAGE TO THEM DURING CONSTRUCTION.

E. CLEANOUT LOCATIONS ARE NUMBERED ON PLAN. ALL CLEANOUTS IN PAVEMENT AREAS ARE TO BE H-20 RATED. CLEANOUTS SHALL BE INSTALLED

G. CONTRACTOR SHALL INSTALL AND BACKFILL ALL TRENCHES AND STRUCTURES PER DETAIL ON SHEET C-7.1

H. STORM SEWER SHOWN HERE FOR REFERENCE ONLY. SEE GRADING PLAN FOR DESIGN DATA

I. THERE SHALL BE A MINIMUM 10 FOOT HORIZONTAL SEPARATION BETWEEN WATER TAPS, WATER SERVICES, PRIVATE WATER SYSTEMS, AND ANY SANITARY AND/OR STORM SEWER SYSTEMS. WHERE 10 FEET HORIZONTAL SEPARATION CANNOT BE OBTAINED, THE BOTTOM OF THE WATER LINE

J. THE EXCAVATING CONTRACTOR MUST TAKE PARTICULAR CARE WHEN EXCAVATING IN AND AROUND EXISTING UTILITY LINES AND EQUIPMENT. VERIFY COVER REQUIREMENTS BY UTILITY CONTRACTORS AND/OR UTILITY COMPANIES SO AS TO NOT CAUSE DAMAGE. K. CAUTION: OVERHEAD LINES ARE PRESENT ON SITE. CONTRACTOR TO TAKE SPECIAL CARE TO PREVENT DAMAGE TO THE LINES AND COORDINATE

L. A SANITARY SEWER IMPACT STATEMENT THAT WILL ADDRESS THE PROPOSED DISCHARGE INTO THE EXISTING SANITARY SEWER RECEIVING

M. APPROPRIATE WATER SERVICE DEMAND DATA (INCLUDING, BUT NOT LIMITED TO, PLANNED LAND USAGE, DENSITIES OF PROPOSED DEVELOPMENT, PIPE SIZES, CONTOURS AND FIRE HYDRANT LAYOUT) TO ALLOW FOR THE PRELIMINARY ANALYSIS OF THE DEMAND FOR WATER SERVICE IF

PROPOSED PRIMARY ELECTRICAL SERVICE. CONTRACTOR TO COORDINATE CONDUIT SIZE, NUMBER OF CONDUITS, CONNECTIONS, AND BEND RADII WITH UTILITY OWNER AND MEP PLANS. CONTRACTOR TO COORDINATE CONNECTION WITH UTILITY OWNER.

PROPOSED SECONDARY ELECTRICAL SERVICE. CONTRACTOR TO COORDINATE CONDUIT SIZE, NUMBER OF CONDUITS, CONNECTIONS, AND BEND RADII WITH UTILITY OWNER AND MEP PLANS. CONTRACTOR TO COORDINATE CONNECTION WITH UTILITY OWNER.

PROPOSED TYPE K COPPER 1.5" DOMESTIC WATER SERVICE. INCLUDE IN BASE BID ALL VALVES, PIPING, STRUCTURES, ETC. THAT WILL BE REQUIRED. SEE MEP PLANS FOR CONTINUATION INTO BUILDING. SEE DETAIL ON SHEET C-7.2. PROPOSED 6" SANITARY SEWER. ASTM D3034, SDR-26. SEWER TO HAVE MINIMUM SLOPE OF 1.00%. CONTRACTOR TO MAINTAIN A MINIMUM OF

PROPOSED 4" SANITARY SEWER. ASTM D3034, SDR-26. SEWER TO HAVE MINIMUM SLOPE OF 2.08%. CONTRACTOR TO MAINTAIN A MINIMUM OF

PROPOSED SANITARY CLEANOUT (TYP.). SEE DETAIL ON SHEET C-7.1.

GREASE TRAP REQUIRED. SEE PLUMBING SHEETS FOR DETAILS.

PROPOSED SANITARY SEWER SERVICE DROP MANHOLE. SEE DETAIL ON SHEET C-7.2.

2" PVC CONDUIT FOR UNDERGROUND TELEPHONE SERVICE. CONTRACTOR TO COORDINATE CONNECTION WITH UTILITY OWNER.

PROPOSED BACKFLOW PREVENTER VAULT PER CITY OF LEE'S SUMMIT STANDARD DRAWING WAT-12. SEE SHEET C-7.2.

PROPOSED 1" IRRIGATION LINE. SEE IRRIGATION PLAN FOR MORE INFORMATION.

PROPOSED ELECTRICAL CONNECTION. CONTRACTOR TO COORDINATE WITH UTILITY OWNER.

PROPOSED SANITARY SEWER WYE CONNECTION TO EXISTING SANITARY SEWER STUB. SEE DETAIL ON SHEET C-7.2.

PROPOSED	DESCRIPTION
	CONSTRUCTION LIMITS
ST	STORM LINE
RD	ROOFDRAIN/UNDERDRAIN
SAN	SANITARY LINE
● ^{co}	SANITARY CLEANOUT
S	SANITARY MANHOLE
00	SANITARY GREASE TRAP
w	WATER LINE
	FIRE HYDRANT
$\boldsymbol{\Theta}$	WATER METER
UE	UNDERGROUND ELECTRIC LINE
Γ-R	ELECTRIC TRANSFORMER
UT	UNDERGROUND TELEPHONE LINE
Ģ	LIGHT POLE



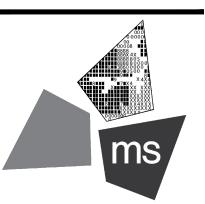
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PROJECT

PROPOSED PT20M BUILDING

NEQ HWY 150 & SW HOLLYWOOD DR. LEE'S SUMMIT, MO 64082

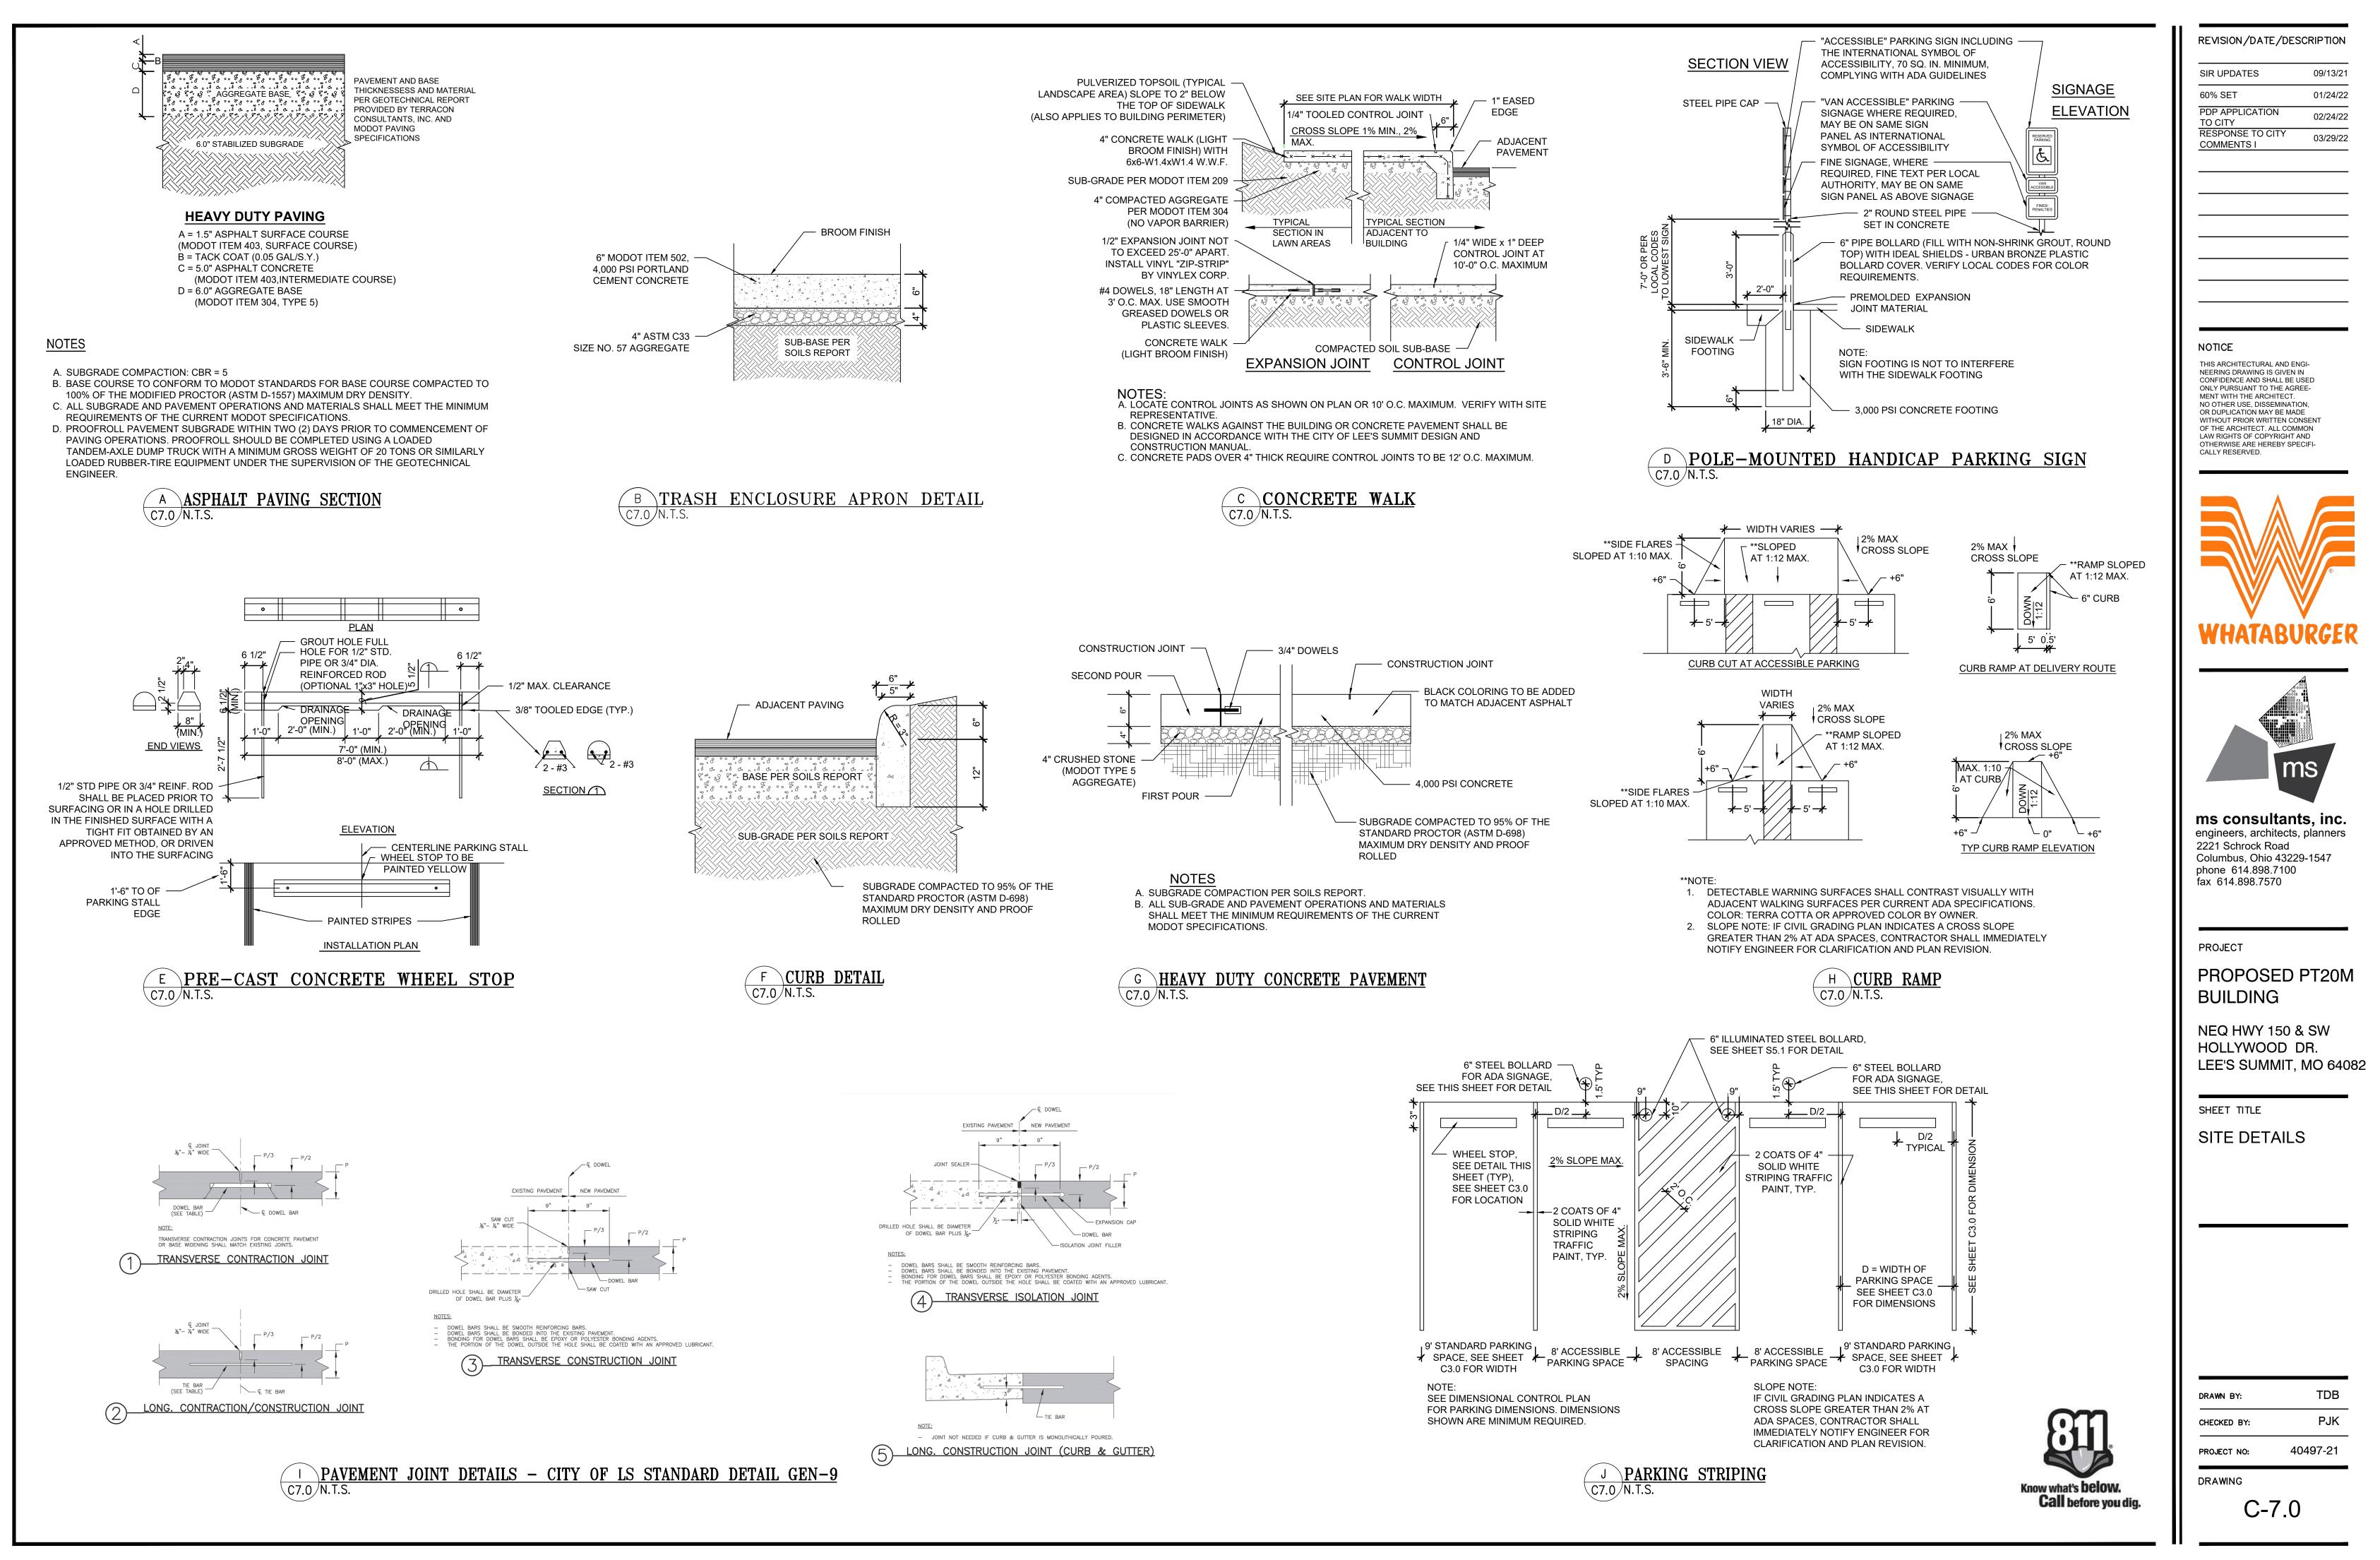
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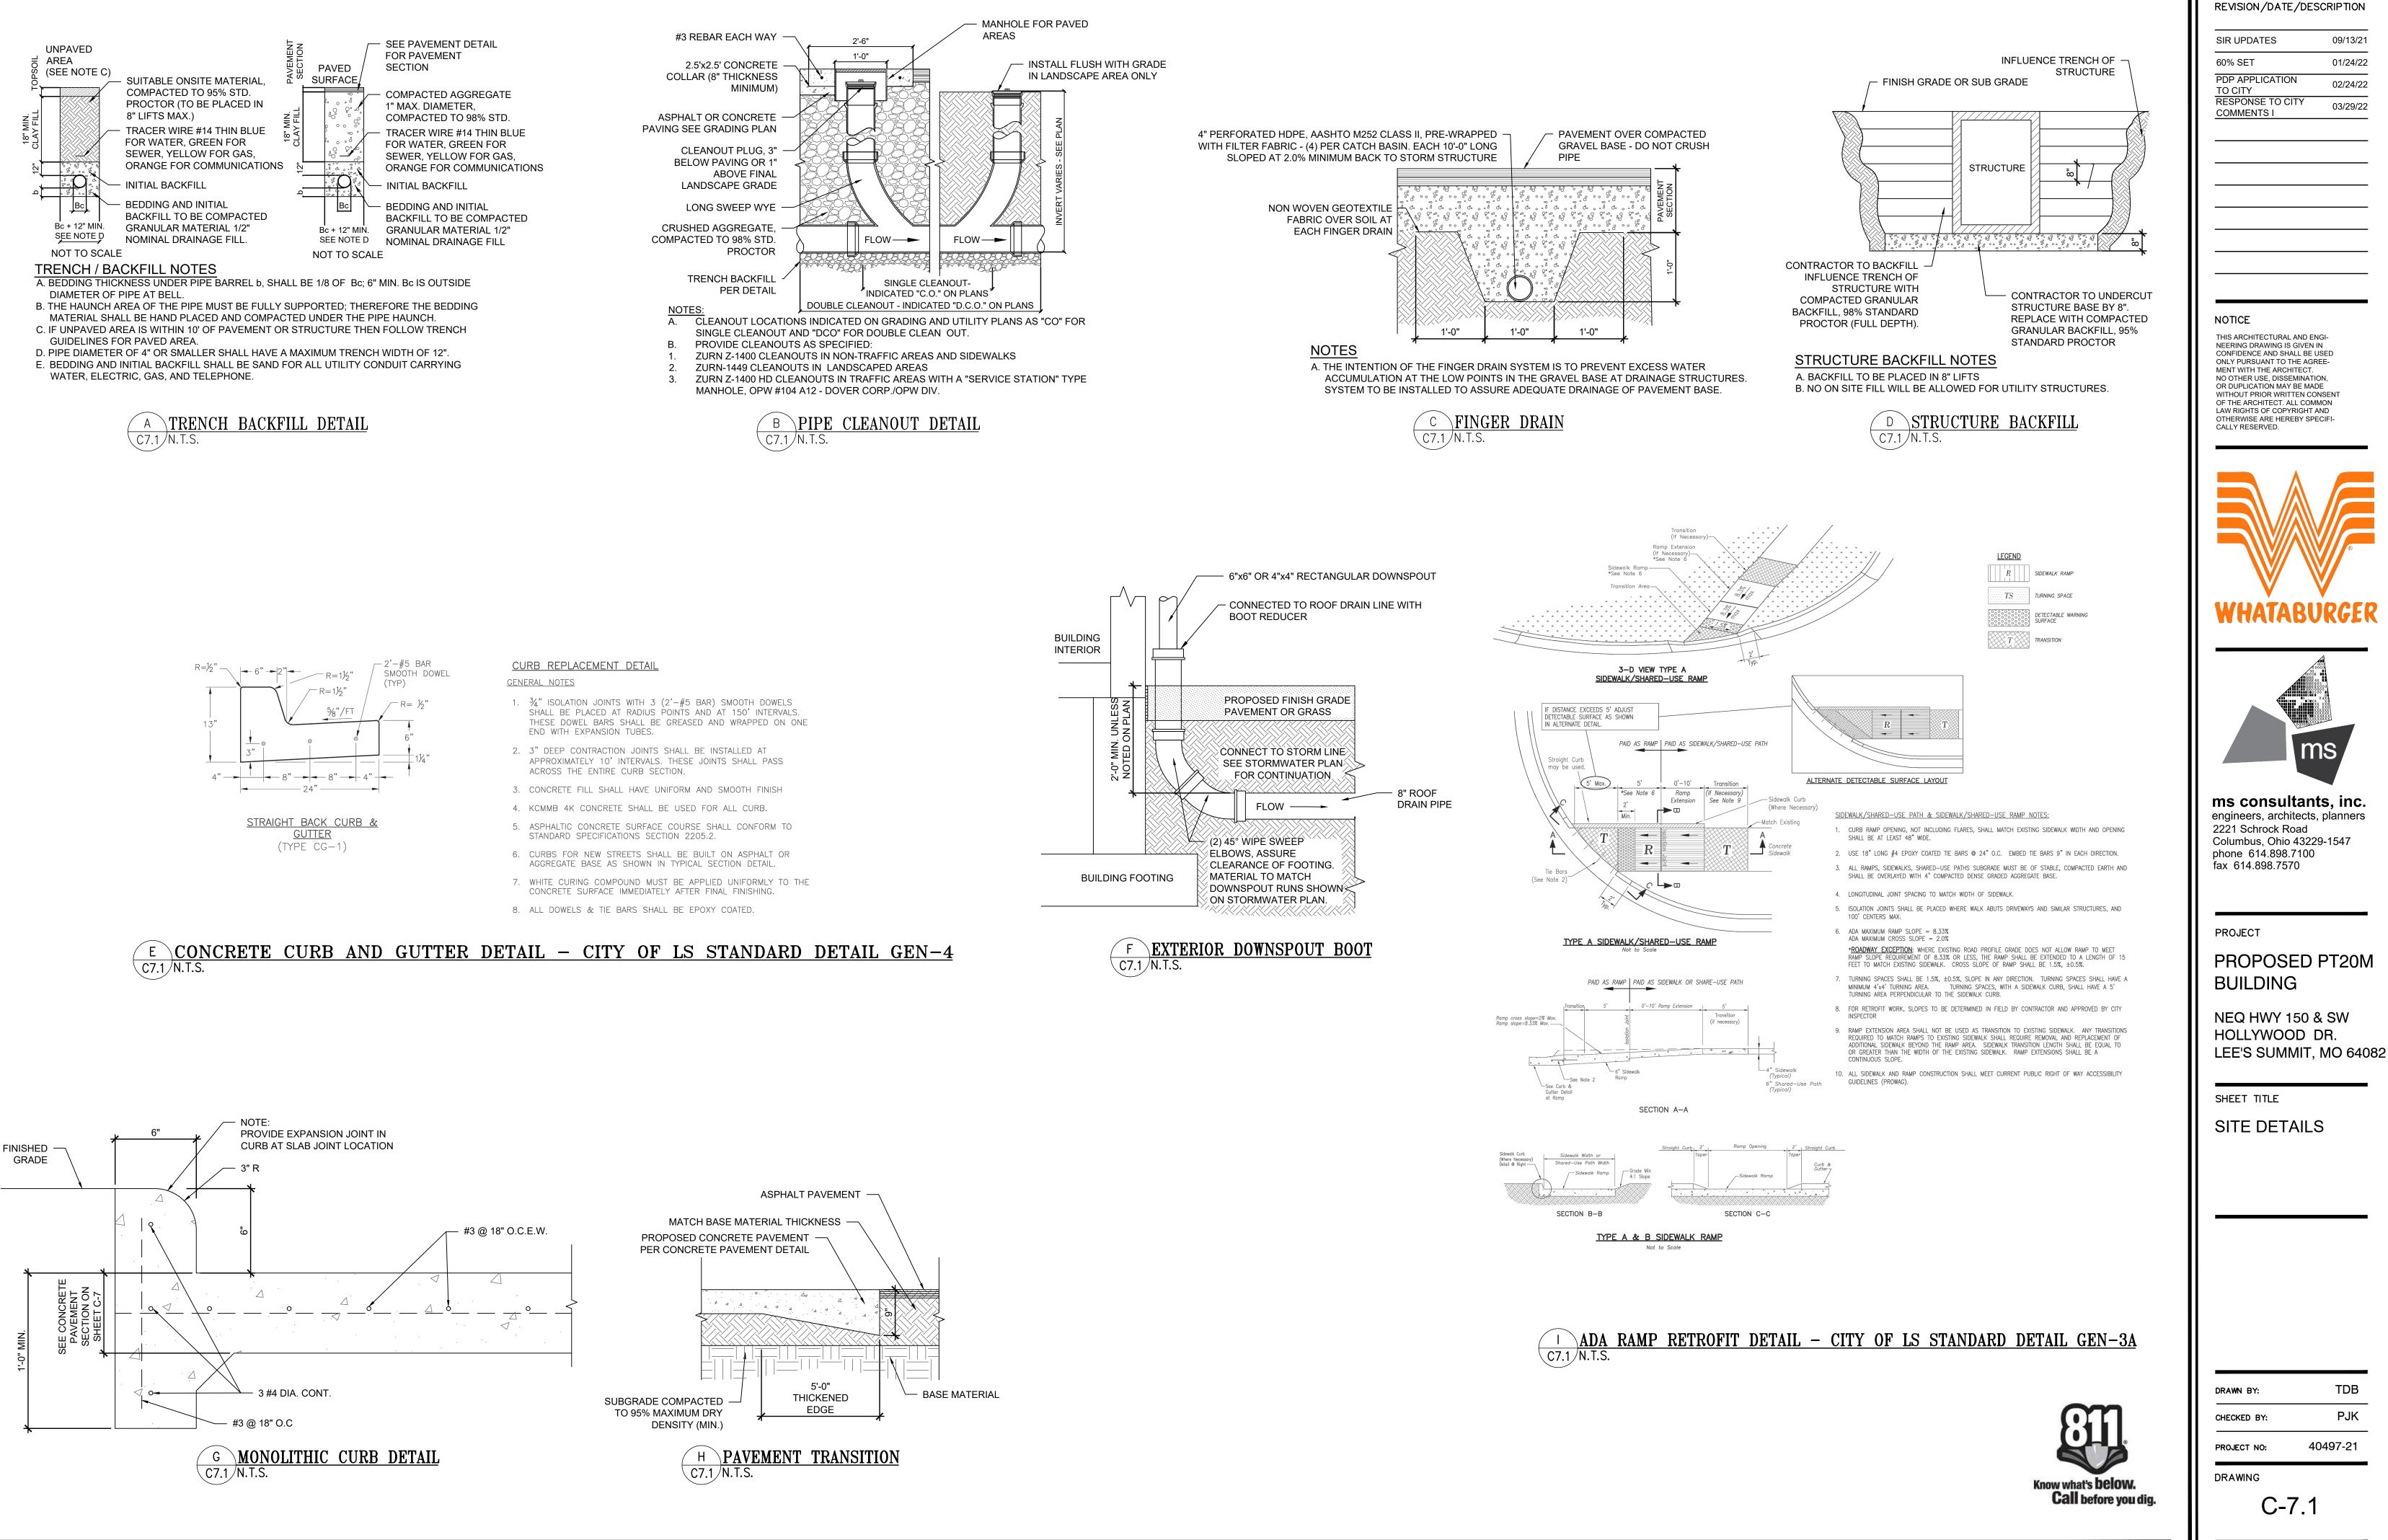
SITE UTILITY PLAN

DRAWN BY:	TDB
CHECKED BY:	PJK
PROJECT NO:	40497-21

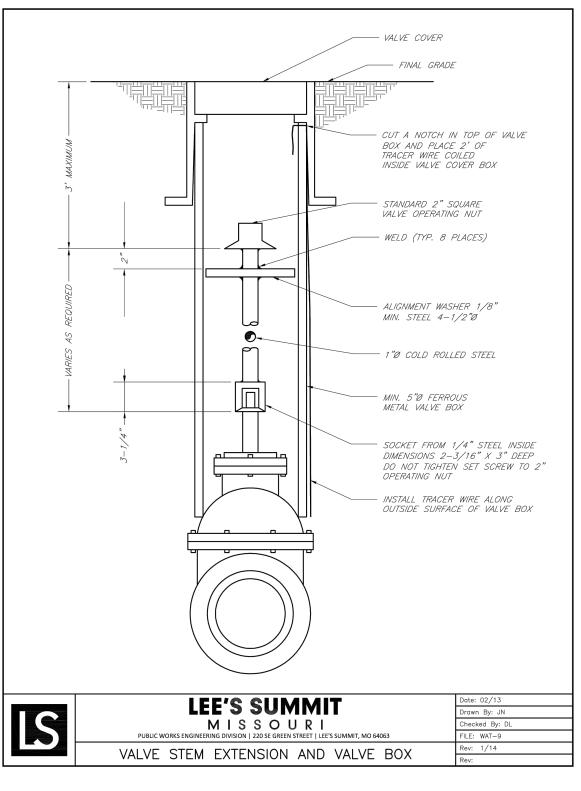
DRAWING

C-6.0

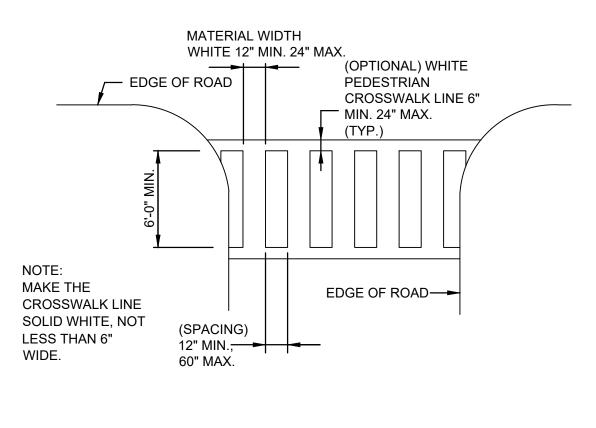




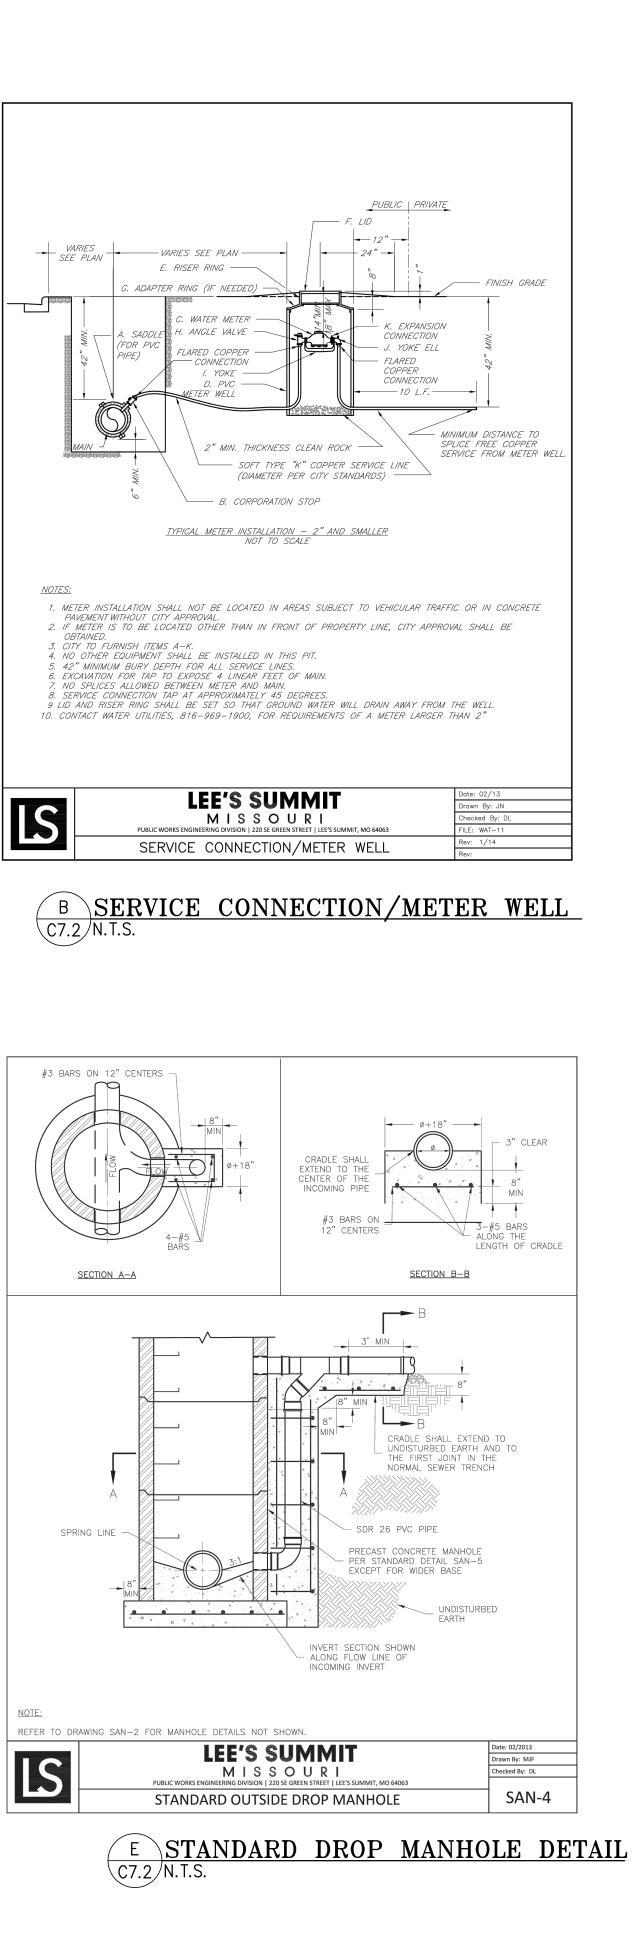
HECKED BY:	PJK
ROJECT NO:	40497-21

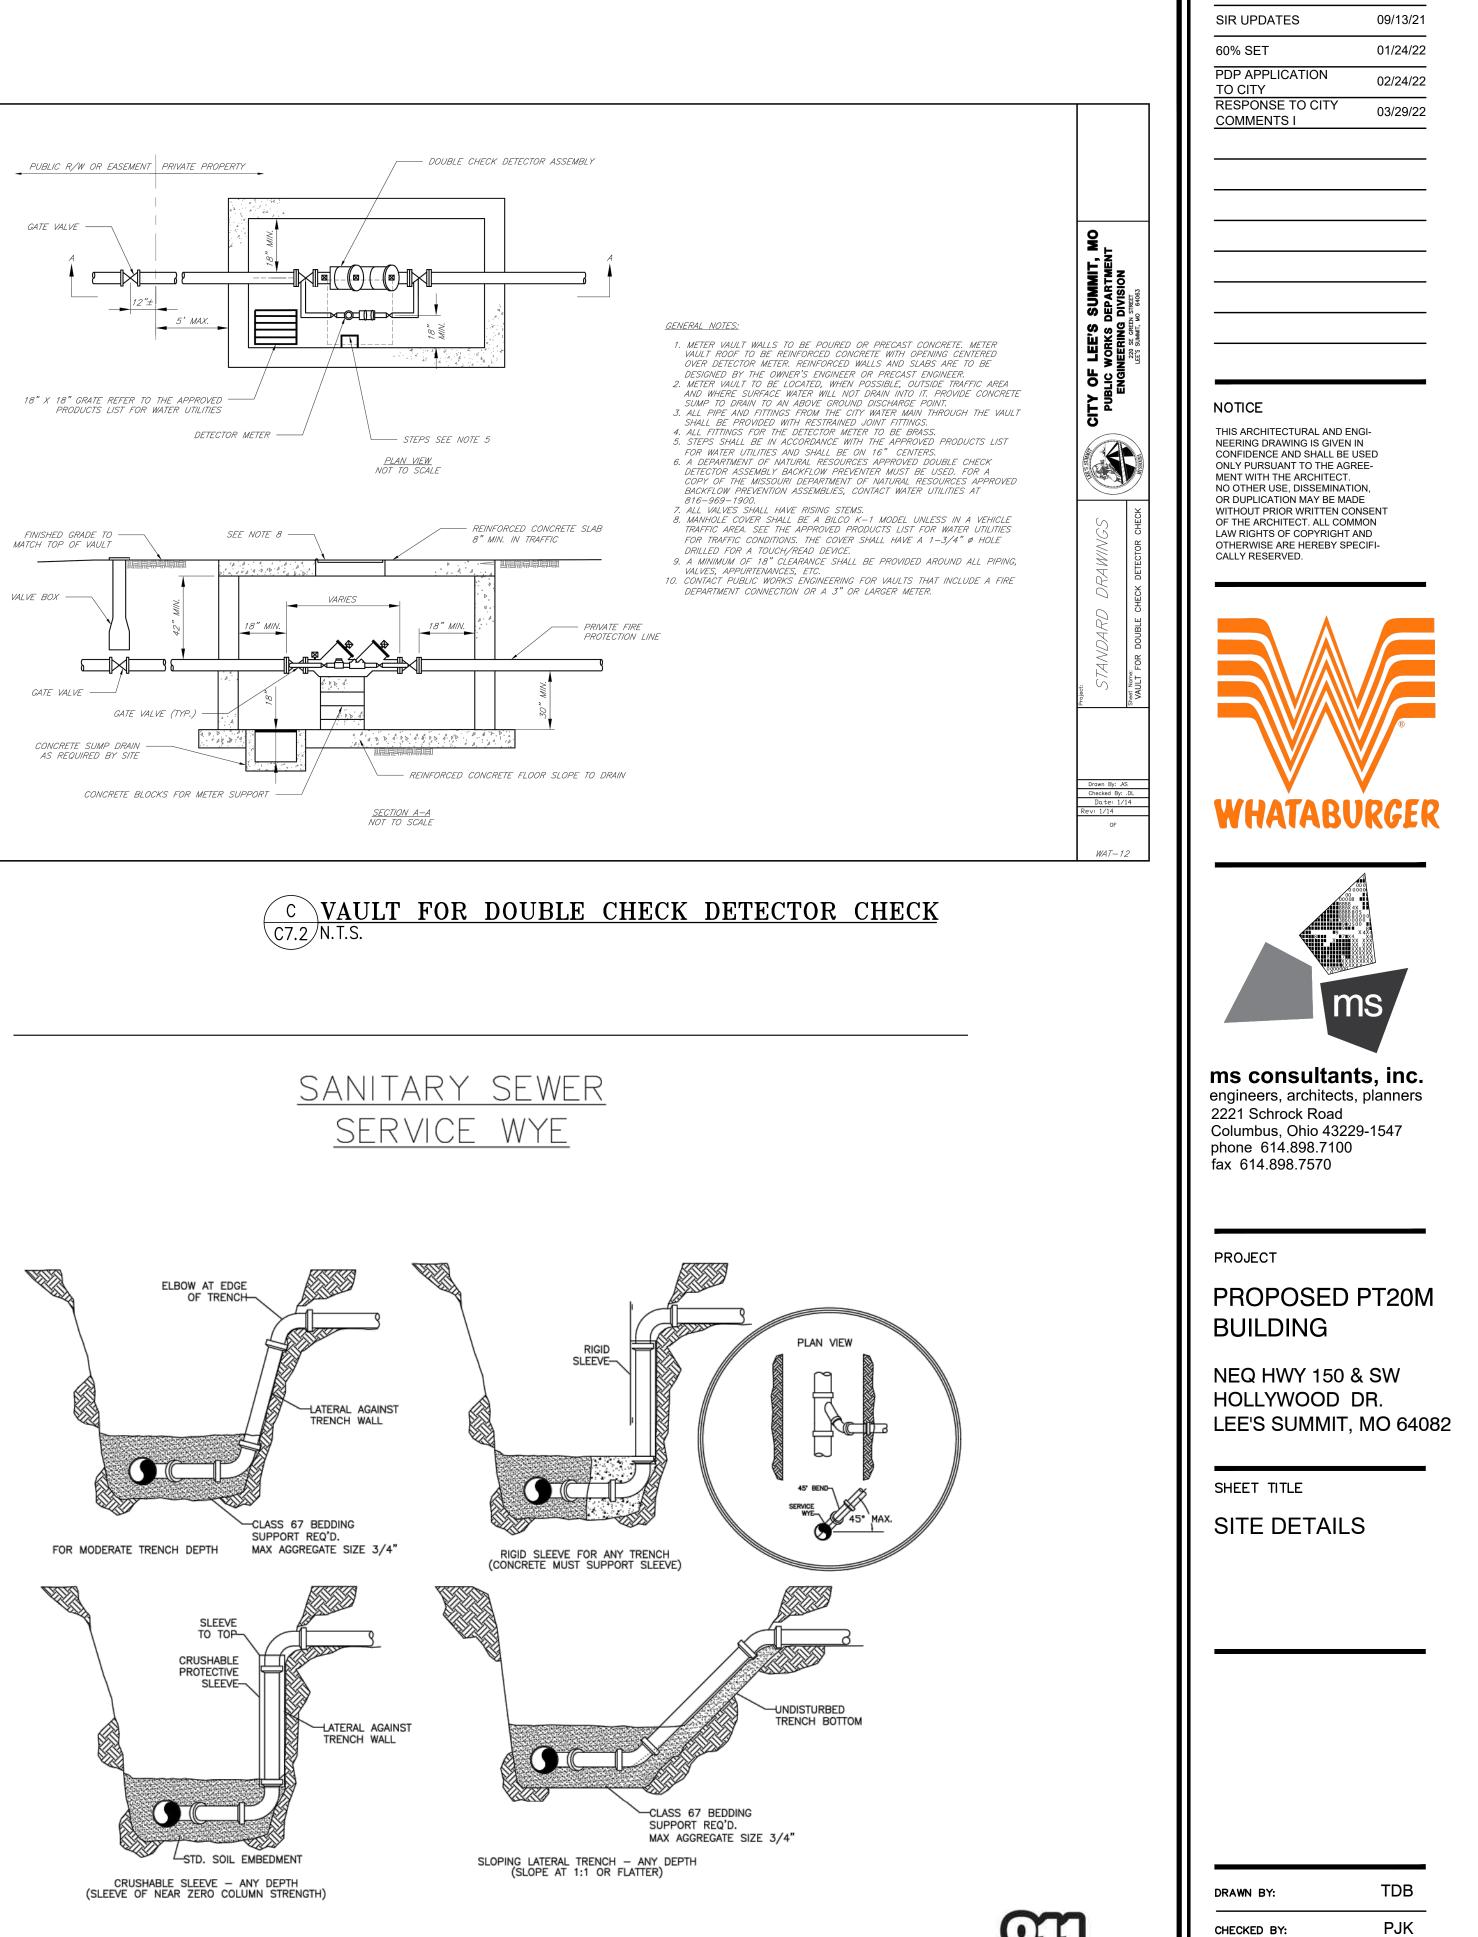


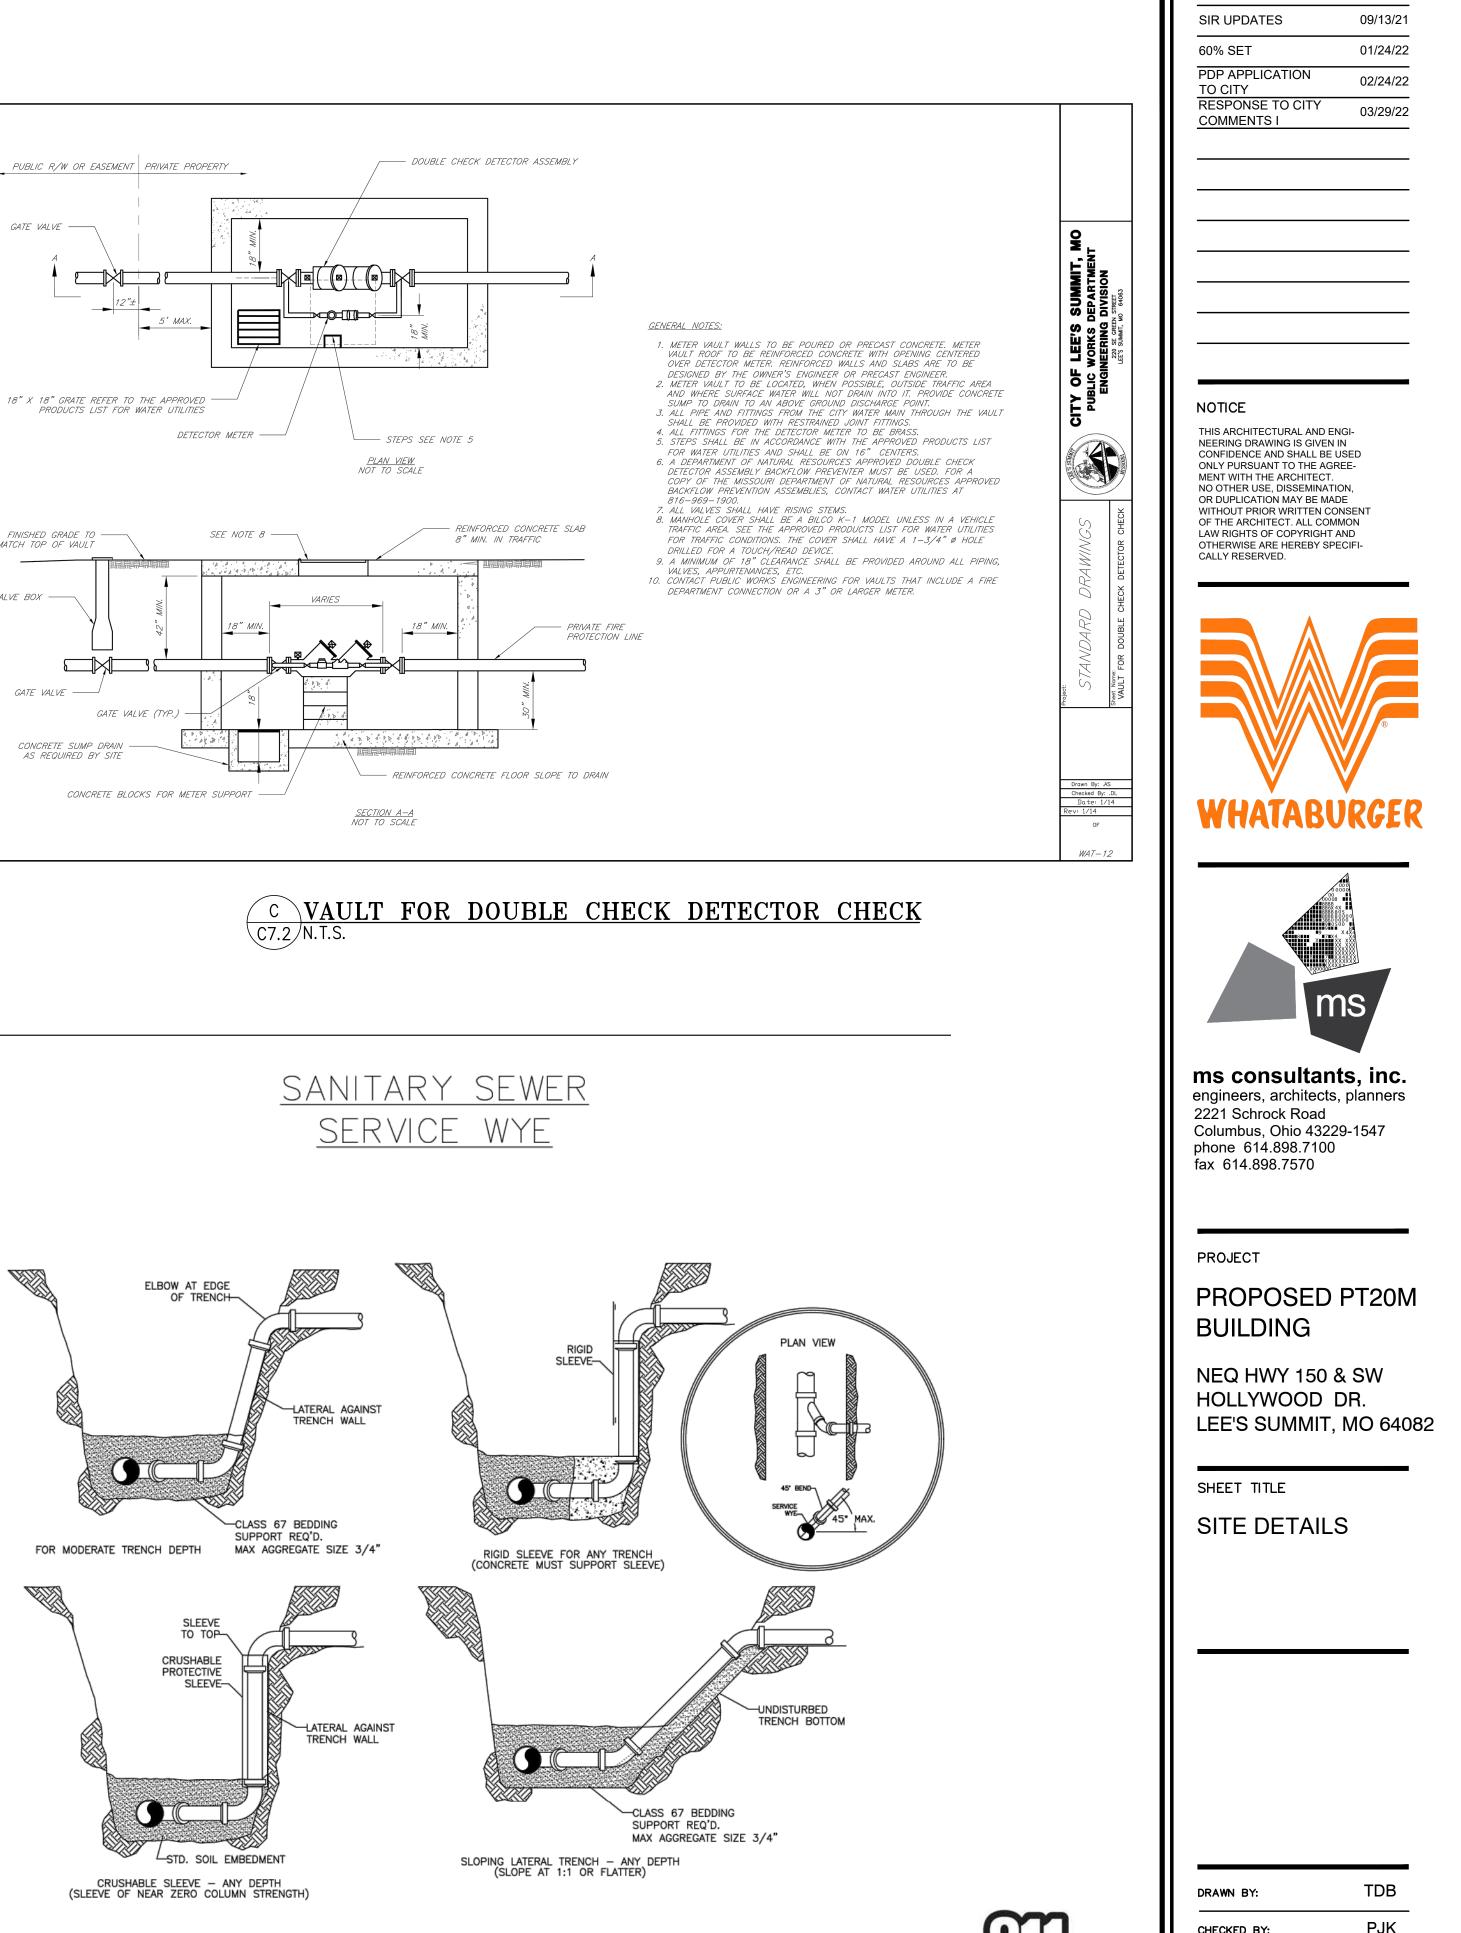




D SIDEWALK CROSSING DETAIL C7.2 N.T.S.







F SANITARY SERVICE WYE DETAIL C7.2 N.T.S.



40497-21

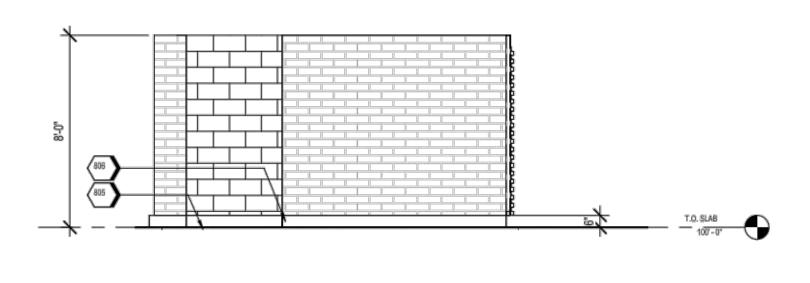
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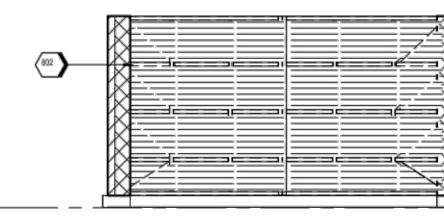




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100'-0"







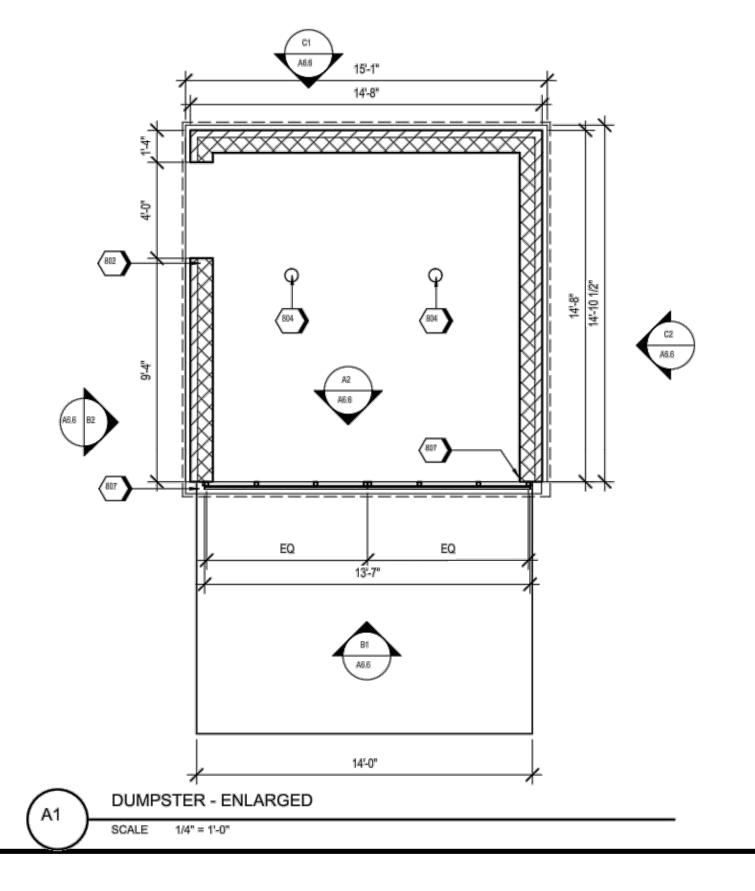
DUMPSTER - GATE INSIDE FACE

KEYNOTES

5	PAINTED CMU FOR WALLS OF ENCLOSURE.
801	PRE-FINISHED CORRUGATED METAL PANEL (MP-01)
802	STRUCTURAL STEEL, PAINT WELDED UNITS PT-5, RE: STRUCTURAL
804	PIPE BOLLARDS: IDEAL SHIELD: URBAN BRONZE, PANTONE 2336 XGC. RE D3/S5.1
805	FINISHED PAVEMENT, RE: CIVIL
806	CONCRETE CURB, RE: STRUCTURAL
807	WELD ANGLE STOPS TO CORNER POST, PAINT PT-5

		\uparrow
(801)		-24 -24
[1.0. SLAB





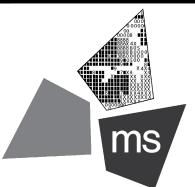
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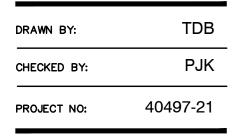
PROJECT

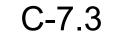
PROPOSED PT20M BUILDING

NEQ HWY 150 & SW HOLLYWOOD DR. LEE'S SUMMIT, MO 64082

SHEET TITLE

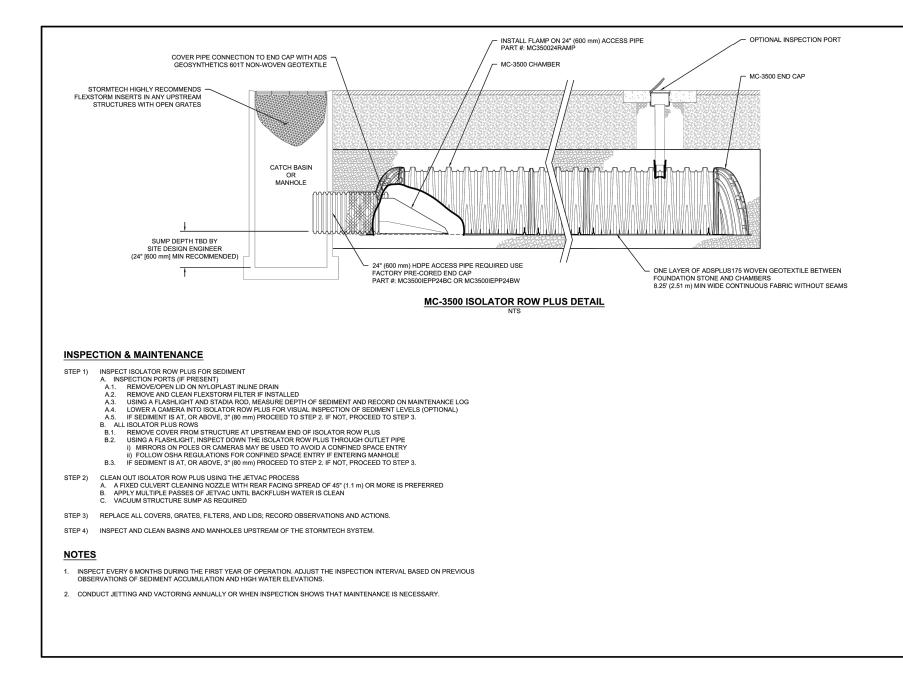
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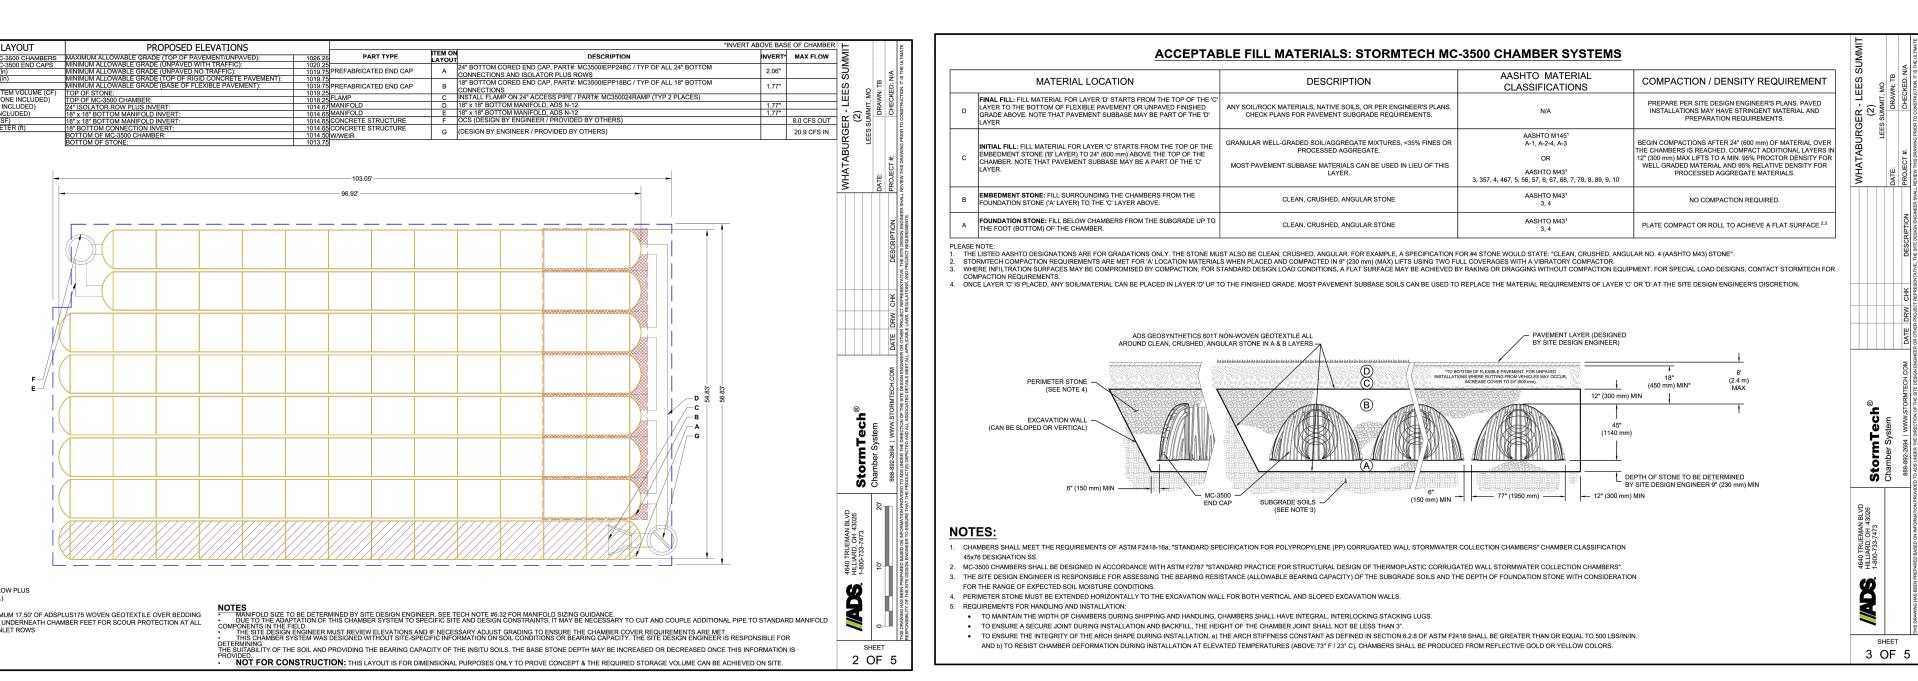


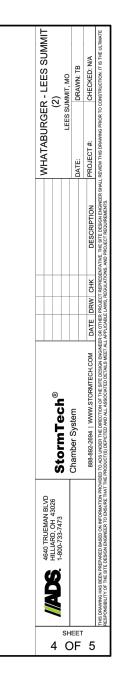


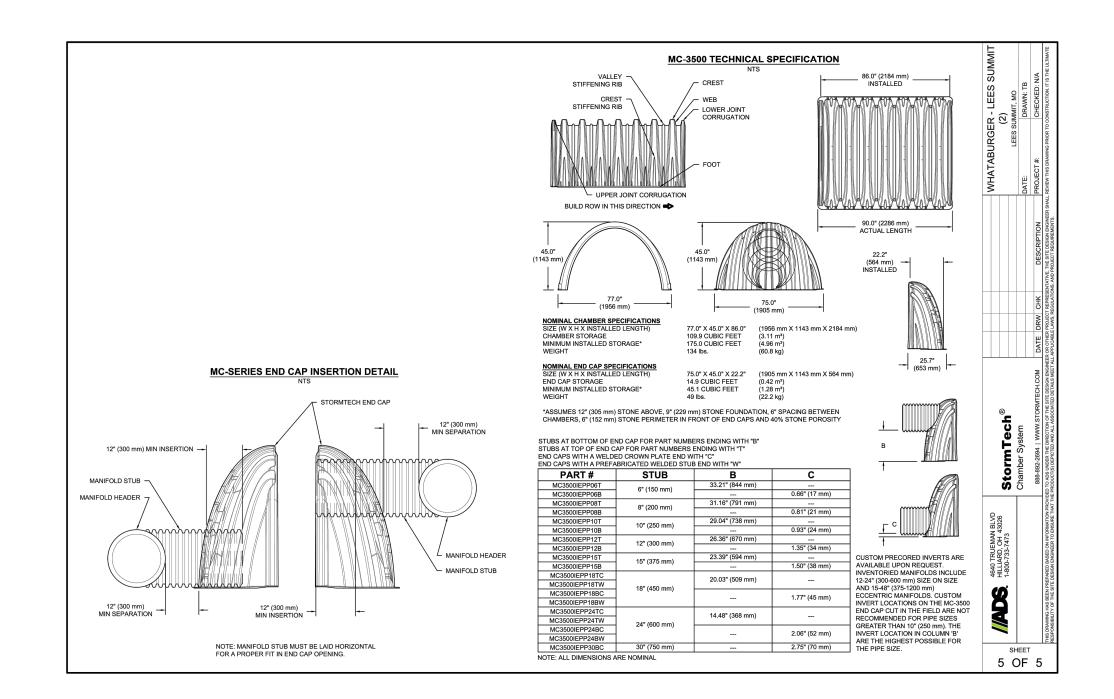


PROJECT INFORMATION		PROPOS 102 STORMTEC 16 STORMTEC 12 STONE ABC
IGINEERED PRODUCT		9 STONE ABC 9 STONE BEL 40 STONE VOI
NAGER	FOR STORMTECH INSTRUCTIONS, DOWNLOAD THE	19665 (PERIMETEI (COVER STO) (BASE STO)
NO SALES REP	Advanced Drainage Systems, Inc.	5815 SYSTEM AR 319.8 SYSTEM PE
WHATABURG	ER - LEES SUMMIT (2)	
	ES SUMMIT, MO	
IC-3500 STORMTECH CHAMBER SPECIFICATIONS	IMPORTANT - NOTES FOR THE BIDDING AND INSTALLATION OF MC-3500 CHAMBER SYSTEM	
CHAMBERS SHALL BE STORMTECH MC-3500.	 STORMTECH MC-3500 CHAMBERS SHALL NOT BE INSTALLED UNTIL THE MANUFACTURER'S REPRESENTATIVE HAS COMPLETED A PRE-CONSTRUCTION MEETING WITH THE INSTALLERS. 	
CHAMBERS SHALL BE ARCH-SHAPED AND SHALL BE MANUFACTURED FROM VIRGIN, IMPACT-MODIFIED POLYPROPYLENE COPOLYMERS.	 STORMTECH MC-3500 CHAMBERS SHALL BE INSTALLED IN ACCORDANCE WITH THE "STORMTECH MC-3500/MC-4500 CONSTRUCTION GUIDE". 	
COPOLIMERS. CHAMBERS SHALL MEET THE REQUIREMENTS OF ASTM F2418-16a, "STANDARD SPECIFICATION FOR POLYPROPYLENE (PP) CORRUGATED WALL STORMWATER COLLECTION CHAMBERS" CHAMBER CLASSIFICATION 45x76 DESIGNATION SS.	 CHAMBERS ARE NOT TO BE BACKFILLED WITH A DOZER OR AN EXCAVATOR SITUATED OVER THE CHAMBERS. STORMTECH RECOMMENDS 3 BACKFILL METHODS: STONESHOOTER LOCATED OFF THE CHAMBER BED. 	
CHAMBER ROWS SHALL PROVIDE CONTINUOUS, UNOBSTRUCTED INTERNAL SPACE WITH NO INTERNAL SUPPORTS THAT WOULD IMPEDE FLOW OR LIMIT ACCESS FOR INSPECTION.	 BACKFILL AS ROWS ARE BUILT USING AN EXCAVATOR ON THE FOUNDATION STONE OR SUBGRADE. BACKFILL FROM OUTSIDE THE EXCAVATION USING A LONG BOOM HOE OR EXCAVATOR. 	
IMPEDE FLOW OR LIMIT ACCESS FOR INSPECTION. THE STRUCTURAL DESIGN OF THE CHAMBERS, THE STRUCTURAL BACKFILL, AND THE INSTALLATION REQUIREMENTS SHALL ENSUI	4. THE FOUNDATION STONE SHALL BE LEVELED AND COMPACTED PRIOR TO PLACING CHAMBERS.	
THAT THE LOAD FACTORS SPECIFIED IN THE AASHTO LRFD BRIDGE DESIGN SPECIFICATIONS, SECTION 12.12, ARE MET FOR: 1) LONG-DURATION DEAD LOADS AND 2) SHORT-DURATION LIVE LOADS, BASED ON THE AASHTO DESIGN TRUCK WITH CONSIDERATIO	5. JOINTS BETWEEN CHAMBERS SHALL BE PROPERLY SEATED PRIOR TO PLACING STONE.	
FOR IMPACT AND MULTIPLE VEHICLE PRESENCES.	 MAINTAIN MINIMUM - 6" (150 mm) SPACING BETWEEN THE CHAMBER ROWS. 	
CHAMBERS SHALL BE DESIGNED, TESTED AND ALLOWABLE LOAD CONFIGURATIONS DETERMINED IN ACCORDANCE WITH ASTM F27 "STANDARD PRACTICE FOR STRUCTURAL DESIGN OF THERMOPLASTIC CORRUGATED WALL STORMWATER COLLECTION CHAMBER LOAD CONFIGURATIONS SHALL INCLUDE: 1) INSTANTANEOUS (<1 MIN) AASHTO DESIGN TRUCK LIVE LOAD ON MINIMUM COVER 2) MAXIMUM PERMANENT (75-YR) COVER LOAD AND 3) ALLOWABLE COVER WITH PARKED (1-WEEK) AASHTO DESIGN TRUCK.	 INLET AND OUTLET MANIFOLDS MUST BE INSERTED A MINIMUM OF 12" (300 mm) INTO CHAMBER END CAPS. IS⁸. EMBEDMENT STONE SURROUNDING CHAMBERS MUST BE A CLEAN, CRUSHED, ANGULAR STONE MEETING THE AASHTO M43 DESIGNATION OF #3 OR #4. 	
REQUIREMENTS FOR HANDLING AND INSTALLATION:	9. STONE MUST BE PLACED ON THE TOP CENTER OF THE CHAMBER TO ANCHOR THE CHAMBERS IN PLACE AND PRESERVE ROW SPACING.	
 TO MAINTAIN THE WIDTH OF CHAMBERS DURING SHIPPING AND HANDLING, CHAMBERS SHALL HAVE INTEGRAL, INTERLOCKIN STACKING LUGS. TO ENSURE A SECURE JOINT DURING INSTALLATION AND BACKFILL, THE HEIGHT OF THE CHAMBER JOINT SHALL NOT BE LES 	ENGINEER	
 THAN 3". TO ENSURE THE INTEGRITY OF THE ARCH SHAPE DURING INSTALLATION, a) THE ARCH STIFFNESS CONSTANT AS DEFINED IN SECTION 6.2.8 OF ASTM F2418 SHALL BE GREATER THAN OR EQUAL TO 500 LBS/IN/IN. AND b) TO RESIST CHAMBER DEFORMAT 	 ADS RECOMMENDS THE USE OF "FLEXSTORM CATCH IT" INSERTS DURING CONSTRUCTION FOR ALL INLETS TO PROTECT THE SUBSURFACE STORMWATER MANAGEMENT SYSTEM FROM CONSTRUCTION SITE RUNOFF. 	
DURING INSTALLATION AT ELEVATED TEMPERATURES (ABOVE 73° F / 23° C), CHAMBERS SHALL BE PRODUCED FROM REFLECTIVE GOLD OR YELLOW COLORS.	NOTES FOR CONSTRUCTION EQUIPMENT	
ONLY CHAMBERS THAT ARE APPROVED BY THE SITE DESIGN ENGINEER WILL BE ALLOWED. UPON REQUEST BY THE SITE DESIGN	1. STORMTECH MC-3500 CHAMBERS SHALL BE INSTALLED IN ACCORDANCE WITH THE "STORMTECH MC-3500/MC-4500 CONSTRUCTION GUIDE".	
ENGINEER OR OWNER, THE CHAMBER MANUFACTURER SHALL SUBMIT A STRUCTURAL EVALUATION FOR APPROVAL BEFORE DELIVERING CHAMBERS TO THE PROJECT SITE AS FOLLOWS: THE STRUCTURAL EVALUATION SHALL BE SEALED BY A REGISTERED PROFESSIONAL ENGINEER. THE STRUCTURAL EVALUATION SHALL DEMONSTRATE THAT THE SAFETY FACTORS ARE GREATER THAN OR EQUAL TO 1.95 F DEAD LOAD AND 1.75 FOR LIVE LOAD, THE MINIMUM REQUIRED BY ASTM F2/87 AND BY SECTIONS 3 AND 12.12 OF THE AASHTU LIRFD BRIDGE DESIGN SPECIFICATIONS FOR THERMOPLEASTIC PIPE.	 WEIGHT LIMITS FOR CONSTRUCTION EQUIPMENT CAN BE FOUND IN THE "STORMTECH MC-3500/MC-4500 CONSTRUCTION GUIDE". 	
THE TEST DERIVED CREEP MODULUS AS SPECIFIED IN ASTM F2419 SHALL BE USED FOR PERMANENT DEAD LOAD DESIGN EXCEPT THAT IT SHALL BE THE 75-YEAR MODULUS USED FOR DESIGN.	3. FULL 36" (900 mm) OF STABILIZED COVER MATERIALS OVER THE CHAMBERS IS REQUIRED FOR DUMP TRUCK TRAVEL OR DUMPING.	
CHAMBERS AND END CAPS SHALL BE PRODUCED AT AN ISO 9001 CERTIFIED MANUFACTURING FACILITY.	USE OF A DOZER TO PUSH EMBEDMENT STONE BETWEEN THE ROWS OF CHAMBERS MAY CAUSE DAMAGE TO CHAMBERS AND IS NOT AN ACCEPTABLE BACKFILL METHOD. ANY CHAMBERS DAMAGED BY USING THE "DUMP AND PUSH" METHOD ARE NOT COVERED UNDER THE STORMTECH STANDARD WARRANTY.	
	CONTACT STORMTECH AT 1-888-892-2694 WITH ANY QUESTIONS ON INSTALLATION REQUIREMENTS OR WEIGHT LIMITS FOR CONSTRUCTION EQUIPMENT.	
		(SEE I
		BED L











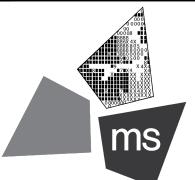
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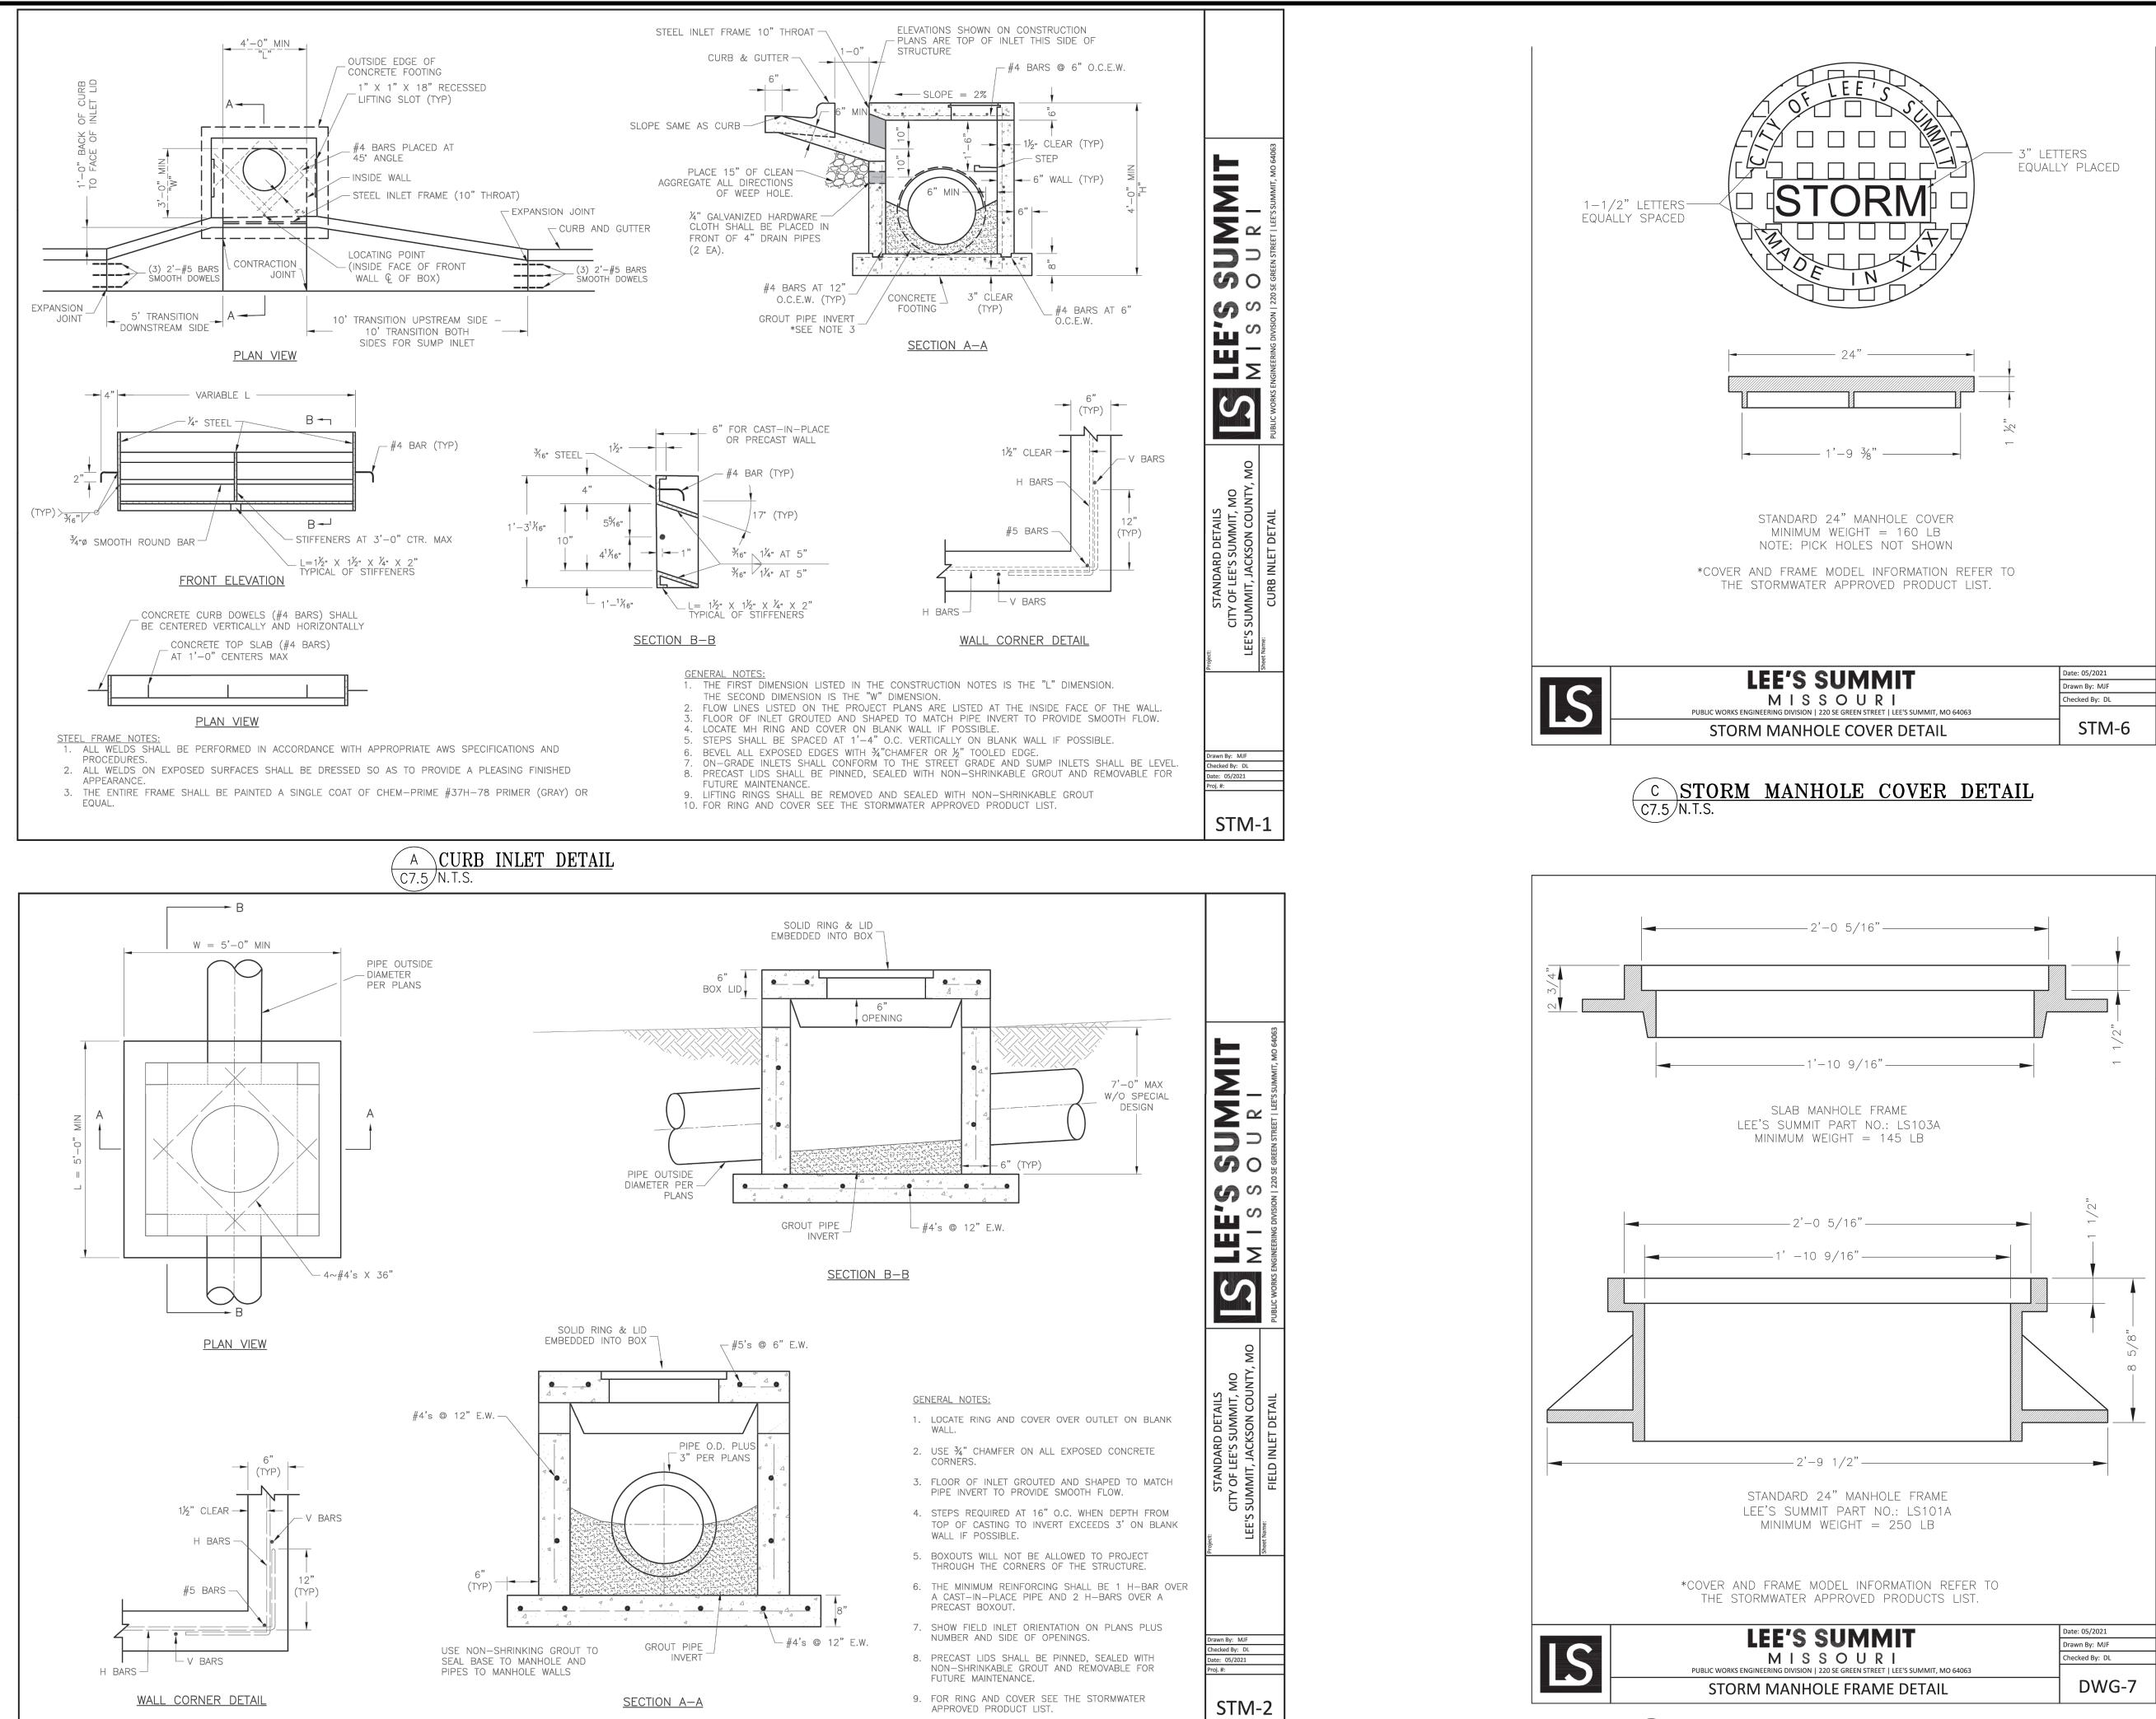
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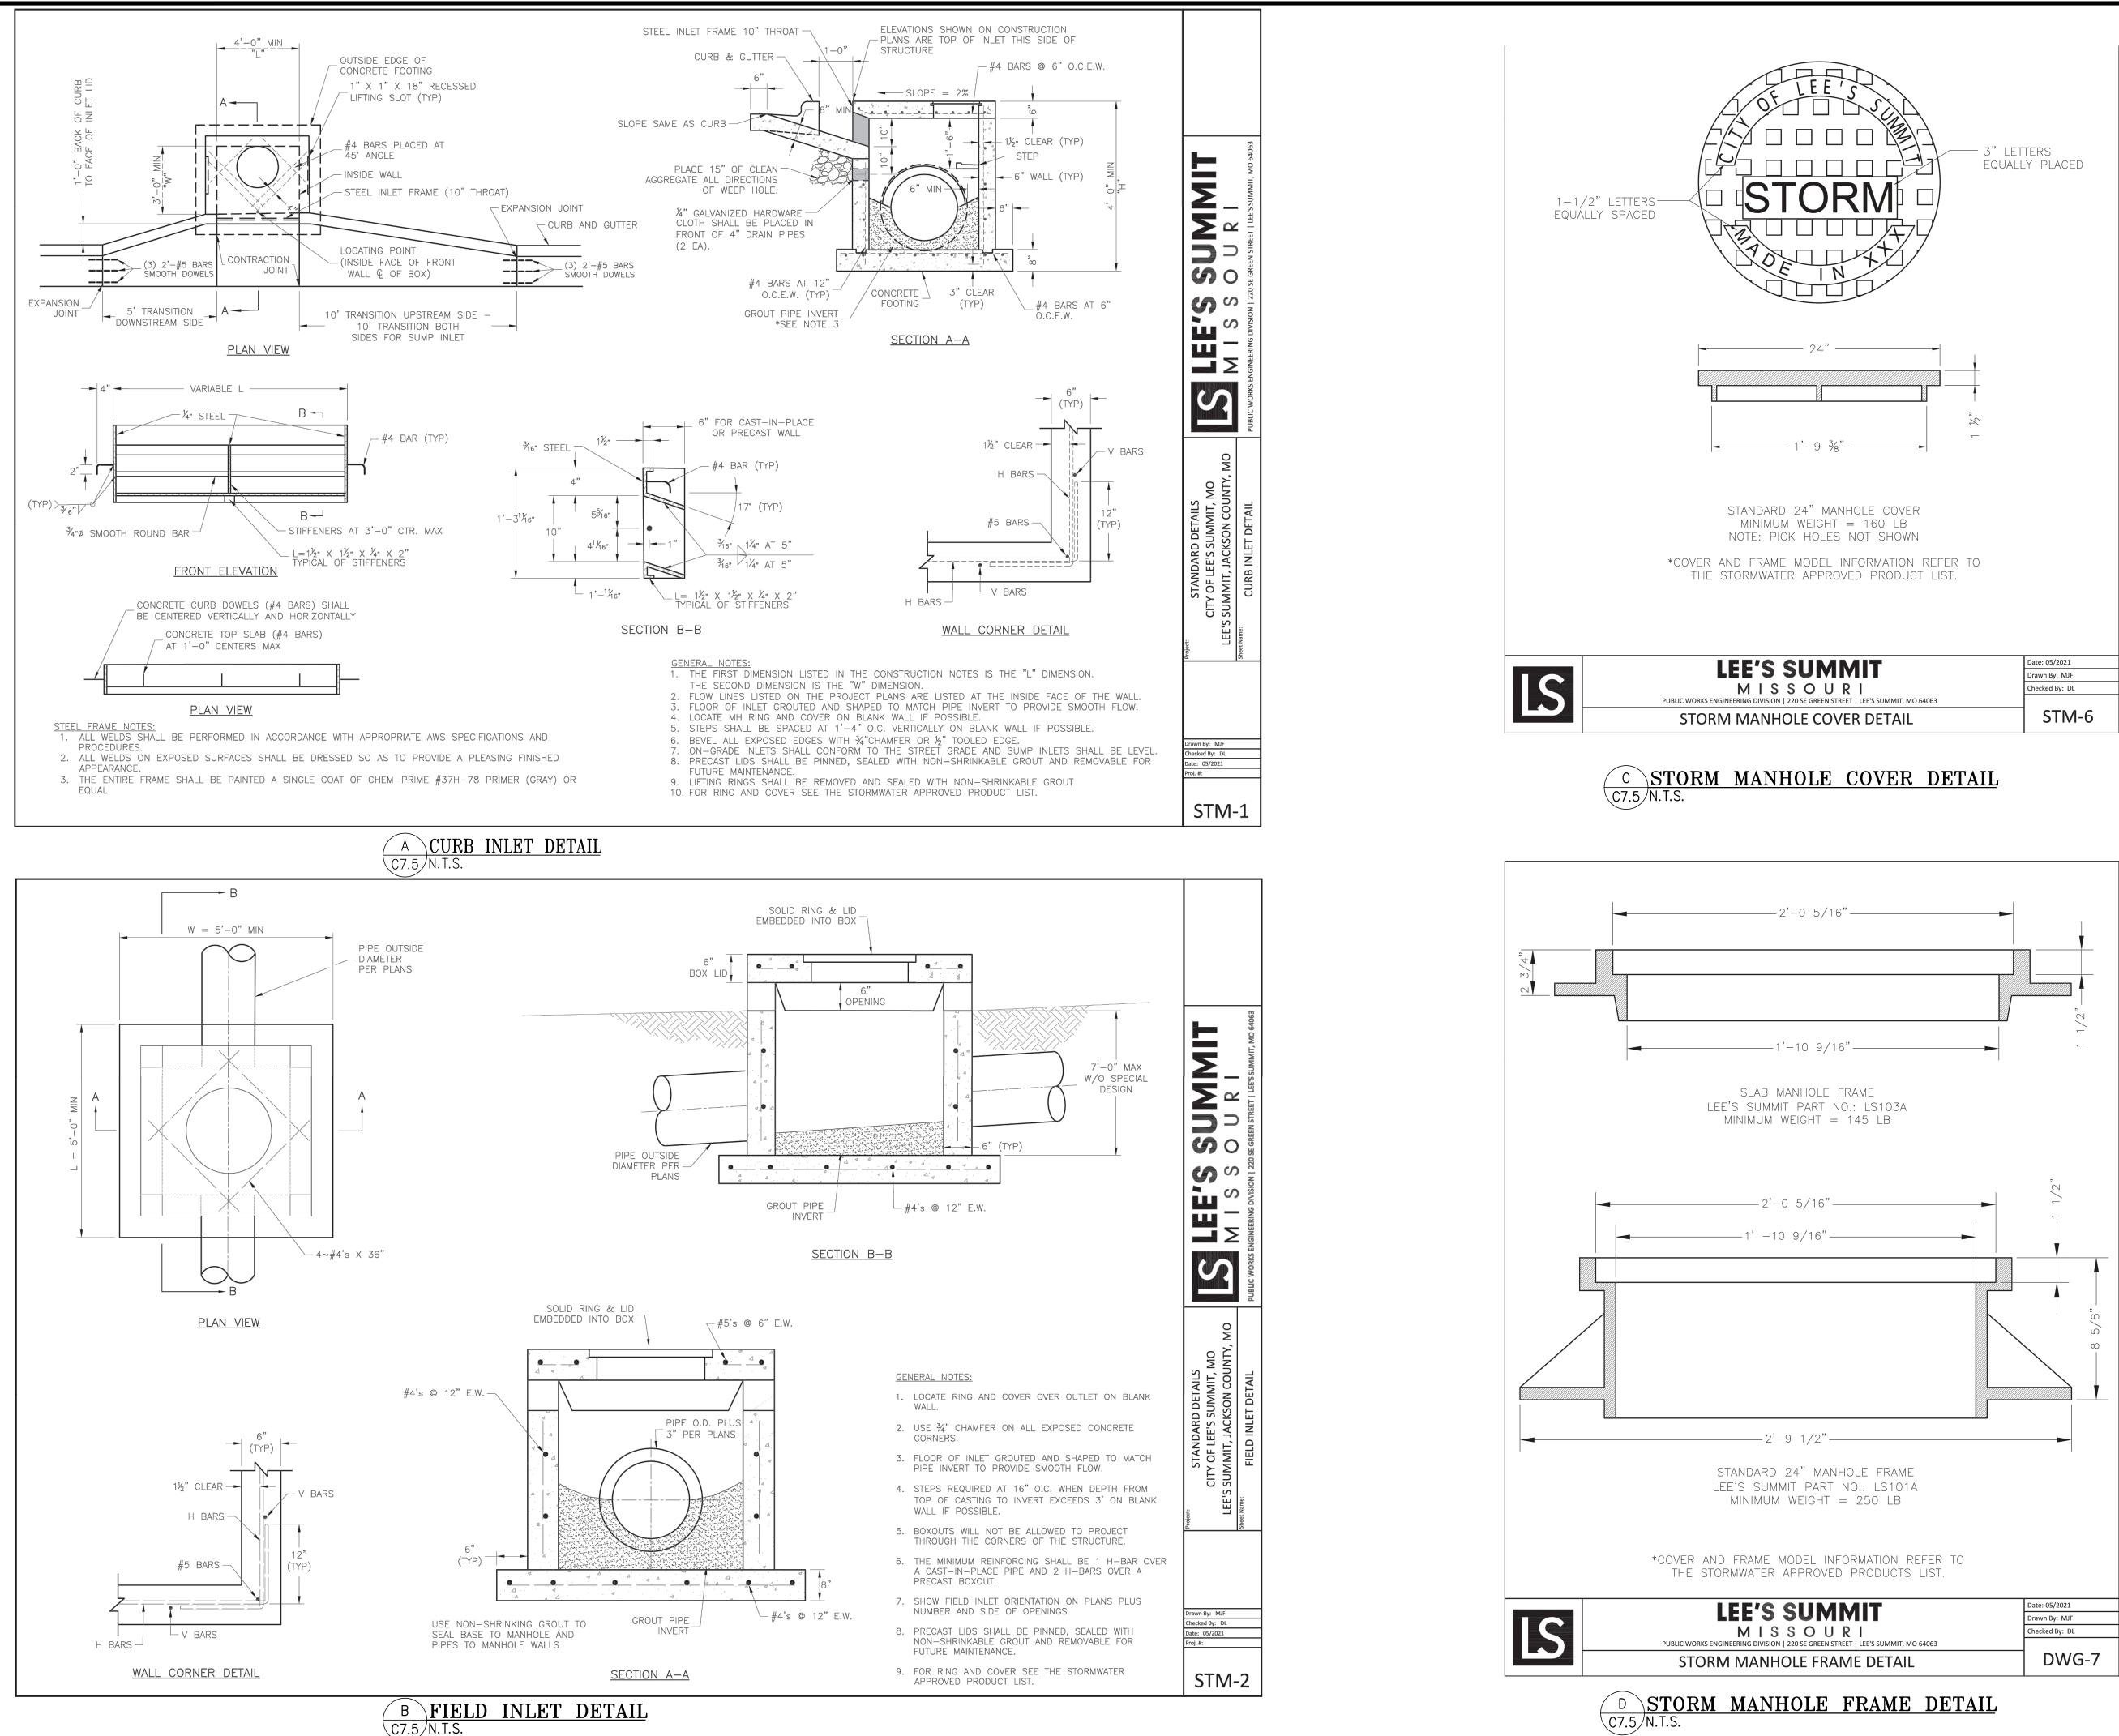
SHEET TITLE

SITE DETAILS

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CHECKED BY:	PJK
PROJECT NO:	40497-21

C-7.4



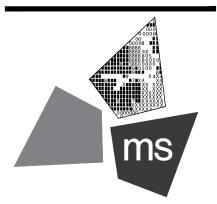




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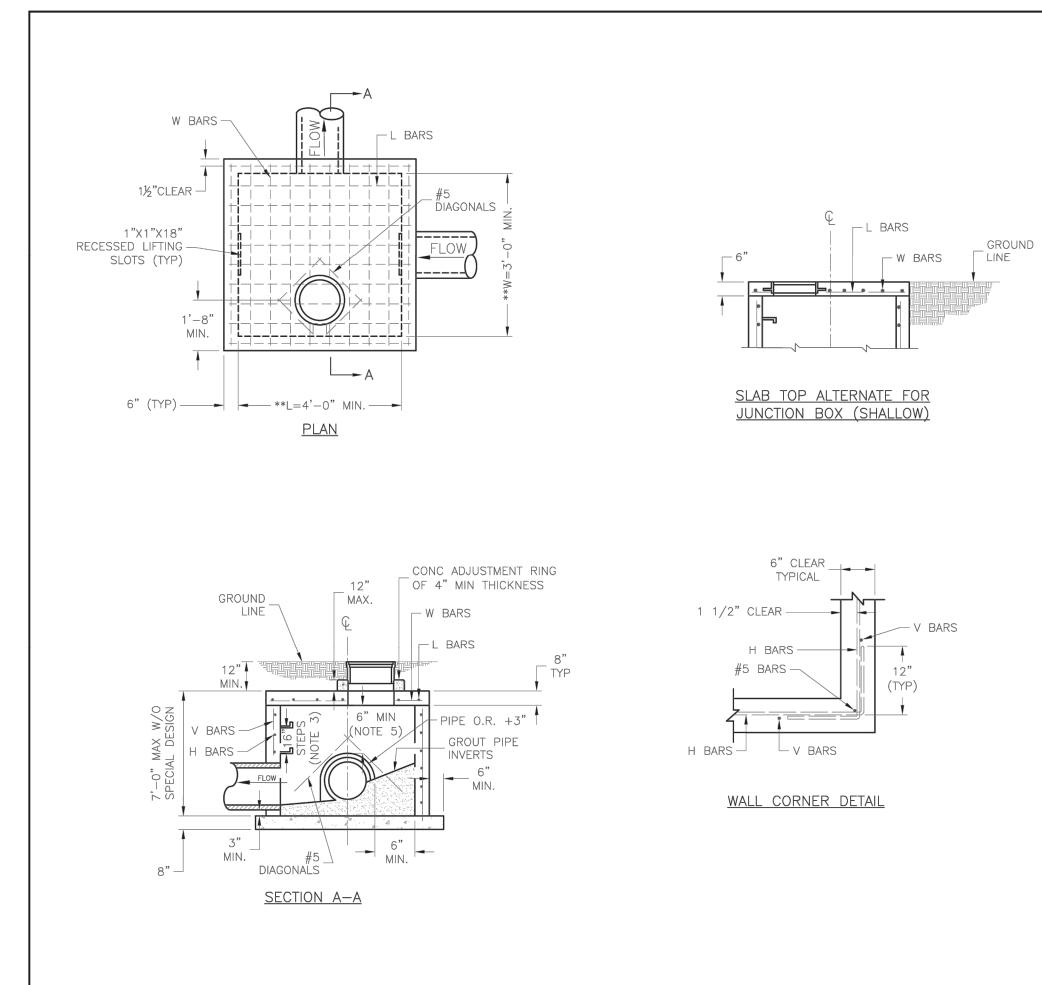
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PROJECT NO:	40497-21

C-7.5



A JUNCTION BOX DETAIL C7.6 N.T.S.

	NON-SHRINKABLE GROUT AND REMOVABLE FOR FUTURE MAINTENANCE.
9.	REINFORCING OF COVERS IN STREETS REQUIRE SPECIAL DESIGN.
10.	FOR RING AND COVER SEE THE STORMWATER APPROVED PRODUCT LIST.

- 8. PRECAST LIDS SHALL BE PINNED, SEALED WITH
- THE MINIMUM REINFORCING SHALL BE 1 H-BAR OVER A CAST-IN-PLACE PIPE AND 2 H-BARS OVER A PRECAST BOXOUT.
- 4. BOXOUTS WILL NOT BE ALLOWED TO PROJECT THROUGH THE CORNERS OF THE STRUCTURE AND THE MINIMUM DISTANCE BETWEEN BOXOUTS IS 6".
- STEPS REQUIRED AT 16" O.C. WHEN DEPTH FROM TOP OF CASTING TO INVERT EXCEEDS 4' ON BLANK WALL IF POSSIBLE.
- 2. USE ¾" CHAMFER STRIP OR ½" R EDGER TOOL ON ALL EXPOSED CONCRETE CORNERS.
- <u>GENERAL NOTES:</u> 1. LOCATE RING AND COVER ON BLANK WALL.

W	5	6	

REINFORCING				
BARS	BAR SIZE	SPACING (IN.)		
Н	4	12		
V	4	12		
L	5	6		
W	5	6		

** INCREASE IN MULTIPLES OF 6" (7'-0") MAX WITHOUT SPECIAL DESIGN. (SEE PROJECT PLANS FOR DETAILS)

		M I S S O U R I	PUBLIC WORKS ENGINEERING DIVISION 220 SE GREEN STREET LEE'S SUMMIT, MO 64063	
Project: STANDARD DETAILS	CITY OF LEE'S SUMMIT, MO	LEE'S SUMMIT, JACKSON COUNTY, MO	Sheet Name: JUNCTION BOX DETAIL	
Drawn Checke Date: 0 Proj. #:	d By: 05/20		.3	

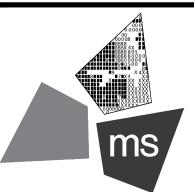
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PROJECT

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NEQ HWY 150 & SW HOLLYWOOD DR. LEE'S SUMMIT, MO 64082

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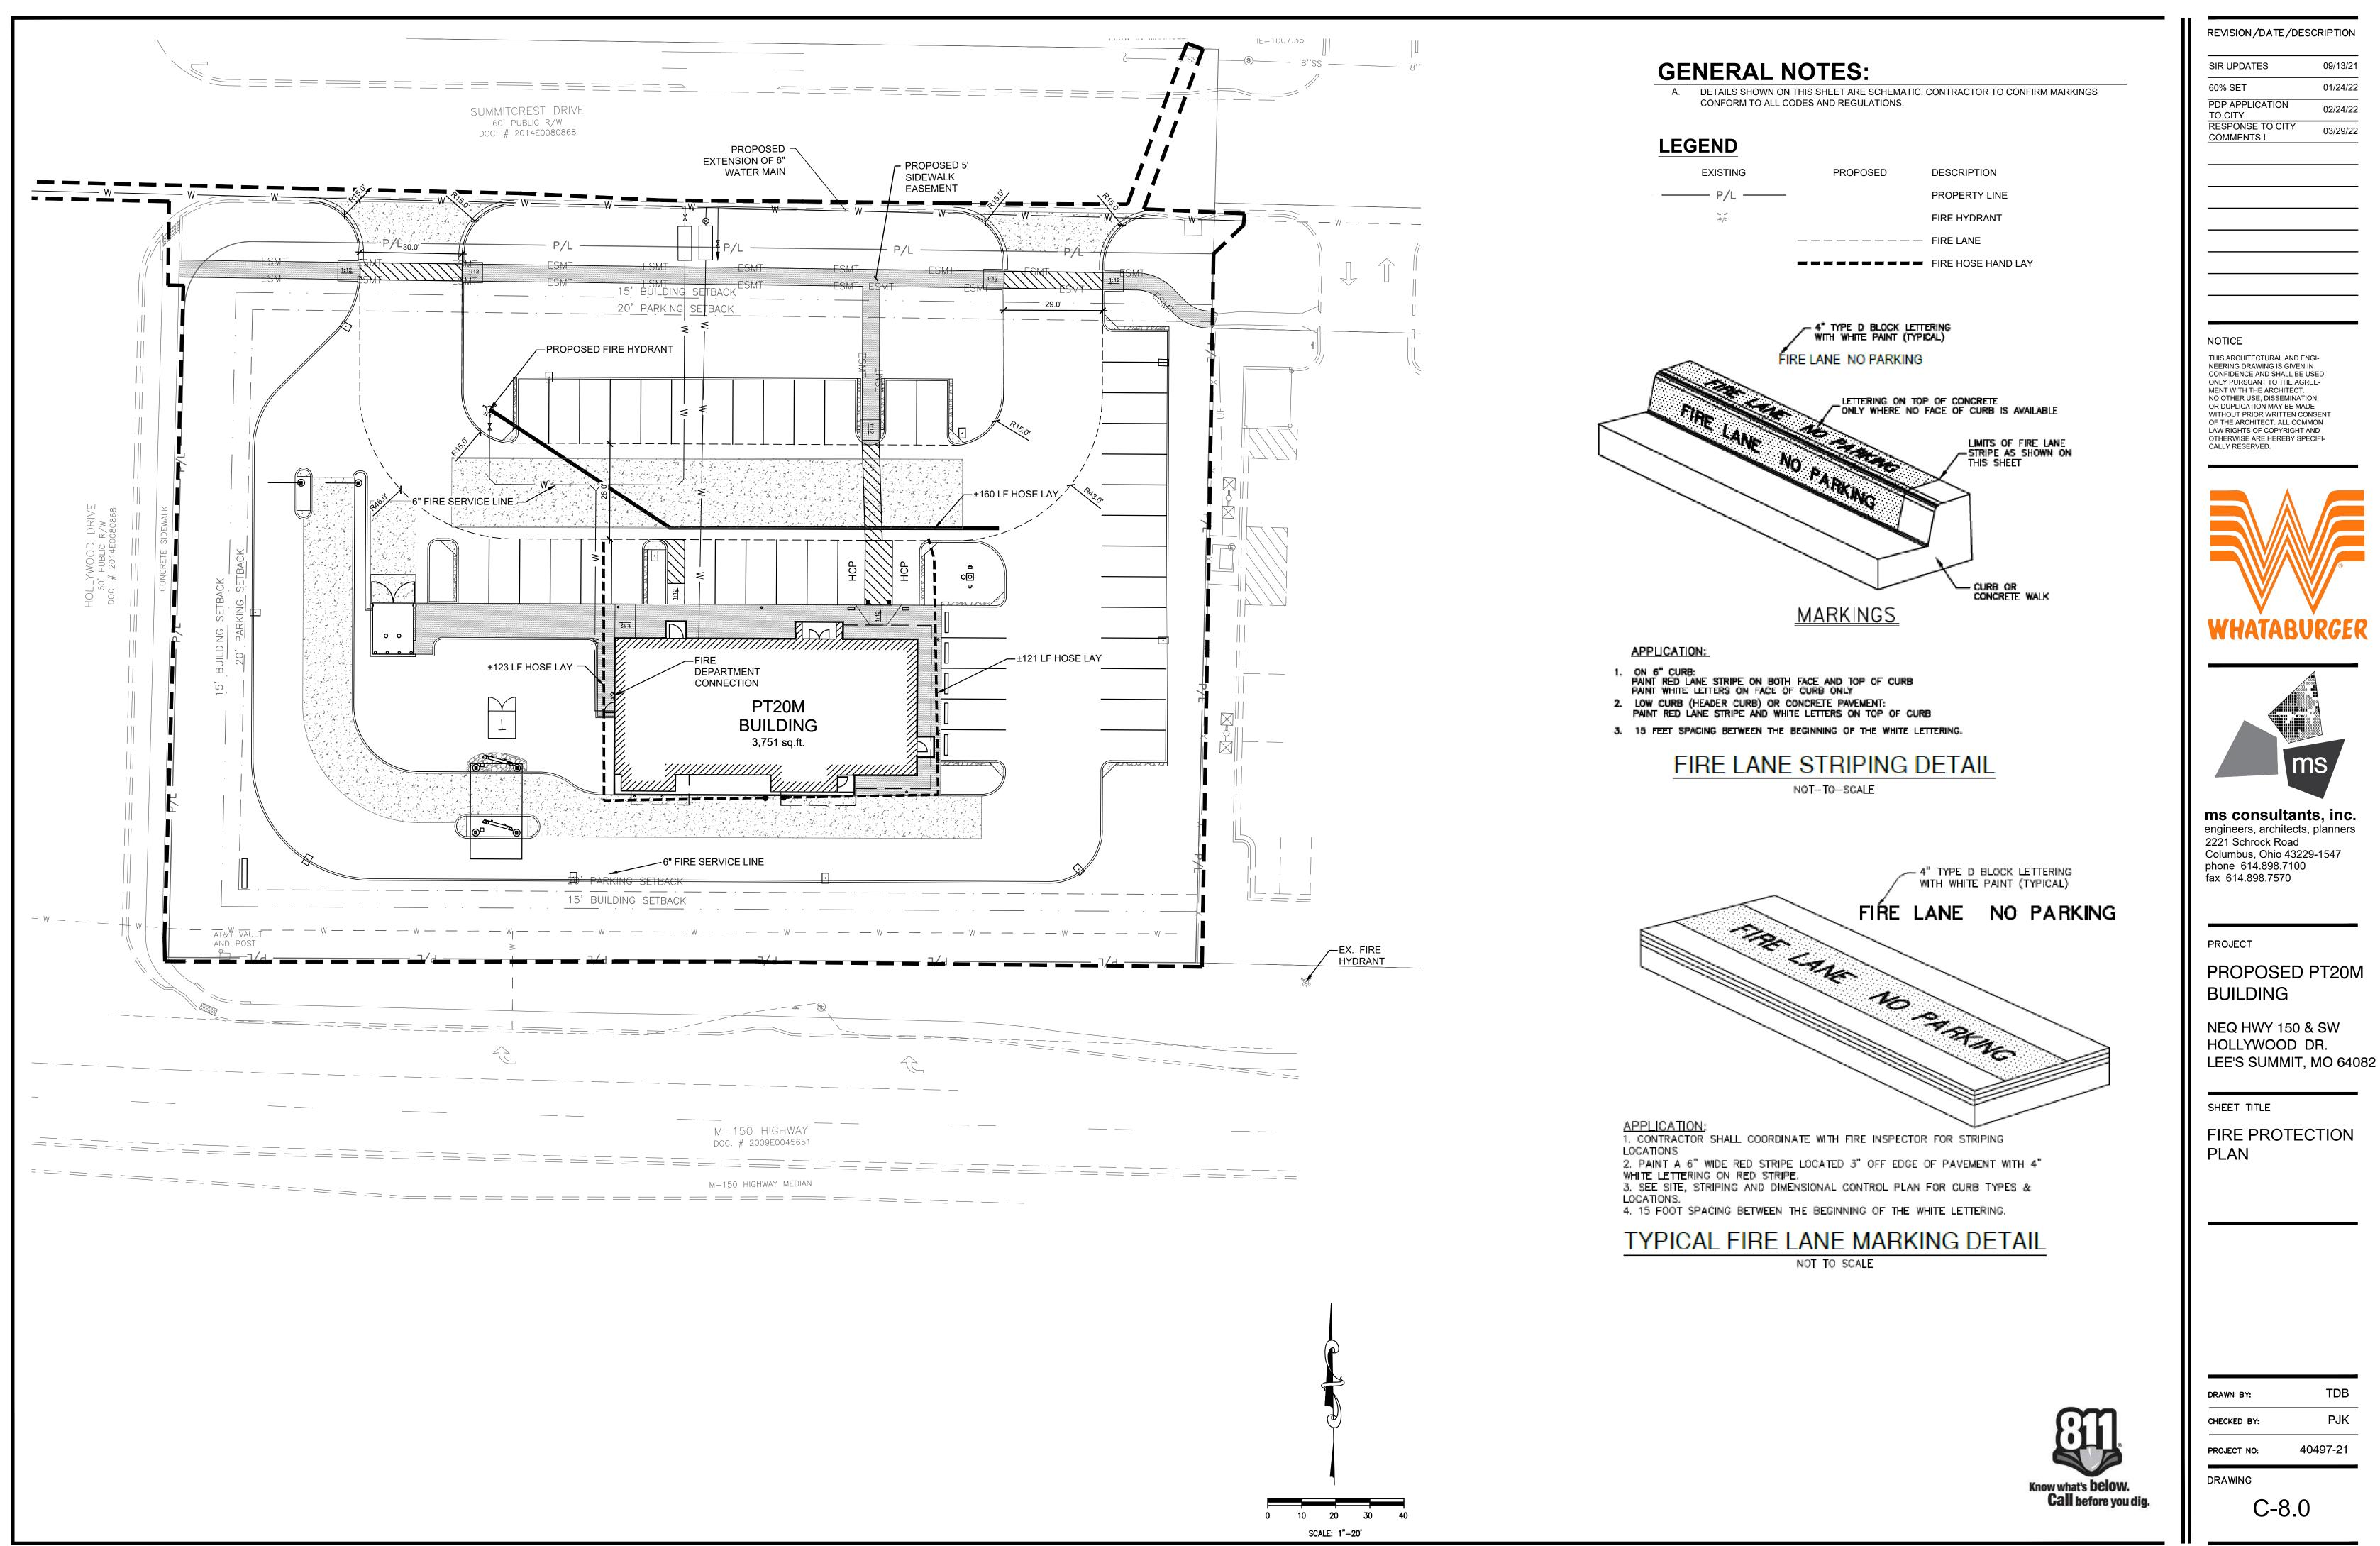
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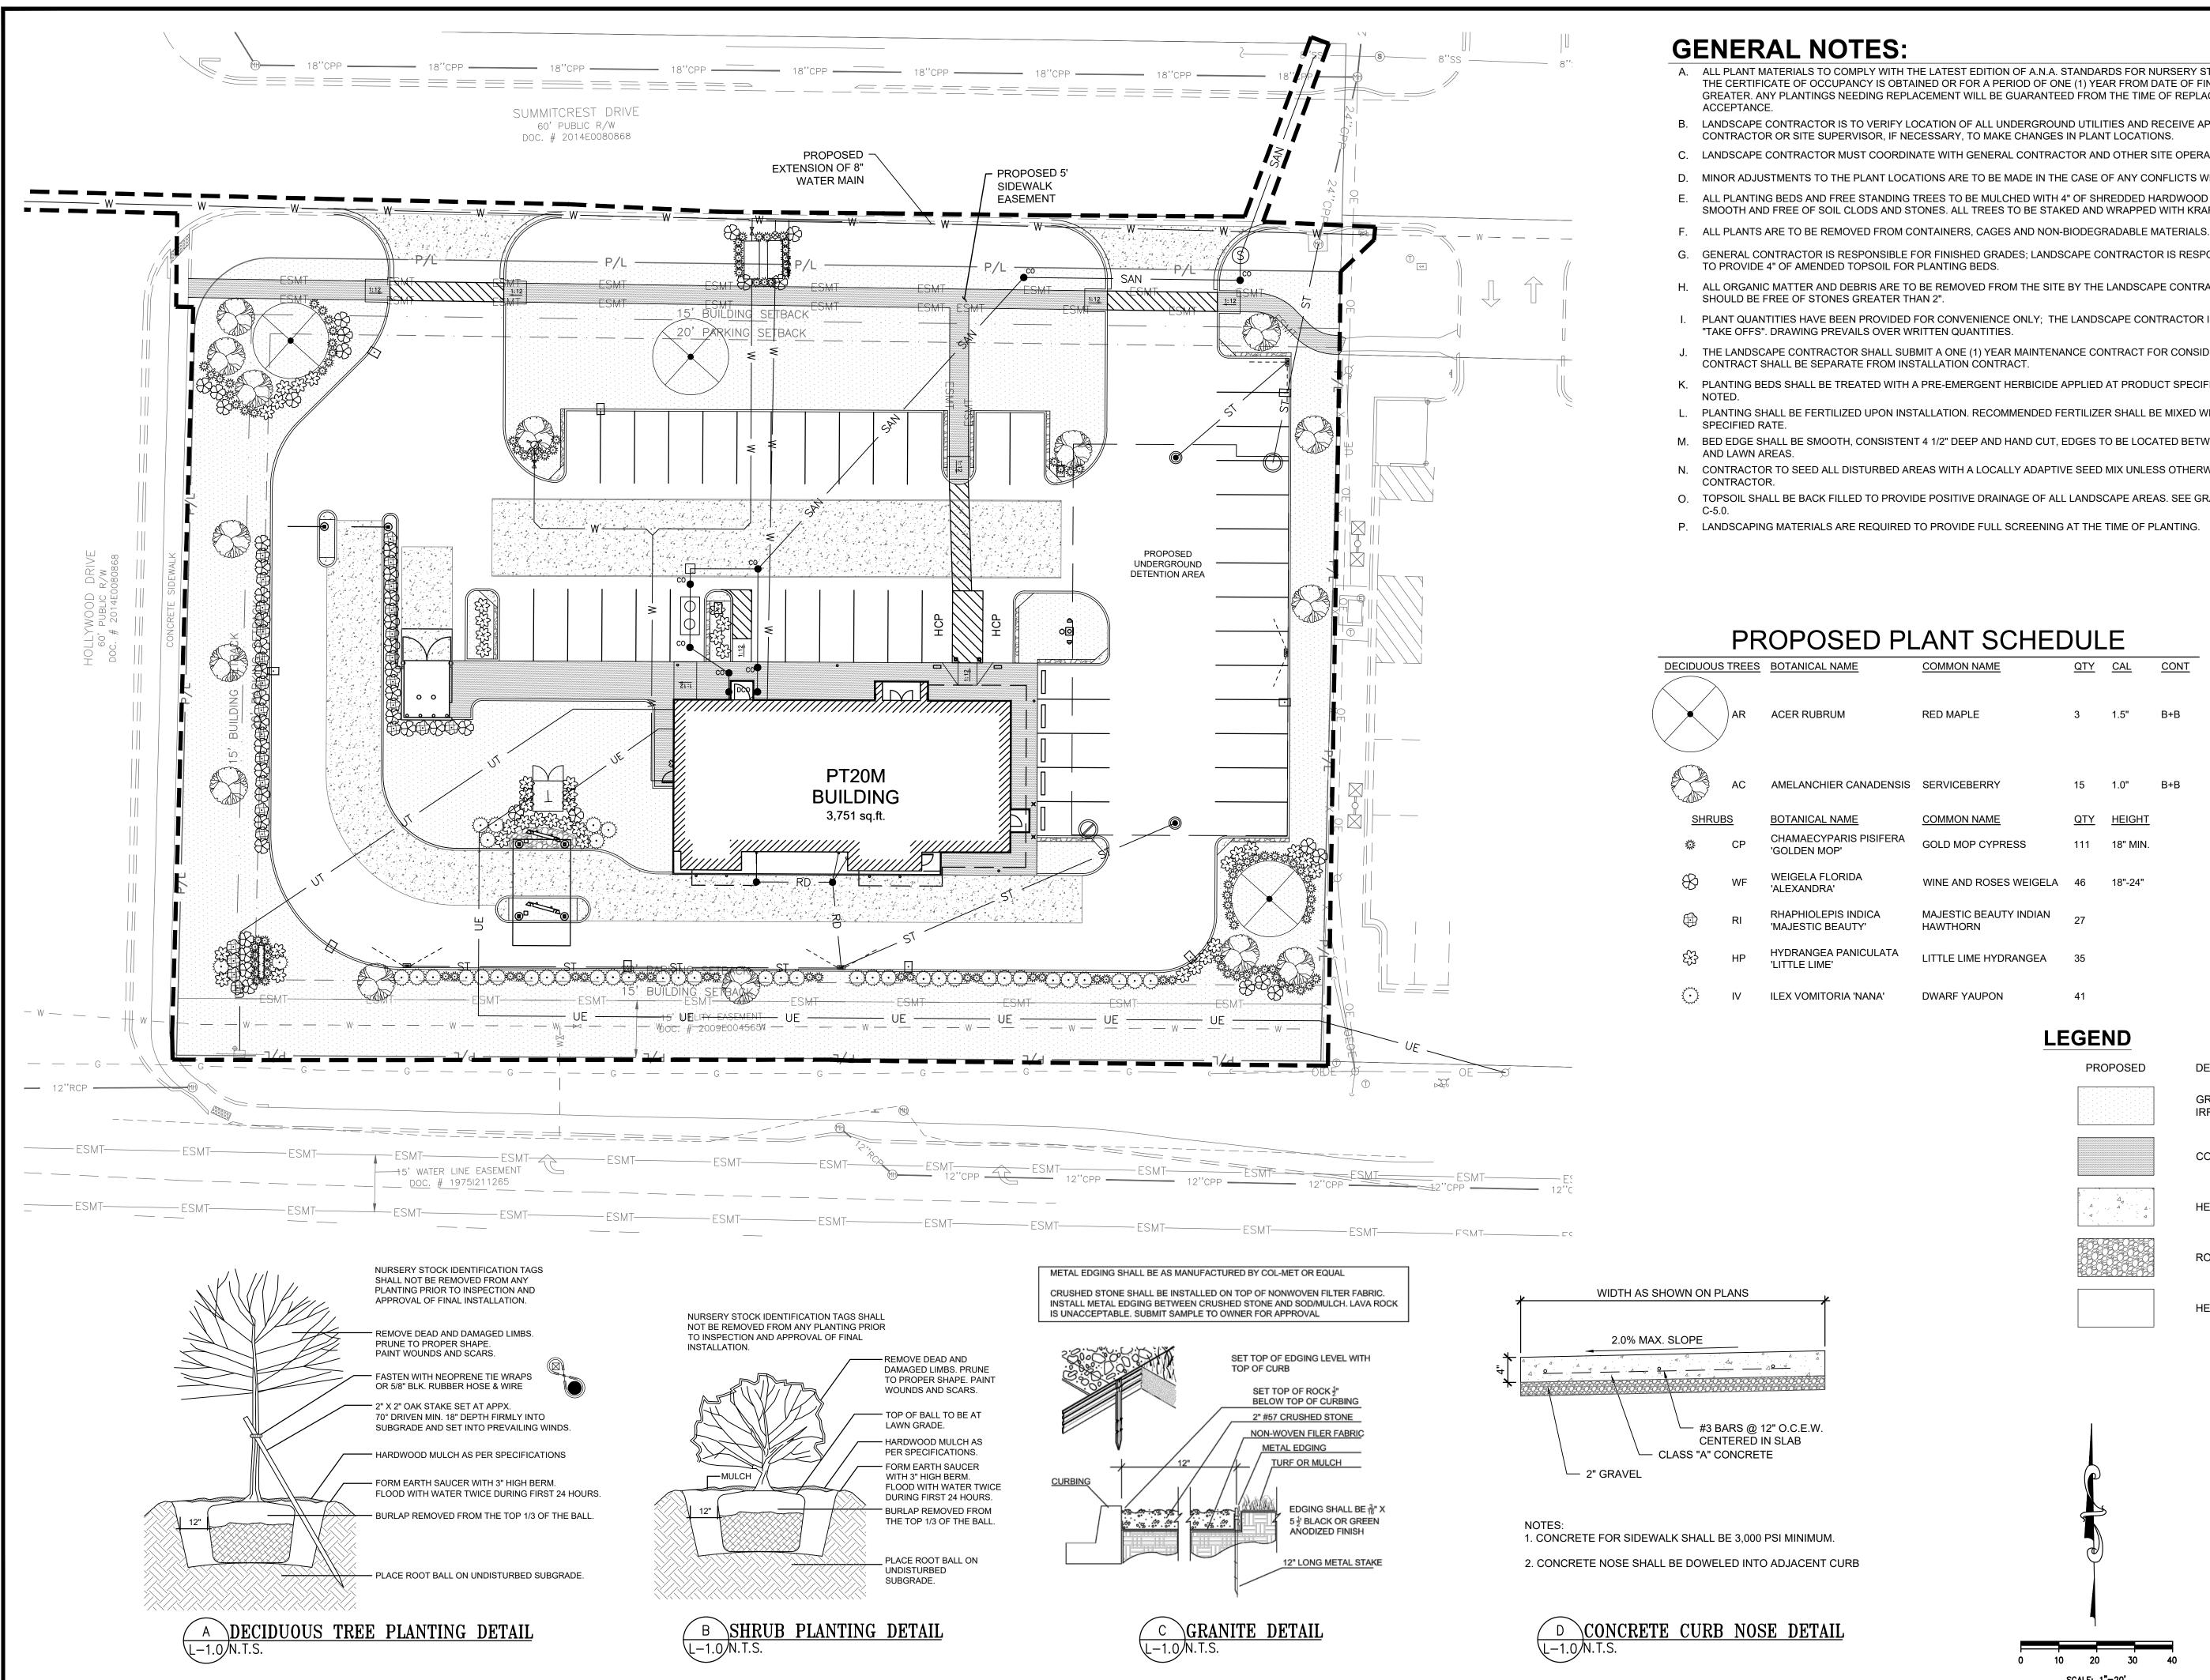
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DRAWING



C-7.6





2. CONCRETE NOSE SHALL BE DOWELED INTO ADJACENT CURB

A. ALL PLANT MATERIALS TO COMPLY WITH THE LATEST EDITION OF A.N.A. STANDARDS FOR NURSERY STOCK AND BE GUARANTEED UNTIL THE CERTIFICATE OF OCCUPANCY IS OBTAINED OR FOR A PERIOD OF ONE (1) YEAR FROM DATE OF FINAL ACCEPTANCE, WHICHEVER IS GREATER. ANY PLANTINGS NEEDING REPLACEMENT WILL BE GUARANTEED FROM THE TIME OF REPLACEMENT IF AFTER FINAL

LANDSCAPE CONTRACTOR IS TO VERIFY LOCATION OF ALL UNDERGROUND UTILITIES AND RECEIVE APPROVAL FROM GENERAL CONTRACTOR OR SITE SUPERVISOR, IF NECESSARY, TO MAKE CHANGES IN PLANT LOCATIONS. C. LANDSCAPE CONTRACTOR MUST COORDINATE WITH GENERAL CONTRACTOR AND OTHER SITE OPERATIONS.

D. MINOR ADJUSTMENTS TO THE PLANT LOCATIONS ARE TO BE MADE IN THE CASE OF ANY CONFLICTS WITH PROPOSED UTILITIES. E. ALL PLANTING BEDS AND FREE STANDING TREES TO BE MULCHED WITH 4" OF SHREDDED HARDWOOD MULCH. BEDS ARE TO BE GRADED SMOOTH AND FREE OF SOIL CLODS AND STONES. ALL TREES TO BE STAKED AND WRAPPED WITH KRAFT TREE WRAP.

G. GENERAL CONTRACTOR IS RESPONSIBLE FOR FINISHED GRADES; LANDSCAPE CONTRACTOR IS RESPONSIBLE FOR FINE GRADING AND TO PROVIDE 4" OF AMENDED TOPSOIL FOR PLANTING BEDS.

H. ALL ORGANIC MATTER AND DEBRIS ARE TO BE REMOVED FROM THE SITE BY THE LANDSCAPE CONTRACTOR. LAWN AREAS AND BEDS I. PLANT QUANTITIES HAVE BEEN PROVIDED FOR CONVENIENCE ONLY; THE LANDSCAPE CONTRACTOR IS RESPONSIBLE FOR HIS OWN

THE LANDSCAPE CONTRACTOR SHALL SUBMIT A ONE (1) YEAR MAINTENANCE CONTRACT FOR CONSIDERATION BY THE OWNER. CONTRACT SHALL BE SEPARATE FROM INSTALLATION CONTRACT.

K. PLANTING BEDS SHALL BE TREATED WITH A PRE-EMERGENT HERBICIDE APPLIED AT PRODUCT SPECIFIED RATE UNLESS OTHERWISE

L. PLANTING SHALL BE FERTILIZED UPON INSTALLATION. RECOMMENDED FERTILIZER SHALL BE MIXED WITH BACKFILL AT PRODUCT

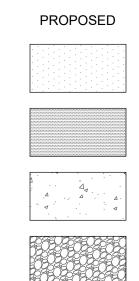
M. BED EDGE SHALL BE SMOOTH, CONSISTENT 4 1/2" DEEP AND HAND CUT, EDGES TO BE LOCATED BETWEEN ALL BEDS (INCLUDING TREES) N. CONTRACTOR TO SEED ALL DISTURBED AREAS WITH A LOCALLY ADAPTIVE SEED MIX UNLESS OTHERWISE DIRECTED BY THE GENERAL

O. TOPSOIL SHALL BE BACK FILLED TO PROVIDE POSITIVE DRAINAGE OF ALL LANDSCAPE AREAS. SEE GRADING AND DRAINAGE PLAN SHEET P. LANDSCAPING MATERIALS ARE REQUIRED TO PROVIDE FULL SCREENING AT THE TIME OF PLANTING.

|--|

JAME	COMMON NAME	<u>QTY</u>	CAL	<u>CONT</u>
JM	RED MAPLE	3	1.5"	B+B
R CANADENSIS	SERVICEBERRY	15	1.0"	B+B
NAME	COMMON NAME	<u>QTY</u>	<u>HEIGHT</u>	
ARIS PISIFERA P'	GOLD MOP CYPRESS	111	18" MIN.	
ORIDA	WINE AND ROSES WEIGELA	46	18"-24"	
'IS INDICA EAUTY'	MAJESTIC BEAUTY INDIAN HAWTHORN	27		
PANICULATA	LITTLE LIME HYDRANGEA	35		
RIA 'NANA'	DWARF YAUPON	41		

LEGEND



DESCRIPTION

GRASS/LANDSCAPED AREA TO BE IRRIGATED

CONCRETE SIDEWALK

HEAVY DUTY CONCRETE PAVEMEN

ROCK AREA

HEAVY DUTY ASPHALT PAVEMENT



20 30 SCALE: 1"=20'



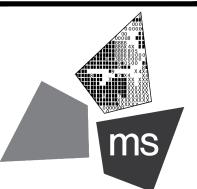
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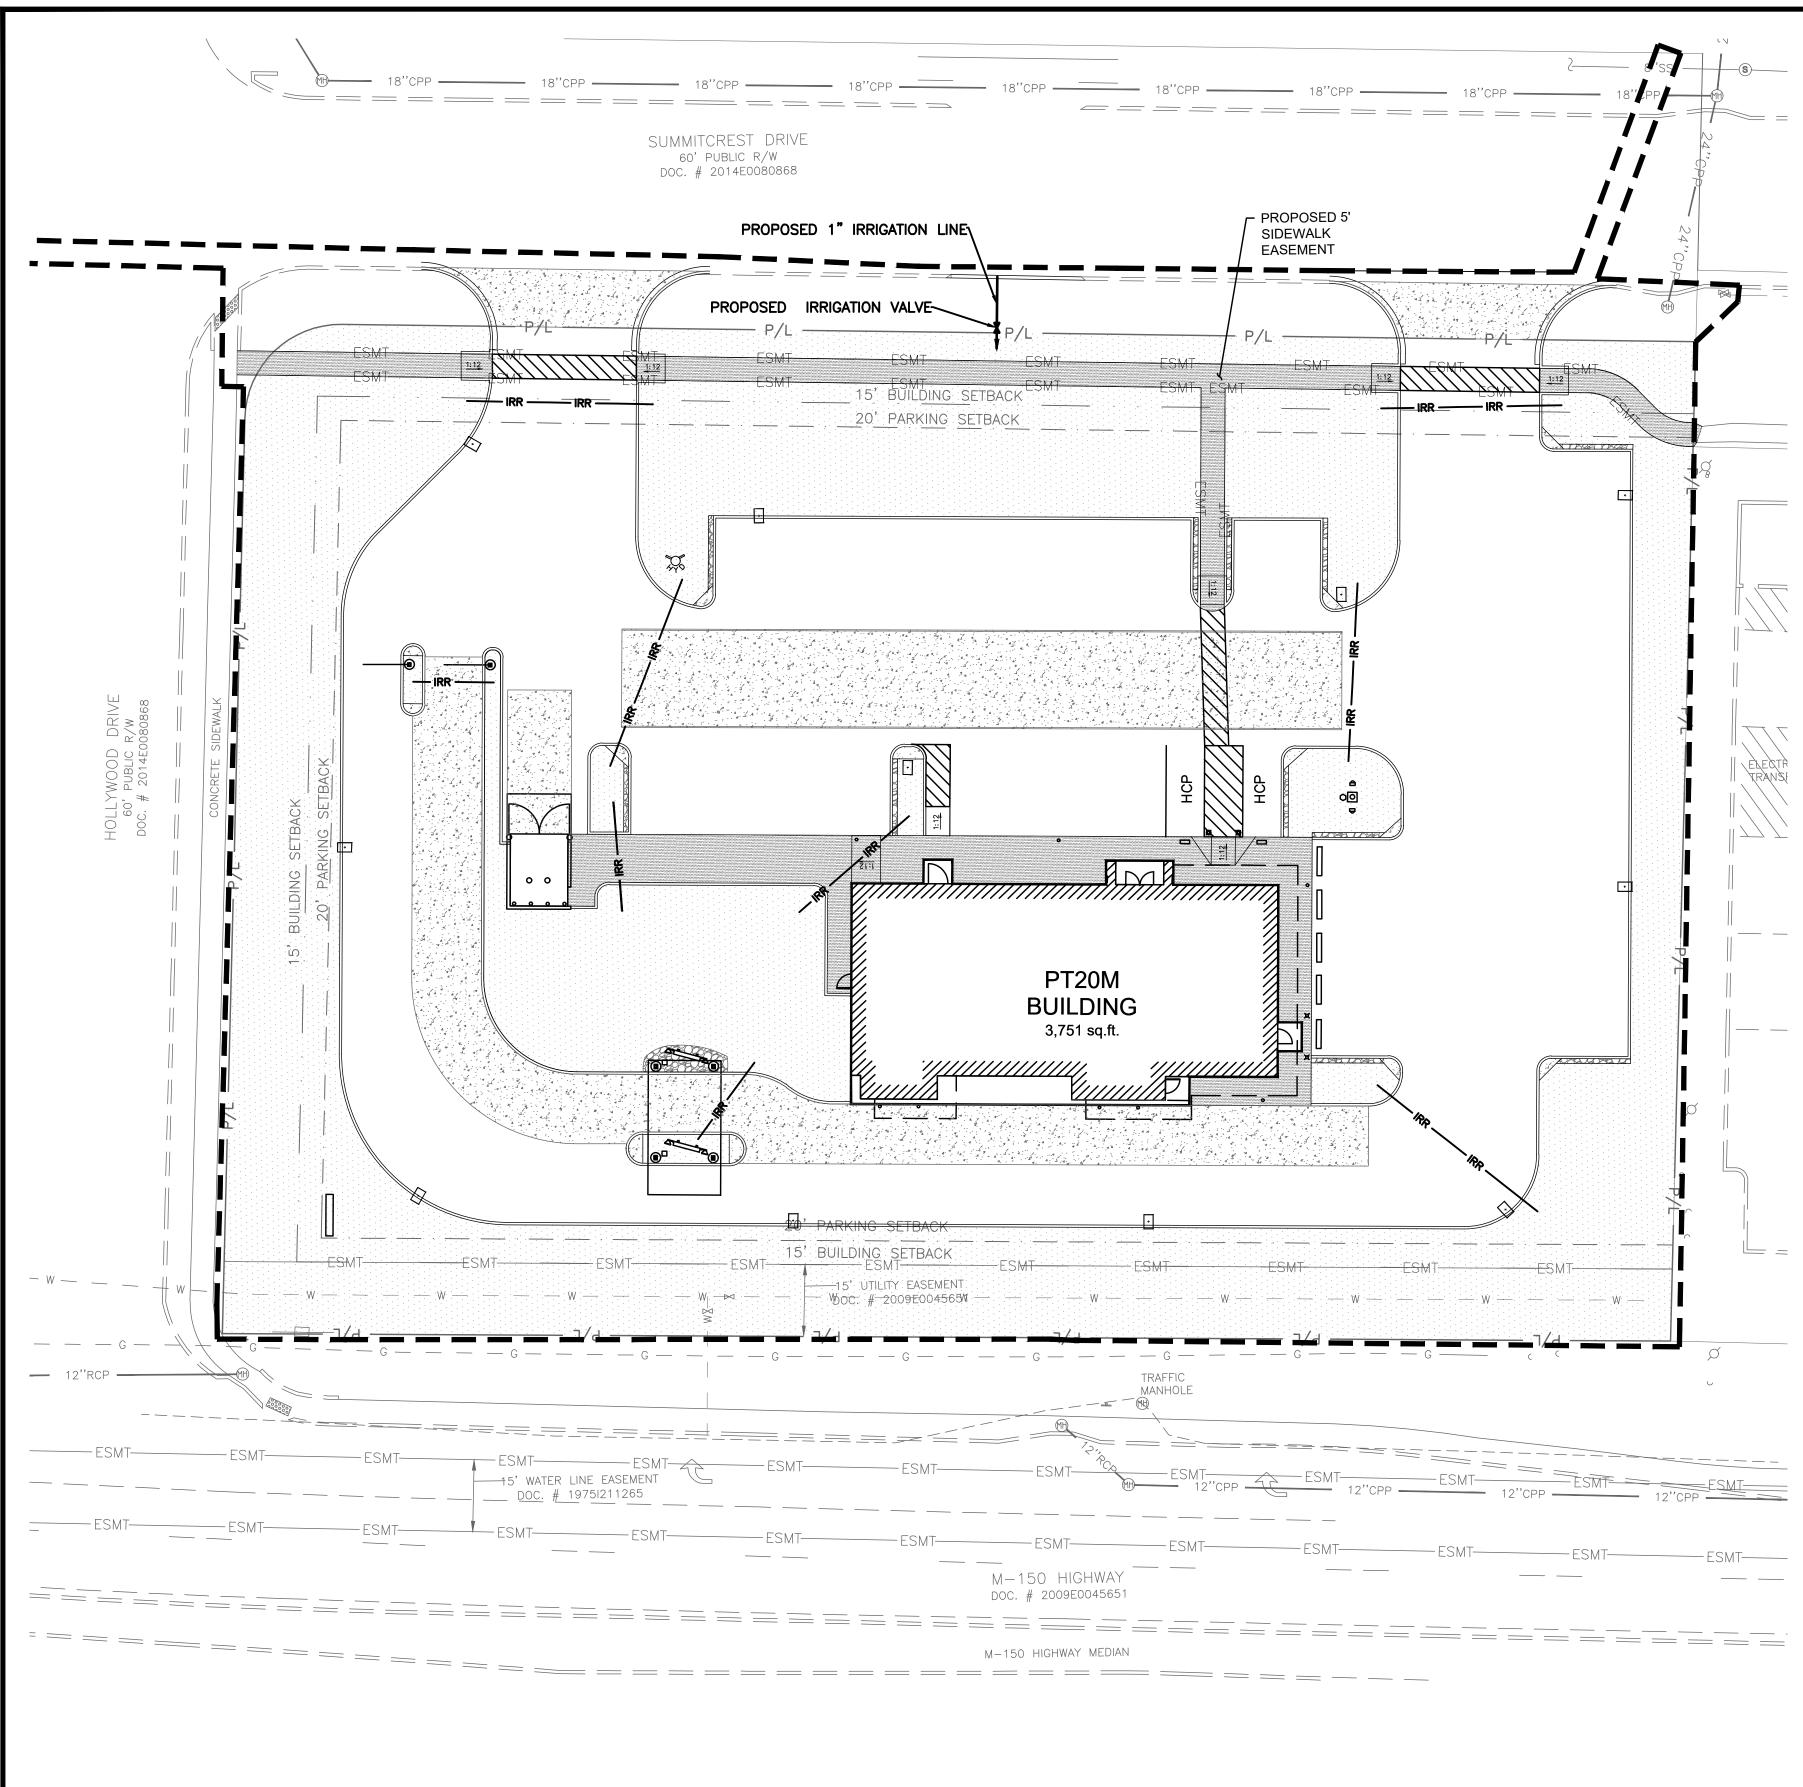
SHEET TITLE

LANDSCAPE PLAN

DRAWN BY:	TDB
CHECKED BY:	PJK
PROJECT NO:	40497-21

DRAWING

L-1.0



LEGEND

PROPOSED

DESCRIPTION GRASS/LANDSCAPED

AREA TO BE IRRIGATED

CONCRETE SIDEWALK

HEAVY DUTY CONCRETE PAVEMENT

PROPOSED

DESCRIPTION

ROCK AREA

HEAVY DUTY ASPHALT PAVEMENT

4" SCHEDULE 40 PVC SLEEVE FOR FUTURE IRRIGATION LINES. CONTRACTOR TO MARK END OF SLEEVES.

- SYSTEM SHALL BE THE RESPONSIBILITY OF THE LANDSCAPE/IRRIGATION CONTRACTOR (CONTRACTOR).
- HEADS, VALVES, CONTROLLER, PIPING AND ACCESSORIES. IRRIGATION HEADS, VALVES AND CONTROLLER ARE TO BE FROM A SINGLE MANUFACTURER. ALL EQUIPMENT MUST
- D. THE CONTRACTOR IS RESPONSIBLE FOR COORDINATING WITH THE OWNER THE FINAL LOCATION OF THE CONTROL PANEL(S). NO ADDITIONAL COSTS SHALL BE ALLOWED FOR ANY ADJUSTMENTS MADE TO THE FINAL LOCATION OF ALL EQUIPMENT.
- AFTER THE ACCEPTANCE OF THE SYSTEM BY THE OWNER.
- CONNECTION WAS NOT AVAILABLE PRIOR TO DESIGN.
- ISOLATION VALVES, AND MANUAL DRAIN VALVES ARE TO BE LOCATED AS NECESSARY TO COMPLETE THE SYSTEM.
- AND SHRUB SPRAY ZONES AND BE CAPABLE OF OPERATING MULTIPLE VALVES PER STATION.
- PLANTING OF FUTURE TREES AND SHRUBS.

PART 1 GENERAL

1.1 REFERENCES

- A. ASTM INTERNATIONAL: 1. ASTM B32 - STANDARD SPECIFICATION FOR SOLDER METAL
- 2. ASTM B42 STANDARD SPECIFICATION FOR SEAMLESS COPPER PIPE, STANDARD SIZES.
- 3. ASTM B88 STANDARD SPECIFICATION FOR SEAMLESS COPPER WATER TUBE. 4. ASTM D2235 - STANDARD SPECIFICATION FOR SOLVENT CEMENT FOR
- ACRYLONITRILE-BUTADIENE-STYRENE (ABS) PLASTIC PIPE AND FITTINGS. 5. ASTM D2241 - STANDARD SPECIFICATION FOR POLYETHYLENE (PE) PLASTIC PIPE
- (SIDR-PR) BASED ON CONTROLLED INSIDE DIAMETER. 6. ASTM D2564 - STANDARD SPECIFICATION FOR SOLVENT CEMENTS FOR POLY (VINYL CHLORIDE) (PVC) PLASTIC PIPING SYSTEMS.
- B. NATIONAL ELECTRICAL MANUFACTURERS ASSOCIATION: 1. NEMA 250 - ENCLOSURES FOR ELECTRICAL EQUIPMENT (1000 VOLTS MAXIMUM).
- 1.2 SYSTEM DESCRIPTION
- C. HYBRID SOLID STATE CONTROLLED UNDERGROUND IRRIGATION SYSTEM, WITH PRESSURE BLOW-OUT DRAIN.
- D. SOURCE POWER: 120 VOLT.
- 1.3 SUBMITTALS
- A. SHOP DRAWINGS: INDICATE PIPING LAYOUT TO WATER SOURCE, LOCATION OF SLEEVES UNDER PAVEMENT, LOCATION AND COVERAGE OF SPRINKLER HEADS, COMPONENTS, PLANT AND LANDSCAPING FEATURES, SITE STRUCTURES, SCHEDULE OF OUTLETS AND FITTINGS TO BE USED.
- B. PRODUCT DATA: SUBMIT COMPONENT AND CONTROL SYSTEM AND WIRING DIAGRAMS. 1.4 CLOSEOUT SUBMITTALS
- A. PROJECT RECORD DOCUMENTS: RECORD ACTUAL LOCATIONS OF CONCEALED COMPONENTS BY NORTHING AND EASTING.
- B. OPERATION AND MAINTENANCE DATA TO OWNER:
- 1. SUBMIT INSTRUCTIONS FOR OPERATION AND MAINTENANCE OF SYSTEM AND CONTROLS, SEASONAL ACTIVATION AND SHUTDOWN, AND MANUFACTURER'S PARTS CATALOG.
- 2. SUBMIT SCHEDULE INDICATING LENGTH OF TIME EACH VALVE IS REQUIRED TO BE OPEN TO DELIVER DETERMINED AMOUNT OF WATER. 1.5 QUALITY ASSURANCE
- A. PERFORM WORK IN ACCORDANCE WITH MANUFACTURER'S STANDARDS. 1.6 COORDINATION
- A. COORDINATE THE WORK WITH SITE BACKFILLING, PAVING, LANDSCAPE GRADING AND DELIVERY OF PLANT LIFE.

PART 2 PRODUCTS

2.1 PIPE MATERIALS

- A. PVC PIPE: ASTM D2241, SDR 26; 160 PSI SOLVENT WELDED SOCKETS.
- B. HDPE PIPE: ASTM D-2239, SDR-15, 100 PSI.
- C. COPPER TUBING: ASTM B88 TYPE K.
- D. FITTINGS: TYPE AND STYLE OF CONNECTION TO MATCH PIPE.
- E. SOLVENT CEMENT: [ASTM D2564 FOR PVC PIPE AND FITTINGS] [ASTM D2235 FOR ABS PIPE AND FITTINGS].
- F. SLEEVE MATERIAL: PVC SCH 40.
- 2.2 OUTLETS
- A. OUTLETS: BRASS CONSTRUCTION.
- B. ROTARY TYPE SPRINKLER HEAD: POP-UP TYPE WITH SCREENS; FULLY ADJUSTABLE FOR FLOW AND PRESSURE; WITH LETTER OR SYMBOL DESIGNATING DEGREE OF ARC AND ARROW INDICATING CENTER OF SPRAY PATTERN.
- C. SPRAY TYPE SPRINKLER HEAD: POP-UP HEAD WITH FULL CIRCLE PATTERN. D. QUICK COUPLER: GALVANIZED.
- 2.3 MANUAL VALVES
- A. VALVES: HIGHLY CORROSION RESISTANT CONSTRUCTION (BRASS, STAINLESS STEEL, ETC.). ALL VALVES SHALL BE ACCESSIBLE FROM ABOVE THROUGH A VALVE BOX.
- B. BACKFLOW PREVENTERS: BRONZE BODY CONSTRUCTION, REDUCED PRESSURE TYPE OR AS DESIGNATED BY LOCAL PLUMBING CODE REQUIREMENTS.
- C. VALVE BOX AND COVER: HDPE RESIN THAT IS RESISTANT TO UV LIGHT, CORROSION MOISTURE, AND CHEMICALS.
- 2.4 CONTROLS AND CONTROL VALVES
- A. CONTROLLER: MUST WORK WITH MANUFACTURER FLOW SENSOR, RAIN SENSOR, AND ****** [OR] ******
- B. CONTROLLER: AUTOMATIC CONTROLLER, MICROPROCESSOR SOLID STATE CONTROL WITH VISIBLE READOUT DISPLAY, TEMPORARY OVERRIDE FEATURE TO BYPASS CYCLE FOR INCLEMENT WEATHER, PROGRAMMABLE FOR 7 DAYS IN QUARTER HOUR INCREMENTS, WITH AUTOMATIC START AND SHUTDOWN.
- C. CONTROLLER HOUSING: NEMA 250 TYPE 3R; WEATHERPROOF, WATERTIGHT, WITH LOCKABLE ACCESS DOOR.
- D. VALVES: HYDRAULIC; NORMALLY CLOSED, INCLUDING REQUIRED FITTINGS AND ACCESSORIES.
- E. WIRE CONDUCTORS: COPPER CONDUCTOR, DIRECT BURIAL TYPE.
- F. RAIN SENSORS: PER SELECTED MANUFACTURER.
- 2.5 ELECTRICAL CHARACTERISTICS AND COMPONENTS A. ELECTRICAL CHARACTERISTICS:
- 1. 120 VOLTS, SINGLE PHASE, 60 HZ.
- B. DISCONNECT SWITCH: FACTORY MOUNT DISCONNECT SWITCH IN CONTROL PANEL.

A. THE LANDSCAPE IRRIGATION SYSTEM SHALL IRRIGATE ALL PROPOSED LANDSCAPE AND GRASS AREAS ON THE PROPERTY. THE DESIGN, PERMITTING, AND INSTALLATION OF THE

THE CONTRACTOR IS TO INSTALL EQUIPMENT NECESSARY TO PROVIDE A COMPLETE, FUNCTIONAL SYSTEM THAT IS IN COMPLIANCE WITH APPLICABLE CODES AND REGULATIONS. THE IRRIGATION CONTRACTOR SHALL SUBMIT SHOP DRAWINGS TO THE OWNER'S REPRESENTATIVE FOR APPROVAL, PRIOR TO CONSTRUCTION, WHICH WILL ILLUSTRATE TYPE OF

HAVE A MANUFACTURERS FIVE YEAR WARRANTY. THE CONTRACTOR SHALL BE RESPONSIBLE FOR PROPER INSTALLATION AND FIELD ADJUSTMENT OF THE ABOVE ITEMS.

E. THE IRRIGATION CONTRACTOR SHALL SUBMIT A WARRANTY POLICY TO THE OWNER WHICH SHALL COVER THE FUNCTION OF THE ENTIRE SYSTEM FOR A PERIOD OF ONE YEAR

CONTRACTOR WILL VERIFY STATIC PRESSURE AND VOLUME OF SITE WATER SUPPLY AND ADJUST ENTIRE IRRIGATION SYSTEM ACCORDINGLY. EACH ZONE OF IRRIGATION SYSTEM IS TO BE DESIGNED WITH A MINIMUM OPERATING PRESSURE OF 45 PSI. IF THE PRESSURE IS BELOW 45 PSI, A PROPERLY SIZED BOOSTER PUMP WILL BE REQUIRED. AS PART OF THE SHOP DRAWINGS, THE IRRIGATION CONTRACTOR WILL PROVIDE CALCULATIONS SHOWING PRESSURE LOSS FROM THE POINT OF CONNECTION TO THE FURTHEST HEAD (AND FOR THE FURTHEST HEAD ON THE LARGEST ZONE). ADJUST DESIGN TO MEET AVAILABLE PRESSURES AND VOLUMES. A CURRENT STATIC PRESSURE READING AT THE POINT OF

G. THE CONTRACTOR IS TO INSTALL ALL EQUIPMENT SUCH THAT THE BUILDING, PARKING AREAS, AND SIDEWALKS ARE NOT SPRAYED OR SUBJECT TO EXCESSIVE RUNOFF. FIELD ADJUSTMENTS MAY BE NECESSARY TO AVOID UNFORESEEN OBSTACLES AND SIMPLIFY INSTALLATION. IRRIGATION SYSTEM ACCESSORIES SUCH AS QUICK COUPLER VALVES,

H. THE IRRIGATION CONTROLLER IS TO BE A HYBRID SOLID STATE TYPE WITH PLASTIC LOCKABLE CABINET. CONTROLLER MUST HAVE DUAL PROGRAMMING FOR TURF SPRAY ZONES

PROVIDE DESIGNATED PVC SLEEVES FOR IRRIGATION PIPES AND WIRING THAT CROSSES UNDER WALKS, STREETS AND CONCRETE PADS. COMBINE PIPING WHENEVER POSSIBLE TO REDUCE QUANTITY OF SLEEVING MATERIALS. WHEN INSTALLING IRRIGATION PIPE ALONG CURBS OR IN ISLANDS, PLACE PIPE AS CLOSE TO CURB AS POSSIBLE TO ALLOW FOR

	MINATION						
Α.	ERIFY LOCATION	OF EXISTING	UTILITI	ES.			
	ERIFY REQUIRED	UTILITIES A	ARE AVA	AILABLE	, IN PROF	PER LOCATI	ON, A
3.2 PF	PARATION						
Α.	OUTE PIPING TO A	VOID PLANT	S, GROU	JND CO	VER, AND	STRUCTURE	S.
В.	AYOUT AND STAKE	LOCATIONS	S OF SYS	STEM C	OMPONEN	ITS.	
C.	EVIEW LAYOUT COORDINATE LOCA SYSTEM.				-	-	-
3.3 TF	INCHING						
A.	RENCH SIZE: . MINIMUM COVER . MINIMUM COVER	•••		••••••			
В.	RENCH TO ACCOM	MODATE GF	RADE CH	IANGES	AND SLOP	PE TO DRAIN	(S).
C.	IAINTAIN TRENCH AMAGING TO PIPE		OF DEB	RIS, M	ATERIAL,	OR OBSTR	JCTIO
3.4 IN	TALLATION						
A.	ONNECT TO UTILI	IES.					

- B. SET OUTLETS AND BOX COVERS AT FINISH GRADE ELEVATIONS.
- C. PROVIDE FOR THERMAL MOVEMENT OF COMPONENTS IN SYSTEM.
- D. SLOPE PIPING FOR SELF DRAINAGE TO DAYLIGHT.
- E. USE THREADED NIPPLES FOR RISERS TO EACH OUTLET.
- F. INSTALL CONTROL WIRING IN ACCORDANCE WITH MANUFACTURER'S RECOMMENDED INSTALLATION PRACTICES. PROVIDE 10 INCH EXPANSION COIL AT EACH CONTROL VALVE, AND AT 100 FT INTERVALS. BURY WIRE BESIDE PIPE. MARK VALVES WITH NEOPRENE VALVE MARKERS CONTAINING LOCKING DEVICE. SET VALVE MARKERS IN VALVE BOXES SET TO FINISH GRADE
- G. AFTER PIPING IS INSTALLED, BUT BEFORE OUTLETS ARE INSTALLED AND BACKFILLING COMMENCES, OPEN VALVES AND FLUSH SYSTEM WITH FULL HEAD OF WATER.

3.5 BACKFILLING

- A. BACKFILL WITH COMPACTED BACKFILL IN ACCORDANCE WITH DETAIL A ON SHEET C-7.1.
- B. INSTALL 3 INCH SAND BEDDING BELOW AND COVER OVER PIPING.
- C. PROTECT PIPING FROM DISPLACEMENT.
- 3.6 FIELD QUALITY CONTROL
- A. PRIOR TO BACKFILLING, TEST SYSTEM FOR LEAKAGE FOR WHOLE SYSTEM TO MAINTAIN 100 PSI PRESSURE FOR ONE HOUR.
- B. SYSTEM IS ACCEPTABLE WHEN NO LEAKAGE OR LOSS OF PRESSURE OCCURS DURING TEST PERIOD.
- C. PROVIDE ONE COMPLETE SPRING SEASON START-UP AND FALL SEASON SHUTDOWN. 3.7 ADJUSTING
- A. ADJUST CONTROL SYSTEM TO ACHIEVE TIME CYCLES REQUIRED
- B. ADJUST HEAD TYPES FOR FULL WATER COVERAGE AS DIRECTED BY OWNER'S REPRESENTATIVE.
- 3.8 DEMONSTRATION AND TRAINING
- A. INSTRUCT OWNER'S PERSONNEL IN OPERATION AND MAINTENANCE OF SYSTEM, INCLUDING ADJUSTING OF SPRINKLER HEADS. USE OPERATION AND MAINTENANCE MATERIAL AS BASIS FOR DEMONSTRATION.

SCALE: 1"=20'



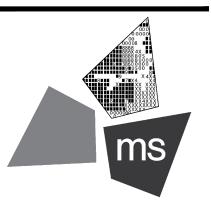
REVISION/DATE/DESCRIPTION

SIR UPDATES	09/13/21
60% SET	01/24/22
PDP APPLICATION TO CITY	02/24/22
RESPONSE TO CITY COMMENTS I	03/29/22

NOTICE

THIS ARCHITECTURAL AND ENGI-NEERING DRAWING IS GIVEN IN CONFIDENCE AND SHALL BE USED ONLY PURSUANT TO THE AGREE MENT WITH THE ARCHITECT. NO OTHER USE DISSEMINATION OR DUPLICATION MAY BE MADE WITHOUT PRIOR WRITTEN CONSENT OF THE ARCHITECT. ALL COMMON LAW RIGHTS OF COPYRIGHT AND OTHERWISE ARE HEREBY SPECIFI-CALLY RESERVED.





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PROJECT

PROPOSED PT20M BUILDING

NEQ HWY 150 & SW HOLLYWOOD DR. LEE'S SUMMIT, MO 64082

SHEET TITLE

IRRIGATION PLAN

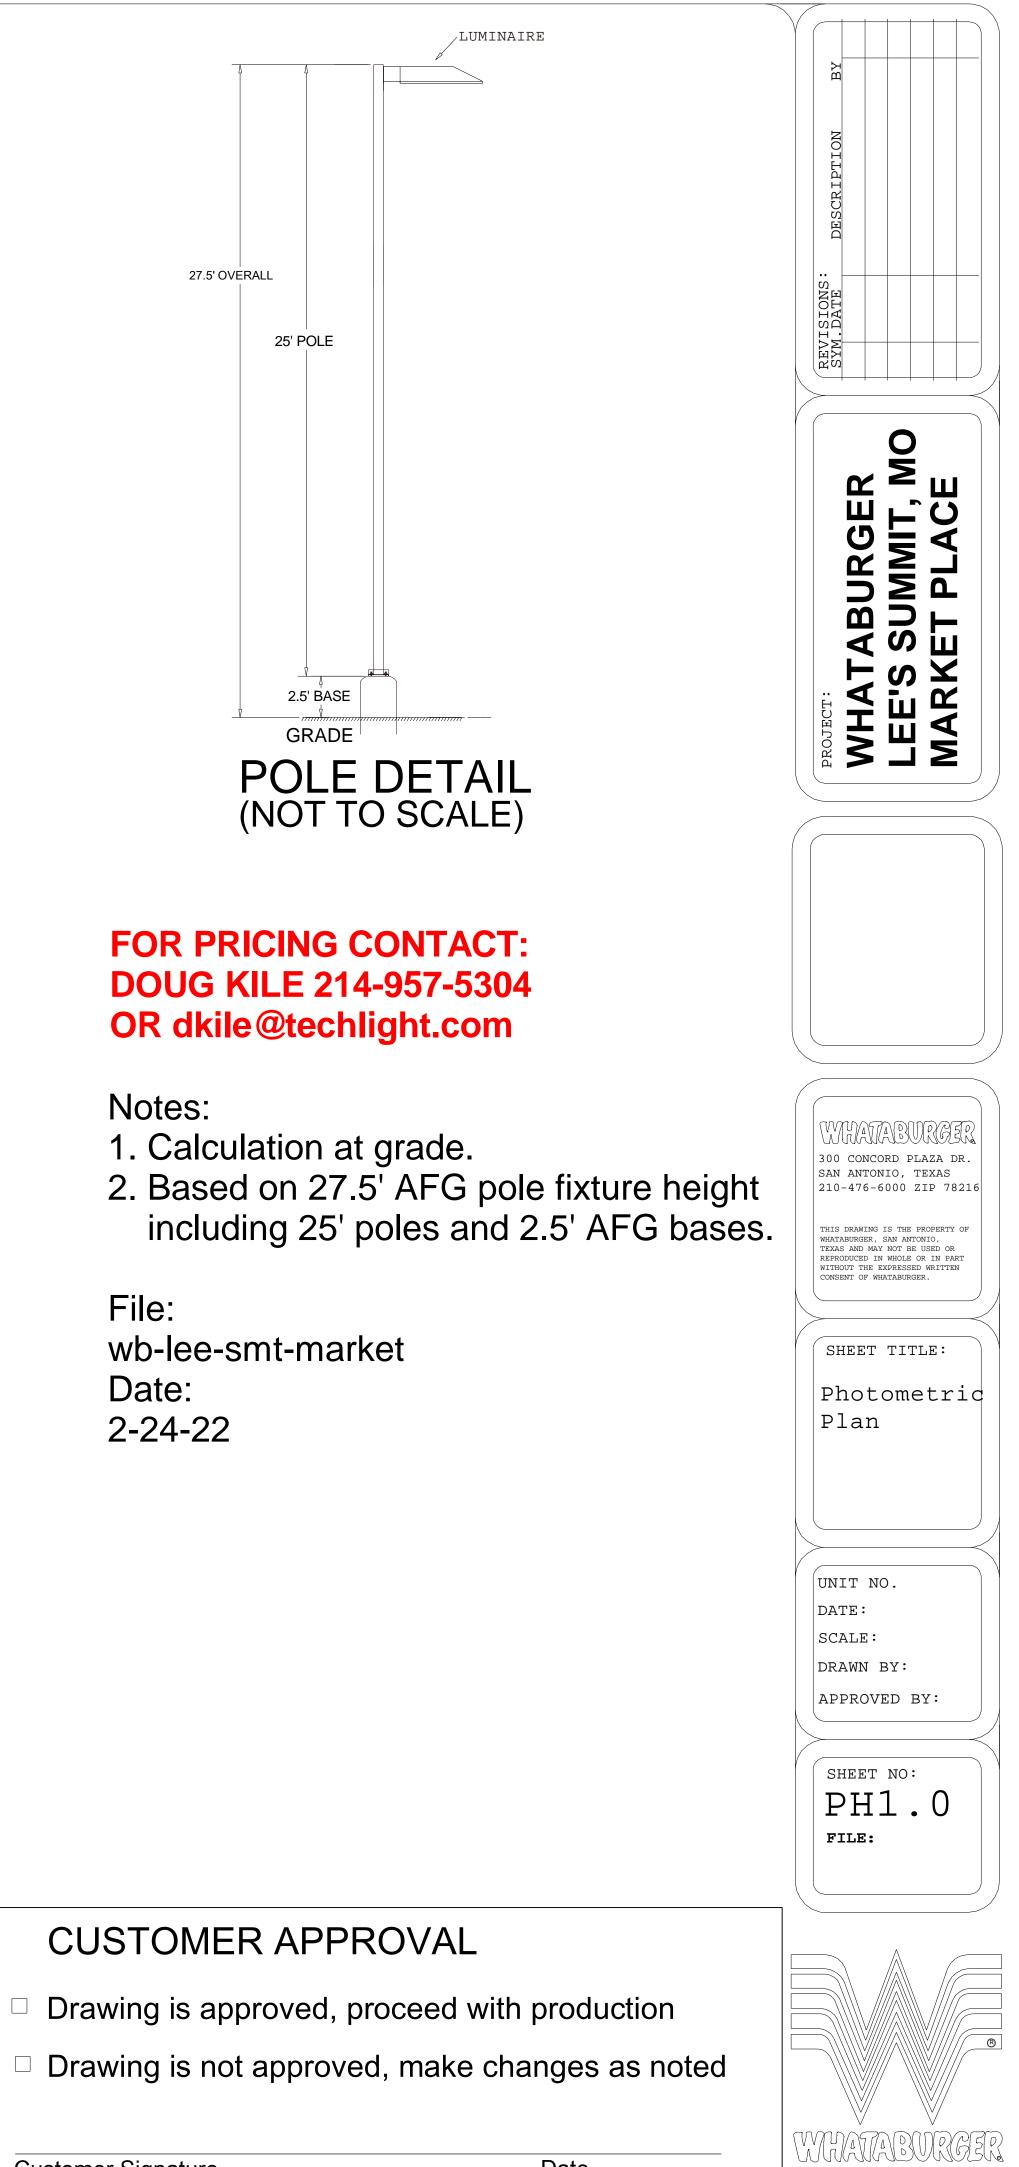
DRAWN BY:	TDB
CHECKED BY:	PJK
PROJECT NO:	40497-21

DRAWING

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	Luminaire Schedule
	Symbol Qty Label Lumens/Lamp Arrangement LLF Description
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SCALE	
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0 20 40 00	SITE Illuminance Fc 2.24 8.1 0.0 N.A. N.A. 1 S1-3 27.5 0
	PARKING AND DRIVE Illuminance Fc 5.39 8.1 1.9 2.84 4.26 2 S1-3 27.5 0 3 S1-3S 27.5 0
TECHLIGHT INC. - DUE TO CHANGING LIGHTING ORDINANCES IT IS THE CONTRACTORS	3 S1-3S 27.5 0 4 S1-3S 27.5 0
RESPONSIBILITY TO SUBMIT THE SITE PHOTOMETRICS AND LUMINAIRE SPECS TO THE LOCAL INSPECTOR BEFORE ORDERING TO ENSURE	5 S1-3S 27.5 0
THIS PLAN COMPLIES WITH LOCAL LIGHTING ORDINACES.	6 S1-3S 27.5 0 7 S1-3S 27.5 0
- THIS LIGHTING DESIGN IS BASED ON INFORMATION SUPPLIED BY OTHERS. CHANGES IN ELECTRICAL SUPPLY, AREA GEOMETRY AND OBJECTS WITHIN	8 \$1-3\$ \$27.5 0
THE LIGHTED AREA MAY PRODUCE ILLUMINATION VALUES DIFFERENT	9 \$1-3\$ \$27.5\$ 0 10 \$1-3\$ \$27.5\$ 0
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Date