CIVIL ENGINEER PREMIER DESIGN GROUP 100 MIDLAND PARK DRIVE WENTZVILLE, MO 63385 314-925-7444 CONTACT: MATT FOGARTY

MUNICIPALITY CITY OF LEE'S SUMMIT 200 SE GREEN LEE'S SUMMIT, MO 64063 (816) 969-1200 CONTACT: DEVELOPMENT SERVICES DEPARTMENT

Е	XIS	STING LEGEND
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	FOL	JND STONE MONUMENT
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		DOUBLE CURB INLET
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—Ug		UNDERGROUND TELEPHONE
	IE—	UNDERGROUND TELEPHONE OVERHEAD ELECTRIC/PHONE
—0i —2"\		2" WATER MAIN
- 2 \	, v	Z VVA I EN IVIAIN

UTILITY PROVIDERS

WATER

CITY OF LEE'S SUMMIT WATER 1200 SE HAMBLEN RD LEE'S SUMMIT, MO 64081 (816) 969 1900 CONTACT: T.B.D.

ELECTRIC

EVERGY 1351 NW WARD RD LEE'S SUMMIT, MO 64086

(888) 471-5275 CONTACT: RON DEJARNETTE

GAS SPIRE

1117 S. PLEASANT ST INDEPENDENCE, MO 64050 (800) 582-1234 CONTACT: T.B.D.

TELEPHONE

AT&T BUSINESS COMMUNICATION SERVICES (618) 346-6400 CONTACT: T.B.D.

FIRE DEPARTMENT CITY OF LEE'S SUMMIT FIRE PROTECTION 207 E. DOUGLAS BLVD LEE'S SUMMIT, MO 64063 (816) 969-1313 CONTACT: MIKE SNIDER - FIRE CHIEF

SANITARY SEWER CITY OF LEE'S SUMMIT SEWER 1200 SE HAMBLEN ROAD LEE'S SUMMIT, MO 64081 (816) 969 1900 CONTACT: T.B.D.

CABLE SPECTRUM

188 NW OLDHAM PKWY LEE'S SUMMIT, MO 64081 (874) 874 2389



FINAL DEVELOPMENT PLAN

500 NW CHIPMAN RD.

ALL OF LOT 4C, SUMMIT ORCHARD, LOT 4C-1, 4C-2 AND 4C-3, CORRECTED SUMMIT ORCHARD, LOTS 4A-4E, A SUBDIVISION IN LEE'S SUMMIT, JACKSON COUNTY, MISSOURI.



LOCATION MAP 1" = 250'

DISTURBED AREA = 0.73 ACRES

COORDINATE DATA:

PER ST. JACKSON COUNTY REGULATIONS, COORDINATE VALUE ARE SHOWN IN U.S. FEET AND ALL BEARINGS ARE GRID BEARINGS. ALL DISTANCES ARE GROUND DISTANCES.

N: X,XXX,XXX.XXX USft. (in U.S. FEET)

E: XXX,XXX.XXX USft. (IN U.S. FEET)

PER MISSOURI COORDINATE SYSTEM 1983, WEST ZONE (ZONE NO. 2403) GRID FACTORS = 0.99899480

BEARINGS ADOPTED:

BASIS OF BEARINGS IS THE STATE PLANE COORDINATE SYSTEM (SPCS) NAD 83 (2011) WEST ZONE

ELEVATION ADOPTED:

THE ELEVATIONS WERE ESTABLISHED USING THE MISSOURI DEPARTMENT OF TRANSPORTATION'S VRS, RTK SYSTEM AND IS REFERENCED TO THE NAVD 88 DATUM WITH GEOID 18.



PRCOM20215300

SHEET INDEX

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C-200	GRADING PLAN
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C-400	INITIAL EROSION CONTROL PLAN
C-401	FINAL EROSION CONTROL PLAN
C-402	EROSION CONTROL DETAILS
C-500	STORM SEWER PROFILES
C-600	CONSTRUCTION DETAILS
C-601	CONSTRUCTION DETAILS
C-700	UTILITY DETAILS
C-800	EXISTING DRAINAGE AREA MAP
C-801	STORMWATER MANAGEMENT PLAN

LANDSCAPE PLAN

L-100

E0.01

PROPERTY DATA

ELECTRICAL SITE & PHOTOMETRIC PLAN

OVERALL SITE ACREAGE ±0.828 ACRES **ADDRESS** 500 NW CHIPMAN RD. PARCEL ID# 52-900-03-42-00-0-00-000 **EXISTING ZONING** PMIX - PLANNED MIXED USE **CURRENT LAND USE** VACANT COMMERCIAL PROPERTY PROPOSED LAND USE COMMERCIAL

LEGAL DESCRIPTION:

ALL OF LOT 4C, SUMMIT ORCHARD, LOT 4C-1, 4C-2 AND 4C-3, CORRECTED SUMMIT ORCHARD, LOTS 4A-4E, A SUBDIVISION IN LEE'S SUMMIT, JACKSON COUNTY, MISSOURI.

SITE COVERAGE CALCULATIONS

SITE AREA = ± 0.828 ACRES / 36,067.68 S.F. FLOOR TO AREA RATIO

EXISTING IMPERVIOUS AREA PARKING LOT AND BUILDING 0.046 ACRES OF PAVEMENT

0.00 ACRES OF BUILDING

EXISTING PERCENT OF IMPERVIOUS AREA COVERAGE = 5.56%

 $\frac{\text{PROPOSED IMPERVIOUS AREA PARKING LOT AND BUILDING}}{0.540 \text{ ACRES OF PAVEMENT}}$

0.022 ACRES OF BUILDING

PROPOSED GREEN SPACE 0.266 ACRES OF GREEN SPACE

PROPOSED PERCENT OF IMPERVIOUS AREA COVERAGE = 67.87%

CONSTRUCTION As Noted on Plans Review **Development Services Departmen** Lee's Summit, Missouri

ELECTRONIC DRAWING NOTE: ELECTRONIC MEDIA OR DIGITAL DRAWINGS ARE INSTRUMENT OF PROFESSIONAL SERVICES. OWNERSHIP OF SUCH WILL BE RETAINED BY THE CIVIL ENGINEER AND MAY NOT BE RELEASED TO CONTRACTORS. CONTRACTORS ARE ADVISED TO CREATE BIDS BASED ON THE USE OF PAPER COPIES OF THE PLANS.





STEVEN D. MARION P.E.
PROFESSIONAL ENGINEER
PE 2006007195

9-30-2021 SHEE

C-000

2109720 A. JONES Drawn By M. FOGARTY Checked By

ISSUED FOR CONSTRUCTION

— 8"W — │ 8" WATER MAIN -X" GAS- GAS LINE —507— CONTOUR LINE UNDERGROUND UTILITIES AND OSHA SAFETY NOTE: Underground utilities and structures have been plotted from available

— 6"W — 6" WATER MAIN

information and therefore, their location must be considered

approximate only. It is the responsibility of the individual contractors

rules and regulations established for the type of construction required by these plans shall be strictly followed (ie. trenching, blasting, etc.)

PAVING, GRADING, AND DRAINAGE NOTES:

TRAFFIC CONTROL ON ALL STATE, CITY AND COUNTY RIGHTS-OF-WAY SHALL MEET THE REQUIREMENTS OF THE MANUAL OF UNIFORM TRAFFIC CONTROL DEVICES (U.S. DOT/FHA) AND THE REQUIREMENTS OF THE STATE AND ANY LOCAL AGENCY HAVING JURISDICTION. IN THE EVENT THAT THE CONTRACT DOCUMENTS AND THE JURISDICTIONAL AGENCY REQUIREMENTS ARE NOT IN AGREEMENT, THE MOST STRINGENT SHALL GOVERN.

THE CONTRACTOR SHALL GRADE THE SITE TO THE ELEVATIONS INDICATED AND SHALL RE-GRADE ANY WASHOUTS WHERE THEY OCCUR AFTER EVERY RAINFALL EVENT UNTIL SOIL IS STABILIZED.

ALL AREAS INDICATED AS PAVEMENT SHALL BE CONSTRUCTED IN ACCORDANCE WITH THE TYPICAL PAVEMENT SECTIONS AS INDICATED ON THE DRAWINGS AND THE PROJECT SPECIFICATIONS.

WHERE EXISTING PAVEMENT IS INDICATED TO BE REMOVED AND REPLACED, THE CONTRACTOR SHALL SAW CUT TO FULL DEPTH OF EXISTING PAVEMENT. CONTRACTOR SHALL PREPARE A SMOOTH, SOUND, VERTICAL FACE AND MATCH THE EXISTING PAVEMENT ELEVATION UNLESS OTHERWISE NOTED. CONTRACTOR SHALL INSTALL LONGITUDINAL BUTT JOINTS WHEN CONNECTING TO EXISTING CONCRETE PAVEMENT

THE CONTRACTOR SHALL ENSURE THAT ALL PLANTING AREAS ARE NOT OVERLY COMPACTED AND DO NOT CONTAIN LIMEROCK. THE CONTRACTOR SHALL EXCAVATE AND REMOVE ALL UNDESIRABLE MATERIAL FROM ALL AREAS ON THE SITE TO BE PLANTED.

ALL DRAINAGE STRUCTURES SHALL BE DE-SILTED AS REQUIRED DURING AND AT THE END OF CONSTRUCTION TO PROVIDE POSITIVE DRAINAGE FLOWS

9. STRIP TOPSOIL AND ORGANIC MATTER AND PAVING MATERIAL FROM ALL AREAS UNDER BUILDING, TOPSOIL MAY BE STOCKPILED ON SITE FOR REPLACEMENT IN GREEN AREAS.

BEFORE PLACING PAVEMENT, CONTRACTOR SHALL VERIFY THAT SUITABLE HANDICAPPED ROUTES (PER A.D.A. REQUIREMENTS) EXIST TO AND FROM EVERY ACCESSIBLE DOOR. IN NO CASE SHALL HANDICAP RAMP SLOPES EXCEED 1 VERTICAL TO 12 HORIZONTAL. IN NO CASE SHALL SIDEWALK CROSS SLOPES EXCEED 2.0 PERCENT. IN NO CASE SHALL LONGITUDINAL SIDEWALK SLOPES EXCEED 5.0 PERCENT. CONTRACTOR SHALL CONTACT ARCHITECT AND CIVIL ENGINEER PRIOR TO PAVING IF ANY EXCESSIVE SLOPES ARE ENCOUNTERED. NO CONTRACTOR CHANGE ORDERS WILL BE ACCEPTED FOR A.D.A. COMPLIANCE ISSUES.

12. CONTRACTOR ADJUSTMENT TO SPOT GRADES TO MAINTAIN POSITIVE DRAINAGE IS ALLOWED, ONLY WITH THE PRIOR APPROVAL OF THE CIVIL ENGINEER. CONTRACTOR SHALL CONTACT THE CIVIL ENGINEER PRIOR TO PAVING IF ANY AREAS OF POOR DRAINAGE ARE ENCOUNTERED.

13. SPOT ELEVATIONS SHOWN ARE TO TOP OF PAVING SURFACE OR FINISHED EARTH GRADE UNLESS NOTED OTHERWISE. WHERE APPLICABLE, ADD 0.50 FEET TO SPOT GRADES SHOWN FOR TOP OF CURB ELEVATIONS.

14. THE CONTRACTOR TAKE ALL MEASURES NECESSARY TO CONTROL TURBIDITY, INCLUDING BUT NOT LIMITED TO, THE INSTALLATION OF BMP'S AT ALL LOCATIONS WHERE THE POSSIBILITY OF TRANSFERRING SUSPENDED SOLIDS INTO THE RECEIVING WATER BODY EXISTS DUE TO THE PROPOSED WORK. BMP'S MUST BE MAINTAINED IN EFFECTIVE CONDITION AT ALL LOCATIONS UNTIL CONSTRUCTION IS COMPLETED AND DISTURBED SOIL AREAS ARE STABILIZED. THEREAFTER, THE CONTRACTOR MUST REMOVE THE TEMPORARY BARRIERS, AT NO TIME SHALL THERE BE ANY OFF-SITE DISCHARGE WHICH VIOLATES LOCAL, STATE, OR FEDERAL WATER QUALITY STANDARDS

15. THE CONTRACTOR MUST REVIEW AND MAINTAIN A COPY OF THE STORM WATER PERMIT COMPLETE WITH ALL CONDITIONS, ATTACHMENTS, EXHIBITS, AND PERMIT MODIFICATIONS, IN GOOD CONDITION, AT THE CONSTRUCTION SITE. THE COMPLETE PERMIT MUST BE AVAILABLE FOR REVIEW UPON REQUEST BY JURISDICTIONAL AGENCIES.

16. IF ANY EXISTING STRUCTURES, FACILITIES, OR IMPROVEMENTS (PUBLIC OR PRIVATE) TO REMAIN ARE DAMAGED DURING CONSTRUCTION, IT SHALL BE THE CONTRACTOR'S RESPONSIBILITY TO REPAIR AND/OR REPLACE THE EXISTING STRUCTURE, FACILITY, OR IMPROVEMENT AS NECESSARY TO RETURN IT TO EXISTING CONDITIONS OR BETTER.

17. CONTRACTOR SHALL REFERENCE ARCHITECT AND ELECTRICAL PLANS AND PROVIDE CONDUIT NEEDED FOR LOT LIGHTING AND SIGNAGE PRIOR TO SITE PAVING.

18. PAVING LINE AND GRADE SHALL "FLUSHOUT" ALONG ALL CONNECTIONS TO EXISTING PAVING.

10. FIELD DENSITY TESTS SHALL BE TAKEN AT A FREQUENCY AS REQUIRED IN THE PROJECT SPECIFICATIONS.

19. ALL BENDS LESS THAN 42" DIAMETER MUST BE FACTORY MANUFACTURED BENDS

20. ALL WORK SHALL BE DONE IN COMPLIANCE WITH THE PROJECT GEOTECHNICAL SERVICE REPORT FOR THIS SITE.

21. PAVING CONTRACTOR IS RESPONSIBLE FOR ALL LAY DOWN CURBS AT INTERSECTIONS WHERE BARRIER FREE RAMPS ARE TO BE CONSTRUCTED.

22. REFERENCE DETAIL SHEETS FOR PAVEMENT JOINT SPACING AND REQUIREMENTS. ALL SAWCUT AND JOINT LOCATIONS WILL BE AS REQUIRED BY THE CITY OF LEE'S SUMMIT INSPECTOR.

23. PRIVATE STORM PIPE MATERIAL SHALL BE PER CITY OF LEE'S SUMMIT SPECIFICATIONS.

24. ALL ELEVATIONS SHOWN ON THE GRADING PLAN ARE TO TOP OF PAVEMENT OR FINISHED GROUND UNLESS NOTED OTHERWISE. ELEVATIONS TO POINTS OTHER THAN THE TOP OF PAVEMENT

TP=TOP OF PAVEMEN TC=TOP OF CURB TW=TOP OF WALL

BW=FINISHED GROUND AT FACE OF WALL

GRND=FINISHED GROUND AT YARD DRAINS, TOP OF FINISHED GRADE IN NON-PAVEMENT AREAS

GRADING PLAN NOTES:

1. THE CONTRACTOR SHALL RESTORE OFFSITE CONSTRUCTION AREAS TO AN EQUAL OR BETTER CONDITION THAN EXISTED PRIOR TO COMMENCEMENT OF CONSTRUCTION.

2. ALL GRADES SHALL BE WITHIN 0.1 FEET MORE OR LESS OF THOSE SHOWN ON THE GRADING PLAN.

3. NO SLOPE SHALL BE GREATER THAN 3:1 AND SHALL BE EITHER SODDED OR SEEDED AND MULCHED UNLESS OTHERWISE NOTED OR DETAILED.

THE CONTRACTOR SHALL FIELD INVESTIGATE THE ENTIRE SITE PRIOR TO HIS BID SUBMITTAL NOTING THE EXISTING VEGETATION, PAVEMENT AREAS, BUILDING MATERIALS, BUILDING MATERIAL TYPES, PARKING LIGHTING, UTILITIES AND TREES. THE REMOVAL AND DISPOSAL OF ALL ITEMS SHALL BE INCLUDED IN THE BID.

5. NO AREA SHALL BE CLEARED WITHOUT PERMISSION OF THE OWNER/DEVELOPER, SILTATION CONTROL WILL BE PROVIDED AS REQUIRED TO PREVENT RUN-OFF. REFER TO THE EROSION CONTROL PLAN(S)

ALL TRASH, DEBRIS, ORGANIC MATERIAL, REFUSE, FROZEN EARTH, ETC., SHALL BE REMOVED FROM FILL AREAS PRIOR TO THE PLACEMENT OF CONTROLLED FILL. ALL FILLS AND BACKFILLS SHALL BE MADE OF SELECTED EARTH MATERIALS, FREE FROM BROKEN MASONRY, ROCK, FROZEN EARTH, RUBBISH, ORGANIC MATERIAL AND DEBRIS

THE CONTRACTOR SHALL PROVIDE EROSION CONTROL PER THE EROSION CONTROL PLAN(S) AND MAY BE REQUIRED TO PROVIDE ADDITIONAL MEASURES AS REQUESTED BY THE CITY OF LEE'S SUMMIT, SHOULD THE EROSION CONTROL PLAN AND DETAILS PROVE TO BE INSUFFICIENT DUE TO UNFORESEEN CIRCUMSTANCES.

8. CARE SHALL BE EXERCISED IN COMPACTION OF BACKFILL MATERIALS OVER THE TOP OF STRUCTURES OR PIPES IN ORDER TO PREVENT DAMAGE TO THE WATERPROOFING MEMBRANES. JOINTS. SEALS AND/OR THE PIPES AND STRUCTURES THEMSELVES. COMPACTION AND PLACING OF BACKFILL AND FILL MATERIALS SHALL BE PERFORMED UNDER THE CONTINUOUS SUPERVISION OF AN APPROVED TESTING LABORATORY. FILL SHALL NOT BE PLACED ON FROZEN GROUND, NOR SHALL FILLING OPERATIONS CONTINUE WHEN THE TEMPERATURE IS SUCH AS TO PERMIT THE LAYER UNDER PLACEMENT TO

ALL CITY, COUNTY, AND STATE ROADS SHALL BE KEPT FREE OF DIRT DAILY.

10. FINAL GRADES SHALL MATCH EXISTING ELEVATIONS AT THE LAND DISTURBANCE LIMITS UNLESS OTHERWISE SHOWN.

11. THE DEVELOPER IS REQUIRED TO PROVIDE ADEQUATE STORM WATER SYSTEMS IN ACCORDANCE WITH THE CITY OF LEE'S SUMMIT, AND EPA STANDARDS.

12. ALL GRADING AND DRAINAGE TO BE IN CONFORMANCE WITH THE CITY OF LEE'S SUMMIT AND EPA STANDARDS.

13. INTERIM STORM WATER DRAINAGE CONTROL IN THE FORM OF SILTATION CONTROL MEASURES ARE REQUIRED.

14. ANY LAND DISTURBANCE ACTIVITY INVOLVING ONE (1) ACRE OR MORE OF LAND IS A MAJOR LAND DISTURBANCE (MLD) AND A LAND DISTURBANCE FOR THE MLD MUST BE OBTAINED FROM THE DEPARTMENT OF PUBLIC WORKS. ANY LAND DISTURBANCE ACTIVITY INVOLVING LESS THAN ONE (1) ACRE IS AN ORDINARY LAND DISTURBANCE AND THE APPROPRIATE PERMIT(S) MUST BE OBTAINED FROM THE DEPARTMENT OF PUBLIC WORKS.

15. G.C. TO BE AWARE THAT A LAND DISTURBANCE PERMIT WILL BE REQUIRED. SITE PLAN/PLAT APPROVAL IS NOT TO BE CONSTRUED AS APPROVAL OF A LAND DISTURBANCE PERMIT.

16. ALL WORK SHALL BE IN COMPLIANCE WITH THE PROJECT GEOTECHNICAL SERVICES REPORT FOR THIS PROJECT.

17. ANY DISTURBED SIDEWALK OR CONCRETE PAVEMENT AREAS SHALL BE REPAIRED BY FULL SLAB REPLACEMENT UNLESS SPECIFICALLY AUTHORIZED BY THE DEVELOPER OR MUNICIPALITY HAVING JURISDICTION.

18. ALL UTILITY SPOILS SHALL BE INCLUDED IN THE GENERAL CONTRACTOR'S BID. GENERAL CONTRACTOR SHALL COORDINATE WITH THE EXCAVATOR AND UTILITY INSTALLER.

19. THE CONTRACTOR SHALL CONTACT THE CITY'S DEVELOPMENT SERVICES ENGINEERING INSPECTOR TO SCHEDULE A PRE-CONSTRUCTION MEETING WITH AN INSPECTOR PRIOR TO ANY LAND

ADA COMPLIANCE NOTES

1. CONTRACTOR SHALL CONFIRM ALL EXISTING SLOPES FOR ACCESSIBLE ROUTES AS WELL AS THE ACCESSIBLE PARKING STALLS AND ACCESSIBLE AISLES WITH A SLOPE METER TO CONFIRM MAXIMUM SLOPES ARE NOT EXCEEDED.

2. CONTRACTOR IS REQUIRED TO PROVIDE AS-BUILT SPOT ELEVATIONS ALONG THE ACCESSIBLE ROUTES SHOWN ON THIS PLAN EVERY 10 FEET IN ORDER TO CONFIRM MAXIMUM (2%) CROSS-SLOPE AND MAXIMUM (5%) SLOPES IN THE DIRECTION OF TRAVEL. IN ADDITION. SPOT ELEVATIONS ARE REQUIRED ON ALL CORNERS AND MIDPOINTS OF ACCESSIBLE PARKING STALLS AND ACCESSIBLE AISLES TO CONFIRM MAXIMUM 2% SLOPES ARE NOT EXCEEDED IN ALL DIRECTIONS. THIS INFORMATION SHALL BE PROVIDED, A MINIMUM OF 2 WEEKS BEFORE STORE TURNOVER.

3. THE GENERAL AND CONCRETE CONTRACTOR SHALL FIELD VERIFY ADA SLOPES DURING CONCRETE POUR. A 2' SMART LEVEL WITH AN ACCURACY TO .029 PERCENT SHALL BE USED FOR VERIFYING SLOPES. ANY SLOPES IN THE ADA AREAS THAT EXCEED A 2% CROSS SLOPE ALONG THE BUILDING, ADA STALLS AND/OR SIDEWALK, 5% RUNNING SLOPE FOR SIDEWALKS AWAY FROM THE PROPOSED PETSUITES BUILDING, AND EXCEED 8.3% ON RAMPS SHALL BE REMOVED AND REPLACED AT THE CONCRETE CONTRACTOR'S EXPENSE. THE SURVEYOR FOR STAKING CAN PROVIDE A REFERENCE FOR ELEVATION HOWEVER CONFIRMATION IS REQUIRED BY SLOPE LEVEL DURING CONSTRUCTION.

ABBREVIATIONS:

AREA INLET (OPEN 4 SIDES UNLESS NOTED OTHERWISE) DAI....... DOUBLE AREA INLET (OPEN 6 SIDES UNLESS NOTED OTHERWISE.

MH..... MANHOLE CURB INLE

DCI..... DOUBLE CURB INLET GRATE INLET WITH SIDE INTAKE. (ELEVATION OF INLET TOP IS TO THE TOP OF GRATE, ADD 0.50' FOR TOP OF SIDE INTAKE.) 2 GRATE INLET WITH SIDE INTAKE. (ELEVATION OF INLET TOP IS TO THE TOP OF GRATE, ADD 0.50' FOR TOP OF SIDE INTAKE.)

FLARED END SECTION

INTERCEPTOR MANHOLE TRENCH DRAIN

ATG...... ADJUST TO GRADE DENOTES HYDRAULIC GRADE JUMP TBR...... TO BE REMOVED TBR&R..... TO BE REMOVED & REPLACED

GENERAL NOTES:

- ALL CONSTRUCTION SHALL BE IN ACCORDANCE WITH THE CITY OF LEE'S SUMMIT SPECIFICATIONS, CITY OF LEE'S SUMMIT "STANDARD DETAILS", THE CITY OF LEE'S SUMMIT'S DESIGN AND CONSTRUCTION MANUAL, LATEST EDITION, THE PROJECT SPECIFICATIONS BOOK, AND THESE CONSTRUCTION PLANS. IN CASE OF CONFLICTING SPECIFICATIONS FOR DETAILS, THE CIVIL ENGINEER SHALL BE CONTACTED PRIOR TO CONSTRUCTION, GENERALLY, THE MOST STRINGENT SPECIFICATION SHALL APPLY.
- 2. DURING THE CONSTRUCTION OF THESE IMPROVEMENTS, ANY INTERPRETATION OF THE STANDARD SPECIFICATIONS, AND ANY MATTER WHICH REQUIRES THE APPROVAL OF THE OWNER, MUST BE APPROVED BY THE CITY OF LEE'S SUMMIT DEVELOPMENT ENGINEER BEFORE ANY CONSTRUCTION INVOLVING THAT DECISION COMMENCES. ASSUMPTIONS ABOUT WHAT THESE DECISIONS MIGHT BE WHICH ARE MADE DURING THE BIDDING PHASE WILL HAVE NO BEARING ON THE DECISION.
- 3. THE CONTRACTOR SHALL BE RESPONSIBLE FOR FURNISHING ALL MATERIAL AND LABOR TO CONSTRUCT THE FACILITY AS SHOWN AND DESCRIBED IN THE CONSTRUCTION DOCUMENTS IN ACCORDANCE WITH THE APPROPRIATE APPROVING AUTHORITIES, SPECIFICATIONS AND REQUIREMENTS. CONTRACTOR SHALL VISIT THE SITE PRIOR TO BIDDING TO DETERMINE EXISTING
- 4. ALL EXISTING UTILITIES SHOWN ARE LOCATED ACCORDING TO THE INFORMATION AVAILABLE TO THE ENGINEER AT THE TIME THE DRAWINGS WERE PREPARED AND HAVE NOT BEEN INDEPENDENTLY VERIFIED BY THE OWNER OR THE ENGINEER. GUARANTEE IS NOT MADE THAT ALL EXISTING UNDERGROUND UTILITIES ARE SHOWN OR THAT THE LOCATION OF THOSE SHOWN ARI ACCURATE. THE LOCATIONS SHOWN ARE FOR BIDDING PURPOSES ONLY. FINDING THE ACTUAL LOCATION OF ANY EXISTING UTILITIES IS THE CONTRACTOR'S RESPONSIBILITY AND SHALL BE DONE BEFORE HE COMMENCES ANY WORK (INCLUDING ORDERING OF MATERIALS) IN THE VICINITY. FURTHERMORE, THE CONTRACTOR SHALL BE FULLY RESPONSIBLE FOR ANY AND ALL DAMAGES DUE TO THE CONTRACTOR'S FAILURE TO EXACTLY LOCATE AND PRESERVE ANY AND ALL UNDERGROUND UTILITIES. THE OWNER OR CEC WILL ASSUME NO LIABILITY FOR ANY DAMAGES SUSTAINED OR COST INCURRED BECAUSE OF THE OPERATIONS IN THE VICINITY OF EXISTING UTILITIES OR STRUCTURES, NOR FOR TEMPORARY BRACING AND SHORING OF SAME. IF IT IS NECESSARY TO SHORE, BRACE, SWING OR RELOCATE A UTILITY, THE UTILITY COMPANY OR DEPARTMENT AFFECTED SHALL BE CONTACTED BY THE CONTRACTOR AND THEIR PERMISSION OBTAINED REGARDING
- IT IS THE CONTRACTOR'S RESPONSIBILITY TO CONTACT THE VARIOUS UTILITY COMPANIES WHICH MAY HAVE BURIED OR AERIAL UTILITIES WITHIN OR NEAR THE CONSTRUCTION AREA BEFORE COMMENCING WORK. THE CONTRACTOR SHALL PROVIDE 72 HOURS MINIMUM NOTICE TO ALL UTILITY COMPANIES PRIOR TO BEGINNING CONSTRUCTION. A LIST OF THE UTILITY COMPANIES WHICH THE CONTRACTOR MUST CALL BEFORE COMMENCING WORK IS PROVIDED ON THE COVER SHEET OF THESE CONSTRUCTION PLANS. THIS LIST SERVES AS A GUIDE ONLY AND IS NOT INTENDED TO LIMIT THE UTILITY COMPANIES WHICH THE CONTRACTOR MAY WISH TO NOTIFY.
- 6. THE CONTRACTOR SHALL BE RESPONSIBLE FOR OBTAINING ALL REQUIRED CONSTRUCTION PERMITS, 3-WAY CONTRACTS, AND BONDS PRIOR TO CONSTRUCTIONS.
- 7. THE CONTRACTOR SHALL HAVE AVAILABLE AT THE JOB SITE AT ALL TIMES ONE COPY OF THE CONTRACT DOCUMENTS INCLUDING PLANS, SPECIFICATIONS AND SPECIAL CONDITIONS, COPIES OF ANY REQUIRED CONSTRUCTION PERMITS
- ANY DISCREPANCIES ON THE DRAWINGS SHALL BE IMMEDIATELY BROUGHT TO THE ATTENTION OF THE OWNER & CIVIL ENGINEER BEFORE COMMENCING WORK. NO FIELD CHANGES OR DEVIATIONS FROM DESIGN ARE TO BE MADE WITHOUT PRIOR APPROVAL TO THE OWNER AND NOTIFICATION TO THE ENGINEER. NO CONSIDERATION WILL BE GIVEN TO CHANGE ORDERS FOR WHICH THE OWNER AND CIVIL ENGINEER WERE NOT CONTACTED PRIOR TO CONSTRUCTION OF THE AFFECTED ITEM.
- 9. ALL COPIES OF COMPACTION, CONCRETE AND OTHER REQUIRED TEST RESULTS ARE TO BE SENT TO THE CIVIL ENGINEER OF RECORD AND THE CITY OF LEE'S SUMMIT DEVELOPMENT ENGINEER DIRECTLY FROM THE TESTING AGENCY.
- 10. THE CONTRACTOR SHALL BE RESPONSIBLE FOR SUBMITTING TO THE CIVIL ENGINEER AND TO CITY A CERTIFIED RECORD SURVEY SIGNED AND SEALED BY A PROFESSIONAL LAND SURVEYOR REGISTERED IN THE STATE OF MISSOURI DEPICTING THE ACTUAL FILED LOCATION OF ALL CONSTRUCTED IMPROVEMENTS THAT ARE REQUIRED BY THE JURISDICTIONAL AGENCIES FOR THE CERTIFICATION PROCESS. ALL SURVEY COSTS WILL BE THE CONTRACTORS RESPONSIBILITY
- 11. ALL NECESSARY INSPECTIONS AND/OR CERTIFICATIONS REQUIRED BY CODES, JURISDICTIONAL AGENCIES AND/OR UTILITY SERVICE COMPANIES SHALL BE PERFORMED PRIOR TO ANNOUNCED BUILDING POSSESSION AND THE FINAL CONNECTION OF SERVICES.
- 12. CONTRACTORS SHALL VERIFY BENCHMARKS AND DATUMS PRIOR TO COMMENCING CONSTRUCTION OR STAKING OF IMPROVEMENTS
- 13. CONTRACTOR SHALL THOROUGHLY CHECK COORDINATION OF CIVIL, LANDSCAPE, MEP, ARCHITECTURAL, AND OTHER PLANS PRIOR TO COMMENCING CONSTRUCTION. OWNER AND CIVIL ENGINEER SHALL BE NOTIFIED OF ANY DISCREPANCY PRIOR TO COMMENCING WITH CONSTRUCTION
- 14. CONTRACTOR SHALL REFER TO THE ARCHITECTURAL PLANS FOR EXACT LOCATIONS AND DIMENSIONS OF VESTIBULES, SLOPE PAVING, SIDEWALKS, EXIT PORCHES, TRUCK DOCKS, PRECISE BUILDING DIMENSIONS, AND EXACT BUILDING UTILITY ENTRANCE LOCATIONS
- 15. ALL DIMENSIONS GIVEN ARE TO FACE OF CURB AND/OR BUILDING. DIMENSIONS FOR PIPES AND STRUCTURES ARE TO THE CENTERLINE, UNLESS OTHERWISE NOTED ON PLANS.
- 16. THE CONTRACTOR IS RESPONSIBLE FOR COORDINATING RELOCATIONS AND INSTALLATIONS OF FRANCHISE UTILITIES NECESSARY FOR ON- AND OFF-SITE CONSTRUCTION.
- 17. ON-SITE AND PERIMETER TRUCK ROUTE AND OTHER DIRECTIONAL SIGNAGE SHALL BE LOCATED OUT OF THE PEDESTRIAN, AUTOMOBILE, AND TRUCK ROUTES AND SHALL BE LOCATED BETWEEN THREE TO FIVE FEET BEHIND THE NEAREST BACK OF CURB UNLESS INDICATED OTHERWISE ON PLANS. SIGN HEIGHT, LOCATION, AND STRUCTURE SHALL BE SUCH THAT THE SIGNS POSE NO THREAT
- 18. ON-SITE AND PERIMETER TRUCK ROUTE AND OTHER DIRECTIONAL SIGNS SHALL BE ORIENTED SO THEY ARE READILY VISIBLE TO THE ONCOMING TRAFFIC FOR WHICH THEY ARE INTENDED. FIELD ADJUSTMENTS OF LOCATION AND ORIENTATION OF THE SIGNS ARE TO BE MADE TO ACCOMPLISH THIS.
- 19. CONTRACTOR SHALL REPLACE ANY FENCING, CURBING, ETC. THAT IS DESTROYED OR DAMAGED DUE TO THE CONSTRUCTION ACTIVITIES.
- 20. CONTRACTOR IS RESPONSIBLE FOR TRAFFIC CONTROL DEVICES AND PLANS FOR ANY STREET WORK
- 21. ALL CONTRACTORS MUST CONFINE THEIR ACTIVITIES TO THE WORK AREA. NO ENCROACHMENTS ONTO DEVELOPED OR UNDEVELOPED AREAS WILL BE ALLOWED. ANY DAMAGE RESULTING THEREFROM SHALL BE CONTRACTOR'S RESPONSIBILITY TO REPAIR.
- 22. THE CONTRACTOR SHALL BE RESPONSIBLE FOR SUBMITTING A TRENCH SAFETY PLAN TO THE DEVELOPER AT THE TIME OF THE PRE-CONSTRUCTION MEETING, OR PRIOR TO BEGINNING CONSTRUCTION OF THESE IMPROVEMENTS. CONTRACTOR SHALL BE RESPONSIBLE FOR MAINTAINING TRENCH SAFETY REQUIREMENTS IN ACCORDANCE WITH MISSOURI STATE LAW AND O.S.H.A. STANDARDS FOR ALL EXCAVATION IN EXCESS OF FIVE FEET IN DEPTH. NO OPEN TRENCHES WILL BE ALLOWED OVERNIGHT. ONSITE SAFETY IS THE SOLE RESPONSIBILITY OF THE CONTRACTOR.
- 23. LIGHT POLES AND SIGNS SHALL NOT BE PLACED IN ADA ACCESSIBLE ROUTES, ACCESSIBLE ACCESS AISLES, AND/OR REINFORCED ZONES BEHIND RETAINING WALLS.
- 24. TO THE MAXIMUM EXTENT PRACTICAL, CONSTRUCTION STAGING, WORKER PARKING, AND ANY OTHER POTENTIALLY NOISY OR OFFENSIVE CONSTRUCTION ACTIVITY SHOULD BE LOCATED AS FAR FROM THE RESIDENTIAL NEIGHBORS AS POSSIBLE
- 25. CONTRACTOR SHALL KEEP THE CONSTRUCTION SITE SECURE FROM TRESPASSERS AT ALL TIMES.
- 26. CONTRACTOR SHALL CONTACT CITY BUILDING OFFICIAL TO LEARN OF ANY UNUSUAL CONSTRUCTION SEQUENCING REQUIREMENTS THAT THE CITY MAY REQUIRE. THE CONTRACTOR IS CAUTIONED THAT THIS AND PERHAPS OTHER SUCH REQUIREMENTS MAY EXIST AND IT IS THE CONTRACTOR'S RESPONSIBILITY TO INVESTIGATE AND COMPLY WITH THEM.
- 27. CONTRACTOR IS RESPONSIBLE FOR OBTAINING ANY NECESSARY FENCE OR WALL PERMITS FROM THE CITY.
- 28. CONTRACTOR IS RESPONSIBLE FOR PROVIDING ADEQUATE TRAFFIC CONTROL PER CITY OF LEE'S SUMMIT STANDARDS.

UTILITY PLAN NOTES

- 1. ALL FILL MATERIAL SHALL BE IN PLACE AND COMPACTED BEFORE INSTALLATION OF PROPOSED UTILITIES.
- 2. CONTRACTOR SHALL NOTIFY THE UTILITY AUTHORITIES INSPECTORS 72 HOURS BEFORE CONNECTING TO ANY EXISTING LINE
- 3. CONTRACTOR SHALL MAINTAIN A MINIMUM OF 3'-6' COVER ON ALL WATERLINES AND 3'-6' ON ALL SANITARY SEWER LINES.
- 4. CONNECTION FROM THE METER TO SITE UTILITY LINES SHALL BE MADE BY BUILDING CONTRACTOR.
- 5. EXISTING UTILITIES SHALL BE VERIFIED IN FIELD PRIOR TO INSTALLATION OF ANY NEW LINES.
- REFER TO MECHANICAL, ELECTRIC AND PLUMBING DRAWINGS FOR ACTUAL TIE-IN LOCATIONS FOR UTILITIES.
- THE CONTRACTOR IS SPECIFICALLY CAUTIONED THAT THE LOCATION AND/OR ELEVATION OF EXISTING UTILITIES AS SHOWN ON THESE PLANS IS BASED ON RECORDS OF THE VARIOUS UTILITY COMPANIES, AND WHERE POSSIBLE, MEASUREMENTS TAKEN IN THE FIELD. THE INFORMATION IS NOT TO BE RELIED ON AS BEING EXACT OR COMPLETE. THE CONTRACTOR MUST CALL THE APPROPRIATE UTILITY COMPANIES AT LEAST 72 HOURS BEFORE ANY EXCAVATION TO REQUEST EXACT FIELD LOCATION OF UTILITIES. IT SHALL BE THE RESPONSIBILITY OF THE CONTRACTOR TO LOCATE ALL EXISTING UTILITIES WHICH CONFLICT WITH THE PROPOSED IMPROVEMENTS SHOWN ON THE PLANS.
- 8. ALL NECESSARY INSPECTIONS AND/OR CERTIFICATIONS REQUIRED BY CODES AND/OR UTILITY SERVICE COMPANIES SHALL BE PERFORMED PRIOR TO THE FINAL CONNECTION OF SERVICE.
- 9. ALL UTILITY SEWER TRENCH BACKFILL SHALL HAVE GRANULAR BACKFILL AND BE MECHANICALLY COMPACTED. 10. THE CONTRACTOR SHALL VERIFY THE LOCATION, CONDITION AND ELEVATION OF ALL PROPOSED SEWER CONNECTION POINTS PRIOR TO THE START OF CONSTRUCTION. ANY DISCREPANCIES THAT

WOULD INTERFERE WITH THE PROPOSED SEWER DESIGN SHALL IMMEDIATELY BE BROUGHT TO THE ATTENTION OF THE ENGINEER.

- 11. ALL PERMIT FEES AND COSTS ASSOCIATED WITH BRINGING UTILITY, SEWER AND WATER SERVICES TO THE BUILDING SHALL BE THE RESPONSIBILITY OF THE CONTRACTOR. ALL FEES AND COSTS SHALL BE
- 12. G.C. IS TO PROVIDE TRENCH, WIRE, AND CONDUIT FOR TELEPHONE AND ELECTRICAL SERVICES, BACKFILL AND GRADE SMOOTH FOR A COMPLETE TELEPHONE AND ELECTRIC INSTALLATION.
- 13. G.C. SHALL BE RESPONSIBLE FOR ANY TAPS TO BE MADE UNDER THE SUPERVISION OF THE CITY WATER DIVISION.
- ANY DISTURBED SIDEWALK SHALL BE FULL SLAB REPLACEMENT.
- 15. EXISTING SANITARY SEWER AND WATER SERVICE SHALL NOT BE INTERRUPTED.
- 16. THE CONTRACTOR SHALL INCLUDE THE COST ESTIMATE PROVIDED BY EVERGY IN HIS/HER BID FOR THE RELOCATION/REMOVAL OF ANY OVERHEAD ELECTRIC OR GUY WIRES. 17. THE REMOVAL AND REPLACEMENT, OR REHABILITATION OF THE EXISTING STRUCTURE(S) WILL BE DETERMINED BY THE CITY OF LEE'S SUMMIT DEVELOPMENT ENGINEER FIELD INSPECTOR. IF THE
- STRUCTURE IS DETERMINED TO REMAIN IN PLACE, THEN THE TOP SHALL BE ADJUSTED TO GRADE, IF NEEDED. 18. ALL STORM SEWER CONSTRUCTION AND MATERIALS SHALL BE IN ACCORDANCE WITH THE CITY OF LEE'S SUMMIT STANDARD SPECIFICATIONS AND CONSTRUCTION DETAILS.
- 19. ALL LATERAL SEWER CONSTRUCTION METHODS TO CONFORM TO LATEST STANDARDS AND SPECIFICATIONS FOR THE CITY OF LEE'S SUMMIT SEWER STANDARD SPECIFICATIONS AND CONSTRUCTION
- 20. ALL CONNECTIONS TO PUBLIC WATER SHALL BE AS REQUIRED BY THE CITY OF LEE'S SUMMIT WATER UTILITIES.
- 21. CONNECTION TO PUBLIC SEWER MAINS SHALL BE AS REQUIRED BY THE CITY OF LEE'S SUMMIT SEWER SANITARY. CONTRACTOR SHALL BE RESPONSIBLE FOR CONTACTING THE PROVIDER PRIOR TO
- 22. ALL TRENCHES UNDER AREAS TO BE PAVED AND UNDER EXISTING PAVING SHALL BE GRANULARLY FILLED WITH 3/4" MINUS CRUSHED LIMESTONE ONLY. BACKFILL SHALL BE PLACED IN ACCORDANCE WITH CITY OF LEE'S SUMMIT STANDARDS.
- 23. TYPE "C" BEDDING PER CITY OF LEE'S SUMMIT STANDARDS REQUIRED FOR PIPES IN ROCK.
- 24. ALL TRENCH BACKFILLS UNDER PAVEMENT WITHIN PUBLIC RIGHT-OF-WAY SHALL BE GRANULAR BACKFILLED. TRENCH BACKFILLS UNDER PAVED AREAS, OUTSIDE OF PUBLIC RIGHT-OF-WAY SHALL BE GRANULAR BACKFILL IN LIEU OF THE EARTH BACKFILL COMPACTED TO 90 PERCENT OF THE STANDARD AASHTO T-180 COMPACTION TEST A.S.T.M. D-1557.
- 25. ALL CONCRETE PIPE SHALL BE REINFORCED, AND CONFORM TO A.S.T.M. DESIGNATION C76-80 CLASS III UNLESS OTHERWISE NOTED
- 26. ALL DIMENSIONS ARE TO THE CENTERLINE OF STRUCTURE EXCEPT FOR END OF PIPES OR FLARED ENDS. FLARED END DIMENSIONS VARY. CONTRACTOR SHALL VERIFY LENGTHS FOR FLARED END SECTIONS PER PROPOSED TYPE OF FLARED END SUBMITTED. REFER TO THE CORRESPONDING SEWER PROFILE SHEET FOR EXACT DIMENSIONS IF APPLICABLE.
- 77. Plumbing Contractor and Surveyor shall confirm structures proposed on these plans match the proposed structures that are onsite, due to change of elevations, and LOCATIONS DEPENDING ON THE STRUCTURE AND TYPE. THE PLUMBING CONTRACTOR SHALL BE RESPONSIBLE FOR ANY ISSUES FOR PROPOSING A DIFFERENT TYPE OF STRUCTURE OR PIPE THAN WHAT IS ON THESE PLANS. GENERAL CONTRACTOR SHALL REIMBURSE CIVIL ENGINEER FOR ANY TIME AND MATERIALS TO ADDRESS CHANGES TO STRUCTURES OR DESIGN FROM WHAT HAS BEEN APPROVED TO REDUCE OVERALL CONSTRUCTION COSTS.
- 28. STANDARDS AND DETAILS FROMCITY OF LEE'S SUMMIT STANDARDS PLANS SHALL SUPERCEDE THESE REQUIREMENTS








engineering plans involved in this project and specifically excludes

PROFESSIONAL ENGINEER PE 2006007195

2109720 Drawn By A. JONES M. FOGARTY Checked Bv


ISSUED FOR CONSTRUCTION

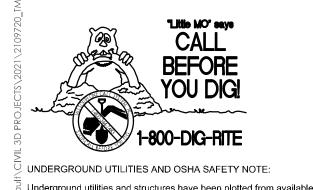

information and therefore, their location must be considered

approximate only. It is the responsibility of the individual contractors to notify the utility companies before actual construction. All O.S.H.A

rules and regulations established for the type of construction required by these plans shall be strictly followed (ie. trenching, blasting, etc.)

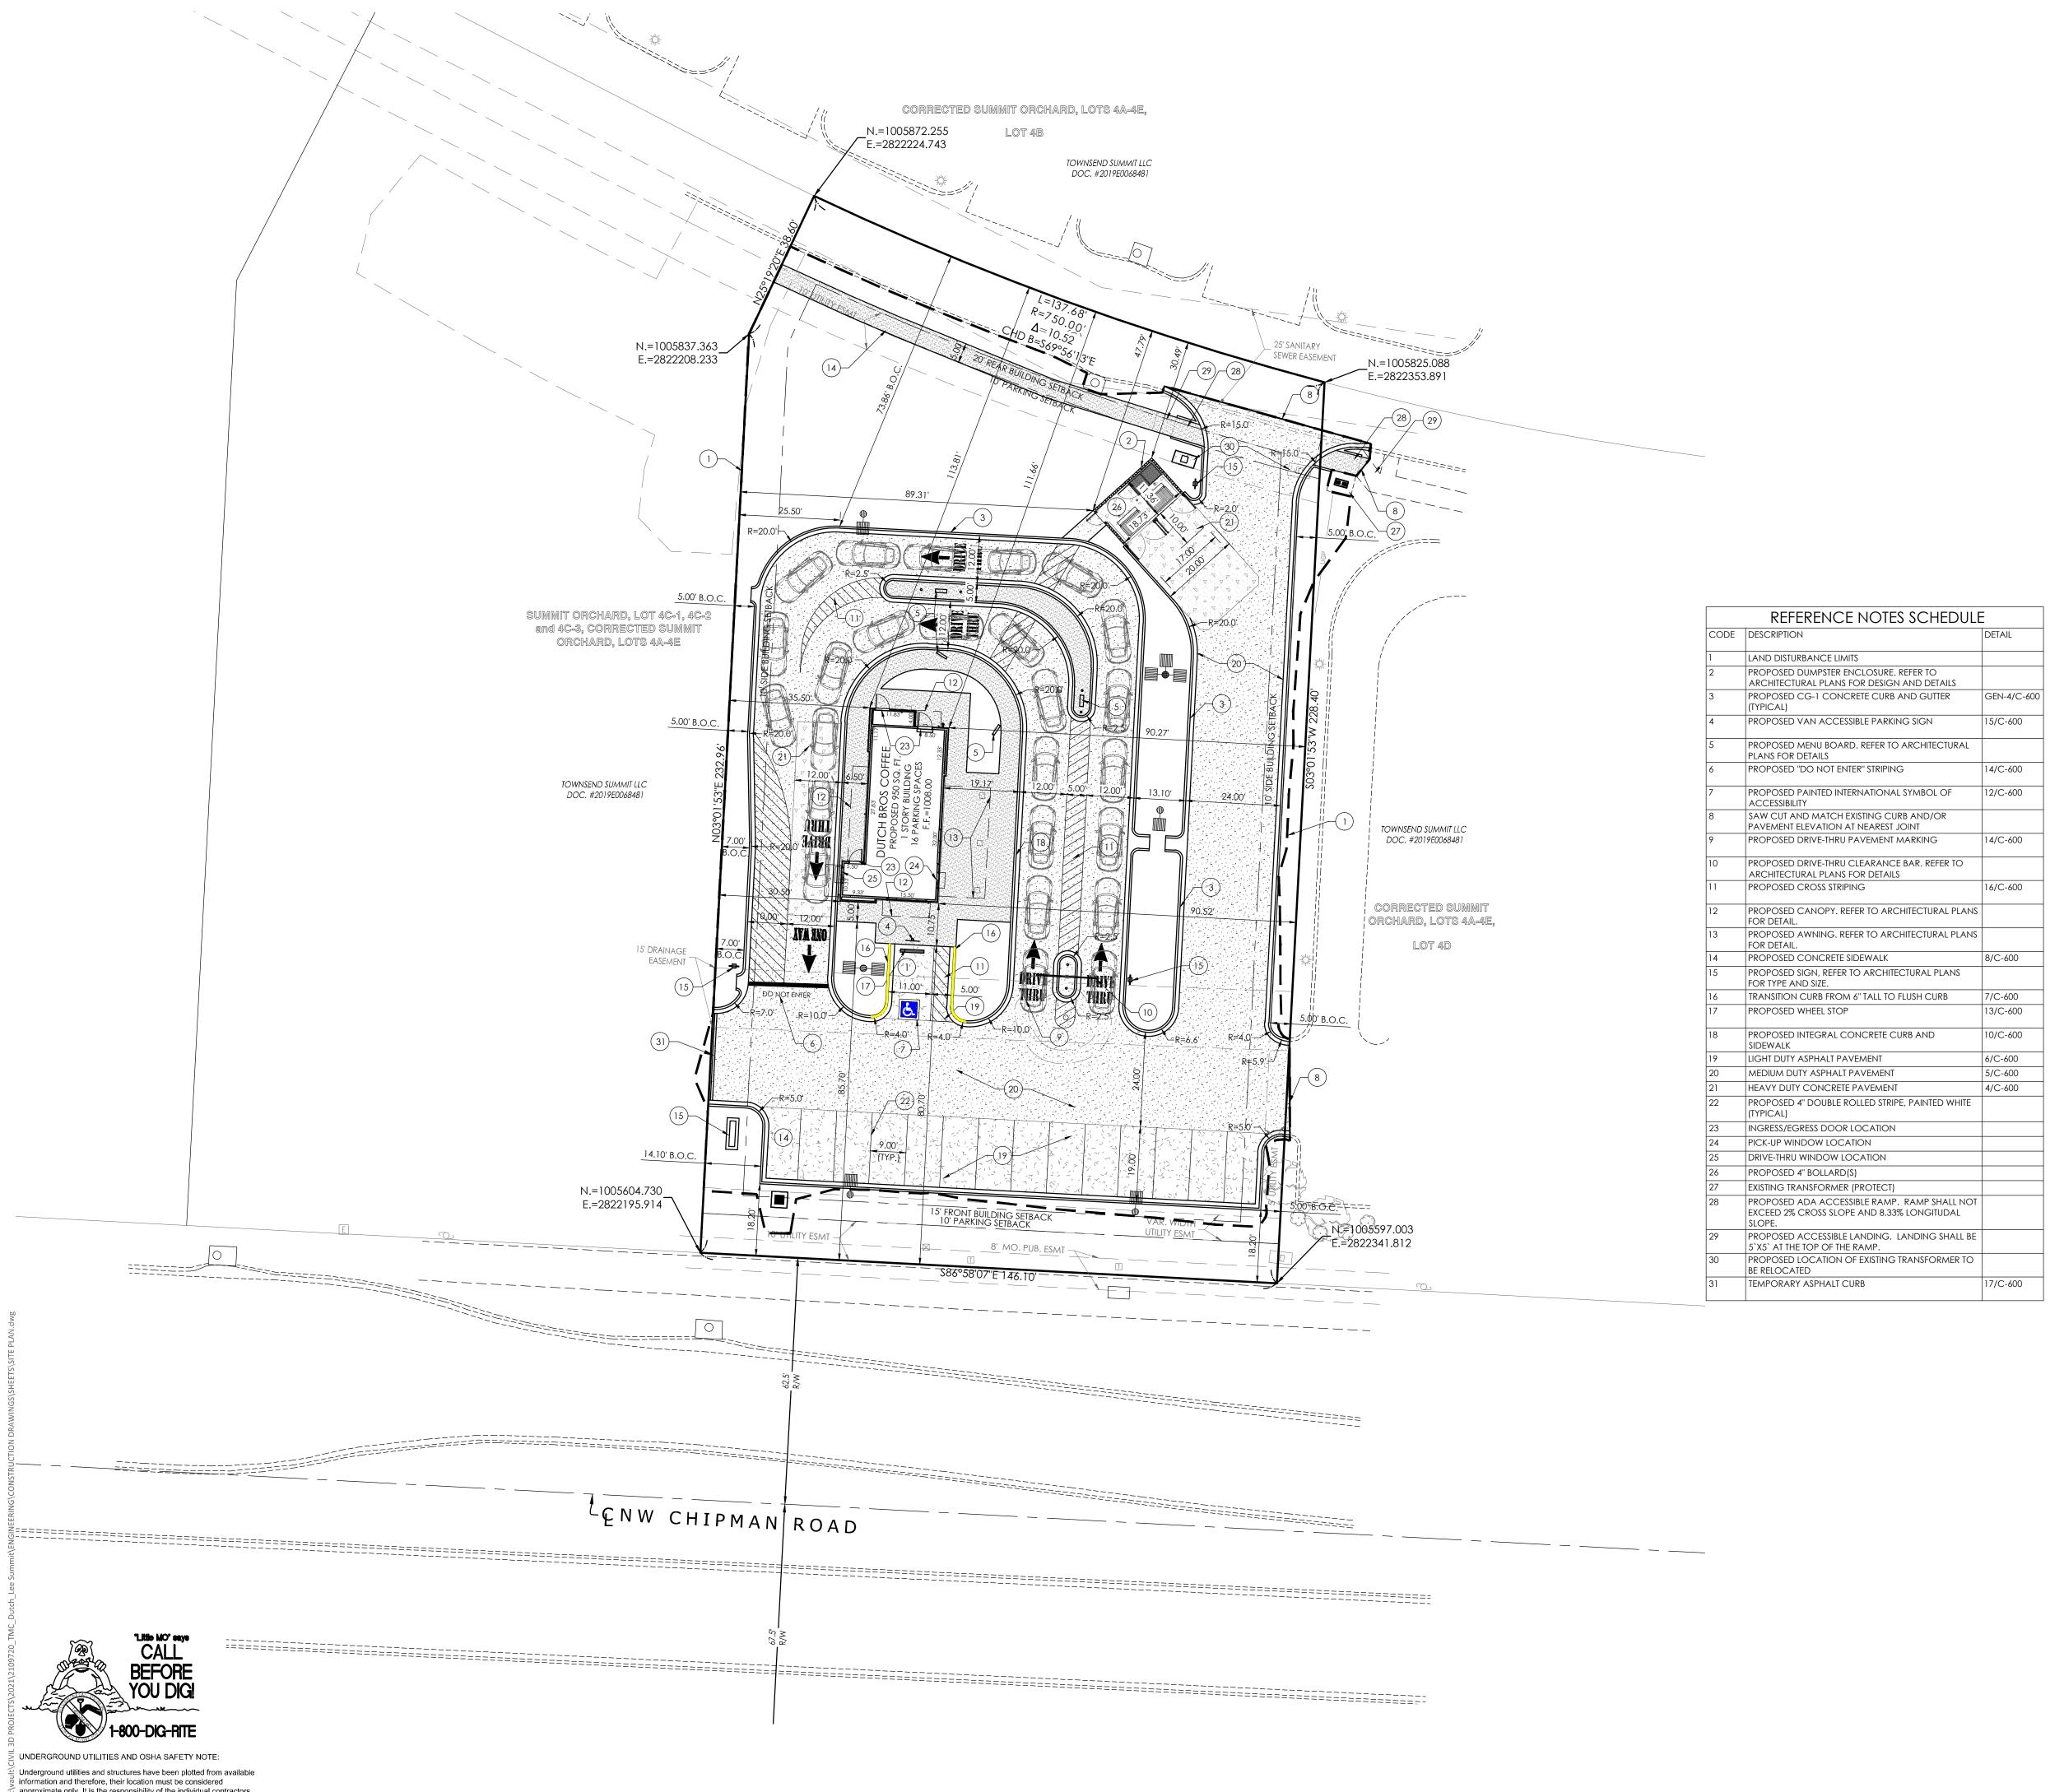



- 1. BASIS OF BEARINGS: THIS SURVEY WAS ADOPTED FROM THE MISSOURI STATE PLANE COORDINATE SYSTEM, NAD 1983 - WEST ZONE
- 2. CURRENT ZONING: PMIX PLANNED MIXED USE
- 3. SURROUNDING ZONING: PMIX PLANNED MIXED USE
- 4. SITE AREA = ±0.828 ACRES
- 5. PROPOSED USE COFFEE SHOP 6. PROPOSED BUILDING HEIGHT - REFER TO ARCHITECTURAL PLANS
- PARKING SETBACK:
- NONE PER RECORDED PLAT
- 8. BUILDING SETBACKS: FRONT BUILDING SETBACK: 15' ALONG NW CHIPMAN ROAD SIDE BUILDING SETBACK: NONE PER RECORDED PLAT REAR BUILDING SETBACK: NONE PER RECORDED PLAT
- 9. FLOOR AREA RATIO 950/36,068 = 0.026 FAR
- 10. IMPERVIOUS COVERAGE SITE = 67.75%
- 11. PARKING AND LOADING REQUIREMENTS
- REQUIRED PARKING: TWO PLUS 1 PER EMPLOYEE ON MAX. SHIFT 2 + 10 EMPLOYEES = 12 PARKING SPACE REQUIRED PROVIDED PARKING= 15 PARKING SPACES
- 12. PER FEMA FIRM PANEL #29095C0417G, EFFECTIVE ON 01/20/2017 THE PROPERTY IS ZONE X (UNSHADED), AREAS DETERMINED TO BE OUTSIDE
- THE 0.2% ANNUAL CHANCE FLOODPLAIN. 13. THIS PROPERTY IS LOCATED WITHIN THE LITTLE CEDAR CREEK WATERSHED.
- 14. OIL AND GAS WELL LOCATIONS: BASED ON MIODNR STATE OIL AND GAS COUNCIL, THERE ARE NO ACTIVE WELLS AS OF JUNE 2, 2020. ALL EXISTING OIL AND GAS WELLS FOR THIS SECTION-TOWNSHIP-RANGE HAVE BEEN ABANDONED OR PLUGGED.

PAVEMENT NOTES

PAVEMENT THICKNESS SHALL BE AS FOLLOWS: (UNLESS NOTED OTHERWISE ON PLAN)

"TYPE "2.01" ASPHALT BASE COURSE

6" MODOT TYPE 5 AGGREGATE WITH GEOGRID OR/ 6" MODOT TYPE 5 AGGREGATE WITH 6" CHEMICALLY STABILIZED BASE

5" TYPE "2.01" ASPHALT BASE COURSE 6" MODOT TYPE 5 AGGREGATE WITH GEOGRID OR/ 6" MODOT TYPE 5 AGGREGATE WITH 6" CHEMICALLY

HEAVY DUTY CONCRETE PAVEMENT (TRASH ENCLOSURE PAD & DRIVE-THRU PAD) 8" NON-REINFORCED PORTLAND CEMENT CONCRETE 4" MODOT TYPE 5 AGGREGATE BASE

CONSTRUCTION As Noted on Plans Review Development Services Department Lee's Summit, Missouri

SCALE IN FEET

STABILIZED BASE


CONCRETE SIDEWALKS

4" PORTLAND CEMENT CONCRETE
4" MODOT TYPE 5 AGGREGATE BASE





ENGINEERS AUTHENTICATION and date hereunder attached. Responsibility is disclaimed for all other engineering plans involved in this project and specifically excludes PROFESSIONAL ENGINEER PE 2006007195

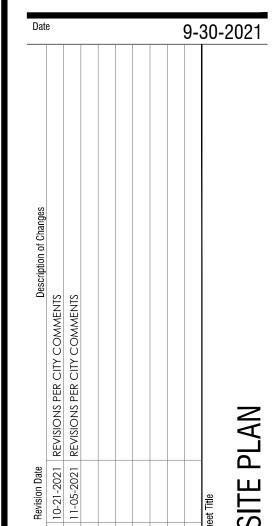



2109720 A. JONES Drawn By M. FOGARTY Checked By

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UNDERGROUND UTILITIES AND OSHA SAFETY NOTE: Underground utilities and structures have been plotted from available information and therefore, their location must be considered approximate only. It is the responsibility of the individual contractors to notify the utility companies before actual construction. All O.S.H.A rules and regulations established for the type of construction required

by these plans shall be strictly followed (ie. trenching, blasting, etc.)



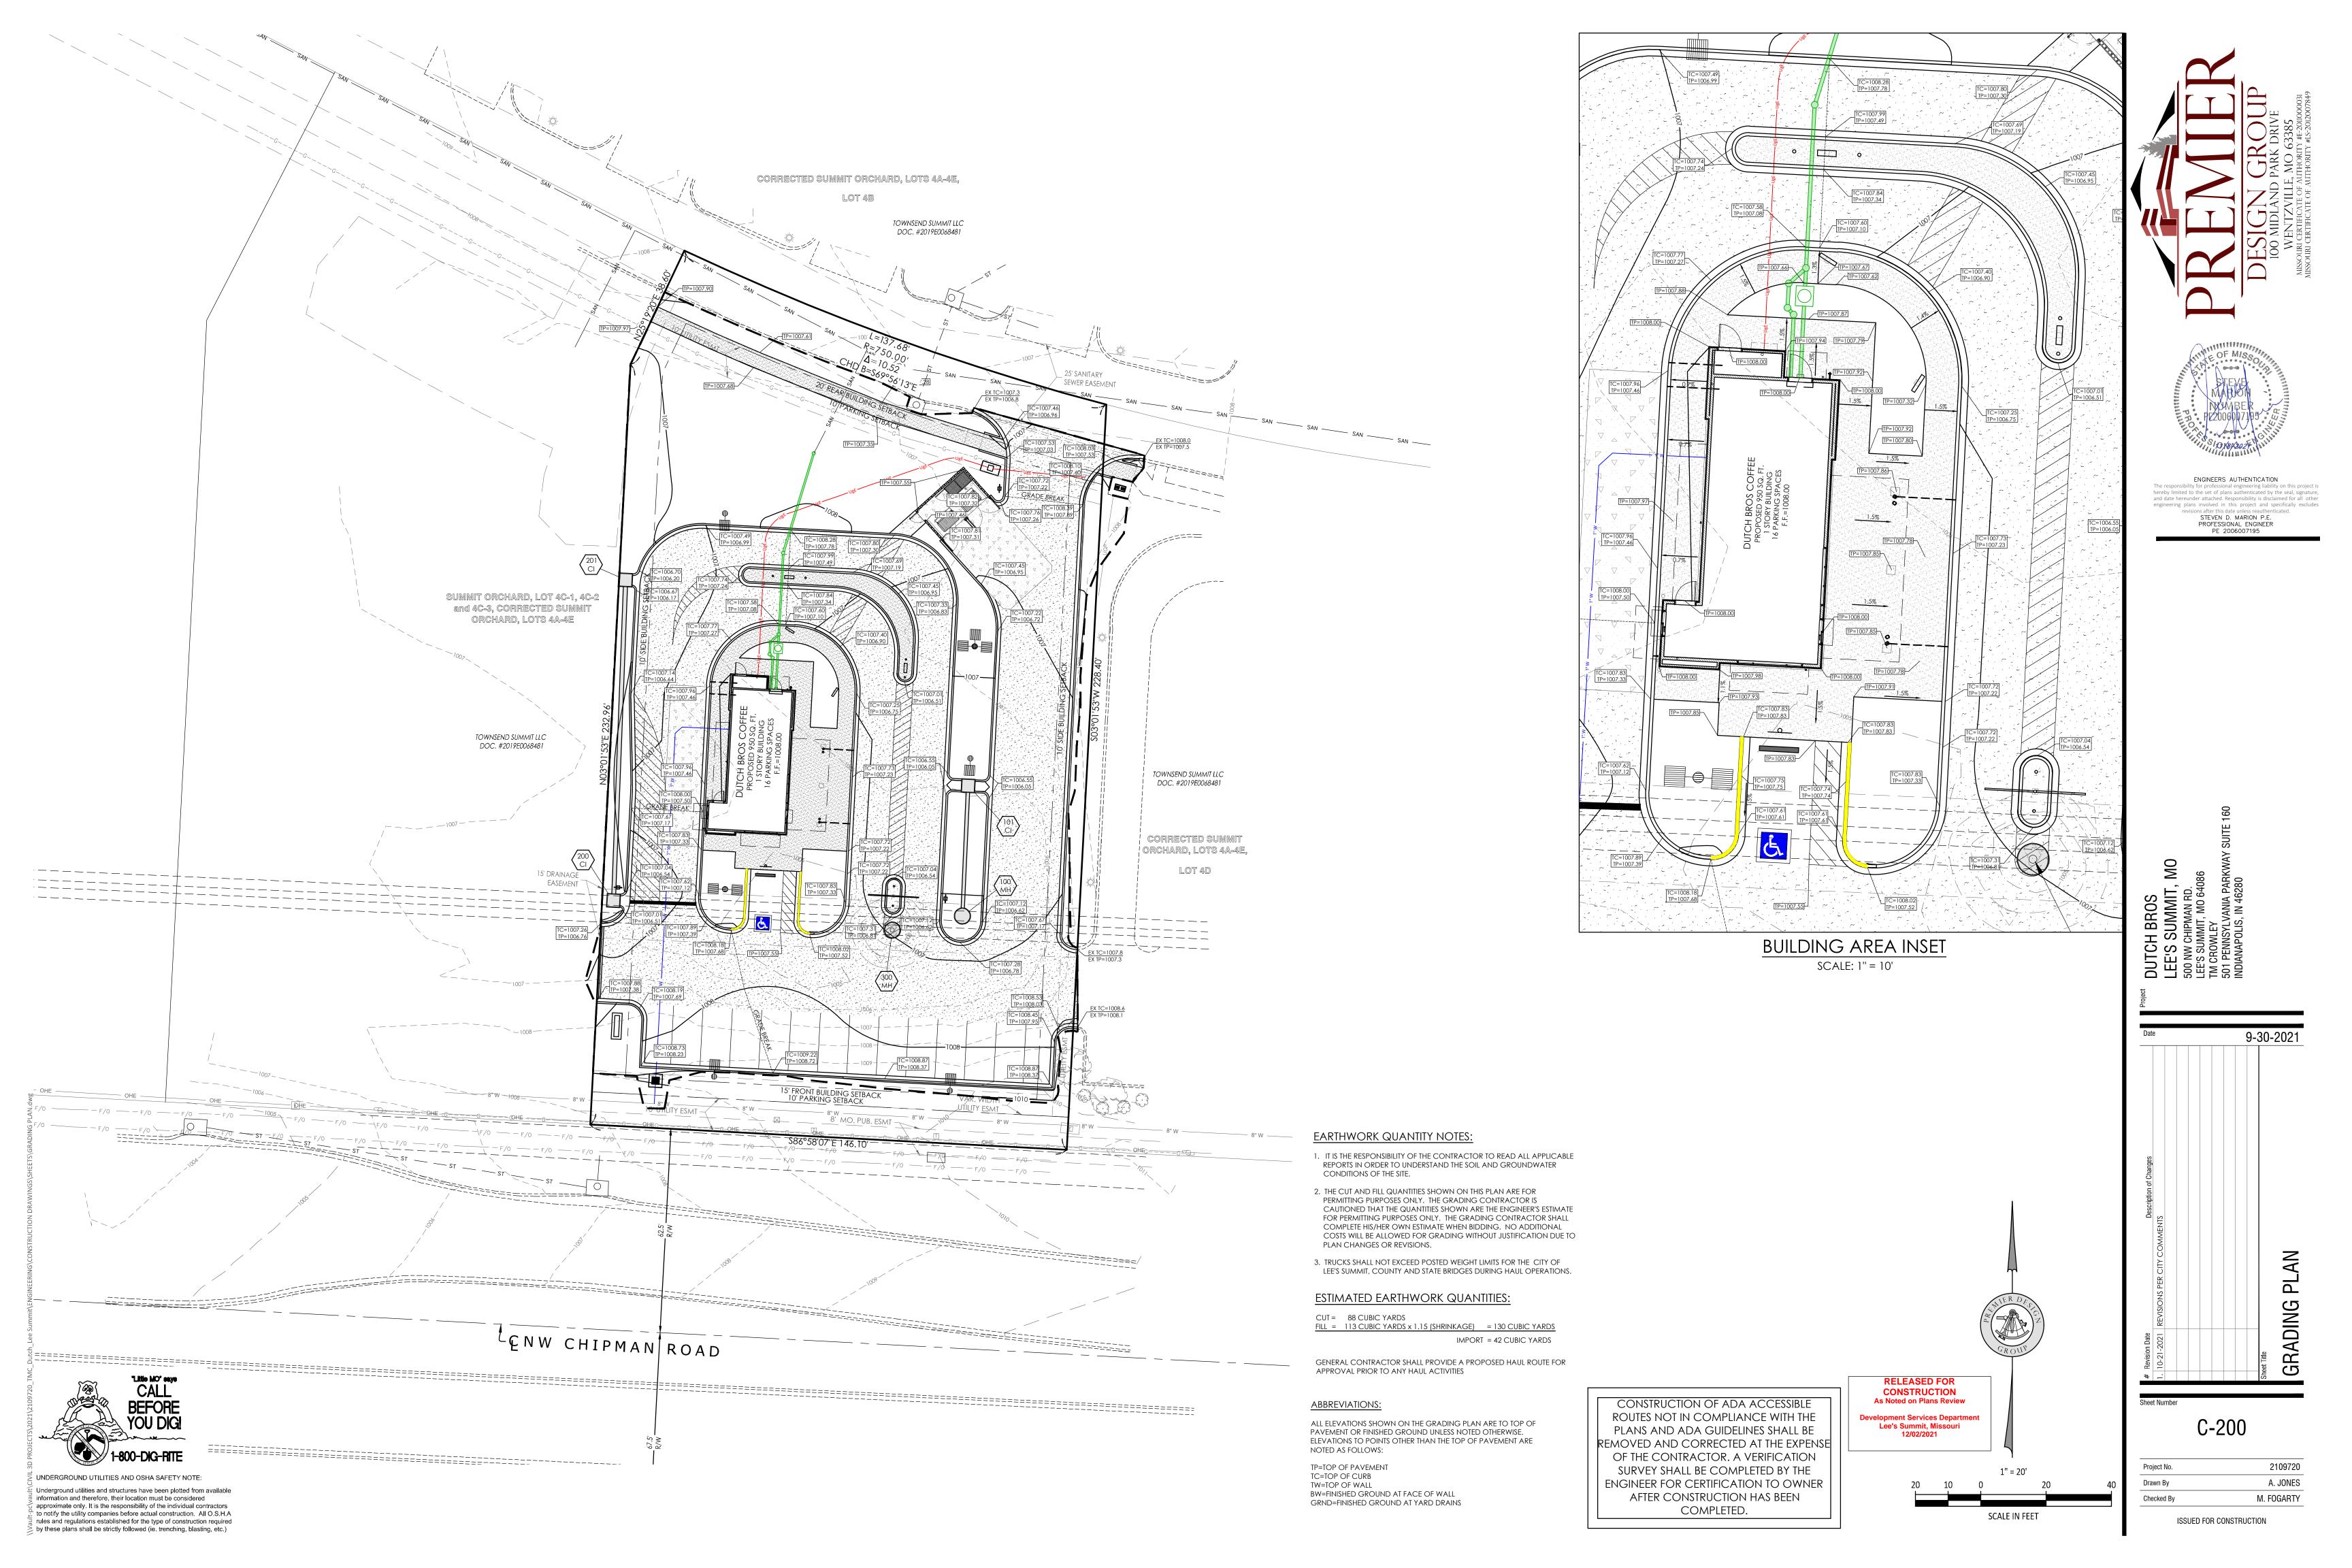

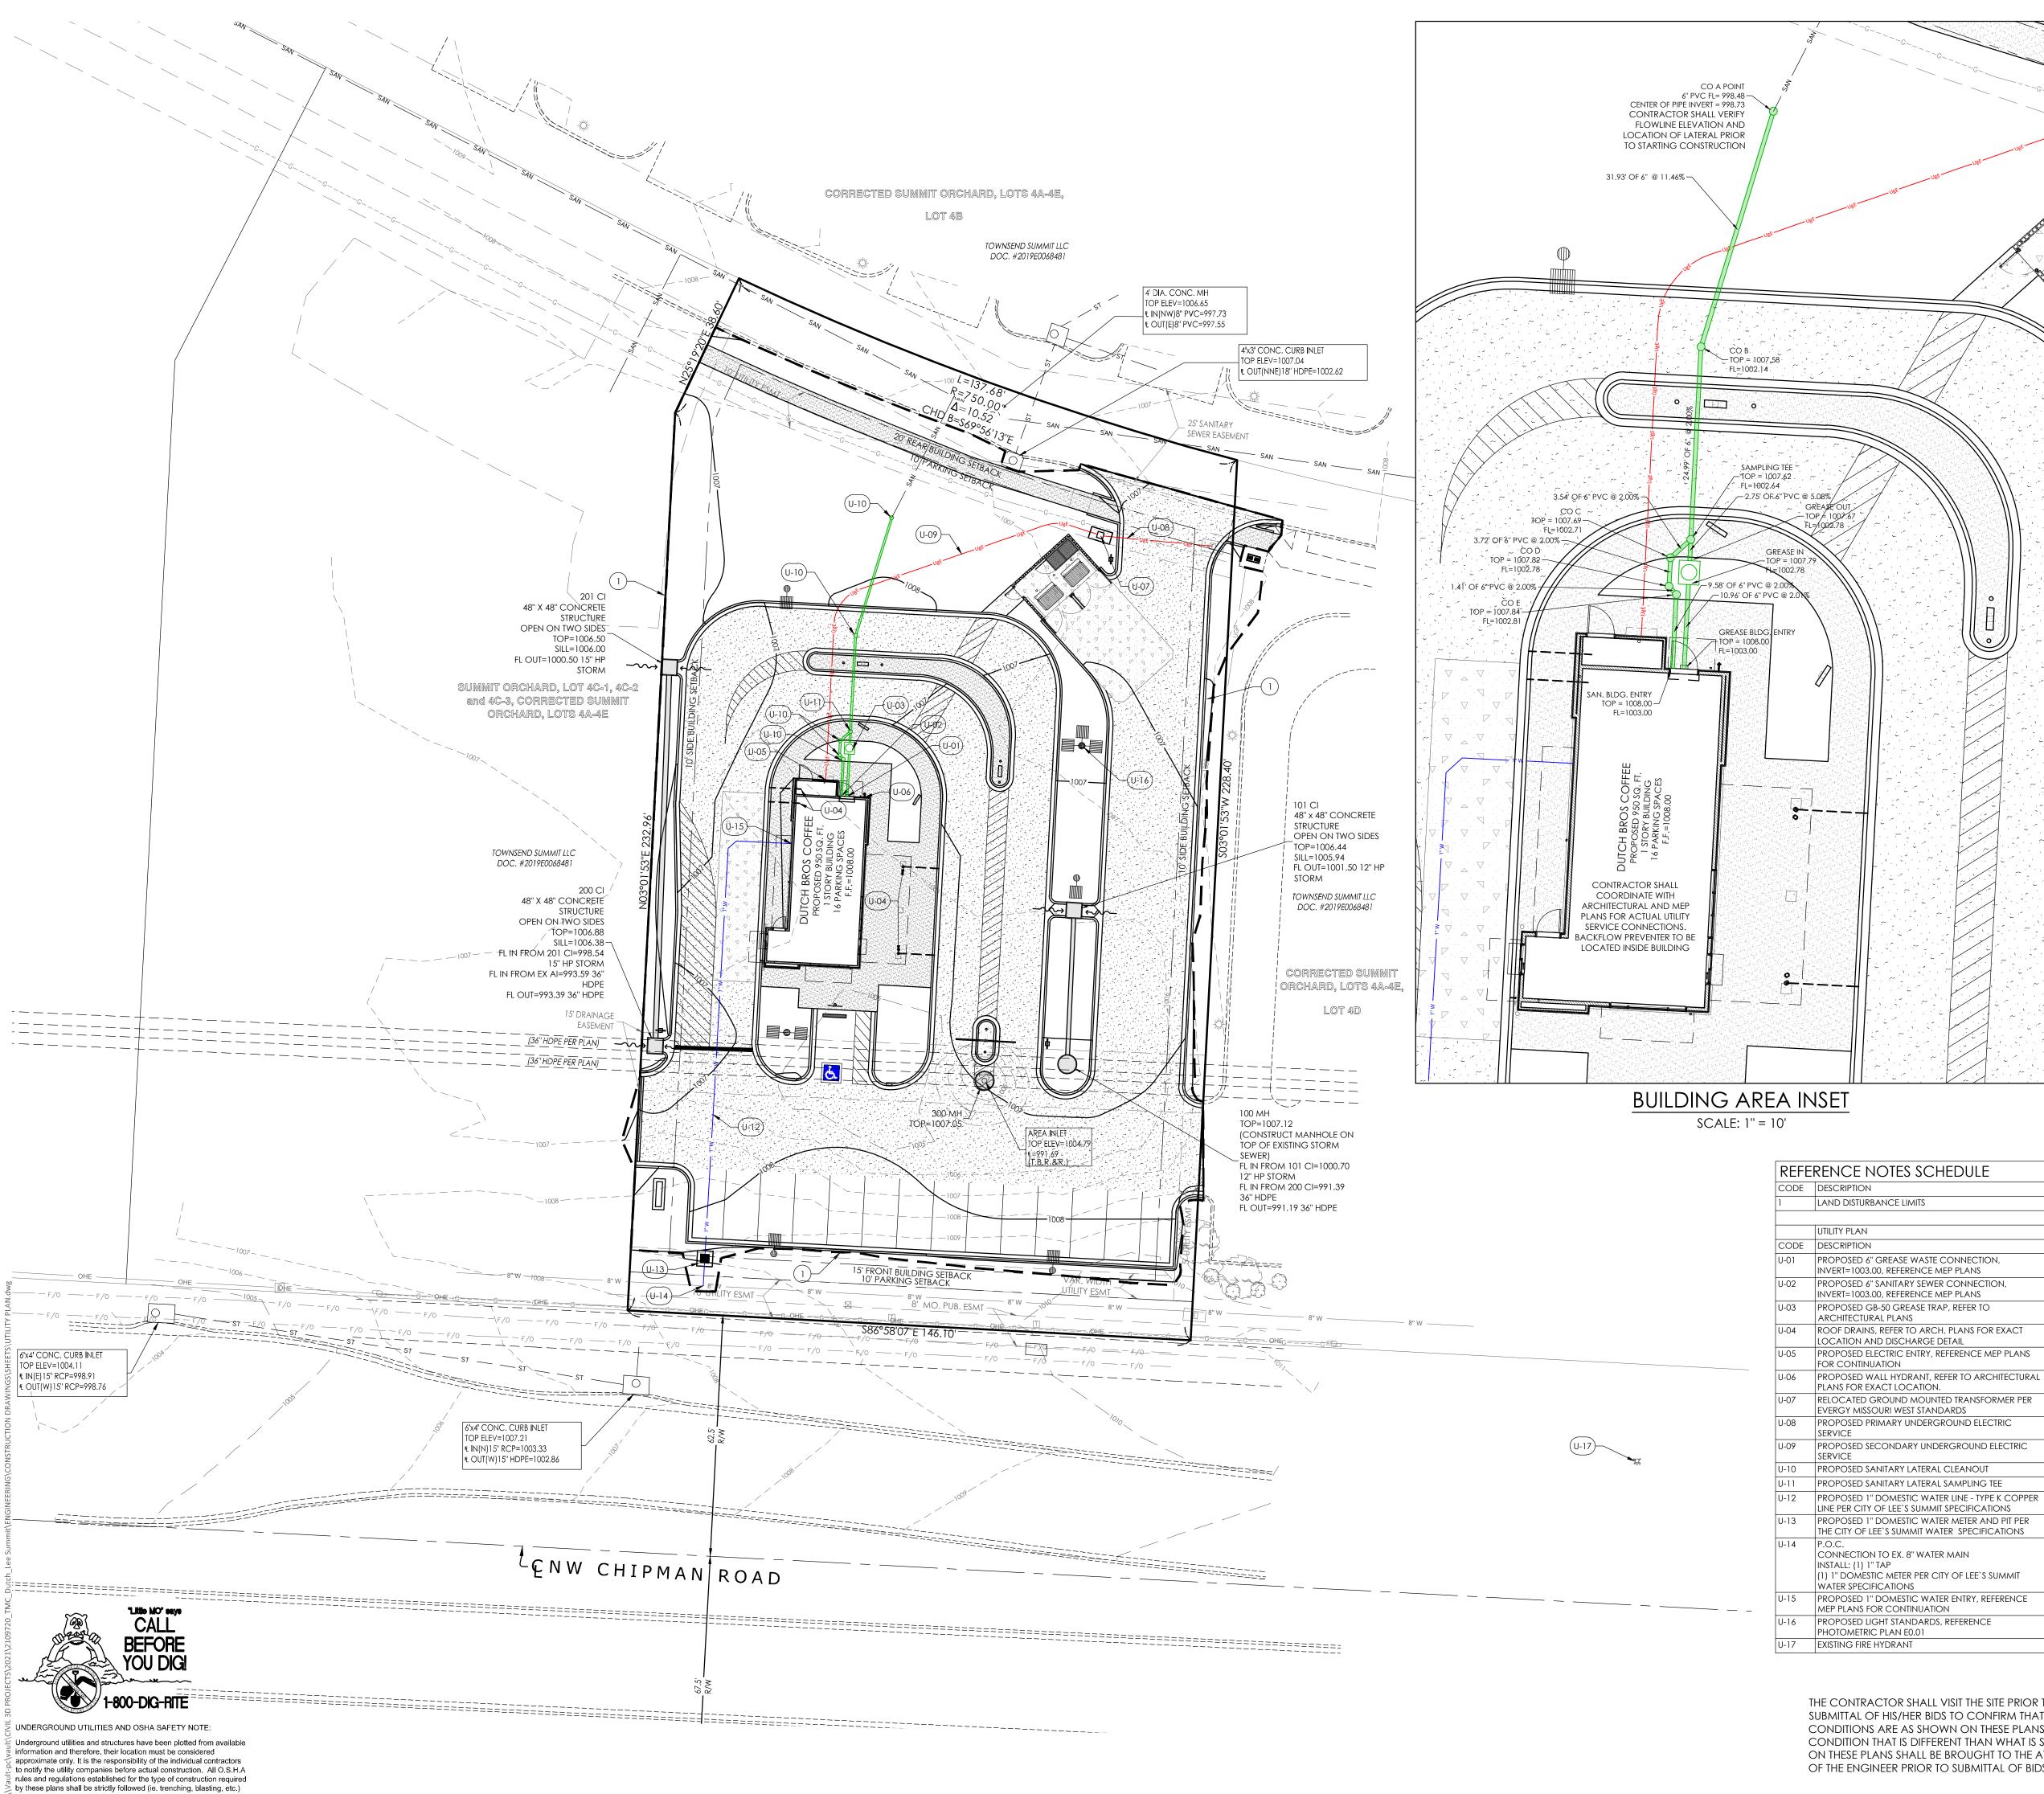UTILITY PLAN NOTES:

- ALL FILL MATERIAL IS TO BE IN PLACE AND COMPACTED BEFORE INSTALLATION OF
- CONTRACTOR SHALL NOTIFY THE UTILITY AUTHORITIES INSPECTORS 72 HOURS BEFORE

CONNECTING TO ANY EXISTING LINE.

BACKFILL, ETC. REQUIRED BY TELEPHONE COMPANY.


- 3. CONTRACTOR SHALL MAINTAIN A MINIMUM OF 3'-6' COVER ON ALL WATERLINES AND 3'-6' ON ALL SANITARY SEWER LINES.
- CONTRACTOR SHALL COORDINATE WITH BUILDING ARCHITECT AND TELEPHONE COMPANY FOR EXACT LOCATIONS OF TELEPHONE ENTRY TO THE BUILDING. CONTRACTOR SHALL BE RESPONSIBLE FOR ANY CONDUITS, PULL WIRES, TRENCHING,
- 5. CONNECTION FROM THE METER TO SITE UTILITY LINES SHALL BE MADE BY BUILDING CONTRACTOR.
- EXISTING UTILITIES SHALL BE VERIFIED IN FIELD PRIOR TO INSTALLATION OF ANY NEW
- REFER TO INTERIOR MECHANICAL, ELECTRIC AND PLUMBING DRAWINGS FOR TIE-IN OF ALL UTILITIES.
- THE CONTRACTOR IS SPECIFICALLY CAUTIONED THAT THE LOCATION AND/OR ELEVATION OF EXISTING UTILITIES AS SHOWN ON THESE PLANS IS BASED ON RECORDS OF THE VARIOUS UTILITY COMPANIES, AND WHERE POSSIBLE, MEASUREMENTS TAKEN IN THE FIELD. THE INFORMATION IS NOT TO BE RELIED ON AS BEING EXACT OR COMPLETE. THE CONTRACTOR MUST CALL THE APPROPRIATE UTILITY COMPANIES AT LEAST 72 HOURS BEFORE ANY EXCAVATION TO REQUEST EXACT FIELD LOCATION OF UTILITIES. IT SHALL BE THE RESPONSIBILITY OF THE CONTRACTOR TO LOCATE ALL EXISTING UTILITIES WHICH
- ALL NECESSARY INSPECTIONS AND/OR CERTIFICATIONS REQUIRED BY CODES AND/OR UTILITY SERVICE COMPANIES SHALL BE PERFORMED PRIOR TO ANNOUNCED BUILDING POSSESSION AND THE FINAL CONNECTION OF SERVICE.

CONFLICT WITH THE PROPOSED IMPROVEMENTS SHOWN ON THE PLANS.

- 10. CONTRACTOR SHALL COORDINATE WITH BUILDING ARCHITECT AND SPIRE FOR EXACT LOCATION OF GAS ENTRY. G.C. TO INCLUDE IN BID FOR CONTRACTOR ANY GAS PIPING, CONDUITS, TRENCHING, BACKFILLING, ETC. REQUIRED BY SPIRE.
- 11. CONTRACTOR SHALL COORDINATE WITH BUILDING ARCHITECT AND EVERGY FOR EXACT LOCATION OF ELECTRIC ENTRY. CONTRACTOR SHALL BE RESPONSIBLE FOR ANY CONDUITS, TRENCHING, BACKFILLING, CABLES, ETC. REQUIRED BY ELECTRIC COMPANY.
- 12. REFER TO MEP PLANS FOR GAS SERVICE SIZING.
- 13. ALL UTILITY SEWER TRENCH BACKFILL SHALL HAVE GRANULAR BACKFILL AND BE MECHANICALLY COMPACTED.
- 14. THE CONTRACTOR SHALL VERIFY THE LOCATION, CONDITION AND ELEVATION OF ALL PROPOSED SEWER CONNECTION POINTS PRIOR TO THE START OF CONSTRUCTION. ANY DISCREPANCIES THAT WOULD INTERFERE WITH THE PROPOSED SEWER DESIGN SHALL IMMEDIATELY BE BROUGHT TO THE ATTENTION OF THE ENGINEER.
- 15. ALL PERMIT FEES AND COSTS ASSOCIATED WITH BRINGING UTILITY, SEWER AND WATER SERVICES TO THE BUILDING SHALL BE THE RESPONSIBILITY OF THE CONTRACTOR. ALL FEES AND COSTS SHALL BE INCLUDED IN THE CONTRACTORS BID.
- 16. ALL CONSTRUCTION MATERIALS USED SHALL CONFORM TO THE CURRENT VERSION OF THE CITY OF LEE'S SUMMIT AND STATE OF MISSOURI SPECIFICATIONS.
- 17. G.C. IS TO PROVIDE TRENCH PULL WIRE AND CONDUIT FOR TELEPHONE AND ELECTRICAL SERVICES, BACKFILL AND GRADE SMOOTH FOR A COMPLETE TELEPHONE AND ELECTRIC INSTALLATION SHALL BE BY THE GENERAL CONTRACTOR.
- 18. GENERAL CONTRACTOR IS TO PROVIDE TRENCH, BACKFILL AND GRADE SMOOTH FOR A COMPLETE WATER LINE INSTALLATION.
- 19. ANY DISTURBED SIDEWALK OR CONCRETE PAVEMENT SHALL BE FULL SLAB
- 20. EXISTING SANITARY SEWER SERVICE SHALL NOT BE INTERRUPTED.
- 21. ALL WATER LINES GREATER THAN 3" SHALL BE C-900 PVC PIPE. WATER LINES SMALLER THAN 3" SHALL BE TYPE "K" COPPER.
- 22. ALL CONNECTIONS TO PUBLIC WATER SHALL BE AS REQUIRED BY CITY OF LEE'S SUMMIT WATER CODES. WATER TAP AND METERS UNDER 2" SHALL BE INSTALLED BY CITY OF LEE'S SUMMIT WATER UP TO THE RIGHT-OF-WAY LINES. WATER TAP AND METERS OVER 2" SHALL BE INSTALLED BY THE CONTRACTOR. CONTRACTOR SHALL BE RESPONSIBLE FOR
- CONTACTING CITY OF LEE'S SUMMIT TO SCHEDULE CONNECTION TO PUBLIC WATER. 23. SANITARY LINES SHALL BE PVC MEETING ASTM D-3034 SDR 26 EXCEPT FOR PIPES THAT CROSS ABOVE WATER MAINS, THIS PIPE SHALL BE AWA C900 UNLESS WATER MAIN IS


CASED. CONTRACTOR SHALL BE RESPONSIBLE FOR CONTACTING CITY OF LEE'S SUMMIT

- 24. CONTRACTOR SHALL COORDINATE WITH ADJACENT PROPERTY OWNERS FOR ANY DISRUPTIONS TO EXISTING UTILITY SERVICES.
- 25. CONTRACTOR IS RESPONSIBLE FOR PAVEMENT REPAIR AND REPLACEMENT REQUIRED FOR ALL UTILITY CONNECTIONS AND INSTALLATIONS.
- 26. THE OWNER/DEVELOPER WILL BE RESPONSIBLE FOR ANY AND ALL APPLICABLE TAP AND SERVICE FEES AS LISTED IN THE MOST CURRENT EDITION OF CITY OF LEE'S SUMMIT RULES AND REGULATIONS FOR CUSTOMER
- COORDINATION WITH THE ELECTRIC, TELEPHONE AND CATV COMPANIES SHALL BE THE RESPONSIBILITY OF THE ELECTRICAL CONTRACTOR AND SHALL BE CONDUCTED IN A MANNER THAT RESULTS IN AN EFFICIENT AND TIMELY
- RELOCATION AND REMOVAL OF THE EXISTING FACILITIES. 28. GROUND ELEVATIONS SHALL BE WITHIN 6" OF THE FINAL PROPOSED ELEVATIONS PRIOR THE START OF ELECTRIC, TELEPHONE AND CATV RELOCATIONS OR INSTALLATIONS OF
- 29. CONTRACTOR SHALL REFERENCE ELECTRICAL PLANS FOR FURTHER INFORMATION AND FOR CONDUIT ROUTING TO LIGHT STANDARDS AND ANY GROUND MOUNTED SIGNS.
- 30. ALL UTILITY IMPROVEMENTS (SERVICES, EXTENSIONS, CONNECTIONS, ETC.) TO BE
- BUILDING SEWER STUBS BEING DISCONNECTED FROM THE SEWER MAIN SHALL BE DISCONNECTED BY THE WATER UTILITIES DEPARTMENT, AFTER THE CONTRACTOR HAS PROVIDED ACCESS TO THE SEWER MAIN VIA AN OSHA COMPLIANT EXCAVATION WITH PROPER SHORING AS NECESSARY. WATER UTILITIES STAFF RESERVE THE RIGHT TO NOT ENTER ANY TRENCH DETERMINED TO BE UNSAFE.

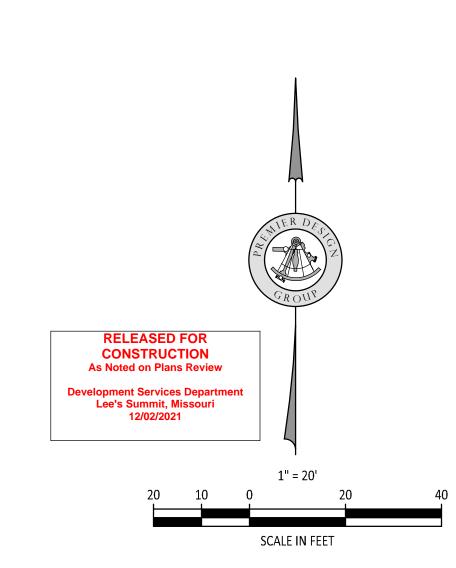



ENGINEERS AUTHENTICATION engineering plans involved in this project and specifically excludes PROFESSIONAL ENGINEER PE 2006007195

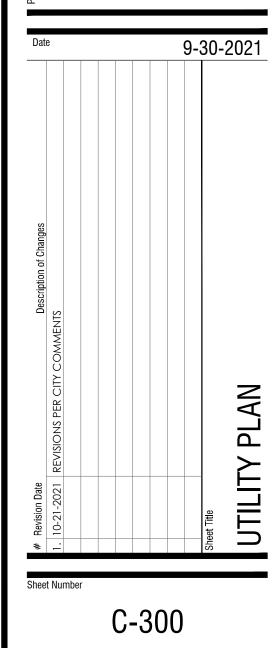

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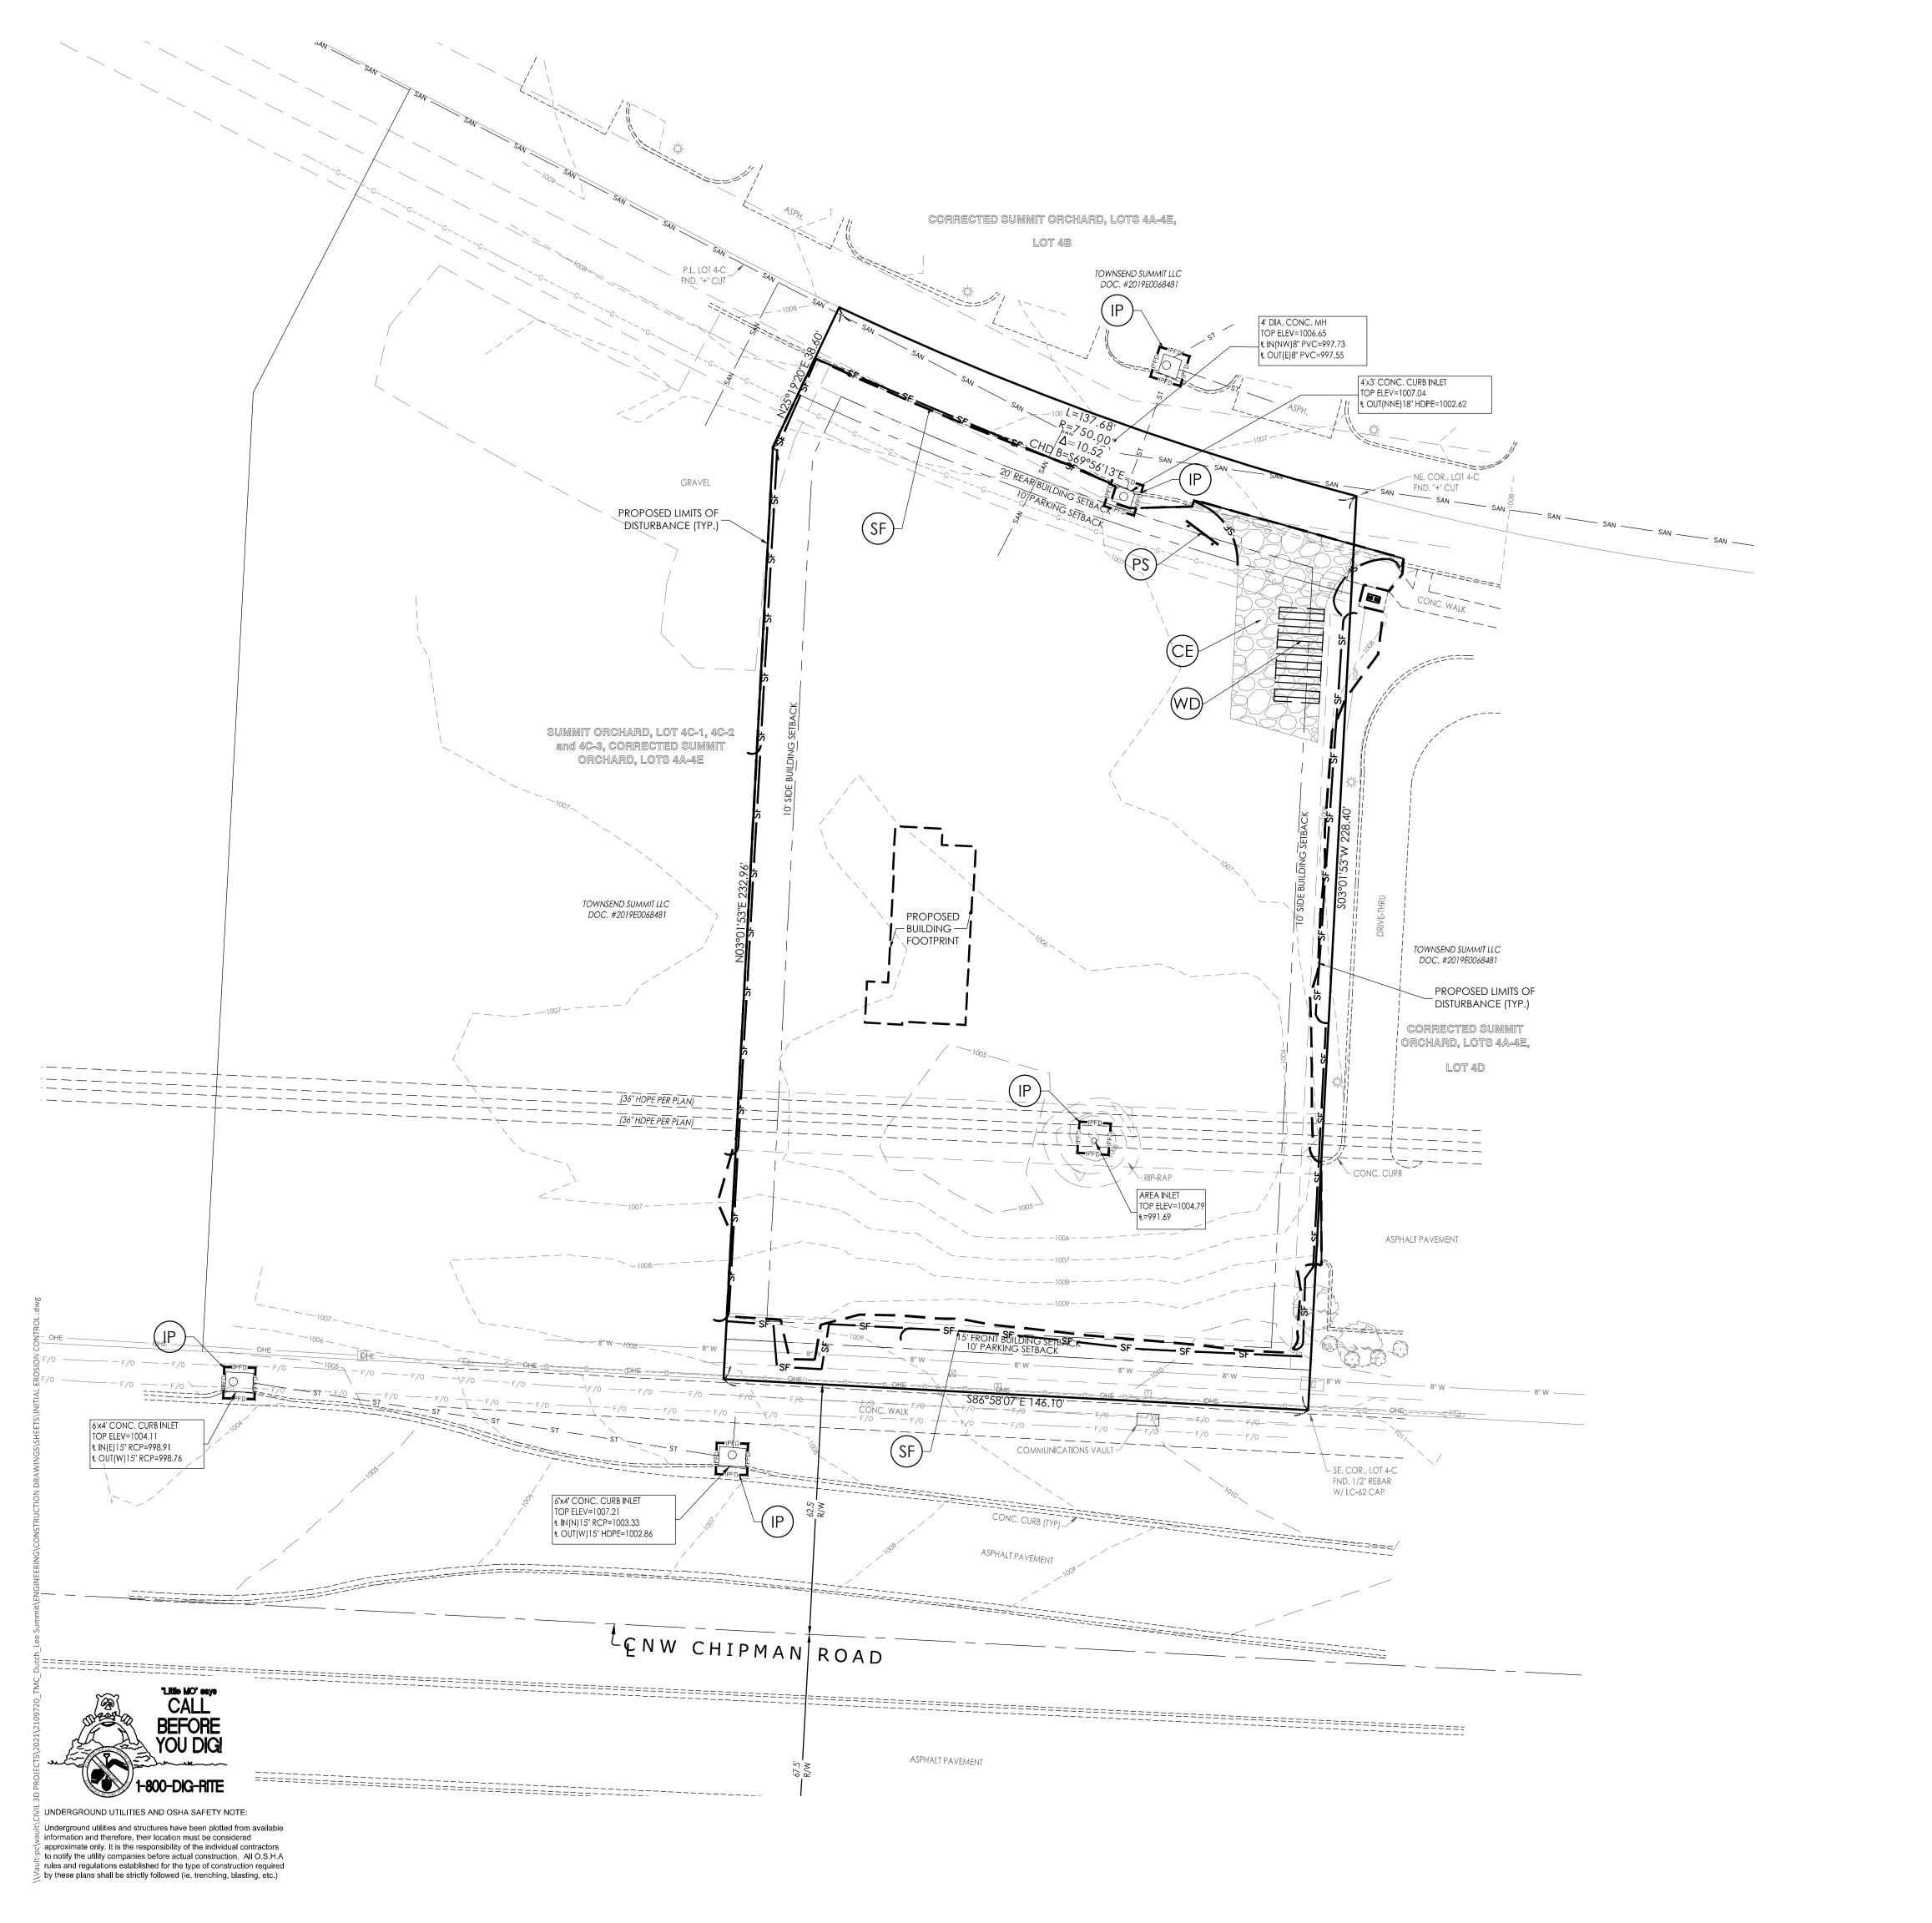
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A. JONES


M. FOGARTY

ISSUED FOR CONSTRUCTION

THE CONTRACTOR SHALL VISIT THE SITE PRIOR TO SUBMITTAL OF HIS/HER BIDS TO CONFIRM THAT THE SITE CONDITIONS ARE AS SHOWN ON THESE PLANS. ANY CONDITION THAT IS DIFFERENT THAN WHAT IS SHOWN ON THESE PLANS SHALL BE BROUGHT TO THE ATTENTION OF THE ENGINEER PRIOR TO SUBMITTAL OF BIDS.



EROSION CONTROL SYMBOL LEGEND

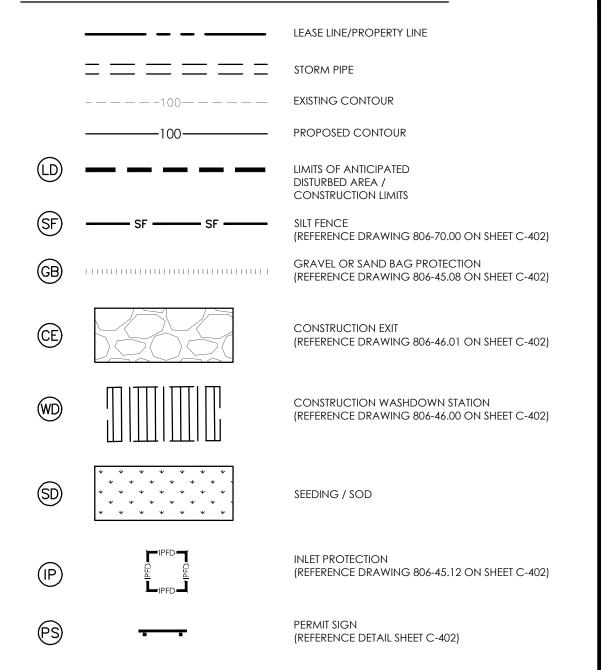

CONSTRUCTION SEQUENCING ACTIVITIES:


- INSTALL PROJECT SIGN & POST PERMITS
 INSTALL SILT & CONSTRUCTION FENCING
 INSTALL INLET PROTECTION
 INSTALL CONSTRUCTION ENTRANCE / EXIT
- INSTALL VEHICULAR WASH DOWN AREA
 BEGIN EXCAVATION & SITE DEMOLITION
 BEGIN BUILDING FOOTINGS & FOUNDATIONS
 BEGIN UTILITY TRENCHING & EXCAVATION
- PARKING & DRIVE AREA PAVING
 FINISHED GRADING & LANDSCAPING
 SEEDING & SOD WORK
- REMOVAL OF EROSION CONTROL AND OTHER BMP's


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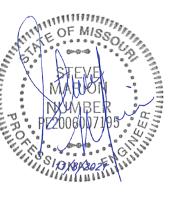
- 1. REFER TO THE EROSION CONTROL DETAIL SHEET & STORMWATER POLLUTION PREVENTION NARRATIVE FOR ADDITIONAL NOTES AND REQUIREMENTS.
- 2. THE GENERAL CONTRACTOR SHALL OBTAIN A COPY OF THE NPDES PERMIT ISSUED FOR THE SITE AND POST IT AT THE PROJECT SITE PRIOR TO ANY LAND DISTURBING ACTIVITIES. REFER TO SITE SIGN DETAIL ON THE EROSION CONTROL DETAIL SHEET.
- 3. CONTRACTOR SHALL INSTALL BMP'S NOTED ON THIS PLAN PRIOR TO BEGINNING ANY LAND DISTURBING, DEMOLITION, OR TREE REMOVAL ACTIVITIES.
- 4. THE CONTRACTOR SHALL INSTALL CONSTRUCTION ENTRANCE/EXIT AND MAINTAIN THESE ENTRANCES DURING CONSTRUCTION.
- 5. THE JOB SITE TRAILER, DUMPSTER, FUELING AREA, STORAGE & LAY-DOWN AREA SHALL BE LOCATED BY THE GENERAL CONTRACTOR AT THE START OF CONSTRUCTION. THESE ITEMS MUST BE NOTED BY THE CONTRACTOR ON THE SWPPP DRAWINGS.
- 6. SOIL STOCKPILES AND DEMOLITION DEBRIS STOCKPILES SHALL HAVE SILT FENCES INSTALLED IF LEFT ON SITE & UNDISTURBED FOR MORE THAN 13 DAYS.

ALL PROJECT SITES ARE REQUIRED TO COMPLY WITH REQUIREMENTS OF THE "CLEAN WATER ACT" ESTABLISHED BY THE US ENVIRONMENTAL PROTECTION AGENCY.

THE EPA'S NATIONAL POLLUTION DISCHARGE ELIMINATION SYSTEM (NPDES) PROGRAM REQUIRES PERMITS TO BE ISSUED BY REGULATORY AGENCIES WHEN PROJECT SITES DISTURB 1 ACRE OR MORE.



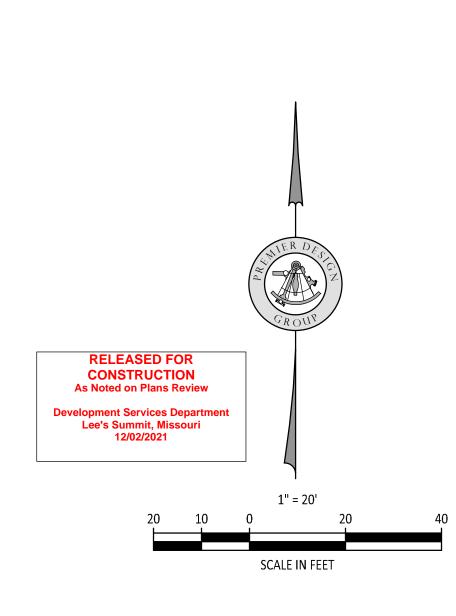

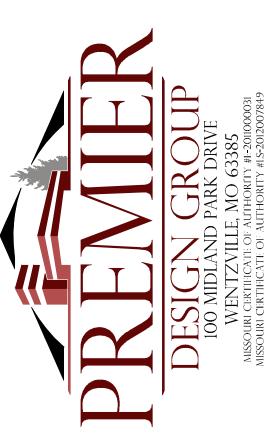


ENGINEERS AUTHENTICATION

The responsibility for professional engineering liability on this project is hereby limited to the set of plans authenticated by the seal, signature, and date hereunder attached. Responsibility is disclaimed for all other engineering plans involved in this project and specifically excludes revisions after this date unless reauthenticated.

STEVEN D. MARION P.E.
PROFESSIONAL ENGINEER
PE 2006007195

LEE'S SUIVIIII, IVIU
500 NW CHIPMAN RD.
LEE'S SUMMIT, MO 64086
TM CROWLEY
501 PENNSYLVANIA PARKWAY SUITE 160
INDIANAPOLIS. IN 46280

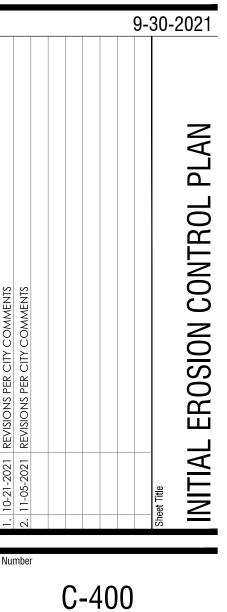


 Project No.
 2109720

 Drawn By
 A. JONES


ISSUED FOR CONSTRUCTION

Checked By

M. FOGARTY

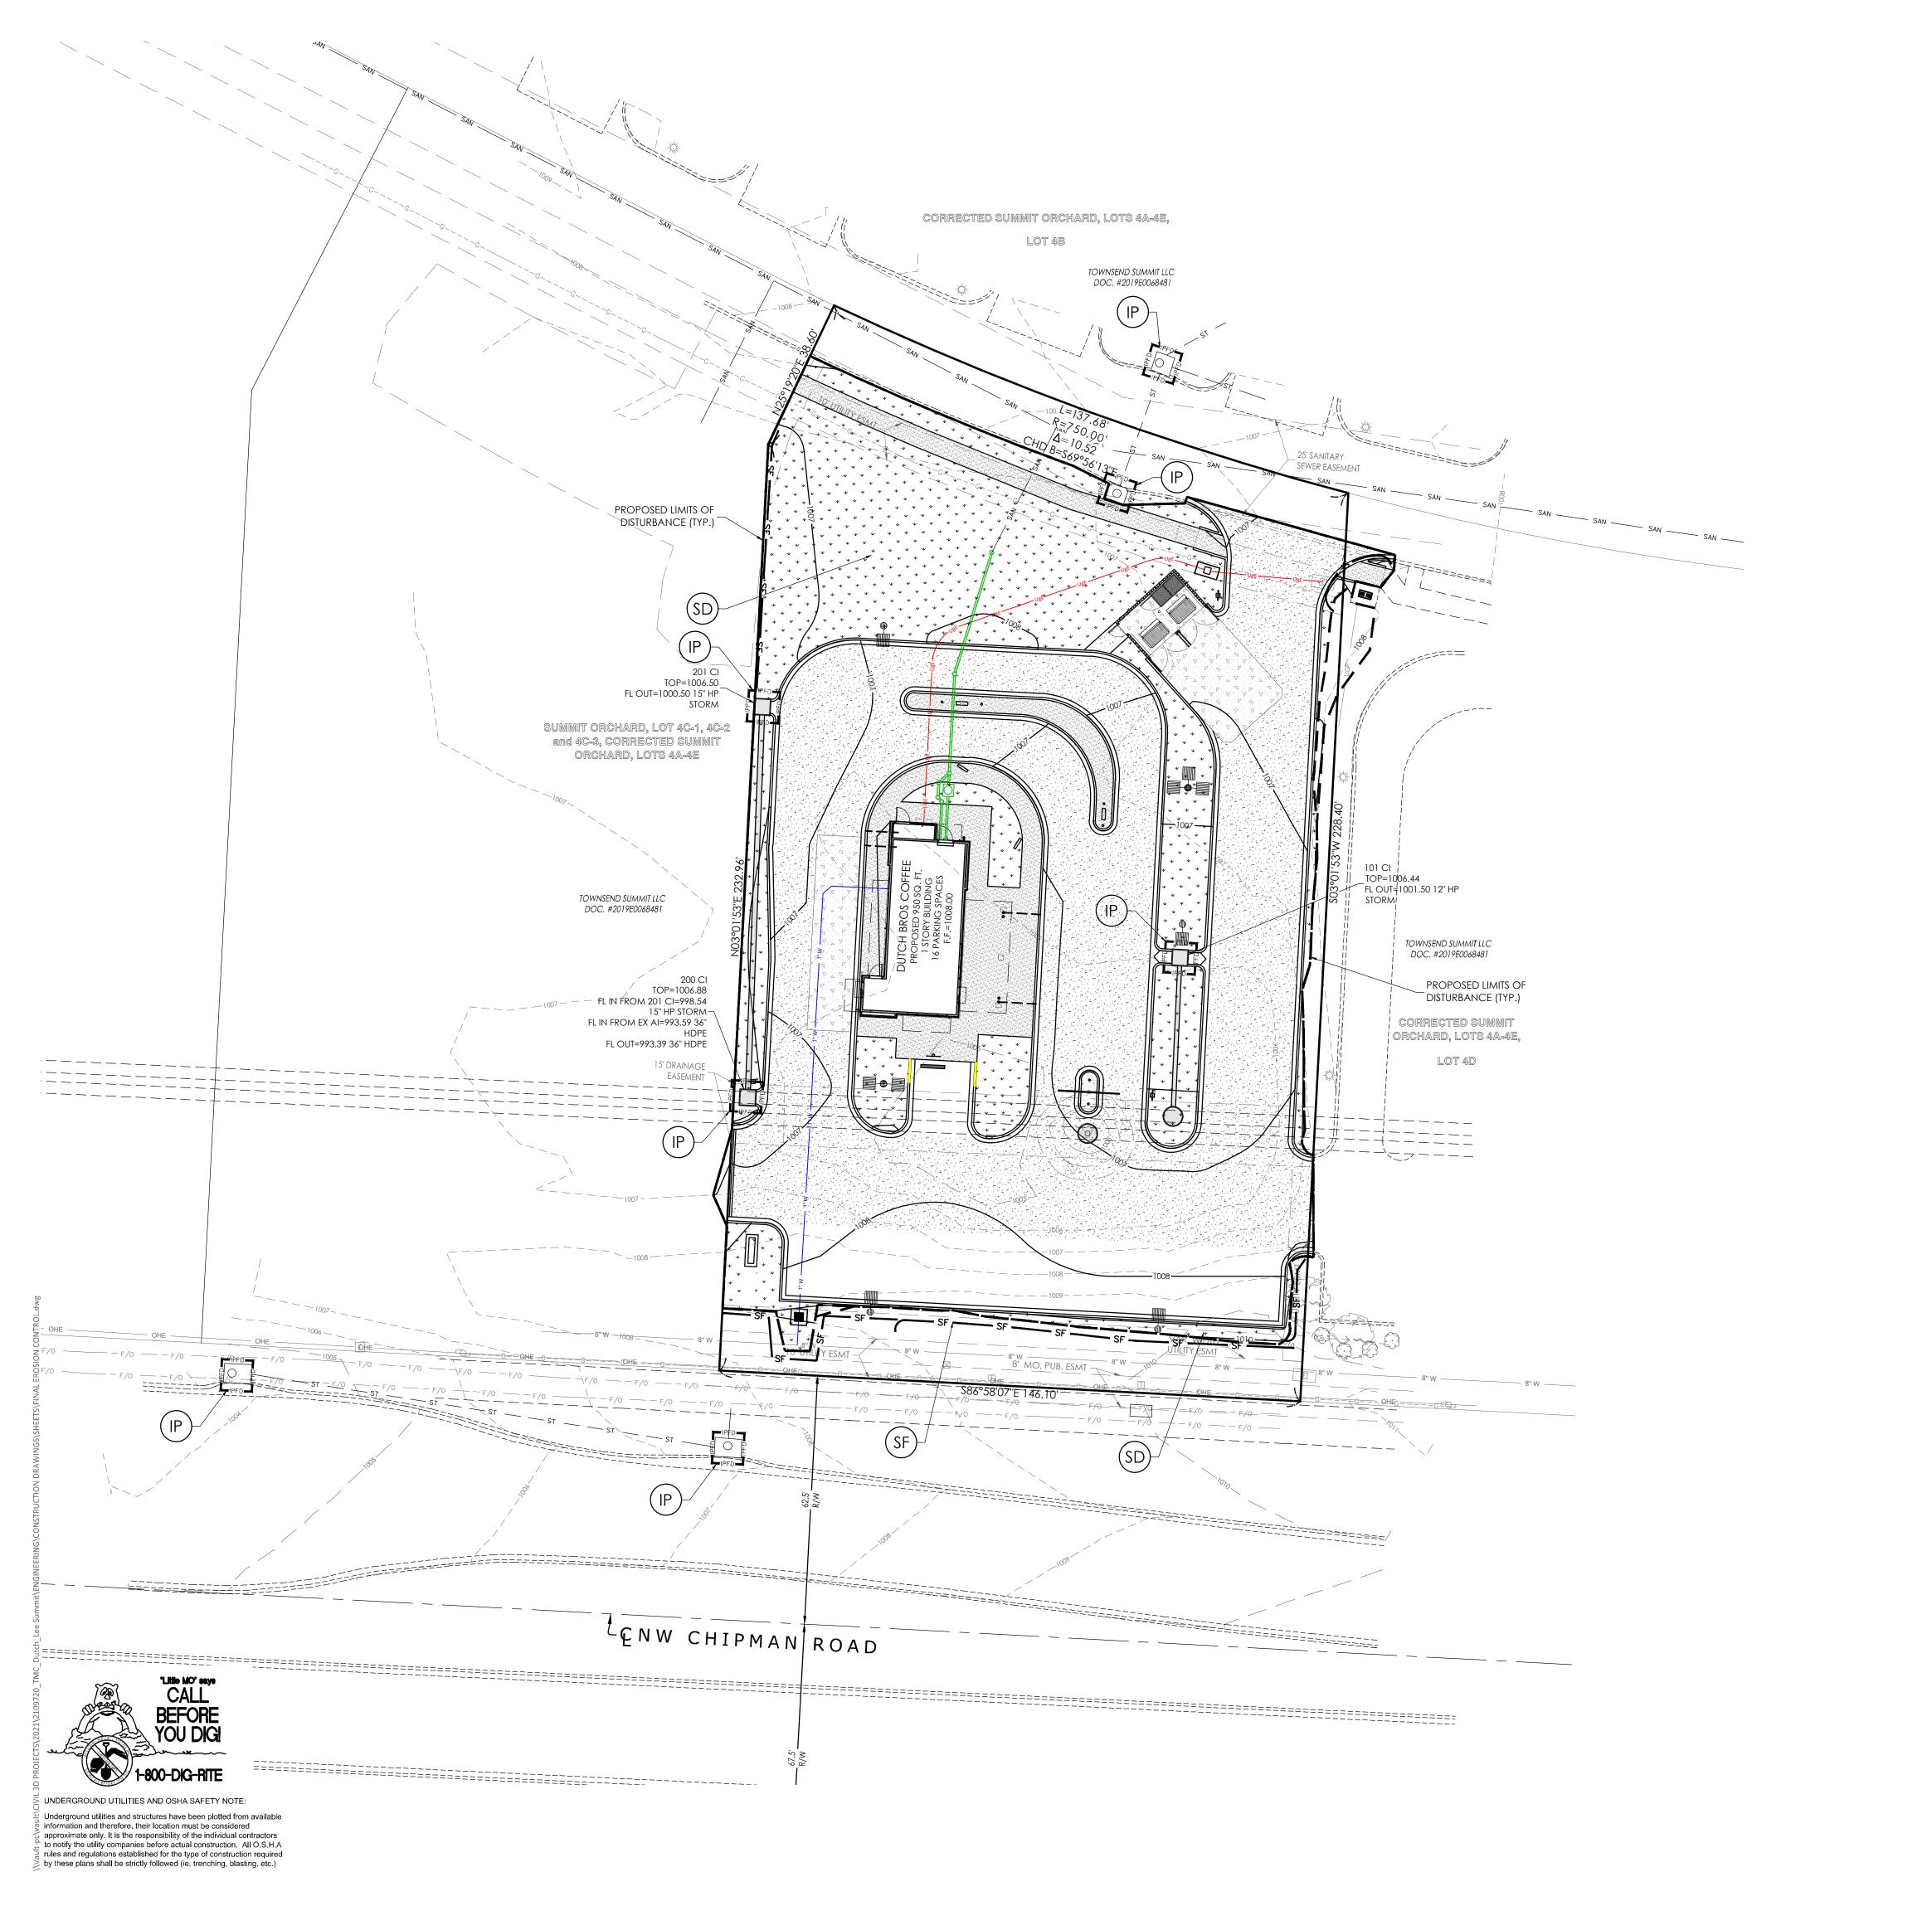

EROSION CONTROL SYMBOL LEGEND

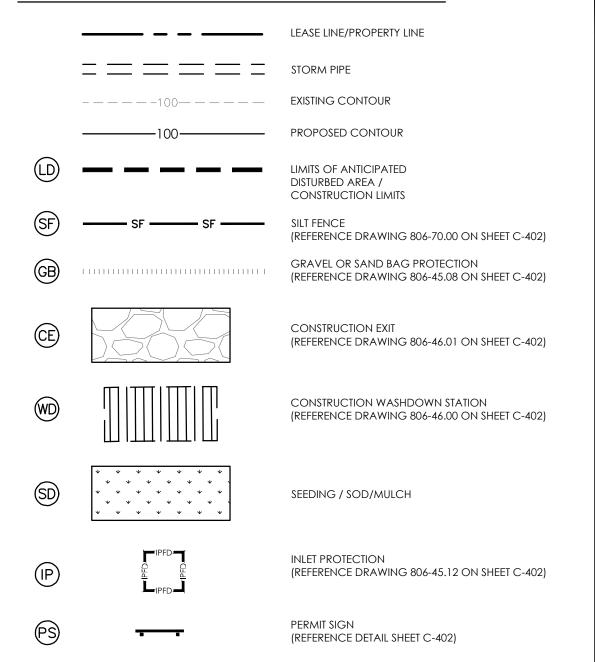

CONSTRUCTION SEQUENCING ACTIVITIES:

- INSTALL PROJECT SIGN & POST PERMITSINSTALL SILT & CONSTRUCTION FENCING
- INSTALL INLET PROTECTION
- INSTALL CONSTRUCTION ENTRANCE / EXITINSTALL VEHICULAR WASH DOWN AREA
- BEGIN EXCAVATION & SITE DEMOLITION
- BEGIN BUILDING FOOTINGS & FOUNDATIONS
 BEGIN UTILITY TRENCHING & EXCAVATION
- PARKING & DRIVE AREA PAVINGFINISHED GRADING & LANDSCAPING
- SEEDING & SOD WORK

 PENOUAL OF FROSION CONTROL AND OTHER
- REMOVAL OF EROSION CONTROL AND OTHER BMP's

NOTES:

- REFER TO THE EROSION CONTROL DETAIL SHEET & STORMWATER
- POLLUTION PREVENTION NARRATIVE FOR ADDITIONAL NOTES AND REQUIREMENTS.
- 2. THE GENERAL CONTRACTOR SHALL OBTAIN A COPY OF THE NPDES PERMIT ISSUED FOR THE SITE AND POST IT AT THE PROJECT SITE PRIOR TO ANY LAND DISTURBING ACTIVITIES. REFER TO SITE SIGN DETAIL ON THE
- ANY LAND DISTURBING ACTIVITIES. REFER TO SITE SIGN DETAIL ON THE EROSION CONTROL DETAIL SHEET.

 3. CONTRACTOR SHALL INSTALL BMP'S NOTED ON THIS PLAN PRIOR TO
- ACTIVITIES.
 4. THE CONTRACTOR SHALL INSTALL CONSTRUCTION ENTRANCE/EXIT AND

BEGINNING ANY LAND DISTURBING, DEMOLITION, OR TREE REMOVAL

- MAINTAIN THESE ENTRANCES DURING CONSTRUCTION.


 5. THE JOB SITE TRAILER, DUMPSTER, FUELING AREA, STORAGE & LAY-DOWN AREA SHALL BE LOCATED BY THE GENERAL CONTRACTOR AT THE START
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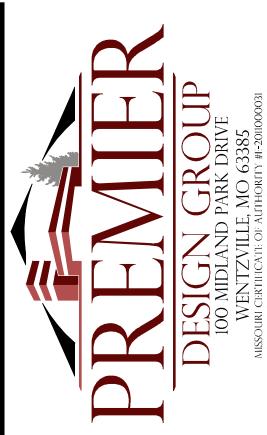
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ALL PROJECT SITES ARE REQUIRED TO COMPLY WITH REQUIREMENTS OF THE "CLEAN WATER ACT" ESTABLISHED BY THE US ENVIRONMENTAL PROTECTION AGENCY.

THE EPA'S NATIONAL POLLUTION DISCHARGE ELIMINATION SYSTEM (NPDES) PROGRAM REQUIRES PERMITS TO BE ISSUED BY REGULATORY AGENCIES WHEN PROJECT SITES DISTURB 1 ACRE OR MORE.





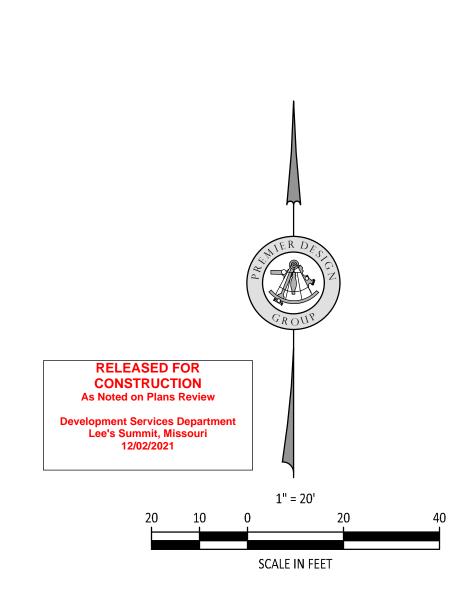

ENGINEERS AUTHENTICATION


The responsibility for professional engineering liability on this project is hereby limited to the set of plans authenticated by the seal, signature, and date hereunder attached. Responsibility is disclaimed for all other engineering plans involved in this project and specifically excludes revisions after this date unless reauthenticated.

STEVEN D. MARION P.E.

PROFESSIONAL ENGINEER

PE 2006007195

LEE'S SUMMIT, MO 500 NW CHIPMAN RD. LEE'S SUMMIT, MO 64086 TM CROWLEY 501 PENNSYLVANIA PARKWAY SUITE 160 INDIANAPOLIS, IN 46280

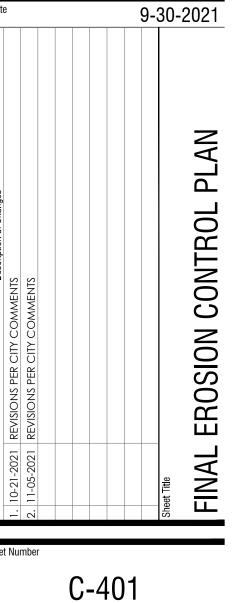

 Project No.
 2109720

 Drawn By
 A. JONES

 Checked By
 M. FOGARTY

- 1. THE CONTRACTOR IS RESPONSIBLE FOR OBTAINING A GRADING PERMIT FROM THE CITY OF CITY OF LEE'S SUMMIT
- 2. THE CONTRACTOR SHALL KEEP & MAINTAIN A COPY OF THE LAND DISTURBANCE PERMIT(S) AND, EROSION CONTROL PLANS AT THE PROJECT SITE DURING CONSTRUCTION.
- 3. ALL EROSION CONTROL MEASURES MUST MEET LOCAL REQUIREMENTS AND THE "PROTECTING WATER QUALITY, A FIELD GUIDE TO EROSION, SEDIMENT AND STORM WATER BEST MANAGEMENT PRACTICES FOR DEVELOPMENT SITES IN MISSOURI AND KANSAS". THE DOCUMENT IS AVAILABLE FROM THE MISSOURI DEPARTMENT OF NATURAL RESOURCES AND CAN BE DOWNLOADED FROM THE DNR WEBSITE AT HTTP:/WWW.DNR.MO.GOV/ENV/WPP/WPCP-GUIDE.HTM.
- 4. PRIOR TO THE START OF ANY LAND DISTURBING ACTIVITIES, EROSION AND SEDIMENT CONTROL MEASURES AND APPLICABLE BMPS SHALL BE INSTALLED.
- 5. THE CONTRACTOR SHALL NOTIFY THE CITY ENGINEER A MINIMUM OF 48 HOURS PRIOR TO THE START OF GRADING SO THAT SITE BMPS CAN BE VERIFIED.
- 6. THE GENERAL CONTRACTOR SHALL HAVE ULTIMATE CONTROL OF THE SITE AND REQUIRE THAT ALL SUBCONTRACTORS, UTILITY COMPANIES, AND ANY PERSON PERFORMING LAND DISTURBING ACTIVITIES CONFORM TO THE REQUIREMENTS OF THE PERMITS ISSUED FOR THE SITE. THIS INCLUDES CONFORMANCE TO THE STORM WATER POLLUTION PLAN PREPARED & MAINTAINED FOR THE SITE.
- 7. THE CONTRACTOR IS RESPONSIBLE FOR MANAGING STORM WATER RUNOFF AND EROSION THROUGHOUT CONSTRUCTION.
- 8. THIS EROSION CONTROL PLAN HAS BEEN PREPARED AS A BEGINNING POINT AND SHOULD EVOLVE AS SITE CONDITIONS WARRANT. THE GENERAL CONTRACTOR SHALL IMPLEMENT ADDITIONAL BMPS AS DEEMED NECESSARY TO ADEQUATELY RETAIN SEDIMENT ON-SITE.
- 9. THE CONTRACTOR SHALL MAINTAIN AND PROTECT EXISTING TREES AND VEGETATION.
- 10. CONSTRUCTION MATERIAL STORAGE AND LAY-DOWN AREAS ARE TO BE AWAY FROM DRAINAGE COURSES AND
- 11. PROVIDE CONTAINERS FOR THE DISPOSAL OF WASTE PAINTS, SOLVENTS, CLEANING COMPOUNDS, ETC.
- 12. PROVIDE TRASH CONTAINERS ONSITE AND PERFORM REGULAR SITE CLEAN UP FOR PROPER DISPOSAL OF SOLID WASTE. SOLID WASTE SHALL INCLUDE, BUT NOT BE LIMITED TO, SCRAP BUILDING MATERIALS, PRODUCT/MATERIAL PACKAGING, FOOD AND DRINK CONTAINERS.
- 13. THE CONTRACTOR SHALL INSTALL CONTAINMENT BERMS & DRIP PANS AT PETROLEUM PRODUCT & LIQUID STORAGE TANK AREAS.
- 14. THE CONTRACTOR SHALL PROVIDE CONCRETE WASH OUT AREAS. CONCRETE TRUCKS SHALL NOT DISCHARGE SURPLUS CONCRETE OR WASH WATER ON THE GROUND OR INTO DITCHES. CONCRETE WASH-OUT AREAS SHALL BE DESIGNED TO ENSURE CONCRETE PARTICLES WILL NOT BE RELEASED FROM THE CONSTRUCTION SITE.
- 15. THE CONTRACTOR SHALL IMPLEMENT DUST CONTROL MEASURES IF CONDITIONS WARRANT. DUST CONTROL MAY INCLLIDE WATERING/IRRIGATION WIND BARRIERS SPRAY ON ADHESIVES TILLING OR CHEMICAL TREATMENT. ANY CLEANUP TO ADJACENT PROPERTIES DUE TO INADEQUATE DUST CONTROL WILL BE THE
- 16. THE CONTRACTOR SHALL PROVIDE FOR SOLID WASTE/TRASH COLLECTION. THE CONSTRUCTION SITE SHALL BE KEPT CLEAN AND ORDERLY.
- 17. THE CONTRACTOR SHALL PROVIDE FOR SANITARY WASTE COLLECTION DURING CONSTRUCTION. PORTA POTTIES SHALL BE LOCATED BY THE CONTRACTOR AND NOTED ON THE DRAWINGS.
- 1. BMP's SHALL BE INSPECTED ONCE A WEEK AND WITHIN 24 HRS OF RAIN EVENTS OF 1/2" OR GREATER. REPAIR AND MAINTENANCE TO BMP'S SHALL BE DONE IMMEDIATELY.
- 2. THE CONTRACTOR SHALL SUBMIT AN INSPECTION REPORT WITHIN 72 HOURS AFTER EVERY STORM EVENT TO THE
- 3. THE CONTRACTOR SHALL ENSURE THE SITE CONFORMS TO THE REQUIREMENTS OF THE EROSION CONTROL PLANS AND INSTALL ADDITIONAL BMP'S SHOULD SITE CONDITIONS WARRANT.

FINAL SITE STABILIZATION


- 1. ONCE GRADED AREAS ARE CONSTRUCTED TO FINAL GRADES, PERMANENT STABILIZATION SHALL BE ESTABLISHED. 2. THE CONTRACTOR SHALL RESTORE OFF-SITE AREAS DAMAGED BY CONSTRUCTION TO A CONDITION, EQUAL TO, OR BETTER THAN THE CONDITION PRIOR TO THE COMMENCEMENT OF CONSTRUCTION.
- 3. ALL EROSION CONTROL BMP's SHALL REMAIN IN PLACE UNTIL THE SITE HAS BEEN PERMANENTLY STABILIZED.
- 4. ONCE THE SITE HAS REACH FINAL STABILIZATION, THE CONTRACTOR IS TO CLEAN AND REMOVE DEBRIS FROM BMP'S AND STORM WATER COLLECTION AREAS. BMP'S ARE THEN TO BE REMOVED.

POTENTIAL POLLUTANTS THAT MAY BE FOUND ON SITE DURING CONSTRUCTION:

Material Trade Name	Chemical/Physical Description	Storm Water Pollutants
Erosion	Solid Particles	Soil, sediment
Fertilizer	Liquid or solid grains	Nitrogen, phosphorus
Pesticides (insecticides, fungicides, herbicides, rodenticides)	Various colored to colorless liquid, powder, pellets, or grains	Chlorinated hydrocarbons, organophosphates, carbonates, arsenic
Asphalt	Black solid	Oil, petroleum distillates
Concrete	White solid	Limestone, sand
Plaster	White granules or powder	Calcium Sulphate, calcium carbonate, sulfuric acid
Glue, adhesives	White or yellow liquid	Polymers, epoxies
Paints	Various colored liquid	Metal oxides, Stoddard solvent, talc, calcium carbonate, arsenic
Curing compounds	Creamy white liquid	Naphtha
Wood preservatives	Clear amber or dark brown liquid	Stoddard solvent, petroleum distillates, arsenic, copper, chromium.
Hydraulic oil/fluids	Brown oily petroleum hydrocarbon	Mineral oil
Gasoline	Colorless, pale brown or pink petroleum hydrocarbon	Benzene, ethyl benzene, toluene, xylene, MTBE
Diesel Fuel	Clear, blue-green to yellow liquid	Petroleum distillate, oil & grease, naphthalene, xylenes
Antifreeze/coolant	Clear green/yellow liquid	Ethylene glycol, propylene glycol, heavy metals (copper, lead, zinc)

MATERIALS STORED ON SITE:

- 1. ALL MATERIALS STORED ON-SITE SHALL BE STORED IN A NEAT, ORDERLY MANNER IN THEIR APPROPRIATE CONTAINERS. IF POSSIBLE, MATERIALS SHALL BE STORED UNDER A ROOF OR OTHER ENCLOSURE.
- 2. PRODUCTS SHALL BE KEPT IN THEIR ORIGINAL CONTAINERS WITH THE MANUFACTURER'S LABEL. SUBSTANCES SHALL NOT BE MIXED WITH ONE ANOTHER UNLESS RECOMMENDED BY THE MANUFACTURER. WHENEVER POSSIBLE, ALL OF THE PRODUCT SHALL BE USED UP BEFORE DISPOSING OF THE CONTAINER. THE MANUFACTURER'S RECOMMENDATIONS FOR THE PROPER USE AND DISPOSAL OF THEIR PRODUCTS SHALL BE FOLLOWED. THE CONSTRUCTION MANGER SHALL INSPECT THE ON-SITE MATERIALS DAILY TO ENSURE THE PROPER USE AND DISPOSAL.
- 3. HAZARDOUS PRODUCTS SHALL BE KEPT IN RESEALABLE CONTAINERS. ORIGINAL LABELS AND MATERIAL SAFETY DATA SHALL BE RETAINED. ALL FEDERAL, STATE AND CITY REGULATIONS SHALL BE FOLLOWED WHEN DISPOSING OF ANY HAZARDOUS WASTE.

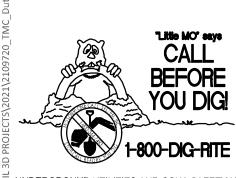

UNDERGROUND UTILITIES AND OSHA SAFETY NOTE: Inderground utilities and structures have been plotted from available information and therefore, their location must be considered approximate only. It is the responsibility of the individual contractor

to notify the utility companies before actual construction. All O.S.H.A

rules and regulations established for the type of construction required by these plans shall be strictly followed (ie. trenching, blasting, etc.)

MAINTENANCE OF EROSION AND SEDIMENTATION CONTROLS:

- 1. SILT FENCING SHALL BE INSPECTED DAILY DURING PERIODS OF RAINFALL, IMMEDIATELY AFTER EACH SIGNIFICANT RAINFALL EVENT, AND WEEKLY DURING PERIODS OF NO RAINFALL, REPAIRS TO SILT FENCES SHALL BE DONE IMMEDIATELY, SEDIMENT SHALL BE REMOVED FROM THE SILT FENCES WHEN THE SEDIMENT REACHES ONE-HALF THE HEIGHT OF THE SILT FENCE.
- 2. THE STABILIZED CONSTRUCTION ENTRANCE SHALL BE INSPECTED REGULARLY, AFTER EVERY RAINFALL EVENT, AND DURING HIGH VOLUMES OF TRAFFIC. REPAIRS TO THE CONSTRUCTION ENTRANCE SHALL BE MADE IMMEDIATELY. ALL SEDIMENTS, AND ALL OTHER MATERIALS, TRACKED ONTO PUBLIC ROADWAYS SHALL BE REMOVED
- 3. SELECT STOCKPILE LOCATION TO AVOID SLOPES AND NATURAL DRAINAGE WAYS, AVOIDING TRAFFIC ROUTES. ON LARGE SITES, RE-SPREADING IS EASIER AND MORE ECONOMICAL WHERE TOPSOIL IS STOCKPILED IN SMALL PILES LOCATED NEAR AREAS
- 4. INSPECT AND MAINTAIN ALL BMPS LOCATED DOWN HILL OF AREA BEING GRADED, AS INDICATED. ADDITIONAL BMPS SHOULD BE CONSTRUCTED IF IT IS OBSERVED THAT THE PROPOSED BMPS ARE NOT EFFECTIVELY LIMITING SEDIMENT TRANSPORT FROM THE SITE.

TYPICAL BMPS THAT MIGHT BE UTILIZED INCLUDE, BUT ARE NOT LIMITED TO:

- SEDIMENT BARRIERS USE SILT FENCES, STRAW BALE SEDIMENT TRAPS OR OTHER BARRIERS WHERE NECESSARY TO RETAIN SEDIMENT
- TEMPORARY SEEDING PROTECT TOPSOIL STOCKPILES BY TEMPORARILY SEEDING AS SOON AS POSSIBLE, NO MORE THAN 14 CALENDAR DAYS AFTER THE FORMATION OF
- PERMANENT VEGETATION IF STOCKPILES WILL NOT BE USED WITHIN 12 MONTHS, THEY MUST BE STABILIZED WITH PERMANENT VEGETATION TO CONTROL EROSION AND WEED

SPILL CONTROL OF POLLUTANTS:

- 1. ALL ON-SITE VEHICLES SHALL BE MONITORED FOR LEAKS AND SHALL RECEIVE REGULAR PREVENTATIVE MAINTENANCE TO REDUCE THE CHANCE OF LEAKAGE.
- 2. CONCRETE TRUCKS SHALL ONLY WASH-OUT OR DISCHARGE SURPLUS CONCRETE, OR DRUM-WASH WATER, AT DEDICATED CONCRETE TRUCK WASH-OUT AREAS. NO EXCESS CONCRETE OR DRUM WASH WATER SHALL BE RELEASED FROM THE SITE.
- 3. PETROLEUM PRODUCTS SHALL BE STORED IN TIGHTLY SEALED CONTAINERS WHICH ARE
- 4. ALL ASPHALTIC SUBSTANCES USED ON-SITE SHALL BE APPLIED ACCORDING TO THE MANUFACTURERS RECOMMENDATIONS.
- 5. FERTILIZERS SHALL BE APPLIED ONLY IN THE MINIMUM AMOUNTS RECOMMENDED BY THE MANUFACTURER. ONCE APPLIED, FERTILIZER SHALL BE WORKED INTO THE SOIL TO LIMIT EXPOSURE TO STORM WATER. THE CONTENTS OF ANY PARTIALLY USED BAGS OF FERTILIZER SHALL BE TRANSFERRED TO A SEALABLE PLASTIC CONTAINER TO AVOID SPILLS.
- 6. ALL SPILLS SHALL BE CLEANED UP IMMEDIATELY AFTER DISCOVERY. THE MANUFACTURER'S RECOMMENDED METHODS FOR SPILL CLEANUP SHALL BE RELAYED TO SITE PERSONNEL AND THEY SHALL BE MADE AWARE OF THE LOCATION OF THE CLEANUP SUPPLIES. MATERIALS AND EQUIPMENT NECESSARY FOR SPILL CLEANUP SHALL BE STORED ON-SITE. IN CASE OF A SPILL. THE SPILL AREA SHALL BE KEPT WELL VENTILATED AND CLEANUP PERSONNEL SHALL WEAR THE APPROPRIATE CLOTHING TO PREVENT INJURY FROM CONTACT WITH THE HAZARDOUS SUBSTANCE. SPILLS OF TOXIC AND HAZARDOUS MATERIAL, REGARDLESS OF THE SIZE OF THE SPILL, SHALL BE REPORTED TO THE APPROPRIATE STATE AND LOCAL GOVERNMENT AGENCIES IMMEDIATELY AFTER DISCOVERY.

CONSTRUCTION ENTRANCE (CE)

- 1. THE LOCATION OF A CONSTRUCTION ENTRANCE/EXIT HAS BEEN SHOWN ON THE EROSION CONTROL PLAN(S). THE CONTRACTOR SHALL INSTALL OR ESTABLISH A DESIGNATED CONSTRUCTION ENTRANCE/EXIT AT THE START OF CONSTRUCTION. IN THE EVENT THE ENTRANCE IS LOCATED IN A DIFFERENT LOCATION, THE CONTRACTOR SHALL UPDATE THE EROSION CONTROL PLAN.
- 2. A PERMIT SIGN SHALL BE INSTALLED AT OR NEAR THE CONSTRUCTION ENTRANCE FOR POSTING RELEVANT CONSTRUCTION PERMITS FOR THE PROJECT.
- 3. AS PART OF THE CONSTRUCTION ENTRANCE, THE CONTRACTOR SHALL INSTALL A VEHICLE WASH DOWN AREA. THE WASH DOWN AREA IS TO PREVENT THE TRACKING OF MUD AND DEBRIS FROM
- 4. TRACKING IS NOT PERMISSIBLE. ANY TRACKING OF MUD AND/OR DEBRIS ONTO OFF-SITE ROADS SHALL BE CLEANED IMMEDIATELY.
- 5. LOCATION AND FINAL DIMENSIONS OF THE CONSTRUCTION ENTRANCE, WASH DOWN AREA AND STAGING AREAS SHALL BE ESTABLISHED BY THE GENERAL CONTRACTOR.
- 6. ALL CONSTRUCTION TRAFFIC LEAVING THE PROJECT SITE SHALL UTILIZE THE CONSTRUCTION ENTRANCE/EXIT.

SILT FENCE (SF)

- 7. SILT FENCE TO BE ADJUSTED AS NECESSARY FOR CONSTRUCTION ACTIVITY.
- 8. UNLESS NOTED OTHERWISE, SILT FENCE SHALL BE A WOVEN GEOTEXTILE FABRIC SUCH AS MIRAFI 100X
- 9. REFER TO THE SILT FENCE DETAIL FOR INSTALLATION REQUIREMENTS.
- 10. SILT FENCES SHALL ONLY BE USED FOR STORM WATER SHEET FLOW CONDITIONS. 11. SILT FENCES SHALL FOLLOW CONTOURS AND UTILIZE "J" HOOKS TO HELP TRAP SEDIMENT.
- 12. SILT FENCES SHALL BE INSPECTED REGULARLY FOR RIPS, TEARS, OR DETERIORATION. DAMAGED
- FENCE SHALL BE REPLACED. 13. WHEN SEDIMENT BUILDS UP TO ONE HALF THE HEIGHT OF THE FENCE, IT SHALL BE CLEANED AND

INLET PROTECTION (IP)


- 1. REFER TO THE INLET PROTECTION DETAILS FOR VARIOUS TYPES OF INLET PROTECTION. THE CONTRACTOR SHALL HAVE THE OPTION OF UTILIZING ANY TYPES SHOWN OR ACCEPTABLE
- 2. INLET PROTECTION DEVICES SHALL BE INSTALLED IMMEDIATELY AROUND EACH INLET ONCE INLET CONSTRUCTION IS COMPLETED. INLET PROTECTION SHALL REMAIN IN PLACE AND BE MAINTAINED

UNTIL THE SITE HAS BEEN CONSIDERED STABLE. SOD OR SEEDING, MULCHING AND FERTILIZING (SD) (SM)

- 1. ALL DISTURBED AREAS WHICH REMAIN UNWORKED FOR 14 DAYS, SHALL BE TEMPORARILY STABILIZED.
- 2. ALL TEMPORARY DIVERSION BERMS, DIVERSION DITCHES AND SOIL STOCKPILE AREAS SHALL BE SEEDED AND MULCHED IMMEDIATELY AFTER GRADING.
- 3. ALL AREAS DISTURBED DURING CONSTRUCTION, WHICH WILL NOT BE PAVED, SHALL HAVE A MINIMUM OF 4" OF TOPSOIL INSTALLED.
- 4. GRASSED AREAS SHALL BE EITHER SODDED OR SEEDED AND MULCHED. REFER TO THE SITE AND LANDSCAPING PLANS FOR LOCATIONS OF EACH.
- 5. ALL RIGHT-OF-WAYS SHALL HAVE SOD INSTALLED. SOD SHALL MEET THE REQUIREMENTS OF THE

LOCAL JURISDICTION AND/OR THE DEPARTMENT OF TRANSPORTATION.

- 6. SOD SHALL BE DROUGHT RESISTANT FESCUE.
- 7. TEMPORARY IRRIGATION MAY BE REQUIRED TO HELP ESTABLISH SODDED/SEEDED AREAS.
- 8. THE CONTRACTOR IS RESPONSIBLE FOR MAINTAINING SODDED AND SEEDED AREAS UNTIL A HEALTHY STAND OF GRASS IS ESTABLISHED.

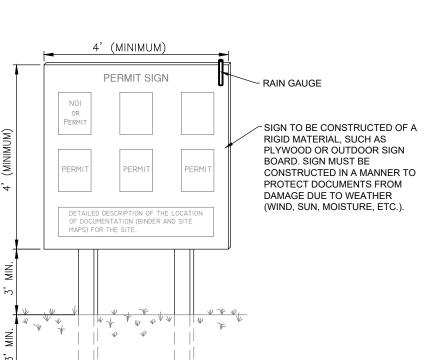

NOTES:

- 1. ALL POSTED DOCUMENTS MUST BE MAINTAINED IN A CLEARLY READABLE CONDITION AT ALL TIMES THROUGHOUT CONSTRUCTION AND UNTIL THE PERMIT HAS BEEN TERMINATED.
- CONTRACTOR SHALL POST OTHER STORMWATER AND/OR EROSION AND SEDIMENT CONTROL RELATED PERMITS ON THE SIGN AS REQUIRED BY THE GOVERNING AGENCY.
- SIGN SHALL BE LOCATED OUTSIDE OF PUBLIC RIGHT-OF-WAY AND EASEMENTS UNLESS APPROVED BY THE GOVERNING AGENCY.
- 4. CONTRACTOR IS RESPONSIBLE FOR ENSURING STABILITY OF THE INFORMATION SIGN.

PERMIT SIGN DETAIL

SEEDING REQUIREMENTS


Permanent Se


Tall Fescue


Smooth Brome Fescue & Brome


Fescue, Rye & BI


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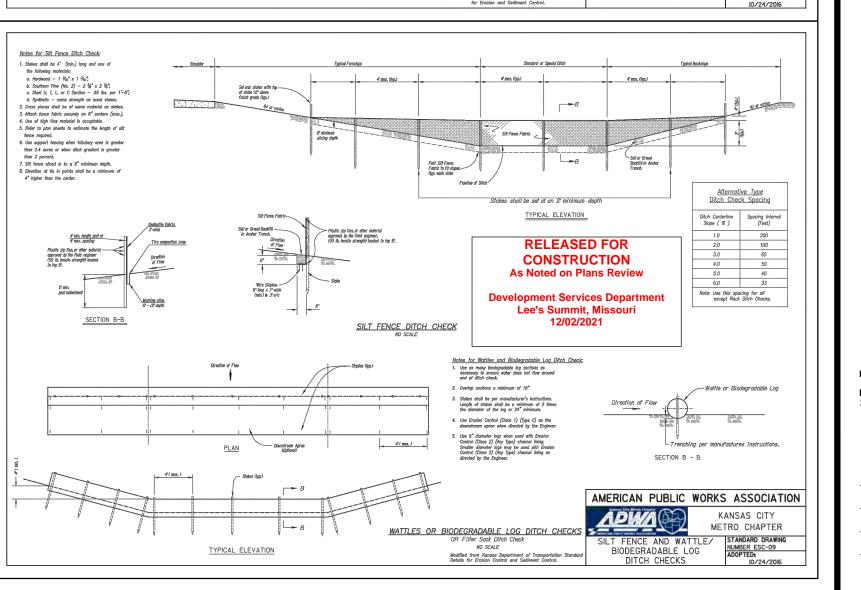


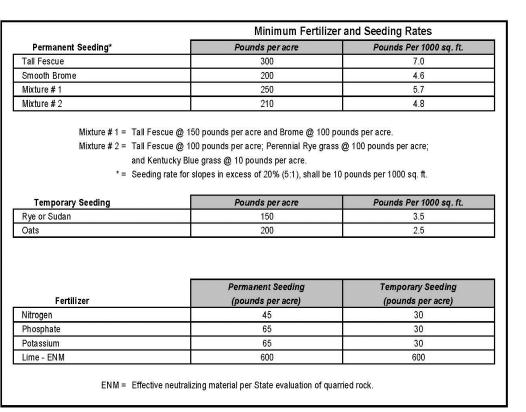


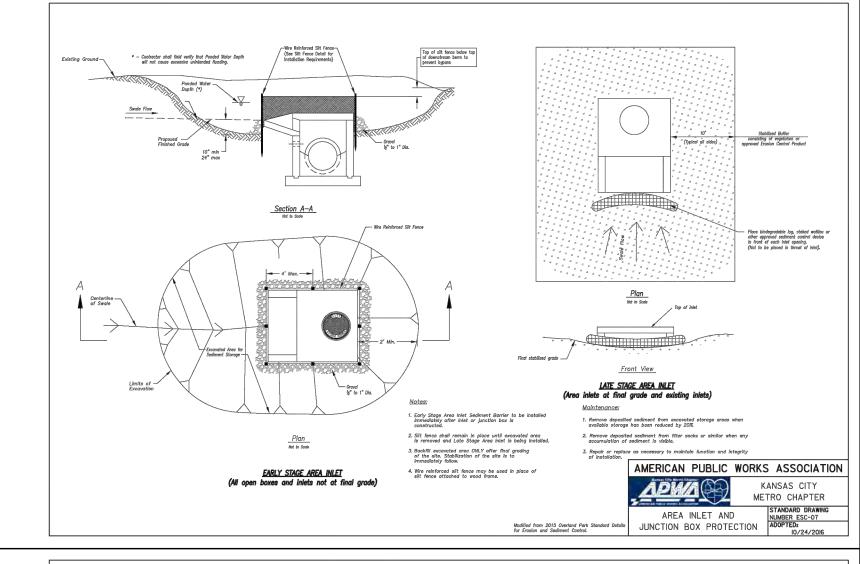

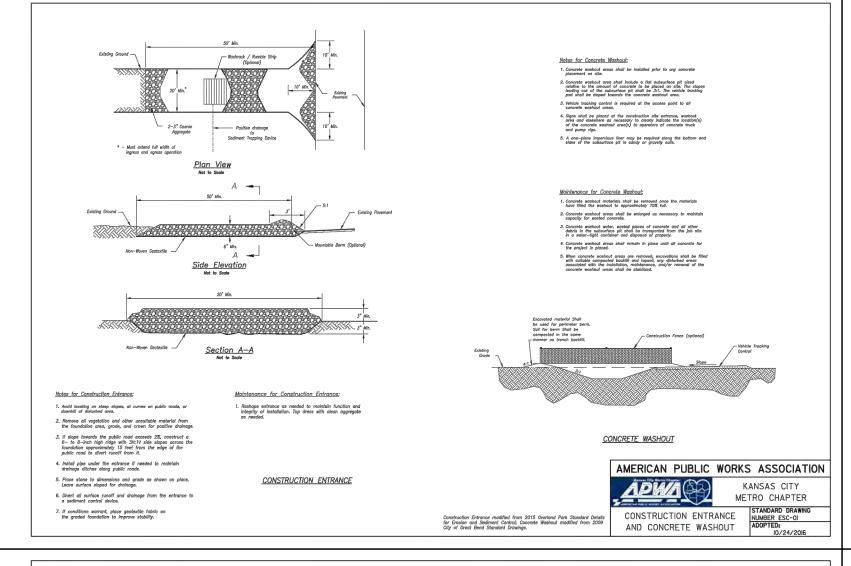

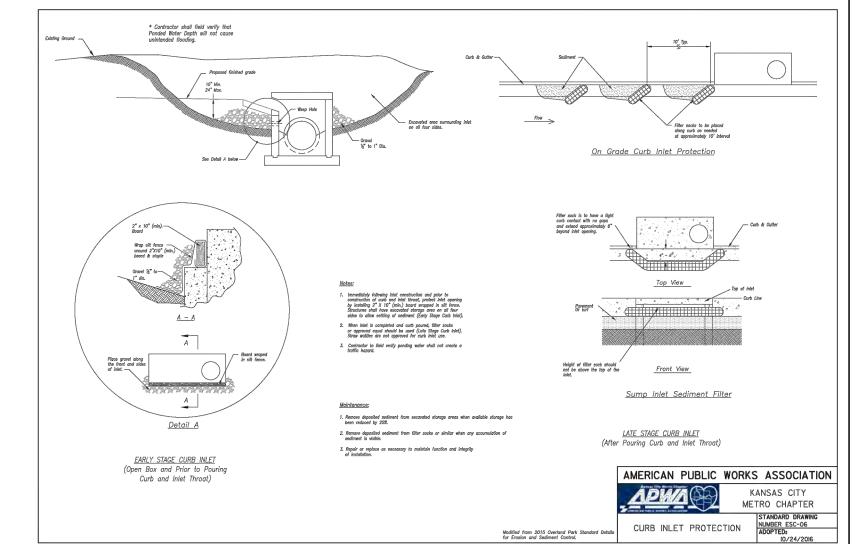

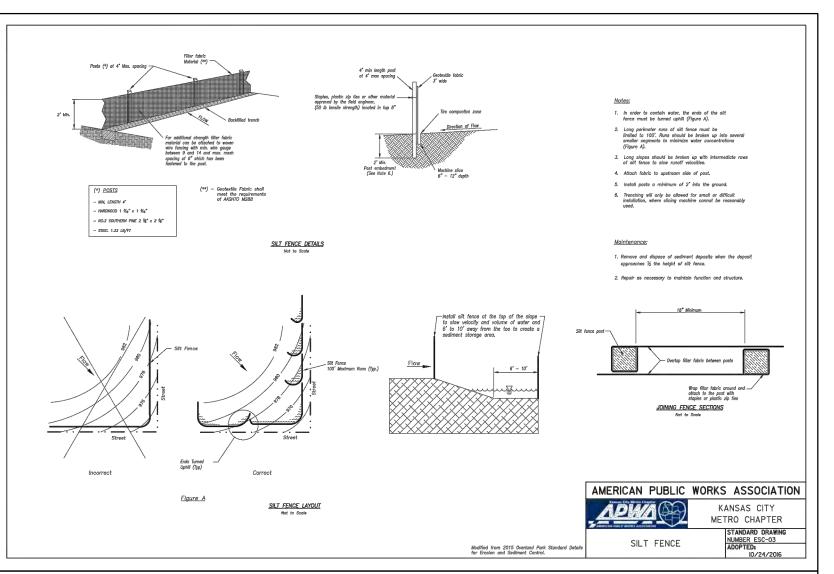

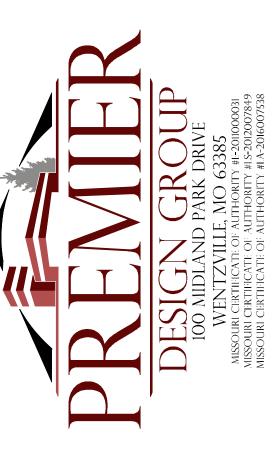



engineering plans involved in this project and specifically exclude PROFESSIONAL ENGINEER

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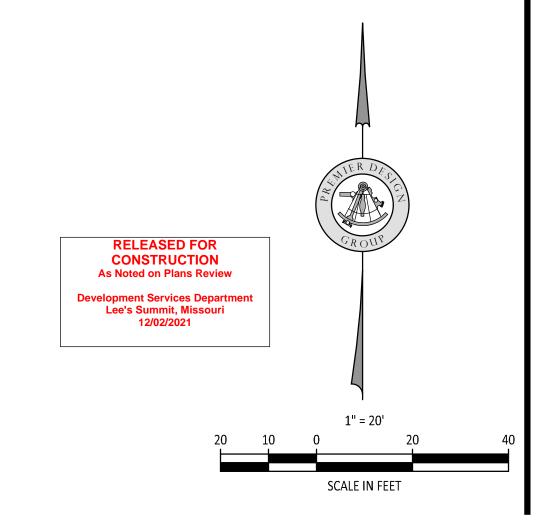
2109720 A. JONES M. FOGARTY Checked By


STORM SEWER PROFILE 201 CI TO 200 CI 1"=20' HORIZONTAL 1"=10' VERTICAL


STORM SEWER PROFILE 101 MH TO 100 CI 1"=20' HORIZONTAL 1"=10' VERTICAL


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	2	201-200	104 CI	98.19	15	1000.5	998.54	2	1006.5	1006.88	0.86**	1001.37	999.14	5.14	-87.844	7.89	0.39	1.00 z	0	0.39	9.88	4.56	4.56	0.02	100	4.56	0	0	n/a

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1	101-100	101 CI	39.877	12	1001.5	1000.7	2	1006.44	1007.12	0.91**	1002.41	1001.45	4.03	-87.458	7.88	0.67	1.00 z	0	n/a	5.46	4.95	4.95	0.02	100	4.95	0	0	n/a
2	201-200	104 CI	98.19	15	1000.5	998.54	2	1006.5	1006.88	1.05**	1001.55	999.3	4.95	-87.844	8.69	0.6	1.00 z	0	n/a	9.88	6.84	6.84	0.02	100	6.84	0	0	n/a



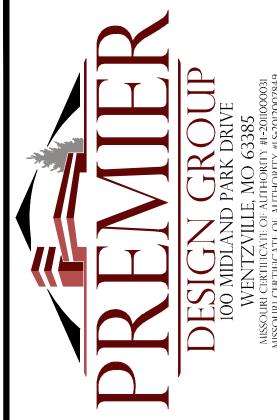

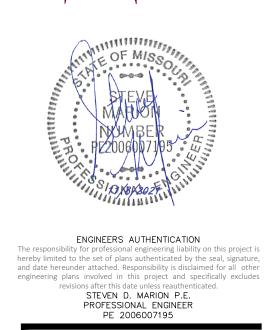

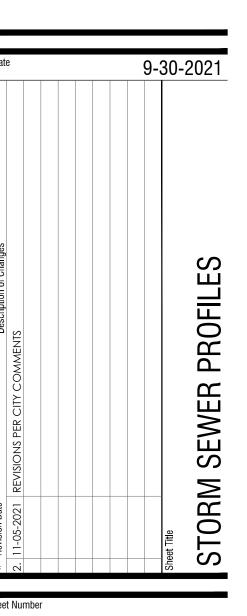

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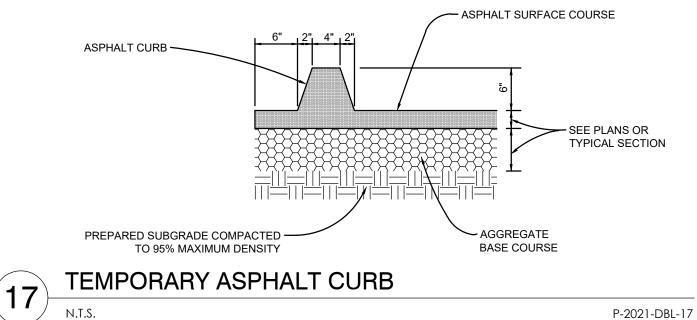
ISSUED FOR CONSTRUCTION


M. FOGARTY

Checked By

UNDERGROUND UTILITIES AND OSHA SAFETY NOTE:

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CROSS STRIPING DETAIL


- NON REFLECTIVE NON REFLECTIVE AISLES SHALL BE MARKED USING HIGH VISIBILITY YELLOW PAINT IN ACCORDANCE WITH ADA AND THE IAC AND OTHER APPLICABLE FEDERAL OR STATE STANDARDS AND REQUIREMENTS, STRIPING VENDOR SHALL VERIFY LOCAL DO NOT APPLY PAVEMENT-MARKING PAINT UNTIL LAYOUT, COLORS, AND PLACEMENT HAVE BEEN VERIFIED WITH 5. APPLY PAINT WITH MECHANICAL EQUIPMENT TO PRODUCE PAVEMENT MARKINGS WITH UNIFORM STRAIGHT EDGES. APPLY AT MANUFACTURER'S RECOMMENDED RATES TO PROVIDE MINIMUM WET FILM THICKNESS OF 15 MILS (0.4 6. 4" WIDE STRIPES IN ACCESS AISLES SHALL BE 2' ON CENTER. 4" OR 8" SEE PLAN
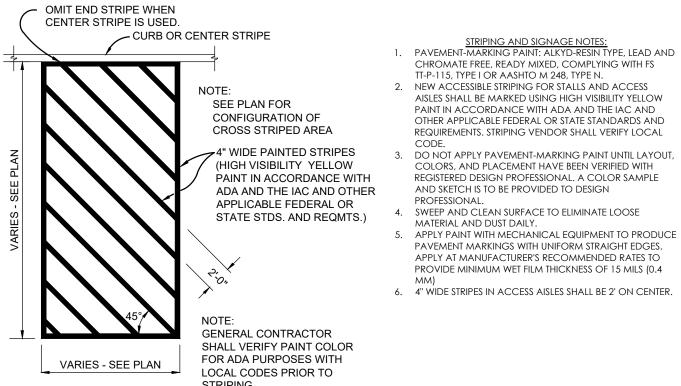
> PAINT SHALL BE APPLIED AT A THICKNESS OF 22 WET MILS AND 15 DRY MILS. YELLOW PAINT SHALL BE USED ON CONCRETE PAVEMENT/WHITE PAINT SHALL BE USED ON ASPHALT PAVEMENT TYPICAL PAVEMENT MARKINGS DETAIL

TYPICAL ARROW

TYPICAL LETTER

TYPICAL PAVEMENT STRIPING

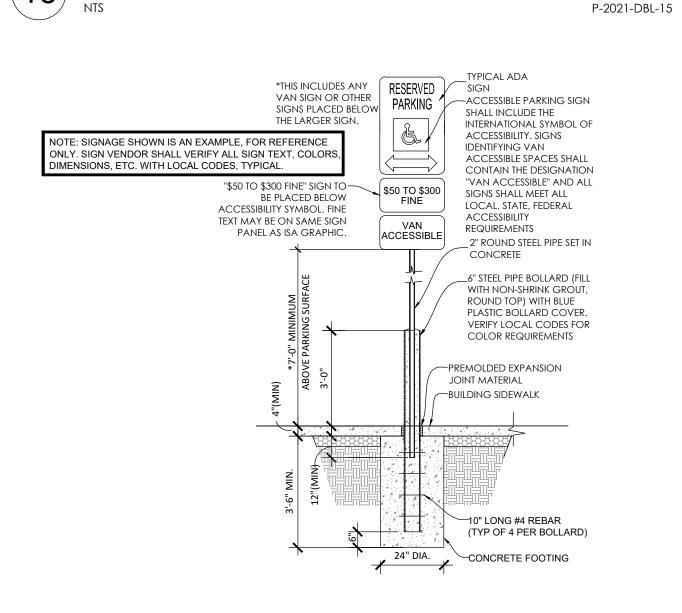


TE: SIGNAGE SHOWN IS AN EXAMPLE, FOR REFERENCE ONLY. SIGN VENDOR SHALL VERIFY ALL SIGN TEXT, COLOR


DIMENSIONS, ETC. WITH LOCAL CODES TYPICAL

6" x ¾" DRAINAGE SLOT. (2 EACH) PAVEMENT AT FINISHED GRADE ¾" ROUND STEEL DOWEL. 3 EACH) MINIMUM 12" L SECTION AA 6" x ¾" DRAINAGE ~ SLOT. (2 EACH) CURB OR STRIPE -Α 🚤 FACE OF CURB TO FACE OF WHEEL STOP CENTERED IN STALL WIDTH PER PLAN PLAN VIEW

PRECAST WHEEL STOP DETAIL

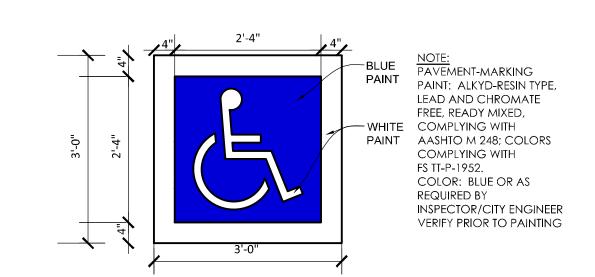


ACCESSIBLE PARKING SYMBOL

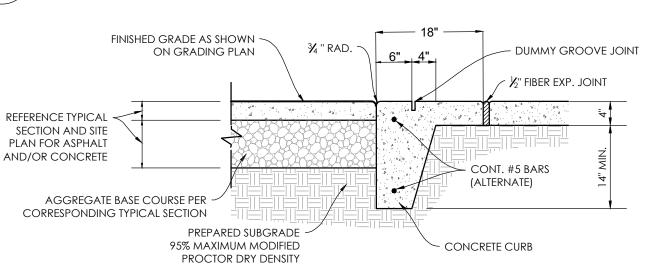


P-2021-DBL-16


FLUSH PAVEMENT AT SIDEWALK DETAIL P-2021-DBL-11

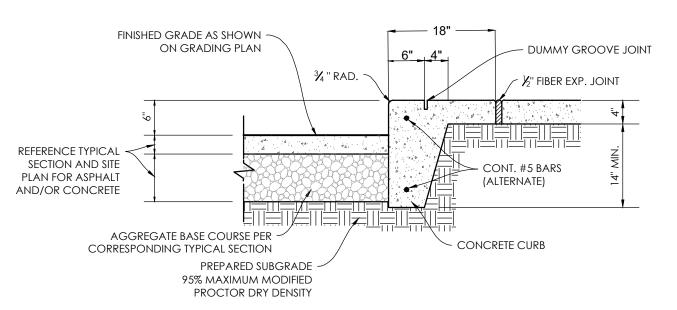

VERTICAL CONCRETE CURB WITH SIDEWALK DETAIL P-2021-DBL-10

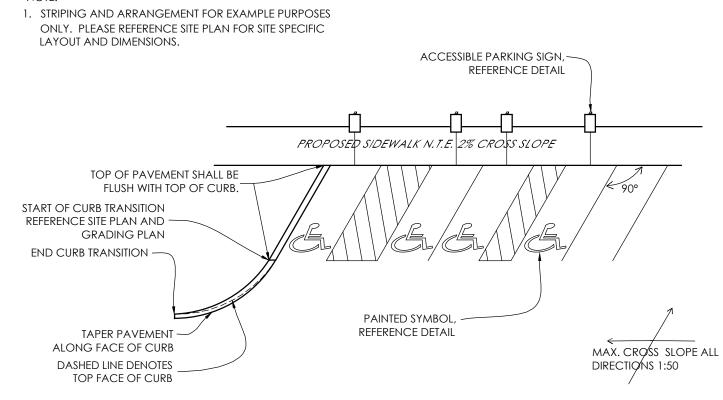



CURB TRANSITION DETAIL P-2021-DBL-08

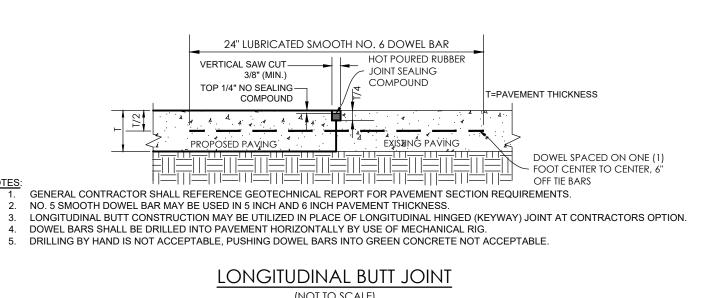



(NOT TO SCALE) ½" EXPANSION JOINT 16'-0" O.C JOINTS TO MATCH SIDEWALK WIDTH (SEE DETAIL) CEMENT - 4" AGGREGATE BASE (ODOT TYPE A) CONCRETE SECTION

CONCRETE SIDEWALK DETAIL P-2021-DB-08

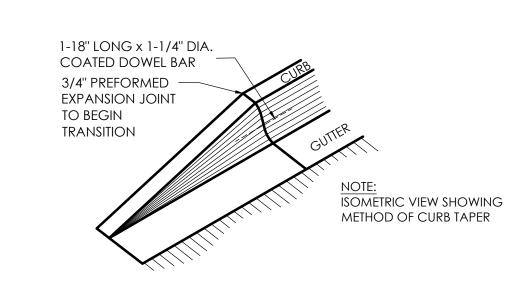


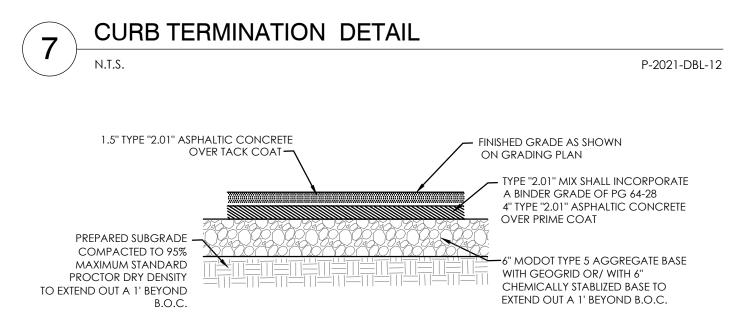


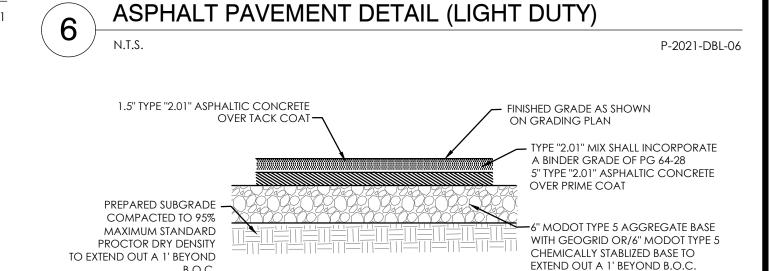


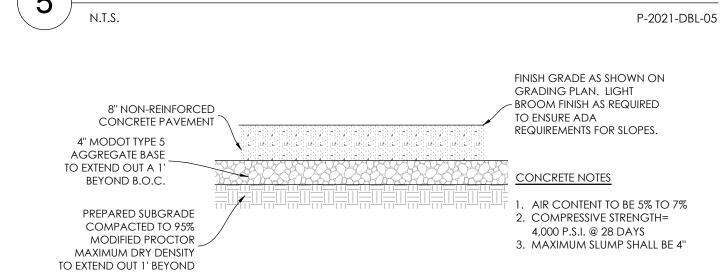


ASPHALT PAVEMENT DETAIL (MEDIUM DUTY)

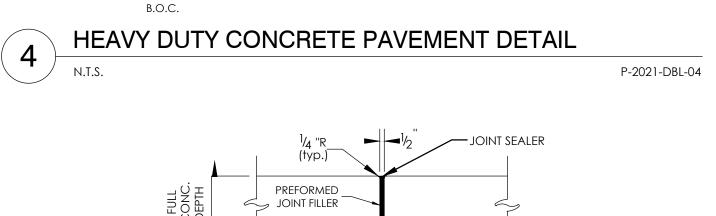

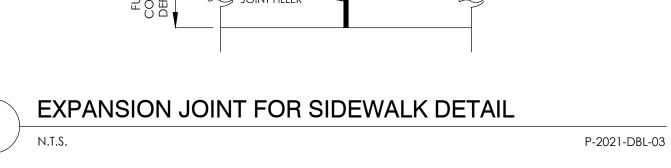


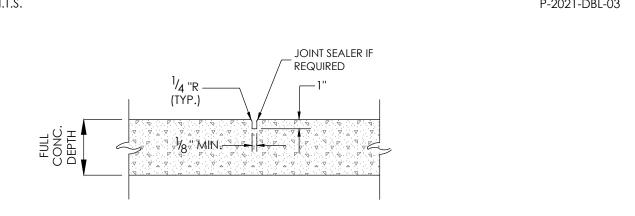

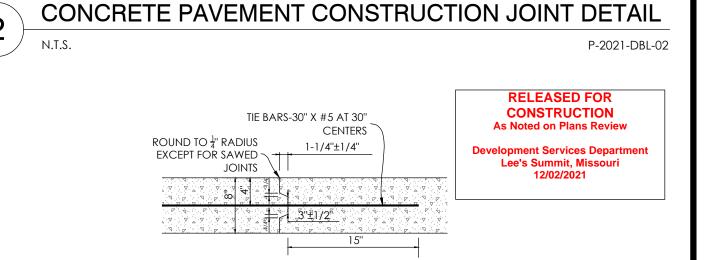

KEYWAY FOR CONCRETE PAVEMENT DETAIL P-2021-DBL-01

ENGINEERS AUTHENTICATION engineering plans involved in this project and specifically excludes PROFESSIONAL ENGINEER
PE 2006007195

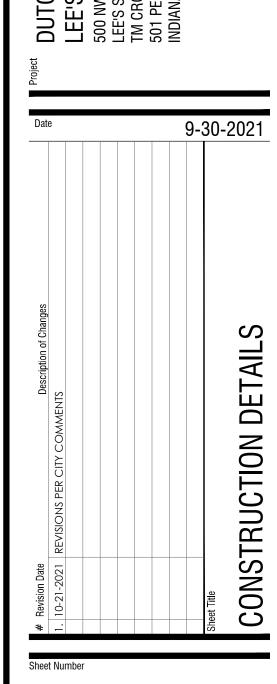

ACCESSIBLE PARKING SIGN

P-2021-DBL-14

P-2021-DBL-09

P-2021-DBL-13

Drawn By Checked By


ISSUED FOR CONSTRUCTION


C-600

2109720

A. JONES

M. FOGARTY

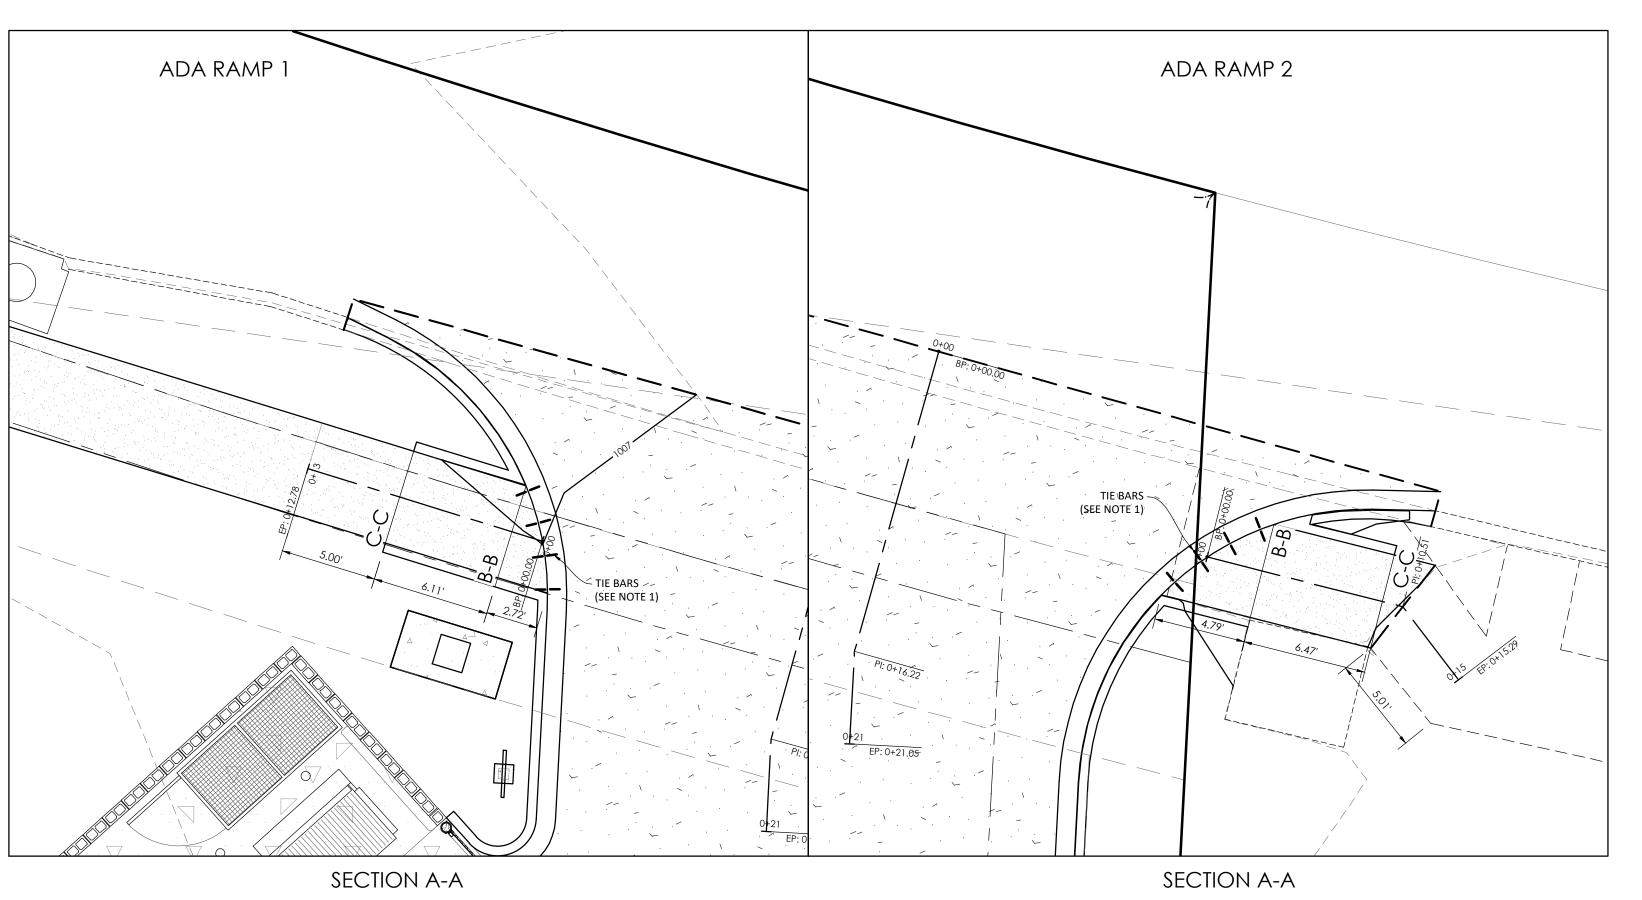

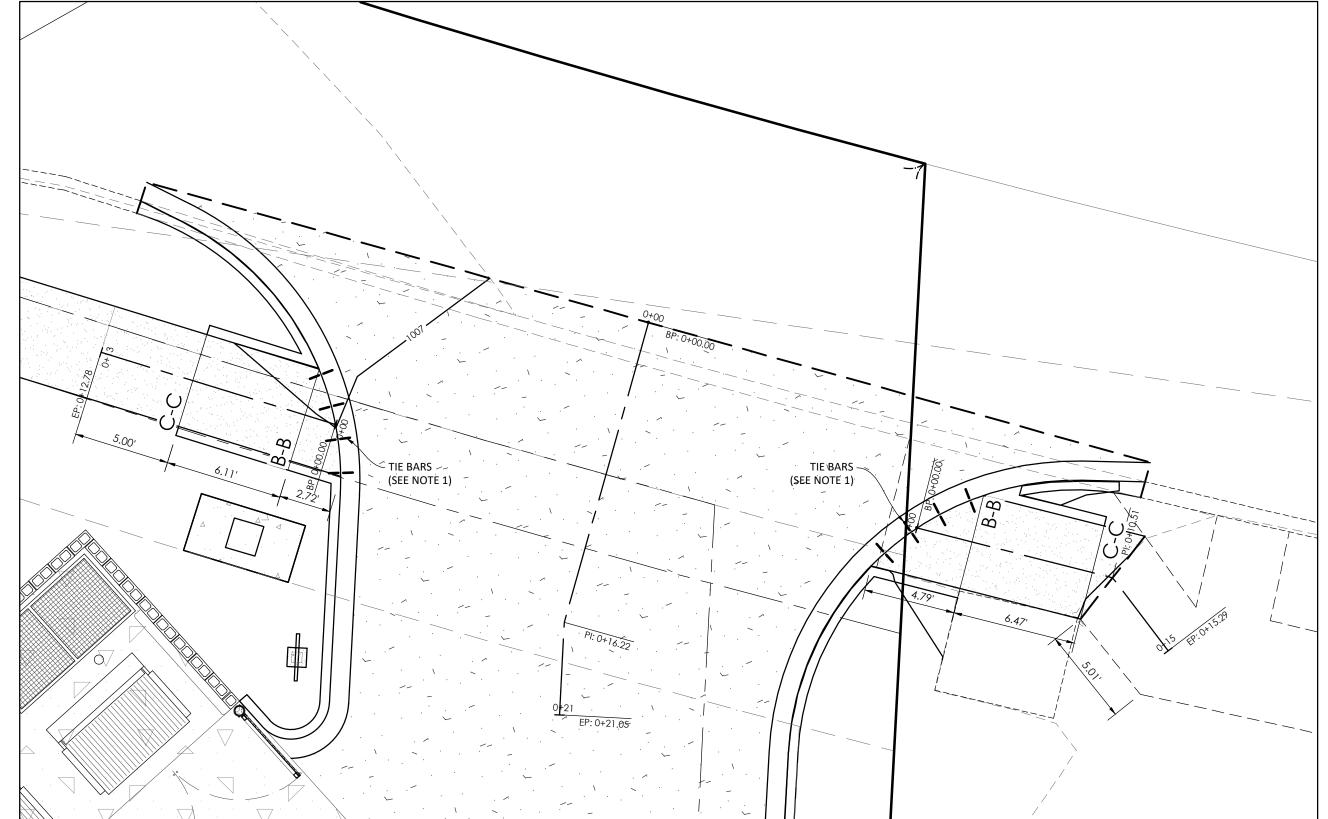

STA:0+00.00

ELEV:1007.12

0+00

ALL WILL BE REJECTED.

0+05

2. ADA MAXIMUM RAMP SLOPE = 8.33%

ADA MAXIMUM CROSS SLOPE = 2.0%

1005

STA:0+05.61_

STA:0+11.45

ELEV:1007.32

0+10

SIDEWALK/SHARED-USE PATH & SIDEWALK/SHARED-USE RAMP NOTES:

STA:0+16.22 STA:0+21.05

ELEV:1007.41 ELEV:1007.54

∽ 6" MODOT TYPE 5

AGGREGATE BASE SEE

DETAIL 6 ON SHEET C-601

0+15

0+20

USE 18" LONG #4 EPOXY COATED TIE BARS @ 24" O.C. EMBED TIE BARS 9" IN EACH DIRECTION

4. DURING INSPECTION PROCESS, SIDEWALKS THAT EXCEED THE MAXIMUM ALLOWABLE SLOPES AT


~ 1.5" TYPE "2.01" ASPHALT

5" TYPE "2.01" ASPHALT


0+25


SURFACE COURSE


BASE COURSE

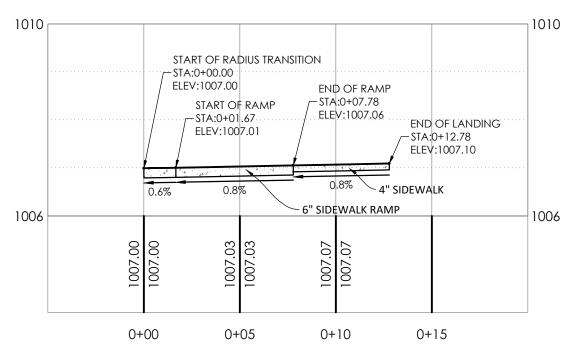


SECTION B-B

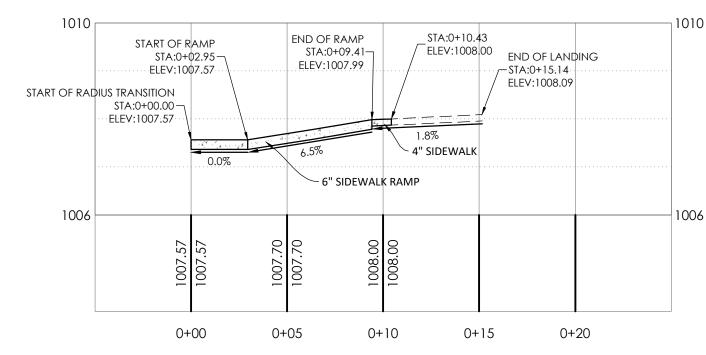


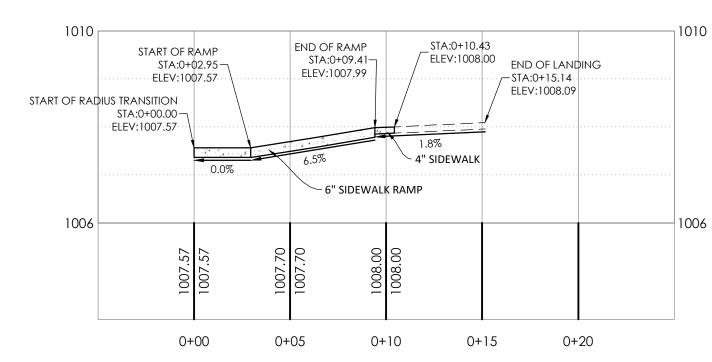

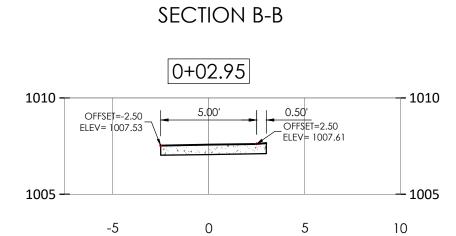

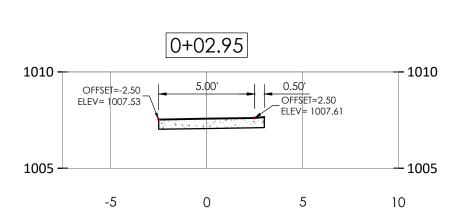



SECTION C-C

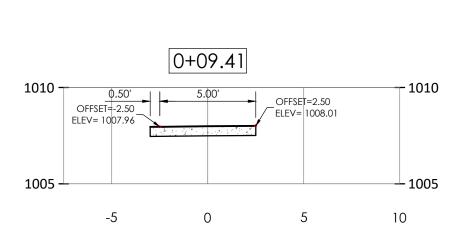






SECTION C-C

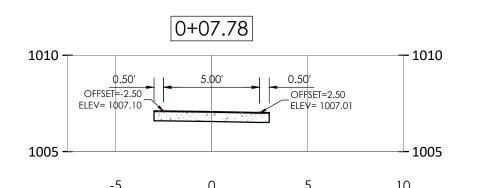

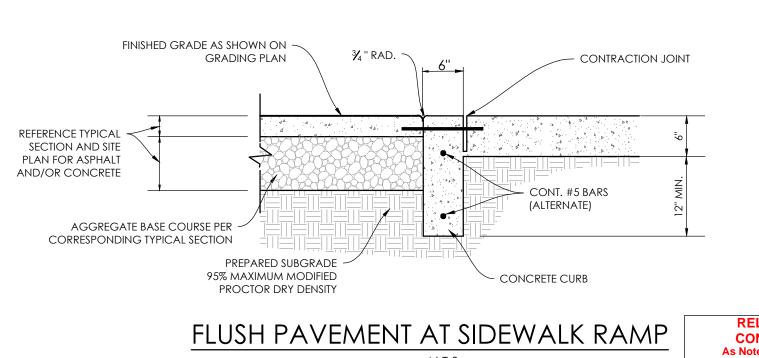


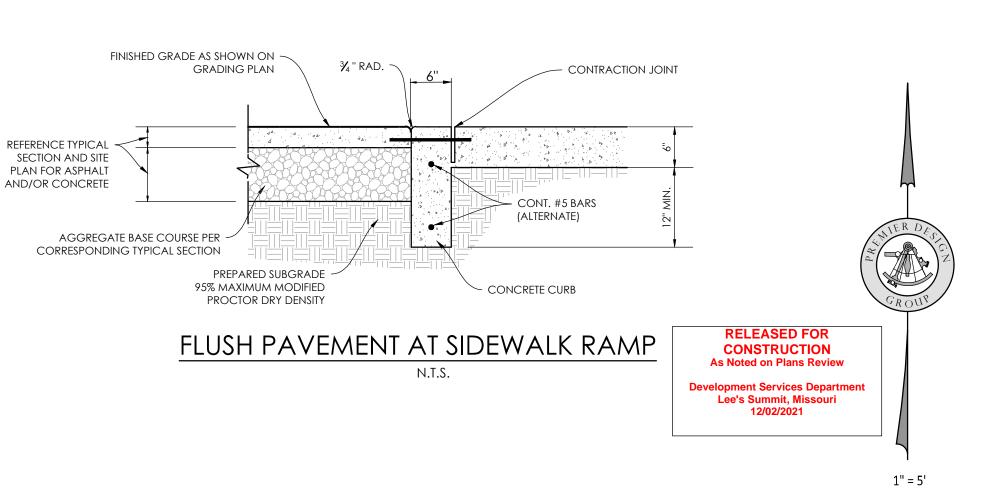

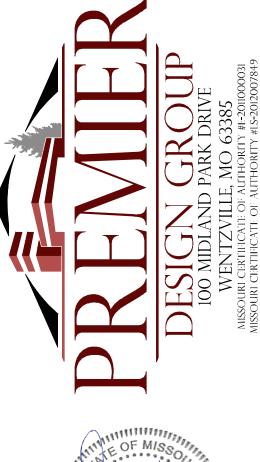

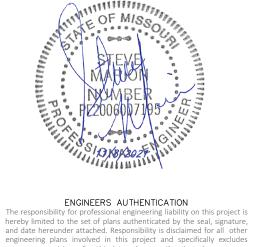

STEVEN D. MARION P.E.
PROFESSIONAL ENGINEER
PE 2006007195

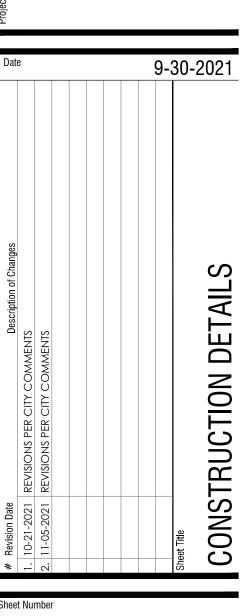

C-601

ISSUED FOR CONSTRUCTION

Drawn By

SCALE IN FEET


Checked By

2109720


A. JONES


M. FOGARTY


UNDERGROUND UTILITIES AND OSHA SAFETY NOTE: Underground utilities and structures have been plotted from available information and therefore, their location must be considered approximate only. It is the responsibility of the individual contractors to notify the utility companies before actual construction. All O.S.H.A rules and regulations established for the type of construction required by these plans shall be strictly followed (ie. trenching, blasting, etc.)

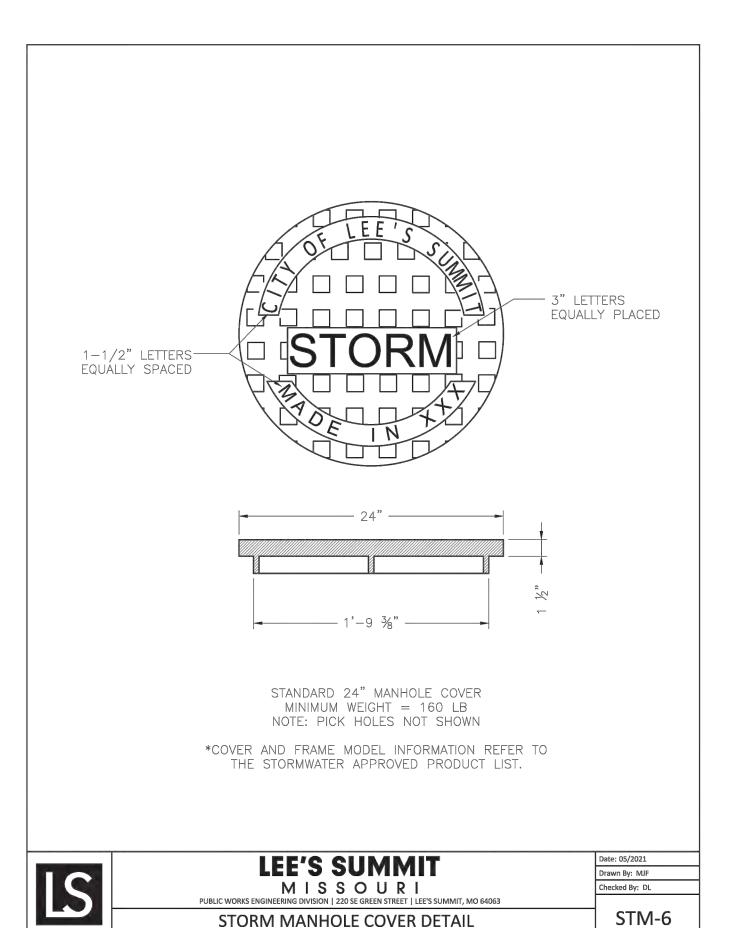



STORM MANHOLE COVER DETAIL

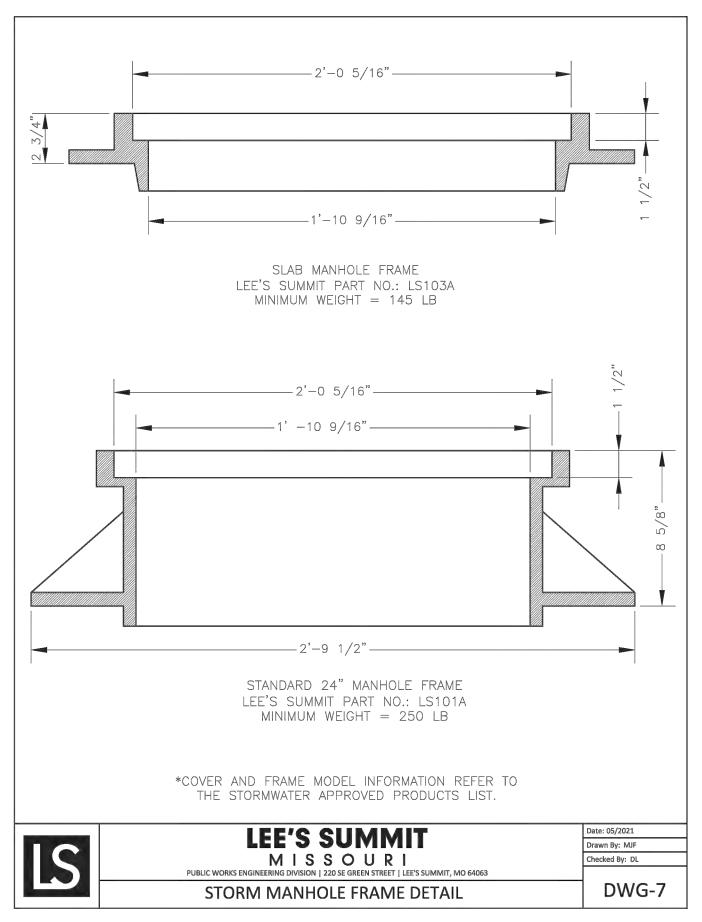


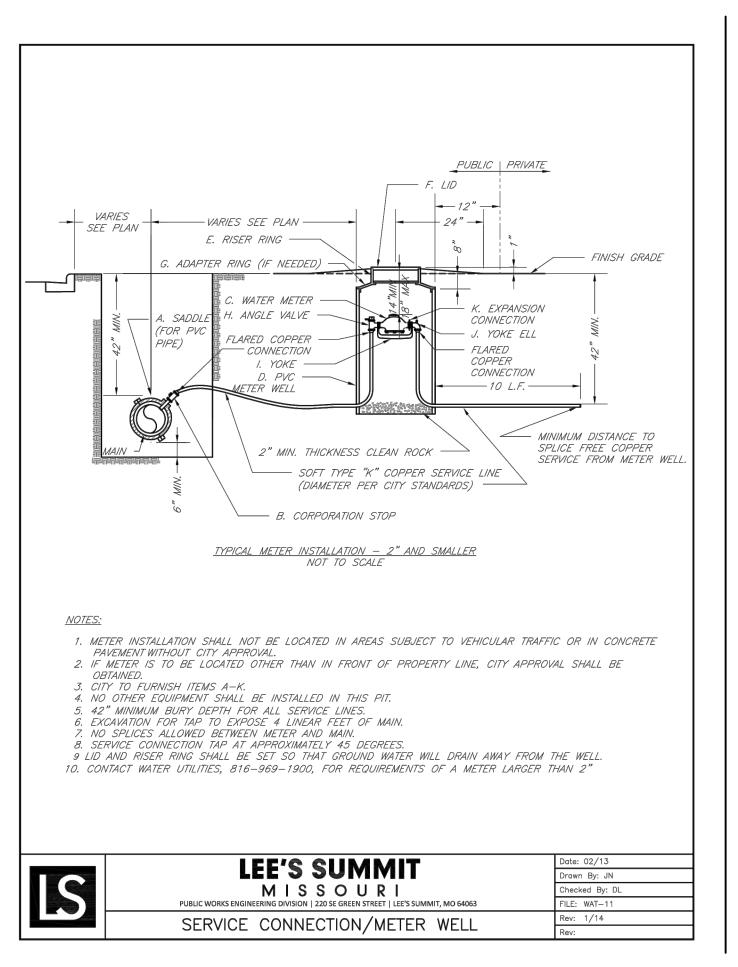

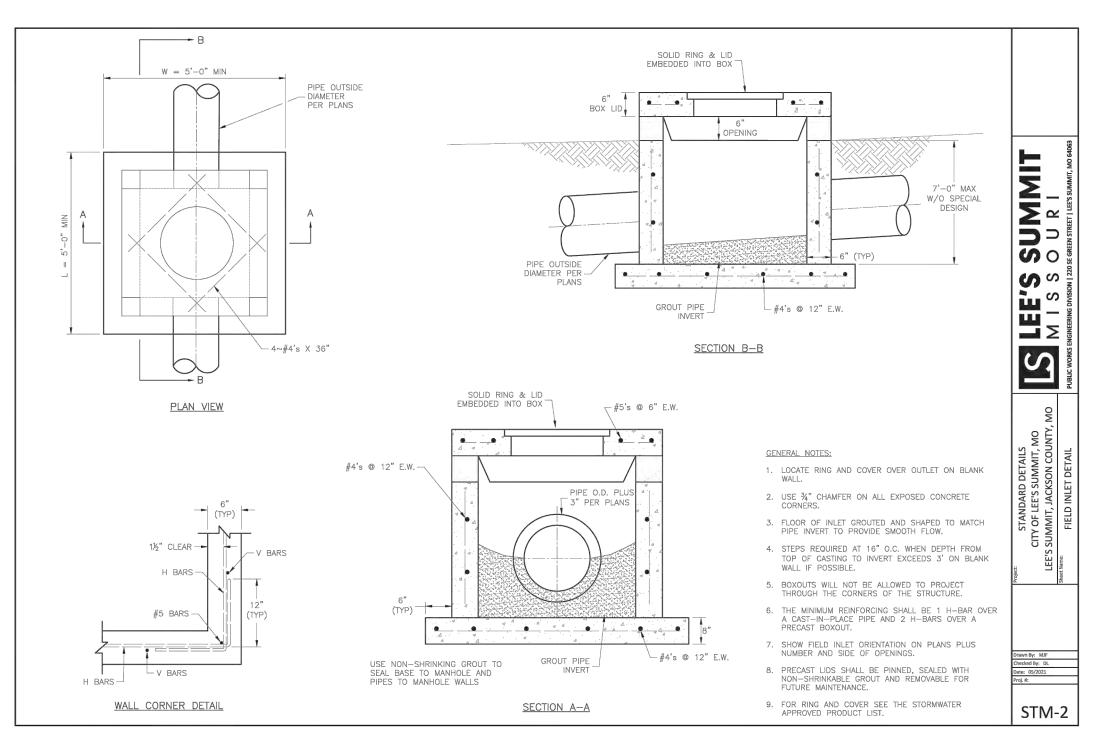

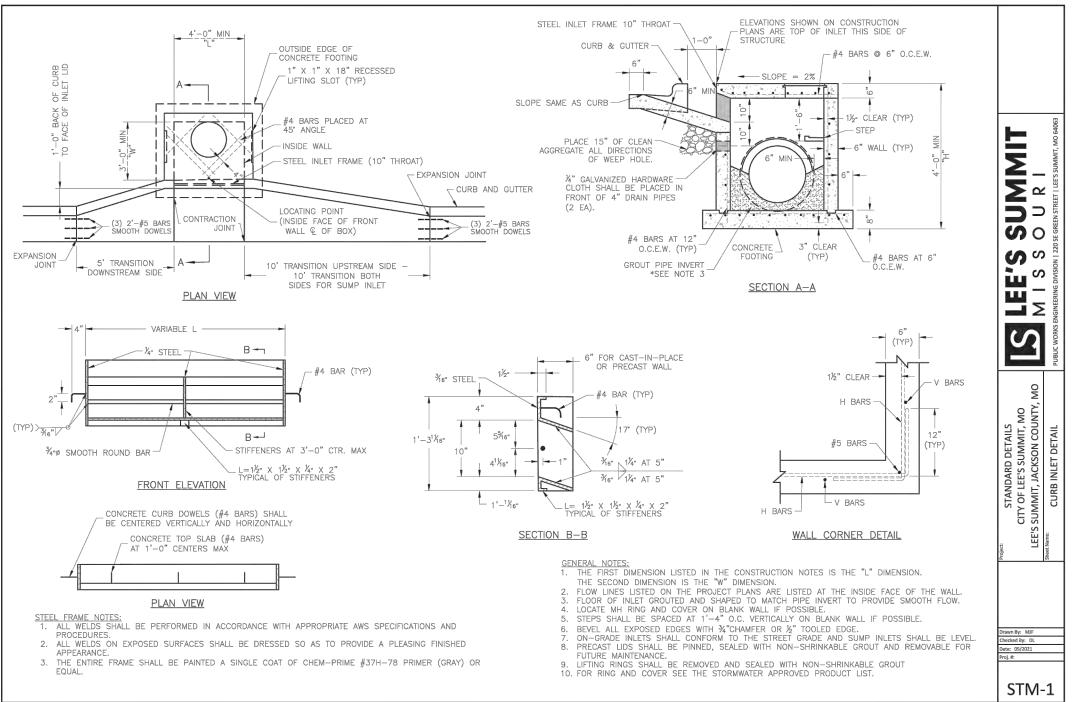

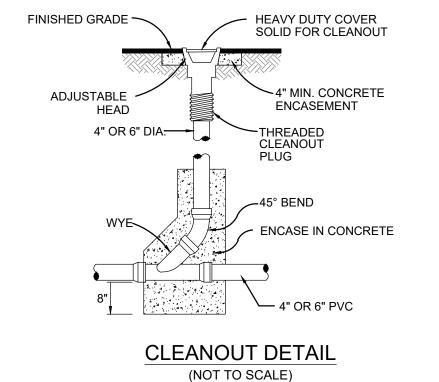

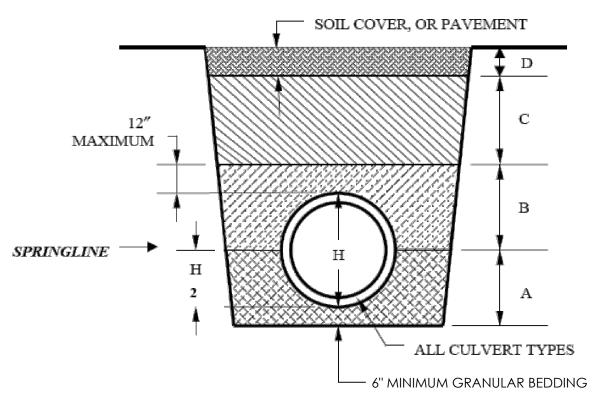


A – Consolidated granular bedding material.


B – Consolidated granular bedding material, flowable backfill (CLSM), or compacted soil – compacted to 90% of maximum density using ASTM D 698. Maximum lift thickness for the granular or soil materials shall be six inches.

C – Consolidated granular bedding material, flowable backfill (CLSM), or compacted soil – compact to approximate density of adjacent soil but not less than 90% of maximum density using ASTM D 698. Lift thickness shall not exceed the capability of the equipment being utilized to achieve the proper density and consolidation; however, in no case shall it exceed six inches for soil.

D – Soil Cover – Soil cover shall be as specified in Section 2102.7. The top twelve inches shall be consolidated soil; the top six inches shall be topsoil suitable for sustaining grass.

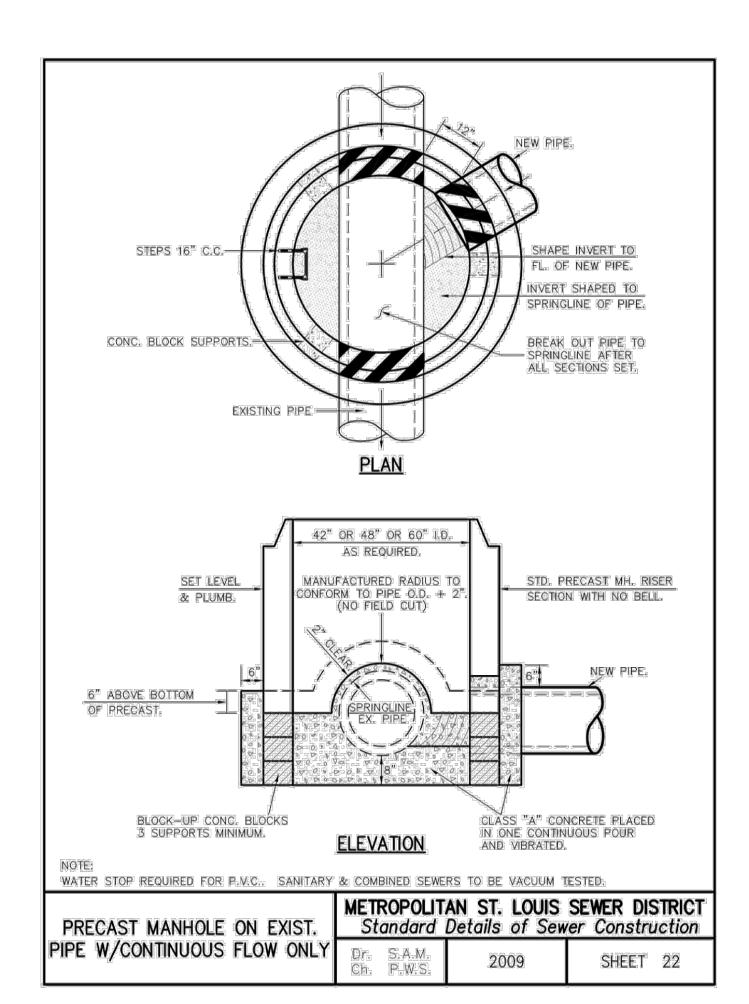




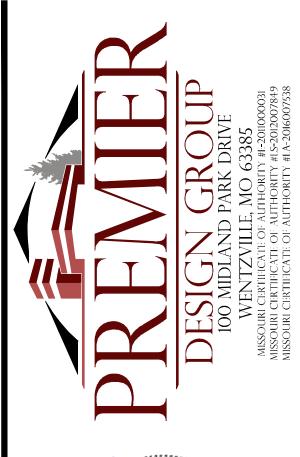



PROFESSIONAL ENGINEER
PE 2006007195



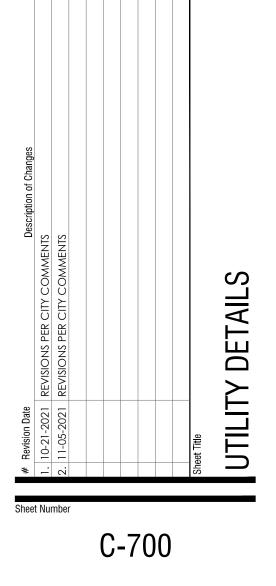

2109720 A. JONES Drawn By M. FOGARTY Checked By

CORRECTED SUMMIT ORCHARD, LOTS 4A-4E, LOT 4B TOWNSEND SUMMIT LLC DOC. #2019E0068481 4'x3' CONC. CURB INLET TOP ELEV=1007.04 € OUT(NNE)18" HDPE=1002.62 AREA B TO EX. CI 0.07 AC @ CN=98 AREA A EXISTING CONDITIONS SUMMIT ORCHARD, LOT 4C-1, 4C-2 and 4C-3, CORRECTED SUMMIT 1.56 AC @ CN=74 orchard, lots 4a-4e TOWNSEND SUMMIT LLC DOC. #2019E0068481 TOWNSEND SUMMIT LLC DOC. #2019E0068481 PROPOSED LIMITS OF DISTURBANCE (TYP.) CORRECTED SUMMIT ORCHARD, LOTS 4A-4E, F#----AREA INLET TOP ELEV=1004.79 6'x4' CONC. CURB INLET TOP ELEV=1004.11 F. IN(E)15" RCP=998.91 F. OUT(W)15" RCP=998.76 6'x4' CONC. CURB INLET TOP ELEV=1007.21 € IN(N)15" RCP=1003.33 € OÙT(W)15" HDPE=1002.86 ENW CHIPMAN ROAD UNDERGROUND UTILITIES AND OSHA SAFETY NOTE: information and therefore, their location must be considered approximate only. It is the responsibility of the individual contractors to notify the utility companies before actual construction. All O.S.H.A rules and regulations established for the type of construction required by these plans shall be strictly followed (ie. trenching, blasting, etc.)

THIS PLAN IS FOR DRAINAGE PURPOSES AND REFERENCE ONLY. DO NOT USE FOR CONSTRUCTION.

MINIMUM TIME OF CONCENTRATION = 5 MINUTES

EXISTING SOILS TYPE = C

CN PVMT = 98

CN GRASS = 74


CN COMMERCIAL AREAS = 94

MASTER DRAINAGE PLAN NOTES


- 1. MBOE (MINIMUM BUILDING OPENING ELEVATION) ELEV = 1008.00
- THE INDIVIDUAL LOT OWNER(S) SHALL NOT CHANGE OR OBSTRUCT THE OVERALL DRAINAGE FLOW LINES OR PATHS ON THE LOT AS SHOWN ON THE MASTER DRAINAGE PLAN, UNLESS SPECIFIC APPLICATION IS MADE AND APPROVED BY THE CITY ENGINEER.

EXISTING RUNOFF TABLE

RUNOFF TABLE
EXISTING Q (CFS)
3.46
7.31
12.87
0.39
0.59
0.86

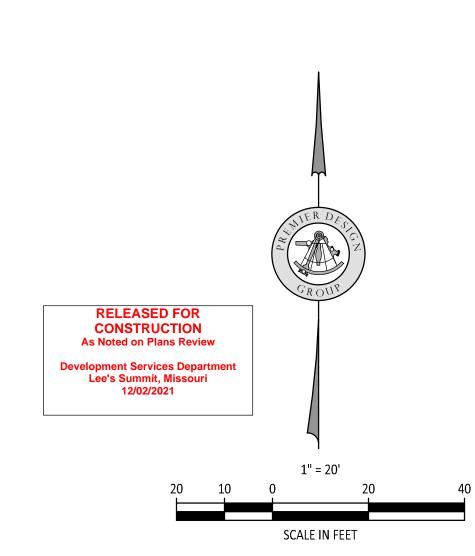



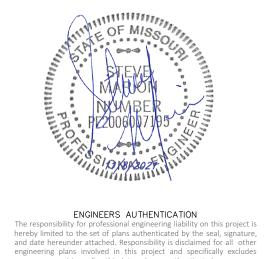

revisions after this date unless reauthenticated.
STEVEN D. MARION P.E.
PROFESSIONAL ENGINEER
PE 2006007195

LEE'S SUMMIT, MO
500 NW CHIPMAN RD.
LEE'S SUMMIT, MO 64086
TM CROWLEY
501 PENNSYLVANIA PARKWAY SUITE 160
INDIANAPOLIS, IN 46280

Sheet Title

EXISTING DRAINAGE AREA MAP


C-800

 Project No.
 2109720

 Drawn By
 A. JONES

 Checked By
 M. FOGARTY

 ISSUED FOR CONSTRUCTION

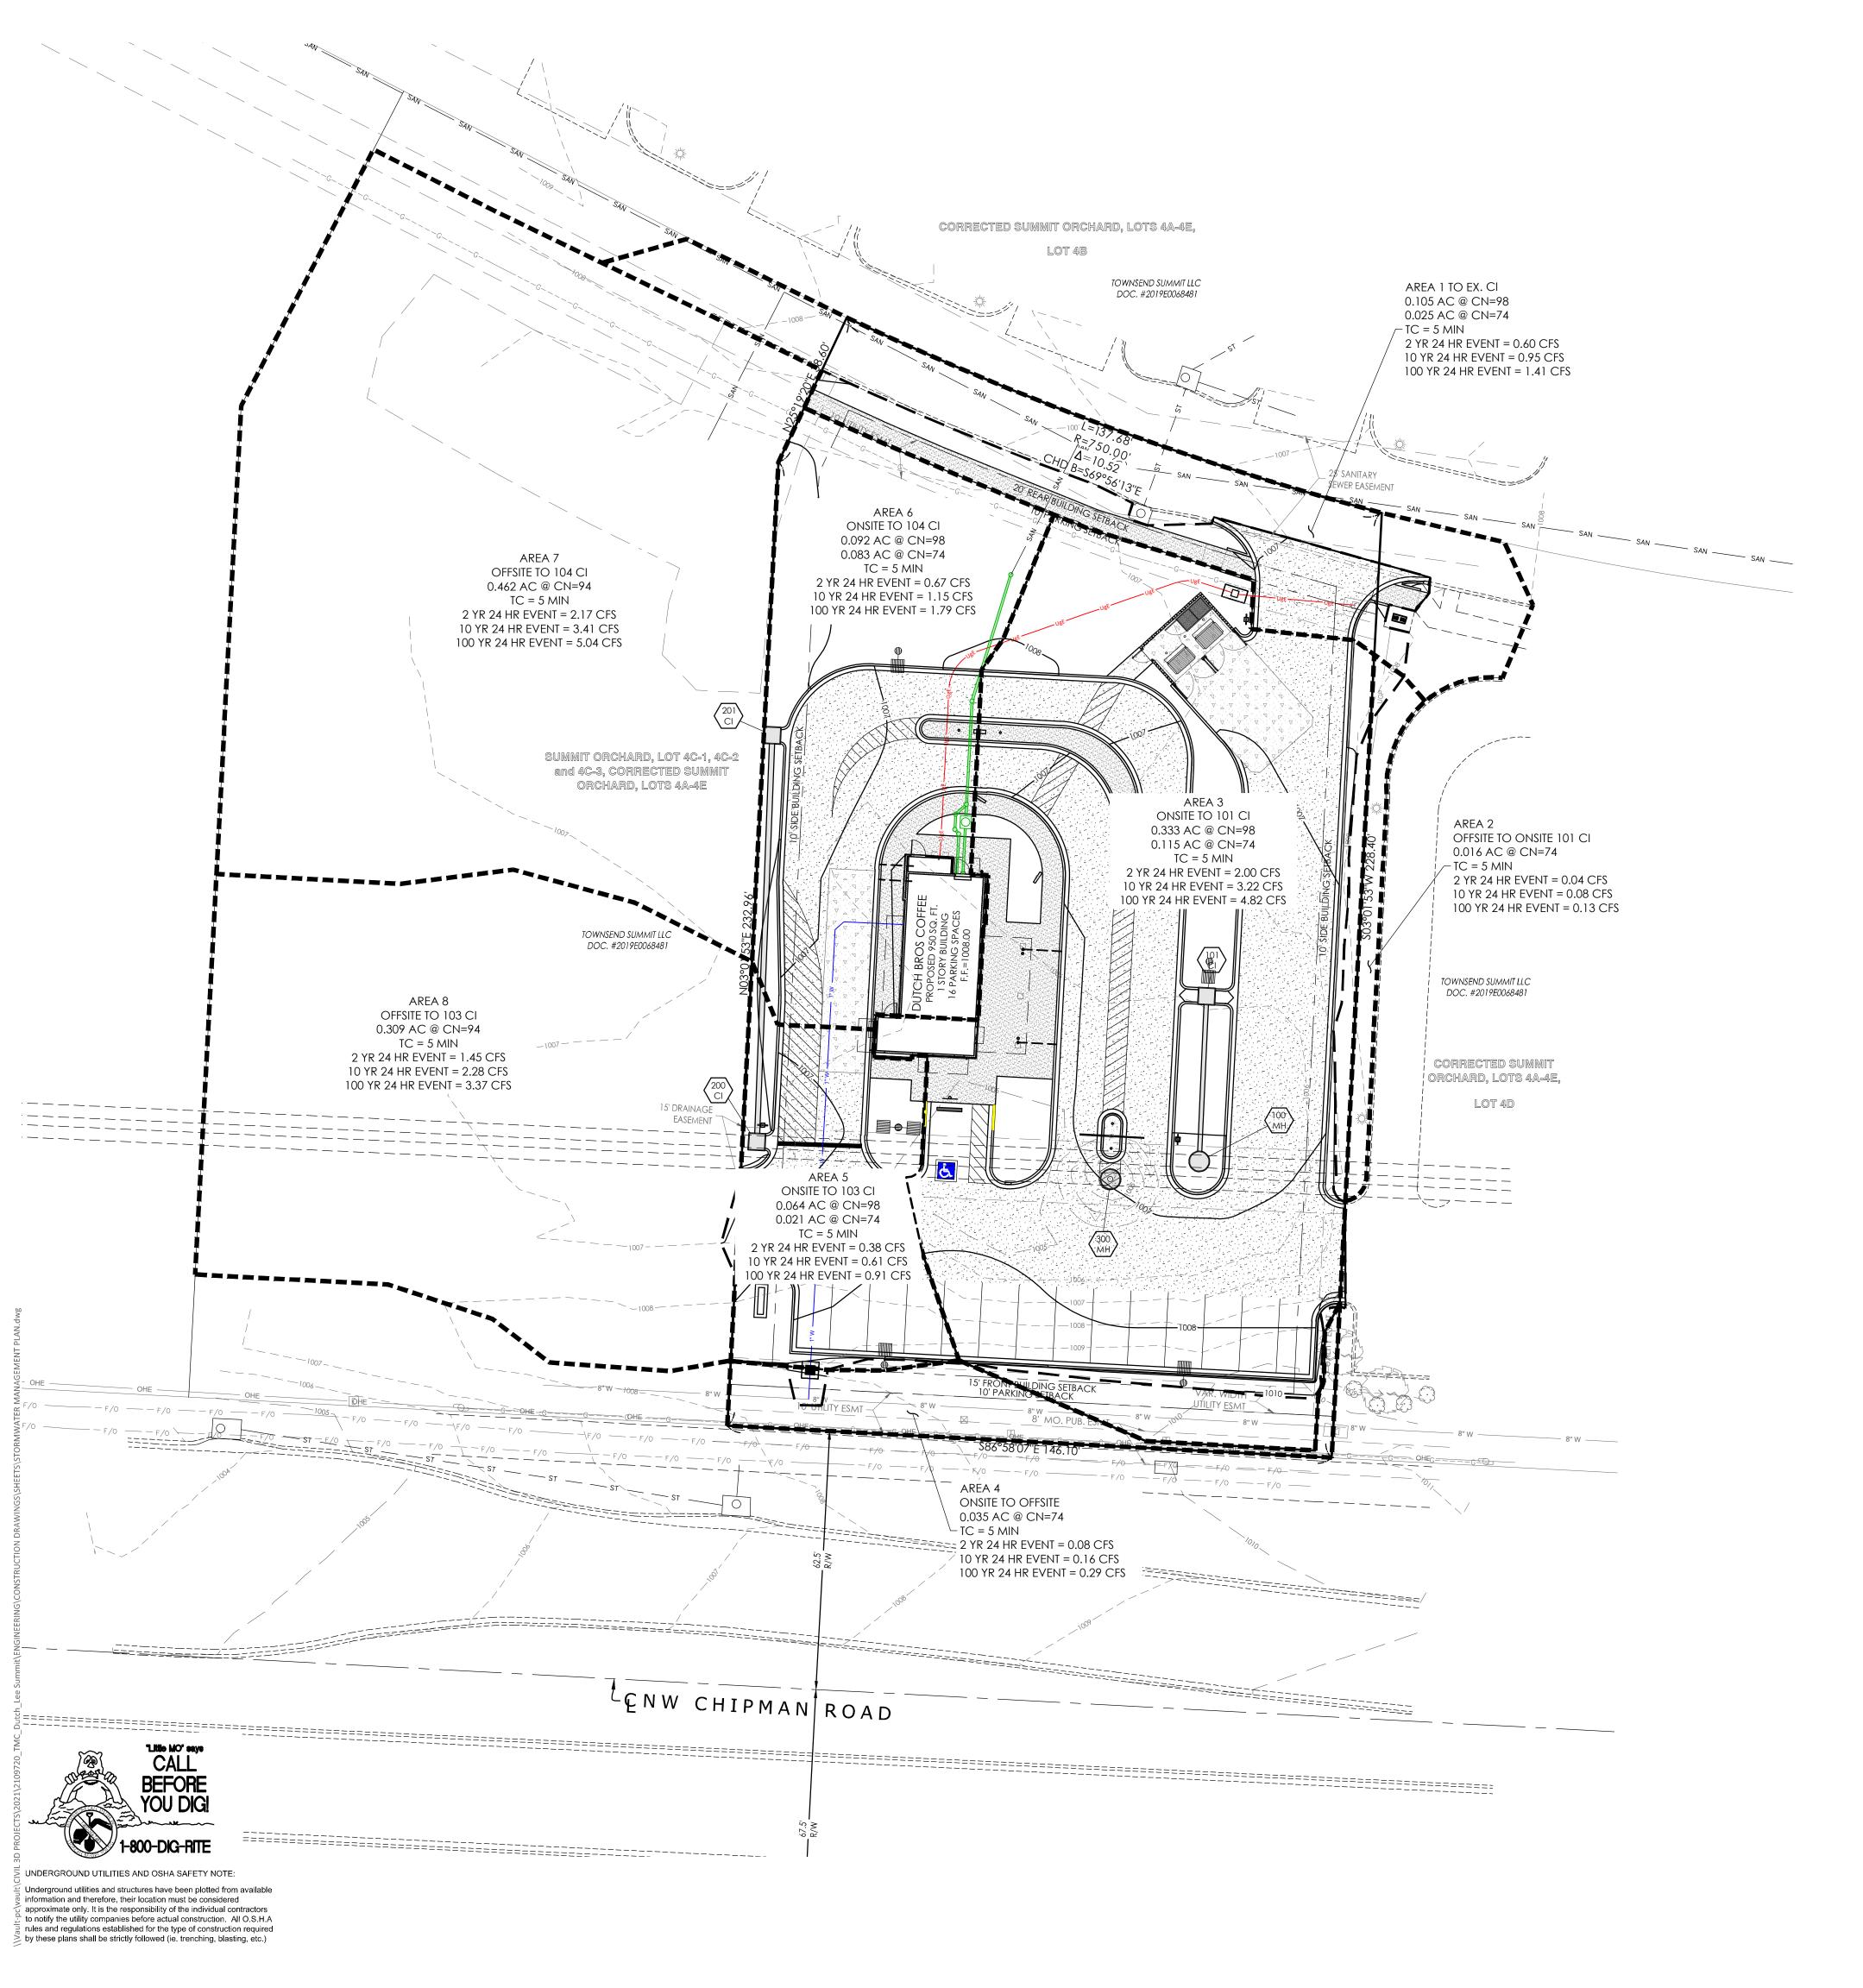

MINIMUM TIME OF CONCENTRATION = 5 MINUTES EXISTING SOILS TYPE = C

EXISTING SOILS TYPE = CCN PVMT = 98


CN GRASS = 74 CN COMMERCIAL AREAS = 94


MASTER DRAINAGE PLAN NOTES


1. MBOE - (MINIMUM BUILDING OPENING ELEVATION)
ELEV = 1008.00

 THE INDIVIDUAL LOT OWNER(S) SHALL NOT CHANGE OR OBSTRUCT THE OVERALL DRAINAGE FLOW LINES OR PATHS ON THE LOT AS SHOWN ON THE MASTER DRAINAGE PLAN, UNLESS SPECIFIC APPLICATION IS MADE AND APPROVED BY THE CITY ENGINEER.

Row Labels	Peak Runoff (cfs)	Impervious Area	Pervious Area	Total Area	Composite CN	TC
AREA 1						
2-Year	0.60	0.105	0.025	0.13	93	5
10-Year	0.95	0.105	0.025	0.13	93	5
100-Year	1.41	0.105	0.025	0.13	93	5
AREA 2						
2-Year	0.04	0	0.016	0.016	74	5
10-Year	0.08	0	0.016	0.016	74	5
100-Year	0.13	0	0.016	0.016	74	5
AREA 3						
2-Year	2.00	0.333	0.115	0.448	92	5
10-Year	3.22	0.333	0.115	0.448	92	5
100-Year	4.82	0.333	0.115	0.448	92	5
AREA 4						
2-Year	0.08	0	0.035	0.035	74	5
10-Year	0.16	0	0.035	0.035	74	5
100-Year	0.29	0	0.035	0.035	74	5
AREA 5						
2-Year	0.38	0.064	0.021	0.085	92	5
10-Year	0.61	0.064	0.021	0.085	92	5
100-Year	0.91	0.064	0.021	0.085	92	5
AREA 6						
2-Year	0.67	0.092	0.083	0.175	87	5
10-Year	1.15	0.092	0.083	0.175	87	5
100-Year	1.79	0.092	0.083	0.175	87	5
AREA 7						
2-Year	2.17	0.462	0	0.462	94	5
10-Year	3.41	0.462	0	0.462	94	5
100-Year	5.04	0.462	0	0.462	94	5
AREA 8						
2-Year	1.45	0.309	0	0.309	94	5
10-Year	2.28	0.309	0	0.309	94	5
100-Year	3.37	0.309	0	0.309	94	5

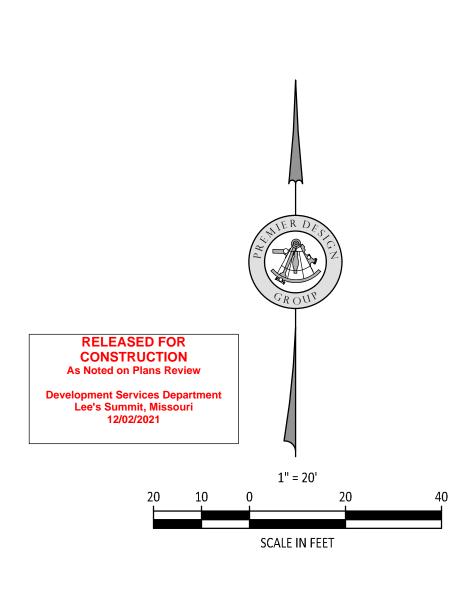

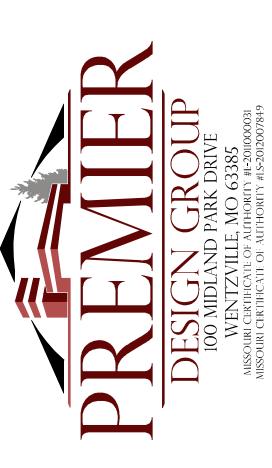

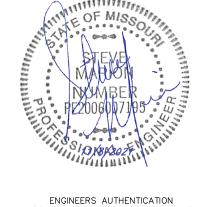

ENGINEERS AUTHENTICATION


The responsibility for professional engineering liability on this project is hereby limited to the set of plans authenticated by the seal, signature, and date hereunder attached. Responsibility is disclaimed for all other engineering plans involved in this project and specifically excludes revisions after this date unless reauthenticated.

STEVEN D. MARION P.E.

PROFESSIONAL ENGINEER

PE 2006007195


500 NW CHIPMAN RD. LEE'S SUMMIT, MO 64086 TM CROWLEY 501 PENNSYLVANIA PARKWAY SUITE 160 INDIANAPOLIS, IN 46280

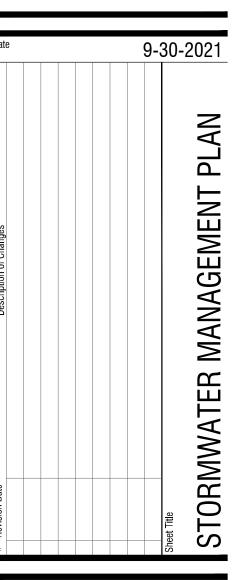

C-801

2109720
A. JONES

wn By A. JONES ecked By M. FOGARTY

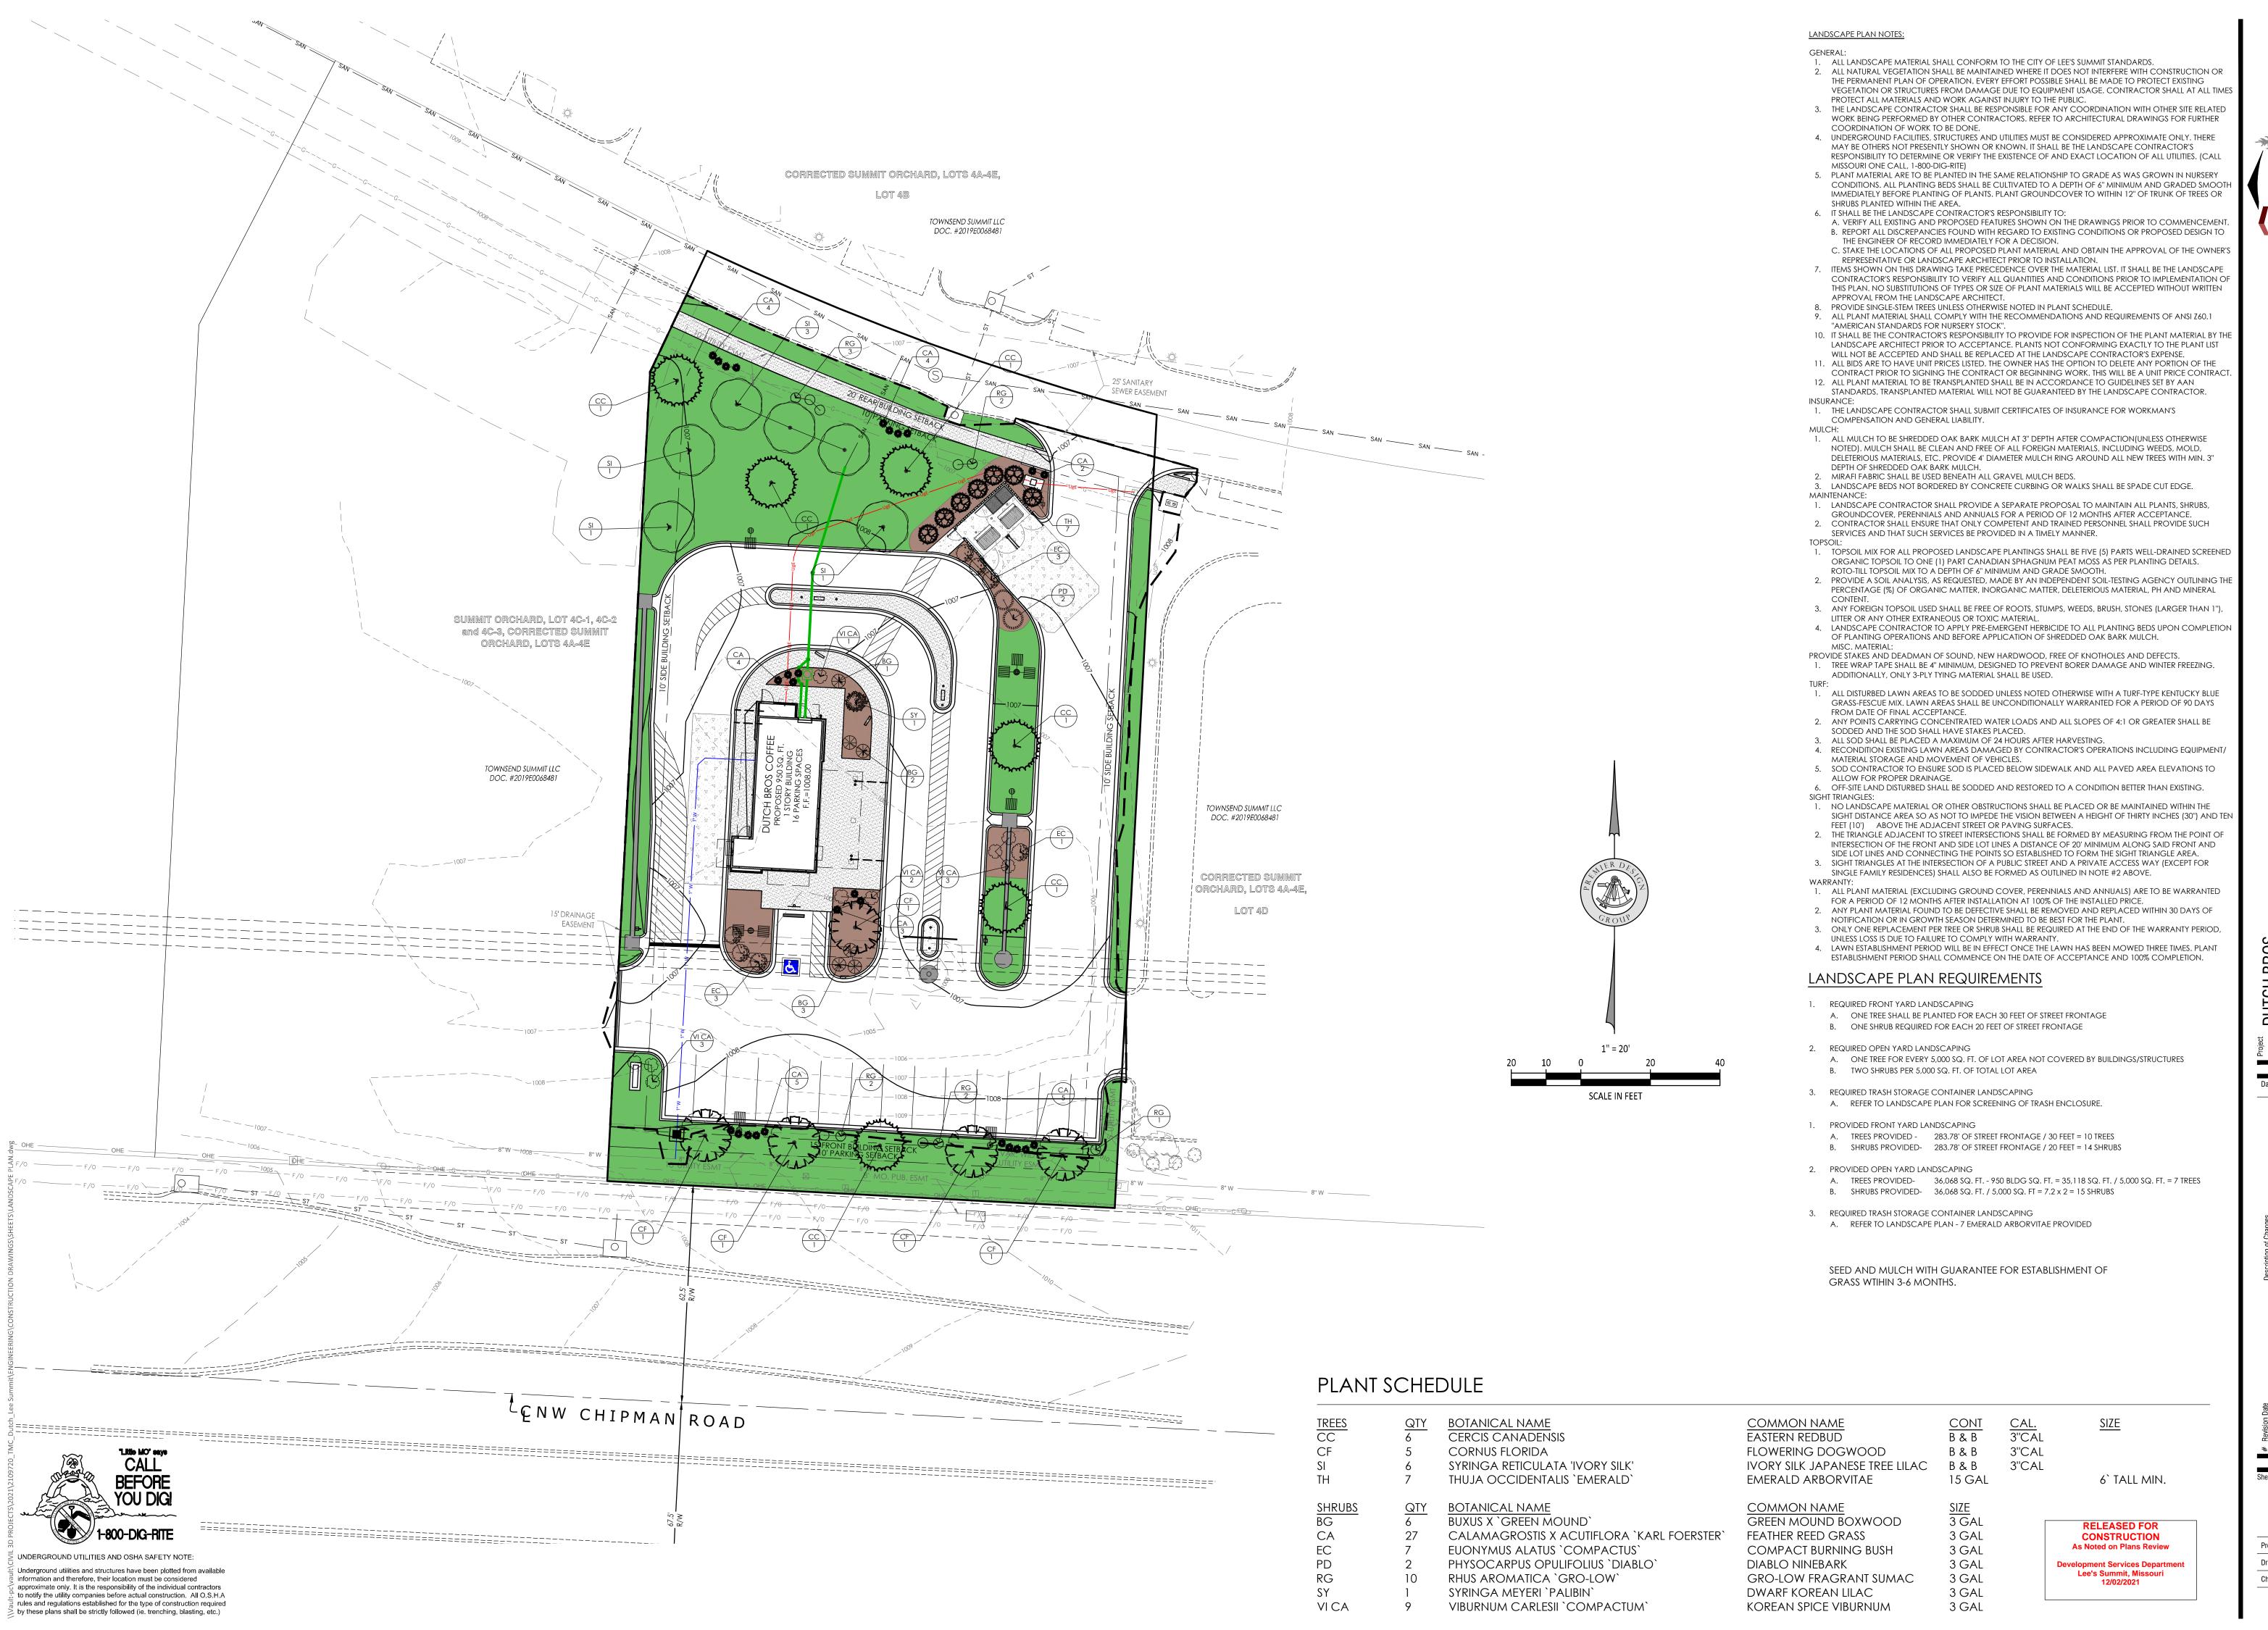





ENGINEERS AUTHENTICATION
The responsibility for professional engineering liability on this project is hereby limited to the set of plans authenticated by the seal, signature, and date hereunder attached. Responsibility is disclaimed for all other engineering plans involved in this project and specifically excludes revisions after this date unless reauthenticated.

STEVEN D. MARION P.E.
PROFESSIONAL ENGINEER
PE 2006007195

LEE'S SUMMIT, MO
500 NW CHIPMAN RD.
LEE'S SUMMIT, MO 64086
TM CROWLEY
501 PENNSYLVANIA PARKWAY SUITE 160
INDIANAPOLIS, IN 46280

Date

Description of Changes

0-21-2021

REVISIONS PER CITY COMMENTS


Title

L-100


 Project No.
 2109720

 Drawn By
 A. JONES

 Checked By
 M. FOGARTY

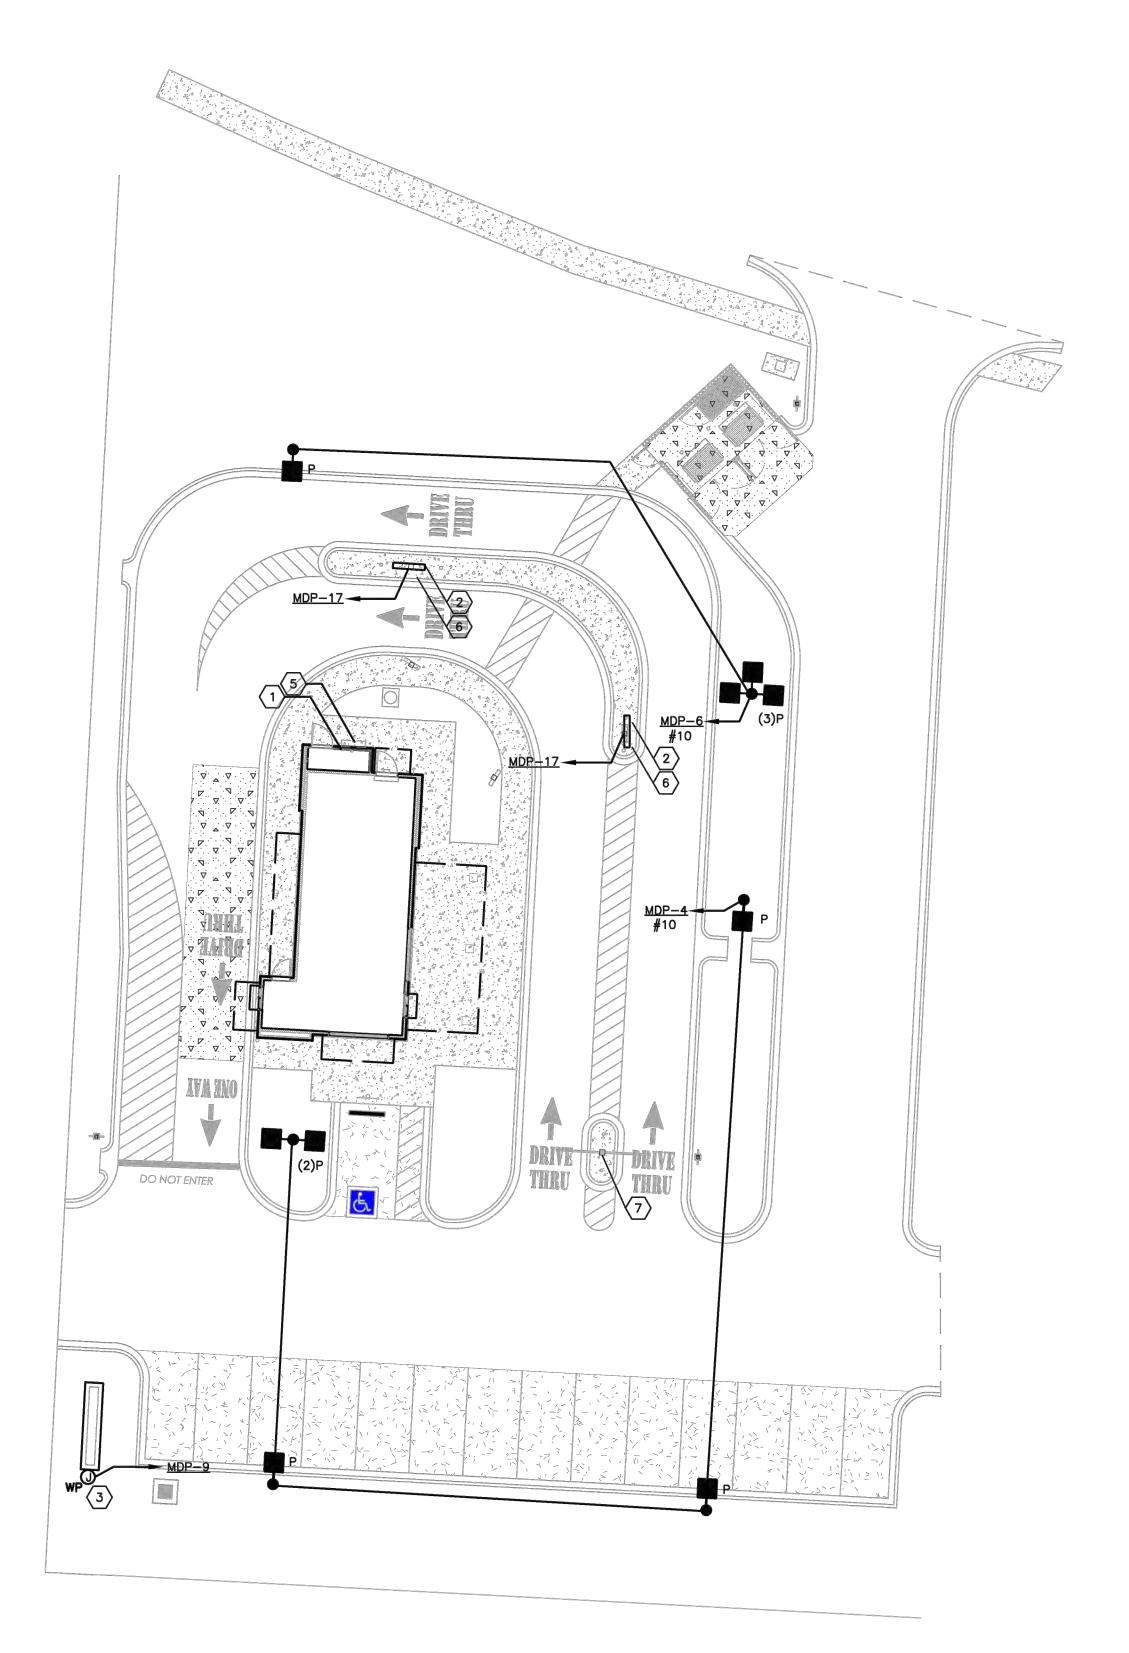



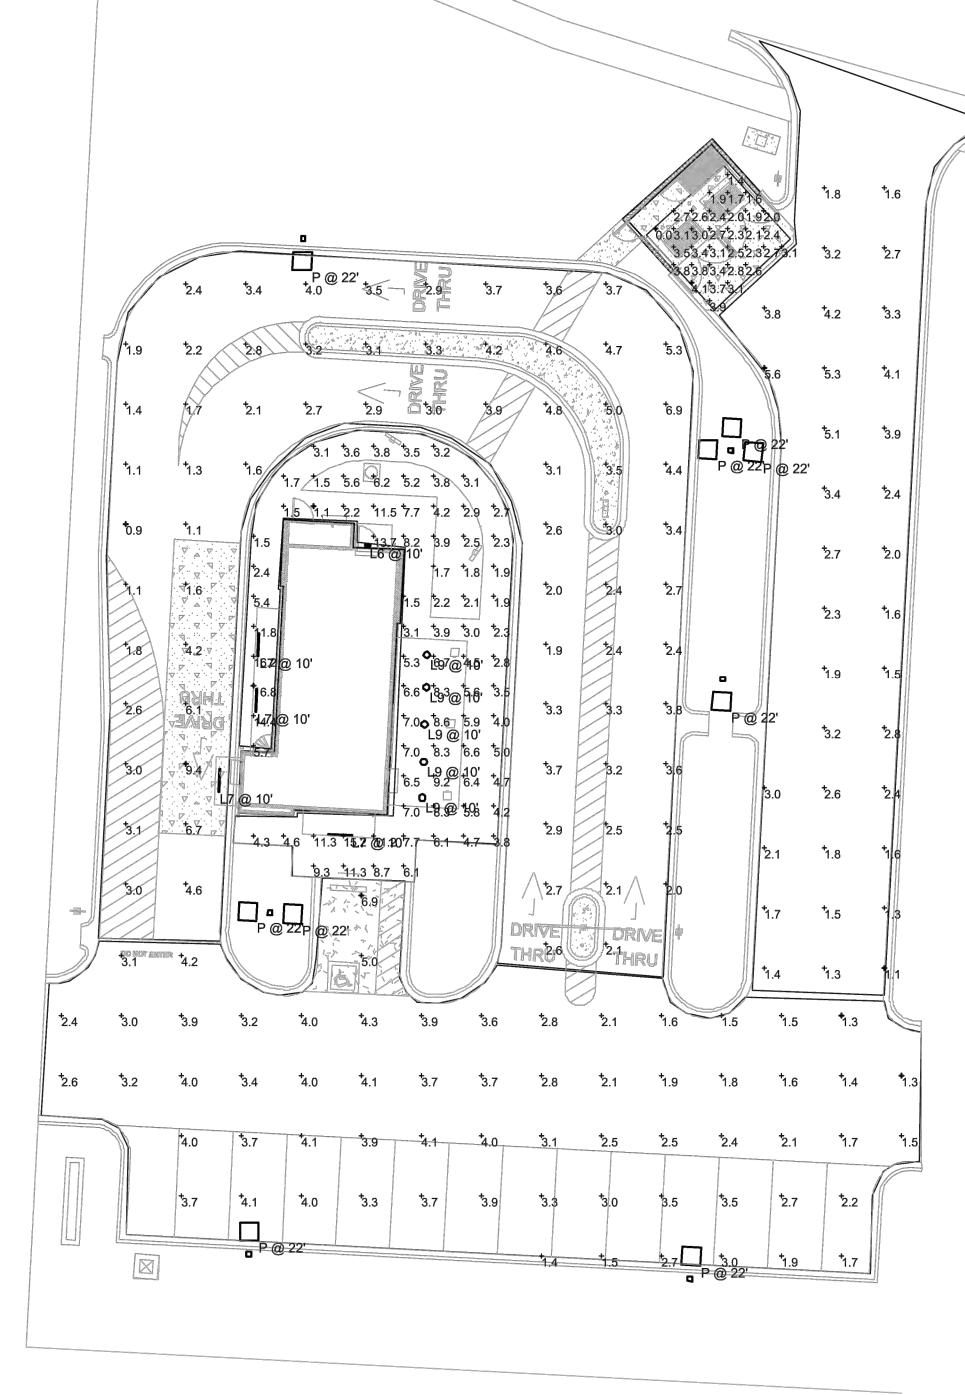

SITE PHOTOMETRIC PLAN

Schedule Symbol	Label	Quantity	Manufacturer	Catalog Number	Description	Number Lamps	Lumens Per Lamp	Light Loss Factor	Wattage
	L6	1	RAB LIGHTING INC.	WPLED26-WPLED26/D10 (WALLPACK) - ALED26- ALED26/D10 (AREA LIGHTER)	CAST FINNED METAL HOUSING, MACHINED METAL HEAT SINK, 1 CIRCUIT BOARD WITH 1 LED, MOLDED PLASTIC REFLECTOR WITH SEMI-SPECULAR FINISH, CLEAR FLAT GLASS LENS IN CAST BROWN PAINTED METAL FRAME.	1	3474	0.92	30
	L7	4	Self	WPLED26-WPLED26/D10 (WALLPACK) - ALED26- ALED26/D10 (AREA LIGHTER)	CROWN-L90-277V 830_BA110	1	4200	0.92	40
0	L9	5	DMF LIGHTING	DRD5S-4R-10930	DRD5S-4R-10930	1	1015	0.92	11.8
	Р	9	NLS Lighting	NV-1-T4-48L-1-40K-UNV- HSS	T4 OPTICS WITH BLACK HSS	1	9674	0.92	156

KEYED NOTES

- 1 LOCATION OF UTILITY METER DISCONNET SWITCH AND CT CABINET. REFER TO "RISER DIAGRAM" ON SHEET E3.01.
- $\langle 2 \rangle$ PROVIDE 120V ELECTRICAL CONNECTION WITH (2)#8 & (1)#8G. IN 2" PVC ROUTED BELOW GRADE FOR DRIVE—THRU BACKLÍT MENU BÖARD PER MANUFACTURER'S INSTRUCTIONS. CONDUIT SHALL COME UP IN CENTER OF POST. SIGN COMPANY REPRESENTATIVE TO GIVE EXACT LOCATIONS/DIMENSIONS FOR GC TO MATCH. CONTRACTOR SHALL REPAIR EXISTING PARKING SURFACES FROM TRENCHING TO MATCH PREVIOUS CONDITIONS.
- 3 PROVIDE 120V ELECTRICAL CONNECTION WITH (2)#8 & (1)#8G. IN 2" PVC ROUTED BELOW GRADE FOR NEW MONUMENT SIGN PER REPRESENTATIVE PRIOR TO ROUGH—IN. CONTRACTOR SHALL REPAIR EXISTING PARKING SURFACES FROM TRENCHING TO MATCH PREVIOUS CONDITIONS.
- 4 NOT USED.
- (5) LOCATION OF CABLE INTERNET DEMARC
- 6 PROVIDE 2" CONDUIT W/ PULL STRING 24" BEHIND MENU BOARD TO CHRISTY BOX FOR FUTURE DIGITAL MENU BOARD UPGRADE . COORDINATE W/ SIGN MANUFACTURER.
- (7) PROVIDE 2" CONDUIT W/ PULL STRING TO CHRISTY BOX BETWEEN "CHOOSE LANE" DIRECTIONAL SIGNAGE AND CLEARANCE BAR FOR FUTURE DRIVE THRU

MIN. DUTCH BROS REQUIREMENTS:


SEE S1.4 FOR POLE BASE DETAIL

GENERAL NOTES

- . FOR UTILITY TRANSFORMER, TELEPHONE SERVICE, GAS, WATER, AND SANITARY SEWER LOCATIONS; SEE CIVIL SITE PLAN.
- . THE ELECTRICAL CONTRACTOR IS RESPONSIBLE FOR COORDINATION AND COMPLIANCE WITH ALL UTILITY COMPANIES REQUIREMENTS. INCOMING POWER AND TELEPHONE SERVICES IS EXISTING TO REMAIN. VERIFY REQUIREMENTS WITH UTILITIES PRIOR TO INSTALLATION.

SITE NOTES

WATER LINES, CONDUITS FOR ELECTRICAL, OR OTHER UTILITIES SHALL BE LOCATED SO AS TO NOT CONFLICT WITH REQUIRED TREE LOCATIONS FOR STREETS AND PARKING LOTS.

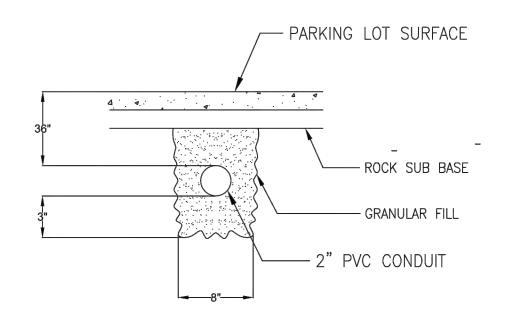

3 TRENCHING DETAIL E100 SCALE: N.T.S.

> RELEASED FOR CONSTRUCTION As Noted on Plans Review Development Services Department Lee's Summit, Missouri 12/02/2021



COR/LIC

ARCHITECT CORALIC, LLC EDIN CORALIC 2643 CAROUSEL DRIVE,

edin@coralicarchitecture.com STRUCTURAL ENGINEER JAMES C. KREHER JIM KREHER 208 N. MAIN STREET,

ST. LOUIS, MO 63125

p: 314.578.4953

COLUMBIA, IL 62236 p: 618.281.8505 jimk@kreherengineering.com

MEP ENGINEER Case Engineering DARRELL R. CASE 796 MERUS CT., FENTON, MO 63026 T. 636.349.1600 F. 636.349.1730 dcase@caseengineeringinc.com

XX.XX.XX

Iding Store Project No: MO0102

ISSUED FOR PERMIT:

REV: DATE: DESCRIPTION:

SHEET NAME: ELECTRICAL

SHEET NUMBER:

PLAN

10.8.2021

E0.01

SITE & PHOTOMETRIC

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