
JY2 NISSON

THE RETREAT AT HOOK FARMS SECOND PLAT

SITE GRADING & SITE DISTURBANCE PLANS

SECTION 23, TOWNSHIP 47 N, RANGE 32 W IN LEE'S SUMMIT, JACKSON COUNTY, MO AREA DISTURBED = 15.16 AC.

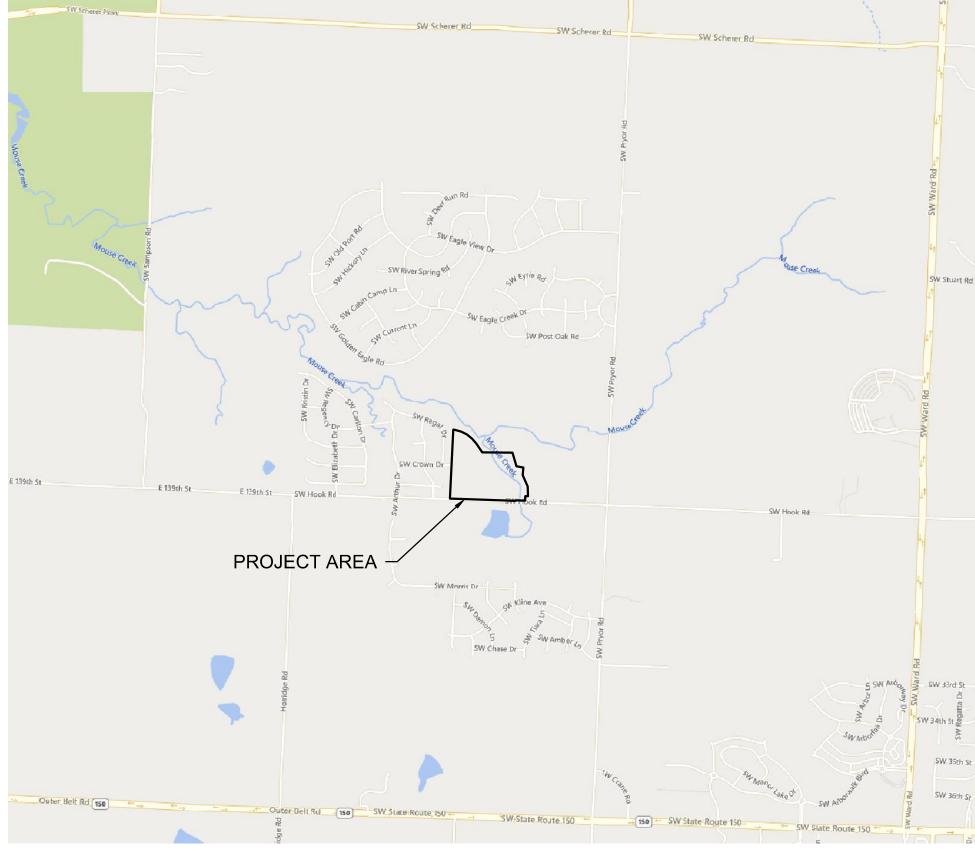

PROPERTY DESCRIPTION

A TRACT OF LAND IN THE SOUTHEAST QUARTER OF SECTION 23, TOWNSHIP 47 NORTH, RANGE 32 WEST OF THE 5TH PRINCIPAL MERIDIAN IN LEE'S SUMMIT, JACKSON COUNTY, MISSOURI BEING BOUNDED AND DESCRIBED BY OR UNDER THE DIRECT SUPERVISION OF JASON S. ROUDEBUSH, P.L.S. 2002014092 AS FOLLOWS: COMMENCING AT THE SOUTHEAST CORNER OF SAID SOUTHEAST QUARTER; THENCE NORTH 87°58'53" WEST, ON THE SOUTH LINE OF SAID SOUTHEAST QUARTER, 2,651.35 FEET TO THE SOUTHEAST CORNER OF MONARCH VIEW 1ST PLAT, A SUBDIVISION OF LAND IN SAID LEE'S SUMMIT RECORDED AS INSTRUMENT NUMBER 98 I 69637 IN BOOK I63 AT PAGE 62 IN JACKSON COUNTY RECORDER OF DEEDS OFFICE, ALSO BEING THE SOUTHWEST CORNER OF SAID SOUTHEAST QUARTER; THENCE NORTH 02°43'00" EAST, ON THE WEST LINE OF SAID SOUTHEAST QUARTER, ALSO BEING THE EAST LINE OF SAID MONARCH VIEW 1ST PLAT, 30.00 FEET TO THE NORTHWEST CORNER OF SW HOOK ROAD AS ESTABLISHED BY RIGHT-OF-WAY DEED RECORDED AS INSTRUMENT NUMBER 1999I 0077639 IN SAID JACKSON COUNTY RECORDER OF DEEDS OFFICE, ALSO BEING THE POINT OF BEGINNING OF THE TRACT OF LAND TO BE HEREIN DESCRIBED; THENCE NORTH 02°43'00" EAST, ON SAID WEST AND EAST LINES. AND ALSO BEING EAST LINE OF MONARCH VIEW 2ND PLAT. A SUBDIVISION OF LAND IN SAID LEE'S SUMMIT. RECORDED AS INSTRUMENT NUMBER 2000I 0047892 IN BOOK I67 AT PAGE 87 IN SAID JACKSON COUNTY RECORDER OF DEEDS OFFICE, 1,163.24 FEET; THENCE LEAVING SAID WEST AND EAST LINES, SOUTH 87"16'25" EAST, 25.54 FEET; THENCE SOUTH 73"15'30" EAST, 121.46 FEET; THENCE SOUTH 62°39'56" EAST, 102.90 FEET; THENCE SOUTH 52°04'22" EAST, 102.90 FEET; THENCE SOUTH 41°28'48" EAST, 102.90 FEET; THENCE SOUTH 33°05'07" EAST, 195.12 FEET; THENCE NORTH 90°00'00" EAST, 510.19 FEET TO A POINT ON THE WESTERLY LINE OF PROPOSED THE RETREAT AT HOOK FARMS; THENCE SOUTH 16'31'39" EAST, ALONG SAID WESTERLY LINE, 238.84 FEET; THENCE SOUTH 78'36'20" EAST, ALONG SAID WESTERLY LINE, 118.51 FEET; THENCE SOUTH 04°39'35" WEST, ALONG SAID WESTERLY LINE, 128.06 FEET; THENCE SOUTH 23°04'06" EAST, ALONG SAID WESTERLY LINE, 206.79 FEET; THENCE SOUTH 02°38'45" EAST, ALONG SAID WESTERLY LINE, 164.78 FEET; THENCE NORTH 87°58'48" WEST, ALONG SAID WESTERLY LINE, 45.85 FEET; THENCE SOUTH 01°54'56" WEST, ALONG SAID WESTERLY LINE, 76.13 FEET; THENCE NORTH 87'58'53" WEST, ALONG SAID WESTERLY LINE, 38.61 FEET TO A POINT ON THE EXISTING NORTHERLY RIGHT-OF-WAY LINE OF SW HOOK ROAD. AS ESTABLISHED BY RIGHT OF WAY DEED RECORDED AS INSTRUMENT NUMBER 2007E0016663 IN SAID JACKSON COUNTY RECORDER OF DEEDS OFFICE; THENCE LEAVING SAID WESTERLY LINE, CONTINUING NORTH 87°58'53" WEST, ALONG SAID EXISTING NORTHERLY RIGHT—OF—WAY LINE 125.00 FEET; THENCE SOUTH 02°01'07" WEST, ALONG SAID EXISTING NORTHERLY RIGHT-OF-WAY LINE, 10.00 FEET; THENCE NORTH 87°58'53" WEST, ALONG SAID EXISTING NORTHERLY RIGHT-OF-WAY LINE, 853.20 FEET TO THE NORTHWEST CORNER OF SAID RIGHT-OF-WAY DEED, ALSO BEING THE NORTHEAST CORNER OF SW HOOK ROAD, AS ESTABLISHED BY SAID RIGHT-OF-WAY DEED INSTRUMENT NUMBER 1999 10077639; THENCE CONTINUING NORTH 87°58'53" WEST ALONG THE EXISTING NORTHERLY RIGHT-OF-WAY LINE OF SAID SW HOOK ROAD, 252.00 FEET TO THE POINT OF BEGINNING. CONTAINING 1,085,519 SQUARE FEET OR 24.92 ACRES, MORE OR LESS.

BENCHMARK

<u>JA-74</u> ELEVATION: 1058.10 N: 978461.2779 E: 2809447.9650 DESCRIPTION: KC METRO ALUMINUM GRS DISK SET IN CONCRETE. THE STATION IS STAMPED JA-74, 1988, AND PROJECTS ABOUT 1 INCH

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C405	GRADING PLAN (FOR REFERENCE)			
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C407	SITE DISTURBANCE PLAN - PHASE A			
C408	SITE DISTURBANCE PLAN - PHASE A DETAILS			
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OIL/GAS WELLS

NO OIL OR GAS WELLS ARE LOCATED WITHIN PROJECT LIMITS.
INFORMATION OBTAINED FROM THE MISSOURI DEPARTMENT OF NATURAL RESOURCES,
GEOLOGICAL SURVEY GEOSCIENCES TECHNICAL RESOURCE ASSESSMENT TOOL (GEOSTRAT)

FLOOD CERTIFICATION

PORTIONS OF THE SITE ARE LOCATED WITHIN ZONE AE "BASE FLOOD ELEVATIONS DETERMINED", ZONE X (SHADED) "AREAS OF 0.2% CHANCE FLOOD; AREAS OF 1% ANNUAL CHANCE FLOOD WITH AVERAGE DEPTHS OF LESS THAN 1 FOOT OR WITH DRAINAGE AREAS LESS THAN 1 SQUARE MILE; AND AREAS PROTECTED BY LEVEES FROM FROM 1% ANNUAL CHANCE FLOOD, AND ZONE X (UNSHADED)" AREAS DETERMINED TO BE OUTSIDE THE 0.2% ANNUAL CHANCE FLOODPLAIN AS DEPICTED ON THE FEMA FLOOD INSURANCE RATE MAP (FIRM) MAP NUMBER 29095C0531G, REVISION DATE JANUARY 20, 2017.

OLSSON HAS BEEN RETAINED TO PROVIDE AS-BUILT DRAWINGS FOR THIS PROJECT.

JULIE E. SELLERS, P.E. CIVIL ENGINEER

MO # PE-2017000367

10/29/21

DATE

drawn by:

checked by:
designed by:
QA/QC by:
project no.:
date:

B.M.W./A.A.
B.M.W./A.A.
A.B.
B.M.W./A.A.
A.B.
A.B.
B.M.W./A.A.
A.B.
A.B.
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B.M.W.

SIT

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SHEET C401

REVIEWED FOR CONSTRUCTION

NOT FOR CONSTRUCTION

NE 1/4

FARMS

<u>UTILITY SERVICE NUMBERS</u>

PHONE: 816-969-1800

SERVICES DEPARTMENT

NAME: SPIRE (MGE) PHONE: 314-342-0500

NAME: AT&T

NAME: EVERGY

PHONE: 816-969-1940

PHONE: 800-286-8313

PHONE: 816-471-5275

NAME: SPECTRUM (TWC) PHONE: 877—772—2253

NAME: GOOGLE FIBER

PHONE: 877-454-6959

NAME: LEE'S SUMMIT PUBLIC WORKS

NAME: LEE'S SUMMIT WATER &

SECOND

SW. HOOK ROAD
LOCATION MAP
SEC. 23, TWP. 47N., RGE. 32W.
(N.T.S.)

THE RETREAT AT HOOK FARMS SECOND PLAT

PROJECT TEAM & UTILITY CONTACT LIST

HUNT MIDWEST REAL ESTATE DEVELOPMENT, INC.

OWNER / DEVELOPER

KANSAS CITY, MO 64161

PHONE: 816.455.2500

PHONE: 816.361.1177

PHONE: 816.361.1177

ENGINEER OLSSON

CONTACT: AARON SCHMIDT

1301 BURLINGTON, SUITE 100

EMAIL: JSELLERS@OLSSON.COM

1301 BURLINGTON, SUITE 100

NORTH KANSAS CITY, MO 64116

EMAIL: JROUDEBOUSH@OLSSON.COM

NORTH KANSAS CITY, MO 64116 CONTACT: JULIE E. SELLERS, P.E.

8300 NE UNDERGROUND DRIVE



- 2. THE CONTRACTOR SHALL BE RESPONSIBLE FOR ANY DEVIATIONS FROM THESE PLANS UNLESS WRITTEN APPROVAL FROM ENGINEER, OWNER, AND DEVELOPER.
- 3. ALL WORK AND MATERIALS SHALL BE SUBJECT TO INSPECTION AND APPROVAL BY THE OWNER OR THE OWNER'S REPRESENTATIVE.
- 4. ALL ESTIMATES OF QUANTITIES ARE FOR INFORMATIONAL PURPOSES ONLY. THE CONTRACTOR SHALL BE RESPONSIBLE FOR DETERMINING QUANTITIES AND ITEMS OF WORK.
- 5. THE CONTRACTOR SHALL BE RESPONSIBLE FOR PROVIDING ALL LABOR, MATERIALS, AND EQUIPMENT REQUIRED TO COMPLETE THE WORK SHOWN IN THE PLANS.
- 6. THE CONTRACTOR SHALL BE RESPONSIBLE FOR OBTAINING ALL REQUIRED PERMITS, PAYING ALL FEES, AND FOR OTHERWISE COMPLYING WITH ALL APPLICABLE REGULATIONS GOVERNING THE WORK.
- 7. THE CONTRACTOR SHALL NOT ENGAGE IN ACTIVITIES THAT MAY ENCROACH ON WATERS OF THE U.S., INCLUDING WETLANDS, UNTIL ANY NECESSARY PERMITS MAY BE OBTAINED. THE CONTRACTOR SHALL REVIEW AND COMPLY WITH ALL CONDITIONS DESCRIBED IN THE PERMIT.
- 8. THE CONTRACTOR SHALL BE SOLELY RESPONSIBLE FOR CONDITIONS OF THE JOB SITE, THE SAFETY OF ALL PERSONS INCLUDING VISITORS AND THE GENERAL PUBLIC, AND PROPERTY DURING PERFORMANCE OF THE WORK. THIS REQUIREMENT WILL APPLY CONTINUOUSLY THROUGHOUT THE PROJECT AND NOT BE LIMITED BY WORKING HOURS. ANY CONSTRUCTION OBSERVATION BY THE ENGINEER OF THE CONTRACTOR'S PERFORMANCE IS NOT INTENDED TO INCLUDE REVIEW OF THE ADEQUACY OF THE CONTRACTOR'S SAFETY MEASURES.
- 9. PRIOR TO COMMENCEMENT OF WORK THE CONTRACTOR SHALL NOTIFY AND COORDINATE WITH ALL UTILITY COMPANIES AND OBTAIN ANY RELEVANT INFORMATION. NOTIFY ENGINEER OF ANY DISCREPANCIES.
- 10. THE CONTRACTOR IS RESPONSIBLE FOR THE PROTECTION OF ALL BOUNDARY CORNERS AND SECTION CORNERS. ANY BOUNDARY CORNER AND/OR SECTION CORNER DISTURBED OR DAMAGED BY CONSTRUCTION ACTIVITIES SHALL BE RESET BY A LAND SURVEYOR LICENSED IN THE STATE OF MISSOURI, AT THE CONTRACTOR'S EXPENSE.
- 11. THE CONTRACTOR IS RESPONSIBLE FOR THE PROTECTION OF ADJACENT PROPERTIES AND SHALL TAKE ALL PRECAUTIONS NECESSARY TO PREVENT DAMAGE DURING CONSTRUCTION. THE CONTRACTOR IS ALSO RESPONSIBLE FOR REPAIRING ANY DAMAGE RESULTING FROM CONSTRUCTION ACTIVITIES.
- 12. PRIOR TO MOVING OFF THE JOB THE CONTRACTOR SHALL NOTIFY THE OWNER AND ENGINEER TO PERFORM A FINAL WALK—THROUGH OF THE CONSTRUCTION SITE.

REFERENCES

- 1. UNLESS EXPLICITLY DESCRIBED OTHERWISE WITHIN THESE PLANS THE FOLLOWING SHALL APPLY:
- A. ALL CONSTRUCTION, INCLUDING THOSE LISTED BELOW, SHALL CONFORM TO THE LATEST CODES AND ORDINANCES OF LEE'S SUMMIT. MISSOURI.
- B. ALL CONSTRUCTION IN MODOT RIGHT-OF-WAY SHALL CONFORM TO THE LATEST SPECIFICATIONS ADOPTED BY U.S. DEPARTMENT OF TRANSPORTATION AND MODOT.
- C. ALL TRAFFIC CONTROL SIGNAGE SHALL CONFORM WITH THE CURRENT EDITION OF THE MANUAL FOR UNIFORM TRAFFIC CONTROL DEVICES (MUTCD).
- D. ALL UTILITY EXTENSIONS AND CONSTRUCTION SHALL CONFORM TO THE STANDARDS AND SPECIFICATIONS OF THE UTILITY COMPANIES...
- E. ALL EXTERIOR PAVEMENT (PCC, ASPHALT, ETC.) SHALL BE IN CONFORMANCE WITH THE SPECIFICATIONS OF LEE'S SUMMIT, MISSOURI AND THE RECOMMENDATIONS OF THE GEOTECHNICAL REPORT.
- 4. THE CONTRACTOR IS RESPONSIBLE FOR CONTACTING THE DELIVERY MANAGER AND COORDINATING ANY MAILBOXES THAT MAY BE DISTURBED. FAILURE TO DO SO MAY SUBJECT THE CONTRACTOR TO PROSECUTION BY THE FEDERAL GOVERNMENT.

EXISTING CONDITIONS

- 1. THE CONTRACTOR SHALL VISIT THE SITE AND BECOME FAMILIAR WITH THE EXISTING CONDITIONS OF THE PROJECT AREA.
- 2. THE CONTRACTOR SHALL BE RESPONSIBLE FOR PERFORMING THEIR OWN INVESTIGATIONS AND MAKING THEIR OWN ASSUMPTIONS REGARDING SITE SURFACE AND SUBSURFACE CONDITIONS. THIS INCLUDES THE LOCATION AND CONSISTENCY OF ANY EXISTING ROCK LAYERS UNDERLYING THE PROJECT SITE. CONTACT THE ENGINEER REGARDING ANY DISCREPANCIES THAT MAY AFFECT THE ABILITY TO CONSTRUCT FROM THESE PLANS AS DESIGNED.
- 3. EXISTING CONDITIONS WERE DETERMINED THROUGH A VARIETY OF METHODS THAT MAY INCLUDE SURVEY, AERIAL IMAGERY, AVAILABLE RECORDS, GIS DATA, ETC. SUBSURFACE CONDITIONS ARE APPROXIMATE AND MAY NOT INCLUDE ALL UTILITIES AND OTHER SITE IMPROVEMENTS PRESENT ON SITE. THE CONTRACTOR SHALL MAKE EXPLORATION EXCAVATIONS AND LOCATE EXISTING UNDERGROUND UTILITIES SUFFICIENTLY AHEAD OF CONSTRUCTION TO PERMIT REVISIONS TO PLANS WHEN CONFLICTS AND DISCREPANCIES ARE FOUND.

CONSTRUCTION

- 1. THE CONTRACTOR SHALL INSTALL TRAFFIC CONTROL WHILE WORKING IN THE PUBLIC RIGHT—OF—WAY AS SHOWN IN THESE PLANS. IF PLANS ARE NOT PROVIDED, CONTRACTOR SHALL COORDINATE AND PROVIDE CONTROLS TO THE SATISFACTION OF THE RIGHT—OF—WAY OWNER.
- 2. THE CONTRACTOR SHALL PROTECT ALL TREES OVER 3" CALIPER FROM DAMAGE. NO TREE SHALL BE REMOVED WITHOUT PERMISSION OF THE OWNER, UNLESS SHOWN OTHERWISE ON THESE PLANS.
- 3. THE CONTRACTOR SHALL DISPOSE ALL WASTE MATERIAL RESULTING FROM THE PROJECT OFF-SITE AND IN STRICT CONFORMANCE WITH ALL LOCAL CODES AND ORDINANCES.
- 4. ALL MANHOLES, CATCH BASINS, UTILITY VALVES AND METER PITS ARE TO BE ADJUSTED OR REBUILT TO GRADE AS REQUIRED. NOT ALL ADJUSTMENTS ARE INDICATED IN THE PLANS.
- 5. THE CONTRACTOR SHALL STREET SWEEP OR OTHERWISE CLEAN ALL ACCESS ROUTES TO THE SITE AT CONCLUSION OF THE PROJECT.

SHOP DRAWINGS

- 1. THE CONTRACTOR SHALL SUBMIT SHOP DRAWINGS A MINIMUM OF 7 DAYS PRIOR TO THE REQUESTED DATE OF APPROVAL. ENGINEER SHALL REVIEW SHOP DRAWINGS OR SAMPLES IN CONFORMANCE WITH THE DESIGN FOR THIS PROJECT AS DESCRIBED IN THE PLANS. THE CONTRACTOR SHALL BE RESPONSIBLE FOR ERRORS OR OMISSIONS IN SHOP DRAWINGS. THE ENGINEER'S REVIEW SHALL NOT EXTEND TO MEANS OR METHODS OF CONSTRUCTION. CONTRACTOR SHALL BE RESPONSIBLE FOR ANY VARIATION FROM THE REQUIREMENTS OF THE CONTRACT DOCUMENTS UNLESS CONTRACTOR HAS NOTIFIED ENGINEER OF EACH SUCH VARIATION AT THE TIME OF SUBMISSION, AND OBTAINED ENGINEER'S WRITTEN APPROVAL OF EACH SUCH VARIATION. PRIOR TO SUBMITTING EACH SHOP DRAWING OR SAMPLE, CONTRACTOR SHALL HAVE REVIEWED AND VERIFIED:
- A. ALL FIELD MEASUREMENTS, QUANTITIES, DIMENSIONS, SPECIFIED PERFORMANCE CRITERIA, INSTALLATION REQUIREMENTS, MATERIALS, CATALOG NUMBERS AND SIMILAR INFORMATION WITH RESPECT
- B. ALL MATERIALS WITH RESPECT TO INTENDED USE, FABRICATION, SHIPPING, HANDLING, STORAGE, ASSEMBLY AND INSTALLATION PERTAINING TO THE PERFORMANCE OF THE WORK;
- C. ALL INFORMATION RELATIVE TO MEANS, METHODS, TECHNIQUES, SEQUENCES AND PROCEDURES OF CONSTRUCTION AND SAFETY PRECAUTIONS AND PROGRAMS INCIDENT THERETO;
- D. CONTRACTOR SHALL ALSO HAVE REVIEWED AND COORDINATED EACH SHOP DRAWING OR SAMPLE WITH OTHER SHOP DRAWINGS AND SAMPLES, AND WITH THE REQUIREMENTS OF THE WORK AND THE CONTRACT DOCUMENTS.
- E. ALL SUBMITTED SHOP DRAWINGS SHALL BEAR A STAMP OR SPECIFIC WRITTEN INDICATION AND SIGNATURE THAT CONTRACTOR HAS FULLY COMPLETED THE ABOVE TASKS.
- SHOP DRAWINGS AS DESCRIBED ABOVE ARE REQUIRED FOR, BUT NOT LIMITED TO, THE FOLLOWING:
- A. ALL STORM SEWER STRUCTURES TO BE INSTALLED WITH THIS PROJECT.
- B. ANY ITEMS IN THESE PLANS THAT ALLOW FOR AN "APPROVED EQUAL" ALTERNATIVE.

GENERAL NOTES:

1. THE INTENT OF THIS LAND DISTURBANCE PLAN IS TO ASSIST THE DEVELOPER IN HIS RESPONSIBILITY TO PROVIDE ALL MATERIALS, TOOLS, EQUIPMENT AND LABOR NECESSARY TO CONTROL EROSION, SILTATION AND DISCHARGES OF SOIL MATERIAL (SEDIMENT) INTO DOWNSTREAM SYSTEMS OR RECEIVING CHANNELS. THIS SHALL BE REQUIRED DURING ALL PHASES OF CONSTRUCTION AND UNTIL SUITABLE GROUND COVER IS ESTABLISHED FOR ALL DISTURBED AREAS. IF ANY METHOD OF CONTROL FAILS, THE DEVELOPER SHALL NOTIFY THE OWNER IMMEDIATELY, SO THAT THE OWNER OR HIS AGENT CAN REVIEW THE DEVELOPER'S PROPOSED METHOD OF REPAIR.

THIS PLAN INDICATES THE CRITICAL AREA(S) OF CONCERN AND THESE AREA(S) WILL BE CONTROLLED AS A MINIMUM. THE CONTROL MAY CONSIST OF TEMPORARY CONTROL MEASURES AS SHOWN ON THE PLANS OR ORDERED BY THE OWNER DURING THE LIFE OF THE CONTRACT TO CONTROL EROSION OR WATER POLLUTION, THROUGH THE USE OF BERMS, DIKES, DAMS, SEDIMENT BASINS, FIBER MATS, NETTING, STRAW BALES, GRAVEL, MULCHES, GRASSES, SLOPE DRAINS, DIVERSION SWALES OR OTHER EROSION CONTROL DEVICES OR METHODS. THE OWNER HAS THE AUTHORITY TO LIMIT THE SURFACE AREA OF ERODIBLE EARTH MATERIAL EXPOSED BY THE CONSTRUCTION OPERATIONS AND TO DIRECT THE DEVELOPER TO PROVIDE IMMEDIATE PERMANENT OR TEMPORARY POLLUTION CONTROL MEASURES TO PREVENT CONTAMINATION OF ADJACENT STREAMS OR OTHER WATER COURSES, LAKES, PONDS, OR OTHER AREAS OF WATER IMPOUNDMENT OR CONVEYANCES.

THE TEMPORARY POLLUTION CONTROL PROVISIONS CONTAINED HEREIN SHALL BE COORDINATED WITH ANY PERMANENT EROSION CONTROL FEATURES SPECIFIED ELSEWHERE IN THE CONTRACT TO THE EXTENT PRACTICAL TO ASSURE ECONOMICAL, EFFECTIVE AND CONTINUOUS EROSION CONTROL THROUGHOUT THE CONSTRUCTION AND POST CONSTRUCTION PERIOD.

- 2. THIS SEDIMENTATION CONTROL PLAN MAKES USE OF THE FOLLOWING APPLICATIONS: ____PRESERVATION OF EXISTING VEGETATION
- _X_SEDIMENT BARRIERS
- _X_SEDIMENT TRAPS
 _X_INLET PROTECTION
- ___OUTLET PROTECTION
 ___SOIL RETAINING SYSTEMS
- ___SLOPE DRAINS
- ___SUBSURFACE DRAINS

PHYSICAL DESCRIPTION OF EACH SPECIFIC SEDIMENT CONTROL DEVICE TO BE UTILIZED IS CALLED OUT ON THE PLANS WITH INSTALLATION PROCEDURES, CONSTRUCTION SPECIFICATIONS AND MAINTENANCE ARRANGEMENT AS CALLED FOR ON THE DETAIL SHEET. IN ADDITION TO THE MEASURES SPECIFIED, THE FOLLOWING GENERAL PRACTICES SHALL BE ADHERED TO WHEN APPLICABLE.

A) CLEARING AND GRUBBING WITHIN 50' OF A DEFINED DRAINAGE COURSE SHOULD BE AVOIDED WHEN POSSIBLE. WHERE CHANGES TO A DEFINED DRAINAGE COURSE OCCUR, WORK SHOULD BE DELAYED UNTIL ALL MATERIALS AND EQUIPMENT NECESSARY TO PROTECT AND COMPLETE THE DRAINAGE CHANGE ARE ON SITE. CHANGES SHALL BE COMPLETED AS QUICKLY AS POSSIBLE ONCE THE WORK HAS BEEN INITIATED. THE AREA IMPACTED BY THE CONSTRUCTION ACTIVITIES SHALL BE REVEGETATED OR PROTECTED FROM EROSION AS SOON AS POSSIBLE, AREAS WITHIN 50' OF A DEFINED DRAINAGE WAYS SHOULD BE RECONTOURED AS NEEDED OR OTHERWISE PROTECTED WITHIN FIVE (5) WORKING DAYS AFTER GRADING HAS CEASED.

B) WHERE SOIL DISTURBING ACTIVITIES CEASE IN AN AREA FOR MORE THAN 14 DAYS, THE DISTURBED AREAS SHALL BE PROTECTED FROM EROSION BY STABILIZING THE AREA WITH MULCH OR OTHER SIMILARLY EFFECTIVE EROSION CONTROL MEASURES. IF THE SLOPE OF THE AREA IS GREATER THAN 3:1 OR IF THE SLOPE IS GREATER THAN 3% AND GREATER THAN 150 FEET IN LENGTH, THEN THE DISTURBED AREAS SHALL BE PROTECTED FROM EROSION BY STABILIZING THE AREA WITH MULCH OR OTHER SIMILARLY EFFECTIVE EROSION CONTROL MEASURES IF ACTIVITIES CEASE FOR MORE THAN SEVEN (7) DAYS.

C) EXISTING VEGETATION SHALL BE PRESERVED TO THE EXTENT AND WHERE PRACTICAL. IN NO CASE SHALL DISTURBED AREAS REMAIN WITHOUT VEGETATIVE GROUND COVER FOR A PERIOD IN EXCESS OF 60 DAYS.

D) ADDITIONAL SITE MANAGEMENT PRACTICES WHICH SHALL BE ADHERED TO DURING THE CONSTRUCTION PROCESS SHALL INCLUDE:

SOLID AND HAZARDOUS WASTE MANAGEMENT INCLUDING PROVIDING TRASH CONTAINERS AND REGULAR SITE CLEAN UP FOR PROPER DISPOSAL OF SOLID WASTE SUCH AS BUILDING MATERIAL, PRODUCT/MATERIAL SHIPPING WASTE, FOOD CONTAINERS AND CUPS, AND PROVIDING CONTAINERS FOR THE PROPER DISPOSAL OF WASTE PAINTS SOLVENTS, AND CLEANING COMPOUNDS.

PROVISIONS OF PORTABLE TOILETS FOR PROPER DISPOSAL OF SANITARY SEWAGE.

STORAGE OF CONSTRUCTION MATERIALS AWAY FROM DRAINAGE COURSES AND LOW AREAS.

INSTALLATION OF CONTAINMENT BERMS AND USE OF DRIP PANS AT PETROLEUM PRODUCT AND LIQUID STORAGE TANKS AND CONTAINERS.

- 3. ALL DISTURBED AREAS SHALL BE SEEDED, FERTILIZED AND MULCHED, OR SODDED, IN ACCORDANCE WITH THE STANDARDS AND SPECIFICATIONS ADOPTED BY THE CITY OF LEE'S SUMMIT AND GOOD ENGINEERING PRACTICES. THIS SHALL BE COMPLETED WITHIN FOURTEEN (14) DAYS AFTER COMPLETING THE WORK, IN ANY AREA. IF THIS IS OUTSIDE OF THE SEEDING PERIOD, SILT BARRIERS OR OTHER SIMILARLY EFFECTIVE MEASURES SHALL BE PROVIDED UNTIL SUCH TIME THAT THE AREAS CAN BE SEEDED.
- 4. THE CONSTRUCTION COVERED BY THESE PLANS SHALL CONFORM TO ALL CURRENT STANDARDS AND SPECIFICATIONS ADOPTED BY THE CITY OF LEE'S SUMMIT. THE DEVELOPER WILL BE RESPONSIBLE FOR DETERMINING ALL ADDITIONAL STANDARDS, SPECIFICATIONS OR REQUIREMENTS WHICH ARE REQUIRED BY GOVERNING AGENCIES (INCLUDING LOCAL, STATE AND FEDERAL AUTHORITIES) HAVING JURISDICTION OVER THE WORK PROPOSED BY THESE CONSTRUCTION DRAWINGS.
- 5. ALL EROSION CONTROL MEASURES, TEMPORARY OR PERMANENT, REQUIRE MAINTENANCE TO PRESERVE THEIR EFFECTIVENESS. ALL EROSION CONTROL DEVICES SHALL BE INSPECTED IMMEDIATELY AFTER EACH HEAVY RAINSTORM AND AT LEAST DAILY DURING PROLONGED RAINFALL. ANY REQUIRED REPAIRS SHOULD BE MADE IMMEDIATELY. ALL COSTS ASSOCIATED WITH THE REPAIR WORK INCLUDING RELATED INCIDENTALS WILL BE THE DEVELOPER'S RESPONSIBILITY AND SHALL BE INCLUDED IN THE DEVELOPER'S BID FOR THE PROPOSED WORK.
- 6. ALL EROSION CONTROL MEASURES TO BE PER APWA KANSAS CITY METRO CHAPTER STANDARD DETAILS.
- 7. THE DEVELOPER MUST REMOVE AT HIS COST ANY BAD SUBSURFACE SOIL WHICH WOULD NOT BE ABLE TO SUPPORT ANY PROPOSED PUBLIC IMPROVEMENT. BACKFILL SHALL BE ACCOMPLISHED IN ACCORDANCE WITH THE CITY OF LEE'S SUMMIT DESIGN AND CONSTRUCTION MANUAL SECTIONS 2100 AND 2201 ENTITLED "GRADING AND SITE PREPARATION" AND "SUBGRADE PREPARATION".

8. THE CONTRACTOR SHALL CONTACT THE CITY'S DEVELOPMENT SERVICES ENGINEERING INSPECTION TO SCHEDULE A PRE-CONSTRUCTION MEETING WITH AN INSPECTOR PRIOR TO ANY DISTURBANCE WORK AT (816) 969-1200


9. TREE CLEARING TO HAPPEN BETWEEN NOVEMBER 1 AND MARCH 31. TREES CLEARED BETWEEN APRIL 1 AND OCTOBER 31 MUST BE TREES GREATER THAN 1,000 FEET FROM FORESTED OR WOODED AREAS OR TREES LESS THAN 3 INCHES IN DIAMETER, AT BREAST HEIGHT, AND NOT MIXED WITH LARGER TREES. IF LARGER TREES NEED TO BE CLEARED, A SURVEY OF THE TREES MUST BE CONDUCTED TO MAKE SURE THERE ARE NO BAT ROOSTS IN THE TREES. TREE CLEARING TO BE CONDUCTED BY CUTTING DOWN AND MULCHING OR BY PUSHING OVER AND MULCHING. TREES SHALL NOT BE BURNED DOWN.

	ESTIMATE OF QUAN	NIIIES		
ITEM NO.	DESCRIPTION	UNIT	QUANTITY	AS-BUILT
	PRIVATE GRADING	·		
1	EXCAVATION	C.Y.	45873	
2	EMBANKMENT	C.Y.	31198	
	SITE DISTURBANCE			
3	CONSTRUCTION ENTRANCE	EA.	1	
4	CURB INLET PROTECTION	EA.	15	
5	AREA INLET PROTECTION	EA.	6	
6	SILT FENCE	L.F.	1758.71	
7	DIVERSION BERM	L.F.	3185.37	
8	ROCK DITCH CHECK	EA.	10	
9	SEDIMENT TRAP	EA.	1	
10	SEDIMENT BASIN	EA.	1	
11	DISTURBED AREA	AC.	15.16	
12	TREE CLEARING	AC.	1.73	
13	PERMANENT SEEDING	AC.	13.45	

SUMMARY OF QUANTITIES AS INDICATED ABOVE AND ANY QUANTITIES AS SHOWN WITHIN THE PLANS HAVE BEEN PROVIDED FOR PERMITTING PURPOSES ONLY AND ARE NOT INTENDED FOR USE IN PREPARATION OF CONTRACT DOCUMENTS. QUANTITIES INTENDED FOR, BUT NOT LIMITED TO, THE PREPARATION OF PROPOSALS AND BID DOCUMENTS SHALL BE INDEPENDENTLY EVALUATED BY THE ESTIMATING PARTY BASED UPON THE CONTENTS OF THESE PLANS.


JULIE ELAINE SELLERS 1 NUMBER \PE-2017000367/ 10/29/21 NERAL NOTES HOOK PLAT T AT OND A O RE, SE(ш ∞ ტ ტ RET SIT B.M.W./A.A drawn by: B M W checked by: B.M.W./A.A. designed by: QA/QC by: A19-4059 project no.: 05-05-2021

SHEET C402

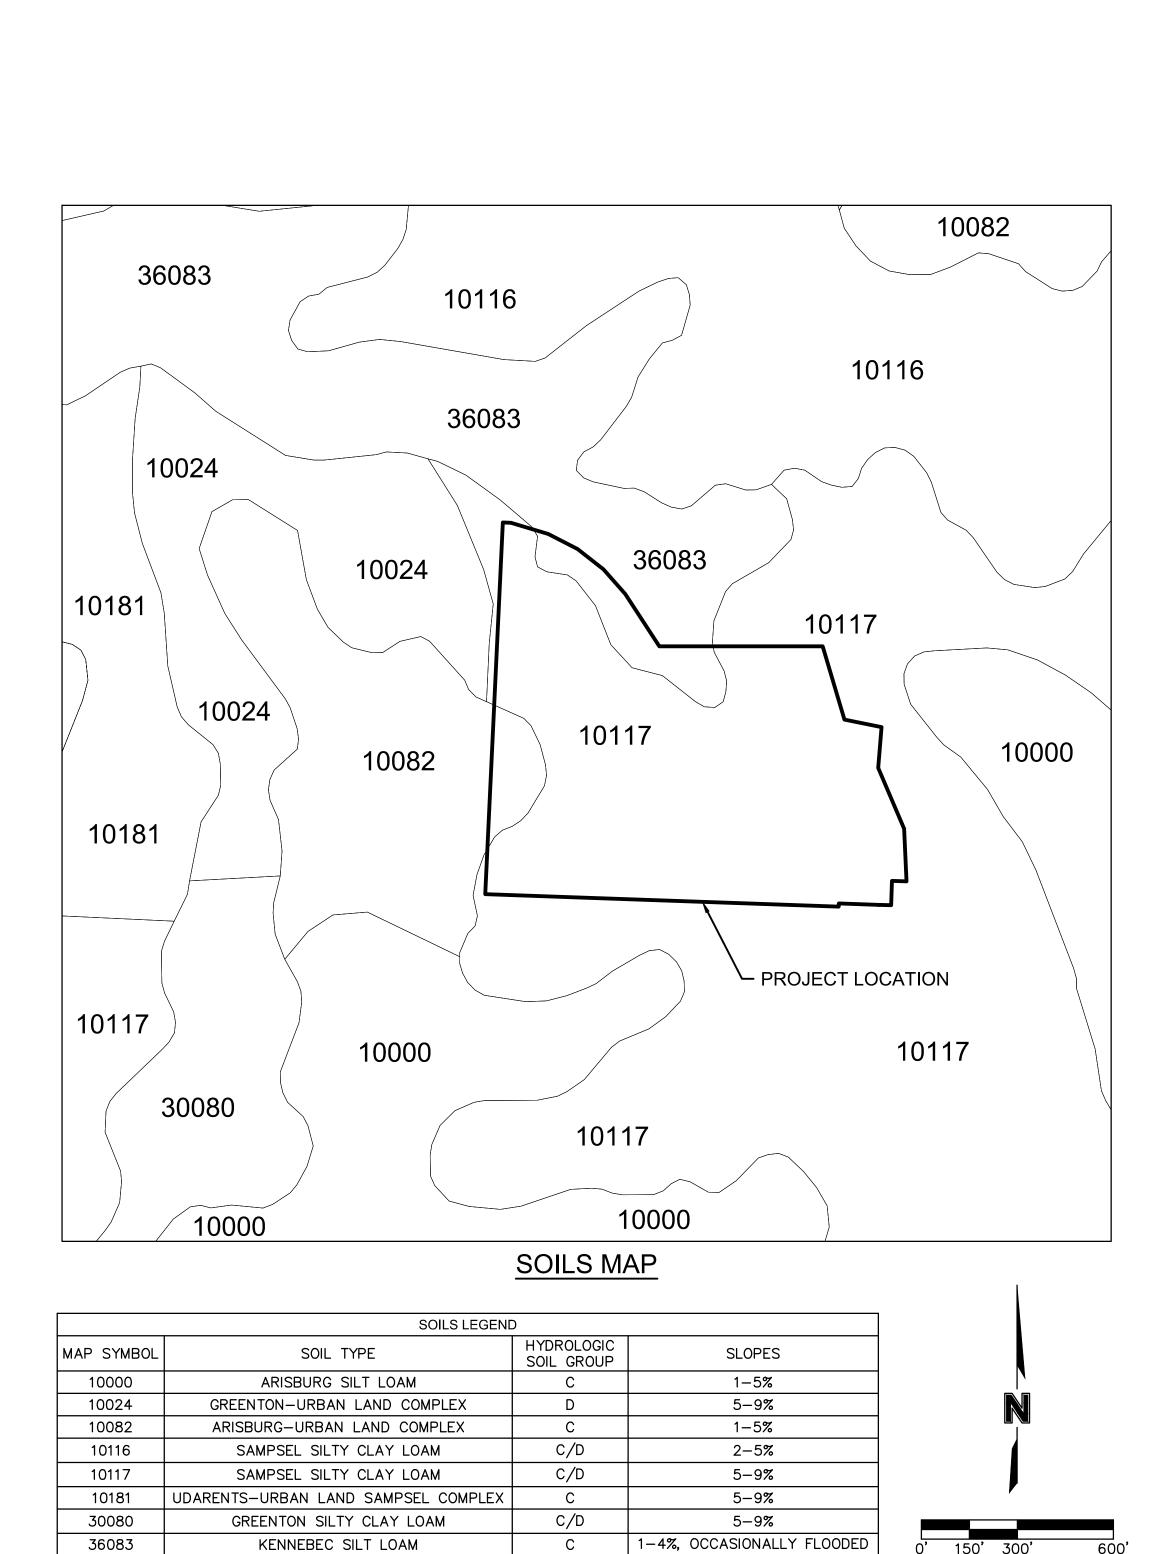

С

SCALE IN FEET

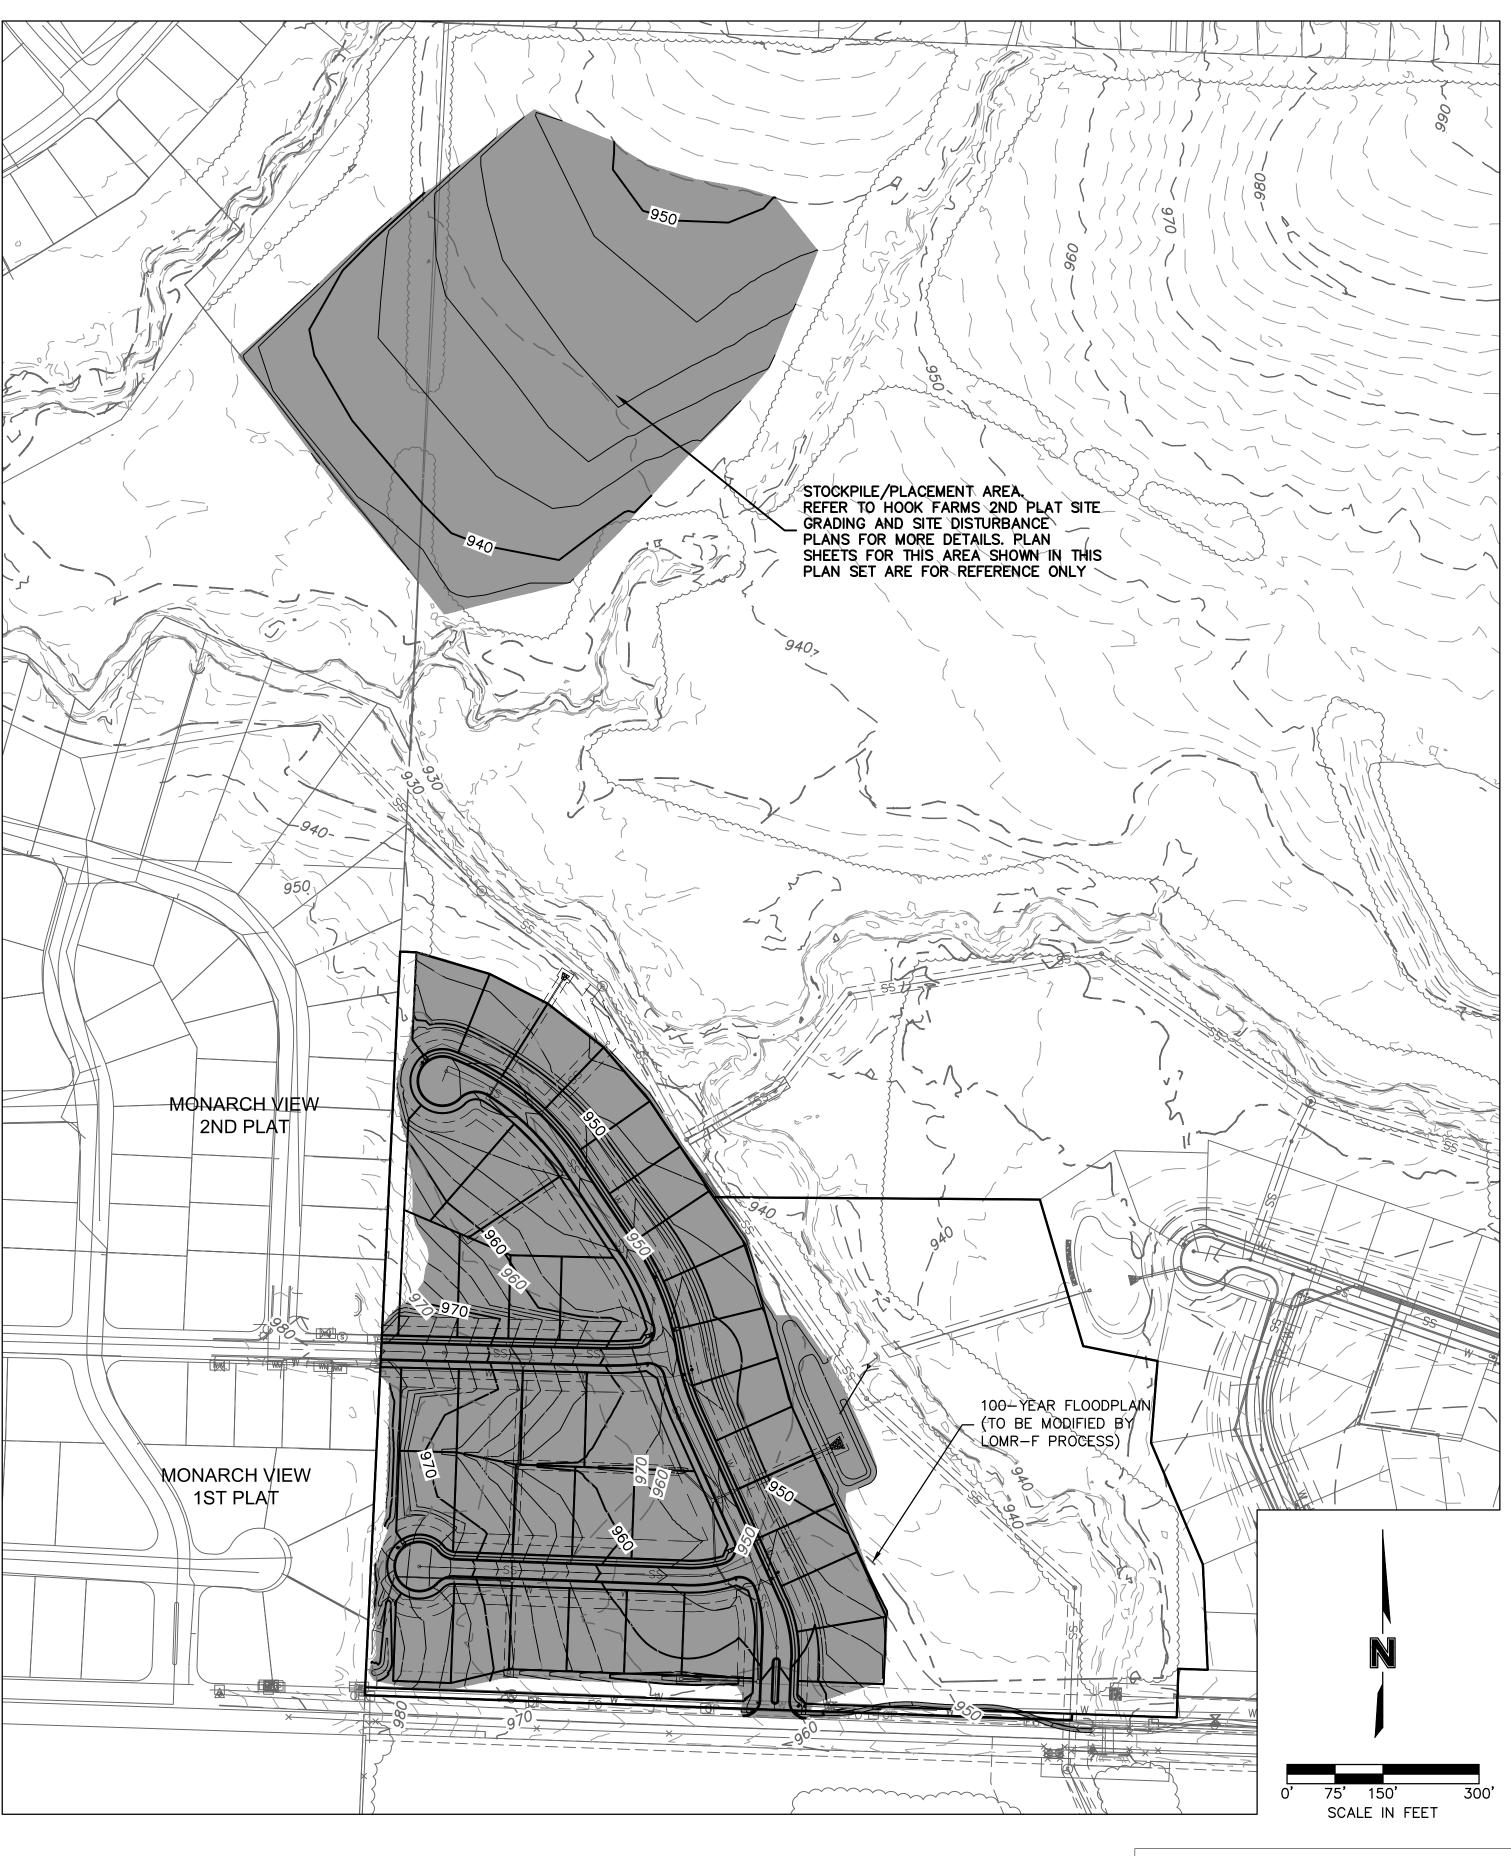

DISTURBED AREA & PRESERVED VEGETATION

LEGEND				
100	EXISTING INDEX CONTOURS			
100	EXISTING INTERMEDIATE CONTOURS			
100	PROPOSED INDEX CONTOURS			
100	PROPOSED INTERMEDIATE CONTOURS			

SITE B.M.W./A.A. drawn by: B.M.W. checked by: B.M.W./A.A. designed by: QA/QC by: project no.: A19-4059 05-05-2021 SHEET

C403

GRADING & SITE DISTURBANCE PLANS

JULIE ELAINE SELLERS


NUMBER PE-2017000367 10/29/21


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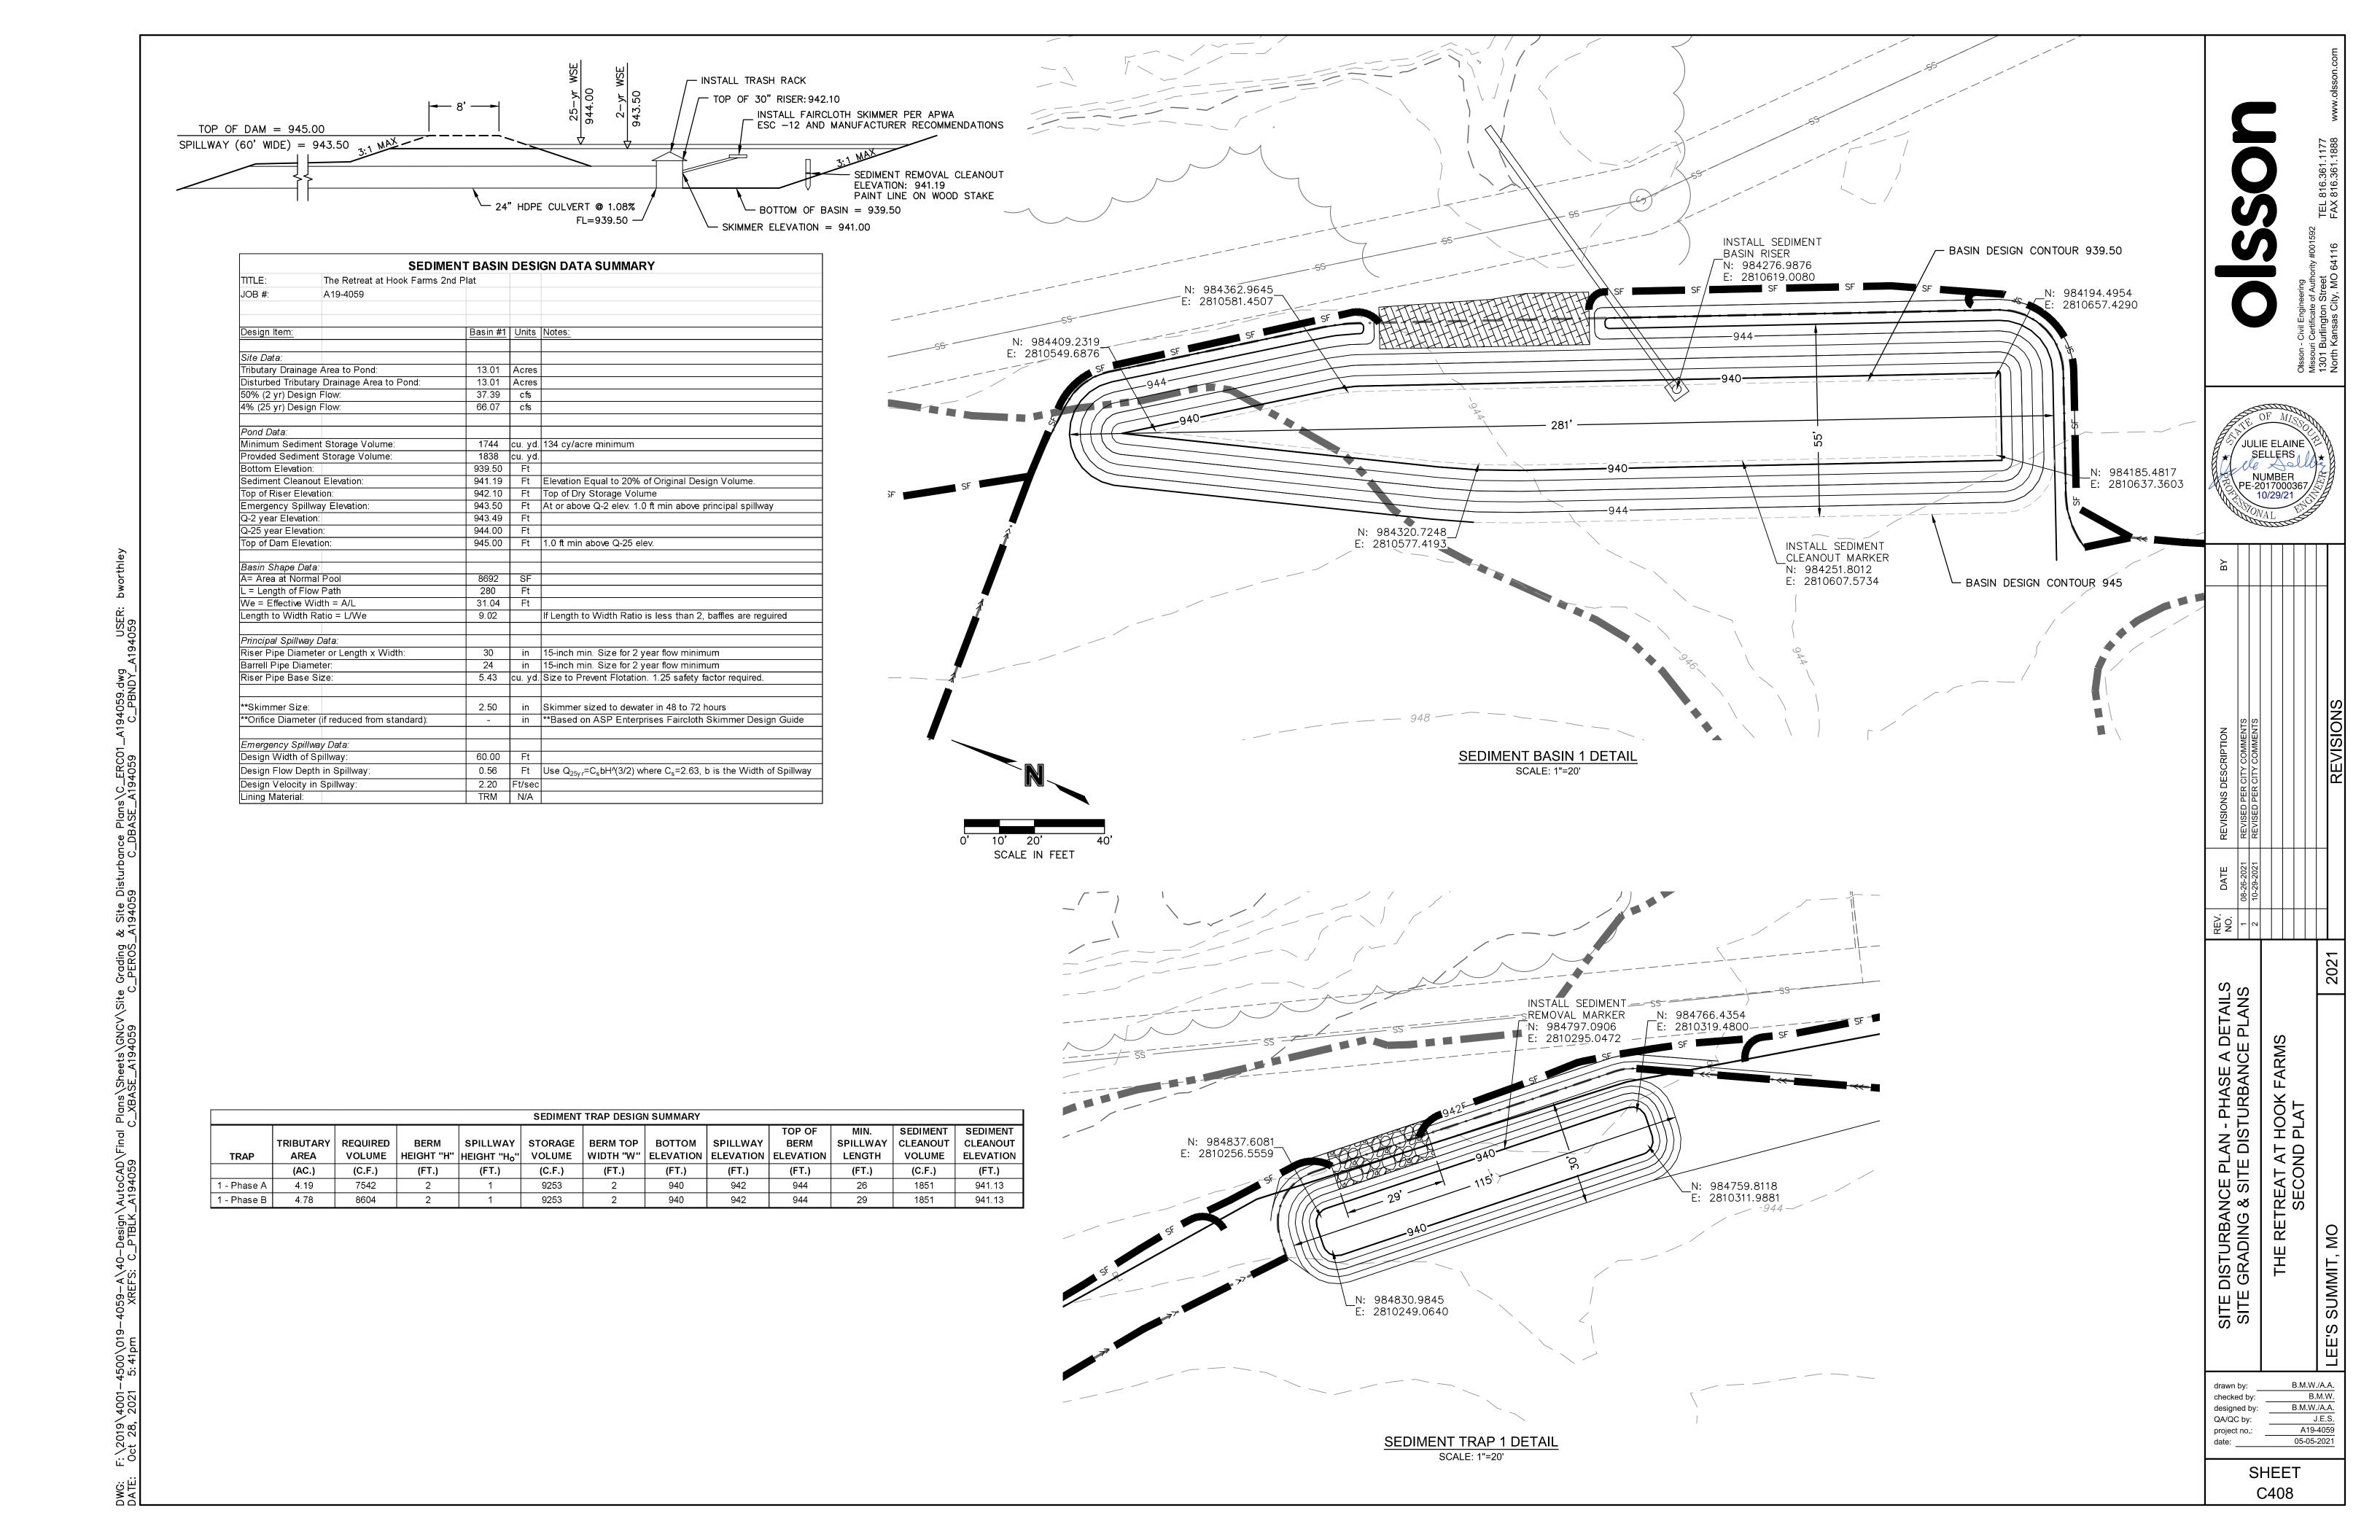
GENERAL NOTES: 1. CONTRACTOR SHALL ADHERE TO THE "DESIGN AND CONSTRUCTION MANUAL" SECTION 2100 AS ADOPTED BY THE CITY OF LEE'S SUMMIT (LATEST EDITION), FOR EXCAVATION AND EMBANKMENT WORK WITHIN THE PROPOSED RIGHT-OF-WAY. 2. AREAS OF CONSTRUCTION SHALL BE STRIPPED OF ALL VEGETATION, ORGANIC MATTER AND TOPSOIL TO A DEPTH AS RECOMMENDED BY GEOTECHNICAL ENGINEER AND OR TESTING AGENCY. SOILS REMOVED DURING SITE STRIPPING SHOULD BE EVALUATED TO DETERMINE IF PORTIONS OF THE TOPSOIL STRATUM MAY BE UTILIZED AS STRUCTURAL FILL WITHIN PAVEMENT AREAS. ANY MATERIAL NOT DEEMED AS SUITABLE FILL MATERIAL BY THE GEOTECHNICAL ENGINEER AND OR TESTING AGENCY SHALL BE REMOVED FROM THE JOB SITE BY THE CONTRACTOR AT HIS EXPENSE. 3. ALL EMBANKMENT OUTSIDE OF RIGHT-OF-WAY SHOULD BE PLACED IN CONTROLLED LIFTS HAVING A MAXIMUM LOOSE LIFT THICKNESS OF 8". EMBANKMENT SHOULD BE COMPACTED TO A MINIMUM OF 95% OF THE MATERIALS MAXIMUM DRY DENSITY AS DETERMINED BY ASTM D-698 (STANDARD PROCTOR COMPACTION). MOISTURE CONTENT OF THE FILL AT THE TIME OF COMPACTION SHALL BE WITHIN A RANGE OF -0 TO +4 PERCENT OF OPTIMUM MOISTURE CONTENT. 4. REFER TO HOOK FARMS 2ND PLAT PLANS FOR MORE DETAILS ABOUT EARTHWORK SHOWN ON THIS SHEET. ······· EARTHWORK QUANTITIES CUT (C.Y.) | FILL (C.Y.) LOCATION FUTURE PHASE 54,547 FUTURE PHASE **EARTHWORK CONTRIBUTIONS** FILL (C.Y.) LOCATION HOOK FARMS 42,194 2ND PLAT RETREAT AT 9,872 HOOK FARMS 2ND PLAT **EXCESS EARTHWORK QUANTITIES NOTES:** 1. EARTHWORK QUANTITIES BASED ON FINISHED GRADE SURFACE AND DO NOT INCLUDE ADJUSTMENTS FOR TOPSOIL AND SHRINKAGE. 2. EARTHWORK QUANTITIES DO NOT TAKE INTO MATERIAL DEEMED UNSUITABLE BY A GEOTECHNICAL FOR EXCAVATION, REMOVAL AND DISPOSAL OF UNSUITABLE MATERIAL AND FOR REPLACING IT WITH SUITABLE MATERIAL.


CONSIDERATION EXCAVATION, REMOVAL AND DISPOSAL OF ENGINEER. THE EARTHWORK CONTRACTOR IS RESPONSIBLE

~ ~960_ 222 220 958.19 225 SW FARMHOUSE ROAD JULIE ELAINE SELLERS 1 NUMBER 257 PE-2017000367 10/29/21 253 246 243 250 231 248 241 GRADING PLAN (FOR REFERENCE) GRADING & SITE DISTURBANCE PLANS **HOOK FARMS** 2ND PLAT THE RETREAT AT P 236 100-YEAR FLOODPLAIN SW HOOK FARM DRIV SITE LEGEND - -100- - EXISTING INDEX CONTOURS B.M.W./A.A. 62 63 64 B.M.W. EXISTING INTERMEDIATE CONTOURS checked by: B.M.W./A.A. designed by: —100— PROPOSED INDEX CONTOURS QA/QC by: project no.: A19-4059 HOOK FARMS 2ND PLAT INDEX CONTOURS 05-05-2021 HOOK FARMS 2ND PLAT INTERMEDIATE CONTOURS SHEET C405



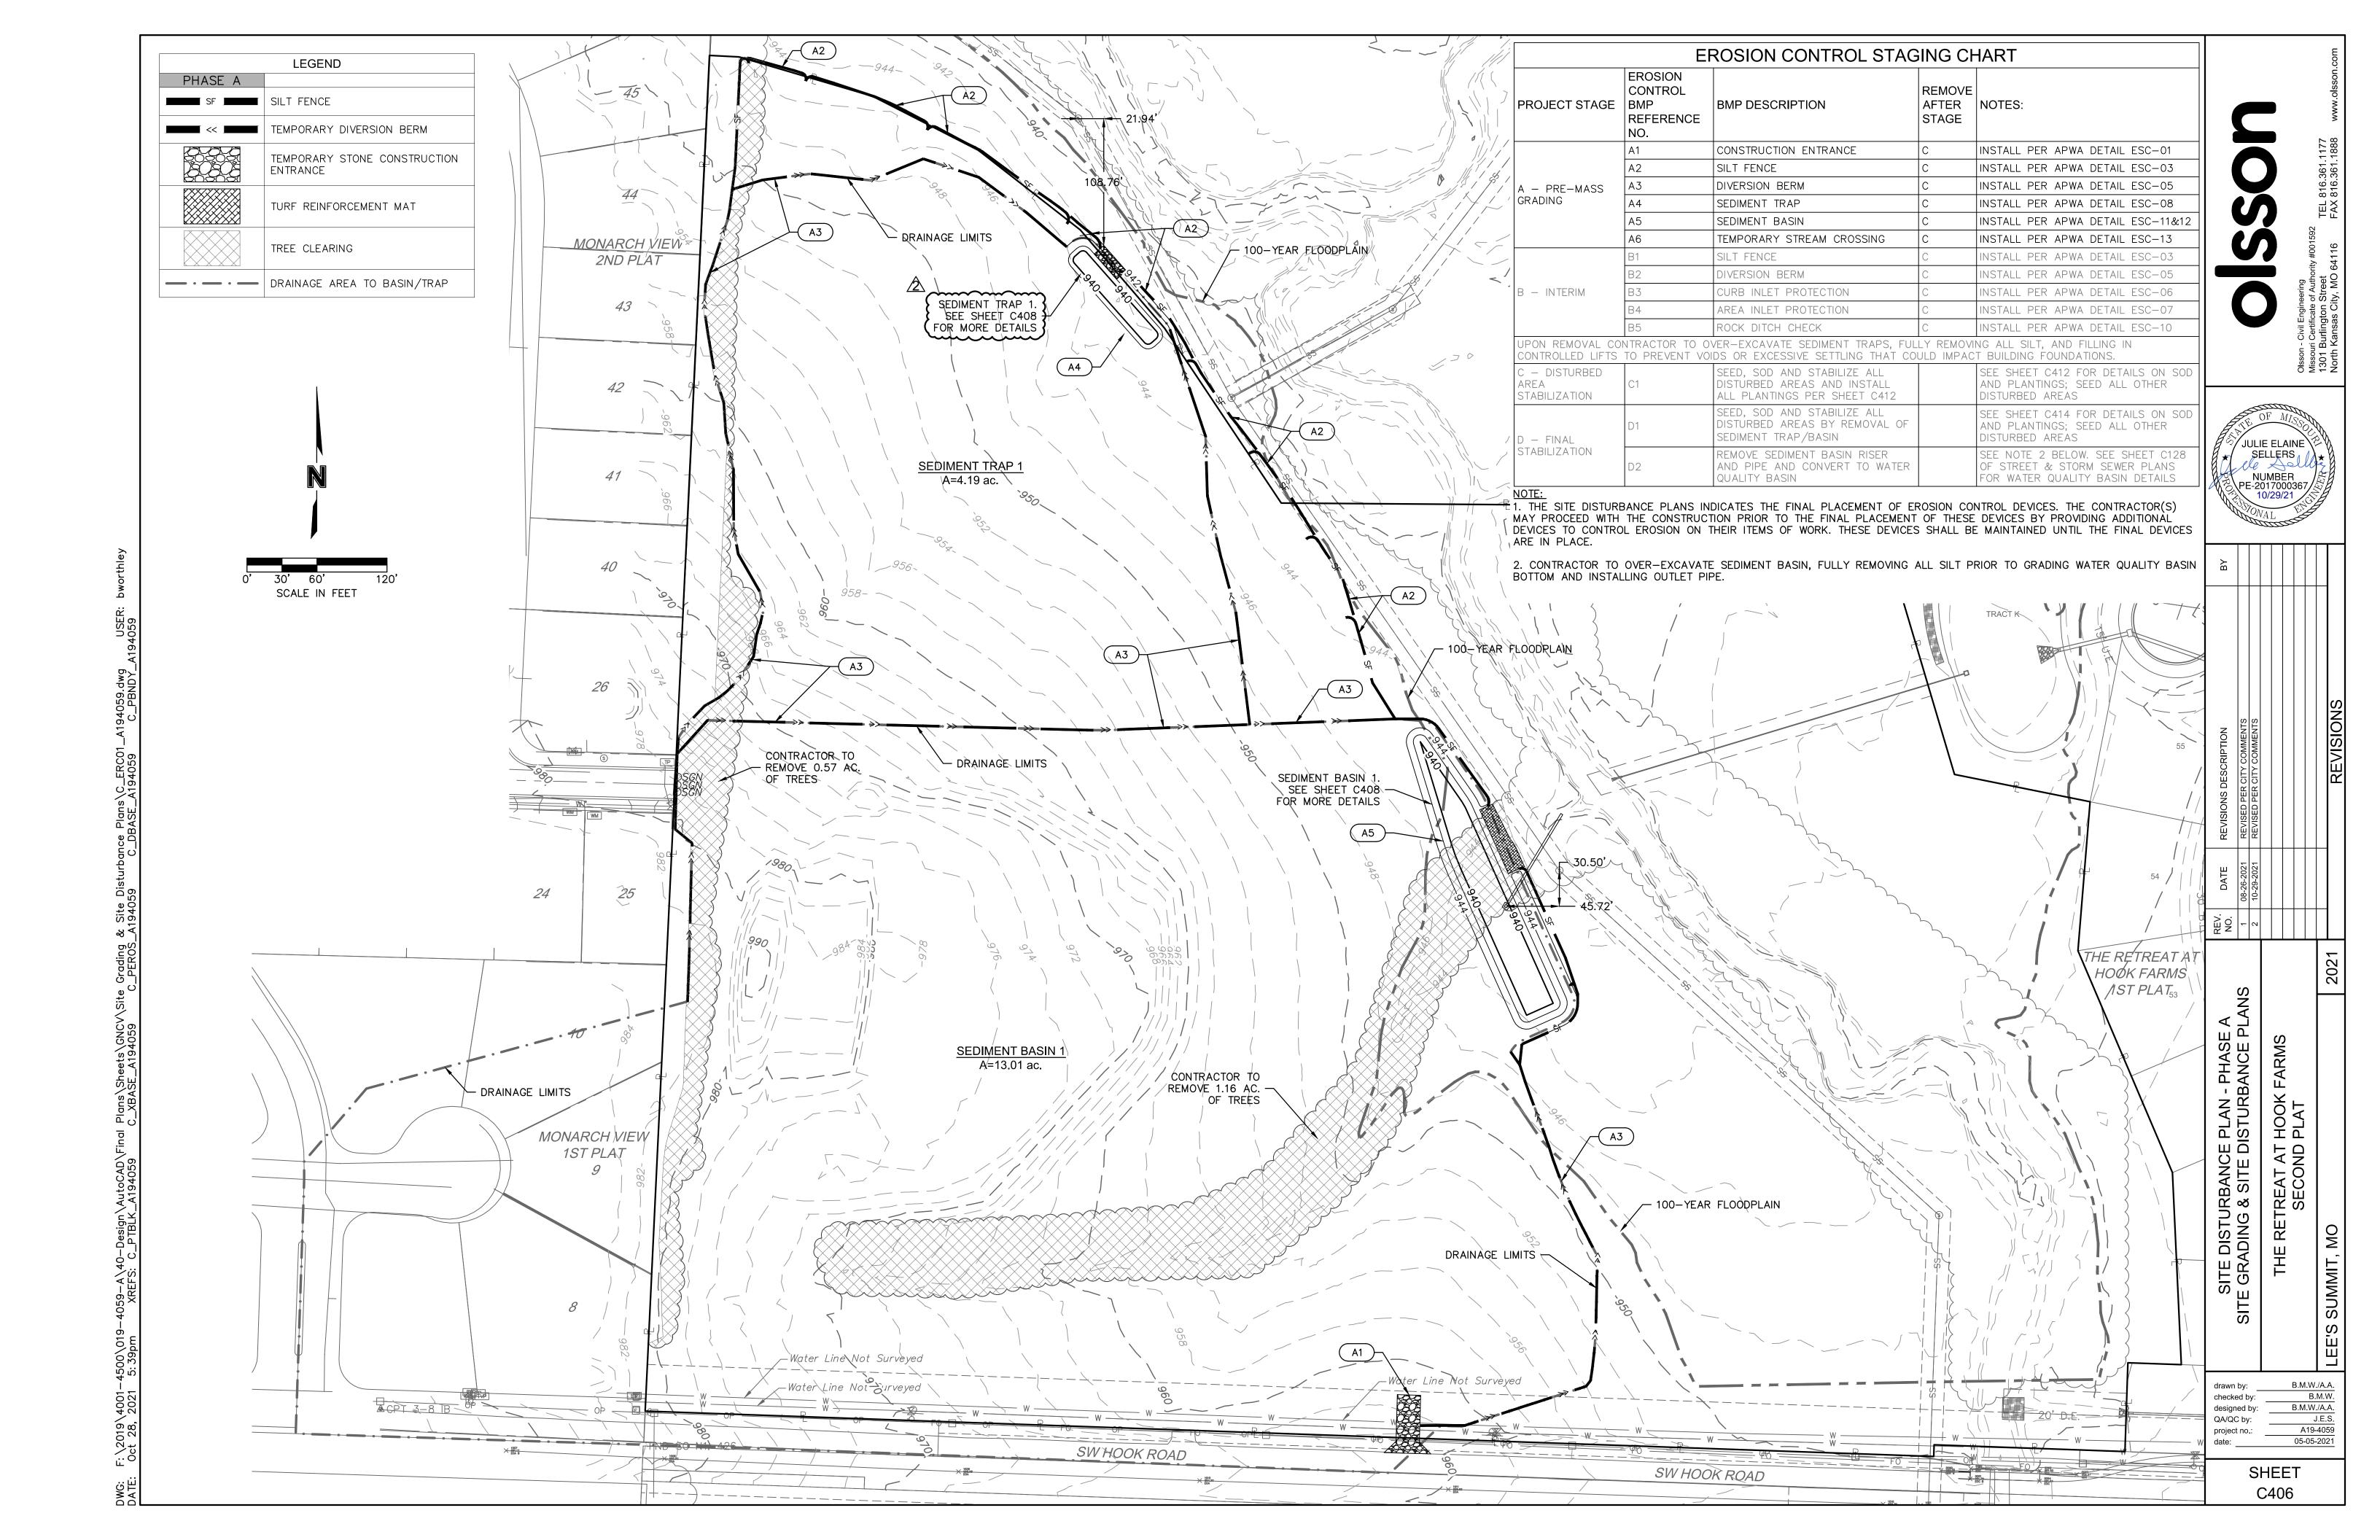

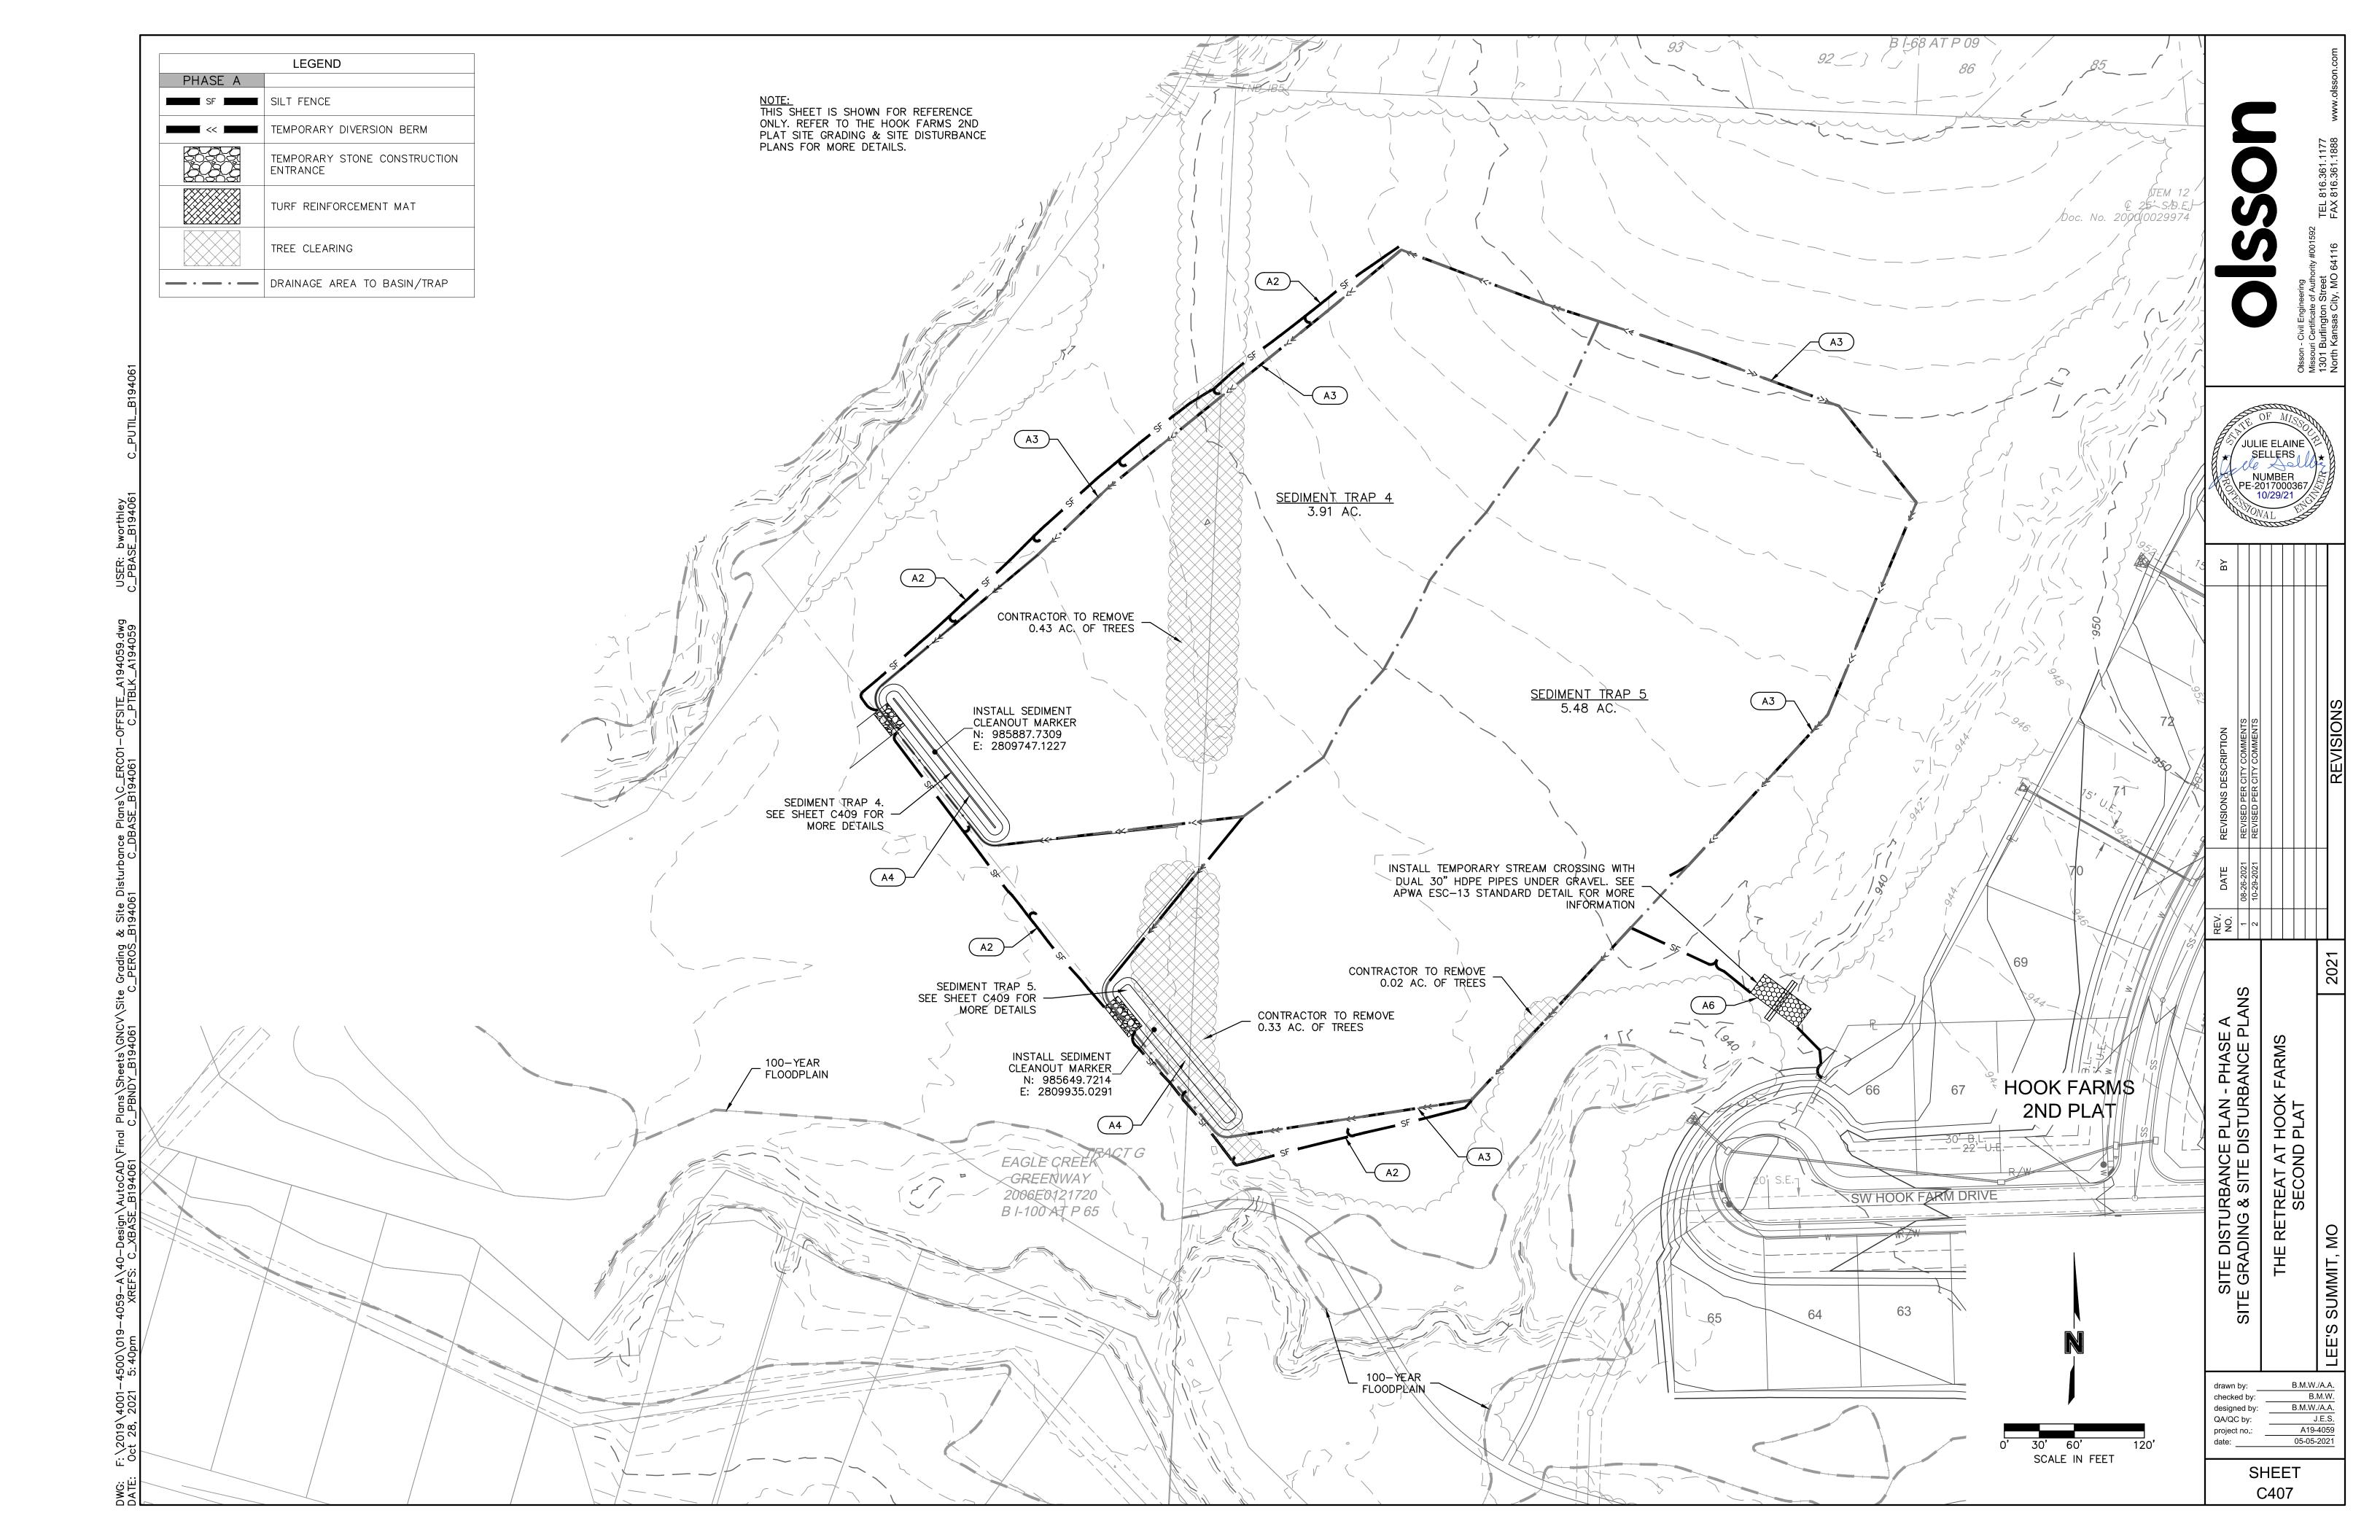

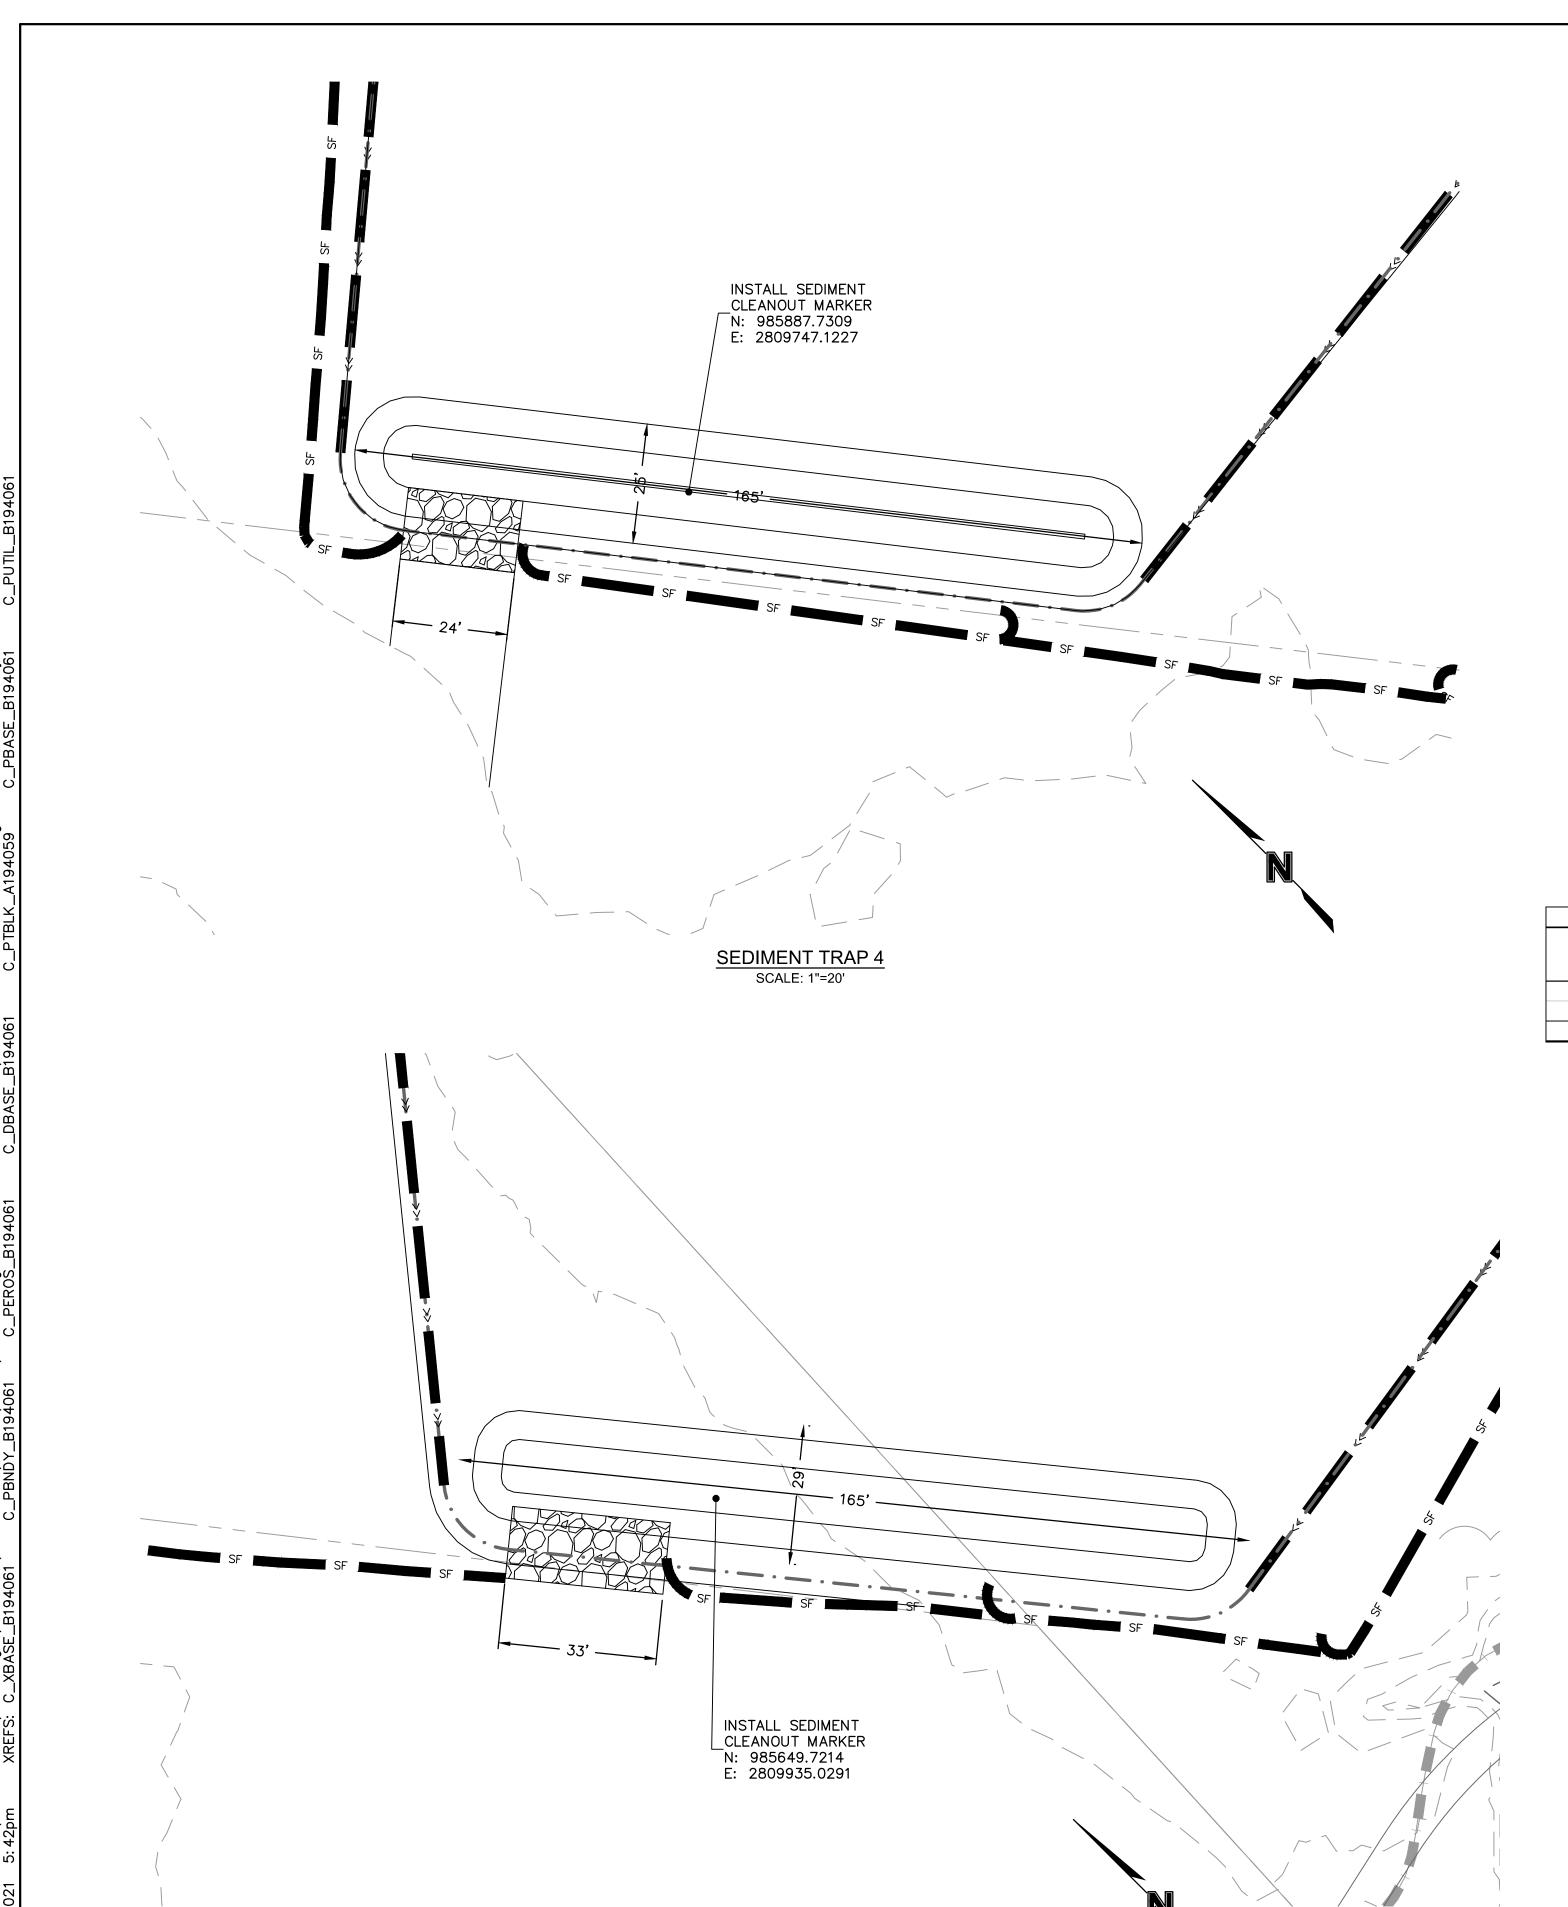

SEDIMENT TRAP 5
SCALE: 1"=20'

SEDIMENT TRAP DESIGN SUMMARY												
TOP OF MIN. SEDIMENT SEDIMENT												
	TRIBUTARY	REQUIRED	BERM	SPILLWAY	STORAGE	BERM TOP	воттом	SPILLWAY	BERM	SPILLWAY	CLEANOUT	CLEANOUT
TRAP	AREA	VOLUME	HEIGHT "H"	HEIGHT "Ho"	VOLUME	WIDTH "W"	ELEVATION	ELEVATION	ELEVATION	LENGTH	VOLUME	ELEVATION
	(AC.)	(C.F.)	(FT.)	(FT.)	(C.F.)	(FT.)	(FT.)	(FT.)	(FT.)	(FT.)	(C.F.)	(FT.)
4	3.91	7045.87	2	1	7984.01	2	932	934	936	24	1596.80	933.67
5	5.48	9871.45	2	1	10415.42	2	933	935	937	33	2083.08	934.46

JULIE ELAINE SELLERS NUMBER PE-2017000367

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SED PER CITY COMMENTS	
SED PER CITY COMMENTS	

REVISIONS DESCRIP	REVISED PER CITY COM	REVISED PER CITY COM		
DATE	08-26-2021	10-29-2021		
NO.	1	2		


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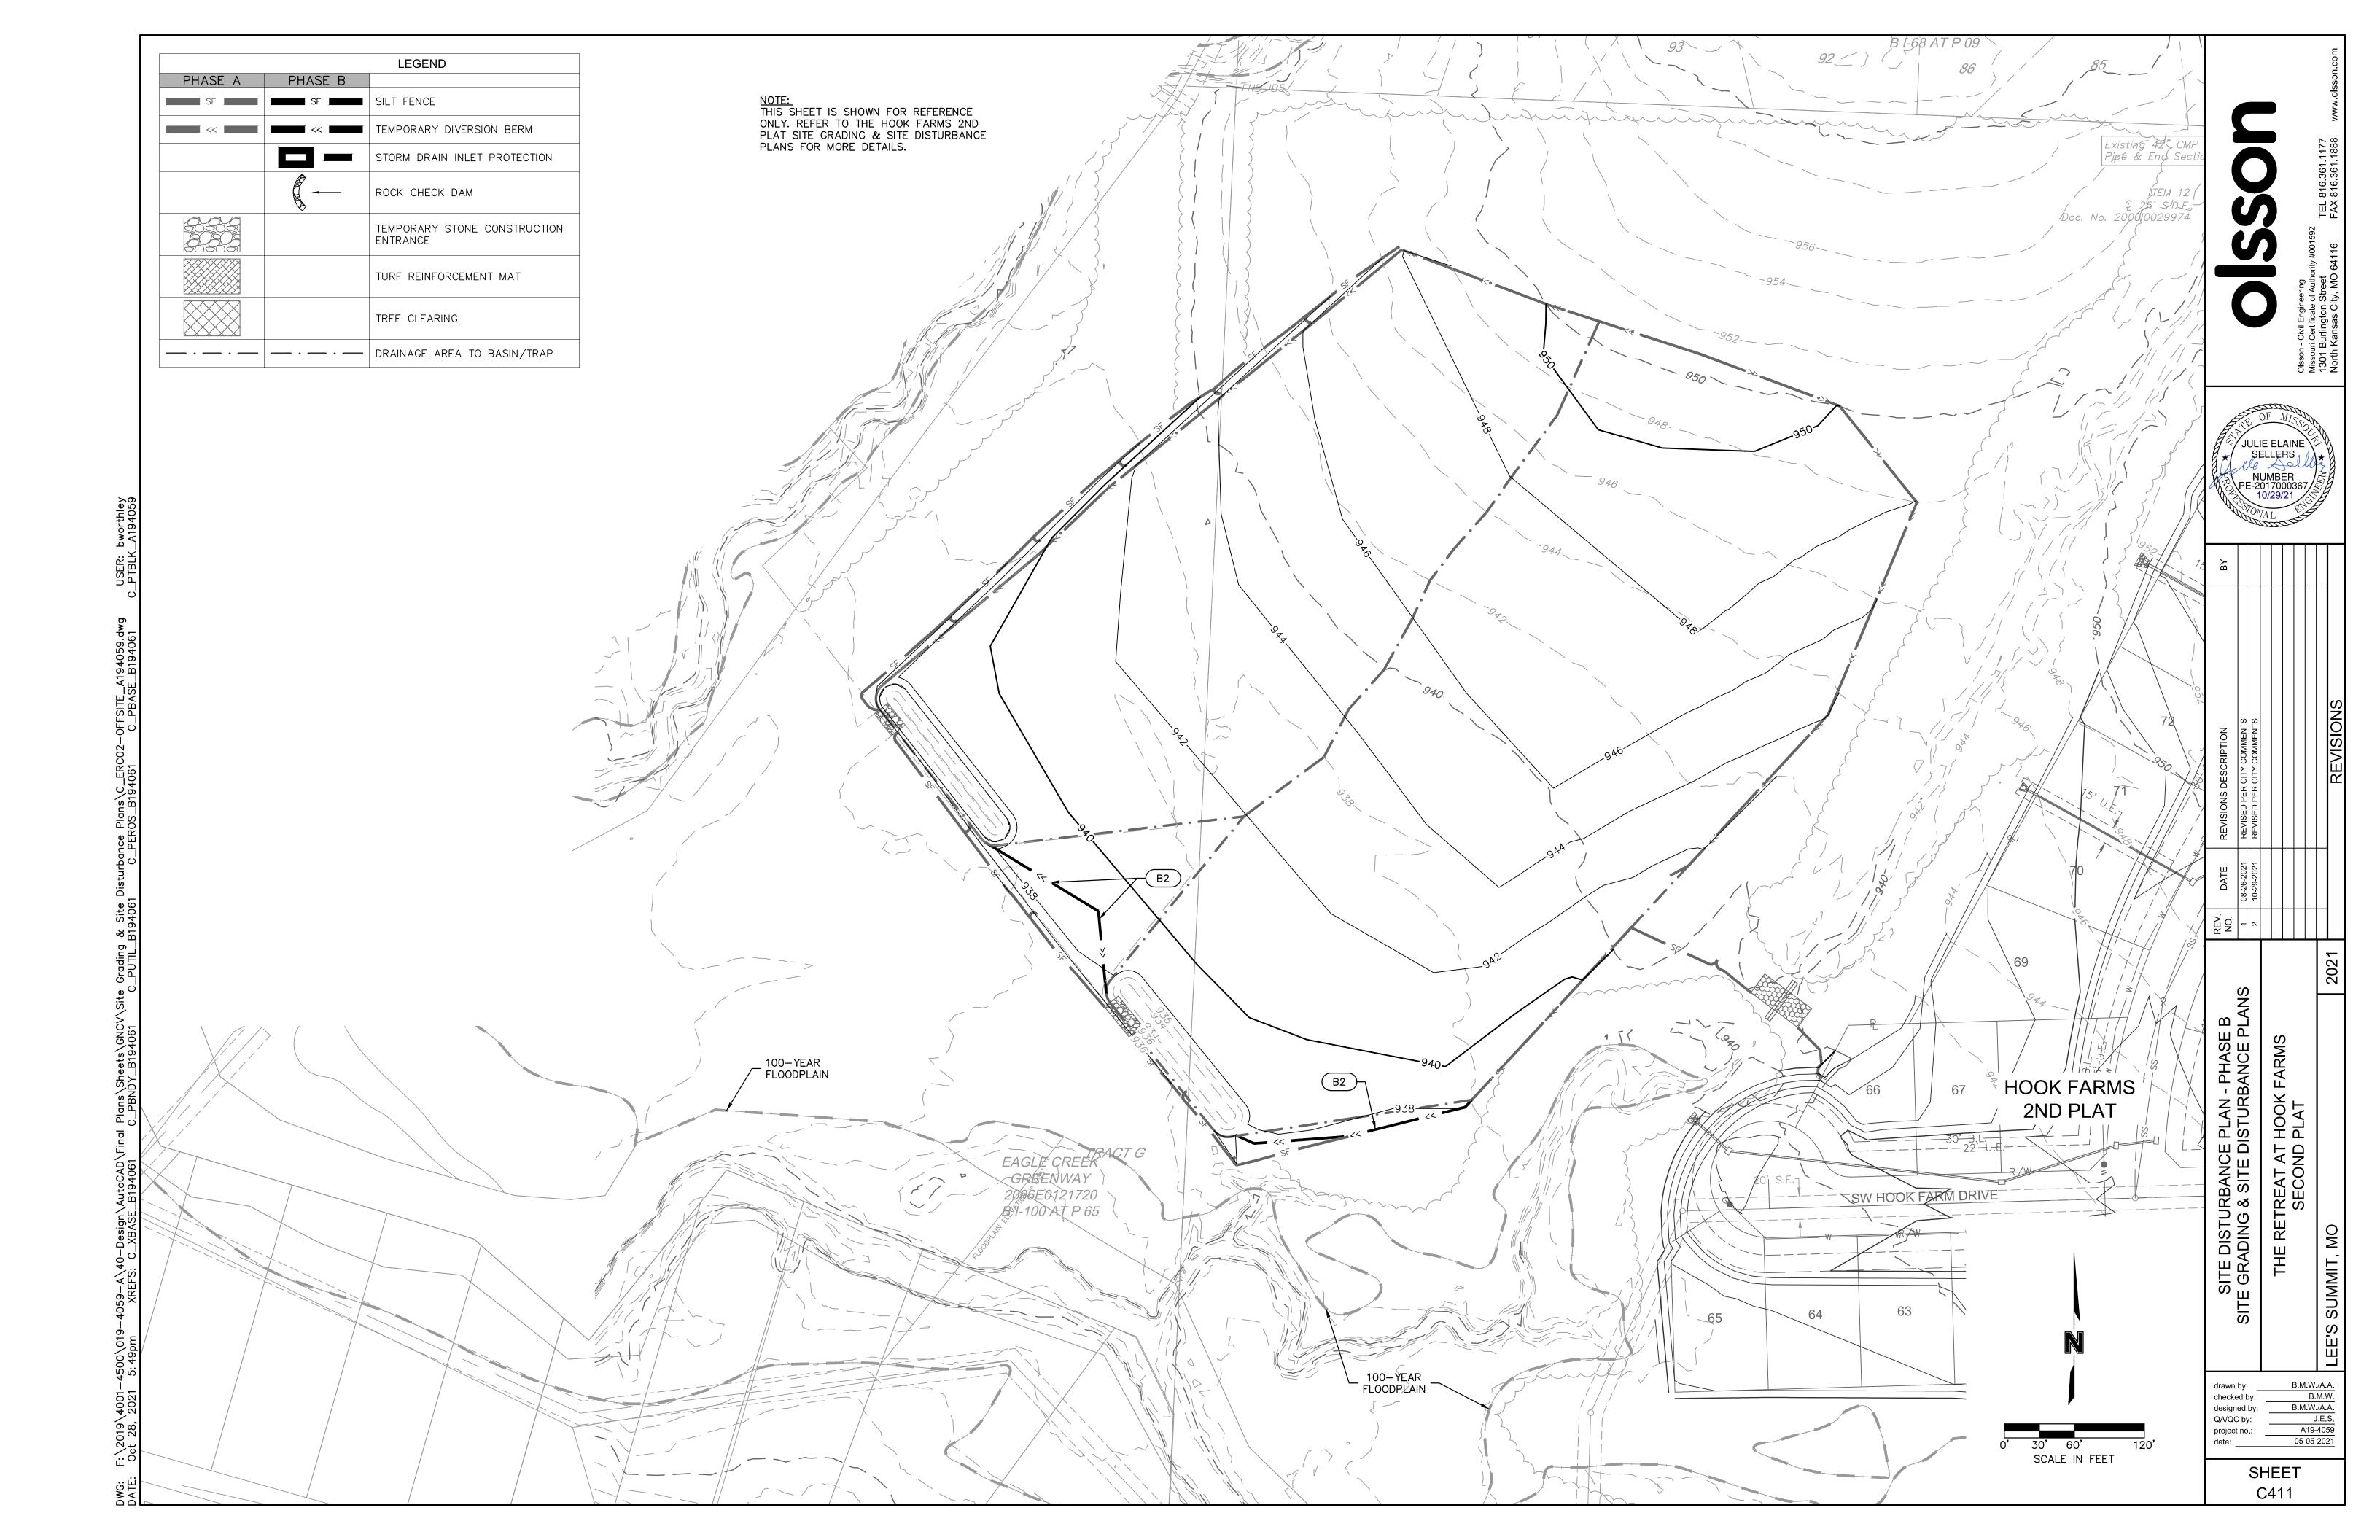
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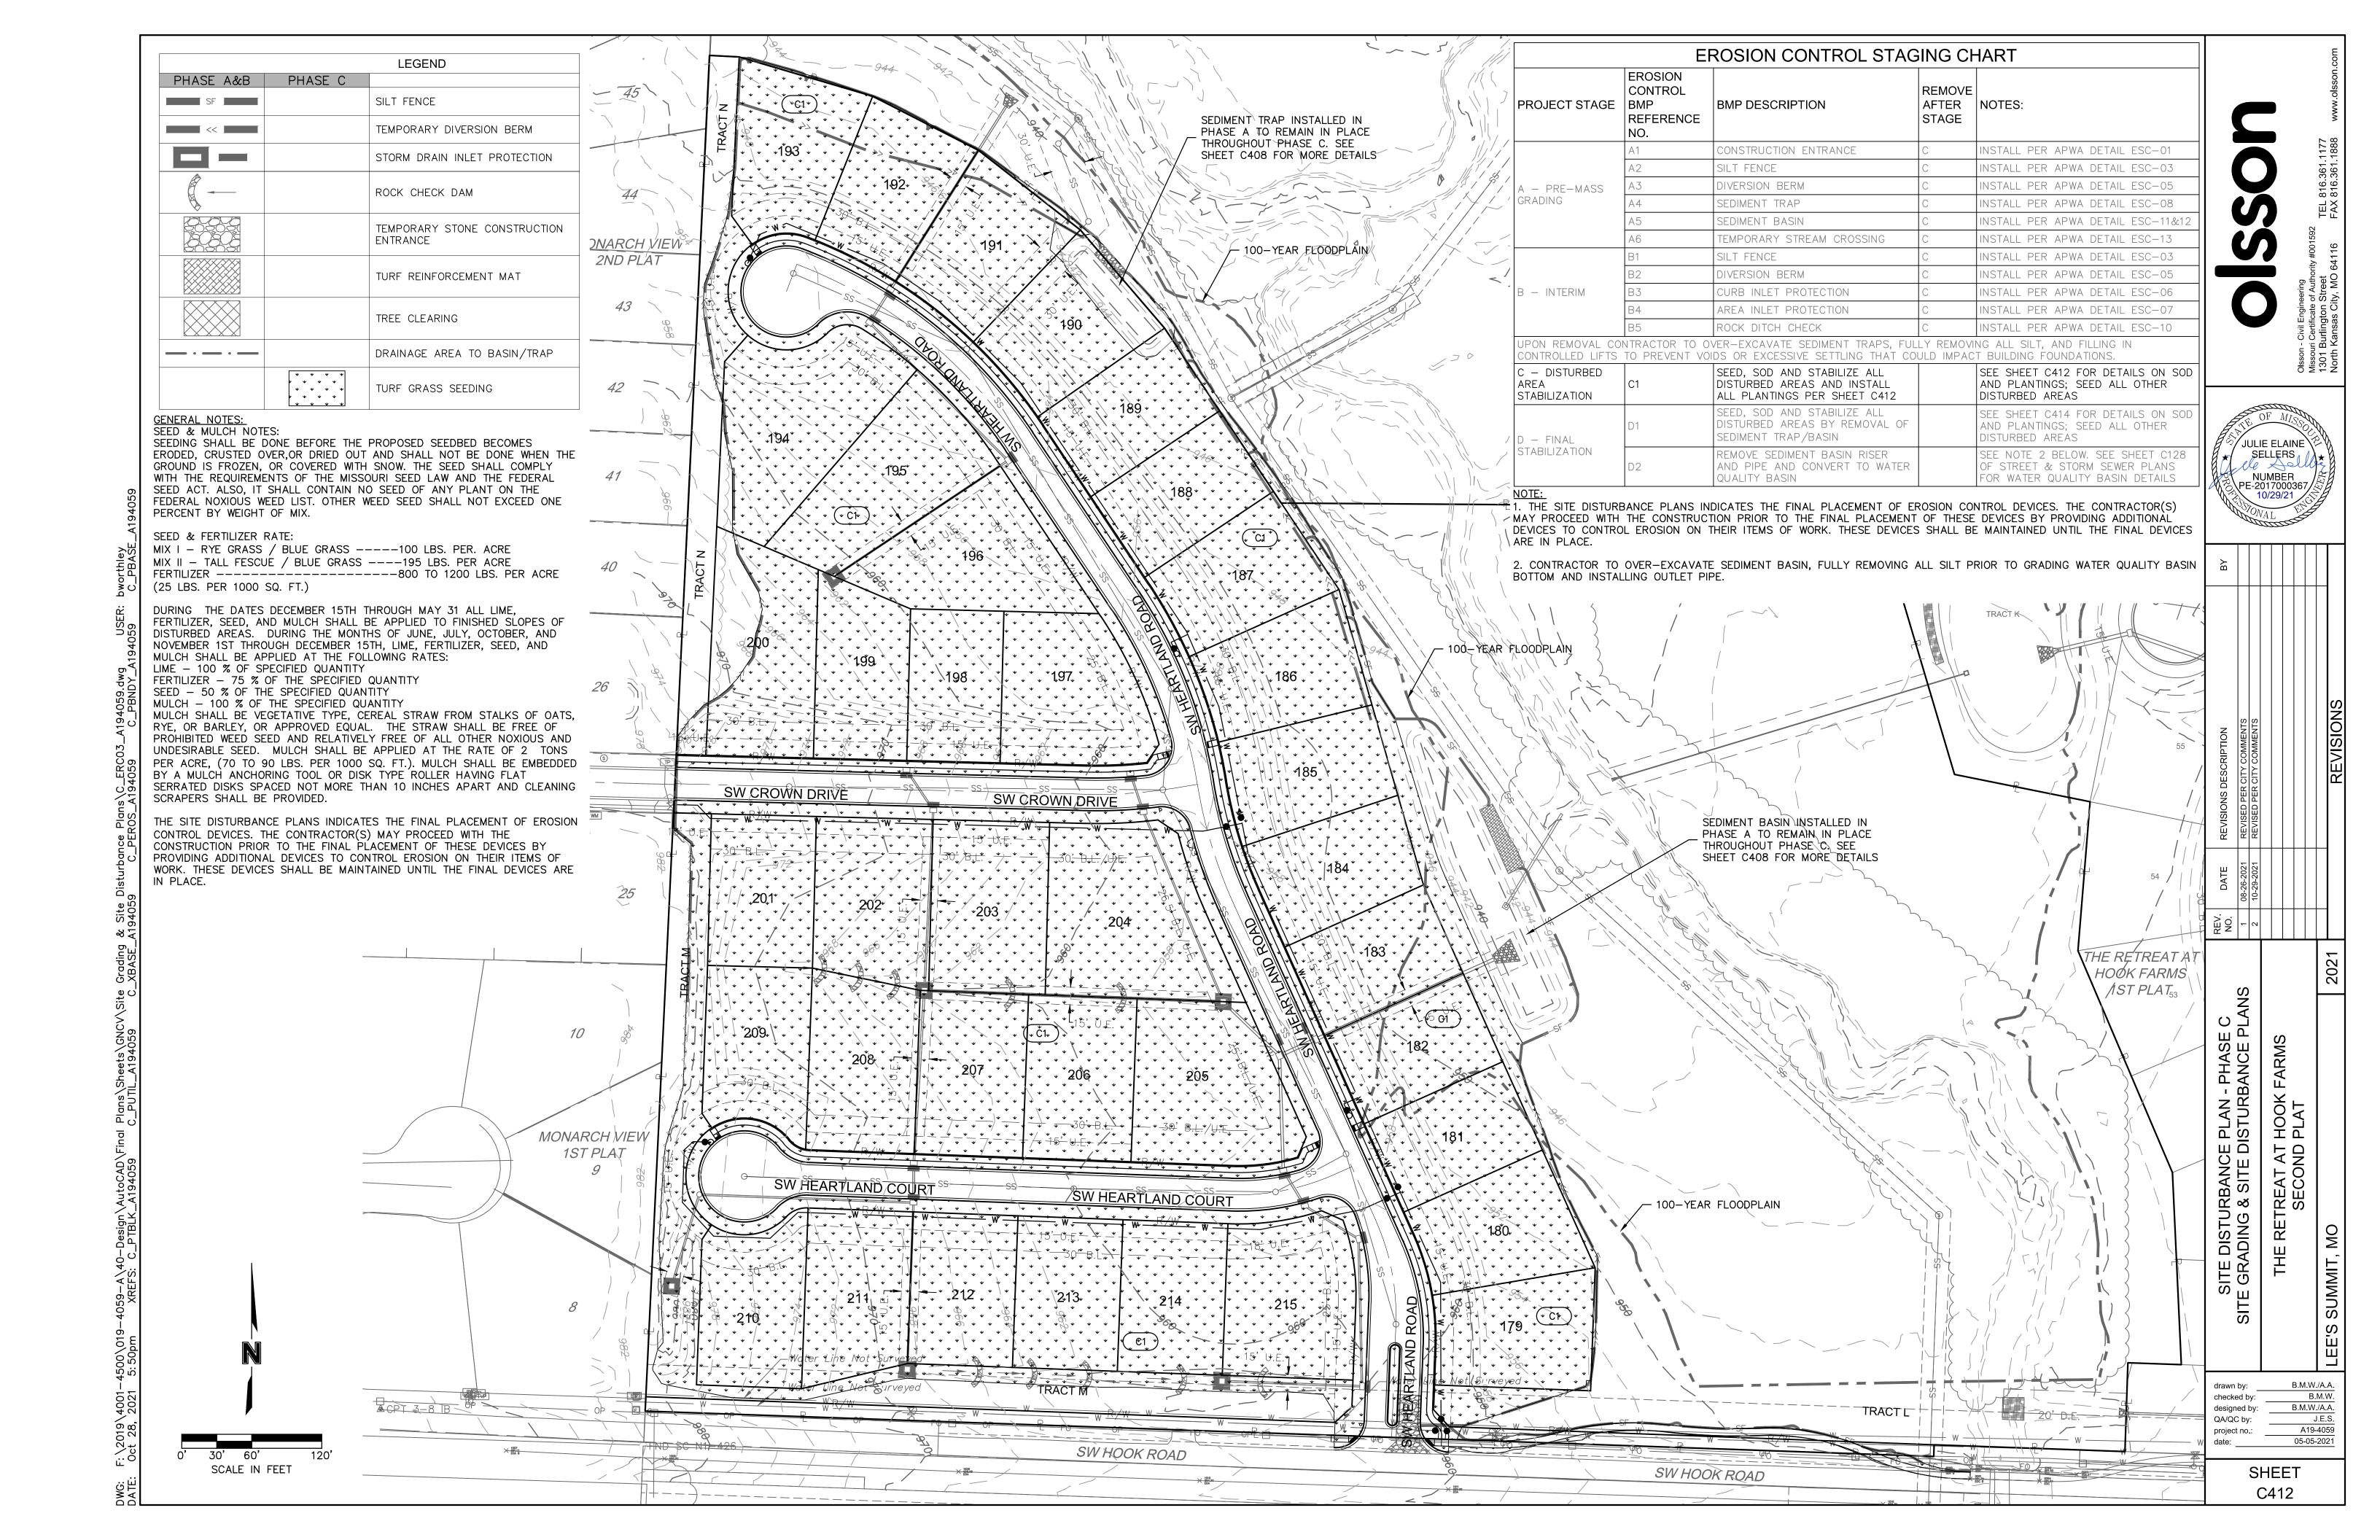
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QC by:	J	E.S.
ect no.:	A19-	4059
:	05-05-	2021


SHEET C409





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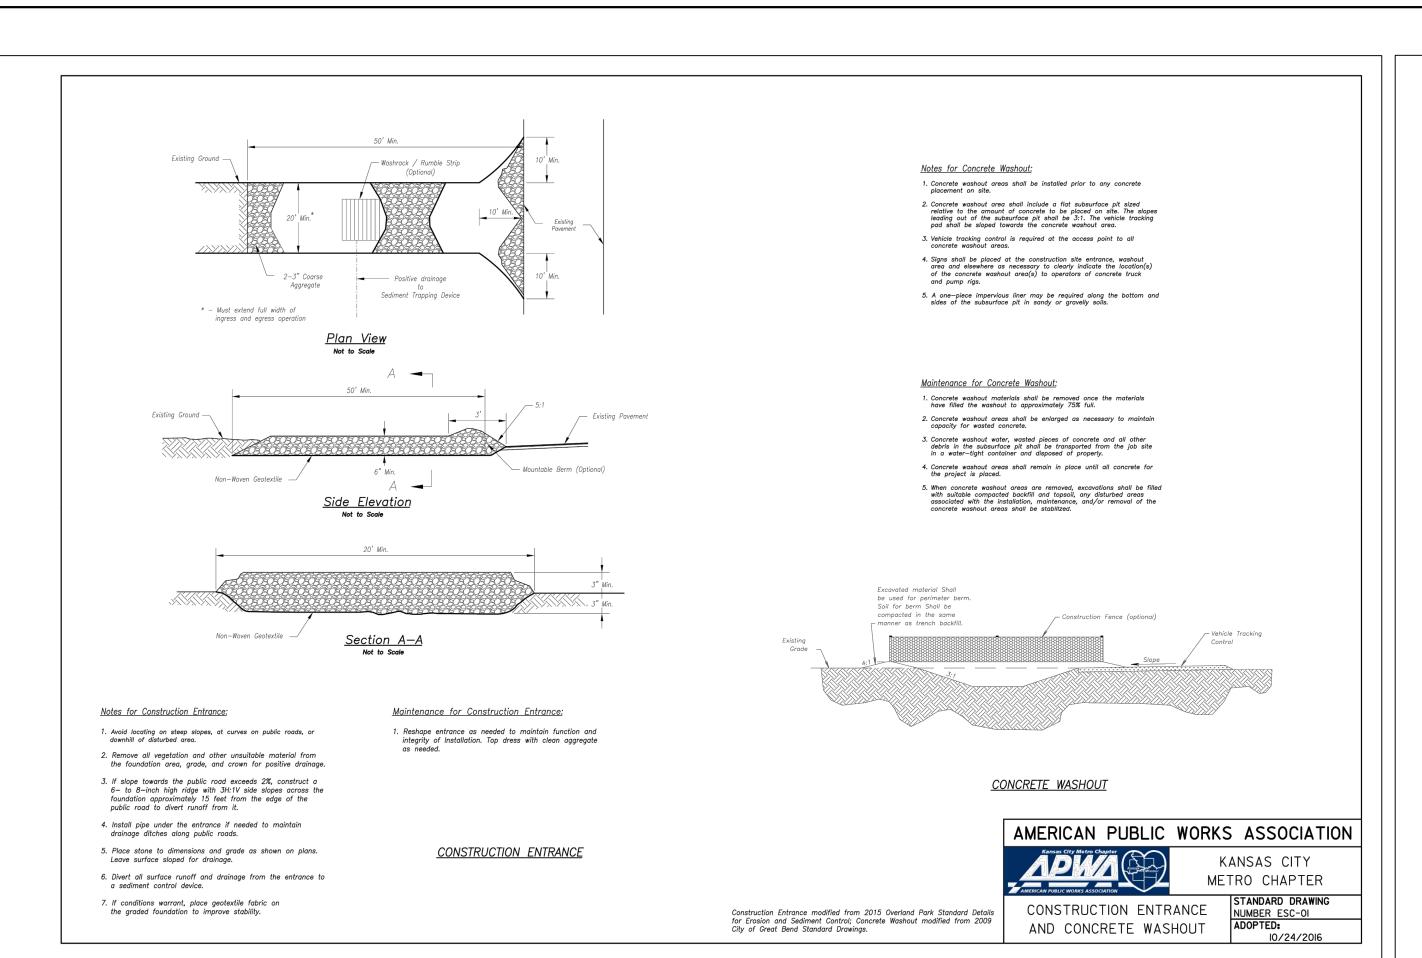





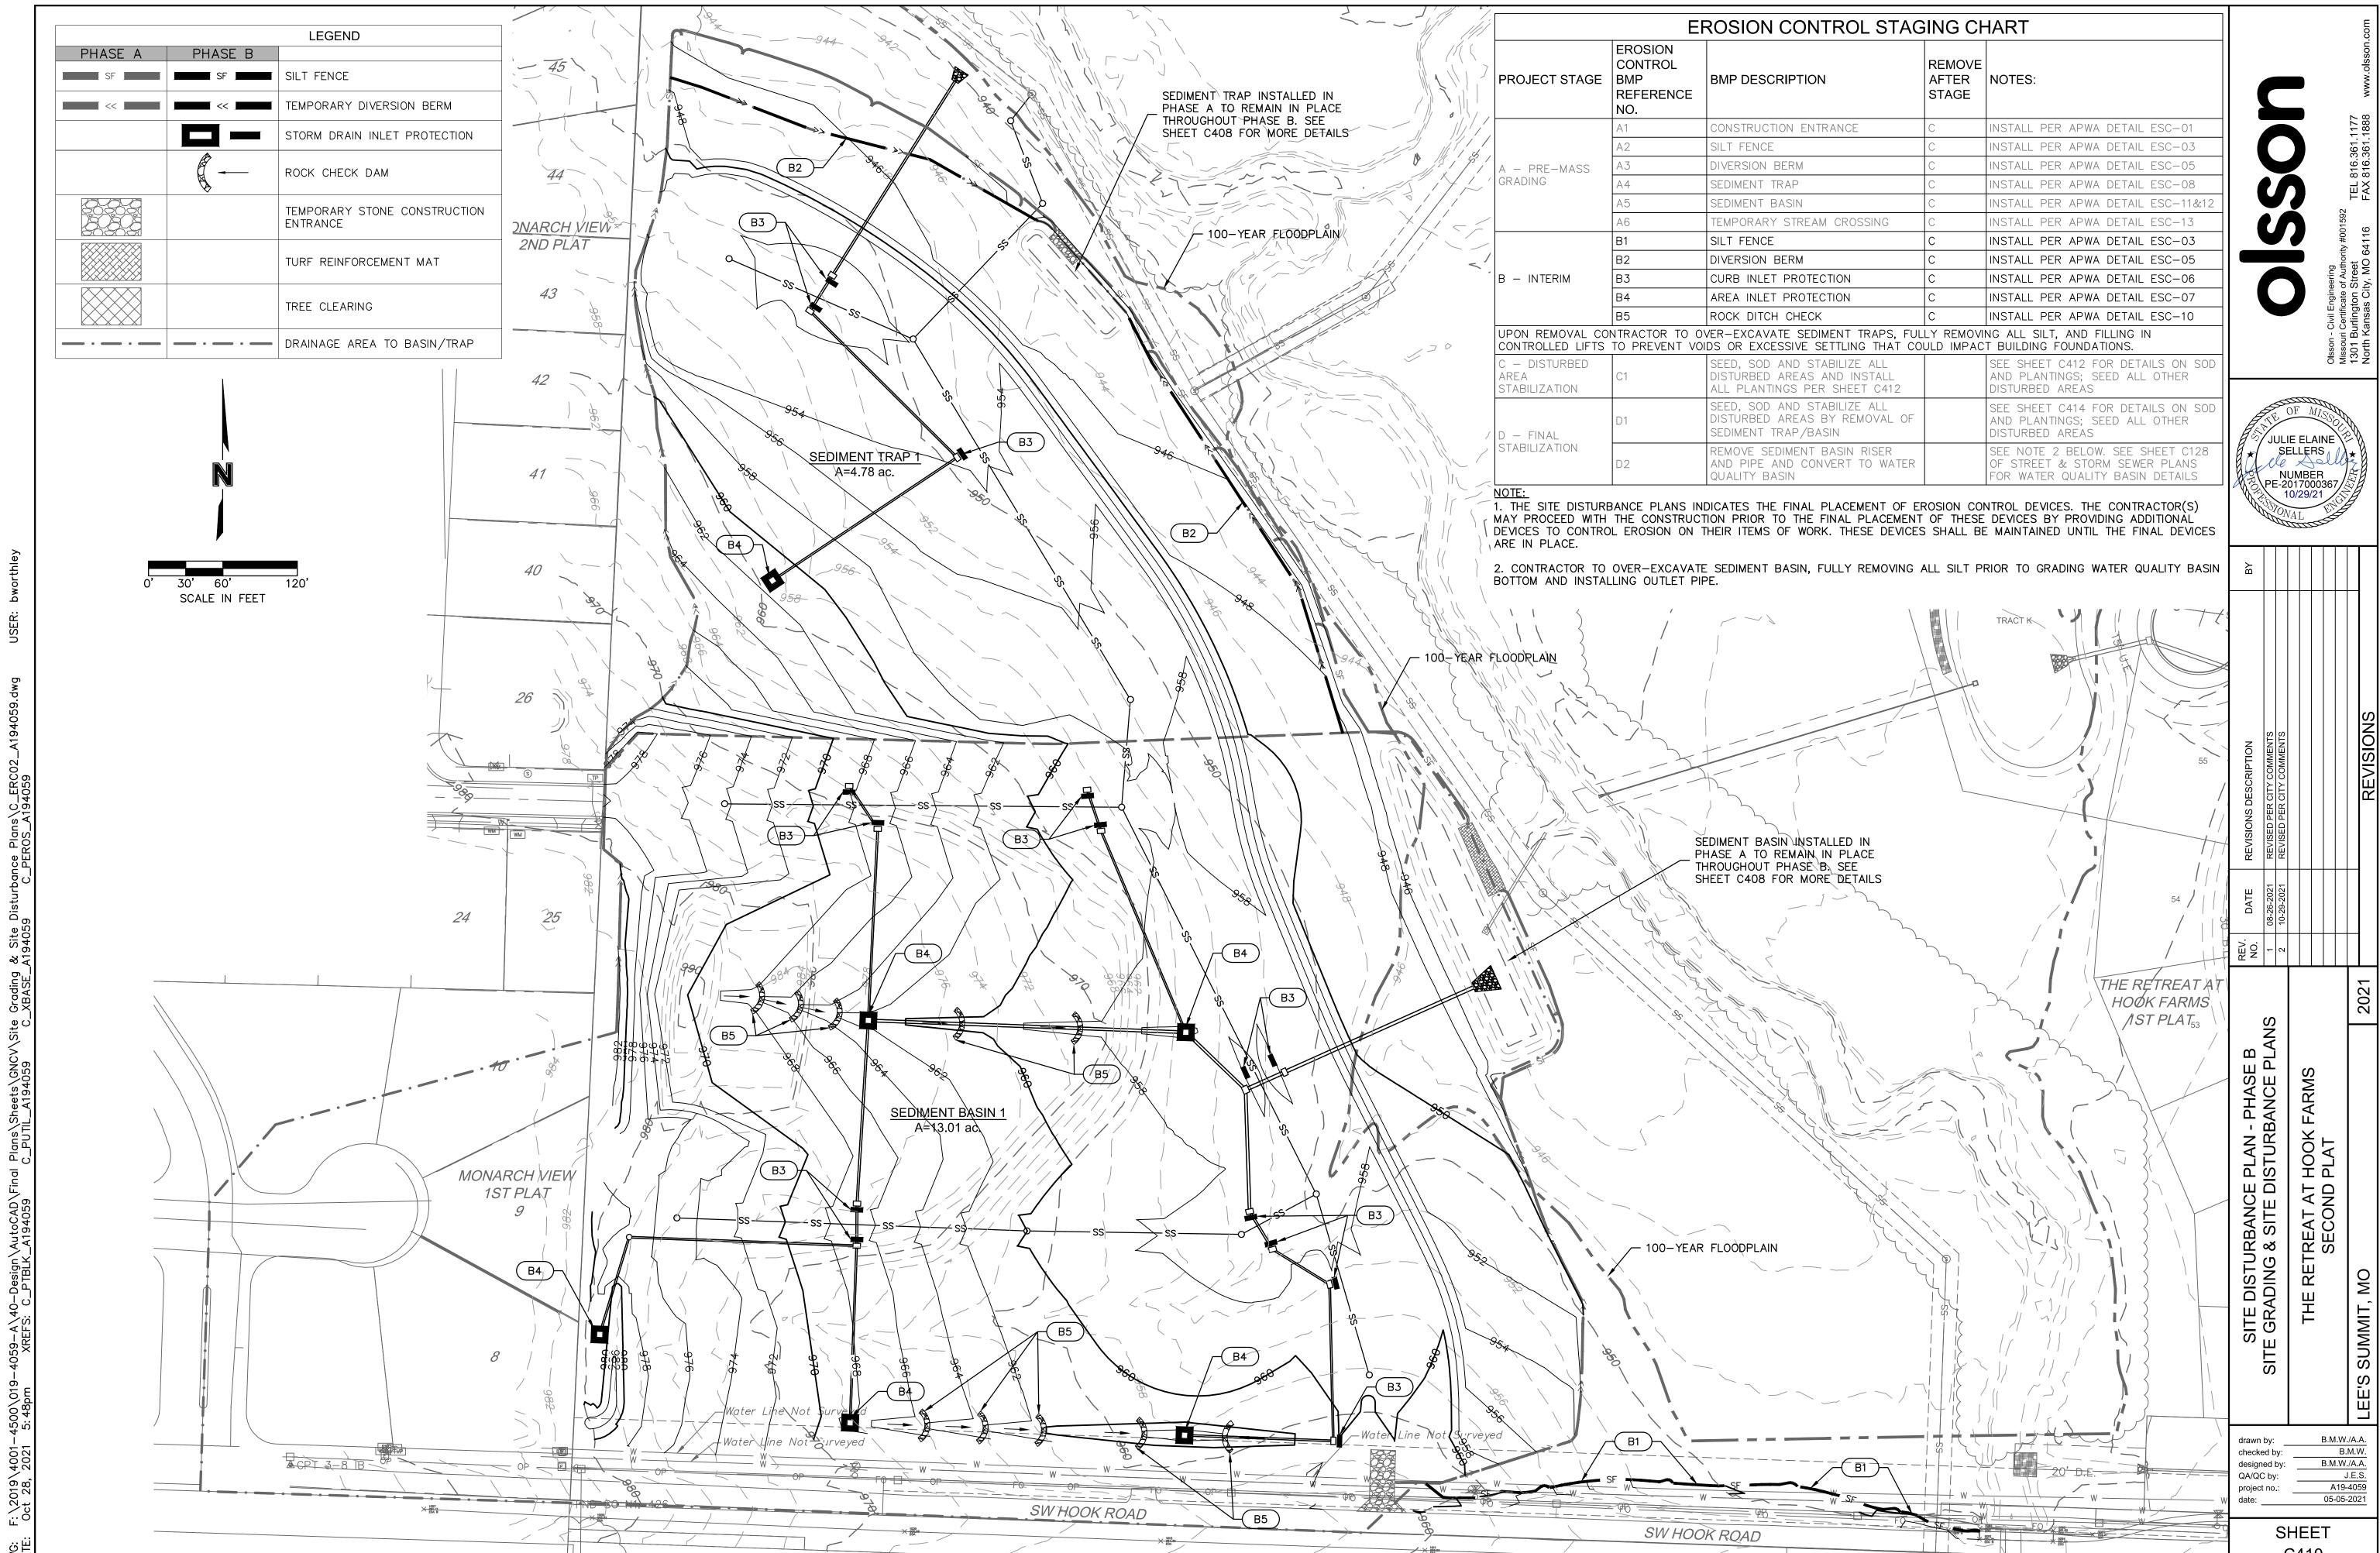


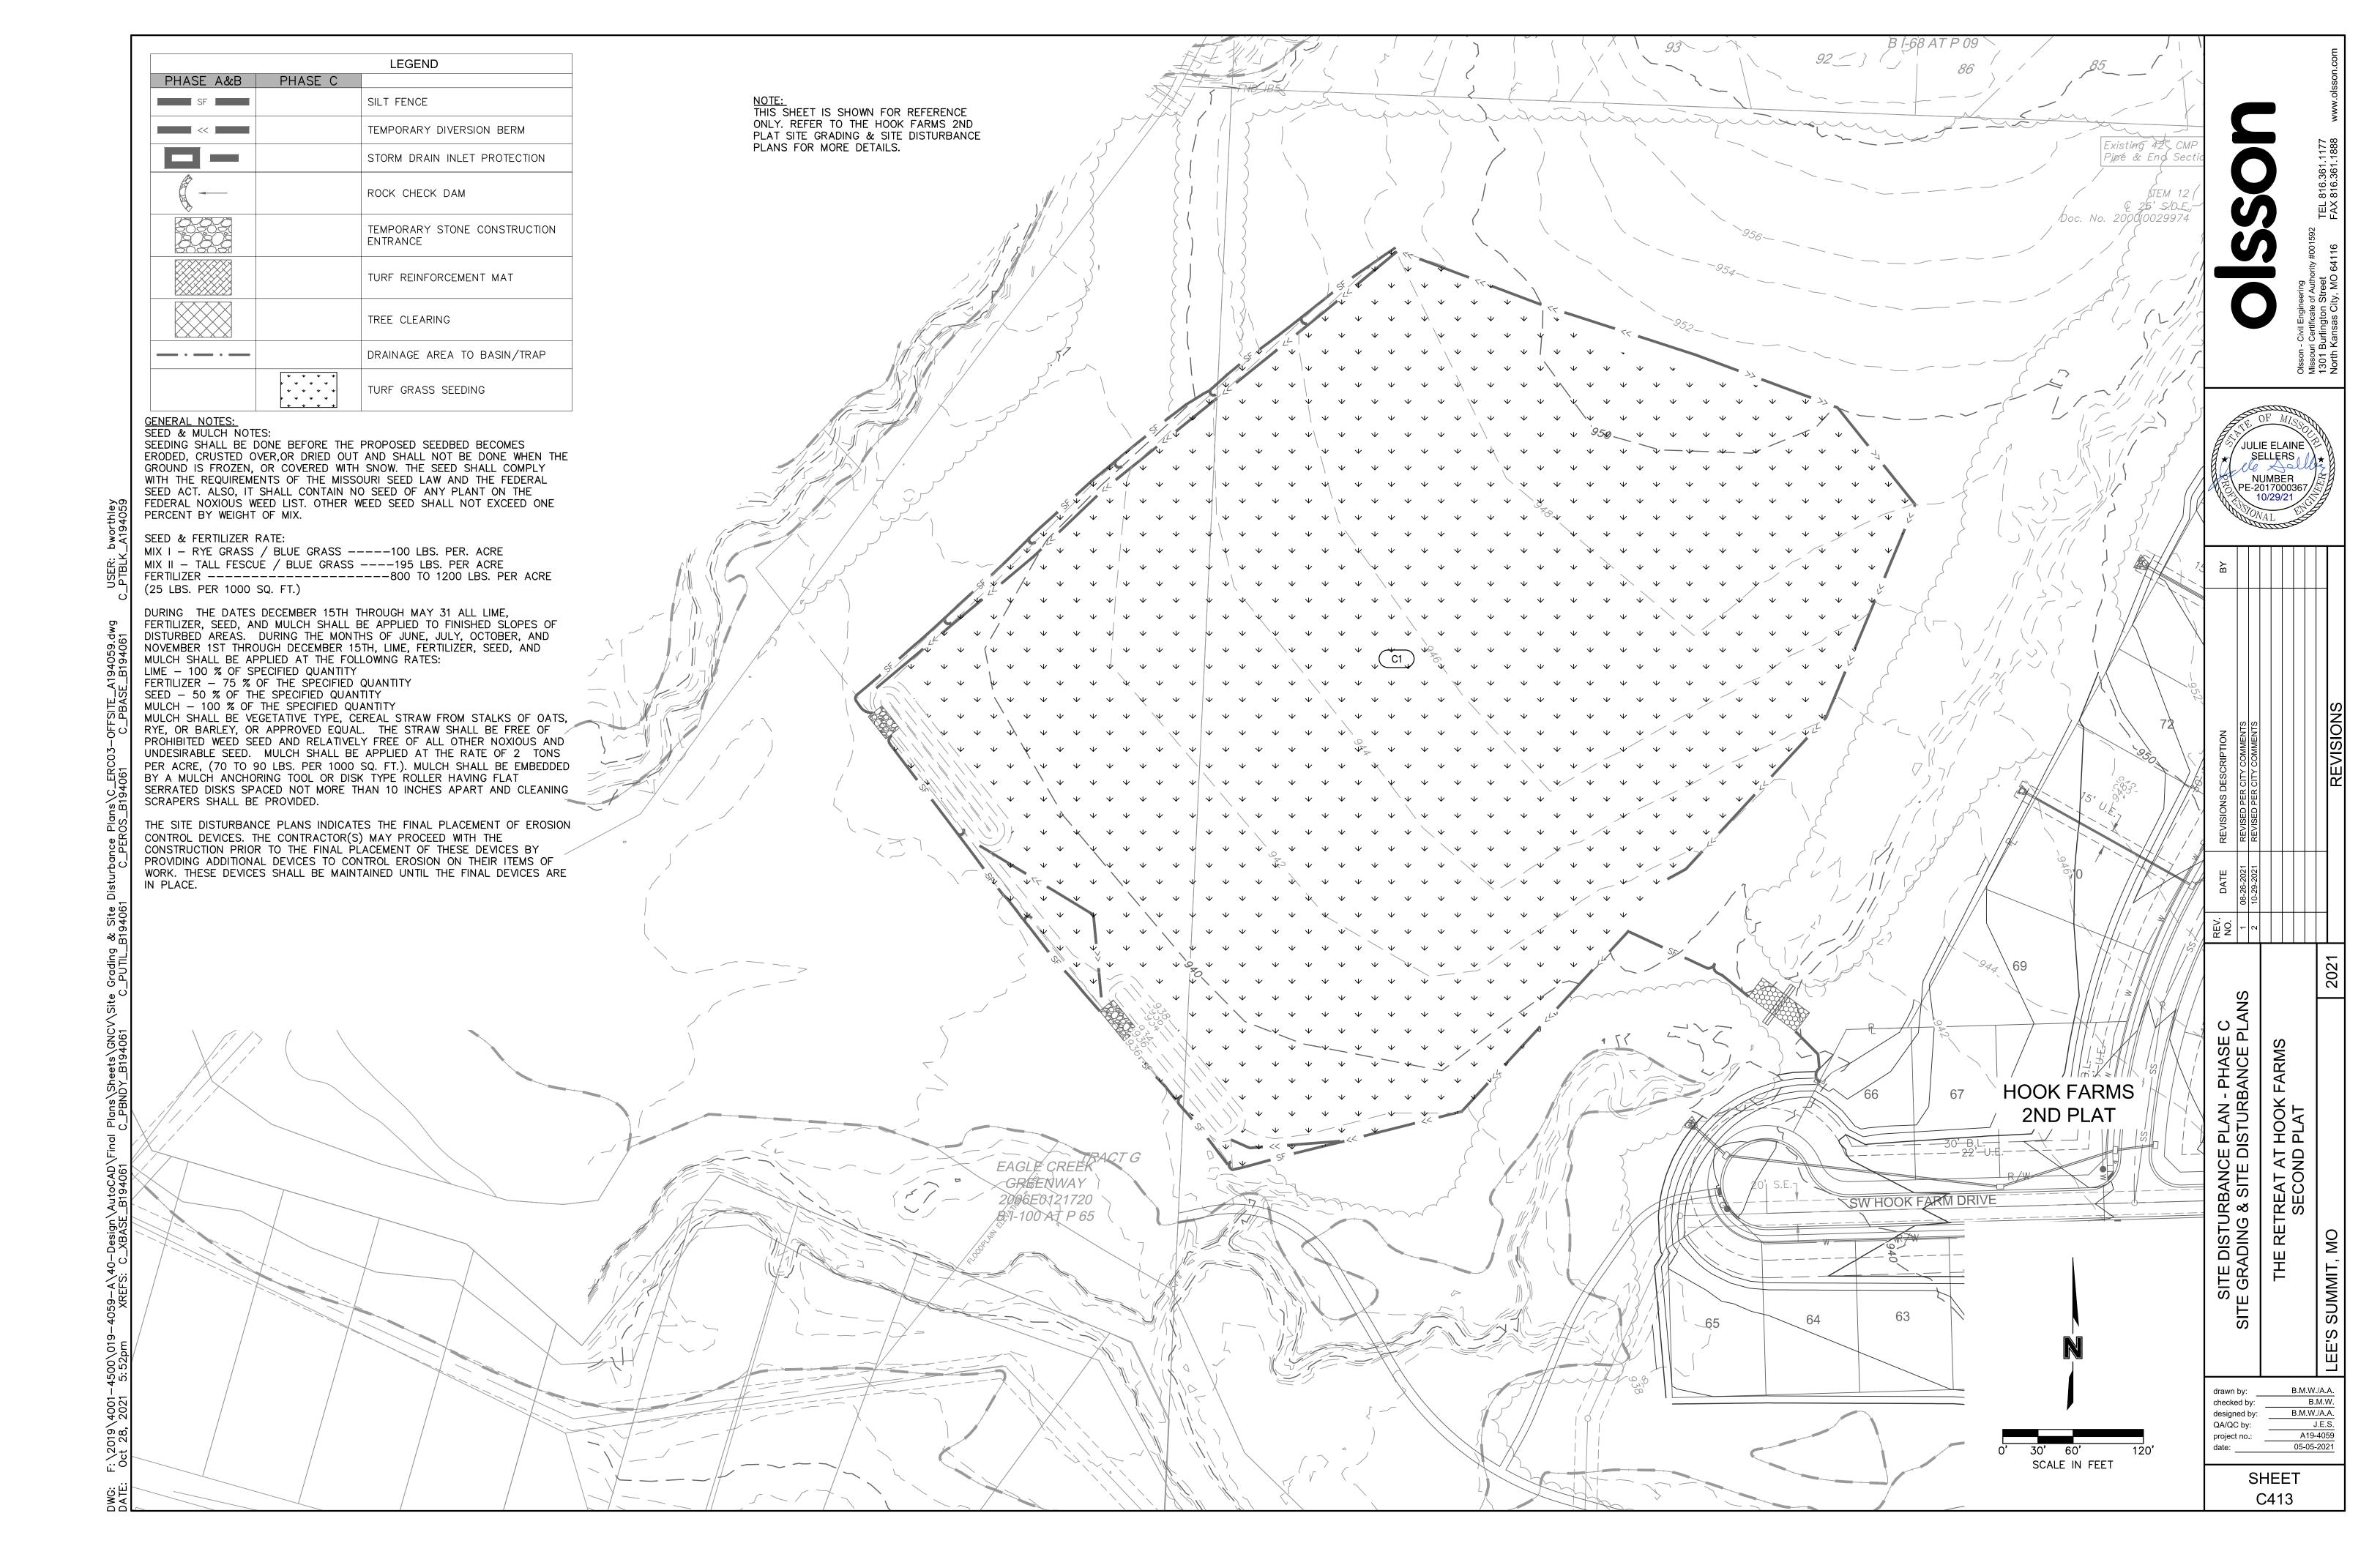


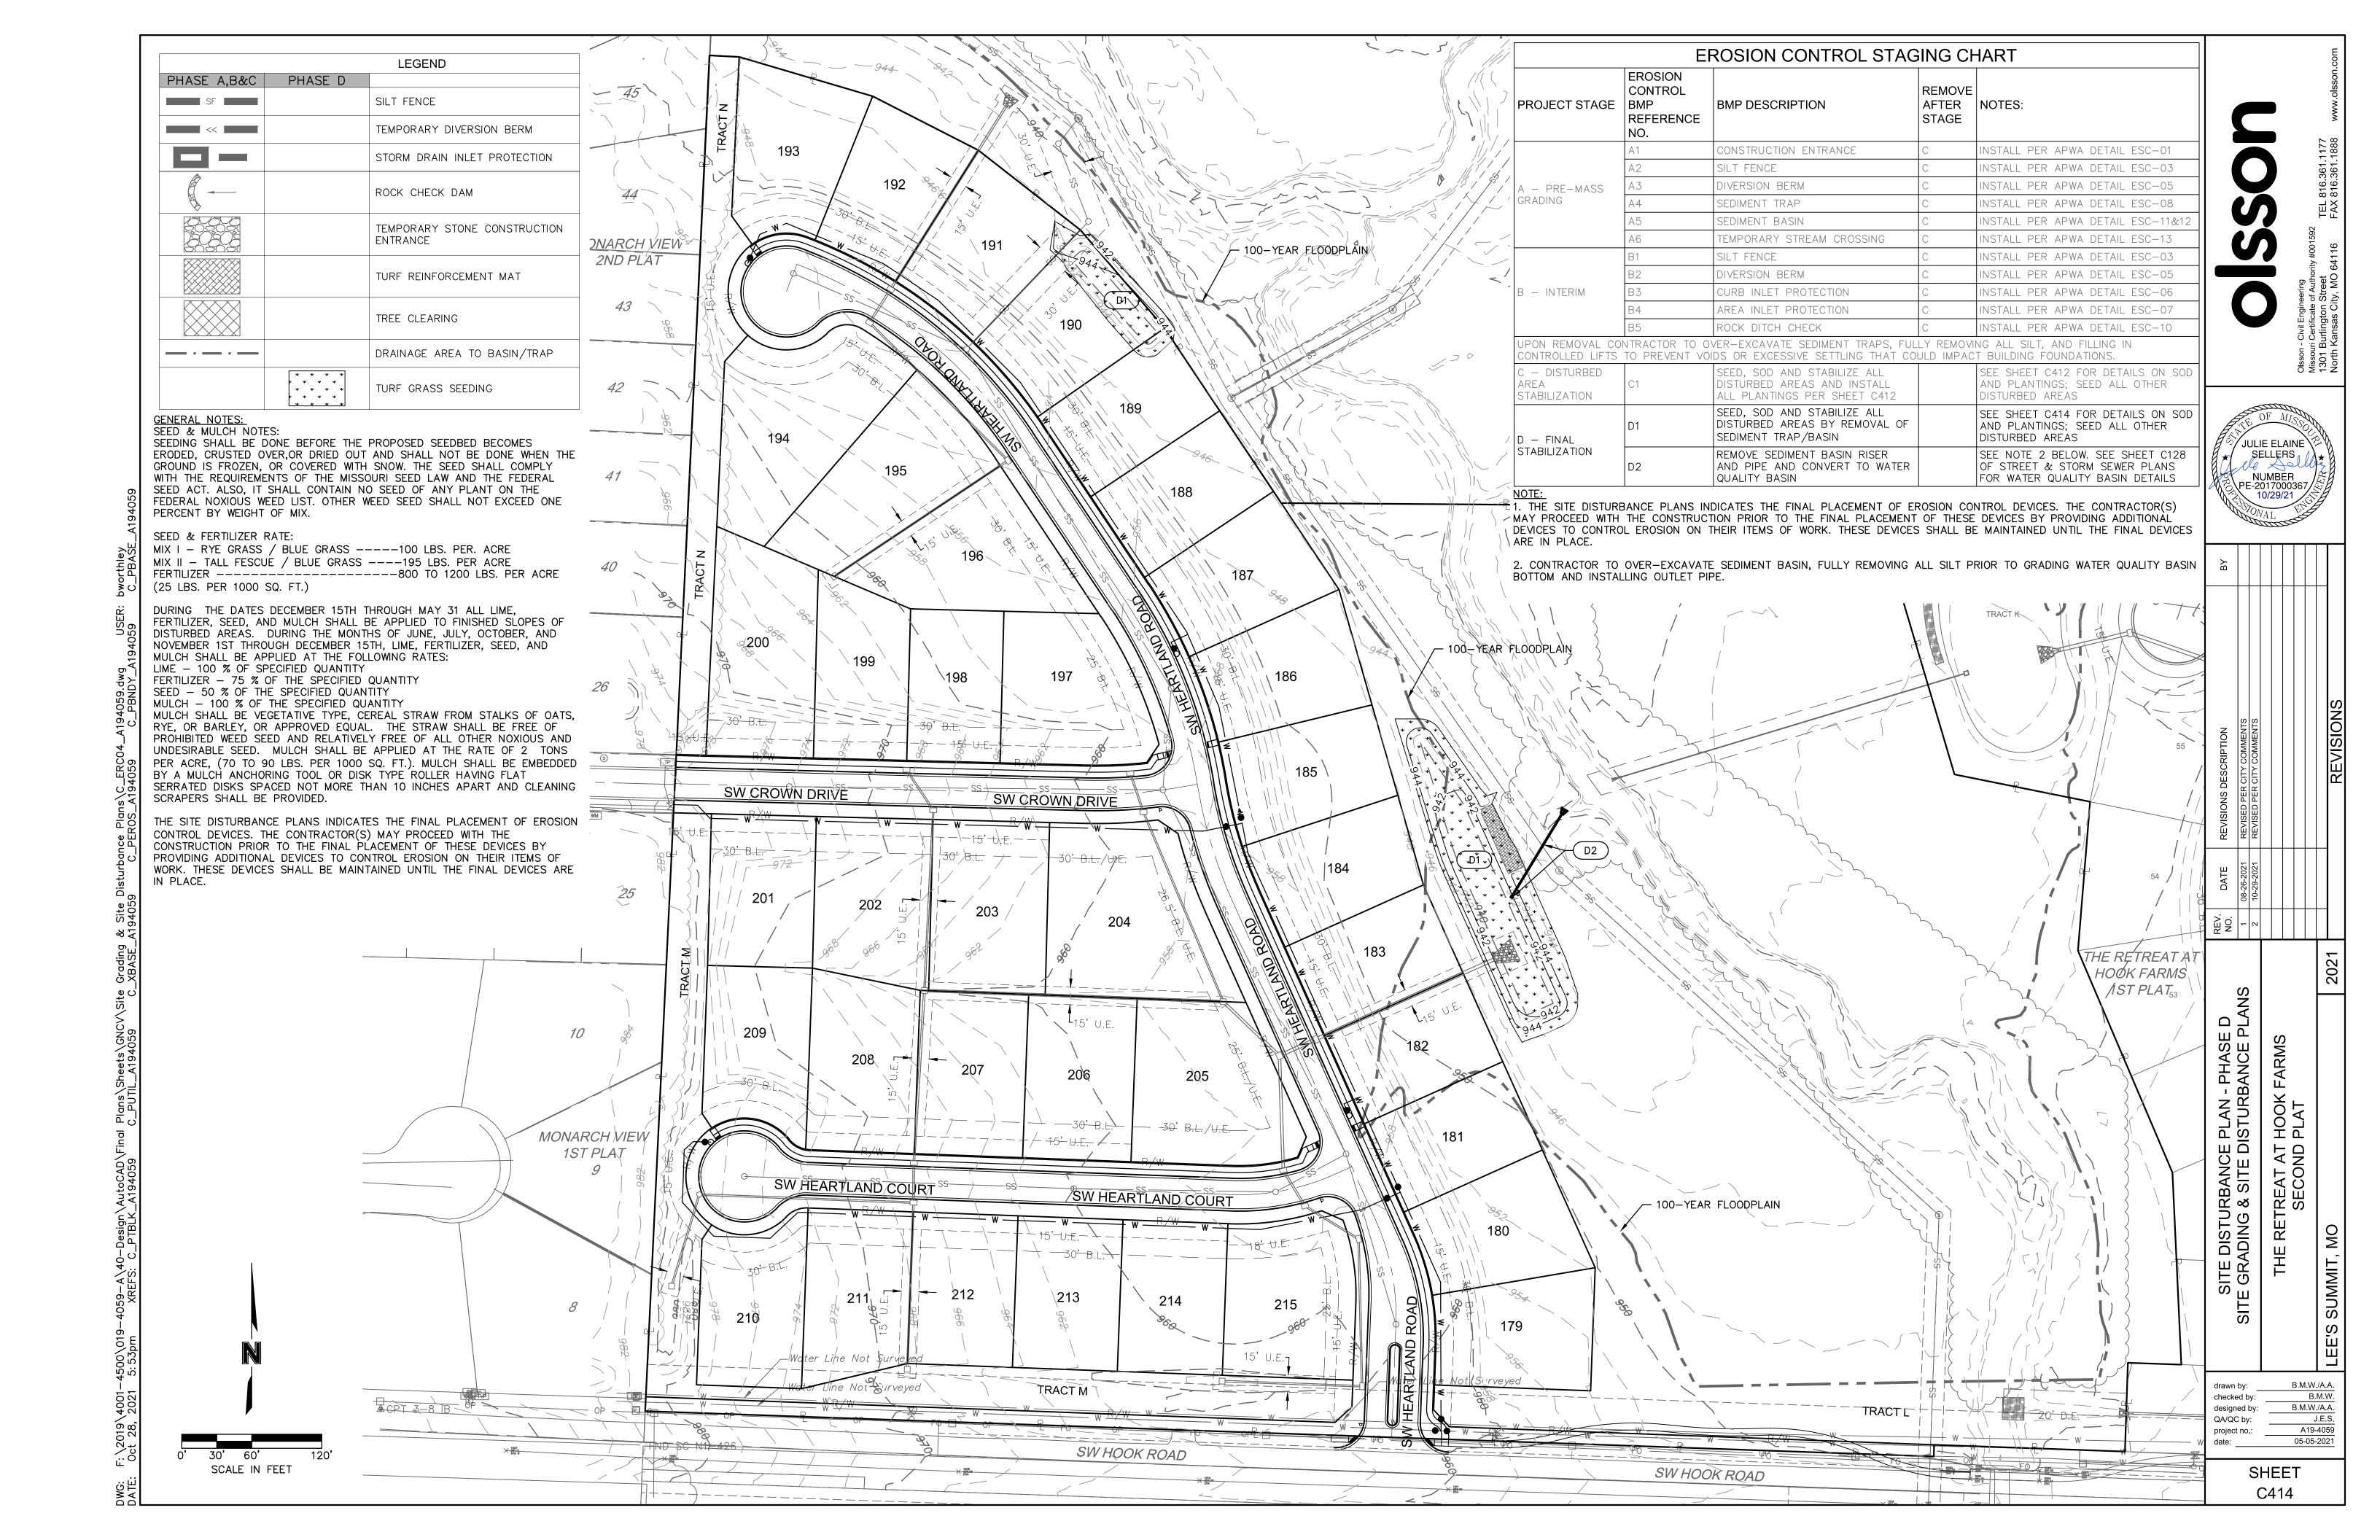

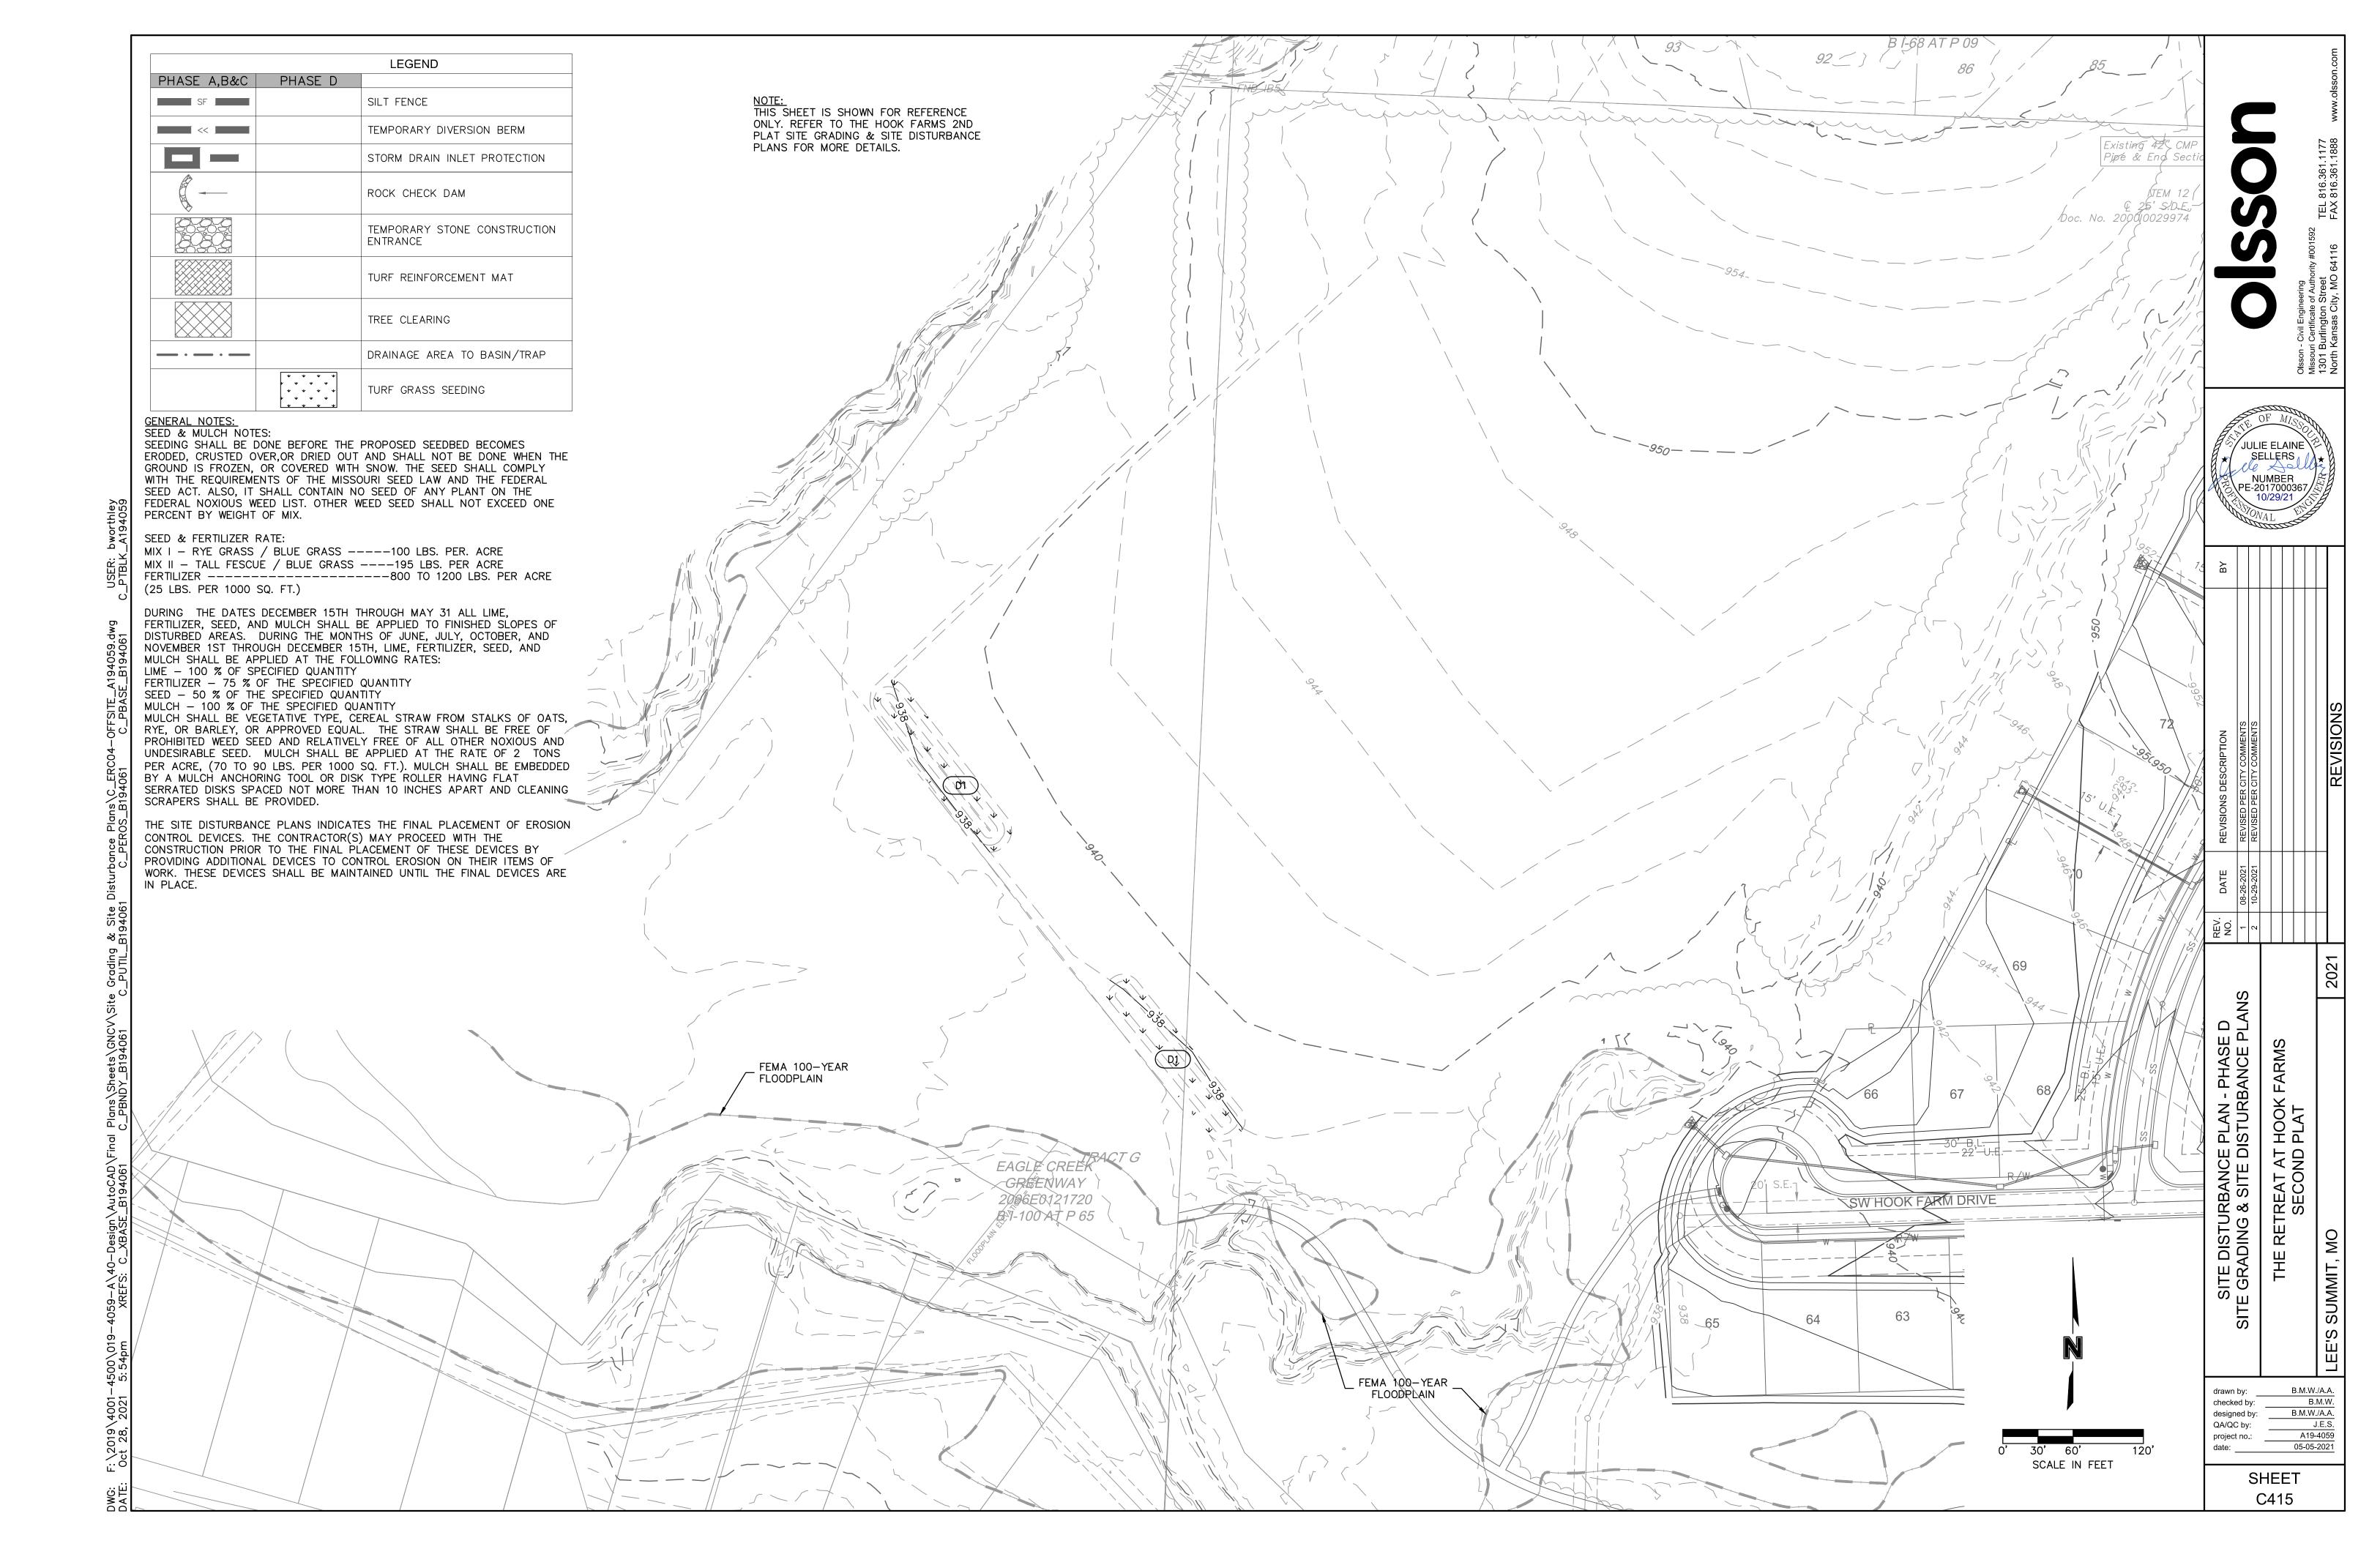

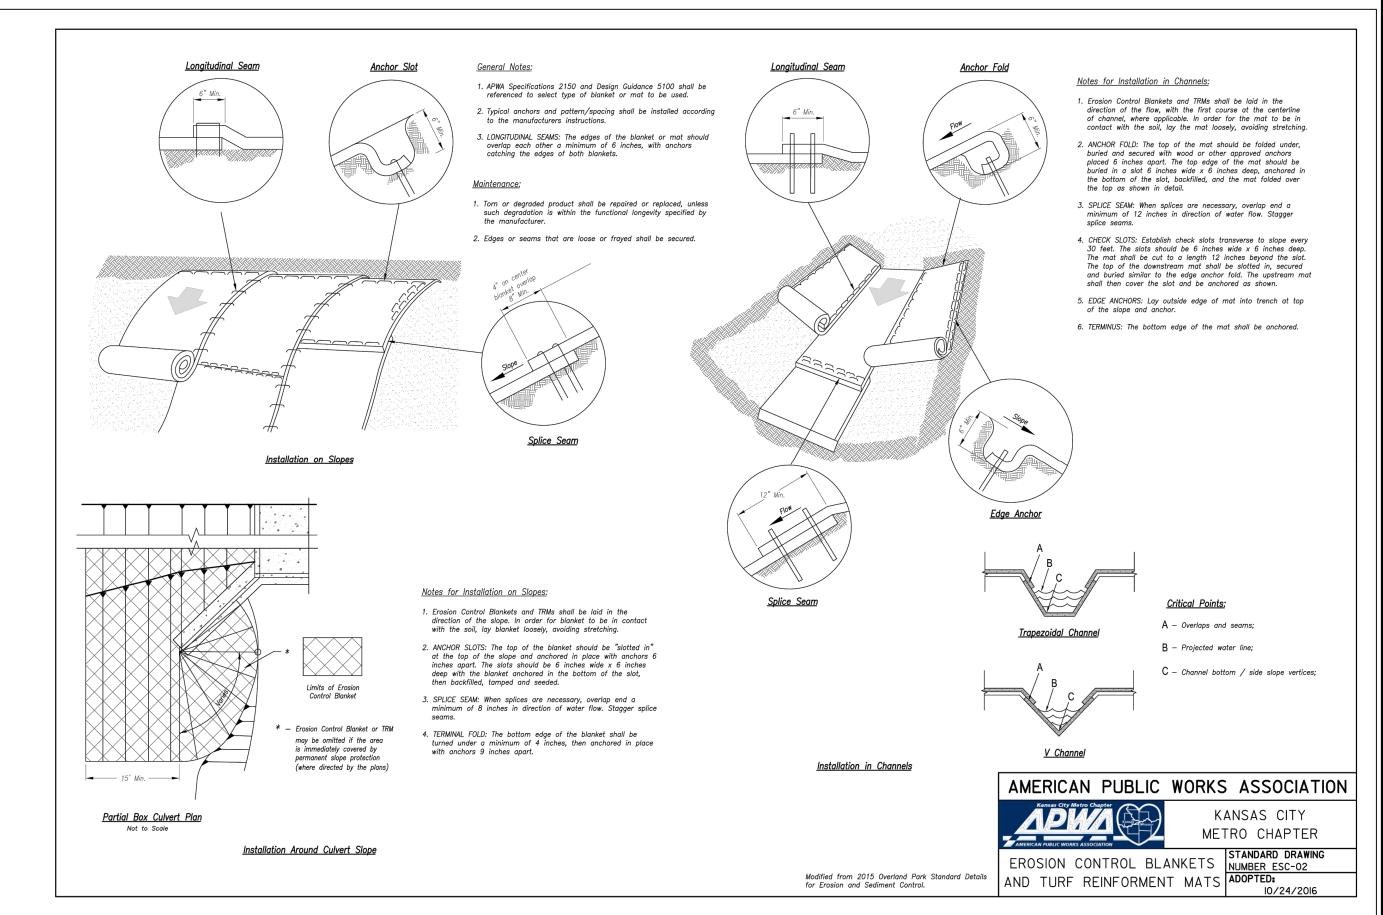

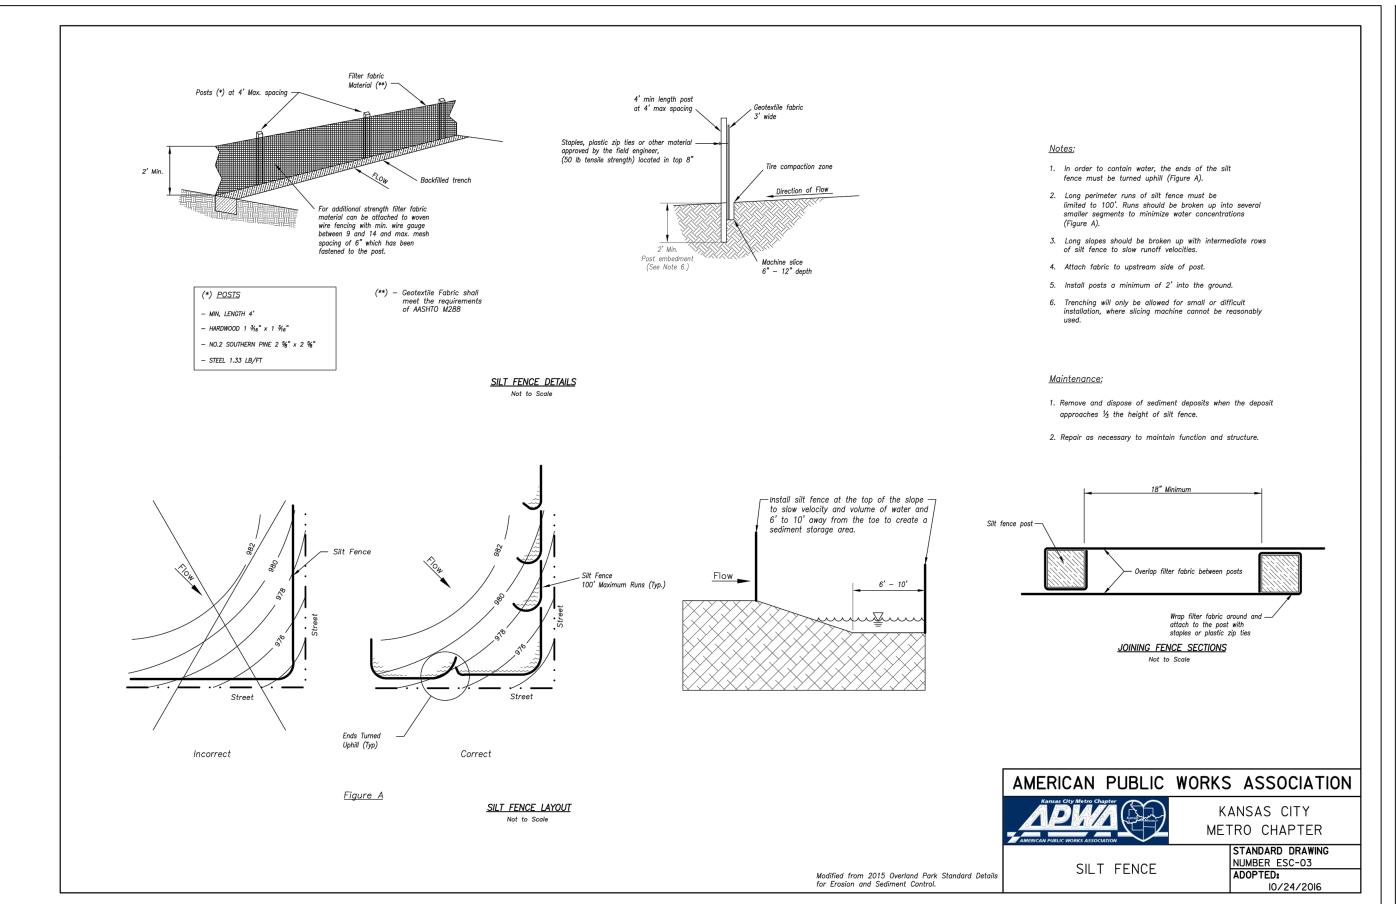

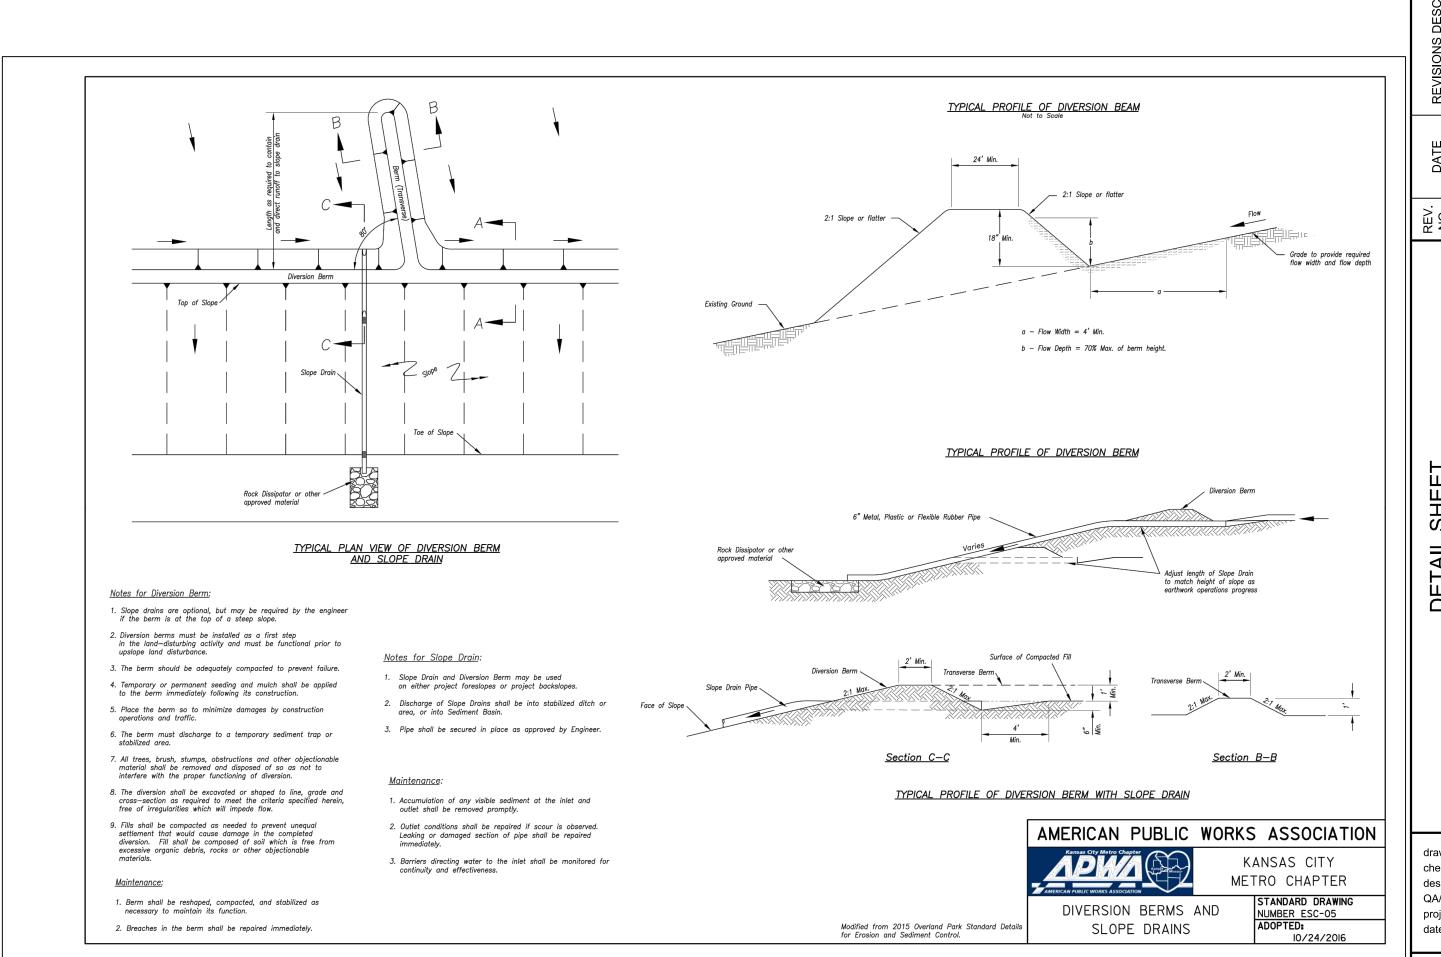

SHEET DISTURBANCE DETAIL & SITE RET SIT B.M.W./A.A. drawn by: B.M.W. checked by: B.M.W./A.A. designed by: QA/QC by: A19-4059 project no.: 05-05-2021 SHEET C416

JULIE ELAINE SELLERS 1

NUMBER \PE-2017000367/

10/29/21

<u>Detail A</u>

* Contractor shall field verify that Ponded Water Depth will not cause

unintended flooding.

2" x 10" (min).

Wrap silt fence -

 Immediately following inlet construction and prior to construction of curb and inlet throat, protect inlet opening by installing 2" X 10" (min.) board wrapped in silt fence. Structures shall have excavated storage area on all four sides to allow settling of sediment (Early Stage Curb Inlet). When inlet is completed and curb poured, filter socks or approved equal should be used (Late Stage Curb Inlet). Straw wattles are not approved for curb inlet use.

Contractor to field verify ponding water shall not create a traffic hazard.

1. Remove deposited sediment from excavated storage areas when available storage has been reduced by 20%.

2. Remove deposited sediment from filter socks or similar when any accumulation of sediment is visible. Repair or replace as necessary to maintain function and integrity of installation.

> AMERICAN PUBLIC WORKS ASSOCIATION KANSAS CITY CURB INLET PROTECTION Modified from 2015 Overland Park Standard Details for Erosion and Sediment Control.

Sump Inlet Sediment Filter

LATE STAGE CURB INLET

(After Pouring Curb and Inlet Throat)

Filter socks to be placed along curb as needed at approximately 10' interval

On Grade Curb Inlet Protection

Filter sock is to have a tight curb contact with no gaps and extend approximately 6" beyond inlet opening.

Height of filter sock should not be above the top of the


METRO CHAPTER STANDARD DRAWING NUMBER ESC-06
ADOPTED:


-Wire Reinforced Silt Fence (See Silt Fence Detail for Top of silt fence below top of downstream berm to prevent bypass * - Contractor shall field verify that Ponded Water Depth Existing Ground -Installation Requirements) will not cause excessive unintended flooding. Ponded Water — Depth (*) Swale Flow (Typical all sides) Section A-A

Not to Scale — Wire Reinforced Silt Fence Place biodegradable log, staked wattles or other approved sediment control device in front of each inlet opening. (Not to be placed in throat of inlet). — 4' Max. — ► Plan
Not to Scale Front View LATE STAGE AREA INLET Limits of — Excavation (Area inlets at final grade and existing inlets) <u>Maintenance:</u> 1. Early Stage Area Inlet Sediment Barrier to be installed Remove deposited sediment from excavated storage areas when available storage has been reduced by 20%. immediately after inlet or junction box is Silt fence shall remain in place until excavated area is removed and Late Stage Area Inlet is being installed. Remove deposited sediment from filter socks or similar when any accumulation of sediment is visible. Not to Scale Backfill excavated area ONLY after final grading of the site. Stabilization of the site is to immediately follow.

Wire reinforced silt fence may be used in place of silt fence attached to wood frame.

EARLY STAGE AREA INLET (All open boxes and inlets not at final grade)

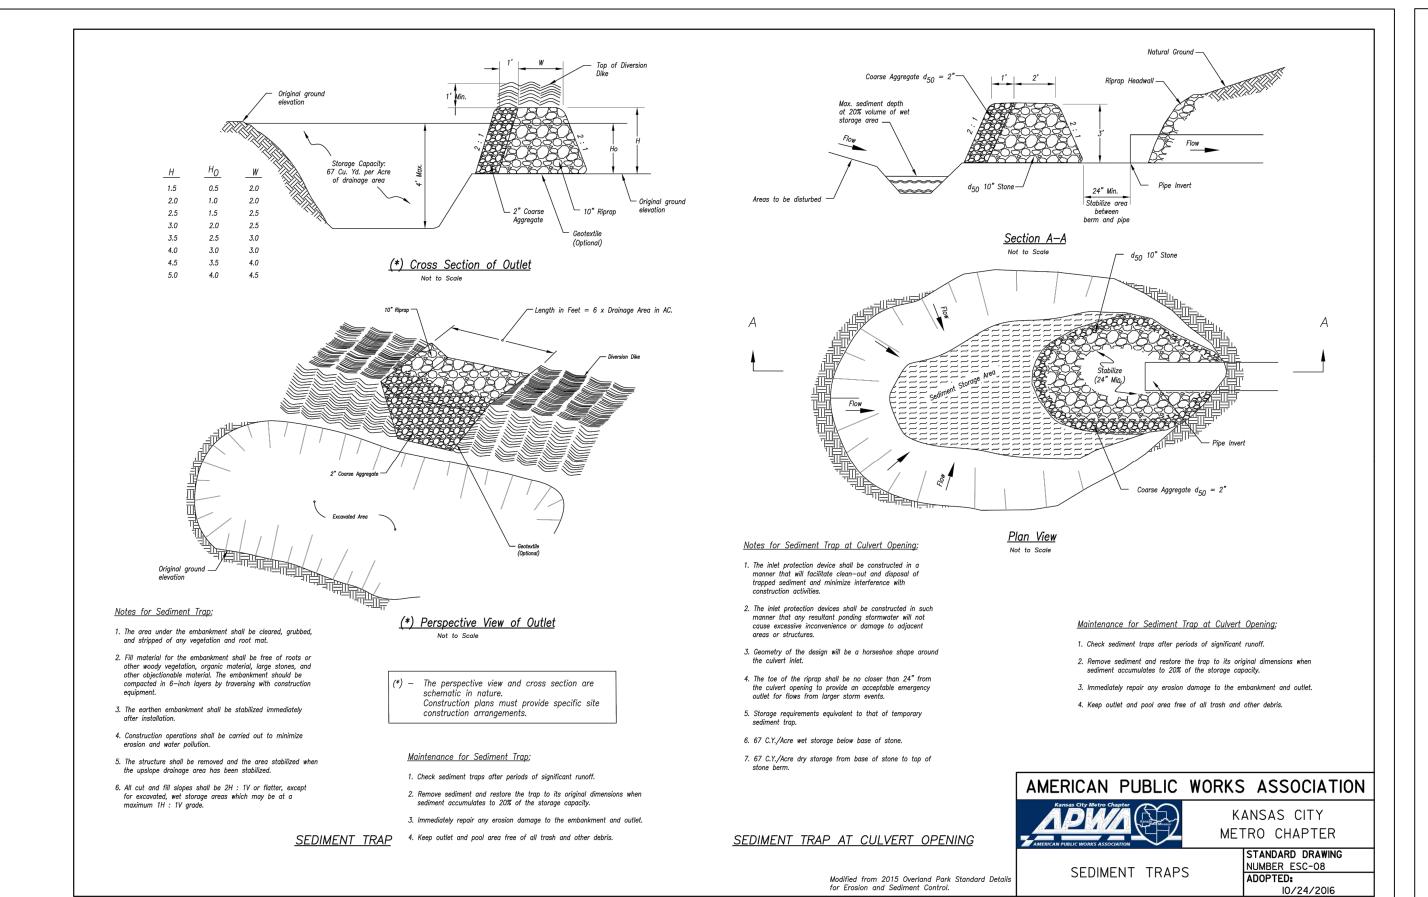

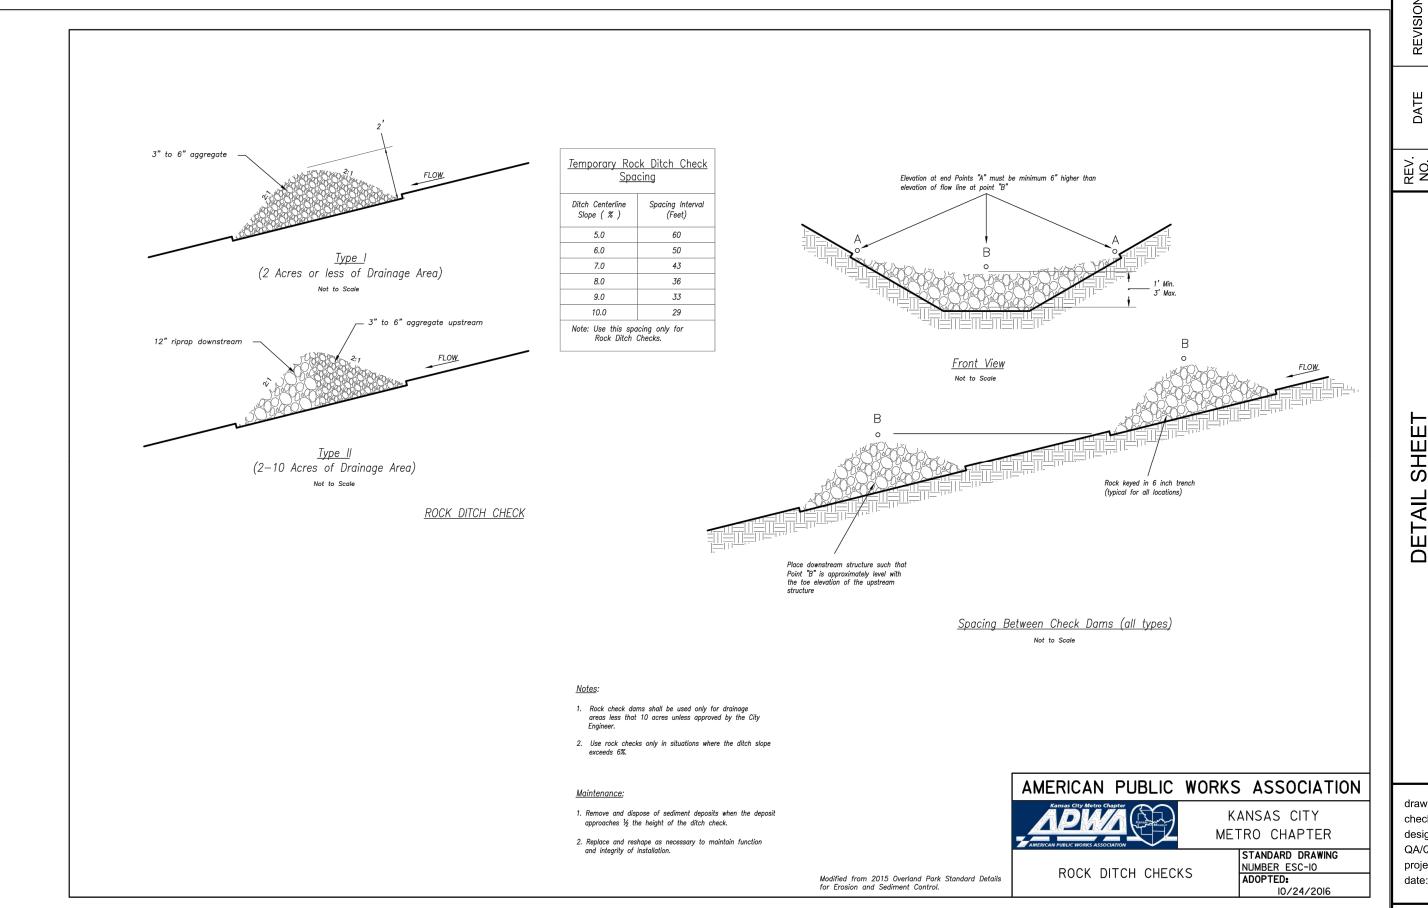

SELLERS 1 NUMBER

JULIE ELAINE PE-2017000367 10/29/21

3. Repair or replace as necessary to maintain function and integrity

AREA INLET AND

JUNCTION BOX PROTECTION

AMERICAN PUBLIC WORKS ASSOCIATION

KANSAS CITY METRO CHAPTER

STANDARD DRAWING

NUMBER ESC-07
ADOPTED:

DETAIL & SITE

RET SITE

drawn by: B.M.W./A.A. B.M.W. checked by: B.M.W./A.A. designed by: QA/QC by: A19-4059 project no.: 05-05-2021

> SHEET C417

Settlement Zone and Sediment Storage (134 CY/Acre min.)

itormwater storage –

Inlet for storm -

water system

Emergency spillway control section— 20 ft. min. length flat section

Emergency spillway should not be constructed over fill material

50% storm design Elevation

(not to overtop emergency spillway) -

Trash rack -

Principal riser w/ skimmer -

Baffles -

Concrete block - sized by -

Engineer to prevent floatation

Channel lining material to withstand 4% design storm flow — (extend to edge of disturbance)

– Primary Spillway w/skimme

(located for accessibility in event of blockage)

<u>Plan View (*)</u>

Not to Scale

__ 4% storm

→ 8' min. →

— Principal spillway

conduit

detail on sht. ESC-12)


Cross Section (*)

Not to Scale

– Low Permeability Backfill

along pipe (Typ.)

Min. 2 —

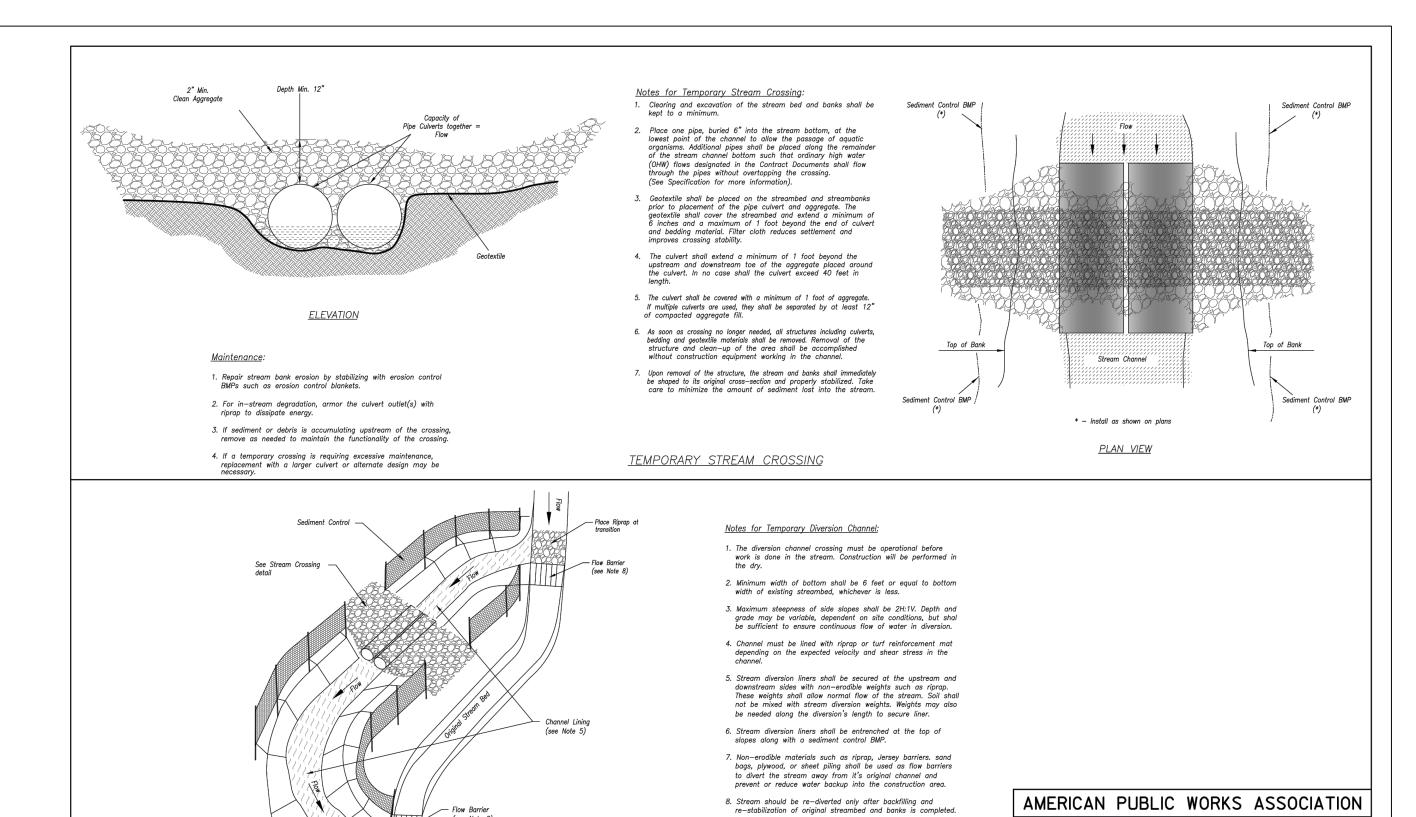

STREAM DIVERSION CHANNEL Modified from 2015 Overland Park Standard Details for Erosion and Sediment Control.

Sediment Basin Design Summary (**) Basin #1 Basin #2 Units Notes

cu yd 134 cy/acre required minimum

Top of dry storage volume

1.0 ft min above Q-25 elevation

15" min. Size for 2 year flow minimum

15" min. Size for 2 year flow minimum

to dewater in 48 to 72 hours

 $1. \ \, \textit{Interior baffles shall be provided to reduce short-circuiting of the basin. See Sht. ESC-12 for approved baffle options.}$

Emergency spillways to be located in a non-fill location when feasible and shall be lined with a non-erodible material such as Riprap or Turf Reinforcement Mat.

2. Remove sediment and restore the basin to its original dimensions when sediment accumulates to 20% of the storage

Embankment stabilized with vegatation immediately include warning signs, reading: "Danger — KEEP OUT".

1. Check temporary sediment basins after periods of significant runoff.

3. Immediately repair any erosion damage to the embankment and outlets.

5. Keep outlet, skimmer and pool area free of all trash and other debris.

4. Repair and/or replace baffles as necessary to maintain function and integrity of installation.

Size to prevent flotation, 1.25 safety factor required

Designer to provide specific details and calculations per application

Designer to provide specific details and calculations per application

AMERICAN PUBLIC WORKS ASSOCIATION

SEDIMENT BASIN

KANSAS CITY

METRO CHAPTER

NUMBER ESC-II
ADOPTED:

KANSAS CITY

METRO CHAPTER

NUMBER ESC-I3
ADOPTED:

STREAM CROSSINGS AND

DIVERSION CHANNELS

STANDARD DRAWING

10/24/2016

STANDARD DRAWING

10/24/2016

Elevation equal to 20% of original design volume

at or above Q-2 elevation. 1.0 ft min above principal spillway

Tributary Drainage Area to Pond 50% (2 yr) Design Flow 4% (25 yr) Design Flow

Minimum Sediment Storage Volume

Provided Sediment Storage Volume

Sediment Cleanout Elevation Top of Riser Elevation

Emergency Spillway Elevation

Top of Dam Elevation

Basin Shape Data: A = Area at Normal Pool L = Length of Flow Path We = Effective Width = A/L

Principal Spillway Data

Emergency Spillway Data: Design Depth in Spillway

Design Velocity in Spillway

Concrete Base size for Riser Pipe

(**) - Required on all Sediment Basin Plan Sheets

Modified from 2015 Overland Park Standard Details

Sediment Basin Notes:

<u>Maintenance</u>:

The plan and cross section are schematic in nature.

Construction plans must provide specific site

construction arrangements.

Riser Pipe dia

Barrel Pipe dia

Skimmer Size


Stabilized outlet (extend to edge of disturbance)


Length to Width Ratio = L/We


Min. Elevation of Emergency spillway.
 (Spillway designed to pass 4% storm)

vegatation immediately
following the construction of
basin

Bottom Elevation

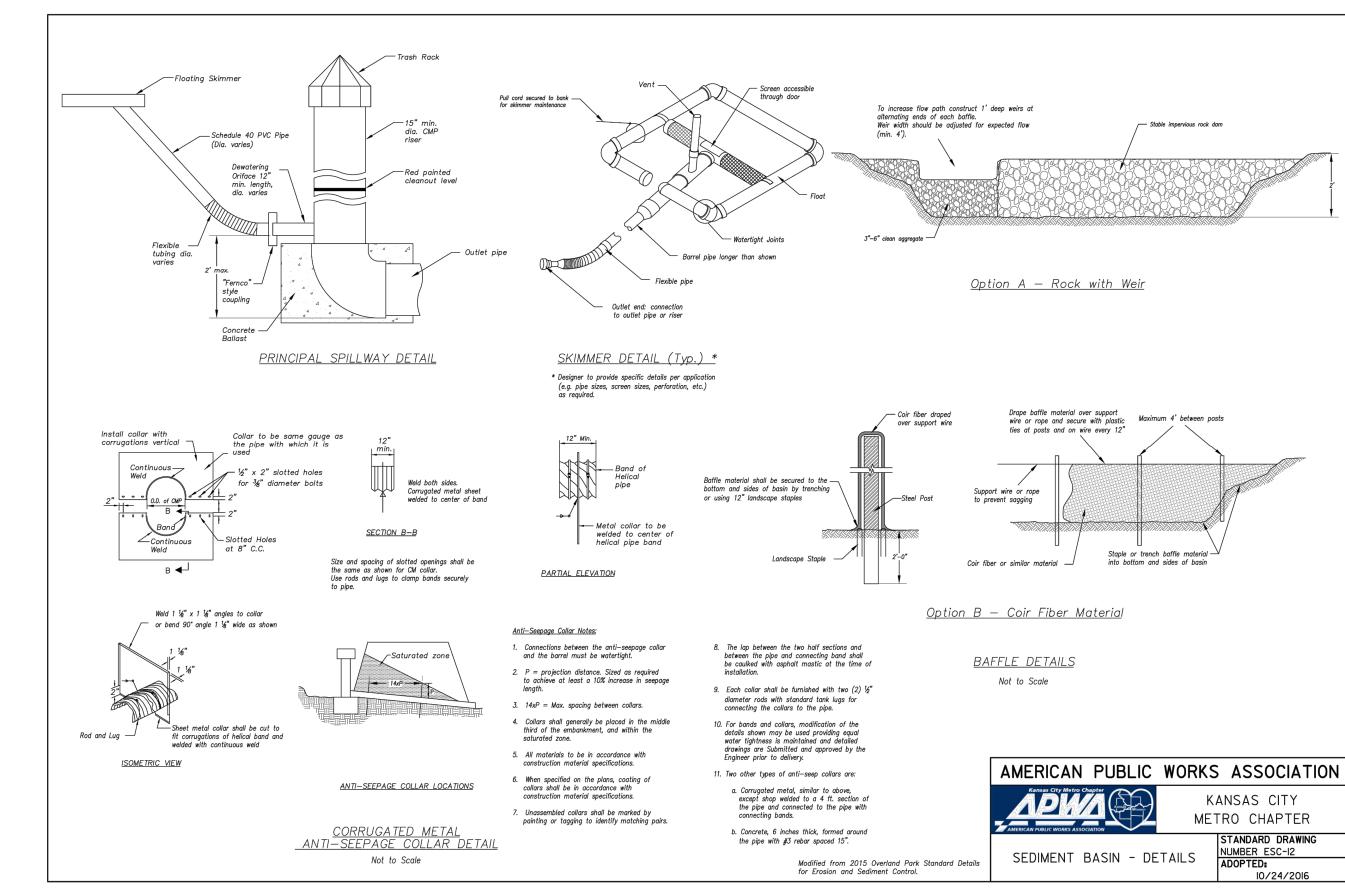

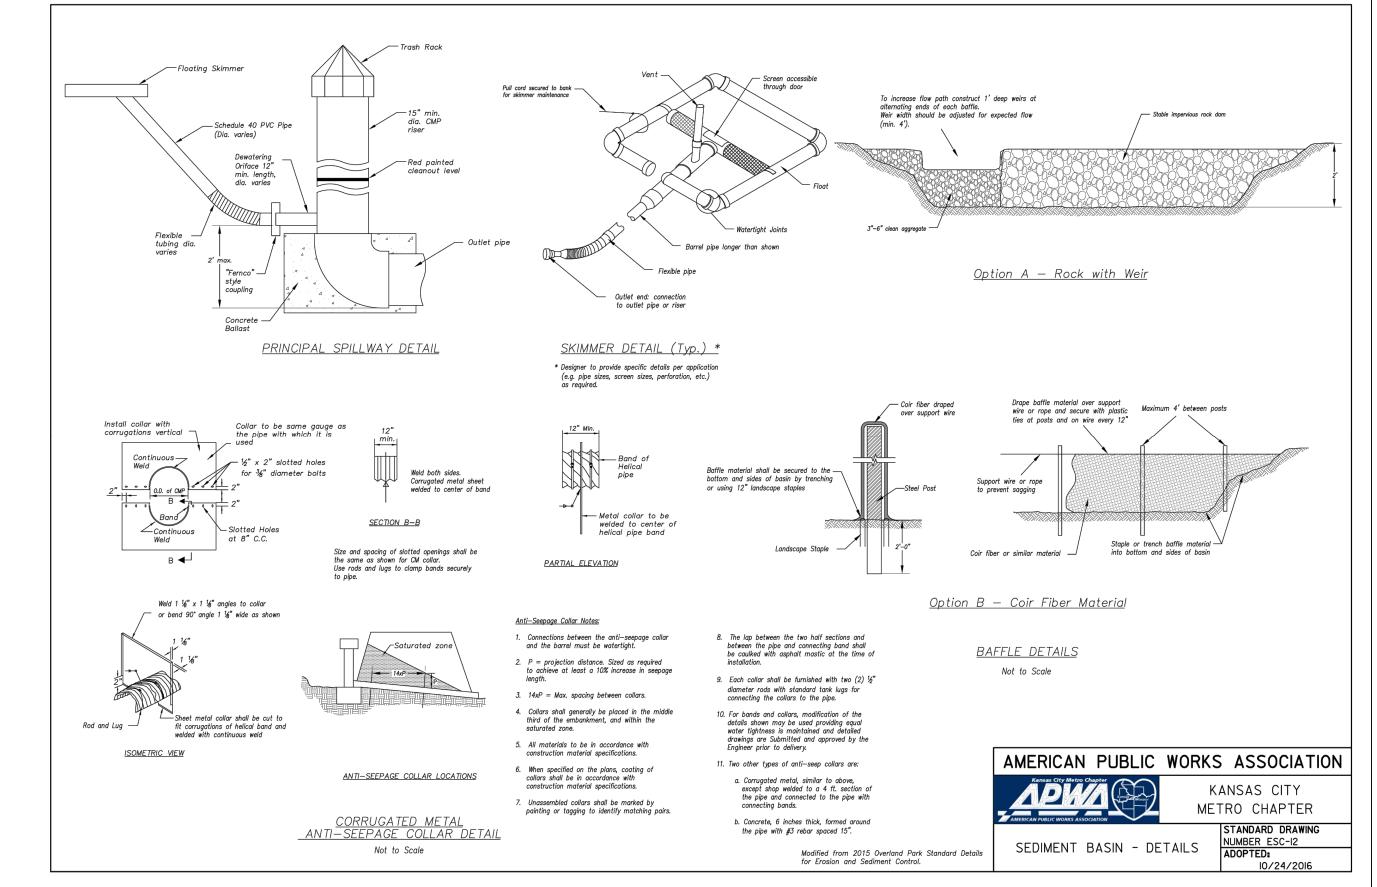

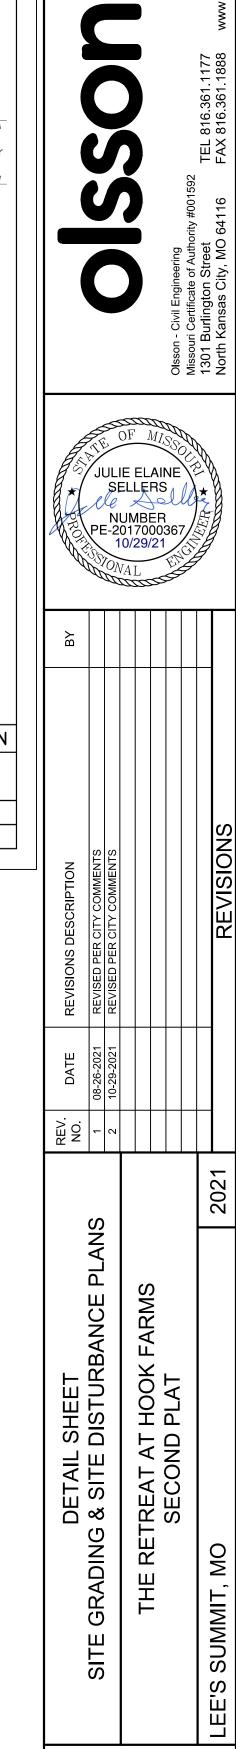

BMW/AA

B.M.W./A.A.

A19-4059

05-05-2021

B.M.W.

drawn by:

checked by:

QA/QC by:

project no.:

SHEET

designed by:

