

GENERAL NOTES:

- A. ALL EXISTING CONDITIONS, TOPOGRAPHY, UTILITIES AND PROPERTY INFORMATION ARE TAKEN FROM A SURVEY OF LAND SITUATED IN THE CITY OF LEE'S SUMMIT, COUNTY OF JACKSON, AND STATE OF MISSOURI, BY SURVEYOR: YOUNG - HOBBS AND ASSOCIATES, 1202 CROSSLAND AVE., CLARKSVILLE, TN 37040, PHONE: (931) 645-2524
- B. CONTRACTOR IS RESPONSIBLE FOR LOCATING AND VERIFYING ALL EXISTING UNDERGROUND UTILITIES PRIOR TO CONSTRUCTION, AND IS RESPONSIBLE FOR ANY DAMAGE TO THEM DURING CONSTRUCTION.
- C. PROVIDE SMOOTH TRANSITION FROM NEWLY PAVED AREAS TO EXISTING PAVED AREAS AS NECESSARY. THE EXISTING EDGE OF PAVEMENT SHALL BE FREE OF ALL LOOSE DEBRIS AT ALL AREAS WHERE PROPOSED PAVEMENT MEETS EXISTING PAVEMENT. THE EDGE OF EXISTING ASPHALT PAVEMENT SHALL BE PROPERLY SEALED WITH A TACK COAT MATERIAL IN ALL AREAS WHERE NEW ASPHALT PAVEMENT IS INDICATED TO JOIN EXISTING.
- D. ALL DIMENSIONS TO FACE OF CURB AND/OR EDGE OF PAVEMENT UNLESS OTHERWISE NOTED.
 E. CONTRACTOR SHALL BE SOLELY RESPONSIBLE FOR AND TAKE ALL PRECAUTIONS NECESSARY TO AVOID DAMAGE TO ADJACENT PROPERTIES DURING THE CONSTRUCTION PHASES OF THIS PROJECT.
- F. REFER TO ARCHITECTURAL DRAWINGS FOR BUILDING DIMENSIONS AND ADDITIONAL INFORMATION.
- G. ALL CONSTRUCTION METHODS AND MATERIALS MUST CONFORM TO CURRENT STANDARDS AND SPECIFICATIONS OF THE FEDERAL, STATE, COUNTY, CITY OR LOCAL REQUIREMENTS, WHICHEVER HAS JURISDICTION.
- H. ALL EXCAVATED AREAS TO BE SEEDED AND/OR SODDED AFTER FINISH GRADING UNLESS OTHERWISE NOTED. ALL NEWLY SEEDED/SODDED AREAS SHALL HAVE A MINIMUM OF 4" OF TOPSOIL. HOLD SOIL DOWN 1" FROM PAVEMENT ELEVATION. CONTRACTOR TO SUPPLY STRAW MULCH WHERE GRASS SEED HAS BEEN PLANTED.
- I. ALL RADII ARE 3.0 FEET UNLESS OTHERWISE SHOWN. ALL RADII INDICATED ON PLANS SHALL BE CONSTRUCTED AS CIRCULAR ARCS.

KEYED NOTES:

SHEET C-9.

- PROPOSED HEAVY DUTY ASPHALT PAVEMENT, SEE DETAIL ON SHEET C-9.
- (2) PROPOSED HEAVY DUTY CONCRETE PAVEMENT, SEE DETAIL ON SHEET C-6.
- 3 PROPOSED ASPHALT PAVEMENT TO BE FLUSH WITH EXISTING.
- 4 PROPOSED PAINTED PARKING STRIPING (TYPICAL). ALL PARKING STRIPES ARE TO BE 4" HIGH-BUILD PAINTED WHITE, UNLESS OTHERWISE NOTED ON THE PLANS, DETAILS OR SPECIFICATIONS.
- 5 PROPOSED 6" STRAIGHT CURB PER CITY OF LEE'S SUMMIT STANDARD DRAWING GEN-4 TYPE C-1, SEE DETAIL ON SHEET C-9.
- (6) PROPOSED CONCRETE SIDEWALK. SEE DETAIL ON SHEET C-9.
- (7) PROPOSED CONCRETE SIDEWALK, SEE DEVELOPER ROADWAY PLANS FOR MORE DETAILS.
- 8 PROPOSED RIGHT-TURN LANE, SEE DEVELOPER ROADWAY PLANS FOR MORE DETAILS.
- PROPOSED BOLLARD, TYP. OF 8. SEE ARCHITECTURAL AND STRUCTURAL PLANS FOR DETAILS.
 PROPOSED ILLUMINATED BOLLARD, TYP. OF 4. SEE ARCHITECTURAL AND STRUCTURAL PLANS
- FOR DETAILS. (1) GENERAL CONTRACTOR TO PROVIDE AND INSTALL (1) POLE-MOUNTED HANDICAP PARKING SIGNS. SIGNS PROVIDED BY CONTRACTOR TO MEET LOCAL REQUIREMENTS, SEE DETAIL ON
- (12) GENERAL CONTRACTOR TO PROVIDE AND INSTALL (1) POLE-MOUNTED HANDICAP PARKING SIGN WITH "VAN ACCESSIBLE" SIGN. SIGNS PROVIDED BY CONTRACTOR TO MEET LOCAL REQUIREMENTS, SEE DETAIL ON SHEET C-9.
- (13) CONCRETE DUMPSTER ENCLOSURE APRON . SEE DETAIL ON SHEET C-9.
- (14) PROPOSED PRE-CAST CONCRETE WHEEL STOP (TYP. OF 8), SEE DETAIL ON SHEET C-9.
- (15) CONCRETE TO BE FLUSH WITH ADJACENT ASPHALT PAVEMENT.
- (16) FLAGPOLE WITH GROUND-MOUNTED LIGHTS, UNITEDFLAG AND BANNER, GARRISON TYPE OR OWNER APPROVED EQUAL, 30' HIGH, 5" BUTT ALUMINUM WITH 14 GAUGE ALUMINUM BALL FINIAL. INCLUDE ALUMINUM ROLLER AND SLEEVE. HARDWARE TO INCLUDE STATIONARY STRUCK, NYLON FLAGSNAPS, AND HALYARDS. ENTIRE ASSEMBLY (INCLUDING FOUNDATION) TO CONFORM TO APPLICABLE CODES, INCLUDING WIND LOADS. SEE ARCHITECTURAL AND STRUCTURAL PLANS FOR DETAILS.
- 17 PROPOSED MONUMENT SIGN, CONTRACTOR TO COORDINATE WITH OWNER. SEE ELECTRICAL PLANS AND SIGNAGE PACKAGE FOR DETAILS.
- (18) PROPOSED DUMPSTER ENCLOSURE AND CONCRETE PAD. SEE ARCHITECTURAL AND STRUCTURAL PLANS FOR DETAILS.
- (19) PROPOSED 215' REDI-ROCK RETAINING WALL WITH PEDESTRIAN RAILING. SEE GRADING PLAN ON SHEET C-6 FOR WALL HEIGHT.
- 20 PROPOSED HEADACHE BAR. SEE ARCHITECTURAL PLANS FOR DETAILS.
- 21 PROPOSED MENU BOARD CANOPY. SEE ARCHITECTURAL PLANS FOR DETAILS.
- 22 PROPOSED EXTERIOR MENU BOARD. SEE ARCHITECTURAL PLANS FOR DETAILS.
- 23 PROPOSED 6" MONOLITHIC CURB, SEE DETAIL ON SHEET C-11.
- 24 ROLL BACK CURB PER CITY OF PER LEE'S SUMMIT STANDARD DRAWING GEN-4 TYPE CG-2, SEE DETAIL ON SHEET C-9.

 TEMPORARY ASPHALT CURB. SEE DETAIL ON SHEET C-9.
 PROPOSED PEDESTRIAN HANDRAIL TO COMPLY WITH ADA 2010 STANDARDS, SECTION 4.8. CONTRACTOR TO SUBMIT THE HANDRAIL DESIGN TO THE ARCHITECT/ENGINEER FOR REVIEW.
 ADA ACCESSIBLE PEDESTRIAN ROUTE.

- (28) CONCRETE TO BE FLUSH WITH ADJACENT ASPHALT PAVEMENT, SEE DETAIL ON SHEET C-11.
- (29) PROPOSED UNDERGROUND STORAGE, SEE DETAILS ON SHEETS C-12 AND C-13.
- (30) 1' WIDE CRUSHED GRANITE STRIP. SEE DETAIL ON SHEET C-11.
- (31) CONCRETE ISLAND NOSE. SEE DETAIL ON SHEET C-11.
- 32 LIGHTPOLE AND FOUNDATION.SEE STRUCTURAL PLANS FOR DETAILS.
- (33) PROPOSED STORM SEWER STRUCTURE, SEE SITE GRADING PLAN, SHEET C-6 FOR MORE INFORMATION.
- (34) PRIVATE SITE AND DEVELOPER WORK INTERFACE.
- (35) RAMP WITH ADA STRIPING, SEE DETAIL ON SHEET C-11.
- (36) CURB RAMP A, SEE DETAIL ON SHEET C-11.
- (37) CURB RAMP B, SEE DETAIL ON SHEET C-11.
- (38) CONCRETE WALK RAMP NOT TO EXCEED 8.33% AND 2.00% CROSS-SLOPE.

PROPOSED DETECTABLE WARNING SURFACE PER MODOT ITEM 608.50.

CURB RAMP C, SEE DETAIL ON SHEET C-11.

CONSTRUCTION AS NOTED ON PLANS REVIEW DEVELOPMENT SERVICES LEE'S SUMMIT, MISSOURI 09/29/2021

RELEASE FOR


REVISION/DATE/DESCRIPTION

60% Plan Set	10/20/20
90% Plan Set	11/17/20
100% Plan Set/Bid Set	12/16/20
Issue for Construction	04/26/21
Bulletin 2	06/04/21
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NOTICE

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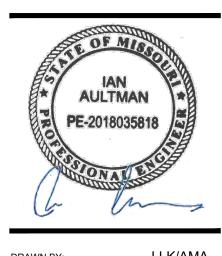
ms consultants, inc. engineers, architects, planners 2221 Schrock Road Columbus, Ohio 43229-1547 phone 614.898.7100 fax 614.898.7570

PROJECT

WHATABURGER PT20M BUILDING

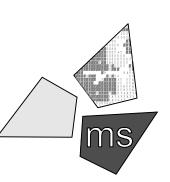
1460 NE DOUGLAS ST. LEE'S SUMMIT, MO 64086

SHEET TITLE SITE DIMENSION PLAN



DRAWN BY:	LLK/AIVIA
CHECKED BY:	KEA
PROJECT NO:	40497-01

DRAWING

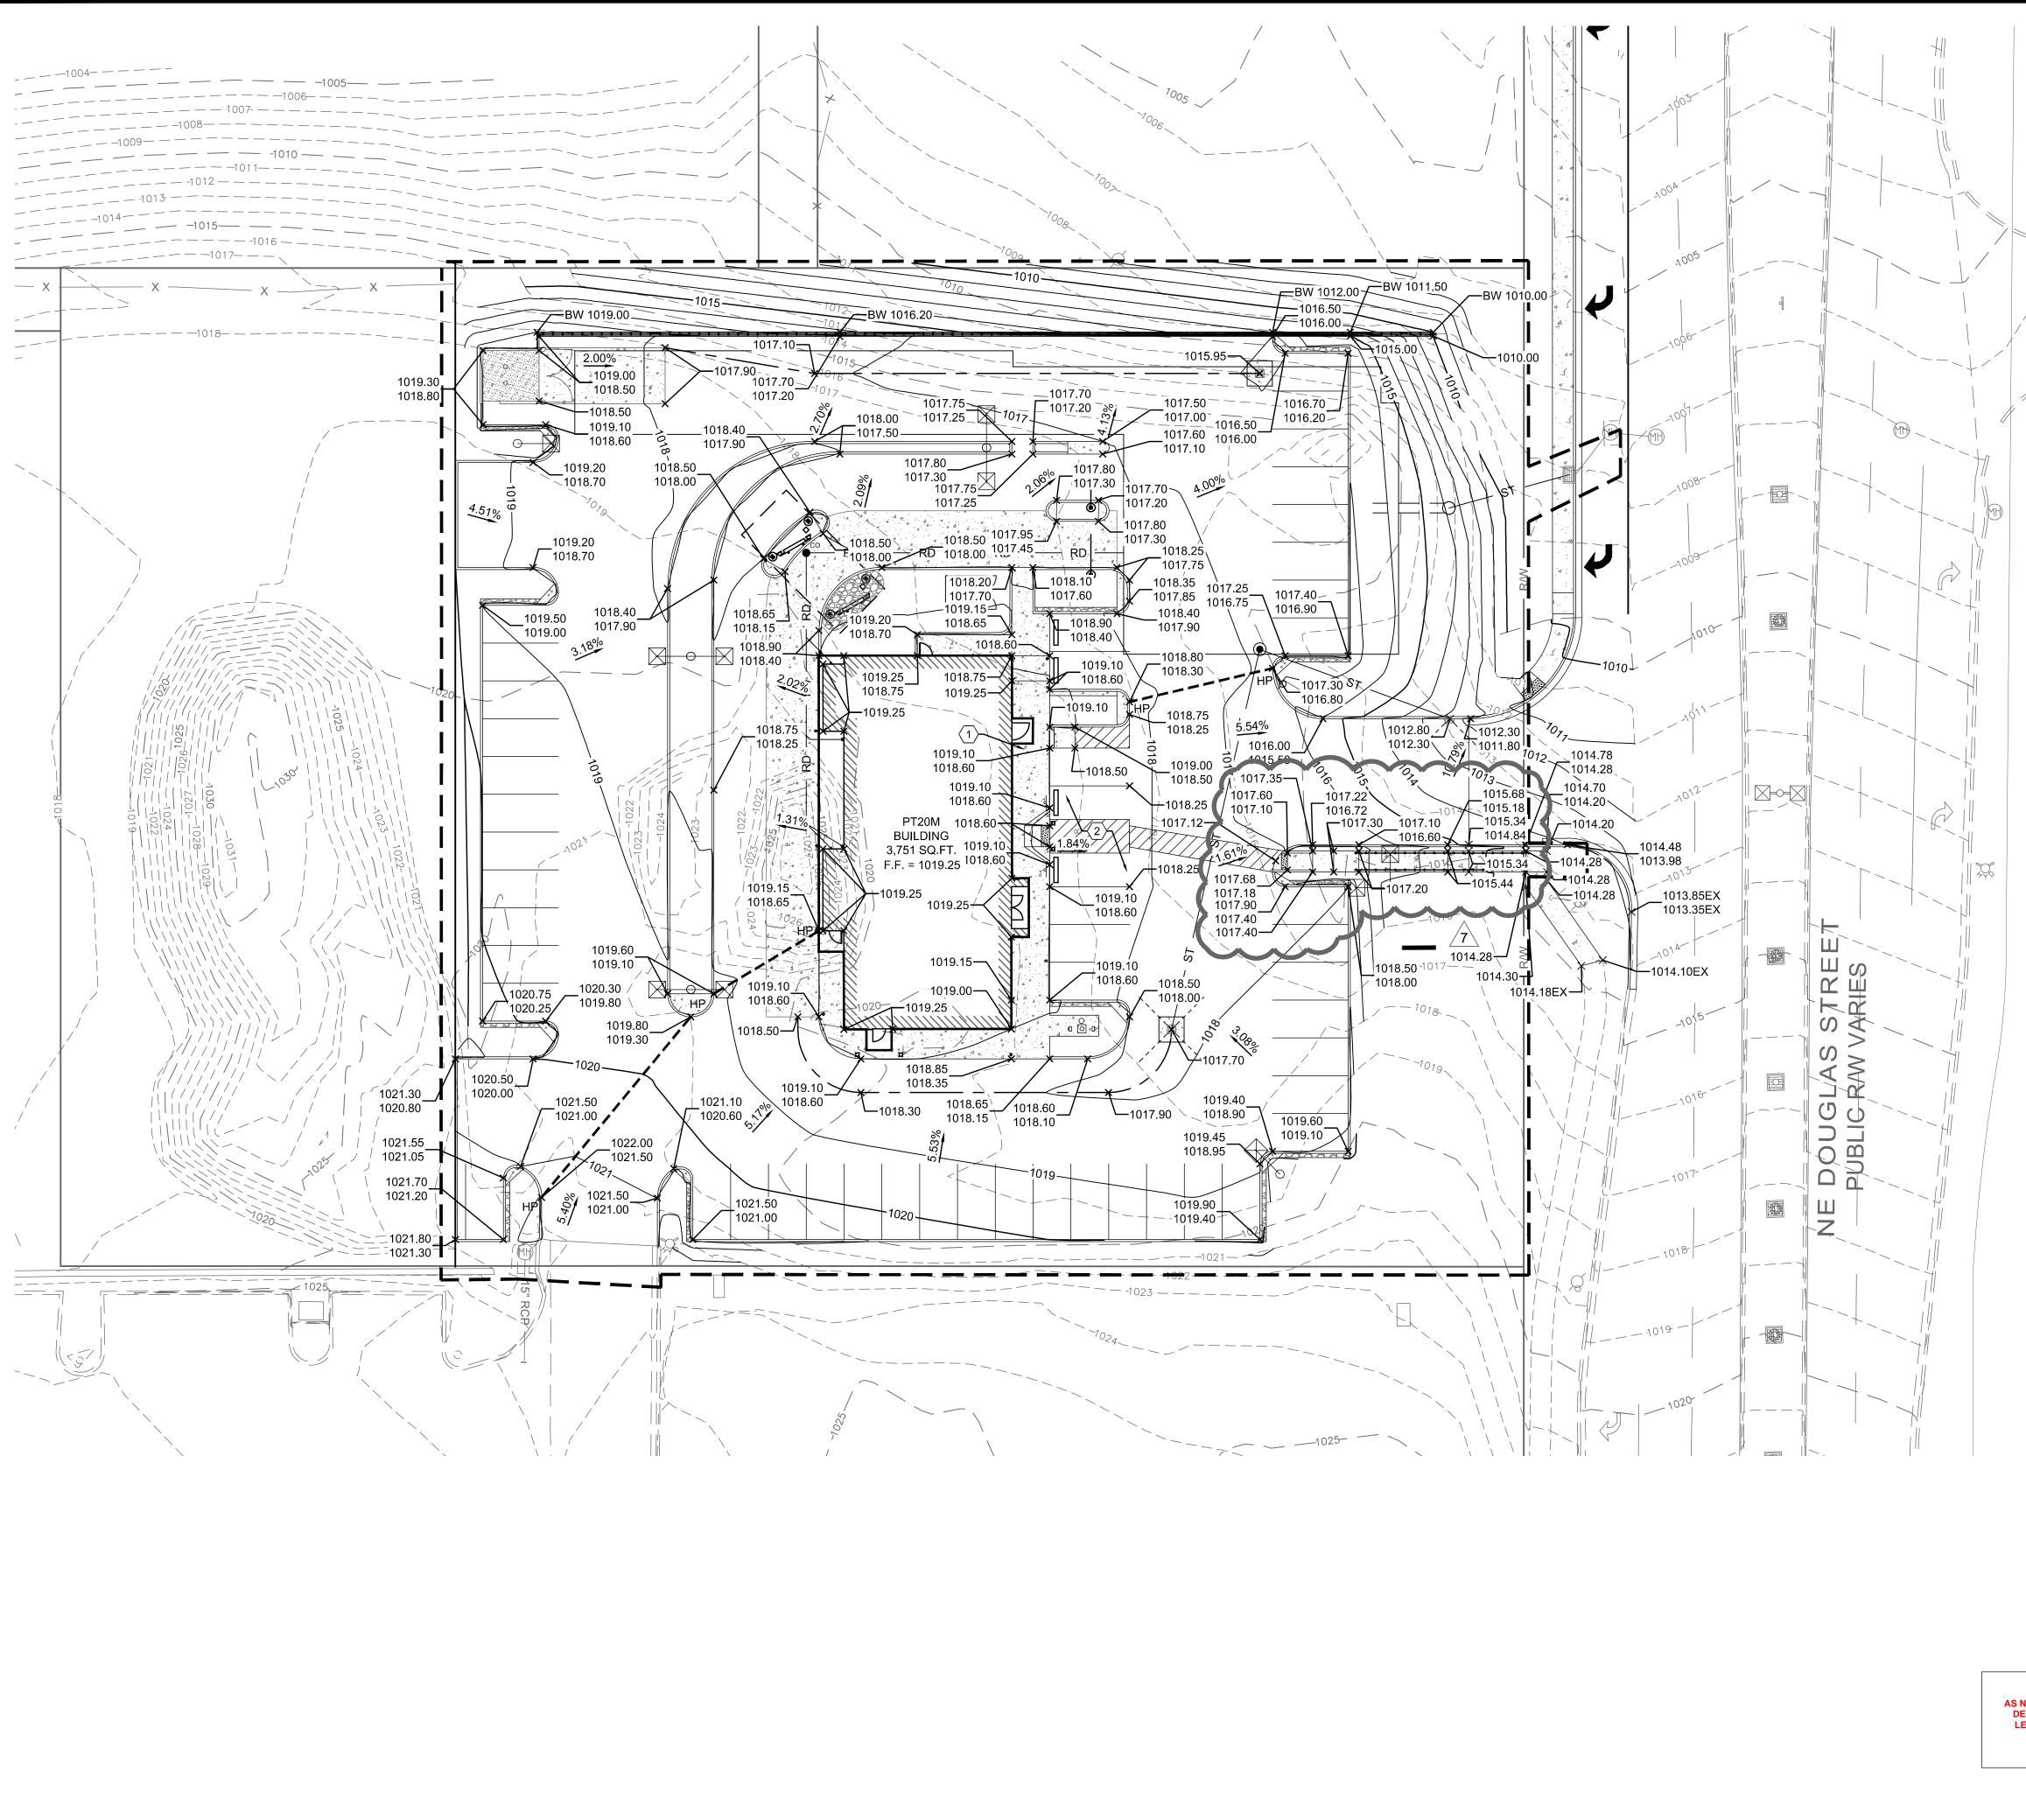

REVISION/DATE/DESCRIPTION

10/20/20

11/17/20

12/16/20

04/26/21

06/04/21

06/25/21

	90% Plan Set
	100% Plan Set/Bid Se
	Issue for Construction
	Bulletin 2
1202	Bulletin 3
DS AND	Bulletin 4

60% Plan Set


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- ALL CONSTRUCTION METHODS AND MATERIAL MUST CONFORM TO CURRENT STANDARD SPECIFICATIONS OF THE FEDERAL, STATE, COUNTY, CITY OR LOCAL REQUIREMENTS, WHICHEVER HAS JURISDICTION.
- ALL PROPOSED SPOT ELEVATIONS SHOWN ARE TOP OF CURB AND FINAL GRADE ELEVATIONS UNLESS OTHERWISE NOTED. CONTRACTOR IS RESPONSIBLE FOR LOCATING AND VERIFYING ALL EXISTING UNDERGROUND
- UTILITIES PRIOR TO CONSTRUCTION. CONTRACTOR TO VERIFY ALL EXISTING GRADES AND CONTACT ENGINEER PRIOR TO BEGINNING WORK IF DISCREPANCY IS FOUND. CONTRACTOR TO VERIFY ASSUMED FINISHED
- FLOOR ELEVATION PRIOR TO BEGINNING WORK. THE EXCAVATING CONTRACTOR MUST TAKE PARTICULAR CARE WHEN EXCAVATING IN AND AROUND EXISTING UTILITY LINES AND EQUIPMENT. VERIFY COVER REQUIREMENTS BY UTILITY
- CONTRACTORS AND/OR UTILITY COMPANIES SO AS TO NOT CAUSE DAMAGE. THE CONTRACTOR SHALL NOTIFY ALL UTILITY COMPANIES 48 HOURS BEFORE CONSTRUCTION IS TO START, TO VERIFY IF ANY UTILITIES ARE PRESENT ON SITE. ALL VERIFICATIONS (LOCATION, SIZE AND DEPTH) SHALL BE MADE BY THE APPROPRIATE UTILITY COMPANIES. WHEN EXCAVATION IS AROUND OR OVER EXISTING UTILITIES, THE CONTRACTOR MUST NOTIFY THE UTILITY SO A REPRESENTATIVE OF THAT UTILITY COMPANY CAN BE PRESENT TO INSTRUCT AND OBSERVE DURING CONSTRUCTION.
- ALL WORK SHALL BE PERFORMED FROM PRIVATE PROPERTY. ALL TRAFFIC LANES MUST REMAIN OPEN AT ALL TIMES.
- CONTRACTOR IS RESPONSIBLE FOR ANY DAMAGE TO THE EXISTING UTILITIES DURING CONSTRUCTION AND ALL DAMAGE SHALL BE REPAIRED TO ORIGINAL CONDITION AT NO ADDITIONAL COST TO THE OWNER OR CITY.
- ALL EXISTING UTILITIES ARE TAKEN FROM SURVEY AND DO NOT NECESSARILY REPRESENT ALL UNDERGROUND UTILITIES ADJACENT TO OR UPON PREMISES SHOWN ON PLAN.

KEYED NOTES:

- (1) CONTRACTOR TO MAINTAIN 2.00% MAX CROSS SLOPE ON SIDEWALK.
- (2) CONTRACTOR TO MAINTAIN MAX 2.00% SLOPE IN ALL DIRECTIONS IN HANDICAP ACCESSIBLE AREA.

LEGEND

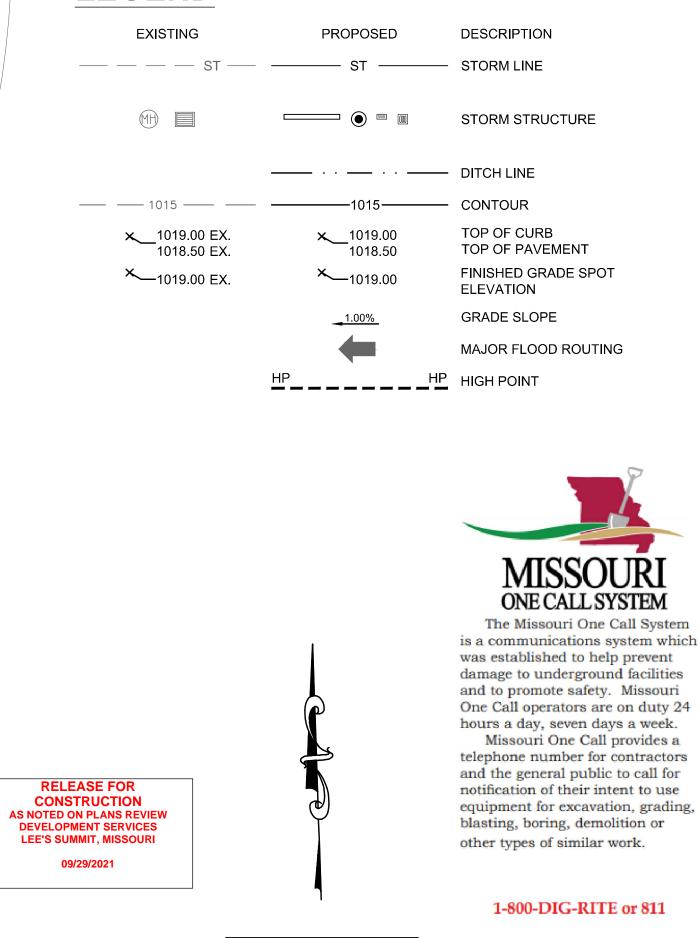

0 10 20

SCALE: 1"=20'


MAKE THE CALL ... IT'S THE LAW

07/08/21 Bulletin 6 08/26/21 Bulletin 7 09/28/21

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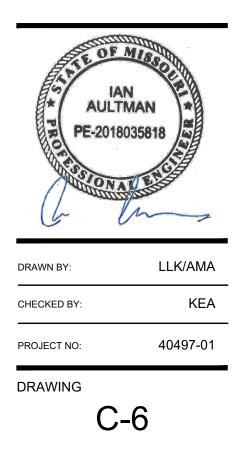
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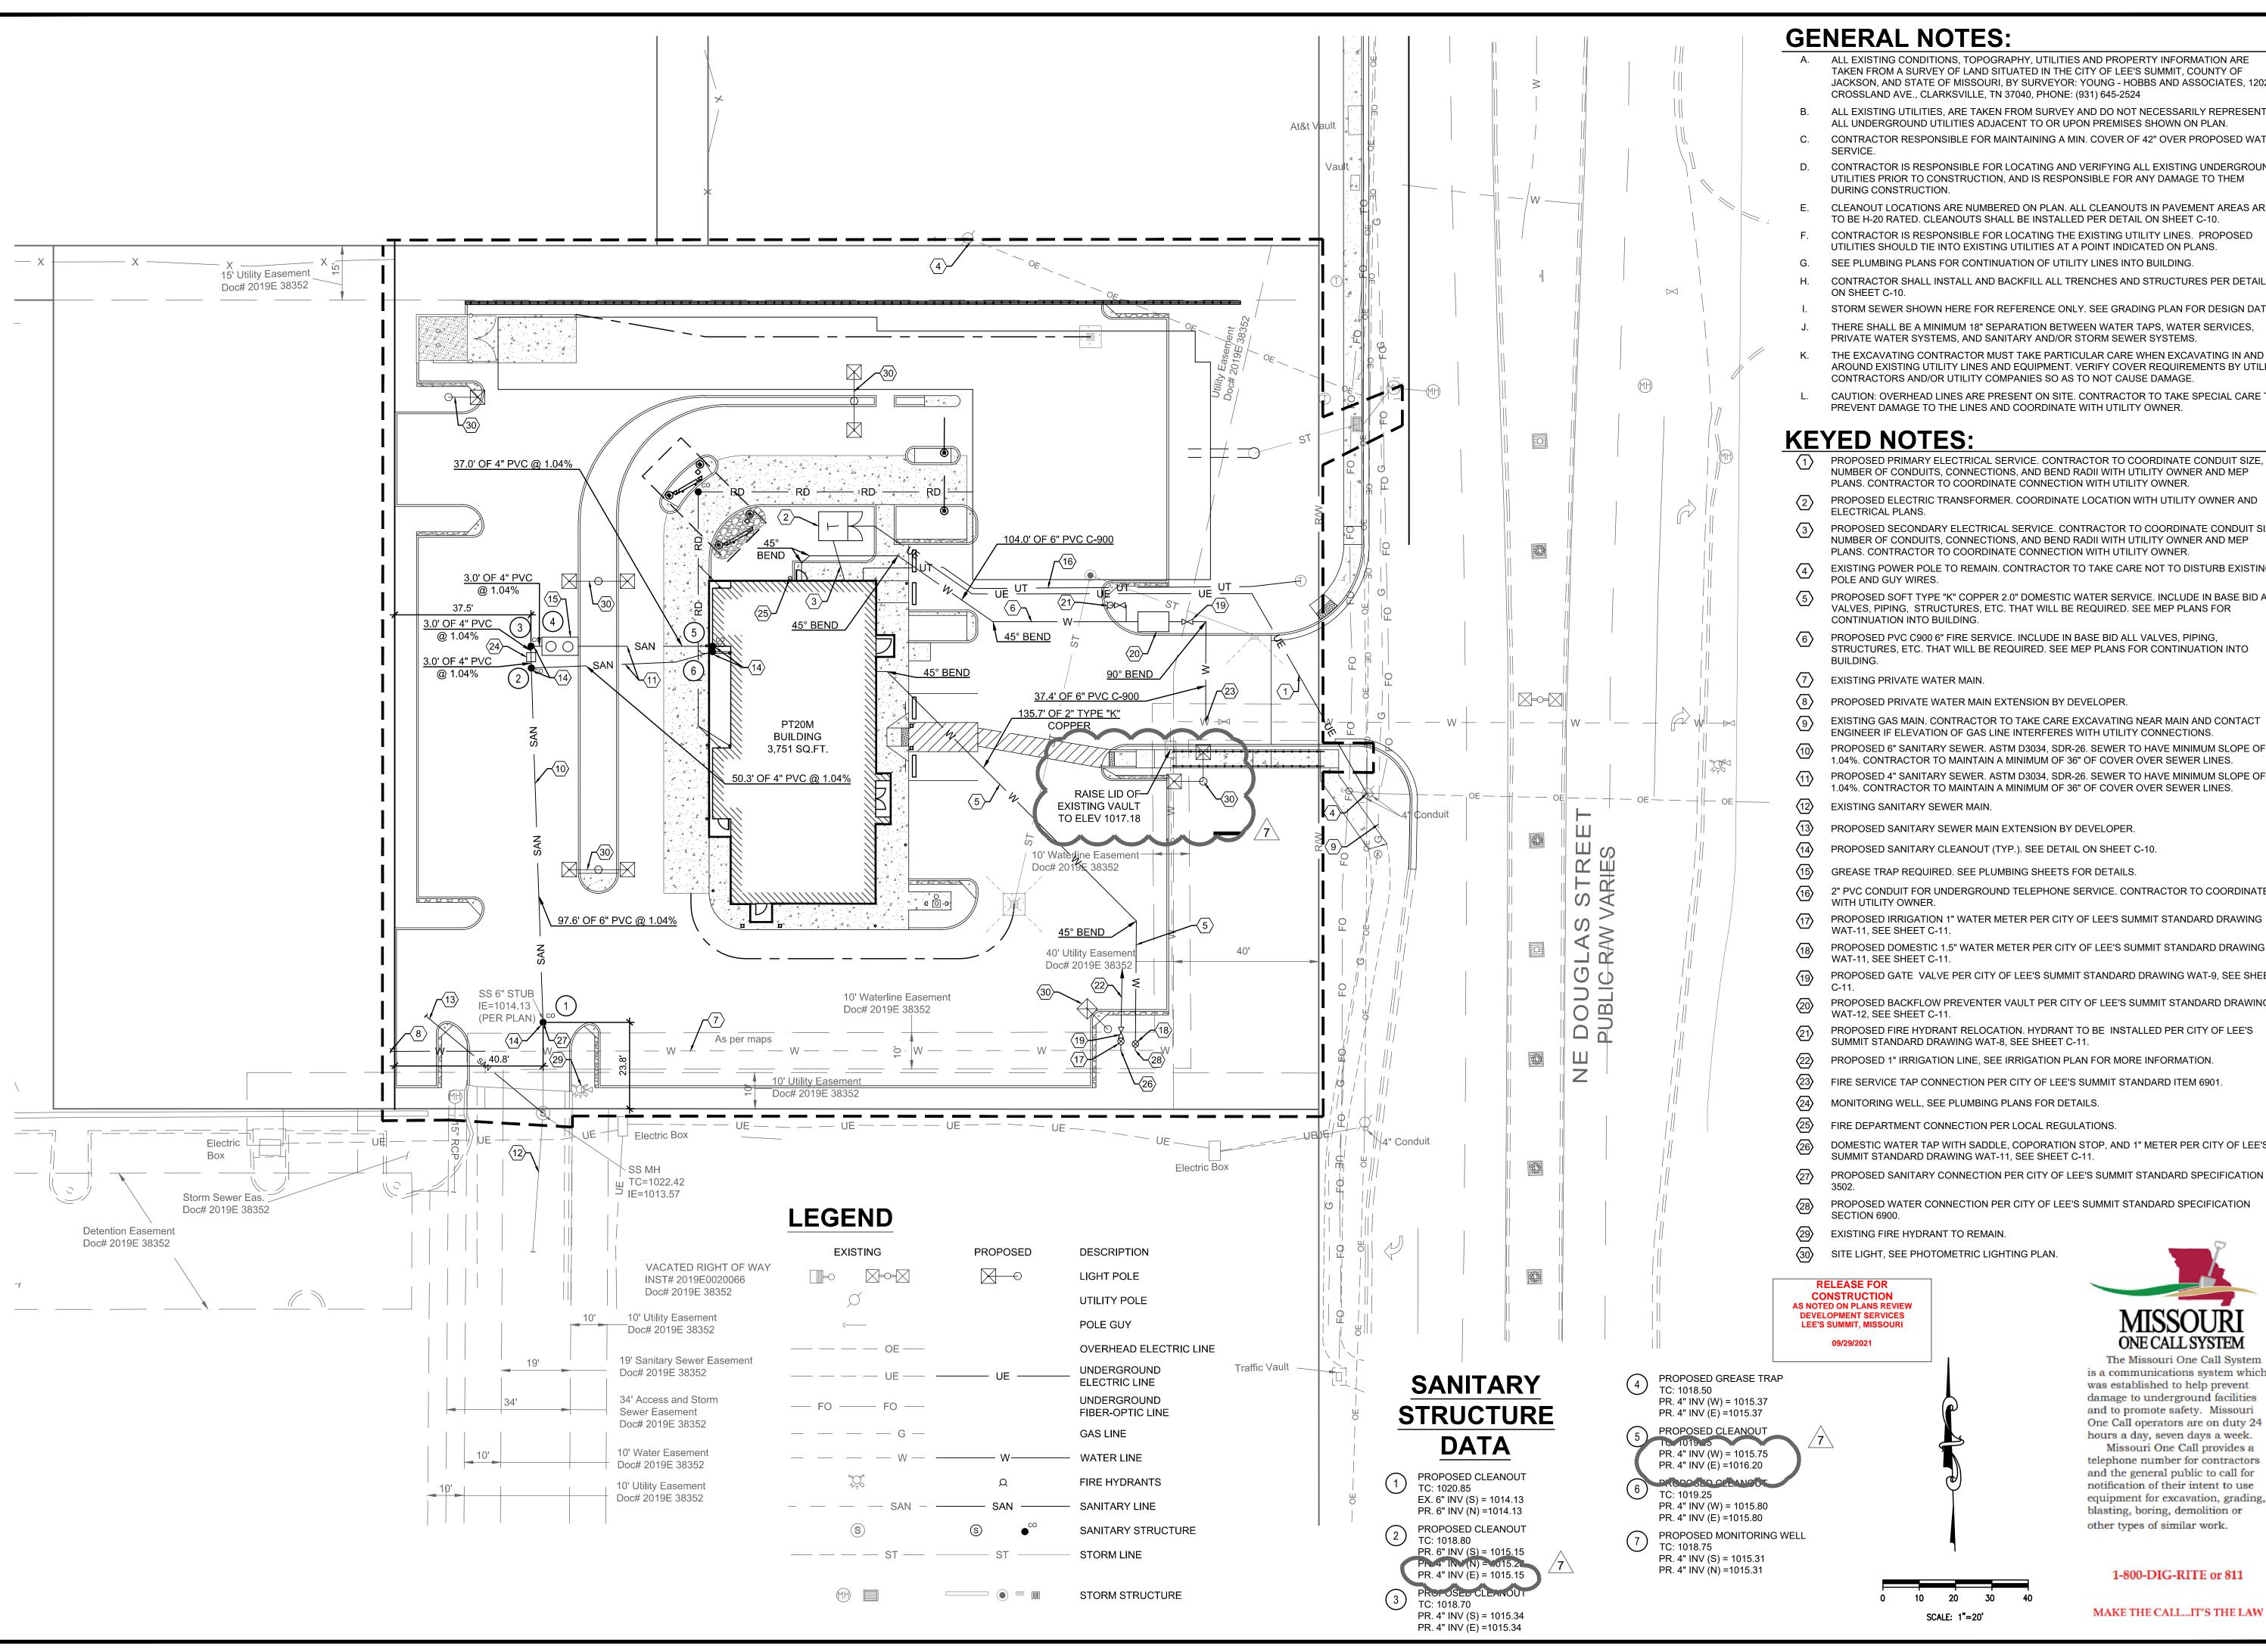
PROJECT

WHATABURGER PT20M BUILDING

1460 NE DOUGLAS ST. LEE'S SUMMIT, MO 64086

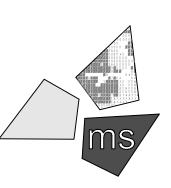SHEET TITLE SITE GRADING PLAN





- A. ALL EXISTING CONDITIONS, TOPOGRAPHY, UTILITIES AND PROPERTY INFORMATION ARE TAKEN FROM A SURVEY OF LAND SITUATED IN THE CITY OF LEE'S SUMMIT, COUNTY OF JACKSON, AND STATE OF MISSOURI, BY SURVEYOR: YOUNG - HOBBS AND ASSOCIATES, 1202 CROSSLAND AVE., CLARKSVILLE, TN 37040, PHONE: (931) 645-2524
- ALL EXISTING UTILITIES, ARE TAKEN FROM SURVEY AND DO NOT NECESSARILY REPRESENT
- CONTRACTOR RESPONSIBLE FOR MAINTAINING A MIN. COVER OF 42" OVER PROPOSED WATER
- CONTRACTOR IS RESPONSIBLE FOR LOCATING AND VERIFYING ALL EXISTING UNDERGROUND
- UTILITIES PRIOR TO CONSTRUCTION, AND IS RESPONSIBLE FOR ANY DAMAGE TO THEM
- CLEANOUT LOCATIONS ARE NUMBERED ON PLAN. ALL CLEANOUTS IN PAVEMENT AREAS ARE TO BE H-20 RATED. CLEANOUTS SHALL BE INSTALLED PER DETAIL ON SHEET C-10. CONTRACTOR IS RESPONSIBLE FOR LOCATING THE EXISTING UTILITY LINES. PROPOSED UTILITIES SHOULD TIE INTO EXISTING UTILITIES AT A POINT INDICATED ON PLANS.
- G. SEE PLUMBING PLANS FOR CONTINUATION OF UTILITY LINES INTO BUILDING.
- CONTRACTOR SHALL INSTALL AND BACKFILL ALL TRENCHES AND STRUCTURES PER DETAIL
- STORM SEWER SHOWN HERE FOR REFERENCE ONLY. SEE GRADING PLAN FOR DESIGN DATA. THERE SHALL BE A MINIMUM 18" SEPARATION BETWEEN WATER TAPS, WATER SERVICES, PRIVATE WATER SYSTEMS, AND SANITARY AND/OR STORM SEWER SYSTEMS.
- THE EXCAVATING CONTRACTOR MUST TAKE PARTICULAR CARE WHEN EXCAVATING IN AND AROUND EXISTING UTILITY LINES AND EQUIPMENT. VERIFY COVER REQUIREMENTS BY UTILITY CONTRACTORS AND/OR UTILITY COMPANIES SO AS TO NOT CAUSE DAMAGE.
- CAUTION: OVERHEAD LINES ARE PRESENT ON SITE. CONTRACTOR TO TAKE SPECIAL CARE TO PREVENT DAMAGE TO THE LINES AND COORDINATE WITH UTILITY OWNER.

- PROPOSED PRIMARY ELECTRICAL SERVICE. CONTRACTOR TO COORDINATE CONDUIT SIZE, NUMBER OF CONDUITS, CONNECTIONS, AND BEND RADII WITH UTILITY OWNER AND MEP PLANS. CONTRACTOR TO COORDINATE CONNECTION WITH UTILITY OWNER.
- PROPOSED ELECTRIC TRANSFORMER. COORDINATE LOCATION WITH UTILITY OWNER AND
- PROPOSED SECONDARY ELECTRICAL SERVICE. CONTRACTOR TO COORDINATE CONDUIT SIZE, NUMBER OF CONDUITS, CONNECTIONS, AND BEND RADII WITH UTILITY OWNER AND MEP PLANS. CONTRACTOR TO COORDINATE CONNECTION WITH UTILITY OWNER.
- EXISTING POWER POLE TO REMAIN. CONTRACTOR TO TAKE CARE NOT TO DISTURB EXISTING
- PROPOSED SOFT TYPE "K" COPPER 2.0" DOMESTIC WATER SERVICE. INCLUDE IN BASE BID ALL VALVES, PIPING, STRUCTURES, ETC. THAT WILL BE REQUIRED. SEE MEP PLANS FOR
- PROPOSED PVC C900 6" FIRE SERVICE. INCLUDE IN BASE BID ALL VALVES, PIPING, STRUCTURES, ETC. THAT WILL BE REQUIRED. SEE MEP PLANS FOR CONTINUATION INTO
- PROPOSED PRIVATE WATER MAIN EXTENSION BY DEVELOPER.
- EXISTING GAS MAIN. CONTRACTOR TO TAKE CARE EXCAVATING NEAR MAIN AND CONTACT ENGINEER IF ELEVATION OF GAS LINE INTERFERES WITH UTILITY CONNECTIONS.
- 1.04%. CONTRACTOR TO MAINTAIN A MINIMUM OF 36" OF COVER OVER SEWER LINES. PROPOSED 4" SANITARY SEWER. ASTM D3034, SDR-26. SEWER TO HAVE MINIMUM SLOPE OF
- 1.04%. CONTRACTOR TO MAINTAIN A MINIMUM OF 36" OF COVER OVER SEWER LINES.
- PROPOSED SANITARY SEWER MAIN EXTENSION BY DEVELOPER.
- PROPOSED SANITARY CLEANOUT (TYP.). SEE DETAIL ON SHEET C-10.
- GREASE TRAP REQUIRED. SEE PLUMBING SHEETS FOR DETAILS.
- 2" PVC CONDUIT FOR UNDERGROUND TELEPHONE SERVICE. CONTRACTOR TO COORDINATE
- PROPOSED IRRIGATION 1" WATER METER PER CITY OF LEE'S SUMMIT STANDARD DRAWING
- PROPOSED DOMESTIC 1.5" WATER METER PER CITY OF LEE'S SUMMIT STANDARD DRAWING
- PROPOSED GATE VALVE PER CITY OF LEE'S SUMMIT STANDARD DRAWING WAT-9, SEE SHEET
- PROPOSED BACKFLOW PREVENTER VAULT PER CITY OF LEE'S SUMMIT STANDARD DRAWING
- PROPOSED FIRE HYDRANT RELOCATION. HYDRANT TO BE INSTALLED PER CITY OF LEE'S
- PROPOSED 1" IRRIGATION LINE, SEE IRRIGATION PLAN FOR MORE INFORMATION.
- FIRE SERVICE TAP CONNECTION PER CITY OF LEE'S SUMMIT STANDARD ITEM 6901.
- MONITORING WELL, SEE PLUMBING PLANS FOR DETAILS.
- FIRE DEPARTMENT CONNECTION PER LOCAL REGULATIONS.
- DOMESTIC WATER TAP WITH SADDLE, COPORATION STOP, AND 1" METER PER CITY OF LEE'S
- PROPOSED SANITARY CONNECTION PER CITY OF LEE'S SUMMIT STANDARD SPECIFICATION
- PROPOSED WATER CONNECTION PER CITY OF LEE'S SUMMIT STANDARD SPECIFICATION
- SITE LIGHT, SEE PHOTOMETRIC LIGHTING PLAN.

MISSOURI ONE CALL SYSTEM The Missouri One Call System

is a communications system which was established to help prevent damage to underground facilities and to promote safety. Missouri One Call operators are on duty 24 hours a day, seven days a week. Missouri One Call provides a

telephone number for contractors and the general public to call for notification of their intent to use equipment for excavation, grading, blasting, boring, demolition or other types of similar work.

1-800-DIG-RITE or 811

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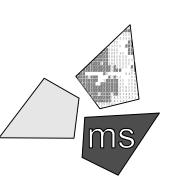
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PROJECT


WHATABURGER PT20M BUILDING

1460 NE DOUGLAS ST. LEE'S SUMMIT, MO 64086

SHEET TITLE SITE UTILITY PLAN

AULT	MISSOLUTION MAN B035818
DRAWN BY:	LLK/AMA

CHECKED BY:	KEA
PROJECT NO:	40497-01
DRAWING	

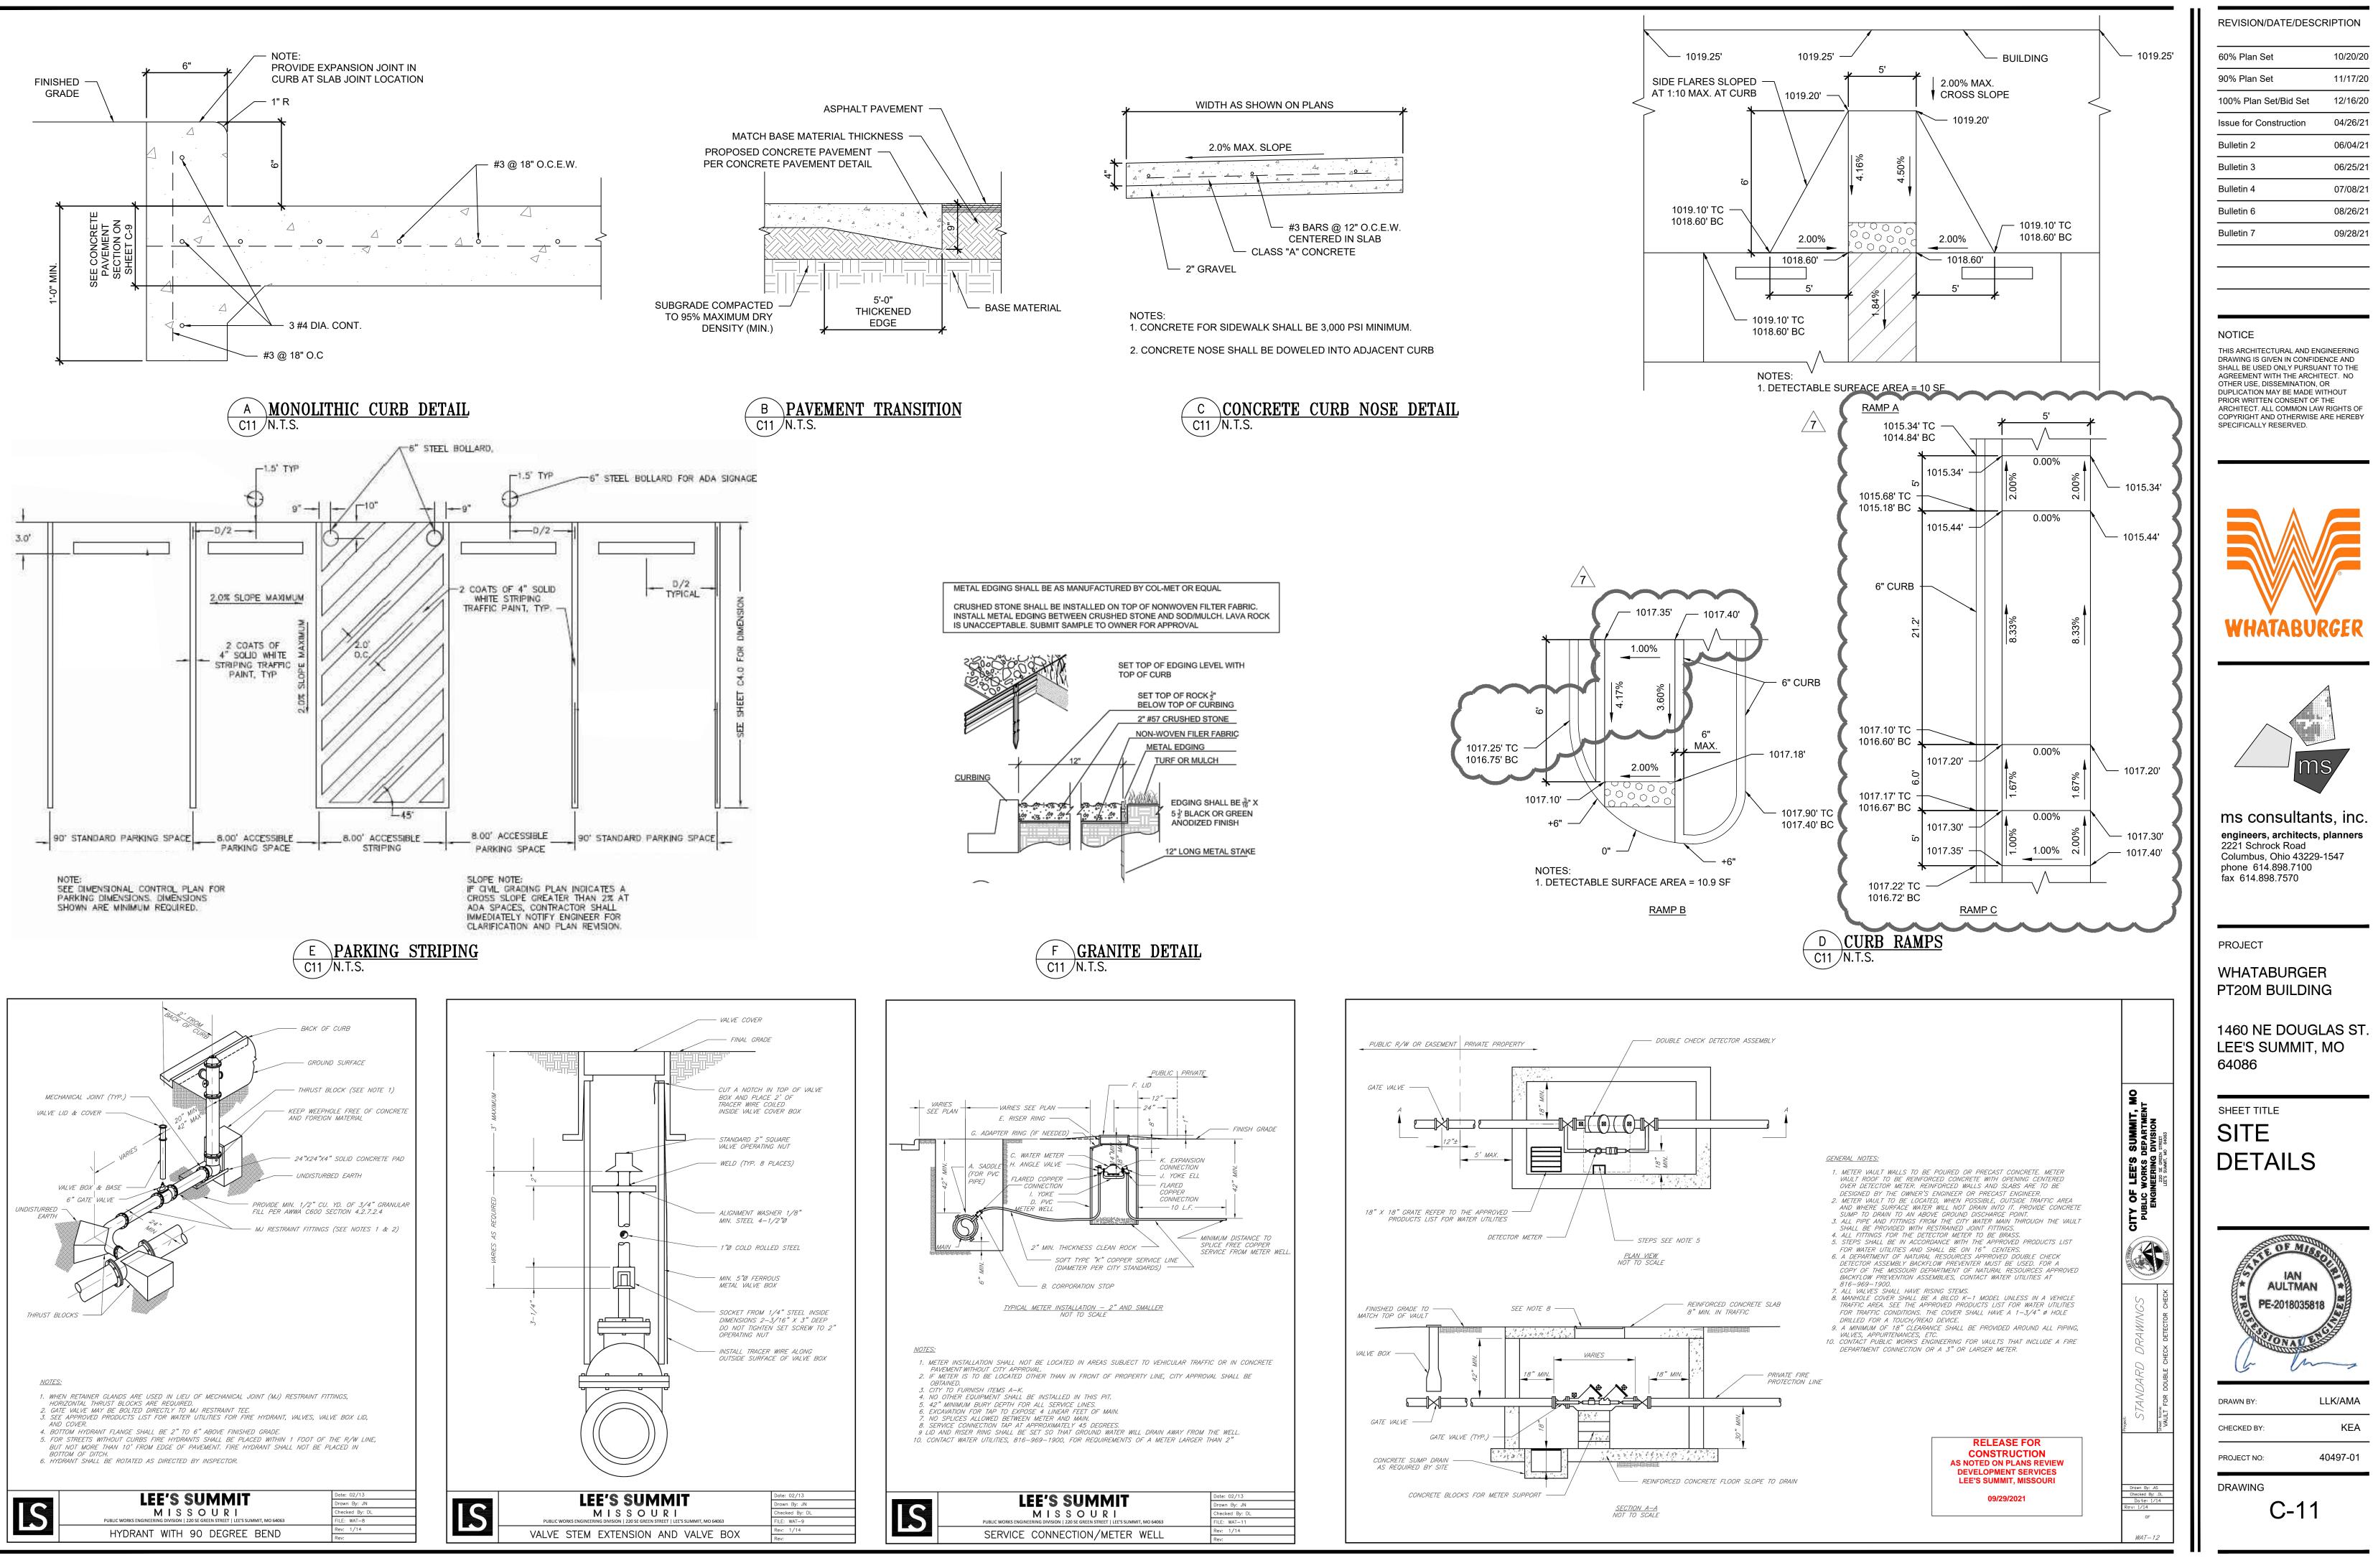

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