



# **AMERICAN TOWER®**

ATC SITE NAME: UNITY VILLAGE MO 2

ATC SITE NUMBER: 306035

T-MOBILE SITE NAME: ATC 306035 - I-470 & 50 HWY

T-MOBILE SITE NUMBER: A5C0133A

SITE ADDRESS: 2150 NORTHWEST LOWENSTEIN,

LEE'S SUMMIT, MO 64081-1905.



**LOCATION MAP** 

# T-MOBILE ANCHOR ANTENNA AMENDMENT PLAN 56791EZ\_SR CONFIGURATION

COMPLIANCE CODE	PROJECT SUMMARY		PROJECT DESCRIPTION		SHEET INDEX			
ALL WORK SHALL BE PERFORMED AND MATERIALS INSTALLED IN ACCORDANCE WITH THE CURRENT EDITIONS OF THE	SITE AD	<del></del>	THE PROPOSED PROJECT INCLUDES MODIFYING GROUND BASED AND TOWER MOUNTED EQUIPMENT AS INDICATED PER BELOW: TOWER WORK:	SHEET NO:	DESCRIPTION:	REV:	DATE:	BY:
FOLLOWING CODES AS ADOPTED BY THE LOCAL GOVERNMENT AUTHORITIES. NOTHING IN THESE PLANS IS		2150 NORTHWEST LOWENSTEIN I=	REMOVE (3) ANTENNA(s), (3) RRU(s), (3) TTA(s), (1) 1-5/8" COAX CABLE, (1) COVP.	G-001	TITLE SHEET	0	08/12/2021	HEG
TO BE CONSTRUED TO PERMIT WORK NOT CONFORMING TO	LEE'S SUMMIT,			G-002	GENERAL NOTES	0	08/12/2021	HEG
THESE CODES.  1. INTERNATIONAL BUILDING CODE (IBC)	COUNTY: LOWI		INSTALL (3) ANTENNAS, (3) RRHS, (2) HCS 2.0 AND (2) 1.46" HYBRID CABLE, (3) SITEPRO 1 STABILIZER KIT (SFS-V-L), (3) SITEPRO 1 BULK PIPE (P2150),	C-101	DETAILED SITE PLAN & TOWER ELEVATION	0	08/12/2021	HEG
NATIONAL ELECTRIC CODE (NEC)	GEOGRAPHIC (	COORDINATES:	(9) SITEPRO 1 CROSSOVER KIT (SCX7-U).		GROUND DETAIL PLAN	0		HEG
3. LOCAL BUILDING CODE	LATITUDE: 3	38.93360600	EXISTING (6) ANTENNAS, (3) RRUS, (6) 7/8" COAX CABLES, (5) 1-5/8" COAX CABLES TO REMAIN.	C-102		-	08/12/2021	
4. CITY/COUNTY ORDINANCES	LONGITUDE:		GROUND WORK:	C-201	TOWER ELEVATION	0	08/12/2021	HEG
	GROUND ELEVA	TION: 974' AMSL	REMOVE (2) AMOB, (1) FXFB, (1) ABIA, (1) ASIA, (1) ESMC, (1) COVP, (1) SSC	C-401	ANTENNA INFORMATION & SCHEDULE	0	08/12/2021	HEG
			CABINET.	C-501	CONSTRUCTION DETAILS	0	08/12/2021	HEG
			INSTALL (1) DELTA HPL3 SSC, (1) DELTA LB3 BSU, (2) HCS2.0, (1) ASIK, (1) ASIB, (3) ABIL W/ (3) ABIC, (2) AMIA, (1) VOLTAGE BOOSTER, (1) AMPLIFIER.	C-502	CABLE AND MOUNTING DETAILS	0	08/12/2021	HEG
			EXISTING (1) FSMF, (1) ASIA, (1) ASIK, (3) ABIA, (1) ABIL TO REMAIN.	C-503	LARGE BATTERY 3 CABINET MANUFACTURER DETAIL	0	08/12/2021	HEG
	PROJEC	CT TEAM	PROJECT NOTES	C-504	HP-LARGE 3 POWER CABINET MANUFACTURER DETAIL	0	08/12/2021	HEG
	TOWER OWNER:	APPLICANT:	THE FACILITY IS UNMANNED.     A TECHNICIAN WILL VISIT THE SITE APPROXIMATELY ONCE	E-501	GROUNDING DETAIL	0	08/12/2021	HEG
	AMERICAN TOWER T-MOBILE NORTHEAST LLC	3. THE PROJECT WILL NOT RESULT IN ANY SIGNIFICANT LAND	E-601	ELECTRICAL ONE-LINE DIAGRAM	0	08/12/2021	HEG	
	10 PRESIDENTIAL WAY WOBURN, MA 01801		DISTURBANCE OR EFFECT OF STORM WATER DRAINAGE.  4. NO SANITARY SEWER, POTABLE WATER OR TRASH	R-601	SUPPLEMENTAL			
UTILITY COMPANIES	ENGINEER:		DISPOSAL IS REQUIRED. 5. HANDICAP ACCESS IS NOT REQUIRED.	R-602	SUPPLEMENTAL			
POWER COMPANY: N/A	ATC TOWER SERVICES, LLC		THE PROJECT DEPICTED IN THESE PLANS QUALIFIES AS     AN ELIGIBLE FACILITIES REQUEST ENTITLED TO	R-603	SUPPLEMENTAL			
PHONE: N/A	3500 REGENCY PKWY STE 100 CARY, NC 27518		EXPEDITED REVIEW UNDER 47 U.S.C. 1455(A) AS A MODIFICATION OF AN EXISTING WIRELESS TOWER THAT		MOUNT MODIFICATION (9 PAGES)			
TELEPHONE COMPANY: N/A PHONE: N/A			INVOLVES THE COLLOCATION, REMOVAL, AND/OR					
	PROPERTY OWNER:		REPLACEMENT OF TRANSMISSION EQUIPMENT THAT IS NOT A SUBSTANTIAL CHANGE UNDER CFR 1.61000 (B)(7).					
<b>Q11</b>	N/A		PROJECT LOCATION DIRECTIONS					
Know what's below. Call before you dig.			FROM LEE'S SUMMIT MUNICIPAL AIRPORT, HEAD SOUTH ON NE DOUGLAS ST TOWARD LEE'S SUMMIT RD 0.7 MI, TURN LEFT TO STAY ON NE DOUGLAS ST 0.6 MI, USE THE RIGHT 2 LANES TO TURN RIGHT TO MERGE WITH I-470 W 0.2 MI, MERGE WITH I-470 W 3.6 MI, TAKE EXIT 5 FOR VIEW HIGH DR 0.2 MI, TURN LEFT ONTO VIEW HIGH DR 459 FT, TURN LEFT TO MERGE WITH I-470 E/US-50 E TOWARD LEE'S SUMMIT 1.2 MI, USE THE RIGHT LANE TO TAKE EXIT 7A FOR U.S 50 E TOWARD SEDALIA 0.5 MI.					





49030 Pontiac Trail, Suite 400 Wixom, Michigan 48393 PHONE: (248) 705-9212

REV.	DESCRIPTION	BY	DATE
$\triangle_{-}$	PRELIM	HEG	03/17/2021
$\triangle_{-}$	FINAL CD	<u>HEG</u>	08/12/2021
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SITE ADDRESS: 2150 NORTHWEST LOWENSTEIN, LEE'S SUMMIT, MO 64081-1905.

SEAL:



# T··Mobile

	DATE DRAWN:	08/12/2021
	ATC JOB NO:	13616192
	CUSTOMER ID:	ATC 306035 - I-470 & 50 HWY
	CUSTOMER #:	A5C0133A

TITLE SHEET

SHEET NUMBER:

REVISION:

G-001

#### **GENERAL CONSTRUCTION NOTES:**

- OWNER FURNISHED MATERIALS, T-MOBILE "THE COMPANY" WILL PROVIDE AND THE CONTRACTOR WILL INSTALL
  - A. BTS EQUIPMENT FRAME (PLATFORM) AND ICEBRIDGE SHELTER (GROUND BUILD/CO-LOCATE ONLY)
  - B. AC/TELCO INTERFACE BOX (PPC)
  - C. ICE BRIDGE (CABLE TRAY WITH COVER) (GROUND BUILD/CO-LOCATE ONLY, GC TO FURNISH AND INSTALL FOR ROOFTOP INSTALLATION)
  - D. TOWERS, MONOPOLES
  - E. TOWER LIGHTING
  - F. GENERATORS & LIQUID PROPANE TANK
  - G ANTENNA STANDARD BRACKETS, FRAMES AND PIPES FOR MOLINTING
  - H. ANTENNAS (INSTALLED BY OTHERS)
  - I. TRANSMISSION LINE
  - J. TRANSMISSION LINE JUMPERS
  - K. TRANSMISSION LINE CONNECTORS WITH WEATHERPROOFING KITS
  - L. TRANSMISSION LINE GROUND KITS
  - M. HANGERS
  - N. HOISTING GRIPS
  - O. BTS EQUIPMENT
- 2. THE CONTRACTOR IS RESPONSIBLE TO PROVIDE ALL OTHER MATERIALS FOR THE COMPLETE INSTALLATION OF THE SITE INCLUDING, BUT NOT LIMITED TO, SUCH MATERIALS AS FENCING, STRUCTURAL STEEL SUPPORTING SUB-FRAME FOR PLATFORM, ROOFING LABOR AND MATERIALS, GROUNDING RINGS, GROUNDING WIRES, COPPER-CLAD OR XIT CHEMICAL GROUND ROD(S), BUSS BARS, TRANSFORMERS AND DISCONNECT SWITCHES WHERE APPLICABLE, TEMPORARY ELECTRICAL POWER, CONDUIT, LANDSCAPING COMPOUND STONE, CRANES, CORE DRILLING, SLEEPERS AND RUBBER MATTING, REBAR, CONCRETE CAISSONS, PADS AND/OR AUGER MOUNTS, MISCELLANEOUS FASTENERS, CABLE TRAYS, NON-STANDARD ANTENNA FRAMES AND ALL OTHER MATERIAL AND LABOR REQUIRED TO COMPLETE THE JOB ACCORDING TO THE DRAWINGS AND SPECIFICATIONS. IT IS THE POSITION OF T-MOBILE TO APPLY FOR PERMITTING AND CONTRACTOR RESPONSIBLE FOR PICKUP AND PAYMENT OF REQUIRED PERMITS.
- ALL WORK SHALL CONFORM TO ALL CURRENT APPLICABLE FEDERAL, STATE, AND LOCAL CODES, INCLUDING ANS/EIA/TIA-222, AND COMPLY WITH ATC CONSTRUCTION SPECIFICATIONS.
- CONTRACTOR SHALL CONTACT LOCAL 811 FOR IDENTIFICATION OF UNDERGROUND UTILITIES PRIOR TO START OF CONSTRUCTION.
- 5. CONTRACTOR SHALL BE RESPONSIBLE FOR COORDINATING ALL REQUIRED
- ALL DIMENSIONS TO, OF, AND ON EXISTING BUILDINGS, DRAINAGE STRUCTURES, AND SITE IMPROVEMENTS SHALL BE VERIFIED IN FIELD BY CONTRACTOR WITH ALL DISCREPANCIES REPORTED TO THE ENGINEER.
- 7. DO NOT CHANGE SIZE OR SPACING OF STRUCTURAL ELEMENTS.
- DETAILS SHOWN ARE TYPICAL; SIMILAR DETAILS APPLY TO SIMILAR CONDITIONS UNLESS OTHERWISE NOTED.
- THESE DRAWINGS DO NOT INCLUDE NECESSARY COMPONENTS FOR CONSTRUCTION SAFETY WHICH SHALL BE THE SOLE RESPONSIBILITY OF THE CONTRACTOR.
- CONTRACTOR SHALL BRACE STRUCTURES UNTIL ALL STRUCTURAL ELEMENTS NEEDED FOR STABILITY ARE INSTALLED. THESE ELEMENTS ARE AS FOLLOWS: LATERAL BRACING, ANCHOR BOLTS, ETC.
- 11. CONTRACTOR SHALL DETERMINE EXACT LOCATION OF EXISTING UTILITIES, GROUNDS DRAINS, DRAIN PIPES, VENTS, ETC. BEFORE COMMENCING WORK.
- 12. INCORRECTLY FABRICATED, DAMAGED, OR OTHERWISE MISFITTING OR NONCONFORMING MATERIALS OR CONDITIONS SHALL BE REPORTED TO THE T-MOBILE REP PRIOR TO REMEDIAL OR CORRECTIVE ACTION. ANY SUCH REMEDIAL ACTION SHALL REQUIRE WRITTEN APPROVAL BY THE T-MOBILE REP PRIOR TO PROCEEDING.
- EACH CONTRACTOR SHALL COOPERATE WITH THE T-MOBILE REP, AND COORDINATE HIS WORK WITH THE WORK OF OTHERS.
- CONTRACTOR SHALL REPAIR ANY DAMAGE CAUSED BY CONSTRUCTION OF THIS PROJECT TO MATCH EXISTING PRE-CONSTRUCTION CONDITIONS TO THE SATISFACTION OF THE T-MOBILE CONSTRUCTION MANAGER.
- ALL CABLE/CONDUIT ENTRY/EXIT PORTS SHALL BE WEATHERPROOFED DURING INSTALLATION USING A SILICONE SEALANT.
- WHERE EXISTING CONDITIONS DO NOT MATCH THOSE SHOWN IN THIS PLAN SET, CONTRACTOR SHALL NOTIFY THE T-MOBILE REP AND ENGINEER OF RECORD IMMEDIATELY.
- 17. CONTRACTOR SHALL ENSURE ALL SUBCONTRACTORS ARE PROVIDED WITH A COMPLETE AND CURRENT SET OF DRAWINGS AND SPECIFICATIONS FOR THIS PROJECT.
- CONTRACTOR SHALL REMOVE ALL RUBBISH AND DEBRIS FROM THE SITE AT THE END OF EACH DAY.
- CONTRACTOR SHALL COORDINATE WORK SCHEDULE WITH AMERICAN TOWER CORPORATION (ATC) AND TAKE PRECAUTIONS TO MINIMIZE IMPACT AND DISRUPTION OF OTHER OCCUPANTS OF THE FACILITY.
- 20. CONTRACTOR SHALL FURNISH T-MOBILE AND AMERICAN TOWER CORPORATION (ATC) WITH A PDF MARKED UP AS-BUILT SET OF DRAWINGS UPON COMPLETION OF WORK.
- PRIOR TO SUBMISSION OF BID, CONTRACTOR SHALL COORDINATE WITH T-MOBILE REP
  TO DETERMINE WHAT, IF ANY, ITEMS WILL BE PROVIDED. ALL ITEMS NOT PROVIDED
  SHALL BE PROVIDED AND INSTALLED BY THE CONTRACTOR. CONTRACTOR WILL INSTALL
  ALL ITEMS PROVIDED.

- 22. PRIOR TO SUBMISSION OF BID, CONTRACTOR SHALL COORDINATE WITH T-MOBILE REP TO DETERMINE IF ANY PERMITS WILL BE OBTAINED BY CONTRACTOR. ALL REQUIRED PERMITS NOT OBTAINED BY T-MOBILE MUST BE OBTAINED, AND PAID FOR, BY THE CONTRACTOR.
- 23. CONTRACTOR SHALL INSTALL ALL SITE SIGNAGE IN ACCORDANCE WITH T-MOBILE SPECIFICATIONS AND REQUIREMENTS.
- 24. CONTRACTOR SHALL SUBMIT ALL SHOP DRAWINGS TO T-MOBILE FOR REVIEW AND APPROVAL PRIOR TO FABRICATION.
- ALL EQUIPMENT SHALL BE INSTALLED ACCORDING TO MANUFACTURER'S SPECIFICATIONS AND LOCATED ACCORDING TO T-MOBILE SPECIFICATIONS, AND AS SHOWN IN THESE PLANS.
- 26. THE CONTRACTOR SHALL SUPERVISE AND DIRECT THE PROJECT DESCRIBED HEREIN. THE CONTRACTOR SHALL BE SOLELLY RESPONSIBLE FOR ALL THE CONSTRUCTION MEANS, METHODS, TECHNIQUES, SEQUENCES AND PROCEDURES AND FOR COORDINATING ALL PORTIONS OF THE WORK UNDER THE CONTRACT.
- CONTRACTOR SHALL NOTIFY T-MOBILE REP A MINIMUM OF 48 HOURS IN ADVANCE OF POURING CONCRETE OR BACKFILLING ANY UNDERGROUND UTILITIES, FOUNDATIONS OR SEALING ANY WALL, FLOOR OR ROOF PENETRATIONS FOR ENGINEERING REVIEW AND APPROVAL.
- 28. CONTRACTOR SHALL BE RESPONSIBLE FOR SITE SAFETY INCLUDING COMPLIANCE WITH ALL APPLICABLE OSHA STANDARDS AND RECOMMENDATIONS AND SHALL PROVIDE ALL NECESSARY SAFETY DEVICES INCLUDING PPE AND PPM AND CONSTRUCTION DEVICES SUCH AS WELDING AND FIRE PREVENTION, TEMPORARY SHORING, SCAFFOLDING, TRENCH BOXES/SLOPING, BARRIERS, ETC.
- 29. THE CONTRACTOR SHALL PROTECT AT HIS OWN EXPENSE, ALL EXISTING FACILITIES AND SUCH OF HIS NEW WORK LIABLE TO INJURY DURING THE CONSTRUCTION PERIOD. ANY DAMAGE CAUSED BY NEGLECT ON THE PART OF THIS CONTRACTOR OR HIS REPRESENTATIVES, OR BY THE ELEMENTS DUE TO NEGLECT ON THE PART OF THIS CONTRACTOR OR HIS REPRESENTATIVES, EITHER TO THE EXISTING WORK, OR TO HIS WORK OR THE WORK OF ANY OTHER CONTRACTOR, SHALL BE REPAIRED AT HIS EXPENSE TO THE OWNER'S SATISFACTION.
- 30. ALL WORK SHALL BE INSTALLED IN A FIRST CLASS, NEAT AND WORKMANLIKE MANNER BY MECHANICS SKILLED IN THE TRADE INVOLVED. THE QUALITY OF WORKMANSHIP SHALL BE SUBJECT TO THE APPROVAL OF THE T-MOBILE REP. ANY WORK FOUND BY THE T-MOBILE REP TO BE OF INFERIOR QUALITY AND/OR WORKMANSHIP SHALL BE REPLACED AND/OR REWORKED AT CONTRACTOR EXPENSE UNTIL APPROVAL IS OBTAINED.
- 31. IN ORDER TO ESTABLISH STANDARDS OF QUALITY AND PERFORMANCE, ALL TYPES OF MATERIALS LISTED HEREINAFTER BY MANUFACTURER'S NAMES AND/OR MANUFACTURER'S CATALOG NUMBER SHALL BE PROVIDED BY THESE MANUFACTURERS AS SPECIFIED.
- 32. T-MOBILE FURNISHED EQUIPMENT SHALL BE PICKED-UP AT THE T-MOBILE WAREHOUSE, NO LATER THAN 48HR AFTER BEING NOTIFIED INSURED, STORED, UNCRATE, PROTECTED AND INSTALLED BY THE CONTRACTOR WITH ALL APPURTENANCES REQUIRED TO PLACE THE EQUIPMENT IN OPERATION, READY FOR USE. THE CONTRACTOR SHALL BE RESPONSIBLE FOR THE EQUIPMENT AFTER PICKING IT UP.
- 33. T-MOBILE OR HIS ARCHITECT/ENGINEER RESERVES THE RIGHT TO REJECT ANY EQUIPMENT OR MATERIALS WHICH, IN HIS OWN OPINION ARE NOT IN COMPLIANCE WITH THE CONTRACT DOCUMENTS, EITHER BEFORE OR AFTER INSTALLATION AND THE EQUIPMENT SHALL BE REPLACED WITH EQUIPMENT CONFORMING TO THE REQUIREMENTS OF THE CONTRACT DOCUMENTS BY THE CONTRACTOR AT NO COST TO T-MOBILE OR THEIR ARCHITECT/ENGINEER.

# SPECIAL CONSTRUCTION ANTENNA INSTALLATION NOTES:

- WORK INCLUDED:
  - A. ANTENNA AND COAXIAL CABLES ARE FURNISHED BY T-MOBILE UNDER A SEPARATE CONTRACT. THE CONTRACTOR SHALL ASSIST ANTENNA INSTALLATION CONTRACTOR IN TERMS OD COORDINATION AND SITE ACCESS. ERECTION SUBCONTRACTOR SHALL BE RESPONSIBLE FOR THE PROTECTION OF PERSONNEL AND
  - B. INSTALL ANTENNA AS INDICATE ON DRAWINGS AND T-MOBILE SPECIFICATIONS.
  - C. INSTALL GALVANIZED STEEL ANTENNA MOUNTS AS INDICATED ON DRAWINGS
  - D. INSTALL FURNISHED GALVANIZED STEEL OR ALUMINUM WAVEGUIDE AND PROVIDE PRINTOUT OF THAT TEST.
  - E. CONTRACTOR SHALL PROVIDE FOUR (4) SETS OF SWEEP TESTS USING ANRITZU-PACKARD 8713B RF SCALAR NETWORK ANALYZER. SUBMIT FREQUENCY DOMAIN REFLECTOMETER(FDR) TESTS RESULTS TO THE PROJECT MANAGER. SWEEP TESTS SHALL BE AS PER ATTACHED RFS "MINIMUM FIELD TESTING RECOMMENDED FOR ANTENNA AND HELIAX COAXIAL CABLE SYSTEMS" DATED 10/5/93. TESTING SHALL BE PERFORMED BY AN INDEPENDENT TESTING SERVICE AND BE BOUND AND SUBMITTED WITHIN ONE WEEK OF WORK COMPLETION.
  - F. INSTALL COAXIAL CABLES AND TERMINATING BETWEEN ANTENNAS AND EQUIPMENT PER MANUFACTURER'S RECOMMENDATIONS. WEATHERPROOF ALL CONNECTIONS BETWEEN THE ANTENNA AND EQUIPMENT PER MANUFACTURER'S REQUIREMENTS. TERMINATE ALL COAXIAL CABLE THREE (3) FEET IN EXCESS OF ENTRY PORT LOCATION UNLESS OTHERWISE STATED.
  - G. ANTENNA AND COAXIAL CABLE GROUNDING:
- ALL EXTERIOR #6 GREED GROUND WIRE "DAISY CHAIN" CONNECTIONS ARE TO BE WEATHER SEALED WITH RFS CONNECTORS/SPLICE WEATHERPROOFING KIT #221213 OR EQUAL.
- 3. ALL COAXIAL CABLE GROUNDING KITS ARE TO BE INSTALLED ON STRAIGHT RUNS OF

COAXIAL CABLE (NOT WITHIN BENDS)

ALL DISCREPANCIES FROM WHAT IS SHOWN ON THESE
CONSTRUCTION DRAWINGS SHALL BE COMMUNICATED TO ATC
ENGINEERING IMMEDIATELY FOR CORRECTION OR RE-DESIGN.
FAILURE TO COMMUNICATE DIRECTLY WITH ATC ENGINEERING OR
ANY CHANGES FROM THE DESIGN CONDUCTED WITHOUT PRIOR
APPROVAL FROM ATC ENGINEERING SHALL BE THE SOLE
RESPONSIBILITY OF THE GENERAL CONTRACTOR.





Wixom, Michigan 48393
PHONE: (248) 705-9212

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T-MOBILE SITE NAME:

ATC 306035 - I-470 & 50

HWY

SITE ADDRESS: 2150 NORTHWEST LOWENSTEIN, LEE'S SUMMIT MO 64081-1905

SEAL:



T · Mobile

DATE DRAWN: 08/12/2021
ATC JOB NO: 13616192
CUSTOMER ID: ATC 306035 - I-470 & 50 HWY
CUSTOMER #: A5C0133A

**GENERAL NOTES** 


SHEET NUMBER:

JMBER: REVISION

G-002


#### SITE PLAN NOTES:

- THIS SITE PLAN REPRESENTS THE BEST PRESENT KNOWLEDGE AVAILABLE TO THE ENGINEER AT THE TIME OF THIS DESIGN. THE CONTRACTOR SHALL VISIT THE SITE PRIOR TO CONSTRUCTION AND VERIFY ALL EXISTING CONDITIONS RELATED TO THE SCOPE OF WORK FOR THIS PROJECT.
- 2. ICE BRIDGE, CABLE LADDER, COAX PORT, AND COAX CABLE ARE SHOWN FOR REFERENCE ONLY. CONTRACTOR SHALL CONFIRM THE EXACT LOCATION OF ALL PROPOSED AND EXISTING EQUIPMENT AND STRUCTURES DEPICTED ON THIS PLAN. BEFORE UTILIZING EXISTING CABLE SUPPORTS, COAX PORTS, INSTALLING NEW PORTS OR ANY OTHER EQUIPMENT, CONTRACTOR SHALL VERIFY ALL ASPECTS OF THE COMPONENTS MEET THE ATC SPECIFICATIONS.

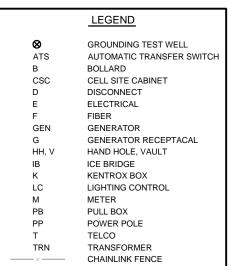

#### PROPOSED CABLE LENGTH:

- ESTIMATED LENGTH OF PROPOSED CABLE IS 170'.
   ESTIMATED LENGTH OF CABLE WAS PROVIDED BY
   CUSTOMER OR CALCULATED BY ADDING THE RAD
   CENTER AND THE DISTANCE FROM EQUIPMENT
   LOCATION TO THE TOWER (ALONG THE ICE BRIDGE)
   AND A SAFETY FACTOR MEASUREMENT OF 15% (OF
   THE TWO PREVIOUS VALUES), CDS DEFER TO
   GREATEST CABLE LENGTH.
- 2. ROUTE PROPOSED CABLES ALONG SAME PATH AS EXISTING CABLES AND IN ACCORDANCE WITH STRUCTURAL ANALYSIS. IF ADEQUATE SPACE EXISTS, ROUTE CABLES THROUGH ENTRY PORT HOLE, UP INSIDE OF MONOPOLE, AND THROUGH EXIT PORT HOLE. IF ROUTING OUTSIDE THE MONOPOLE, ATTACH CABLES USING STAND-OFF ADAPTERS MOUNTED TO TOWER USING STAINLESS STEEL BANDING. ADEQUATELY SECURE CABLES USING EITHER APPROPRIATELY SIZED STAINLESS STEEL SNAP-INS OR MOUNTING HARDWARE AND BRACKETS AS SPECIFIED BY CABLE MANUFACTURER.

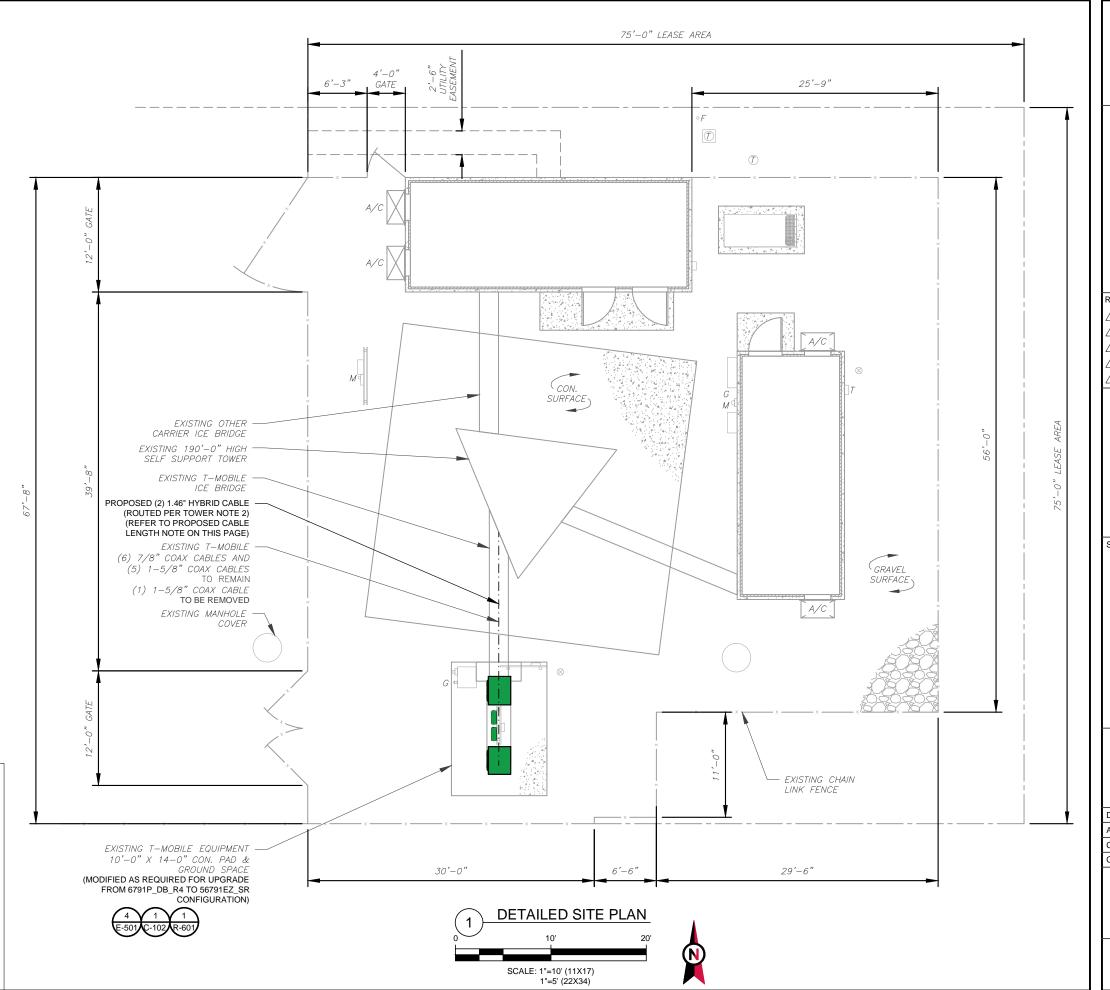





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REV.	DESCRIPTION	BY	DATE
A_	PRELIM	HEG	03/17/2021
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$\overline{\triangle}$	<u>-</u>		

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UNITY VILLAGE MO 2

T-MOBILE SITE NAME:

ATC 306035 - I-470 & 50

HWY SITE ADDRESS:

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SEAL



# T··Mobile

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ATC JOB NO:	13616192
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## **DETAILED SITE PLAN**


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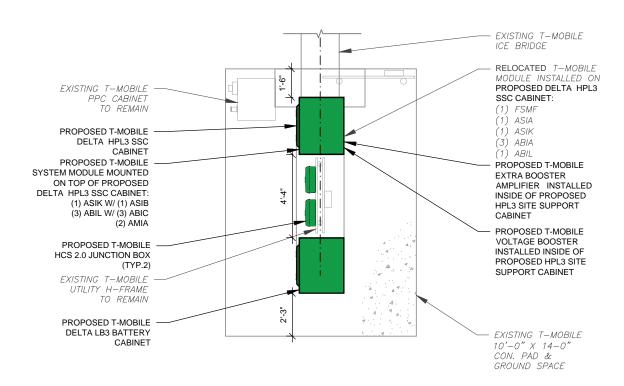
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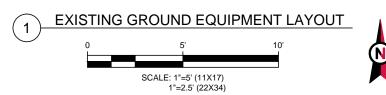
C-101


#### SITE PLAN NOTES:


- CONTRACTOR TO VERIFY THERE IS NO LIVE AAV FIBER RUNNING THROUGH EXISTING DEAD EQUIPMENT. IF SO, THIS WILL NEED TO BE RERUN THROUGH CONDUIT PRIOR TO REMOVING DEAD 2G (6201 CABS) EQUIPMENT.
- REMOVE EXISTING 2G CABINETS, AND POWER / TELCO WHIPS ASSOCIATED WITH THE DEAD 2. EQUIPMENT IF APPLICABLE.
- 3. ALL OPEN PORTS NEED TO BE SEALED / WEATHERPROOFED PROPERLY
- 4. ALL UNNEEDED / EXCESS EQUIPMENT AND GARBAGE TO BE REMOVED FROM EQUIPMENT AREA. DISPOSE OF MATERIALS PROPERLY OFF SITE.





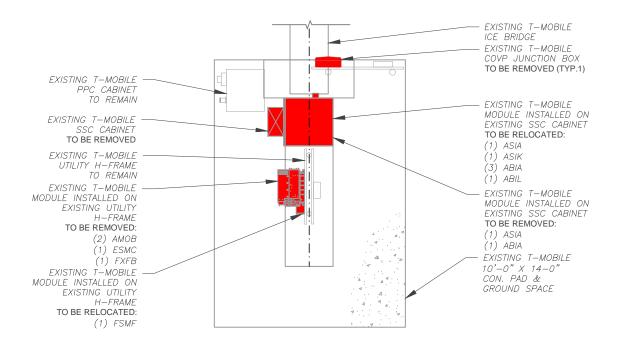

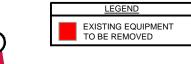

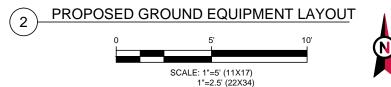



LEGEND PROPOSED EQUIPMENT TO BE INSTALLED





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REV.	DESCRIPTION	BY DATE
<u> </u>	PRELIM	HEG 03/17/2021
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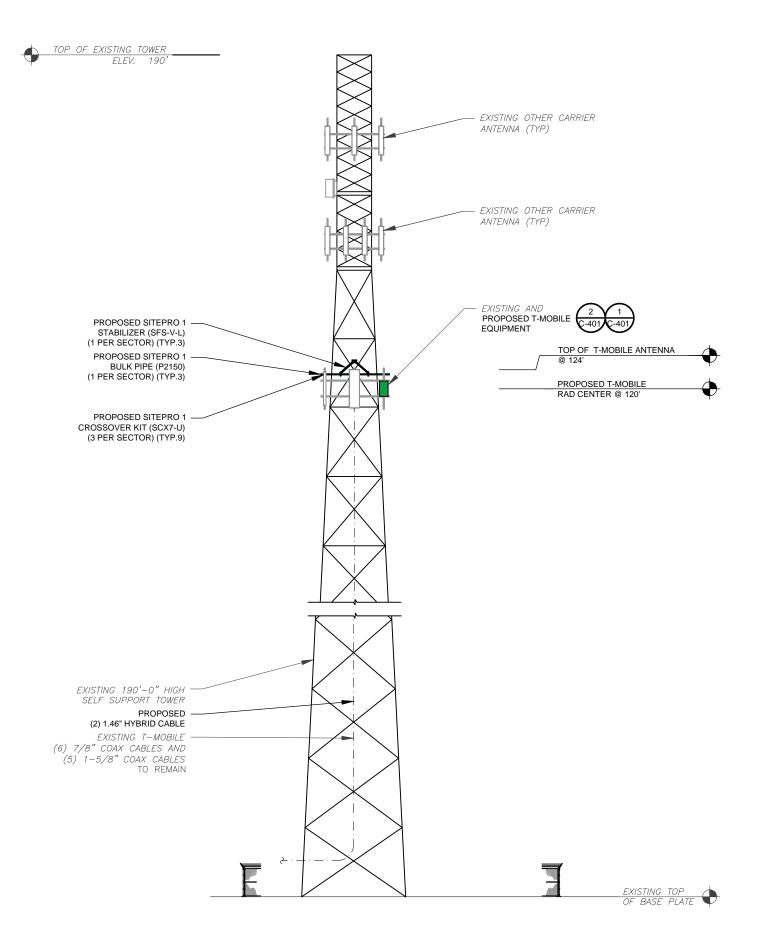


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		ATC JOB NO:	13616192
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# **DETAILED GROUND** PLAN

SHEET NUMBER:

C-102



**TOWER ELEVATION** 

SCALE: N.T.S.

PER MOUNT ANALYSIS COMPLETED BY SCOTT A. WIRGAU, DATED 08/02/2021, THE EXISTING MOUNT MUST BE MODIFIED TO ADEQUATELY
SUPPORT THE PROPOSED LOADING. THE MOUNT MODIFICATION PROPOSED IN THE MOUNT ANALYSIS, INCLUDED AT THE END OF THIS PLAN SET, MUST BE INSTALLED PRIOR TO THE INSTALLATION OF THE PROPOSED ANTENNAS AND OTHER EQUIPMENT

NOTES:
THIS DRAWING IS FOR EXHIBIT AND LAYOUT PURPOSES ONLY.

PLEASE REFER TO STRUCTURAL DOCUMENTS (PREPARED BY OTHERS) FOR PROJECT STRUCTURAL CALCULATION AND RESULTS.

NO WORK IS TO BE DONE WITHOUT AN APPROVED STRUCTURAL ANALYSIS PROVIDED BY OTHERS.

### SPECIAL NOTES:

- GC TO VERIFY ALL HEIGHTS AND AZIMUTHS IN FIELD PRIOR TO CONSTRUCTION. GC SHALL NOTIFY P.M. AND ARCHITECT/ENGINEER OF ANY DISCREPANCIES IMMEDIATELY.
- STRUCTURAL/ DESIGN & ANALYSIS SHALL BE PERFORMED & APPROVED BY TOWER OWNER AND MANUFACTURER (STRUCTURAL ANALYSIS BY OTHERS)
- . STRUCTURAL ANALYSIS PERFORMED BY OTHERS. CONTRACTOR TO THOROUGHLY REVIEW THE TOWER STRUCTURAL ANALYSIS FOR INFORMATION PERTAINING TO TOWER UPGRADES, MOUNTING TYPES, ANTENNA HEIGHTS, AND CABLE ROUTING, ANY OTHER DISCREPANCIES BETWEEN THE DRAWINGS, STRUCTURAL ANALYSIS, AND TOWER PLANS SHOULD BE BROUGHT TO THE ATTENTION OF THE PROJECT MANAGER PRIOR TO BIDDING AND INSTALLATION.

- IT IS THE CONTRACTOR'S RESPONSIBILITY TO CONFIRM WITH THE AMERICAN TOWER CONSTRUCTION MANAGER THAT THEY HAVE THE MOST RECENT VERSION OF THE STRUCTURAL ANALYSIS BEFORE COMMENCING WORK. EXISTING AND PROPOSED TOWER APPURTENANCES, MOUNTS, AND ANTENNAS ARE SHOWN BASED ON THE STRUCTURAL ANALYSIS.
- ROUTE PROPOSED CABLES ALONG SAME PATH AS EXISTING CABLES AND IN ACCORDANCE WITH STRUCTURAL ANALYSIS. IF ADEQUATE SPACE EXISTS, ROUTE CABLES THROUGH ENTRY PORT HOLE, UP INSIDE OF MONOPOLE, AND THROUGH EXIT PORT HOLE. IF ROUTING OUTSIDE THE MONOPOLE, ATTACH CABLES USING STAND-OFF ADAPTERS MOUNTED TO TOWER USING STAINLESS STEEL BANDING. ADEQUATELY SECURE CABLES USING EITHER APPROPRIATELY SIZED STAINLESS STEEL SNAP-INS OR MOUNTING HARDWARE AND BRACKETS AS SPECIFIED BY CABLE MANUFACTURER.
- TOWER ELEVATIONS ARE MEASURED FROM TOP OF BASE PLATE TO MATCH STRUCTURAL ANALYSIS. ELEVATIONS DO NOT REFLECT TRUE ABOVE GROUND LEVEL (A.G.L.)





49030 Pontiac Trail. Suite 400 Wixom, Michigan 48393 PHONE: (248) 705-9212

REV.	DESCRIPTION	BY	DATE
A_	PRELIM	HEG	03/17/2021
$\triangle_{-}$	FINAL CD	<u>HEG</u>	08/12/2021
$\triangle$			
$\triangle$			
$\wedge$			

ATC SITE NUMBER: 306035

ATC SITE NAME:

**UNITY VILLAGE MO 2** 

T-MOBILE SITE NAME:

ATC 306035 - I-470 & 50 HWY

SITE ADDRESS:

2150 NORTHWEST LOWENSTEIN, LEE'S SUMMIT. MO 64081-1905.




T··Mobile

	DATE DRAWN:	08/12/2021
	ATC JOB NO:	13616192
	CUSTOMER ID:	ATC 306035 - I-470 & 50 HWY
	CUSTOMER #:	A5C0133A

**TOWER ELEVATION** 

SHEET NUMBER:

C-201

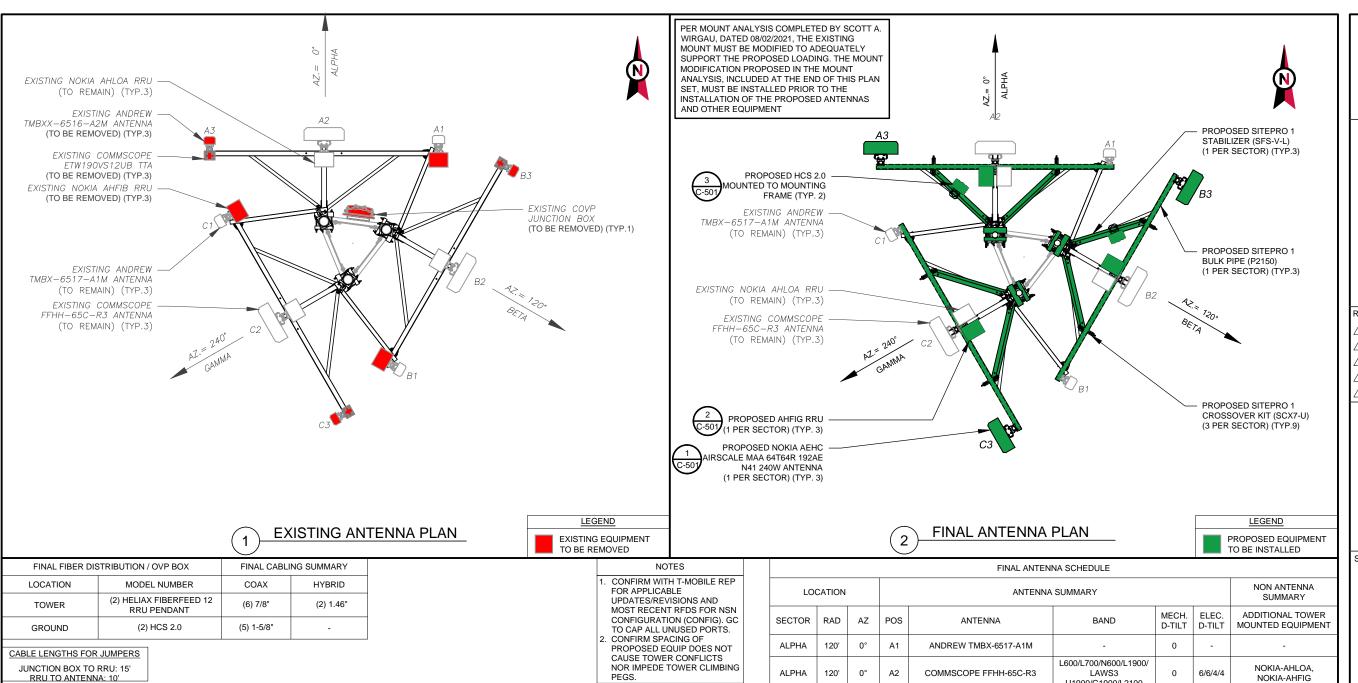

NOKIA-AHFIG U1900/G1900/L2100 ALPHA 120' 0° A3 NOKIA AEHC L2500/N2500 0 4 ANDREW TMBX-6517-A1M BETA 120' 120° B1 0 L600/L700/N600/L1900/ NOKIA-AHLOA. BETA 120' 120° B2 COMMSCOPE FFHH-65C-R3 0 LAWS3 6/6/4/4 NOKIA-AHFIG U1900/G1900/L2100 BETA 120' 120° ВЗ NOKIA AEHC L2500/N2500 0 4 GAMMA 120' 240° C1 ANDREW TMBX-6517-A1M 0 L600/L700/N600/L1900/ NOKIA-AHLOA, 120' 240° C2 COMMSCOPE FFHH-65C-R3 0 6/6/4/4 GAMMA LAWS3 NOKIA-AHFIG U1900/G1900/L2100 GAMMA 120' 240° СЗ NOKIA AEHC L2500/N2500 0 4





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RE	V. DESCRIPTION	BY	DATE
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<u> </u>	FINAL CD	<u>HEG</u>	08/12/2021
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ATC SITE NUMBER: 306035
ATC SITE NAME:

UNITY VILLAGE MO 2
T-MOBILE SITE NAME:

ATC 306035 - I-470 & 50 HWY

> SITE ADDRESS: 2150 NORTHWEST LOWENSTEIN, LEE'S SUMMIT. MO 64081-1905.

SEAL




# T··Mobile

DATE DRAWN:	08/12/2021
ATC JOB NO:	13616192
CUSTOMER ID:	ATC 306035 - I-470 & 50 HWY
CUSTOMER #:	A5C0133A


# RF SCHEDULE AND ANTENNA INSTALLATION

SHEET NUMBER:

C-401

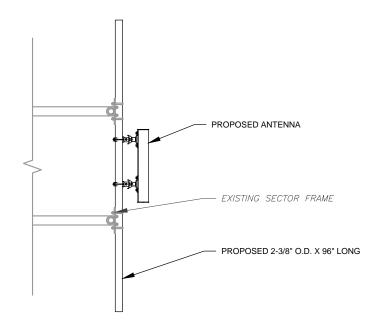

PROPOSED 5G ANTENNA MOUNTING DETAIL - TYPICAL
SCALE: N.T.S

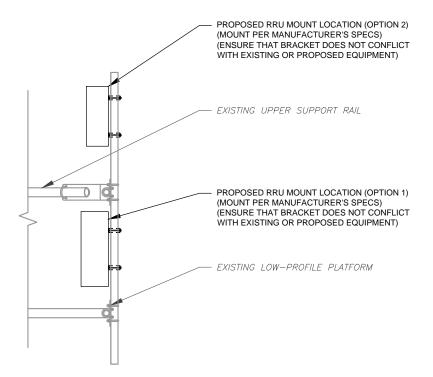

PROPOSED OVP
(MOUNT PER
MANUFACTURER'S SPECS)
(ENSURE THAT BRACKET DOES
NOT CONFLICT WITH EXISTING
OR PROPOSED EQUIPMENT)

PROPOSED MOUNTING
PIPE ATTACHED EXISTING
STAND-OFF SUPPORT

EXISTING PLATFORM
STAND-OFF SUPPORT

PROPOSED RRU MOUNTING DETAIL - TYPICAL

SCALE: N.T.S.

PROPOSED OVP MOUNTING
SCALE: N.T.S.





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REV.	DESCRIPTION	BY DATE
<u> </u>	PRELIM	HEG 03/17/2021
<u> </u>	FINAL CD	HEG 08/12/2021
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ATC SITE NUMBER: 306035
ATC SITE NAME:

UNITY VILLAGE MO 2

T-MOBILE SITE NAME:

ATC 306035 - I-470 & 50

HWY

SITE ADDRESS: 2150 NORTHWEST LOWENSTEIN, LEE'S SUMMIT, MO 64081-1905.

SEAL:



# T··Mobile


	DATE DRAWN:	08/12/2021
	ATC JOB NO:	13616192
	CUSTOMER ID:	ATC 306035 - I-470 & 50 HWY
	CUSTOMER #:	A5C0133A

# CONSTRUCTION DETAILS

SHEET NUMBER:

C-501


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TYPICAL AHLOA UNIT MOUNTING DETAIL
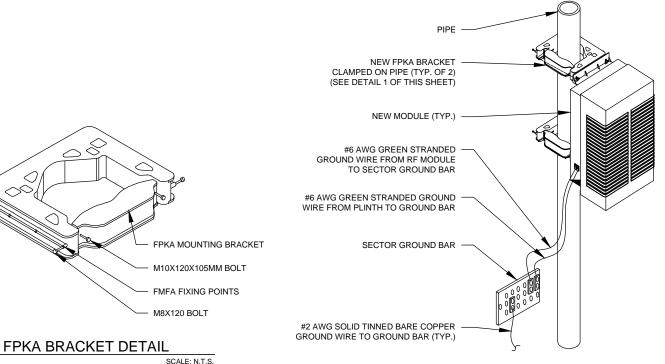
## FRONT OF THE ANTENNA

ANTENNA #2 ANTENNA #3 ANTENNA #4 ANTENNA #1



SECTOR AND THE 4TH PORT OF ANTENNA EXAMPLE: COAX WITH FOUR BANDS OF RED TAPE WILL REPRESENT ALPHA SECTOR AND THE 4TH PORT OF ANTENNA

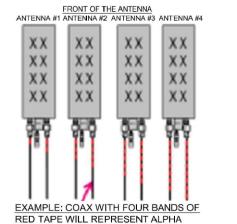ANTENNA AND COAXIAL CABLE SCHEDULE

ID W/LABEL MAKER

ANTENNAS WILL BE LABELED (BACK OF ANTENNA VIEW) RIGHT

COAX/JUMPER LINES WILL BE IDENTIFIED BY SECTOR COLOR

ROWN + SECTOR COLOR BANDS (1 & 2)

AND BY NUMBER OF BANDS AROUND THE COAX/JUMPER

BLUE

YELLOW

WHITE

PINK

DRANGE

URPLE

COAX COLOR CODING

SECTOR A

SECTOR B

SECTOR C

SECTOR D

SECTOR E

SECTOR F

FIBER ID

UNUSED COAX

MICROWAVE

DWE T-1'S + GPS

DOWNLINK CABLE

LMU

TO LEFT 1-X PORTS

- 1. ALL ANTENNAS SHALL BE FURNISHED WITH DOWNTILT BRACKETS. CONTRACTOR SHALL COORDINATE REQUIRED MECHANICAL DOWNTILT FOR EACH ANTENNA WITH RF ENGINEER. ANTENNA DOWNTILT SHALL BE SET AND VERIFIED BY A SMART LEVEL.
- 2. CONTRACTOR SHALL INSTALL COLOR CODE RINGS ON EACH OF THE HYBRID CABLES AND JUMPER CABLES WITH UV RESISTANT TAPE. ALL CABLE SHALL BE MARKED AT TOP AND BOTTOM WITH 2" COLOR TAPE OR STENCIL TAG. COLOR TAPE MAY BE OBTAINED FROM GRAYBAR ELECTRONICS.







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REV.	DESCRIPTION	BY	DATE
$ \mathbb{A}_{-}$	PRELIM	HEG	03/17/2021
$ \triangle _{-}$	FINAL CD	HEG	08/12/2021
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ATC SITE NUMBER: 306035

ATC SITE NAME:

**UNITY VILLAGE MO 2** 

T-MOBILE SITE NAME:

ATC 306035 - I-470 & 50

HWY

SITE ADDRESS: 2150 NORTHWEST LOWENSTEIN, LEE'S SUMMIT. MO 64081-1905.





DATE DRAWN:	08/12/2021
ATC JOB NO:	13616192
CUSTOMER ID:	ATC 306035 - I-470 & 50 HWY
CUSTOMER #:	A5C0133A

**CABLE AND MOUNTING DETAILS** 

REVISION:

SHEET NUMBER:

C-502

RF JUMPER CONNECTION DETAIL SCALE: N.T.S.

CABLE TIE


TO 221.27 IN/LBS

JUMPERS TO BE TORQUED

(1) WRAP OF INSULATION TAPE (OVERLAPPING 50%) (2) STRETCH WRAPPED WRAPS OF SELF AMALGAMATING TAPE (STRETCH 30%, OVERLAPPING 50%)

(3) WRAPS OF INSULATION TAPE

(OVERLAPPING 50%)

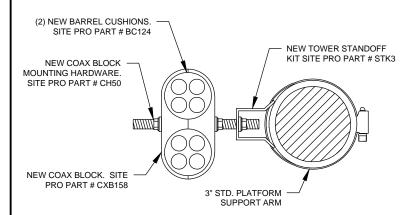

RF JUMPER MOUNTING DETAIL 5

SCALE: N.T.S.



# **Large Battery 3 Cabinet**

## **Product Features**

Compact design for battery strings:

- · Direct air cooling solution
- Supports four strings of -48V VRLA batteries up to 210Ah
- 600A rated bus bar with 200A breaker per string
- · Bulk Input / Output with ability to daisy chain cabinets
- · Front to Front Air Flow
- · Corrosion resistant aluminum construction
- · Powder coated high gloss finish
- Designed to meet GR-487





# **Specifications**

Aluminium enclosure  30 x 72 x 35 in. (381 x 1829x 889mm), Depth with Door: 41.2 in. (1047mm)  ~540 lbs (~245kg) (without batteries) 4 battery trays to support up to 4 strings 210Ah batteries Pad-mount, plinth option Polyester Power Paint (Tan) UL Listed , IEC / EN 60950  -40°C to +50°C (-40°F to +122°F) with solar load IP55 designed to GR-487 65dBA 95%, non-condensing (Max.)  Direct Air Cooling Forced air heating (1) 1000W AC heaters		
30 x 72 x 35 in. (381 x 1829x 889mm), Depth with Door: 41.2 in. (1047mm) ~540 lbs (~245kg) (without batteries) 4 battery trays to support up to 4 strings 210Ah batteries Pad-mount, plinth option Polyester Power Paint (Tan) UL Listed , IEC / EN 60950  -40°C to +50°C (-40°F to +122°F) with solar load IP55 designed to GR-487 65dBA 95%, non-condensing (Max.) Direct Air Cooling		
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65dBA 95%, non-condensing (Max.) Direct Air Cooling		
Direct Air Cooling		
Direct Air Cooling		
Direct Air Cooling		
And the state of t		
Total an including (1) Total The includes		
Knock-out plate on each upper side wall		
Additional knockouts each side		
3 point latching, 5/16 nut driver tool, pad-locking capability		
10 double-hole ¼"-20 threaded holes on 5/8" center ground bar		
4 Lifting Tabs		
Optional 6" plinth available		
AC Load Center:		
30A heater breaker		
Left or Right side AC entry options		
AC Surge Protection (option)		
DC Load Center:		
600A bulk feed bus bar		
(4) 200A bolt in battery breakers		
(4) 2-hole lug landings,(2 output/2 input from second battery cabine		
Temp Probes		
Battery Trays:		
(4) battery trays		
(4) -48V battery strings (210Ah max each)		
Connection kit:		
(1) DC 10A Breaker supplied (install onto HPL3 Power Cabinet)		
LED interior cabinet light		
(2) DC powered Axial fans with (1) F5 Filters		
Door intrusion alarm		
(1) 1000W AC powered heaters		
ESOF015-ECV04 Large Battery 3 (LB3) Cabinet		
37993318816900-S Plinth for V1/V2, HPL2, HPL3, LB2 and LB3		
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Delta Group Website: www.deltaww.com

www.deltapowersolutions.com United States of America & Canada: Delta Electronics (USA) Inc. 2925 E. Plano Parkway Plano, TX (Texas) 75074

> DEUSTPS.Sales@deltaww.com DEUSTPS.Orders@deltaww.com

1-877-DELTA-08 option 3 (877-335-8208 option 3) DEUSTPS.Support@deltaww.com

DEUSTPS.Services@deltaww.com

DEUSTPS.RMA@deltaww.com

Product Website:

Sales and Orders:

Field Support:

Installation Services:

\*All specifications are subject to change without prior notice.

www.deltaww.com



LARGE BATTERY 3 CABINET MANUFACTURER DETAIL - FOR REFERENCE ONLY

SCALE: N.T.S.

LARGE BATTERY 3 **CABINET** MANUFACTURER DETAIL

SHEET NUMBER:

C-503



# **HP-Large 3 Power Cabinet**

## **Product Features**

Compact design for equipment, power and battery:

- · 30RU supports 3 radios and transport equipment
- 600A @ -48V power system
- · Slimline high efficiency rectifier
- · ORION Touch screen Controller
- Rear Access Hatch

Direct air cooling solution, 6000W capacity, 5°C delta T Easy slide-in filter replacement for Merv-13 or Gore filter connects with:

- · SB3, 2-string battery cabinet
- LB3, 4-string battery cabinet
- V2, Expansion equipment and battery cabinet

Designed to GR-487 specifications

www.deltaww.com





## **Specifications**

Model	HP-Large 3 Power Cabinet		
1. General			
Construction	Aluminum enclosure		
Dimensions (Wx Hx D)	30 x 72 x 36 in. (762 x 1829 x 914 nm), Depth with door: 43 in. (1092 mm)		
Weight	~551 lbs (~270kg) (without customer equipment or batteries)		
Internal rack dimension	Total Equipment space, 30RU: Horizontal rack: 19" x 27RU Vertical rack: 19" x 3RU		
	Power System space: 23" x 12RU		
Mounting options	Pad-mount, plinth option		
Finish	Polyester Powder Paint (Tan)		
Safety	UL Listed , IEC / EN 60950		

Z. Environment	
Operating temperature	-40°C to +50°C ( -40°F to +122°F) with solar load. IP55
Protection class	designed to GR-487
Acoustics	5°C delta T: 70 dBA @ 6000W, 65dBA @5000W heat load
Humidity (relative)	95%,non-condensing (Max.)

3. Thermal management					
Cooling	Equipment:	Direct Air Cooling, 6000W capacity, 5°C delta T (6) centrifugal redundant fans, (3) Merv-13 or optional GORE filters front door (3) Merv-13 f Rear hatch			

Heating Equipment: Forcedair heating	$\frac{1}{2}$	) 1000W	AC	near
--------------------------------------	---------------	---------	----	------

4. Equipment		
	Knock-out plate on	each upper side wall
Cable Entry	Additional knockout	s each side
	(1) 3" conduit hole	with hole plug
Door latch	3 point latching, 5/1	6 nut driver tool, pad-locking capability
Primary ground	The second secon	20 threaded holes on 5/8" center ground bar
Lifting Ears	4 Lifting Tabs	
Standard equipment	AC Load Center: 24	0V split phase, dual feed / (1) 200A + (1)100A
	20	8V 3-phase, single feed / (1) 200A
	AC Surge Protection	for each breaker feed
	GFCI Receptacle 12	20V
	(6 form-C) Alarm Te	ermination block
	(1) Thermal Probe	
	605A/ 54V (336kVV)	redundant Power System with DIN rail distribution:
		ns (3x55A DPR3000 rectifiers included)
		(2x10A, 3x50A, and 6x100A load breakers included)
	16 poles for batte (2) SB350 genera	
	(Z) SB350 genera LVD over-ride sw	
	(2) SB175 Battery	
	(2) SB350 Battery	
Fron	Door: (6) DC powered	centrifugal fans with (3) MERV-13 filters, (GORE option)
		larm pressure switch
	Door intrusion	- Control of the Cont
	(2) 1000W AC p	owered heaters
	LED interior cab	
Rear	Hatch: Exhaust vent will	
5. Ordering information		
Cabinet	ESOA600-HCU01	HP-Large 3 600A Power / Equipment Cabinet
Rectifier	ESR-48/60A A-T	48V / 56A 3000W, 96.4%, CAN communication
Controller (Spare)	TPS1020028AU17	Orion TOUCH Controller
Plinth, 6"	37993318816900-S	Plinth for V1/V2, HPL2, HPL3, LB2 and LB3 cabine

Delta Group Website: www.deltaww.com Product Website: www.deltapowersolutions.com United States of America & Canada: Delta Electronics U.S. Inc. 2925 E. Plano Parkway Plano, TX (Texas) 75074 Sales and Support: Sales: DEUSTPS.Sales@deltaww.com Orders: DEUSTPS.Orders@deltaww.com Field Support: 1-877-DELTA-08 option 3 (877-335-8208 option 3) DEUSTPS.Support@deltaww.com Installation Services: DEUSTPS.Services@deltaww.com DEUSTPS.RMA@deltaww.com



Front Door and Rear Hatch Open

\*All specifications are subject to change without prior notice.



HP-LARGE 3 POWER CABINET MANUFACTURER DETAIL - FOR REFERENCE ONLY


SCALE: N.T.S.

HP-LARGE 3 POWER
CABINET
MANUFACTURER DETAIL

SHEET NUMBER:

C-504


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- THIS DETAIL IS INTENDED TO SHOW THE GENERAL GROUNDING REQUIREMENTS. SLIGHT ADJUSTMENTS MAY BE REQUIRED BASED ON EXISTING SITE CONDITIONS. THE CONTRACTOR SHALL MAKE FIELD ADJUSTMENTS AS NEEDED AND INFORM THE CONSTRUCTION MANAGER OF ANY CONFLICTS.
- SITE GROUNDING SHALL COMPLY WITH T-MOBILE GROUNDING STANDARDS, LATEST EDITION, AND COMPLY WITH T-MOBILE GROUNDING CHECKLIST, LATEST VERSION. WHEN NATIONAL AND LOCAL GROUNDING CODES ARE MORE STRINGENT THEY SHALL GOVERN.

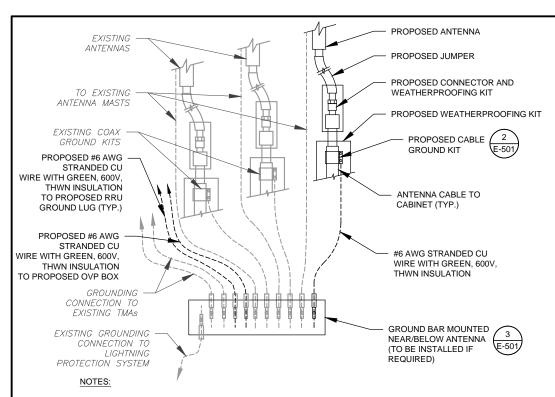

SCALE: N.T.S.



### GROUND KIT NOTES:

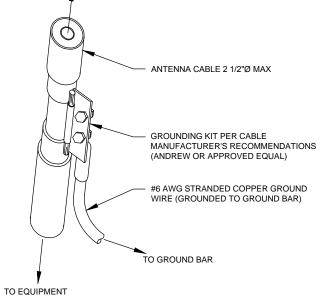
 DO NOT INSTALL CABLE GROUND KIT AT A BEND AND ALWAYS DIRECT GROUND WIRE DOWN TO GROUND BAR.

TO ANTENNA

 CONTRACTOR SHALL PROVIDE WEATHERPROOFING KIT (ANDREW PART NUMBER 221213) AND INSTALL/TAPE PER MANUFACTURER'S SPECIFICATIONS.

2 CABLE GROUND KIT CONNECTION DETAIL

SCALE: N.T.S.

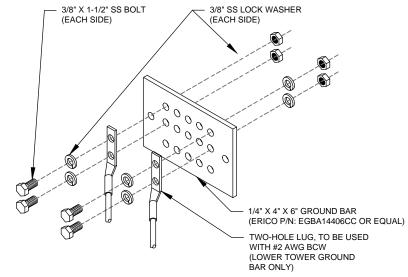

#### **GROUND BAR NOTES:**

- GROUND BAR KITS COME WITH ALL HARDWARE, NUTS, BOLTS, WASHERS, ETC. EXCEPT THE STRUCTURAL MOUNTING MEMBER(S).
- 2. GROUND BAR TO BE BONDED DIRECTLY TO TOWER.







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F	REV.	DESCRIPTION	BY	DATE
1	A.	PRELIM	HEG	03/17/202
	◬.	FINAL CD	<u>HEG</u>	08/12/202
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1,	$\wedge$			
	$\Delta$			
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ATC SITE NUMBER: 306035

UNITY VILLAGE MO 2

T-MOBILE SITE NAME:

ATC 306035 - I-470 & 50 HWY

SITE ADDRESS: 2150 NORTHWEST LOWENSTEIN, LEE'S SUMMIT. MO 64081-1905.

SEAL



# T · · Mobile ·

	DATE DRAWN:	08/12/2021
	ATC JOB NO:	13616192
	CUSTOMER ID:	ATC 306035 - I-470 & 50 HWY
	CUSTOMER #:	A5C0133A

## **GROUNDING DETAILS**

SHEET NUMBER:


E-501

REVISION:

ELECTRICAL NOTES:

- I. IT IS THE RESPONSIBILITY OF THE CONTRACTOR TO COORDINATE WITH THE T-MOBILE REPRESENTATIVE AND LOCAL UTILITY COMPANY FOR THE INSTALLATION OF CONDUITS, CONDUCTORS, BREAKERS, DISCONNECTS, OR ANY OTHER EQUIPMENT REQUIRED FOR ELECTRICAL SERVICE. ALL ELECTRICAL WORK SHALL BE PERFORMED IN ACCORDANCE WITH LATEST EDITION OF THE STATE AND NATIONAL CODES, ORDINANCES AND REGULATIONS APPLICABLE TO THIS PROJECT.
- 2. ATC HAS NOT VERIFIED ANY EXISTING T-MOBILE GROUND EQUIPMENT OR ELECTRICAL LOADING. PROPOSED WORK BASED ON INSTALLATION CONFIGURATION PROVIDED BY T-MOBILE. CONTRACTOR TO VERIFY EXISTING T-MOBILE PANEL HAS SUFFICIENT SPACE FOR PROPOSED BREAKER. PROPOSED CABLE AND CONDUIT SHALL BE MINIMUM SIZE PER BELOW IN CHART.
- 3. FOR SPECIFIC CABINET / ANCILLARY EQUIPMENT WIRING REQUIREMENTS, THE T-MOBILE CONTRACTOR SHOULD REFERENCE DESIGN DOCUMENTS PROVIDED BY T-MOBILE FOR THIS CURRENT PROJECT CONFIGURATION, IN ACCORDANCE WITH LOCAL JURISDICTION REQUIREMENTS & NEC STANDARDS & PRACTICES.

OCPD SIZE	WIRE SIZE	GROUND SIZE	CONDUIT SIZE
80A/2P	2#3 AWG	#8 AWG	1-1/4"
100/2P	2#2 AWG	#8 AWG	1-1/4"
125A/2P	2#1 AWG	#8 AWG	1-1/2"
150A/2P	2#1/0 AWG	#8 AWG	1-1/2"

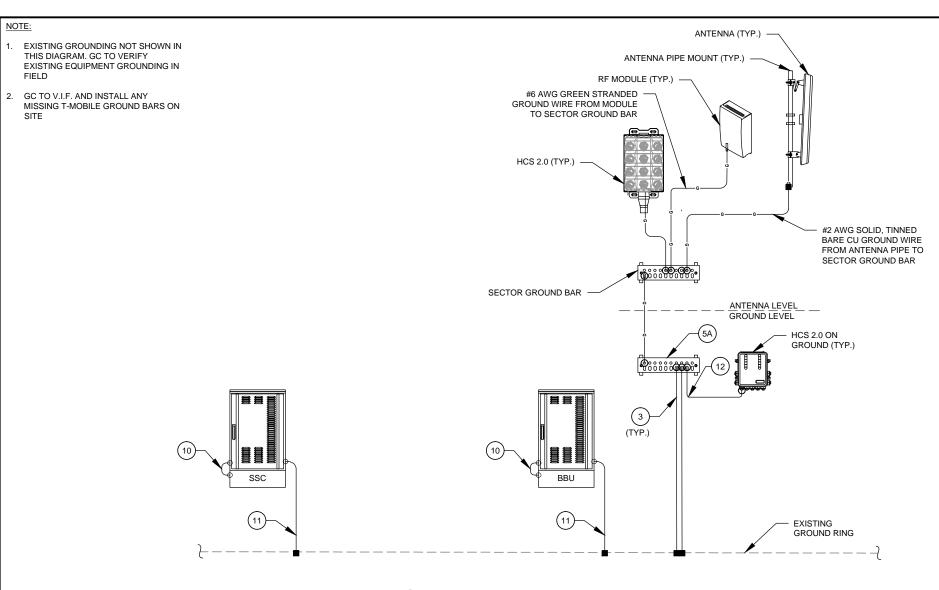


EQUIPMENT POWER, TELCO AND GROUNDING DIAGRAM

SCALE: N.T.S.

## **KEY NOTES:**

- #2 SOLID, TINNED BARE COPPER GROUND WIRE FROM ICE BRIDGE TO ICE BRIDGE POST.
- #2 SOLID, TINNED BARE COPPER GROUND WIRE, BOND ICE BRIDGE POST W/ VS TYPE CADWELD. (1 PER POST REQUIRED).
- (3) #2 SOLID, TINNED BARE COPPER GROUND WIRE FROM GROUND BAR TO GROUND RING (2 REQUIRED).
- #2 SOLID, TINNED BARE COPPER GROUND WIRE FROM NEW POST TO EXISTING GROUND RING
- 5 NEW GROUND BAR
- (5A) EXISTING GROUND BAR
- #6 AWG GREEN STRANDED GROUND CU WIRE FROM NEW MODULES TO PLINTH
- #2 AWG SOLID TINNED BARE GROUND CU WIRE FROM STEEL CUBE W/ MODULES TO GROUND RING
- 7A #2 AWG SOLID TINNED BARE GROUND CU WIRE FROM MODULES PLINTH TO GROUND RING
- 8 #6 AWG GREEN STRANDED GROUND CU WIRE FROM MODULES TO PLINTH
- 9 #2 AWG SOLID TINNED BARE GROUND CU WIRE FROM MODULE'S PLINTH TO GROUND RING

- #6 AWG GREEN STRANDED GROUND CU WIRE FROM SSC TO SSC PLINTH
- #2 AWG SOLID TINNED BARE GROUND CU WIRE FROM SSC TO GROUND RING
- #2 AWG GREEN STRANDED CU GROUND WIRE FROM NEW COVP TO GROUND BAR
- #2 AWG GREEN STRANDED CU GROUND WIRE FROM NEW ALARM BOX TO GROUND BAR
- 46 AWG GREEN STRANDED CU GROUND WIRE FROM NEW HYBRID CABLE TO GROUND BAR
- #2 AWG GREEN STRANDED GROUND WIRE FROM NEW RF MODULE TO GROUND BAR
- #2 AWG SOLID, TINNED BARE CU GROUND WIRE FROM NEW GROUND BAR TO EXISTING GROUND RING/ROD
- #2 AWG SOLID, TINNED BARE CU GROUND WIRE FROM FCOA CABINET TO EXISTING GROUND RING/BAR
- #6 AWG SOLID, TINNED BARE CU GROUND WIRE FROM NEW DIPLEXER/TRIPLEXER TO EXISTING GROUND BAR
- #2 AWG SOLID TINNED BARE GROUND CU WIRE FROM BATTERY CABINET TO GROUND RING

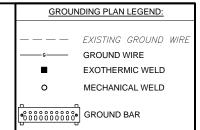





49030 Pontiac Trail, Suite 400 Wixom, Michigan 48393 PHONE: (248) 705-9212

DESCRIPTION	BY DATE
PRELIM	HEG 03/17/2021
FINAL CD	HEG 08/12/2021
	PRELIM

ATC SITE NUMBER: 306035

ATC SITE NAME:

UNITY VILLAGE MO 2
T-MOBILE SITE NAME:

ATC 306035 - I-470 & 50

HWY

SITE ADDRESS: 2150 NORTHWEST LOWENSTEIN, LEE'S SUMMIT, MO 64081-1905.

SEAL:



# T··Mobile


I	DATE DRAWN:	08/12/2021
I	ATC JOB NO:	13616192
I	CUSTOMER ID:	ATC 306035 - I-470 & 50 HWY
I	CUSTOMER #:	A5C0133A

# ELECTRICAL ONE-LINE DIAGRAM

SHEET NUMBER:

REVISION:

E-601

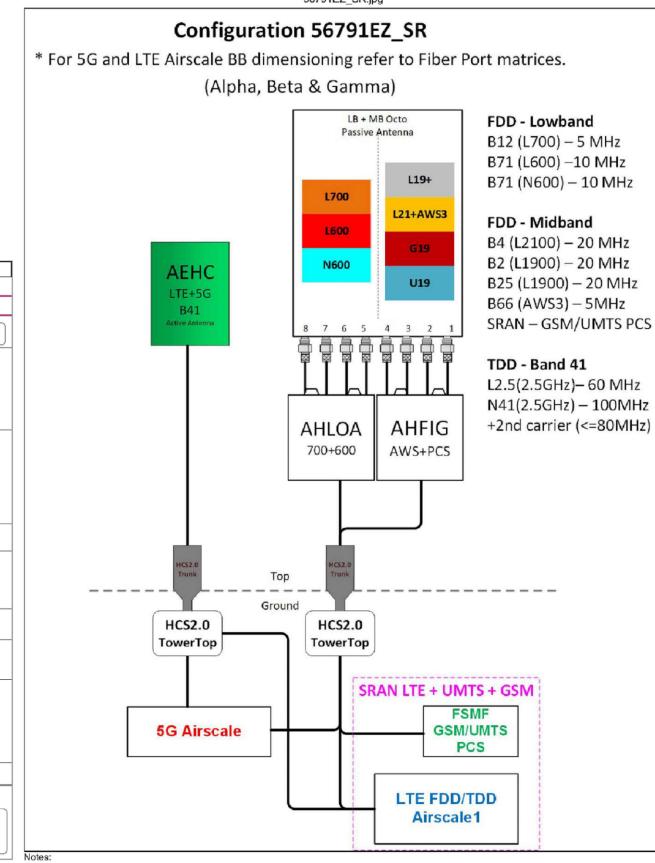

	Template: 56791EZ_SR					
Enclosure	1	2	3	4		
Enclosure Type	Generic 600A Site Support Cabinet	Tower Top Mount (Nokia)	(Ancillary Equipment (Nokia)	Generic Battery Cabinet for 600A SSC		
Baseband	ASIA (L2100) (L1900) (L700) (L700) (L400)					
Baseband Submodule	ABIA (x 2) L2100 L1900 LAWS3  ABIL (x 3) N2500  ABIL N600  ABIL N600					
Baseband Subrack	(AMIA (x 2))					
Hybrid Cable System	Voltage Booster needed if hybrid under 250'  Extra Booster Amplifier needed if hybrid under 250'		Nokia HCS 2.0 Trunk *Select Length* (x 2)			
Junction Box			Nokia HCS 2.0 Tower Junction Box (x 2)			
Power subsystem	Rectifier Shelf *Select size*  Breakers *Select size*			Batteries *Select size*		
Radio		AHLOA (x 3)  L700  L600  N600  L900  LAWS3  U1900  G1900				
Transport System	CSR IXRe V2 (Gen2)					

Proposed RAN Equipment

RAN Scope of Work:

Anchor Upgrade: Current on air is L2100/LAWS3, L1900/U1900/GSM, and L700//L600/N600

Install (2) HCS 2.0 Hybrid Trunk Cables with Breakout Feature Install (2) HCS 2.0 Junction Boxes at the BTS: Raycap RTMDC-5634-PF-48

**CABINET CONFIGURATION** 


ANTENNA CONFIGURATION

NOTE: THIS SHEET CREATED BY OTHERS AND PROVIDED BY REQUEST OF CUSTOMER WITHOUT EDIT.

**SUPPLEMENTAL** 

SHEET NUMBER: REVISION:

R-601

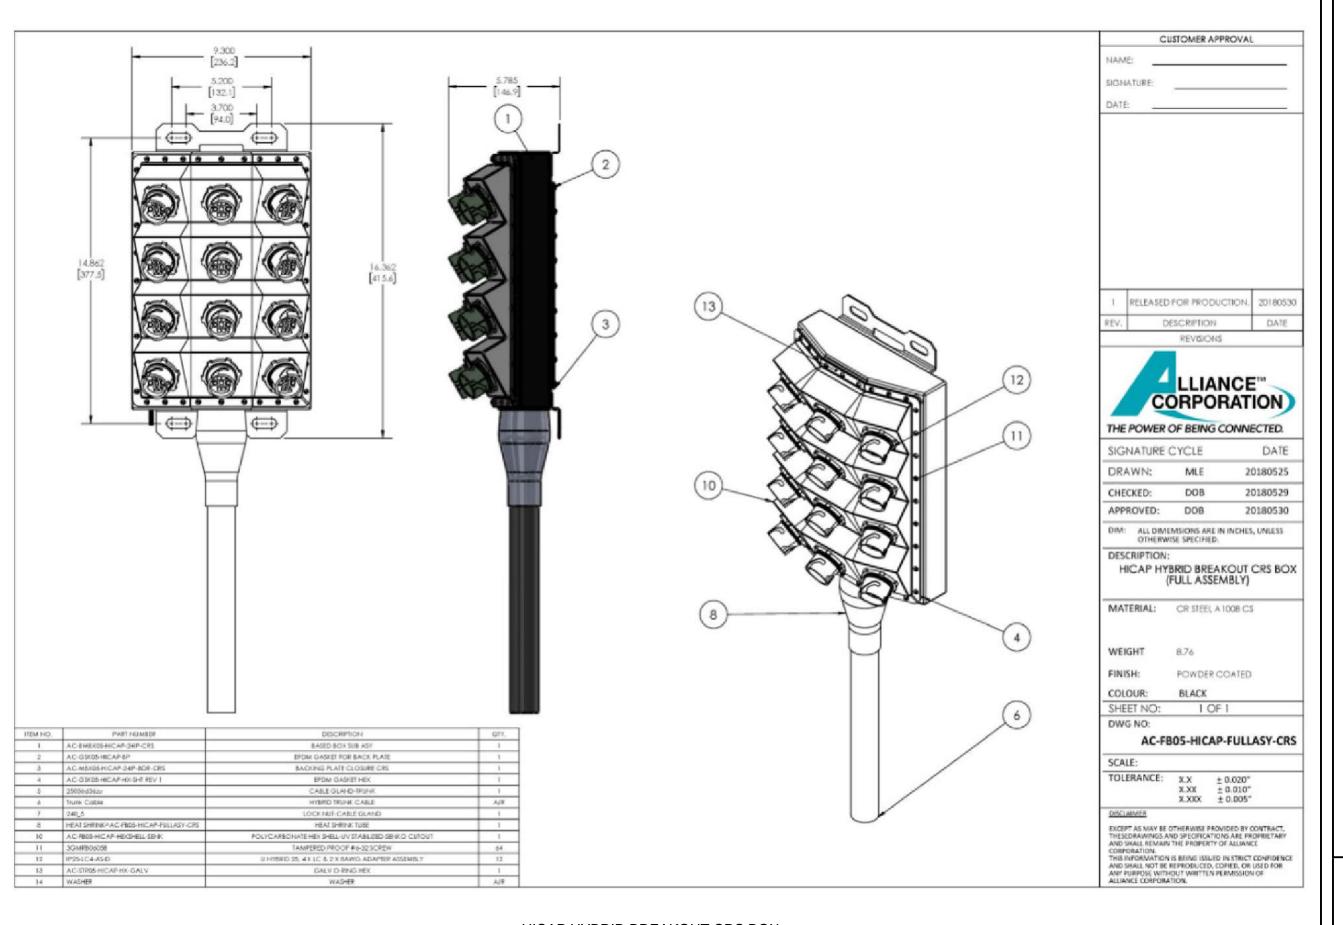

**SUPPLEMENTAL** 


SHEET NUMBER:

REVISION:

R-602

NOTE: THIS SHEET CREATED BY OTHERS AND PROVIDED BY REQUEST OF CUSTOMER WITHOUT EDIT.

MECHANICAL	JACKET COLOR	BLACK
	OUTER DIAMETER (IN)	1.46
	MIN BENDING RADIUS(IN), MULTIPLE BENDS, LOADED	29.2
	MIN BENDING RADIUS(IN), MULTIPLE BENDS, UNLOADED	14.6
	MIN BENDING RADIUS(IN), SINGLE BEND, UNLOADED	10.22
	MIN BENDING RADIUS(IN), FURCATION	1.2
	ARMOR	CORRUGATED COPPER
	WEIGHT(Ib/kft)	1610
	COMPRESSION(Ib/IN)	250
	TENSILE LOAD, LONG TERM(Ibf)	180
	TENSILE LOAD, SHORT TERM(Ibf)	600
ELECTRICAL	CONDUCTOR MATERIAL	COPPER
	CONDUCTOR CONSTRUCTION	STRAND
	CONDUCTOR COLOR	BLUE/BLACK
	RESISTIVITY(nΩ @20°C)	16.78 nohm-M
	CONDUCTORS, QTY	12
	CONDUCTOR SIZE(AWG)	6
	EMI SHIELD	YES
	UL RATING	ULTC-OF-ER
OPTICAL	FIBER TYPE	SINGLE MODE (G.657.A2)
	FIBERS, QTY	48
	ATTENUATION(dB/km), MAX, 1550/1285-1330 nm	0.5
	DISPERSION, MAX, 1550/1285-1330 nm	18 ps/3.5 ps
	RETURN LOSS(dB)	>50
	INSERTION LOSS(dB), POST ENVIRONMENTAL	REDUCTION < 0.65
	RETURN LOSS(dB), POST ENVIRONMENTAL	REDUCTION < 5
	CUTOFF WAVELENGTH(nm)	1260
	PIGTAIL TERMINATION	LC PAIR, STRAIGHT
ENVIRON	OPERATING TEMP("F)	-40 TO +167
	STORAGE TEMP("F)	-40 TO +167
	UV	IEC 60068-2-5
	THERMAL CYCLE	IEC 60068-2-14
	VIBRATION	IEC 60068-2-64
	IMPACT(ft lb)	4.4 NM PER ICEA696

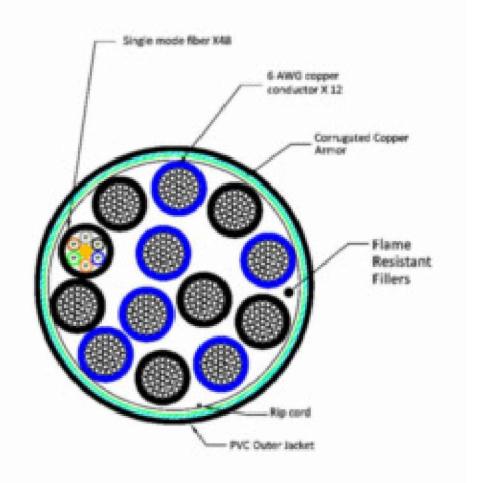

NOTE: CABLE CROSS-SECTION NOT DRAWN TO SCALE

SUPPLEMENTAL

SHEET NUMBER:

REVISION:

R-603





SITE NAME: UNITY VILLAGE MO 2

SITE NUMBER: 306035

ATC PROJECT NUMBER: 13616192\_C9\_05

SITE ADDRESS: 2150 NW LOWENSTEIN

LEES SUMMIT, MO 64081



**LOCATION MAP** 

# MOUNT REINFORCEMENT DRAWINGS PREPARED FOR T-MOBILE

PROJECT TEAM	PROJECT DESCRIPTION	SHEET	SHEET TITLE	RI
		G-002	IBC GENERAL NOTES AND MOUNT MODIFICATION INSPECTION	
TOWER OWNER	THE PROJECT DEPICTED IN THESE PLANS ARE BASED ON THE RECOMMENDATIONS OUTLINED IN THE STRUCTURAL ANALYSIS COMPLETED	S-101	MODIFICATION PROFILE	
AMERICAN TOWER	UNDER ENGINEERING PROJECT NUMBER 13616192_C8_01 DATED 06/28/21. SATISFACTORY COMPLETION OF THE WORK INDICATED IN THESE PLANS WILL	S-102	SAFETY CLIMB LAYOUT	
10 PRESIDENTAL WAY	RESULT IN THE STRUCTURE MEETING THE REQUIREMENTS OF THE SPECIFICATIONS UNDER WHICH THE STRUCTURAL WAS COMPLETED.	R-601	SUPPLEMENTAL	
WOBURN, MA 01801	5. 25. 16. 11. 16. 16. 17. 17. 17. 17. 17. 17. 17. 17. 17. 17	R-602	SUPPLEMENTAL	
	PROJECT NOTE	R-901	SUPPLEMENTAL	
ENGINEERED BY		R-902	SUPPLEMENTAL	
ATC TOWER SERVICES	THE PROJECT DEPICTED IN THESE PLANS QUALIFIES AS AN ELIGIBLE FACILITIES REQUEST ENTITLED TO EXPEDITED REVIEW UNDER 47 U.S.C.	R-903	SUPPLEMENTAL	
3500 REGENCY PARKWAY, SUITE 100	§ 1455(A) AS A MODIFICATION OF AN EXISTING WIRELESS TOWER THAT INVOLVES THE COLLOCATION, REMOVAL, AND/OR REPLACEMENT OF			
CARY, NC 27518	TRANSMISSION EQUIPMENT THAT IS NOT A SUBSTANTIAL CHANGE UNDER CFR § 1.6100 (B)(7).			
CARRIER INFORMATION	COMPLIANCE CODE			
CARRIER: T-MOBILE  CARRIER SITE NAME: ATC 306035 - I-470 & 50 HWY  CARRIER SITE NUMBER: A5C0133A	ALL WORK SHALL BE PERFORMED AND MATERIALS INSTALLED IN ACCORDANCE WITH THE CURRENT EDITIONS OF THE FOLLOWING CODES AS ADOPTED BY THE LOCAL GOVERNMENT AUTHORITIES. NOTHING IN THESE PLANS IS TO BE CONSTRUED TO PERMIT WORK NOT CONFORMING TO THESE CODES.			
<b>811</b> .	ANSI/TIA/EIA: STRUCTURAL STANDARDS (222-H EDITION)     INTERNATIONAL BUILDING CODE (2009 IBC)			
	PROJECT LOCATION			
Know what's below.	GEOGRAPHIC COORDINATES			
Call before you dig.	LATITUDE: 38.93361269			
	LONGITUDE: -94.41749129			

# AMERICAN TOWER®

ATC TOWER SERVICES 3500 REGENCY PARKWAY SUITE 100 CARY, NC 27518 PHONE: (919) 468-0112

COA: 2015011232

THESE DRAWINGS AND/OR THE ACCOMPANYING SPECIFICATION AS INSTRUMENTS OR SERVICE ARE THE EXCLUSIVE PROPERTY OF AMERICAN TOWER. THEIR USE AND PUBLICATION SHALL BE RESTRICTED TO THE ORIGINAL SITE FOR WHICH THEY ARE PREPARED. ANY USE OR DISCLOSURE OTHER THAN THAT WHICH RELATES TO AMERICAN TOWER OR THE SPECIFIED CARRIER IS STRICTLY PROHIBITED. TITLE TO THESE DOCUMENTS SHALL REMAIN THE PROPERTY OF AMERICAN TOWER WHETHER OR NOT THE PROJECT IS EXECUTED. NEITHER THE ARCHITECT NOR THE ENGINEER WILL BE PROVIDING ON-SITE CONSTRUCTION REVIEW OF THIS PROJECT. CONTRACTOR(S) MUST VERIFY ALL DIMENSIONS AND ADVISE AMERICAN TOWER OF ANY DISCREPANCIES. ANY PRIOR ISSUANCE OF THIS DRAWING IS SUPERSEDED BY THE LATEST VERSION ON FILE WITH AMERICAN TOWER.

REV	. DESCRIPTION	BY	DATE
◬	FIRST ISSUE	RJS	07/30/21
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ATC SITE NUMBER:


306035

ATC SITE NAME:

UNITY VILLAGE MO 2

MISSOURI

SITE ADDRESS: 2150 NW LOWENSTEIN LEES SUMMIT, MO 64081

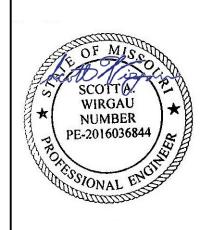

DRAWN BY:	RJS
APPROVED BY:	MFE
DATE DRAWN:	07/30/21
ATC JOB NO:	13616192_C9_05

COVER

SHEET NUMBER:


G-001

#### **GENERAL**

- ALL WORK TO BE COMPLETED PER APPLICABLE LOCAL STATE FEDERAL CODES AND ORDINANCES AND COMPLY WITH ATC CONSTRUCTION SPECIFICATIONS FOR WIRELESS TOWER SITES. THE CONTRACTOR IS RESPONSIBLE FOR OBTAINING AND ABIDING BY ALL REQUIRED PERMITS
- ALL WORK INDICATED ON THESE DRAWINGS SHALL BE PERFORMED BY QUALIFIED CONTRACTORS EXPERIENCED IN TOWER AND FOUNDATION CONSTRUCTION
- 3. THE CONTRACTOR SHALL NOTIFY THE ENGINEER OF RECORD IMMEDIATELY OF ANY INSTALLATION INTERFERENCES. ALL NEW WORK SHALL ACCOMMODATE EXISTING CONDITIONS DETAILS NOT SPECIFICALLY SHOWN ON THE DRAWINGS SHALL FOLLOW SIMILAR DETAILS FOR THIS JOB.
- ANY SUBSTITUTIONS SHALL CONFORM TO THE REQUIREMENTS OF THESE NOTES AND SPECIFICATIONS, AND SHOULD BE SIMILAR TO THOSE SHOWN. ALL SUBSTITUTIONS SHALL BE SUBMITTED TO THE ENGINEER OF RECORD FOR REVIEW AND APPROVAL PRIOR TO FABRICATION
- ANY MANUFACTURED DESIGN ELEMENTS SHALL CONFORM TO THE REQUIREMENTS OF THESE NOTES AND SPECIFICATIONS AND SHOULD BE SIMILAR TO THOSE SHOWN. THESE DESIGN ELEMENTS MUST BE STAMPED BY AN ENGINEER PROFESSIONALLY REGISTERED IN THE STATE OF THE PROJECT, AND SUBMITTED TO THE ENGINEER OF RECORD FOR APPROVAL PRIOR TO FABRICATION.
- 6. ALL WORK SHALL BE DONE IN ACCORDANCE WITH LOCAL CODES AND OSHA SAFETY REGULATIONS.
- THE CONTRACTOR IS RESPONSIBLE FOR THE DESIGN AND EXECUTION OF ALL MISCELLANEOUS SHORING, BRACING, TEMPORARY SUPPORTS, ETC. NECESSARY, PER ANSI/TIA-322 AND ANSI/ASSE A10.48. TO PROVIDE A COMPLETE AND STABLE STRUCTURE AS SHOWN ON THESE DRAWINGS.
- CONTRACTOR'S PROPOSED INSTALLATION SHALL NOT INTERFERE, NOR DENY ACCESS TO, ANY EXISTING OPERATIONAL AND SAFETY EQUIPMENT.

#### STRUCTURAL STEEL

- ALL DETAILING, FABRICATION AND ERECTION OF STRUCTURAL STEEL SHALL CONFORM TO THE AISC SPECIFICATIONS LATEST EDITION
- 2. ALL EXPOSED STRUCTURAL STEEL MEMBERS SHALL BE HOT-DIPPED GALVANIZED AFTER FABRICATION PER ASTM A123. EXPOSED STEEL HARDWARE AND ANCHOR BOLTS SHALL BE GALVANIZED PER ASTM A153 OR B695.
- ALL U-BOLTS SHALL BE ASTM A36 OR EQUIVALENT, WITH LOCKING DEVICE, UNLESS NOTED OTHERWISE
- 4. FIELD CUT EDGES, EXCEPT DRILLED HOLES, SHALL BE GROUND SMOOTH.
- ALL FIELD CUT SURFACES, FIELD DRILLED HOLES & GROUND SURFACES WHERE EXISTING PAINT OR GALVANIZATION REMOVAL WAS REQUIRED SHALL BE REPAIRED WITH (2) BRUSHED COATS OF ZRC GALVILITE COLD GALVANIZING COMPOUND PER ASTM A780 AND MANUFACTURERS RECOMMENDATIONS.
- ALL STRUCTURAL STEEL EMBEDDED IN THE CONCRETE SHALL BE APPLIED WITH (2) BRUSHED COATS OF POLYGUARD CA-14 MASTIC OR FOLIVALENT. REFER TO THE MANUFACTURER SPECIFICATIONS FOR SURFACE PREPARATION AND APPLICATION. APPLICATION OF POLYGUARD 400 WRAP IS NOT ESSENTIAL
- CONTRACTOR SHALL PERFORM WORK ON ONLY ONE (1) TOWER FACE AND REPLACE/REINFORCE ONE (1) BOLT/MEMBER AT A TIME
- 8. ALL FIELD DRILLED HOLES TO BE USED FOR FIELD BOLTING INSTALLATION SHALL BE STANDARD HOLES, AS DEFINED BY AISC, UNLESS NOTED OTHERWISE.

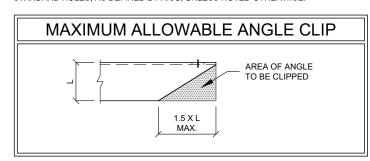

### **PAINT**

AS REQUIRED, CLEAN AND PAINT PROPOSED STEEL ACCORDING TO FAA ADVISORY CIRCULAR AC 70/7460-1L

#### WELDING

- 1. ALL WELDING TO BE PERFORMED BY AWS CERTIFIED WELDERS AND CONDUCTED IN ACCORDANCE WITH THE LATEST EDITION OF THE AWS WELDING CODE D1.1.
- 2. ALL WELDS SHALL BE INSPECTED VISUALLY. IF DIRECTED BY ENGINEER OF RECORD, 25% OF WELDS SHALL BE INSPECTED WITH DYE PENETRANT OR MAGNETIC PARTICLE (100% IF REJECTABLE DEFECTS ARE FOUND) TO MEET THE ACCEPTANCE CRITERIA OF AWS D1.1. REPAIR ALL WELDS AS NECESSARY.
- 3. INSPECTION SHALL BE PERFORMED BY AN AWS CERTIFIED WELD INSPECTOR.
- 4. ALL ELECTRODES TO BE LOW HYDROGEN, MATCHING FILLER AND/OR BASE METAL, PER AWS D1.1, UNLESS NOTED OTHERWISE
- 5. IN CASES WHERE BASE METAL GRADE IS UNKNOWN, ALL WELDING ON LATTICE TOWERS SHALL BE DONE WITH E70XX ELECTRODES; ALL WELDING ON POLE STRUCTURES SHALL BE DONE WITH E80XX FLECTRODES UNLESS NOTED OTHERWISE
- 6. PRIOR TO FIELD WELDING GALVANIZED MATERIAL, CONTRACTOR SHALL GRIND OFF GALVANIZING 1/2" BEYOND ALL FIELD WELD SURFACES. AFTER WELD AND WELD INSPECTION IS COMPLETE, REPAIR ALL GROUND AND WELDED SURFACES WITH ZRC GALVILITE COLD GALVANIZING COMPOUND PER ASTM A780 AND MANUFACTURERS RECOMMENDATIONS.

#### **BOLT TIGHTENING PROCEDURE**

- 1. STRUCTURAL CONNECTIONS TO BE ASSEMBLED AND INSPECTED IN ACCORDANCE WITH RCSC SPECIFICATIONS.
- 2 FLANGE BOLTS SHALL BE INSTALLED AND TIGHTENED USING DIRECT TENSION INDICATING (DTI) SQUIRTER WASHERS. DTI SQUIRTER WASHERS ARE TO BE INSTALLED AND ORIENTED / TIGHTENED PER MANUFACTURER SPECIFICATIONS TO ACHIEVE DESIRED LEVEL OF BOLT PRE-TENSION
- 3. IN LIEU OF USING DTI SQUIRTER WASHERS, FLANGE BOLTS MAY BE TIGHTENED USING AISC / RCSC "TURN-OF-THE-NUT" METHOD, PENDING APPROVAL BY THE ENGINEER OF RECORD (EOR). TIGHTEN FLANGE BOLTS USING THE CHART BELOW:

#### **BOLT LENGTHS UP TO AND INCLUDING FOUR DIAMETERS**

DOL	ENGING OF TO AND INCEODING FOOR DIAME	
1/2"	BOLTS UP TO AND INCLUDING 2.0 INCH LENGTH	+1/3 TURN BEYOND SNUG TIGHT
5/8"	BOLTS UP TO AND INCLUDING 2.5 INCH LENGTH	+1/3 TURN BEYOND SNUG TIGHT
3/4"	BOLTS UP TO AND INCLUDING 3.0 INCH LENGTH	+1/3 TURN BEYOND SNUG TIGHT
7/8"	BOLTS UP TO AND INCLUDING 3.5 INCH LENGTH	+1/3 TURN BEYOND SNUG TIGHT
1"	BOLTS UP TO AND INCLUDING 4.0 INCH LENGTH	+1/3 TURN BEYOND SNUG TIGHT
1-1/8"	BOLTS UP TO AND INCLUDING 4.5 INCH LENGTH	+1/3 TURN BEYOND SNUG TIGHT
1-1/4"	BOLTS UP TO AND INCLUDING 5.0 INCH LENGTH	+1/3 TURN BEYOND SNUG TIGHT
1-3/8"	BOLTS UP TO AND INCLUDING 5.5 INCH LENGTH	+1/3 TURN BEYOND SNUG TIGHT
1-1/2"	BOLTS UP TO AND INCLUDING 6.0 INCH LENGTH	+1/3 TURN BEYOND SNUG TIGHT

#### BOLT LENGTHS OVER FOUR DIAMETERS BUT NOT EXCEEDING EIGHT DIAMETERS

BULIL	ENGINS OVER FOUR DIAMETERS I	DUT NOT EXCEEDING EIGHT DIAMETER
1/2"	BOLTS 2.25 TO 4.0 INCH LENGTH	+1/2 TURN BEYOND SNUG TIGHT
5/8"	BOLTS 2.75 TO 5.0 INCH LENGTH	+1/2 TURN BEYOND SNUG TIGHT
3/4"	BOLTS 3.25 TO 6.0 INCH LENGTH	+1/2 TURN BEYOND SNUG TIGHT
7/8"	BOLTS 3.75 TO 7.0 INCH LENGTH	+1/2 TURN BEYOND SNUG TIGHT
1"	BOLTS 4.25 TO 8.0 INCH LENGTH	+1/2 TURN BEYOND SNUG TIGHT
1-1/8"	BOLTS 4.75 TO 9.0 INCH LENGTH	+1/2 TURN BEYOND SNUG TIGHT
1-1/4"	BOLTS 5.25 TO 10.0 INCH LENGTH	+1/2 TURN BEYOND SNUG TIGHT
1-3/8"	BOLTS 5.75 TO 11.0 INCH LENGTH	+1/2 TURN BEYOND SNUG TIGHT
1-1/2"	BOLTS 6.25 TO 12.0 INCH LENGTH	+1/2 TURN BEYOND SNUG TIGHT

### **BOLT TIGHTENING PROCEDURE (CONTINUED)**

SPLICE BOLTS SUBJECT TO DIRECT TENSION SHALL BE INSTALLED AND TIGHTENED AS PER SECTION 8.2.1 OF THE AISC "SPECIFICATION FOR STRUCTURAL JOINTS USING A325 OR A490 BOLTS", LOCATED IN THE AISC MANUAL OF STEEL CONSTRUCTION. THE INSTALLATION PROCEDURE IS PARAPHRASED AS FOLLOWS:

FASTENERS SHALL BE INSTALLED IN PROPERLY ALIGNED HOLES AND TIGHTENED BY ONE OF THE METHODS DESCRIBED IN SUBSECTION 8.2.1 THROUGH 8.2.4.

#### 8.2.1 TURN-OF-NUT PRETENSIONING

BOLTS SHALL BE INSTALLED IN ALL HOLES OF THE CONNECTION AND BROUGHT TO A SNUG TIGHT CONDITION AS DEFINED IN SECTION 8.1. UNTIL ALL THE BOLTS ARE SIMULTANEOUSLY SNUG TIGHT AND THE CONNECTION IS FULLY COMPACTED. FOLLOWING THIS INITIAL OPERATION ALL BOLTS IN THE CONNECTION SHALL BE TIGHTENED FURTHER BY THE APPLICABLE AMOUNT OF ROTATION SPECIFIED ABOVE DURING THE TIGHTENING OPERATION THERE SHALL BE NO ROTATION OF THE PART NOT TURNED BY THE WRENCH. TIGHTENING SHALL PROGRESS SYSTEMATICALLY.

ALL OTHER BOLTED CONNECTIONS SHALL BE BROUGHT TO A SNUG TIGHT CONDITION AS DEFINED IN SECTION 8.1 OF THE SPECIFICATION.

ALL BOLT HOLES SHALL BE ALIGNED TO PERMIT INSERTION OF THE BOLTS WITHOUT UNDUE DAMAGE TO THE THREADS. BOLTS SHALL BE PLACED IN ALL HOLES WITH WASHERS POSITIONED AS REQUIRED AND NUTS THREADED TO COMPLETE THE ASSEMBLY. COMPACTING THE JOINT TO THE SNUG-TIGHT CONDITION SHALL PROGRESS SYSTEMATICALLY FROM THE MOST RIGID PART OF THE JOINT. THE SNUG-TIGHTENED. CONDITION IS THE TIGHTNESS THAT IS ATTAINED WITH A FEW IMPACTS OF AN IMPACT WRENCH OR THE FULL EFFORT OF AN IRONWORKER USING AN ORDINARY SPUD WRENCH TO BRING THE CONNECTED PLIES INTO FIRM CONTACT.

# **AMERICAN TOWER**

**ATC TOWER SERVICES** 3500 REGENCY PARKWAY SUITE 100 **CARY, NC 27518** PHONE: (919) 468-0112

THESE DRAWINGS AND/OR THE ACCOMPANYING SPECIFICATION THESE DRAWINGS AND/OR THE ACCOMPANYING SPECIFICATION AS INSTRUMENTS OR SERVICE ARE THE EXCLUSIVE PROPERTY OF AMERICAN TOWER. THEIR USE AND PUBLICATION SHALL BE RESTRICTED TO THE ORIGINAL SITE FOR WHICH THEY ARE PREPARED. ANY USE OR DISCLOSURE OTHER THAN THAT WHICH STANDARD AND SERVICES OF THE STANDARD AND THE S RELATES TO AMERICAN TOWER OR THE SPECIFIED CARRIER IS STRICTLY PROHIBITED. TITLE TO THESE DOCUMENTS SHALL REMAIN THE PROPERTY OF AMERICAN TOWER WHETHER OR NO THE PROJECT IS EXECUTED, NEITHER THE ARCHITECT NOR THE ENGINEER WILL BE PROVIDING ON-SITE CONSTRUCTION REVIEW OF THIS PROJECT, CONTRACTOR(S) MUST VERIEY ALL DIMENSIONS AND ADVISE AMERICAN TOWER OF ANY DISCREPANCIES. ANY PRIOR ISSUANCE OF THIS DRAWING IS SUPERSEDED BY THE LATEST VERSION ON FILE WITH AMERICAN

L	REV.	DESCRIPTION	BY	DATE
ı	$\triangle_{-}$	FIRST ISSUE	RJS	07/30/21
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ATC SITE NUMBER:

306035

ATC SITE NAME:

**UNITY VILLAGE MO 2** 

**MISSOURI** 

SITE ADDRESS 2150 NW LOWENSTEIN LEES SUMMIT, MO 64081



DRAWN BY:	RJS
APPROVED BY:	MFE
DATE DRAWN:	07/30/21
ATC JOB NO:	13616192_C9_05

**IBC GENERAL NOTES** AND MOUNT MODIFICATION INSPECTION

REVISION

SHEET NUMBER:

G-002

## MODIFICATION INSPECTION NOTES

MMI - MOUNT MODIFICATION INSPECTION

GC - GENERAL CONTRACTOR ATC - AMERICAN TOWER CORPORATION

THE MOUNT MODIFICATION INSPECTION (MMI) PROCEDURE IS INTENDED TO CONFIRM THAT CONSTRUCTION AND INSTALLATION MEETS ENGINEERING DESIGN. ATC PROCEDURES AND ATC STANDARD SPECIFICATIONS FOR WIRELESS TOWER SITES.

TO ENSURE THAT THE REQUIREMENTS OF THE MMI ARE MET, IT IS VITAL THAT THE GENERAL CONTRACTOR SUBMIT ALL REQUIRED PHOTOGRAPHS AND DRAWINGS TO AMERICAN TOWER CORPORATION (ATC).


# **GENERAL CONTRACTOR**

THE GENERAL CONTRACTOR IS REQUIRED TO:


- REVIEW THE REQUIREMENTS OF THE MMI CHECKLIST.
- UNDERSTAND ALL INSPECTION REQUIREMENTS.


THE GENERAL CONTRACTOR SHALL PERFORM AND RECORD THE INSPECTION RESULTS IN ACCORDANCE WITH THE REQUIREMENTS OF THE MMI CHECKLIST.

	MOUNT MODIFICATION INSPECTION CHECKLIST				
INSPECTION DOCUMENT	INSPECTION TESTING REQUIRED	RESPONSIBILITY			
ON-SITE COLD GALVANIZING VERIFICATION	PHOTOGRAPHIC EVIDENCE OF COLD GALVANIZATION TYPE AND APPLICATION IN ALL APPLICABLE LOCATIONS TO BE INCLUDED WITHIN THE MMI REPORT	•	GC		
GC AS-BUILT DRAWINGS WITH CONSTRUCTION RED-LINES	"AS-BUILT" DRAWINGS INDICATING ANY APPROVED CHANGES TO ENGINEERED PLANS TO MMI FOR APPROVAL/REVIEW AND INCLUSION IN MMI REPORT	*	GC		
PHOTOGRAPHS	PHOTOGRAPHIC EVIDENCE OF MOUNT MODIFICATION INSPECTION, ON SITE REMEDIATION, AND ITEMS FAILING INSPECTION & REQUIRING FOLLOW UP TO BE INCLUDED WITHIN THE MMI REPORT. COMPLETE PHOTO LOG IS TO BE SUBMITTED WITHIN MMI REPORT.	*	GC		

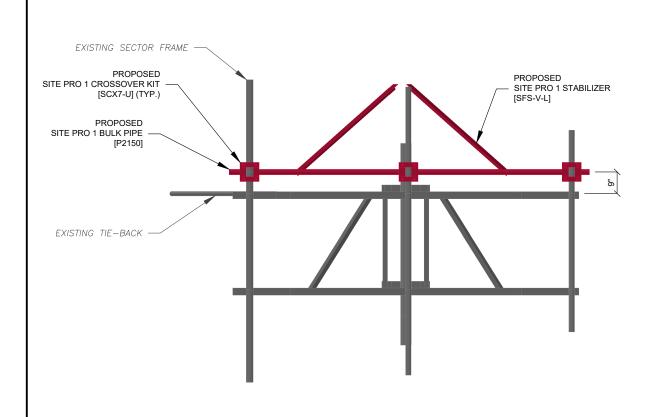


## TYPICAL MOUNT MODIFICATION FRONT VIEW

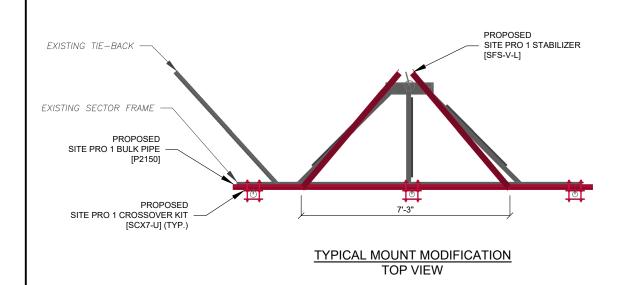

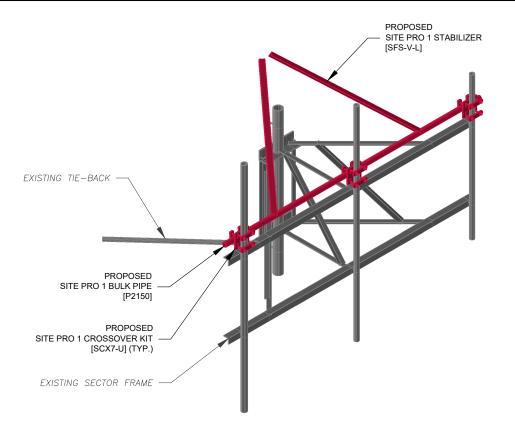

## TYPICAL MOUNT MODIFICATION ISOMETRIC VIEW

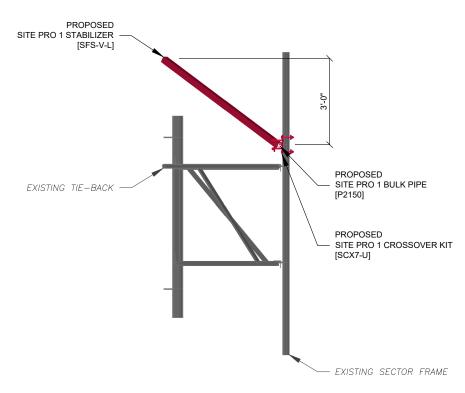

## TYPICAL MOUNT MODIFICATION SIDE VIEW

IN THE EVENT A PROPOSED MODIFICATION PART LISTED IN THE DRAWINGS IS NOT AVAILABLE, AN APPROVED EQUIVALENT CAN BE SUBSTITUTED. FOR APPROVAL OF EQUIVALENT PART OR QUESTIONS PLEASE CONTACT AMERICAN TOWER PMI INBOX AT PMI@AMERICANTOWER.COM.



ATC TOWER SERVICES 3500 REGENCY PARKWAY SUITE 100 CARY, NC 27518 PHONE: (919) 468-0112 COA: 2015011232

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REV.	DESCRIPTION	BY	DATE
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ATC SITE NUMBER:


306035

ATC SITE NAME:

**UNITY VILLAGE MO 2** 

MISSOURI

SITE ADDRESS: 2150 NW LOWENSTEIN LEES SUMMIT, MO 64081

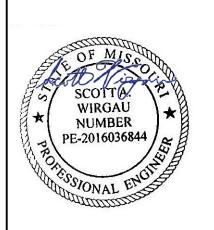

DRAWN BY:	RJS
APPROVED BY:	MFE
DATE DRAWN:	07/30/21
ATC JOB NO:	13616192_C9_05

## MODIFICATION PROFILE

SHEET NUMBER:

REVISION S-101

SAFETY CLIMB LOCATION



NOTE: =

CONTRACTOR TO INSTALL MOUNT MODIFICATIONS PER THE MANUFACTURERS SPECIFICATION.
MODIFICATIONS SHALL NOT OBSTRUCT, INTERFERE, OR BLOCK EXISTING SAFETY CLIMB SYSTEM. IF
ANY OF THESE OCCURS DURING INSTALLATION CONTACT THE AMERICAN TOWER PMI INBOX
PMI@AMERICANTOWER.COM



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REV.	DESCRIPTION	BY	DATE
$\triangle$	FIRST ISSUE	RJS	07/30/21
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ATC SITE NUMBER:

306035

ATC SITE NAME:

UNITY VILLAGE MO 2

MISSOURI

SITE ADDRESS: 2150 NW LOWENSTEIN LEES SUMMIT, MO 64081




DRAWN BY:	RJS
APPROVED BY:	MFE
DATE DRAWN:	07/30/21
ATC JOB NO:	13616192_C9_05

SAFETY CLIMB LAYOUT

SHEET NUMBER:

S-102

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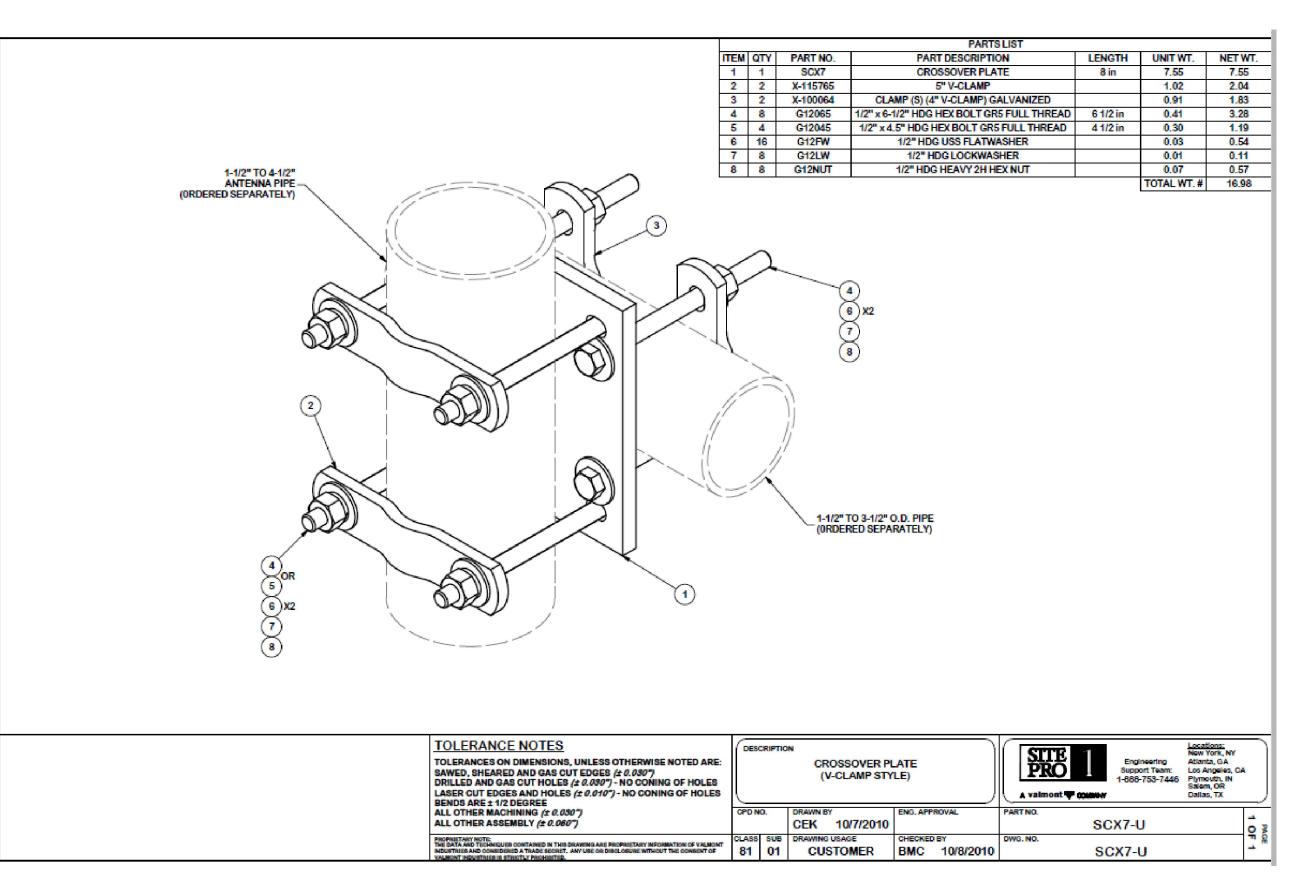
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SUPPLEMENTAL

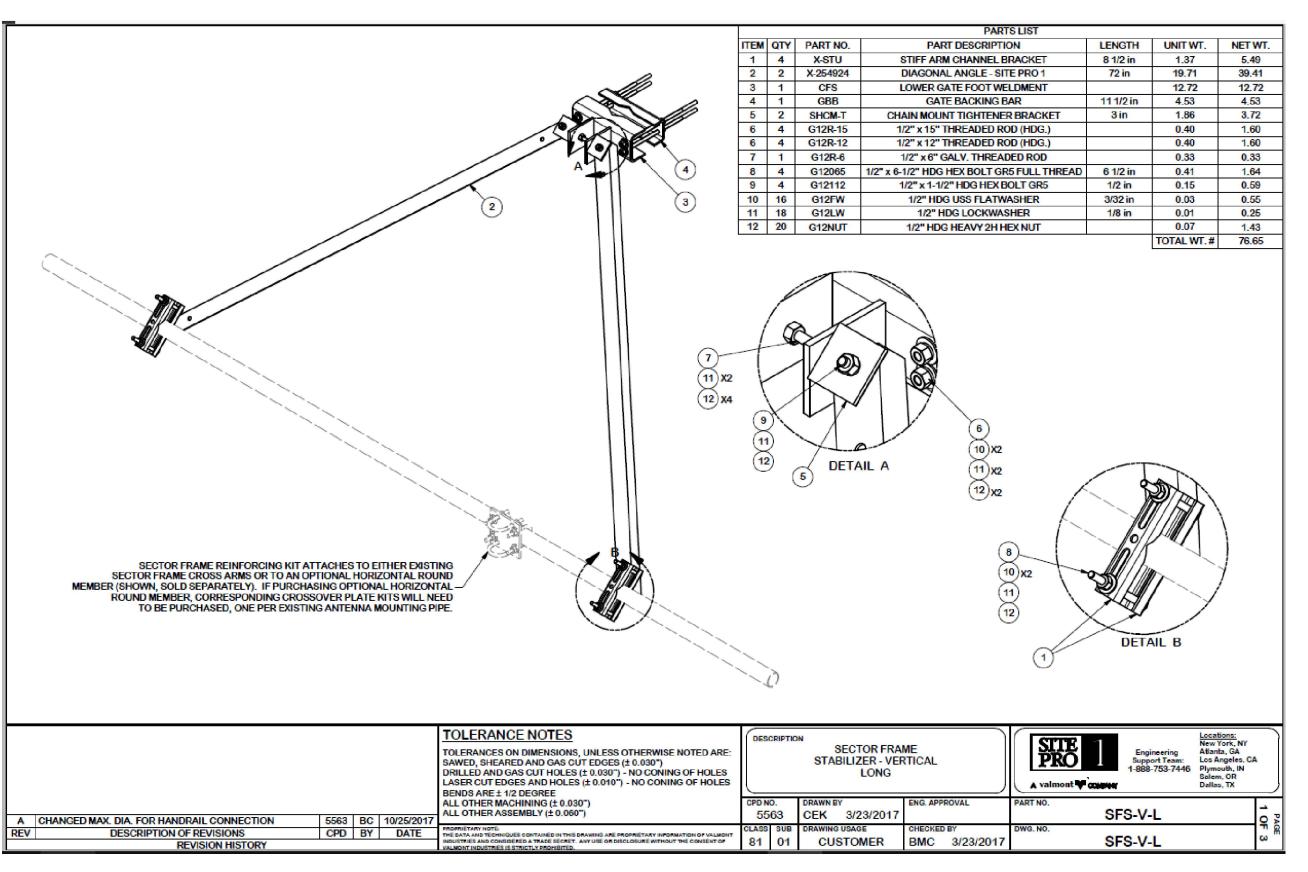SHEET NUMBER:

R-601

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SUPPLEMENTAL

SHEET NUMBER:

R-602

REVISION:

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## 10:17 AM 7/27/2021

# Option 1 - Modify: Estimate for T-Mobile @ 306035 (Unity Village MO 2) -- 13616192\_C9\_05

Site Data and Design Parameters			
Asset OTM #	306035		
Asset Name	Unity Village MO 2		
State	MO		
County	Jackson		
City	Lees Summit		
Failing Analysis Eng. #	13616192_C8_01		
Mod. Drawing Eng. #	13616192_C9_05		

Dates and Designers			
Mount Analysis Date / By	6/28/2021 /	KS	
Design Date / By 7/27/2021 / MFE		MFE	
Checked Date / By	1		
Detailer (Prev/Current/Level)	1	1	
Software	RISA		
Tower Type	Self-Support	3-sided	
Mount Type	V-Frame		

Building Codes	TIA/IBC:	ANSI/TIA-222-F	1	1	2009 IBC
	Local:				
Failing Analysis % / Code		175%	/		TIA-H
Post Mod % / Controlling Me	ember	98%	1		Horizontals
Usage Limit % / Reason		105%	1		N/A

Carrier	S
# of RADs	1
Carrier	T-Mobile
•	

Any modification design comments or assumptions? No (including notes to the Estimator)

2 Install Site Pro 1 P2150 Pipe w/ SCX7-U crossovers on All (3) sector(s)

Item# Scope Item

Modification Summary
Scope Item
Install Site Pro 1 SFS-V-L V Style Stabilizer on All (3) sector(s)

Estimated Modification Cost \$		
	<b>Estimated Modification Cost</b>	\$10,000

Option 2 - Replace: Estimate for T-Mobile @ 306035 (Unity Village MO 2) -- 13616192\_C9\_05

	Tower Info	
Tower Number	306035	
Tower Name	Unity Village MO 2	
State	MO	

Additional Info	
Can modifications be Installed?	Yes
What is the post-mod capacity?	98%

	Jurisdictional Codes
Design TIA Code Current TIA Code	Unknown
Current TIA Code	ANSI/TIA-222-H
IBC	2009 IBC
Other	-

Project Requirements		
New Mount Face Width	150	in
Number of Sectors	3	

Project Information	
Carrier	T-Mobile
Structure Type	Self-Support

Recommended Mount Replacement Site Pro 1 VFA10-SD-S\*

Estimated Replacement Cost \$ 36,000.00

SUPPLEMENTAL

SHEET NUMBER:

R-901



## AMERICAN TOWER

#### **Post Modification Mount Analysis Report**

ATC Site Name : Unity Village MO 2, MO

ATC Site Number : 306035
Engineering Number : 13616192\_C9\_05

Mount Elevation : 119 ft

Carrier Site Name : ATC 306035 - I-470 & 50 Hwy

Carrier Site Number : A5C0133A

Site Location : 2150 NW LOWENSTEIN

Lees Summit, MO 64081-1905 38.93361269, -94.41749129

: Jackson : July 27, 2021

Max Usage : 98%

Result : Contingent Pass

Prepared By:
Michael Ellis
Structural Engineer I

County

COA: 2006031326

ATC Tower Services - 3500 Regency Parkway, Suite 100 - Cary, NC 27518 - 919.468.0112 Office - 919.466.5414 Fax - www.americantower

# AMERICAN TOW

Eng. Number 13616192\_C9\_05 July 27, 2021

#### Table of Contents

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nalysis	1	
Conclusion	1	
pplication Loading	2	
tructure Usages	2	
Nount Layout	3	
quipment Layout	4	
tandard Conditions	.5	

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# MERICAN TOWER

Eng. Number 13616192\_C9\_05 July 27, 2021 Page 1

#### Introduction

The purpose of this report is to summarize results of the mount analysis performed for T-Mobile at 119 ft.

#### porting Documents

appoint botainer		
Mount Mapping	B+T GRP Project #149605.001.01, dated April 30, 2021	
Radio Frequency Data Sheet	RFDS ID #A5C0133A, dated January 12, 2021	
Reference Photos	Site photos from 2021	

#### nalvsis

mount was analyzed using American Tower Corporation's Mount Analysis Program and RISA-3D

his mount was analyzed using Am	nerican Tower Corporation's Mount Analysis Program and RISA-3D
Basic Wind Speed:	109 mph (3-Second Gust)
Basic Wind Speed w/ Ice:	40 mph (3-Second Gust) w/ 1 1/2" radial ice concurrent
Codes:	ANSI/TIA-222-H
Exposure Category:	С
Risk Category:	II
Topographic Factor Procedure:	Method 2
Feature:	Flat
Crest Height (H):	0 ft
Crest Length (L):	0 ft
Spectral Response:	Ss = 0.099, S1 = 0.068
Site Class:	D - Stiff Soil
Live Loads:	I m = 500 lbs. I v = 250 lbs

#### Conclusion

Based on the analysis results, the antenna mount meets the requirements per the applicable codes listed above provided the modifications listed below are completed:

Install modification per ATC Drawing #13616192\_C9\_05

If you have any questions or require additional information, please contact American Tower via email at Engineering@americantower.com. Please include the American Tower site name, site number, and engineering number in the subject line for any questions.

ATC Towar Sendrar - 3500 Bennary Bydwyn Sulla 100 - Cary MC 27510 - 010 460 0112 Office - 010 466 5414 Cay - years moscionatowar room



Eng. Number 13616192\_C9\_05 July 27, 2021 Page 2


#### plication Loading

Mount Centerline (ft)	Equipment Centerline (ft)	Qty	Equipment Manufacturer & Model
119.0 120.0		3	Nokia AEHC
	3	Andrew TMBX-6517-A1M	
	120.0	3	Commscope FFHH-65C-R3
	2	Commscope HELIAX FiberFeed 12 RRU Pendant Connect	
		3	Nokia AHFIG 70.55 lbs
		3	Nokia AirScale Dual RRH 4T4R B12/71 240W AHLOA


#### ructure Usages


Structural Component	Controlling Usage	Pass/Fail
Horizontals	98%	Pass
Verticals	11%	Pass
Diagonals	44%	Pass
Tie-Backs	11%	Pass
Mount Pipes	73%	Pass
Mod-Kit	57%	Pass

ATC Truser Sendon - 3500 Remons Barbaras Suite 100 - Cars NC 27510 - 010 450 0112 Office - 010 455 5414 Cars - www.moneleastrangr.com

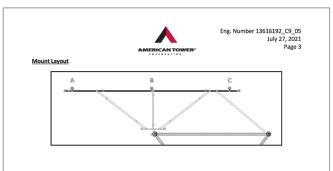

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SHEET NUMBER:

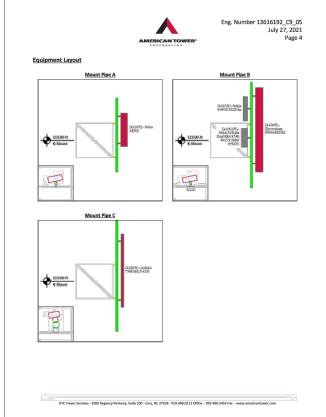R-902

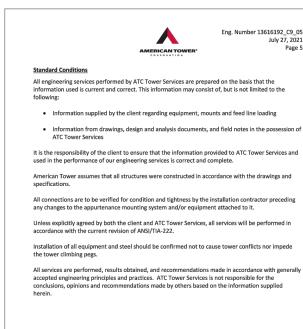REVISION


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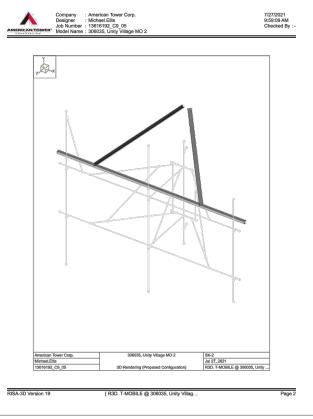
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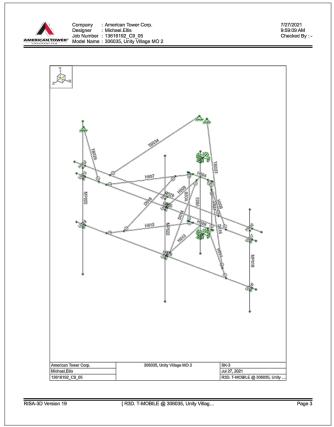
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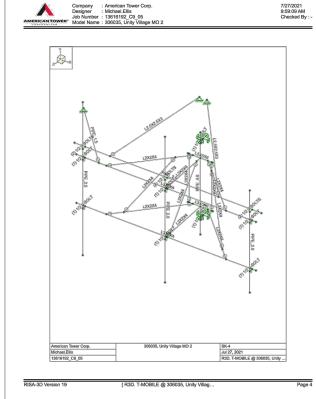
SUITE 100


\* Equipment with EPA values N/A were not considered in the mount analys








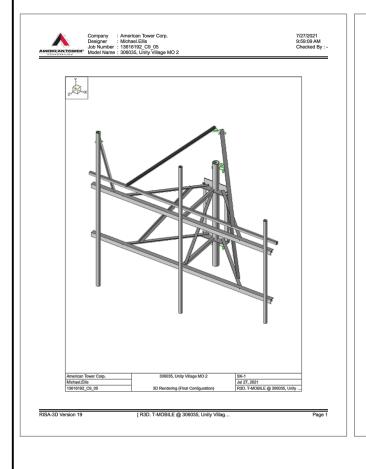

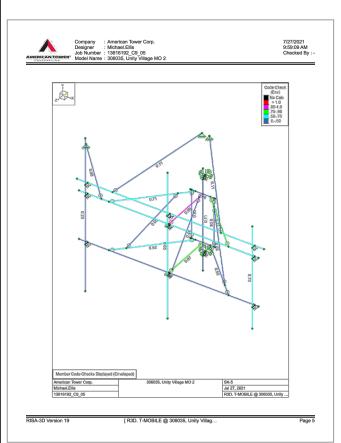

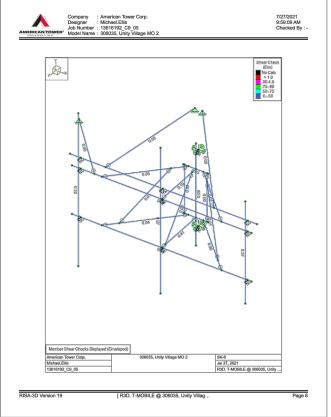



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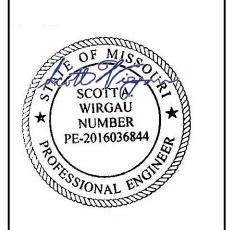
306035

ATC SITE NAME:

**UNITY VILLAGE MO 2** 

MISSOURI

SITE ADDRESS: 2150 NW LOWENSTEIN LEES SUMMIT, MO 64081



DRAWN BY:	RJS
APPROVED BY:	MFE
DATE DRAWN:	07/30/21
ATC JOB NO:	13616192_C9_05

SUPPLEMENTAL

SHEET NUMBER:

R-903

REVISION: