UTILITIES/GOVERNING AGENCIES CONTACTS:

SANITARY SEWER LEE'S SUMMIT WATER UTILITIES 1200 SE HAMBLEN ROAD LEE'S SUMMIT, MO 64063 PHONE: (816) 969-1900

WATER

LEE'S SUMMIT WATER UTILITIES 1200 SE HAMBLEN ROAD LEE'S SUMMIT, MO 64063 PHONE: (816) 969-1900 <u>GAS</u> SPIRE

3025 SE CLOVER DR LEE'S SUMMIT, MO 64082 CONTACT: BOBBIE SAULSBERRY PHONE: (816) 969-2266 EMAIL: BOBBIE.SAULSBEERY@SPIREENERGY.COM

ELECTRIC EVERGY LEE'S SUMMIT SERVICE CENTER 1300 SE HAMBLEN ROAD LEE'S SUMMIT, MO 64081 CONTACT: DOUG DAVIN PHONE: (816) 347-4320 EMAIL: DOUG.DAVIN@EVERGY.COM

TELEPHONE/ CABLE


ATET 2121 E. 63RD STREET, CIOI KANSAS CITY, MO 64130 CONTACT: DARRIN SHEPARD PHONE (O): (816) 772-0336 PHONE (C): (816) 535-7658 EMAIL: DS616H@ATT.COM

ADDITIONAL GOVERNING AGENCIES CONTACTS:

DEVELOPMENT SERVICES

CITY OF LEE'S SUMMIT -DEVELOPMENT SERVICES 220 SE GREEN STREET LEE'S SUMMIT, MO 64063 PHONE: (816) 969-1200

STORMWATER MANAGEMENT CITY OF LEE'S SUMMIT -PUBLIC WORKS 220 SE GREEN STREET LEE'S SUMMIT, MO 64063 PHONE: (816) 969-1800

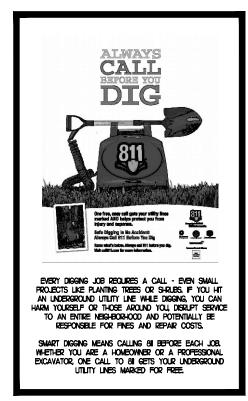

FIRE PREVENTION CITY OF LEE'S SUMMIT FIRE DEPARTMENT 207 S.E. DOUGLAS LEE'S SUMMIT, MO 64063 CONTACT: JIM EDEN

PHONE: (816) 969-1313

INT MODOT - KANSAS CITY DISTRICT 600 NE COLBERN ROAD LEE'S SUMMIT, MO 64086 CONTACT: MELISSA BLACK PHONE: (816) 607-2153 EMAIL: MELISSA.BLACK@MODOT.MO.GOV

EROSION CONTROL & WATER QUALITY MODNR - KANSAS REGIONAL OFFICE 500 NE COLBERN ROAD LEE'S SUMMIT, MO 64086 CONTACT: KAREN ROUSE PHONE: (816) 251-0700 EMAIL: KAREN.ROUSE.@DNR.MO.GOV

> A BOOR HOUSE THE SE BLUE PKWY US HWY 50 US

FOR CALIBER COLLISION 710 SE BLUE PARKWAY LEE'S SUMMIT, MO 64063 JACKSON COUNTY, MISSOURI

GENERAL NOTES

- I. INFORMATION CONCERNING UNDERGROUND UTILITIES WAS OBTAINED FROM AVAILABLE RECORDS AND FIELD CONDITIONS WHEN POSSIBLE, BUT THE CONTRACTOR MUST DETERMINE THE EXACT LOCATION AND ELEVATION OF ALL EXISTING UTILITIES BY DIGGING TEST PITS BY HAND AT ALL UTILITY CROSSINGS WELL IN ADVANCE OF TRENCHING. IF THE CLEARANCES ARE LESS THAN SPECIFIED ON THE PLANS OR 12", WHICHEVER IS LESS, CONTACT FREELAND & KAUFFMAN, INC. (864-233-5497) AND OWNER PRIOR TO PROCEEDING WITH CONSTRUCTION.
- 2. THE CONTRACTOR SHALL INCLUDE IN HIS CONTRACT PRICE THE REMOVAL AND DISPOSAL OF ANY EXCESS TOPSOIL HE/SHE DETERMINES IS NOT REQUIRED TO PERFORM THE FINAL GRADING AND LANDSCAPING OPERATION.
- 3. THE CONTRACTOR IS RESPONSIBLE FOR THE DESIGN AND IMPLEMENTATION OF ALL REQUIRED/NECESSARY SHEETING, SHORING, AND SPECIAL EXCAVATION MEASURES REQUIRED ON THE PROJECT TO MEET OSHA, FEDERAL, STATE AND LOCAL REGULATIONS PURSUANT TO THE INSTALLATION OF THE WORK INDICATED ON THE DRAWINGS. OWNER AND FREELAND & KAUFFMAN, INC. ACCEPT NO RESPONSIBILITY FOR THE DESIGN TO INSTALL SAID ITEMS.
- 4. CALL UTILITY LOCATOR SERVICE 72 HOURS IN ADVANCE OF DIGGING AT 811.
- 5. ALL WORK SHALL CONFORM TO THE CITY OF LEE'S SUMMIT STANDARDS AND SPECIFICATIONS.
- 6. ALL CURB/HANDICAP RAMP DESIGNS SHALL CONFORM TO ADA STANDARDS OR CITY OF LEE'S SUMMIT STANDARDS, WHICHEVER IS MORE RESTRICTIVE.
- 7. PRE-CAST DRAINAGE AND SANITARY SEWER STRUCTURES HAVE BEEN SPECIFIED ON THE PLANS. OWNER AND FREELAND & KAUFFMAN, INC., HOWEVER, ASSUME NO RESPONSIBILITY FOR THESE STRUCTURES AS FIELD CONDITIONS DURING CONSTRUCTION OFTEN DICTATE MINOR ELEVATION ADJUSTMENTS. THE CONTRACTOR ASSUMES ALL RESPONSIBILITY AND EXPENSE FOR MODIFYING THESE STRUCTURES TO ACCOMMODATE THESE FIELD ADJUSTMENTS.
- 8. THE CONTRACTOR IS RESPONSIBLE FOR PREPARING AND SUBMITTING TO FREELAND & KAUFFMAN, INC. AS-BUILT WATER AND SEWER INFORMATION, TO ENABLE FREELAND AND KAUFFMAN, INC. TO PREPARE THE REQUIRED AS-BUILT/RECORD DRAWINGS TO OBTAIN PERMITS TO PLACE UTILITIES INTO OPERATION. THE CONTRACTOR IS ALSO REQUIRED TO PROVIDE FREELAND AND KAUFFMAN COPIES OF THE WATER AND SEWER PRESSURE TESTS, WATER MAIN BACTERIOLOGICAL TESTS, BACKFLOW PREVENTION TESTS BY A CERTIFIED BACKFLOW PREVENTION SPECIALIST, ETC. CONTRACTOR SHALL NOTIFY FREELAND & KAUFFMAN, INC. AT LEAST 72 HOURS IN ADVANCE OF ALL UTILITY TESTING.
- 9. ALL WATER LINE AND SEWER LINE INSTALLATION SHALL CONFORM TO THE STANDARDS AND DETAILS OF CITY OF LEE'S SUMMIT AND LEE'S SUMMIT WATER UTILITIES
- IO. THE CONTRACTOR IS RESPONSIBLE FOR FAMILIARIZING HIMSELF WITH THESE STANDARDS.
- II. THE LAND DISTURBANCE PERMIT MUST BE KEPT ON THE WORK SITE AND SHOWN UPON REQUEST.
- 12. THE CONTRACTOR SHALL INCLUDE IN THE CONTRACT PRICE ALL MATERIAL AND LABOR ASSOCIATED WITH THE TESTING OF THE WATER AND SEWER LINES REQUIRED BY CITY OF LEE'S SUMMIT AND LEE'S SUMMIT WATER UTILITIES
- 13. THE CONTRACTOR SHALL INCLUDE IN THE CONTRACT PRICE ANY DE-WATERING NECESSARY TO CONSTRUCT THE PROJECT AS SHOWN ON THE PLANS.
- 14. SEDIMENT CONTROL MEASURES MUST BE INSPECTED ONCE EVERY 7 CALENDAR DAYS AND WITHIN 24-HOURS OF QUALIFYING STORM EVENTS, AND MAINTAINED AS NEEDED TO INSURE THAT THE INTENDED PURPOSES ARE ACCOMPLISHED.
- 15. ALL PRE-CAST DRAINAGE AND MANHOLE STRUCTURES MUST MEET CITY OF LEE'S SUMMIT AND MODOT SPECIFICATIONS.
- 16. THE CONTRACTOR IS RESPONSIBLE FOR SECURING THE SERVICES OF A MISSOURI REGISTERED LAND SURVEYOR ON-SITE TO PROVIDE ALL CONSTRUCTION STAKE-OUT SERVICES. THE CONTRACTOR IS ALSO RESPONSIBLE FOR INSURING THE SURVEYOR IS IN POSSESSION OF THE LATEST REVISIONS OF ALL PLANS.
- 15. A CITY OF LEE'S SUMMIT AND MODOT ENCROACHMENT PERMITS ARE REQUIRED FOR ALL WORK WITHIN THE PUBLIC ROADWAY RIGHT-OF-WAY.
- 16. THE FINANCIAL RESPONSIBILITY (FRO) AND NPDES COVERAGE LETTER MUST BE KEPT ON THE JOB SITE AND SHOWN UPON REQUEST.

Shee	et List Table
Sheet Number	Sheet Title
1	COVER SHEET
2	SURVEY
3	DEMOLITION PLAN
4	EROSION CONTROL PHASE I
5	EROSION CONTROL PHASE 2
6	EROSION CONTROL DETAILS
7	EROSION CONTROL DETAILS
8	SITE PLAN
9	SITE DETAILS
10	SITE DETAILS
	SITE DETAILS
12	SITE DETAILS
13	GRADING PLAN
4	NLET AREA MAP
6	STORM PROFILES
6	STORM DETAILS
/	STORM DETAILS
18	UGD DETAILS
19	UGD DETAILS
20	UTILITY PLAN
21 22	UTILITY DETAILS
23	
	LANDSCAPE PLAN
24 25	LANDSCAPE DETAILS
26	SIGHT DISTANCE EXHIBIT
ASI.I	TRASH ENCLOSURE DETAIL
AS2.01	BUILDING ELEVATIONS
SPI.0	PHOTOMETRIC PLAN

REVISIONS

NO. DATE

FREELAI	ND and	KAUFFMAN,	
	ENGINE 209 WEST STO NVILLE, SOUTH 864-282 NC LICENSE	ONE AVENUE CAROLINA 29609 -3039	
DRAWN BY:	BAC		
CHECKED BY:	TMB		
DATE:	07/23/2021		
A REAL PROPERTY OF	NUMB 2021014		

ENGINEER-

FREELAND and KAUFFMAN, INC. 209 WEST STONE AVENUE GREENVILLE, SC 29609 TELEPHONE (864) 233-5497 FAX (864) 233-8915

DEVELOPER/OWNER-

CROSS DEVELOPMENT CC LEE'S SUMMIT, LLC. 4336 MARSH RIDGE RAOD CARROLLTON, TX 75010 CONTACT: NICK FORE TELEPHONE (214) 614-8252

> SHEET I AUGUST 23, 2021

SITE LOCATION MAP (NOT TO SCALE)


LOT 5

=1014.72

---8"cmp out l

Building

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- TABLE A ITEMS: 1) Monuments set as shown
- 2) Address 710 SE 7th Terrace, Lee's Summit, MO 64063
- 3) Flood Zone X Federal Emergency Management Agency (FEMA) Flood Insurance Rate Maps (FIRM) 29183C0185G effective 1/20/2016 and 29189C0205G effective 1/20/2016
- 4) There are 60,209 square feet in Lot 2
- 5) Vertical datum is NAVD 88 (See Benchmark Note)
- 6a) No zoning letter provided
- 6b) No zoning letter provided
- 7a) There is no building on property
- 8) Substantial features are shown
- 9) There is no designated parking on property
- 10) There were no division or party walls designated by the client.
- 11a) Utilities as shown
- 13) The names of adjoining property owners are shown as of the date of the survey from the Assessor's records online.
- 14) Site is approximately 0.2 miles east of SE Missouri 291 Highway along SE 7th Terrace.
- 16) There is no new construction on or adjacent to site, however, there is a "Final Development Plan, Concept Developement Plan, for Lawn & Leisure Addition - Lot 1 and Chapman Plaza II - Lot 1 & Lot 2", by Hamilton & Sterrett, Inc., Engineers, Land Surveyors & Planners, Signed & Sealed by Leslie R. Hamilton, MO E-22616, dated March 13, 2015. Plans depict proposed parking, building and detention.
- 17) There was no evidence of changes in street right of way lines, and none made available to the surveyor by the controlling jurisdiction. There is no evidence of recent street or sidewalk construction or repairs observed during the process of conducting the field work.

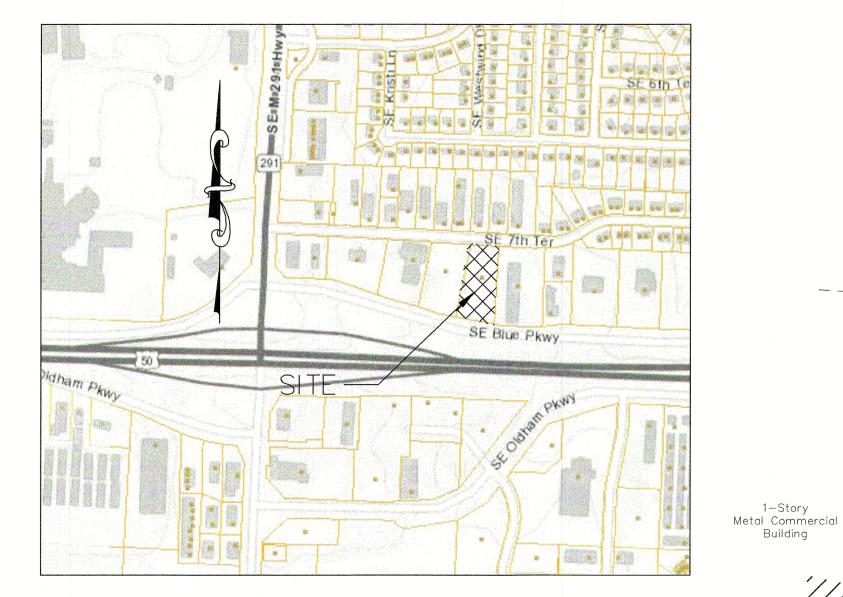
Chicago Title Insurance Company Commitment No. 211007 Dated April 19, 2021

Description:

Lot 2, CHAPMAN PLAZA II, a subdivision in Lee's Summit, Jackson County, Missouri, according to the recorded plat thereof.

Chicago Title Insurance Company Commitment No. 211007 Dated April 19, 2021 Schedule B, Part II, Exceptions, Item #s

- 8) Rights of way, and easement, together with abutter's rights of direct access to State of Missouri, Doc# 882977 in Bk 1820 pg 1 - property has direct access along the South line of Lot 2 to Se Blue Parkway, as shown, temporary easement mentioned for landscaping should be no longer in effect.
- 9) Electric line easement to Missouri Public Service Company Doc# 907336 in Bk 1884 pg 30, as shown
- 10) Boundaries, building lines, easements and dedications on Chapman Plaza II, Doc# 2010E122508, as shown
- 11) Easement for storm drainage, Doc# 2011E0088607, as shown
- 12) Easement for storm drainage, Doc# 2011E0088608, as shown

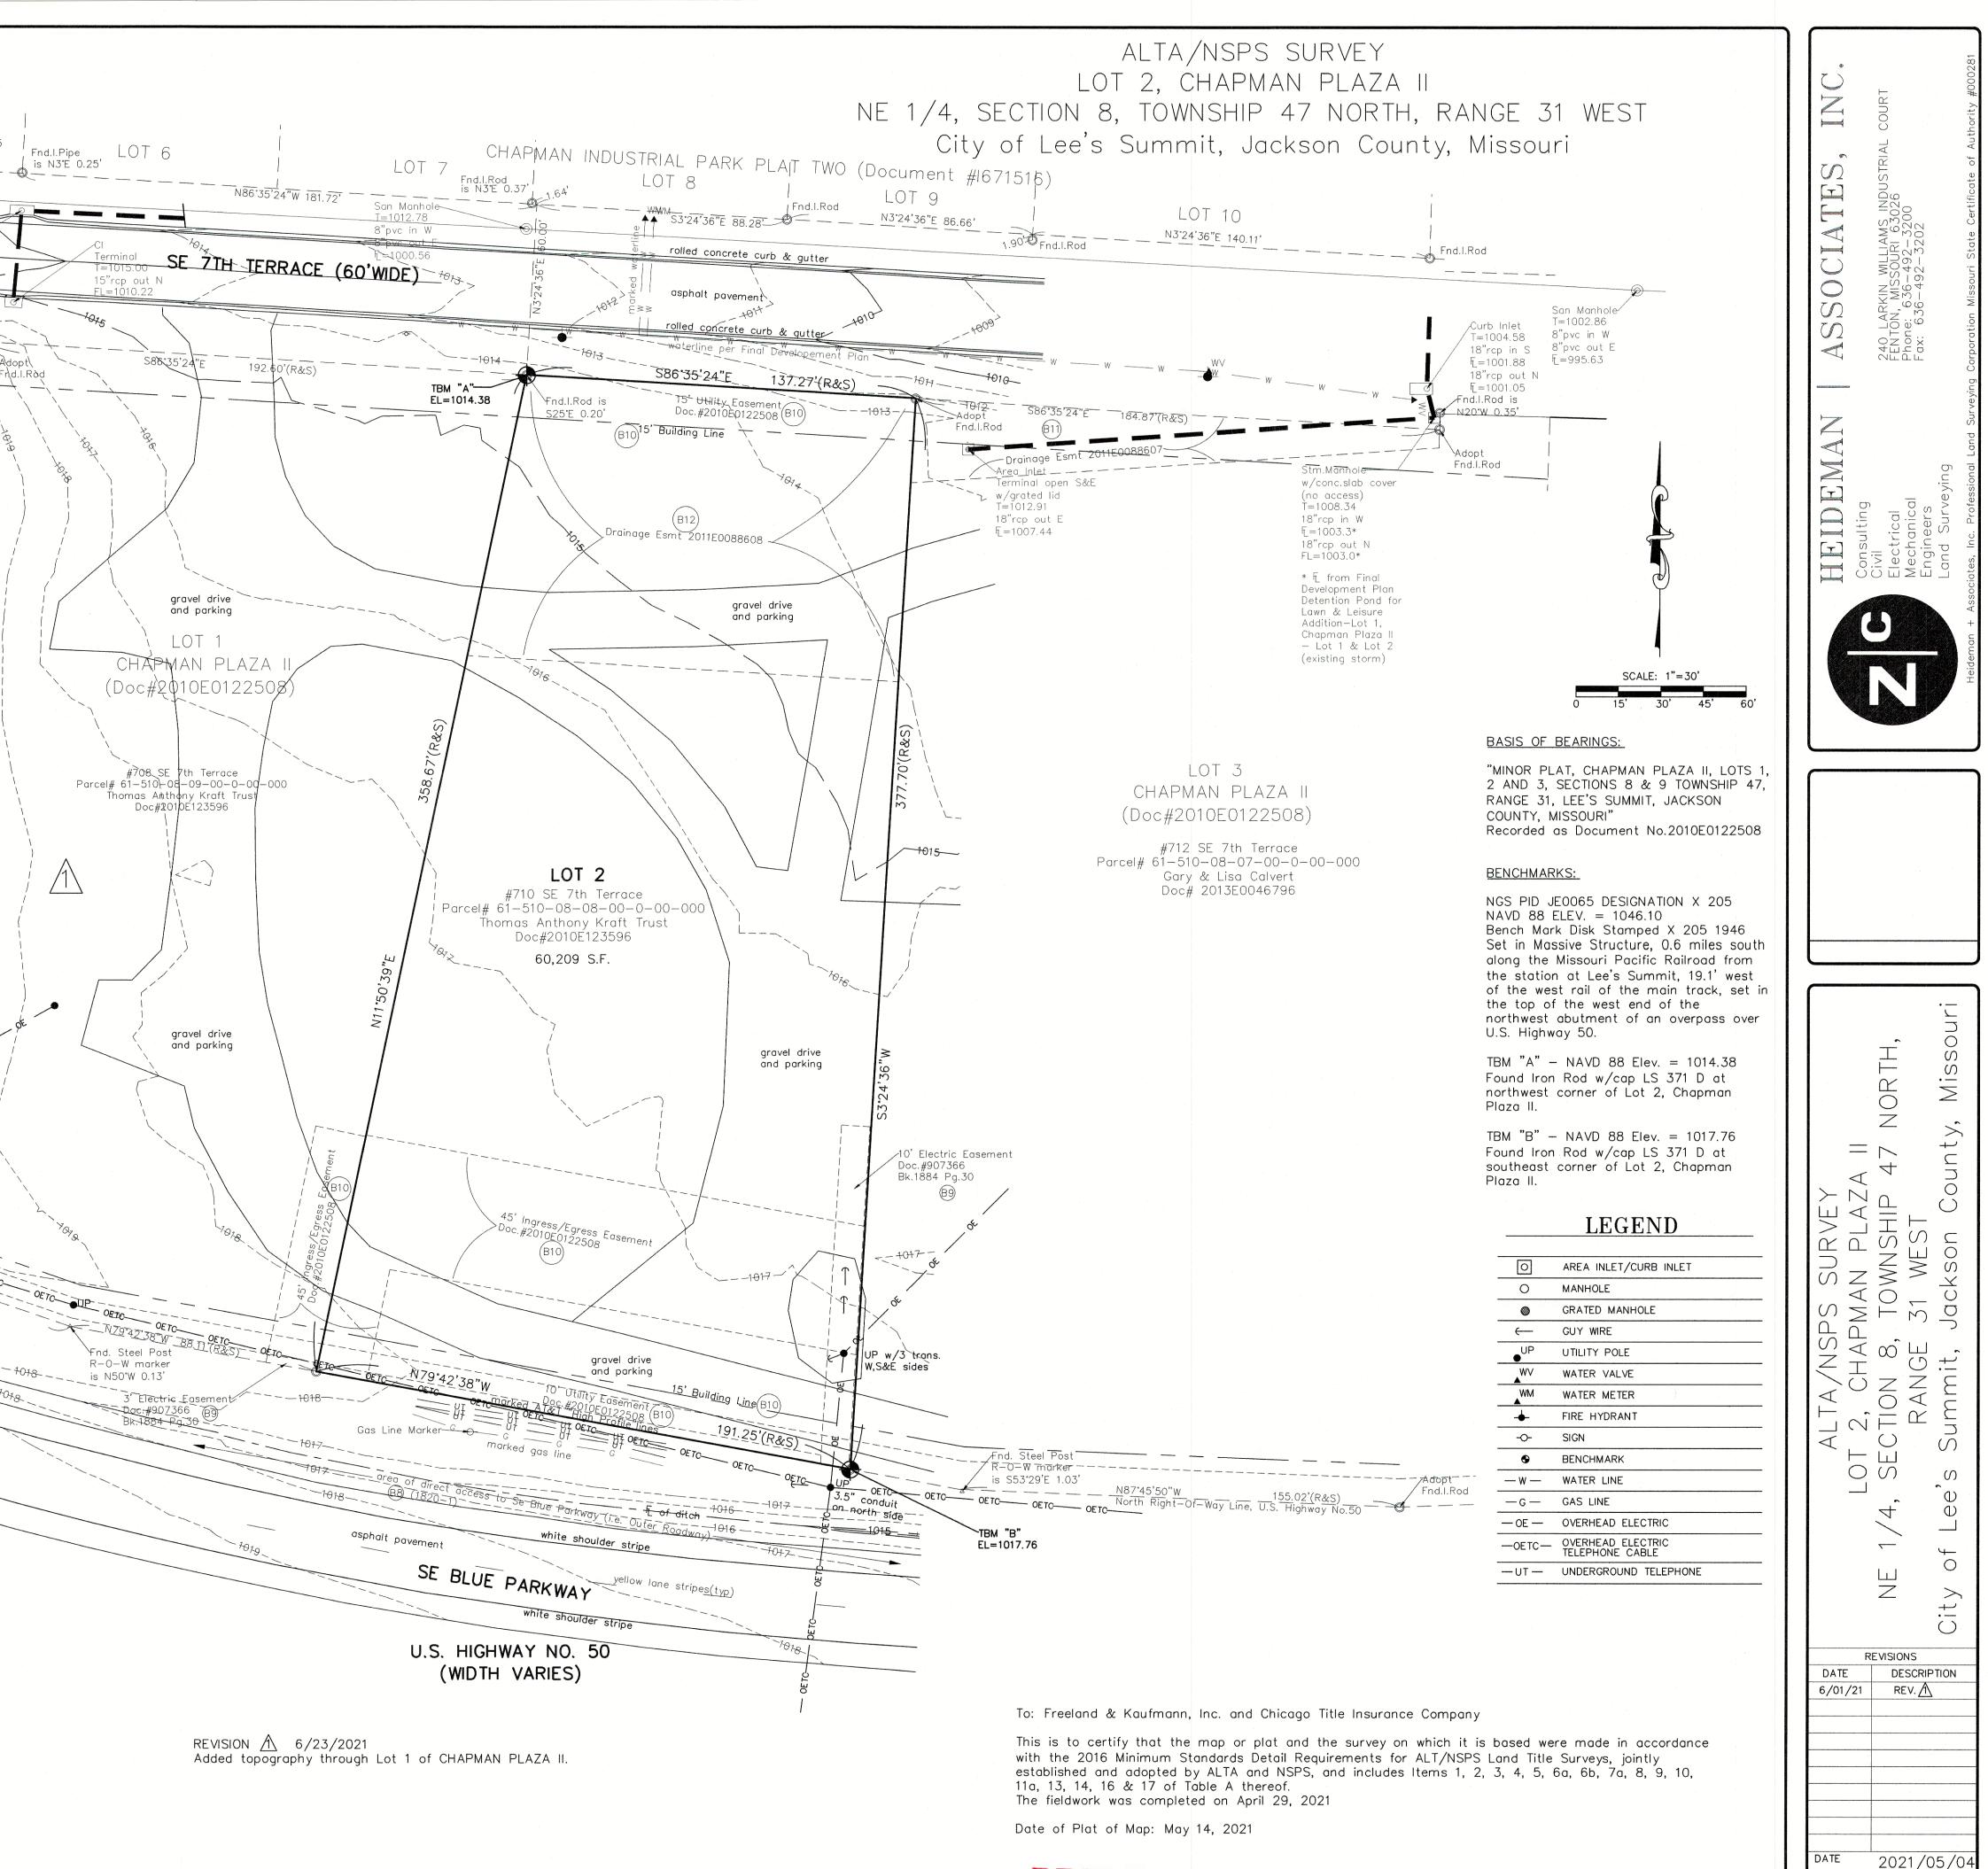

PRELIMINARY

MARK WILEY MO PLS 2437

CHECKED BY DRAWN BY


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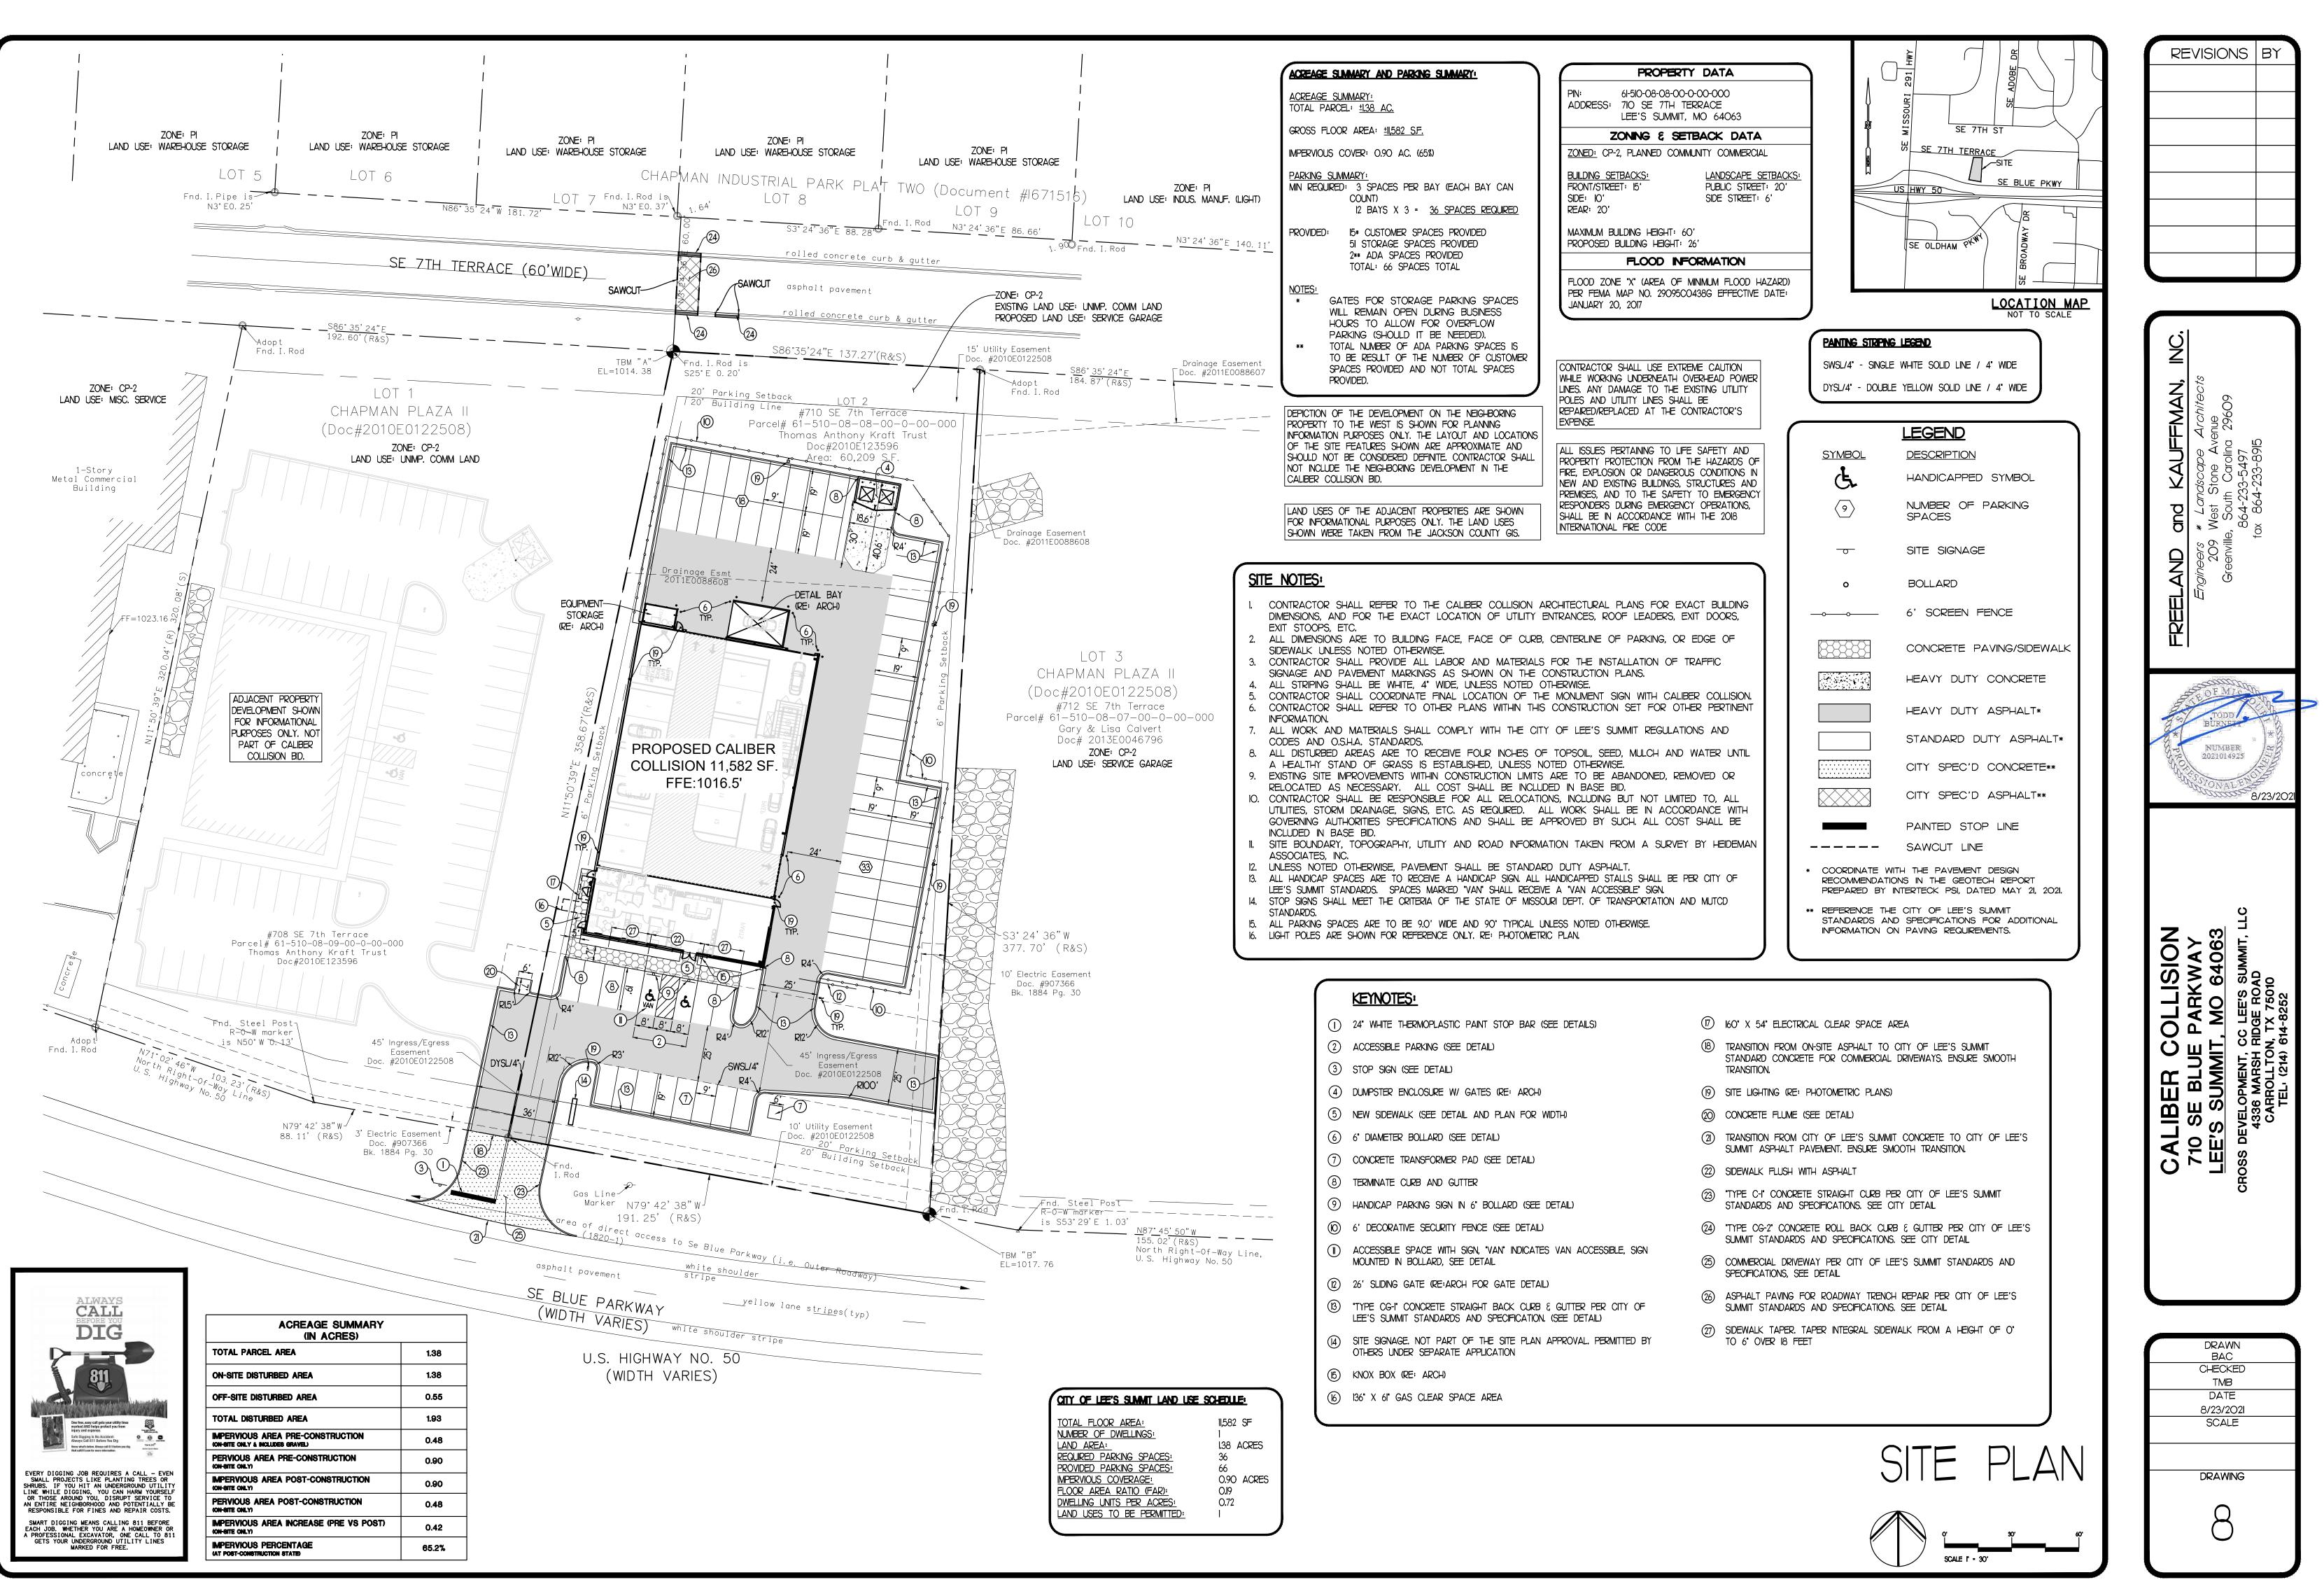
JOB NO. 211029




SMART DIGGING MEANS CALLING 811 BEFORE EACH JOB. WHETHER YOU ARE A HOMEOWNER OR A PROFESSIONAL EXCAVATOR, ONE CALL TO 81 GETS YOUR UNDERCROUND UTILITY LINES MARKED FOR FREE.

IMPERVIOUS AREA INCREASE (PRE VS POST) 0.42 (ON-SITE ONLY) IMPERVIOUS PERCENTAGE 65.2% (AT POST-CONSTRUCTION STATE)

SCALE I = 30'

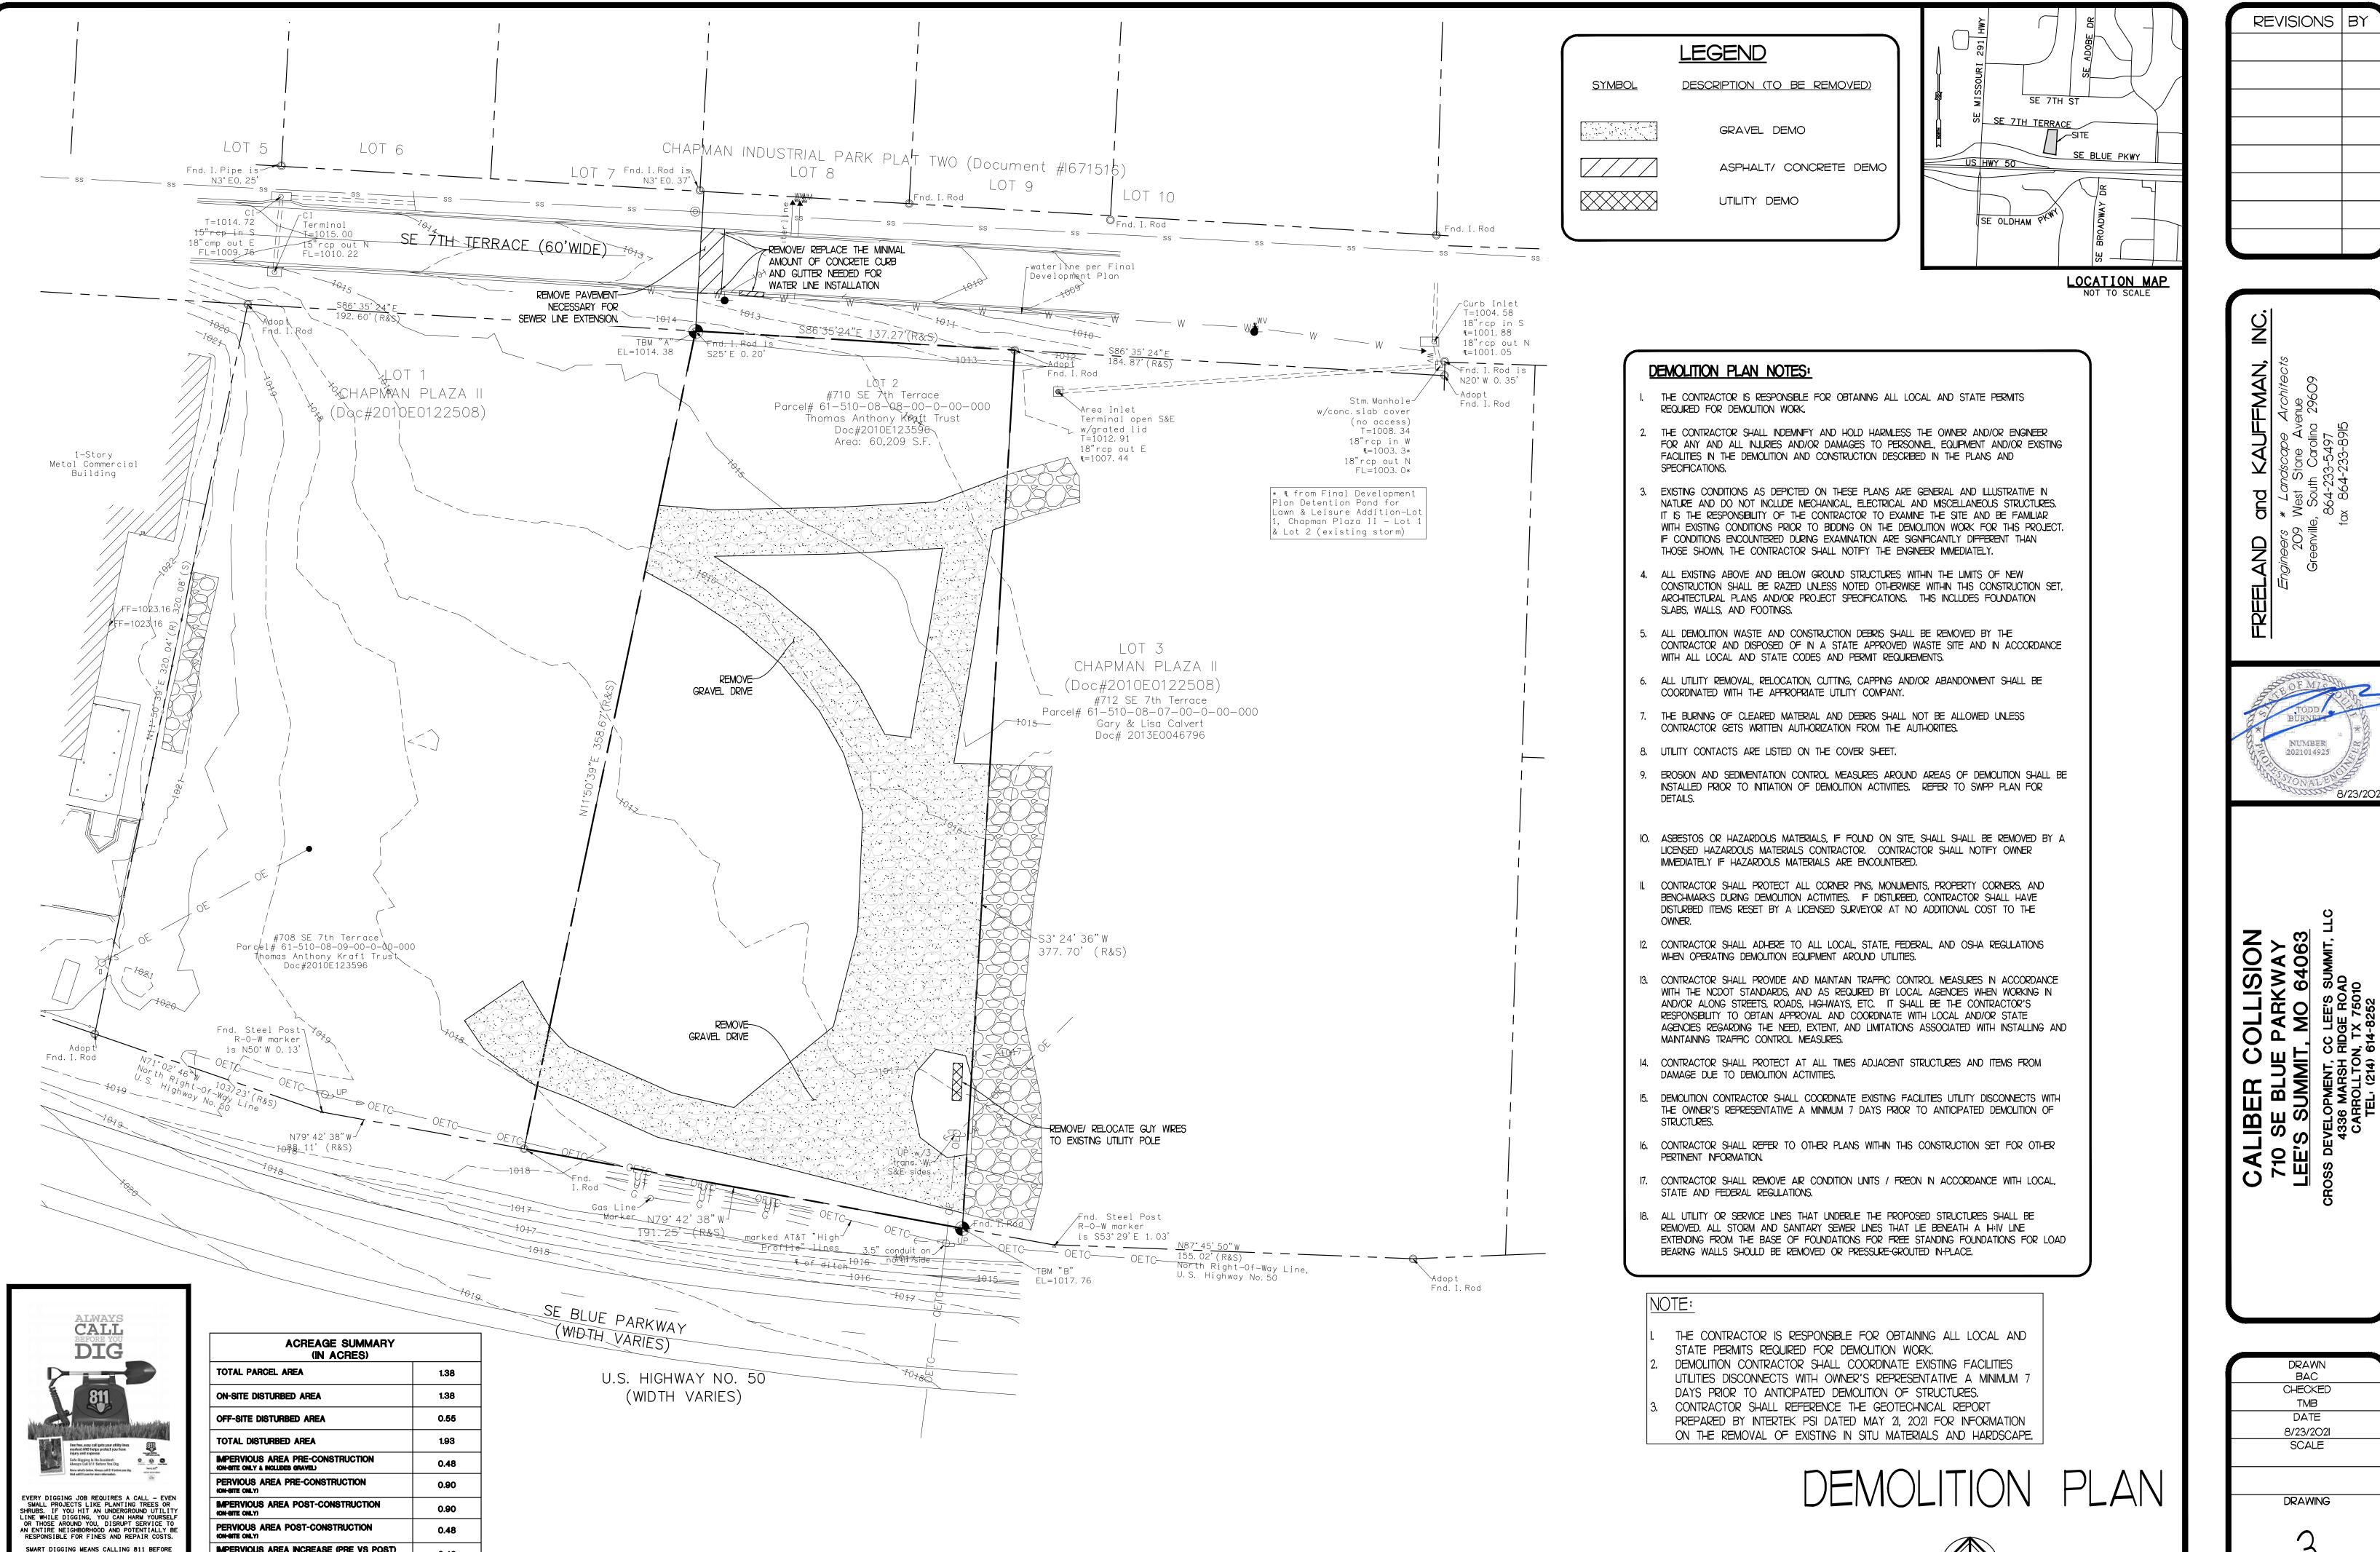

SITE	PLA	
SCALE I	- 30' 30'	6

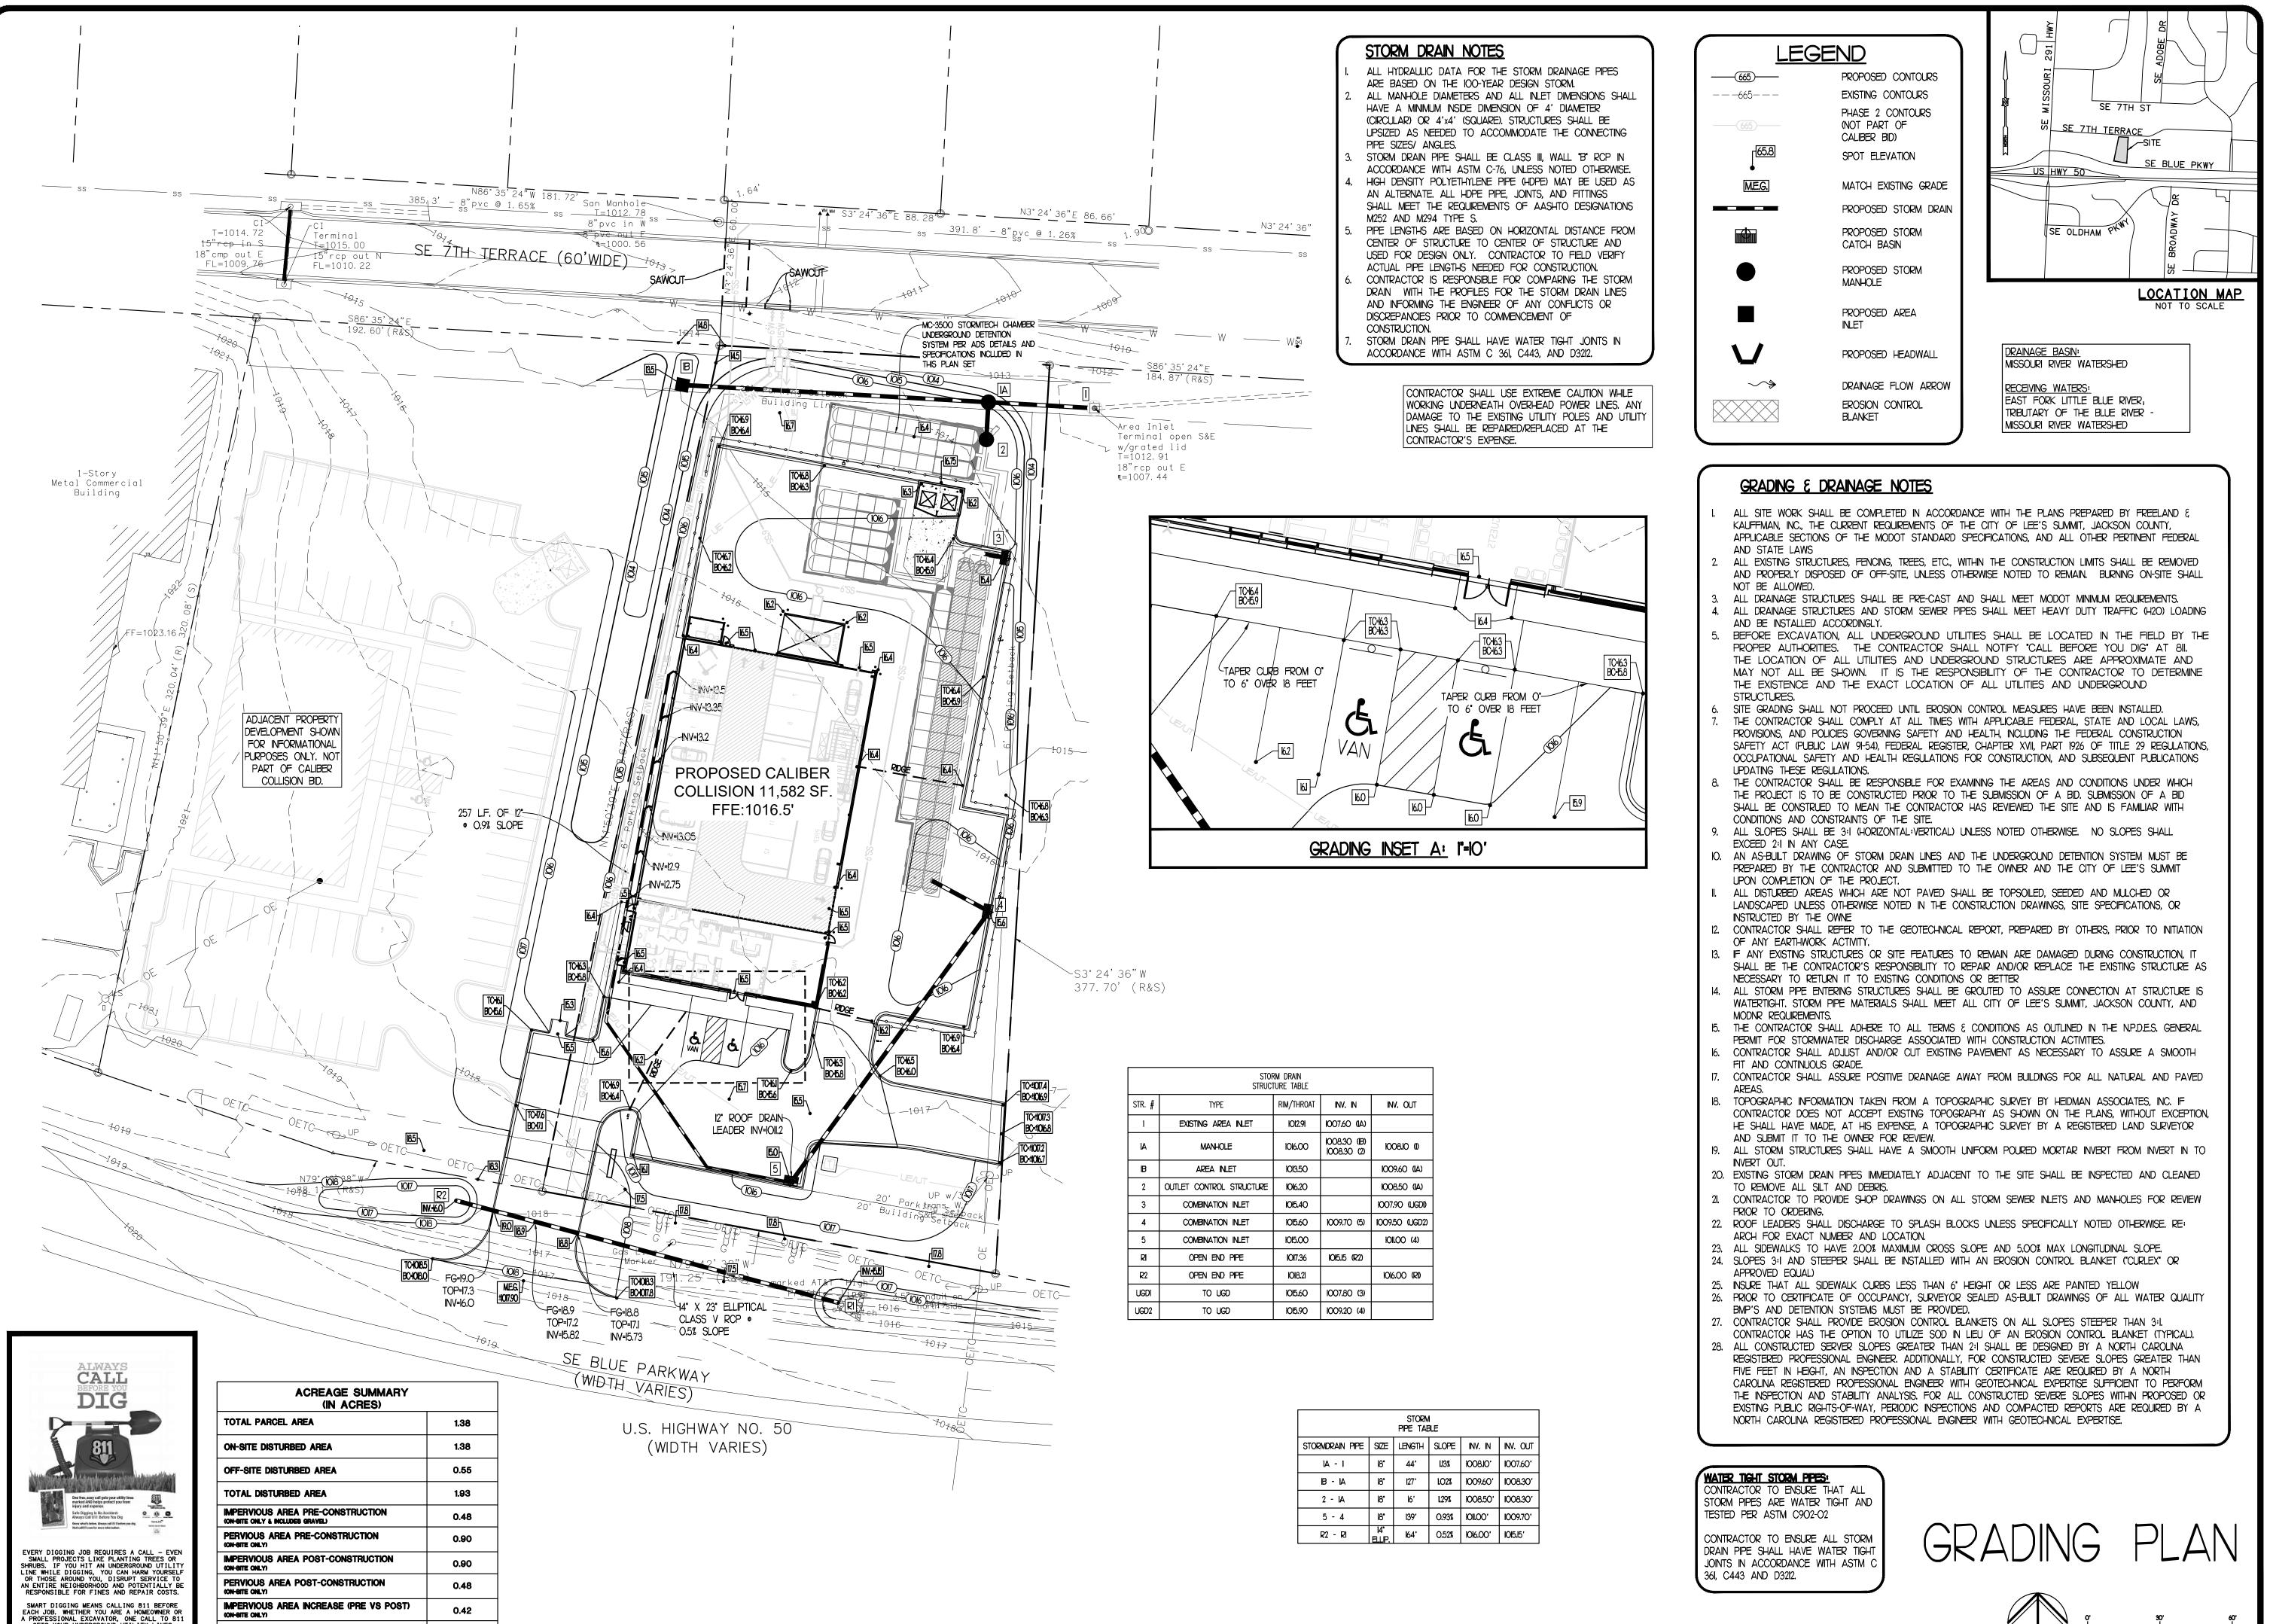

SMART DIGGING MEANS CALLING 811 BEFORE EACH JOB. WHETHER YOU ARE A HOMEOWNER OR A PROFESSIONAL EXCAVATOR, ONE CALL TO 81 GETS YOUR UNDERGROUND UTILITY LINES MARKED FOR FREE.

IMPERVIOUS PERCENTAGE 65.2% (AT POST-CONSTRUCTION STATE)

SCALE I = 30'

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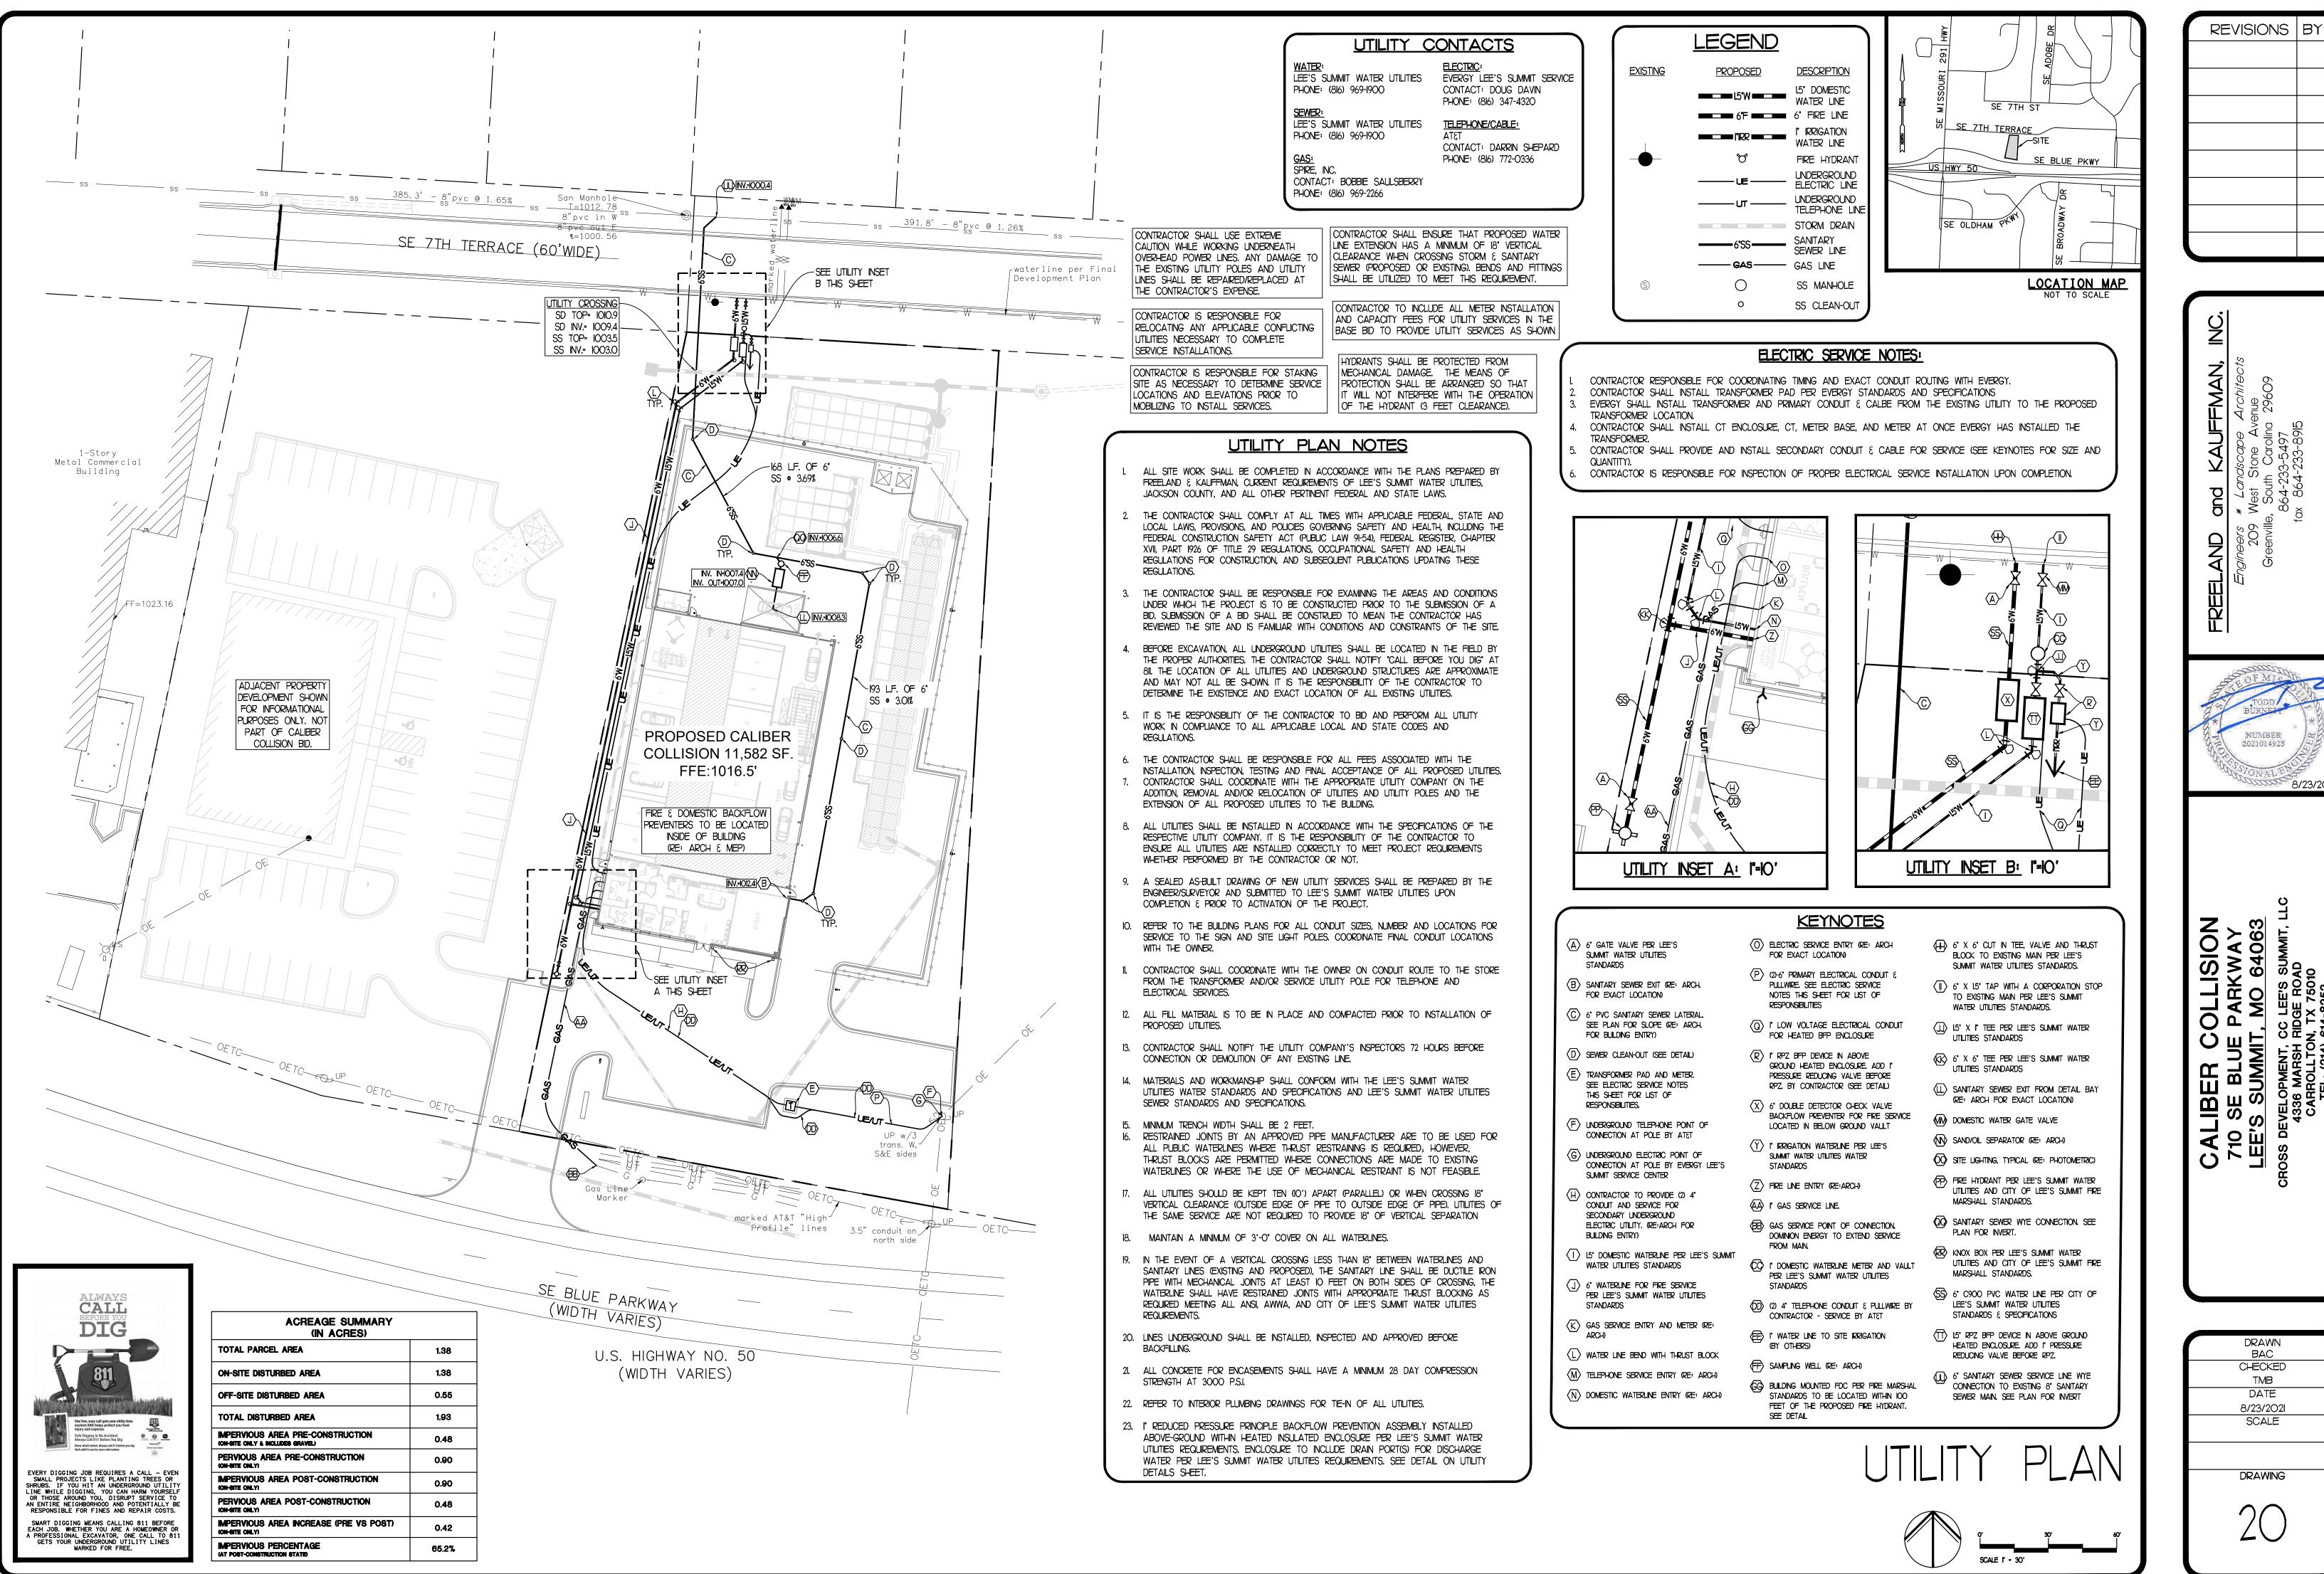
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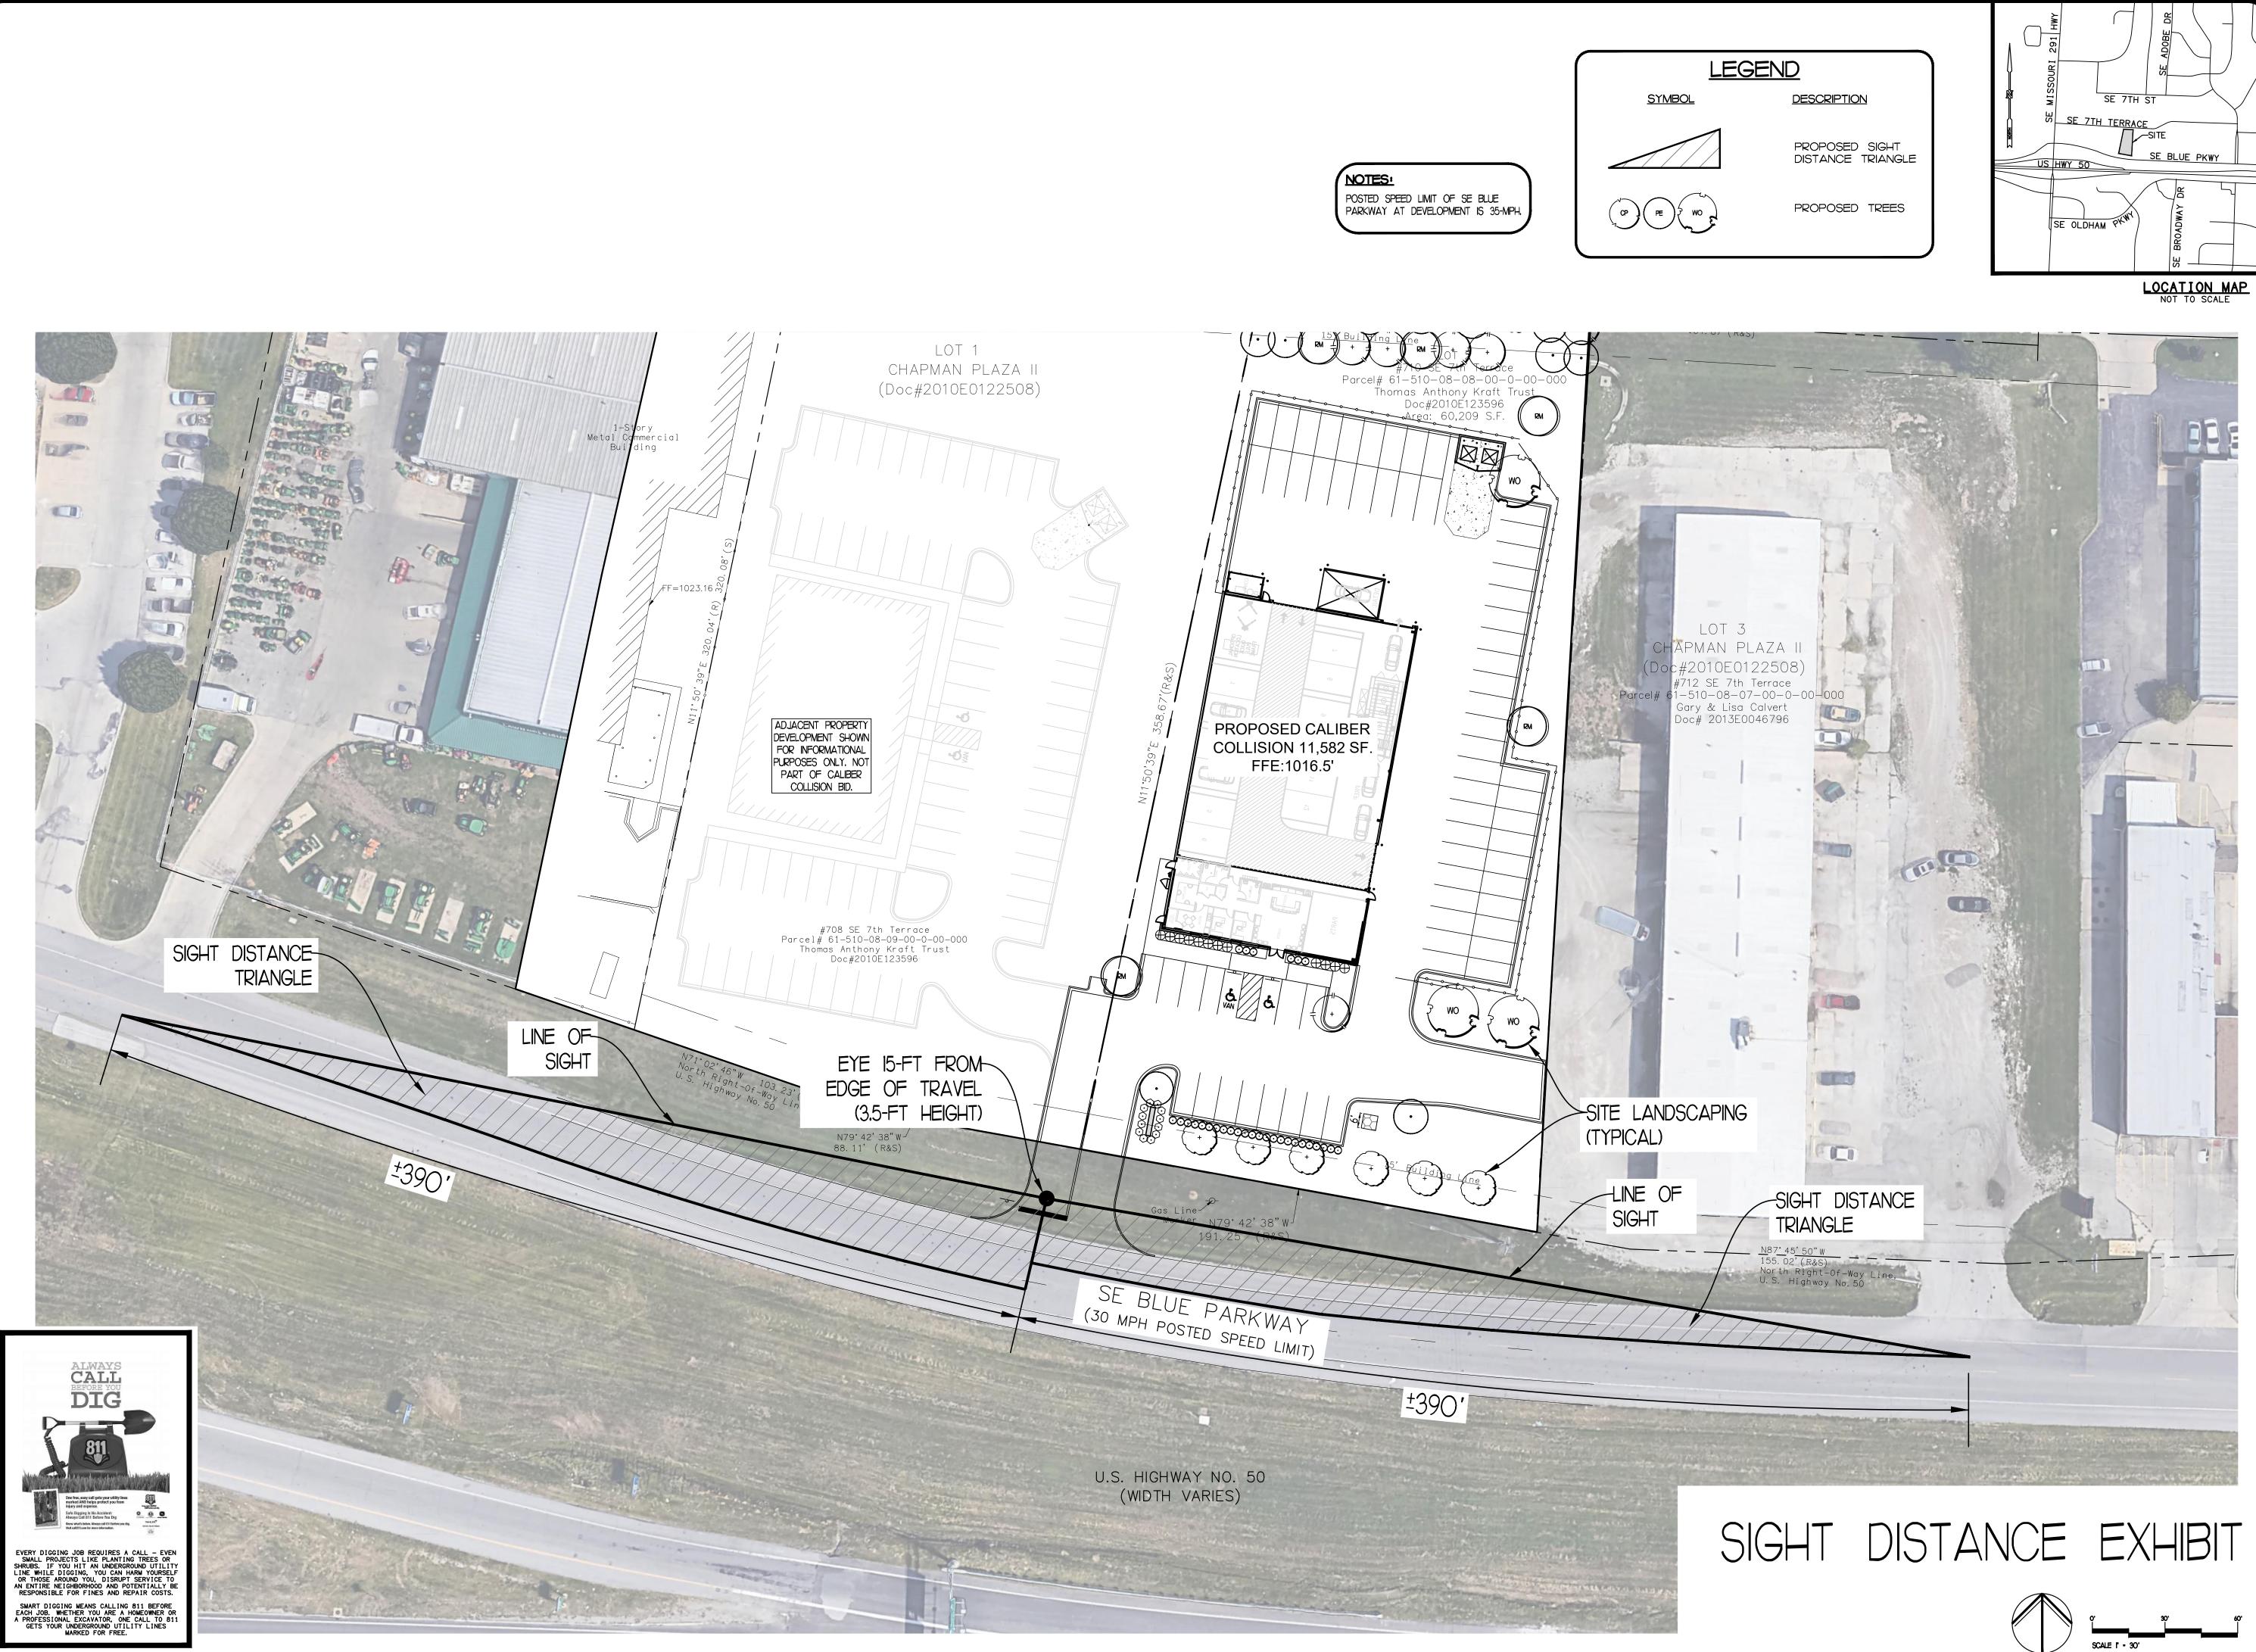
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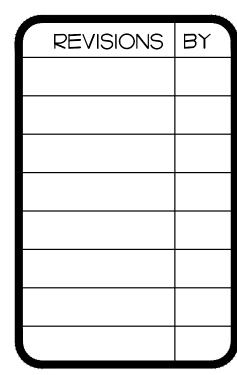
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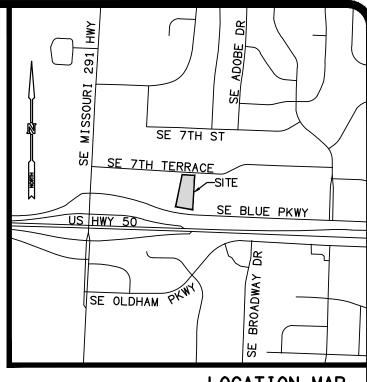
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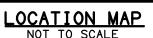
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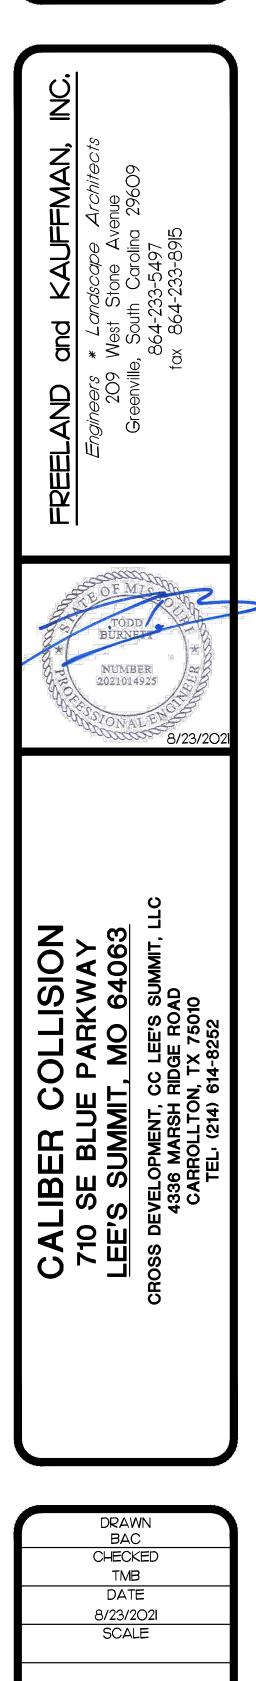













DRAWING


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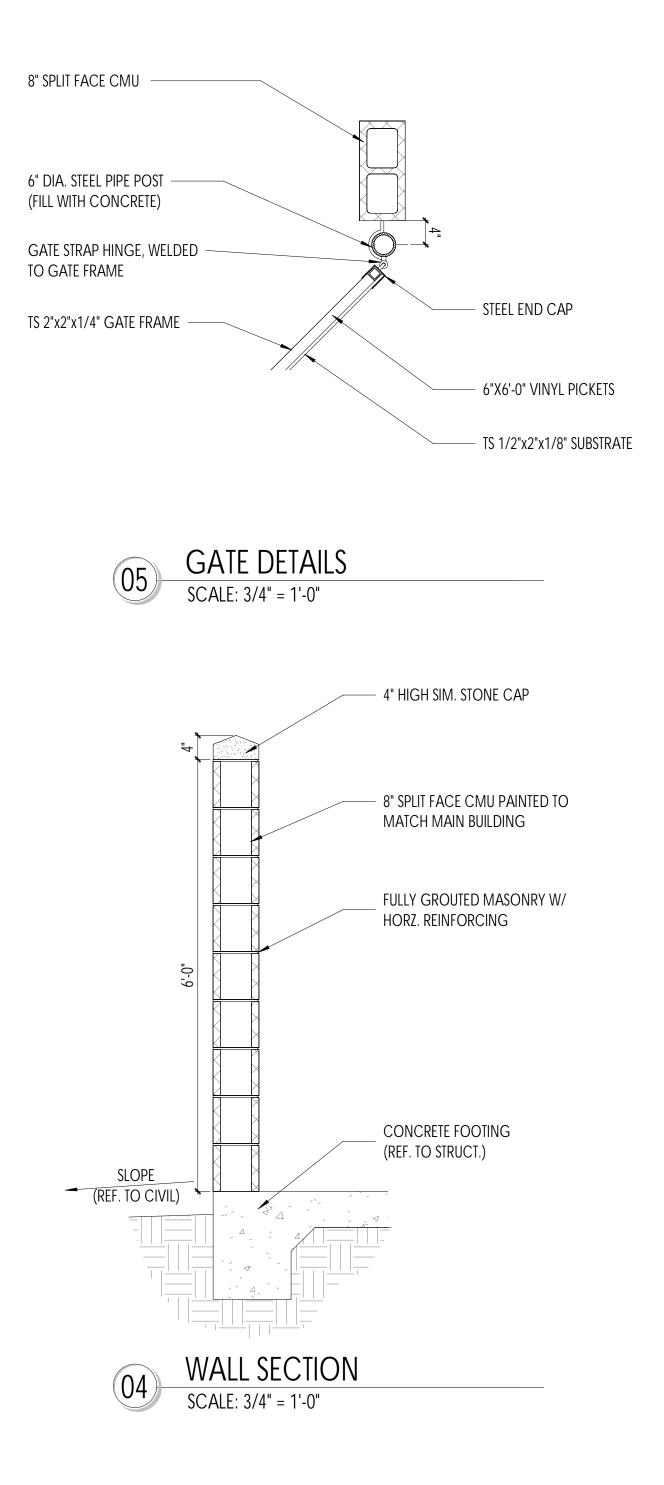


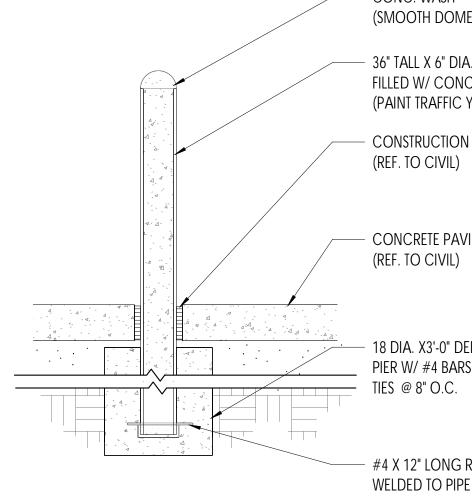BOLLARD DETAIL

SCALE: 3/4" = 1'-0"

07



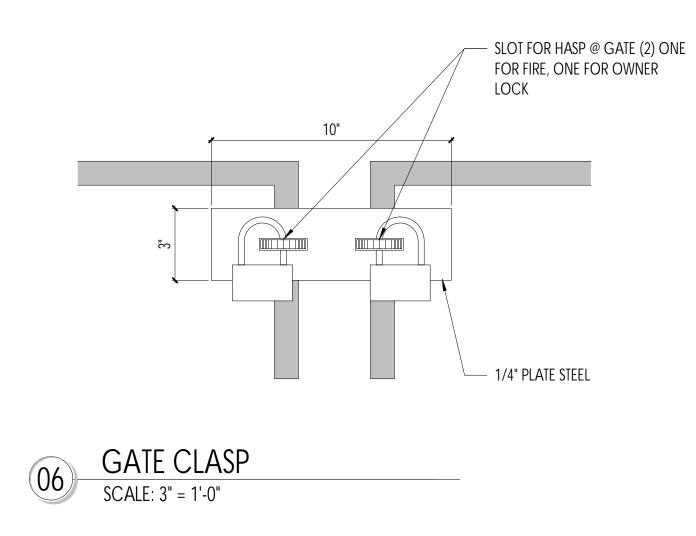


- CONC. WASH (SMOOTH DOME TYPE) — 36" TALL X 6" DIA. STEEL PIPE FILLED W/ CONC. (PAINT TRAFFIC YELLOW) - CONSTRUCTION JOINT

CONCRETE PAVING (REF. TO CIVIL)

— 18 DIA. X3'-0" DEEP CONC. _ PIER W/ #4 BARS VERT. & #3 TIES @ 8" O.C.

— #4 X 12" LONG RE-BAR WELDED TO PIPE (4 REQ'D)

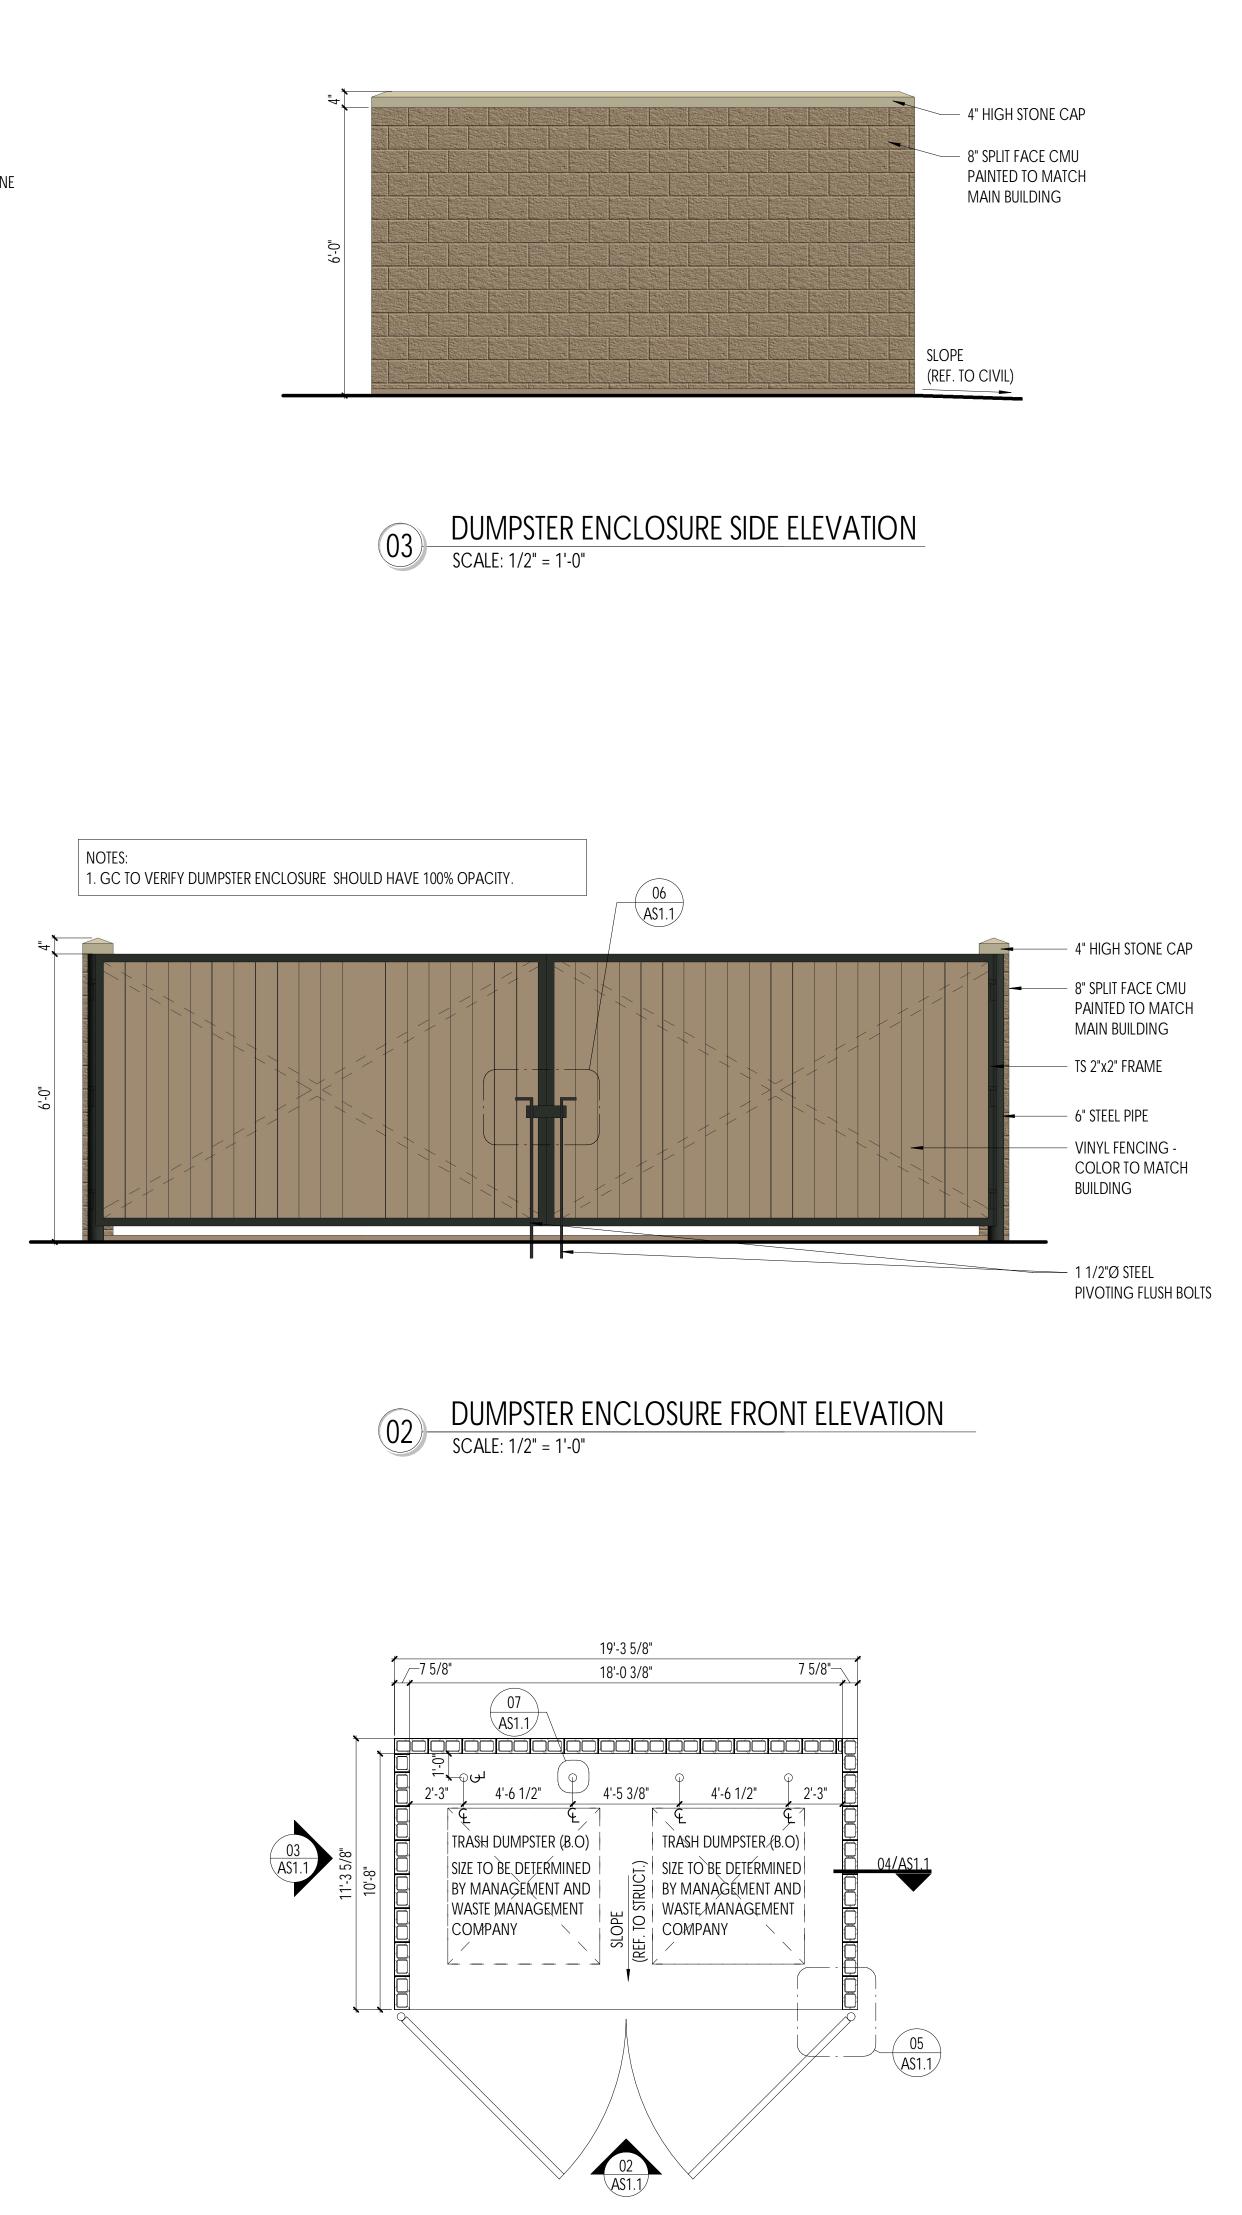

DUMPSTER ENCLOSURE PLAN SCALE: 1/4" = 1'-0" 01





LEE'S SUMMIT, MISSOURI

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Job Number: Issue Date:

Revisions: Revisions:

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Site and Trash Enclosure Details

AS1.1


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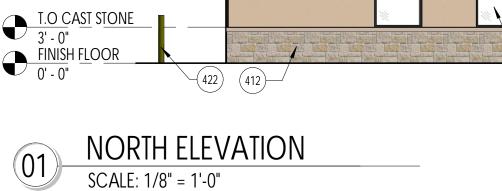
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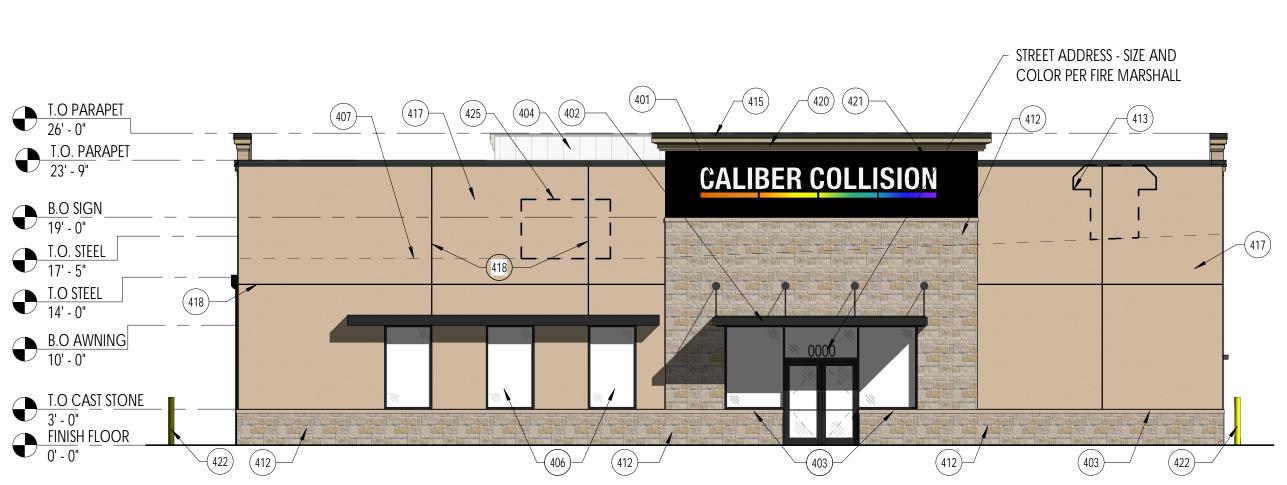


Sheet Number:







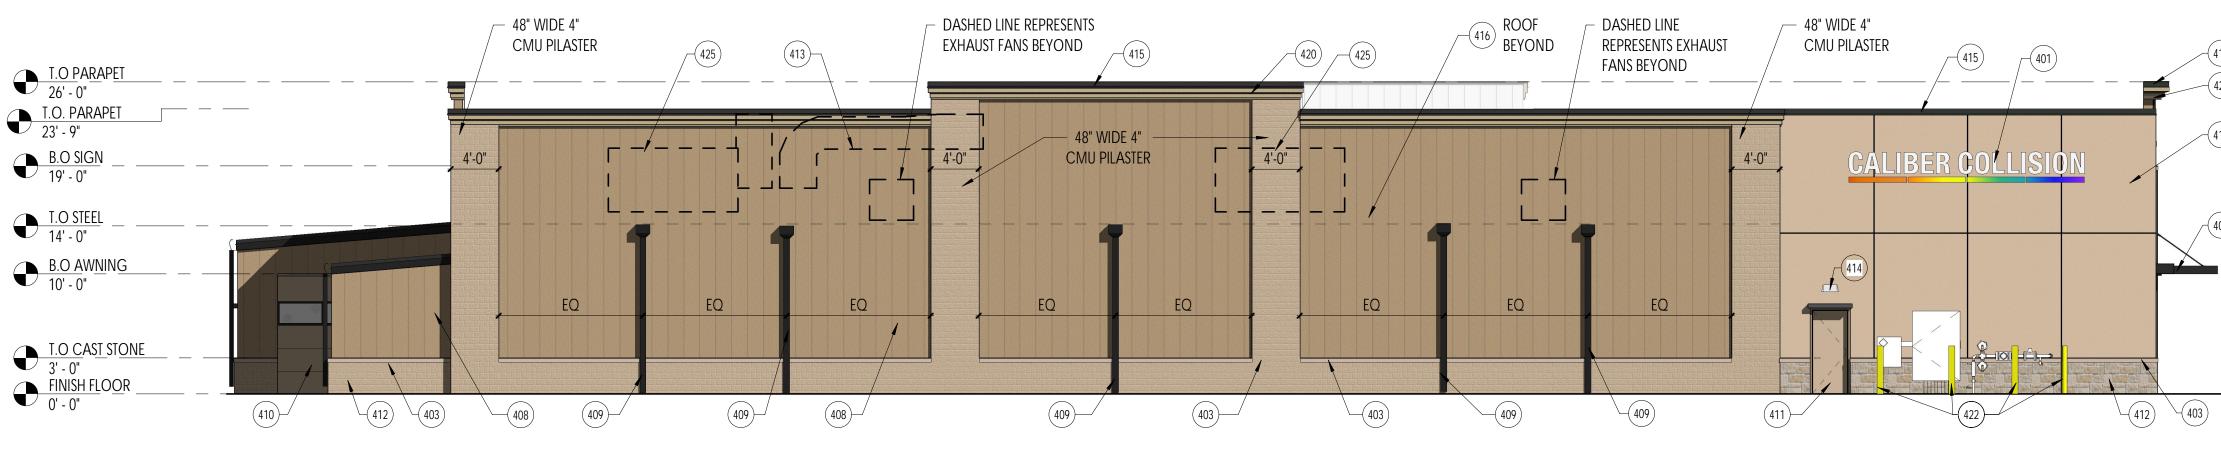

FACADE DIRECTION	EAST DIRECTION	WEST DIRECTION	NORTH DIRECTION	SOUTH DIRECTION
Metal (Panel, Coping, Frames, and Doors) Sq. ft.	36.39	248.69	93.27	497.7
PERCENTAGE (%)	2.80%	7.22%	4.64%	18.00%
STONE SQ. FT.	74.12	2.31	482.7	0
PERCENTAGE (%)	2.15%	0.07%	24.00%	0%
CAST STONE SQ. FT.	50.6	44.14	37.28	32.55
PERCENTAGE (%)	1.47%	1.28%	1.85%	1.18%
EIFS SQ. FT.	109.19	139.54	172.35	80.5
PERCENTAGE (%)	3.17%	4.03%	8.57%	2.91%
glazing sq. ft.	0	28.61	177	65.82
PERCENTAGE (%)	0%	0.83%	8.80%	2.38%
3 STEP STUCCO SQ. FT.	618.92	13.05	1048.3	0
PERCENTAGE (%)	17.98%	0.38%	52.13%	0%
STUCCO PANEL SQ. FT.	1874.16	2298.15	0	1811.91
PERCENTAGE (%)	54.46%	66.43%	0%	65.54%
CMU SQ. FT.	618.22	642.13	0	276.21
PERCENTAGE (%)	17.96%	18.56%	0%	9.99%
LOUVERS SQ. FT.	0	42	0	0
PERCENTAGE (%)	0%	1.21%	0%	0%
TOTAL SQ. FT.	3441.61	3459.62	2010.9	2764.6
TOTAL PERCENTAGE	100%	100%	100%	100%

FINISH KEY	DESCRIPTION	LOCATION	MANUFACTURER	PRODUCT COLOR	IDENTIFICATION/ FINISH/ STYLE	CONTACT
AL-2	STOREFRONT SYSTEM	OFFICE EXTERIOR	KAWNEER OR APPROVED EQUAL	DARK ANODIZED BRONZE	2" X 4-1/2" ALUMINUM FRAME	N/A
CS-1	CAST STONE (REF. ELEV)	OFFICE EXTERIOR	CORONADO STONE/ EL DORADO STONE	CORONADO- OFF WHITE EL DORADO- BUCKSKIN	REFER TO SPECS-047300	N/A-SAMPLE TO BE PROVIDED BY GC
CP-1	CUSTOM CANOPY	LOBBY ENTRANCE	ARCHITECTURAL FABRICATORS	DARK BRONZE	HELIOS 399 X 446	ARCH. FABRICATORS 1-800-962-8027
EF-4	EXTERIOR BANDING	-	SHERWIN WILLIAMS	TRICORN BLACK	-	BRETT C. HUCKLEBURY 214-728-6696
GR-2	EXTERIOR MASONRY MORTAR	-	SGS-SOLOMON COLORS INC.	10X BUFF	TYPE S MORTAR	BART SNOWDEN 214-794-9159
M-1	EXTERIOR MASONRY	-	GC TO PROVIDE LOCAL ALTERNATE OR APPROVAL	CORONADO- TEXAS CREAM EL DORADO- AUSTIN CREAM	CORONADO STONE/ EL DORADO STONE REFER TO SPECS-047300	N/A
PT-3	EXTERIOR DOOR PAINT	-	SHERWIN WILLIAMS	NOMADIC DESERT	SW 6107	BRETT C. HUCKLEBURY 214-728-6696
PT-7	Exterior finish		SHERWIN WILLIAMS	NOMADIC DESERT	SW 6107	BRETT C. HUCKLEBURY 214-728-6696
PT-9	EXTERIOR CORNICE	-	DRYVIT	BAVARIAN WOOD #448	SAND PEBBLE	N/A
MTL-1	MTL. ROOFING	SHOP ROOF	METL-SPAN	SOLAR WHITE	PREM. WEATHER XL E0.85 SRI:76	METL-SPAN 877-585-9969
MTL-2	RAKE, GUTTER, TRIM	EXTERIOR	METL-SPAN	BURNISHED SLATE	PREM. WEATHER XL E:0.86 SRI:25	METL-SPAN 877-585-9969
PNL-1	ARCHITECTURAL WALL PANEL	SHOP EXTERIOR PANEL	STRUKTUROC	SADDLE TAN	STUCCO TEXTURED ARCHITECTURAL PANEL	STRUKTUROC, INC. 952-884-7694

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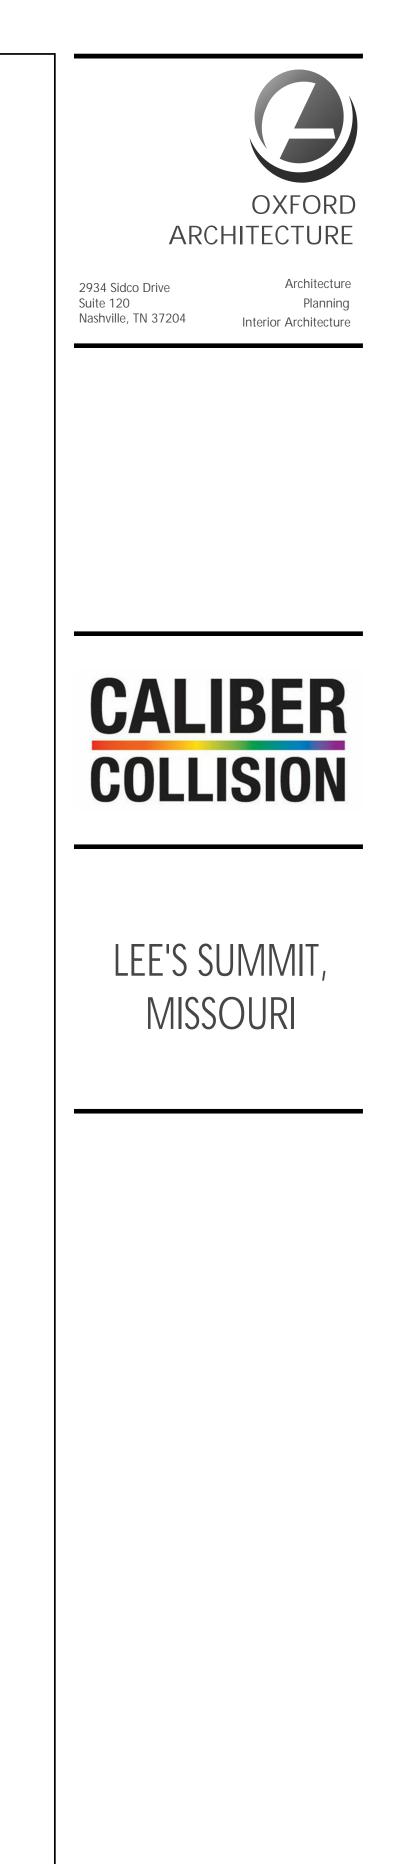
KEYNOTES:

- 401 SIGNAGE (BY OTHERS)-PROVIDE 3/4" PLYWD. BACKING (SEPARATE PERMIT).
- 402 PREMANUFACTURED MTL. AWNING W/ TIE RODS BY G.C. 403 SYNTHETIC STONE SILL/WATER TABLE. REFER TO SPECS.
- 404 PARAPET BACK PANEL (SOLAR WHITE COLOR).
- 405 MTL. GUTTER-PROVIDED BY MTL. BUILDING PROVIDER AND INSTALLED BY GC.
- 406 STOREFRONT / GLAZING (AL-2).
- 407 ROOFLINE BEYOND.
- 408 STRUKTUROC STUCCO TEXTURED ARCHITECTURAL METAL PANEL (PNL-1). 409 PRE-FINISHED 6"x4" D (SQUARE) METAL DOWNSPOUT (BURNISHED SLATE)-PROVIDED BY MTL. BUILDING SUPPLIER AND INSTALLED BY GC.
- 410 FACTORY FINISHED SECTIONAL OH DOOR (PT-3).
- 411 HOLLOW MTL. DOOR (PT-3) AND FRAME (SADDLE TAN). PROVIDE DRIP CAP OVER DOORS WITH NO OVERHEAD COVER.
- 412 SYNTHETIC STONE VENEER (M-1). 413 EXHAUST AND AIR INTAKE, REF. PAINT BOOTH SHEETS.
- 414 WALL MOUNTED LIGHT FIXTURE, REF. MEP.
- 415 PRE-FINISHED MTL. COPING (MTL-2) PROVIDED BY MTL. BUILDING SUPPLIER AND INSTALLED BY GC.
- 416 METAL BUILDING STANDING SEAM ROOFING (MTL-1). 417 3 STEP STUCCO INTEGRATED COLOR (PT-3).
- 418 CONTROL JOINT
- 419 WALL LOUVER, (CLEAR ANODIZED FINISH) REF. MEP
- 420 EIFS CORNICE. (PT-9).
- 421 EIFS ACCENT BANDING-PAINT TO MATCH SW6258 TRICORN BLACK (EF-4). 422 BOLLARDS.
- 423 PRE-FINISHED METAL BUILDING "R" PANEL ROOFING.
- 424 SPLIT FACE C.M.U COLOR TO MATCH (PT-7) LIGHT STONE.
- 425 DASH LINE REPRESENTS ROOF TOP UNIT BEYOND.

GENERAL NOTE

- DOWNSPOUTS ARE INDICATED FOR SIZE, QUANTITY, AND APPROXIMATE LOCATION ONLY.
- HOLLOW METAL STEEL DOORS, FRAMES, EXPOSED METAL FLASHING AND EXPOSED MISCELLANEOUS STEEL SHALL MATCH ADJACENT BUILDING COLOR UNLESS NOTED OTHERWISE. IF THERE ARE TWO ADJACENT COLORS AT THE DOOR LOCATIONS CONTRACTOR TO USE THE BASE OF THE BOTTOM FINISH FOR THE ENTIRE DOOR.
- SIGNAGE SHALL BE PERMITTED SEPARATELY.
- REFER TO THIS SHEET FOR FINISHES AND MATERIALS.
- PAINT EXPOSED STEEL BEAMS IN STORAGE AREA.
- MECHANICAL SCREENING TO MATCH THE ROOF MATERIAL.
- THE LIGHT SOURCE FOR EXTERIOR FIXTURES SHALL NOT PROJECT BELOW THE OPAQUE HOUSING SELECTED. NO FIXTURE SHALL DIRECTLY PROJECT LIGHT HORIZONTALLY.





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TBD Job Number: TBD Issue Date: Revisions: Revisions:

Revisions: Revisions: Revisions:

Exterior Elevations (Colored)

Sheet Number:



Symbol	Label	Quantity	Manufacturer	Catalog Number	Description	Number Lamps	Lumens Per Lamp	Light Loss Factor
	Α	5	EATON - McGRAW- EDISON (FORMER COOPER LIGHTING)	GLEON-AF-03-LED-E1- SL4-HSS	GALLEON AREA AND ROADWAY LUMINAIRE (3) 70 CRI, 4000K, 1050mA LIGHTSQUARES WITH 16 LEDS EACH AND TYPE IV SPILL LIGHT ELIMINATOR OPTICS WITH HOUSE SIDE SHIELD	48	314	1
	В	4	COOPER LIGHTING SOLUTIONS - McGRAW- EDISON (FORMERLY EATON)	IST-SA1A-740-U-SL2	IMPACT ELITE LED TRAPEZOID LUMINAIRE (1) 70 CRI, 4000K, 350mA LIGHTSQUARE WITH 16 LEDS AND TYPE II SPILL LIGHT ELIMINATOR OPTICS	16	171	1
	С	2	COOPER LIGHTING SOLUTIONS - McGRAW- EDISON (FORMERLY EATON)	IST-SA1D-740-U-SL4	IMPACT ELITE LED TRAPEZOID LUMINAIRE (1) 70 CRI, 4000K, 800mA LIGHTSQUARE WITH 16 LEDS AND TYPE IV SPILL LIGHT ELIMINATOR OPTICS	16	345	1
	D	4	EATON - McGRAW- EDISON (FORMER COOPER LIGHTING)	GLEON-AF-02-LED-E1- 5WQ	GALLEON AREA AND ROADWAY LUMINAIRE (2) 70 CRI, 4000K, 1050mA LIGHTSQUARES WITH 16 LEDS EACH AND TYPE V WIDE OPTICS	32	410	1

Description	Symbol	Avg	Max	Min	Max/Min	Avg/Min
SITE	+	1.1 fc	5.7 fc	0.0 fc	N/A	N/A
100' BEYOND PROP LINE	+	0.0 fc	0.8 fc	0.0 fc	N/A	N/A

166 20.1 45.2 113

+0.0 ⁺ +0.0 ⁺ 0.0 ⁺ 0 +0.0 $\left(\begin{array}{c} +1.8 \\ +4.2 \\ +3.5 \\ +2.8 \\ +2.1 \\ +1.8 \\ +1.5 \\ +1.5 \\ +1.5 \\ +1.5 \\ +1.5 \\ +1.5 \\ +1.5 \\ +1.5 \\ +1.5 \\ +1.4 \\ +1.3 \\ +1.1 \\ +0.9 \\ +0.7 \\ +0.6 \\ +0.5 \\ +0.4 \\ +0.6 \\ +0.4 \\ +0.4 \\ +0.4 \\ +0.4 \\ +0.4 \\ +0.4 \\ +0.4 \\ +0.6 \\ +1.0 \\ +1.2 \\ +1.3 \\ +1.5 \\ +1.7 \\ +2.8 \\ +1.7 \\ +2.8 \\ +1.5$ C @ 15 0.0 \$+0.1 \$+0.1 \$+0.1 \$+0.5 \$+0.6 \$+0.6 \$+0.7 \$+0.7 \$+0.7 \$+0.7 \$+0.8 \$+0.8 \$+0.9 \$+1.0 \$+1.2 \$+1.8 08 PROPOSED CALIDER +0.1 +0.1 +0.2 +0.3 +0.3 +0.4 +0.5 +0.6 +0.6 +0.6 +0.6 +0.6 +0.6 +0.6 +0.6 +0.6 +0.7 +0.8 +0.9 +1.0 +0.8CALLISION 18,582 SF. 0.1 +0.2 +0.3 +0.4 +0.4 +0.5 +0.6 +0.7 +0.7 +0.7 +0.7 +0.7 +0.7 +0.7 +0.6 +0.6 +0.6 +0.7 +0.8 +1.0 #1,0 +1.2 FFE:10H.S +0,1 +0.7 +1.0 +1.0 +0.9 +0.8 +0.9 +0.9 +0.9 +0.9 +0.9 +0.9 +0.8 +0.8 +0.7 +0.7 +0.7 +0.6 +0.7 +0.9 +1.3 +2.3 +4.0 +3.4 +2.7 +2.2 +1.8 +1.5 +1.6 +1.7 +1.7 +1.8 +1.6 +1.3 +1.0 +0.9 +0.8 +0.9 +1.1 +2.0 +4.8 B = 10^{-1} $\begin{array}{c} +0.0 & +$ ⁺+1.3 ⁺4.2 ⁺3.4 ⁺2.7 ⁺2/1 ⁺1.6 ⁺1/3 ⁺1.1 ⁺1.0 $0^{+}0.0^{+}0.0^{+}0.0^{+}0.0^{+}0.0^{+}0.0^{+}0.0^{+}0.0^{+}$ $\begin{array}{c} + 0.0 &$ ⁺0.0 ⁺0.0 ⁺0.0 $\begin{array}{c} +0.0 \\ +$ $0, t_{0.0}, t_{0.0}$ +0.0 +0.0 +0.0 +0.0 +0.0 +0.0 +0.0 +0.0 +0.0 +0.0 +0.0 +0.1 $\begin{array}{c} + 0.0 \\ - 0.0 \\ - 0.0 \\ - 0.0 \\ - 0.0 \\ - 0.0 \\ - 0.0 \\ - 0.0 \\ - 0.0 \\ - 0.1 \\ - 0.1 \\ - 0.1 \\ - 0.1 \\ - 0.1 \\ - 0.1 \\ - 0.2 \\ - 0.3 \\ - 0.4 \\ - 0.3 \\ - 0.4 \\ - 0.3 \\ - 0.4 \\ - 0.5 \\ - 0.7 \\ - 0.7 \\ - 0.8 \\ - 0.9 \\$ $\begin{array}{c} +0.0 & +$ to 0, ⁺0.0 ⁺0.0 ⁺0.0 ⁺0.0 ⁺0.0 ⁺0.0 ⁺0.0 ⁺0.0 ⁺0.1 ⁺0.1 ⁺0.1 ⁺0.1 ⁺0.2 ⁺0.2 ⁺0.2 ⁺0.2 ⁺0.3 ⁺0.3 ⁺0.3 ⁺0.2 ⁺0.2 ⁺0.2 ⁺0.2 ⁺0.1 ⁺ ⁺0.0 ⁺0.1 ⁺ ^{--±}00 --[±]00 ⁺00 ⁺00 ---[±]0:0 ⁺0.0 ⁺0.0

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Designer Date 07/12/2021 Scale Not to Scale Drawing No. Summary

.0	+0.0	+0.0	+0.0	+0.0	+0.0	+0.0	+0.0	+0.0	+0.0	+0.0	+0.0	+0.0	+0.0	+0.0	+0.0	+0.0	+0.0	+0.0
.0	+0.0	+0.0	+0.0	+0.0	+0.0	+0.0	+0.0	+0.0	+0.0	+0.0	+0.0	+0.0	+0.0	+0.0	+0.0	+0.0	+0.0	+0.0
.0	+0.0	+0.0	+0.0	+0.0	+0.0	+0.0	+0.0	+0.0	+0.0	+0.0	+0.0	+0.0	+0.0	+0.0	+0.0	+0.0	+0.0	+0.0
.0	+0.0			+0.0	+0.0	+0.0	+0.0	+0.0	+0.0	+0.0	+0.0	+0.0	+0.0	+0.0	+0.0	+0.0	+0.0	+0.0
		[[]] 0.0			+0.0	+0.0	+0.0	+0.0	+0.0	+0.0	+0.0	+0.0	+0.0	+0.0	+0.0	+0.0	+0.0	+0.0
.0	+0.0			+0.0	+0.0	+0.0	+0.6		+0.0	+0.0	+0.0	+0.0	+0.0	+0.0	+0.0	+0.0	+0.0	+0.0
	0.0		+0.0	↓ + 0.0		+0.0		4004380 ⁴ 0.0		+0.0	+0.0	+0.0	⊥ ⁺ 0.0		+0.0	+0.0	+0.0	+0.0
			+0.0	+0.0	+0.0	+0.0	+0.0	+0.0	+0.0	+0.0					+0.0	+0.0	+0.0	+0.0
.0	+0.0	+0.0	+0.0	+0.0	+0.0	+0.0	+0.0	+0.0	+0.0	+0.0	+0.0		⁼⁺ 0.0	+0.0	+0.0	+0.0	+0.0	+0.0
.0	+0.0	+0.0	+0.0	+0.0	+0.0	+0.0	+0.0	+0.0	+0.0	+0.0	+0.0	+0.0	+0.0	+0.0	+0.0	+0.0	+0.0	+0.0
	中四伯目		0.0	0.0			0.0		+0.0	+0.0	+0.0	+0.0	+0.0	+0.0	+0.0	+0.0	+0.0	+0.0
0.0	+0.0	+0.0	⁺ 0.0	+0.0	+0.0	+0.0	+0.0	+0.0	+0.0	+0.0	+0.0	+0.0	•0.0 = +0.0	+0.0	+0.0	+0.0	+0.0	+0.0
!'E-	⊐ ₽Ţ + 0.0	₩5] + <mark>0.0</mark>	+0.0	+0.0-	+0.0	+0.0	+0.0	+d.d	0.0 ⁺	+0.0	+0.0			0.0		+0.0	+0.0	+0.0
.0	+ 0.0	+0.0	⁺ 0.0	+ 0.0	+ 0.0	+0.0	+0.0	+00	+0.0	0.0 -∆dagri ⊓† a j a aa		+0.0	+0.0	+0.0	+0.0	+0.0	+0.0	+0.0
.1 ⊌π	+ 0.0	1,077 2 0.0 Tentes	+0.0	+ 0.0	+ 0.0	+0.0	+0.0	+0.0	+0.0	+0.0	+0.0	+0.0	+0.0	+0.0	+0.0	+0.0	+0.0	+0.0
		1.900 0.1 1.61 Trust		⁺ 0.0	⁺ 0.0	+ 0.0	+0.0	+0.0										
				⁺ 0.1	⁺ 0.0	+0.0	+0.0		⁺ 0.0/	+0.0	⁺ 0.0	⁺ 0.0	⁺ 0.0	⁺ 0.0	⁺ 0.0	⁺ 0.0	+0.0	+0.0
_	223.5	2015F.	+0.8	+24	+0.2	+0.1	+0.0		/'0.0	⁺ 0.0	+0.0	+0.0	+0.0	⁺ 0.0	⁺ 0.0	⁺ 0.0	⁺ 0.0	+0.0
4	+4.1	4.3			+0.7	+0.3	+0.1	5	+0.0)		+0.0	+0.0	+0.0	+0.0	⁺ 0.0	⁺ 0.0	⁺ 0.0	+0.0
.6	3.8		*+3.2		(1.6)	+1.0	+0.3	K	0.0	Ê	+0.0	⁺ 0.0	+0.0	+0.0	+0.0	+ +	+ +	+0.0
.0	+3.1			2.8		⁺ 2,1	+0,5	P	0.0	⁺ 0.0	+0.0	+0.0	+0.0	⁺ 0.0	⁺ 0.0	⁺ 0.0	⁺ 0.0	+0.0
.0	2.5	+20	⊳ <u></u> 3.2		3.6	+3.5	+.)	[‡] 0.0	+0.0	⁺ 0.0	⁺ 0.0	+0.0	+0.0	+0.0	⁺ 0.0	⁺ 0.0	+0.0	'0.I
	+	+ 2.5	+2.9	+3.4	3.6 +	3.5 + 4.0	4	t o.o	⁺ 0.0	+0.0	⁺ 0.0	⁺ 0.0	⁺ 0.0	+0.0	⁺ 0.0	⁺ 0.0	⁺ 0.0	+0.0
		(DE A01		17	3.8 + 4.3	-#1	0.2	+0.1	⁺ 0.0	+0.0	+0.0	⁺ 0.0	⁺ 0.0	⁺ 0.0	⁺ 0.0	⁺ 0.0	⁺ 0.0	+0.0
.2	⁺ 1.7	⁺ 2.2	⁺ 3.0	+2.0		⁺ 4.3	"0.3 +	0.1	⁺ 0.0	+0.0	⁺ 0.0	+0.0	⁺ 0.0	⁺ 0.0	⁺ 0.0	⁺ 0.0	⁺ 0.0	+0.0
.0	+1.5	+2.0	+2.8	+3.9	+4.6	1.	*22		⁺ 0.0	⁺ 0.0	⁺ 0.0	⁺ 0.0	+0.0	+0.0	⁺ 0.0	⁺ 0.0	⁺ 0.0	+0.
9	1.4 +.	⁺ 1.9	⁺ 2.7	+3.5	+ <u>3.8</u>	⁺ 2.6/	+0.2	⁺ 0.1	⁺ 0.0	+0.0	⁺0.0 ⊄11A	⁺ 0.0 PRIAN	: 101 0.0 1 PTA 1		+0.0	⁺ 0.0	⁺ 0.0	+ 0 .
	+1.3	+ +	+2.6	±3.3	+4.2 +	+1.4	+0.1	⁺ 0.0	⁺ 0.0	⁺ 0.0 ∣[+0.0	+ <mark>0.0</mark> 1010E	+0.0	+0.0	⁺ 0.0	⁺ 0.0	⁺ 0.0	⁺ 0.
	⁺ 1.2	+1.6	+2.1	2.6	⁺ 2.6	+0.6	+0.1	⁺ 0.0	⁺ 0.0	+0.0	+0.0	# 0,0 99	: †010 ∎	TI 010	⁺ 0.0	⁺ 0.0	⁺ 0.0	+0.0
ľ	+0.9	⁺ 1.3	1.5	+1.7	*1 +4.	+0.3	+0.1	⁺ 0.0	+0.0	+0.0	⁺ 0.0	40-10-44 8 0::0 5 (1900)	Ů 0,0 ≌	N to: 0	⁺ 0.0	⁺ 0.0	⁺ 0.0	+0.0
-	+0.8	+1.0	+1.2	+1.3	1.1	40.6	+02	⁺ 0.0	⁺ 0.0	⁺ 0.0	⁺ 0.0	0.0	0.0	4189918 ⁺ 0.0	⁺ 0.0	⁺ 0.0	⁺ 0.0	+0.0
	+0.8	+1.1	+1.5	+1.7	+1.7	[†] 1.4	To 5	⁺ 0.1	0.0	10.0	+0.0	+0.0	⁺ 0.0	⁺ 0.0	⁺ 0.0	⁺ 0.0	⁺ 0.0	+0.0
6	⁺ 0.9	+1.3_	+1.8	+2.3	+2.7	⁺ 2.6	+ 6 B	0.1		+0.0	⁺ 0.0	⁺ 0.0	⁺ 0.0	⁺ 0.0	⁺ 0.0	⁺ 0.0	⁺ 0.0	+0.0
7	+1.1	+1.5-	+2.1	+2/8	+3.5	*4 .1	+0.8	0.1	0.1	+0.0	⁺ 0.0	⁺ 0.0	⁺ 0.0	+0.0	⁺ 0.0	⁺ 0.0	+0.0	+0.0
2	+1.5	+1.7-	+2.3	+ 3.2	+3.8	4.0	0.3	-0.2	¥0.1	⁺ 0.0	⁺ 0.0	⁺ 0.0	⁺ 0.0	⁺ 0.0	⁺ 0.0	⁺ 0.0	⁺ 0.0	+0.0
0	+1.9	1.9	2.9	4.2	+4.7	+ 4.7	K	0.2	0.1	⁺ 0.1	+0.0	+0.0	⁺ 0.0	⁺ 0.0	⁺ 0.0	⁺ 0.0	⁺ 0.0	+0.0
4	+1.9	+2.2	2.9	+3.8	+4.3	4.0	0 22	0.2	0.1	⁺ 0.1	+0.0	⁺ 0.0	⁺ 0.0	⁺ 0.0	⁺ 0.0	⁺ 0.0	⁺ 0.0	+0.0
4 0'	+2.2	+2.5	*3.1	+3.8	4.3	+2/1		0.2	0 .1	⁺ 0.1	⁺ 0.0	+0.0	⁺ 0.0	⁺ 0.0	⁺ 0.0	⁺ 0.0	⁺ 0.0	+0.0
0	72.3	+2.6	+3.0	*3.7	⁺ 4,2	+1.3	Ŕ	t0.2	0.1	- <mark>+</mark> 01-v	⊎ ⁺ 0.0	+0.0	+0.0	+ 0.0	+ 0.0	+ 0.0	+ 0.0	+ 0.0
1	+2.3	+2.5	+2.7	3.0	+2.6	0.9	0.4	0.2	N	» هجمه « ۳.۹۵۰ (Re 0.1		⁺ 0.0	⁺ 0.0	⁺ 0.0	⁺ 0.0	⁺ 0.0	⁺ 0.0	+0.0
4	2.1	+2.2	2.2	+2.0	+1.4	⁺ 0.7	0.4	0.3	+0.1	+0.1	+0.0	+0.0	+0.0	+0.0	+0.0	+0.0	+0.0	+0.0
1	+2.0	+1.9	1.7	1.3	1 0.9	⁺ 0.6	10.4	0.3		+0.1	+0.0	+0.0	+0.0	+0.0	+0.0	+0.0	+0.0	+0.0
8	+1.9	@ 22	+1.5	} 1.1−	+0.8	+0.6	+0,4	0.2	+0.1	+0.1	+0.0	+0.0	+0.0	+0.0	+0.0	+ 0.0	+0.0	+0.0
6 F	±1.6	⁺ 1.5	⁺ 1.3	⁺ 1.0	+0.7	+0.5	10.4	$\overline{\mathbb{O}}$	0.1	+0.1	+0.0	+0.0	+0.0	+0.0	+0.0	+0.0	+0.0	+0.0
2	⁺ 1.3	⁺ 1.2	+1.1	+0.9	+0.6	+0.5	10.3	0.2	0,1	+0.1	+0.0	+0.0	+0.0	+0.0	+0.0	+0.0	+0.0	+0.
9	⁺ 0.9	⁺ 0.9	- ⁺ 08	⁺ 0.7	⁺ 0.6	+0.4	+0.3	0.2	0.1	+0.1	+0.0	+0.0	+0.0	+0.0	+0.0	+0.0	+0.0	+0.
6	⁺ 0.6	+0.6	+0.6	+0.5	+0.5	+0.3	0.2	0.2 0.1	0.1	+0.0	+0.0	0.0 ⁺ 0.0	+0.0	+0.0	+0.0	+0.0	0.0 ⁺	+ 0.
5	⁺ 0.5	+0.4	+0.4	+0.4	+0.3	03	0.2	0.1	0.1	0.0 ⁺	0.0 ⁺	0.0 ⁺	0.0 ⁺	0.0 ⁺	0.0 +0.0	0.0 ⁺	0.0 ⁺	0. +0.
3	+ <mark>0.3</mark> ™™	+0.3	+0.3	+0.2	+0.2	+0.2	+0,1	Y	É	0.0 ⁺ 0.0	0.0 ⁺	0.0	0.0 ⁺	0.0 ⁺	0.0 ⁺	0.0 ⁺	0.0 ⁺	•0. +0.
	+0.2	+0.2	+0.2		⁺ 0.1	+0.1			0.1		0.0 +0.0	0.0 +0.0	0.0 +0.0	0.0 +0.0			0.0 +0.0	
4~~	+0.1	+0.1		+0.1	+0.1		0.1		0.0	+0.0					⁺ 0.0	+0.0		+0.
	0.1***			+	+0.0		0.1 ншя аб	+0.0		+0.0	R-D-V		+0.0	+0.0	⁺ 0.0	+0.0	⁺ 0.0	+0.
1				+0.0		+0.0	0.0 +0.0		+0.0	-d		±0,0≞		+0.0	+0.0	+0.0	⁺ 0.0	+0.
)	⁺ 0.0	+0.0	+0.0	+0.0	⁺ 0.0	+0.0	+0.0	+0.0	T EN			+0.0	+0.0	⁺ 0.0	⁺ 0.0	+0.0	⁺ 0.0	+0.
)	+ +	<u>+</u> 0.0	+0.0	+0.0	⁺ 0.0	+0.0	+0.0	+0.0		11+7 m 0.0	⁺ 0.0	+ +	⁺ 0.0	⁺ 0.0	⁺ 0.0	⁺ 0.0	⁺ 0.0	+0.
)		+0.0-			+0.0	+0.0		- ⁺ 0.0	+0.0	+0.0	⁺ 0.0	+0.0	⁺ 0.0	⁺ 0.0	⁺ 0.0	⁺ 0.0	+0.0	⁺ 0.
)	+0.0		⁺ 0.0	⁺ 0.0	+0.0	+0.0	+0.0	+0.0	⁺ 0.0	+0.0	+0.0	+0.0	⁺ 0.0	+0.0	+0.0	⁺ 0.0	⁺ 0.0	+0.
)	⁺ 0.0		+0.0	+0.0		+0.0	+0.0	⁺ 0.0	⁺ 0.0	⁺ 0.0	+0.0	⁺ 0.0	⁺ 0.0	⁺ 0.0	⁺ 0.0	⁺ 0.0	⁺ 0.0	+0.0
)	⁺ 0.0	⁺ 0.0	⁺ 0.0	⁺ 0.0	⁺ 0.0	+0.0	+0.0	⁺ 0.0	⁺ 0.0	⁺ 0.0	⁺ 0.0	⁺ 0.0	⁺ 0.0	⁺ 0.0	⁺ 0.0	⁺ 0.0	⁺ 0.0	+0.0
0	⁺ 0.0	⁺ 0.0	⁺ 0.0	⁺ 0.0	⁺ 0.0	⁺ 0.0	⁺ 0.0	⁺ 0.0	⁺ 0.0	⁺ 0.0	⁺ 0.0	⁺ 0.0	⁺ 0.0	⁺ 0.0	⁺ 0.0	⁺ 0.0	⁺ 0.0	+0.0
	⁺ 0.0	⁺ 0.0	⁺ 0.0	⁺ 0.0	⁺ 0.0	+0.0	⁺ 0.0	+0.0	⁺ 0.0	⁺ 0.0	⁺ 0.0	⁺ 0.0	⁺ 0.0	⁺ 0.0	+0.0	+0.0	⁺ 0.0	+0.0
0														+	+	+		+0.0
	+0.0	⁺ 0.0	+0.0	+0.0	+0.0	+0.0	+0.0	+0.0	⁺ 0.0	+0.0	+0.0	⁺ 0.0	⁺ 0.0	⁺ 0.0	⁺ 0.0	⁺ 0.0	⁺ 0.0	0.1