
FINAL DEVELOPMENT PLAN STORAGE MART 156

LOCATION MAP

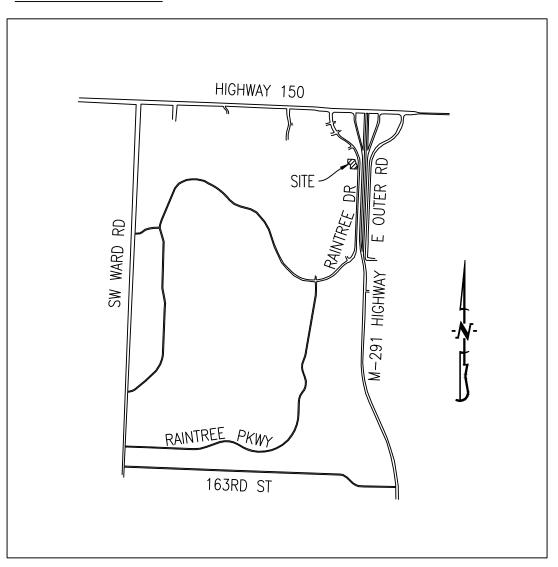

PROJECT BENCHMARK:

TBM #1 — CHISELED MARKINGS ON EAST SIDE OF MANHOLE RIM LOCATED APPROX. 70' NORTHEAST OF THE NORTHEAST CORNER OF PROJECT SITE.

TBM #2 - SANITARY SEWER MANHOLE RIM LOCATED APRROX. 44' NORTHWEST OF THE SOUTHEAST CORNER OF ELEVATION = 980.20

TBM #3 - WATER VALVE LOCATED AT THE NORTHEAST CORNER OF PROJECT SITE.

ELEVATION = 984.12

WATER:

CITY OF LEE'S SUMMIT

1200 SE HAMBLEN ROAD

LEE'S SUMMIT. MO 64081

SANITARY SEWER:

DEPARTMENT OF PUBLIC WORKS

CITY OF LEE'S SUMMIT

220 SE GREEN STREET LEE'S SUMMIT, MO 64063

130 SE HAMBLEN ROAD

LEE'S SUMMIT, MO

816-347-4320

816-969-1800

ELECTRIC:

KCP&L

816-969-1900

WATER UTILITIES DEPARTMENT

FLOOD PLAIN STATEMENT:

A PART OF THIS TRACT IS LOCATED WITHIN THE 100-YEAR FLOODPLAIN AS PER THE FEMA FIRM PANEL NUMBER 29095C0532G, DATE JANUARY 20, 2017. THIS SITE DRAINS TO TRIBUTARY G1 TO LAKE WINNEBAGO.

LEGAL DESCRIPTION:

LOT 2A AND LOT 3A, SOUTH M-291 SAFETY MINI STORAGE LOTS 1A, 2A & 3A, RECORDED INSTRUMENT NO. 2006D0028581. A SUBDIVISION IN LEE'S SUMMIT, JACKSON COUNTY.

UTILITY COMPANIES:

LOCATES:

MISSOURI ONE CALL INC. 1022 B NORTHEAST DRIVE JEFFERSON CITY, MO 65109 1-800-344-7483

TELEPHONE:

AT&T 215 N. SPRING INDEPENDENCE, MO 816-325-5610

NATURAL GAS: SPIRE INC.

3025 SE CLOVER ROAD LEE'S SUMMIT, MO 816-969-2266

CABLE TELEVISION:

TIME WARNER 6550 WINCHESTER AVENUE KANSAS CITY, MO 913-643-1901

GENERAL NOTES:

THE CITY OF LEE'S SUMMIT UDO & DESIGN & CONSTRUCTION MANUAL SHALL GOVERN OVER THESE PLANS AND SPECIFICATIONS.

ALL UTILITY CONSTRUCTION SHALL BE IN ACCORDANCE WITH THE CITY OF LEE'S SUMMIT DESIGN & CONSTRUCTION MANUAL. CONTRACTOR TO HAVE A COPY OF THE CITY'S LATEST EDITION OF SPECIFICATIONS AND STANDARDS FOR ALL STREET, STORM, AND SANITARY CONSTRUCTION ON SITE AT ALL TIMES DURING CONSTRUCTION.

CONTRACTOR WILL BE RESPONSIBLE FOR PLACEMENT AND MAINTENANCE OF TRAFFIC CONTROL DEVICES NECESSARY TO COMPLETE THEIR PORTION OF WORK. THE DEVICES AND METHODS EMPLOYED WILL COMPLY WITH THE CURRENT VERSION OF THE MANUAL ON UNIFIED TRAFFIC CONTROL DEVICES.

THIS TRACT CONTAINS APPROXIMATELY 1.27 ACRES.

EXISTING UTILITIES SHOWN FOR REFERENCE ONLY. CONTRACTOR SHALL COORDINATE LOCATES (HORIZONTAL AND VERTICAL) PRIOR TO

ALL EXCAVATION TO BE IN ACCORDANCE WITH SECTIONS 319.010-319.050. REVISED STATUTES OF THE STATE OF MISSOURI. SUCH COMPLIANCE SHALL NOT, HOWEVER, EXCUSE ANY PERSON MAKING ANY EXCAVATION FROM DOING SO IN A CAREFUL AND PRUDENT

A GEOTECHNICAL EVALUATION OF THE SUBSURFACE SOIL, GROUNDWATER CONDITIONS, AND A SLOPE STABILITY ANALYSIS HAS BEEN PERFORMED BY CROCKETT GEOTECHNICAL. REFER TO REPORT NUMBER: G18353. THE OWNER SHALL SATISFY THEMSELVES OF ALL GEOTECHNICAL CONDITIONS PRIOR TO ANY CONSTRUCTION.

ALL LAND DISTURBANCE ACTIVITIES SHALL BE IN ACCORDANCE WITH CITY OF LEE'S SUMMIT CODE OF ORDINANCES.

ANY FILL PLACEMENT WITHIN STREET RIGHT-OF-WAY SHALL BE INSPECTED BY THE CITY OF LEE'S SUMMIT AND MODOT.

REFER TO STORMWATER POLLUTION PREVENTION PLAN (SWPPP) FOR NARRATIVE REPORT AND BMP DESCRIPTIONS AND DETAILS.

ALL SLOPES ARE 3:1 OR FLATTER UNLESS OTHERWISE NOTED.

IT IS THE INTENT OF THESE PLANS TO COMPLY WITH THE REQUIREMENTS OF THE MoDNR CLEAN WATER COMMISSION.

ALL DISTURBED AREAS WITHIN THE "LIMITS OF DISTURBANCE" SHALL BE FINE GRADED, SEEDED, AND MULCHED.

THE CONTRACTOR IS RESPONSIBLE FOR MAINTAINING ALL EROSION CONTROL DEVICES AND REMOVING THEM ONCE THE SITE IS STABILIZED.

ALL SERVICE LATERALS SHALL BE INSTALLED AS PER CITY OF LEE'S SUMMIT REQUIREMENTS AT 2.0% (MIN.) GRADE.

ALL EXCAVATION WITHIN THE STREET RIGHT-OF-WAY SHALL BE BACKFILLED PER CURRENT CITY OF LEE'S SUMMIT AND MODOT SPECIFICATIONS.

ALL SEWERLINES SHALL BE CONSTRUCTED AT LEAST 10 FEET HORIZONTALLY, EDGE TO EDGE, FROM ANY WATERLINE AND AT LEAST 24 INCHES VERTICALLY BETWEEN THE OUTSIDE LIMITS OF THE SANITARY SEWER AND WATERLINE. FOR CONDITIONS OTHER THAN THOSE IDENTIFIED ABOVE, CONTACT THE ENGINEER FOR SPECIFIC INSTRUCTIONS.

ALL STORM SEWER PIPE SHALL BE INSTALLED PER MANUFACTURER'S RECOMMENDATIONS. REFER TO DETAIL FOR PIPE BEDDING

IN ORDER TO TERMINATE A STATE OPERATING PERMIT THE MISSOURI DEPARTMENT OF NATURAL RESOURCES (MDNR) REQUIRES THAT THE PERMITTEE SUBMIT A COMPLETED FORM H (INCLUDED WITH THE APPROVAL PERMIT) TO THE MDNR. A PERMIT IS ELIGIBLE FOR TERMINATION WHEN EITHER PERENNIAL VEGETATION, PAVEMENT, BUILDINGS, OR STRUCTURES USING PERMANENT MATERIALS COVER ALL AREAS THAT HAVE BEEN DISTURBED. VEGETATIVE COVER SHALL BE AT LEAST 70% OF FULLY ESTABLISHED PLANT DENSITY OVER 100% OF THE DISTURBED AREA. A COPY OF FORM H SHOULD BE SUBMITTED TO THE CITY AT WHICH TIME THE CITY WILL REMOVE THE PROJECT FROM ITS INSPECTION SCHEDULE.

LAND DISTURBANCE SITES SHOULD BE INSPECTED ON A REGULAR SCHEDULE AND WITHIN A REASONABLE TIME PERIOD (NOT TO EXCEED 48 HOURS) FOLLOWING HEAVY RAINS. REGULARLY SCHEDULED INSPECTIONS SHALL BE AT A MINIMUM OF ONCE PER WEEK. ANY DEFICIENCIES SHALL BE NOTED IN A WEEKLY REPORT OF THE INSPECTION AND CORRECTED WITHIN SEVEN CALENDAR DAYS OF THE REPORT. CONTRACTORS ARE REQUIRED TO SUBMIT TO CITY INSPECTION STAFF COPIES OF THEIR INSPECTION REPORTS REQUIRED BY THE STORMWATER POLLUTION PREVENTION PLAN (SWPPP) ON A MONTHLY BASIS.

NO OIL AND GAS WELLS EXIST ON THIS TRACT ACCORDING TO THE MISSOURI DEPARTMENT OF NATURAL RESOURCES OIL AND GAS PERMIT DATABASE. ALSO, NO PHYSICAL EVIDENCE EXIST THAT AN OIL AND/OR GAS WELL IS PRESENT ON THIS TRACT.

TOTAL DISTURBED AREA ON SITE = 1.27 AC.

MISSOURI DNR LAND DISTURBANCE PERMIT NUMBER MORA14456.

REVISION KEY			£		2	က	4	55	<u>=</u> 6	<u> </u>	:8	တ	10	=	12	13		ğ	<u> </u>
REV#	DATE	COMMENTS	COVER	E E	뜅	뜅	뜅	뜅	핑	Œ	CE 8	CE 9	CE 10	Œ	30	CE 13	LSI	EL001	EL101
	8/26/2019	ORIGINAL SUBMITTAL	Х	Х	Χ	Χ	Х	Χ	Χ	Χ	Χ	Χ	Χ	Χ	X	X	Χ	Х	X
\triangle	9/27/2019	CITY COMMENTS	Х		Х	Χ	Х	Х	Х	Χ	Χ		Χ				Χ		
2	11/22/2019	CITY COMMENTS	Х		Χ	Χ	Х	Χ	Χ								Χ		
3	01/16/2020	CITY COMMENTS	Х			Χ	Х	Χ											

SHEET INDEX:

CE 1 - DEMOLITION PLAN

CE 2 - EROSION CONTROL PLAN

CE 3 - GRADING PLAN

CE 4 - UTILITY PLAN

CE 5 - STORM SEWER PROFILE - LINES 1, 2, 3 & 4 & STORM SEWER DETAILS

CE 6 - SITE PLAN

CE 7 - SITE CONSTRUCTION DETAILS

CE 8 - ACCESSIBLE PARKING, SANITARY SEWER & SECURITY FENCE DETAILS

CE 9 - STORM SEWER DETAILS

CE 10 - SECURITY FENCE DETAILS

CE 11 - SECURITY GATE DETAILS

= = = = Existing curb

MINIMUM FINISH FLOOR OF STRUCTURE

EXISTING LIGHT POLE

EXISTING GUY WIRE

LEGEND OF SYMBOLS:

OUTER STREAM BUFFER

	EXISTING CURB	FF=XXX.X	MINIMUM FINISH FLOOR OF STRUCTURE
	PROPOSED CURB	(XXX.XX TC)	PROPOSED TOP OF CURB ELEVATION
	RIP RAP	(XXX.XX TP)	PROPOSED TOP OF PAVEMENT ELEVATION
	EXISTING STRUCTURE	XXX.XX FG	PROPOSED FINISH GRADE ELEVATION
~~~~~	EXISTING TREELINE	(XXX.XX TW)	PROPOSED TOP OF WALL
~~~~	PROPOSED TREELINE	(XX)	LOT NUMBER
000	EDGE OF WATERWAY		
— — W — —	EXISTING WATERLINE	$\langle \chi \rangle$	STORM SEWER STRUCTURE LABEL
——— w ———	PROPOSED WATERLINE	V	CANITADY COMED CONTOURS LADS
—— G ——	EXISTING GAS LINE	(X)	SANITARY SEWER STRUCTURE LABEL
G	PROPOSED GAS LINE	H.P.	HIGH POINT
UT	EXISTING UNDERGROUND TELEPHONE	L.P.	LOW POINT
- $ -$ UTV $ -$	EXISTING UNDERGROUND CABLE TELEVISION		EXISTING SIGNS
- $-$ - HVE $ -$	EXISTING HIGH VOLTAGE ELECTRIC	Ø	EXISTING POWER POLE
—— OE ——	EXISTING OVERHEAD ELECTRIC	GV	EXISTING GAS VALVE
- $ -$ UE $ -$	EXISTING UNDERGROUND ELECTRIC	\bowtie	EXISTING WATER VALVE
——— OETV ———	EXISTING OVERHEAD ELEC. & TV	©	EXISTING GAS METER
— — OETVT — —	EXISTING OVERHEAD ELEC., TV & TELE.		EXISTING WATER METER
—— s ——	EXISTING SANITARY SEWER	₩ W	EXISTING FIRE HYDRANT
—— s ——	PROPOSED SANITARY SEWER	•	
XXX	EXISTING MINOR CONTOUR	©	MANHOLE EVICTING CANITARY SERVER LATERAL
$ \! \! \! \! \! \! \! \! \! \! \! \! \! \! \! \! \!$	EXISTING MAJOR CONTOUR	— -•	EXISTING SANITARY SEWER LATERAL
XXX	PROPOSED MINOR CONTOUR		PROPOSED SANITARY SEWER LATERAL
XXX	PROPOSED MAJOR CONTOUR	®	PROPOSED TRACER WIRE TEST STATION BOX
	100 YEAR FLOOD PLAIN	AC	EXISTING AIR CONDITIONER
$\overline{1}$	FLOODWAY		EXISTING TELEPHONE PEDESTAL
··	ORDINARY HIGH WATER MARK	ET	EXISTING ELECTRICAL TRANSFORMER
··	STREAM SIDE BUFFER	E	EXISTING ELECTRIC METER
		×	EVICTING LIGHT DOLE

SHEET INDEX CONT.:

CE 12 - EROSION CONTROL DETAILS CE 13 - EROSION CONTROL DETAILS (CONT.)

LS1 - LANDSCAPING PLAN

EL001 - SITE LIGHTING COVER SHEET


EL101 - SITE LIGHTING PLAN

OWNER:

NEW TKG-STORAGEMART PARTNERS PORTF LLC 215 N STADIUM BLVD., SUITE #207 COLUMBIA, MO 65203 (573) 449-0091



THIS SHEET HAS BEEN SIGNED, SEALED AND DATED ELECTRONICALLY

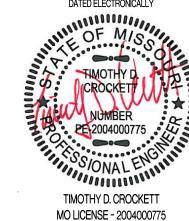


SITE/CIVIL ENGINEER:



ENGINEERING CONSULTANTS 1000 W. Nifong Blvd., Bldg. 1 Columbia, Missouri 65203 (573) 447-0292

www.crockettengineering.com

Crockett Engineering Consultants, LLC Missouri Certificate of Authority #2000151301

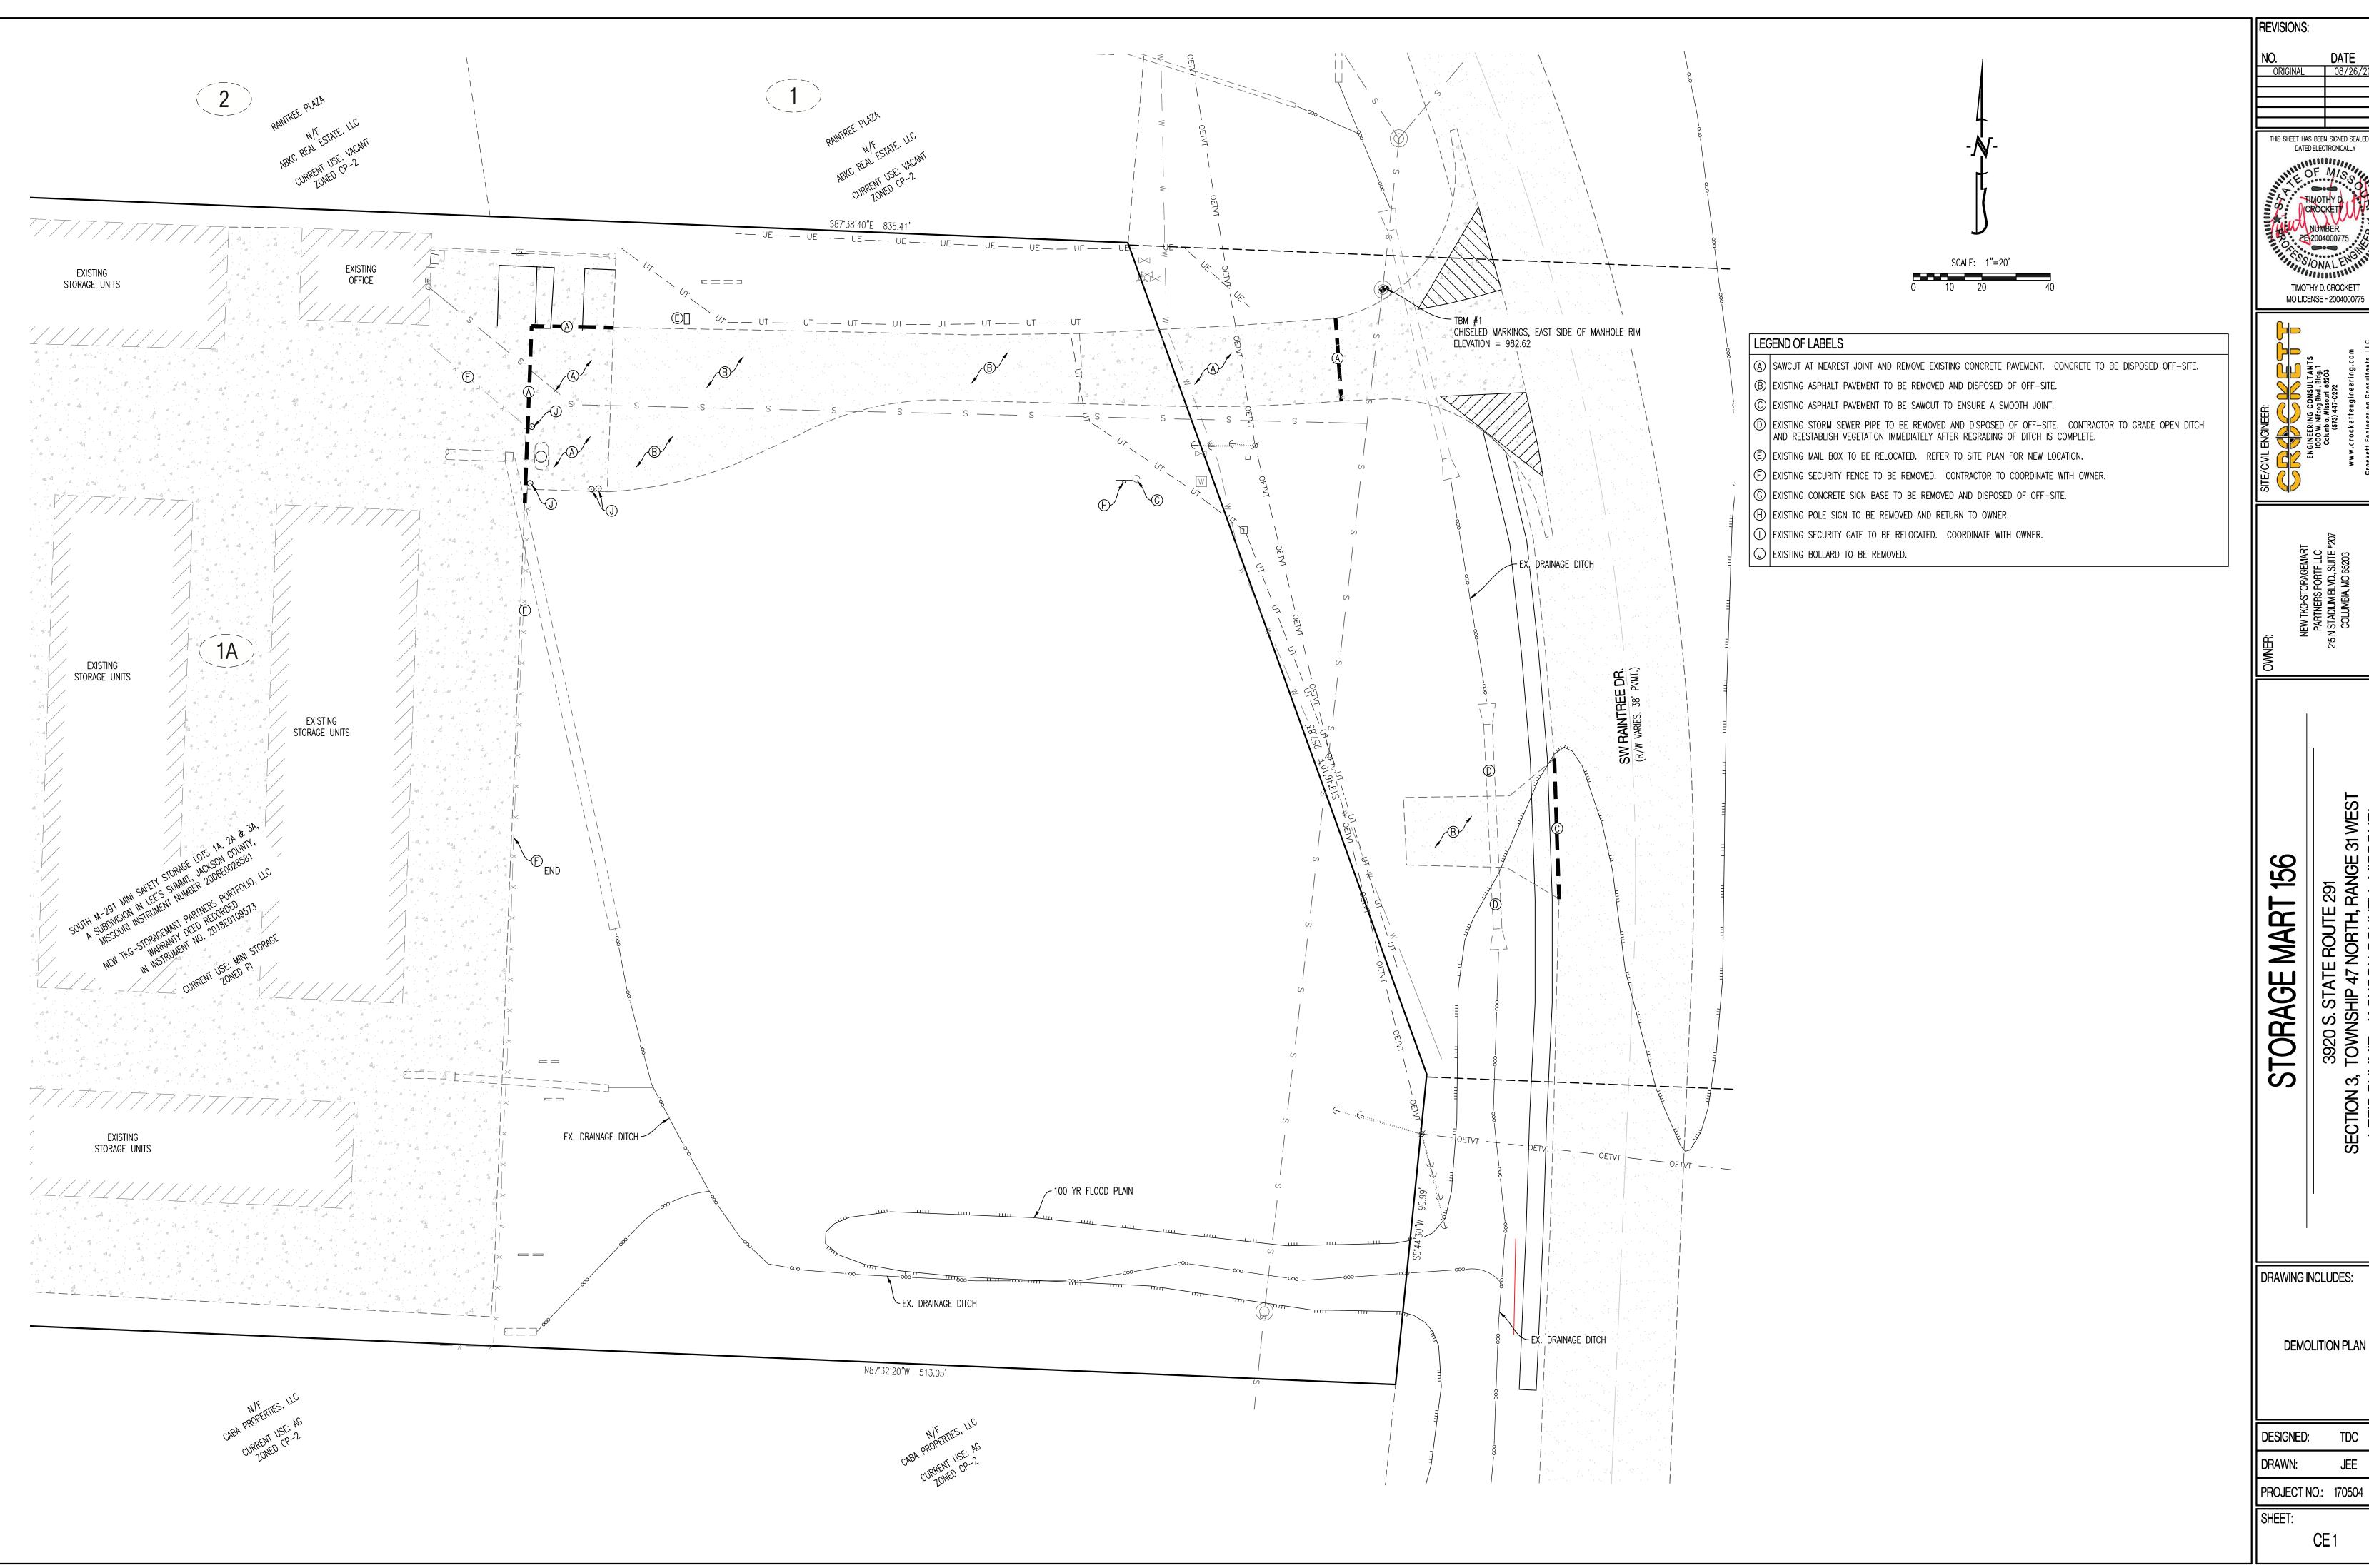


THIS SHEET HAS BEEN SIGNED, SEALED AND

TIMOTHY D. CROCKETT

DRAWING INCLUDES:

DEMOLITION PLAN

TDC JEE

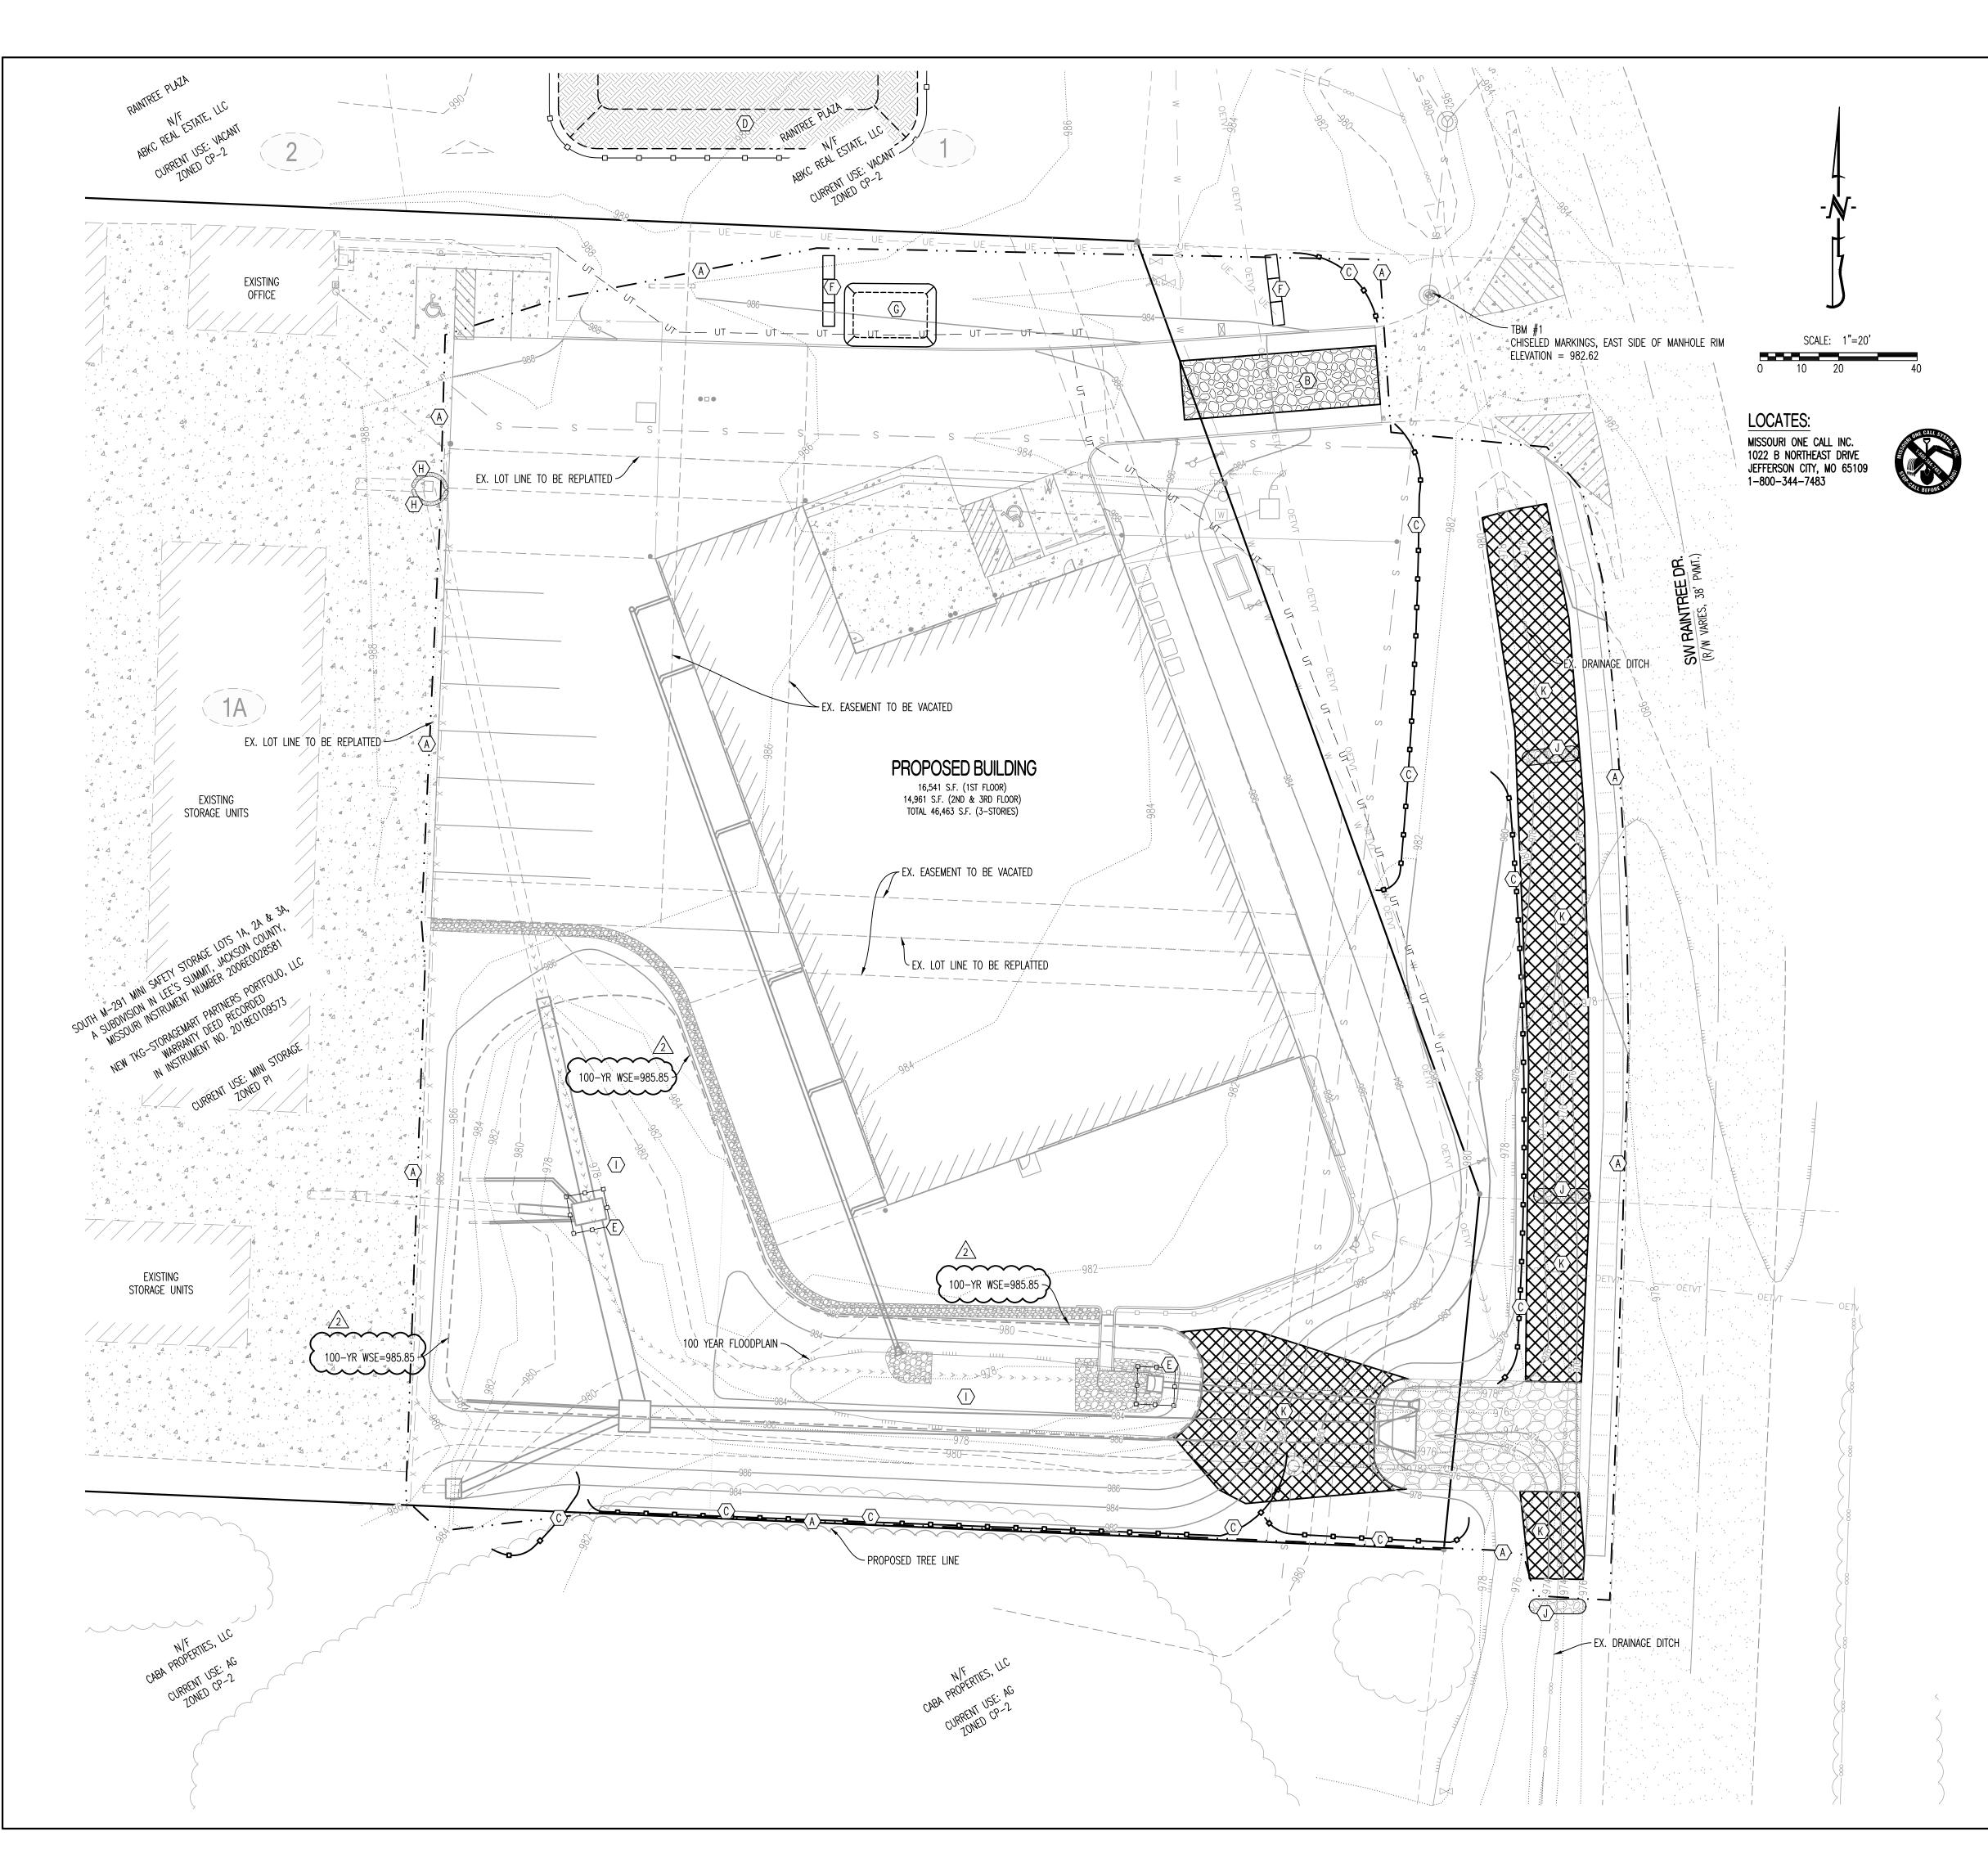

LEGEND OF LABELS:

- (A) LIMITS OF DISTURBANCE.
- B INSTALL 3" CRUSHED STONE FOR CONSTRUCTION EXIT (6" THICK x 12'W x 50'L). ALL CONSTRUCTION TRAFFIC SHALL LEAVE THE SITE VIA THIS EXIT. NO TRACKING OF MUD ONTO PUBLIC STREETS IS ALLOWED.
- (C) INSTALL SILT FENCE AS SHOWN. PORTIONS OF SILT FENCE WILL BE INSTALLED PER INITIAL EROSION CONTROL PLAN. IN LIEU OF SILT FENCE CONTRACTOR MAY INSTALL WATTLES AND BIODEGRADABLE LOGS.
- TOP SOIL STORAGE. CONTRACTOR TO ACQUIRE WRITTEN PERMISSION FROM ADJACENT PROPERTY OWNER FOR STORAGE OF TOP SOIL OR FIND ALTERNATE OFFSITE LOCATION.
- (E) INSTALL INLET PROTECTION. SILT FENCE WRAPPED AROUND THROAT OF INLET.
- F STAKED STRAW BALE DITCH CHECK.
- 20' X 30' X 3' MIN CONCRETE WASHOUT FACILITY.

 THE WASHOUT FACILITY IS TO BE LINED WITH A PLASTIC LINING MATERIAL (10 MIL POLYETHYLENE SHEETING MIN.)

 FREE OF HOLES, TEARS, OR OTHER DEFECTS THAT COULD COMPROMISE THE IMPERMEABILITY OF THE MATERIAL.

 WASHOUT FACILITIES MUST BE CLEANED, OR NEW FACILITIES MUST BE CONSTRUCTED AND READY FOR USE ONCE THE WASHOUT IS 75% FULL. A SIGN SHALL BE INSTALLED ADJACENT TO FACILITY TO INFORM CONCRETE EQUIPMENT OPERATORS TO UTILIZE THE PROPER FACILITIES.
- (H) INSTALL GUTTERBUDDY OR APPROVED EQUAL.
- PROPOSED DETENTION FACILITY AREA TO BE USED AS A TEMPORARY SEDIMENT TRAP UNTIL AREAS DRAINING TO HAS VEGETATION ESTABLISHED.
- TYPE II ROCK DITCH CHECK. REFER TO DETAIL SHEET CE 13.
- INSTALL NORTH AMERICAN GREEN VMAX S350 EROSION CONTROL MAT. CONTRACTOR TO INSTALL PER MANUFACTURES

SEQUENCE OF CONSTRUCTION:

- 1. OBTAIN MODOT, STATE AND CITY OF LEE'S SUMMIT COUNTY LAND DISTURBANCE PERMITS PRIOR TO ANY LAND DISTURBANCE ACTIVITIES..
- 2. INSTALL BMP'S NEEDED FOR LAND DISTURBANCE SUCH AS SILT FENCE, ROCK DITCH CHECK AND STAKED STRAW BALES AS SHOWN ON THE PLAN.
- 3. BEGIN SITE DEMOLITION AND GRADING OPERATIONS. EXISTING PAVEMENT MAY BE USED AS CONSTRUCTION ENTRANCE UNTIL DEMOLITION OF PAVEMENT IN AREA OF THE ENTRANCE HAS STARTED. ONCE DEMOLITION OF PAVEMENT IS COMPLETED A TEMPORARY CONSTRUCTION ENTRANCE SHALL BE INSTALLED.
- 4. CONSTRUCT DETENTION FACILITY. DETENTION FACILITY TO BE UTILIZED AS TEMPORARY SEDIMENT TRAP. PAVED AREAS TO BE BROUGHT UP TO SUBGRADE. ALL NON-PAVED AREAS TO BE BROUGHT UP TO FINAL GRADE AND SEEDED AND MULCHED AS SOON AS POSSIBLE.
- 5. INSTALL INLET PROTECTION IMMEDIATELY AFTER PLACEMENT OF INLETS.
- 6. INSTALL FINAL LANDSCAPING.
- 7. AFTER ALL SURFACE AREAS AS STABILIZED, SILT FENCE AND INLET BARRIERS MAY BE REMOVED.

GENERAL NOTES:

EROSION AND SEDIMENT CONTROL SHALL CONFORM TO SECTION 5100 EROSION AND SEDIMENT CONTROL OF THE KANSAS CITY METROPOLITAN CHAPTER OF THE AMERICAN PUBLIC WORKS ASSOCIATION (APWA), CURRENT EDITION.

DRY DETENTION BASIN MAINTENANCE SCHEDULE:

ACTIVITY	FREQUENCY
ESTABLISHMENT	
WATERING PLANTS (SEEDED AREAS UP TO 8 WEEKS, PLUGS IN DROUGHT)	1" PER WEEK AS NEEDED
WEED CONTROL (FLAIL MOW, STRING-TRIM, SELECTIVE/PREEMERG HERBICIDES)	MONTHLY
REMOVE LITTER AND DEBRIS (TRASH, LEAVES, SAND, MOWER DISCHARGE)	MONTHLY
MONITOR & REPAIR EROSION (STABILIZE SOIL, REPLACE PLANTS, SECURE EDGING)	MONTHLY
CHECK FOR STANDING WATER (LONGER THAN DESIGN, ANY PUDDLES, SATURATE SOIL)	MONTHLY
ADD MULCH (MOISTURE & WEED CONTROL WITH PLUGS/CONTAINERS, 3" OR LESS)	ANNUALLY
INSPECT DRAINAGE AREA (PARKING LOT SWEEPING, TRASH PICKUP, ETC.)	ANNUALLY
REPLACE DEAD PLANTS (USE DESIGN SPECIES/SIZE; OVERSEED, INSTALL DEEP CELL PLUGS)	ANNUALLY, AS NEEDED
MAINTENANCE	
VEGETATION CLEANUP (SPOT TREAT, PRESCRIBED BURN, PRUNE)	ANNUALLY, SPRING OR FALL
EVALUATE PLAN COMPOSITION (WOODY INVASION, GRASS/FLOWER RATION, "RIGHT PLANT RIGHT PLACE")	ANNUALLY
SEDIMENT REMOVAL, EROSION CONTROL (REMOVE SEDIMENT WHEN 25% OF STORAGE HAS BEEN LOST)	ANNUALLY
ADDRESS ANIMAL DAMAGE (BEAVER DAMS, MUSKRAT BURROWS, DEER RUBS)	ANNUALLY
VERIFY STRUCTURAL COMPONET FUNCTION (ORIFICES AND OUTLET PROTECTION)	ANNUALLY
EXTENDED DRY DETENTION BASIN	
STRING TRIM VEGETATION TO MINIMIZE DISTURBANCE	ANNUALLY
INSPECTION FOR EROSION IN FLOW LINES AND SLOPES	ANNUALLY

NO. DATE

ORIGINAL 08/26/2

1 09/27/2
2 11/22/2

DRIGINAL 06/25/2

1 09/27/2

2 11/22/2

IS SHEET HAS BEEN SIGNED, SEALE DATED ELECTRONICALLY

S SHEET HAS BEEN SIGNED, SEALED AND DATED ELECTRONICALLY

OF M/S

TIMOTHY D

CROCKETT

NUMBER

PE 2004000775

TIMOTHY D. CROCKETT

MO LICENSE - 2004000775

ENGINEERING CONSULTANTS
1000 W. Nifong Blvd., Bldg. 1
Columbia, Missouri 65203
(573) 447-0292

www.crockettengineering.com

Crockett Engineering Consultants, LLC
Missouri Certificate of Authority

NEW TRG-3 I ORAGEMART PARTNERS PORTELLC 215 N STADIUM BLVD., SUITE #207 COLUMBIA, MO 65203

TE ROUTE 291 47 NORTH, RANGE 31 WE

SECTION 3, TOV

STORAGE

DRAWING INCLUDES:

EROSION CONTROL PLAN


DESIGNED: TDC


DRAWN: JEE

PROJECT NO.: 170504

SHEET:

CE 2

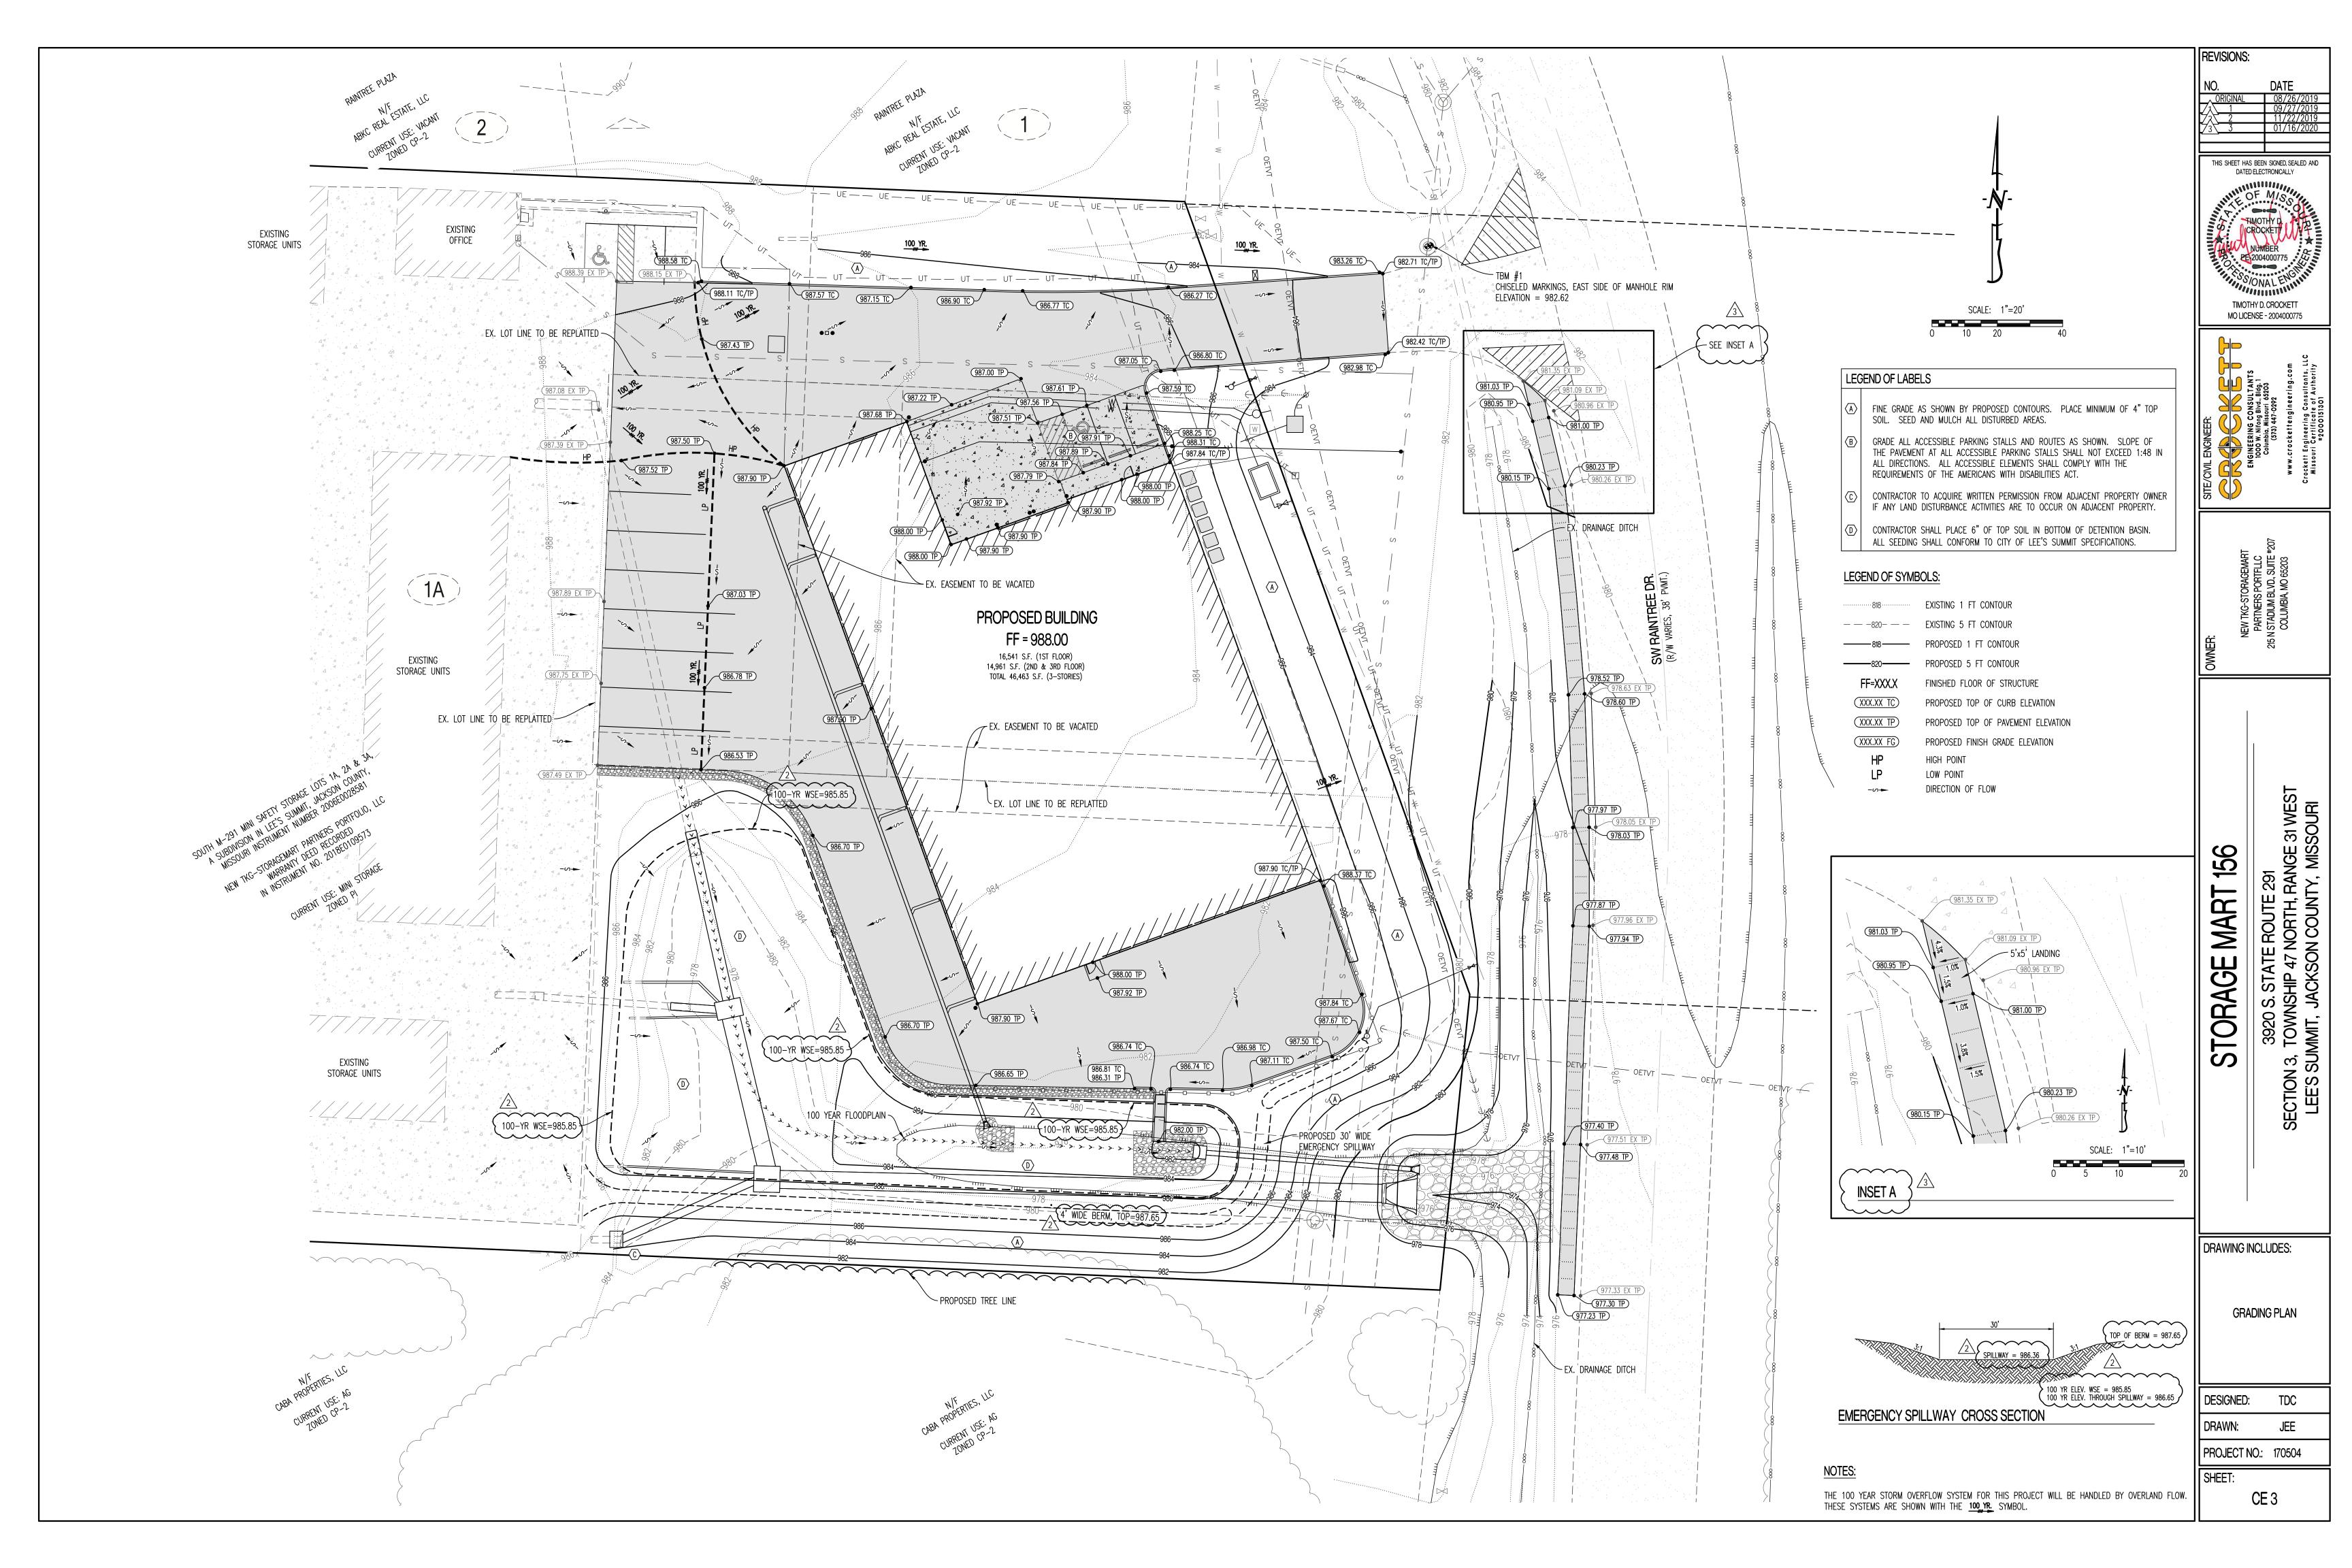

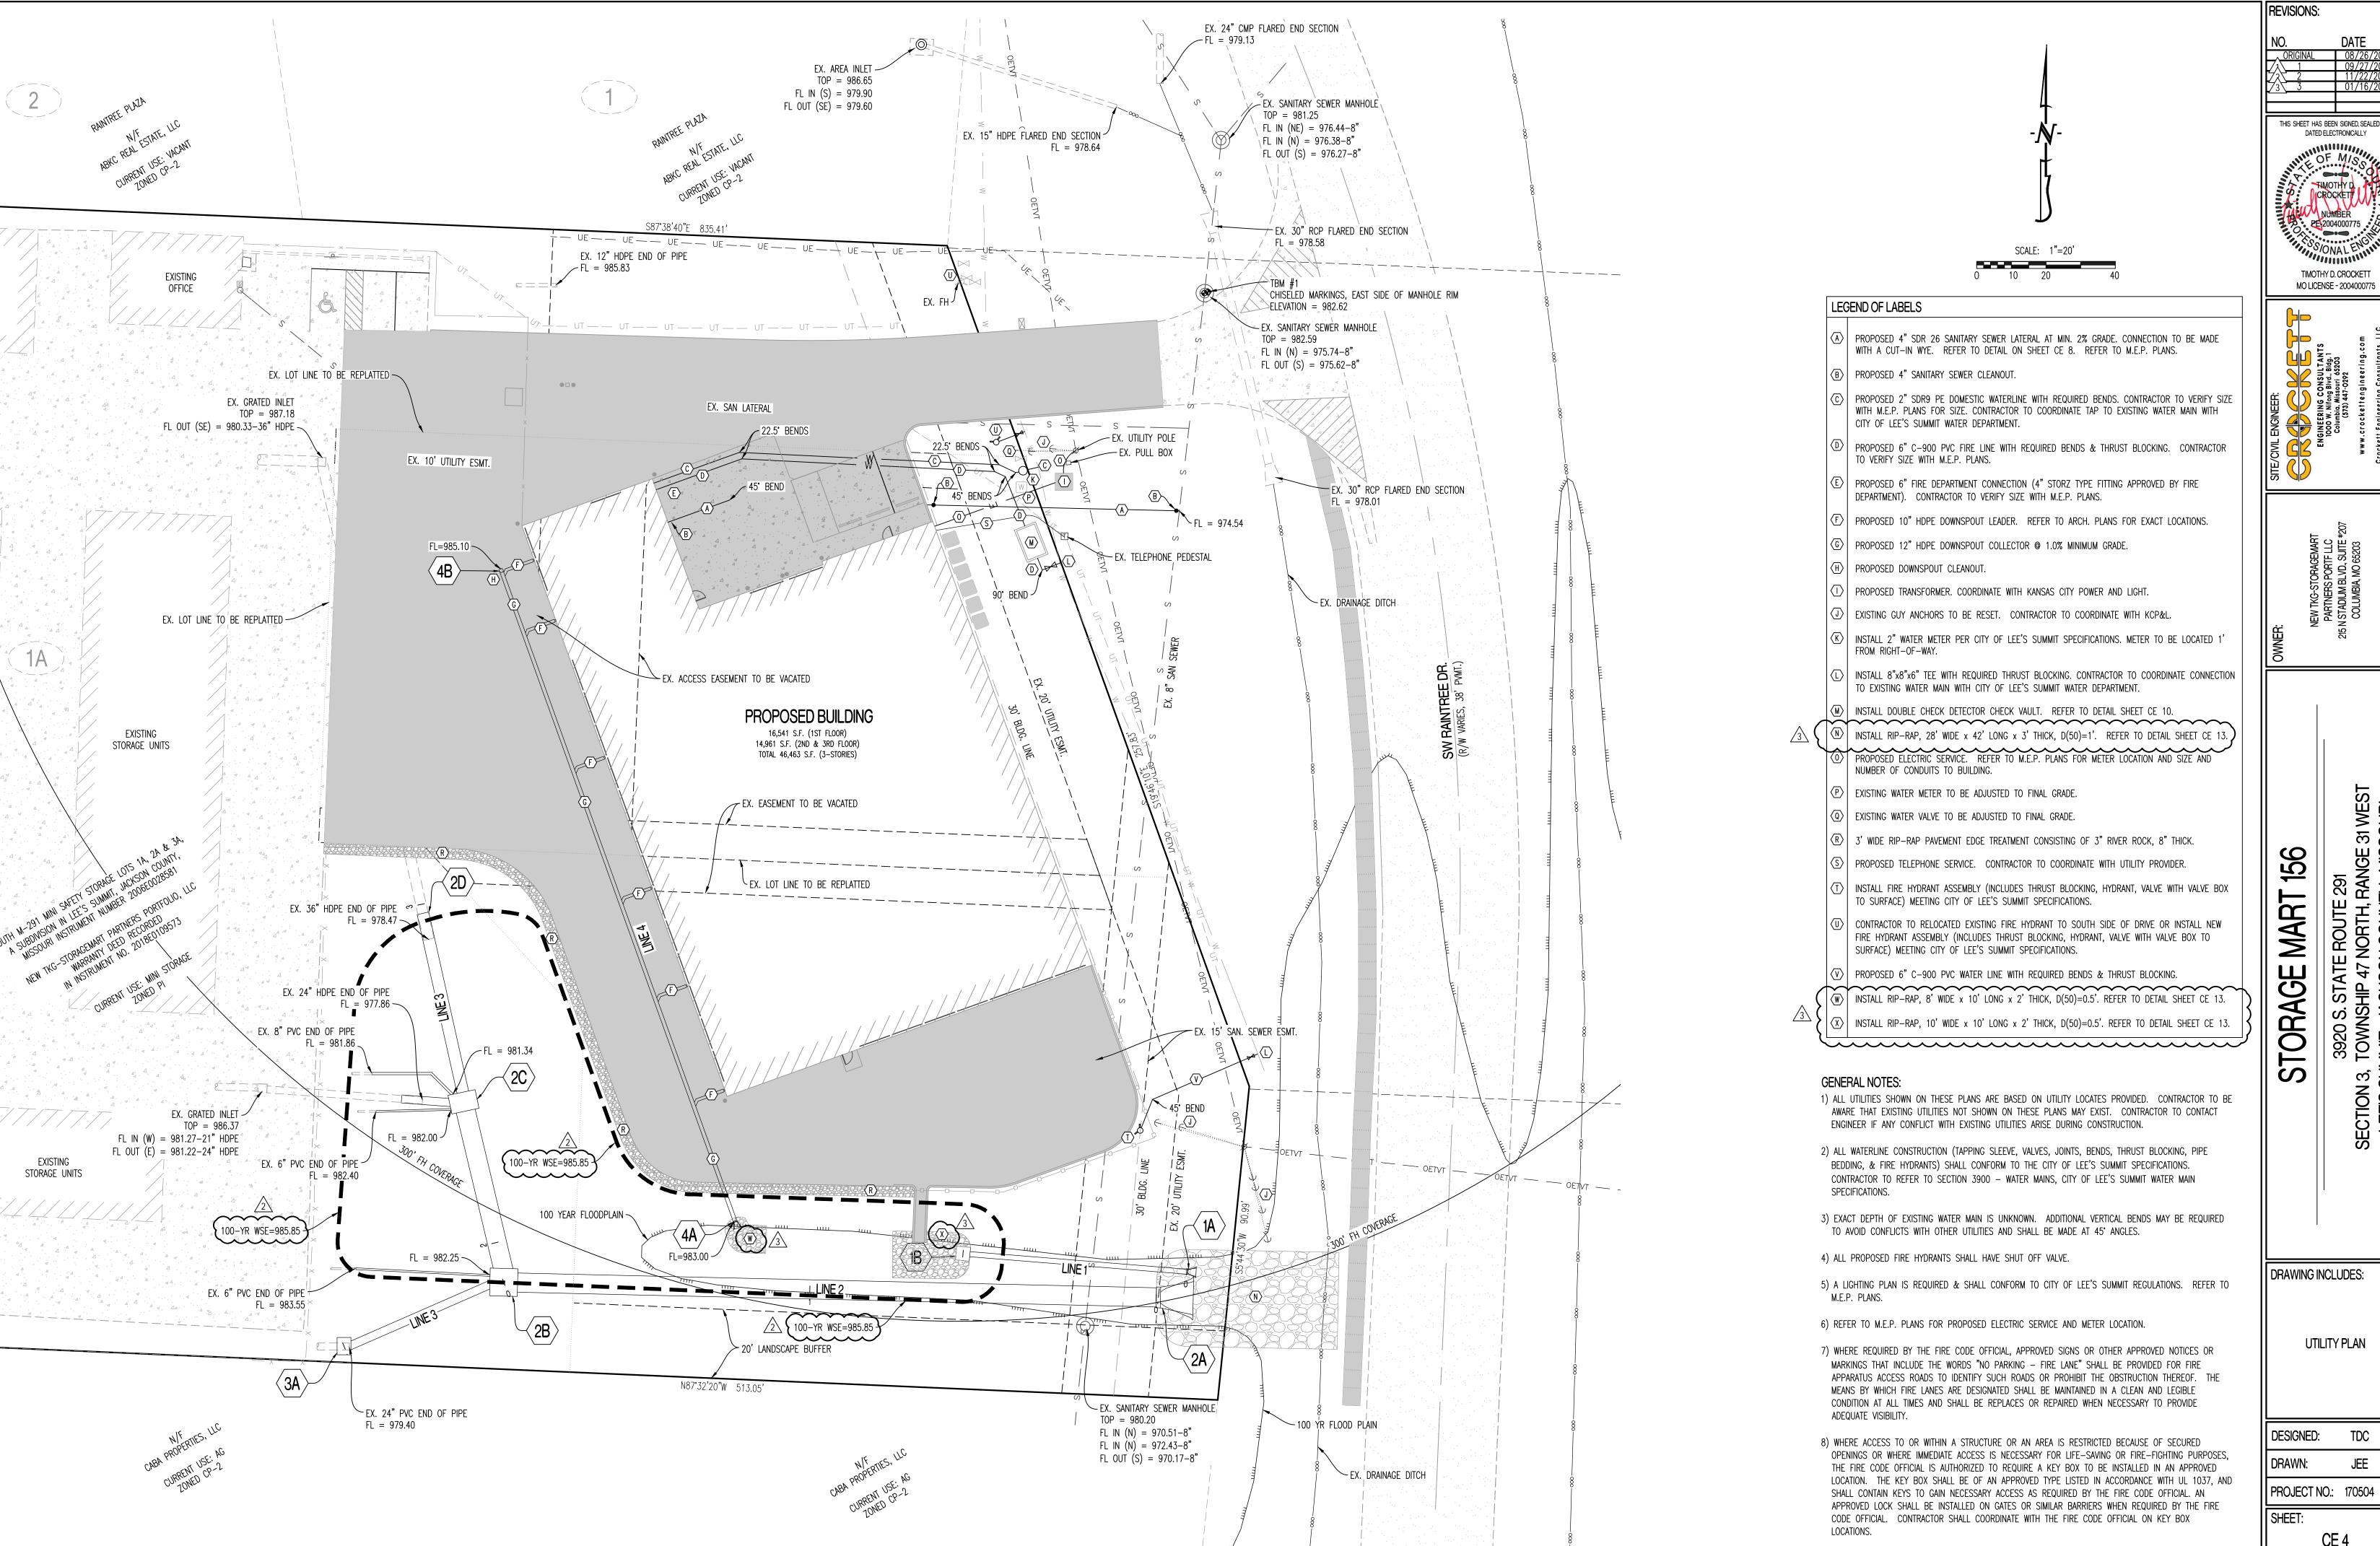

REVISIONS:


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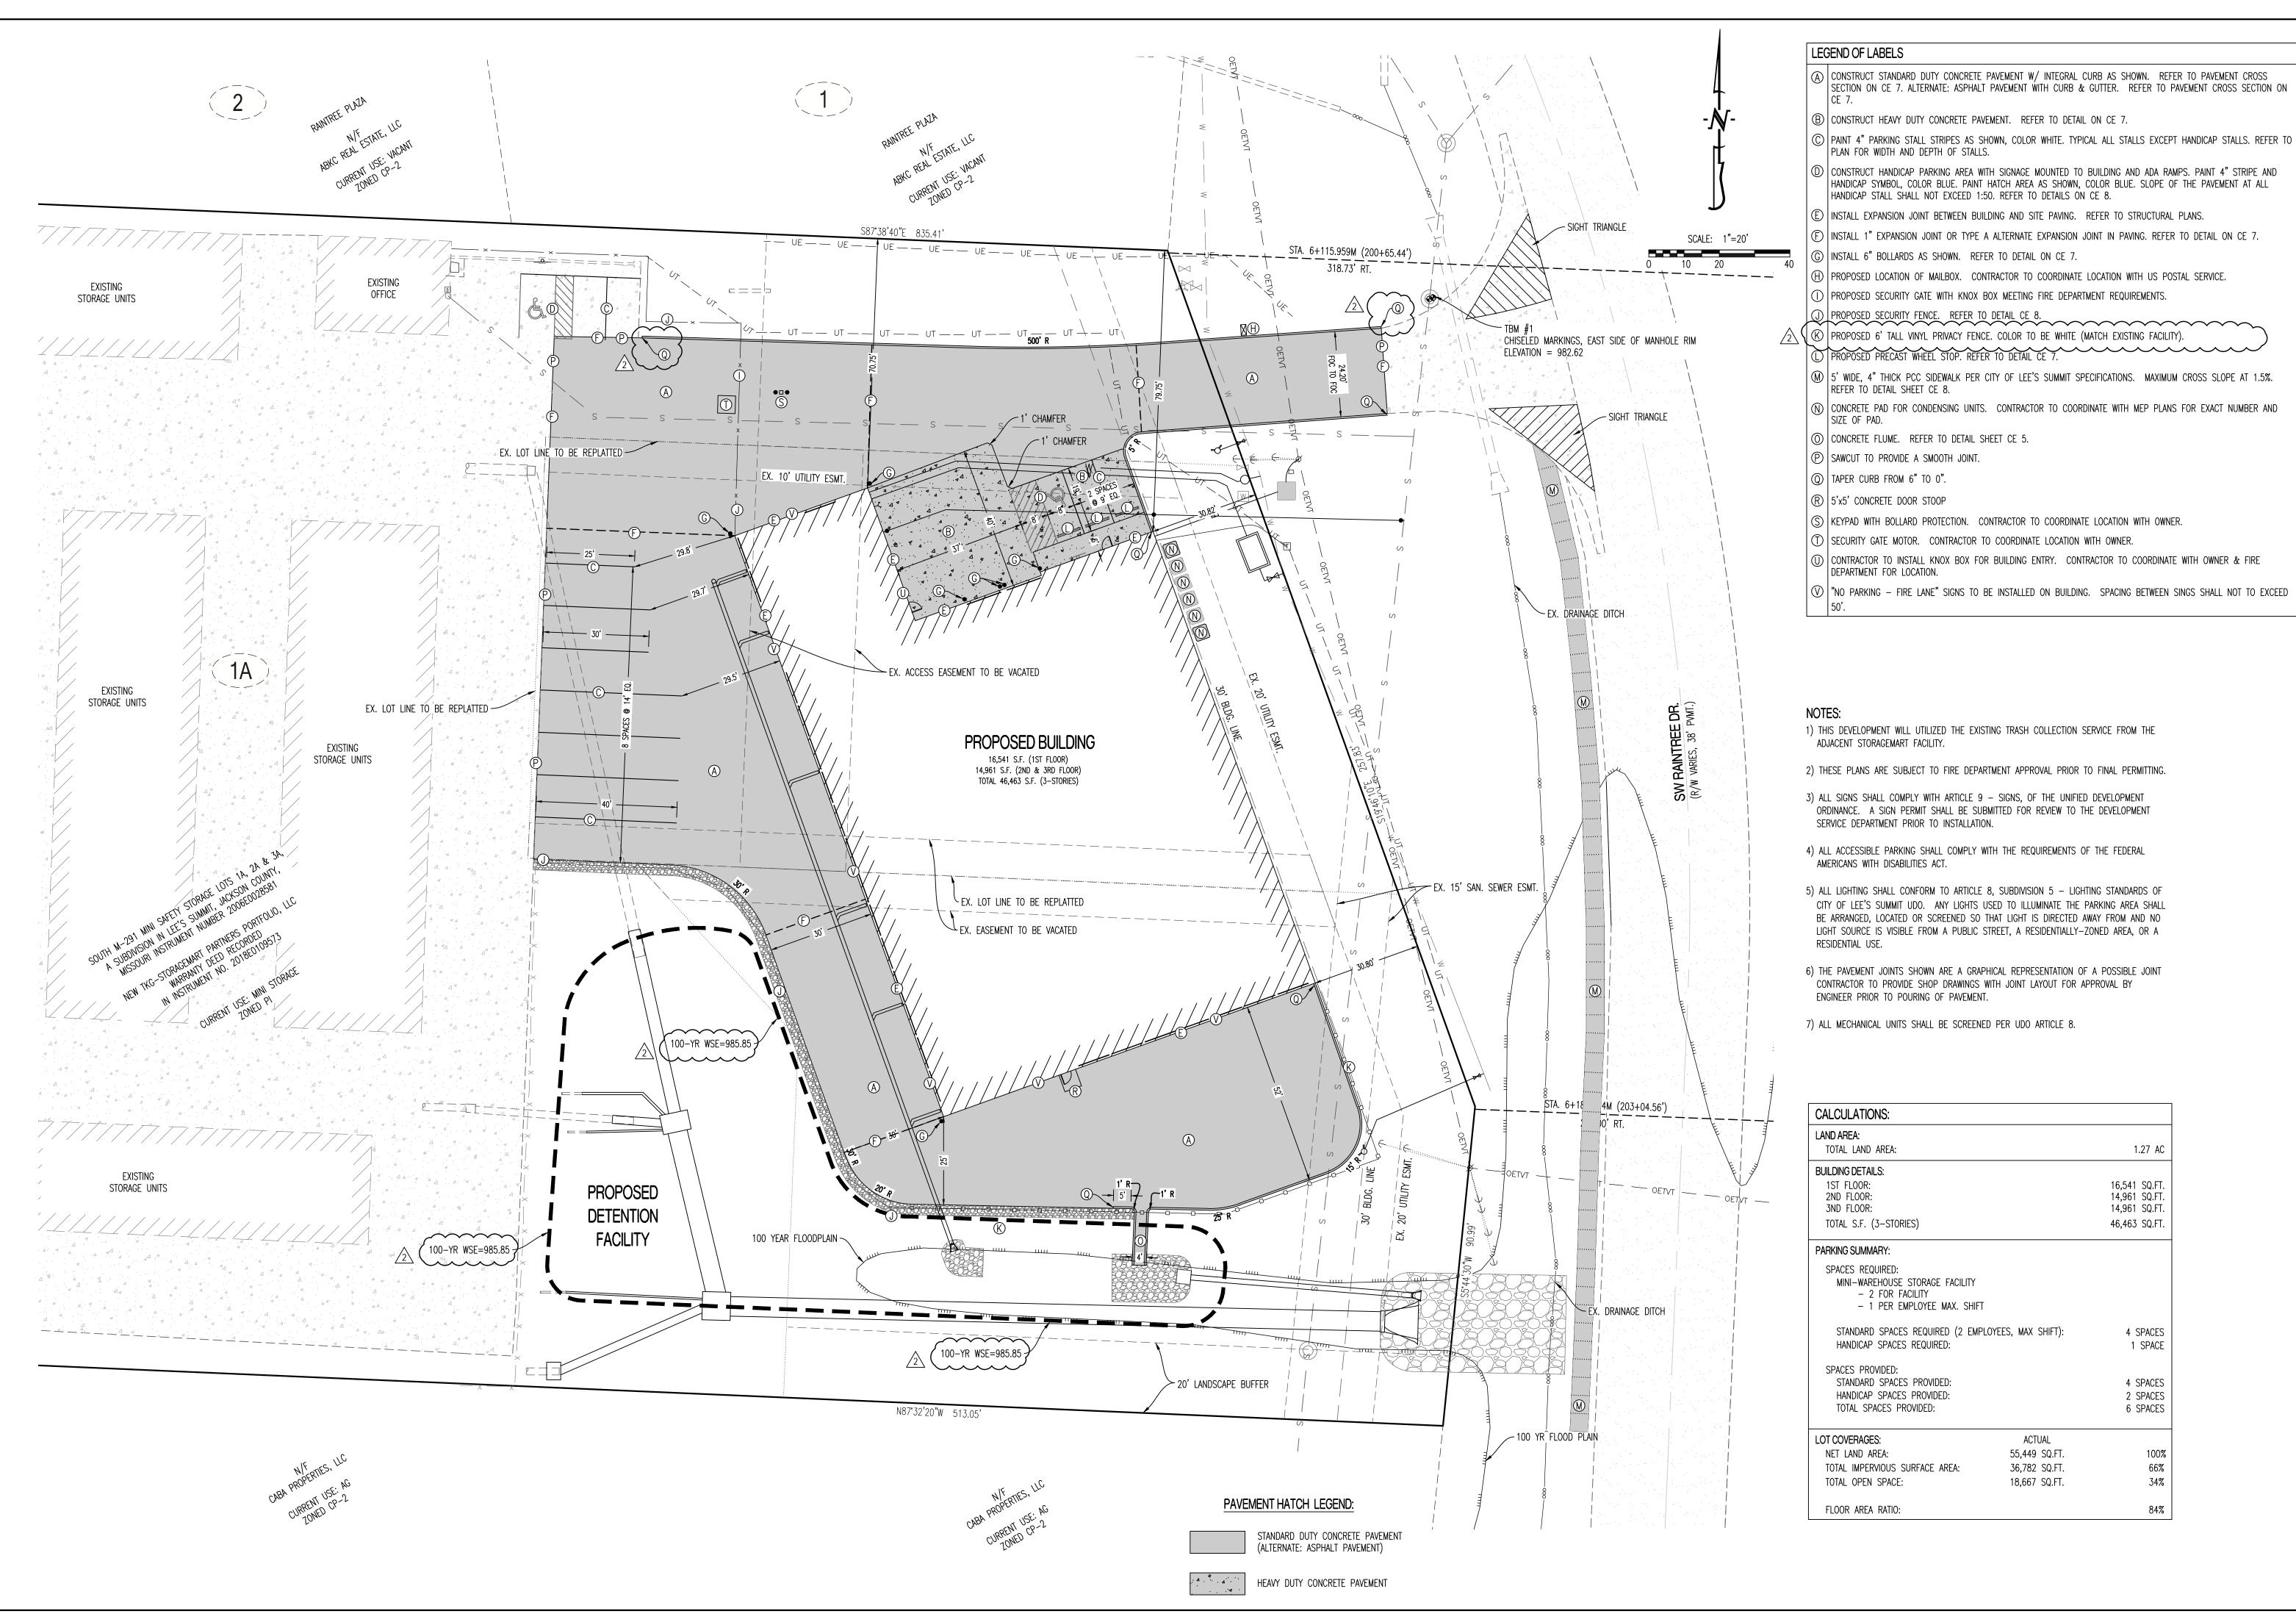
TIMOTHY D. CROCKETT

UTILITY PLAN

TDC JEE

PROJECT NO.: 170504



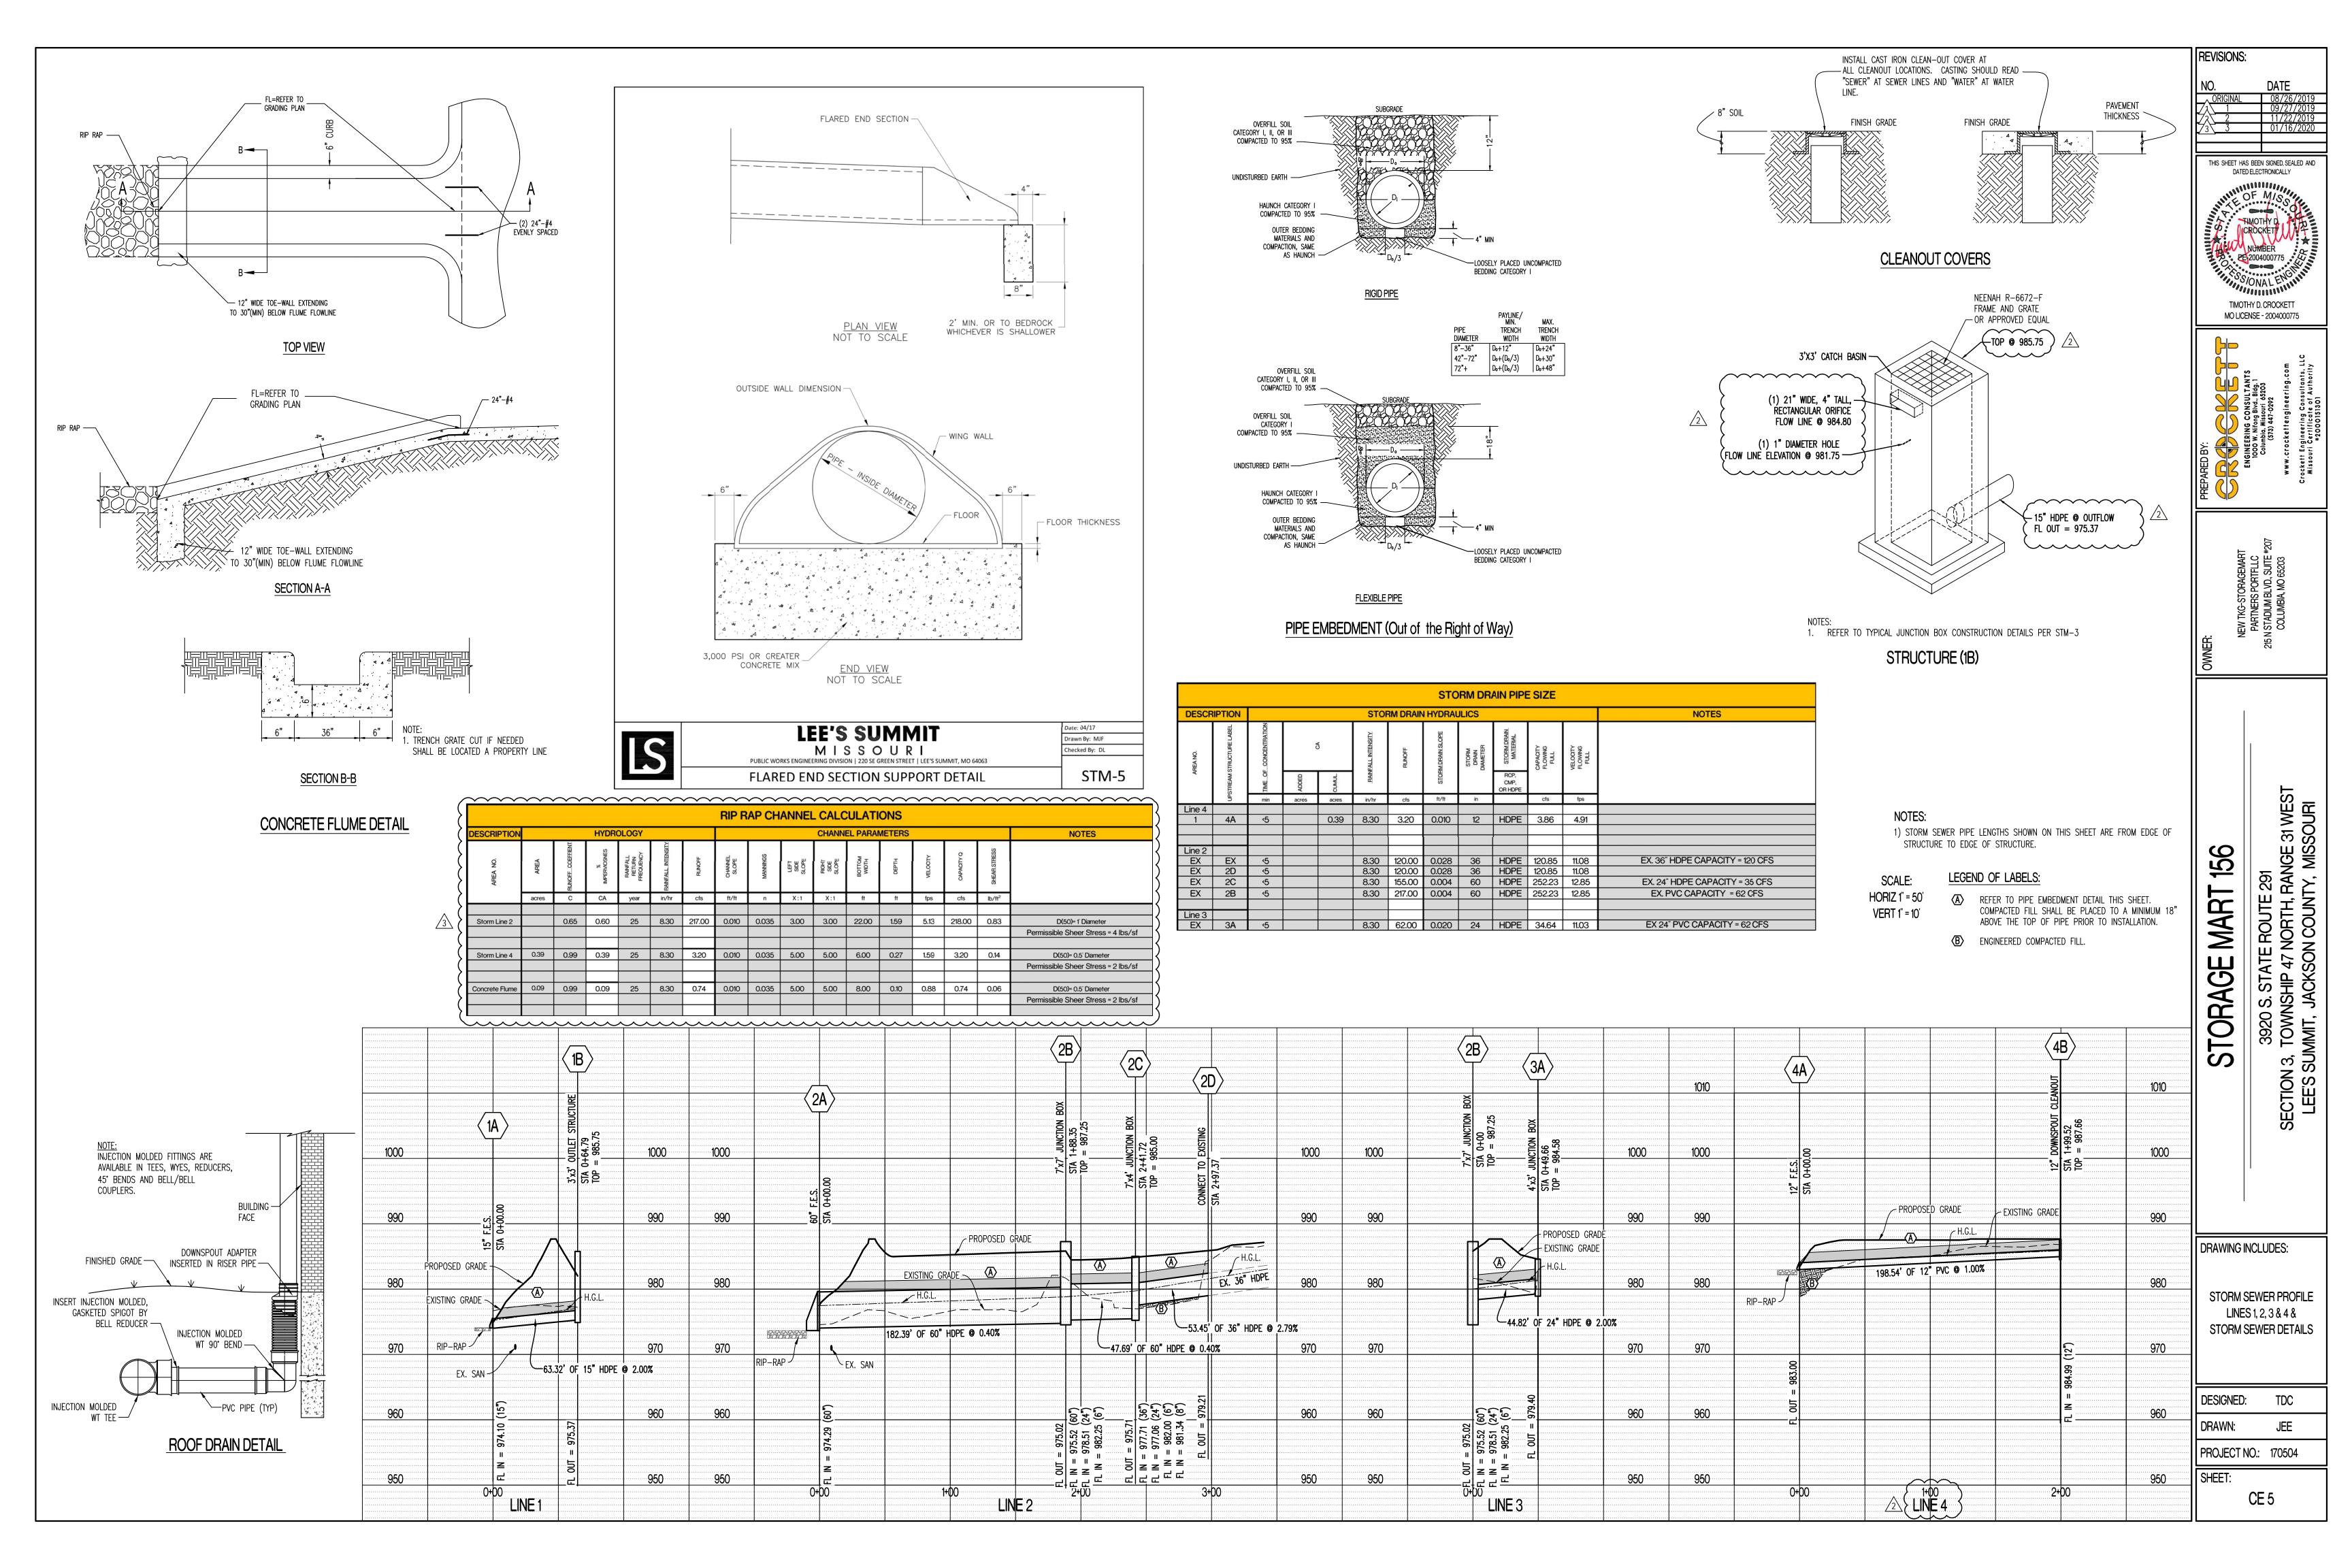

REVISIONS:

DATE

ORIGINAL 08/26/2019

1 09/27/2019

2 11/22/2019

THIS SHEET HAS BEEN SIGNED, SEA DATED ELECTRONICALLY

TIMOTHY D. CROCKETT

IGINEERING CONSULTANTS
1000 W. Nifong Blvd., Bldg. 1
Columbia, Missouri 65203
(573) 447-0202
V. crockettengineering.com
11 Engineering Consultants, LLC
ouri Certificate of Authority

NEW TKG-STORAGEMART PARTNERS PORTF LLC 215 N STADIUM BLVD., SUITE #207 COLUMBIA, MO 65203

215 N S 215 N S O O

STORAGE MART 156

3920 S. STATE ROUTE 291
3. TOWNSHIP 47 NORTH, RANGE 31 WES

3920 S. STATE ROUTE ECTION 3, TOWNSHIP 47 NORTH LEE'S SUMMIT, JACKSON COUN

DRAWING INCLUDES:


SITE PLAN


DESIGNED: TDC

DRAWN: JEE
PROJECT NO.: 170504


SHEET:

CE 6

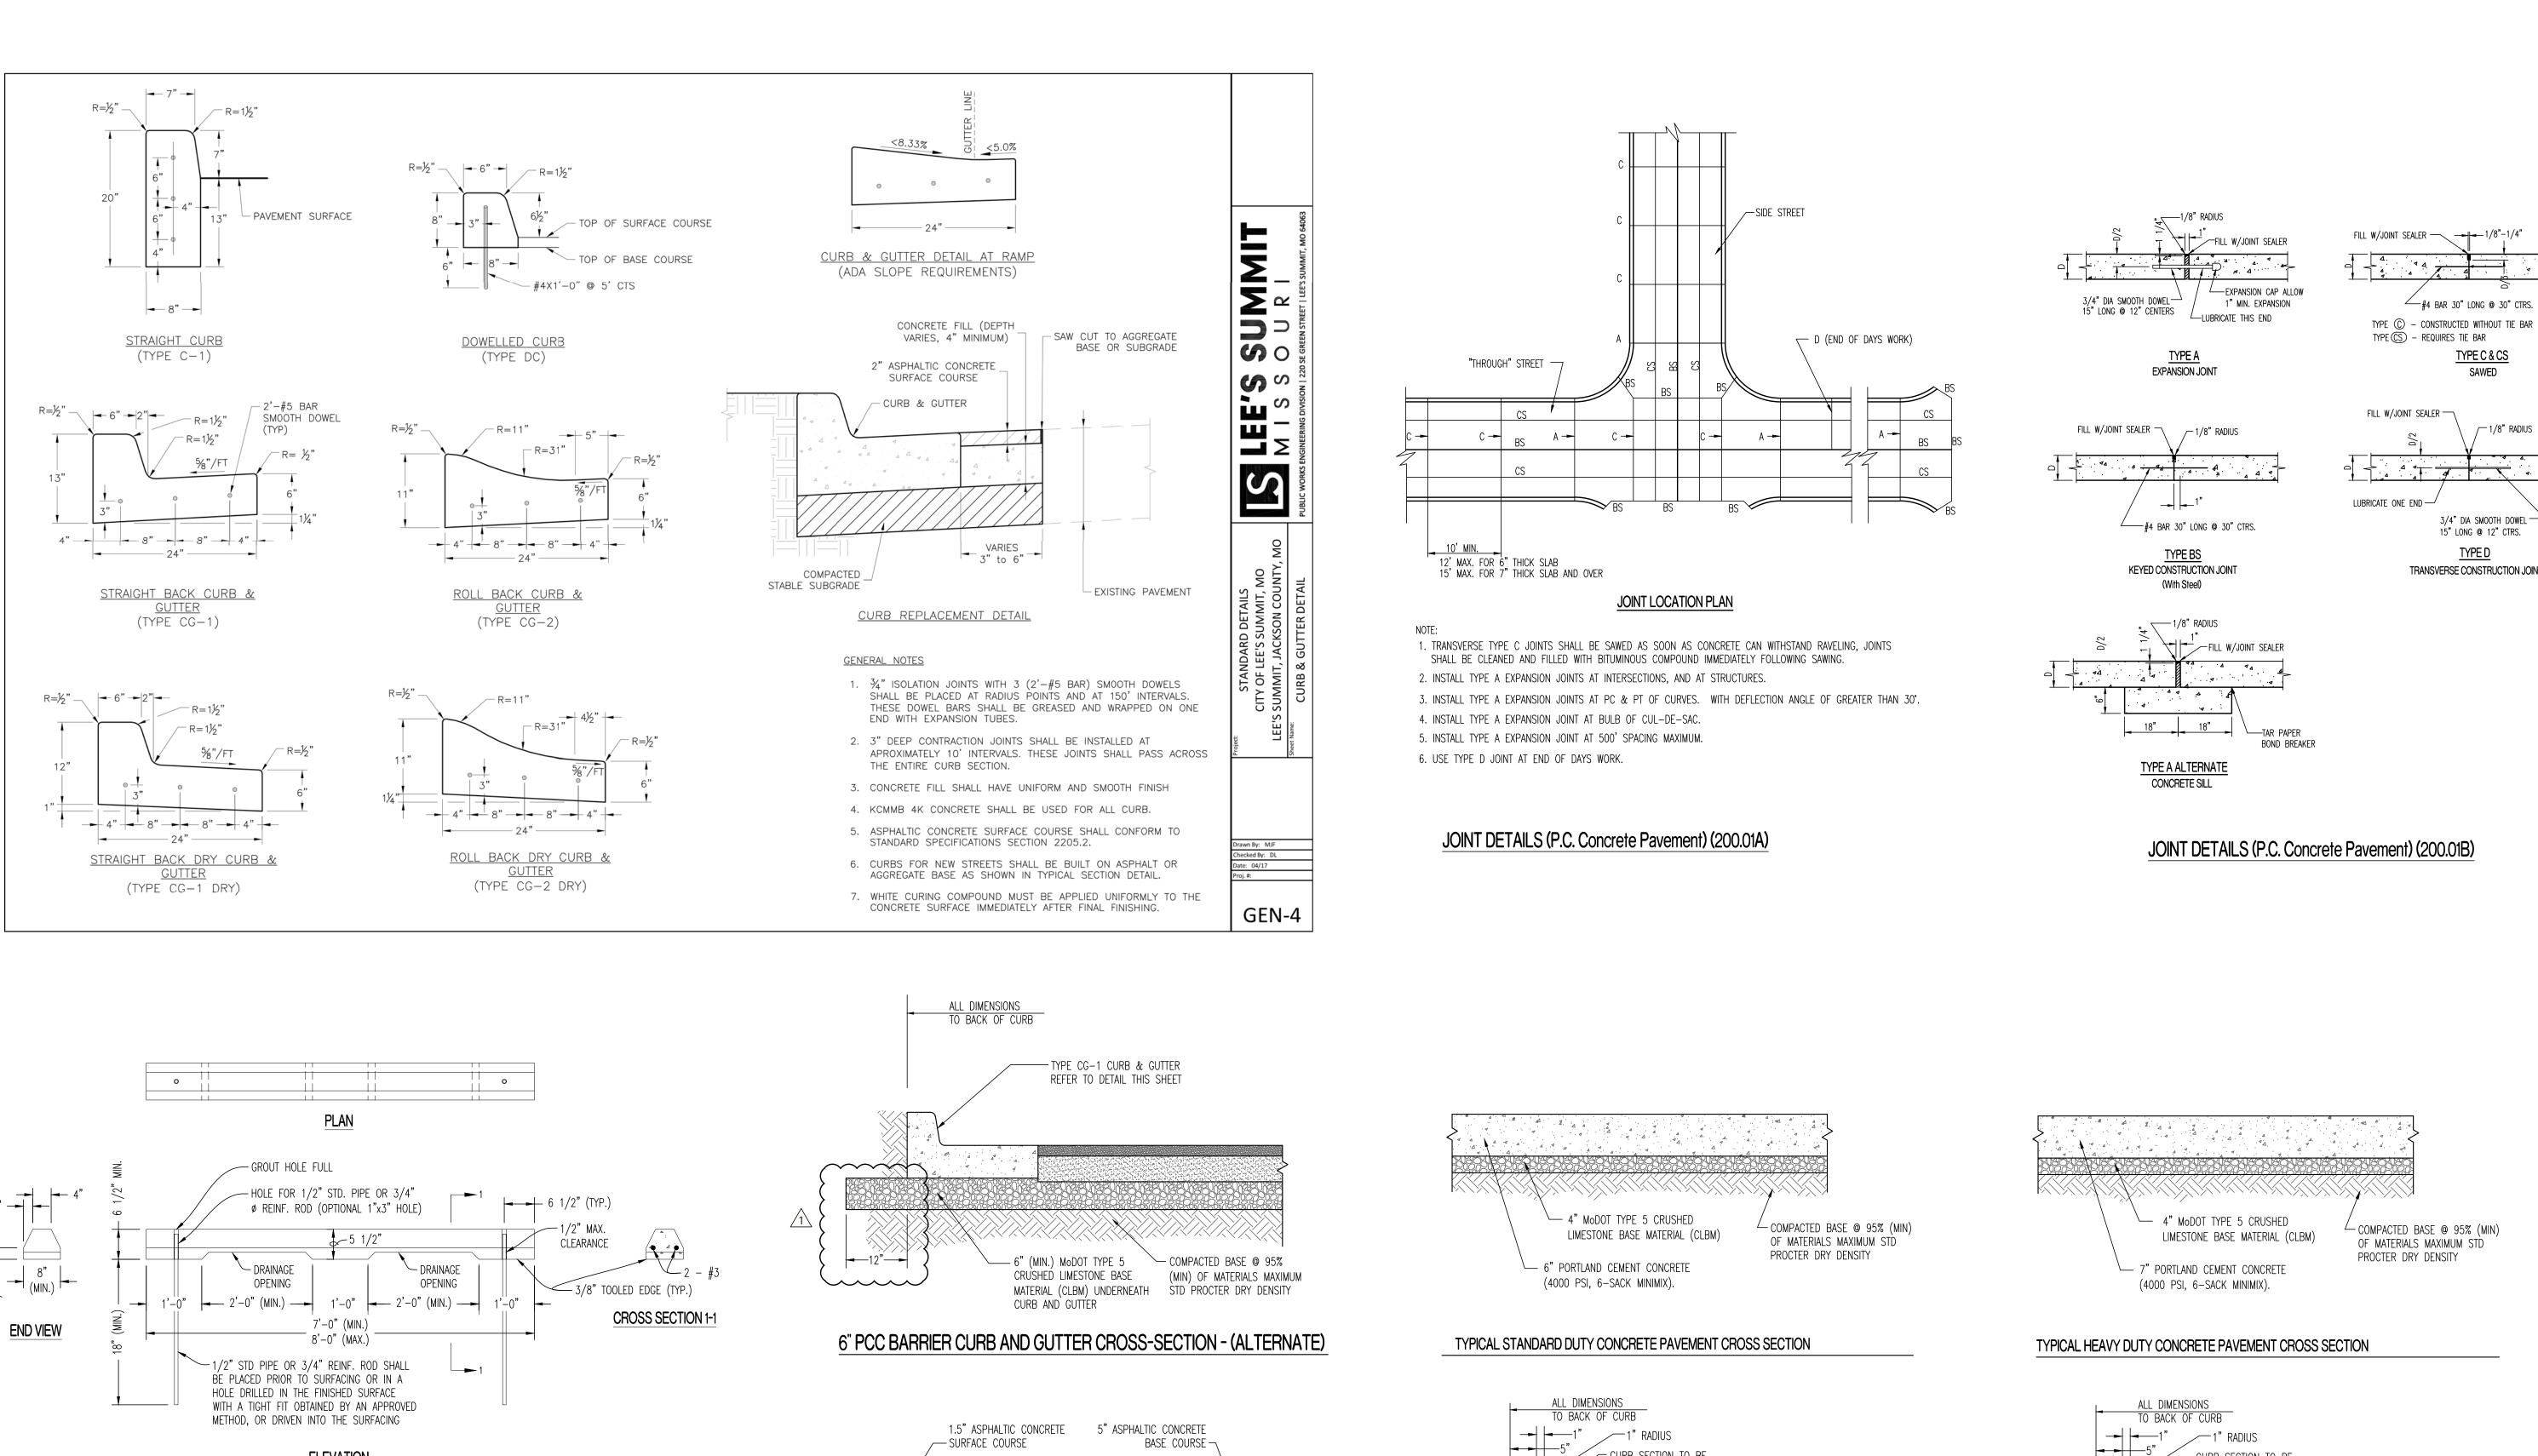

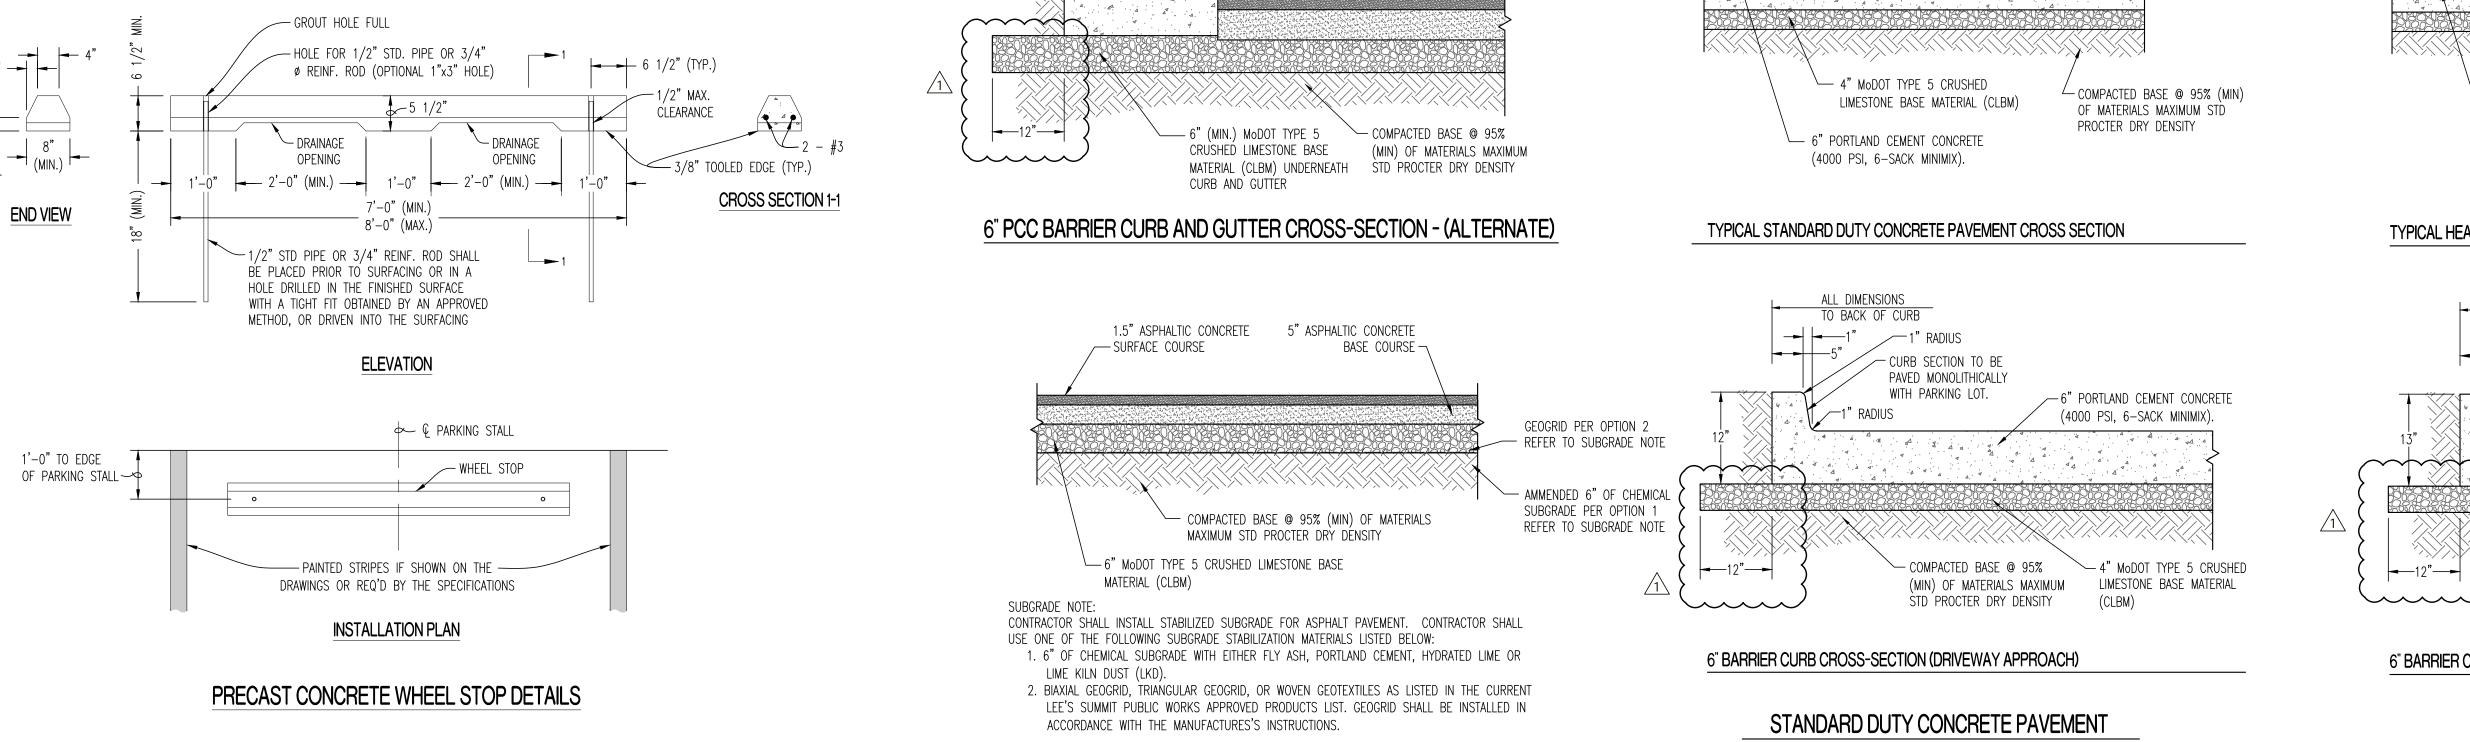

TYPICAL ASPHALT PAVEMENT CROSS-SECTION (ALTERNATE)

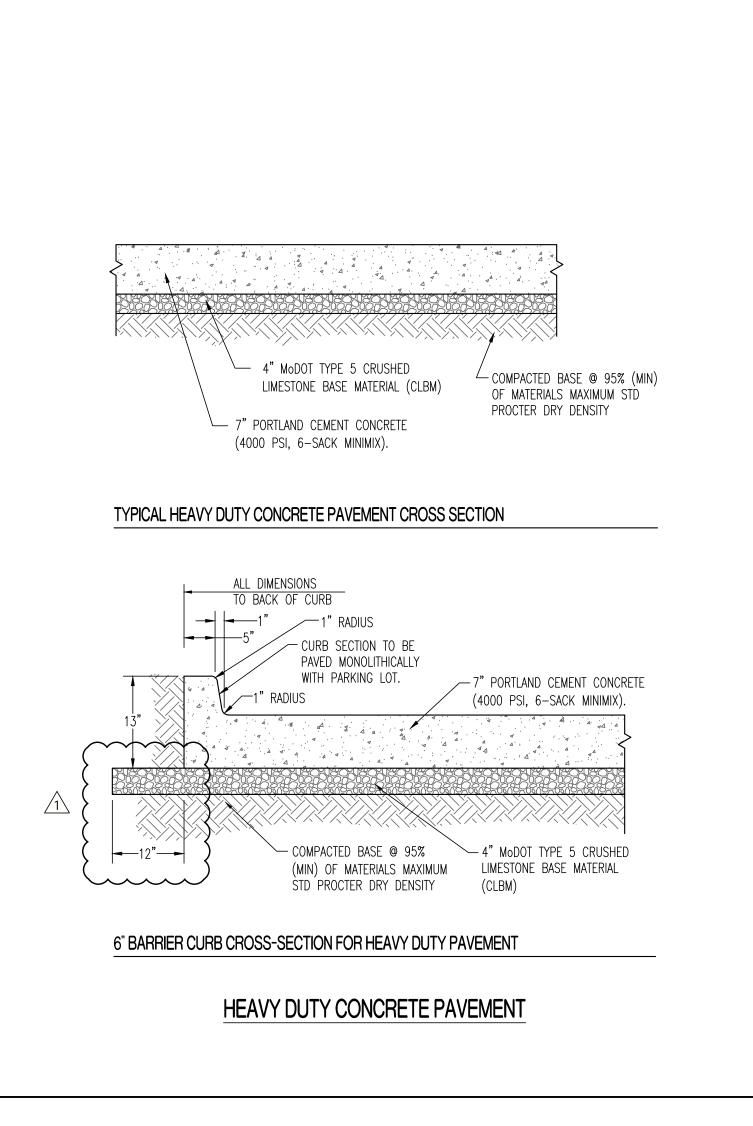

3920 S. STATE ROUTE 291 ECTION 3, TOWNSHIP 47 NORTH, RANGE 31 W LEE'S SUMMIT, JACKSON COUNTY, MISSOL STORAGE MART 156 DRAWING INCLUDES: SITE CONSTRUCTION **DETAILS** DESIGNED: TDC DRAWN: JEE PROJECT NO.: 170504 SHEET: CE 7

THIS SHEET HAS BEEN SIGNED, SEALED AND DATED ELECTRONICALLY

TIMOTHY D. CROCKETT

MO LICENSE - 2004000775

#4 BAR 30" LONG @ 30" CTRS.

TYPE C & CS

SAWED


3/4" DIA SMOOTH DOWEL -


15" LONG @ 12" CTRS.


TYPE D


TRANSVERSE CONSTRUCTION JOINT

___ 1/8" RADIUS

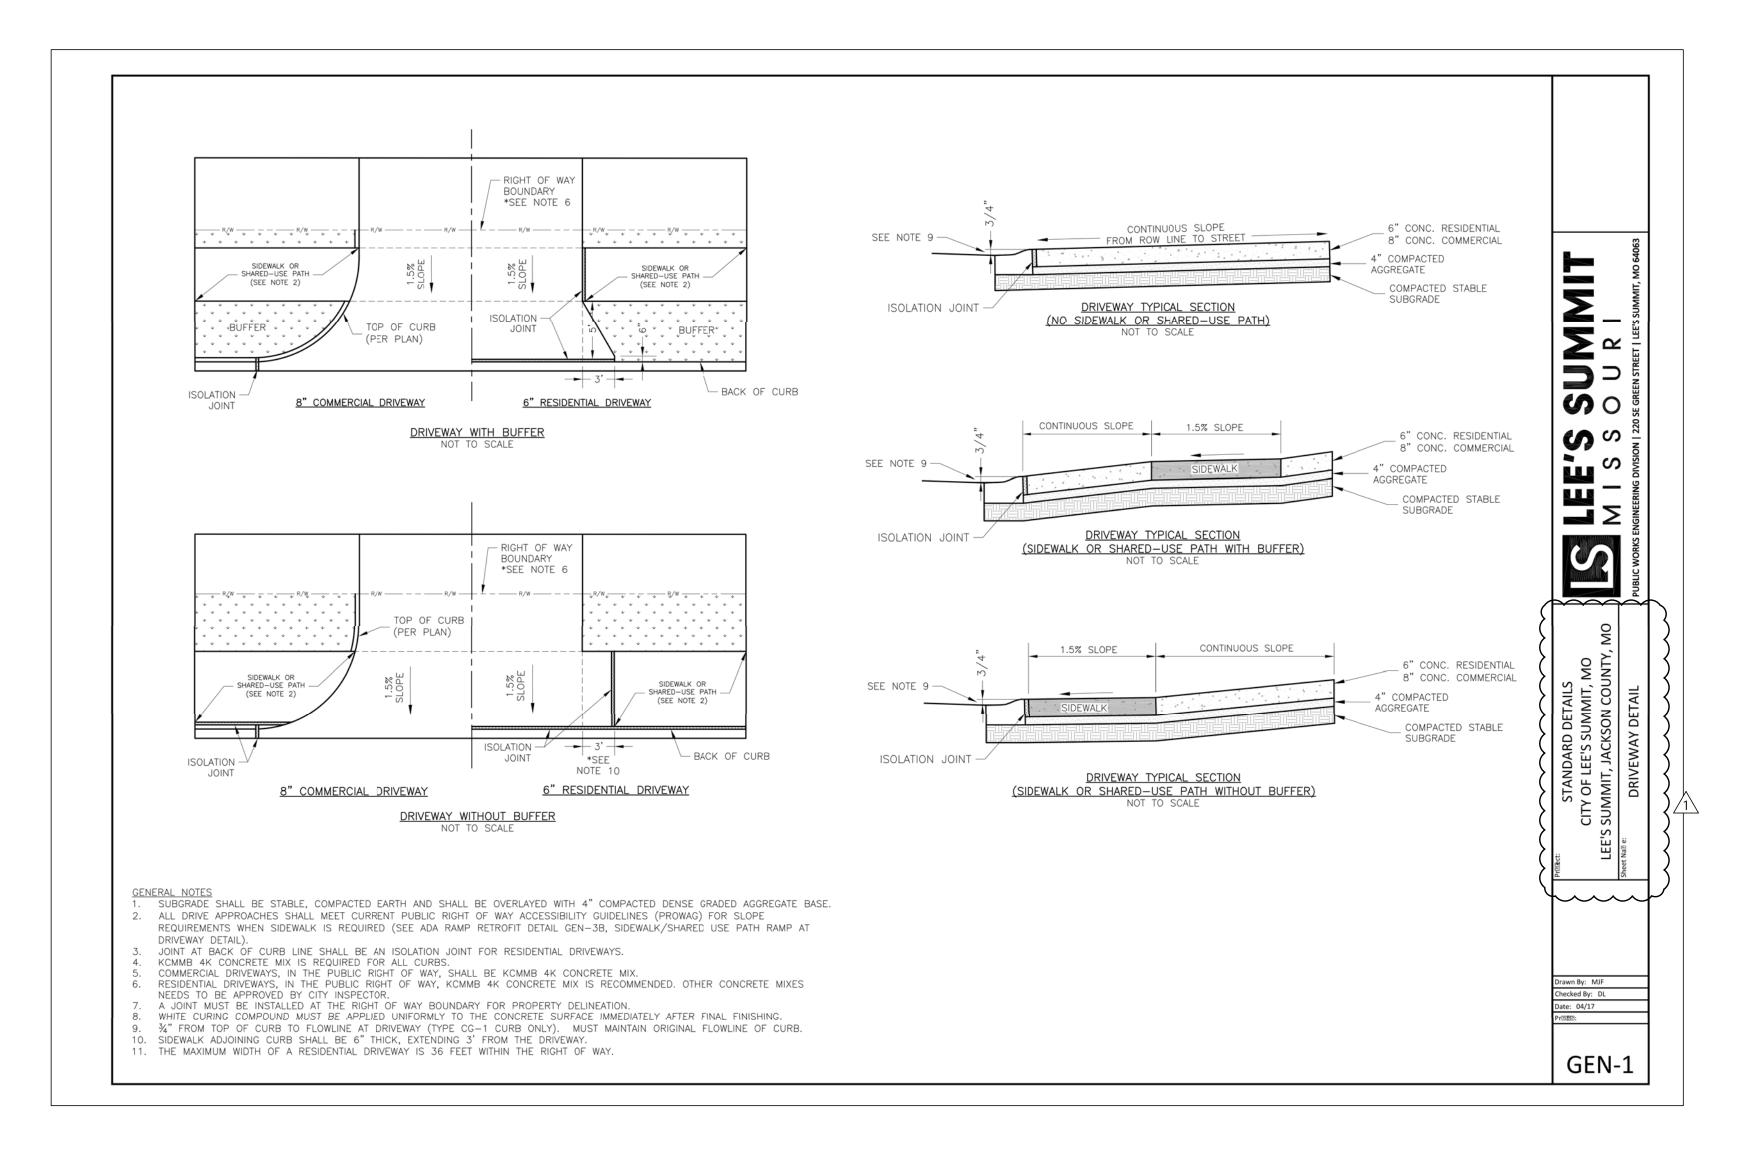

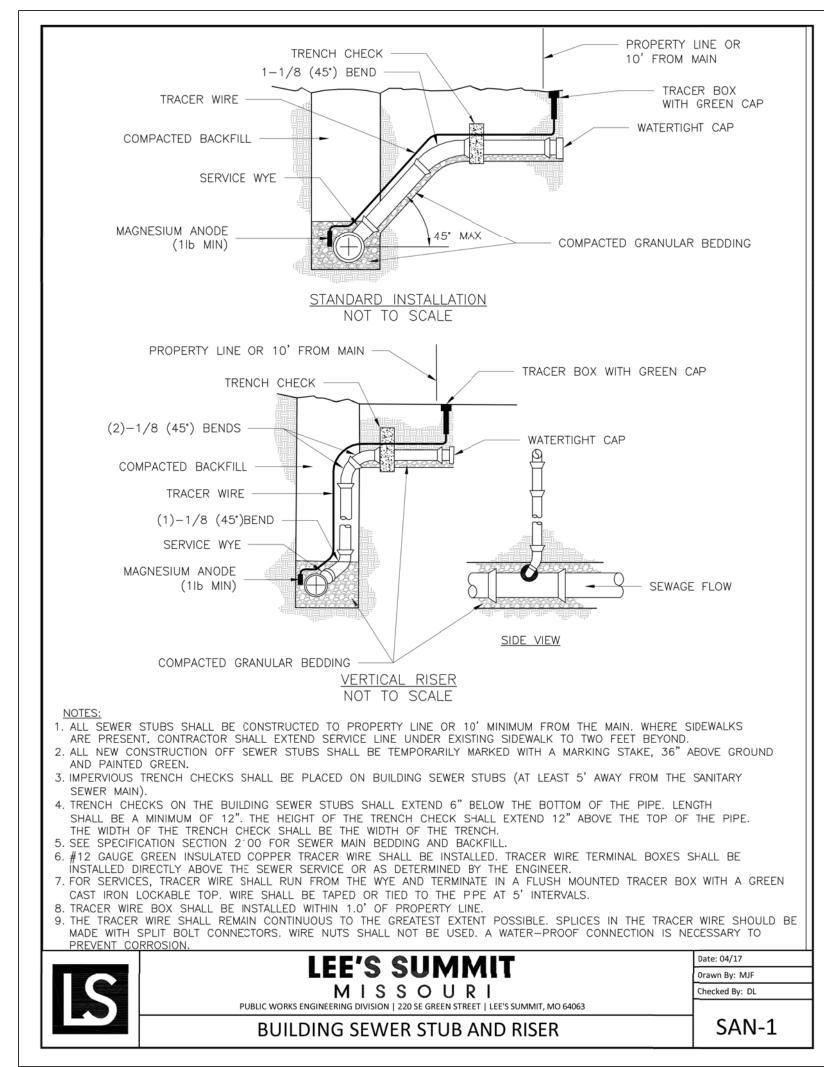


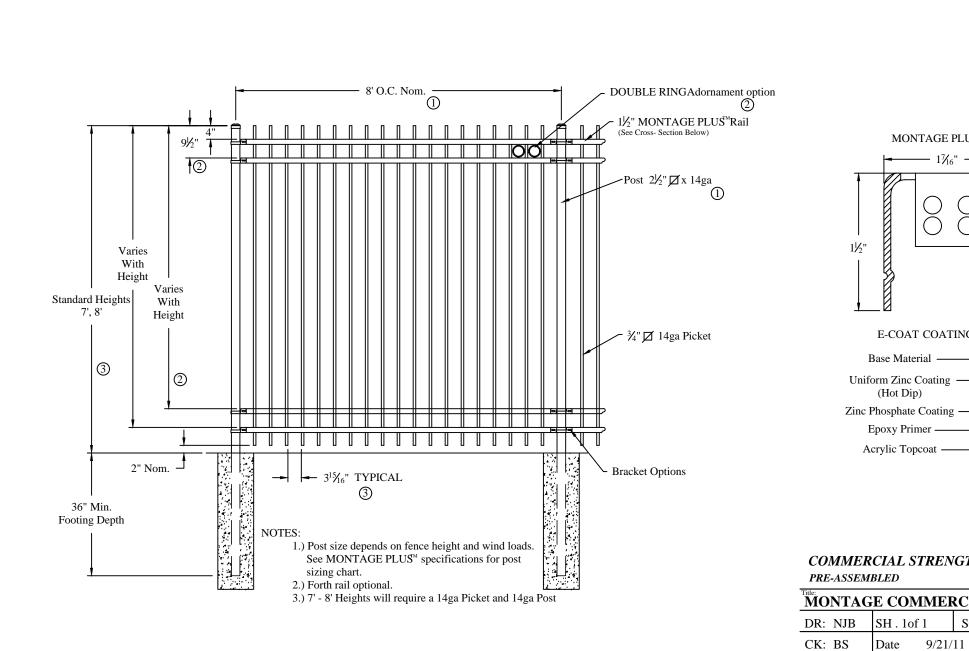

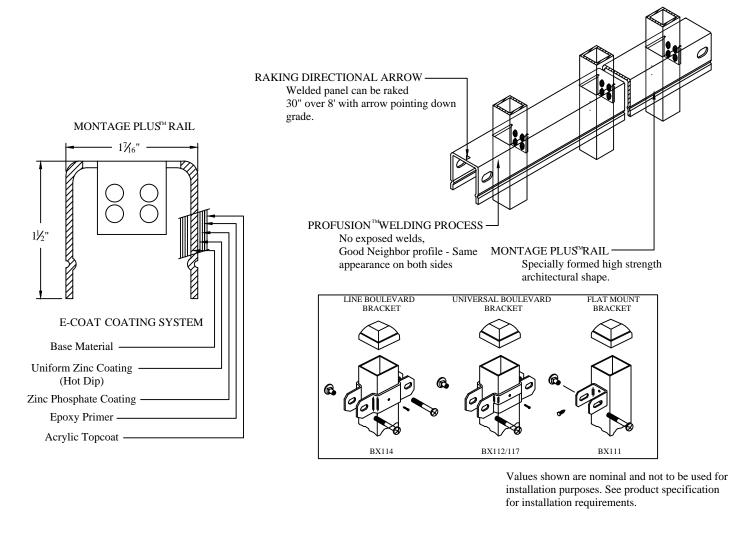

COMMERCIAL STRENGTH WELDED STEEL PANEL PRE-ASSEMBLED MONTAGE COMMERCIAL GENESIS 3/4-RAIL

1555 N. Mingo Tulsa, OK 74116 DR: NJB SH . 1 of 1 SCALE: DO NOT SCALE 1-888-333-3422 REV: d www.ameristarfence.com

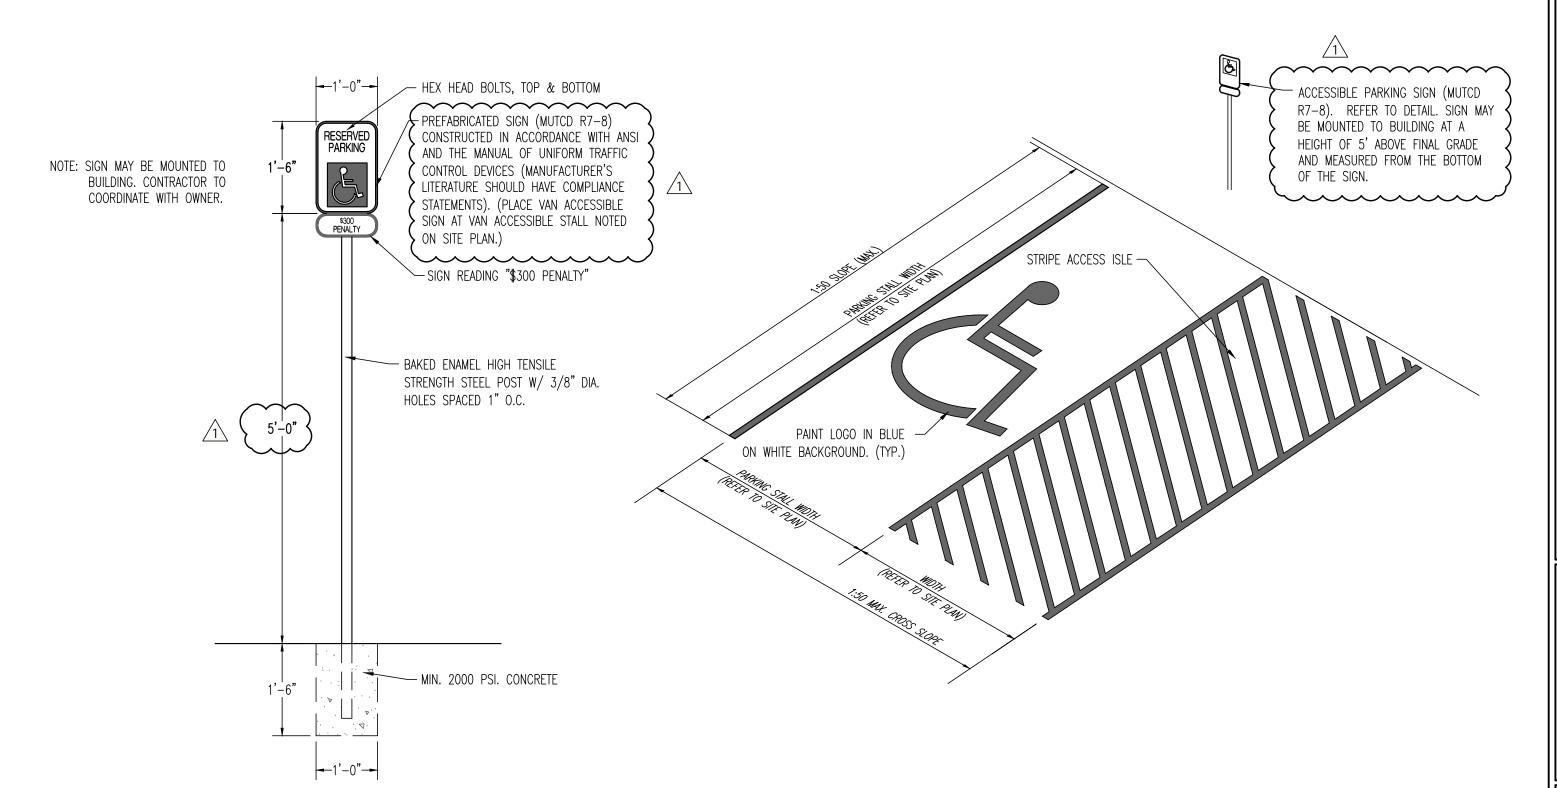

ACCESSIBLE PARKING SIGN

ACCESSIBLE PARKING STALL AREA DETAIL

DATED ELECTRONICALLY TIMOTHY D. CROCKETT MO LICENSE - 2004000775

REVISIONS:

STORAGE MART 156 3920 S SECTION 3, TOWN! LEE'S SUMMIT, J


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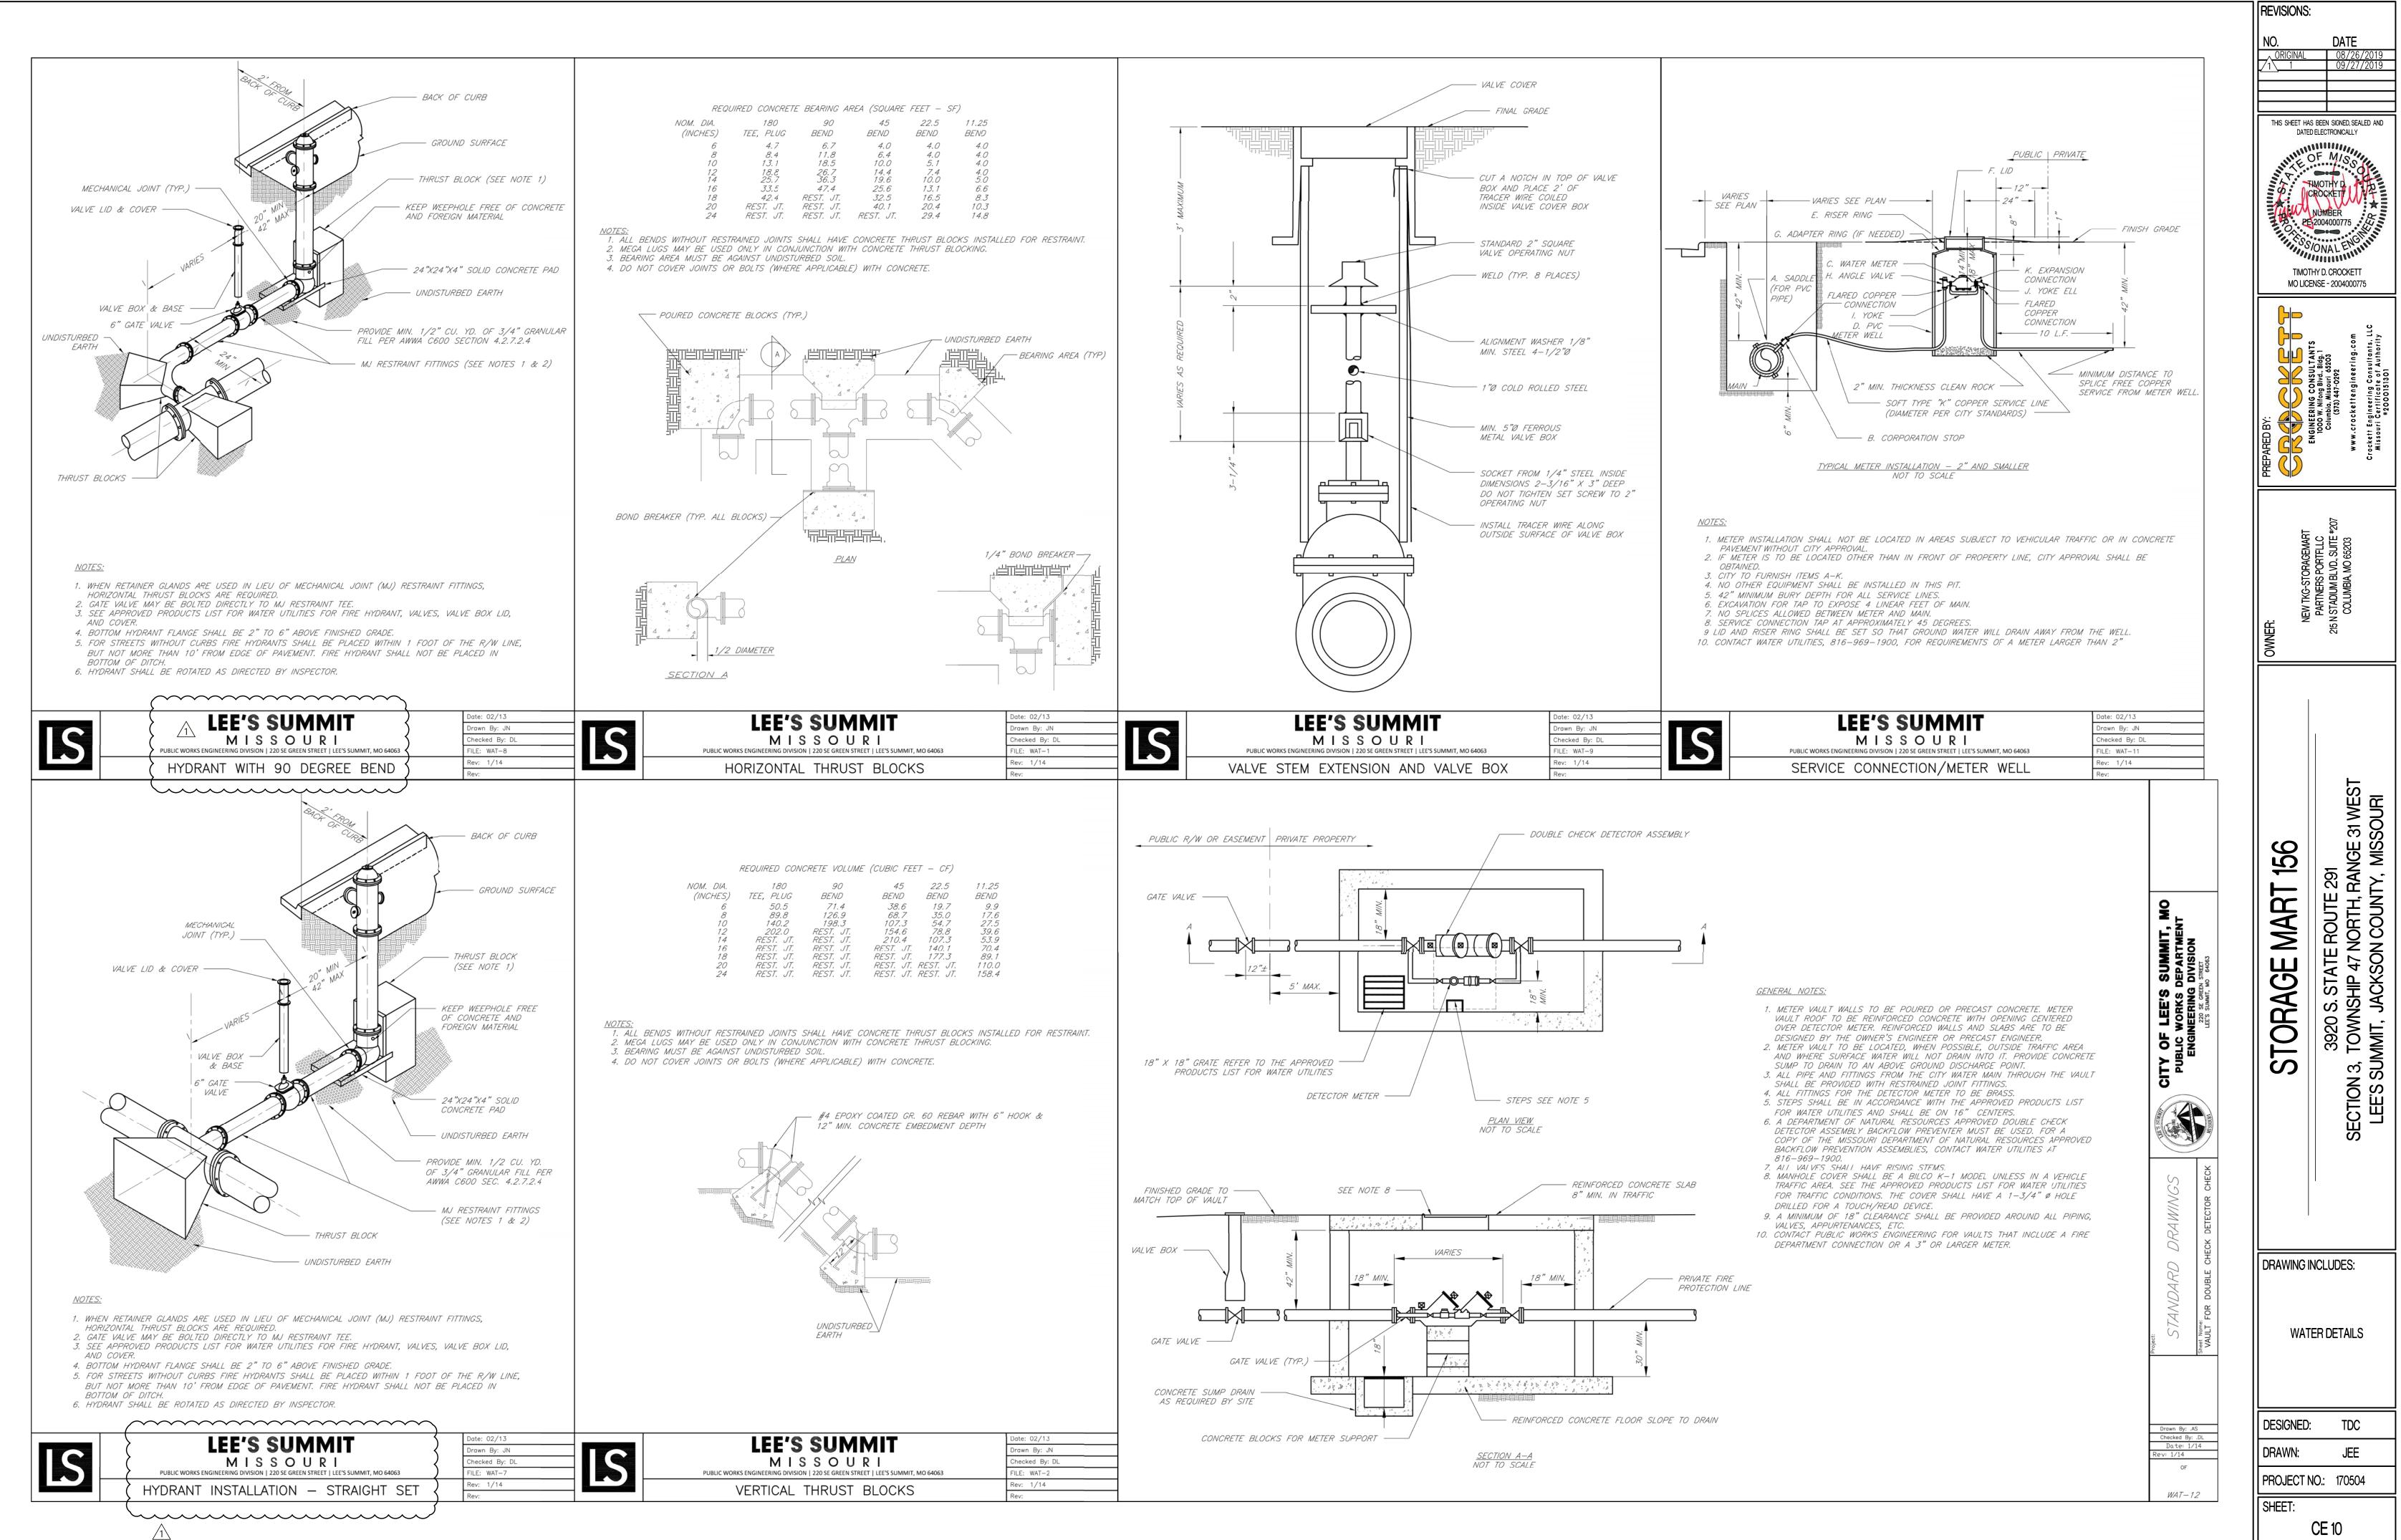
ACCESSIBLE PARKING, SANITARY SEWER &


SECURITY FENCE DETAILS

DESIGNED: TDC JEE PROJECT NO.: 170504

SHEET:



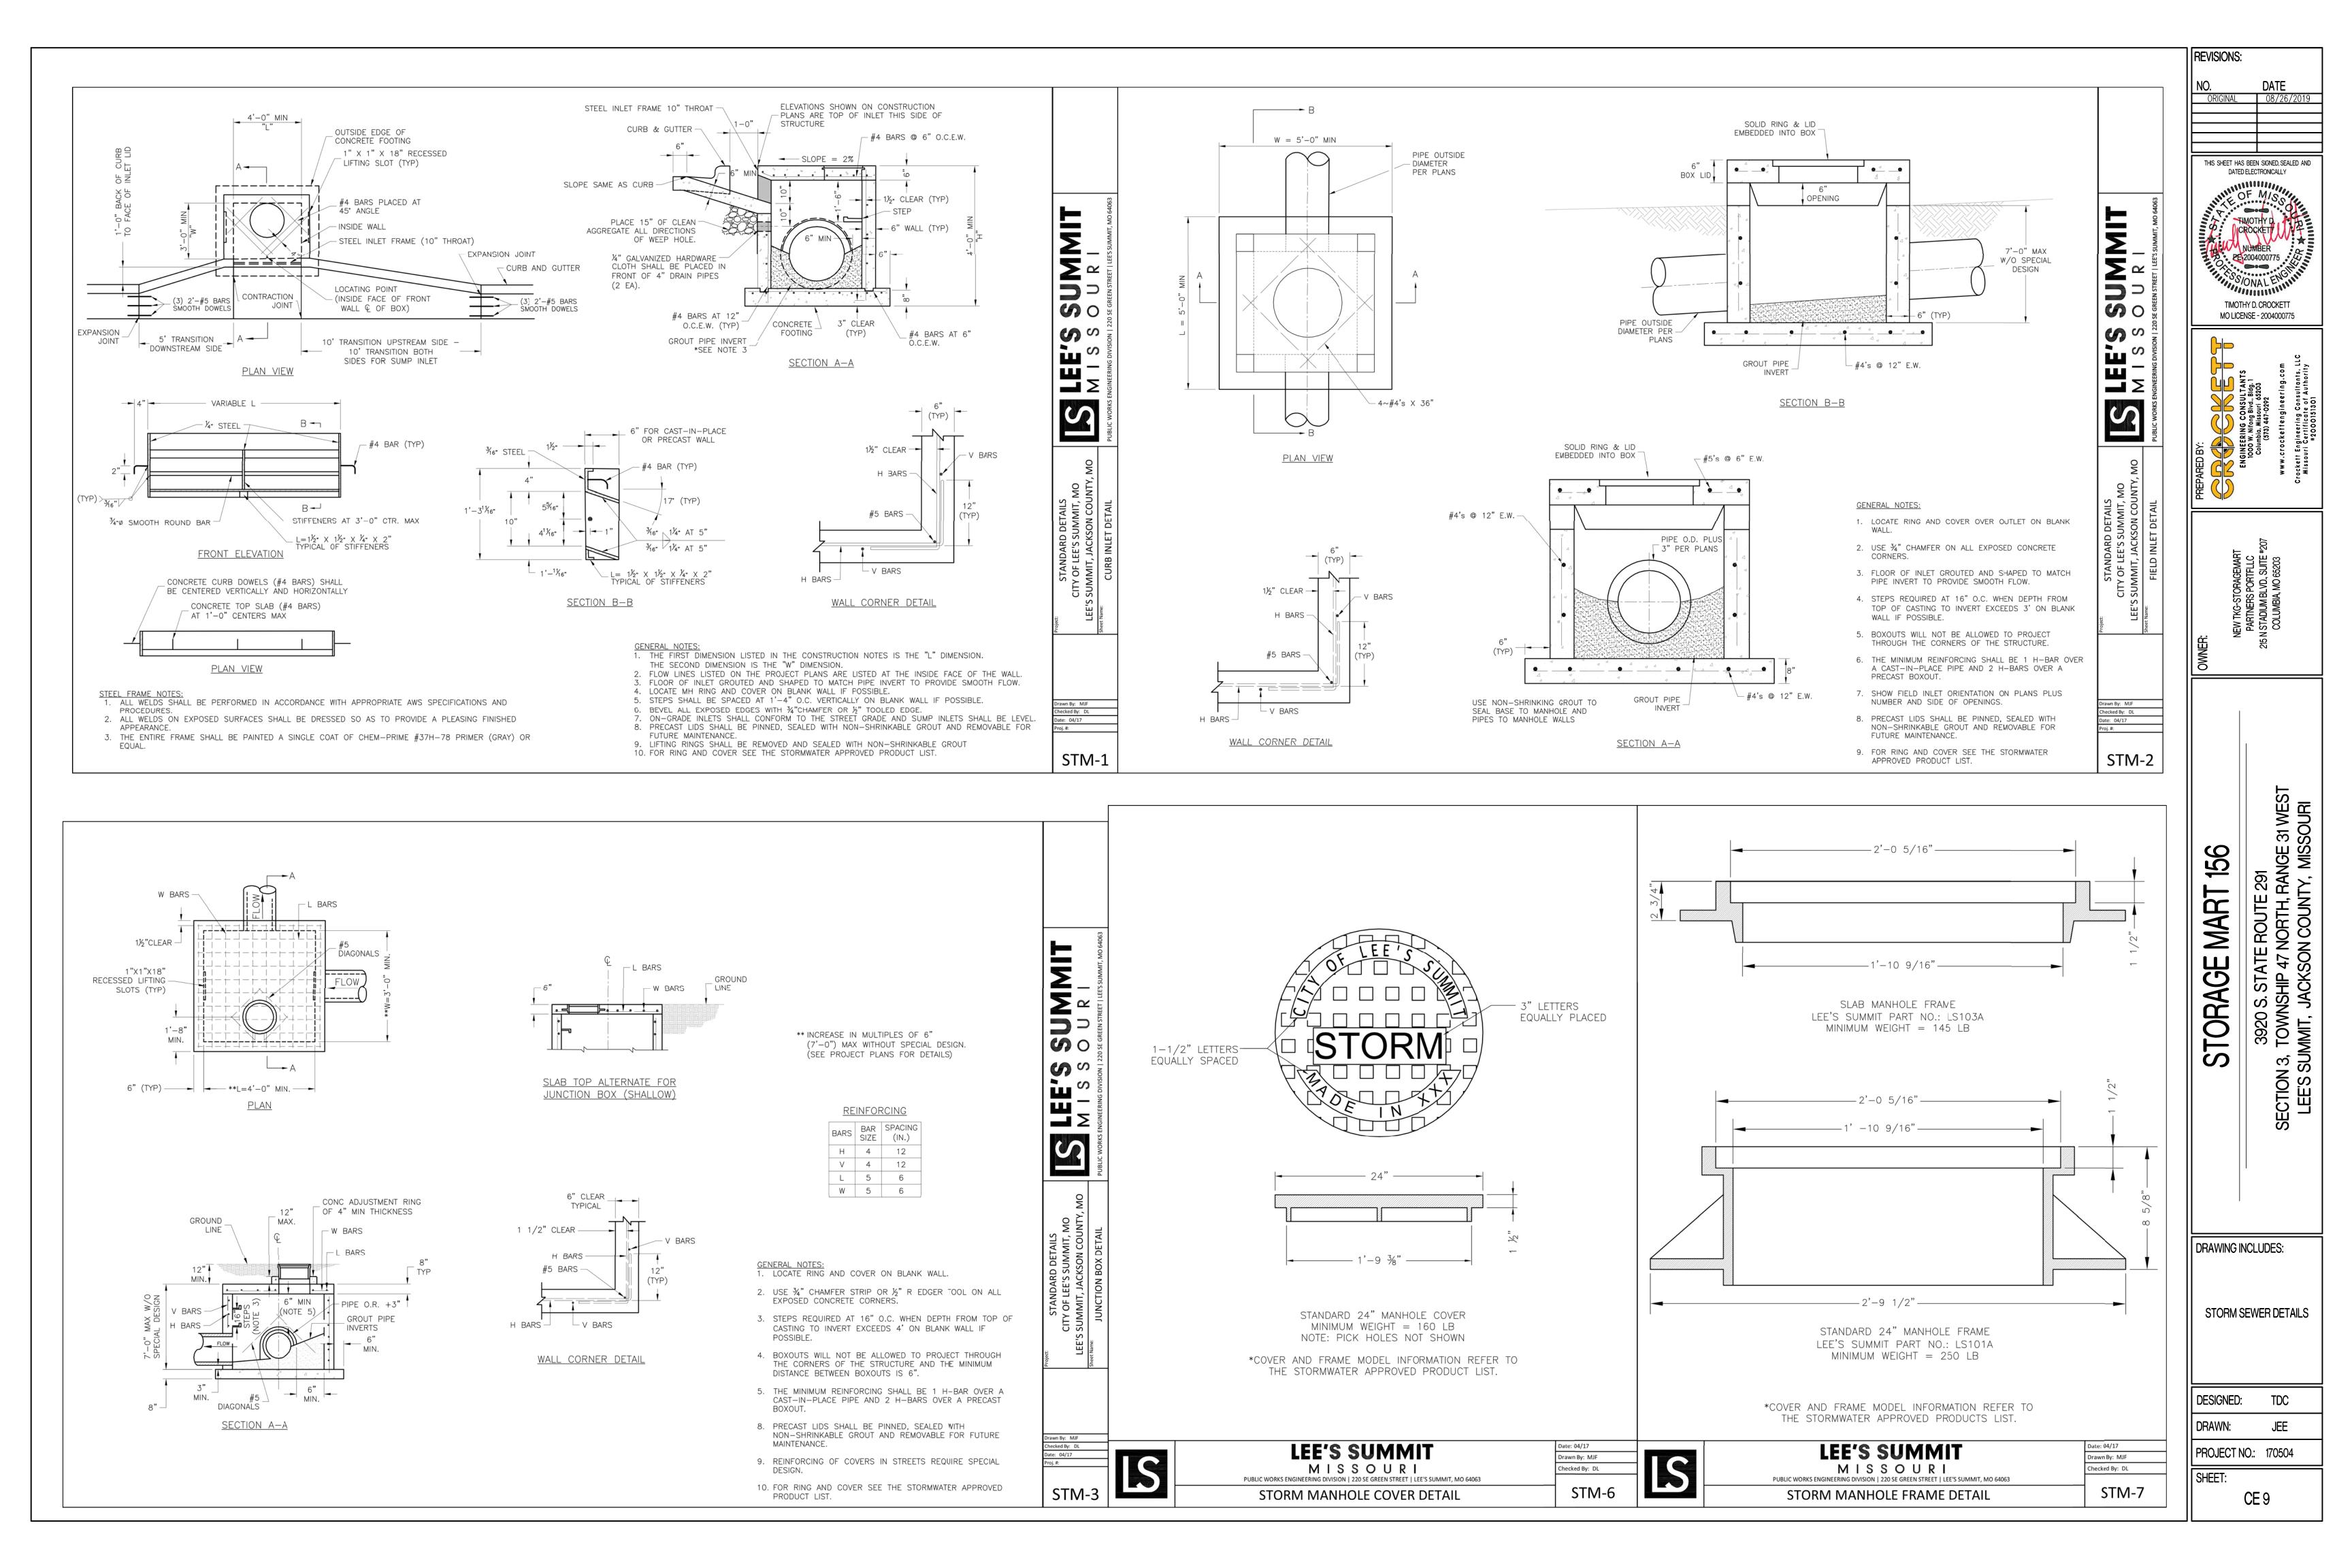

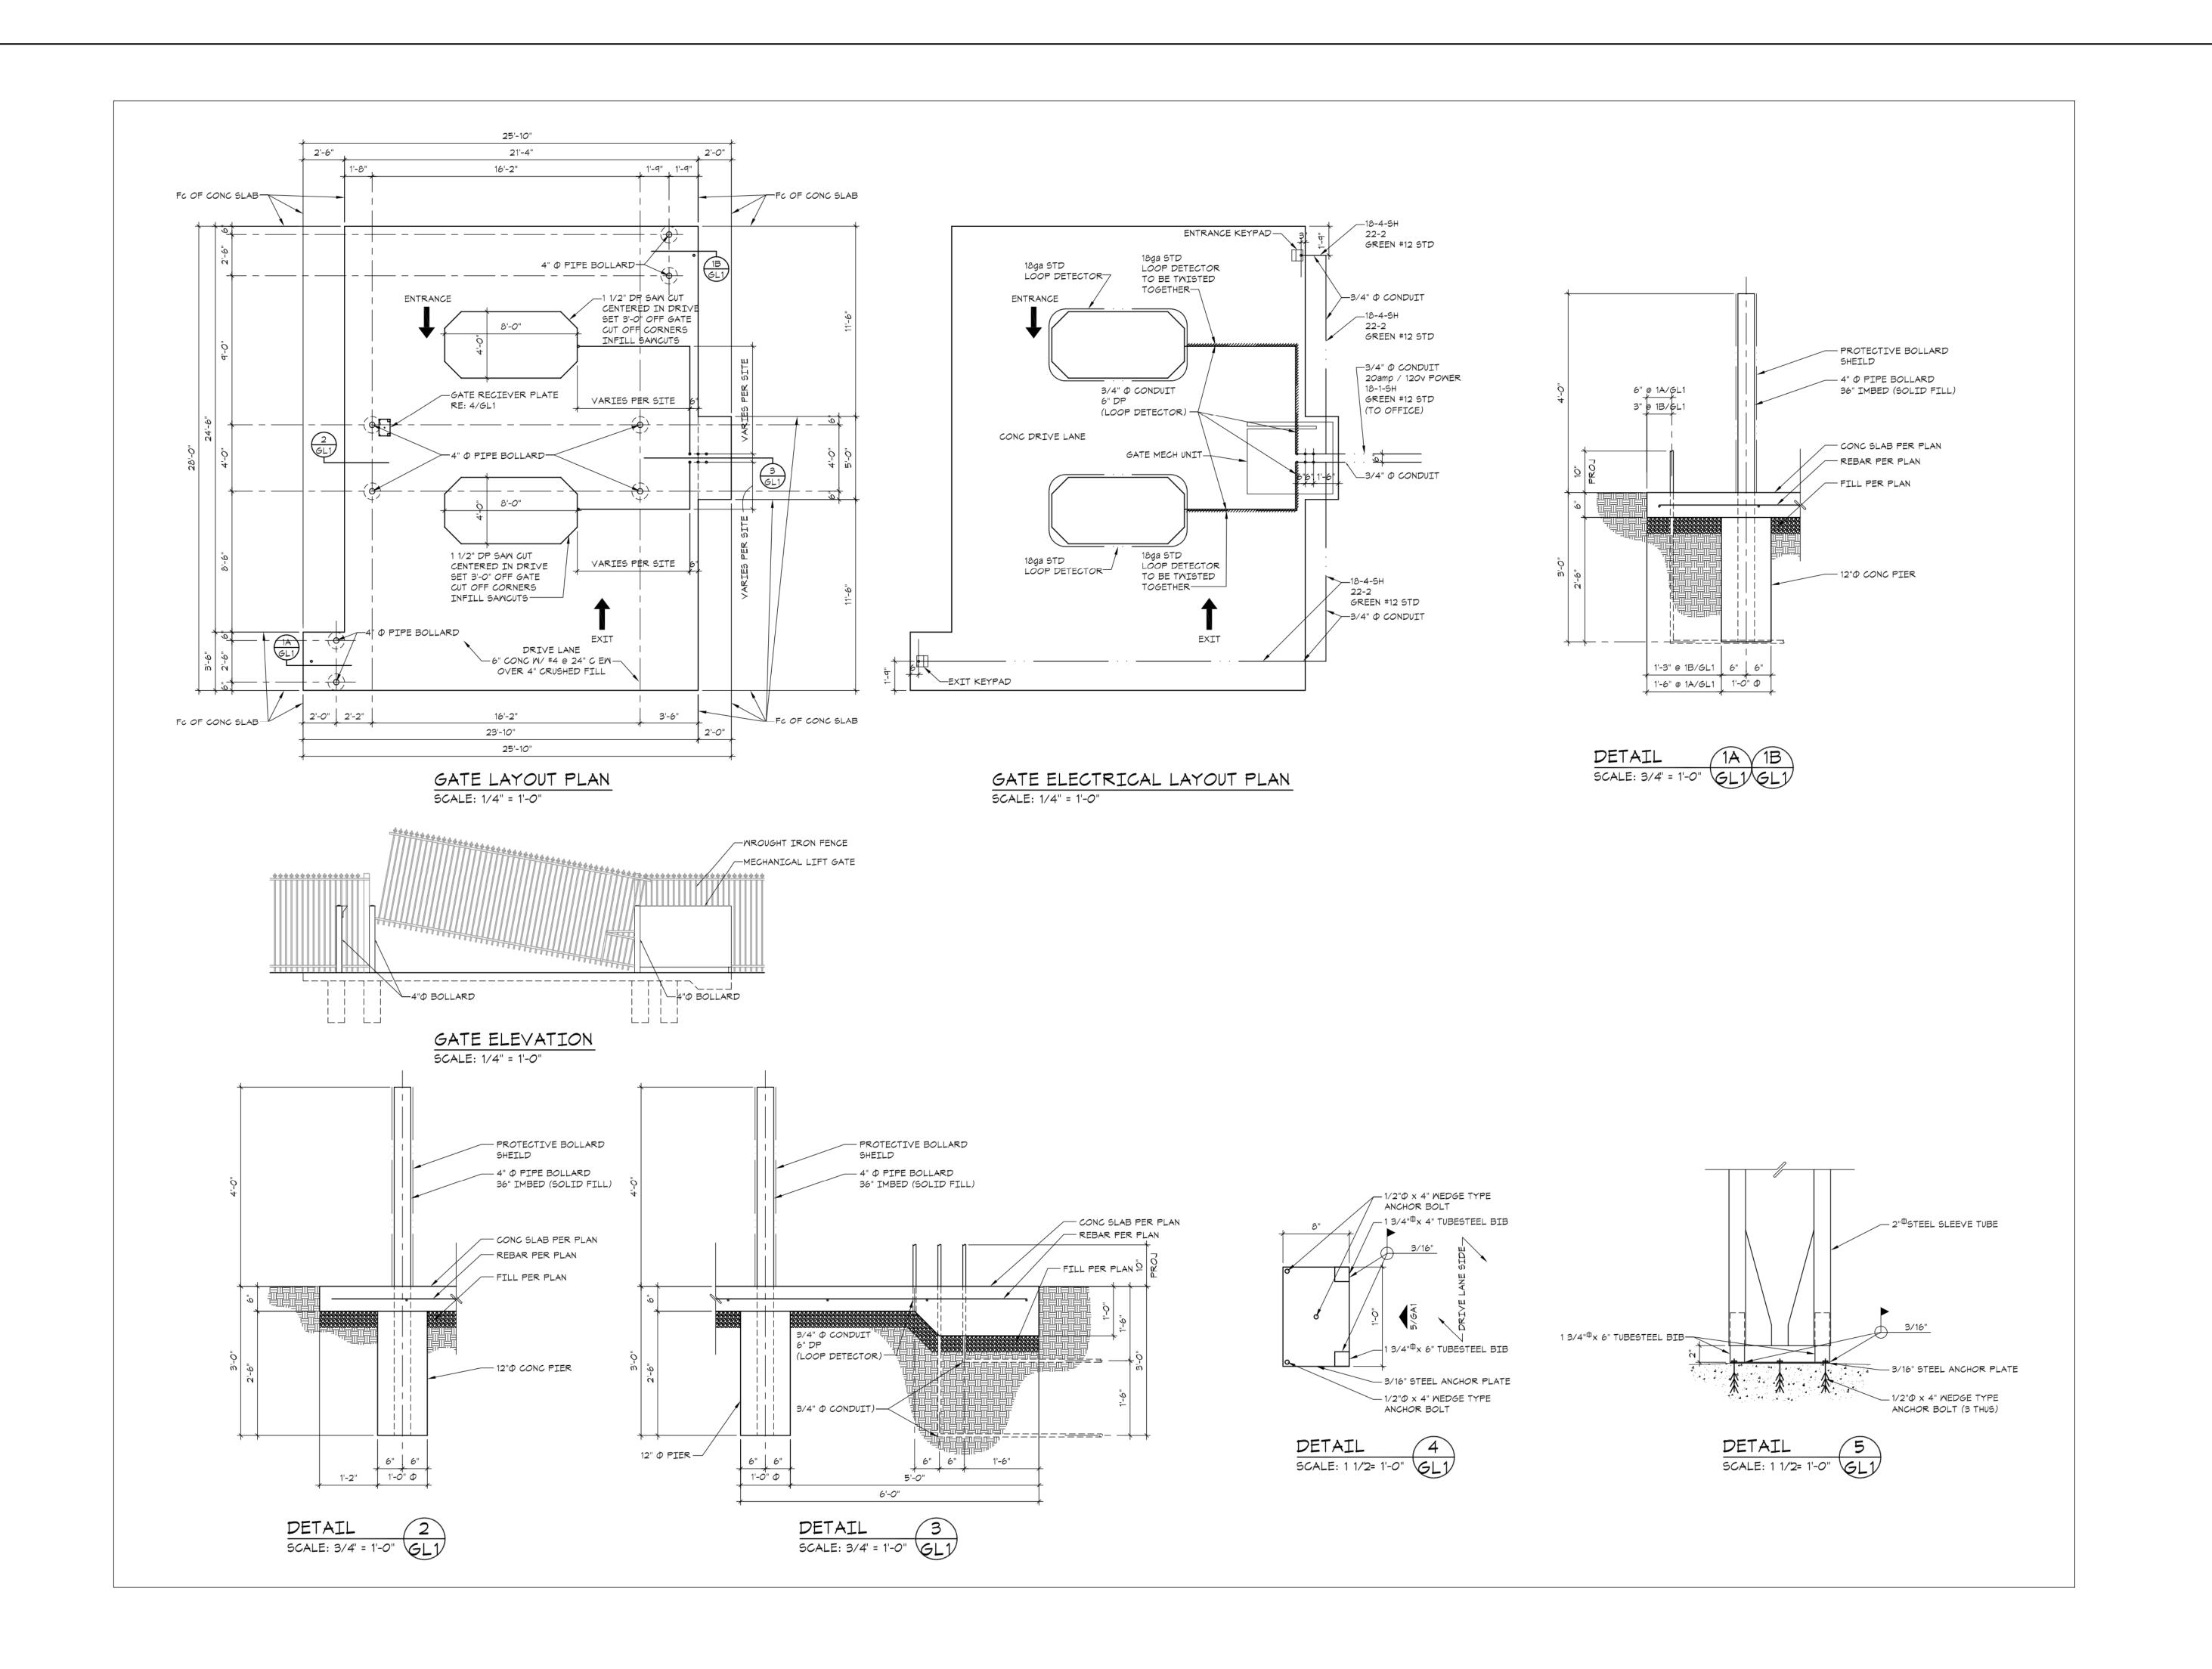

THIS SHEET HAS BEEN SIGNED, SEALED AND DATED ELECTRONICALLY TIMOTHY D. CROCKETT MO LICENSE - 2004000775

| REVISIONS:

STORAGE MART 156

3920 S. STATE ROUTE 291 SECTION 3, TOWNSHIP 47 NORTH, RANGE 31 M LEE'S SUMMIT, JACKSON COUNTY, MISSOU

DRAWING INCLUDES:


SECURITY GATE DETAILS

DESIGNED: TDC DRAWN: JEE

PROJECT NO.: 170504

SHEET:

CE 11

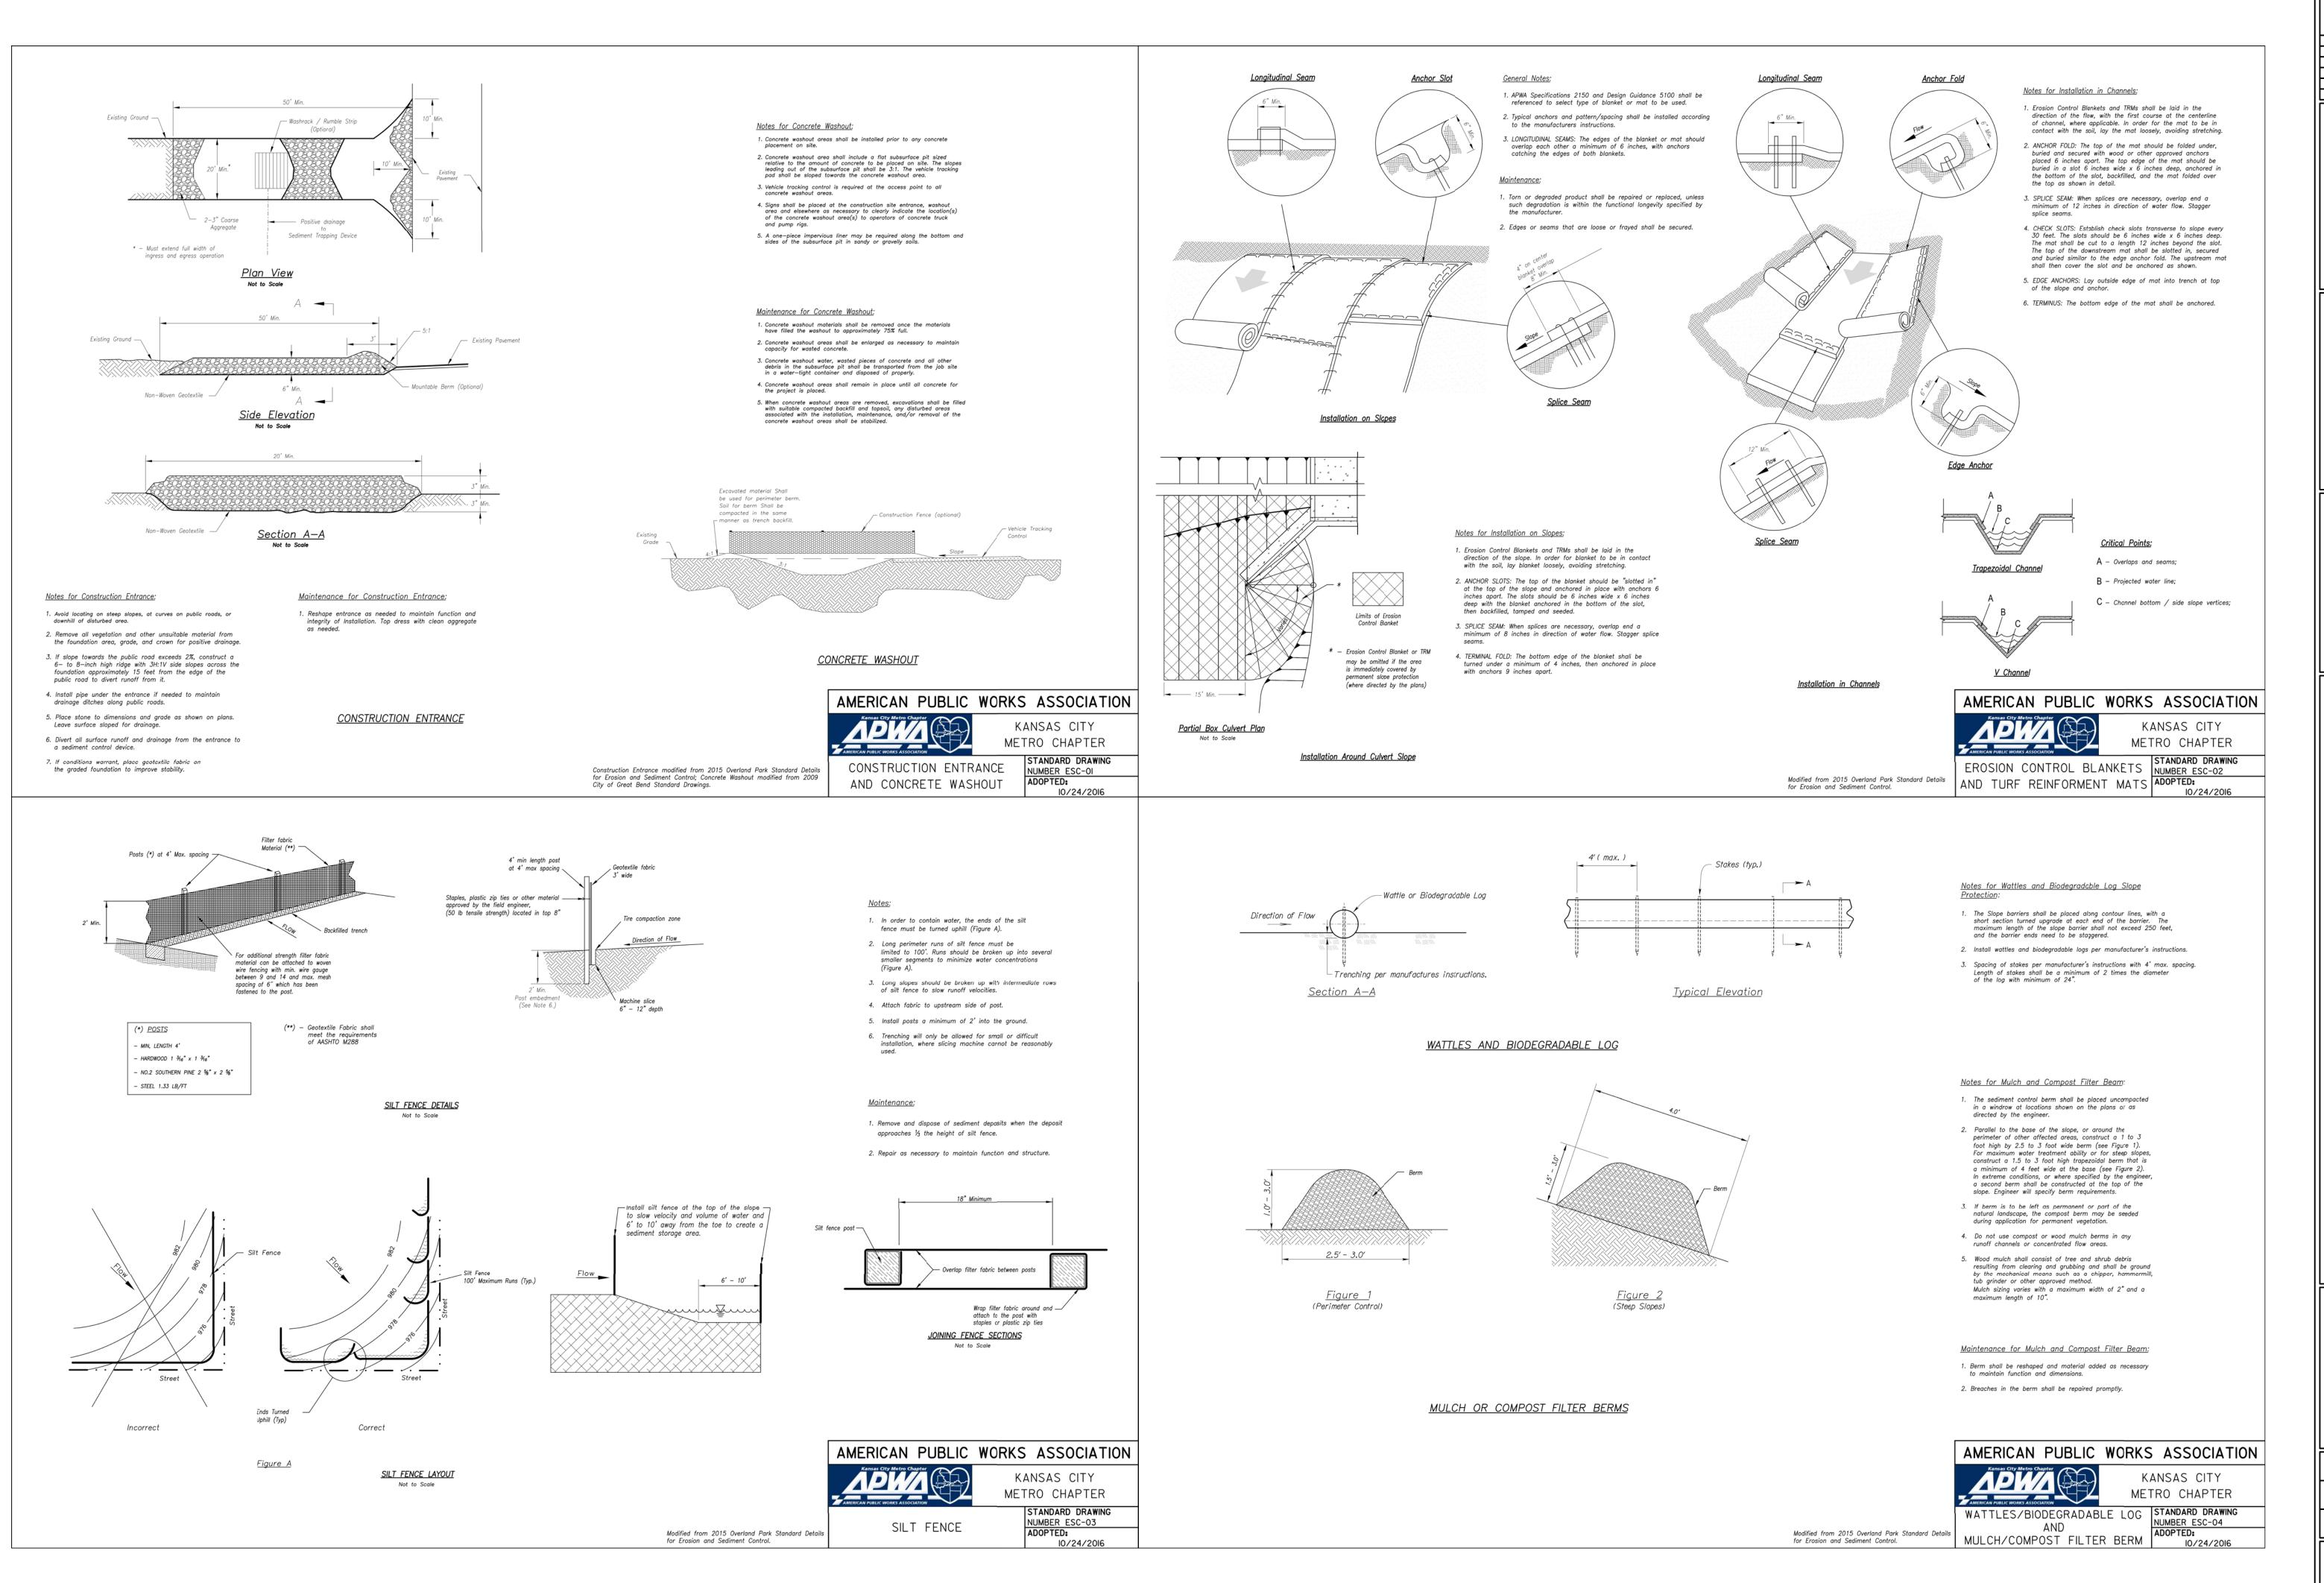

THIS SHEET HAS BEEN SIGNED, SEALED AND DATED ELECTRONICALLY

TIMOTHY D. CROCKETT MO LICENSE - 2004000775

31 W SOU 156 MART


TORAGE 3, SL S

DRAWING INCLUDES:

EROSION CONTROL DETAILS

DESIGNED: TDC DRAWN: JEE PROJECT NO.: 170504

SHEET:

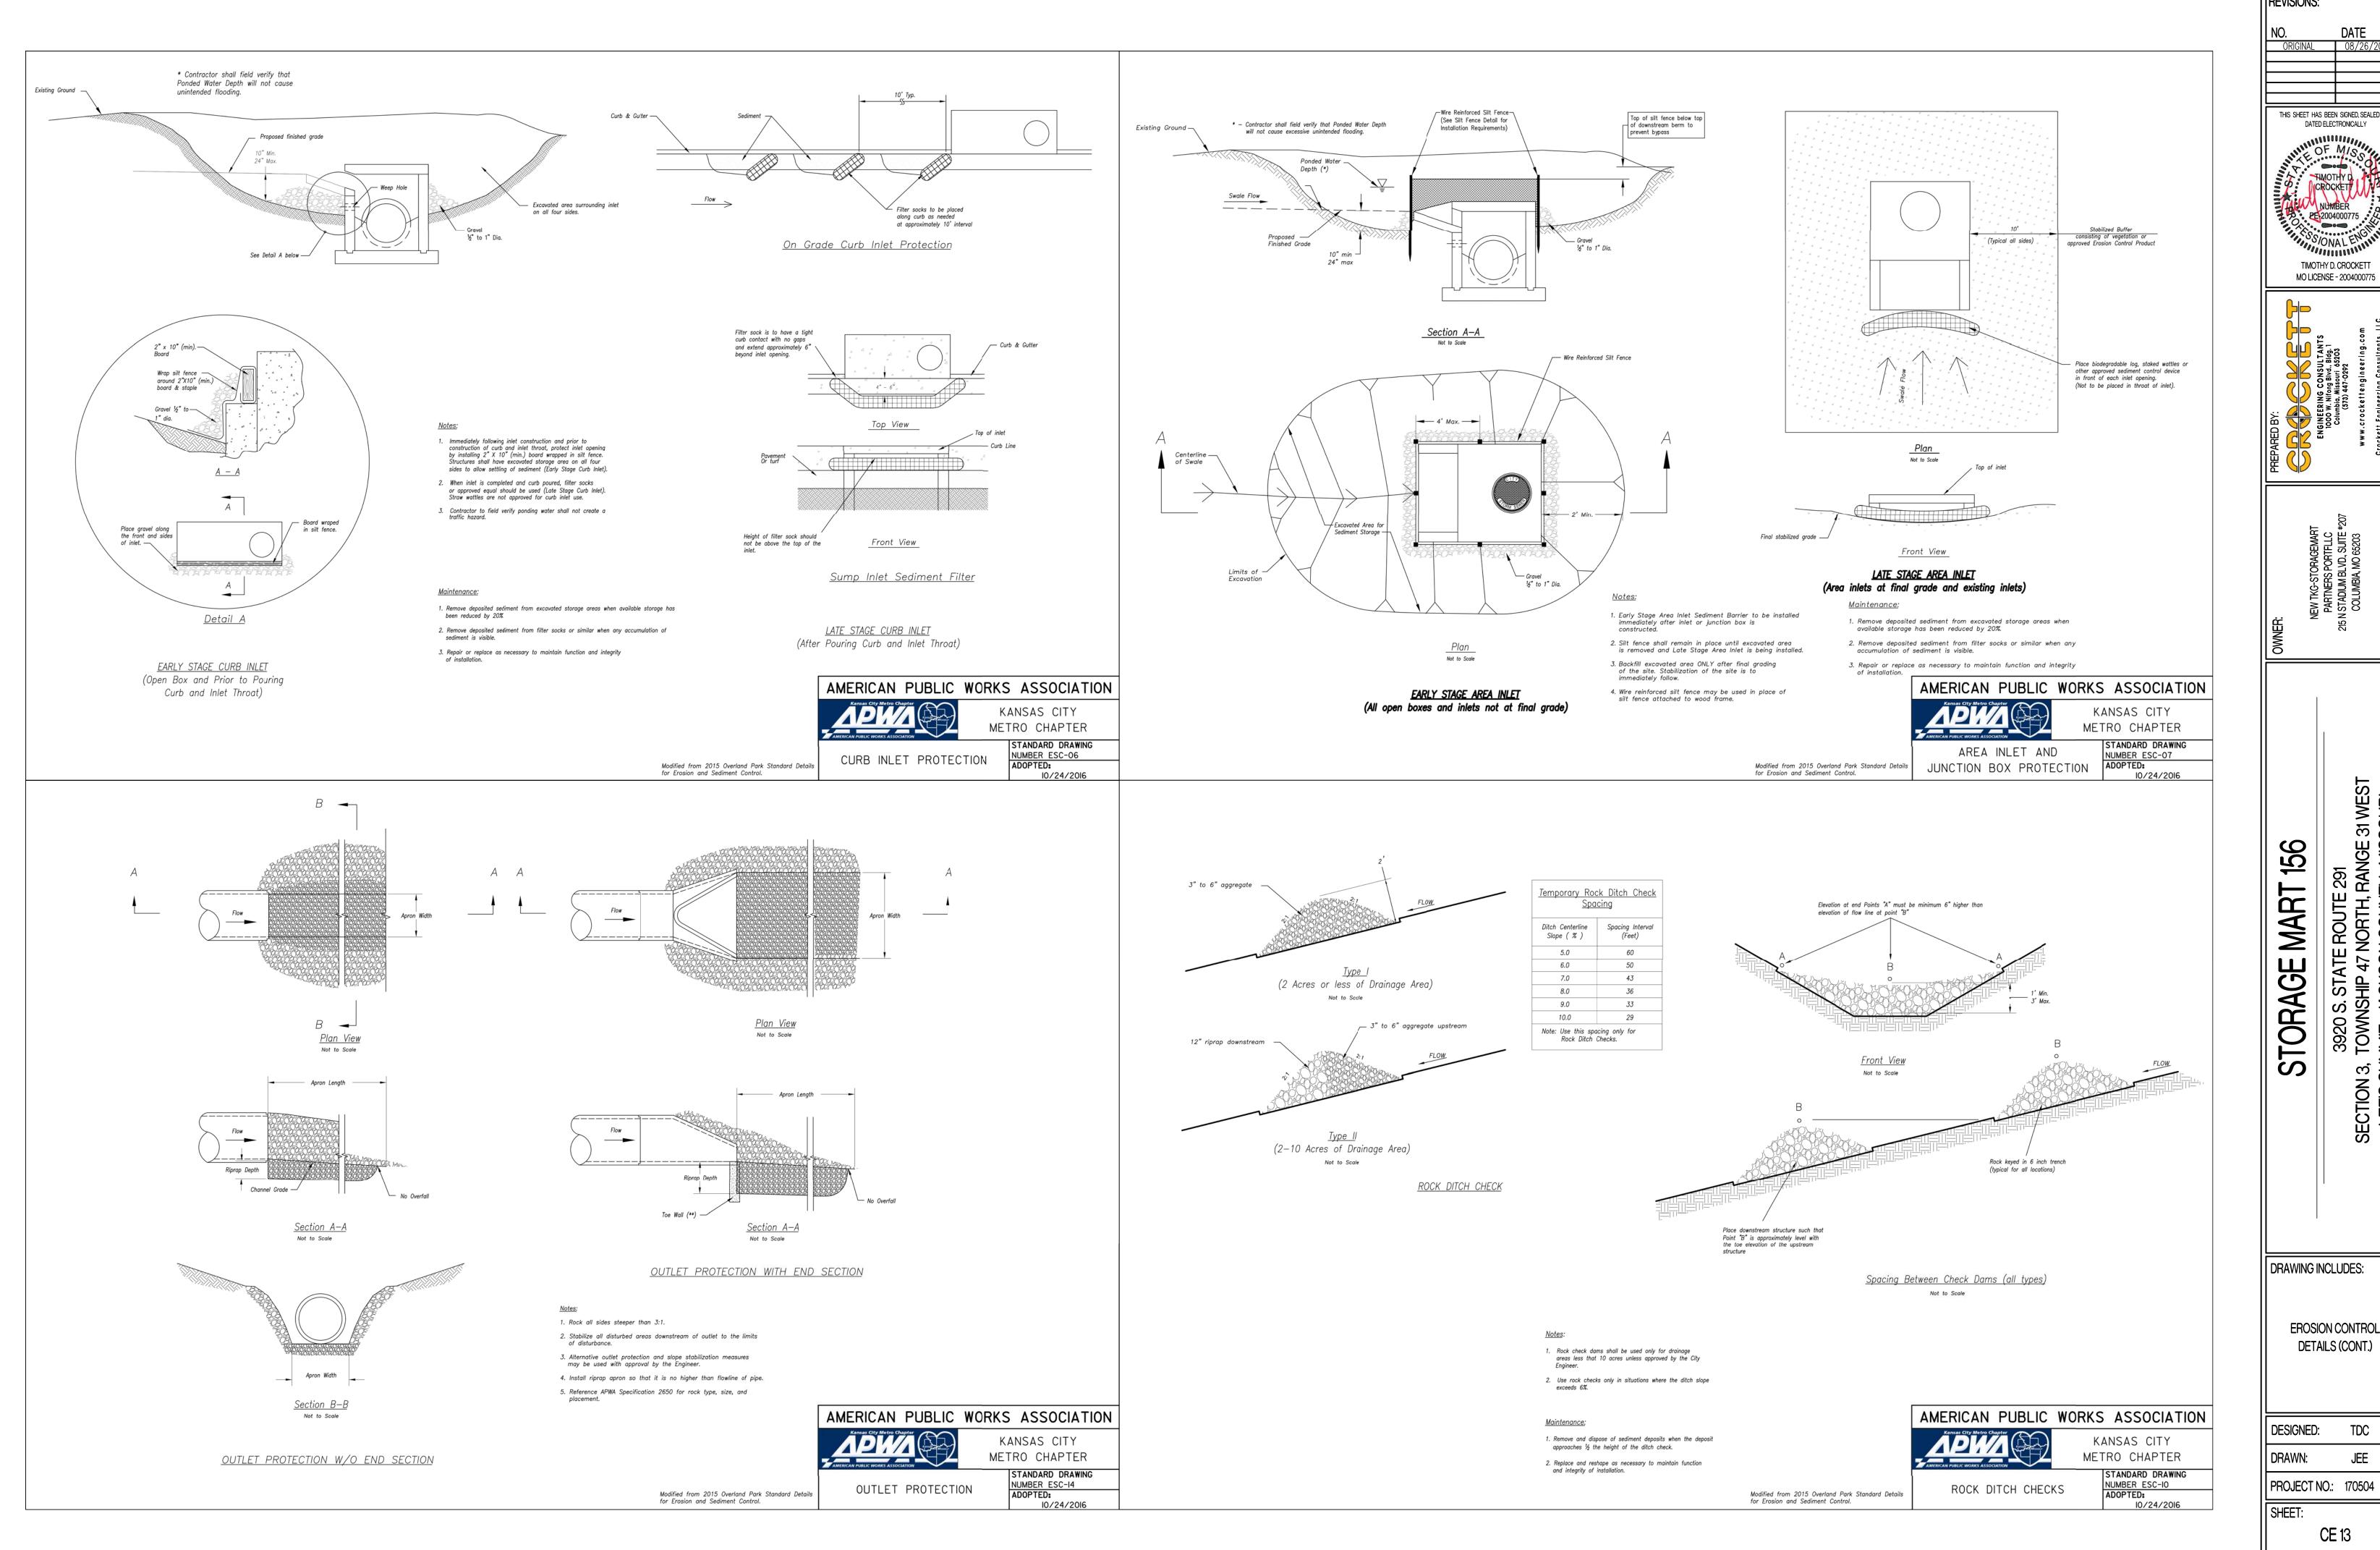

DATED ELECTRONICALLY TIMOTHY D. CROCKETT

3920 S. STATE ROUTE 291 ECTION 3, TOWNSHIP 47 NORTH, RANGE 31 M LEE'S SUMMIT, JACKSON COUNTY, MISSOU

DRAWING INCLUDES:

EROSION CONTROL

DETAILS (CONT.)

DESIGNED: TDC JEE PROJECT NO.: 170504

		OEM OEM OEM OEM
N1*40'50"E 119.48'	S87°32'55"E 198.39'	SCREENING SHALL BE IT THAT IS Y ARE TO PLANTING
N87*33'45"W 29.29'		EX. 15' SAN. SEWER ESMT.
	N8732'20"W 186,71"	OF IVIT

LANDSCAPE COMPLIANCE:									
LANDSCAPE REQUIREMENTS	REQUIREMENTS	PROPOSED							
1 TREE PER 30' OF STREET FRONTAGE	STREET FRONTAGE = 284' 284/30 = 10 TREES	10 TREES							
1 SHRUB PER 20' OF STREET FRONTAGE	STREET FRONTAGE = 284' 284/20 = 15 TREES	15 SHRUBS							
STREET FRONTAGE GREEN STRIP	20'	20'							
2 SHRUBS PER 5,000 SQ.FT. OF TOTAL LOT AREA EXCLUDING BUILDING FOOTPRINT	55,449 SQ.FT16,651 SQ.FT. = 38,798 SQ.FT./5,000 x 2 = 16 SHRUBS	16 SHRUBS							
1 TREE PER 5,000 SQ.FT. OF TOTAL LOT AREA EXCLUDING BUILDING FOOTPRINT	55,449 SQ.FT16,651 SQ.FT. = 38,798 SQ.FT./5,000 = 8 TREES	8 TREES							
1 SHADE TREE PER 500 SQ.FT. OF BUFFER AREA 1 ORNAMENTAL TREE PER 750 SQ.FT. OF BUFFER AREA 1 EVERGREEN TREE PER 300 SQ.FT. OF BUFFER AREA 1 SHRUB PER 200 SQ.FT. OF BUFFER AREA	BUFFER AREA = 3,740 SQ.FT. 3,750/500 = 8 SHADE TREES 3,750/750 = 5 ORNAMENTAL TREES 3,750/300 = 13 EVERGREEN TREES 3,750/200 = 19 SHRUBS	8 SHADE TREES 5 ORNAMENTAL TREES 13 EVERGREEN TREES 19 SHRUBS							
12 SHRUBS PER 40 L.F. OF PARKING AREA = 1 SHRUB PER 3.33 L.F.	24/3.33 = 7 SHRUBS	7 SHRUBS							


THE PLANT LIST IS PROVIDED FOR THE CONVENIENCE OF THE

- CONTRACTOR. THE CONTRACTOR SHALL VERIFY ALL PLANT COUNTS
 AND IF A DISCREPANCY EXISTS THE PLAN SHALL GOVERN.
 LANDSCAPE CONTRACTOR SHALL BE RESPONSIBLE FOR BECOMING AWARE OF ALL UNDERGROUND UTILITIES, PIPES, AND STRUCTURES. THE LANDSCAPE CONTRACTOR SHALL BE HELD RESPONSIBLE FOR CONTACTING ALL UTILITY COMPANIES FOR FIELD LOCATION OF ALL UNDERGROUND UTILITY LINES PRIOR
- LANDSCAPE CONTRACTOR TO RECEIVE SITE GRADED TO ± -0.10 FOOT OF FINISHED GRADE. PLANTING BACK FILL MIX IS TO CONSIST OF 80% NATIVE TOPSOIL, AND 20% ORGANIC MATTER. SHRUB BEDS, BERMS, AND TREE WELLS ARE TO BE MULCHED WITH 3-4" DYED HARDWOOD MULCH.
- ALL SEEDED AREAS WITH A SLOPE OF 2:1 OR GREATER SHALL BE CONTROLLED WITH EROSION CONTROL NETTING.
 ALL BED AND LAWN AREAS SHALL BE IRRIGATED WITH POP-UP SPRAY HEADS.
 ALL LAWN AREAS TO BE SODDED WITH TALL FESCUS SOD. LANDSCAPE CONTRACTOR SHALL GUARANTEE ALL PLANT MATERIAL FOR A PERIOD OF TWELVE MONTHS.

ALL PLANTING BEDS AND TREE RINGS TO BE SEPERATED FROM TURF AREAS BY 'V' TRENCHING. ALL PLANT MATERIAL MUST MEET THE SPECIFICATIONS OF THE AMERICAN ASSOCIATION OF NURSERYMEN.


PLANT SCHEDULE

SYMBOL QUANTITY - TYPE OF PLANT - EXAMPLES OF PLANTS - SIZE PLANTED

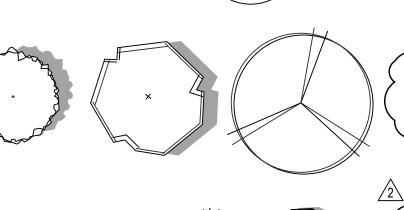


TO ANY EXCAVATION.


8 - SHADE TREE - BLACK GUM, YELLOWWOOD, AMERICAN HORNBEAM, ETC - 3''CAL. (MIN.)

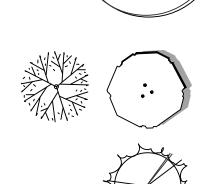


23 - ORNAMENTAL TREE - DECIDUOUS HOLLY, REDBUD, GREEN HAWTHORNE, ETC - 3'' CAL. (MIN.)

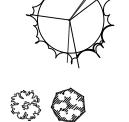


13 - EVERGREEN TREE - EASTERN RED CEDAR, LACEBARK PINE, ETC - 8' H (MIN.)

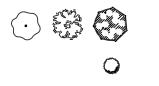

30 - FLOWERING SHRUB - BLACK HAW VIBURNUM (FOR BUFFER), WILD HYDRANGEA, NINEBARK, ETC - 5 GAL 45-EVERGREEN SHRUB - SKY ROCKET JUNIPER, DWARF ARBORVITAE, ETC - 5 GAL

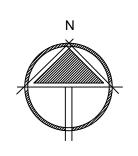

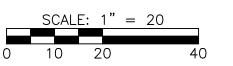



2450 TRAILS WEST AVENUE

WWW.ROSTLANDSCAPING.COM

COLUMBIA, MO 65202 (573) 445-4465

FOR S DEVELOPMENT SUMMIT, GE OAD 3920 S STATE R LANDSCAPI

9.27.19 Date: DESIGNER: JP

SCALE: 1"=20'-0"

REVISIONS:

9.27.19 - CITY COMMENTS 11.22.19 - CITY COMMENTS

SHEET NUMBER:

PROJECT NUMBER:

REPRODUCTION OF THESE PLANS IN WHOLE OR PART OR THE REPRODUCTION OF DERIVATIVE WORKS THEREOF WITHOUT THE WRITTEN PERMISSION OF ROST INC IS PROHIBITED. USE OF THESE PLANS IS LIMITED TO THE CONSTRUCTION OF THIS PROJECT ONLY. USE OF THESE PLANS FOR ANY PURPOSE OTHER THAN USE ON THIS PROJECT IS STRICTLY PROHIBITED.

Site Lighting Design Drawings for

Storage Mart Addition

3920 South State Route 291 Lee's Summit, Jackson County, Missouri

GENERAL MEP SPECIFICATIONS

1. IT IS THE RESPONSIBILITY OF THE CONTRACTOR TO REVIEW AND UNDERSTAND ALL DRAWINGS AND SPECIFICATIONS IN THE CONTRACT DOCUMENTS. EACH CONTRACTOR IS RESPONSIBLE FOR ALL WORK ASSOCIATED WITH HIS TRADE REGARDLESS OF WHERE THE WORK IS DEPICTED IN THE DRAWINGS OR SPECIFICATIONS.

COORDINATED IN FIELD. THE CONTRACTOR SHALL INCLUDE THIS COORDINATION IN HIS SCOPE AND INCLUDE ALL COSTS OF MODIFYING THE LAYOUT AS REQUIRED IN HIS BID.

3. THE CONTRACTOR IS RESPONSIBLE FOR PROVIDING ALL NECESSARY PARTS AND LABOR TO

2. THE LAYOUT OF SYSTEMS SHOWN ON PLANS ARE APPROXIMATE AND WILL NEED TO BE

- 3. THE CONTRACTOR IS RESPONSIBLE FOR PROVIDING ALL NECESSARY PARTS AND LABOR TO PRODUCE A COMPLETE AND FULLY OPERATIONAL SYSTEM UNLESS STATED OTHERWISE ON DIAMS
- PLANS.

 4. ALL MATERIALS TO BE NEW, FIRST CLASS, AND INSTALLED PER MANUFACTURE'S PUBLISHED INSTRUCTIONS
- INSTRUCTIONS.
- 5. ALL WORK SHALL BE PERFORMED IN COMPLIANCE WITH LOCALLY ADOPTED CODES AND ORDINANCES.
- 6. CONTRACTOR IS RESPONSIBLE FOR TO COORDINATE EQUIPMENT LOCATIONS AND SYSTEM ROUTING WITH OTHER TRADES PRIOR TO INSTALLATION.
 7. CONTRACTOR TO GUARANTEE ALL MATERIALS AND WORKMANSHIP FOR A PERIOD OF ONE YEAR
- FROM THE DATE THE PROJECT IS TURN OVER TO THE OWNER, UNLESS NOTED OTHERWISE.

 8. CONTRACTOR IS TO INCLUDE IN HIS SCOPE THE COST OF ALL PERMITS, INSPECTIONS, METERING,
- AND TAPS ASSOCIATED WITH HIS WORK.
- 9. CONTRACTOR IS RESPONSIBLE FOR ALL EXCAVATION, CUTTING, CORING, PATCHING, AND BACKFILL REQUIRED TO COMPLETE HIS WORK, UNLESS NOTED OTHERWISE.
- 10. THESE PLANS ARE NOT TO BE SCALED. SEE ARCHITECTURAL PLANS FOR DIMENSIONS. WHERE THERE IS A CONFLICT BETWEEN ARCHITECTURAL DIMENSIONS AND MEP DIMENSION, ARCHITECTURAL SHALL GOVERN.
- 11. SEE DISCIPLINE SHEETS FOR ADDITIONAL DISCIPLINE SPECIFIC SPECIFICATIONS.

ELECTRICAL SPECIFICATIONS

 GENERAL
 1.1. THE ENTIRE ELECTRICAL SYSTEM SHALL BE CONTINUOUSLY GROUNDED. EVERY BRANCH CONDUIT SHALL INCLUDE A GREEN GROUND CONDUCTOR SIZED PER NEC.

1.2. ARC-FAULT CIRCUITS SHALL BE RUN WITH A DEDICATED NEUTRAL AS REQUIRED BY MANUFACTURER.

1.2. PROVIDE DEDMANENT ARC ELASH LABEL AFELYED TO EVERY DISCONNECT AND DANE

1.3. PROVIDE PERMANENT ARC-FLASH LABEL AFFIXED TO EVERY DISCONNECT AND PANEL.
1.4. PROVIDE TYPE WRITTEN PANEL SCHEDULE FOR EACH PANEL.
2. MATERIALS

2.1. CONDUIT & CONDUCTORS

- 2.1.1. ALL CONDUCTORS SIZES INDICATED ON PLANS ARE COPPER UNLESS NOTED
- 2.1.2. ABOVE GRADE CONDUCTORS SHALL BE THHN COPPER. BELOW GRADE CONDUCTORS SHALL BE XHHW-2.
- 2.1.3. MINIMUM CONDUCTOR SIZE SHALL BE #12 UNLESS NOTED OTHERWISE. 120V, 20 AMP CIRCUITS WITH CONDUCTOR LENGTH GREATER THAN 100' SHALL BE MINIMUM #10. ELECTRICAL CONTRACTOR IS RESPONSIBLE FOR MEASURING ACTUAL CONDUCTOR LENGTH AND INCREASING CONDUCTOR SIZE TO COMPENSATE FOR VOLTAGE DROP AS REQUIRED BY NEC.
- 2.1.4. RIGID GALVANIZED OR SCHEDULE 40 PVC CONDUIT SHALL BE USED FOR SERVICE WIRING, BELOW GRADE INSTALLATIONS, OR WHERE EXPOSED TO WEATHER.
- 2.1.5. IN APPLICATIONS OTHER THAN THOSE LISTED IN 2.1.4, EMT OR MC CABLE IS ACCEPTABLE. WHERE CONDUCTORS ARE PROTECTED FROM DAMAGE, ENCLOSED IN BUILDING MATERIALS, AND CONSTRUCTION IS OF A PERMITTED TYPE, NM CABLE MAY BE USED.
- 2.2. DEVICES2.2.1. CONTRACTOR TO PROVIDE J-BOXES, COVER PLATES, AND ANY ACCESSORIES REQUIRED
- TO PROVIDE A COMPLETE SYSTEM. SEE ARCHITECTURAL PLANS FOR DEVICE COLORS.

 2.2.1. DUPLEX RECEPTACLES SHALL BE TAMPER RESISTANT, 20 AMP, EQUAL TO LEVITON
- 2.2.2. TOGGLE WALL SWITCHES SHALL BE EQUAL TO LEVITON CS120-2
- 2.2.3. DIMMER SWITCHES SHALL BE TESTED WITH FIXTURES AND LAMPS FOR COMPATIBILITY.

REFERENCED CODES IN EFFECT


2014 NATIONAL ELECTRIC CODE

2015 INTERNATIONAL ENERGY CONSERVATION CODE


SHEET INDEX

1. EL001 SITE LIGHTING COVER SHEET

2. EL101 SITE LIGHTING PLAN

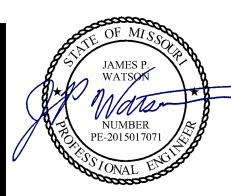

James Watson, P.E. May 17, 2019 PE-2015017071 MO Certificate of Authority # 2018029680

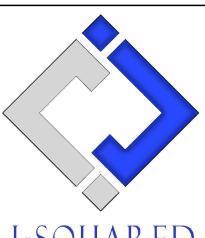

J-SQUARED

Moberly, Missouri 65270 573 - 234 - 4492 phone www.j-squaredeng.com

J2 PROJECT No:	J20038
J2 DESIGN:	JAP

ISSUE TITLE	DATE
PERMIT SET	05 - 17 - 2019

art Addition

Storage

SHEET TITLE

SITE LIGHTING COVER SHEET

IEEI NUMBEK

EL001


	EXTERIOR LIGHT FIXTURE SCHEDULE											
TAG	MANUFACTURER (OR EQUAL)	MODEL NUMBER (OR EQUAL)	DESCRIPTION	MOUNTING	LUMEN OUTPUT	CCT (°K)	CRI	VOLTS	WATTS	NOTES		
WP1	MCGRAW-EDISON	GWC-AF-02-LED-E1-T4FT-P	WALL PACK	EXTERIOR WALL	12874	4000	70	120	113	MOUNTED ON EXTERIOR WALL, TOP OF FIXTURE AT 15' ABOVE FINISHED GRADE. WITH PHOTOCELL		
WP2	MCGRAW-EDISON	GWC-AF-02-LED-E1-SL3-P	WALL PACK	EXTERIOR WALL	12424	4000	70	120	113	MOUNTED ON EXTERIOR WALL, TOP OF FIXTURE AT 15' ABOVE FINISHED GRADE. WITH PHOTOCELL		
NOTES:												

1. VERIFY LIGHT FIXTURE FINISHES WITH OWNER / ARCHITECT PRIOR TO INSTALLATION

SITE PHOTOMETRIC SUMMARY												
AREA AVERAGE MAXIMUM MININUM MAX/MIN AVG/MIN												
NEW PARKING	1.94 fc	5.1 fc	0.3 fc	17.0:1	6.47:1							


NOTES:

CALCULATIONS BASED ON 95% OF DATA POINT SOURCES, LOWER 2.5% & UPPER 2.5% OF DATA POINTS OMITTED

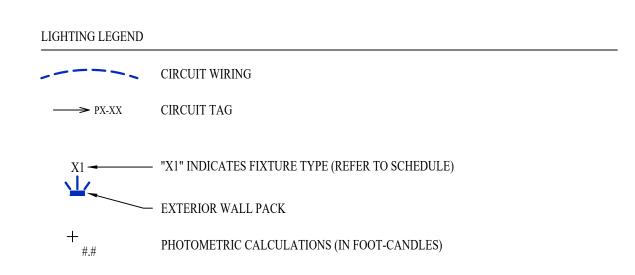

SITE LIGHTING PLAN GENERAL NOTES:


- 1. SITE PHOTOMETRIC VALUES SHOWN HAVE BEEN CALCULATED PER SPECIFIED LIGHT FIXTURES AT INDICATED MOUNTING HEIGHTS. ANY CHANGES OR ALTERATIONS TO LIGHTING LAYOUT SHOWN WILL REQUIRE RECALCULATING SITE PHOTOMETRICS AND WILL THE RESPONSIBILITY OF THE ELECTRICAL CONTRACTOR / EQUIPMENT SUPPLIER.
- 2. PHOTOMETRIC CALCULATIONS SHOWN DO NOT INCLUDE EXISTING LIGHT FIXTURE(S), ONLY NEW WALL-PACK FIXTURE(S) SHOWN.

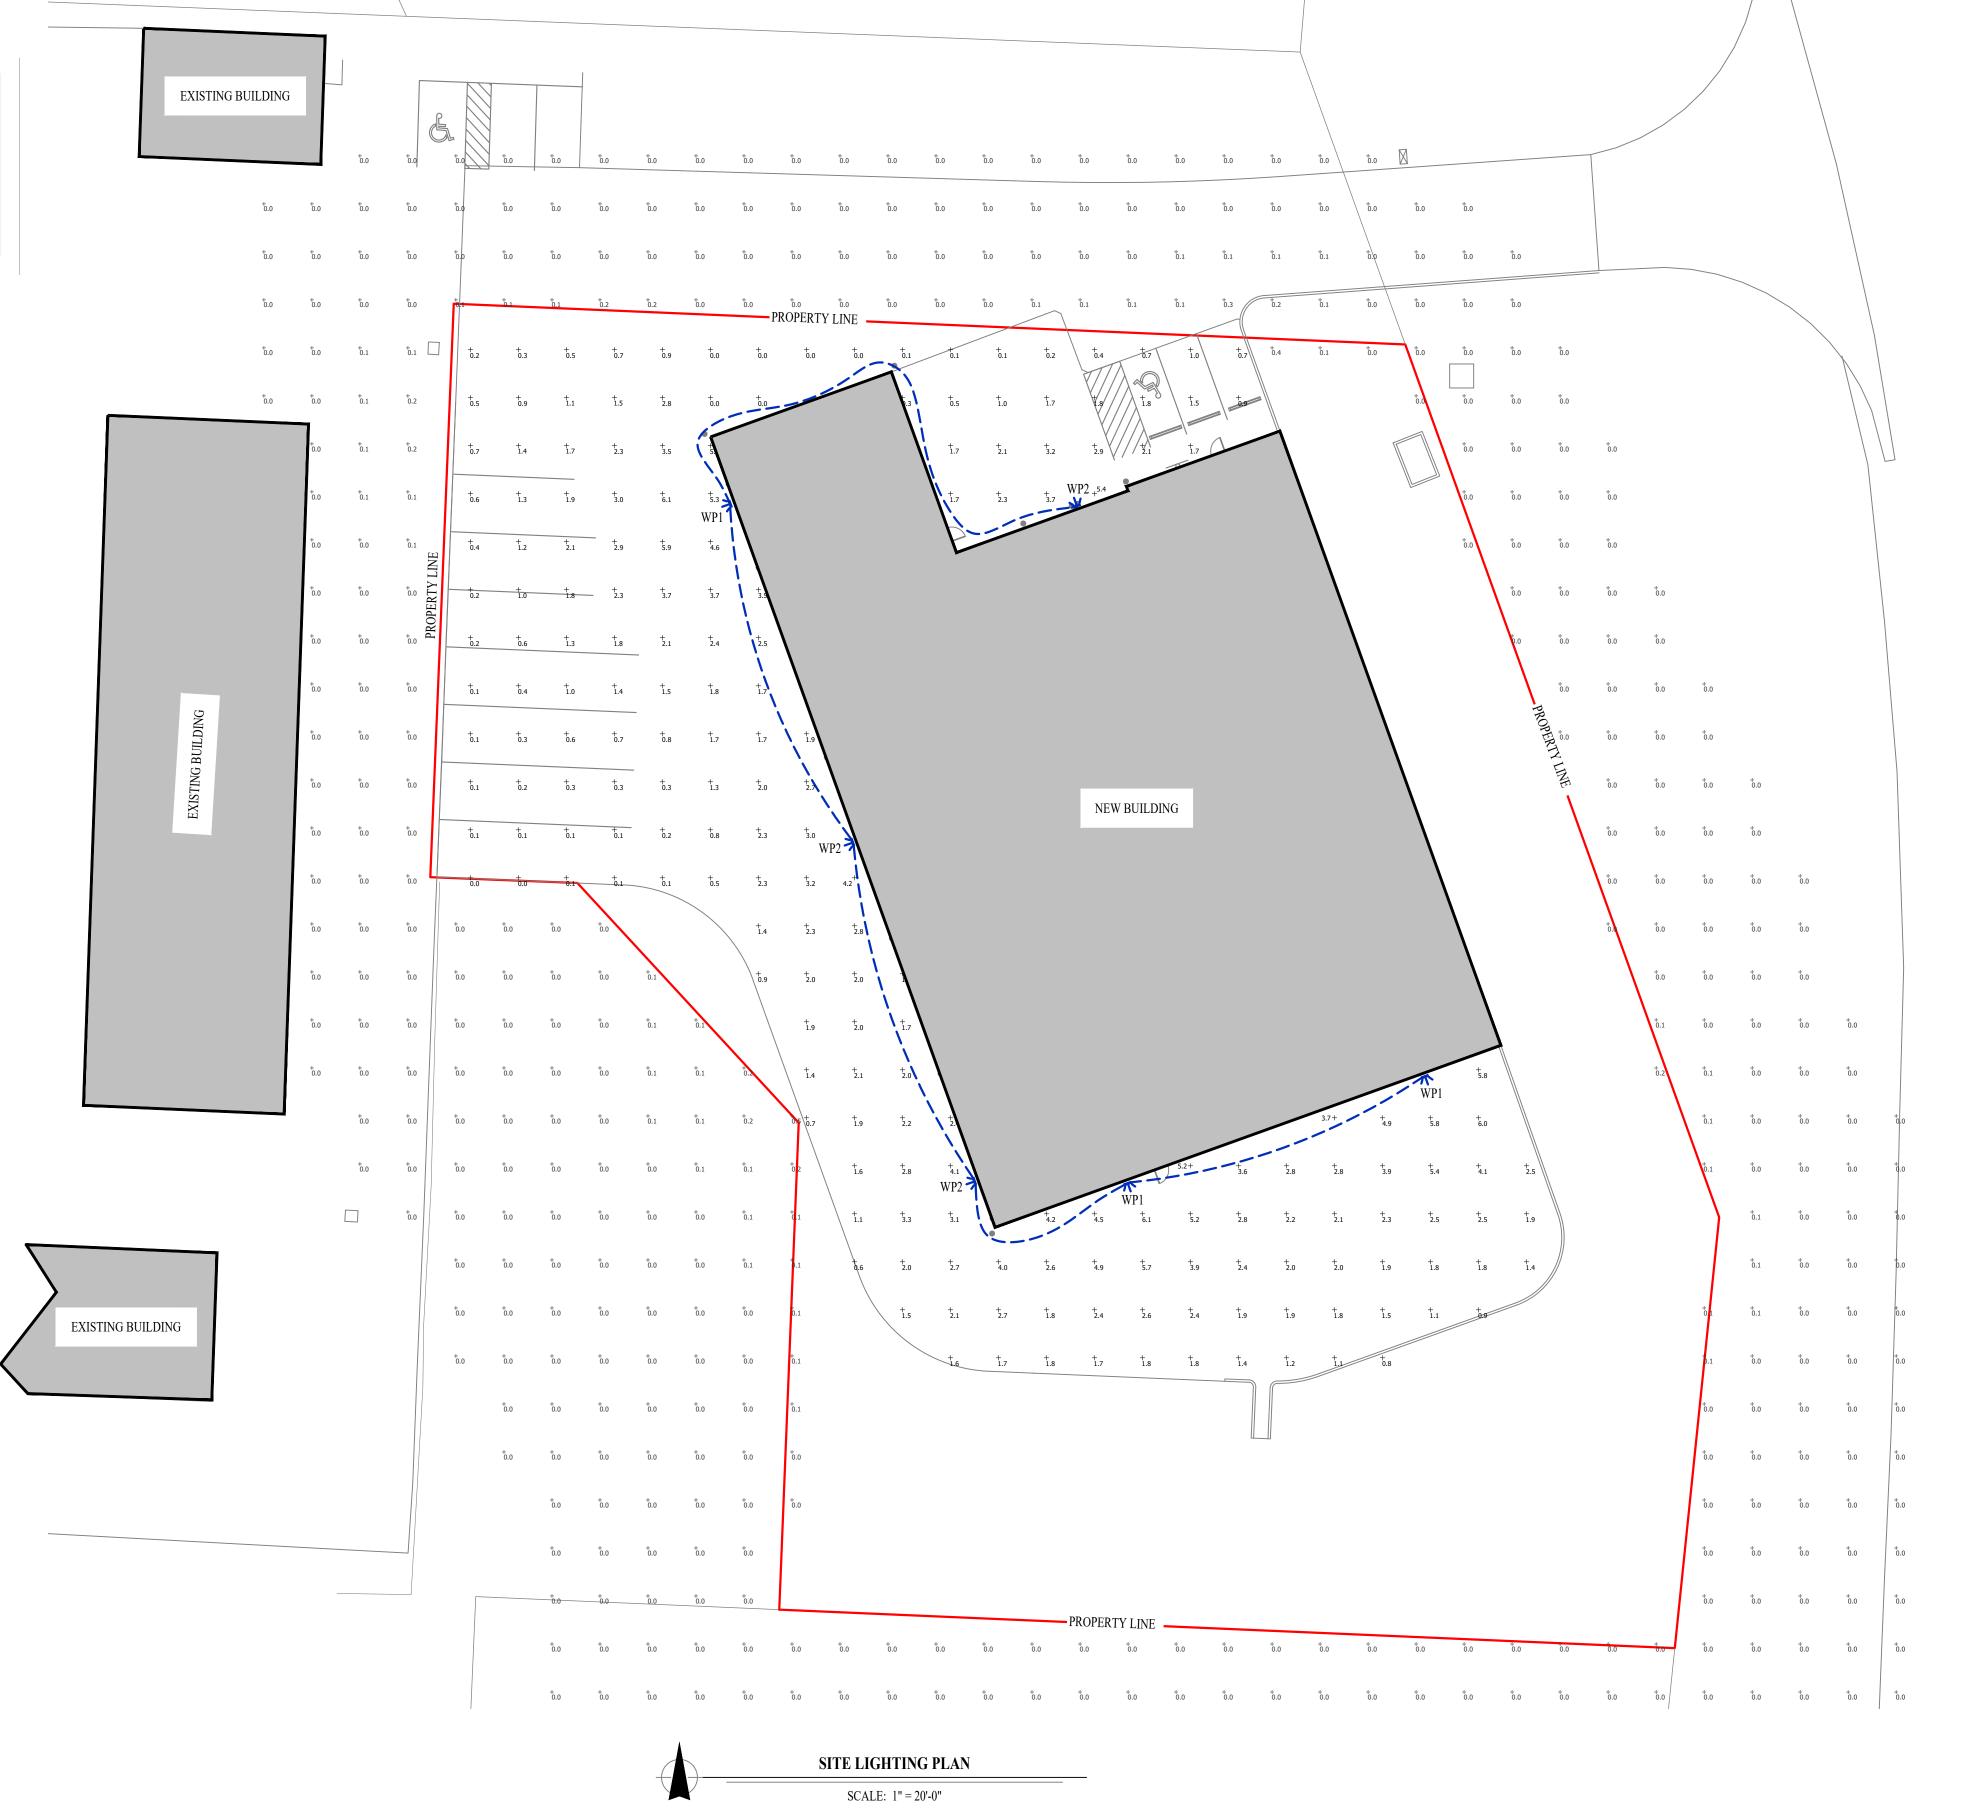

JAMES P. WATSON

NUMBER
PE-2015017071

James Watson, P.E. May 17, 2019 PE-2015017071 MO Certificate of Authority # 2018029680

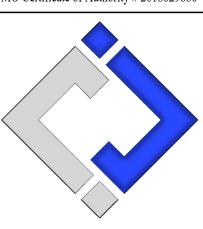

J-SQUAREL

ENGINEERING
630 North Morley Street, Suite 102
Moberly, Missouri 65270

573 - 234 - 4492 phone www.j-squaredeng.com

J2 PROJECT No: J20038

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ISSUE TITLE DATE
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Storage Mart Addition

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SITE LIGHTING PLAN

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EL101

