



AMERICAN TOWER®

ATC SITE NAME: UNITY VILLAGE MO 2

ATC SITE NUMBER: 306035

AT&T PACE NUMBER: MRKSL045230, MRKSL045284

MRKSL045778, MRKSL045231, MRKSL045484

AT&T SITE ID: KS4022 AT&T FA CODE: 10000434

AT&T SITE NAME: UNITY VILLAGE

SITE ADDRESS: 2150 NORTHWEST LOWENSTEIN DRIVE

LEES SUMMIT, MO 64081

AT&T MOBILITY ANTENNA AMENDMENT DRAWINGS



LOCATION MAP

COMPLIANCE CODE	PROJECT SUMMARY	PROJECT DESCRIPTION		SHEET INDEX			
ALL WORK SHALL BE PERFORMED AND MATERIALS INSTALLED N ACCORDANCE WITH THE CURRENT EDITIONS OF THE	SITE ADDRESS:	THE PROPOSED PROJECT INCLUDES MODIFYING GROUND BASED AND TOWER MOUNTED EQUIPMENT AS INDICATED PER BELOW:	SHEET DESCRIPTION:		REV:	DATE:	BY:
COLLOWING CODES AS ADOPTED BY THE LOCAL SOVERNMENT AUTHORITIES. NOTHING IN THESE PLANS IS	2150 NORTHWEST LOWENSTEIN DRIVE	TOWER WORK:	G-001	COVER SHEET	0	06/24/2021	RC
O BE CONSTRUED TO PERMIT WORK NOT CONFORMING TO	LEES SUMMIT, MO 64081	REMOVE (3) ANTENNAS AND (6) RRHS	G-002	GENERAL NOTES	0	06/24/2021	RC
HESE CODES. INTERNATIONAL BUILDING CODE (IBC)	COUNTY: JACKSON	INSTALL (3) ANTENNAS AND (3) RRHS	C-001	OVERALL SITE PLAN	0	06/24/2021	RC
NATIONAL BOILDING CODE (IBC)	GEOGRAPHIC COORDINATES:	EXISTING (9) ANTENNAS, (3) TMAS, (12) RRHS, (3) SQUID, (6) #8 AWG					
LOCAL BUILDING CODE	LATITUDE: 38.9336100	DC CABLES, (2) 18 PAIR FIBER TRUNK, (1) 3/8" RET CONTROL CABLE, AND (12) 1-5/8" COAX CABLES TO REMAIN	C-101	DETAILED SITE PLAN	0	06/24/2021	RC
. CITY/COUNTY ORDINANCES	LONGITUDE: -94.4169400	GROUND WORK:	C-102	SHELTER LAYOUT	0	06/24/2021	RC
	GROUND ELEVATION: 983' AMSL	EXISTING (1) EXISTING FSM4 ASIA C1 AND 5GNR ASIK C2 TO REMAIN	C-201	TOWER ELEVATION	0	06/24/2021	RC
		INSTALL (1) AMIA, (4) ABIA, (2) ASIA, (1) ABIL, (1) ASIK AND (1) POWER	C-401	RF SCHEDULE AND ANTENNA INSTALLATION	0	06/24/2021	RC
		CONVERTER	C-501	CONSTRUCTION DETAILS	0	06/24/2021	RC
		PROJECT NOTES	E-501	GROUNDING DETAILS	0	06/24/2021	RC
	PROJECT TEAM	THE FACILITY IS UNMANNED.	R-601	SUPPLEMENTAL			
	TOWER OWNER: APPLICANT:	2. A TECHNICIAN WILL VISIT THE SITE APPROXIMATELY ONCE A MONTH FOR ROUTINE INSPECTION AND MAINTENANCE.	R-602	SUPPLEMENTAL			
	AMERICAN TOWER AT&T MOBILITY	THE PROJECT WILL NOT RESULT IN ANY SIGNIFICANT LAND DISTURBANCE OR EFFECT OF STORM WATER DRAINAGE.	R-603	SUPPLEMENTAL			
	10 PRESIDENTIAL WAY	NO SANITARY SEWER, POTABLE WATER OR TRASH DISPOSAL IS REQUIRED.	R-604	SUPPLEMENTAL			
UTILITY COMPANIES	WOBURN, MA 01801	5. HANDICAP ACCESS IS NOT REQUIRED.	R-605	SUPPLEMENTAL			
POWER COMPANY:KCP&L		PROJECT LOCATION DIRECTIONS	R-606	SUPPLEMENTAL			
PHONE: TBD TELEPHONE COMPANY; AT&T	ARCHITECT (COORDINATING PROFESSIONAL:	DIRECTIONS FROM CHARLES B WHEELER DOWNTOWN AIRPORT, DEPART AND HEAD TOWARD NW LOU HOLLAND DR, TURN LEFT	R-607	SUPPLEMENTAL			
PHONE: TBD	PETER LICHOMSKI, AIA	ONTO NW LOU HOLLAND DR, ROAD NAME CHANGES TO N RICHARDS RD. AT THE ROUNDABOUT. TAKE THE 1ST EXIT FOR					
	49030 PONTIAC TRAIL, SUITE 400,	RAMP, MERGE ONTO US-169 S / N BROADWAY FWY S, KEEP					+
	WIXOM, MI 48393 PH: (248) 705-9212	STRAIGHT TO GET ONTO BROADWAY BLVD, TURN LEFT ONTO W 6TH ST. TAKE THE RAMP ON THE LEFT AND FOLLOW SIGNS FOR					
	Fn. (240)/03-9212	I-35 NORTH / I-70 EAST / US-24 EAST / US-40 EAST, TAKE THE RAMP					
		ON THE RIGHT FOR US-71 SOUTH / I-70 EAST / US-40 EAST AND					
		HEAD TOWARD JOPLIN / ST LOUIS, KEEP STRAIGHT TO GET ONTO					
	PROPERTY OWNER:	US-71 S, TAKE THE RAMP ON THE RIGHT FOR I-470 EAST / US-50					
		EAST / I-435 WEST / US-50 WEST AND HEAD TOWARD LEE'S SUMMIT					
Know what's below .	AMERICAN TOWER CORPORATION	/ WICHITA, AT EXIT 7A, HEAD RIGHT ON THE RAMP FOR US-50 EAST					
Call before you dig.	116 HUNTIGTON AVENUE,	TOWARD SEDALIA, TURN RIGHT ONTO NW PRYOR RD, TURN RIGHT ONTO NW LOWENSTEIN DR, TURN RIGHT, ARRIVE AT					
Sali bololo you digi	11TH FLOOR BOSTON, MA 02116	2150 NORTHWEST LOWENSTEIN DRIVE, LEES SUMMIT, MO 64081					- 1





REV.	DESCRIPTION	BY	DATE
A_	PRELIM	RC_	05/25/21
△.	FINAL CD	RC	06/24/21
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ATC SITE NUMBER:


306035

ATC SITE NAME:

UNITY VILLAGE MO 2

SITE ADDRESS: 2150 NORTHWEST LOWENSTEIN DRIVE LEES SUMMIT, MO 64081

SEAL:

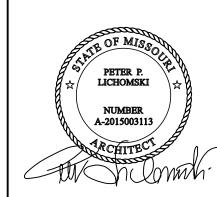



DATE DRAWN:	05/25/21
ATC JOB NO:	13619563
CUSTOMER ID:	KS4022
CUSTOMER NAME:	UNITY VILLAGE

COVER SHEET

SHEET NUMBER:

G-001

GENERAL CONSTRUCTION NOTES:

- OWNER FURNISHED MATERIALS, AT&T MOBILITY "THE COMPANY" WILL PROVIDE AND THE 22. CONTRACTOR WILL INSTALL
 - A. BTS EQUIPMENT FRAME (PLATFORM) AND ICEBRIDGE SHELTER (GROUND
 - B. AC/TELCO INTERFACE BOX (PPC)
 - C. ICE BRIDGE (CABLE TRAY WITH COVER) (GROUND BUILD/CO-LOCATE ONLY, GC TO FURNISH AND INSTALL FOR ROOFTOP INSTALLATION)

 - D. TOWERS, MONOPOLES TOWER LIGHTING
 - GENERATORS & LIQUID PROPANE TANK
 - ANTENNA STANDARD BRACKETS, FRAMES AND PIPES FOR MOUNTING
 - ANTENNAS (INSTALLED BY OTHERS)
 - TRANSMISSION LINE
 - TRANSMISSION LINE JUMPERS
 - TRANSMISSION LINE CONNECTORS WITH WEATHERPROOFING KITS
 - TRANSMISSION LINE GROUND KITS
 - HANGERS
 - N. HOISTING GRIPS
 - O. BTS EQUIPMENT
- THE CONTRACTOR IS RESPONSIBLE TO PROVIDE ALL OTHER MATERIALS FOR THE COMPLETE INSTALLATION OF THE SITE INCLUDING, BUT NOT LIMITED TO, SUCH MATERIALS AS FENCING, STRUCTURAL STEEL SUPPORTING SUB-FRAME FOR PLATFORM, ROOFING LABOR AND MATERIALS, GROUNDING RINGS, GROUNDING WIRES, COPPER-CLAD OR XIT CHEMICAL GROUND ROD(S), BUSS BARS, TRANSFORMERS AND DISCONNECT SWITCHES WHERE APPLICABLE TEMPORARY ELECTRICAL POWER CONDUIT, LANDSCAPING COMPOUND STONE, CRANES, CORE DRILLING, SLEEPERS AND RUBBER MATTING, REBAR, CONCRETE CAISSONS, PADS AND/OR AUGER MOUNTS, MISCELLANEOUS FASTENERS, CABLE TRAYS, NON-STANDARD ANTENNA FRAMES AND ALL OTHER MATERIAL AND LABOR REQUIRED TO COMPLETE THE JOB ACCORDING TO THE DRAWINGS AND SPECIFICATIONS. IT IS THE POSITION OF AT&T MOBILITY TO APPLY FOR PERMITTING AND CONTRACTOR RESPONSIBLE FOR PICKUP AND PAYMENT OF
- ALL WORK SHALL CONFORM TO ALL CURRENT APPLICABLE FEDERAL, STATE, AND LOCAL CODES, INCLUDING ANSI/EIA/TIA-222, AND COMPLY WITH ATC CONSTRUCTION SPECIFICATIONS.
- CONTRACTOR SHALL CONTACT LOCAL 811 FOR IDENTIFICATION OF UNDERGROUND UTILITIES PRIOR TO START OF CONSTRUCTION
- CONTRACTOR SHALL BE RESPONSIBLE FOR COORDINATING ALL REQUIRED
- ALL DIMENSIONS TO, OF, AND ON EXISTING BUILDINGS, DRAINAGE STRUCTURES, AND SITE IMPROVEMENTS SHALL BE VERIFIED IN FIELD BY CONTRACTOR WITH ALL DISCREPANCIES REPORTED TO THE ENGINEER
- DO NOT CHANGE SIZE OR SPACING OF STRUCTURAL ELEMENTS.
- DETAILS SHOWN ARE TYPICAL; SIMILAR DETAILS APPLY TO SIMILAR CONDITIONS UNLESS 32.
- THESE DRAWINGS DO NOT INCLUDE NECESSARY COMPONENTS FOR CONSTRUCTION SAFETY WHICH SHALL BE THE SOLE RESPONSIBILITY OF THE CONTRACTOR
- CONTRACTOR SHALL BRACE STRUCTURES UNTIL ALL STRUCTURAL ELEMENTS NEEDED 33. FOR STABILITY ARE INSTALLED. THESE ELEMENTS ARE AS FOLLOWS: LATERAL BRACING,
- CONTRACTOR SHALL DETERMINE EXACT LOCATION OF EXISTING UTILITIES, GROUNDS DRAINS, DRAIN PIPES, VENTS, ETC. BEFORE COMMENCING WORK
- 12. INCORRECTLY FABRICATED, DAMAGED, OR OTHERWISE MISFITTING OR NONCONFORMING MATERIALS OR CONDITIONS SHALL BE REPORTED TO THE AT&T
 MOBILITY REP PRIOR TO REMEDIAL OR CORRECTIVE ACTION. ANY SUCH REMEDIAL ACTION SHALL REQUIRE WRITTEN APPROVAL BY THE AT&T MOBILITY REP PRIOR TO
- EACH CONTRACTOR SHALL COOPERATE WITH THE AT&T MOBILITY REP, AND COORDINATE HIS WORK WITH THE WORK OF OTHERS.
- CONTRACTOR SHALL REPAIR ANY DAMAGE CAUSED BY CONSTRUCTION OF THIS PROJECT TO MATCH EXISTING PRE-CONSTRUCTION CONDITIONS TO THE SATISFACTION OF THE AT&T MOBILITY CONSTRUCTION MANAGER
- ALL CABLE/CONDUIT ENTRY/EXIT PORTS SHALL BE WEATHERPROOFED DURING INSTALLATION USING A SILICONE SEALANT
- WHERE EXISTING CONDITIONS DO NOT MATCH THOSE SHOWN IN THIS PLAN SET, CONTRACTOR SHALL NOTIFY THE AT&T MOBILITY REP AND ENGINEER OF RECORD
- 17. CONTRACTOR SHALL ENSURE ALL SUBCONTRACTORS ARE PROVIDED WITH A COMPLETE AND CURRENT SET OF DRAWINGS AND SPECIFICATIONS FOR THIS PROJECT
- 18. CONTRACTOR SHALL REMOVE ALL RUBBISH AND DEBRIS FROM THE SITE AT THE END OF
- CONTRACTOR SHALL COORDINATE WORK SCHEDULE WITH AMERICAN TOWER CORPORATION (ATC) AND TAKE PRECAUTIONS TO MINIMIZE IMPACT AND DISRUPTION OF OTHER OCCUPANTS OF THE FACILITY.
- 20. CONTRACTOR SHALL FURNISH AT&T MOBILITY AND AMERICAN TOWER CORPORATION (ATC) WITH A PDF MARKED UP AS-BUILT SET OF DRAWINGS UPON COMPLETION OF
- PRIOR TO SUBMISSION OF BID. CONTRACTOR SHALL COORDINATE WITH AT&T MOBILITY REP TO DETERMINE WHAT, IF ANY, ITEMS WILL BE PROVIDED. ALL ITEMS NOT PROVIDED SHALL BE PROVIDED AND INSTALLED BY THE CONTRACTOR. CONTRACTOR WILL INSTALL

ALL ITEMS PROVIDED.

- PRIOR TO SUBMISSION OF BID. CONTRACTOR SHALL COORDINATE WITH AT&T MOBILITY 3. REP TO DETERMINE IF ANY PERMITS WILL BE OBTAINED BY CONTRACTOR. ALL REQUIRED PERMITS NOT OBTAINED BY AT&T MOBILITY MUST BE OBTAINED, AND PAID
- CONTRACTOR SHALL INSTALL ALL SITE SIGNAGE IN ACCORDANCE WITH AT&T MOBILITY 23.
- CONTRACTOR SHALL SUBMIT ALL SHOP DRAWINGS TO AT&T MOBILITY FOR REVIEW AND
- ALL EQUIPMENT SHALL BE INSTALLED ACCORDING TO MANUFACTURER'S SPECIFICATIONS AND LOCATED ACCORDING TO AT&T MOBILITY SPECIFICATIONS, AND AS SHOWN IN THESE PLANS.
- 26. THE CONTRACTOR SHALL SUPERVISE AND DIRECT THE PROJECT DESCRIBED HEREIN. THE CONTRACTOR SHALL BE SOLELY RESPONSIBLE FOR ALL THE CONSTRUCTION MEANS, METHODS, TECHNIQUES, SEQUENCES AND PROCEDURES AND FOR COORDINATING ALL PORTIONS OF THE WORK UNDER THE CONTRACT.
- CONTRACTOR SHALL NOTIFY AT&T MOBILITY REP A MINIMUM OF 48 HOURS IN ADVANCE OF POURING CONCRETE OR BACKFILLING ANY UNDERGROUND UTILITIES FOUNDATIONS OR SEALING ANY WALL, FLOOR OR ROOF PENETRATIONS FOR ENGINEERING REVIEW
- CONTRACTOR SHALL BE RESPONSIBLE FOR SITE SAFETY INCLUDING COMPLIANCE WITH ALL APPLICABLE OSHA STANDARDS AND RECOMMENDATIONS AND SHALL PROVIDE ALL NECESSARY SAFETY DEVICES INCLUDING PPE AND PPM AND CONSTRUCTION DEVICES SUCH AS WELDING AND FIRE PREVENTION, TEMPORARY SHORING, SCAFFOLDING, TRENCH BOXES/SLOPING, BARRIERS, ETC.
- THE CONTRACTOR SHALL PROTECT AT HIS OWN EXPENSE, ALL EXISTING FACILITIES AND SUCH OF HIS NEW WORK LIABLE TO INJURY DURING THE CONSTRUCTION PERIOD. ANY DAMAGE CAUSED BY NEGLECT ON THE PART OF THIS CONTRACTOR OR HIS REPRESENTATIVES, OR BY THE ELEMENTS DUE TO NEGLECT ON THE PART OF THIS CONTRACTOR OR HIS REPRESENTATIVES, EITHER TO THE EXISTING WORK, OR TO HIS WORK OR THE WORK OF ANY OTHER CONTRACTOR, SHALL BE REPAIRED AT HIS EXPENSE TO THE OWNER'S SATISFACTION.
- ALL WORK SHALL BE INSTALLED IN A FIRST CLASS, NEAT AND WORKMANLIKE MANNER BY MECHANICS SKILLED IN THE TRADE INVOLVED. THE QUALITY OF WORKMANSHIP SHALL BE SUBJECT TO THE APPROVAL OF THE AT&T MOBILITY REP. ANY WORK FOUND BE REPLACED AND/OR REWORKED AT CONTRACTOR EXPENSE UNTIL APPROVAL IS OBTAINED.
- IN ORDER TO ESTABLISH STANDARDS OF QUALITY AND PERFORMANCE, ALL TYPES OF MATERIALS LISTED HEREINAFTER BY MANUFACTURER'S NAMES AND/OR MANUFACTURER'S CATALOG NUMBER SHALL BE PROVIDED BY THESE MANUFACTURERS
- AT&T MOBILITY FURNISHED EQUIPMENT SHALL BE PICKED-UP AT THE AT&T MOBILITY WAREHOUSE, NO LATER THAN 48HR AFTER BEING NOTIFIED INSURED, STORED, UNCRATE, PROTECTED AND INSTALLED BY THE CONTRACTOR WITH ALL APPURTENANCES REQUIRED TO PLACE THE EQUIPMENT IN OPERATION, READY FOR USE. THE CONTRACTOR SHALL BE RESPONSIBLE FOR THE EQUIPMENT AFTER PICKING IT
- AT&T MOBILITY OR HIS ARCHITECT/ENGINEER RESERVES THE RIGHT TO REJECT ANY EQUIPMENT OR MATERIALS WHICH, IN HIS OWN OPINION ARE NOT IN COMPLIANCE WITH THE CONTRACT DOCUMENTS, EITHER BEFORE OR AFTER INSTALLATION AND THE EQUIPMENT SHALL BE REPLACED WITH FOUIPMENT CONFORMING TO THE REQUIREMENTS OF THE CONTRACT DOCUMENTS BY THE CONTRACTOR AT NO COST TO AT&T MOBILITY OR THEIR ARCHITECT/ENGINEER.

SPECIAL CONSTRUCTION ANTENNA INSTALLATION NOTES:

- WORK INCLUDED:
 - A. ANTENNA AND COAXIAL CABLES ARE FURNISHED BY AT&T MOBILITY UNDER A SEPARATE CONTRACT. THE CONTRACTOR SHALL ASSIST ANTENNA INSTALLATION CONTRACTOR IN TERMS OD COORDINATION AND SITE ACCESS. ERECTION SUBCONTRACTOR SHALL BE RESPONSIBLE FOR THE PROTECTION OF
 - INSTALL ANTENNA AS INDICATE ON DRAWINGS AND AT&T MOBILITY
 - C. INSTALL GALVANIZED STEEL ANTENNA MOUNTS AS INDICATED ON DRAWINGS
 - D. INSTALL FURNISHED GALVANIZED STEEL OR ALUMINUM WAVEGUIDE.
 - E. CONTRACTOR SHALL PROVIDE FOUR (4) SETS OF SWEEP TESTS USING ANRITZU-PACKARD 8713B RF SCALAR NETWORK ANALYZER, SUBMIT FREQUENCY AMMILEO-FACAMO 67 ISB N 50ALAN NEI WORK AWAI ZER, SUBMIT FREQUENT DOMAIN REFLECTOMETER(FOR) TESTS RESULTS TO THE PROJECT MANAGER. SWEEP TESTS SHALL BE AS PER ATTACHED RFS "MINIMUM FIELD TESTING RECOMMENDED FOR ANTENNA AND HELIAX COAXIAL CABLE SYSTEMS" DATED 10/5/93. TESTING SHALL BE PERFORMED BY AN INDEPENDENT TESTING SERVICE AND BE BOUND AND SUBMITTED WITHIN ONE WEEK OF WORK COMPLETION.
 - INSTALL COAXIAL CABLES AND TERMINATING BETWEEN ANTENNAS AND EQUIPMENT PER MANUFACTURER'S RECOMMENDATIONS. WEATHERPROOF ALL CONNECTIONS BETWEEN THE ANTENNA AND EQUIPMENT PER MANUFACTURER'S REQUIREMENTS. TERMINATE ALL COAXIAL CABLE THREE (3) FEET IN EXCESS OF ENTRY PORT LOCATION UNLESS OTHERWISE STATED
 - ANTENNA AND COAXIAL CABLE GROUNDING
- ALL EXTERIOR #6 GREED GROUND WIRE "DAISY CHAIN" CONNECTIONS ARE TO BE WEATHER SEALED WITH RFS CONNECTORS/SPLICE WEATHERPROOFING KIT #221213 OR

EQUAL.

ALL COAXIAL CABLE GROUNDING KITS ARE TO BE INSTALLED ON STRAIGHT RUNS OF COAXIAL CABLE (NOT WITHIN BENDS

> ALL DISCREPANCIES FROM WHAT IS SHOWN ON THESE CONSTRUCTION DRAWINGS SHALL BE COMMUNICATED TO ATC ENGINEERING IMMEDIATELY FOR CORRECTION OR RE-DESIGN. FAILURE TO COMMUNICATE DIRECTLY WITH ATC ENGINEERING OF ANY CHANGES FROM THE DESIGN CONDUCTED WITHOUT PRIOR APPROVAL FROM ATC ENGINEERING SHALL BE THE SOLE RESPONSIBILITY OF THE GENERAL CONTRACTOR.





PHONE: (248) 705-9212

DESCRIPTION BY DATE RC 05/25/21 RC 06/24/21 FINAL CD

ATC SITE NUMBER:

306035

ATC SITE NAME:

UNITY VILLAGE MO 2

SITE ADDRESS: 2150 NORTHWEST LOWENSTEIN DRIVE LEES SUMMIT, MO 64081

SEAL:






DATE DRAWN 05/25/21 ATC JOB NO: 13619563 CUSTOMER ID: KS4022 CUSTOMER NAME: UNITY VILLAGE

GENERAL NOTES

SHEET NUMBER:

REVISION:

G-002

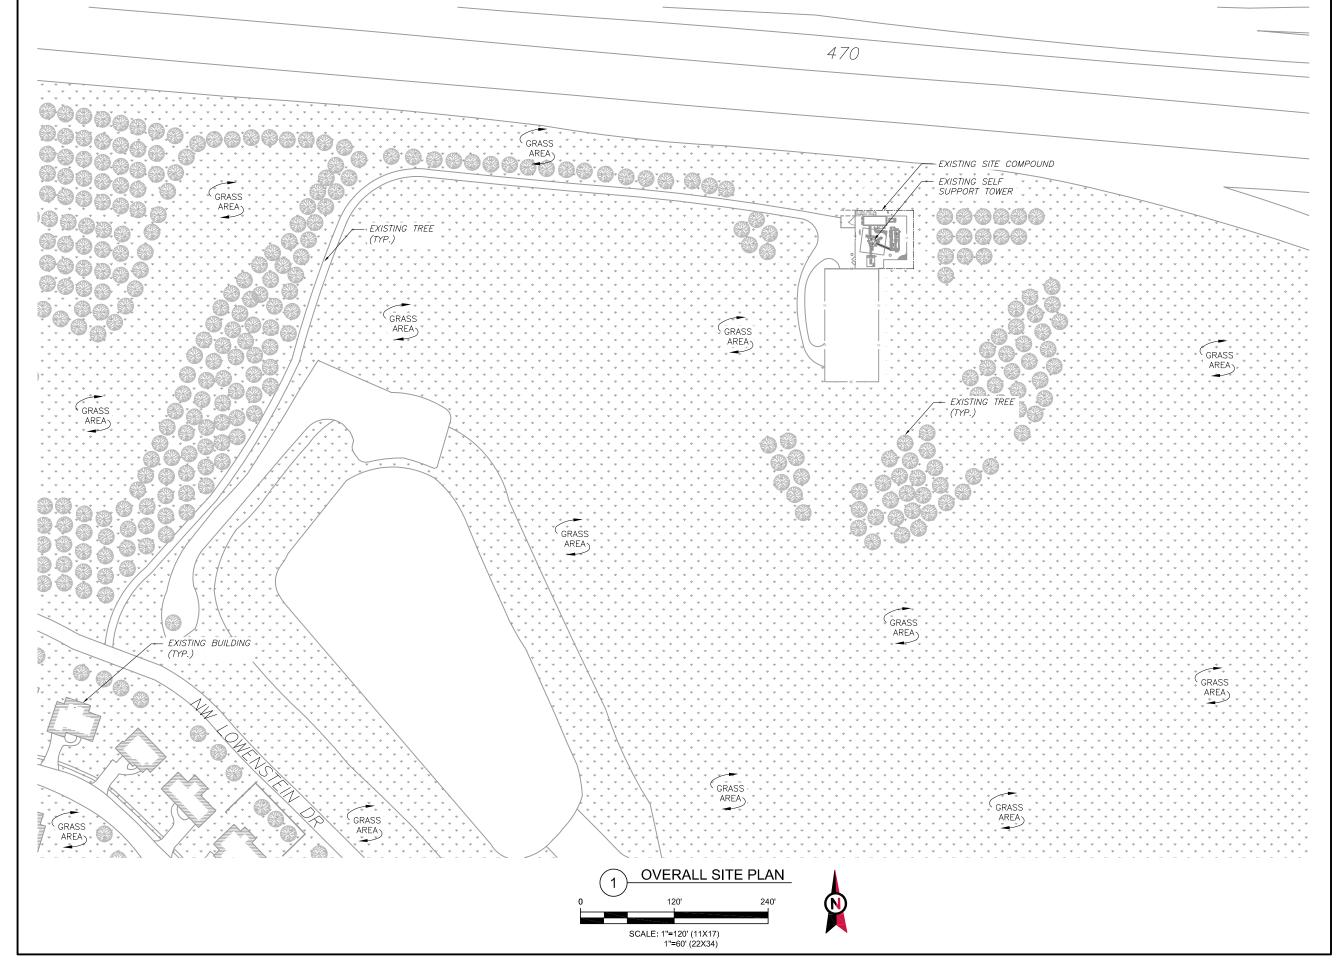





REV.	DESCRIPTION	BY	DATE
\mathbb{A}_{-}	PRELIM	RC	05/25/21
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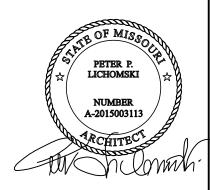
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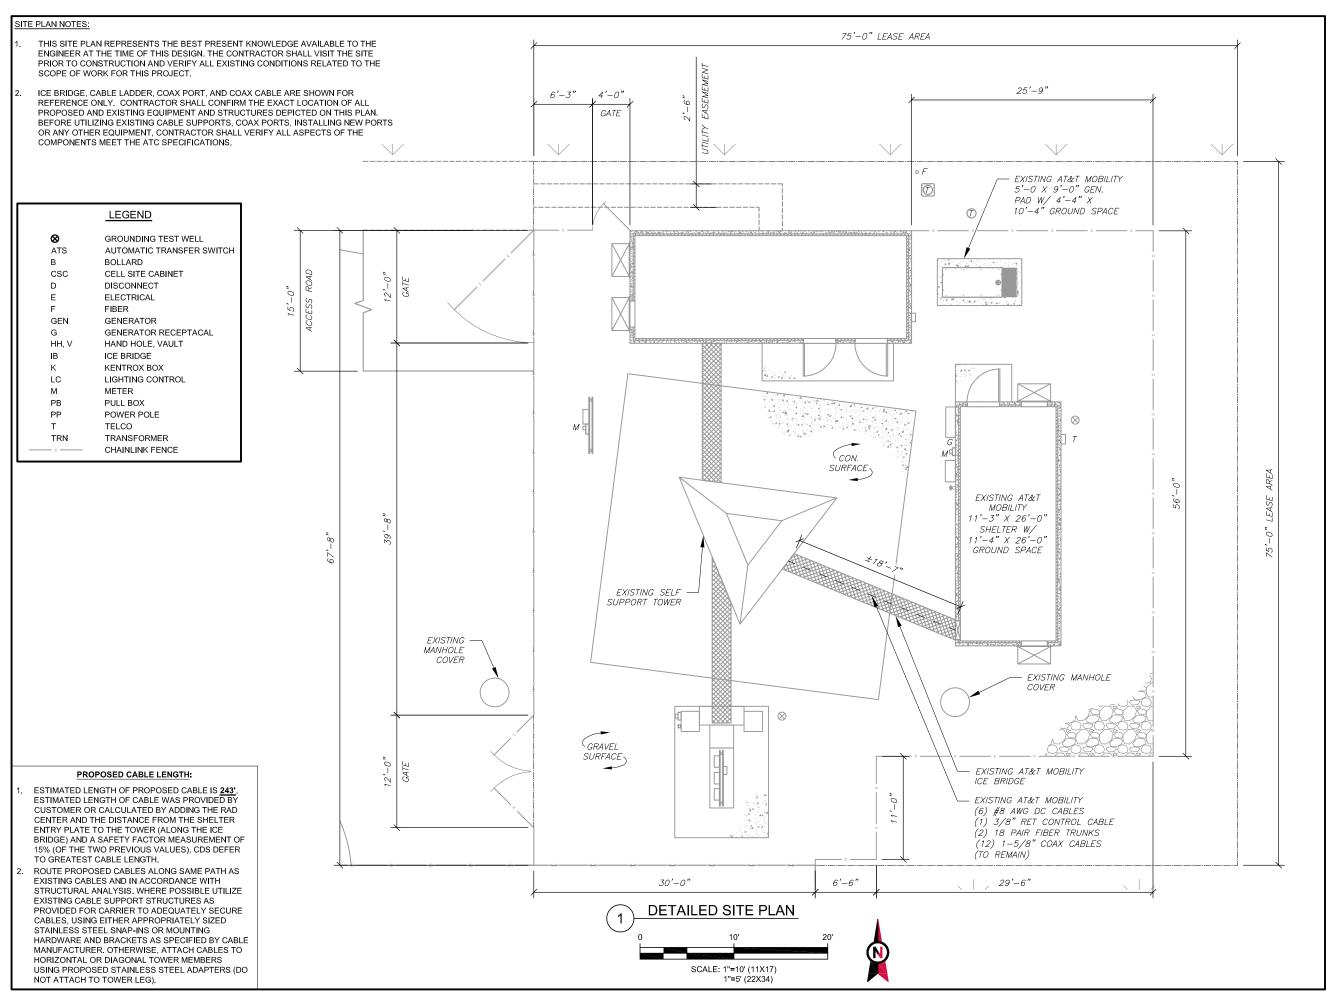
DATE DRAWN:	05/25/21
ATC JOB NO:	13619563
CUSTOMER ID:	KS4022
CUSTOMER NAME:	UNITY VILLAGE

OVERALL SITE PLAN

SHEET NUMBER:

C-001

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\mathbb{A}_{-}	PRELIM	RC_	05/25/21
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PHONE: (248) 705-9212

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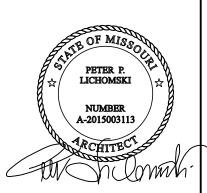
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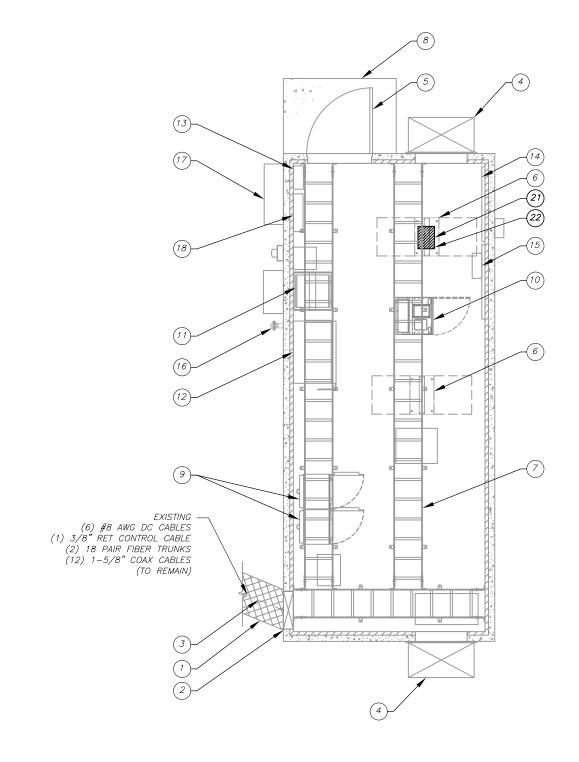


DATE DRAWN:	05/25/21
ATC JOB NO:	13619563
CUSTOMER ID:	KS4022
CUSTOMER NAME:	UNITY VILLAGE

DETAILED SITE PLAN

SHEET NUMBER:

C-101



EXISTING EQUIPMENT

EXISTING ICE BRIDGE

EXISTING COAX PORT

EXISTING HVAC

EXISTING DOOR

EXISTING FIF RACK

EXISTING STOOP

EXISTING GSM CABINET

EXISTING UMTS CABINET

EXISTING DC POWER PLANT

EXISTING BATTERIES

EXISTING AC PANEL

EXISTING TELCO BOARD

EXISTING FIBER BOX

EXISTING GPS ANTENNA

NEW POWER CONVERTER

EXISTING METER

EXISTING DISCONNECT SWITCH

EXISTING MANUAL TRANSFER SWITCH

EXISTING FSM4 ASIA C1 AND 5GNR ASIK C2

(1) AMIA, (4) ABIA, (2) ASIA, (1) ABIL AND (1) ASIK

(5)

(10)

(16)


(18)

(19)

(20)

EXISTING COAX TRUNK CABLE

EXISTING ELEVATED CABLE TRAY (TYP.)

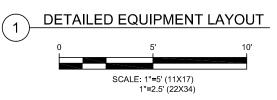







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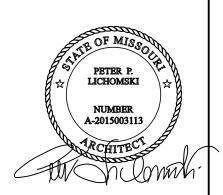
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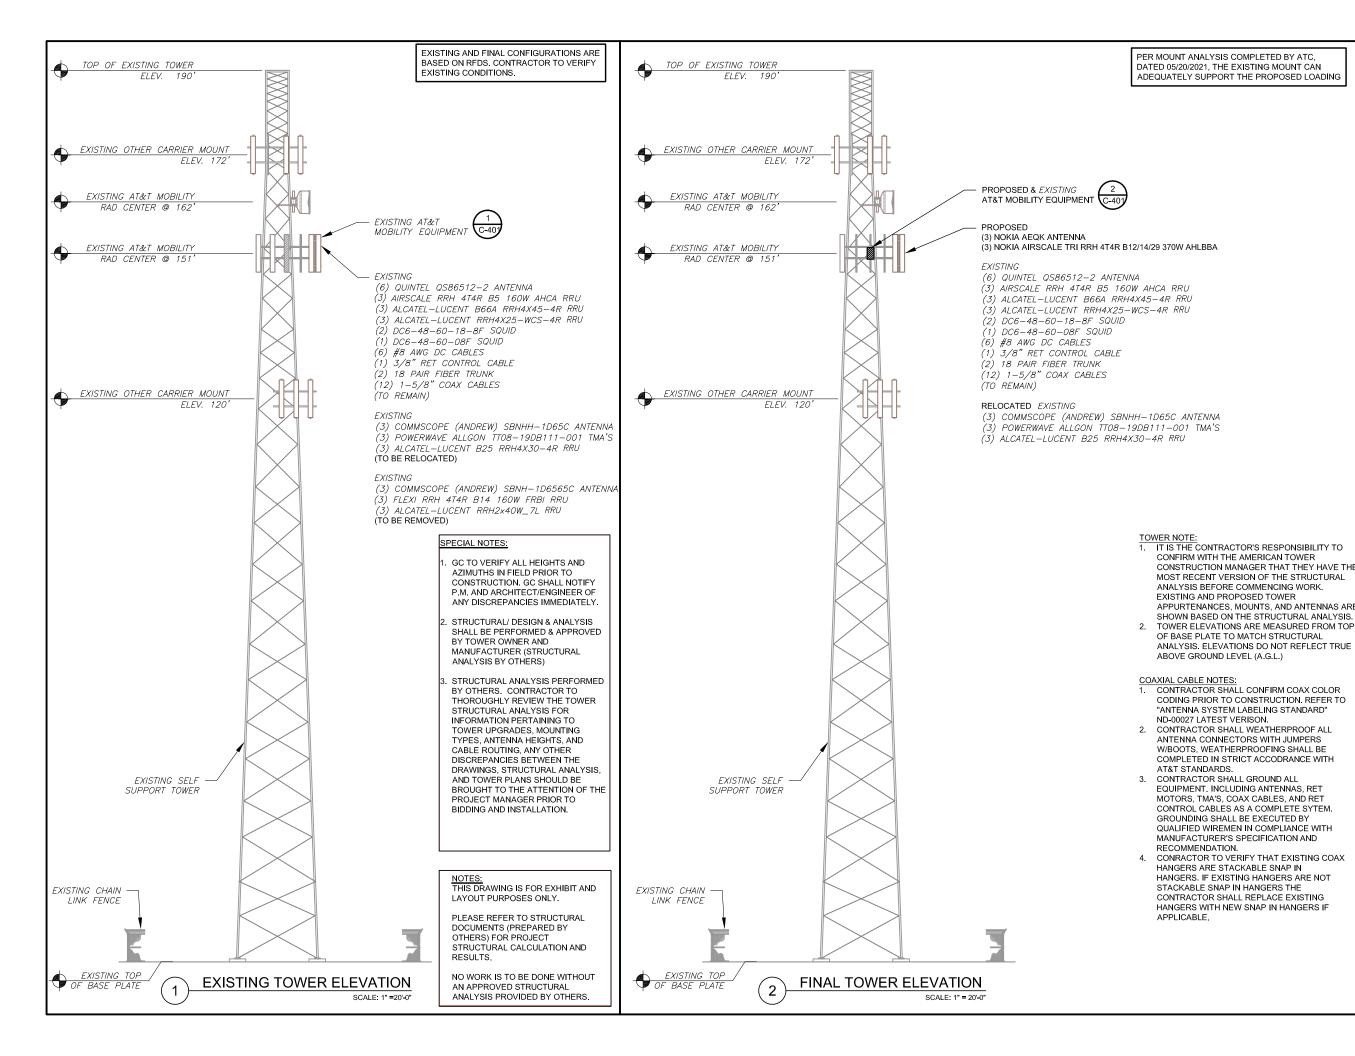
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CUSTOMER ID:	KS4022
CUSTOMER NAME:	UNITY VILLAGE

SHELTER LAYOUT

SHEET NUMBER:

REVISION:

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PHONE: (248) 705-9212

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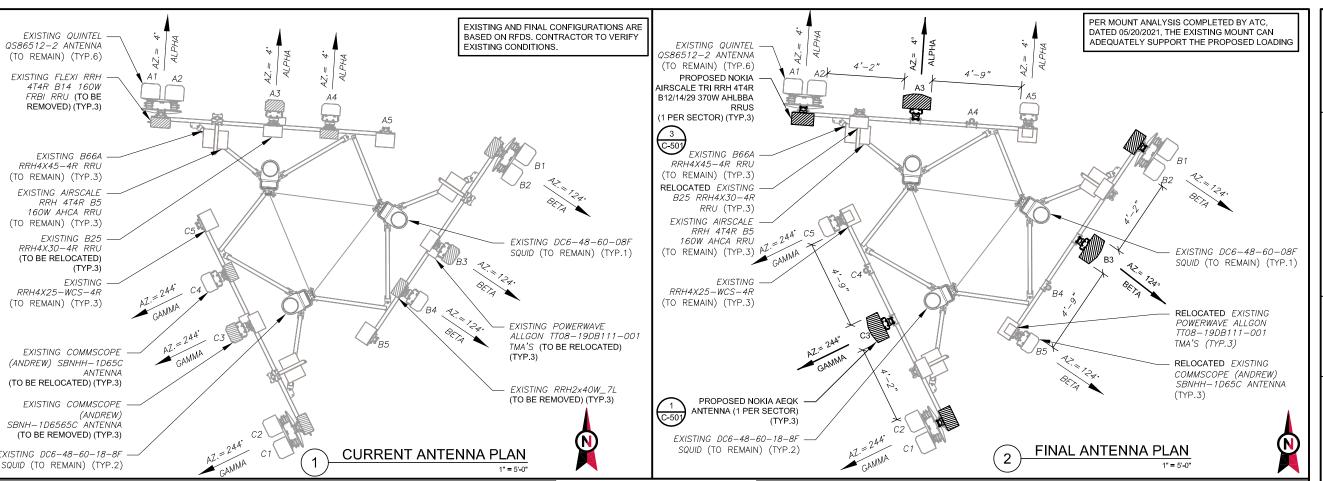




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CUSTOMER ID: KS4022
CUSTOMER NAME: UNITY VILLAGE

TOWER ELEVATION

C-201



	CURRENT ANTENNA SCHEDULE										
LOCATION			ANTENNA SUMMARY NON ANTENNA SUMMARY								
SECTOR	RAD	AZ	POS ANTENNA BAND STATUS		ADDITIONAL TOWER MOUNTED EQUIPMENT	STATUS					
					LTE 700/LTE		FLEXI RRH 4T4R B14 160W FRBI	RMV			
			A1	QUINTEL QS86512-2	850/5G 850/LTE	RMN	AIRSCALE RRH 4T4R B5 160W AHCA	RMN			
					AWS		B66A RRH4X45—4R	RMN			
			A2	QUINTEL QS86512-2	LTE PCS	RMN	_	-			
ALPHA	151'	4°	A3	COMMSCOPE (ANDREW)	UMTS 850	RMV	TT08-19DB111-001_1900 TMA	REL			
			AS	SBNH-1D6565C	OWI 2 000	KIVIV	B25 RRH4X30-4R	REL			
			A4	COMMSCOPE (ANDREW)	LTE 700/LTE WCS	REL	RRH2X40W_7L	RMV			
			A4	SBNHH-1D65C	LIE 700/LIE WC3	REL	RRH4X25-WCS-4R	RMN			
			A5	_	_	-	_	-			
					LTE 700/LTE		FLEXI RRH 4T4R B14 160W FRBI	RMV			
			B1	1 QUINTEL QS86512-2		RMN	AIRSCALE RRH 4T4R B5 160W AHCA	RMN			
							B66A RRH4X45—4R	RMN			
			B2	QUINTEL QS86512-2 LTE PCS RMN		-	-				
BETA	151'	124°	B3	В3	COMMSCOPE (ANDREW)	UMTS 850	RMV	TT08-19DB111-001_1900 TMA	REL		
			ь	SBNH-1D6565C	OW13 000	KIVIV	B25 RRH4X30-4R	REL			
			D/	B4	COMMSCOPE (ANDREW)	LTE 700/LTE WCS	REL	RRH2X40W_7L	RMV		
					D4	SBNHH-1D65C	LIL 700/LIL WC3	KLL	RRH4X25-WCS-4R	RMN	
			B5	_	_	-	_	_			
								LTE 700/LTE		FLEXI RRH 4T4R B14 160W FRBI	RMV
			C1	QUINTEL QS86512-2	850/5G 850/LTE	RMN	AIRSCALE RRH 4T4R B5 160W AHCA	RMN			
					AWS		B66A RRH4X45—4R	RMN			
			C2	QUINTEL QS86512-2	LTE PCS	RMN	_	_			
GAMMA	151'	244°	C3	COMMSCOPE (ANDREW)	UMTS 850	RMV	TT08-19DB111-001_1900 TMA	REL			
			03	SBNH-1D6565C	OW13 000	IXIVIV	B25 RRH4X30-4R	REL			
			C4	COMMSCOPE (ANDREW)	LTE 700/LTE WCS	REL	RRH2X40W_7L	RMV			
				SBNHH-1D65C	LIL 700/LIL WOO	IXEL	RRH4X25-WCS-4R	RMN			
			C5	_	_	_	_	_			

EXISTING FIBER DISTRIBUTI	ON/SQUID		EXISTING CABLI	NG SUMMARY	
MODEL NUMBER	STATUS	COAX	DC	FIBER	STATUS
(2) DC6-48-60-18-8F	RMN	(12) 1-5/8"	(6) #8 AWG DC CABLES	(1) 3/8" RET CONTROL CABLE,	RMN
DC6-48-60-08F	RMN	_	1	(2) 18 PAIR FIBER TRUNKS	RMN

NOTES
BASED ON APPROVED ATC
APPLICATION 306035, DATED N/A.
CONFIRM WITH AT&T MOBILITY
REP FOR APPLICABLE
UPDATES/REVISIONS AND MOST
RECENT RFDS FOR NSN
CONFIGURATION (CONFIG). GC TO
CAP ALL UNUSED PORTS

MOTES

2. ATC HAS NOT YET VERIFIED ANY EXISTING ANTENNA CONFIG OR MOUNT CONFIG. CONTRACTOR TO VERIFY MOUNT CONFIG HAS SUFFICIENT SPACE FOR PROPOSED LESSEE EQUIPMENT (EQUIP) (I.E. CLEARANCES, MOUNT PIPE, SUFFICIENT LENGTH, ETC.)

ALL PROPOSED EQUIP INCLUDING ANTENNAS, COAX, ETC, SHALL BE MOUNTED IN ACCORDANCE WITH THE TOWER STRUCTURAL ANALYSIS ON FILE WITH ATC'S CM.

CONFIRM SPACING OF PROPOSED EQUIP DOES NOT CAUSE TOWER CONFLICTS NOR IMPEDE TOWER CLIMBING PEGS.

POSITIONS START WITH FIRST PIPE ON THE LEFT SIDE (AS VIEWED FROM BEHIND THE

STATUS ABBREVIATIONS RMV: TO BE REMOVED

RMN: TO REMAIN REL: TO BE RELOCATED
DSC: TO BE DISCONNECTED & REMAIN ADD: TO BE ADDED

CABLE LENGTHS FOR JUMPERS FIBER DISTRIBUTION/SQUID TO RRU: 15' RRU TO ANTENNA: 10'

				F	FINAL ANTENNA SCHEDULE	Ξ		
LOC	ATION			ANTENI	NA SUMMARY		NON ANTENNA SUMMAF	₹Y
SECTOR	RAD	AZ	POS	ANTENNA	BAND	STATUS	ADDITIONAL TOWER MOUNTED EQUIPMENT	STATUS
					LTE 700/LTE		AIRSCALE TRI RRH 4T4R B12/14/29 370W AHLBBA	ADD
			A1	QUINTEL QS86512-		RMN	AIRSCALE RRH 4T4R B5 160W AHCA	RMN
							B66A RRH4X45-4R	RMN
ALPHA	151'	4°	A2	QUINTEL QS86512-	2 UMTS PCS	RMN	B25 RRH4X30-4R	REL
			А3	NOKIA AEQK	5G CBAND	ADD	-	-
			A4	-	-	-	-	-
			A5	COMMSCOPE (ANDRE)	W) UMTS 850/ LTE WCS	DEL	TT08-19DB111-001_1900 TMA	REL
			AS	SBNHH-1D65C	UMIS 850/ LIE WCS	REL	RRH4X25-WCS-4R	RMN
					LTE 700/LTE		AIRSCALE TRI RRH 4T4R B12/14/29 370W AHLBBA	ADD
			B1	QUINTEL QS86512		RMN	AIRSCALE RRH 4T4R B5 160W AHCA	RMN
							B66A RRH4X45-4R	RMN
BETA	151'	124°	B2	QUINTEL QS86512-	2 UMTS PCS	RMN	B25 RRH4X30-4R	REL
			В3	NOKIA AEQK	5G CBAND	ADD	-	-
			B4	-	-	-	-	-
			B5	COMMSCOPE (ANDRE)	W) UMTS 850/ LTE WCS	REL	TT08-19DB111-001_1900 TMA	REL
			D 3	SBNHH-1D65C	OWITS 650/ LTE WCS	KEL	RRH4X25-WCS-4R	RMN
					LTE 700/LTE		AIRSCALE TRI RRH 4T4R B12/14/29 370W AHLBBA	ADD
			C1 QUINTEL QS86512-2 850/5G 850/LTE RMN AWS	AIRSCALE RRH 4T4R B5 160W AHCA	RMN			
							B66A RRH4X45-4R	RMN
GAMMA	151'	244°	C2	QUINTEL QS86512-	2 UMTS PCS	RMN	B25 RRH4X30-4R	REL
			C3	NOKIA AEQK	5G CBAND	ADD	-	-
			C4	-	-	-	-	-
			C5	COMMSCOPE (ANDRE)	W) UMTS 850/ LTE WCS	REL	TT08-19DB111-001_1900 TMA	REL
			Co	SBNHH-1D65C	OWITS 000/ LIE WCS	KEL	RRH4X25-WCS-4R	RMN
	FIN	AL FIB	ER DIS	TRIBUTION/SQUID	F	FINAL CABL	ING SUMMARY	

DC

(6) #8 AWG DC CABLES





Wixom, Michigan 48393 PHONE: (248) 705-9212

REV.	DESCRIPTION	BY	DATE
\triangle _	PRELIM	RC_	05/25/21
\triangle_{-}	FINAL CD	RC	06/24/21
\wedge			
$\overline{\wedge}$			

ATC SITE NUMBER:

306035

ATC SITE NAME:

UNITY VILLAGE MO 2

SITE ADDRESS: 2150 NORTHWEST LOWENSTEIN DRIVE LEES SUMMIT, MO 64081

SEAL:





DATE DRAWN:	05/25/21
ATC JOB NO:	13619563
CUSTOMER ID:	KS4022
CUSTOMER NAME:	UNITY VILLAGE

RF SCHEDULE AND ANTENNA INSTALLATION

SHEET NUMBER: C-401

STATUS

RMN

RMN

FIBER

(1) 3/8" RET CONTROL CABLE.

(2) 18 PAIR FIBER TRUNKS

REVISION:

EQUIPMENT SCHEDULES

MODEL NUMBER

(2) DC6-48-60-18-8F


DC6-48-60-08F

STATUS


RMN

COAX

(12) 1-5/8'

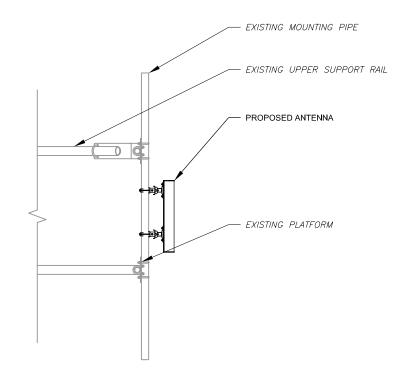



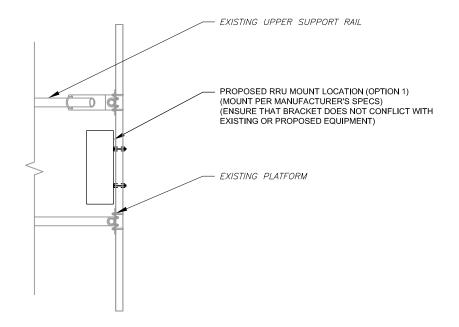

TYPICAL RRU DETAIL
-FOR REFERENCE ONLY
SCALE: N.T.S.





REV.	DESCRIPTION	BY	DATE
A.	PRELIM	RC	05/25/21
<u> </u>	FINAL CD	RC	06/24/21
\triangle			
$\bar{\Lambda}$			

ATC SITE NUMBER:


306035

ATC SITE NAME:

UNITY VILLAGE MO 2

SITE ADDRESS: 2150 NORTHWEST LOWENSTEIN DRIVE LEES SUMMIT, MO 64081

SEAL:

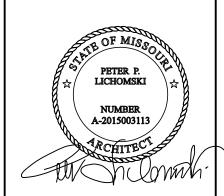




I	DATE DRAWN:	05/25/21
I	ATC JOB NO:	13619563
ı	CUSTOMER ID:	KS4022
ı	CUSTOMER NAME:	UNITY VILLAGE

CONSTRUCTION DETAILS


SHEET NUMBER:

C-501

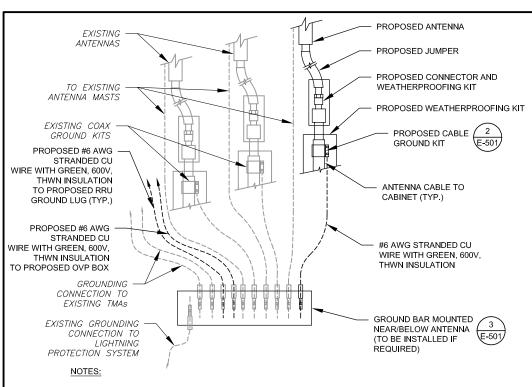

- 1. THIS DETAIL IS INTENDED TO SHOW THE GENERAL GROUNDING REQUIREMENTS. SLIGHT ADJUSTMENTS MAY BE REQUIRED BASED ON EXISTING SITE CONDITIONS. THE CONTRACTOR SHALL MAKE FIELD ADJUSTMENTS AS NEEDED AND INFORM THE CONSTRUCTION MANAGER OF ANY CONFLICTS.
- 2. SITE GROUNDING SHALL COMPLY WITH AT&T MOBILITY GROUNDING STANDARDS, LATEST EDITION, AND COMPLY WITH AT&T MOBILITY GROUNDING CHECKLIST, LATEST VERSION. WHEN NATIONAL AND LOCAL GROUNDING CODES ARE MORE STRINGENT THEY SHALL

TYPICAL ANTENNA GROUNDING DIAGRAM

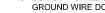

TO EQUIPMENT

DO NOT INSTALL CABLE GROUND KIT AT A BEND AND ALWAYS DIRECT GROUND WIRE DOWN TO GROUND BAR.

TO ANTENNA

0

2. CONTRACTOR SHALL PROVIDE WEATHERPROOFING KIT (ANDREW PART NUMBER 221213) AND INSTALL/TAPE PER MANUFACTURER'S SPECIFICATIONS.



TO GROUND BAR

- ANTENNA CABLE 2 1/2"Ø MAX


GROUNDING KIT PER CABLE

(ANDREW OR APPROVED EQUAL)


MANUFACTURER'S RECOMMENDATIONS

#6 AWG STRANDED COPPER GROUND

WIRE (GROUNDED TO GROUND BAR)

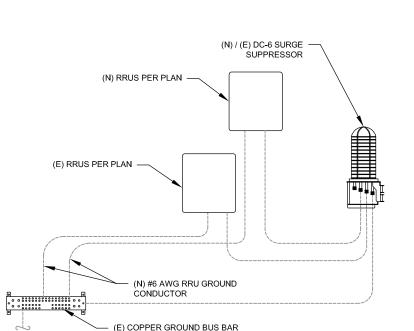


TYP. RRU GROUNDING

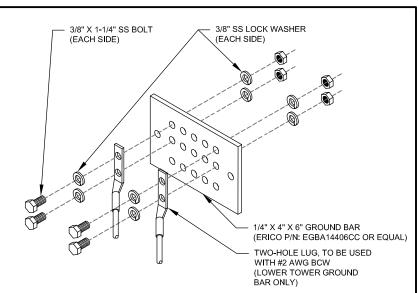

GROUND BAR NOTES:

- GROUND BAR KITS COME WITH ALL HARDWARE, NUTS, BOLTS, WASHERS, ETC. EXCEPT THE STRUCTURAL MOUNTING MEMBER(S).
- 2. GROUND BAR TO BE BONDED DIRECTLY TO TOWER.

TYP. TOWER GROUND BAR DETAIL

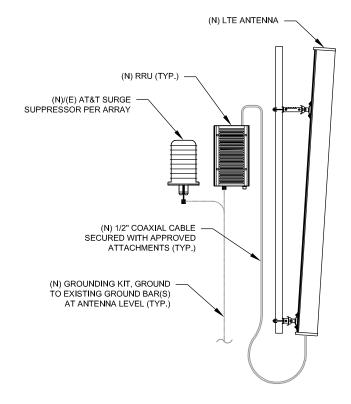







REV.	DESCRIPTION	BY	DATE
<u> </u>	PRELIM	RC_	05/25/21
<u> </u>	FINAL CD	RC	06/24/21
\triangle			
\wedge			

PHONE: (248) 705-9212

ATC SITE NUMBER:


306035

ATC SITE NAME:

UNITY VILLAGE MO 2

SITE ADDRESS: 2150 NORTHWEST LOWENSTEIN DRIVE LEES SUMMIT, MO 64081

SEAL:

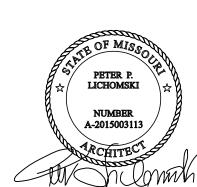




DATE DRAWN:	05/25/21
ATC JOB NO:	13619563
CUSTOMER ID:	KS4022
CUSTOMER NAME:	UNITY VILLAGE

GROUNDING DETAILS

SHEET NUMBER: E-501


REVISION:

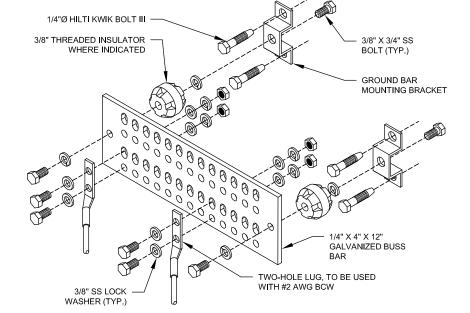


GROUND BAR NOTES

- GROUND KITS COME WITH ALL HARDWARE, NUTS, BOLTS, WASHERS, ETC. EXCEPT THE STRUCTURAL MOUNTING MEMBER(S)
- GROUND BAR SHALL BE BOLTED TO STRUCTURAL MEMBER OR ANCHORED TO CONCRETE SLAB W/ HILTI KWIK BOLT III.

TYP. MAIN GROUND BAR DETAIL SCALE: N.T.S

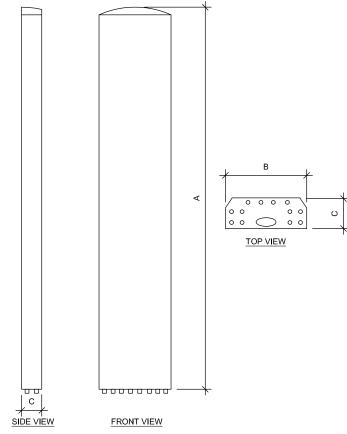

ANTENNA SPECIFICATIONS					
ANTENNA MODEL	А	В	С	WEIGHT (LBS)	
AEQK	29.5"	17.2"	9.5"	99.2	

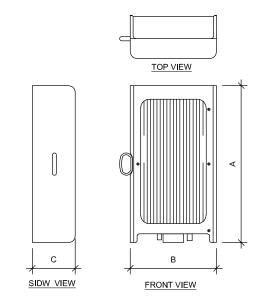

RRU SPECIFICATIONS					
RRU MODEL	А	В	С	WEIGHT (LBS)	
NOKIA AIRSCALE TRI RRH 4T4R B12/14/29 370 W AHLBBA	24.0"	14.1"	7.8"	94.8	

SUPPLEMENTAL


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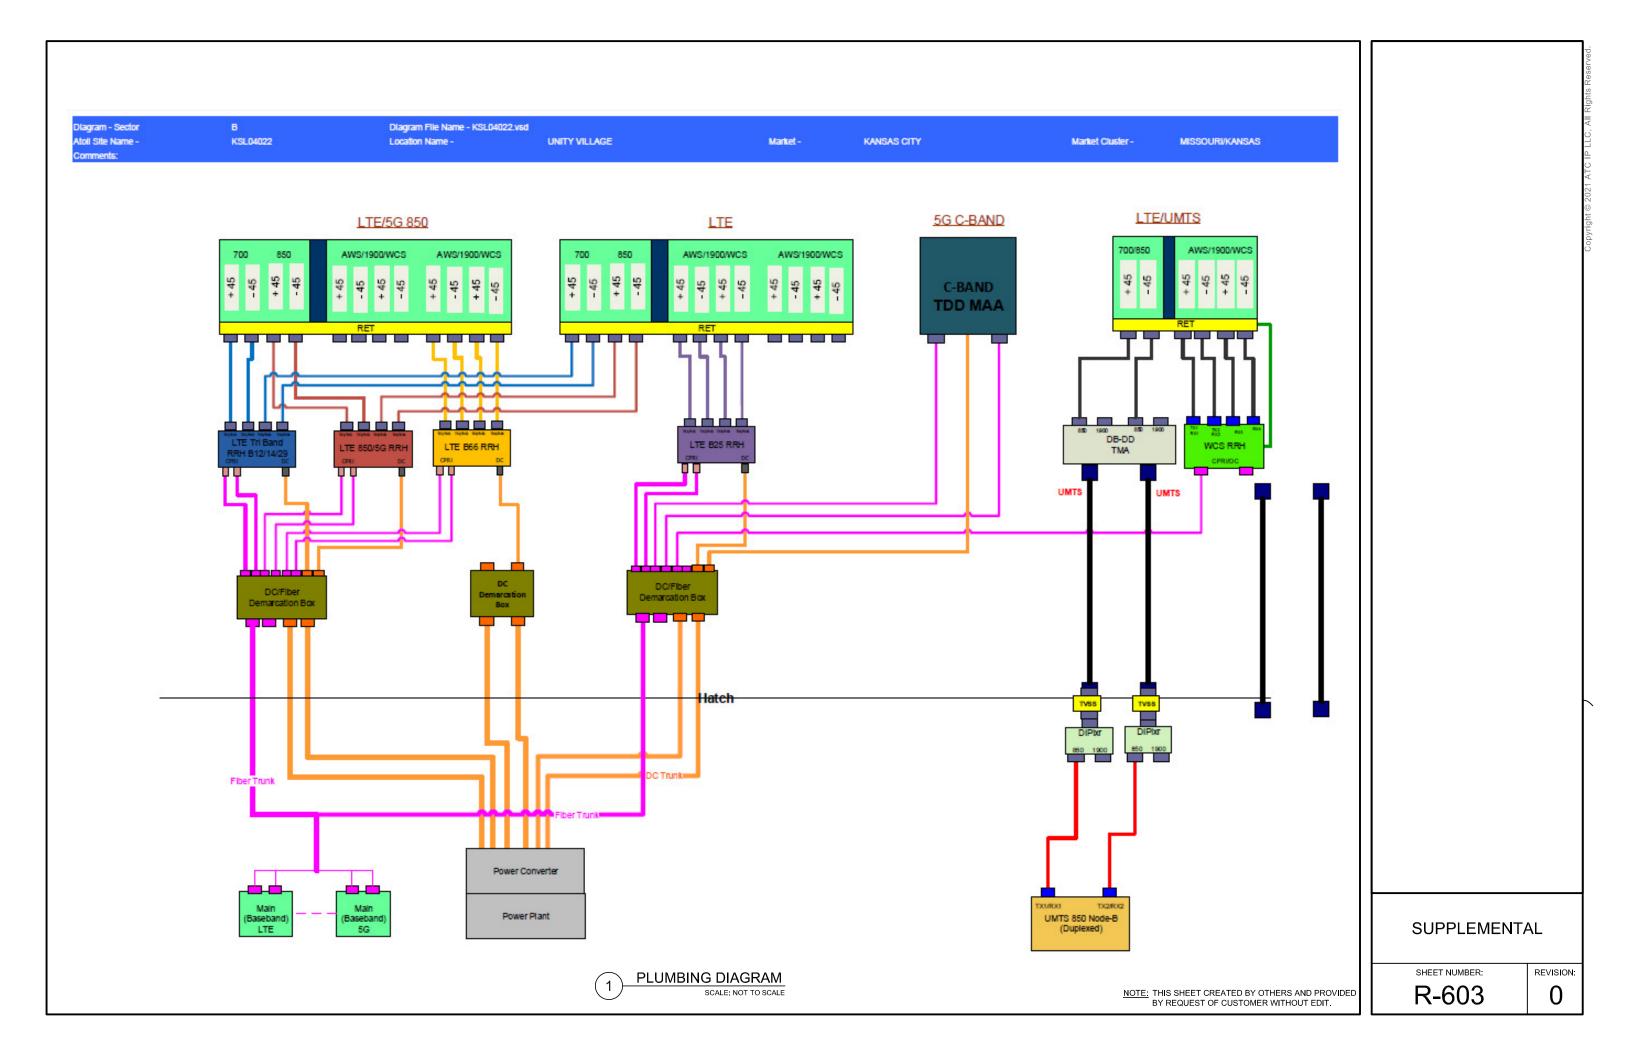
R-601


1

REVISION:

EQUIPMENT SPECIFICATIONS
SCALE: NOT TO SCALE



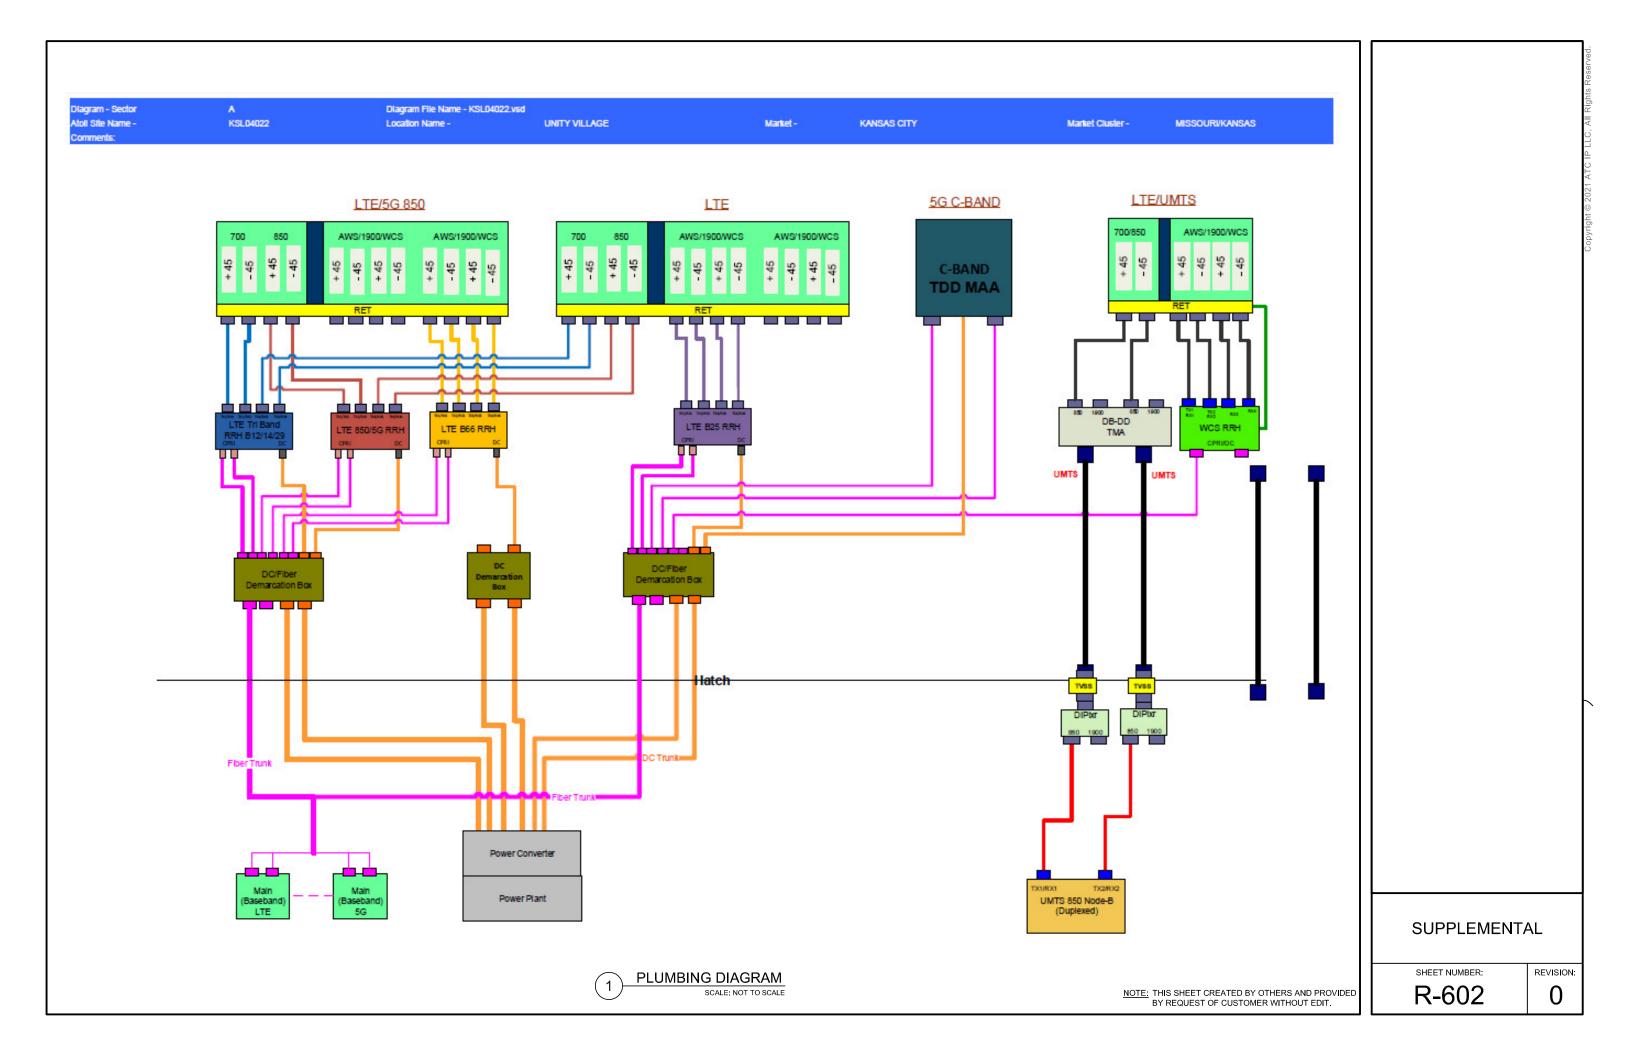

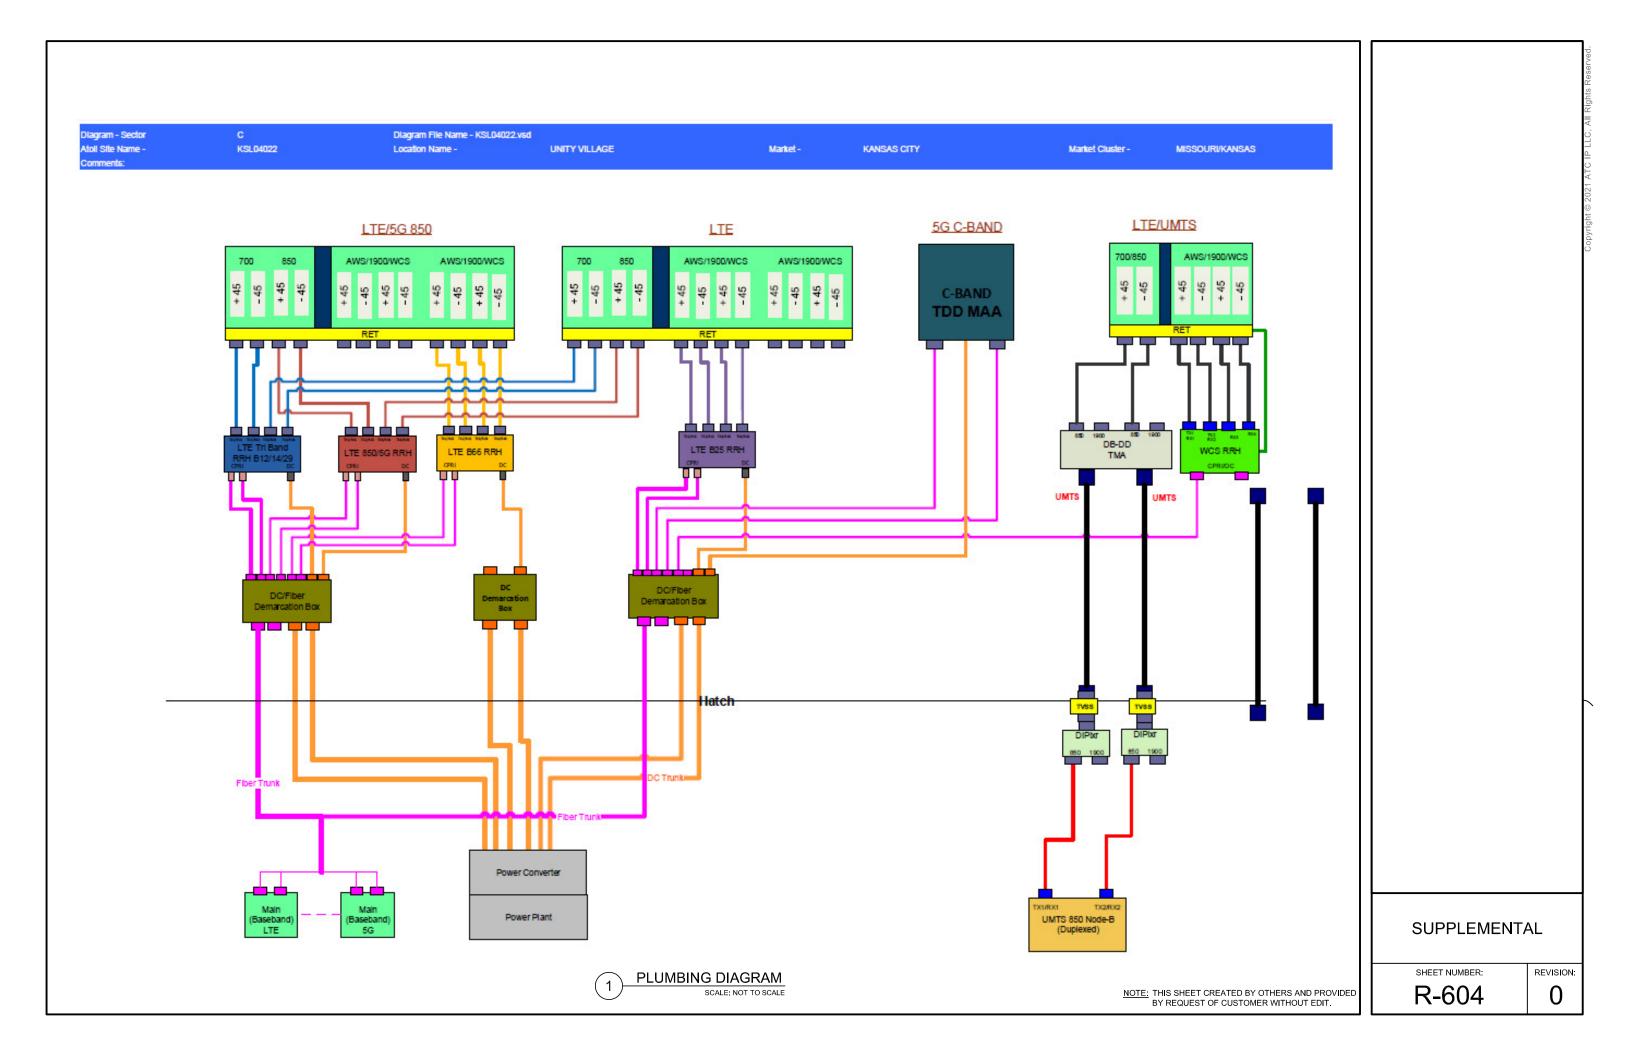



Mount Analysis Report

ATC Site Name : Unity Village MO 2, MO

ATC Site Number : 306035

Engineering Number : 13619563_C8_01

Mount Elevation : 150 ft

Carrier : AT&T Mobility

Carrier Site Name : UNITY VILLAGE

Carrier Site Number : KS4022

Site Location : 2150 NW LOWENSTEIN

Lees Summit, MO 64081-1905

Reviewed By:

38.93361269 , -94.41749129

County : Jackson

Date : May 20, 2021

Max Usage : 46% Result : Pass

Prepared By: Alan Samboy Structural Engineer

Alan Sambey

TOF MISCONIA SCOTTONIA WIRGAU NUMBER PE-2016036844

COA: 2006031326

ATC Tower Services - 3500 Regency Parkway, Suite 100 - Cary, NC 27518 - 919.468.0112 Office - 919.466.5414 Fax - www.americantower.com



Eng. Number 13619563_C8_01 May 20, 2021 Page 1

Introduction

The purpose of this report is to summarize results of the mount analysis performed for AT&T Mobility at $150\,$ ft.

Supporting Documents

Specifications Sheet	Sabre C10857007C, dated February 29, 2016	
Radio Frequency Data Sheet	RFDS ID #10000434, dated April 28, 2021	
Reference Photos	Site photos from 2019	

Analysis

This mount was analyzed using American Tower Corporation's Mount Analysis Program and RISA-3D

Basic Wind Speed:	109 mph (3-Second Gust)
Basic Wind Speed w/ Ice:	40 mph (3-Second Gust) w/ 1 1/2" radial ice concurrent
Codes:	ANSI/TIA-222-H
Exposure Category:	С
Risk Category:	11
Topographic Factor Procedure:	Method 2
Feature:	Flat
Crest Height (H):	0 ft
Crest Length (L):	0 ft
Spectral Response:	Ss = 0.099, S1 = 0.068
Site Class:	D - Stiff Soil
Live Loads:	Lm = 500 lbs, Lv = 250 lbs

Conclusion

Based on the analysis results, the antenna mount meets the requirements per the applicable codes listed above. The mount can support the equipment as described in this report.

If you have any questions or require additional information, please contact American Tower via email at Engineering@americantower.com. Please include the American Tower site name, site number, and engineering number in the subject line for any questions.

ATC Tower Services - 3500 Regency Parkway, Suite 100 - Cary, NC 27518 - 919.468.0112 Office - 919.466.5414 Fax - www.americantower.com

NOTE: THIS SHEET WAS CREATED BY OTHERS AND PROVIDED AT THE REQUEST OF THE CUSTOMER WITHOUT EDIT. PLEASE REFERENCE THE MOUNT ANALYSIS REPORT FOR COMPLETE MOUNT ANALYSIS CALCULATIONS AND DETAILS. SUPPLEMENTAL PAGES INCLUDED IN THE

ANALYSIS CALCULATIONS AND DETAILS. SUPPLEMENTAL PAGES INCLUDED IN THE CONSTRUCTION DRAWINGS ARE FOR REFERENCE ONLY. GENERAL CONTRACTOR IS TO VERYIFY THEY HAVE THE MOST RECENT MOUNT ANALYSIS PRIOR TO CONTRUCTION.

SUPPLEMENTAL

R-605 Revision:

MOUNT ANALYSIS



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Application Loading

Mount Centerline (ft)	Equipment Centerline (ft)	Qty	Equipment Manufacturer & Model
162.0	162.0	1	Andrew Microwaves UHX6-105
		3	Nokia AEQK AirScale MAA 64T64R 192AE n77 200W
		6	Quintel QS86512-2
		3	Commscope SBNHH-1D65C
		3	Powerwave Allgon TT08-19DB111-001
		1	Raycap DC6-48-60-18-8F
1500	151.0	1	Raycap DC6-48-60-0-8F
150.0	151.0	1	Raycap DC6-48-60-18-8F ("Squid")
		3	Nokia AHLBBA
		3	Alcatel-Lucent RRH4X25-WCS
		3	Nokia AirScale RRH 4T4R B5 160W AHCA
		3	Alcatel-Lucent B66A RRH4x45-4R w/ Solar Shield
	[3	Alcatel-Lucent B25 RRH4x30

Structure Usages

Structural Component	Controlling Usage	Pass/Fail
Horizontals	45%	Pass
Verticals	20%	Pass
Diagonals	17%	Pass
Tie-Backs	4%	Pass
Mount Pipes	46%	Pass


ATC Tower Services - 3500 Regency Parkway, Surte 100 - Cary, NC 27518 - 919.458.01.12 Office - 919.456.5414 fax - www.americantower.com

SUPPLEMENTAL

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RF REQUIREMENTS FOR 700 B14 FIRSTNET, 700 B12, 700D B29 ANTENNA SEPARATION

- Horizontal separation (side to side of antenna): >= 3'
- ☐ Vertical separation (between the tips of the antennas): > 3'
- ☐ Inter-sector separation: > 3' between the center of the antenna backplanes.

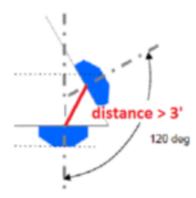

- ☐ Please note additional horizontal separation may be required if B14 antennas azimuth are different from others or antennas are severely angled with respect to the mount.
- ☐ Typical 3' horizontal separation can tolerate skew angle up to 6°.



SUPPLEMENTAL