PARAGON STAR VILLAGE

Lot 20 / HUB Building - RESUBMITTAL

1401 NW View High Drive, Lee's Summit, MO

SHEET INDEX

GENERAL SITE PLAN

EXISTING CONDITIONS GRADING PLAN

DIMENSION PLAN

CONSTRUCTION DETAILS

EROSION CONTROL PLAN

EROSION CONTROL NOTES


EROSION CONTROL DETAILS

EROSION CONTROL DETAILS TRUCK TURNING MOVEMENT

A1.01 ARCHITECTURAL SITE PLAN A1.02 BUILDING ELEVATIONS AND DETAILS

LANDSCAPE

L100 PLANTING PLAN

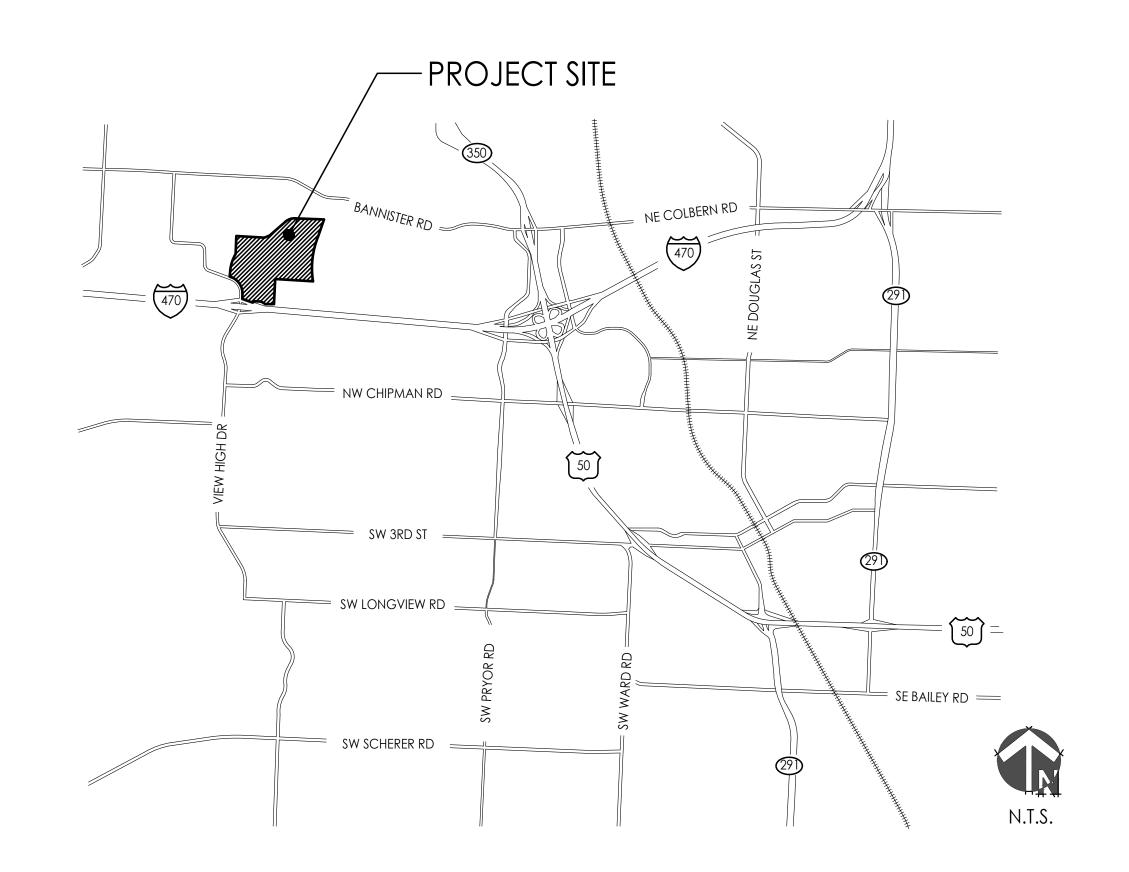

PLANS PREPARED BY



MO Engnieering Corp 000133







March 31, 2021

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Hoerr Schaudt

Landscape Architects

MO Landscape Arch Corp 2019004088

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MO Engineering Corp 000556

FINKLE + WILLIAMS Architecture 8787 Renner Blvd., Suite 100 Lenexa, KS 66219 913.498.1550

OWNER

Paragon Star, LLC 801 NW Commerce Drive Lee's Summit, MO 64086 855.802.6800 www.paragonstarusa.com

www.finklewilliams.com MO Architecture Corp 00453304

COVERSHEET

JOB NO: 1249 SCALE: DATE: 03.31.2021 DRAWN BY:

CIVIL ENGINEERING

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PROFESSIONAL SEAL:

Final Development Plan Extents:

Lot 20 and a portion of Lot 14, Paragon Star Second Plat

<u>Lot 20:</u>

Parking Setback: 2 FT Building Setback to property line: 5 FT

Prepared and Submitted By:

George Butler Associates, Inc. 9801 Renner Boulevard Lenexa, Kansas 66219 Phone: 913-492-0400 Fax: 913-577-8312 Contact: Clint Loumaster, P.E. Email: cloumaster@gbateam.com

Floodplain:

According to FEMA Flood Insurance Rate Map (FIRM) Community Panel No. 29095C0404G, effective Date 1/20/17, the tract lies partially within an area designated as Special Flood Hazard Areas. Special Flood Hazard Areas defined on portions of the site include regulatory floodway, Zone AE (with depths identified on site from 810 to 811), and 0.2% Annual Chance Flood Hazard Areas.


A CLOMR has been issued for this project, case number 20-07-0520R, dated 2/14/20. Proposed Floodplain/ Floodway refers to boundary set by this CLOMR.

<u>Parking:</u>

Total Parking Spaces = 498 Regular Spaces = 473 ADA Spaces = 25


<u>Notes:</u>

No oil or gas wells are located on site per Missouri Department of Natural Resources.

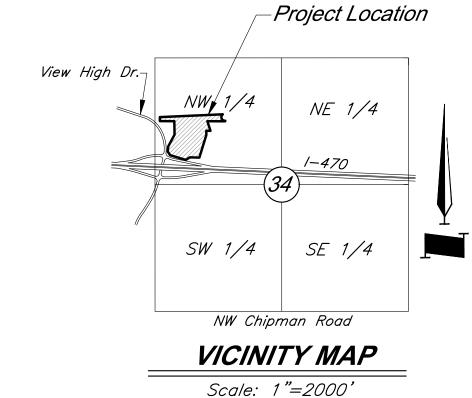

Legend

Barbed Wire Fence Centerline Power Pole — — Fiber Optic Line Guy Anchor Electric Meter Gas Line Guard Rail Electrical Transformer Electric Pedestal — - - - OHE - - - OHE — Over Head Electric Power Pole/Telephone Pole Power Pole/Light Pole — Property Line Gas Meter — Right-of-Way Line Gas Valve Sanitary Sewer Line Curb Inlet Stream Junction Box — UGE— — — UGE— — Underground Electric Sanitary Sewer Manhole —— UGT — — — Underground Telephone Light Pole Underground Cable TV Boring Hole Water Line Proposed Grades Property Corner Proposed Storm Sewers Telephone Manhole Telephone Pedestal Existing Grades Telephone Pole = = Existing Storm Sewers Proposed Building Tree Deciduous Fire Hydrant Water Meter Proposed Floodway Proposed Floodplain Stream Corridor

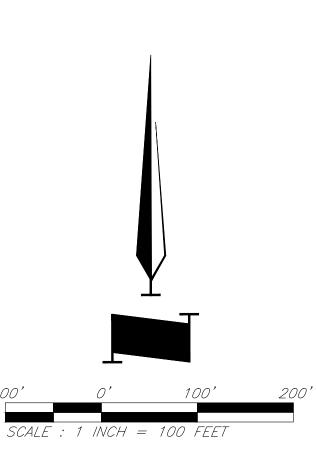

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PROJECT:

Building

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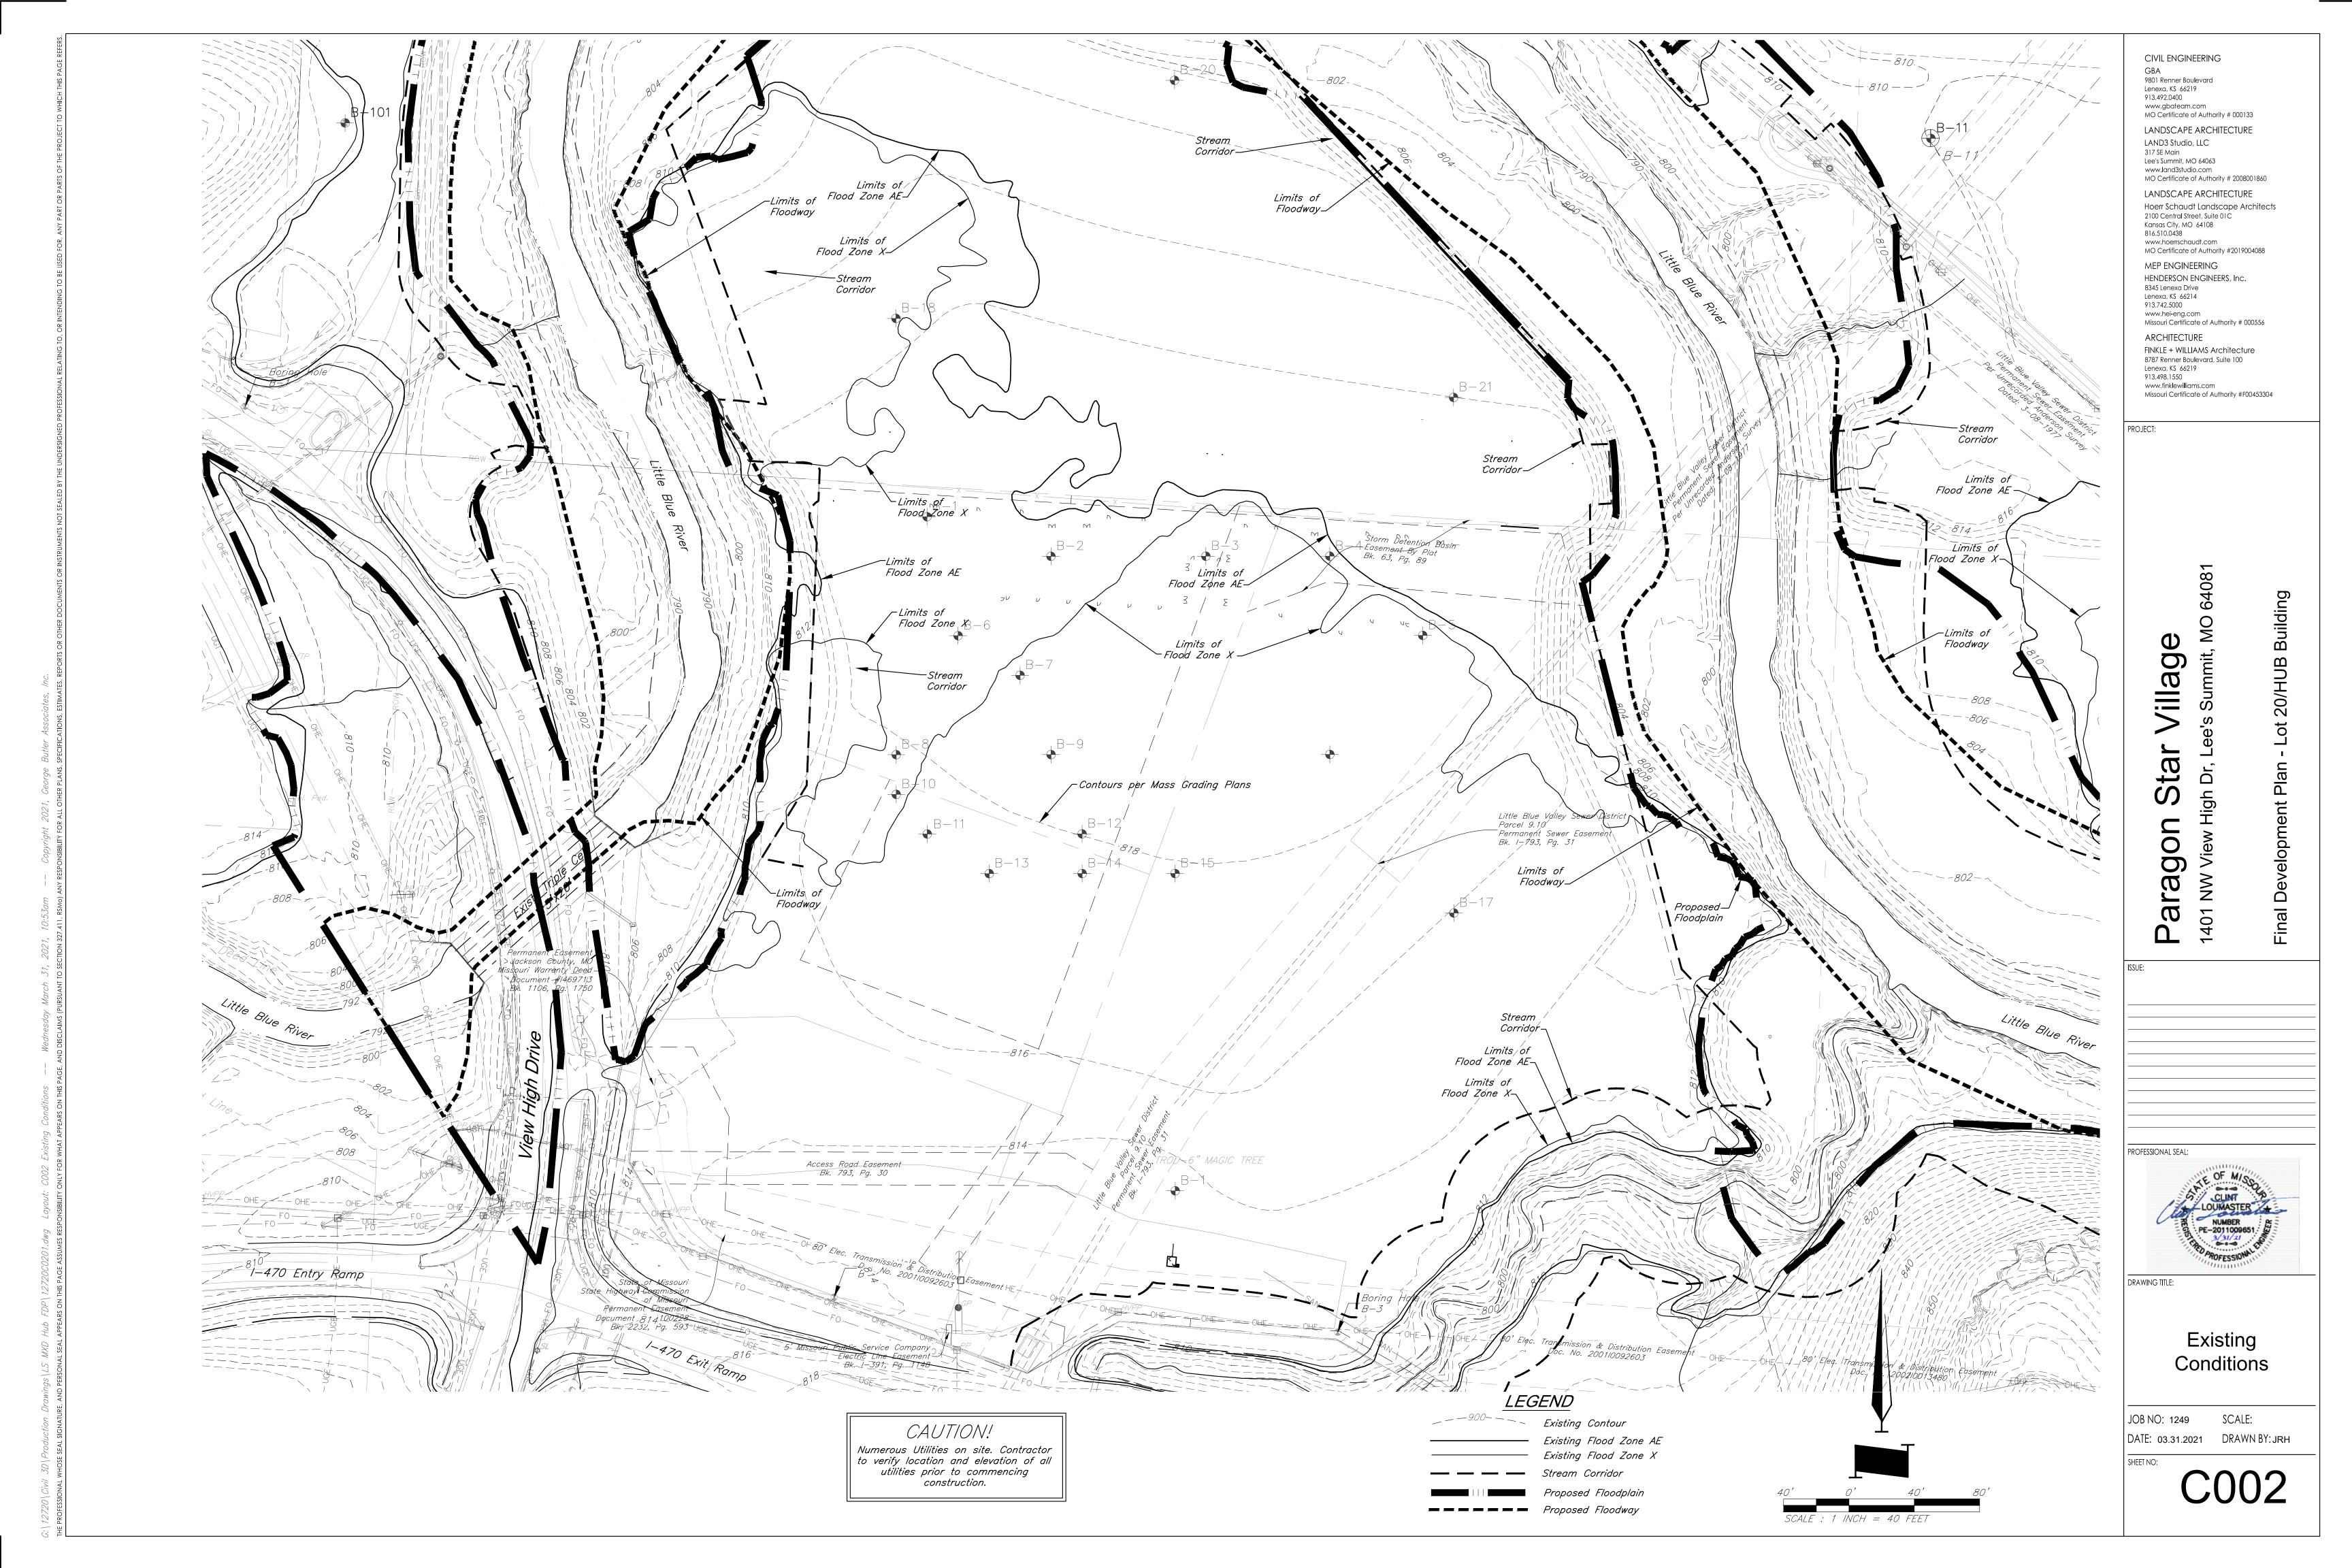
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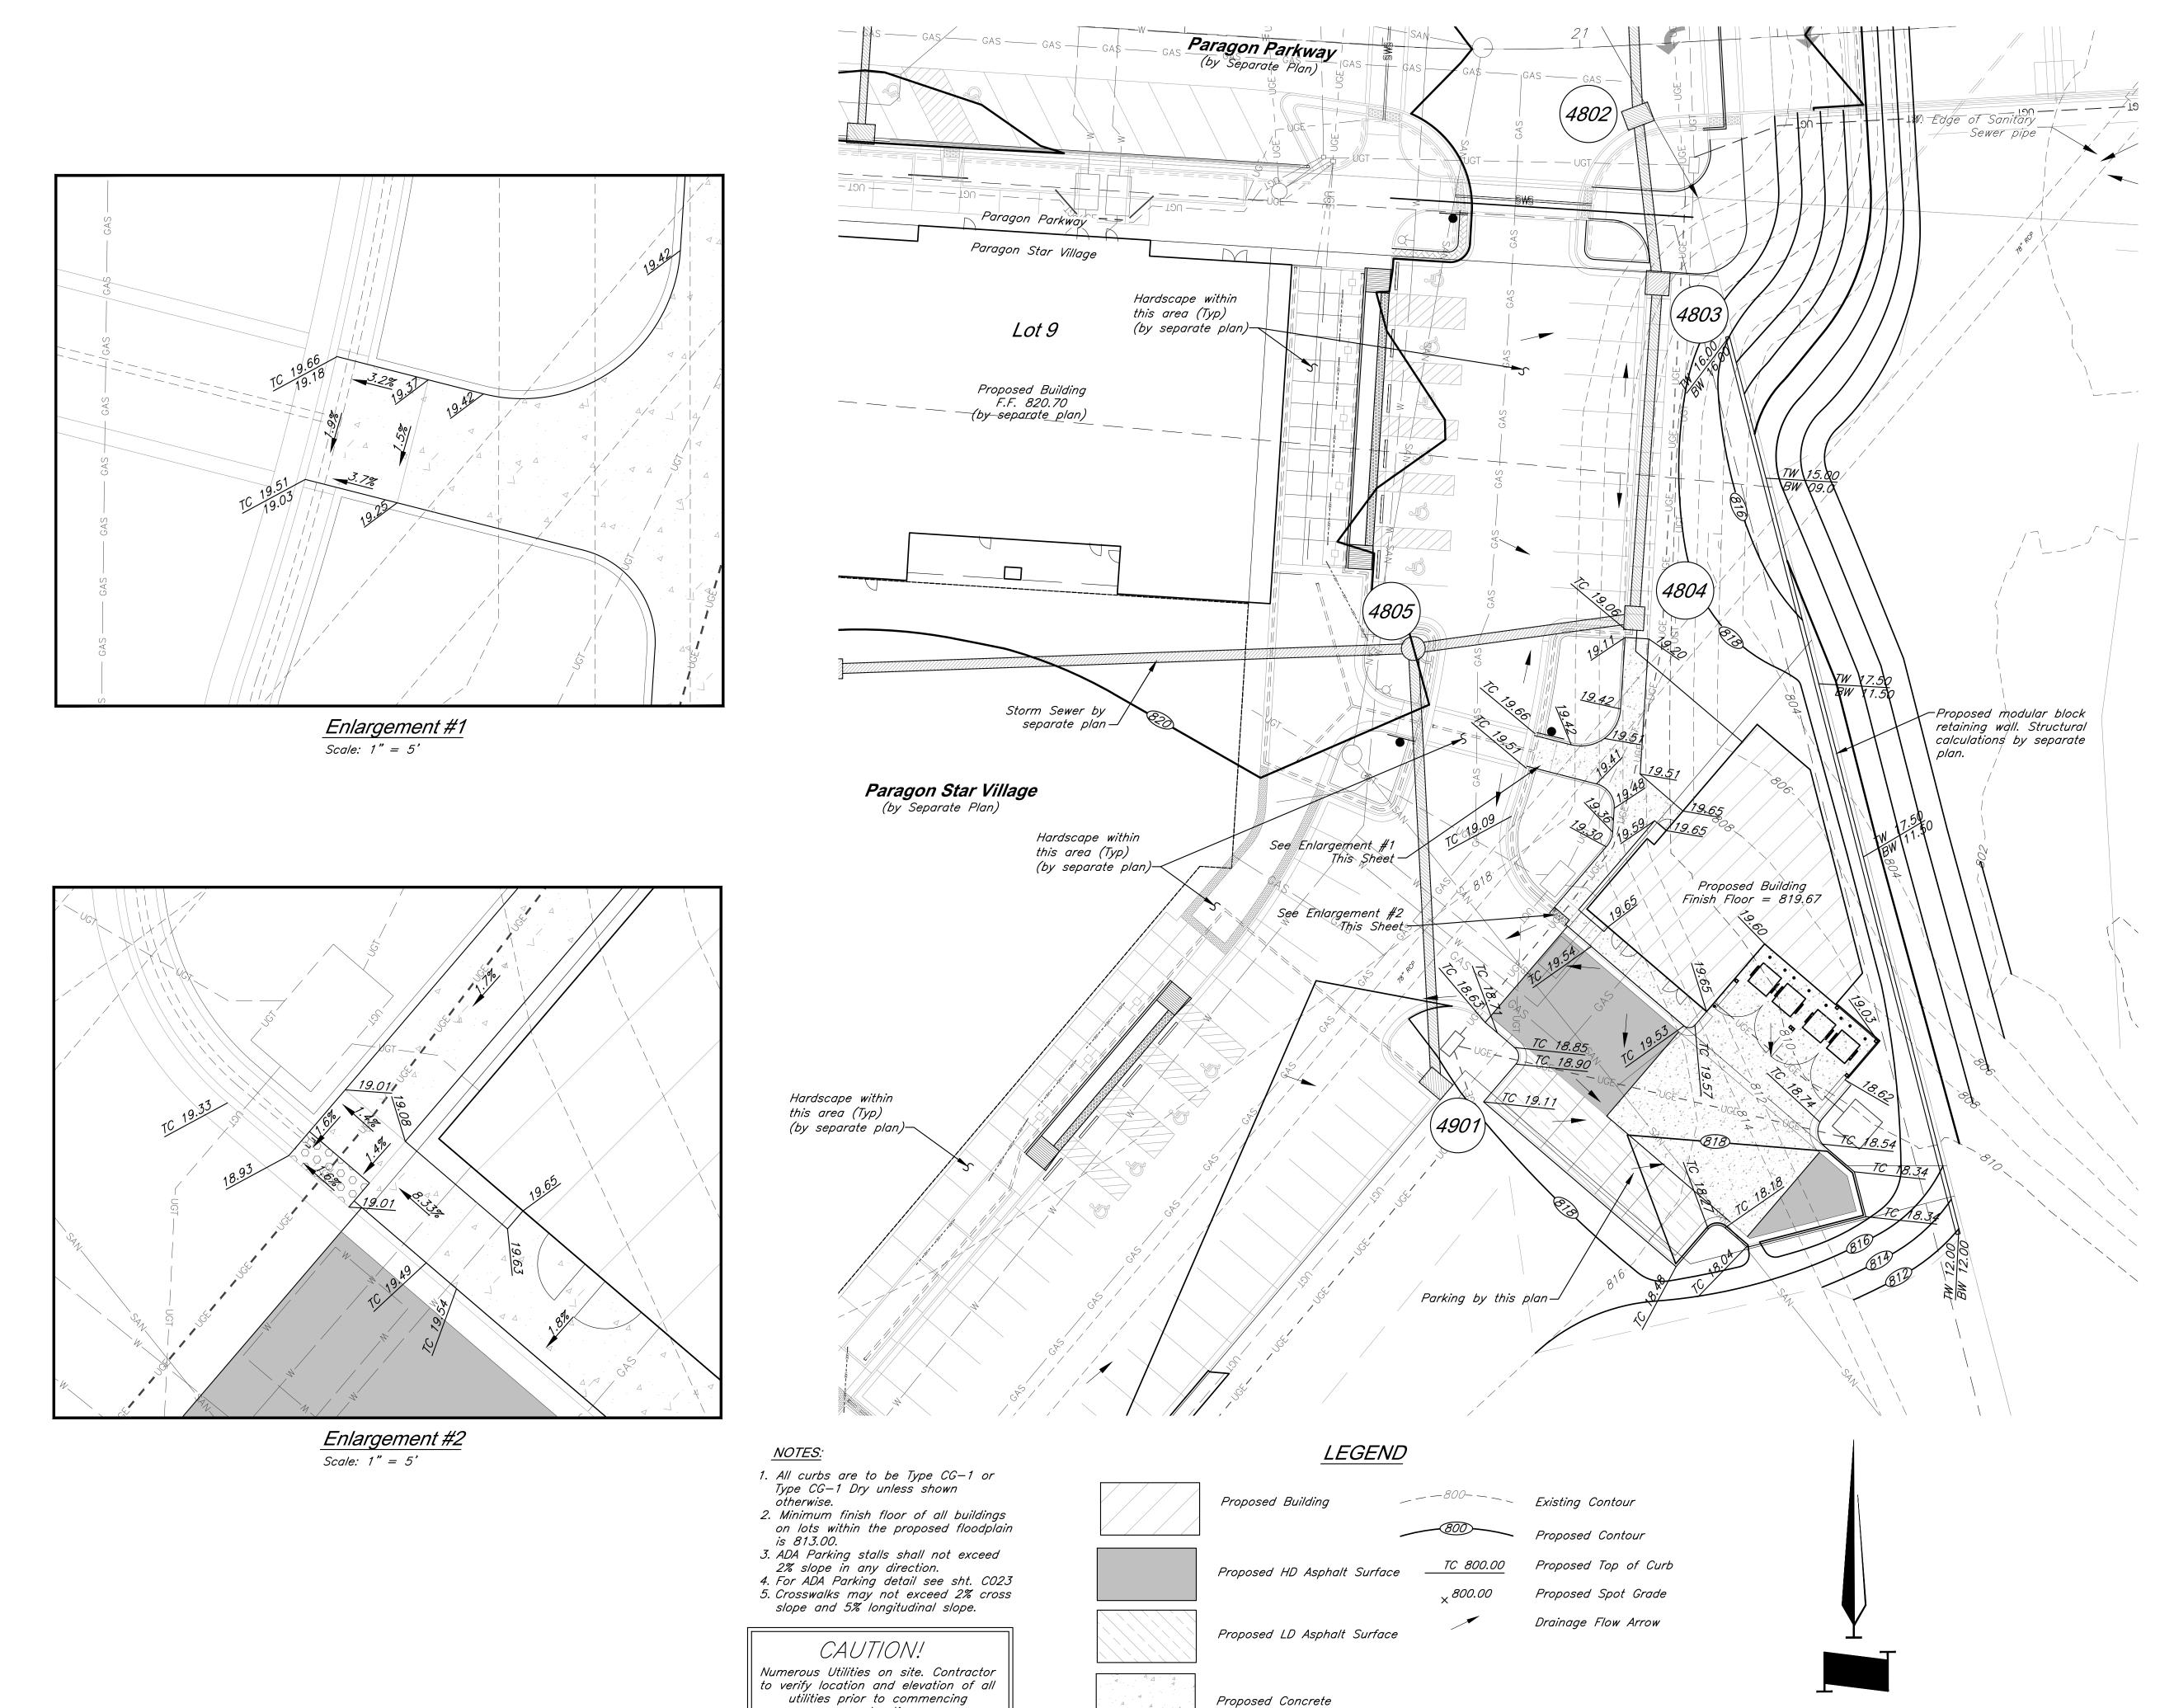
General Site Plan

JOB NO: 1249 SCALE: DATE: 03.31.2021 DRAWN BY: JRH

corner of concrete guardrail at the Northeast corner of 1470 bridge spanning View High Drive. Coordinates: N=1008590.33', E=2803864.07', EL=833.80

BM #13 — Chiseled "L" on NE corner of Interstate 470 and Cedar Creek Bridge Coordinates:N=1008342.79', E=2806758.22', EL=852.04'





construction.

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PROJECT:

PROJECT:

Star Village
In Dr. Lee's Summit, MO 64081


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Building

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PROFESSIONAL SEAL:



DRAWING TITLE:


SCALE : 1 INCH = 20 FEET

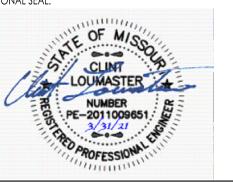Grading Plan

JOB NO: 1249 SCALE:
DATE: 03.31.2021 DRAWN BY: JRH

SHEET NO:

C003

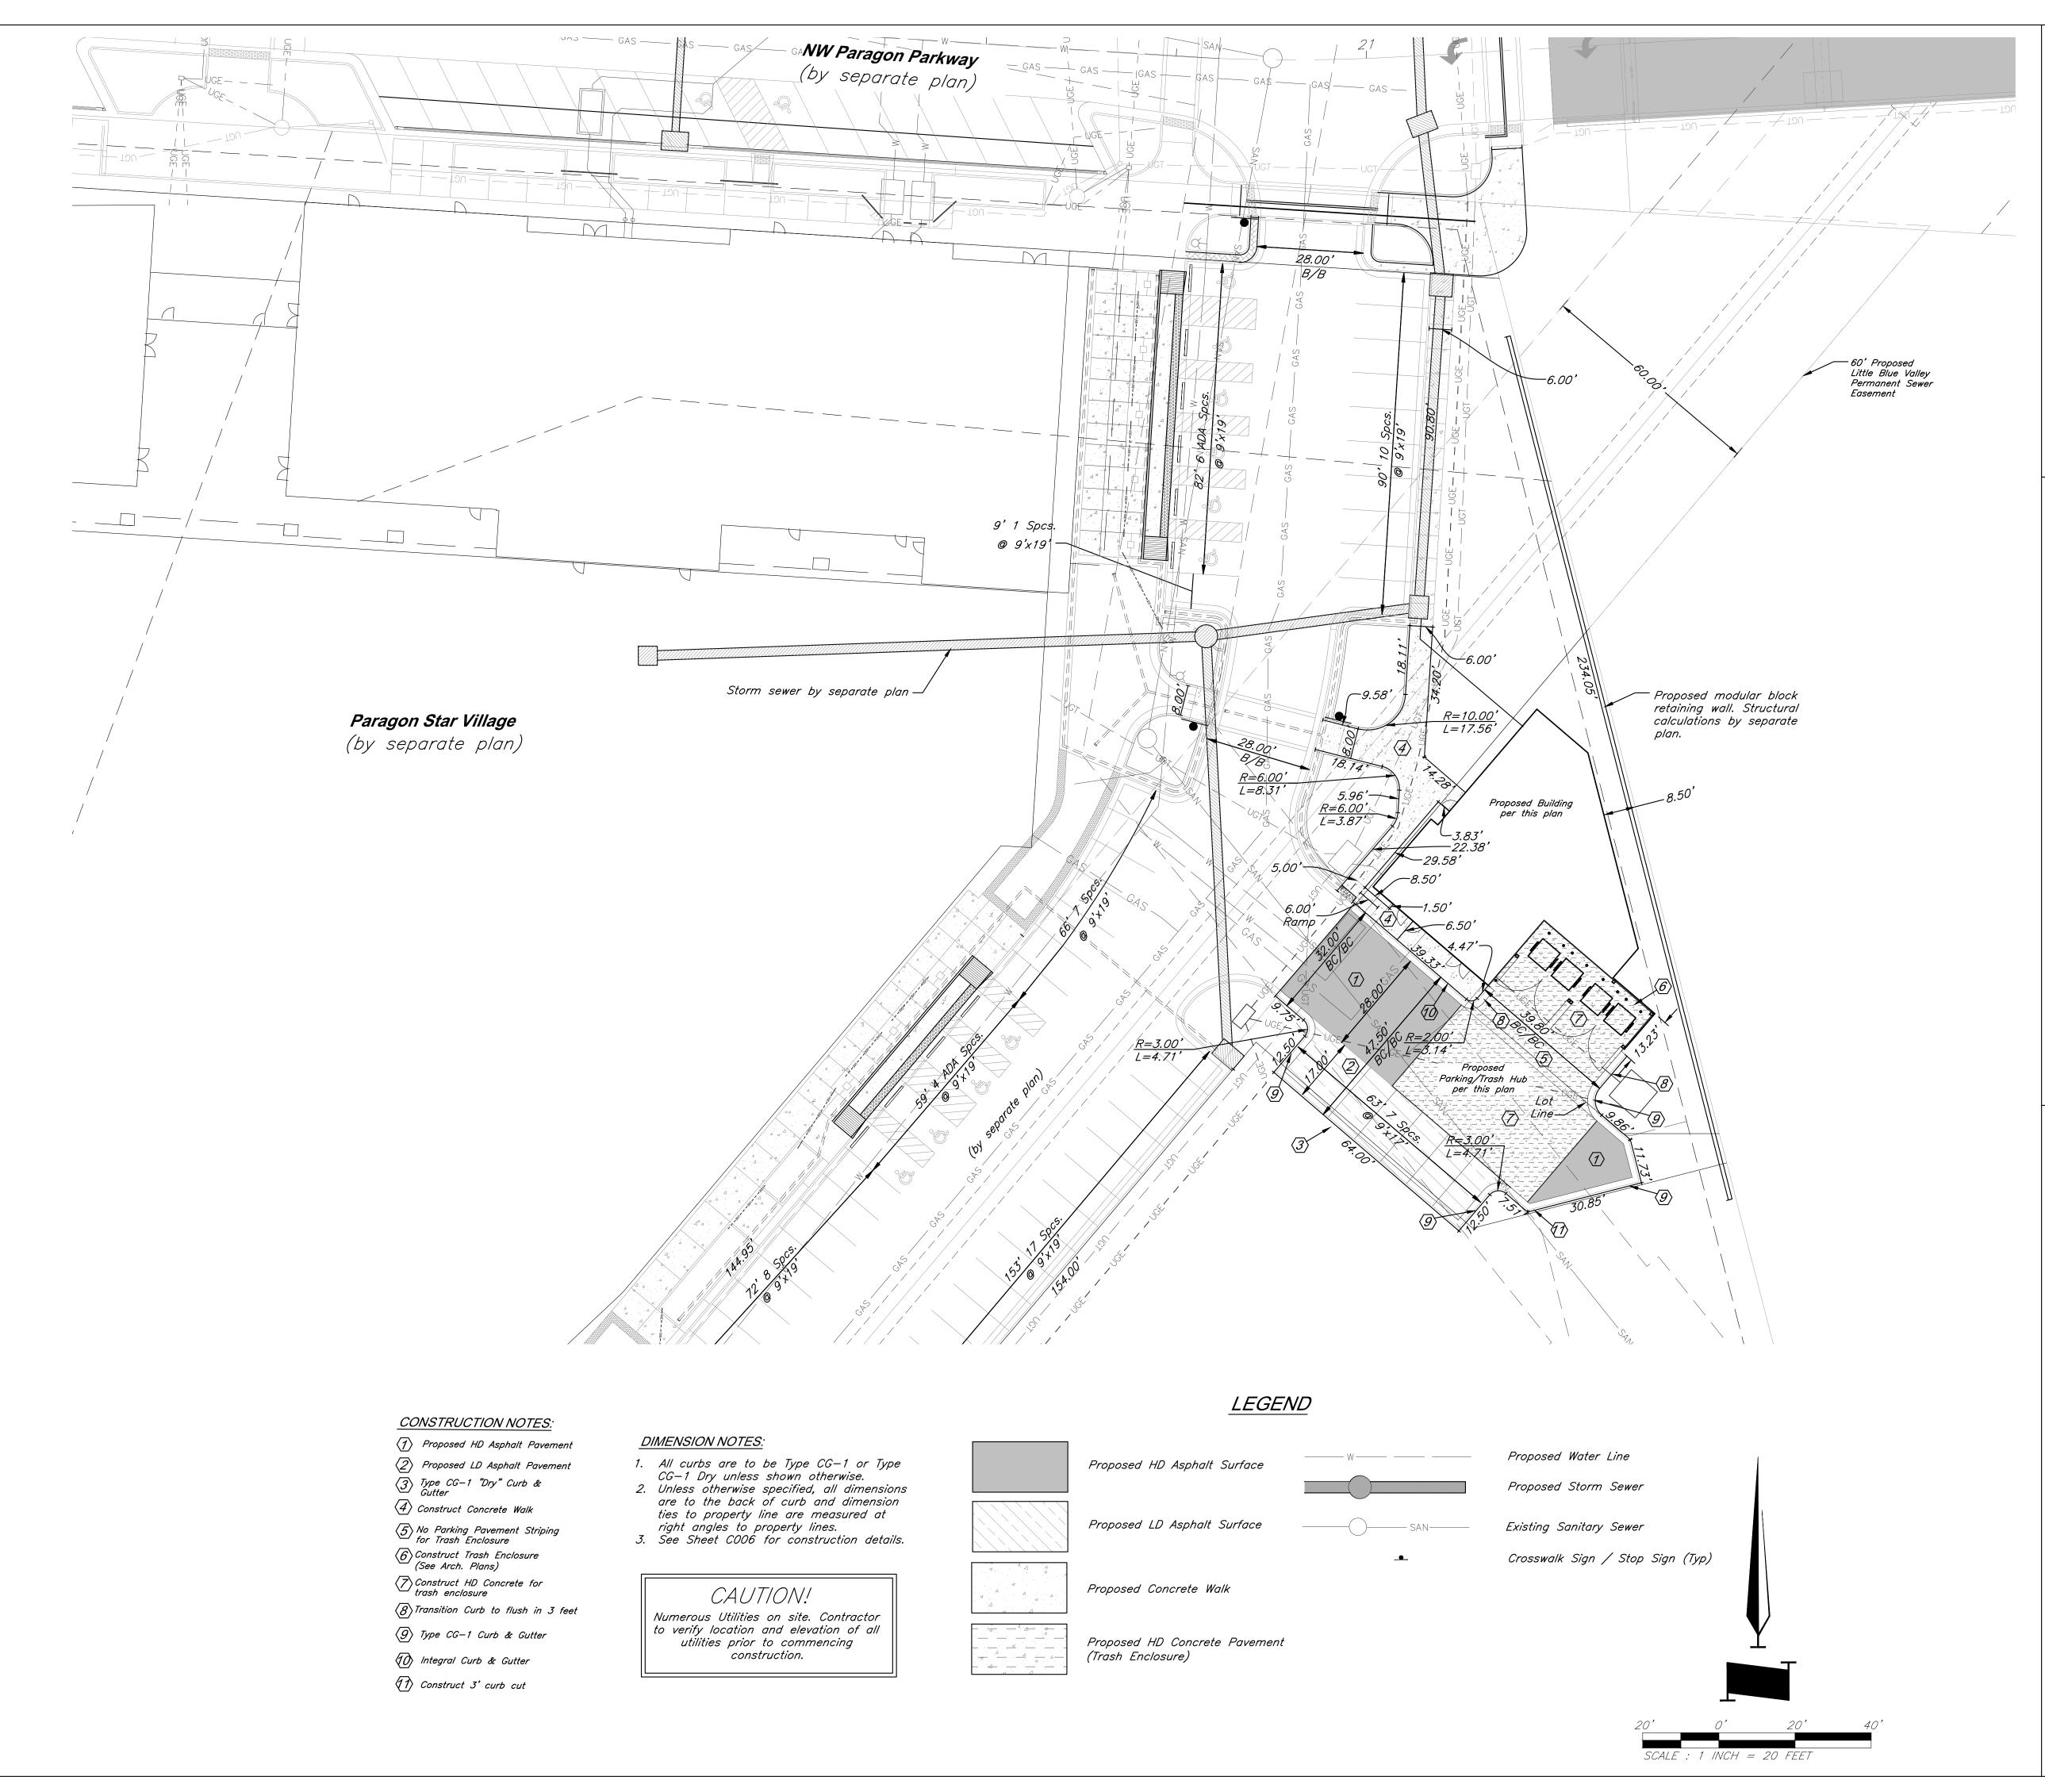

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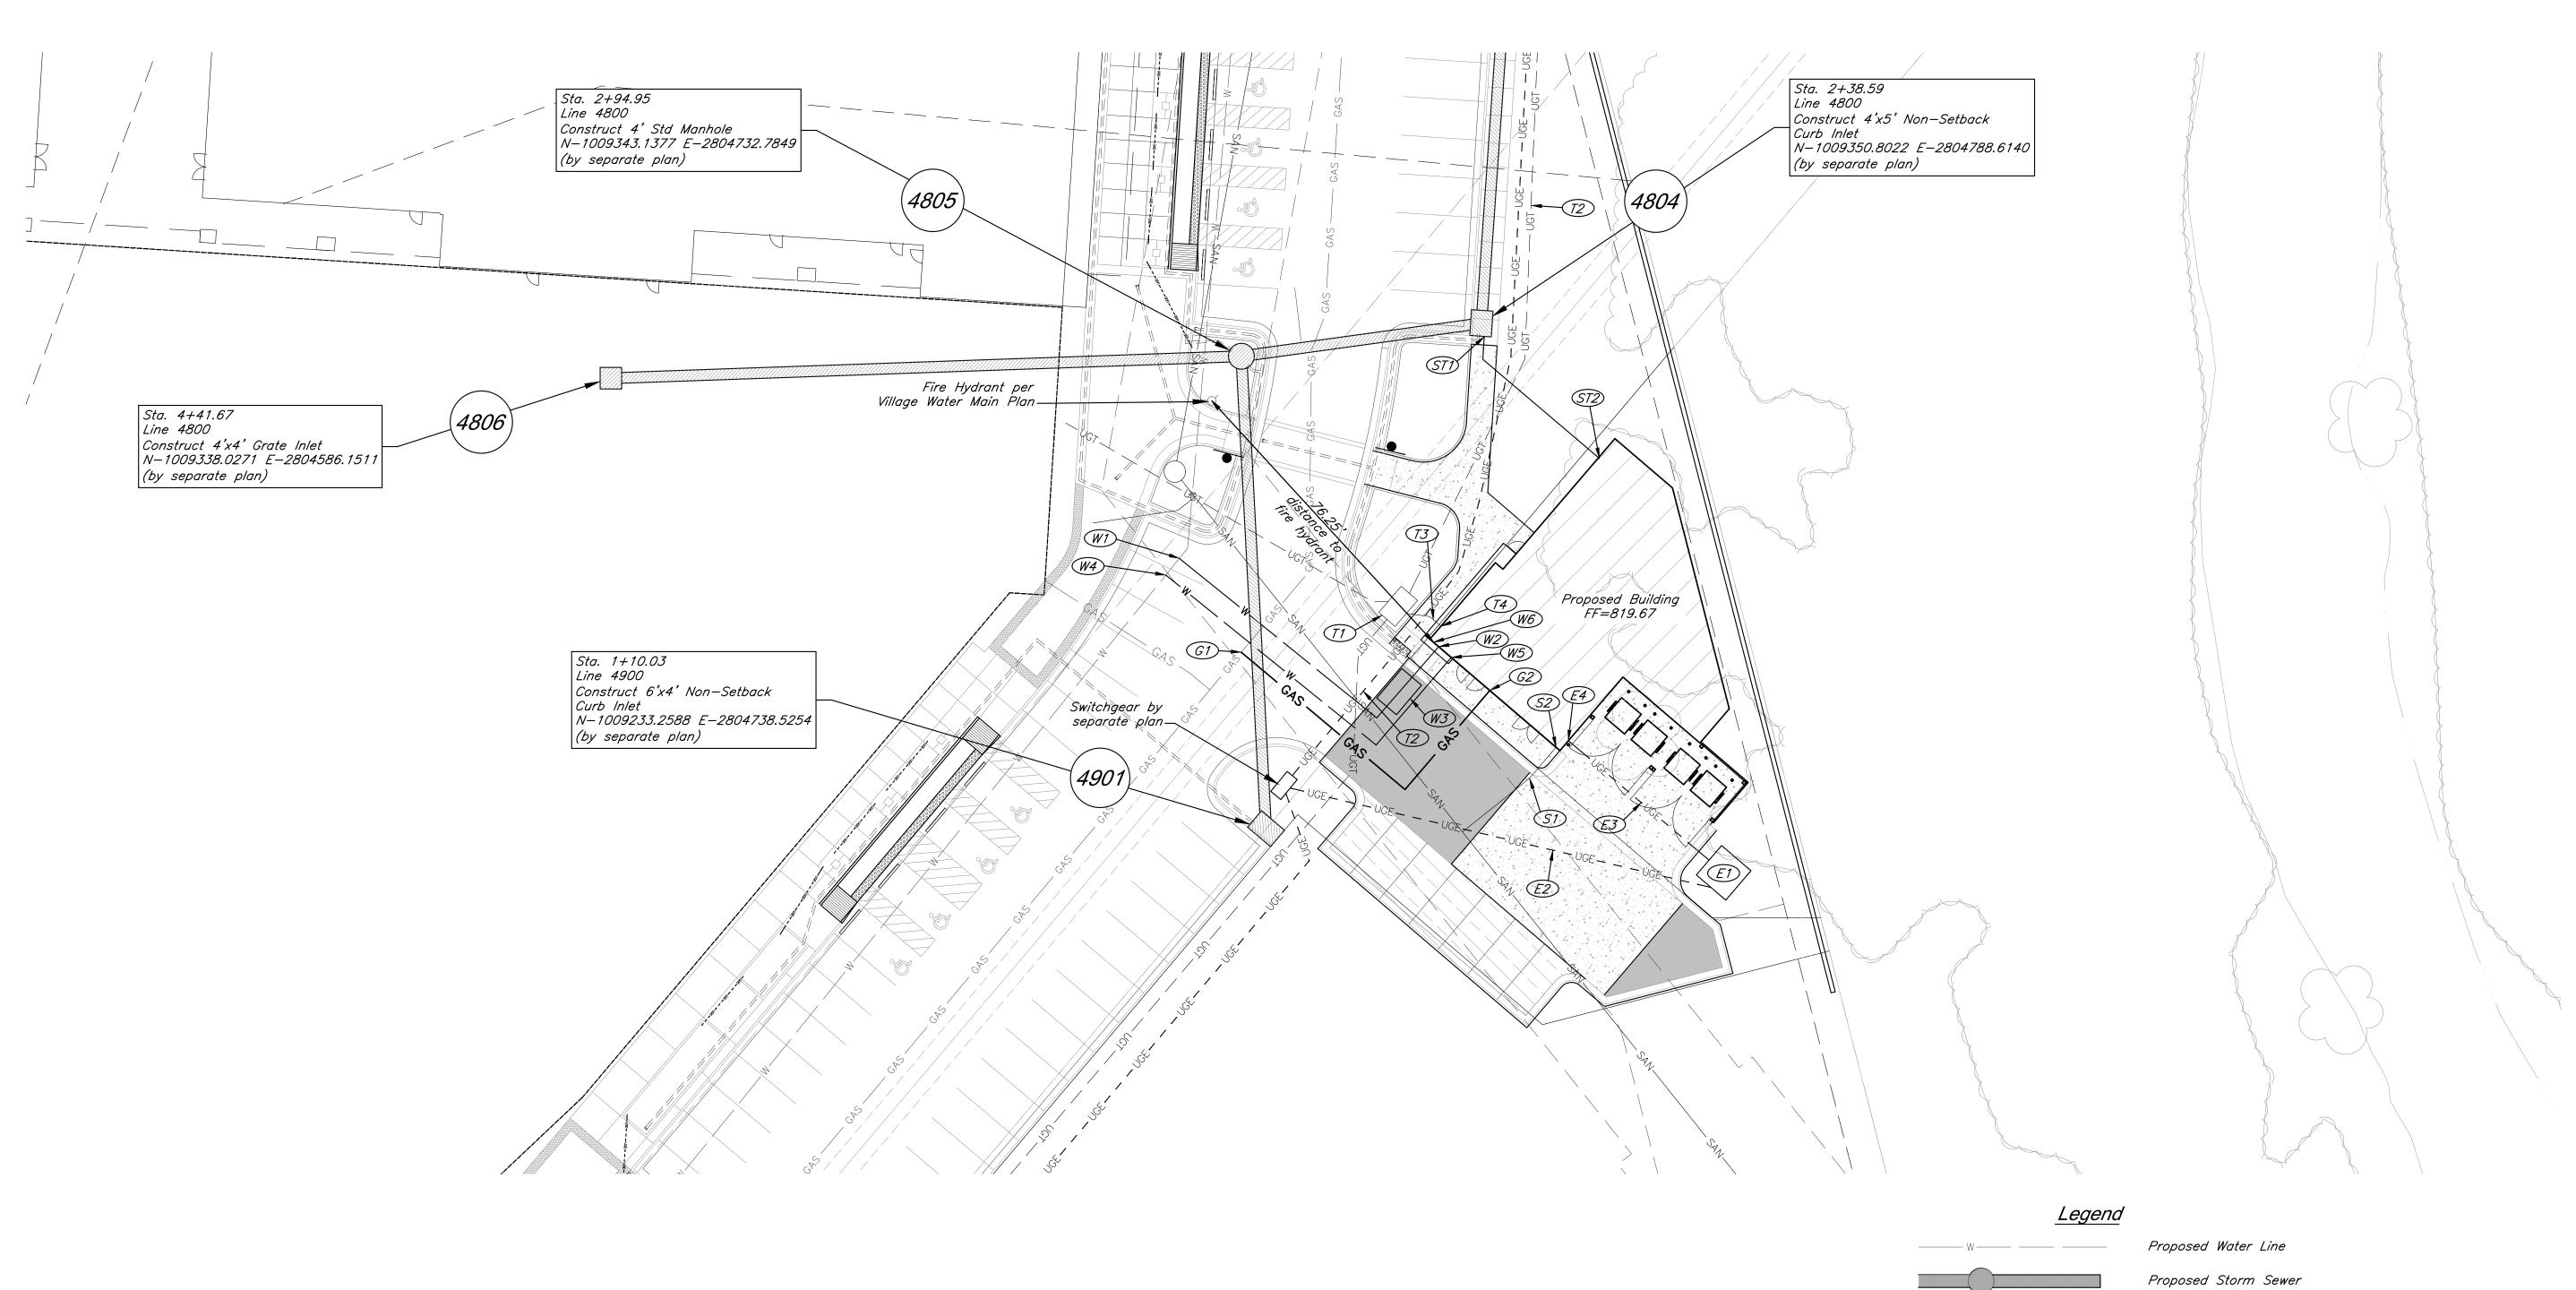
1401



DRAWING TITLE:

Dimension Plan

SCALE: JOB NO: 1249 DATE: 03.31.2021 DRAWN BY: JRH



Telecom Construction Notes

- 71) 11.5'x9.5'x7.5' Communication Vault by separate plan
- (72) Communication Line by separate plan
- 13 Install 12 LF Sch. 40 PVC Conduit to building stub T4
- 74 Communication building stub

Electrical Service Construction Notes

- E1) 9'x9' Transformer Pad per Evergy Standards
- E2 Install 100 LF 4" Sch. 40 PVC conduit from switchgear to transformer
- E3 Install 41 LF 4" Sch. 40 PVC conduit from transformer to building stub E4
- E4 Electrical service line building stub

Sanitary Sewer Construction Notes

- S1) Connect to existing sanitary sewer stub, [=809.95.] Install 9.47 LF 6" Dia. SDR26 PVC east at 2% to S2.
- S2 Connect to building stub, [=810.14

Water Line Construction Notes

- W1) Connect domestic water service line to existing 12" PVC water main via tapping sleeve with (2) 12" gate valves on the main and (1) 3" gate valve on the service line. Install 72 LF 3" Dia. C901 HDPE Domestic Water Service Line to building stub W2.
- W2) Connect domestic water service line to building
- W3) Install 3" Water Meter in vault per Lee's Summit Standards. Water meter sized per MEP plan. Vault to have 9" lid casting.
- W4) Connect fire protection water service line to existing 12" PVC water main via tapping sleeve with (2) 12" gate valves on the main and (1) 6" gate valve on the service line. Install 90 LF 6" Dia. C900 PVC Fire Protection Water Service Line to building stub W5.
- W5) Connect fire protection water service line to building
- W6) Approximate location Fire Department Connection

Gas Service Line Construction Notes

- (G1) Connect gas service line to gas main. Contractor to coordinate with spire energy. Install 80 LF 2.5" Dia. gas service line to building gas line stub.
- G2) Connect gas service line to building stub

Storm Sewer Construction Notes

- ST1) Connect 12" HDPE pipe to structure 4804 via core and grout, F_L =814.99. Install 42 LF 12" Dia. HDPE Pipe @ 2% to roof drain stub ST2.
- ST2) Connect 12" HDPE to roof drain building stub, $F_L = 815.83$

- 1. Pipe length called out is from center of structure to center of structure. Payment for pipe length is from inside face to inside face of structure.
- 2. Storm Sewer Structure Station offset and coordinates based on center of structure. Top elevations are top center of lid. 3. Tops on all in grade inlets shall maintain street
- slope, low point inlets to be set level. 4. Fire department connection locations are preliminary and subject to change upon final design. IFC distance requirements for FDCs shall be met with
- final design. 5. Water meter size is preliminary and subject to change upon final design. MEP plan shall govern meter sizing.

General Utility Notes


- 1. See Sheet COO6 for Construction Details.
- 2. Contractor to deflect conduits as necessary to avoid conflicts with other utilities.
- 3. Contractor shall coordinate with the Surveyor to leave trenches open for collecting survey data for record drawings.
- 4. Water line minimum burial depth shall be 42
- 5. Gas line to be constructed by Spire. 6. 3" Dia. HDPE water service line shall be AWWA C901 4710 DR11 PC200.
- 7. HDPE Storm sewer pipe shall be ADS N-12.




Paragon Star Village

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Proposed Sanitary Sewer

Construction Line for Paragon Parkway and Paragon Star Village

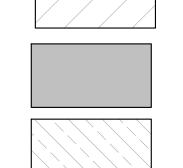Proposed Gas Line

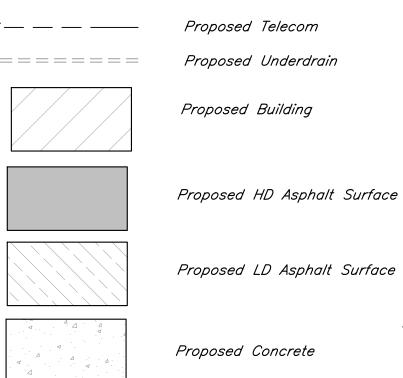Proposed Underground Electric

Proposed Telecom Proposed Underdrain

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PROJECT:


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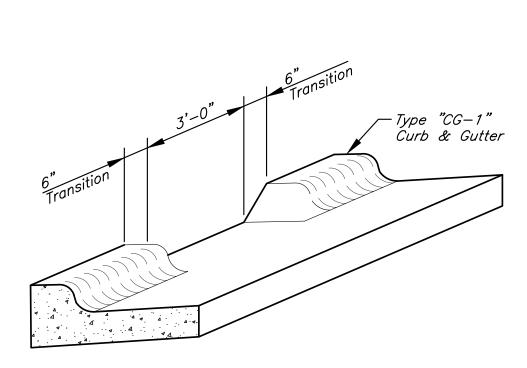
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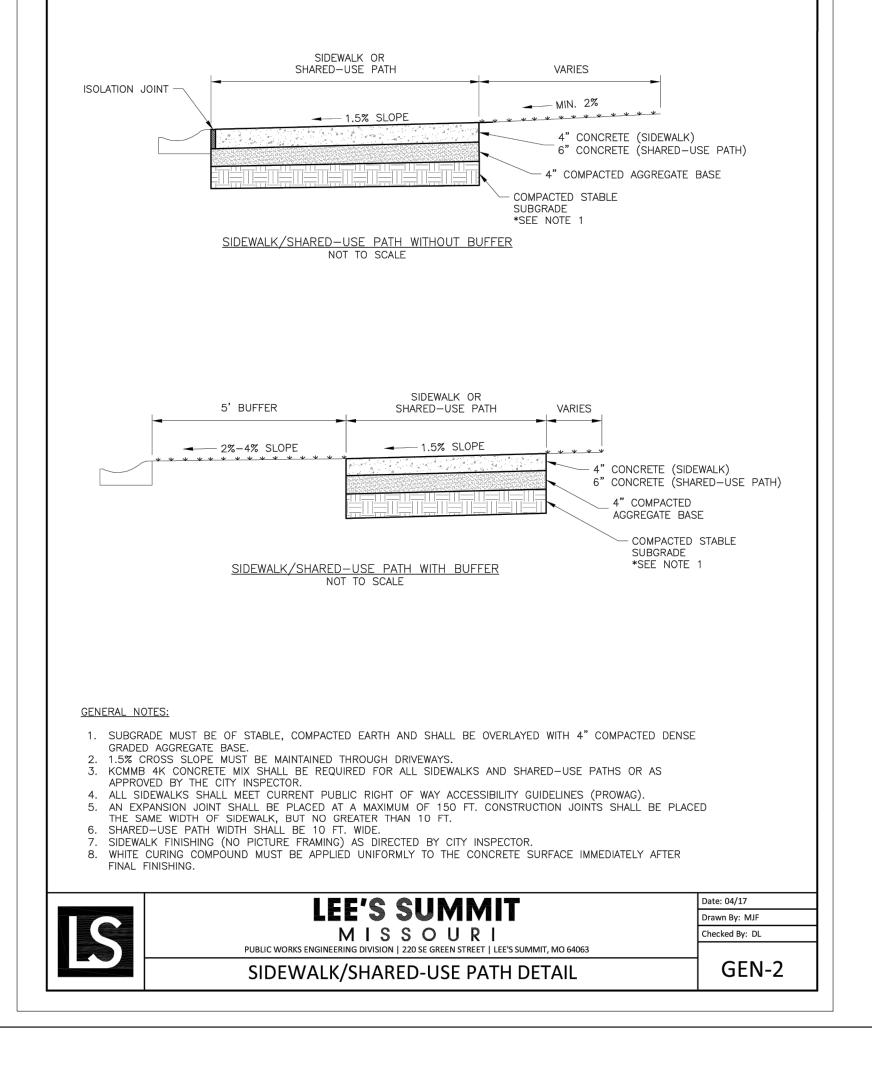
Utility Plan


JOB NO: 1249 SCALE: DATE: 03.31.2021 DRAWN BY: JRH






TYPICAL CURB CUT DETAIL Not To Scale

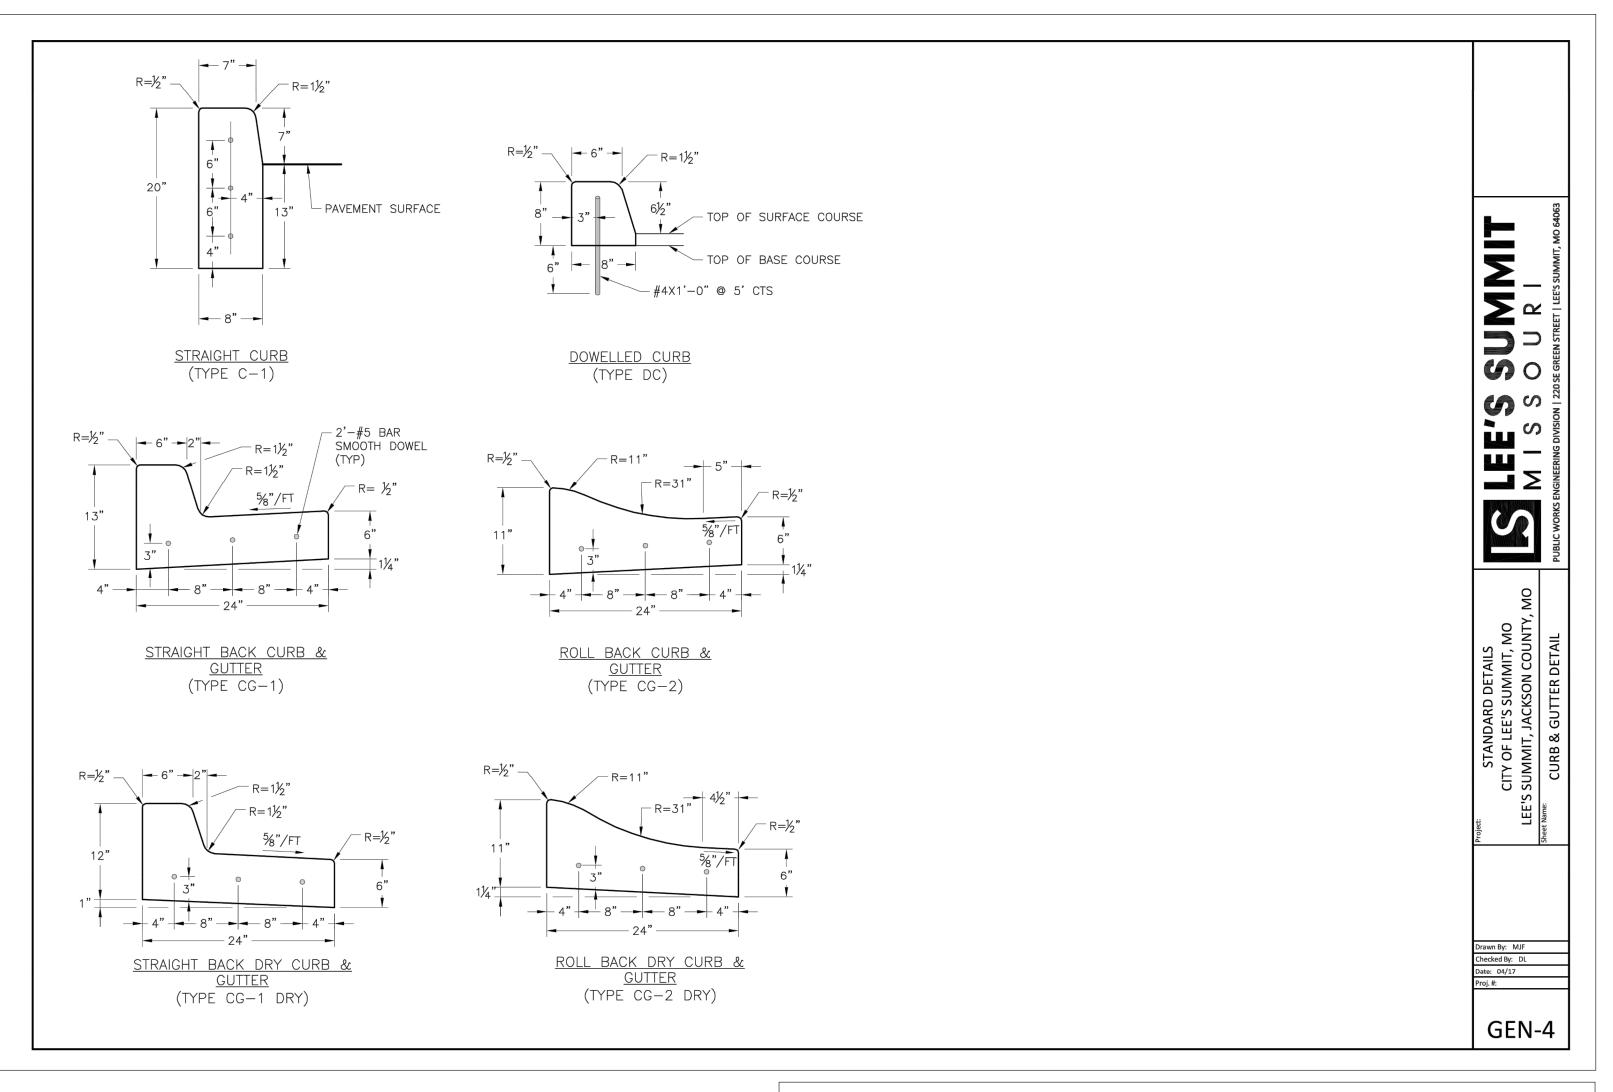


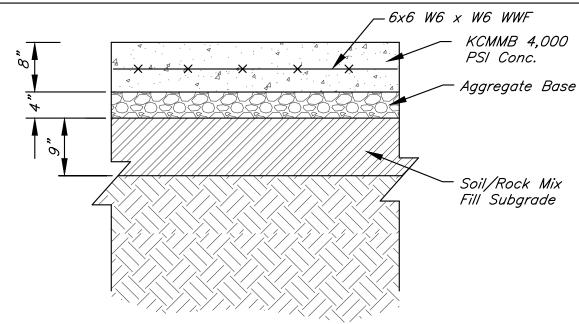

HEAVY DUTY CONCRETE PAVEMENT SECTION

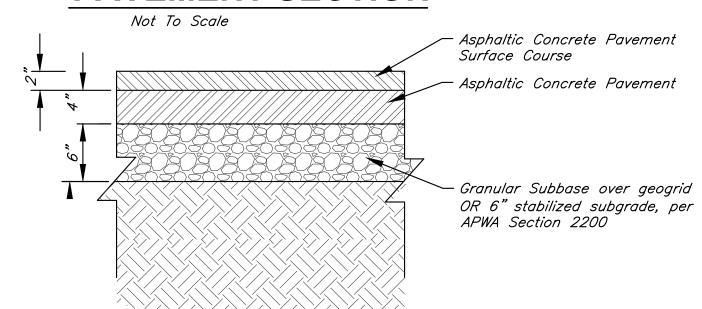


LIGHT DUTY ASPHALT PAVEMENT SECTION

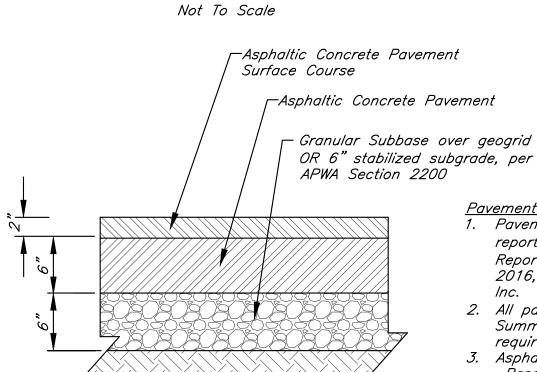

- <u>Pavement Notes:</u> 1. Pavement sections from geotechnical report title "Geotechnical Engineering Report - Soccer Fields", dated July 27, 2016, prepared by Terracon Consultants,
- 2. All pavement shall meet City of Lee's Summit UDO Section 8.620
- 3. Asphalt mix shall be APWA Base: 1-01, 2-01 or 5-01 Surface: 2-01, 3-01 or 5-01
- 4. Subgrade stabilization shall be per Lee's Summit Standard Specifications APWA Section 2200.

HEAVY DUTY ASPHALT PAVEMENT SECTION

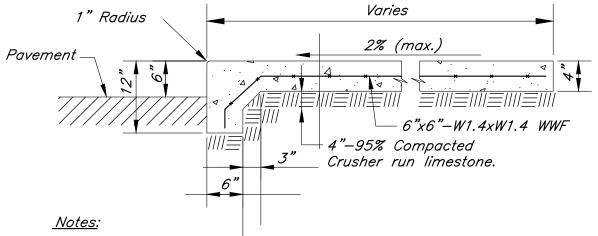

1. ³/4" Expansion Joints Placed at Radius Points and Structures with 2' Lengths of #5 Smooth Dowels. The Dowels will be Greased & Wrapped on Alternate Ends with Expansion Tubes.

- 2. $1-\frac{1}{2}$ " Deep Contraction Joints shall be placed at Approximately 15' Intervals.
- 3. Fix Dowels with Bar Chairs or Equal.
- 4. All concrete shall be KCMMB-4K.

INTEGRAL CONCRETE SIDEWALK/CURB Not to Scale

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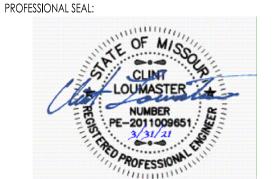
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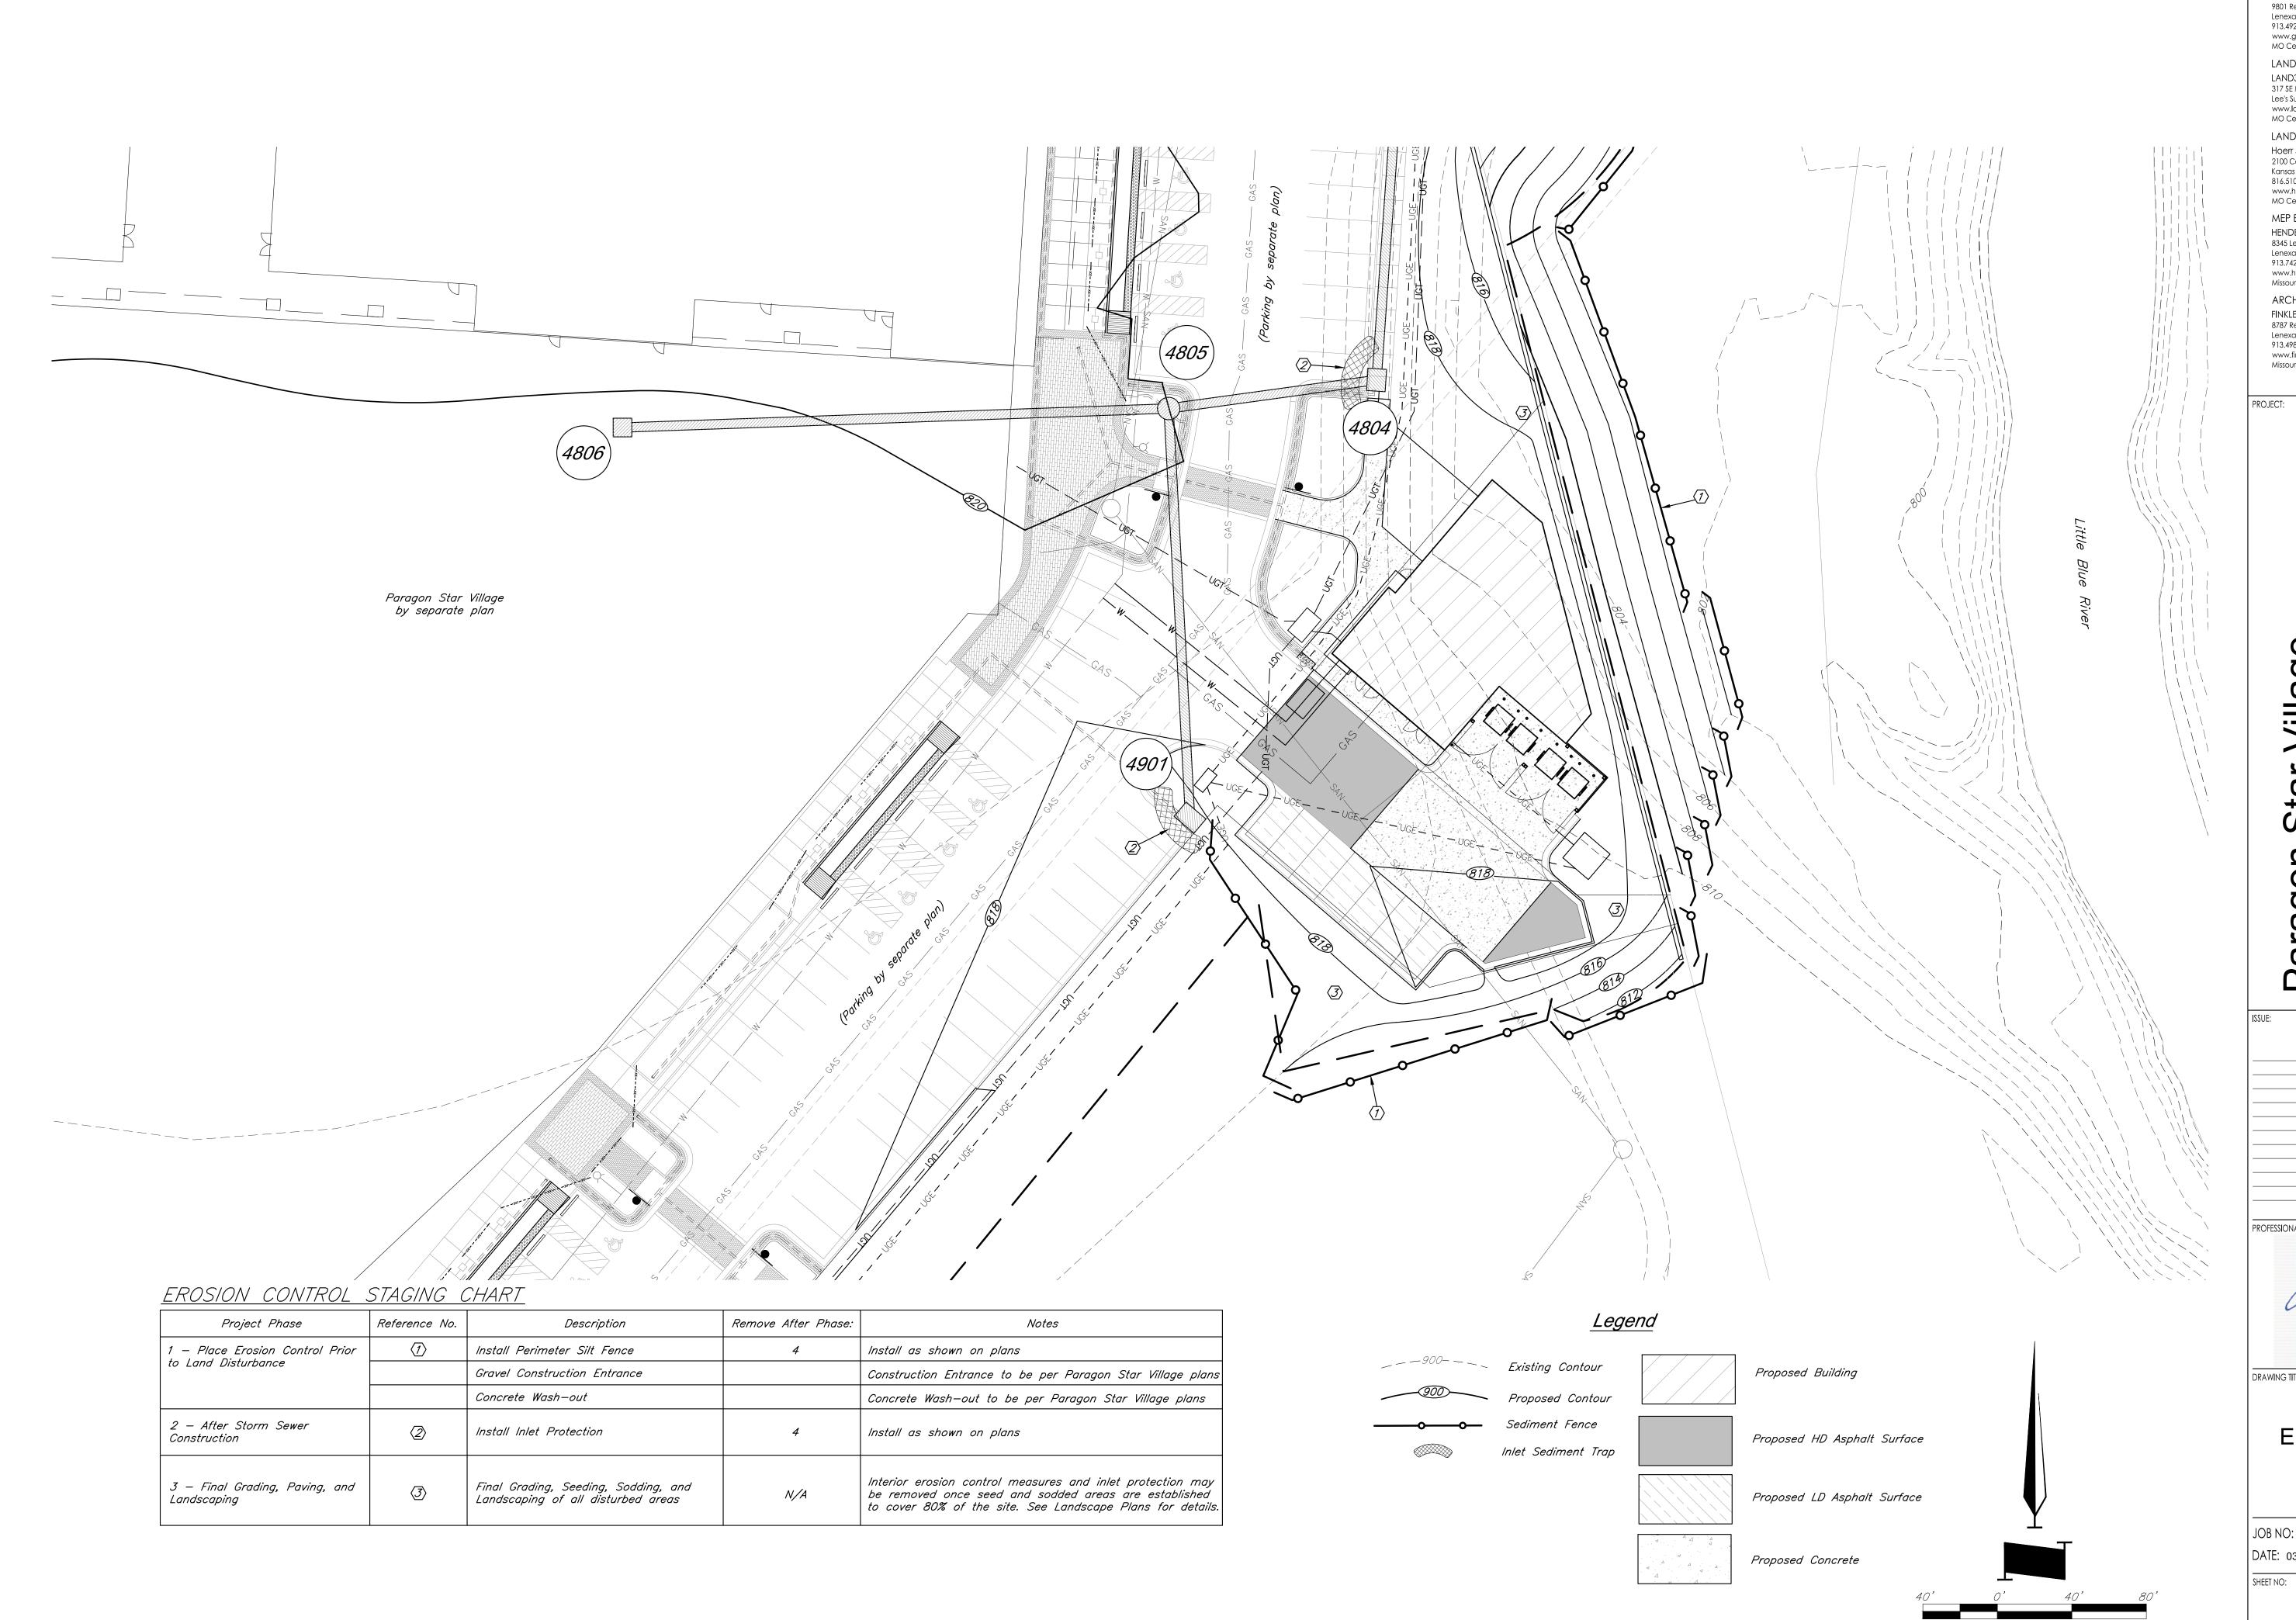
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DRAWING TITLE:

Construction Details

JOB NO: 1249 DATE: 03.31.2021 DRAWN BY: JRH



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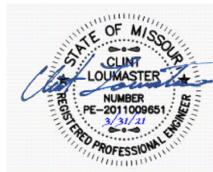
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aragon

Building

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PROFESSIONAL SEAL:



DRAWING TITLE:

Erosion Control Plan

JOB NO: 1249 SCALE: DATE: 03.31.2021 DRAWN BY: JRH

EROSION AND SEDIMENT CONTROL NOTES

The layout of erosion control best management practices (BMPs) shown on the engineering plans is intended to control erosion and minimize, if not eliminate, the transport of sediment from the disturbed areas. The Contractor shall be responsible for the evaluation of existing surface drainage patterns and for making adjustments to the BMP locations to best control erosion and minimize, if not eliminate, the transport of sediment from the disturbed areas. The following are measures to achieve the control of erosion and sediment.

- 1. Stabilization Practices Stabilization practices are very effective at preventing erosion by shielding the soil surface from the impact of rain, slowing the velocity of runoff, holding soils in place, and increasing infiltration of runoff and allowing the soil to absorb more rainfall.
 - a. Temporary Seeding Stabilization During acceptable growing periods (see Table 1 below); temporary seeding of annual vegetation with a straw mulch cover shall be used as a temporary cover until permanent vegetation is established. If there is a possibility that a vegetative cover will be required to control erosion for more than 1 year, then consider the addition of a perennial/permanent grass species as part of a seeding mixture.

Table 1. Temporary Seeding Dates and Minimum Application Rates

Seeding Dates	Temporary Seed Species	Minimum Application Rates (pure live seed lbs. per acre)	Straw Mulch (tons per acre)
Jan. 1 – Jan. 31	None	Not Applicable	2.5
Feb. 1 - May 31	Annual Ryegrass	<i>120</i>	1.5
June 1 - Aug.4	None	Not Applicable	2.5
Aug. 15 - Nov. 15	Cereal/Winter Rye	120	1.5
Nov. 16 - Dec. 31	None	Not Applicable	2.5

Seedbed Preparation — For broadcast seeding or drilling, loosen soil to depth of 3 inches. For no till drilling, loosen soil if it is compacted. Loosen compacted, hard or crusted soil surfaces with a disk, ripper, chisel, harrow or other tillage equipment. Avoid preparing the seedbed under excessively wet conditions. For establishment and long—term growth, apply a complete fertilizer at rates recommended by soil tests or as specified in plans and specifications. If soil pH is less than 6.0, apply lime according to soil tests. Incorporate necessary lime and fertilizer to a depth of 3 to 6 inches of soil.

Installation — For the best results use certified seed. Apply seed uniformly using a cyclone seeder, drop—type spreader, drill, cultipacker seeder or hydroseeder. When using a drill seeder, plant rye or other grains about 1 inch deep and plant grasses no more than ½ inch. A vegetative straw mulch cover shall be applied over the seed mixture to help germinate and establish plant cover, control weeds, and protect seed mixture against temperature extremes. Follow straw mulch preparation and application procedures described herein.

b. Temporary Mulch Stabilization — During non-growing periods, a straw mulch cover shall be applied in unseeded areas to protect against erosion until temporary or permanent vegetation is established.

Site Preparation — Divert runoff water from areas above the site that will be mulched. Remove stumps, roots and other debris from the construction area. Grade area as needed to permit the use of equipment for seeding,

mulching and maintenance. Shape area so that it is relatively smooth.

Application — Spread straw mulch uniformly over the area with a power blower, hydroseeder, or by hand. No more than 25% of the ground surface should be visible after spreading. Apply straw mulch at a rate of 1.5 tons per acre as a seed cover or 2.5 tons per acre as a stand alone cover. The straw should be dry, unchopped, unweathered; free of weed seeds and rot. In areas of steep slopes or high winds, or in critical areas such as swales, mulching may need to be secured to the ground with a binder, netting, or tacking.

c. Permanent Seeding Stabilization — All disturbed areas shall be permanently seeded with a cool season grass mixture as specified in the Standards and Specifications of the City of Lee's Summit, Missouri..

Seedbed Preparation — loosen soil to depth of 3 inches. For no till drilling, loosen soil if it is compacted. Loosen compacted, hard or crusted soil surfaces with a disk, ripper, chisel, harrow or other tillage equipment. Avoid preparing the seedbed under excessively wet conditions. For establishment and long—term growth, apply a complete fertilizer at rates recommended by soil tests or as specified in plans and specifications. If soil pH is less than 6.0, apply lime according to soil tests. Incorporate necessary lime and fertilizer to a depth of 3 to 6 inches of soil.

Installation — For the best results use certified seed. Apply seed uniformly using a hydroseeder. A vegetative straw mulch cover shall be applied over the seed mixture to help germinate and establish plant cover, control weeds, and protect seed mixture against temperature extremes. Follow straw mulch preparation and application procedures described in the Standards and Specifications of the City of Lee's Summit, Missouri.

2. Structural Practices

a. Silt Fence — A temporary sediment barrier consisting of a geotextile fabric shall be installed as shown on the attached engineering plans and details. Silt fencing shall be installed to maintain sediment onsite.

Minimum Requirements:

Location — Fence should be built on a nearly level grade and at least 10 feet from the toe of the slope to provide a broad shallow sediment pool. Install on the contour, where fence can intercept runoff as a sheet flow; not located crossing channels, waterways or other concentrated flow paths; not attached to existing trees.

Spacing of Support Posts — 10 feet maximum for fence supported by wire; 6 feet maximum for high strength fabric without supportive wire backing. Support posts should be driven into the ground a minimum of 10 inches deep.

Trench — Bottom 1 foot of fence must be buried minimum of 4 inches deep.

- b. Inlet Protection When installation of the storm drainage system is complete, gravel curb inlet sediment traps will be placed at the drainage system inlets. Construction shall be in accordance with attached engineering plans and details.
- c. Stockpiles The toe of stockpiles shall be placed a minimum of 10 feet from erosion control measures.

 If stockpiles are to remain for more than 14 days, they shall be temporarily stabilized with vegetative mulch and temporary seeding.
- 3. Maintenance The contractor shall repair all erosion control measures or re—seed areas that are disturbed or damaged as a result of weather or other situations, within 2 days after the occurrence. This will include all areas bare of vegetation.

EROSION CONTROL GENERAL NOTES

- 1. The Contractor is responsible for erosion control during construction and until the
 Owner and City accepts the work as complete. The erosion control measures shown on this plan are a
 typical minimum installation. The Contractor shall be responsible for adjusting or adding to these
 measures as necessary during the phasing of the construction to assure adequate control.
- 2. Clearing and grubbing within 50' of a defined drainage course should be avoided when possible. Where changes to a defined drainage course occur, work should be delayed until all materials and equipment necessary to protect and complete the drainage change are on site. Changes shall be completed as quickly as possible once the work has been initiated. The area impacted by the construction activities shall be revegetated or protected from erosion as soon as possible, areas within 50' of a defined drainage ways should be recontoured as needed or otherwise protected within five (5) working days after grading has ceased.
- 3. Where soil disturbing activities cease in an area for more than 14 days, the disturbed areas shall be protected from erosion by stabilizing the area with mulch or other similarly effective erosion control measures. If the slope of the area is greater than 3:1 or if the slope is greater than 3% and greater than 150 feet in length, then the disturbed areas shall be protected from erosion by stabilizing the area with mulch or other similarly effective erosion control measures if activities cease for more than seven (7) days.
- 4. Existing vegetation shall be preserved to the extent and where practical. In no case shall disturbed areas remain without vegetative ground cover for a period in excess of 60 days.
- 5. Additional site management practices which shall be adhered to during the construction process shall include:

—Solid and hazardous waste management including providing trash containers and regular site clean up for proper disposal of solid waste such as building and construction material, product/material shipping waste, food containers and cups, and providing containers for the proper disposal of waste paints solvents, and cleaning compounds.

-Provisions of portable toilets for proper disposal of sanitary sewage.

-Storage of construction materials away from drainage courses and low areas.

—Installation of containment berms and use of drip pans at petroleum product and liquid storage tanks and containers.

6. All disturbed areas shall be seeded, fertilized and mulched, or sodded, in accordance with the Standards and Specifications adopted by the City of Lee's Summit, Missouri and good engineering

practices. This shall be completed within fourteen (14) days after completing the work, in any area. If this is outside of the seeding period, silt barriers or other similarly effective measures shall be provided until such time that the areas can be seeded.

- 7. All erosion control measures, temporary or permanent, require maintenance to preserve their effectiveness. All erosion control devices shall be inspected immediately after each heavy rainstorm and at least daily during prolonged rainfall. Any required repairs should be made immediately. All costs associated with the repair work including related incidentals will be the contractor's responsibility and shall be included in the Contractor's bid for the proposed work. Only after the project is complete and accepted can the erosion control be removed.
- 8. Seeding shall be done before the proposed seedbed becomes eroded, crusted over, or dried out and shall not be done when the ground is frozen, or covered with snow. The seed shall comply with requirements of the Missouri Seed Law and the Federal Seed Act. Also, it shall contain no seed of any plant on the Federal Noxious Weed List. Other weed seed shall not exceed one percent by weight of mix.
- 9. During the dates Dec. 15 through May 30 ALL lime, fertilizer, seed, and mulch shall be applied to finished slopes of disturbed areas. During the months of June, July, October, and November 1st through December 15th, lime, fertilizer, seed, and mulch shall be applied at the following rates:

Lime – 100% of the specified quantity
Fertilizer – 75% of the specified quantity
Seed – 50% of the specified quantity
Mulch – 100% of the specified quantity

10. Mulch shall be Vegetative type, cereal straw form stalks of oats, rye, or barley, or approved equal. The straw shall be free of prohibited weed seed and relatively free of all other noxious and undesirable seed. Apply straw mulch at a rate of 1.5 tons per acre as a seed cover or 2.5 tons per acre as a stand alone cover. Mulch shall be embedded by a mulch anchoring tool or disk type roller having flat serrated disks spaced not more than 10 inches apart and cleaning scrapers shall be provided.

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PROJECT:

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Building

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NW View High Dr, Lee's Summit, MC

ISSUE:

PROFESSIONAL SEAL:



DRAWING TITLE:


Erosion Control Notes

JOB NO: 1249 SCALE:

DATE: 03.31.2021 DRAWN BY: JRH

SHEET NO:

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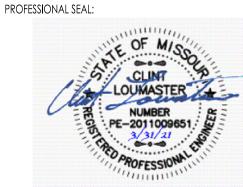
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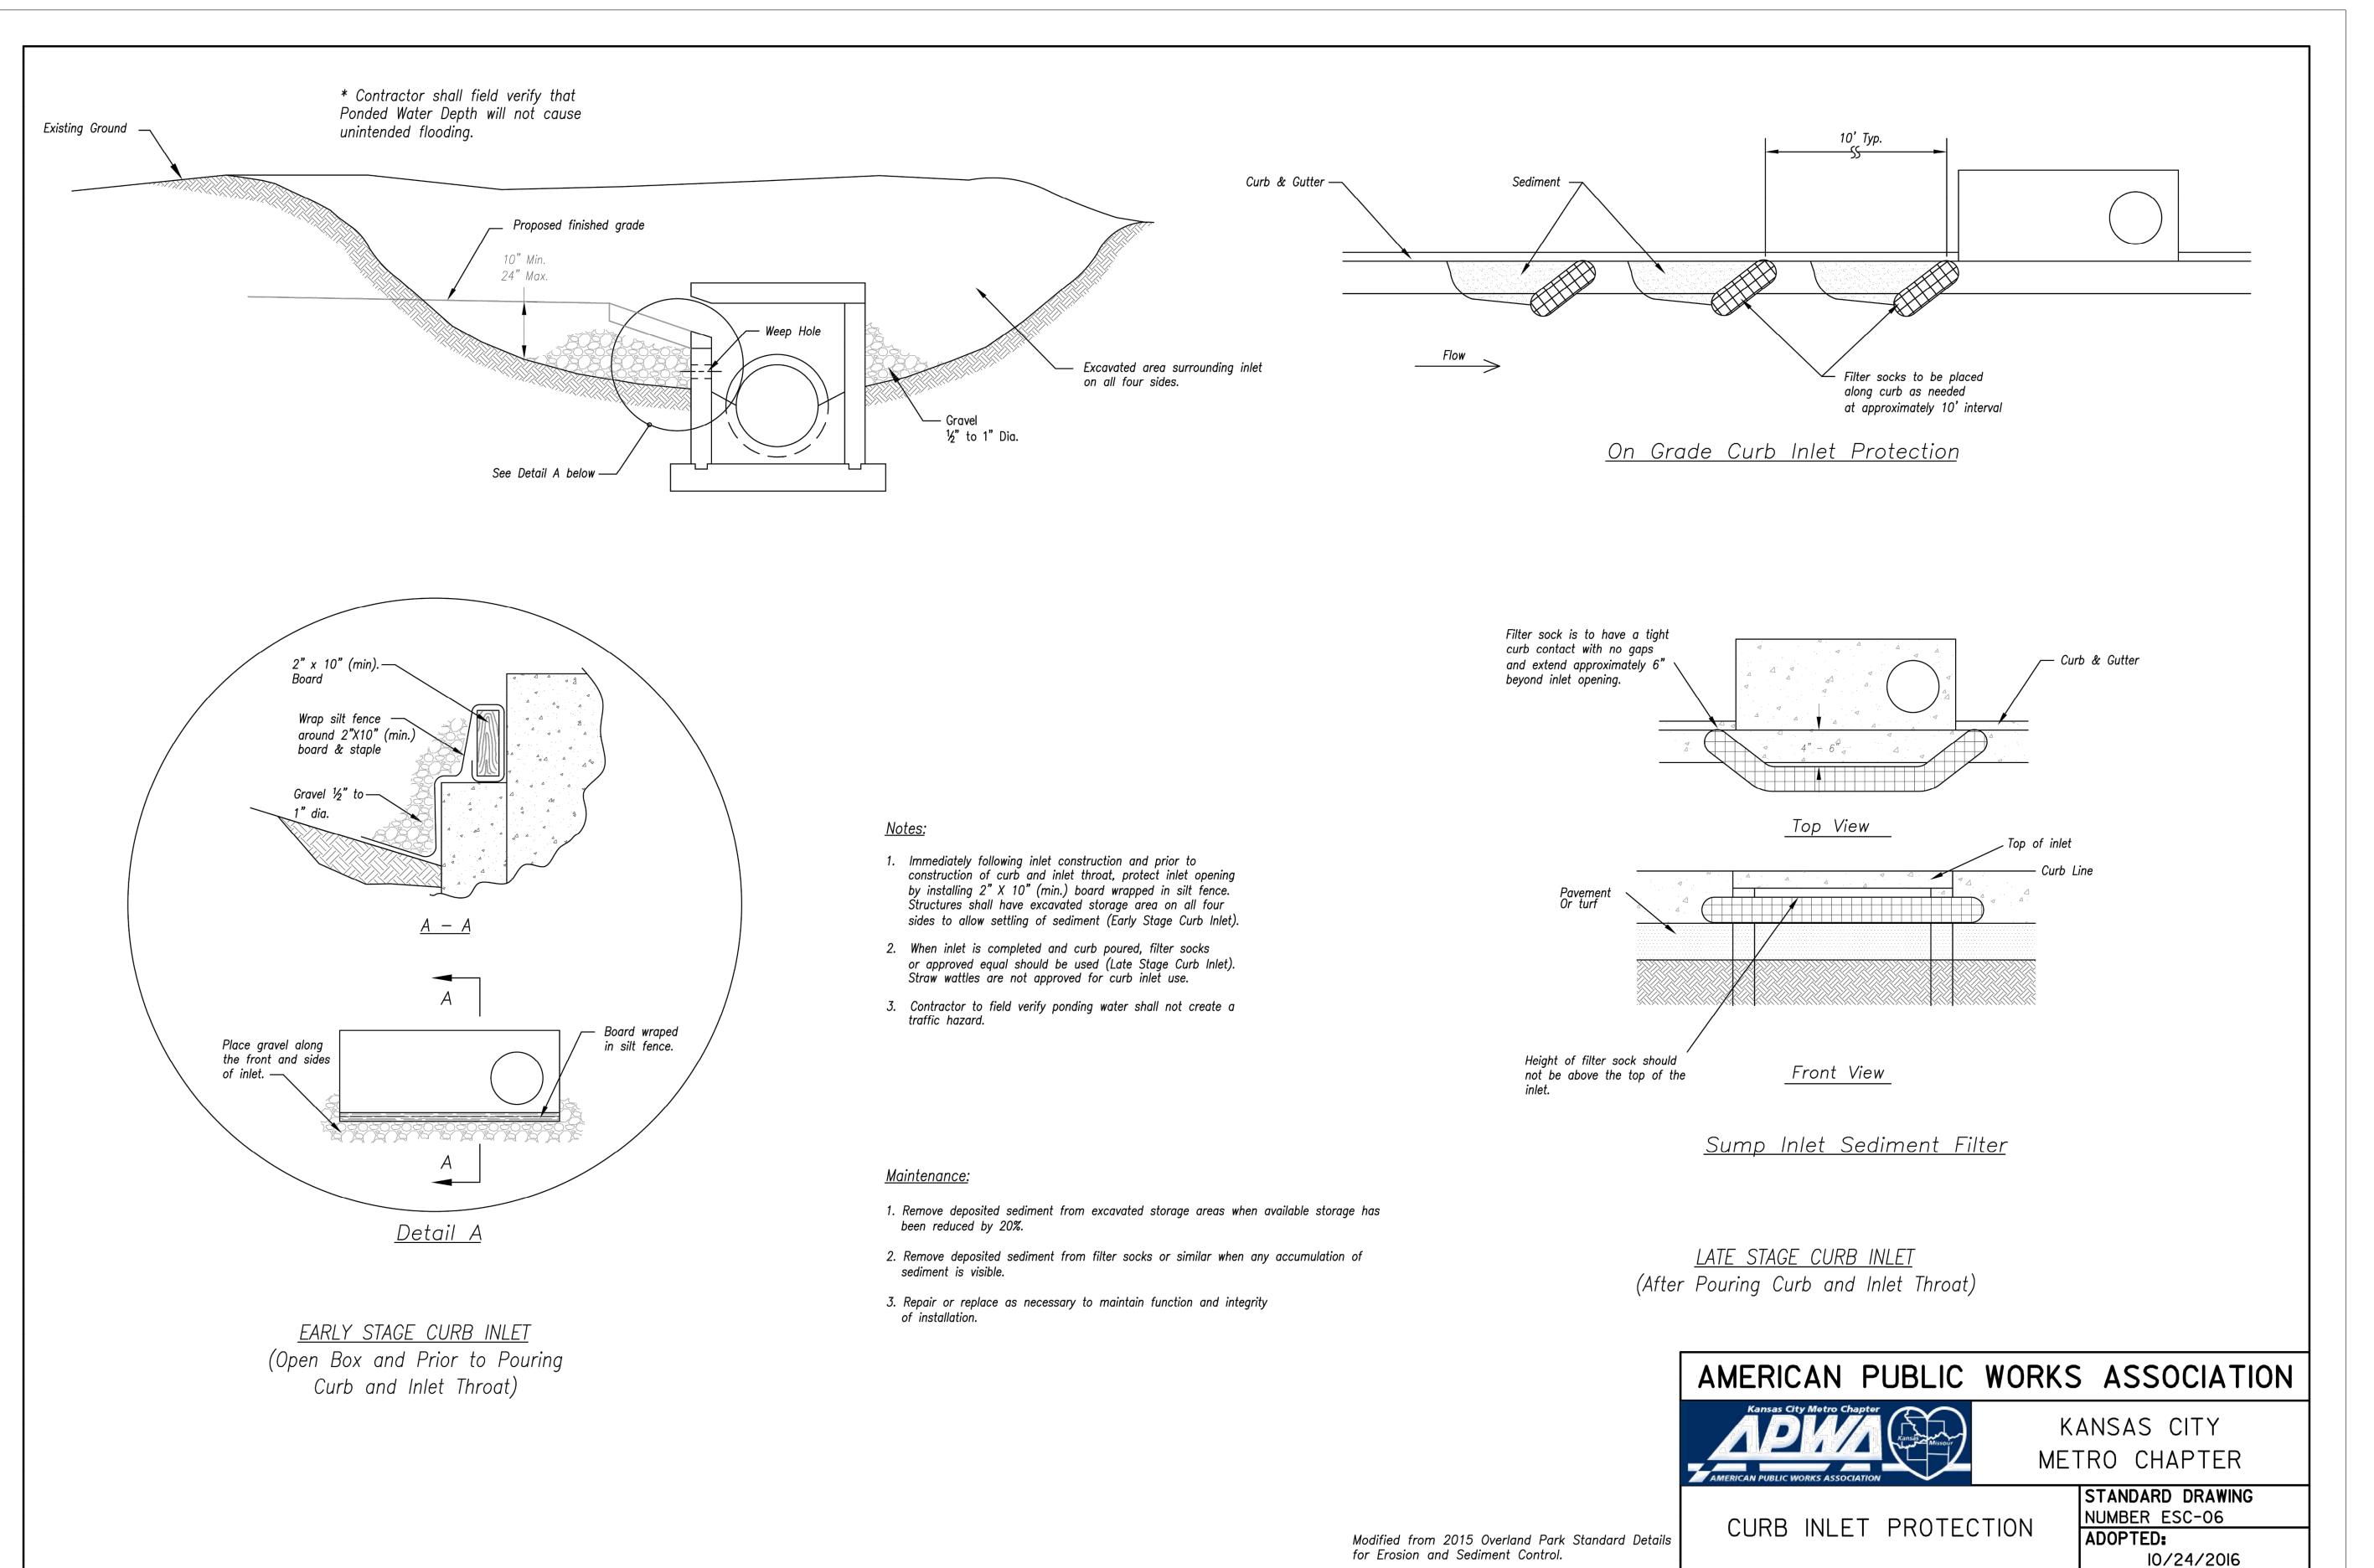
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DRAWING TITLE:

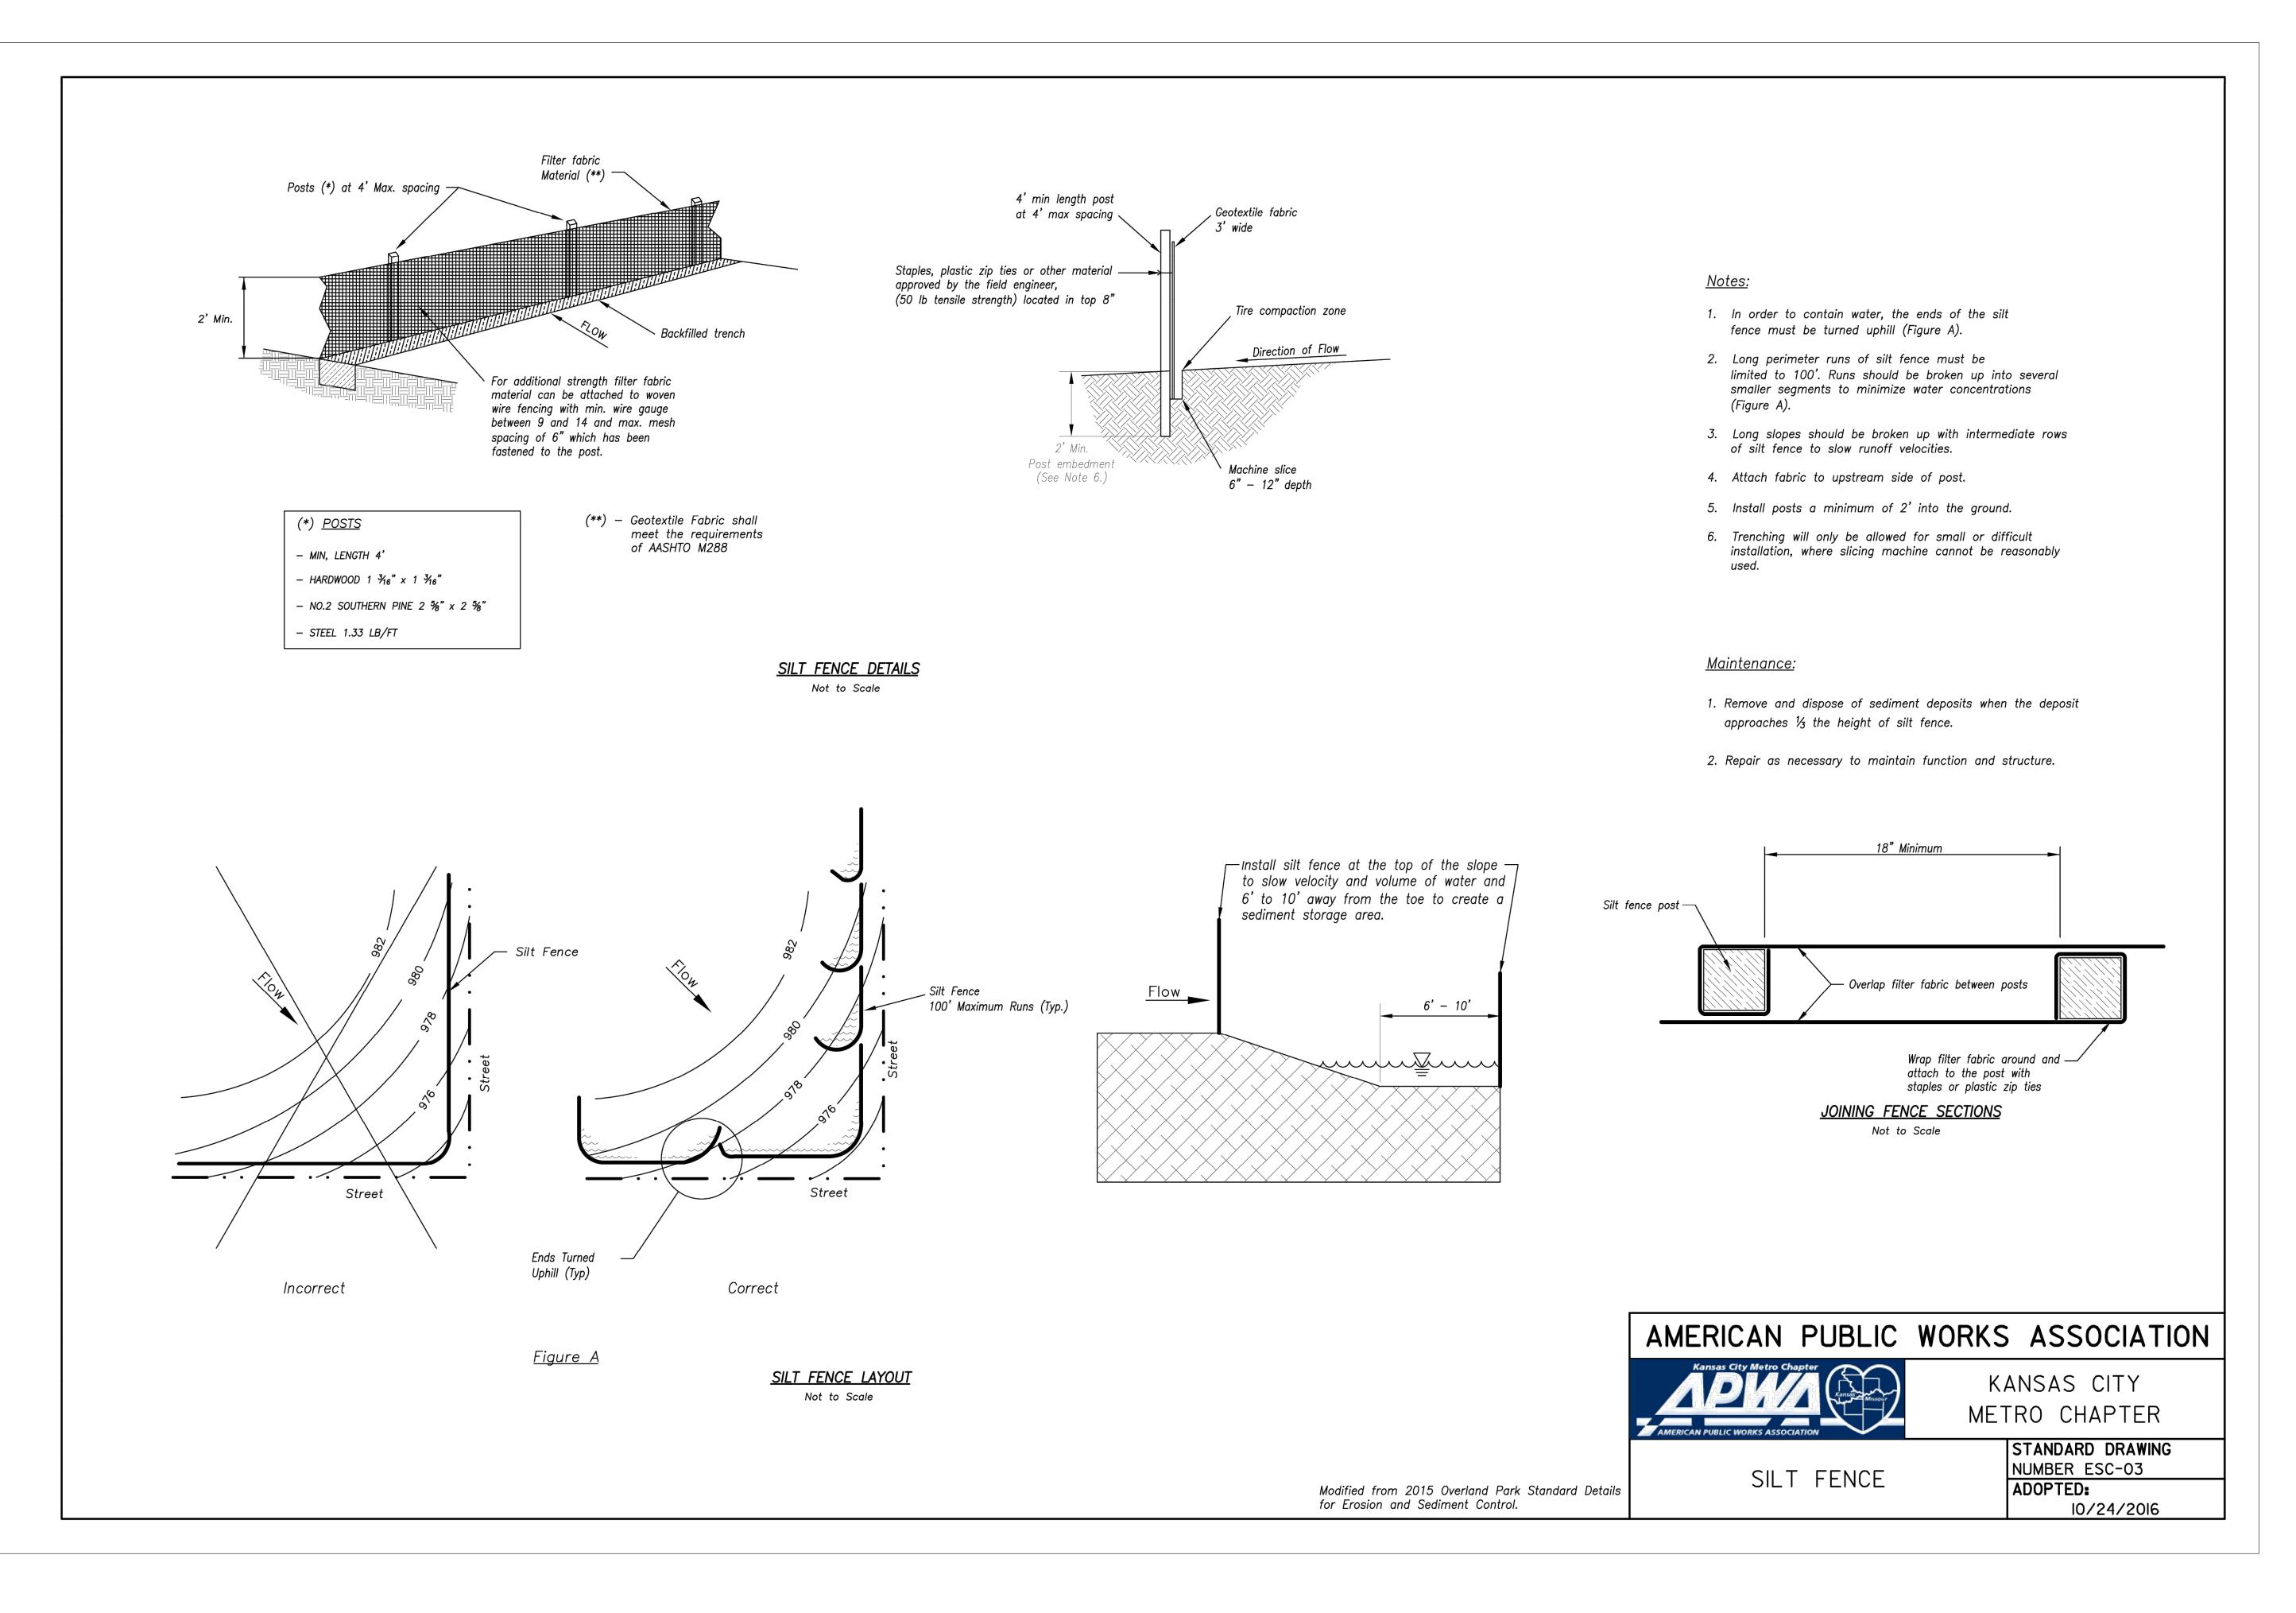Erosion Control Details

JOB NO: 1249 SCALE: DATE: 03.31.2021 DRAWN BY: JRH



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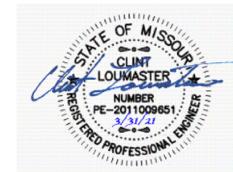
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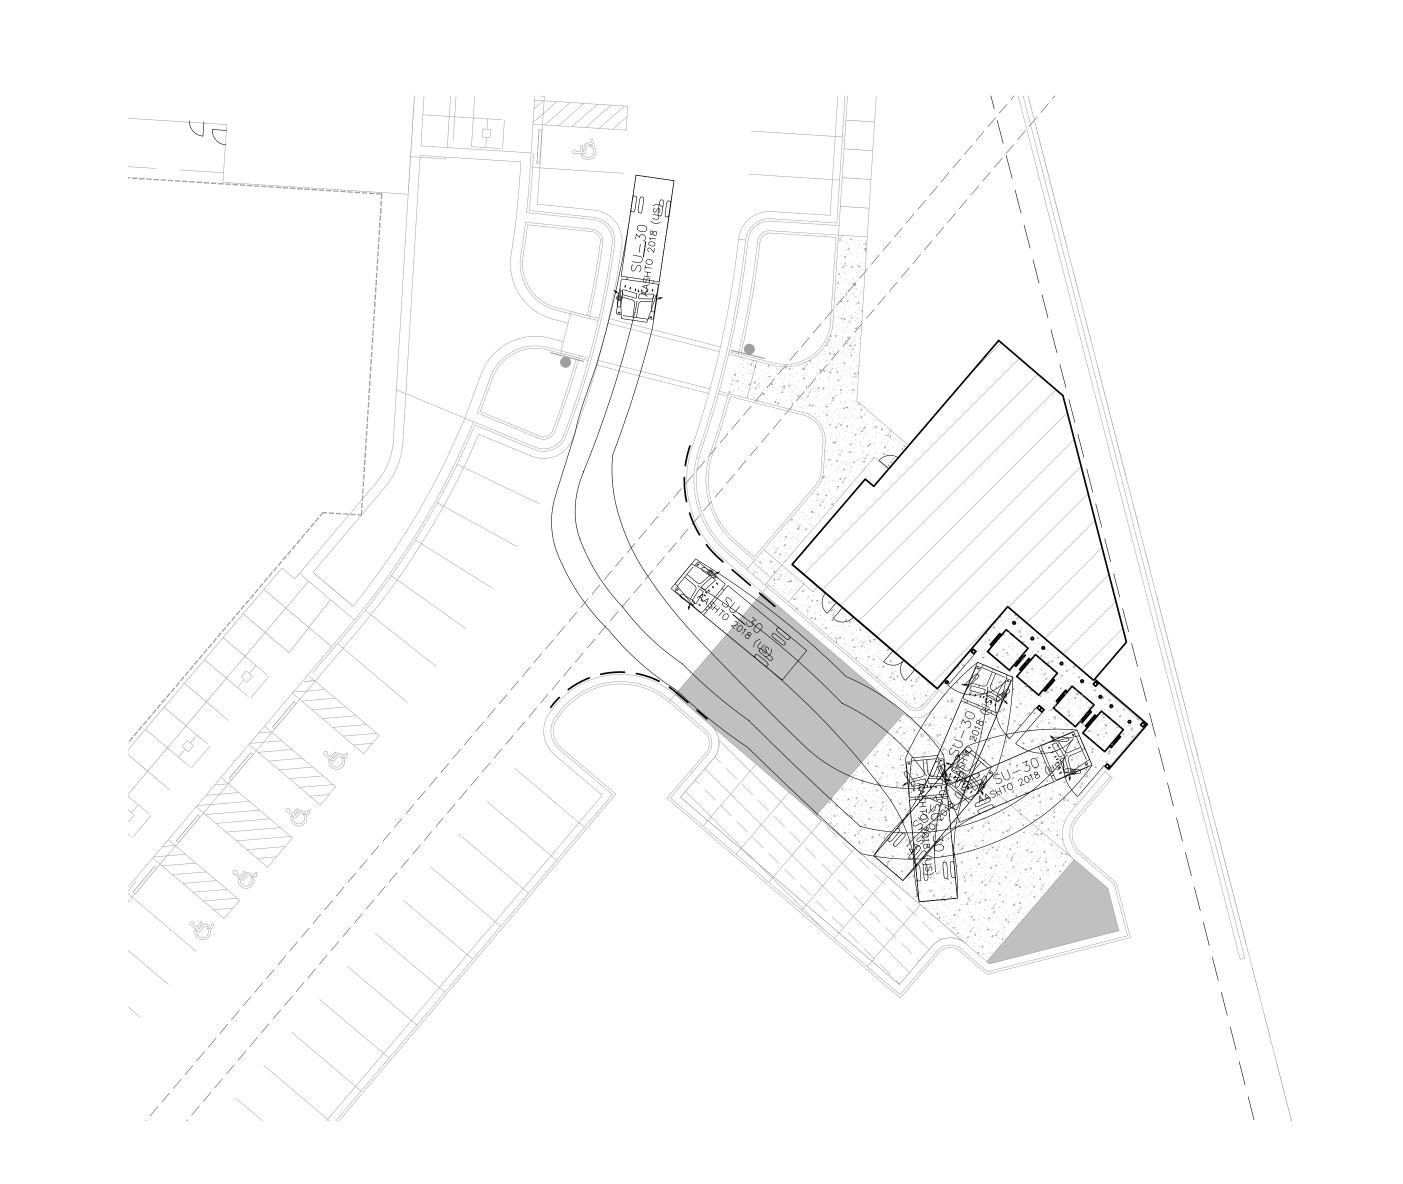
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Erosion Control Details


JOB NO: 1249 SCALE: DATE: 03.31.2021 DRAWN BY: JRH



<u>Legend</u>

— — — 2' offset from face of curb

Turning Movements using SU-30 Design Vehicle. Movements to a 2' clearance from tire track and curb.

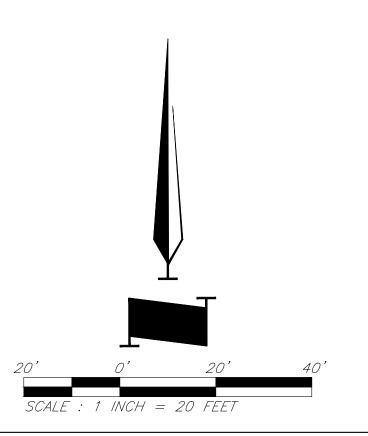

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PROJECT:

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Building

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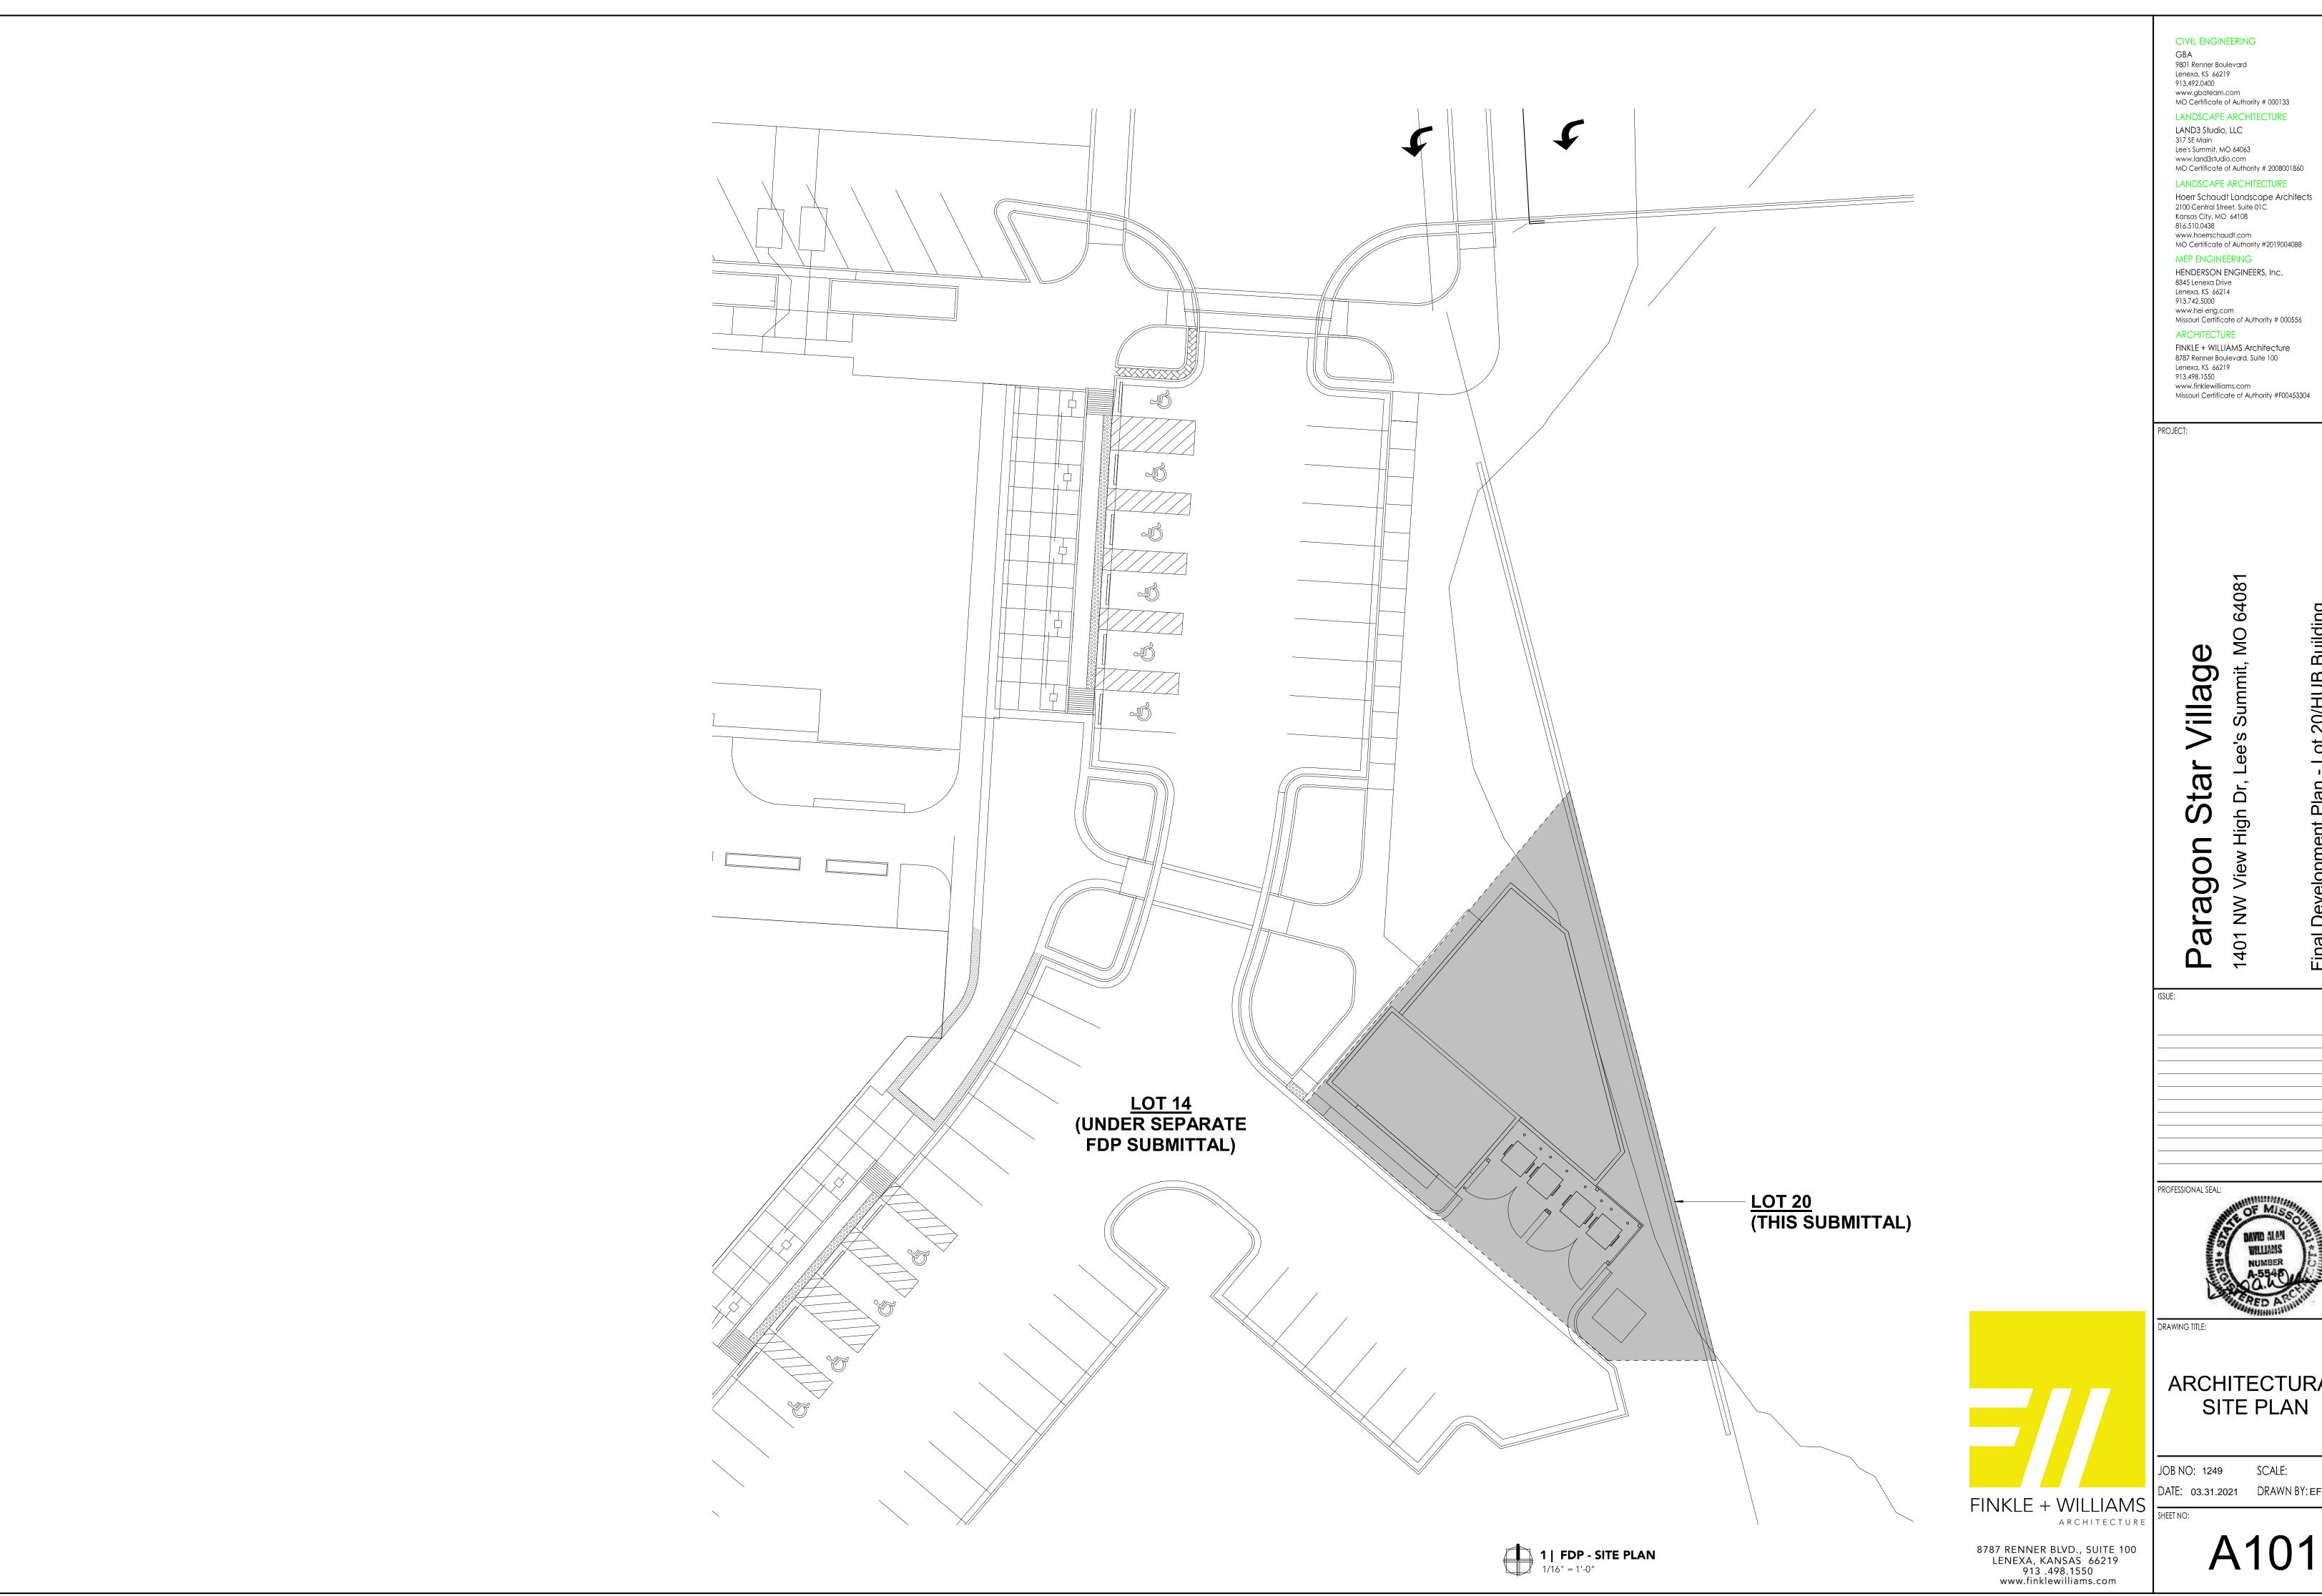
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Truck Turning Movement

JOB NO: 1249 SCALE:

DATE: 03.31.2021 DRAWN BY: JRH



Paragon 1401 NW View F


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PROFESSIONAL SEAL:

ARCHITECTURAL SITE PLAN


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02 | WEST ELEVATION 1/8" = 1'-0"

01 | FDP - FLOOR PLAN 1/8" = 1'-0"



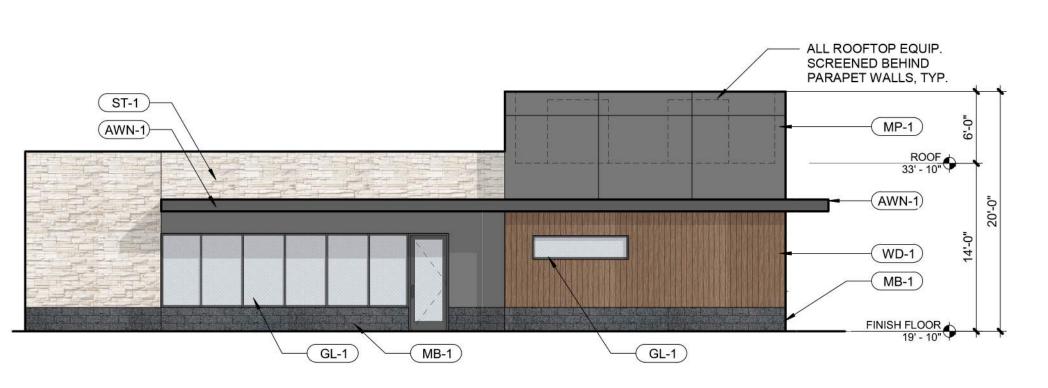

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EXTERIOR MATERIAL LEGEND

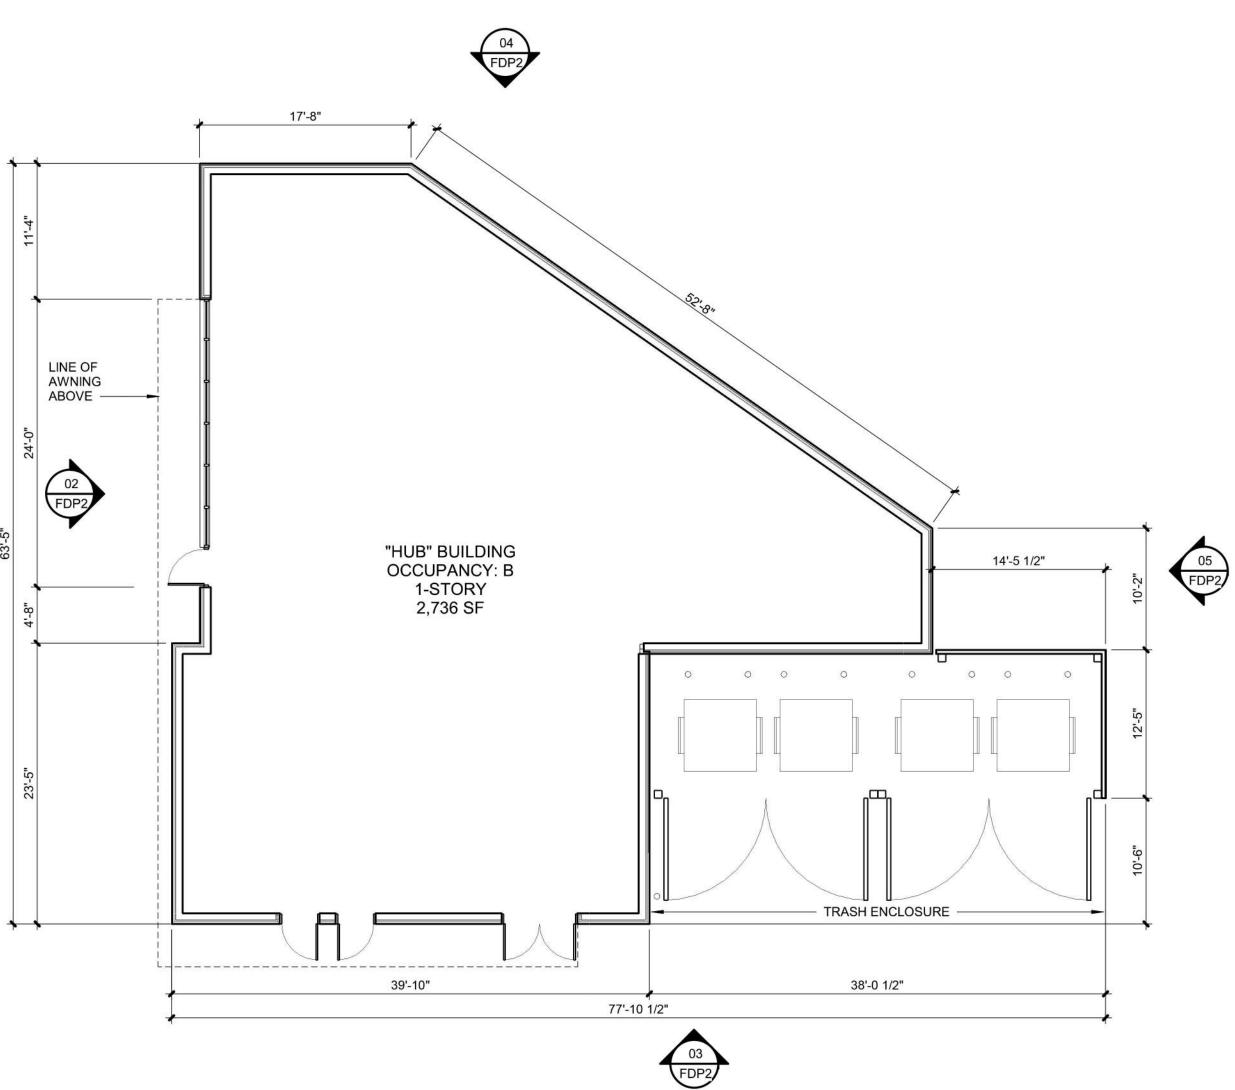WD-1 GEOLAM VERTIGO 5010 COMPOSITE CLADDING, COLOR: MOLESKIN

ST-1 ELDORADO CULTURED STONE VANTAGE 30, COLOR: WHITE ELM

MB-1 GROUND FACE 8X16 MASONRY BLOCK PER STRUCTURAL DWGS, BURNISHED FINISH, COLOR: MIDWEST SLATE

(AWN-1) CANOPY: PAINTED STEEL CHANNEL FRAME WITH GEOLAM VERTIGO 5010 SOFFIT, COLOR: MOLESKIN

GL-1 STOREFRONT TYPE 1: 2" x 4.5" KAWNEER PERMACOAT SMOKE GRAY ALUMINUM CENTER GLAZED STOREFRONT SYSTEM W/ 1" INSULATED LOW-E GLAZING UNIT

MP-1
ALUMINUM COMPOSITE METAL (ACM) DRY SYSTEM: ALUCOBOND, COLOR: NAUTRAL BRUSHED CARBON; ACM PANEL JOINTS TO ALIGN W/ GLAZING PER ELEVATIONS
PERFORATED METAL PANEL ON STEEL TUBE GATE/FRAME AT TRASH ENCLOSURE/SCREEN FENCE


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PROFESSIONAL SEAL:

DRAWING TITLE:

FLOOR PLAN AND **ELEVATIONS**

JOB NO: 1249 SCALE: DATE: 03.31.2021 DRAWN BY: EF

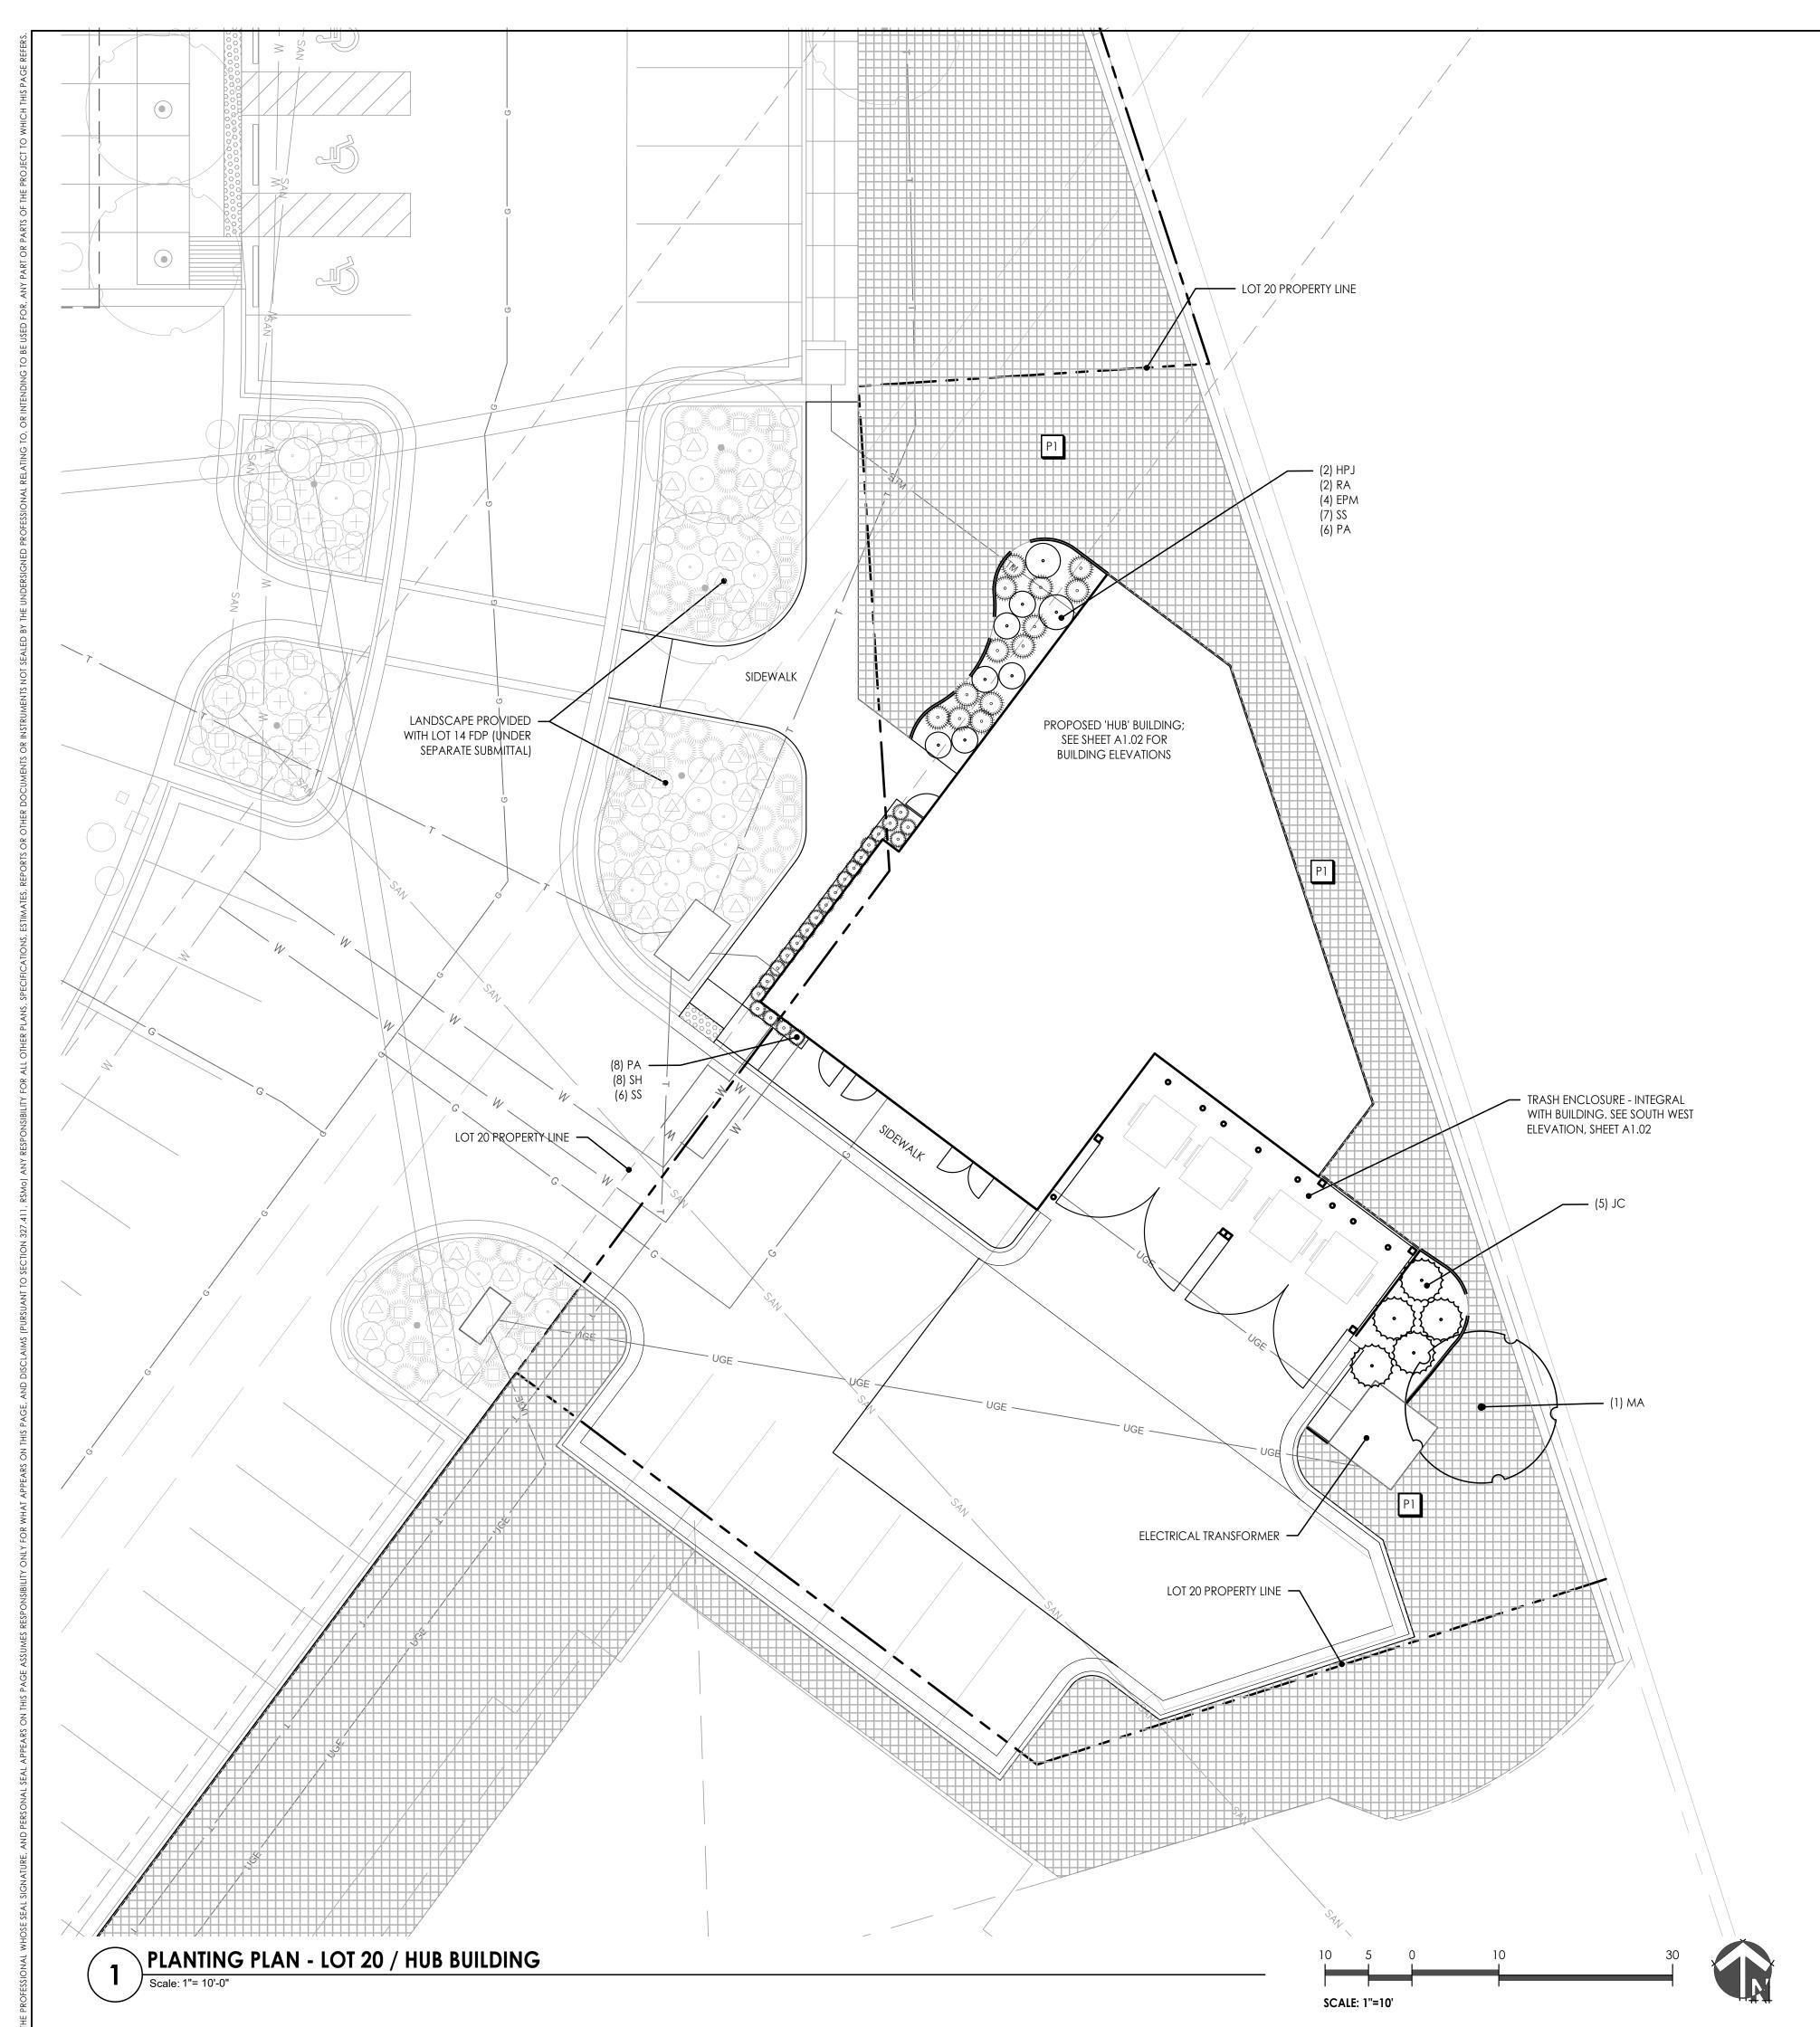

PLANTING NOTES

- 1. THIS PLAN PROVIDES LAYOUT, QUANTITY & SIZES OF ALL PLANT MATERIAL TO BE INSTALLED BY THE LANDSCAPE CONTRACTOR. REFER TO **SECTION 329300 - PLANTS** AND SECTION 329200 - TURF AND GRASSES FOR COMPLETE SCOPE OF WORK, RESPONSIBILITIES, PRODUCTS & EXECUTION OF
- 2. CONTRACTOR SHALL VERIFY LOCATION OF ALL UTILITIES BY CONTACTING ALL OF THE RESPECTIVE UTILITY COMPANIES AND/ OR THE LOCAL "ONE-CALL"/"CALL-BEFORE-YOU-DIG" SYSTEM AND BY EXCAVATING TEST PITS IF NECESSARY.
- 3. LOCATIONS OF ALL PLANT MATERIALS SHALL BE STAKED IN THE FIELD AND APPROVED BY THE OWNERS REPRESENTATIVE PRIOR TO PLANTING.
- 4. THE LANDSCAPE CONTRACTOR SHALL BE RESPONSIBLE TO SEED ALL DISTURBED AREAS BACK TO ORIGINAL FINISHED GRADE ELEVATIONS, INCLUDING, EQUIPMENT MATERIAL STORAGE AREA AND STAGING AREAS ADJACENT TO SITE.

PLANTING SCHEDULE COMMON NAME SYM. SIZE & REMARKS KEY **BOTANICAL NAME** ORNAMENTAL TREE Royal Raindrops® Crabapple 3" cal. Malus 'JFS-KW5' **EVERGREEN TREE** Perfecta Juniper 8' ht. min. Juniperus chinensis 'Perfecta' DECIDUOUS SHRUB RA Grow-low Sumac 3 gal. Rhus aromatica 'Gro-low' Little Lime® Hydrangea 5 gal. Hydrangea paniculata 'Jane' E OF ORNAMENTAL GRASS Dwarf Fountain Grass 1 gal. Pennisetum alopecuroides 'Hameln'' Little Bluestem 1 gal. Schizachyrium scoparium Prairie Dropseed 1 gal. Sporobolus heterolepis PERENNIAL/GROUNDCOVER Purple Coneflower 1 gal. Echinacea purpurea 'Magnus' TURF/SEED MIXES Native Prairie Seed Mix Butterfly Milkweed- Asclepias tuberosa (5%) Blue Wild Indigo-Baptisia australis (5%) New Jersey Tea- Ceanothus americanus (5%) Amethyst Vernal Witchhazel (10%) Switchgrass-Panicum virgatum (13%)

Little Bluestem- Schizachyrium scoparium (30%)

Fall Aster - Symphotrichum oblongifolium (10%)

Indiangrass- Sorghastrum nutans (20%)

LANDSCAPE CALCULATIONS

	Ordinance Requirement	Required for this Site	Proposed
8.790.A.2 Street Frontage Trees	One (1) tree per 30 linear feet of street frontage.	Provided by overall	N/A
	20-foot-wide landscape strip along street frontage	development landscaping	
8.790.A.2 Street Frontage Green	20-foot-wide landscape setback	Provided by overall	N/A
Strip		development landscaping	
8.790.A.3 Street Frontage Shrubs	One (1) shrub per 20 linear feet of street frontage	Provided by overall	N/A
		development landscaping	
8.790.B.1 Open Yard Areas	Two (2) shrubs per 5,000 SF of total lot area,	Site area 0.16 Ac (7,153 sf) -	43 Shrubs provided
	excluding building footprint	Building (2,736 sf) = 4,417 sf	
		2 shrubs required	
8.790.B.2 Open Yard Areas	All portions of site not covered with paving or		Meets requirement
	buildings must be landscaped. Ground covers used		
	on slopes in excess of 3:1		
8.790.B.3 Open Yard Areas	Additional trees required at a ratio of one (1) tree	Site area 0.16 Ac (7,153 sf) -	1 tree provided
	for evary 5,000 square feet of lot area not covered	Building (2,736 sf) = 4,417	
	by buildings/structures	1 tree required	
8.810.A Parking Lot Landscape	Islands required, constituting at least 5% of the	Parking lot area (3922 sf) x	288 sf planted
Islands	entire parking lot area. Every four rows of parking	0.05 = 197 sf required	islands; additional
	shall include an island at least 10' in width.		islands adjacent to
			FDP parcel
8.810.B Parking Lot Landscape	Islands are required at the end of every parking		Islands @ each end
Islands	bay, at least 9 foot wide and one-half the length of		of parking bay
	the adjacent parking space. Island shall be planted		
	in trees, shrubs, grass or ground cover		
8.810.C Parking Lot Landscape	Tree planting ares shall be no less than ten feet in		Meets requirement
Islands	width. No tree shall be less than four feet from		
	the back of curb. All islands, strips or other		
	planting ares shall be curbed.		
8.820.C.1 Parking Lot Screening, if	Planted Only: A hedge consisting of at least 12	Provided by overall	N/A
required	shurbs per 40 linear feet. Shrubs must be at least	development landscaping	
	18 inches tall at the time of planting		

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Building

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Landscape Plan

SCALE: 1" = 10'-0" DATE: 03.31.2021 DRAWN BY: EDD