LEGEND

EXISTING	PROPOSED	DESCRIPTION
		CONSTRUCTION LIMITS
		PROPERTY LINE
R/W		RIGHT-OF-WAY LINE
		EASEMENT
X		FENCE
	$\overline{\times} \rightarrow$	LIGHT POLE
ý –		UTILITY POLE
(POLE GUY
OE		OVERHEAD ELECTRIC LINE
——————————————————————————————————————	UE	UNDERGROUND ELECTRIC LINE
FO FO		UNDERGROUND FIBER-OPTIC LINE
— — — G —		GAS LINE
— — — W —	W	WATER LINE
~~~~~~~~~~~~~~~~~~~~~~~~~~~~~~~~~~~~~~	Д	FIRE HYDRANTS
— — — SAN —	SAN	SANITARY LINE
S	S ● ^{co}	SANITARY STRUCTURE
ST	ST	STORM LINE
MH		STORM STRUCTURE
		DITCH LINE
1015		CONTOUR
×1019.00 EX. 1018.50 EX.	×1019.00 1018.50	TOP OF CURB TOP OF PAVEMENT
×1019.00 EX.	×1019.00	FINISHED GRADE SPOT ELEVATION
	1.00%	GRADE SLOPE
		MAJOR FLOOD ROUTING
	HP HP	HIGH POINT
		SEEDING/LANDSCAPE AREA
		CONCRETE
		STRUCTURAL CONCRETE

# **OWNER**

WHATABURGER 300 CONCORD PLAZA DR. SAN ANTONIO, TX 78216 PHONE: (210) 476-6000 CONTACT: CLINT SAAVEDRA EMAIL: csaavedra@wbhq.com

# **SURVEYOR**

YOUNG - HOBBS AND ASSOCIATES 1202 CROSSLAND AVE. CLARKSVILLE, TN 37040 PHONE: (931) 645-2524 CONTACT: DAVE R. HOBBS

## ENGINEER

ms consultants, inc. 2221 SCHROCK ROAD COLUMBUS, OHIO 43229 PHONE: (614) 898-7100 CONTACT: KAILEN AKERS EMAIL: kakers@msconsultants.com

# **GEOTECHNICAL ENGINEER**

TERRACON CONSULTANTS, INC. 15620 W. 113th STREET LENEXA, KANSAS 66219 PHONE: (913) 492-7777 CONTACT: KOLE C. BERG, P.E.

# WHATABURGER

# 1460 NE DOUGLAS ST. LEE'S SUMMIT, MO 64086 JACKSON COUNTY



VICINITY MAP N.T.S.

## BENCHMARK

<u>TBM:</u> 5/8" IRON PIN SET ELEVATION = 1014.41

BASIS OF BEARINGS: MO (W) STATE PLANE COORDINATE SYSTEM SPC (2403 MO W)

## **FLOOD INFORMATION**

THIS PROPERTY IS LOCATED WITHIN AN AREA HAVING ZONE DESIGNATIONS OF "X" BY THE FEDERAL EMERGENCY MANAGEMENT AGENCY, ON FLOOD INSURANCE RATE MAP NO. 29095C0409G, WITH A MAP REVISED DATE OF JANUARY 20, 2017, IN JACKSON COUNTY, STATE OF MISSOURI, WHICH IS THE CURRENT FLOOD INSURANCE RATE MAP FOR THE COMMUNITY IN WHICH SAID PROPERTY IS SITUATED.



В.

ENGINEERING INSPECTION AT (816) 969-1200 AT LEAST 48 HOURS PRIOR TO THE COMMENCEMENT OF ANY CONSTRUCTION. ALL CONSTRUCTION SHALL FOLLOW THE CITY OF LEE'S SUMMIT DESIGN AND CONSTRUCTION MANUAL AS ADOPTED BY ORDINANCE 5813. WHERE DISCREPANCIES EXIST BETWEEN THESE PLANS AND THE DESIGN AND CONSTRUCTION MANUAL, THE DESIGN AND CONSTRUCTION MANUAL SHALL PREVAIL.


REVISION/DATE/DESCRIPTION

60% Plan Set	10/20/20
90% Plan Set	11/17/20
00% Plan Set/Bid Set	12/16/20

#### NOTICE

THIS ARCHITECTURAL AND ENGINEERIN DRAWING IS GIVEN IN CONFIDENCE AND SHALL BE USED ONLY PURSUANT TO THE AGREEMENT WITH THE ARCHITECT. NO OTHER USE, DISSEMINATION, OR DUPLICATION MAY BE MADE WITHOUT PRIOR WRITTEN CONSENT OF THE ARCHITECT. ALL COMMON LAW RIGHTS OF COPYRIGHT AND OTHERWISE ARE HEREBY SPECIFICALLY RESERVED.



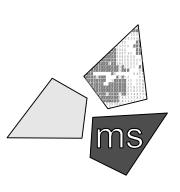


ms consultants, inc. engineers, architects, planners 2221 Schrock Road Columbus, Ohio 43229-1547 phone 614.898.7100 fax 614.898.7570

#### PROJECT

WHATABURGER PT20M BUILDING

1460 NE DOUGLAS ST. LEE'S SUMMIT, MO 64086


## SHEET TITLE COVER SHEET

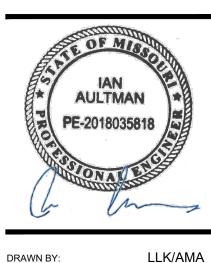

CHECKED BY:	KEA
PROJECT NO:	40497-01

**C**-'

DRAWING

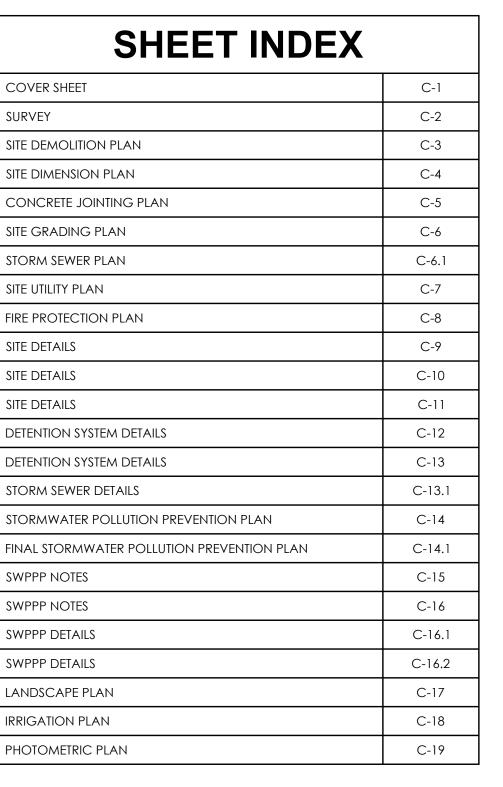

THE CONTRACTOR SHALL NOTIFY THE CITY OF LEE'S SUMMIT DEVELOPMENT




The Missouri One Call System is a communications system which was established to help prevent damage to underground facilities and to promote safety. Missouri One Call operators are on duty 24 hours a day, seven days a week.

Missouri One Call provides a telephone number for contractors and the general public to call for notification of their intent to use equipment for excavation, grading, blasting, boring, demolition or other types of similar work.

#### 1-800-DIG-RITE or 811

#### MAKE THE CALL ... IT'S THE LAW

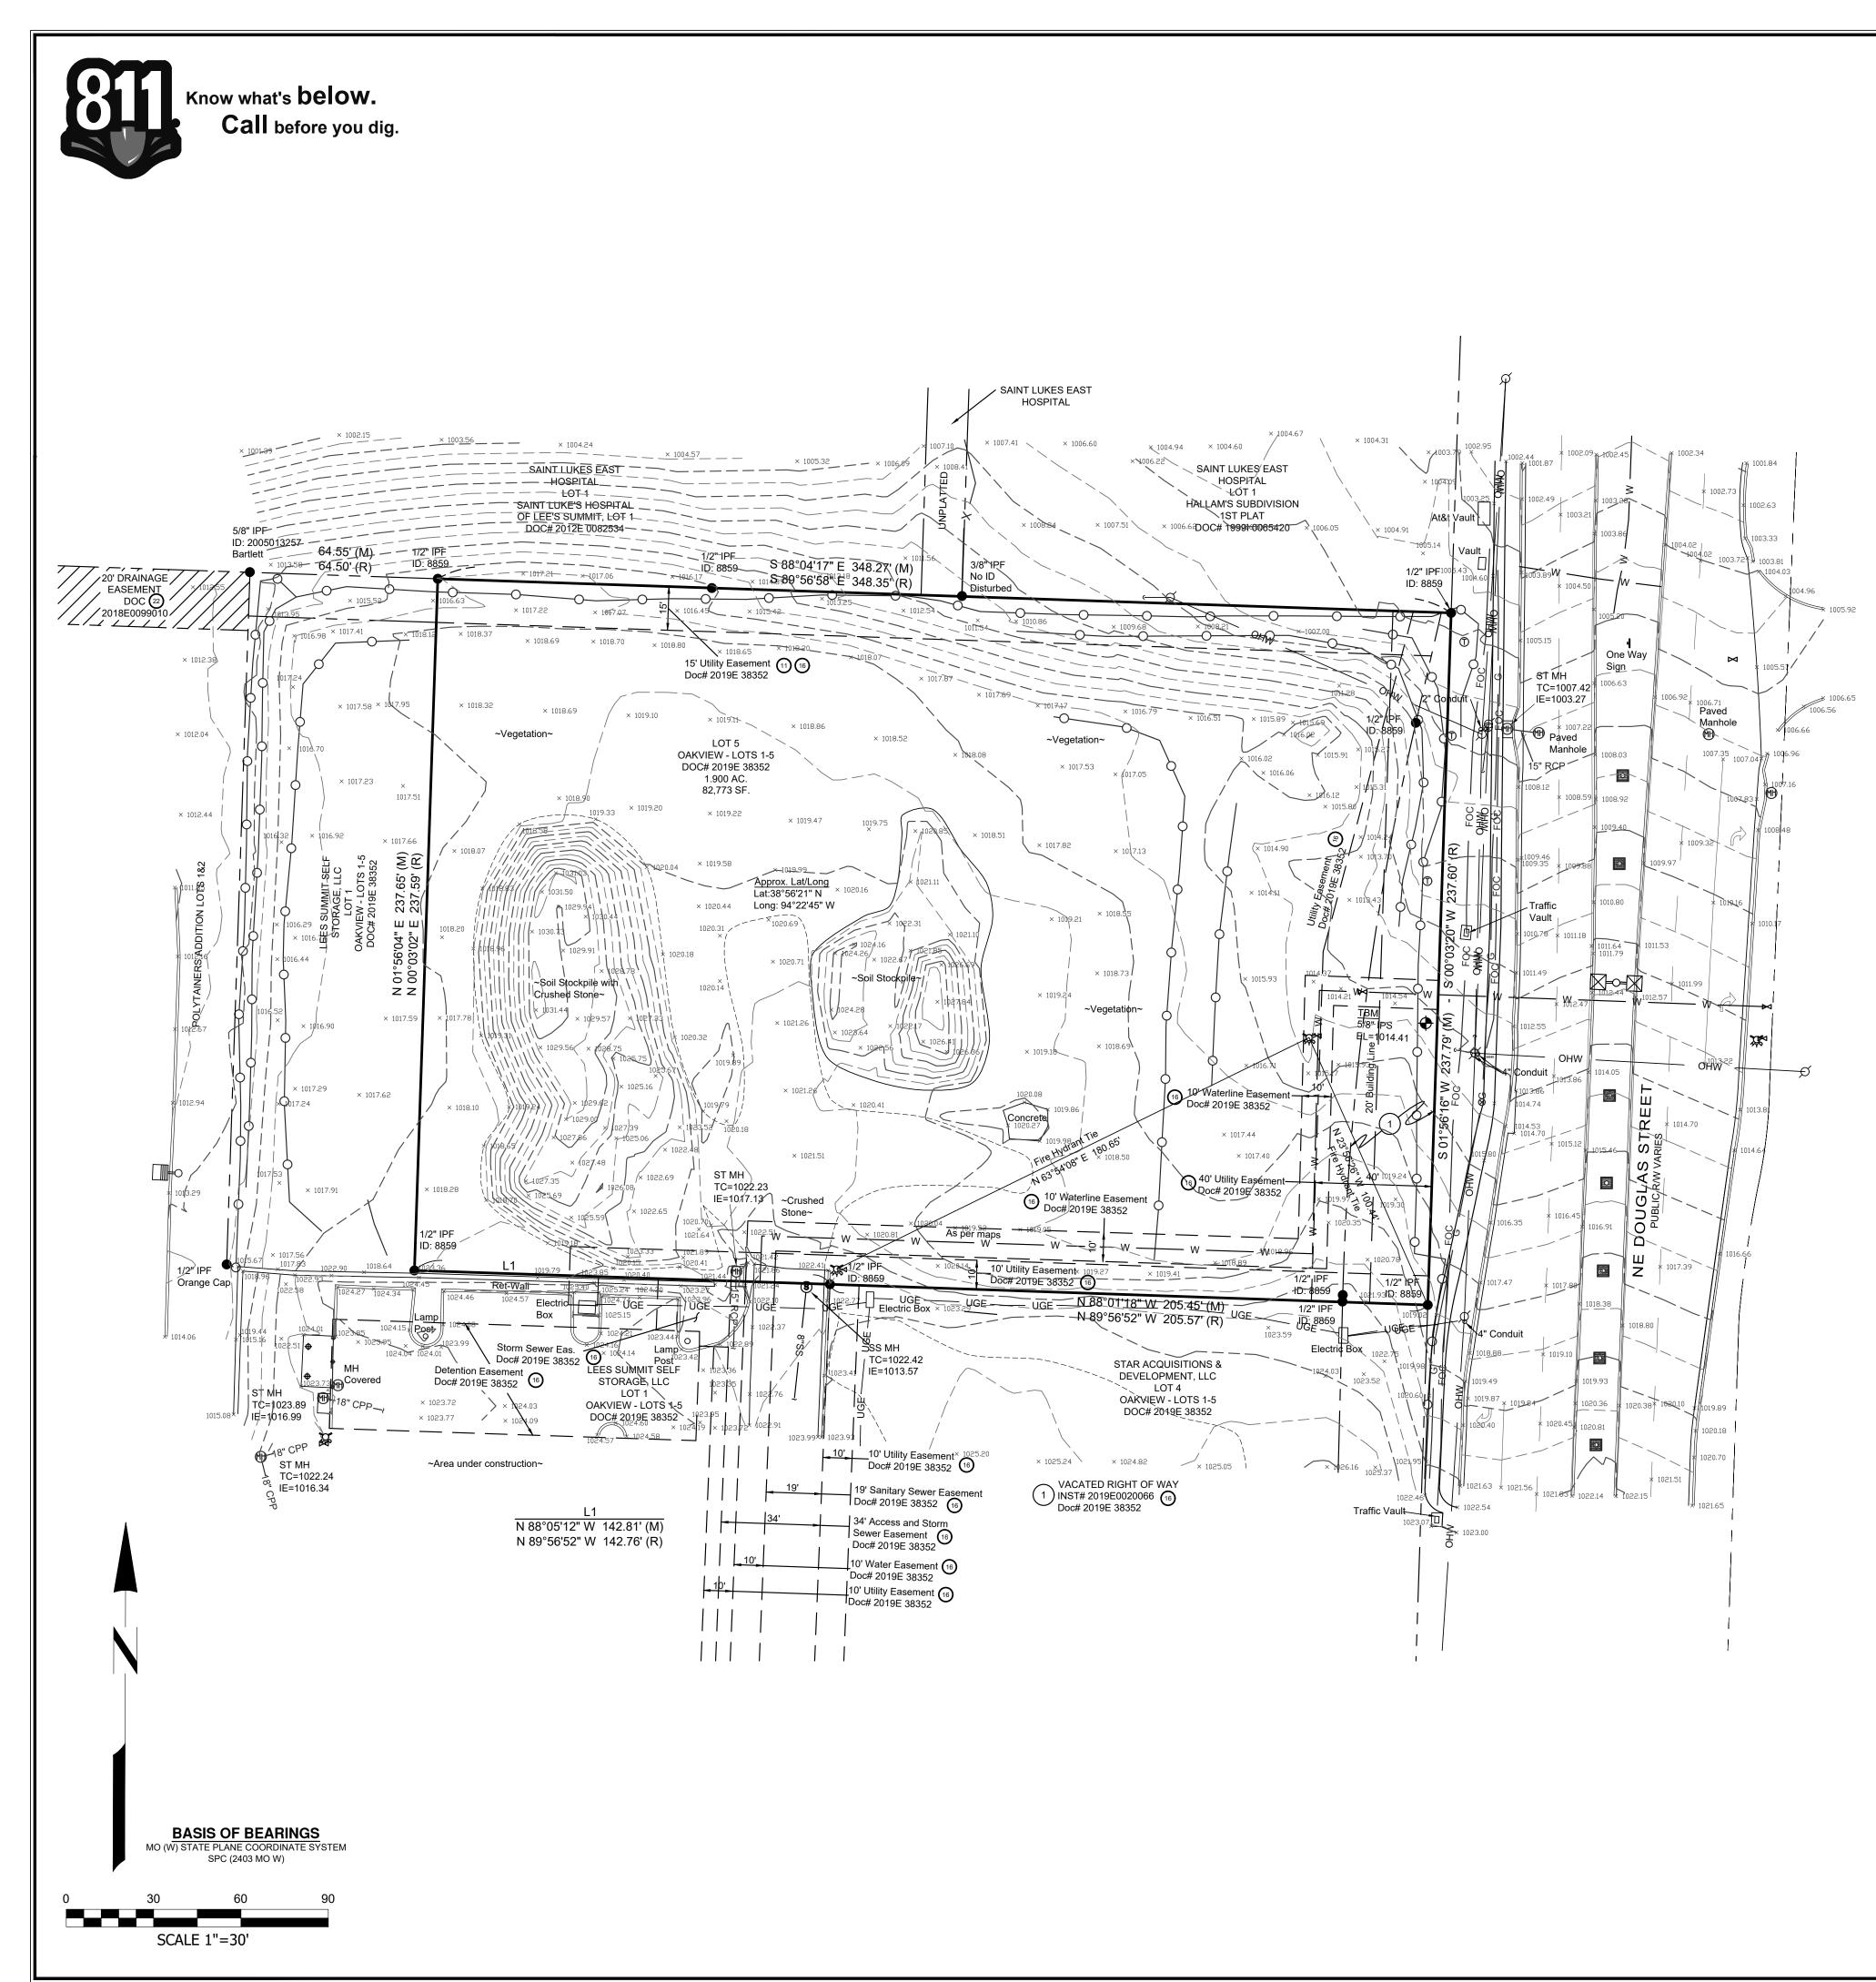

## SITE ADDRESS

LEES SUMMIT, MO

#### 1450 NE DOUGLAS ST

REGULAR SPACES: HANDICAP SPACES: TOTAL SPACES:

#### LEGEND IRON PIN SET (IPS) IRON PIN FOUND, AS NOTED _ BENCHMARK, AS NOTED _ BOLLARD _ SIGN, AS NOTED _SEWER MANHOLE _ FIRE HYDRANT _ WATER VALVE _ UTILITY POLE _GUY WIRE _ELECTRIC METER _ GAS VALVE _ TELEPHONE BOX _GATE POST __ GRATE INLET _ STORM MANHOLE __ LANDSCAPE GRATE PROPERTY LINE _____ EASEMENT LINE _____ SETBACK LINES · OHW ______ OVERHEAD WIRE __ UNDERGROUND ELECTRIC UGE — – X _____ FENCE LINE _____O_____ SILT FENCE LINE - W _____ WATER LINE, AS NOTED _____SS______SANITARY SEWER, AS NOTED GAS LINE, AS NOTED _____ FOC _____ UNDERGROUND FIBER OPTIC _____ST_____STORM SEWER PIPE, AS NOTED LIGHT POLE LIGHT POLE(2-WAY) $\boxtimes \neg \neg \boxtimes$ TABLE A NOTES:

THE PHYSICAL ADDRESS OF THE SITE WAS OBTAINED PLAT RECORD IN DOC# 2019E 38352.
THIS PROPERTY IS LOCATED WITHIN AN AREA HAVING ZONE DESIGNATIONS OF "X" BY THE FEDERAL EMERGENCY MANAGEMENT AGENCY, ON FLOOD INSURANCE RATE MAP NO.29095C0409G, WITH A MAP REVISED DATE OF JANUARY 20, 2017, IN JACKSON COUNTY, STATE OF MISSOURI, WHICH IS THE CURRENT FLOOD INSURANCE RATE MAP FOR THE COMMUNITY IN WHICH SAID PROPERTY IS SITUATED."
CONTOURS WERE DERIVED FROM RANDOM SHOTS AND CROSS SECTIONS AND ARE SHOWN AT ONE FOOT INTERVALS. ELEVATIONS SHOWN HEREON ARE BASED ON GPS OBSERVATIONS TOGETHER WITH AN OPUS SOLUTION, DATED 8/10/2020 (NAVD88,GEOID18).
NO ZONING REPORT PROVIDED TO THIS SURVEYOR.
THERE WAS EVIDENCE OF RECENT EARTH MOVING, BUILDING CONSTRUCTION, OR BUILDING ADDITIONS OBSERVED IN THE PROCESS OF CONDUCTING THE FIELDWORK.
THERE WAS EVIDENCE OF RECENT CHANGES IN STREET RIGHT OF WAY LINES. THERE WAS EVIDENCE OF RECENT OR STREET SIDEWALK CONSTRUCTION OR REPAIRS OBSERVED IN THE PROCESS OF CONDUCTING THE FIELDWORK.

ITEM 18: THERE WAS NO WETLAND DELINEATION OBSERVED IN THE PROCESS OF CONDUCTING THE FIELDWORK.

#### LAND DESCRIPTION (PER TITLE):

#### Tract 1: Lot 5, OAKVIEW - LOTS-1-5, a subdivision in Lee's Summit, Jackson County, Missouri, according to the recorded plat thereof.

Tract 2: Non-exclusive, perpetual drainage easements and temporary construction easement created by Easements and Maintenace Agreement dated November

14, 2018 and recorded November 15, 2018 as Document No. 2018E0099010. Subject to the terms, provisions and conditions set forth in said instrument. Tract 3:

Non-exlusive perpetual appurtenant easement for pedestrian and vehicular ingress and egress and maintenance created by Maintenance Agreement (for platted ingress and egress easement) dated November 14, 2018 as Document No. 2018E0099011. Subject to the terms, provisions and conditions set forth in said instrument.

#### Tract 4:

Non-exclusive easement for maintenance, repair and replacement of common facilities created by Common Facilities Maintenance and Reimbursement Agreement dated July 11, 2019 and recorded July 12, 2019 as Document No. 2019E0053459. Subject to the terms, provisions and conditions set forth in said instrument.

#### SURVEY NOTES:

INFORMATION REGARDING THE PRESENCE, SIZE AND LOCATION OF UNDERGROUND UTILITIES IS SHOWN HEREON. THIS INFORMATION HAS BEEN SHOWN BASED ON THE LOCATION ABOVE GROUND APPURTENANCES, AVAILABLE DESIGN PLANS, AND FLAGES AND PAINT PLACED BY THE UNDERGROUND PROTECTION SERVICE. NO CERTIFICATION IS MADE AS TO THE ACCURACY OF THOROUGHNESS OF THE INFORMATION CONCERNING UNDERGROUND UTILITIES AND STRUCTURES SHOWN HEREON. (MISSOURI ONE CALL 1-800-DIG-RITE). THIS SURVEY WAS PERFORMED WITHOUT THE BENEFIT OF A PRIVATE UTILITY LOCATE.

CONTACT PROPER AUTHORITIES BEFORE BUILDING NEAR UTILITY LINES, FOR EASEMENT WIDTH AND RESTRICTIONS. UTILITIES ARE APPROXIMATE AND SHOULD BE VERIFIED PRIOR TO ANY CONSTRUCTION.


UNLESS STATED OTHERWISE, ANY MONUMENT REFERRED TO HEREIN AS AN "IRON PIN SET" IS A SET 5/8" DIAMETER REBAR, WITH AN YELLOW PLASTIC CAP STAMPED "YOUNG-HOBBS"

THIS SURVEY HAS BEEN PREPARED FOR THE EXCLUSIVE USE OF THE PERSON OR ENTITIES NAMED HERON. NO EXPRESS OR IMPLIED WARRANTIES WITH RESPECT TO THE INFORMATION SHOWN HEREON IS TO BE EXTENDED TO ANY PERSONS OR ENTITIES OTHER THAN THOSE SHOWN HEREON.

LIST OF ENCROACHMENTS: NONE, THE OWNERSHIP OF CURB, UTILITIES, FENCES, AND/OR PERIMETER WALLS SHOWN HEREON ARE NOT KNOWN AND THUS ARE NOT LISTED AS ENCROACHMENTS. CURB, UTILITIES, FENCES, AND/OR PERIMETER WALLS ARE SHOWN IN THEIR RELATIVE POSITION TO THE BOUNDARY.

I DO HEREBY STATE THAT THIS IS A TRUE, COMPLETE AND CORRECT SURVEY OF THE DESCRIBED REAL PROPERTY SITUATED IN THE COUNTY OF CASS, MISSOURI AND THAT THIS SURVEY WAS EXECUTED IN ACCORDANCE WITH THE CURRENT MISSOURI MINIMUM STANDARDS FOR PROPERTY SURVEYS (URBAN SURVEY 1:20,000)

## PARKING COUNT

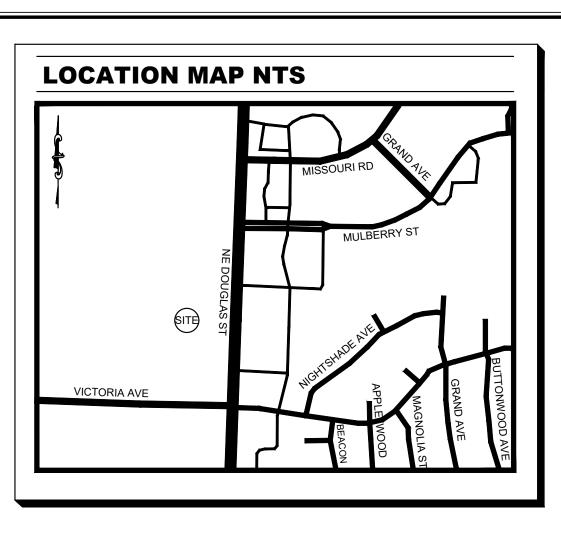

## SURVEYOR'S CERTIFICATION:

TO: OAK VIEW LEE'S SUMMIT, LLC, A TEXAS LIMITED LIABILITY COMPANY AND CHICAGO TITLE INSURANCE COMPANY THIS IS TO CERTIFY THAT THIS MAP OR PLAT AND THE SURVEY ON WHICH IT IS

BASED WERE MADE IN ACCORDANCE WITH THE 2016 MINIMUM STANDARD DETAIL REQUIREMENTS FOR ALTA/NSPS LAND TITLE SURVEYS, JOINTLY ESTABLISHED AND ADOPTED BY ALTA AND NSPS, AND INCLUDES ITEMS 1, 2, 3, 4, 5, 6(a), 6(b), 7(a-c), 8, 9, 13, 16, 17, 18, AND 20 OF TABLE A THEREOF. THE FIELD WORK WAS COMPLETED ON JUNE 4, 2020.

DATE OF PLAT OR MAP: AUGUST 10, 2020.

DAVE R. HOBBS, PLS 2014020711 dave@younghobbs.com

# NOTES CORRESPONDING TO SCHEDULE B:

DATE

CHICAGO TITLE INSURANCE COMPANY COMMITMENT DATE: MAY 28, 2020. COMMITMENT NO.: 200889

-Items 1-7 are either standard exceptions or are not surveying related.

8) Covenants, conditions and restrictions but omitting any covenants or restrictions, if any, including but not limited to those based upon race, color, religion, sex, sexual orientation, familial status, marital status, disability, handicap, national origin, ancestry, source of income, gender, gender identity, gender expression, medical condition or genetic information, as set forth in applicable state or federal laws, except to the extent that said covenant or restriction is permitted by applicable law, as set forth in the document Recording Date: February 10, 1989 Recording No: Recording No:1-896908, in Book 1-1888, Page 1123, as affected by Waiver of Use Restriction recorded June 2,2016 as Document No. 2016E0048717. (SUBJECT TO THIS ITEM) 9) Easement granted to the City of Lee's Summit, recorded March 16,1989 as Document No.1-901781, in Book 1-1897, Page 480. (DOES NOT AFFECT) 10) Drainage and Sewer Easement granted to the City of Lee's Summit, recorded March 1,1990 as Document No. 1-963299,in Book 1-2000, Page 1089. (DOES NOT AFFECT)

11) Building lines, restrictions, utility, drainage, storm sewer, sanitary sewer, and waterline easements shown on the plat recorded March 21,2016 as Document No. 2016E0023636 in Plat Book 161at Page 47. (AFFECTS, AS SHOWN HEREON)

12) Sign and Access Easement granted to 1400 North Douglas Corporation, recorded March 23, 2016 as Document No. 2016E0024979. (DOES NOT AFFECT)

13) Ingress and Egress Easement established by the plat recorded March 21,2016 as Document No. 2016E0023636, in Book 161, Page 47. (DOES NOT AFFECT)

14) Approval of Development recorded February 21,2018 as Document No.2018E0013736. (SUBJECT TO THIS ITEM)

15) Terms, provisions and easements of Maintenance Agreement recorded November 15, 2018 as Document No. 2018E0099011. (DOES NOT AFFECT)

16) Building lines, restrictions, utility, drainage, storm sewer, sanitary sewer, and waterline easements shown on the plat,

OAKVIEW - LOTS 1-5, recorded May 24, 2019 as Document No.2019E0038352. (AFFECTS, AS SHOWN HEREON)

17) Terms and provisions of Ordinance No.8630 of the City of Lee's Summit, Missouri recorded May 24,2019 as Document No.2019E0038456, for the purpose of approving the plat of OAKVIEW - LOTS 1-5. (SUBJECT TO THIS ITEM)

18) Covenants, conditions and restrictions but omitting any covenants or restrictions, if any, including but not limited to those based upon race, color, religion, sex, sexual orientation, familial status, marital status, disability, handicap, national origin, ancestry, source of income, gender, gender identity, gender expression, medical condition or genetic information as set forth in applicable state or federal laws, except to the extent that said covenant or restriction is permitted by applicable law, as sat forth in the Common Facilities Maintenance and Reimbursement Agreement

Recording Date: July 12,2019 Recording No: 2019E0053459. (SUBJECT TO THIS ITEM)

19) Connection Easement recorded July 12, 2019 as Document No. 2019E0053544. (MAY AFFECT; PARTIAL DOCUMENT SENT TO SURVEYOR)

20) State court judgments, state tax liens, and federal tax liens, if any, against the party(ies) to be insured as owner(s). (SUBJECT TO THIS ITEM)

21) Tenancy rights, either as month to month or by virtue of written leases, of persons now in possession of any part

of the Land. (SUBJECT TO THIS ITEM)


22) ADDED 6.30.2020 Terms, provisions and easements of Easements and Maintenace Agreement dated November 14, 2018 and recorded November 15, 2018 as Document No. 2018E0099010. (DOES NOT AFFECT)

23) ADDED 6.30.2020

Terms, provisions and easements of Common Facilities Maintenance and Reimbursement Agreement dated July 11, 2019 and recorded July 12, 2019 as Document No. 2019E0053459. (SUBJECT TO THIS ITEM)

YOUNG - HOBBS         AND         ASSOCIATES         1202 CROSSLAND AVE.         CLARKSVILLE, TN 37040         PHONE 931-645-2524         FAX 931-645-2768		
DAVE R. HOBBS, PLS 2014020711		
Revision		
No. Date		
CLIENT CLIENT CLIENT COUNTRY OF CONTRACT OF CONTRACT.		
ALTA/NSPS LAND TITLE SURVEY		
OWNER INFORMATION OAK VIEW LEES SUMMIT LLC PROPERTY 201 HAWKS RIDGE TRL COLLEYVILLE, TX 76034 PARCEL: 52-900-02-37-00-00-000 LOT 5 DOC# 2019E 38352		
CITY OF LEES SUMMIT COUNTY OF JACKSON STATE OF MISSOURI		
DRAWN BY: CLH/KAB		

SHEET 1 OF

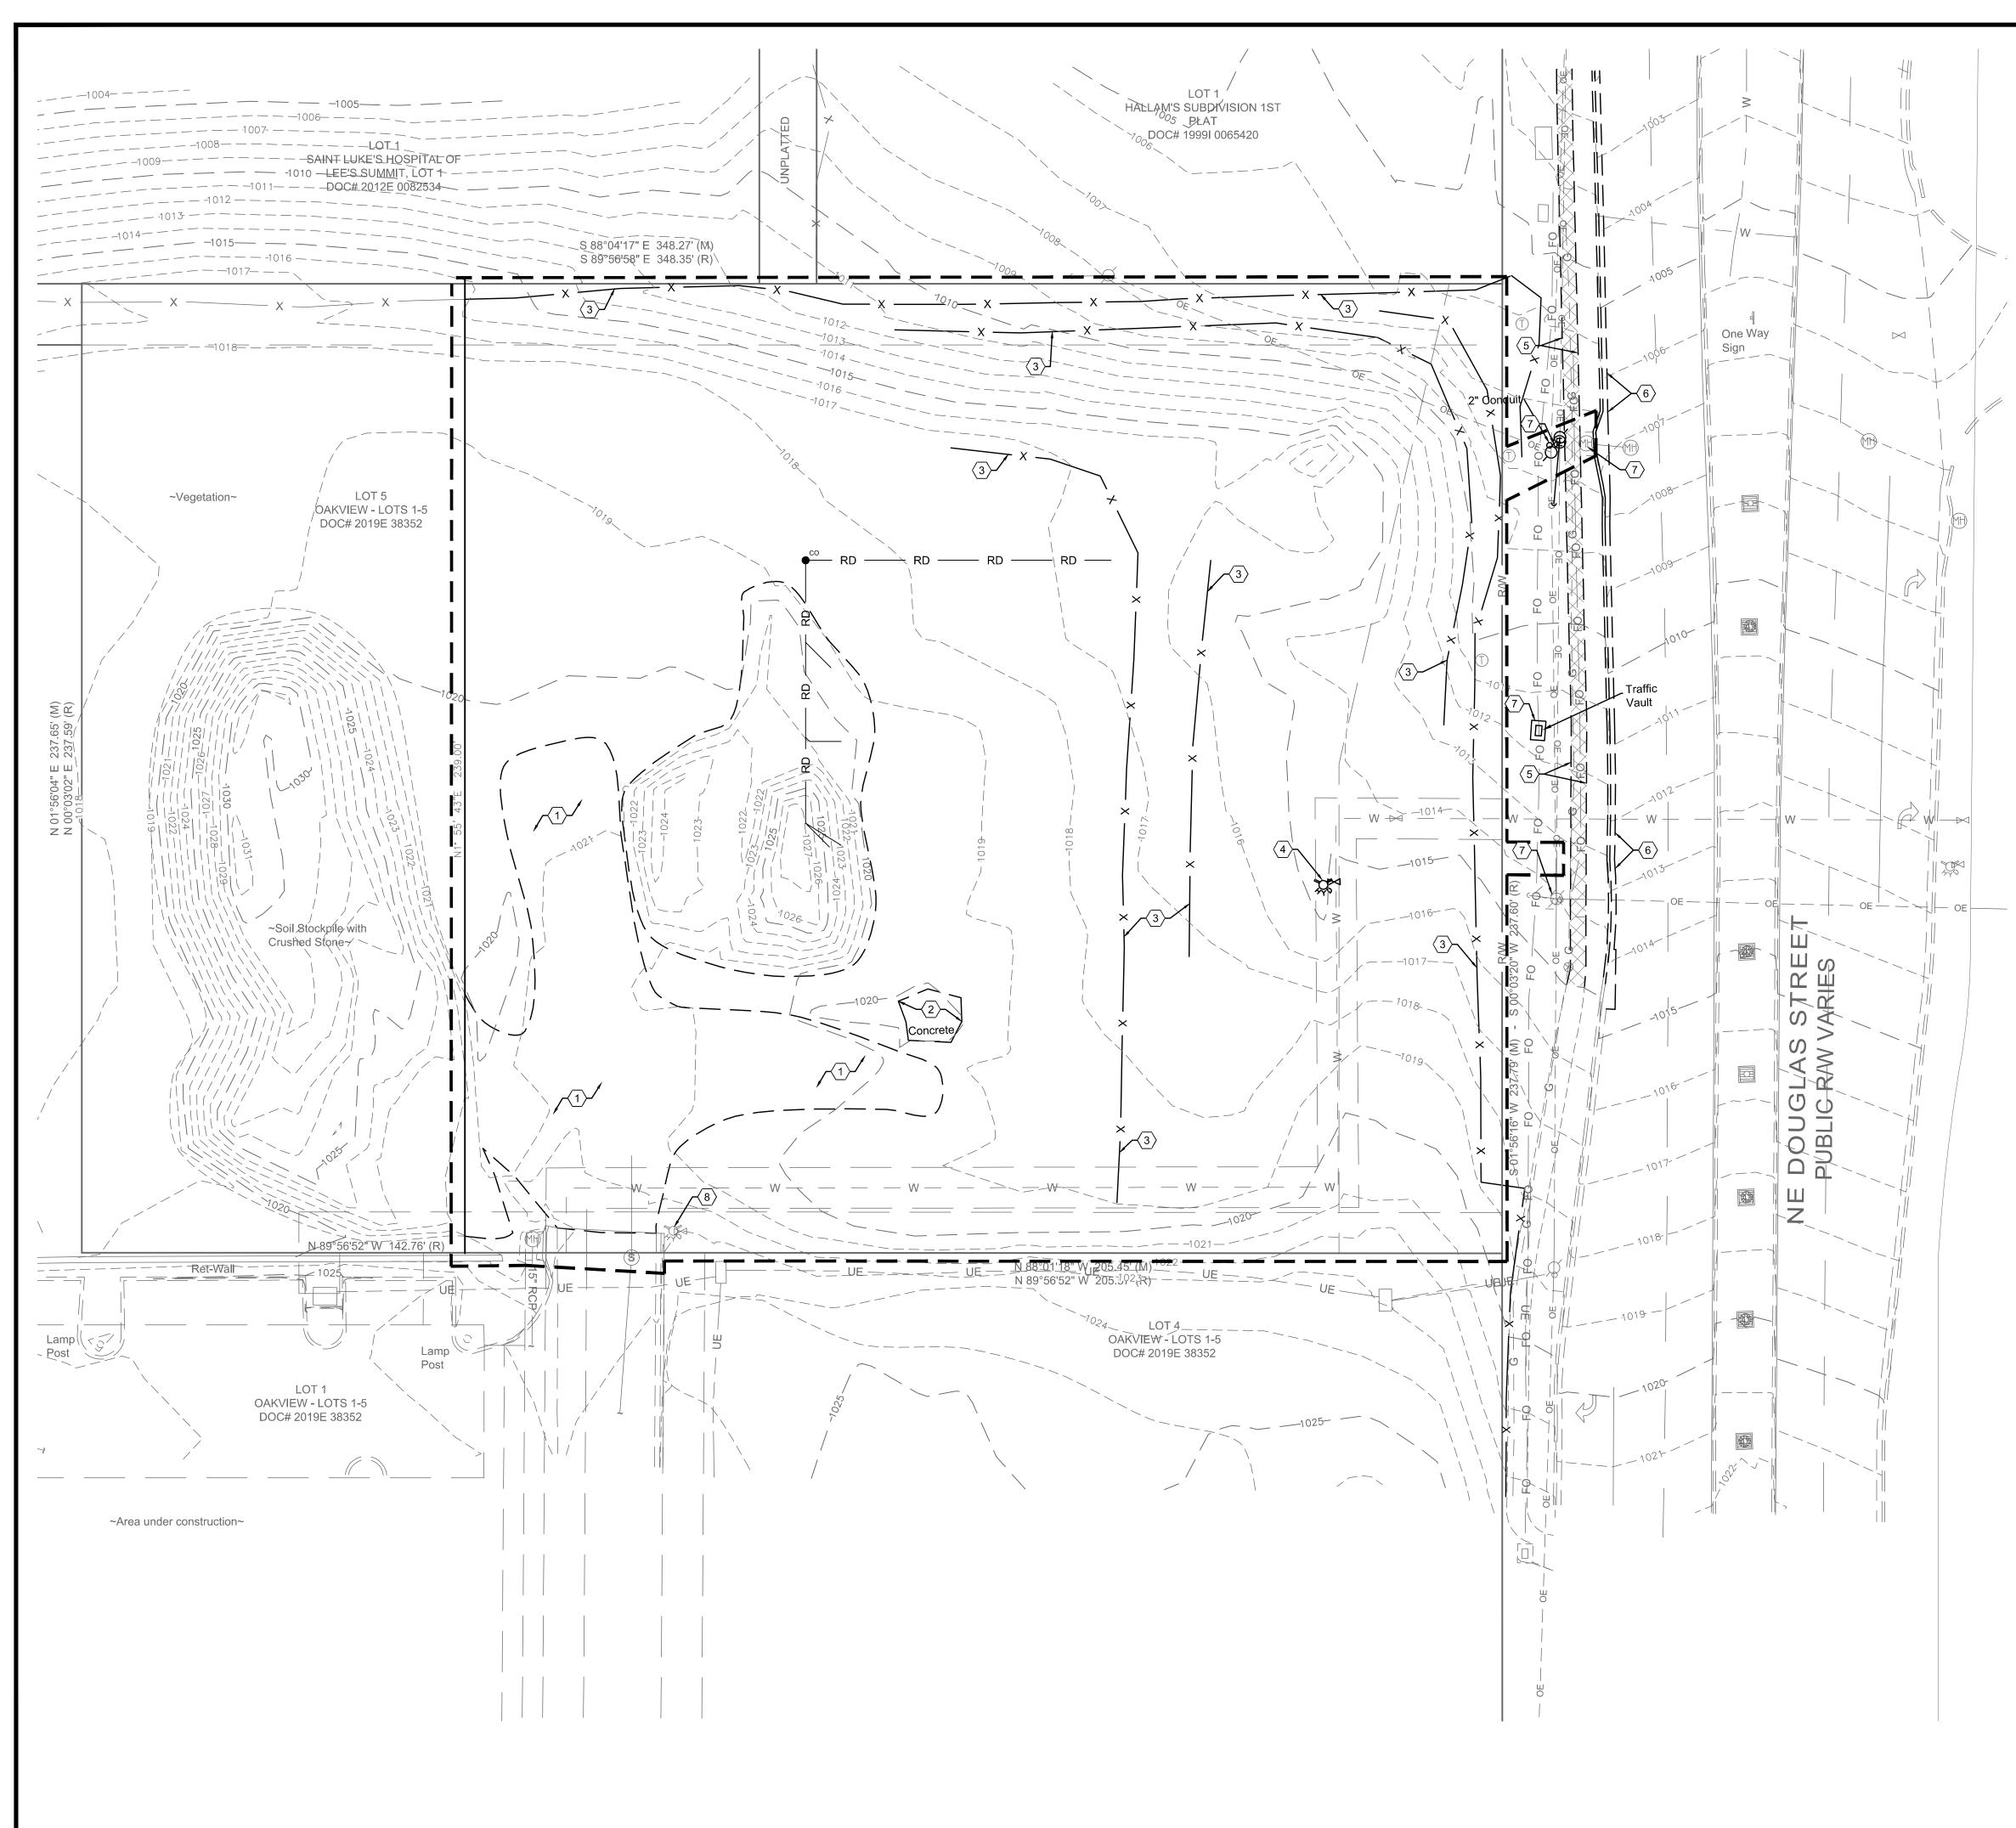

## **GENERAL NOTES:**

- A. ALL EXISTING CONDITIONS, TOPOGRAPHY, UTILITIES AND PROPERTY INFORMATION ARE TAKEN FROM A SURVEY OF LAND SITUATED IN THE CITY OF LEE'S SUMMIT, COUNTY OF JACKSON, AND STATE OF MISSOURI, BY SURVEYOR: YOUNG - HOBBS AND ASSOCIATES, 1202 CROSSLAND AVE., CLARKSVILLE, TN 37040, PHONE: (931) 645-2524
- B. AT START OF PROJECT AND PRIOR TO DEMOLITION OF EXISTING CONDITIONS, CONTRACTOR SHALL BE IN CONTACT WITH ADJACENT PROPERTY OWNERS, CITY REPRESENTATIVE, UTILITY REPRESENTATIVES AND OWNER REPRESENTATIVE TO COORDINATE DEMOLITION TIMING.
- C. CONTRACTOR TO REMOVE AND DISPOSE OF ALL DEBRIS AND OTHER MATERIALS RESULTING FROM DEMOLITION AND CONSTRUCTION OPERATIONS. DISPOSAL WILL BE IN ACCORDANCE WITH ALL LOCAL, STATE AND FEDERAL REGULATIONS GOVERNING SUCH OPERATIONS.
- D. CONTRACTOR SHALL TAKE ALL PRECAUTIONS NECESSARY TO AVOID DAMAGE TO ADJACENT PROPERTIES DURING CONSTRUCTION PHASES OF THIS PROJECT. CONTRACTOR WILL BE SOLELY RESPONSIBLE FOR DAMAGE TO NEIGHBORING PROPERTIES OCCURRING AS A RESULT OF CONSTRUCTION ACTIVITIES.
- E. ALL EXISTING UTILITIES ARE SHOWN HEREIN AS REFERENCE ONLY AND ARE BASED ON RECORD OF THE VARIOUS UTILITY COMPANIES, A FIELD SURVEY AND EXISTING PLANS. CONTRACTOR IS RESPONSIBLE FOR DETERMINING THE EXACT LOCATIONS OF ALL UTILITIES PRIOR TO DEMOLITION ACTIVITIES. CONTRACTOR IS RESPONSIBLE FOR ANY DAMAGE TO UTILITIES DURING CONSTRUCTION.
- F. THE CONTRACTOR SHALL NOTIFY ALL UTILITY COMPANIES 48 HOURS BEFORE CONSTRUCTION IS TO START, TO VERIFY IF ANY UTILITIES ARE PRESENT ON SITE. ALL VERIFICATIONS (LOCATION, SIZE AND DEPTH) SHALL BE MADE BY THE APPROPRIATE UTILITY COMPANIES. WHEN EXCAVATION IS AROUND OR OVER EXISTING UTILITIES, THE CONTRACTOR MUST NOTIFY THE UTILITY SO A REPRESENTATIVE OF THAT UTILITY COMPANY CAN BE PRESENT TO INSTRUCT AND OBSERVE DURING CONSTRUCTION.
- G. CONTRACTOR SHALL CONFINE ALL STOCKPILING OF DEMOLITION MATERIALS TO WITHIN THE LIMITS OF THE SUBJECT PROPERTY.
- H. NO OIL AND/OR GAS WELLS ARE LOCATED ON SITE PER THE MISSOURI DEPARTMENT OF NATURAL RESOURCES WEBSITE.


## **KEYED NOTES:**


- (1) EXISTING CRUSHED STONE AND GRAVEL TO BE REMOVED AND DISPOSED OF.
- 2 EXISTING CONCRETE TO BE REMOVED AND DISPOSED OF.
- (3) EXISTING FENCE TO BE REMOVED AND RETURNED TO OWNER.
- (4) EXISTING FIRE HYDRANT AND WATER VALVE TO BE REMOVED AND RELOCATED. COORDINATE WITH OWNER AND WATER COMPANY.
- $\langle 5 \rangle$  EXISTING SIDEWALK TO BE DEMOLISHED BY OTHERS.
- (6) EXISTING CURB AND GUTTER TO BE DEMOLISHED BY OTHERS.
- $\langle 7 \rangle$  EXISTING UTILITY STRUCTURE TO BE RELOCATED BY OTHERS.

PROPOSED

 $\langle 8 \rangle$  EXISTING FIRE HYDRANT TO REMAIN.

# LEGEND

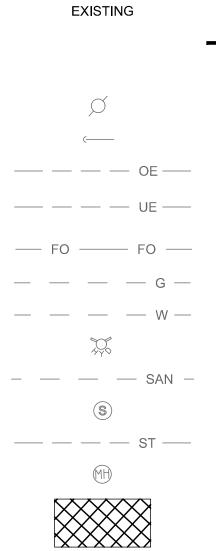

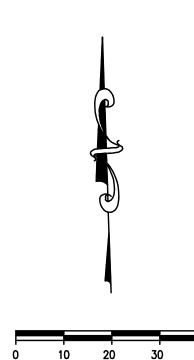

0 10 20 30 SCALE: 1"=20'

DESCRIPTION CONSTRUCTION LIMITS LIGHT POLE UTILITY POLE POLE GUY OVERHEAD ELECTRIC LINE UNDERGROUND ELECTRIC LINE UNDERGROUND FIBER-OPTIC LINE GAS LINE WATER LINE FIRE HYDRANTS SANITARY LINE SANITARY STRUCTURE STORM LINE STORM STRUCTURE

DEMOLISHED SIDEWALK



The Missouri One Call System is a communications system which was established to help prevent damage to underground facilities and to promote safety. Missouri One Call operators are on duty 24 hours a day, seven days a week. Missouri One Call provides a telephone number for contractors and the general public to call for notification of their intent to use equipment for excavation, grading, blasting, boring, demolition or other types of similar work.

#### 1-800-DIG-RITE or 811

MAKE THE CALL ... IT'S THE LAW


REVISION/DATE/DESCRIPTION

60% Plan Set	10/20/20
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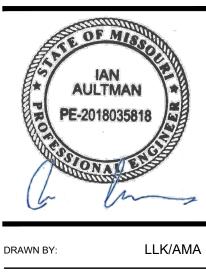
ms consultants, inc. engineers, architects, planners 2221 Schrock Road Columbus, Ohio 43229-1547 phone 614.898.7100 fax 614.898.7570

#### PROJECT

WHATABURGER PT20M BUILDING


1460 NE DOUGLAS ST. LEE'S SUMMIT, MO 64086
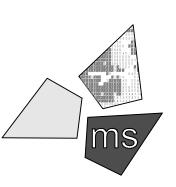
## SHEET TITLE SITE DEMOLITION PLAN



CHECKED BY:	KEA
PROJECT NO:	40497-01
DRAWING	

**C-3** 

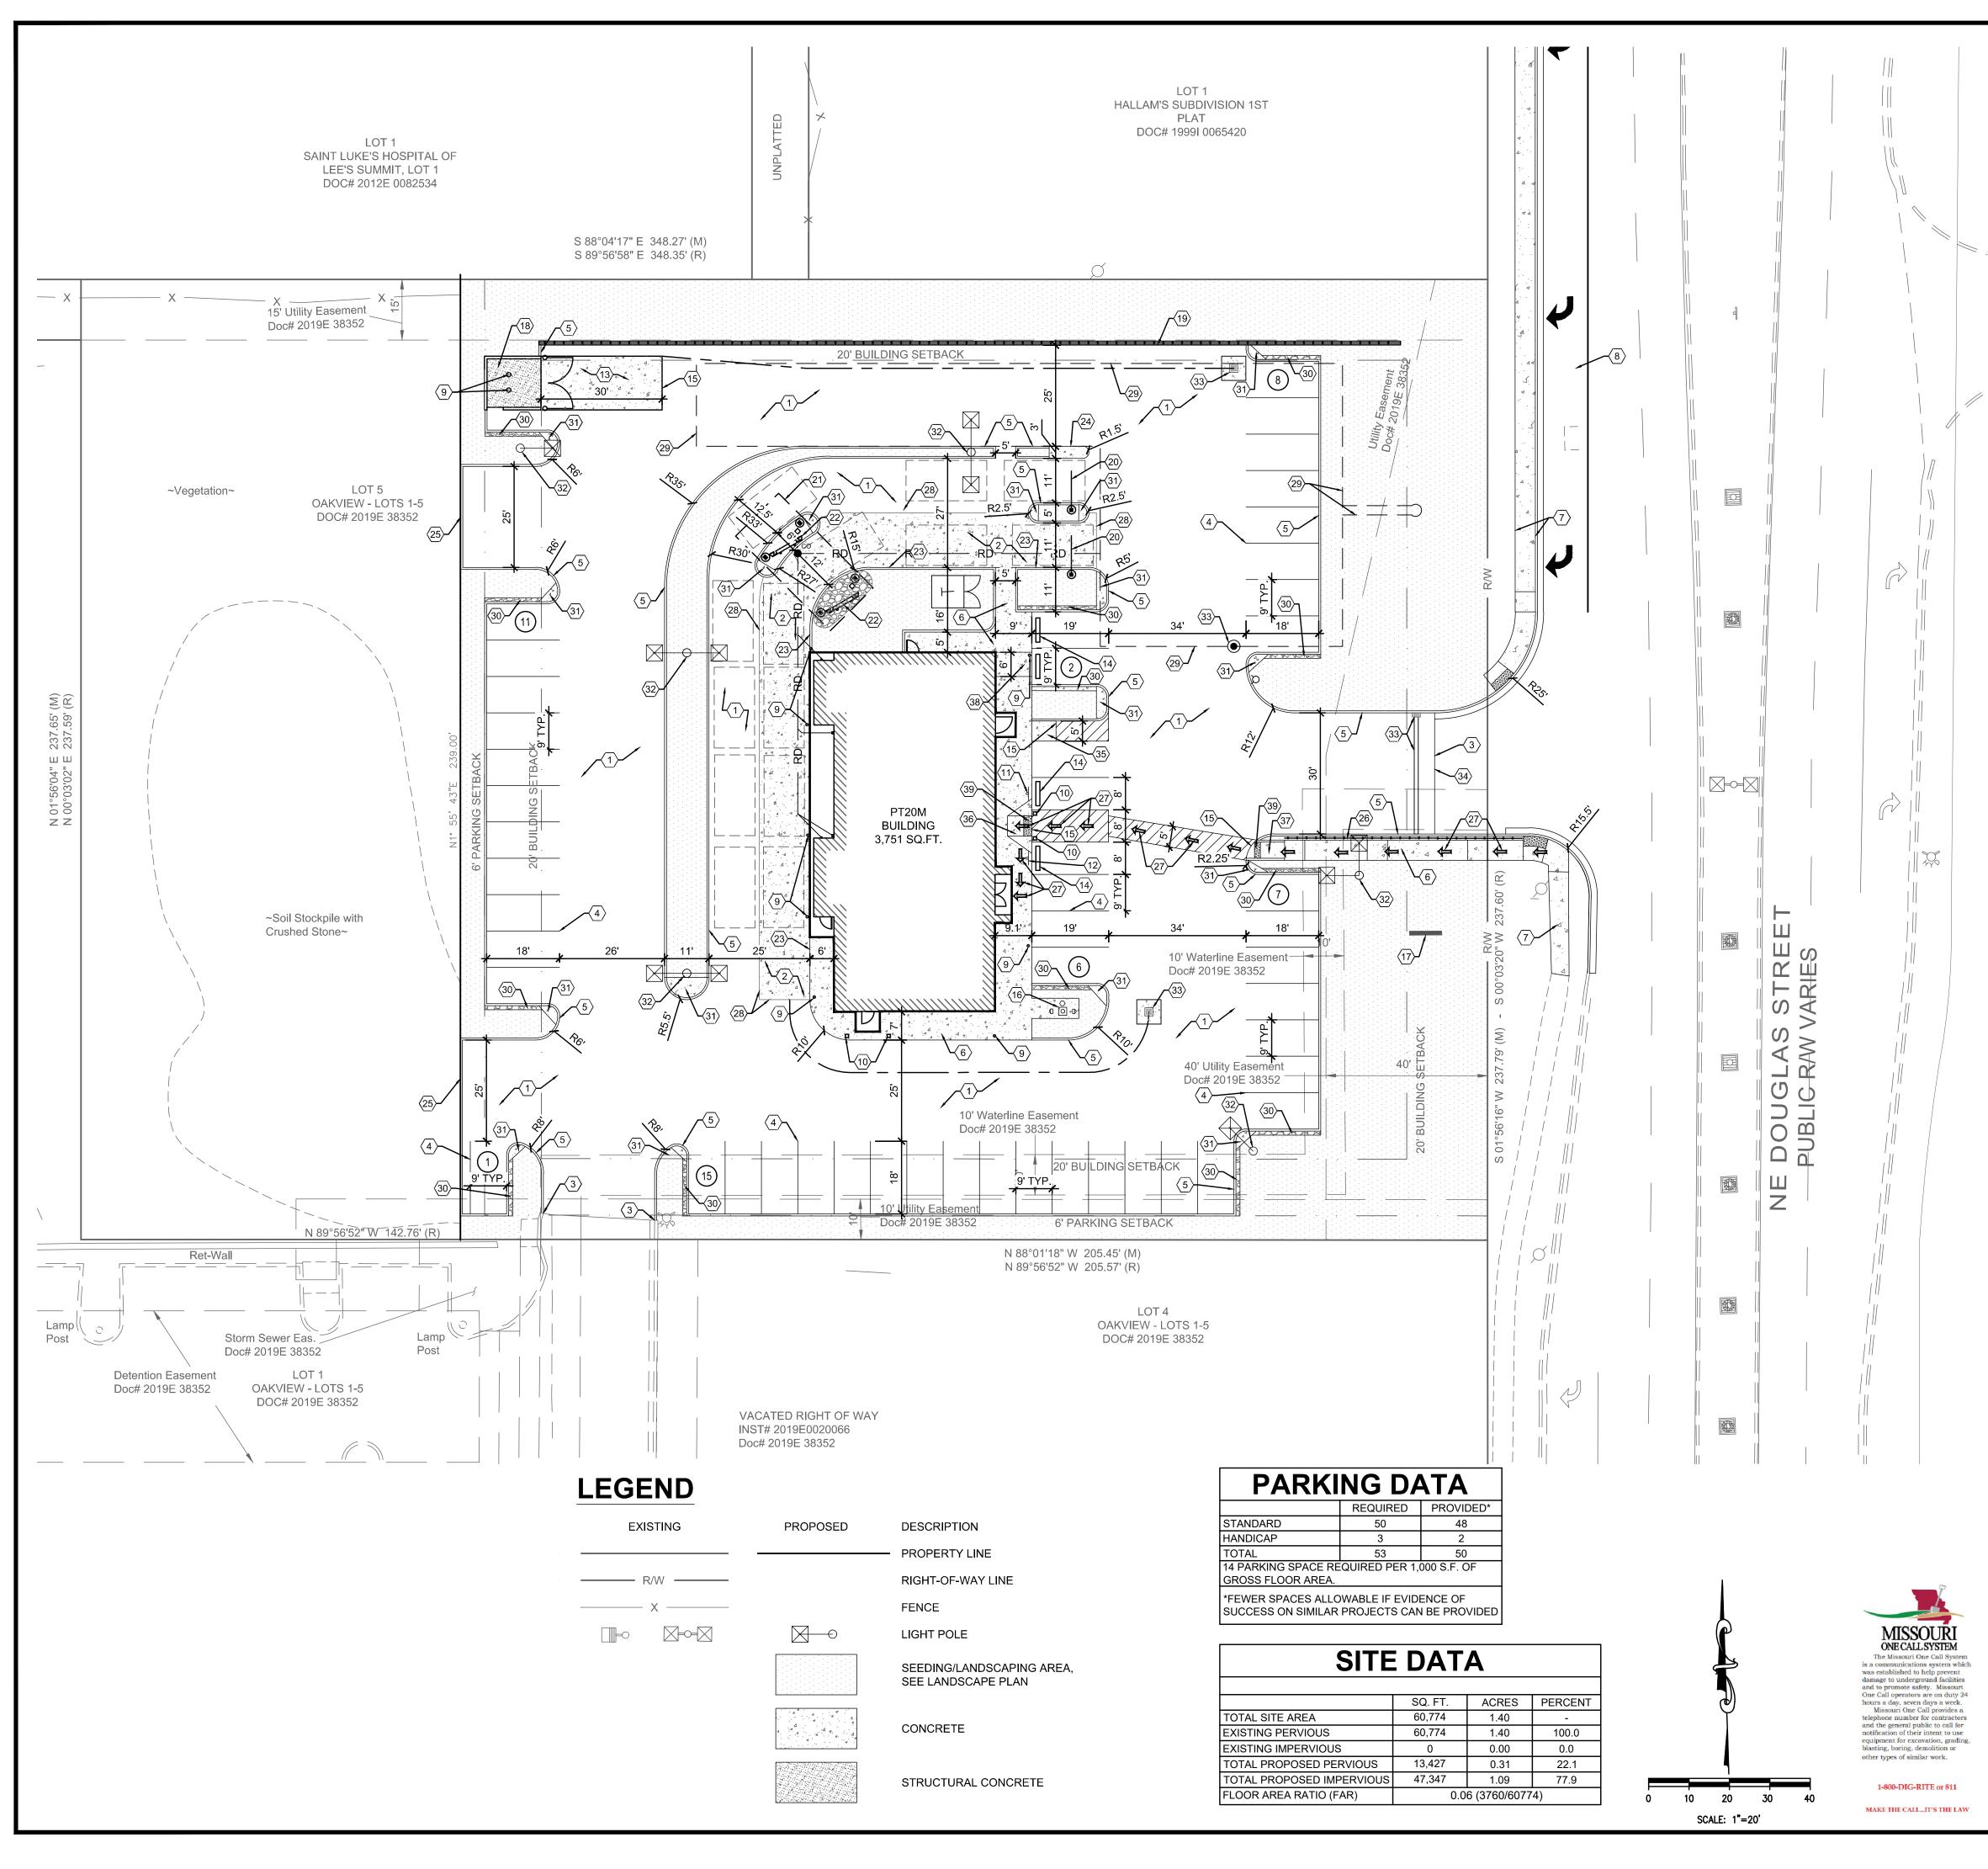

## **GENERAL NOTES:**

- A. ALL EXISTING CONDITIONS, TOPOGRAPHY, UTILITIES AND PROPERTY INFORMATION ARE TAKEN FROM A SURVEY OF LAND SITUATED IN THE CITY OF LEE'S SUMMIT, COUNTY OF JACKSON, AND STATE OF MISSOURI, BY SURVEYOR: YOUNG - HOBBS AND ASSOCIATES, 1202 CROSSLAND AVE., CLARKSVILLE, TN 37040, PHONE: (931) 645-2524
- B. CONTRACTOR IS RESPONSIBLE FOR LOCATING AND VERIFYING ALL EXISTING UNDERGROUND UTILITIES PRIOR TO CONSTRUCTION, AND IS RESPONSIBLE FOR ANY DAMAGE TO THEM DURING CONSTRUCTION.
- C. PROVIDE SMOOTH TRANSITION FROM NEWLY PAVED AREAS TO EXISTING PAVED AREAS AS NECESSARY. THE EXISTING EDGE OF PAVEMENT SHALL BE FREE OF ALL LOOSE DEBRIS AT ALL AREAS WHERE PROPOSED PAVEMENT MEETS EXISTING PAVEMENT. THE EDGE OF EXISTING ASPHALT PAVEMENT SHALL BE PROPERLY SEALED WITH A TACK COAT MATERIAL IN ALL AREAS WHERE NEW ASPHALT PAVEMENT IS INDICATED TO JOIN EXISTING.
- D. ALL DIMENSIONS TO FACE OF CURB AND/OR EDGE OF PAVEMENT UNLESS OTHERWISE NOTED.
   E. CONTRACTOR SHALL BE SOLELY RESPONSIBLE FOR AND TAKE ALL PRECAUTIONS NECESSARY TO AVOID DAMAGE TO ADJACENT PROPERTIES DURING THE CONSTRUCTION PHASES OF THIS PROJECT.
- F. REFER TO ARCHITECTURAL DRAWINGS FOR BUILDING DIMENSIONS AND ADDITIONAL INFORMATION.
- G. ALL CONSTRUCTION METHODS AND MATERIALS MUST CONFORM TO CURRENT STANDARDS AND SPECIFICATIONS OF THE FEDERAL, STATE, COUNTY, CITY OR LOCAL REQUIREMENTS, WHICHEVER HAS JURISDICTION.
- H. ALL EXCAVATED AREAS TO BE SEEDED AND/OR SODDED AFTER FINISH GRADING UNLESS OTHERWISE NOTED. ALL NEWLY SEEDED/SODDED AREAS SHALL HAVE A MINIMUM OF 4" OF TOPSOIL. HOLD SOIL DOWN 1" FROM PAVEMENT ELEVATION. CONTRACTOR TO SUPPLY STRAW MULCH WHERE GRASS SEED HAS BEEN PLANTED.
- I. ALL RADII ARE 3.0 FEET UNLESS OTHERWISE SHOWN. ALL RADII INDICATED ON PLANS SHALL BE CONSTRUCTED AS CIRCULAR ARCS.

## **KEYED NOTES:**

FOR DETAILS.

- PROPOSED HEAVY DUTY ASPHALT PAVEMENT, SEE DETAIL ON SHEET C-9.
- (2) PROPOSED HEAVY DUTY CONCRETE PAVEMENT, SEE DETAIL ON SHEET C-6.
- 3 PROPOSED ASPHALT PAVEMENT TO BE FLUSH WITH EXISTING.
- 4 PROPOSED PAINTED PARKING STRIPING (TYPICAL). ALL PARKING STRIPES ARE TO BE 4" HIGH-BUILD PAINTED WHITE, UNLESS OTHERWISE NOTED ON THE PLANS, DETAILS OR SPECIFICATIONS.
- 5 PROPOSED 6" STRAIGHT CURB PER CITY OF LEE'S SUMMIT STANDARD DRAWING GEN-4 TYPE C-1, SEE DETAIL ON SHEET C-9.
- $\fbox{6} \qquad \mathsf{PROPOSED} \ \mathsf{CONCRETE} \ \mathsf{SIDEWALK}. \ \mathsf{SEE} \ \mathsf{DETAIL} \ \mathsf{ON} \ \mathsf{SHEET} \ \mathsf{C-9}.$
- PROPOSED CONCRETE SIDEWALK, SEE DEVELOPER ROADWAY PLANS FOR MORE DETAILS.
- 8 PROPOSED RIGHT-TURN LANE, SEE DEVELOPER ROADWAY PLANS FOR MORE DETAILS.
- PROPOSED BOLLARD, TYP. OF 8. SEE ARCHITECTURAL AND STRUCTURAL PLANS FOR DETAILS.
   PROPOSED ILLUMINATED BOLLARD, TYP. OF 4. SEE ARCHITECTURAL AND STRUCTURAL PLANS
- (1) GENERAL CONTRACTOR TO PROVIDE AND INSTALL (1) POLE-MOUNTED HANDICAP PARKING SIGNS. SIGNS PROVIDED BY CONTRACTOR TO MEET LOCAL REQUIREMENTS, SEE DETAIL ON SHEET C-9.
- (12) GENERAL CONTRACTOR TO PROVIDE AND INSTALL (1) POLE-MOUNTED HANDICAP PARKING SIGN WITH "VAN ACCESSIBLE" SIGN. SIGNS PROVIDED BY CONTRACTOR TO MEET LOCAL REQUIREMENTS, SEE DETAIL ON SHEET C-9.
- (13) CONCRETE DUMPSTER ENCLOSURE APRON . SEE DETAIL ON SHEET C-9.
- (14) PROPOSED PRE-CAST CONCRETE WHEEL STOP (TYP. OF 8), SEE DETAIL ON SHEET C-9.
- (15) CONCRETE TO BE FLUSH WITH ADJACENT ASPHALT PAVEMENT.
- (16) FLAGPOLE WITH GROUND-MOUNTED LIGHTS, UNITEDFLAG AND BANNER, GARRISON TYPE OR OWNER APPROVED EQUAL, 30' HIGH, 5" BUTT ALUMINUM WITH 14 GAUGE ALUMINUM BALL FINIAL. INCLUDE ALUMINUM ROLLER AND SLEEVE. HARDWARE TO INCLUDE STATIONARY STRUCK, NYLON FLAGSNAPS, AND HALYARDS. ENTIRE ASSEMBLY (INCLUDING FOUNDATION) TO CONFORM TO APPLICABLE CODES, INCLUDING WIND LOADS. SEE ARCHITECTURAL AND STRUCTURAL PLANS FOR DETAILS.
- (17) PROPOSED MONUMENT SIGN, CONTRACTOR TO COORDINATE WITH OWNER. SEE ELECTRICAL PLANS AND SIGNAGE PACKAGE FOR DETAILS.
- PROPOSED DUMPSTER ENCLOSURE AND CONCRETE PAD. SEE ARCHITECTURAL AND STRUCTURAL PLANS FOR DETAILS.
- (19) PROPOSED 215' REDI-ROCK RETAINING WALL WITH PEDESTRIAN RAILING. SEE GRADING PLAN ON SHEET C-6 FOR WALL HEIGHT.
- PROPOSED HEADACHE BAR. SEE ARCHITECTURAL PLANS FOR DETAILS.
- 21 PROPOSED MENU BOARD CANOPY. SEE ARCHITECTURAL PLANS FOR DETAILS.
- 22 PROPOSED EXTERIOR MENU BOARD. SEE ARCHITECTURAL PLANS FOR DETAILS.
- PROPOSED 6" MONOLITHIC CURB, SEE DETAIL ON SHEET C-11.
- ROLL BACK CURB PER CITY OF PER LEE'S SUMMIT STANDARD DRAWING GEN-4 TYPE CG-2, SEE DETAIL ON SHEET C-9.
- (25) TEMPORARY ASPHALT CURB. SEE DETAIL ON SHEET C-9.
- PROPOSED PEDESTRIAN RAILING TO MATCH RAILING INSTALLED AT NORTHERN RETAINING WALL.
- 27 ADA ACCESSIBLE PEDESTRIAN ROUTE.
- CONCRETE TO BE FLUSH WITH ADJACENT ASPHALT PAVEMENT, SEE DETAIL ON SHEET C-11.
- (29) PROPOSED UNDERGROUND STORAGE, SEE DETAILS ON SHEETS C-12 AND C-13.
- (30) 1' WIDE CRUSHED GRANITE STRIP. SEE DETAIL ON SHEET C-11.
- (31) CONCRETE ISLAND NOSE. SEE DETAIL ON SHEET C-11.
- (32) LIGHTPOLE AND FOUNDATION.SEE STRUCTURAL PLANS FOR DETAILS.
- (33) PROPOSED STORM SEWER STRUCTURE, SEE SITE GRADING PLAN, SHEET C-6 FOR MORE INFORMATION.
- (34) PRIVATE SITE AND DEVELOPER WORK INTERFACE.
- (35) RAMP WITH ADA STRIPING, SEE DETAIL ON SHEET C-11.
- (36) CURB RAMP A, SEE DETAIL ON SHEET C-11.
- (37) CURB RAMP B, SEE DETAIL ON SHEET C-11.
- (38) CONCRETE WALK RAMP NOT TO EXCEED 8.33% AND 2.00% CROSS-SLOPE.
- (39) PROPOSED DETECTABLE WARNING SURFACE PER MODOT ITEM 608.50.


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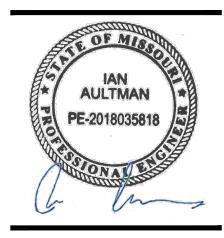
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#### PROJECT

WHATABURGER PT20M BUILDING


1460 NE DOUGLAS ST. LEE'S SUMMIT, MO 64086

## SHEET TITLE SITE DIMENSION PLAN

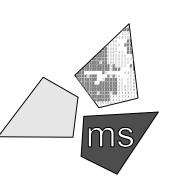

DRAWN BY:	LLK/AMA
CHECKED BY:	KEA
PROJECT NO:	40497-01

DRAWING

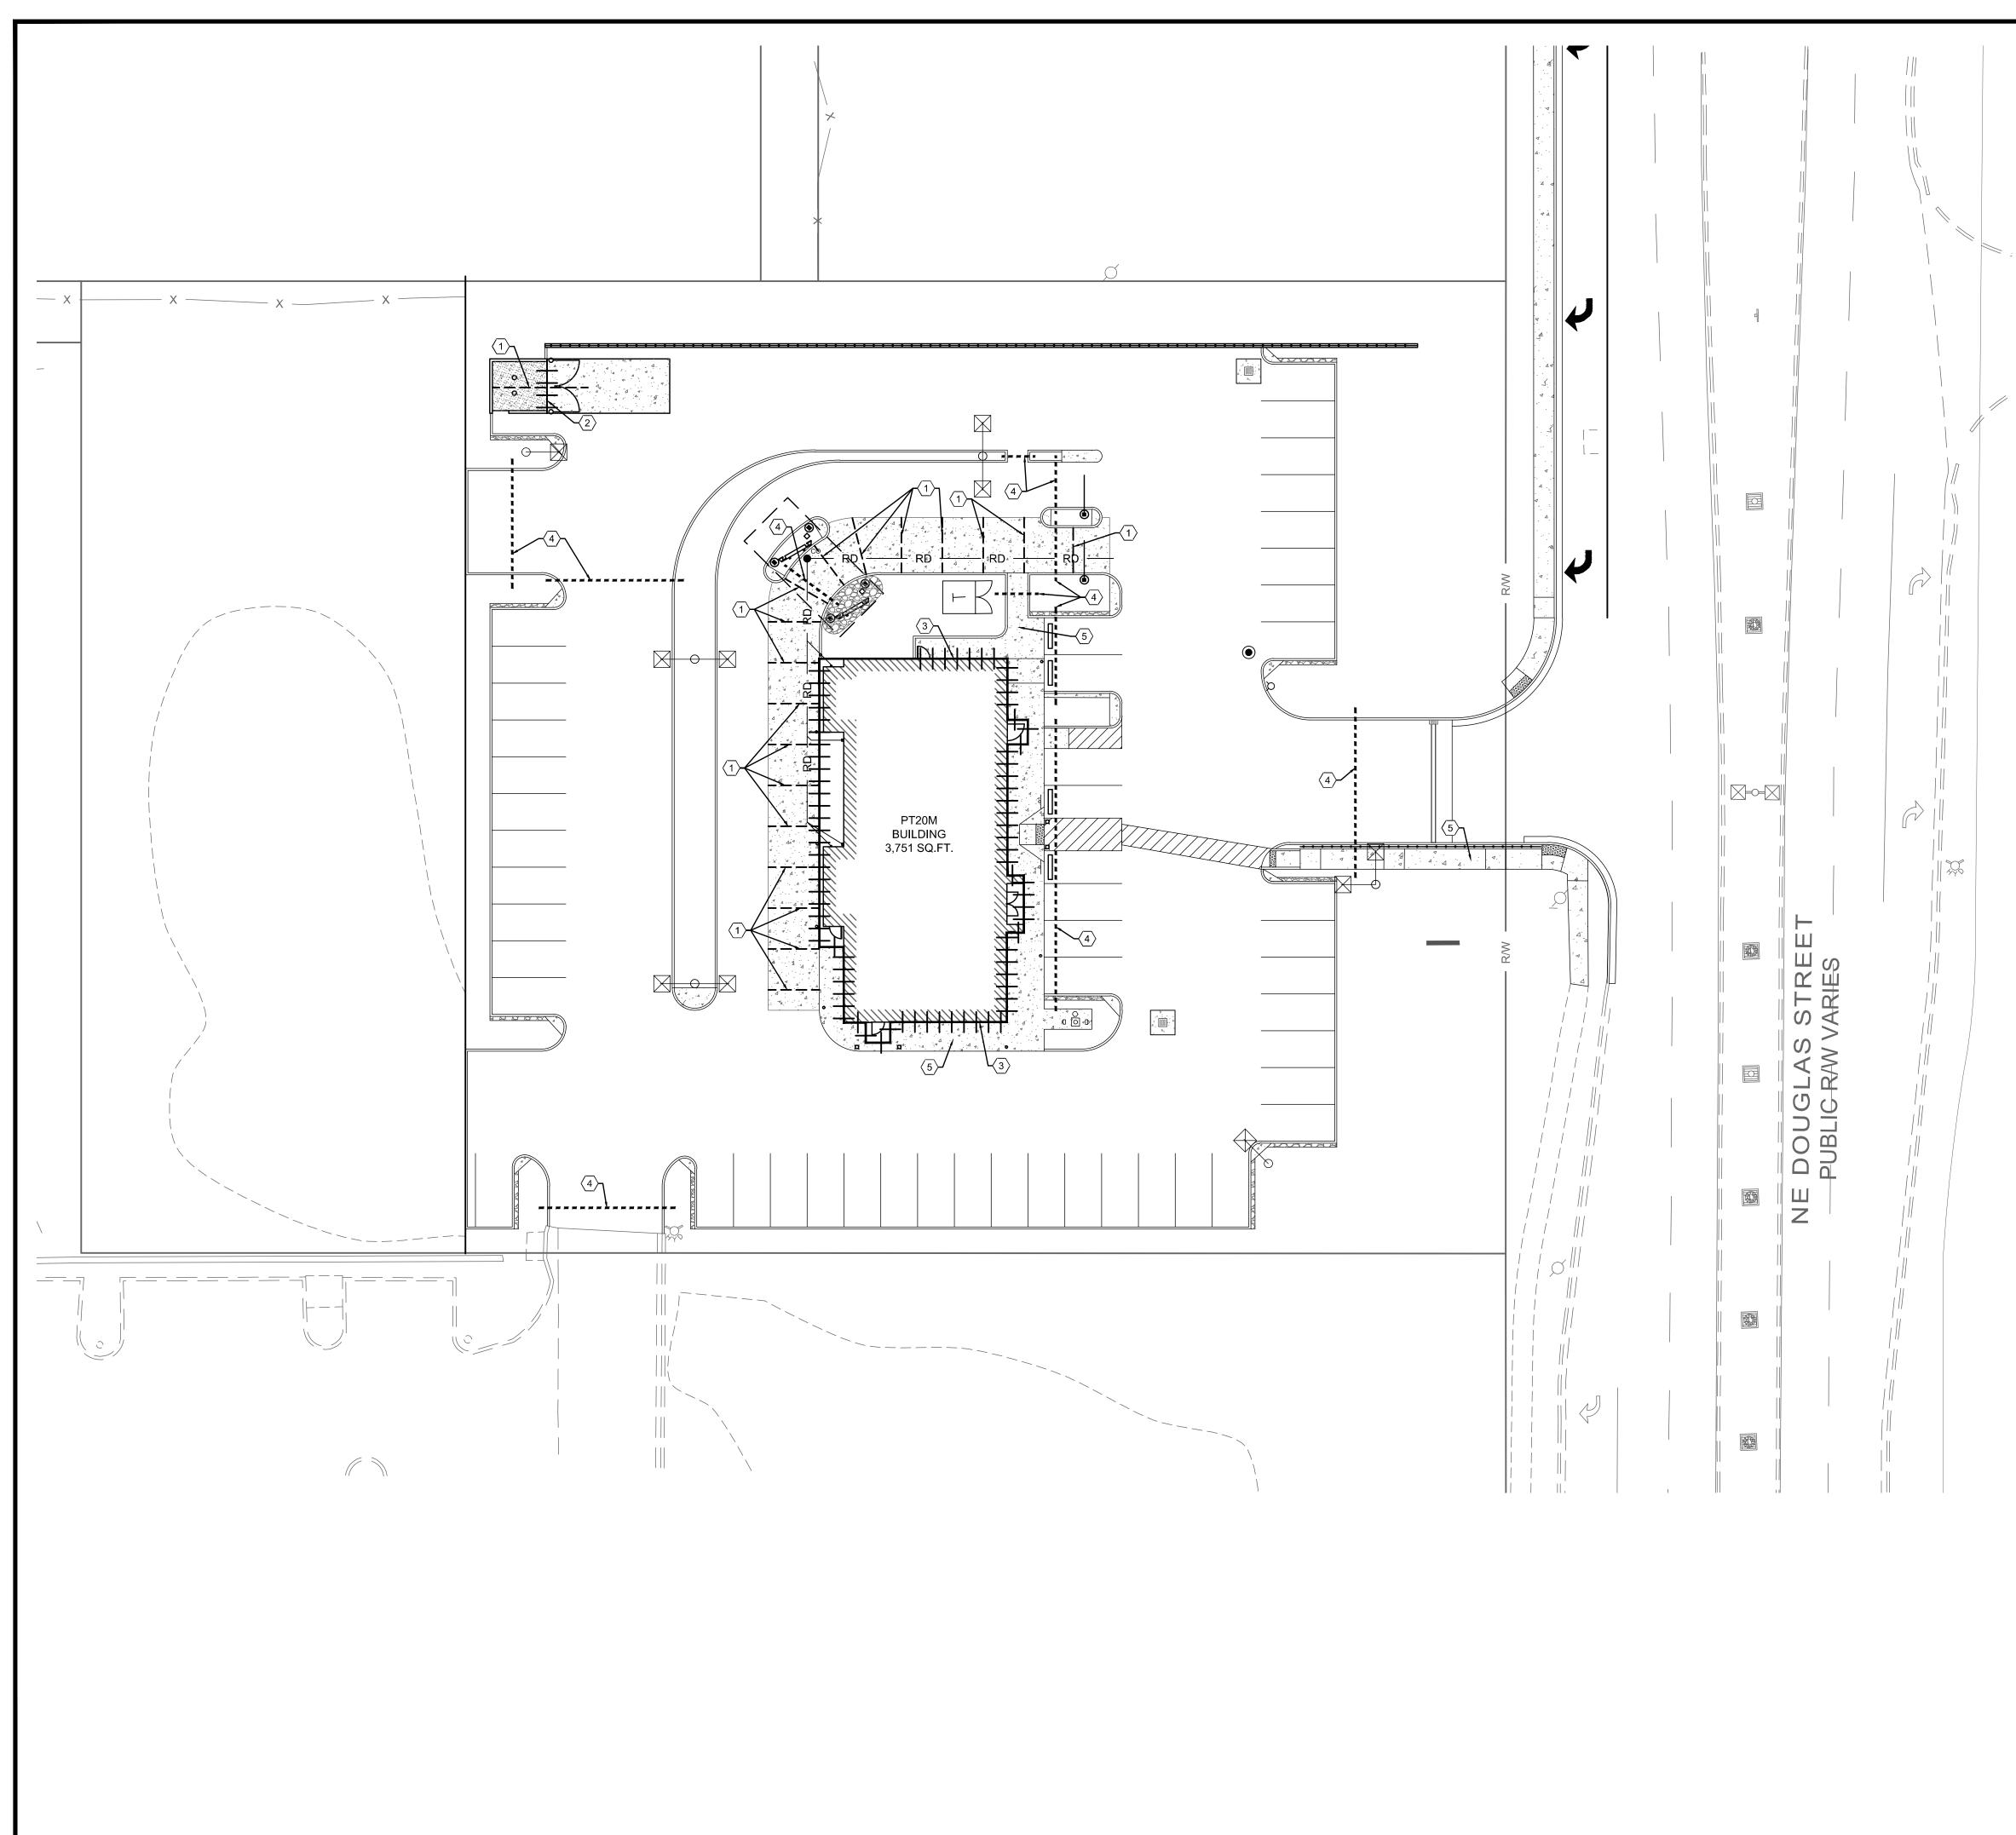

## **GENERAL NOTES:**

- A. PAVEMENT SPECIFICATION AND RECOMMENDATIONS ARE TAKEN FROM GEOTECHNICAL REPORT PROVIDED BY TERRACON CONSULTANTS, INC., PROJECT #02205198REV1, DATED SEPTEMBER 2, 2020.
- B. PORTLAND CEMENT CONCRETE SHALL HAVE A MINIMUM 28-DAY COMPRESSIVE STRENGTH OF 4,000 PSI.
- C. MAXIMUM CONTROL JOINT SPACING SHALL NOT EXCEED 12 FEET.
- D. EXPANSION JOINTS SHALL BE USED WHEREVER THE PAVEMENT WILL ABUT A STRUCTURAL ELEMENT SUBJECT TO DIFFERENT MAGNITUDE OF MOVEMENT (E.G., LIGHT POLES, RETAINING WALLS, EXISTING PAVEMENT, STAIRWAYS, ENTRYWAY PIERS, BUILDING WALLS, MANHOLES, ETC.)
- E. EXPANSION JOINTS SHALL BE SEALED PER DETAILS ON SHEET C-9 TO MINIMIZE MOISTURE INFILTRATION INTO SUBGRADE SOILS AND RESULTANT CONCRETE DETERIORATION AT THE JOINTS.
- F. SLEEVES SHOWN ARE FOR IRRIGATION ONLY. ADDITIONAL SLEEVES MAY BE REQUIRED FOR OTHER FRANCHISE UTILITIES. CONTRACTOR SHALL COORDINATE LOCATION AND SUPPLY ADDITIONAL SLEEVES REQUIRED FOR ELECTRICAL AND TELECOMMUNICATION SERVICES.
- G. ALL CONCRETE JOINTS SHALL RUN CONTINUOUSLY THROUGH CURBS.

## **KEYED NOTES:**

- SAWED CONSTRUCTION JOINT REQUIRED, TYPICAL. SEE DETAIL H ON SHEET C-9.
- (2) DOWELED EXPANSION JOINT REQUIRED, TYPICAL. SEE DETAIL H ON SHEET C-9.
- (3) EXPANSION JOINT REQUIRED WHERE CONCRETE OR CURB ABUTS BUILDING FOUNDATION, STORM STRUCTURE, FLUME, OR SIDEWALK OPENING. SEE DETAIL H ON SHEET C-9.
- (4) SCHEDULE 40 PVC IRRIGATION SLEEVE, COORDINATE WITH IRRIGATION PLAN.
- 5 FOR SIDEWALK JOINTING, SEE DETAILS ON SHEET C-9.

## LEGEND

PROPOSED	DESCRIPTION
	CONTRACTION JOINT
+++++++++++++++++++++++++++++++++++++++	EXPANSION JOINT
	4" SCHEDULE 40 PVC SLEE\ SEE IRRIGATION PLAN



is a communications system which was established to help prevent damage to underground facilities and to promote safety. Missouri One Call operators are on duty 24

hours a day, seven days a week. Missouri One Call provides a telephone number for contractors and the general public to call for notification of their intent to use equipment for excavation, grading, blasting, boring, demolition or other types of similar work.

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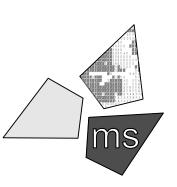
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#### PROJECT

WHATABURGER PT20M BUILDING

1460 NE DOUGLAS ST. LEE'S SUMMIT, MO 64086


#### SHEET TITLE

CONCRETE JOINTING PLAN


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DRAWN BY:	LLK/AMA

	LLN/AIVIA
CHECKED BY:	KEA
PROJECT NO:	40497-01
DRAWING	

C-5

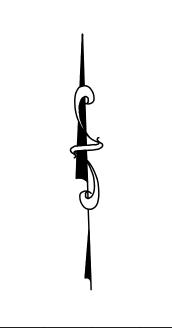

D 10 20 30 40 SCALE: 1"=20'

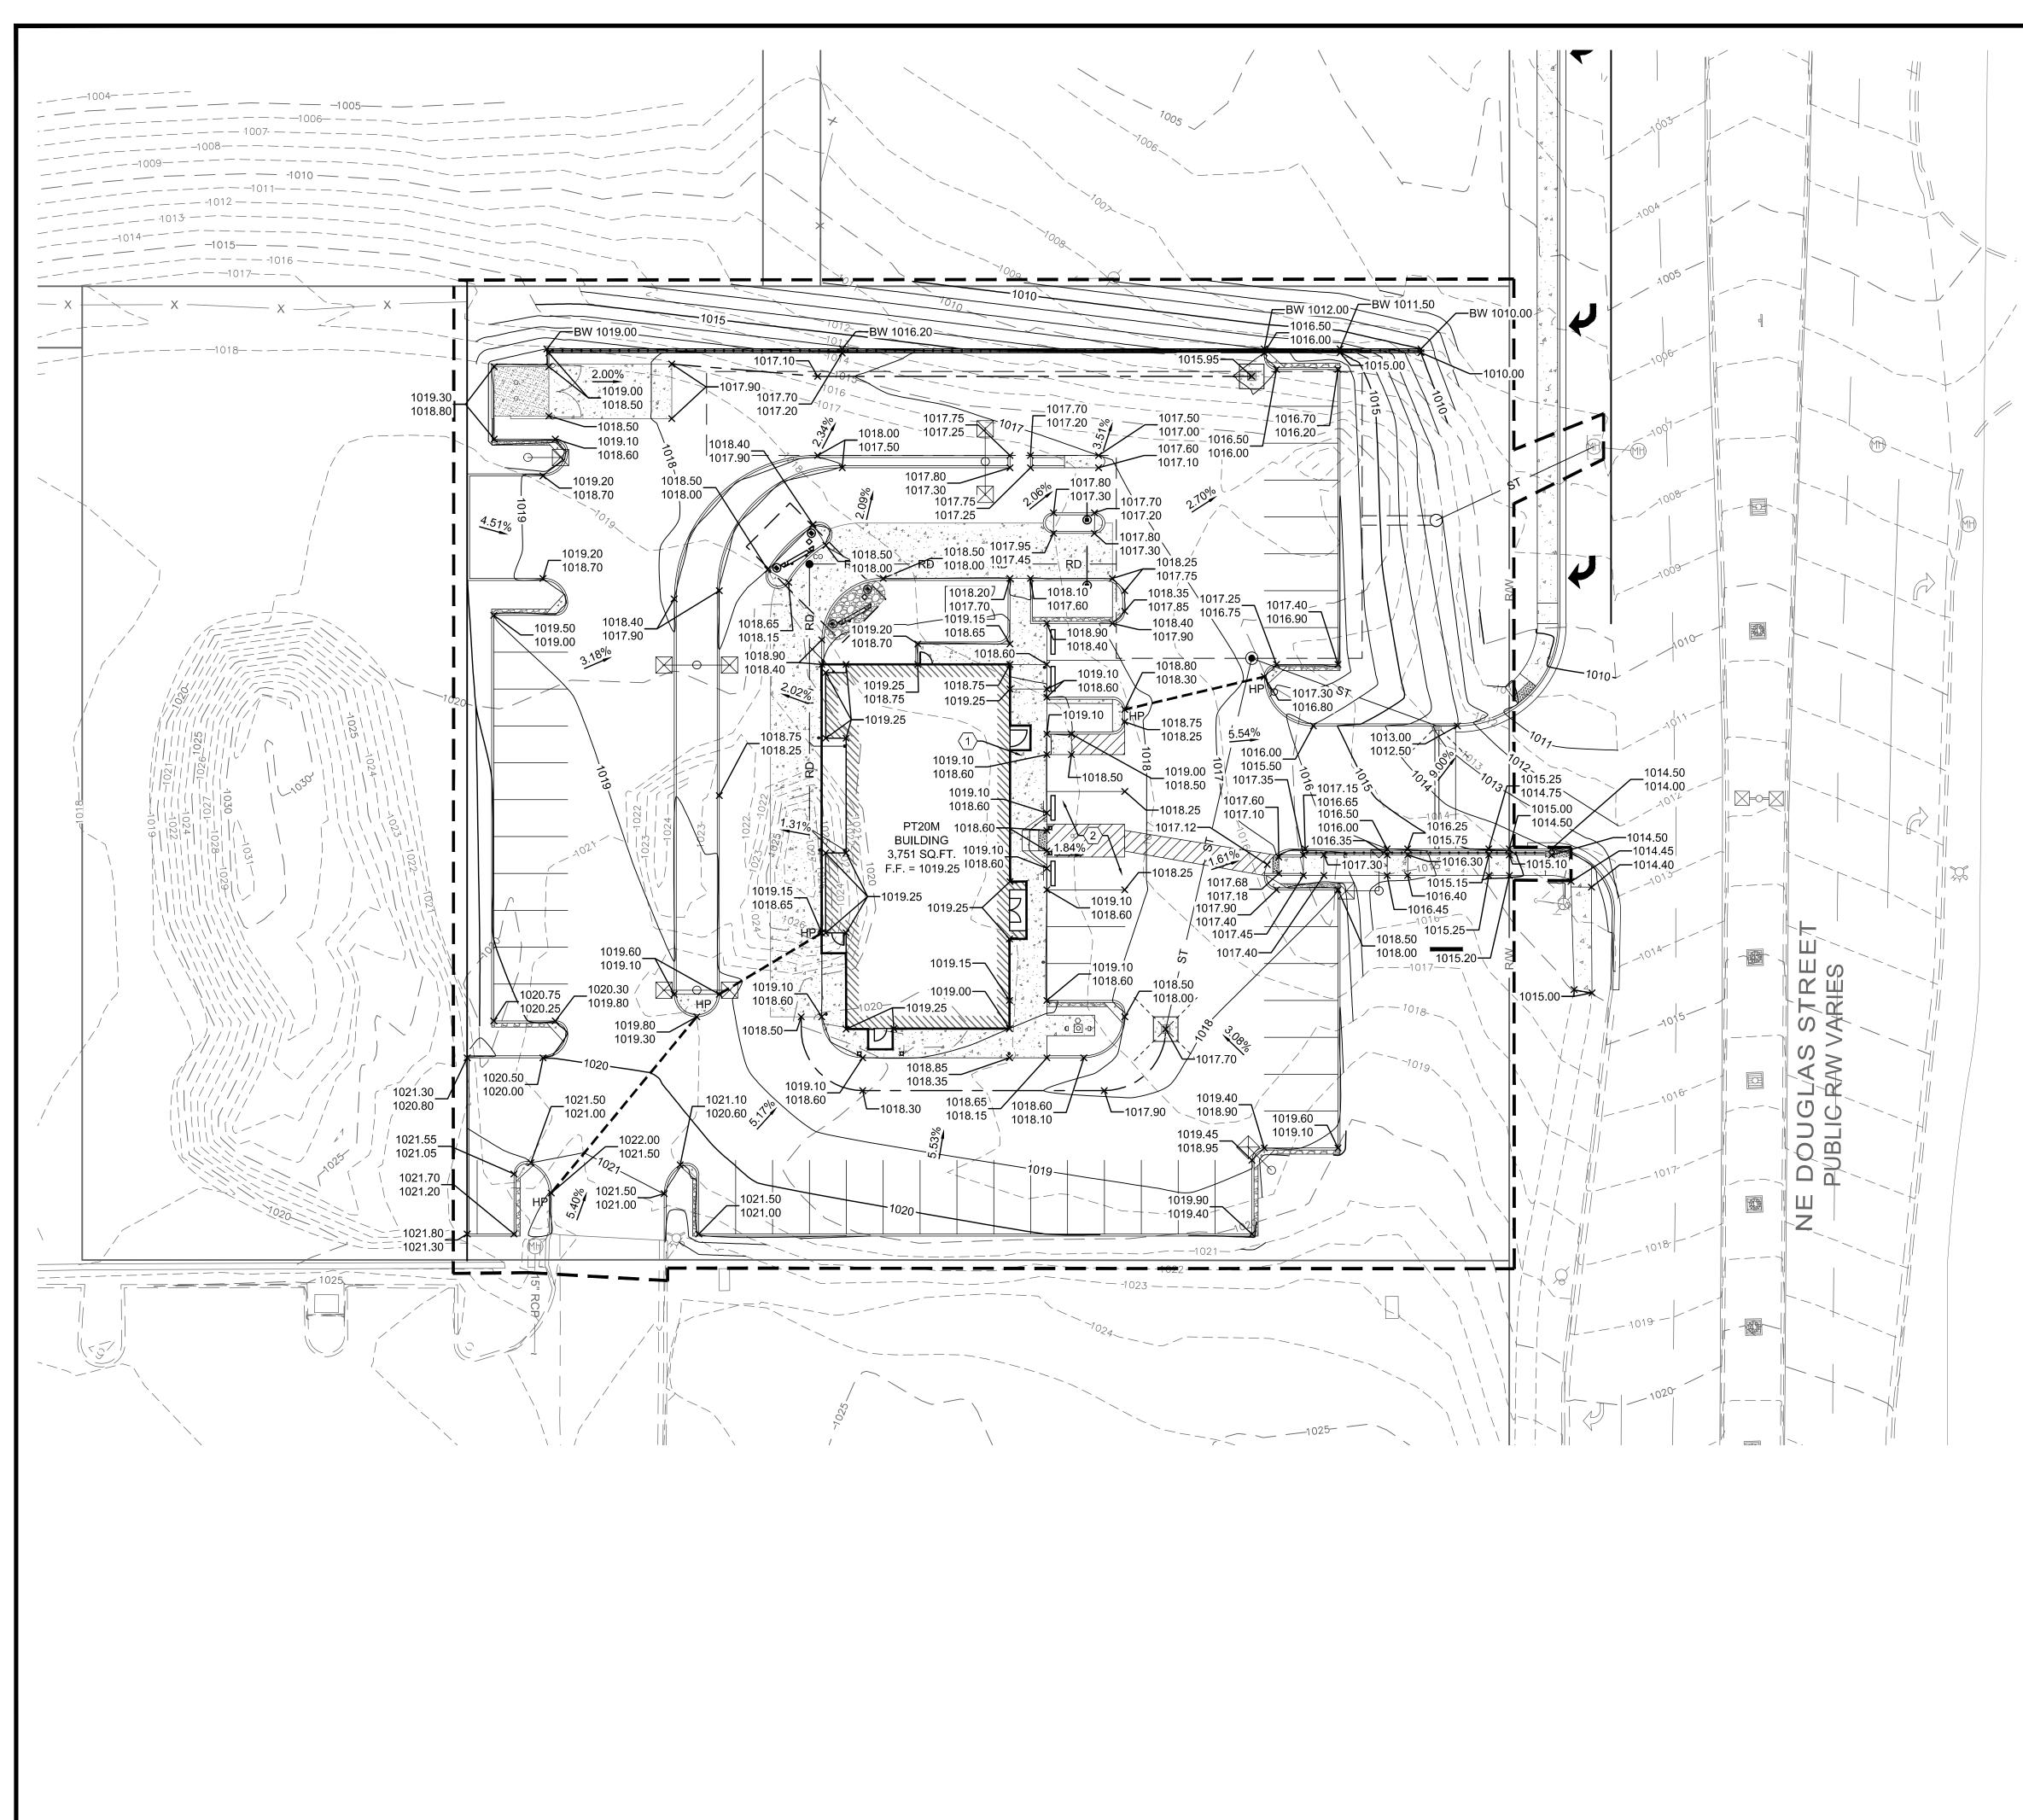

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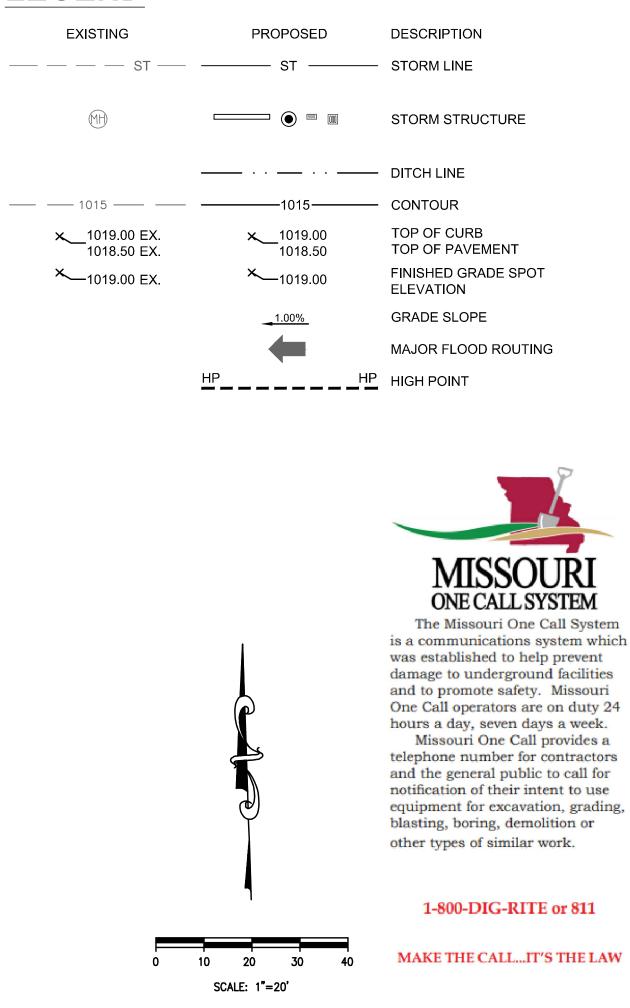
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- B. ALL CONSTRUCTION METHODS AND MATERIAL MUST CONFORM TO CURRENT STANDARDS AND SPECIFICATIONS OF THE FEDERAL, STATE, COUNTY, CITY OR LOCAL REQUIREMENTS, WHICHEVER HAS JURISDICTION.
- C. ALL PROPOSED SPOT ELEVATIONS SHOWN ARE TOP OF CURB AND FINAL GRADE ELEVATIONS UNLESS OTHERWISE NOTED.
- D. CONTRACTOR IS RESPONSIBLE FOR LOCATING AND VERIFYING ALL EXISTING UNDERGROUND UTILITIES PRIOR TO CONSTRUCTION.
   E. CONTRACTOR TO VERIFY ALL EXISTING GRADES AND CONTACT ENGINEER PRIOR TO
- BEGINNING WORK IF DISCREPANCY IS FOUND. CONTRACTOR TO VERIFY ASSUMED FINISHED FLOOR ELEVATION PRIOR TO BEGINNING WORK.F. THE EXCAVATING CONTRACTOR MUST TAKE PARTICULAR CARE WHEN EXCAVATING IN AND
- AROUND EXISTING UTILITY LINES AND EQUIPMENT. VERIFY COVER REQUIREMENTS BY UTILITY CONTRACTORS AND/OR UTILITY COMPANIES SO AS TO NOT CAUSE DAMAGE.
- G. THE CONTRACTOR SHALL NOTIFY ALL UTILITY COMPANIES 48 HOURS BEFORE CONSTRUCTION IS TO START, TO VERIFY IF ANY UTILITIES ARE PRESENT ON SITE. ALL VERIFICATIONS (LOCATION, SIZE AND DEPTH) SHALL BE MADE BY THE APPROPRIATE UTILITY COMPANIES. WHEN EXCAVATION IS AROUND OR OVER EXISTING UTILITIES, THE CONTRACTOR MUST NOTIFY THE UTILITY SO A REPRESENTATIVE OF THAT UTILITY COMPANY CAN BE PRESENT TO INSTRUCT AND OBSERVE DURING CONSTRUCTION.
- H. ALL WORK SHALL BE PERFORMED FROM PRIVATE PROPERTY. ALL TRAFFIC LANES MUST REMAIN OPEN AT ALL TIMES.
- I. CONTRACTOR IS RESPONSIBLE FOR ANY DAMAGE TO THE EXISTING UTILITIES DURING CONSTRUCTION AND ALL DAMAGE SHALL BE REPAIRED TO ORIGINAL CONDITION AT NO ADDITIONAL COST TO THE OWNER OR CITY.
- J. ALL EXISTING UTILITIES ARE TAKEN FROM SURVEY AND DO NOT NECESSARILY REPRESENT ALL UNDERGROUND UTILITIES ADJACENT TO OR UPON PREMISES SHOWN ON PLAN.

## **KEYED NOTES:**

- (1) CONTRACTOR TO MAINTAIN 2.00% MAX CROSS SLOPE ON SIDEWALK.
- (2) CONTRACTOR TO MAINTAIN MAX 2.00% SLOPE IN ALL DIRECTIONS IN HANDICAP ACCESSIBLE AREA.


## LEGEND



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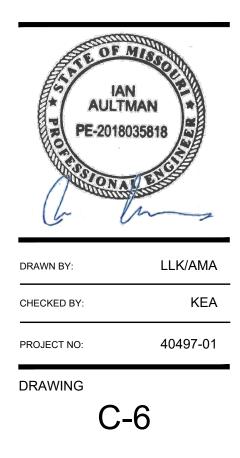
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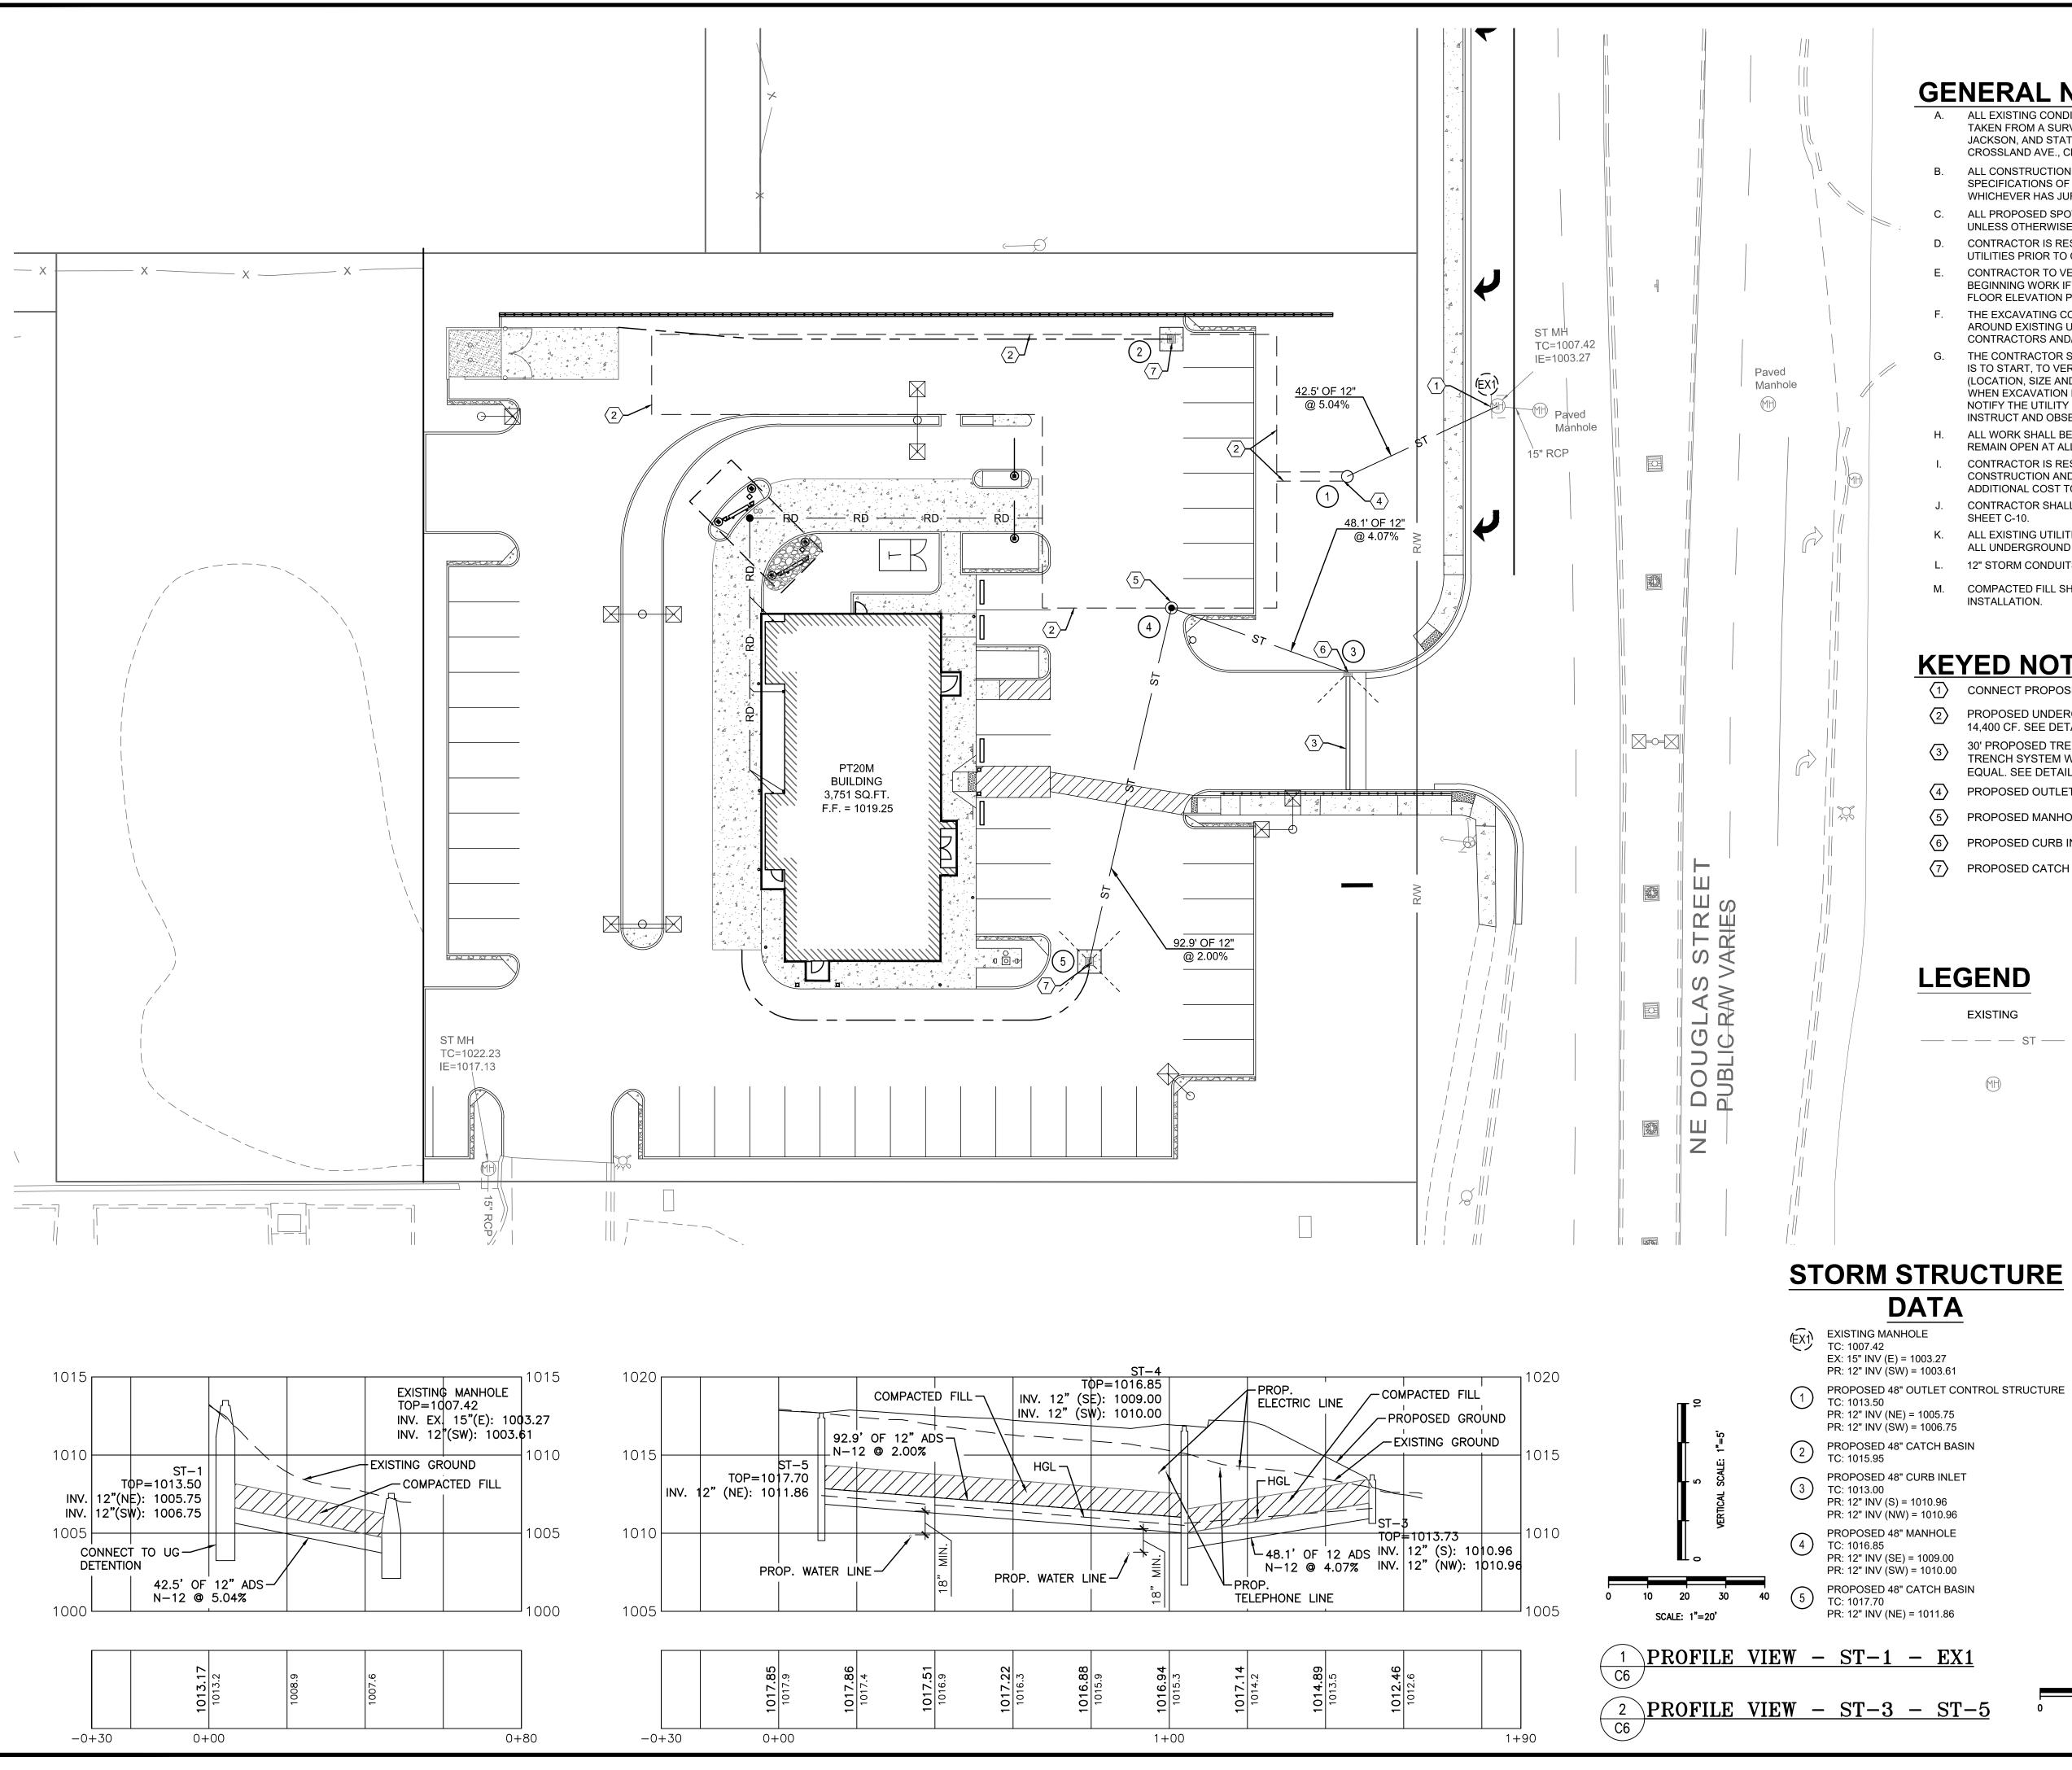
#### PROJECT

WHATABURGER PT20M BUILDING

1460 NE DOUGLAS ST. LEE'S SUMMIT, MO 64086
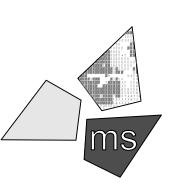
## SHEET TITLE SITE GRADING PLAN





60% Plan Set	10/20/20
90% Plan Set	11/17/20
100% Plan Set/Bid Set	12/16/20


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- B. ALL CONSTRUCTION METHODS AND MATERIAL MUST CONFORM TO CURRENT STANDARDS AND SPECIFICATIONS OF THE FEDERAL, STATE, COUNTY, CITY OR LOCAL REQUIREMENTS, WHICHEVER HAS JURISDICTION.
- ALL PROPOSED SPOT ELEVATIONS SHOWN ARE TOP OF CURB AND FINAL GRADE ELEVATIONS UNLESS OTHERWISE NOTED.
- CONTRACTOR IS RESPONSIBLE FOR LOCATING AND VERIFYING ALL EXISTING UNDERGROUND UTILITIES PRIOR TO CONSTRUCTION. CONTRACTOR TO VERIFY ALL EXISTING GRADES AND CONTACT ENGINEER PRIOR TO
- BEGINNING WORK IF DISCREPANCY IS FOUND. CONTRACTOR TO VERIFY ASSUMED FINISHED FLOOR ELEVATION PRIOR TO BEGINNING WORK.
- THE EXCAVATING CONTRACTOR MUST TAKE PARTICULAR CARE WHEN EXCAVATING IN AND AROUND EXISTING UTILITY LINES AND EQUIPMENT. VERIFY COVER REQUIREMENTS BY UTILITY CONTRACTORS AND/OR UTILITY COMPANIES SO AS TO NOT CAUSE DAMAGE.
- THE CONTRACTOR SHALL NOTIFY ALL UTILITY COMPANIES 48 HOURS BEFORE CONSTRUCTION IS TO START, TO VERIFY IF ANY UTILITIES ARE PRESENT ON SITE. ALL VERIFICATIONS (LOCATION, SIZE AND DEPTH) SHALL BE MADE BY THE APPROPRIATE UTILITY COMPANIES. WHEN EXCAVATION IS AROUND OR OVER EXISTING UTILITIES, THE CONTRACTOR MUST NOTIFY THE UTILITY SO A REPRESENTATIVE OF THAT UTILITY COMPANY CAN BE PRESENT TO INSTRUCT AND OBSERVE DURING CONSTRUCTION.
- ALL WORK SHALL BE PERFORMED FROM PRIVATE PROPERTY. ALL TRAFFIC LANES MUST REMAIN OPEN AT ALL TIMES.
- CONTRACTOR IS RESPONSIBLE FOR ANY DAMAGE TO THE EXISTING UTILITIES DURING CONSTRUCTION AND ALL DAMAGE SHALL BE REPAIRED TO ORIGINAL CONDITION AT NO ADDITIONAL COST TO THE OWNER OR CITY.
- CONTRACTOR SHALL INSTALL AND BACKFILL STRUCTURES AND TRENCHES PER DETAILS ON SHEET C-10.
- ALL EXISTING UTILITIES ARE TAKEN FROM SURVEY AND DO NOT NECESSARILY REPRESENT ALL UNDERGROUND UTILITIES ADJACENT TO OR UPON PREMISES SHOWN ON PLAN. 12" STORM CONDUITS ARE ADS N-12 SMOOTH INTERIOR HDPE PIPE OR APPROVED EQUAL.
- COMPACTED FILL SHALL BE PLACED A MINIMUM OF 18" ABOVE THE TOP OF PIPE PRIOR TO INSTALLATION.

## **KEYED NOTES:**

- (1) CONNECT PROPOSED STORM SYSTEM OUTLET TO EXISTING STORM SEWER SYSTEM.
- PROPOSED UNDERGROUND DETENTION, ADS STORMTECH MC-4500 CHAMBER SYSTEM, 14,400 CF. SEE DETAILS ON SHEETS C-12 AND C-13.
- 30' PROPOSED TRENCH DRAIN, 12" ACO S300K POWERDRAIN HEAVY DUTY MODULAR TRENCH SYSTEM WITH 878Q LONGITUDINAL DUCTILE IRON ADA GRATE, OR APPROVED EQUAL. SEE DETAILS ON SHEET C-13.
- PROPOSED OUTLET CONTROL STRUCTURE. SEE DETAILS ON SHEET C-10.
- PROPOSED MANHOLE. SEE DETAILS ON SHEET C-13.1.
- PROPOSED CURB INLET. SEE DETAIL ON SHEET C-13.1.
- PROPOSED CATCH BASIN WITH CONCRETE COLLAR. SEE DETAILS ON SHEET C-10.

# LEGEND

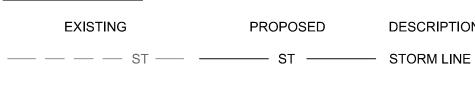

DESCRIPTION

STORM STRUCTURE

PROPOSED 48" OUTLET CONTROL STRUCTURE



0 10 20 30 SCALE: 1"=20'



is a communications system which was established to help prevent damage to underground facilities and to promote safety. Missouri One Call operators are on duty 24 hours a day, seven days a week. Missouri One Call provides a telephone number for contractors and the general public to call for

notification of their intent to use equipment for excavation, grading, blasting, boring, demolition or other types of similar work.


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#### MAKE THE CALL ... IT'S THE LAW

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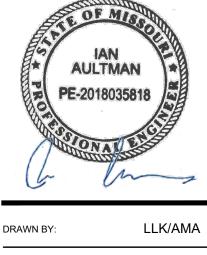
#### PROJECT

WHATABURGER PT20M BUILDING

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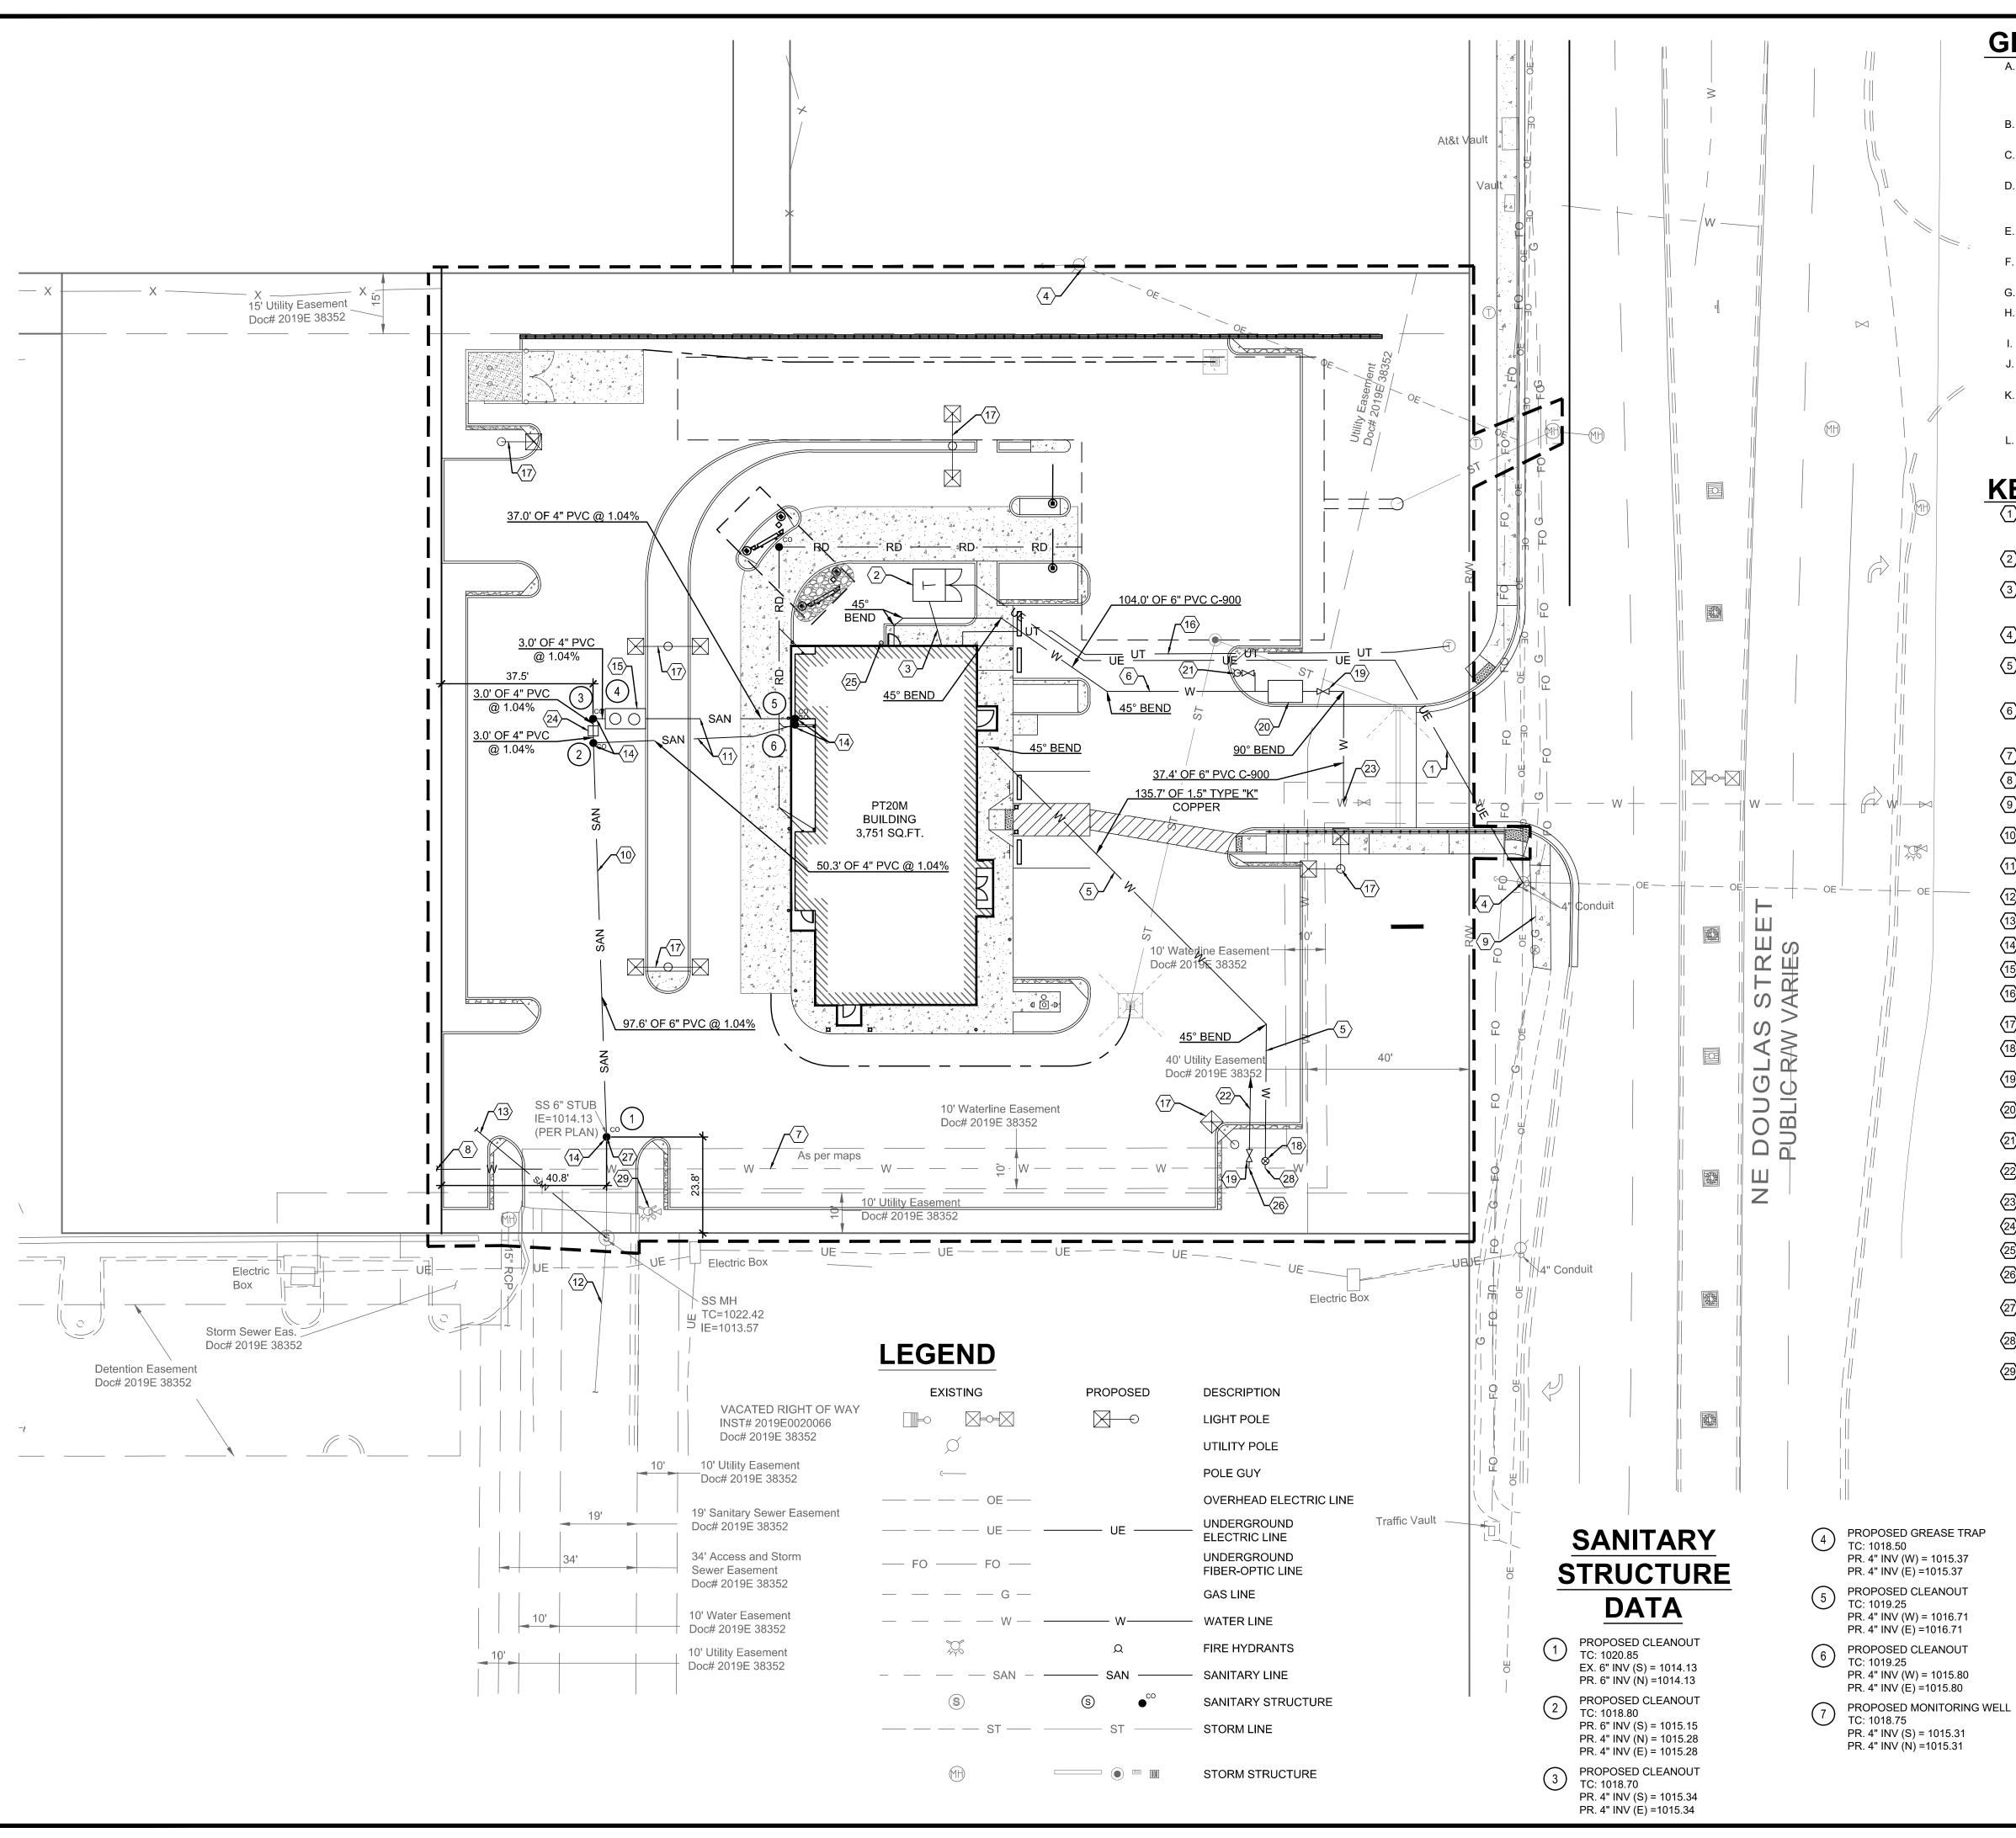
## SHEET TITLE STORM SEWER

# PLAN

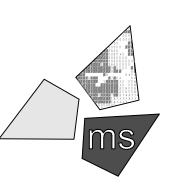

CHECKED BY:	KEA
PROJECT NO:	40497-01
DRAWING	

C-6.




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- ALL EXISTING UTILITIES, ARE TAKEN FROM SURVEY AND DO NOT NECESSARILY REPRESENT ALL UNDERGROUND UTILITIES ADJACENT TO OR UPON PREMISES SHOWN ON PLAN.
- CONTRACTOR RESPONSIBLE FOR MAINTAINING A MIN. COVER OF 42" OVER PROPOSED WATER
- SERVICE. CONTRACTOR IS RESPONSIBLE FOR LOCATING AND VERIFYING ALL EXISTING UNDERGROUND
- UTILITIES PRIOR TO CONSTRUCTION, AND IS RESPONSIBLE FOR ANY DAMAGE TO THEM DURING CONSTRUCTION.
- CLEANOUT LOCATIONS ARE NUMBERED ON PLAN. ALL CLEANOUTS IN PAVEMENT AREAS ARE TO BE H-20 RATED. CLEANOUTS SHALL BE INSTALLED PER DETAIL ON SHEET C-10. CONTRACTOR IS RESPONSIBLE FOR LOCATING THE EXISTING UTILITY LINES. PROPOSED UTILITIES SHOULD TIE INTO EXISTING UTILITIES AT A POINT INDICATED ON PLANS.
- G. SEE PLUMBING PLANS FOR CONTINUATION OF UTILITY LINES INTO BUILDING.
- CONTRACTOR SHALL INSTALL AND BACKFILL ALL TRENCHES AND STRUCTURES PER DETAIL
- ON SHEET C-10. STORM SEWER SHOWN HERE FOR REFERENCE ONLY. SEE GRADING PLAN FOR DESIGN DATA.
- THERE SHALL BE A MINIMUM 18" SEPARATION BETWEEN WATER TAPS, WATER SERVICES, PRIVATE WATER SYSTEMS, AND SANITARY AND/OR STORM SEWER SYSTEMS.
- THE EXCAVATING CONTRACTOR MUST TAKE PARTICULAR CARE WHEN EXCAVATING IN AND AROUND EXISTING UTILITY LINES AND EQUIPMENT. VERIFY COVER REQUIREMENTS BY UTILITY CONTRACTORS AND/OR UTILITY COMPANIES SO AS TO NOT CAUSE DAMAGE.
- CAUTION: OVERHEAD LINES ARE PRESENT ON SITE. CONTRACTOR TO TAKE SPECIAL CARE TO PREVENT DAMAGE TO THE LINES AND COORDINATE WITH UTILITY OWNER.

## **KEYED NOTES:**

- PROPOSED PRIMARY ELECTRICAL SERVICE. CONTRACTOR TO COORDINATE CONDUIT SIZE, NUMBER OF CONDUITS, CONNECTIONS, AND BEND RADII WITH UTILITY OWNER AND MEP PLANS. CONTRACTOR TO COORDINATE CONNECTION WITH UTILITY OWNER.
- PROPOSED ELECTRIC TRANSFORMER. COORDINATE LOCATION WITH UTILITY OWNER AND ELECTRICAL PLANS.
- PROPOSED SECONDARY ELECTRICAL SERVICE. CONTRACTOR TO COORDINATE CONDUIT SIZE, (3) NUMBER OF CONDUITS, CONNECTIONS, AND BEND RADII WITH UTILITY OWNER AND MEP PLANS. CONTRACTOR TO COORDINATE CONNECTION WITH UTILITY OWNER.
- EXISTING POWER POLE TO REMAIN. CONTRACTOR TO TAKE CARE NOT TO DISTURB EXISTING  $\langle 4 \rangle$ POLE AND GUY WIRES.
- PROPOSED SOFT TYPE "K" COPPER 1.5" DOMESTIC WATER SERVICE. INCLUDE IN BASE BID ALL VALVES, PIPING, STRUCTURES, ETC. THAT WILL BE REQUIRED. SEE MEP PLANS FOR CONTINUATION INTO BUILDING.
- PROPOSED PVC C900 6" FIRE SERVICE. INCLUDE IN BASE BID ALL VALVES, PIPING,  $\langle 6 \rangle$ STRUCTURES, ETC. THAT WILL BE REQUIRED. SEE MEP PLANS FOR CONTINUATION INTO BUILDING.
- $\langle 7 \rangle$ EXISTING PRIVATE WATER MAIN.
- PROPOSED PRIVATE WATER MAIN EXTENSION BY DEVELOPER.
- EXISTING GAS MAIN. CONTRACTOR TO TAKE CARE EXCAVATING NEAR MAIN AND CONTACT ENGINEER IF ELEVATION OF GAS LINE INTERFERES WITH UTILITY CONNECTIONS.
- PROPOSED 6" SANITARY SEWER. ASTM D3034, SDR-26. SEWER TO HAVE MINIMUM SLOPE OF 1.04%. CONTRACTOR TO MAINTAIN A MINIMUM OF 36" OF COVER OVER SEWER LINES. PROPOSED 4" SANITARY SEWER. ASTM D3034, SDR-26. SEWER TO HAVE MINIMUM SLOPE OF
- 1.04%. CONTRACTOR TO MAINTAIN A MINIMUM OF 36" OF COVER OVER SEWER LINES. (12) EXISTING SANITARY SEWER MAIN.
- (13) PROPOSED SANITARY SEWER MAIN EXTENSION BY DEVELOPER.
- $\langle 14 \rangle$ PROPOSED SANITARY CLEANOUT (TYP.). SEE DETAIL ON SHEET C-10.
- (15) GREASE TRAP REQUIRED. SEE PLUMBING SHEETS FOR DETAILS.
- (16) 2" PVC CONDUIT FOR UNDERGROUND TELEPHONE SERVICE. CONTRACTOR TO COORDINATE WITH UTILITY OWNER.
- SITE LIGHT, SEE PHOTOMETRIC LIGHTING PLAN. (17)
- PROPOSED DOMESTIC 1.5" WATER METER PER CITY OF LEE'S SUMMIT STANDARD DRAWING
- WAT-11, SEE SHEET C-11. PROPOSED GATE VALVE PER CITY OF LEE'S SUMMIT STANDARD DRAWING WAT-9, SEE SHEET (19) C-11.
- 20 PROPOSED BACKFLOW PREVENTER VAULT PER CITY OF LEE'S SUMMIT STANDARD DRAWING WAT-12, SEE SHEET C-11.
- PROPOSED FIRE HYDRANT RELOCATION. HYDRANT TO BE INSTALLED PER CITY OF LEE'S SUMMIT STANDARD DRAWING WAT-8, SEE SHEET C-11.
- PROPOSED 1" IRRIGATION LINE WITH 1" METER IN VAULT, SEE IRRIGATION PLAN FOR MORE 22 INFORMATION.
- 23 FIRE SERVICE TAP CONNECTION PER CITY OF LEE'S SUMMIT STANDARD ITEM 6901.
- 24 MONITORING WELL, SEE PLUMBING PLANS FOR DETAILS.
- (25) FIRE DEPARTMENT CONNECTION PER LOCAL REGULATIONS.
- 26 DOMESTIC WATER TAP WITH SADDLE, COPORATION STOP, AND METER PER CITY OF LEE'S SUMMIT STANDARD DRAWING WAT-11, SEE SHEET C-11.
- 27 PROPOSED SANITARY CONNECTION PER CITY OF LEE'S SUMMIT STANDARD SPECIFICATION 3502
- **28** PROPOSED WATER CONNECTION PER CITY OF LEE'S SUMMIT STANDARD SPECIFICATION SECTION 6900.
- 29 EXISTING FIRE HYDRANT TO REMAIN.

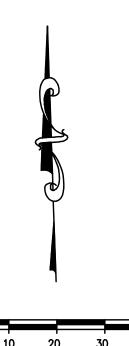

20 30 SCALE: 1"=20'

MISSOUR ONE CALL SYSTEM The Missouri One Call System

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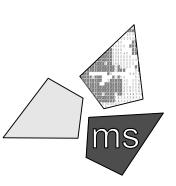
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#### PROJECT

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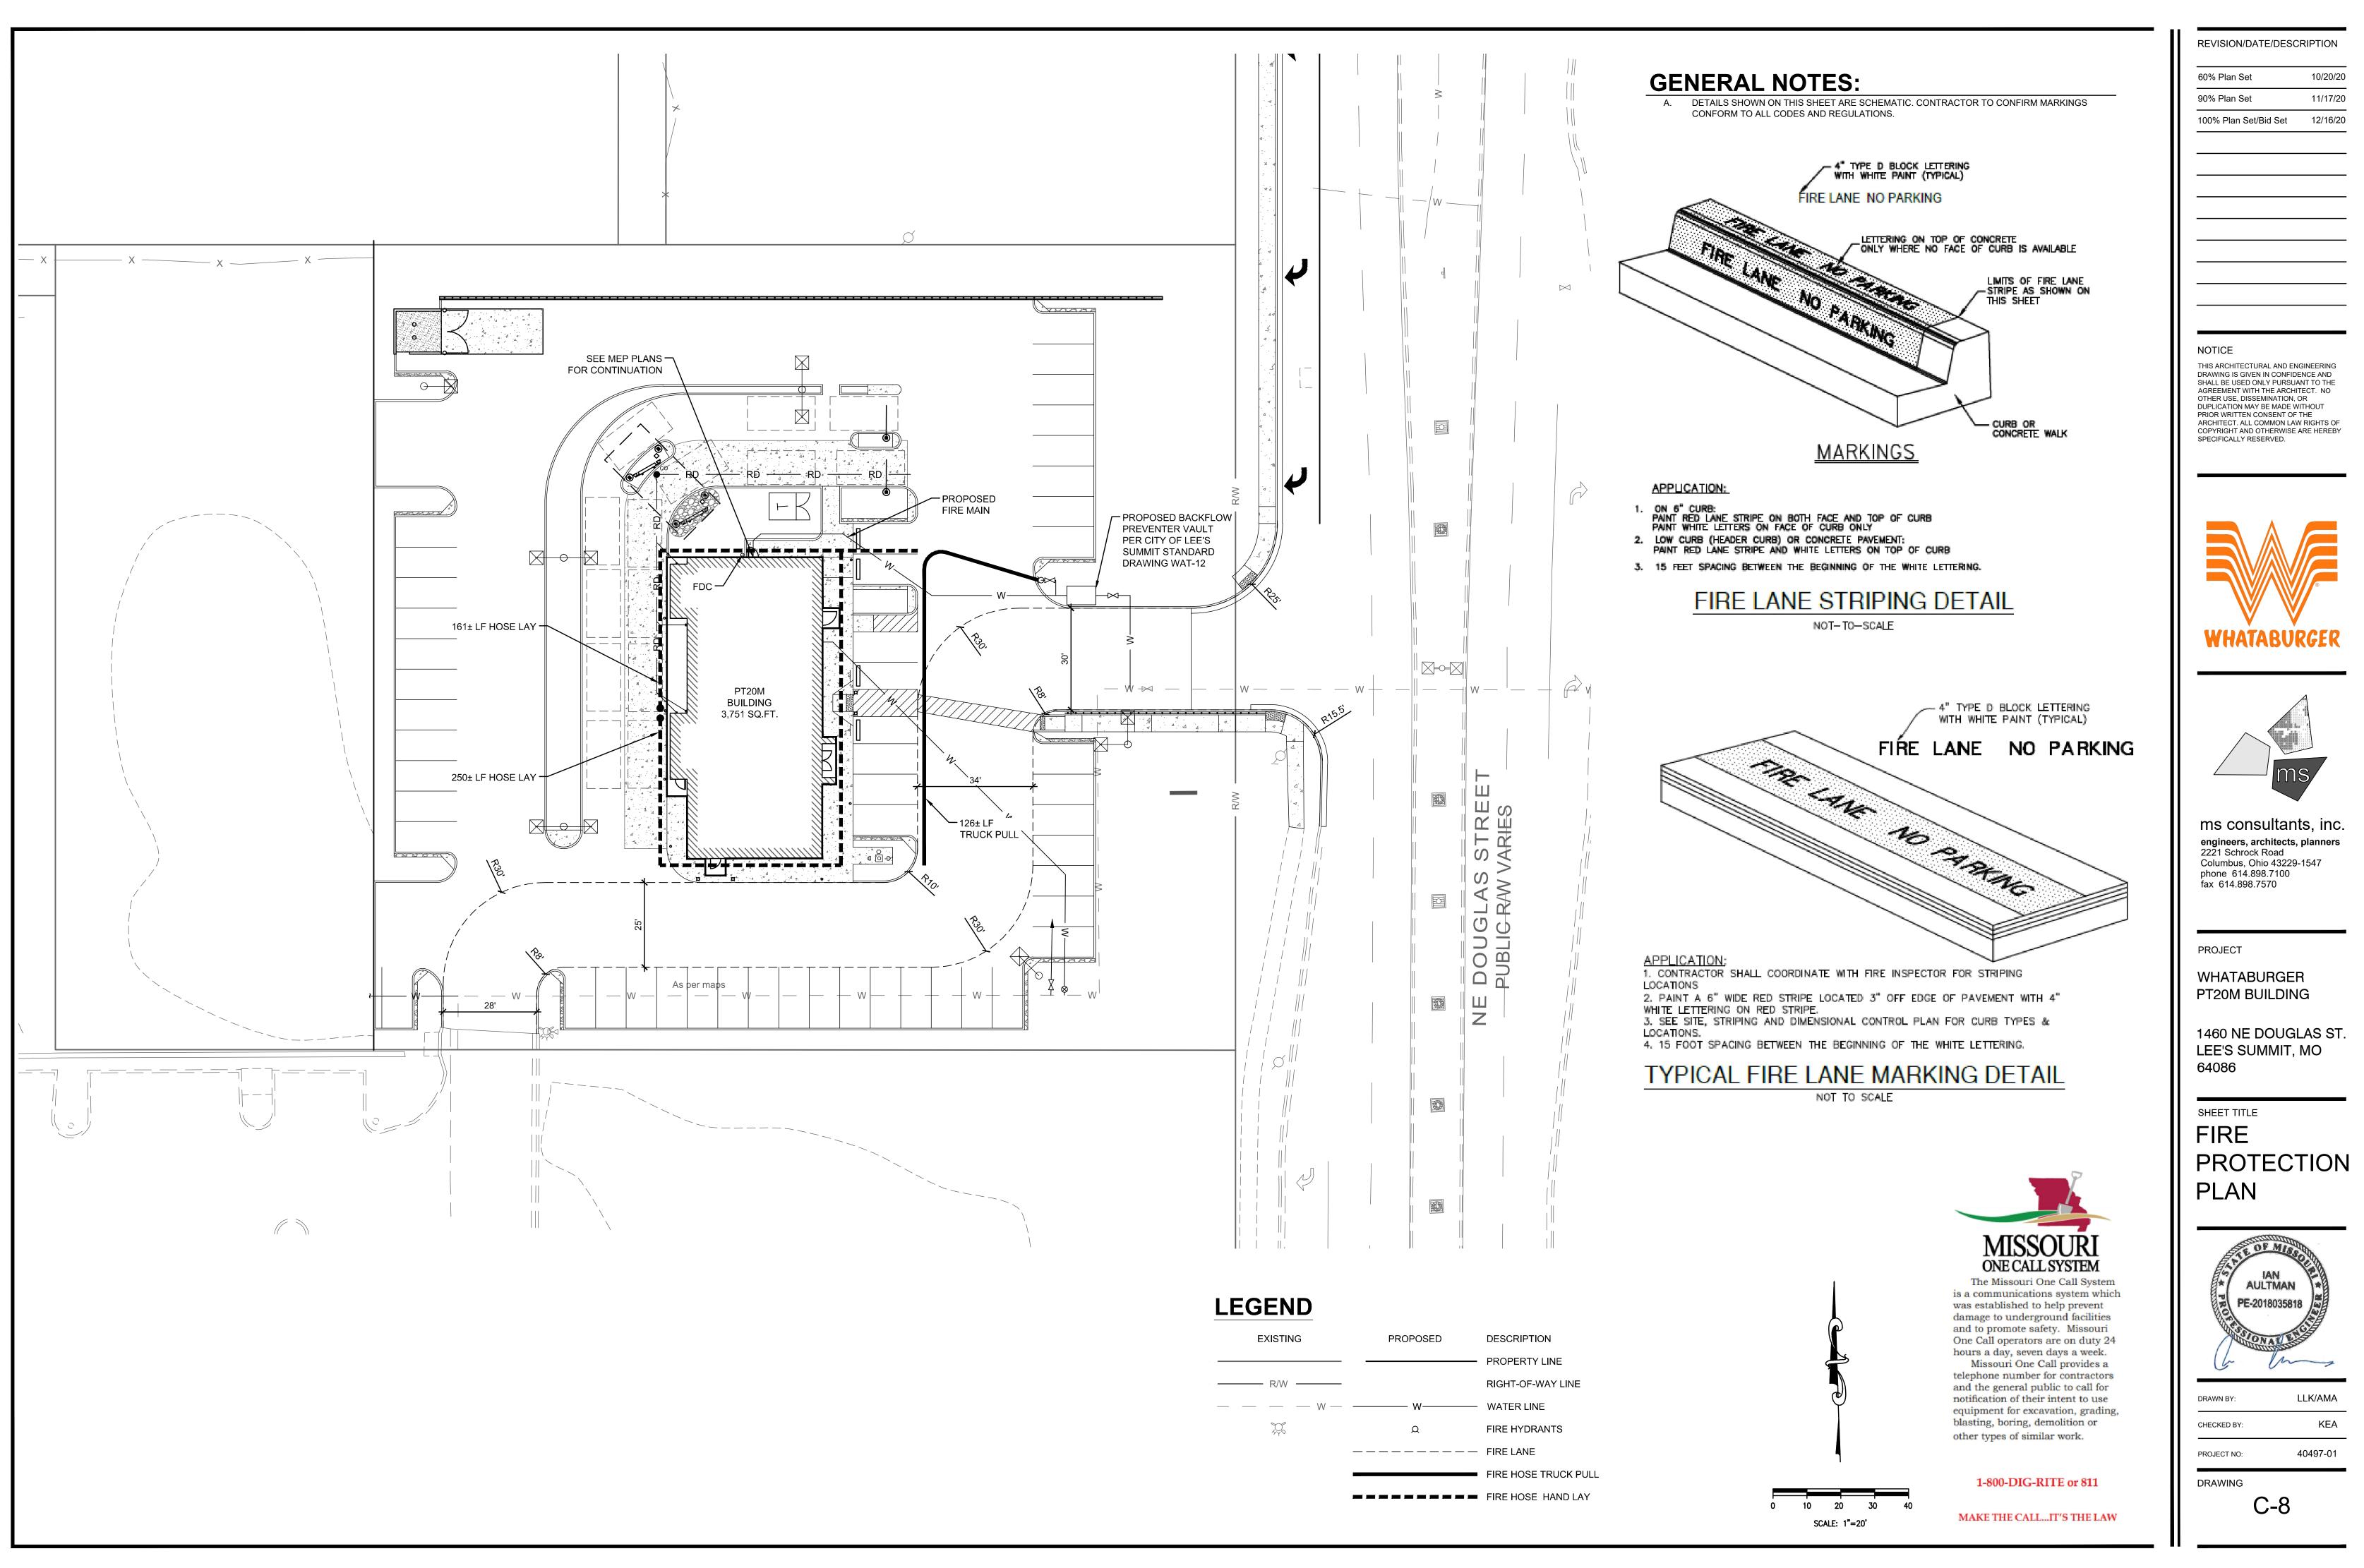
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## SHEET TITLE SITE UTILITY PLAN


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DRAWN BY:	LLK/AMA

CHECKED BY:	KEA
PROJECT NO:	40497-01
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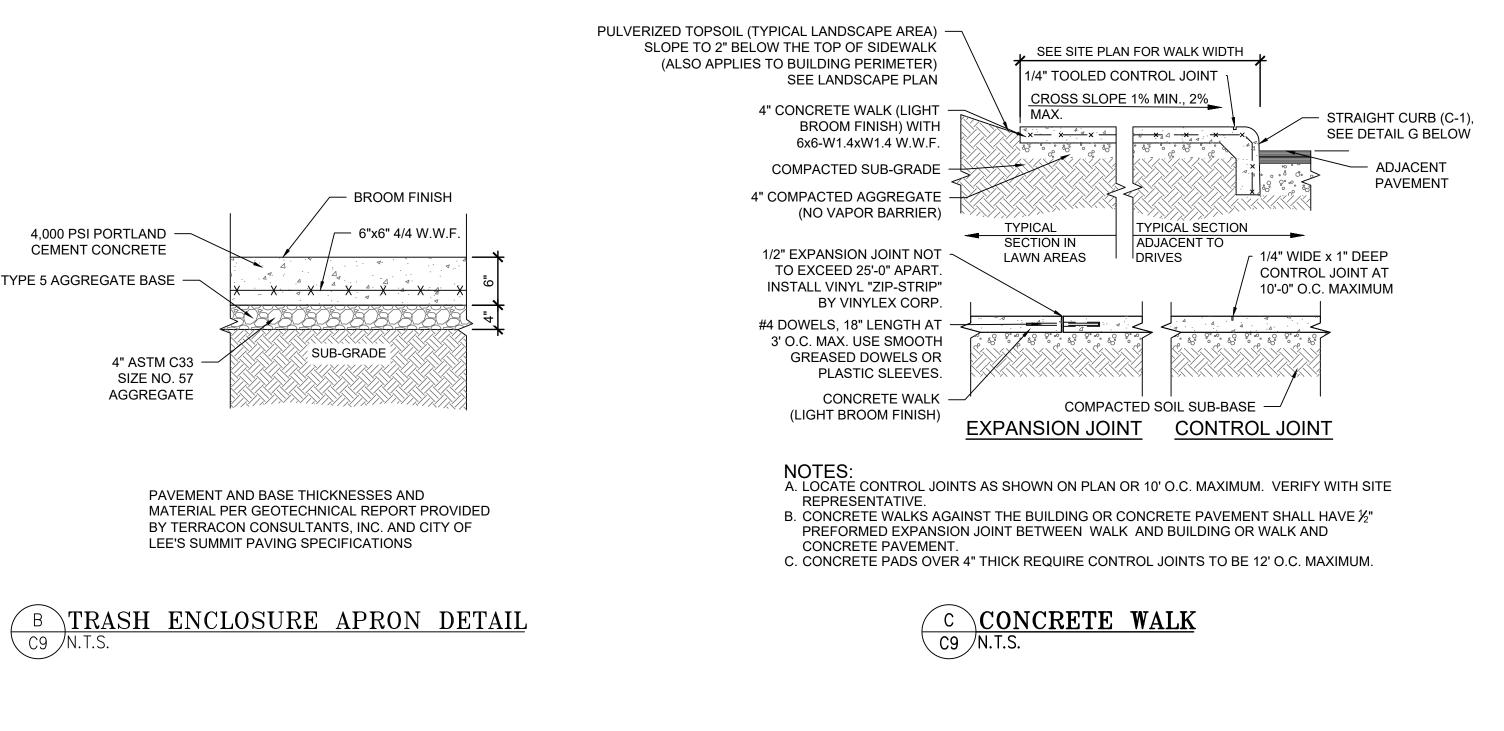
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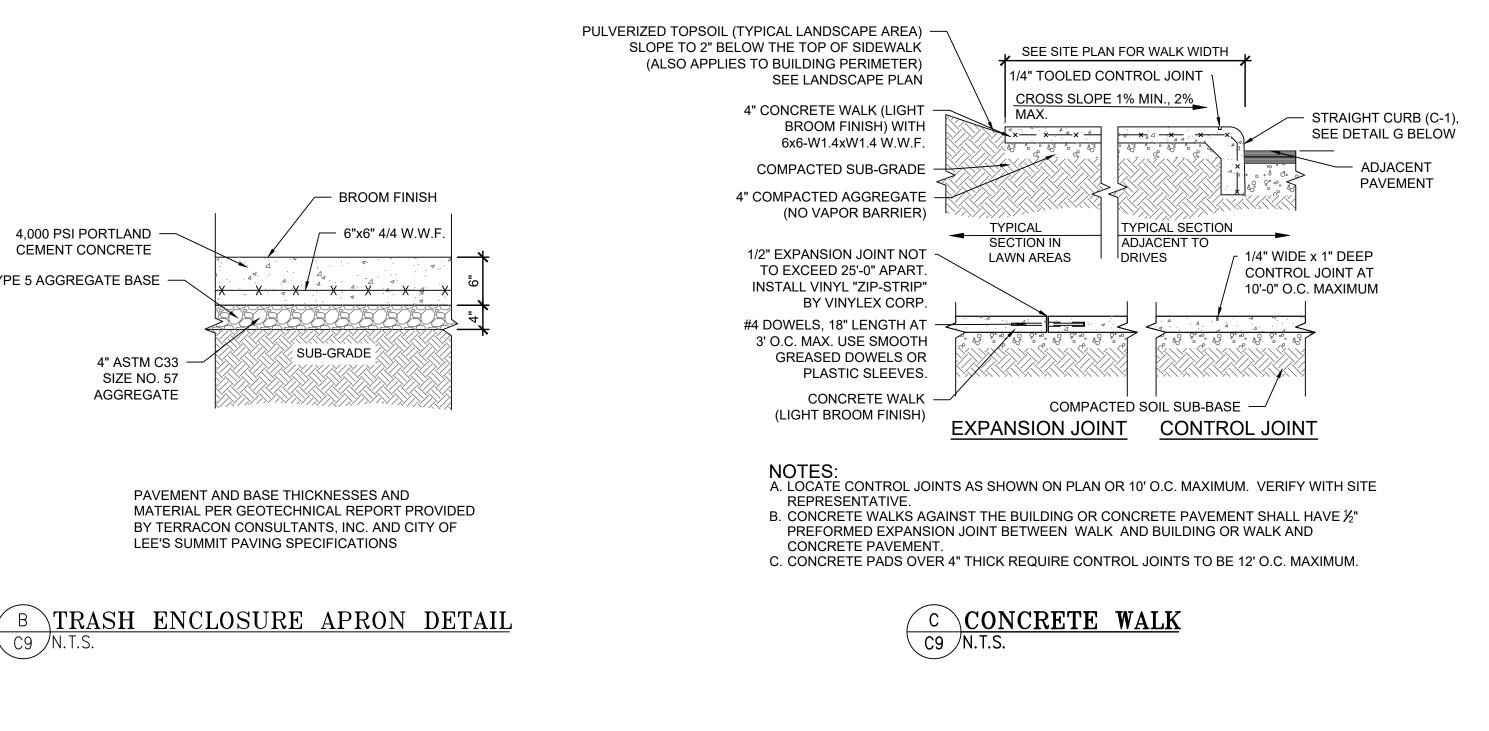



#### NOTES


- A. SUBGRADE COMPACTION: CBR= 5
- B. BASE COURSE TO CONFORM TO CITY OF LEE'S SUMMIT STANDARDS FOR BASE COURSE
- REQUIREMENTS OF THE CURRENT CITY OF LEE'S SUMMIT SPECIFICATIONS



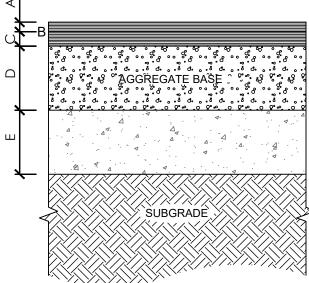




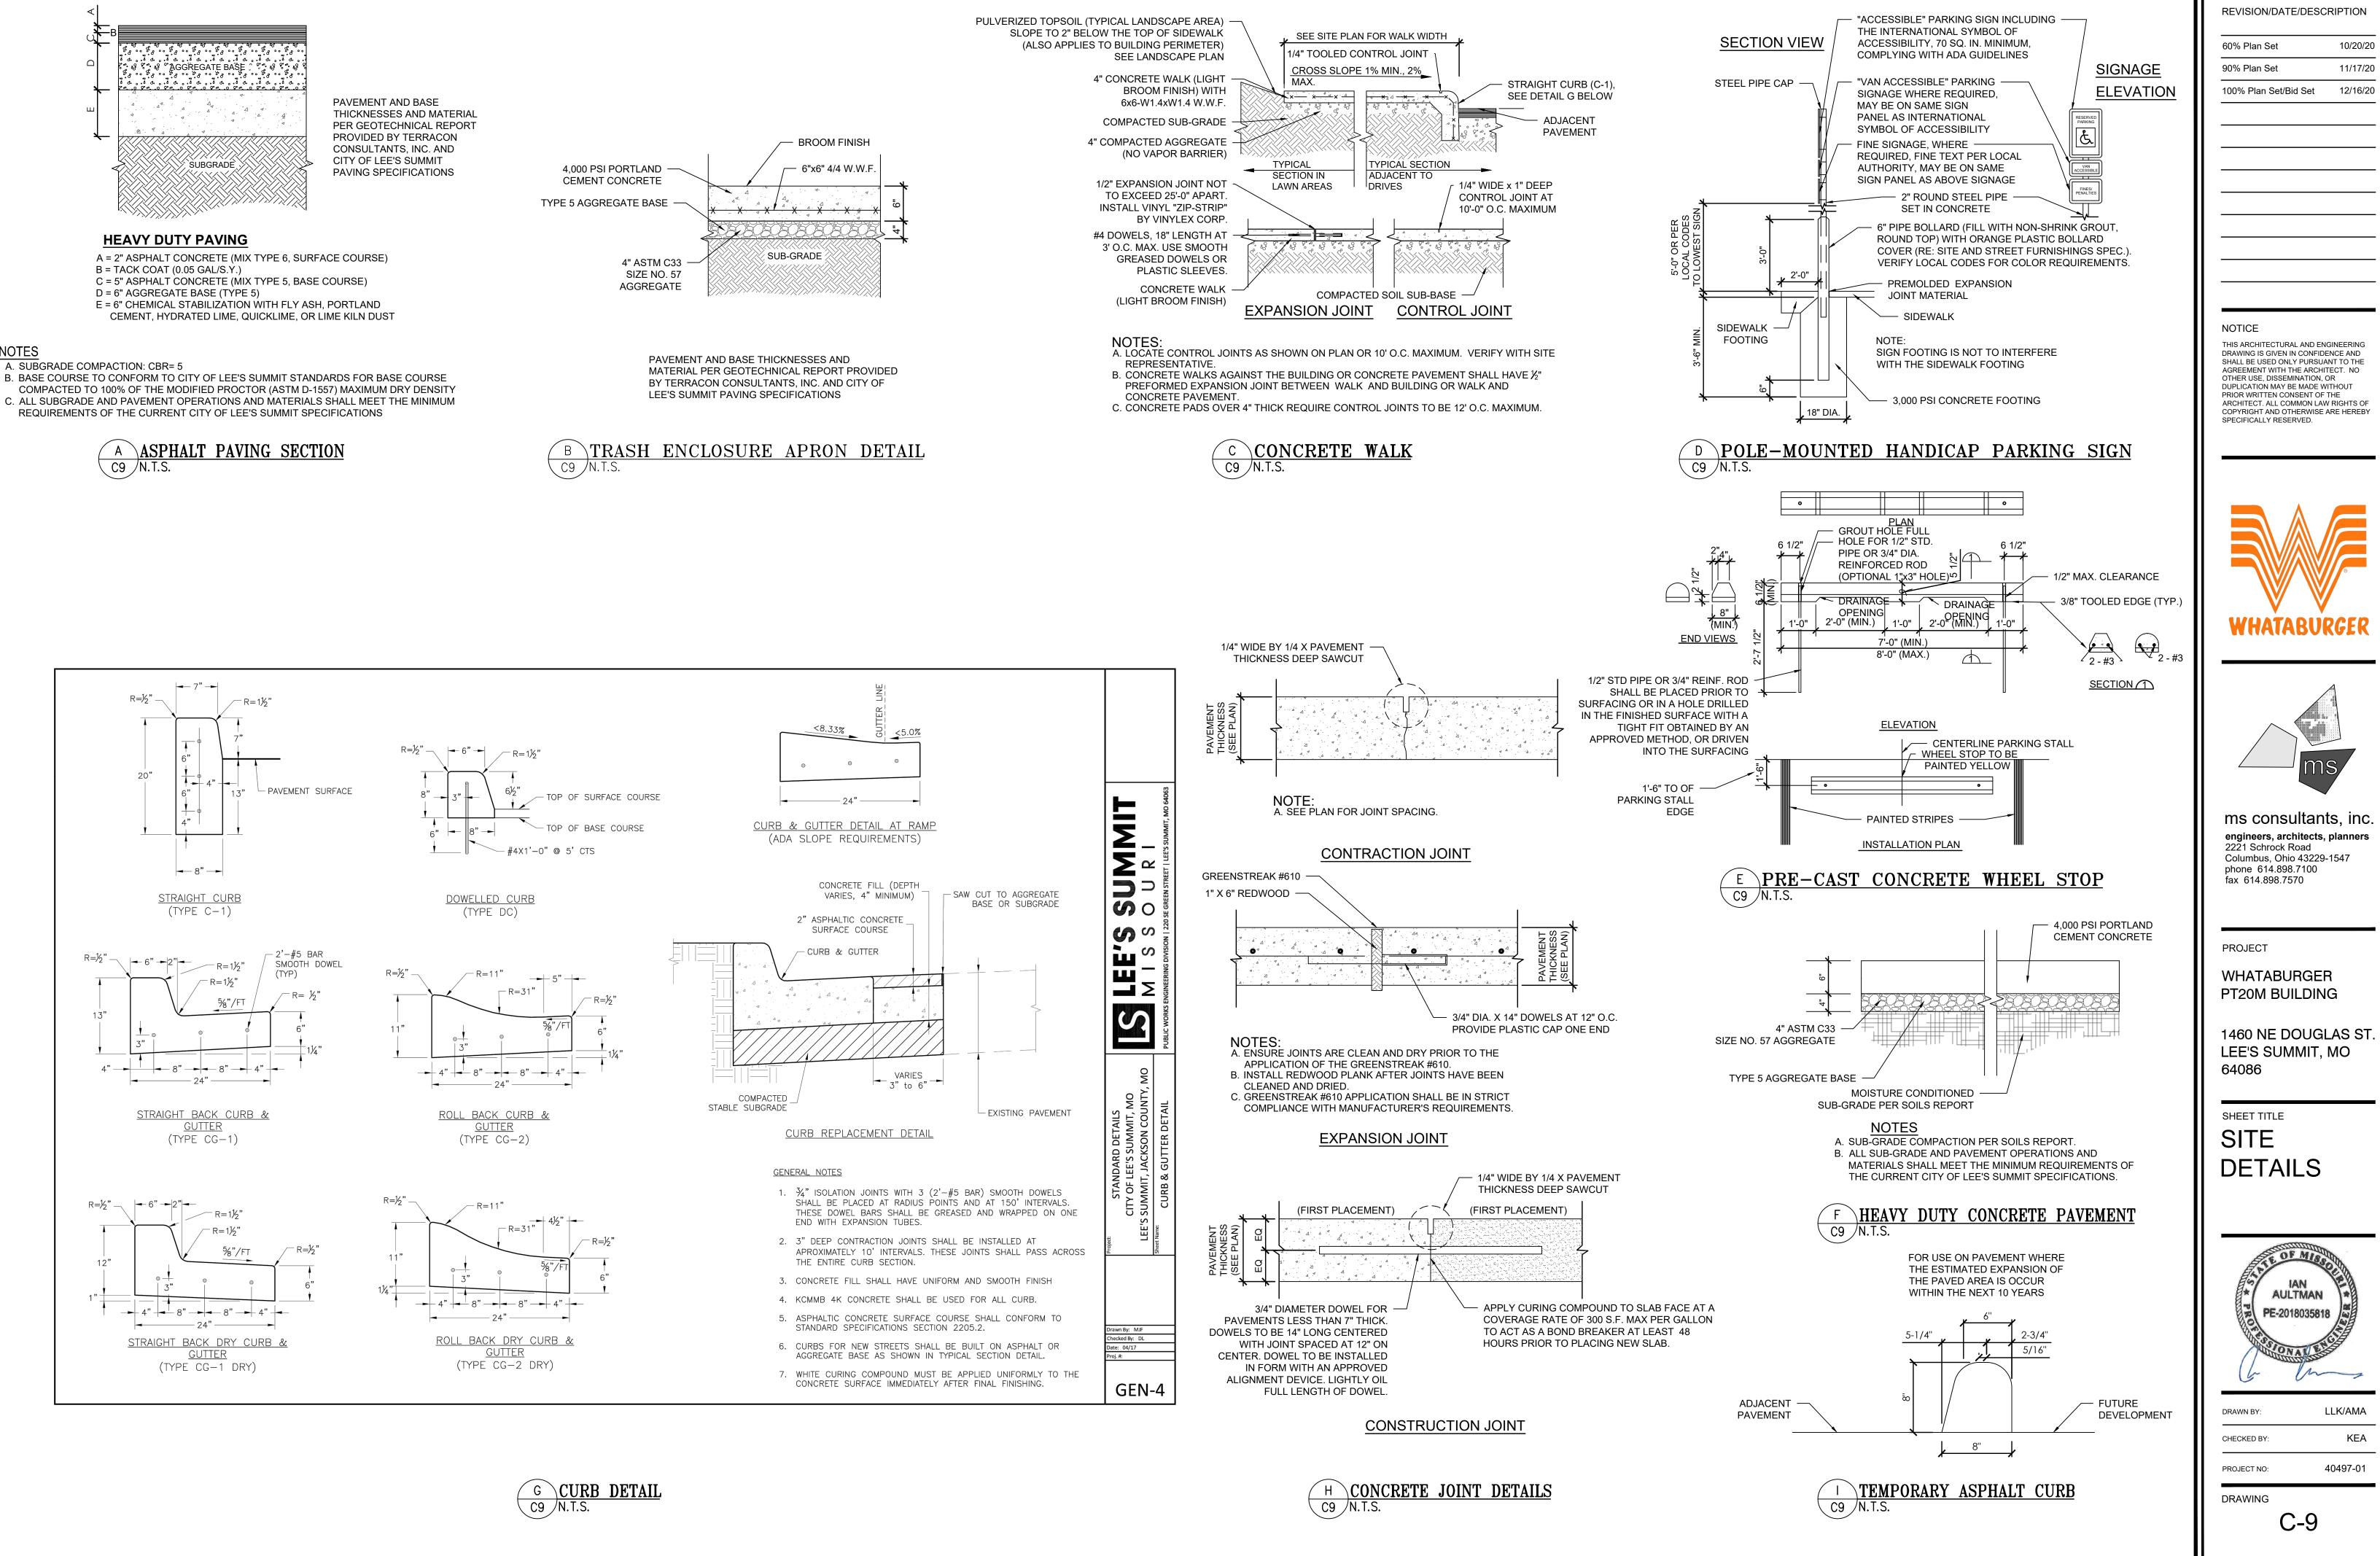

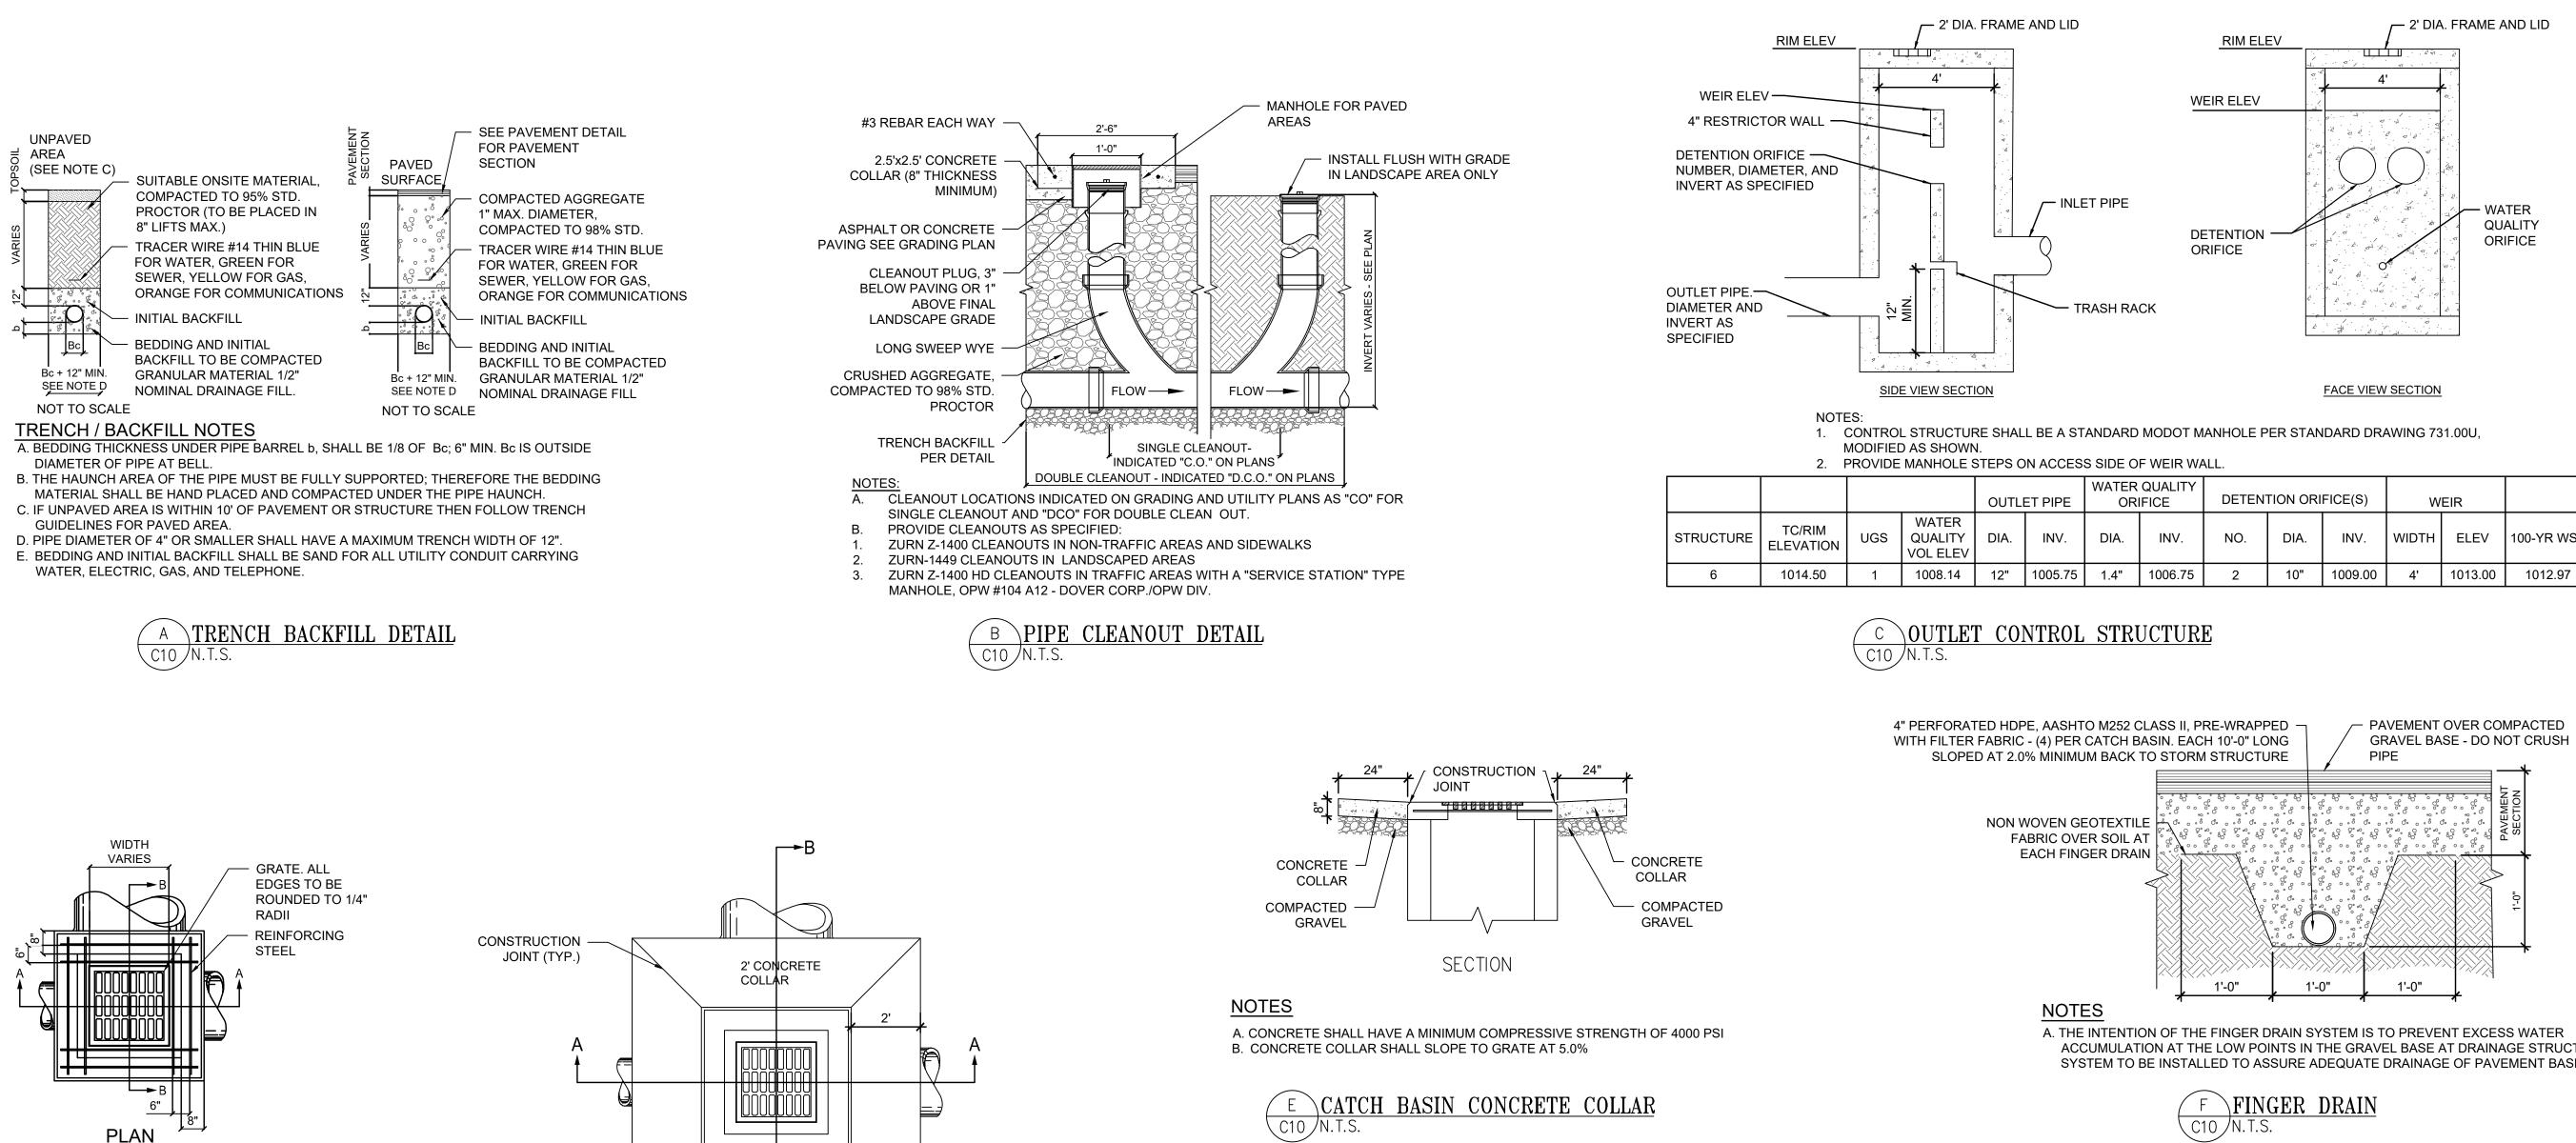



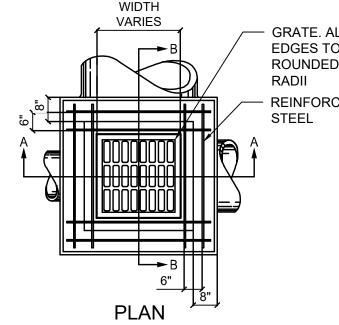


	BASIN SIZING					
INSIDE DIMENSIC	N PI	PE SIZE	TOP SLAB REINFORCING AT 6" O.C.			
3'-0" x 3'-0	" 12	" TO 33"	(8) #4 BARS			
4'-0" x 4'-0	)" 36	6" TO 42"	(12) #4 BARS			


#### CONCRETE TABLE

AGGREGATE	DRY AGG	REGATES (	LB/C.Y.)	CEMENT CONTENT	WATER- CEMENT RATIO	
	FINE	COARSE	TOTAL	(LB/C.Y.)	(MAX)	
GRAVEL	1160	1735	2895	600	0.5	
LIMESTONE	1285	1630	2915	600	0.5	
SLAG	1350	1360	2710	600	0.5	


#### NOTES

- A. GRATE: EJ NO. 5115M2, 5115Z OR APPROVED EQUAL NEENAH NO. 4852, 1893-0018 OR APPROVED EQUAL.
- WALLS: CAST-IN-PLACE WALLS SHALL HAVE A NOMINAL THICKNESS OF 8". PRECAST WALLS SHALL HAVE A MINIMUM THICKNESS OF 6" AND BE REINFORCED SUFFICIENTLY TO SHIPPING AND HANDLING WITHOUT DAMAGE. PRECAST TOPS SHALL BE 8" THICK. STEPS: STEPS SHALL BE PROVIDED WHERE THE DEPTH OF THE STRUCTURE EXCEEDS 6' CONCRETE: CAST-IN-PLACE CONCRETE TO MEET THE COMPOSITION SPECIFIED IN THE CONCRETE TABLE. ALL PRECAST CONCRETE SHALL MEET THE REQUIREMENTS OF ASTM C478. B. INLETS OVER 12' IN DEPTH SHALL BE PRECAST OR CAST-IN-PLACE CONCRETE; REINFORCED WITH #4 BARS ON 12" CENTERS BOTH VERTICALLY AND HORIZONTALLY WITH 2" CLEARANCE
- FROM INSIDE WALL FACE. PRECAST BASE: IF A PRECAST BASE IS USED, IT SHALL BE SET DEEP ENOUGH SO THAT THE to to the total to the total tot TOP CAN BE PLACED ON THE BASE TO PROVIDE THE GRATE ELEVATION SPECIFIED IN THE PLANS. PRECAST GRADE RINGS MAY BE USED TO ADJUST THE TOP ELEVATION. MINIMUM OF TWO COURSES OF BRICK SHALL BE USED TO ADJUST THE TOP ELEVATION. LOCATION AND ELEVATION: WHEN GIVEN ON THE PLANS, THE LOCATION AND THE ELEVATION ARE AT THE TOP CENTER OF THE GRATE.
- MINIMUM DEPTH: THE MINIMUM DEPTH SHALL BE THE OUTSIDE DIAMETER (O.D.) OF THE OUTLET PIPE PLUS 7". OPENINGS: PIPE OPENINGS SHALL BE THE O.D. OF THE PIPE BEING SUPPLIED PLUS 2" WHEN PREFABRICATED OR FIELD CUT. THE INTERSTITIAL SPACE SHALL BE FILLED WITH GROUT.

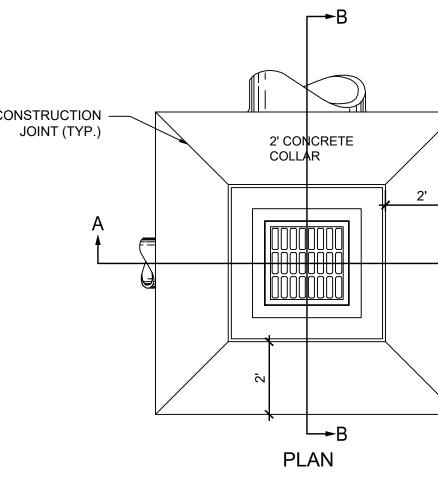

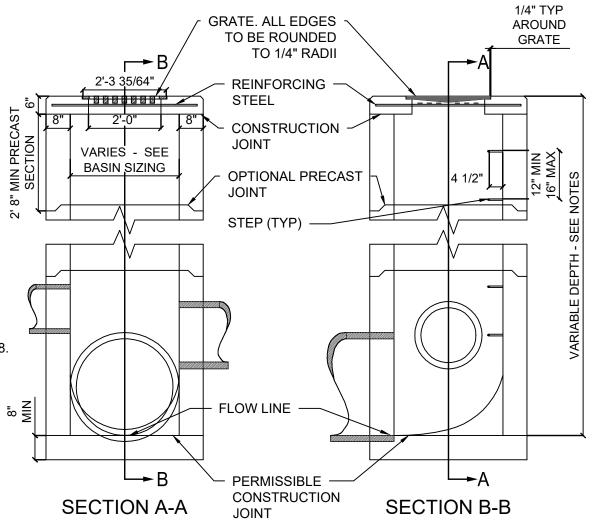


D SQUARE CATCH BASIN DETAIL

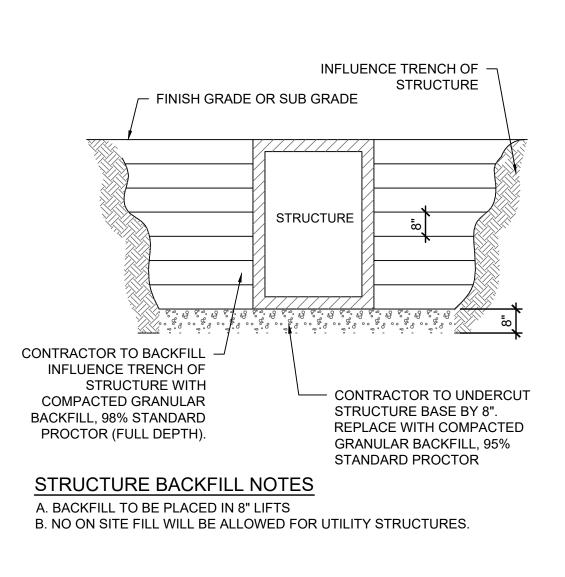



PIPE		QUALITY FICE	DETEN	TION ORI	FICE(S)	W	EIR	
INV.	DIA.	INV.	NO.	DIA.	INV.	WIDTH	ELEV	100-YR WSE
005.75	1.4"	1006.75	2	10"	1009.00	4'	1013.00	1012.97

ACCUMULATION AT THE LOW POINTS IN THE GRAVEL BASE AT DRAINAGE STRUCTURES. SYSTEM TO BE INSTALLED TO ASSURE ADEQUATE DRAINAGE OF PAVEMENT BASE.

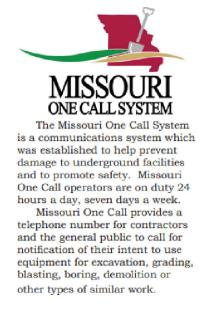


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90% Plan Set 100% Plan Set/Bid Set	11/17/20
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ARCHITECT. ALL COMMON LAV COPYRIGHT AND OTHERWISE A SPECIFICALLY RESERVED.	
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ms consultan	ts inc
engineers, architects, 2221 Schrock Road	
Columbus, Ohio 43229- phone 614.898.7100 fax 614.898.7570	-1547
14.000.7070	
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WHATABURGEF PT20M BUILDIN	
1460 NE DOUGI LEE'S SUMMIT,	
64086	
SHEET TITLE SITE	
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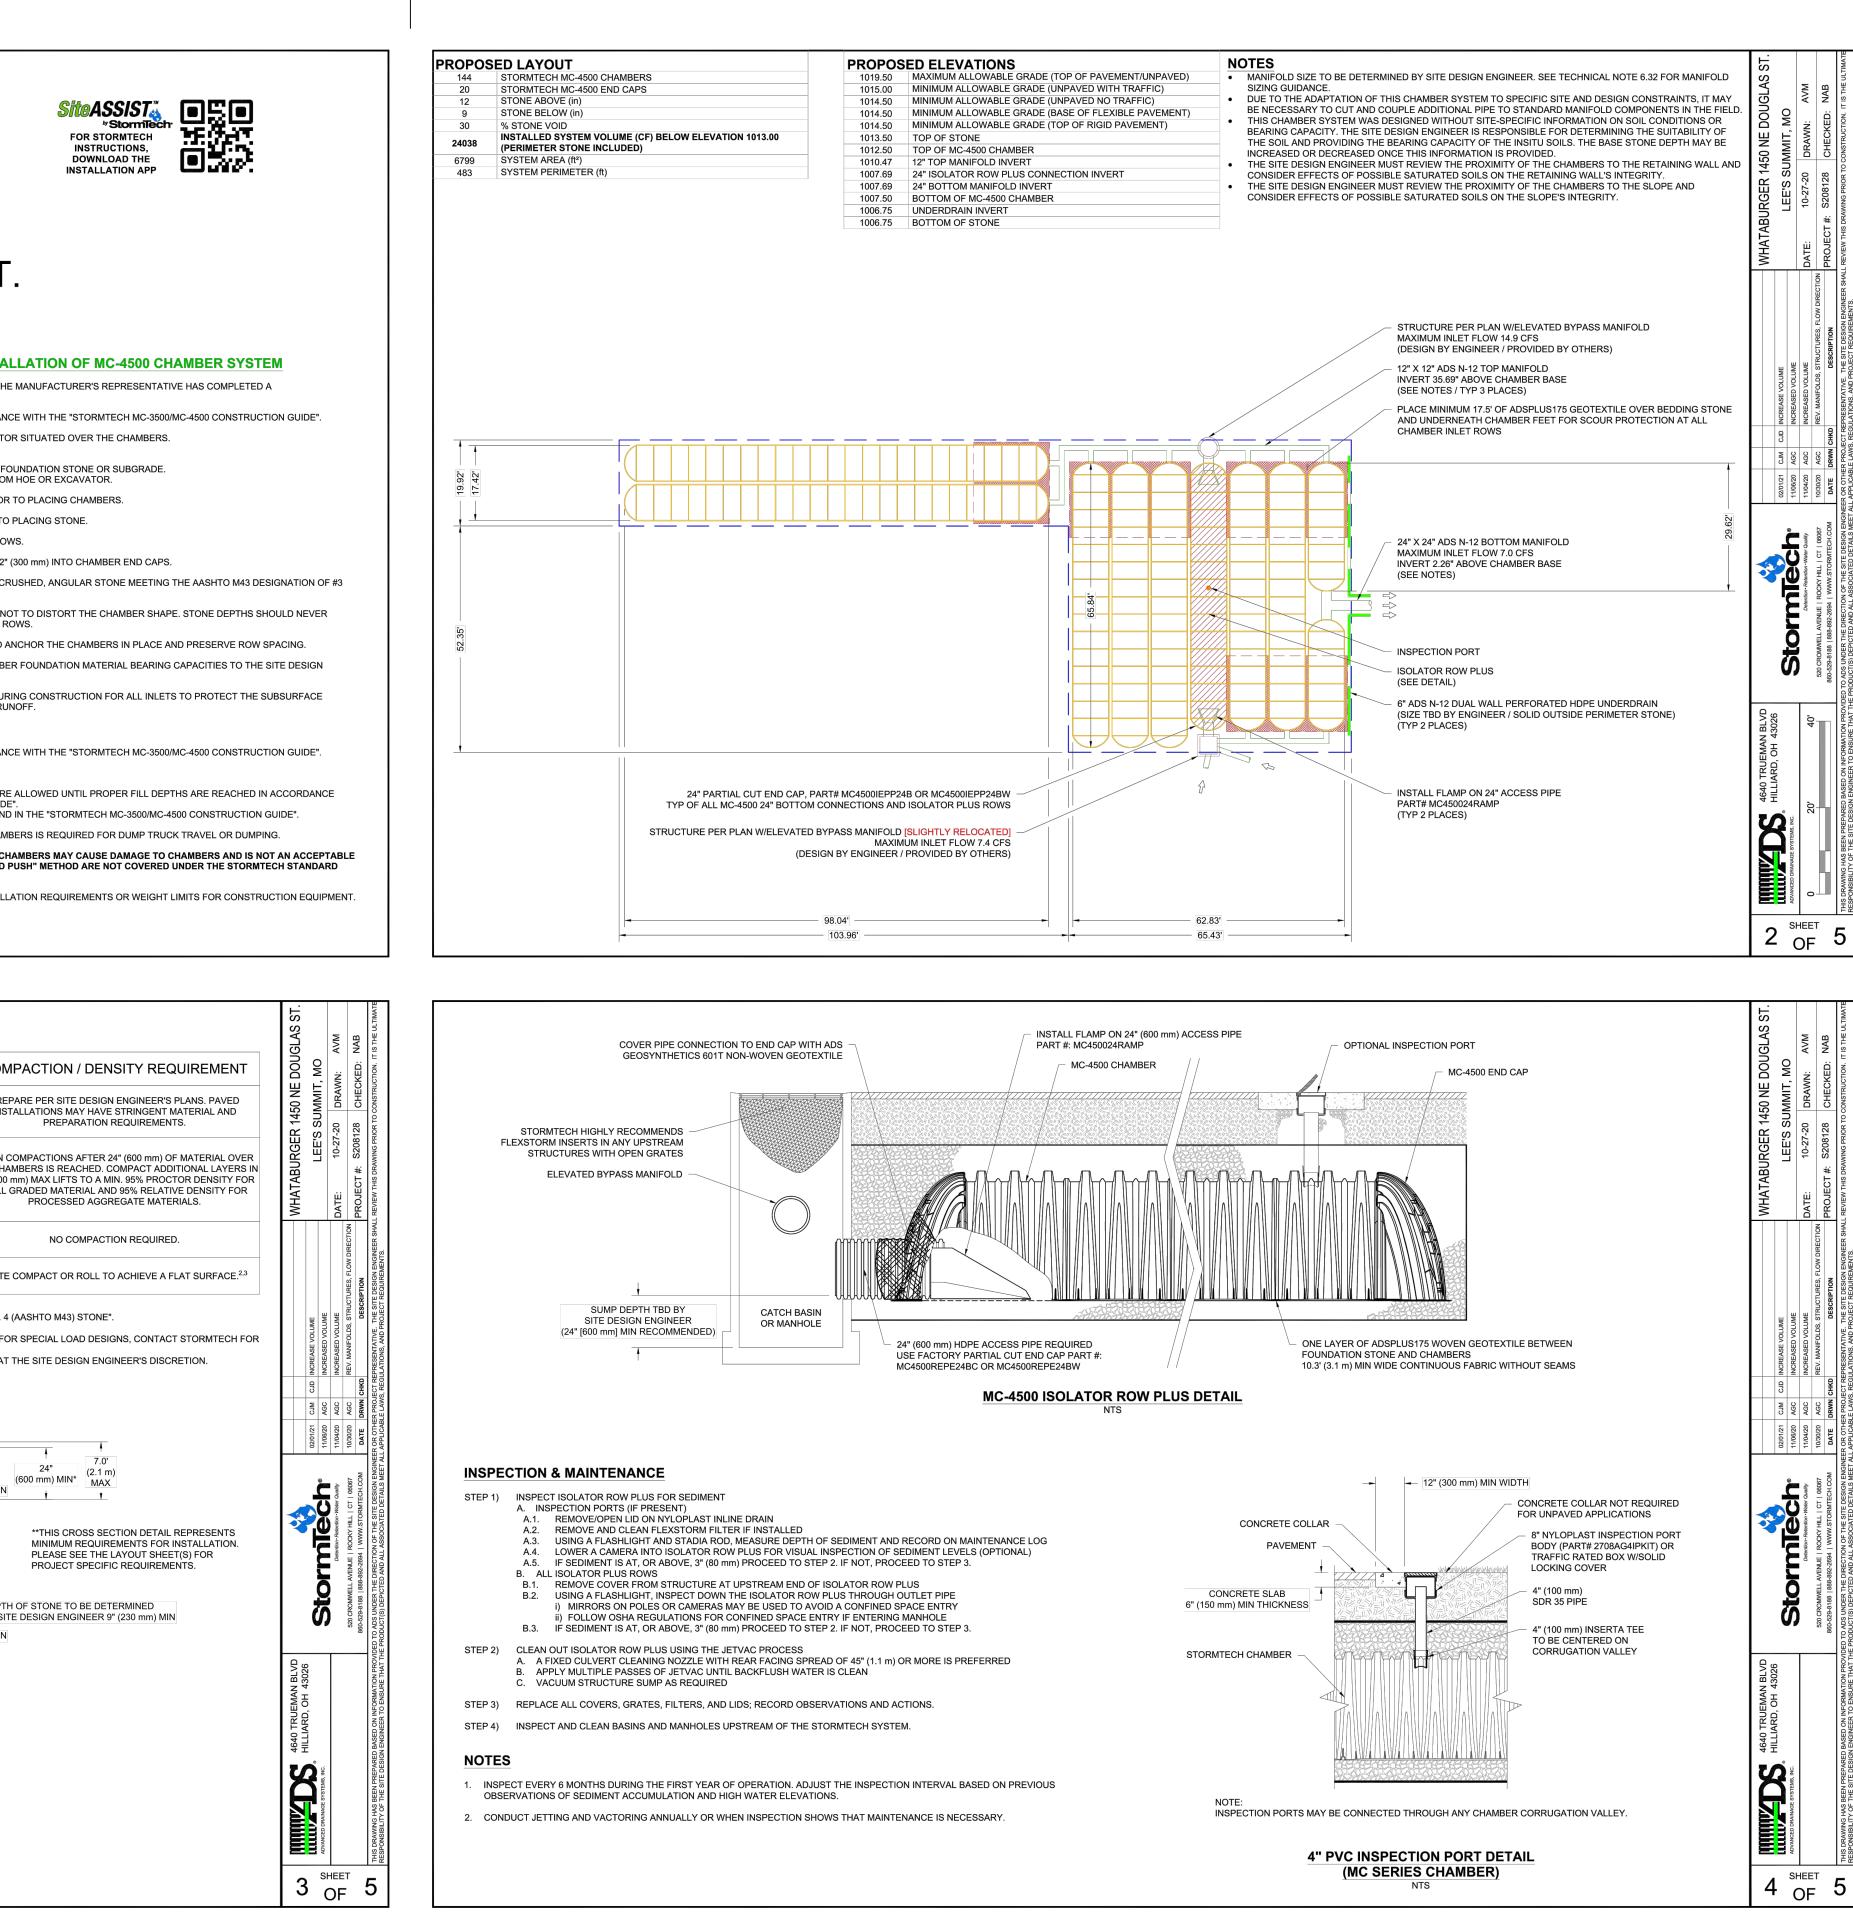
REVISION/DATE/DESCRIPTION



ENGINEERED PRODUCT MANAGER:	DJECT INFORMATION DIRK HUDSON 816-602-4201 DIRK.HUDSON@ADS-PIPE.COM DUSTIN KETCHUM		
ADS SALES REF			
PROJECT NO:	S208128		
	ADVANCE	ED DRAINAGE SYSTEMS, INC.	
	WHATABURGER	R 1450 NE DOUGLAS S	ST
	LE	EE'S SUMMIT, MO	
MC-4500	STORMTECH CHAMBER SPECIFICATIONS	<b>IMPORTANT - NOTES FOR THE BIDDING AND I</b>	NSTA
. CHAMBERS	SHALL BE STORMTECH MC-4500.	<ol> <li>STORMTECH MC-4500 CHAMBERS SHALL NOT BE INSTALLED UN PRE-CONSTRUCTION MEETING WITH THE INSTALLERS.</li> </ol>	NTIL THE
CHAMBERS	SHALL BE ARCH-SHAPED AND SHALL BE MANUFACTURED FROM VIRGIN, IMPACT-MODIFIED POLYPROPYLENE	2. STORMTECH MC-4500 CHAMBERS SHALL BE INSTALLED IN ACC	ORDAN
. CHAMBERS	NS. SHALL MEET THE REQUIREMENTS OF ASTM F2418-16a, "STANDARD SPECIFICATION FOR POLYPROPYLENE (PP) ED WALL STORMWATER COLLECTION CHAMBERS" CHAMBER CLASSIFICATION 60x101.	<ol> <li>CHAMBERS ARE NOT TO BE BACKFILLED WITH A DOZER OR EXI STORMTECH RECOMMENDS 3 BACKFILL METHODS:         <ul> <li>STONESHOOTER LOCATED OFF THE CHAMBER BED.</li> <li>BACKFILL AS ROWS ARE BUILT USING AN EXCAVATOR ON</li> </ul> </li> </ol>	
	ROWS SHALL PROVIDE CONTINUOUS, UNOBSTRUCTED INTERNAL SPACE WITH NO INTERNAL SUPPORTS THAT WOULD DW OR LIMIT ACCESS FOR INSPECTION.		
	TURAL DESIGN OF THE CHAMBERS, THE STRUCTURAL BACKFILL, AND THE INSTALLATION REQUIREMENTS SHALL EN		
	.OAD FACTORS SPECIFIED IN THE AASHTO LRFD BRIDGE DESIGN SPECIFICATIONS, SECTION 12.12, ARE MET FOR: 1) ATION DEAD LOADS AND 2) SHORT-DURATION LIVE LOADS, BASED ON THE AASHTO DESIGN TRUCK WITH CONSIDERAT	RATION	
FOR IMPAC	T AND MULTIPLE VEHICLE PRESENCES.	6. MAINTAIN MINIMUM 9" (230 mm) SPACING BETWEEN THE CHAME	
	SHALL BE DESIGNED, TESTED AND ALLOWABLE LOAD CONFIGURATIONS DETERMINED IN ACCORDANCE WITH ASTM PRACTICE FOR STRUCTURAL DESIGN OF THERMOPLASTIC CORRUGATED WALL STORMWATER COLLECTION CHAMB		
LOAD CON	GURATIONS SHALL INCLUDE: 1) INSTANTANEOUS (<1 MIN) AASHTO DESIGN TRUCK LIVE LOAD ON MINIMUM COVER 2; ERMANENT (75-YR) COVER LOAD AND 3) ALLOWABLE COVER WITH PARKED (1-WEEK) AASHTO DESIGN TRUCK.	8 EMBEDMENT STONE SUBBOUNDING CHAMBERS MUST BE A CU	EAN, CF
. REQUIREM • TO M	ENTS FOR HANDLING AND INSTALLATION: AINTAIN THE WIDTH OF CHAMBERS DURING SHIPPING AND HANDLING, CHAMBERS SHALL HAVE INTEGRAL, INTERLOCI	9. STONE SHALL BE BROUGHT UP EVENLY AROUND CHAMBERS S DIFFER BY MORE THAN 12" (300 mm) BETWEEN ADJACENT CHAM	
<ul> <li>TO EI</li> </ul>	KING LUGS. ISURE A SECURE JOINT DURING INSTALLATION AND BACKFILL, THE HEIGHT OF THE CHAMBER JOINT SHALL NOT BE L		
	3". ISURE THE INTEGRITY OF THE ARCH SHAPE DURING INSTALLATION, a) THE ARCH STIFFNESS CONSTANT AS DEFINED ION 6.2.8 OF ASTM F2418 SHALL BE GREATER THAN OR EQUAL TO 500 LBS/IN/IN. AND b) TO RESIST CHAMBER DEFORM		СНАМВЕ
	NG INSTALLATION AT ELEVATED TEMPERATURES (ABOVE 73° F / 23° C), CHAMBERS SHALL BE PRODUCED FROM ECTIVE GOLD OR YELLOW COLORS.	12. ADS RECOMMENDS THE USE OF "FLEXSTORM CATCH IT" INSER STORMWATER MANAGEMENT SYSTEM FROM CONSTRUCTION S	
	IBERS THAT ARE APPROVED BY THE SITE DESIGN ENGINEER WILL BE ALLOWED. UPON REQUEST BY THE SITE DESIGI OR OWNER, THE CHAMBER MANUFACTURER SHALL SUBMIT A STRUCTURAL EVALUATION FOR APPROVAL BEFORE		
DELIVERIN	S CHAMBERS TO THE PROJECT SITE AS FOLLOWS:	1. STORMTECH MC-4500 CHAMBERS SHALL BE INSTALLED IN ACC	ORDAN
THE S     DEAD     LRFD     THE T	ITRUCTURAL EVALUATION SHALL BE SEALED BY A REGISTERED PROFESSIONAL ENGINEER. ITRUCTURAL EVALUATION SHALL DEMONSTRATE THAT THE SAFETY FACTORS ARE GREATER THAN OR EQUAL TO 1.9: LOAD AND 1.75 FOR LIVE LOAD, THE MINIMUM REQUIRED BY ASTM F2787 AND BY SECTIONS 3 AND 12.12 OF THE AASH BRIDGE DESIGN SPECIFICATIONS FOR THERMOPLASTIC PIPE. 'EST DERIVED CREEP MODULUS AS SPECIFIED IN ASTM F2418 SHALL BE USED FOR PERMANENT DEAD LOAD DESIGN PT THAT IT SHALL BE THE 75-YEAR MODULUS USED FOR DESIGN.	ASHTO • NO EQUIPMENT IS ALLOWED ON BARE CHAMBERS. • NO RUBBER TIRED LOADER, DUMP TRUCK, OR EXCAVATO	ors are N guide
CHAMBERS	AND END CAPS SHALL BE PRODUCED AT AN ISO 9001 CERTIFIED MANUFACTURING FACILITY.	3. FULL 36" (900 mm) OF STABILIZED COVER MATERIALS OVER THE	E CHAM
		USE OF A DOZER TO PUSH EMBEDMENT STONE BETWEEN THE ROW: BACKFILL METHOD. ANY CHAMBERS DAMAGED BY USING THE "DUM WARRANTY.	
		CONTACT STORMTECH AT 1-888-892-2694 WITH ANY QUESTIONS ON I	NOTAL

	MATERIAL LOCATION	DESCRIPTION	AASHTO MATERIAL CLASSIFICATIONS	COMP
D	FINAL FILL: FILL MATERIAL FOR LAYER 'D' STARTS FROM THE TOP OF THE 'C' LAYER TO THE BOTTOM OF FLEXIBLE PAVEMENT OR UNPAVED FINISHED GRADE ABOVE. NOTE THAT PAVEMENT SUBBASE MAY BE PART OF THE 'D' LAYER	ANY SOIL/ROCK MATERIALS, NATIVE SOILS, OR PER ENGINEER'S PLANS. CHECK PLANS FOR PAVEMENT SUBGRADE REQUIREMENTS.	N/A	PREPA INSTA
С	INITIAL FILL: FILL MATERIAL FOR LAYER 'C' STARTS FROM THE TOP OF THE EMBEDMENT STONE ('B' LAYER) TO 24" (600 mm) ABOVE THE TOP OF THE CHAMBER. NOTE THAT PAVEMENT SUBBASE MAY BE A PART OF THE 'C' LAYER.	GRANULAR WELL-GRADED SOIL/AGGREGATE MIXTURES, <35% FINES OR PROCESSED AGGREGATE. MOST PAVEMENT SUBBASE MATERIALS CAN BE USED IN LIEU OF THIS LAYER.	AASHTO M145 ¹ A-1, A-2-4, A-3 OR AASHTO M43 ¹ 3, 357, 4, 467, 5, 56, 57, 6, 67, 68, 7, 78, 8, 89, 9, 10	BEGIN CC THE CHAM 12" (300 m WELL GI
В	EMBEDMENT STONE: FILL SURROUNDING THE CHAMBERS FROM THE FOUNDATION STONE ('A' LAYER) TO THE 'C' LAYER ABOVE.	CLEAN, CRUSHED, ANGULAR STONE	AASHTO M43 ¹ 3, 4	
А	FOUNDATION STONE: FILL BELOW CHAMBERS FROM THE			
SE NOTE: HE LISTED A TORMTECH ( VHERE INFILT COMPACTION	SUBGRADE UP TO THE FOOT (BOTTOM) OF THE CHAMBER. ASHTO DESIGNATIONS ARE FOR GRADATIONS ONLY. THE STONE MU COMPACTION REQUIREMENTS ARE MET FOR 'A' LOCATION MATERIAL TRATION SURFACES MAY BE COMPROMISED BY COMPACTION, FOR S REQUIREMENTS. 'C' IS PLACED, ANY SOIL/MATERIAL CAN BE PLACED IN LAYER 'D' UP T ADS GEOSYNTHETICS 601T NON-W	NGULAR STONE IN A & B LAYERS	ILL COVERAGES WITH A VIBRATORY COMPACTOR. Y RAKING OR DRAGGING WITHOUT COMPACTION EQU	GULAR NO. 4 (A JIPMENT. FOR
SE NOTE: HE LISTED A TORMTECH ( VHERE INFILT COMPACTION	SUBGRADE UP TO THE FOOT (BOTTOM) OF THE CHAMBER. ASHTO DESIGNATIONS ARE FOR GRADATIONS ONLY. THE STONE MU COMPACTION REQUIREMENTS ARE MET FOR 'A' LOCATION MATERIAL TRATION SURFACES MAY BE COMPROMISED BY COMPACTION, FOR S REQUIREMENTS. 'C' IS PLACED, ANY SOIL/MATERIAL CAN BE PLACED IN LAYER 'D' UP T ADS GEOSYNTHETICS 601T NON-W	UST ALSO BE CLEAN, CRUSHED, ANGULAR. FOR EXAMPLE, A SPECIFICATION F LS WHEN PLACED AND COMPACTED IN 9" (230 mm) (MAX) LIFTS USING TWO FU STANDARD DESIGN LOAD CONDITIONS, A FLAT SURFACE MAY BE ACHIEVED BY TO THE FINISHED GRADE. MOST PAVEMENT SUBBASE SOILS CAN BE USED TO OVEN GEOTEXTILE ALL AROUND	3, 4 FOR #4 STONE WOULD STATE: "CLEAN, CRUSHED, ANG JUL COVERAGES WITH A VIBRATORY COMPACTOR. Y RAKING OR DRAGGING WITHOUT COMPACTION EQU REPLACE THE MATERIAL REQUIREMENTS OF LAYER ' PAVEMENT LAYER (DESIGNED	JIPMENT. FOR
SE NOTE: HE LISTED A TORMTECH ( VHERE INFILT COMPACTION ONCE LAYER (	SUBGRADE UP TO THE FOOT (BOTTOM) OF THE CHAMBER. ASHTO DESIGNATIONS ARE FOR GRADATIONS ONLY. THE STONE MU COMPACTION REQUIREMENTS ARE MET FOR 'A' LOCATION MATERIAL IRATION SURFACES MAY BE COMPROMISED BY COMPACTION, FOR S REQUIREMENTS. 'C' IS PLACED, ANY SOIL/MATERIAL CAN BE PLACED IN LAYER 'D' UP T ADS GEOSYNTHETICS 601T NON-W CLEAN, CRUSHED, AN PERIMETER STONE (SEE NOTE 4) EXCAVATION WALL	UST ALSO BE CLEAN, CRUSHED, ANGULAR. FOR EXAMPLE, A SPECIFICATION FU S WHEN PLACED AND COMPACTED IN 9" (230 mm) (MAX) LIFTS USING TWO FU STANDARD DESIGN LOAD CONDITIONS, A FLAT SURFACE MAY BE ACHIEVED BY TO THE FINISHED GRADE. MOST PAVEMENT SUBBASE SOILS CAN BE USED TO POVEN GEOTEXTILE ALL AROUND NGULAR STONE IN A & B LAYERS	3, 4 OR #4 STONE WOULD STATE: "CLEAN, CRUSHED, ANG JUL COVERAGES WITH A VIBRATORY COMPACTOR. Y RAKING OR DRAGGING WITHOUT COMPACTION EQU REPLACE THE MATERIAL REQUIREMENTS OF LAYER ' PAVEMENT LAYER (DESIGNED BY SITE DESIGN ENGINEER) *TO BOTTOM OF FLEXIBLE PAVEMENT. FOR UNPAVED STALLOWS WHERE RUTTING FROM VEHICLES MAY OCCUR. TO BOTTOM OF FLEXIBLE PAVEMENT. FOR UNPAVED STALLOWS WHERE RUTTING FROM VEHICLES MAY OCCUR. 12" (3)	GULAR NO. 4 (A JIPMENT. FOR 'C' OR 'D' AT TH (( 300 mm) MIN 60"
SE NOTE: HE LISTED A TORMTECH ( VHERE INFILT COMPACTION ONCE LAYER (	SUBGRADE UP TO THE FOOT (BOTTOM) OF THE CHAMBER. ASHTO DESIGNATIONS ARE FOR GRADATIONS ONLY. THE STONE MU COMPACTION REQUIREMENTS ARE MET FOR 'A' LOCATION MATERIAL ITRATION SURFACES MAY BE COMPROMISED BY COMPACTION, FOR S REQUIREMENTS. 'C' IS PLACED, ANY SOIL/MATERIAL CAN BE PLACED IN LAYER 'D' UP T ADS GEOSYNTHETICS 601T NON-W CLEAN, CRUSHED, AI PERIMETER STONE (SEE NOTE 4)	UST ALSO BE CLEAN, CRUSHED, ANGULAR. FOR EXAMPLE, A SPECIFICATION FULS WHEN PLACED AND COMPACTED IN 9" (230 mm) (MAX) LIFTS USING TWO FULSTANDARD DESIGN LOAD CONDITIONS, A FLAT SURFACE MAY BE ACHIEVED BY FO THE FINISHED GRADE. MOST PAVEMENT SUBBASE SOILS CAN BE USED TO OVEN GEOTEXTILE ALL AROUND NGULAR STONE IN A & B LAYERS	3, 4 OR #4 STONE WOULD STATE: "CLEAN, CRUSHED, ANG JUL COVERAGES WITH A VIBRATORY COMPACTOR. Y RAKING OR DRAGGING WITHOUT COMPACTION EQU REPLACE THE MATERIAL REQUIREMENTS OF LAYER ' PAVEMENT LAYER (DESIGNED BY SITE DESIGN ENGINEER) *TO BOTTOM OF FLEXIBLE PAVEMENT. FOR UNPAVED STALLOWS WHERE RUTTING FROM VEHICLES MAY OCCUR. TO BOTTOM OF FLEXIBLE PAVEMENT. FOR UNPAVED STALLOWS WHERE RUTTING FROM VEHICLES MAY OCCUR. 12" (3)	GULAR NO. 4 (A JIPMENT. FOR 'C' OR 'D' AT TH 'C' OR 'D' AT TH 300 mm) MIN


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   MC-4500 CHAMBERS SHALL BE DESIGNED IN ACCORDANCE WITH ASTM F2787 "STANDARD PRACTICE FOR STRUCTURAL DESIGN OF THERMOPLASTIC CORRUGATED WALL STORMWATER COLLECTION CHAMBERS".
- 3. THE SITE DESIGN ENGINEER IS RESPONSIBLE FOR ASSESSING THE BEARING RESISTANCE (ALLOWABLE BEARING CAPACITY) OF THE SUBGRADE SOILS AND THE DEPTH OF FOUNDATION STONE WITH CONSIDERATION FOR THE RANGE OF EXPECTED SOIL MOISTURE CONDITIONS.
- 4. PERIMETER STONE MUST BE EXTENDED HORIZONTALLY TO THE EXCAVATION WALL FOR BOTH VERTICAL AND SLOPED EXCAVATION WALLS.
- 5. REQUIREMENTS FOR HANDLING AND INSTALLATION:
   TO MAINTAIN THE WIDTH OF CHAMBERS DURING SHIPPING AND HANDLING, CHAMBERS SHALL HAVE INTEGRAL, INTERLOCKING STACKING LUGS.
- TO ENSURE A SECURE JOINT DURING INSTALLATION AND BACKFILL, THE HEIGHT OF THE CHAMBER JOINT SHALL NOT BE LESS THAN 3".
  TO ENSURE THE INTEGRITY OF THE ARCH SHAPE DURING INSTALLATION, a) THE ARCH STIFFNESS CONSTANT AS DEFINED IN SECTION 6.2.8 OF ASTM F2418 SHALL BE GREATER THAN OR EQUAL TO 500 LBS/IN/IN. AND b) TO RESIST CHAMBER DEFORMATION DURING INSTALLATION AT ELEVATED TEMPERATURES (ABOVE 73° F / 23° C), CHAMBERS SHALL BE PRODUCED FROM REFLECTIVE GOLD OR YELLOW COLORS.

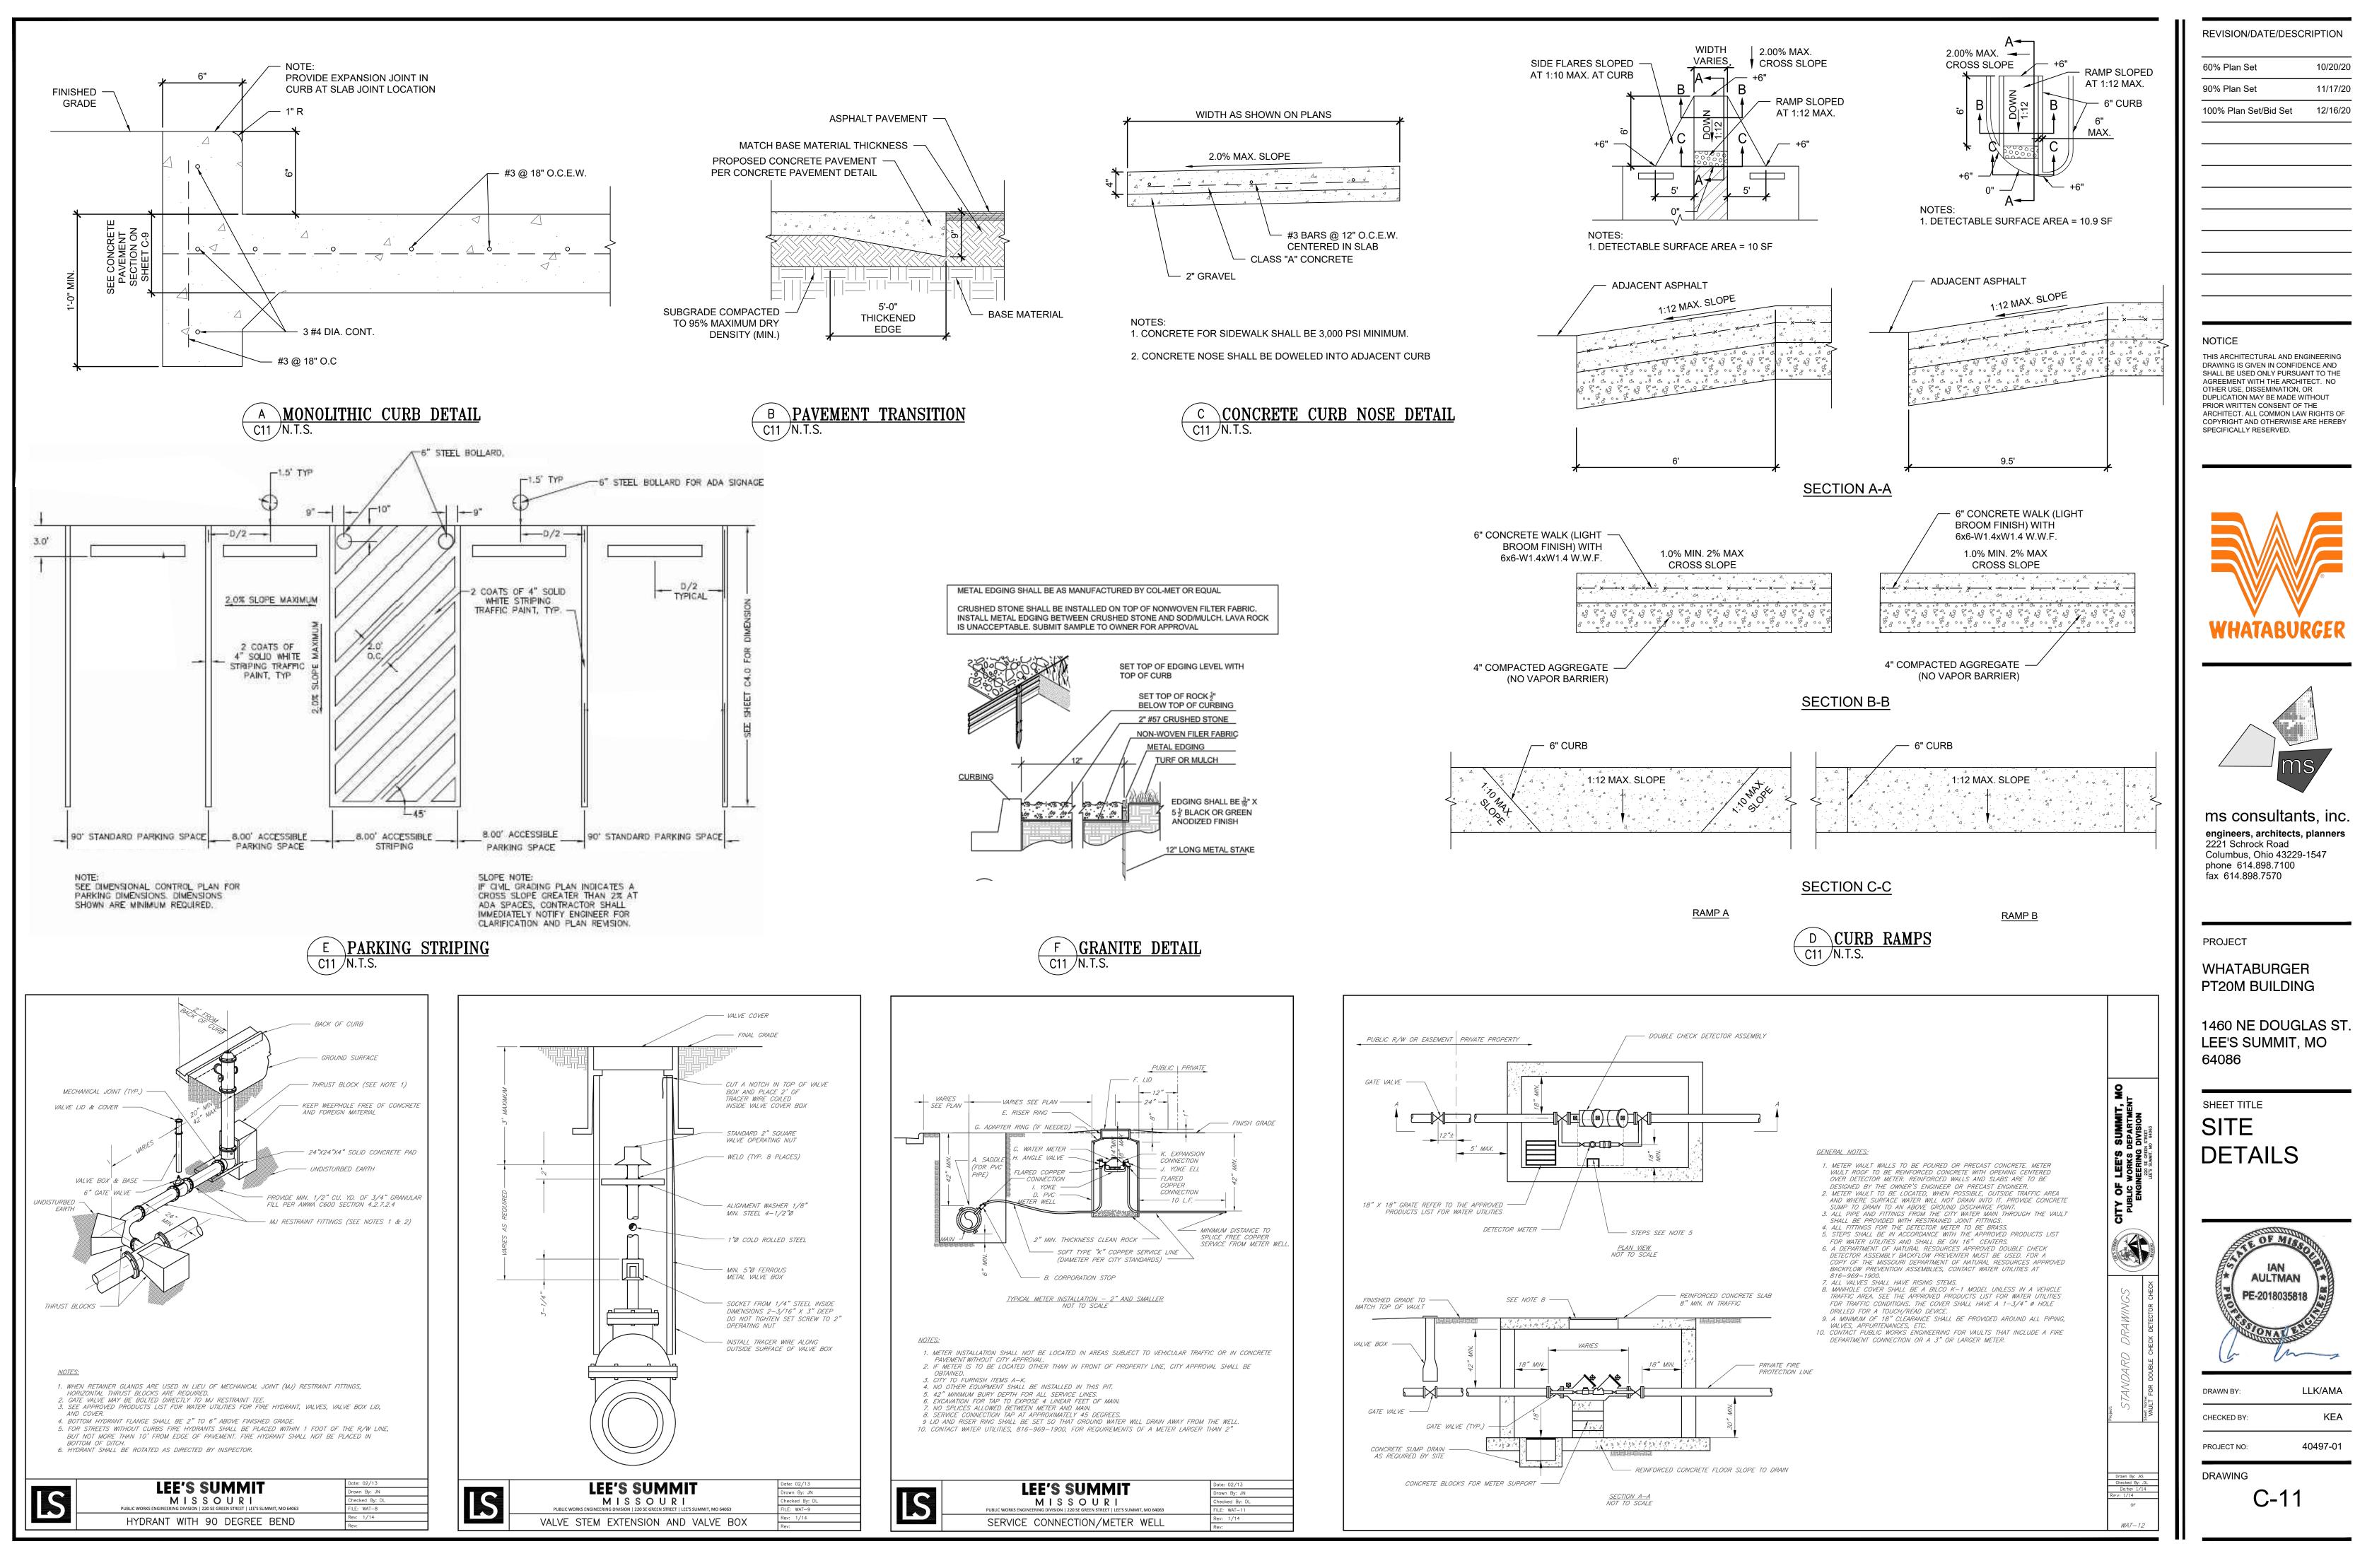

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**REVISION/DATE/DESCRIPTION** 

# WHATABURGER

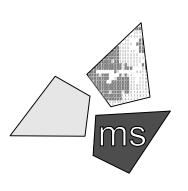

ms consultants, inc. engineers, architects, planners 2221 Schrock Road Columbus, Ohio 43229-1547 phone 614.898.7100 fax 614.898.7570


#### PROJECT

WHATABURGER PT20M BUILDING

1460 NE DOUGLAS ST. LEE'S SUMMIT, MO 64086

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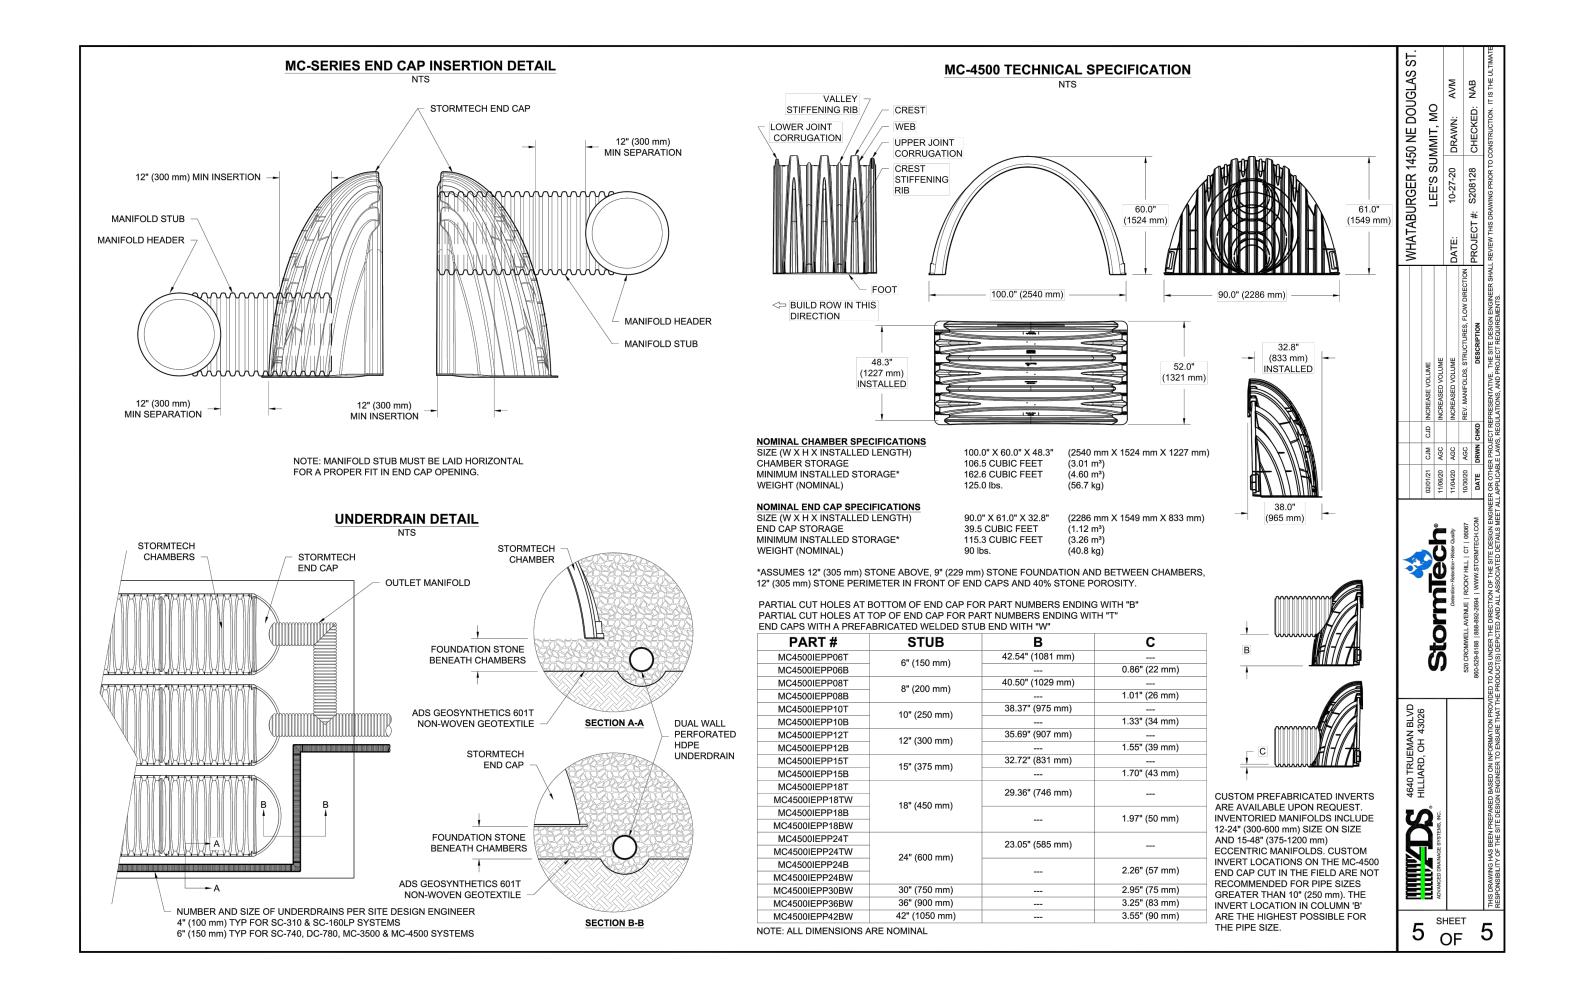


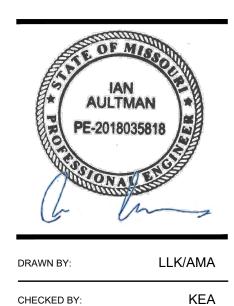


DRAWING C-12

PROJECT NO:

40497-01



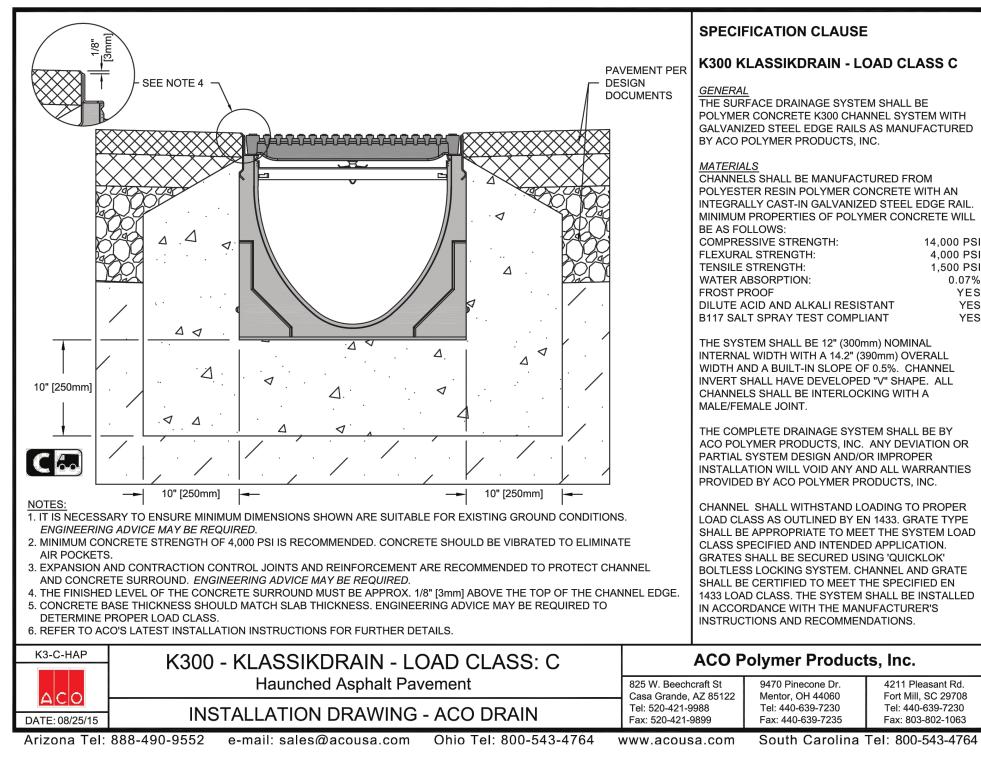




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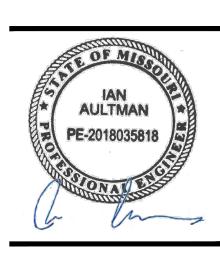
ms consultants, inc. engineers, architects, planners 2221 Schrock Road Columbus, Ohio 43229-1547 phone 614.898.7100 fax 614.898.7570

#### PROJECT

WHATABURGER PT20M BUILDING


1460 NE DOUGLAS ST. LEE'S SUMMIT, MO 64086
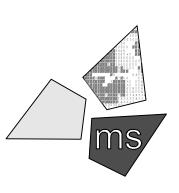
## SHEET TITLE DETENTION SYSTEM DETAILS



DRAWN BY:	LLK/AMA
CHECKED BY:	KEA
PROJECT NO:	40497-01

DRAWING

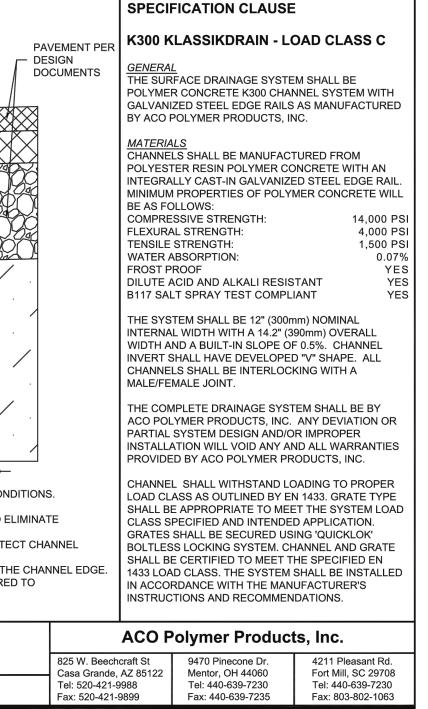





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#### MAKE THE CALL ... IT'S THE LAW

C-13



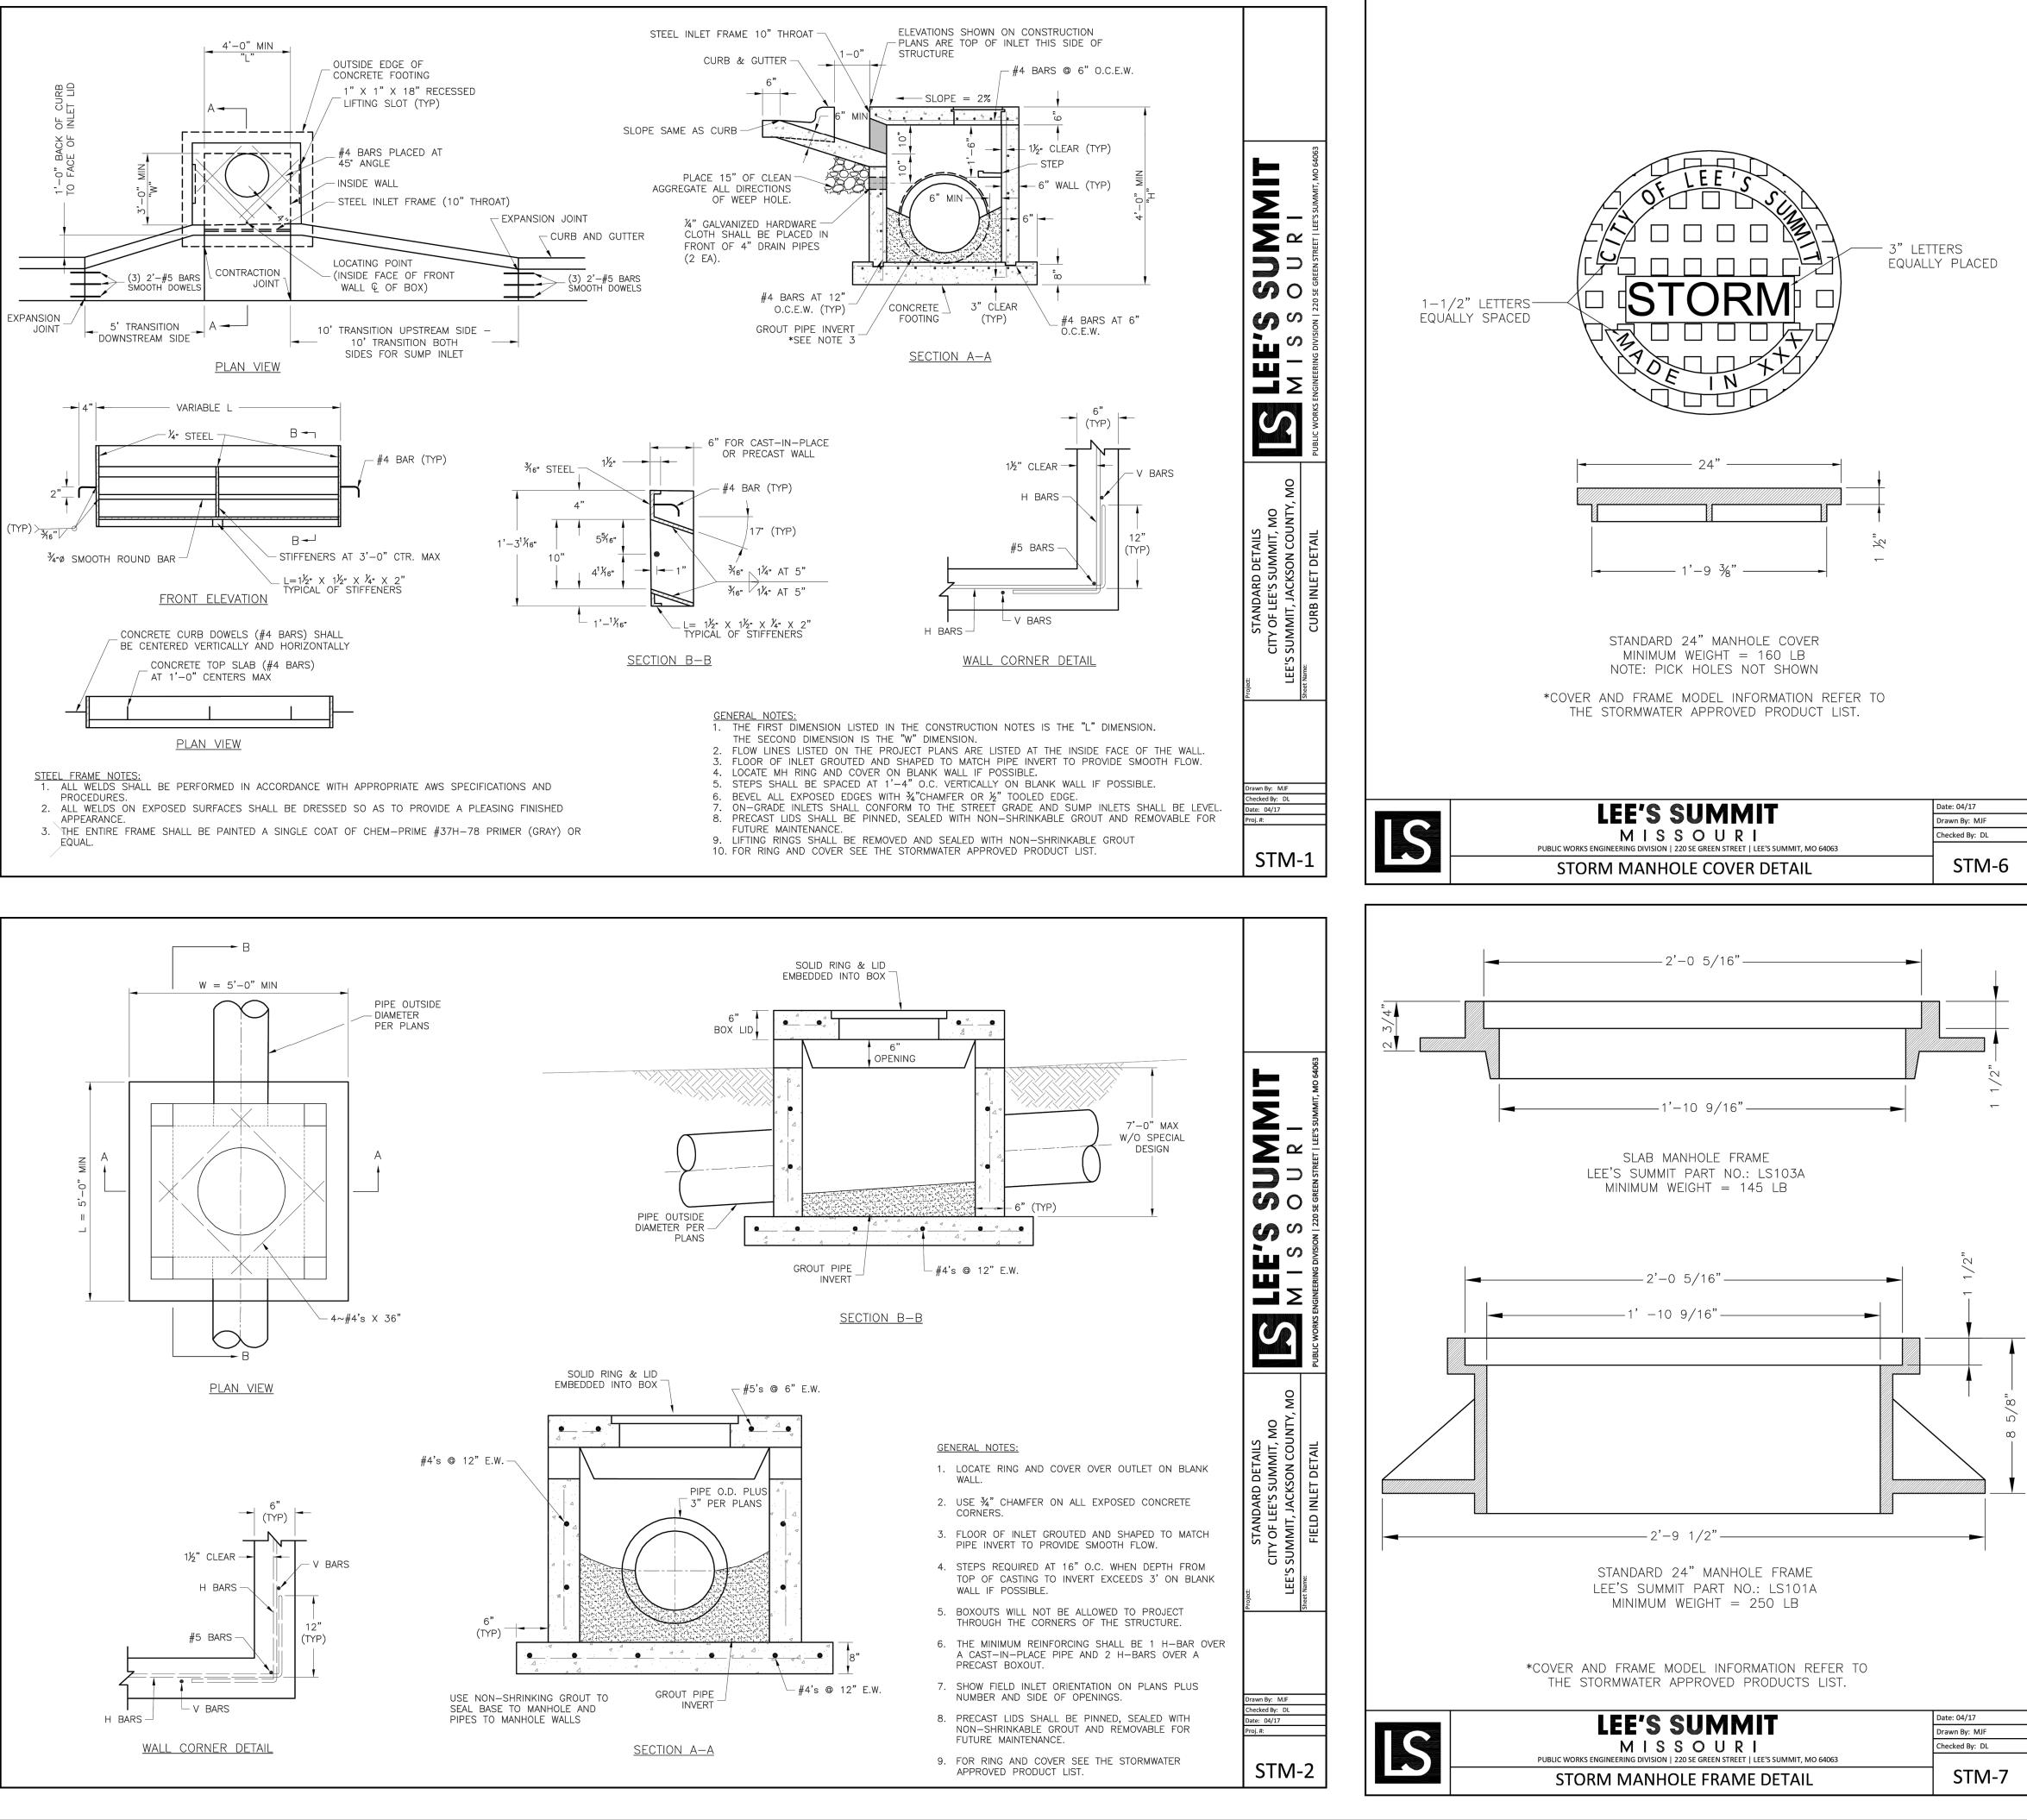


ANAIT	Date: 04/17
MMIT	Drawn By: MJF
URI	Checked By: DL
N STREET   LEE'S SUMMIT, MO 64063	
OVER DETAIL	STM-6

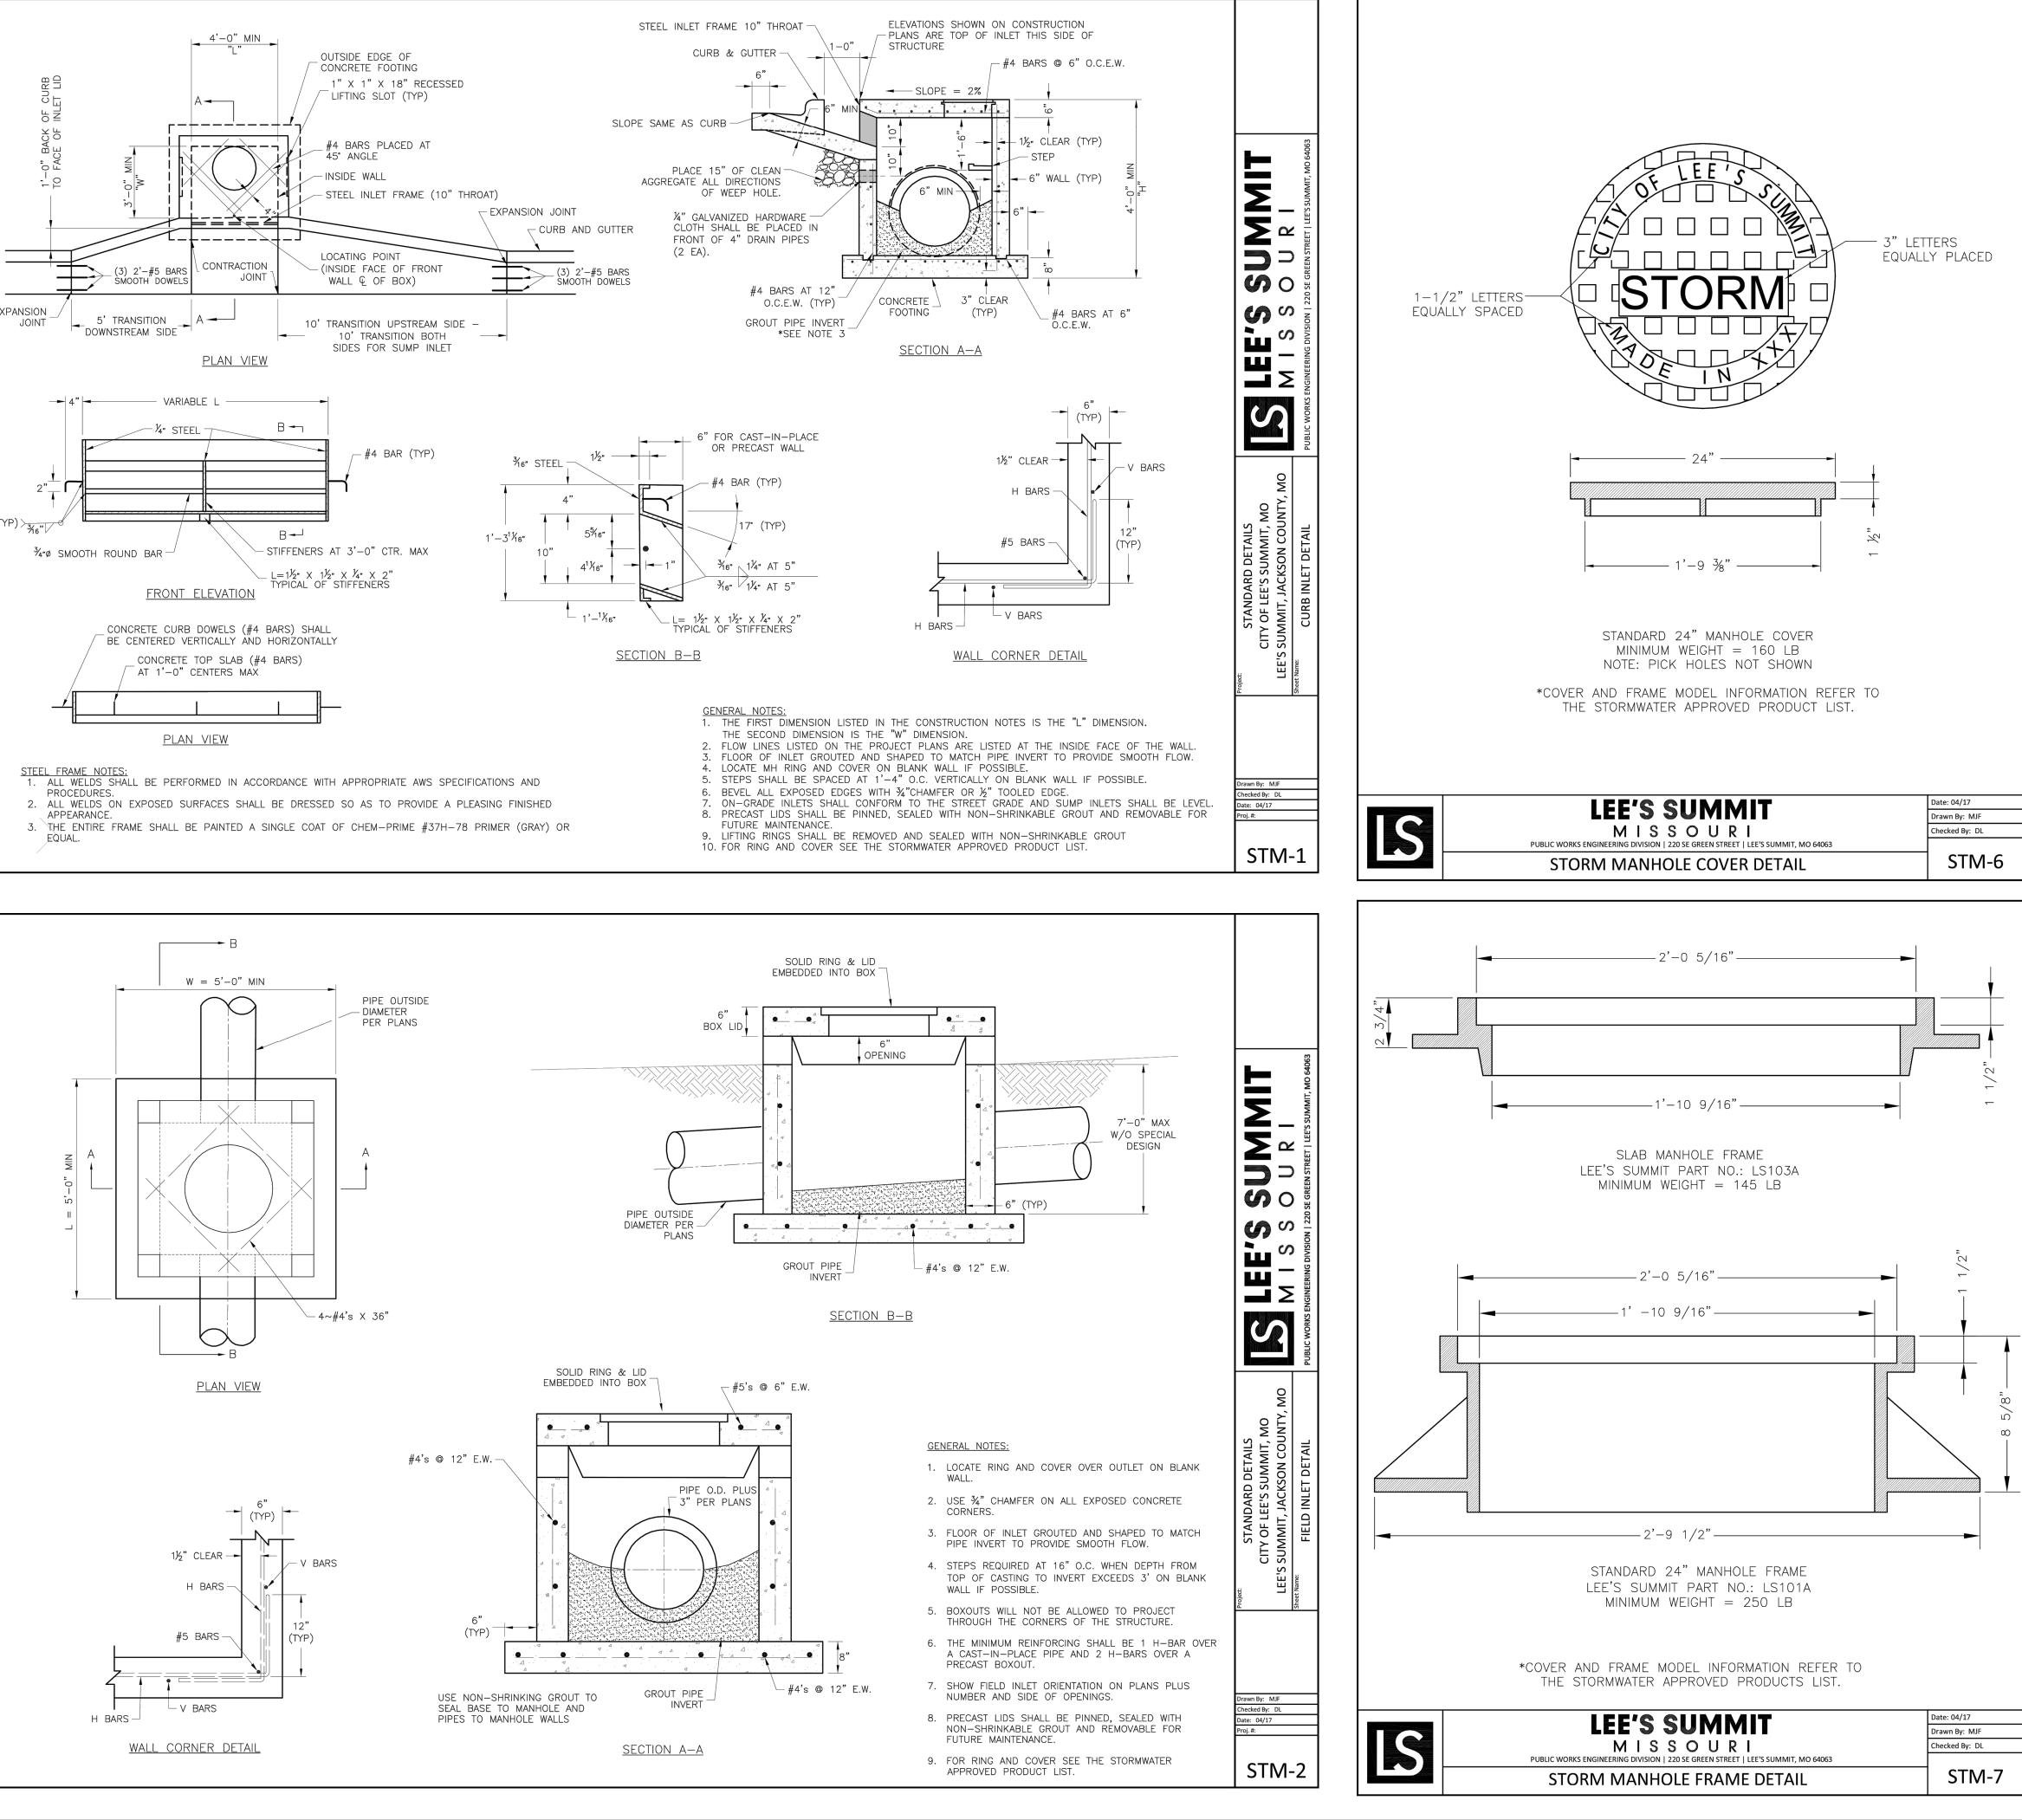Date: 04/17	
Date: 04/17 Drawn By: MJF	
U R I Checked By: DL	
EN STREET   LEE'S SUMMIT, MO 64063	
RAME DETAIL STM	-7

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90% Plan Set	11/17/20
100% Plan Set/Bid Set	12/16/20
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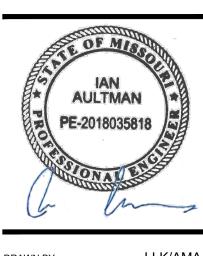
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#### PROJECT

WHATABURGER PT20M BUILDING

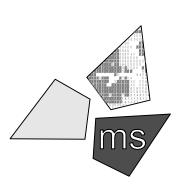
1460 NE DOUGLAS ST. LEE'S SUMMIT, MO 64086

## SHEET TITLE STORM SEWER DETAILS



DRAWN BY:	LLK/AMA
CHECKED BY:	KEA
PROJECT NO:	40497-01
DRAWING	

C-13.1

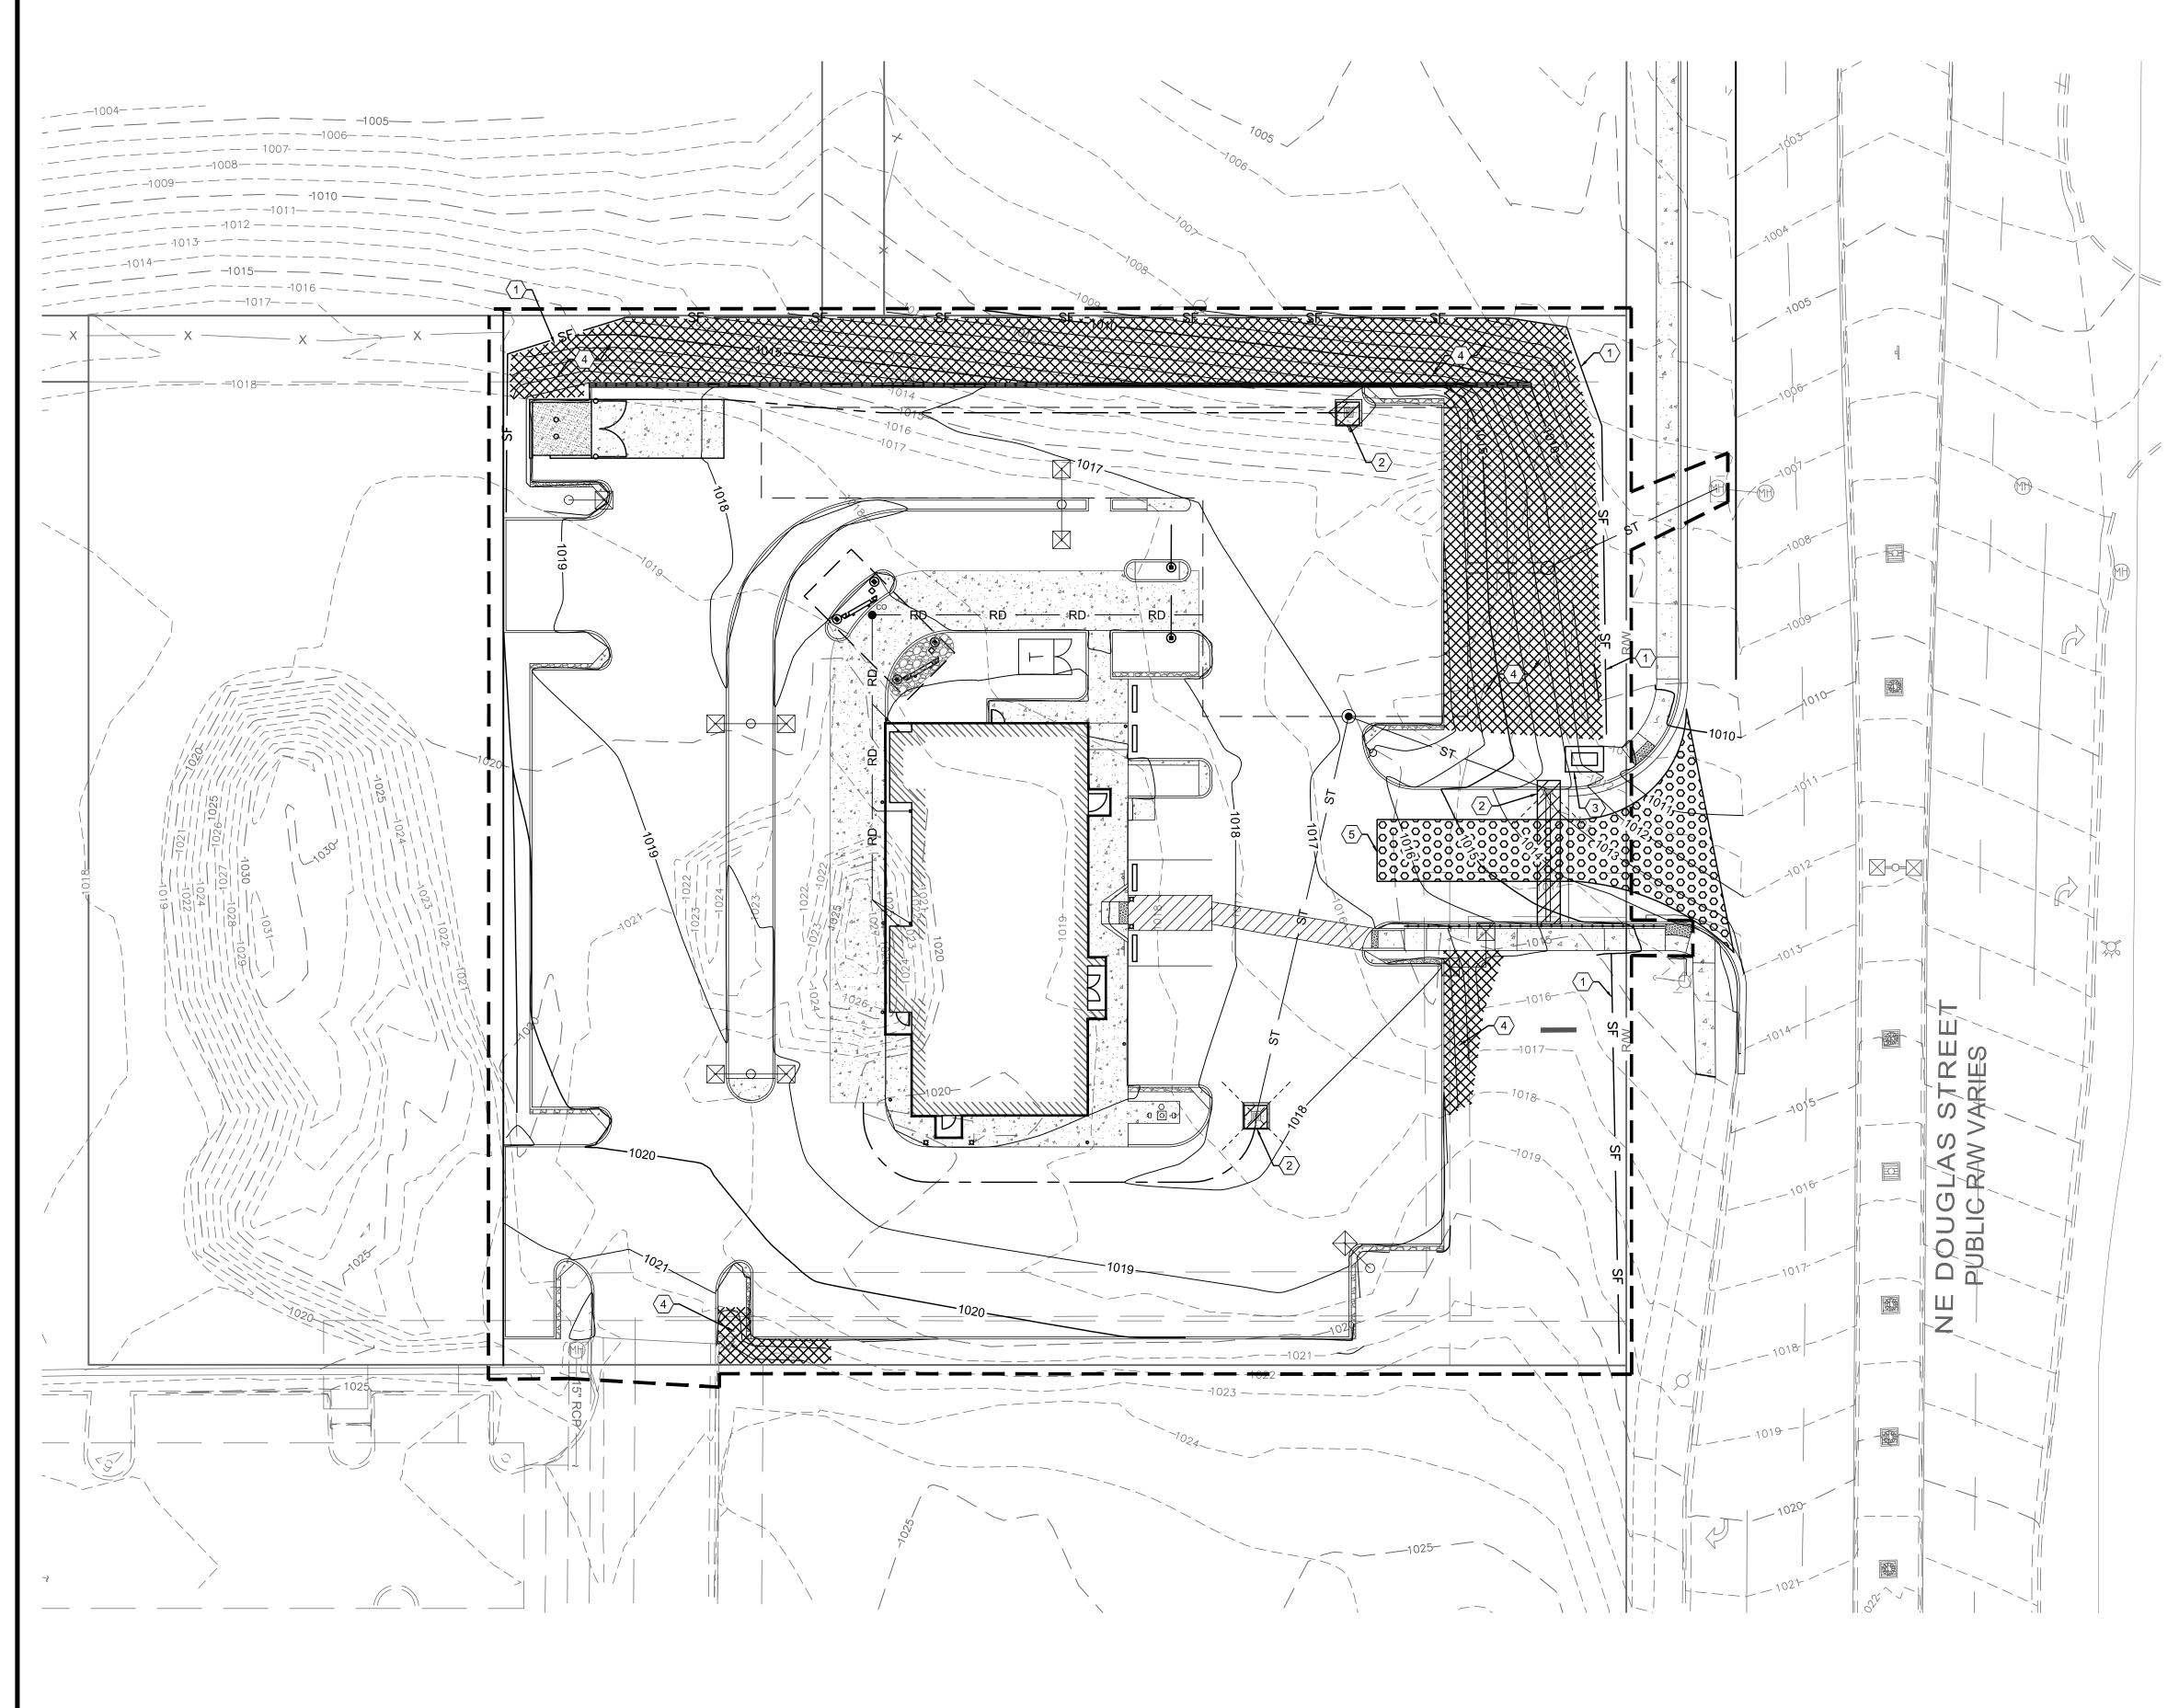

## **KEYED NOTES:**

- TEMPORARY SILT FENCE, SEE DETAIL ON SHEET C-16.1.
- (2) INLET PROTECTION, SEE DETAILS ON SHEET C-16.2.
- (3) CONCRETE WASHOUT, SEE DETAIL ON SHEET C-16.1.
- 4 SLOPE PROTECTION, SEE DETAIL ON SHEET C-16.1.
- 5 CONSTRUCTION ENTRANCE, SEE DETAIL ON SHEET C-16.1.

## LEGEND

EXISTING

PROPOSED — SF — SILT FENCE 



DESCRIPTION


CONCRETE WASHOUT

SLOPE PROTECTION

CONSTRUCTION ENTRANCE

## CONSTRUCTION SEQUENCE

- 1. INSTALL ALL PERIMETER EROSION AND SEDIMENT CONTROL BMPS AT THE LOCATIONS INDICATED ON THE STORM WATER POLLUTION PREVENTION PLAN (SWPPP) PRIOR TO ANY EARTH DISTURBANCE.
- 2. CONSTRUCT THE STABILIZED CONSTRUCTION ENTRANCE.
- 3. CLEAR AND GRUB AS NEEDED.
- 4. FULL SITE GRADING.
- 5. PILE TOPSOIL WITHIN SILT FENCE PERIMETER.
- 6. STABILIZE DENUDED AREAS AND STOCKPILES WITHIN 14 DAYS OF LAST CONSTRUCTION ACTIVITY IN THAT AREA AND INSTALL SLOPE PROTECTION AND TEMPORARY SEEDING AS NEEDED.
- 7. INSTALL CONCRETE WASHOUT.
- 8. INSTALL PROPOSED UTILITIES INCLUDING INLET PROTECTION AS STORM INLETS ARE INSTALLED.
- 9. BUILDING CONSTRUCTION AND SITE PAVING.
- 10. REMOVE CONCRETE WASHOUT.
- 11. FINAL GRADING AND INSTALL PERMANENT SEEDING ON NON-PAVED AREAS OF SITE.
- 12. RESEED ANY DISTURBED AREAS AND LANDSCAPE SITE.
- 13. ONCE 70% VEGETATIVE COVERAGE IS ACHIEVED, REMOVE TEMPORARY EROSION PROTECTION.

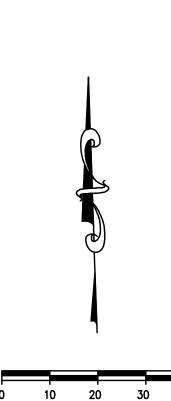

SCALE: 1"=20'



is a communications system which was established to help prevent damage to underground facilities and to promote safety. Missouri One Call operators are on duty 24 hours a day, seven days a week. Missouri One Call provides a telephone number for contractors and the general public to call for notification of their intent to use

1-800-DIG-RITE or 811

equipment for excavation, grading, blasting, boring, demolition or other types of similar work.

#### MAKE THE CALL ... IT'S THE LAW


**REVISION/DATE/DESCRIPTION** 

60% Plan Set 10/20/20 90% Plan Set 11/17/20 100% Plan Set/Bid Set 12/16/20

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#### PROJECT

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## SHEET TITLE

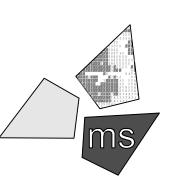


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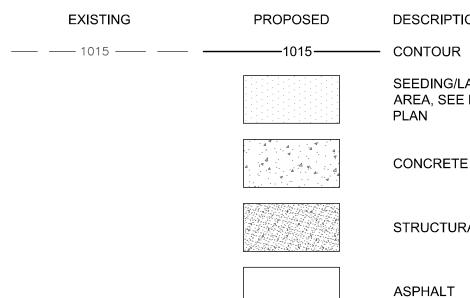
C-14

DRAWING



## LEGEND

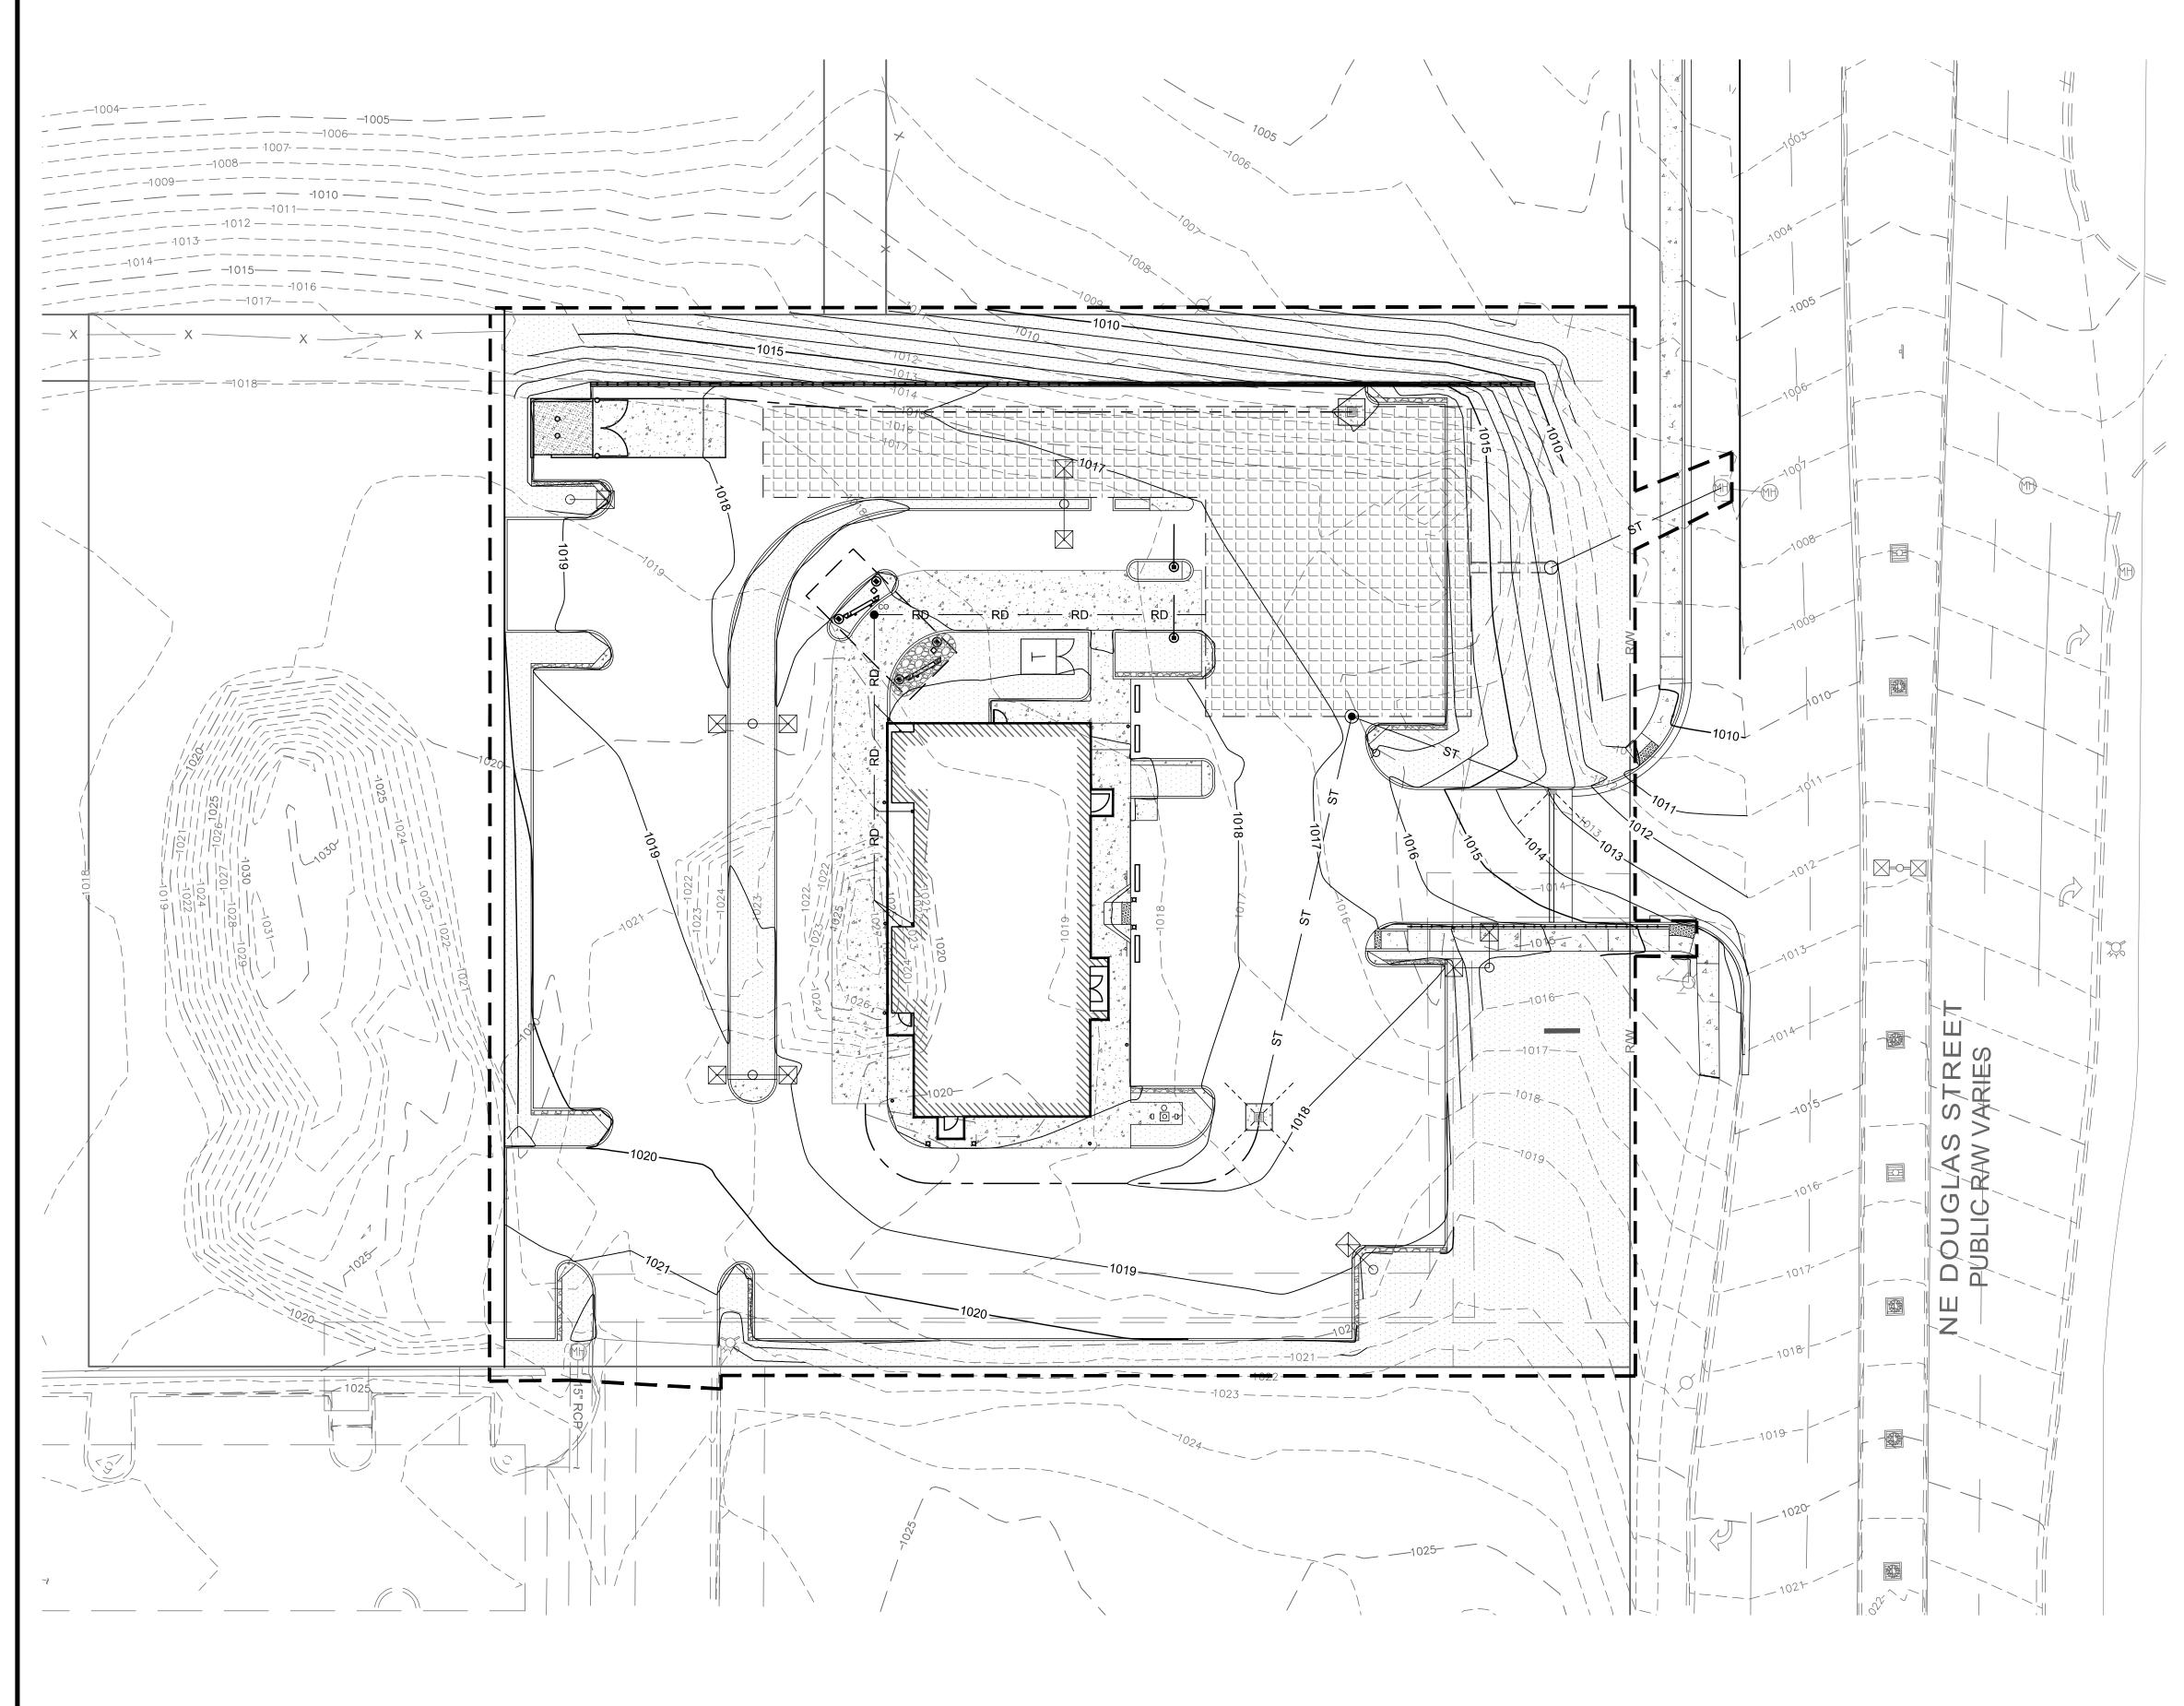EXISTING



DESCRIPTION

SEEDING/LANDSCAPING AREA, SEE LANDSCAPE PLAN

CONCRETE

STRUCTURAL CONCRETE

ASPHALT

UNDERGROND STORAGE



The Missouri One Call System is a communications system which was established to help prevent was established to help prevent damage to underground facilities and to promote safety. Missouri One Call operators are on duty 24 hours a day, seven days a week. Missouri One Call provides a telephone number for contractors and the general public to call for notification of their intent to use

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#### MAKE THE CALL ... IT'S THE LAW

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REVISION/DATE/DESCRIPTION

60% Plan Set

90% Plan Set


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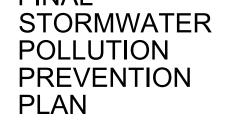
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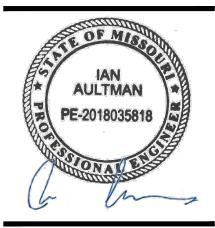
#### PROJECT

WHATABURGER PT20M BUILDING

1460 NE DOUGLAS ST. LEE'S SUMMIT, MO 64086

#### SHEET TITLE FINAL




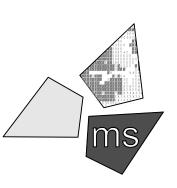

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CHECKED BY:	KEA
PROJECT NO:	40497-01

DRAWING

C-14.1

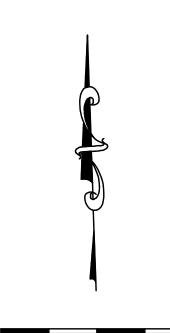

10 20 30 SCALE: 1"=20'

PROJECT NAME AND LOCATION WHATABURGER		POST CONSTRU
1460 NE DOUGLAS ST. LEE'S SUMMIT, MO 64086		UNDERGRO
OWNER NAME AND ADDRESS WHATABURGER 300 CONCORD PLAZA DR. SAN ANTONIO, TX 78216		<ul> <li>12" SUMPS</li> <li>ADS - ISOL</li> <li>G<u>OTHER SI</u></li> </ul>
PHONE: (210) 476-6000 CONTACT: CLINT SAAVEDRA		TEMPORAF     WILL BE LE
EMAIL: csaavedra@wbhq.com SITE CONTACT		<ul> <li>PERMANEN</li> <li>1 YEAR OR</li> <li>SEDIMENT</li> </ul>
ms consultants, inc. 2221 SCHROCK ROAD COLUMBUS, OHIO 43229		ADDITIONAL BM
PHONE: (614) 898-7100 CONTACT: KAILEN AKERS EMAIL: kakers@msconsultants.com		AS TIRES, CARS RESTRICTED A
GENERAL SCOPE OF PROJECT THIS PROJECT WILL CONSIST OF A RESTAURANT AND THE C ASSOCIATED DRAINAGE FACILITIES AND OTHER MISCELLAN		1. WITHIN CO 2. WITHIN 1,00 3. WITHIN A C
NATURE OF CONSTRUCTION ACTIVITY (CHECK ALL THAT APP		OUTSIDE THE R
SUBDIVISION       COMMERCIAL       X       INDUSTRIAL       P.U.D.       OTHER		OFF THE PROP ACTIVITIES: HE HEATING OR W LANDSCAPE W EPA), AND AGR
<u>SOIL TYPES</u> 10024 - GREENTON-URBAN LAND COMPLEX, 5 TO 9 PERCENT	SLOPES	
10082 - ARISBURG-URBAN LAND COMPLEX, 1 TO 5 PERCENT CONSTRUCTION SITE ESTIMATES	SLOPES	USED IN ACCOF DISCHARGE TO MUST BE OBSE
TOTAL SITE AREA: CONSTRUCTION SITE AREA TO BE DISTURBED:	<u> </u>	SHORT TERM F
PERCENTAGE IMPERVIOUS AREA BEFORE CONSTRUCTION: RUNOFF COEFFICIENT BEFORE CONSTRUCTION: PERCENTAGE IMPERVIOUS AREA AFTER CONSTRUCTION:	<u>0.0%</u> 0.30 74.7%	AIR PERMITTING ACTIVITIES ASS CONCRETE BAT
RUNOFF COEFFICIENT AFTER CONSTRUCTION:	0.75	SPECIFIC MISS THE CORRESP EPA FOR ALL C
RECEIVING WATERS THE SITE IS TRIBUTARY TO LITTLE CEDAR CREEK BY AN EXIS	STING STORM SEWER.	WASTE DISPOS
CONSTRUCTION SEQUENCE THE ORDER OF MAJOR ACTIVITIES WILL BE AS FOLLOWS:		BOUNDARIES D OF BY THE CON AND CONSTRUC
<ol> <li>PRE-CONSTRUCTION MEETING</li> <li>BEFORE AND SITE GRADING ACTIVITIES BEGIN</li> </ol>		OFFSITE VEHIC
a. INSTALL PERIMETER SILT FENCES b. INSTALL INLET PROTECTION ON EXISTING INLETS		ROADS SHALL E CONTROL EROS
<ul><li>c. CONSTRUCT TEMPORARY CONSTRUCTION ENTRAN</li><li>3. BEGIN SITE GRADING AND TOPSOIL STRIPPING</li></ul>	ICE	CONTROL SEDI SANITARY WAS
a. ESTABLISH TOPSOIL STOCKPILE WITHIN SILT FENCE b. STABILIZE DENUDED AREAS AND STOCKPILES WITH	E PERIMETER IIN 14 DAYS OF LAST CONSTRUCTION ACTIVITY IN THAT AREA	
c. INSTALL EROSION CONTROL MATTING AT LOCATION 4. INSTALL UTILITIES, SANITARY SEWERS, WATER SERVICE		FERTILIZERS AI MANUFACTURE SPECIFICATION
5. BEFORE INSTALLING UNDERGROUND DETENTION.	JRING INSTALLATION OF UNDERGROUND DETENTION. NOTIFY	NOT ANTICIPAT
ENGINEER 5 DAYS PRIOR TO INSTALLATION b. INSTALL GEOTEXTILE BOX INLET PROTECTION AND	DANDY BAG OR APPROVED EQUAL ON ALL SITE INLETS	MAINTENANCE THE CONTRACT THE REMOVAL
c. INSTALL SILT FENCE AROUND PERIMETER OF UNDE LADEN CONSTRUCTION RUNOFF FROM ENTERING T	RGROUND DETENTION EXCAVATION TO PREVENT ANY SEDIMENT THE SYSTEM DURING CONSTRUCTION	THE REMOVAL
<ol> <li>6. INSTALL UNDERGROUND DETENTION</li> <li>7. BEGIN CONSTRUCTION OF BUILDING FOUNDATION AND</li> </ol>	STRUCTURE	AND FOLLOWIN SHALL BE REQU SWPPP AMEND
<ol> <li>INSTALL CURBS, PREPARE PAVEMENT SUBGRADE AND I</li> <li>PAVE AREAS AND EXTERIOR BUILDING CONSTRUCTED</li> </ol>		AND SEDIMENT
<ol> <li>10. FINAL GRADING AND PERMANENT SEEDING OF THE NON GRADE</li> <li>11. ONCE 70% VEGETATIVE COVERAGE IS ACHIEVED, REMC</li> </ol>	I-PAVED AREAS OF THE SITE WITHIN 7 DAYS OF FINISHING FINAL	A. PROJECT F
POTENTIAL SOURCES OF POLLUTION		B. PROVIDE A
CONCRETE DETERGENTS		C. REVIEW ST CONTROLS BARE SPOT
WOOD FERTILIZERS PAINTS (ENAMEL AND LATEX)		D. ONCE HEAI
CLEANING SOLVENTS PETROLEUM BASED PRODUCTS		HEIGHT OF E. REVIEW ST
EROSION AND SEDIMENT CONTROLS		NECESSAR
BMP DESCRIPTION: MAINTENANCE AND INSPECTION:	CLEARING AND GRUBBING AS NEEDED	F. AN INSPEC OF 0.5 INCH
REFERENCE: BMP DESCRIPTION:	TECHNICAL SPECIFICATION	ANY AMEN
MAINTENANCE AND INSPECTION: REFERENCE:	AS NEEDED E&S DETAILS	G. IF THE CON CONSTRUC BASIS AND
BMP DESCRIPTION:	TEMPORARY SEEDING AND MULCHING	DISCHARG
MAINTENANCE AND INSPECTION: REFERENCE:	WEEKLY AND AFTER HEAVY RAIN E&S DETAILS	INSPECTIONS QUALIFIED PER
BMP DESCRIPTION: MAINTENANCE AND INSPECTION:	PERMANENT SEEDING AND MULCHING WEEKLY AND AFTER HEAVY RAIN	DISTURBED ARI STORAGE OF M POLLUTANTS E
REFERENCE:	E&S DETAILS	AND SEDIMENT AND MAINTENA OF WATER OR (
BMP DESCRIPTION: MAINTENANCE AND INSPECTION: REFERENCE:	CONSTRUCTION ENTRANCE AS NEEDED E&S DETAILS	FOLLOWING TH
BMP DESCRIPTION: MAINTENANCE AND INSPECTION:	ADS - ISOLATOR ROW AS NEEDED	ALLOWABLE NO THEM FROM BE
REFERENCE:	O&M MANUAL	<ol> <li>WATERS U</li> <li>WATER US</li> <li>POTABLE V</li> </ol>
		4. ROUTINE E 5. PAVEMENT
		ALL SPILLE

UCTION BMP'S

OUND DETENTION

AT CATCH BASINS ATOR ROW

EDIMENT AND EROSION CONTROL NOTES

RY EROSION CONTROLS WILL BE APPLIED PRIOR TO ONSET OF WINTER WEATHER FOR DISTURBED AREAS THAT EFT IDLE OVER WINTER.

NT EROSION CONTROLS WILL BE APPLIED WITHIN 7 DAYS FOR DISTURBED AREAS REMAINING DORMANT FOR OVER R AT FINAL GRADE.

CONTROL DEVICES WILL BE IMPLEMENTED FOR ALL AREAS REMAINING DISTURBED OVER 7 DAYS.

<u> MP'S</u> S: NO MATERIALS MAY BE BURNED WHICH CONTAIN RUBBER, GREASE, ASPHALT, OR PETROLEUM PRODUCTS SUCH S, AUTO PARTS, PLASTICS OR PLASTIC COATED WIRE. OPEN BURNING IS NOT ALLOWED IN RESTRICTED AREAS. REAS ARE DEFINED AS:

DRPORATION LIMITS

000 FEET OF A MUNICIPAL CORPORATION ONE MILE ZONE OUTSIDE OF A CORPORATION OF 10,000 OR MORE

RESTRICTED AREA, NO OPEN BURNING CAN TAKE PLACE WITHIN 1,000 FEET OF AN INHABITED BUILDING LOCATED PERTY WHERE THE FIRE IS SET. OPEN BURNING IS PERMISSIBLE IN A RESTRICTED AREA FOR THE FOLLOWING ATING TAR, WELDING AND ACETYLENE TORCHES, SMUDGE POTS AND SIMILAR OCCUPATIONAL NEEDS, AND ARMTH FOR OUTDOOR BARBEQUES. OUTSIDE OF RESTRICTED AREAS, OPEN BURNING IS PERMISSIBLE FOR ASTES (PLANT MATERIAL), LAND-CLEARING WASTES (PLANT MATERIAL, WITH PRIOR WRITTEN PERMISSION FROM RICULTURAL WASTES (MATERIAL GENERATED BY CROP, HORTICULTURAL, OR LIVESTOCK PRODUCTION PRACTICES.

L/SUPPRESSANTS: DUST CONTROL IS REQUIRED TO PREVENT NUISANCE CONDITIONS. DUST CONTROLS MUST BE RDANCE WITH MANUFACTURER'S SPECIFICATION AND NOT BE APPLIED IN A MANNER, WHICH WOULD RESULT IN A WATERS OF THE STATE. ISOLATION DISTANCES FROM BRIDGES, CATCH BASINS, AND OTHER DRAINAGE WAYS RVED. APPLICATION (EXCLUDING WATER) MAY NOT OCCUR WHEN PRECIPITATION IS IMMINENT AS NOTED IN THE ORECAST. USED OIL MAY NOT BE APPLIED FOR DUST CONTROL.

G REQUIREMENTS: ALL CONTRACTORS AND SUB CONTRACTORS MUST BE MADE AWARE THAT CERTAIN SOCIATED WITH CONSTRUCTION WILL REQUIRE AIR PERMITS. ACTIVITIES INCLUDING BUT NOT LIMITED TO MOBILE TCH PLANTS, MOBILE ASPHALT PLANTS, CONCRETE CRUSHERS, LARGE GENERATORS, ETC., WILL REQUIRE OURI EPA AIR PERMITS FOR INSTALLATION AND OPERATION. THESE ACTIVITIES MUST SEE AUTHORIZATION FROM ONDING OF MISSOURI EPA. NOTIFICATION FOR RESTORATION AND DEMOLITION MUST BE SUBMITTED TO MISSOURI COMMERCIAL SITES TO DETERMINE IF ASBESTOS CORRECTIVE ACTIONS ARE REQUIRED.

AL: THE CONTRACTOR SHALL PROVIDE LITTER CONTROL AND COLLECTION OF MATERIALS WITHIN THE PROJECT URING CONSTRUCTION. ALL FERTILIZER, HYDROCARBON, OR OTHER CHEMICAL CONTAINERS SHALL BE DISPOSED NTRACTOR IN ACCORDANCE WITH THE EPA'S STANDARD PRACTICES. NO SOLID MATERIAL INCLUDING BUILDING ICTION MATERIAL SHALL BE DISPOSED OF, DISCHARGED OR BURIED ONSITE.

LE TRACKING: LOADED HAUL TRUCKS SHALL BE COVERED WITH A TARPAULIN. EXCESS DIRT MATERIAL ON THE BE REMOVED IMMEDIATELY. HAULING ON UNPAVED SURFACES SHALL BE MONITORED TO MINIMIZE DUST AND SION. HAUL ROADS SHALL BE WATERED OR OTHER CONTROLS PROVIDED AS NECESSARY TO REDUCE DUST AND IMENTS.

STE: THE CONTRACTOR SHALL PROVIDE PORTABLE SANITARY WASTE FACILITIES. THESE FACILITIES SHALL BE R EMPTIED BY A LICENSED SANITARY WASTE MANAGEMENT CONTRACTOR AS REQUIRED BY STATE REGULATIONS.

ND PESTICIDES: FERTILIZER SHALL BE APPLIED AT A RATE SPECIFIED BY THE SPECIFICATIONS OR THE ER. THE APPLICATION OF FERTILIZERS SHALL BE ACCOMPLISHED IN A MANNER AS DESCRIBED BY THE N OR MANUFACTURER TO ENSURE THE PROPER INSTALLATION AND TO AVOID OVER FERTILIZING. PESTICIDES ARE FED FOR THIS PROJECT.

TOR WILL BE RESPONSIBLE FOR MAINTENANCE AND REPAIRS OF EROSION AND SEDIMENT CONTROL DEVICES AND OF THE EROSION AND SEDIMENT CONTROL DEVICES AFTER THE NOTICE OF TERMINATION IS EXECUTED.

TOR SHALL REVIEW THE PROJECT AND ALL EROSION AND SEDIMENT CONTROLS ON A DAILY BASIS AND DURING NG RAINFALL EVENTS. AN INSPECTION FORM HAS BEEN PROVIDED IN THE SPECIFICATIONS. THE CONTRACTOR UIRED TO KEEP A LOG OF ALL THE DAILY INSPECTION REPORTS, GRADING AND STABILIZATION ACTIVITIES, AND DMENTS AT THE SITE. THE FOLLOWING PRACTICES WILL BE IMPLEMENTED TO MAINTAIN AND MONITOR EROSION CONTROLS.

REVIEW ON A DAILY BASIS.

AND MAINTAIN RAIN GAUGES ONSITE (IF NOT AVAILABLE IN THE AREA) TO RECORD RAINFALL DATA DAILY.

TABILIZATION PRACTICES AND CONTROLS ON A DAILY BASIS AND MAINTAIN AND REPAIR THESE MEASURES AND S AS NECESSARY. TEMPORARY AND/OR PERMANENT SEEDING, MULCHING AND SODDING SHALL BE REPAIRED IN TS AND WASHOUTS, AND HEALTHY GROWTH ESTABLISHED.

LTHY GROWTH OF TURF IS ESTABLISHED, THE CONTRACTOR SHALL MAINTAIN THESE AREAS TO INSURE THE THE GRASS DOES NOT REACH MORE THAN 6 INCHES ABOVE THE ESTABLISHED GRADE.

TRUCTURAL PRACTICES ON A DAILY BASIS AND MAINTAIN AND REPAIR THESE MEASURES AND CONTROLS AS RY. BUILT UP SEDIMENTS SHALL BE REMOVED FROM SILT FENCES AND FILTER CLOTH SHALL BE REPLACED AS RY AND WHEN THEY HAVE SERVED THEIR USEFULNESS.

CTION AND MAINTENANCE REPORT SHALL BE COMPLETED WEEKLY AND WITHIN 24 HOURS OF A RAINFALL EVENT HES OR MORE. THE CONTRACTOR SHALL CREATE AN INSPECTION AND MAINTENANCE REPORT LOG AND NOTE IDMENTS TO THE SWPPP THAT OCCUR DURING CONSTRUCTION.

NTRACTOR ELECTS TO APPLY FOR PERMITS FOR DISCHARGE OF STORMWATER FROM THE SITE DURING CTION, ALL POINTS OF DISCHARGE OF STORMWATER RUNOFF FROM THE SITE SHALL BE INSPECTED ON A DAILY CONTROLS AND MEASURES REPAIRED AS NECESSARY TO MAINTAIN ACCEPTABLE WATER QUALITY AND E VOLUMES IN ACCORDANCE WITH THE PERMIT.

RSONNEL SHALL INSPECT ALL POINTS OF DISCHARGE, AS APPLICABLE, FROM THE PROJECT SITE AND ALL REAS OF THE CONSTRUCTION SITE THAT HAVE NOT BEEN STABILIZED. DISTURBED AREAS AND AREAS USED FOR IATERIALS EXPOSED TO PRECIPITATION SHALL BE INSPECTED FOR EVIDENCE OF, OR POTENTIAL FOR ENTERING THE STORMWATER MANAGEMENT SYSTEM. THE STORMWATER MANAGEMENT SYSTEM AND EROSION I CONTROL MEASURES SHALL BE OBSERVED TO ENSURE THAT THEY ARE OPERATING CORRECTLY. INSPECTION ANCE REPORTS SHALL BE COMPLETED AT LEAST EVERY WEEK AND FOLLOWING A RAINFALL EVENT OF 0.5 INCHES GREATER (SEE ATTACHED FORM). THESE FORMS SHALL BE RETAINED FOR A PERIOD OF AT LEAST 3 YEARS HE DATE THE SITE IS FINALLY STABILIZED.

ON-STORMWATER DISCHARGE MANAGEMENT

ON-STORMWATER DISCHARGES AND THE MEASURES USED TO ELIMINATE OR REDUCE THEM AND TO PREVENT ECOMING CONTAMINATED MAY INCLUDE DEPENDING ON THE PERMIT:

JSED TO WASH VEHICLES WHERE DETERGENTS ARE NOT USED

SED TO CONTROL DUST

WATER INCLUDING UNCONTAMINATED WATER LINE FLUSHINGS

EXTERNAL BUILDING WASH DOWN THAT DOES NOT USE DETERGENTS

T WASH WATER WHERE SPILLS OR LEAKS OF TOXIC OR HAZARDOUS MATERIALS HAVE NOT OCCURRED (UNLESS ED MATERIAL HAS BEEN REMOVED) AND WHERE DETERGENTS ARE NOT USED 6. UNCONTAMINATED AIR CONDITIONING OR COMPRESSOR CONDENSATE

7. UNCONTAMINATED GROUND WATER OR SPRING WATER

8. FOUNDATION OR FOOTING DRAINS WHERE FLOWS ARE NOT CONTAMINATED WITH PROCESS MATERIALS SUCH AS SOLVENTS 9. UNCONTAMINATED EXCAVATION DEWATERING 10. LANDSCAPE IRRIGATION

ESTABLISH PROPER EQUIPMENT/VEHICLE FUELING AND MAINTENANCE PRACTICES EQUIPMENT FUELING AND MAINTENANCE, OIL CHANGING, ETC., SHALL BE PERFORMED AWAY FROM WATERCOURSES, DITCHES, OR STORM DRAINS, IN AN AREA DESIGNATED FOR THAT PURPOSE. THE DESIGNATED AREA SHALL BE EQUIPPED FOR RECYCLING OIL AND CATCHING SPILLS. SECONDARY CONTAINMENT SHALL BE PROVIDED FOR ALL FUEL OIL STORAGE TANKS. THESE AREAS MUST BE INSPECTED EVERY SEVEN DAYS AND WITHIN 24 HOURS OF A 0.5 INCH OR GREATER RAIN EVENT TO ENSURE THERE ARE NO EXPOSED MATERIALS WHICH WOULD CONTAMINATE STORM WATER.

SPILL PREVENTION CONTROL PLAN SITE OPERATORS MUST BE AWARE THAT SPILL PREVENTION CONTROL AND COUNTERMEASURES (SPCC) REQUIREMENTS APPLY. AN SPCC PLAN IS REQUIRED FOR SITES WITH ONE SINGLE ABOVEGROUND STORAGE OF 1,320 GALLONS OR MORE, OR 42,000 GALLONS OF UNDERGROUND STORAGE. SOILS THAT HAVE BEEN CONTAMINATED MUST BE DISPOSED OF IN ACCORDANCE WITH SECTION "CONTAMINATED SOILS" FOUND BELOW.

SPILLS ON PAVEMENT SHALL BE ABSORBED WITH SAWDUST, CAT LITTER OR OTHER ABSORBENT MATERIAL AND DISPOSED OF WITH THE TRASH AT A LICENSED SANITARY LANDFILL. HAZARDOUS OR INDUSTRIAL WASTES SUCH AS MOST SOLVENTS, GASOLINE, OIL-BASED PAINTS, AND CEMENT CURING COMPOUNDS REQUIRE SPECIAL HANDLING. SPILLS SHALL BE REPORTED TO THE EPA (1-913-281-0991). SPILLS OF 25 GALLONS OR MORE OF PETROLEUM PRODUCTS SHALL BE REPORTED TO EPA (1-913-281-0991), THE LOCAL FIRE DEPARTMENT, AND THE LOCAL EMERGENCY PLANNING COMMITTEE WITHIN 30 MINUTES OF THE DISCOVERY OF THE RELEASE. ALL SPILLS, WHICH RESULT IN CONTACT WITH WATER OF THE STATE, MUST BE REPORTED TO THE EPA'S HOTLINE.

#### CONTAMINATED SOILS

IF SUBSTANCES SUCH AS OIL, DIESEL FUEL, HYDRAULIC FLUID, ANTIFREEZE, ETC., ARE SPILLED, LEAKED, OR RELEASED ONTO THE SOIL, THE SOIL SHOULD BE DUG UP AND DISPOSED OF AT A LICENSED SANITARY LANDFILL OR OTHER APPROVED PETROLEUM CONTAMINATED SOIL REMEDIATION FACILITY (NOT A CONSTRUCTION/DEMOLITION DEBRIS LANDFILL). PLEASE BE AWARE THAT STORM WATER RUN OFF ASSOCIATED WITH CONTAMINATED SOILS ARE NOT BEING AUTHORIZED UNDER THE EPA'S GENERAL STORMWATER PERMIT ASSOCIATED WITH CONSTRUCTION ACTIVITIES. IN THE EVENT THERE ARE LARGE EXTENSIVE AREAS OF CONTAMINATED SOILS ADDITIONAL MEASURES ABOVE AND BEYOND THE CONDITIONS OF THE EPA'S GENERAL CONSTRUCTION STORMWATER PERMIT WILL BE REQUIRED. DEPENDING ON THE EXTENT OF CONTAMINATION, ADDITIONAL TREATMENT AND/OR COLLECTION AND DISPOSAL MAY BE REQUIRED. ALL STORMWATER DISCHARGES ASSOCIATED WITH CONTAMINATED SOILS MUST BE AUTHORIZED UNDER AN ALTERNATE NPDES PERMIT.


#### REVISION/DATE/DESCRIPTION

)% Plan Set	10/20/20
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00% Plan Set/Bid Set	12/16/20

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#### PROJECT

WHATABURGER PT20M BUILDING

1460 NE DOUGLAS ST. LEE'S SUMMIT, MO 64086

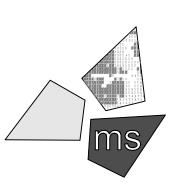SHEET TITLE SWPPP NOTES

PE-201803581	
DRAWN BY:	LLK/AMA

CHECKED BY:	KEA
PROJECT NO:	40497-01

**U-15** 

DRAWING

## TEMPORARY SEEDING

#### DESCRIPTION

TEMPORARY SEEDINGS ESTABLISH TEMPORARY COVER ON DISTURBED AREAS BY PLANTING APPROPRIATE RAPIDLY GROWING ANNUAL GRASSES OR SMALL GRAINS. TEMPORARY SEEDING PROVIDES EROSION CONTROL ON AREAS IN BETWEEN CONSTRUCTION OPERATIONS. GRASSES, WHICH ARE QUICK GROWING, ARE SEEDED AND USUALLY MULCHED TO PROVIDE PROMPT, TEMPORARY SOIL STABILIZATION. IT EFFECTIVELY MINIMIZES THE AREA OF A CONSTRUCTION SITE PRONE TO EROSION AND SHOULD BE USED EVERYWHERE THE SEQUENCE OF CONSTRUCTION OPERATIONS ALLOWS VEGETATION TO BE ESTABLISHED.

SPECIFICATIONS FOR TEMPORARY SEEDING

TEMPORARY SEEDING SPECIES SELECTION				
SEEDING DATES	SPECIES	LB/1000 SF	LB/ACREA	
MAR 1 TO AUG 15	OATS	3	128-4 BUSHEL	
	TALL FESCUE	1	40	
	ANNUAL RYEGRASS	1	40	
	PERENNIAL RYGRASS	1	40	
	TALL FESCUE	1	40	
	ANNUAL RYEGRASS	1	40	
	ANNUAL RYEGRASS	1.25	55	
	PERENNIAL RYEGRASS	3.25	142	
	CREEPING RED FESCUE	0.40	17	
	KENTUCKY BLUEGRASS	0.40	17	
	OATS	3	128-3 BUSHEL	
	TALL FESCUE	1	40	
	ANNUAL RYEGRASS	1	40	
AUG 16 TO NOV	RYE	3	112-3 BUSHEL	
	TALL FESCUE	1	40	
	ANNUAL RYEGRASS	1	40	
	WHEAT	3	120-2 BUSHEL	
	TALL FESCUE	1	40	
	ANNUAL RYEGRASS	1	40	
	PERENNIAL RYE	1	40	
	TALL FESCUE	1	40	
	ANNUAL RYEGRASS	1	40	
	ANNUAL RYEGRASS	1.25	40	
	PERENNIAL RYEGRASS	3.25	40	
	CREEPING RED FESCUE	0.40	40	
	KENTUCKY BLUEGRASS	0.40		
NOV 1 TO FEB 29 USE MULCH ONLY OR DORMANT SEEDING				

- 1. STRUCTURAL EROSION AND SEDIMENT CONTROL PRACTICES SUCH AS DIVERSIONS AND SEDIMENT TRAPS SHALL BE INSTALLED AND STADILIZED WITH TEMPORARY SEEDING PRIOR TO CRADING THE REST OF THE CONSTRUCTION SITE
- STABILIZED WITH TEMPORARY SEEDING PRIOR TO GRADING THE REST OF THE CONSTRUCTION SITE.
   TEMPORARY SEED SHALL BE APPLIED BETWEEN CONSTRUCTION OPERATIONS ON SOIL THAT WILL NOT BE GRADED OR REWORKED FOR 14 DAYS OR GREATER. THESE IDLE AREAS SHALL BE SEEDED WITHIN 7 DAYS AFTER GRADING.
- THE SEEDBED SHOULD BE PULVERIZED AND LOOSE TO ENSURE THE SUCCESS OF ESTABLISHING VEGETATION. TEMPORARY SEEDING SHOULD NOT BE POSTPONED IF IDEAL SEEDBED PREPARATION IS NOT POSSIBLE.
- SOIL AMENDMENTS TEMPORARY VEGETATION SEEDING RATES SHALL ESTABLISH ADEQUATE STANDS OF VEGETATION, WHICH MAY REQUIRE THE USE OF SOIL AMENDMENTS. BASE RATES FOR LIME AND FERTILIZER SHALL BE USED.
- 5. SEEDING METHOD SEED SHALL BE APPLIED UNIFORMLY WITH A CYCLONE SPREADER, DRILL, CULTIPACKER SEEDER, OR HYDROSEEDER. WHEN FEASIBLE, SEED THAT HAS BEEN BROADCAST SHALL BE COVERED BY RAKING OR DRAGGING AND THEN LIGHTLY TAMPED INTO PLACE USING A ROLLER OR CULTIPACKER. IF HYDROSEEDING IS USED, THE SEED AND FERTILIZER WILL BE MIXED ON-SITE AND THE SEEDING SHALL BE DONE IMMEDIATELY AND WITHOUT INTERRUPTION.

MULCHING TEMPORARY SEEDING:

- APPLICATIONS OF TEMPORARY SEEDING SHALL INCLUDE MULCH. WHICH SHALL BE APPLIED DURING OR IMMEDIATELY AFTER SEEDING. SEEDINGS MADE DURING OPTIMUM SEEDING DATES ON FAVORABLE, VERY FLAT SOIL CONDITIONS MAY NOT NEED MULCH TO ACHIEVE ADEQUATE STABILIZATION.
   MATERIALS:
- 2.1. STRAW IF STRAW IS USED, IT SHALL BE UNROTTED SMALL-GRAIN STRAW APPLIED AT A RATE OF 2 TONS PER ACRE
- OR 90 LBS./ 1,000 SQ. FT. (2-3 BALES) 2.2. HYDROSEEDERS IF WOOD CELLULOSE FIBER IS USED, IT SHALL BE USED AT 2000 LBS./ AC. OR 46 LB./ 1,000-SQ.-FT.
- 2.2. AT DROSEEDERS IF WOOD CELLOLOSE FIBER IS USED, IT SHALL BE USED AT 2000 LBS./ AC. OR 40 LB./ 1,000-SQ.-FT.
   2.3. OTHER OTHER ACCEPTABLE MULCHES INCLUDE MULCH MATTINGS APPLIED ACCORDING TO MANUFACTURER'S RECOMMENDATIONS OR WOOD CHIPS APPLIED AT 6 TON/ AC.
- STRAW MULCH SHALL BE ANCHORED IMMEDIATELY TO MINIMIZE LOSS BY WIND OR WATER. ANCHORING METHODS:
   3.1. MECHANICAL A DISK, CRIMPER, OR SIMILAR TYPE TOOL SHALL BE SET STRAIGHT TO PUNCH OR ANCHOR THE MULCH MATERIAL INTO
- THE SOIL. STRAW MECHANICALLY ANCHORED SHALL NOT BE FINELY CHOPPED BUT LEFT TO A LENGTH OF APPROXIMATELY 6 INCHES. 3.2. MULCH NETTING NETTING SHALL BE USED ACCORDING TO THE MANUFACTURERS RECOMMENDATIONS. NETTING MAY BE NECESSARY TO HOLD MULCH IN PLACE IN AREAS OF CONCENTRATED RUNOFF AND ON CRITICAL SLOPES.
- 3.3. SYNTHETIC BINDERS SYNTHETIC BINDERS SUCH AS ACRYLIC DLR (AGRI-TAC), DCA-70, PETROSET, TERRA TRACK OR EQUIVALENT MAY BE USED AT RATES RECOMMENDED BY THE MANUFACTURER.
- 3.4. WOOD-CELLULOSE FIBER WOOD-CELLULOSE FIBER BINDER SHALL BE APPLIED AT A NET DRY WT. OF 750 LB./AC. THE WOOD-CELLULOSE FIBER SHALL BE MIXED WITH WATER AND THE MIXTURE SHALL CONTAIN A MAXIMUM OF 50 LB. / 100 GAL.

## DUST CONTROL

#### DESCRIPTION

DUST CONTROL INVOLVES PREVENTING OR REDUCING DUST FROM EXPOSED SOILS OR OTHER SOURCES DURING LAND DISTURBING, DEMOLITION AND CONSTRUCTION ACTIVITIES TO REDUCE THE PRESENCE OF AIRBORNE SUBSTANCES WHICH MAY PRESENT HEALTH HAZARDS, TRAFFIC SAFETY PROBLEMS OR HARM ANIMAL OR PLANT LIFE.

SPECIFICATIONS FOR DUST CONTROL

- 1. VEGETATIVE COVER AND/MULCH APPLY TEMPORARY OR PERMANENT SEEDING AND MULCH TO AREAS THAT WILL REMAIN IDLE FOR OVER 21 DAYS. SAVING EXISTING TREES AND LARGE SHRUBS WILL ALSO REDUCE SOIL AND AIR MOVEMENT ACROSS DISTURBED AREAS. SEE TEMPORARY SEEDING; PERMANENT SEEDING; MULCHING PRACTICES; AND TREE AND NATURAL AREA PROTECTION PRACTICES.
- 2. WATERING SPRAY SITE WITH WATER UNTIL THE SURFACE IS WET BEFORE AND DURING GRADING AND REPEAT AS NEEDED, ESPECIALLY ON HAUL ROADS AND OTHER HEAVY TRAFFIC ROUTES. WATERING SHALL BE DONE AT A RATE THAT PREVENTS DUST BUT DOES NOT CAUSE SOIL EROSION. WETTING AGENTS SHALL BE UTILIZED ACCORDING TO MANUFACTURERS INSTRUCTIONS.
- SPRAY-ON ADHESIVES APPLY ADHESIVE ACCORDING TO THE FOLLOWING TABLE OR MANUFACTURER'S INSTRUCTIONS.
   STONE GRADED ROADWAYS AND OTHER SUITABLE AREAS WILL BE STABILIZED USING CRUSHED STONE OR COARSE GRAVEL AS SOON AS PRACTICABLE AFTER REACHING AN INTERIM OR FINAL GRADE. CRUSHED STONE OR COARSE GRAVEL CAN BE USED AS A PERMANENT COVER TO PROVIDE CONTROL OF SOIL EMISSIONS.
- BARRIERS EXISTING WINDBREAK VEGETATION SHALL BE MARKED AND PRESERVED. SNOW FENCING OR OTHER SUITABLE BARRIER MAY BE PLACED PERPENDICULAR TO PREVAILING AIR CURRENTS AT INTERVALS OF ABOUT 15 TIMES THE BARRIER HEIGHT TO CONTROL AIR CURRENTS AND BLOWING SOIL.
- OPERATION AND MAINTENANCE WHEN TEMPORARY DUST CONTROL MEASURES ARE USED; REPETITIVE TREATMENT SHOULD BE APPLIED AS NEEDED TO ACCOMPLISH CONTROL. STREET CLEANING - PAVED AREAS THAT HAVE ACCUMULATED SEDIMENT FROM CONSTRUCTION SHOULD BE CLEANED DAILY, OR AS NEEDED, UTILIZING A STREET SWEEPER OR BUCKET -TYPE END LOADER OR SCRAPER.

## PERMANENT SEEDING

#### DESCRIPTION

PERENNIAL VEGETATION IS ESTABLISHED ON AREAS THAT WILL NOT BE RE-DISTURBED FOR PERIODS LONGER THAN 12 MONTHS. PERMANENT SEEDING INCLUDES SITE PREPARATION, SEEDBED PREPARATION, PLANTING SEED, MULCHING, IRRIGATION AND MAINTENANCE.

PERMANENT VEGETATION IS USED TO STABILIZE SOIL, REDUCE EROSION, PREVENT SEDIMENT POLLUTION, REDUCE RUNOFF BY PROMOTING INFILTRATION, AND PROVIDE STORMWATER QUALITY BENEFITS OFFERED BY DENSE GRASS COVER.

#### SPECIFICATION FOR PERMANENT SEEDING

- SITE PREPARATION:
  1. SUBSOILER, PLOW, OR OTHER IMPLEMENT SHALL BE USED TO REDUCE SOIL COMPACTION AND ALLOW MAXIMUM INFILTRATION. (MAXIMIZING INFILTRATION WILL HELP CONTROL BOTH RUNOFF RATE AND WATER QUALITY.) SUBSOILING SHOULD BE DONE WHEN THE SOIL MOISTURE IS LOW ENOUGH TO ALLOW THE SOIL TO CRACK OR FRACTURE. SUBSOILING SHALL NOT BE DONE ON SLIP-PRONE AREAS
- WHERE SOIL PREPARATION SHOULD BE LIMITED TO WHAT IS NECESSARY FOR ESTABLISHING VEGETATION.
  THE SITE SHALL BE GRADED AS NEEDED TO PERMIT THE USE OF CONVENTIONAL EQUIPMENT FOR SEEDBED PREPARATION AND SEEDING.
  TOPSOIL SHALL BE APPLIED WHERE NEEDED TO ESTABLISH VEGETATION.

#### SEEDBED PREPARATION:

- 1. TEST THE SOIL CONDITIONS FOR FEEDING BEFORE STARTING SEEDING AND MULCHING.
- 2. LIME AGRICULTURAL GROUND LIMESTONE SHALL BE APPLIED TO ACID SOIL AS RECOMMENDED BY A SOIL TEST. IN LIEU OF A SOIL TEST, LIME SHALL BE APPLIED AT THE RATE OF 100 POUNDS PER 1,000-SQ. FT. OR 2 TONS PER ACRE.
- FERTILIZER FERTILIZER SHALL BE APPLIED AS RECOMMENDED BY A SOIL TEST. CONTRACTOR SHALL PERFORM LAB TESTING ON SOIL AND PROVIDE A CERTIFIED FERTILIZER RATIO FOR THE SITE SOILS AND SPECIFIED SEED MIX.
- 4. THE LIME AND FERTILIZER SHALL BE WORKED INTO THE SOIL WITH A DISK HARROW, SPRING-TOOTH HARROW, OR OTHER SUITABLE FIELD IMPLEMENT TO A DEPTH OF 3 INCHES. ON SLOPING LAND, THE SOIL SHALL BE WORKED ON THE CONTOUR.

#### SEEDING DATES AND SOIL CONDITIONS:

SEEDING SHOULD BE DONE MARCH 1 TO MAY 31 OR AUGUST 1 TO SEPTEMBER 30. IF SEEDING OCCURS OUTSIDE OF THE ABOVE SPECIFIED DATES, ADDITIONAL MULCH AND IRRIGATION MAY BE REQUIRED TO ENSURE A MINIMUM OF 80% GERMINATION. TILLAGE FOR SEEDBED PREPARATION SHOULD BE DONE WHEN THE SOIL IS DRY ENOUGH TO CRUMBLE AND NOT FORM RIBBONS WHEN COMPRESSED BY HAND. FOR WINTER SEEDING, SEE THE FOLLOWING SECTION ON DORMANT SEEDING.

#### DORMANT SEEDINGS:

1. SEEDINGS SHOULD NOT BE MADE FROM OCTOBER 1 THROUGH NOVEMBER 20. DURING THIS PERIOD, THE SEEDS ARE LIKELY TO GERMINATE BUT PROBABLY WILL NOT BE ABLE TO SURVIVE THE WINTER.

- THE FOLLOWING METHODS MAY BE USED FOR DORMANT SEEDING :
   FROM OCTOBER 1 THROUGH NOVEMBER 20, PREPARE THE SEEDBED, ADD THE REQUIRED AMOUNTS OF LIME AND FERTILIZER, THEN MULCH AND ANCHOR. AFTER NOVEMBER 20, AND BEFORE MARCH 15, BROADCAST THE SELECTED SEED MIXTURE. INCREASE THE SEEDING RATES BY 50% FOR THIS TYPE OF SEEDING.
- 2.2. FROM NOVEMBER 20 THROUGH MARCH 15, WHEN SOIL CONDITIONS PERMIT, PREPARE THE SEEDBED, LIME AND FERTILIZE, APPLY THE SELECTED SEED MIXTURE, MULCH AND ANCHOR. INCREASE THE SEEDING RATES BY 50% FOR THIS TYPE OF SEEDING.
  2.3. APPLY SEED UNIFORMLY WITH A CYCLONE SEEDER, DRILL, CULTIPACKER SEEDER, OR HYDRO-SEEDER (SLURRY MAY INCLUDE SEED
- AND FERTILIZER) ON A FIRM, MOIST SEEDBED.
- 2.4. WHERE FEASIBLE, EXCEPT WHEN A CULTIPACKER TYPE SEEDER IS USED, THE SEEDBED SHOULD BE FIRMED FOLLOWING SEEDING OPERATIONS WITH A CULTIPACKER, ROLLER, OR LIGHT DRAG. ON SLOPING LAND, SEEDING OPERATIONS SHOULD BE ON THE CONTOUR WHERE FEASIBLE.

#### MULCHING:

 MULCH MATERIAL SHALL BE APPLIED IMMEDIATELY AFTER SEEDING. DORMANT SEEDING SHALL BE MULCHED. 100% OF THE GROUND SURFACE SHALL BE COVERED WITH AN APPROVED MATERIAL.
 MATERIALS:

- 2.1. STRAW IF STRAW IS USED IT SHALL BE UNROTTED SMALL-GRAIN STRAW APPLIED AT THE RATE OF 2 TONS PER ACRE OR 90 POUNDS (TWO TO THREE BALES) PER 1,000-SQ. FT. THE MULCH SHALL BE SPREAD UNIFORMLY BY HAND OR MECHANICALLY APPLIED SO THE SOIL SURFACE IS COVERED. FOR UNIFORM DISTRIBUTION OF HAND-SPREAD MULCH, DIVIDE AREA INTO APPROXIMATELY 1,000-SQ.-FT. SECTIONS AND SPREAD TWO 45-LB. BALES OF STRAW IN EACH SECTION.
- 2.2. HYDROSEEDERS IF WOOD CELLULOSE FIBER IS USED, IT SHALL BE APPLIED AT 2,000 LB./AC. OR 46 LB./1,000 SQ. FT.
  2.3. OTHER OTHER ACCEPTABLE MULCHES INCLUDE ROLLED EROSION CONTROL MATTINGS OR BLANKETS APPLIED ACCORDING TO MANUFACTURER'S RECOMMENDATIONS OR WOOD CHIPS APPLIED AT 6 TONS PER ACRE.
- 3. STRAW AND MULCH ANCHORING METHODS-STRAW MULCH SHALL BE ANCHORED IMMEDIATELY TO MINIMIZE LOSS BY WIND OR WATER: 3.1. MECHANICAL A DISK, CRIMPER, OR SIMILAR TYPE TOOL SHALL BE SET STRAIGHT TO PUNCH OR ANCHOR THE MULCH MATERIAL INTO THE SOLL STRAW MECHANICALLY ANCHORED SHALL NOT BE EINELY CHORDED BUT, CENERALLY BE LEET LONCER THAN & INCHES
- THE SOIL. STRAW MECHANICALLY ANCHORED SHALL NOT BE FINELY CHOPPED BUT, GENERALLY, BE LEFT LONGER THAN 6 INCHES. 3.2. MULCH NETTING NETTING SHALL BE USED ACCORDING TO THE MANUFACTURER IFS RECOMMENDATIONS. NETTING MAY BE NECESSARY TO HOLD MULCH IN PLACE IN AREAS OF CONCENTRATED RUNOFF AND ON CRITICAL SLOPES.
- 3.3. ASPHALT EMULSION ASPHALT SHALL BE APPLIED AS RECOMMENDED BY THE MANUFACTURE OR AT THE RATE OF 160 GALLONS PER ACRE.
  3.4. SYNTHETIC BINDERS SYNTHETIC BINDERS SUCH AS ACRYLIC DLR (AGRI-TAC), DCA-70, PETROSET, TERRA TACK OR EQUIVALENT MAY
- BE USED AT RATES SPECIFIED BY THE MANUFACTURER. 3.5. WOOD CELLULOSE FIBER WOOD CELLULOSE FIBER SHALL BE APPLIED AT A NET DRY WEIGHT OF 750 POUNDS PER ACRE. THE WOOD CELLULOSE FIBER SHALL BE MIXED WITH WATER WITH THE MIXTURE CONTAINING A MAXIMUM OF 50 POUNDS CELLULOSE PER 100 GALLONS OF WATER.

#### IRRIGATION:

PERMANENT SEEDING SHALL INCLUDE IRRIGATION TO ESTABLISH VEGETATION DURING DRY WEATHER OR ON ADVERSE SITE CONDITIONS, WHICH REQUIRE ADEQUATE MOISTURE FOR SEED GERMINATION AND PLANT GROWTH. IRRIGATION RATES SHALL BE MONITORED TO PREVENT EROSION AND DAMAGE TO SEEDED AREAS FROM EXCESSIVE RUNOFF. CONTRACTOR SHALL MAINTAIN PERMANENT SEEDING FOR UP TO ONE YEAR FROM SUBSTANTIAL COMPLETION TO FIX, REPAIR, WATER, REFERTILIZE AND/OR RESEED GRASSED AREAS.

	SEE	DING RATE	NOTEO	
SEED MIX	LBS/ACRE	LBS/1,000 SF	NOTES	
	GEN	IERAL USE		
CREEPING RED FESCUE	20-40	1⁄2-1	FOR CLOSE MOWING AND FOR	
DOMESTIC RYEGRASS	10-20	1/4-1/2	WATERWAYS WITH <2.0 FT/SEC VELOCITY	
KENTUCKY BLUEGRASS	20-40	1⁄2-1		
TALL FESCUE	40-50	1-11/4		
TURF-TYPE (DWARF) FESCUE	90	21⁄4		
	STEEP BANK	S OR CUT SLOPES		
TALL FESCUE	40-50	1-11/4		
CROWN VETCH	10-20	1⁄4-1⁄2	DO NOT SEED LATER THAN	
TALL FESCUE	20-30	1/2-3/4	AUGUST	
FLAT PEA	20-25	¥2-¾	DO NOT SEED LATER THAN AUGUST	
TALL FESCUE	20-30	¥2-¾	AUGUS1	
	ROAD DITCI	HES AND SWALES		
TALL FESCUE	40-50	1- ¹ 1⁄4		
TURF-TYPE (DWARF) FESCUE	90	21⁄4		
KENTUCKY BLUE GRASS	5	$\mathcal{Y}_{10}$		
LAWNS				
KENTUCKY BLUEGRASS	100-120	2		
PERENNIAL RYEGRASS		2		
KENTUCKY BLUEGRASS	100-120	2	FOR SHADED AREAS	
CREEPING RED FESCUE		1-1⁄2	<u> </u>	

#### PERMA

#### AREA REQUIRING PERMANENT STAE

ANY AREA THAT WILL LIE DORMANT FOR OR MORE.

ANY AREA WITHIN 50 FEET OF A STREAT RIPARIAN SETBACK AREA AND AT FINAL ANY AREA AT FINAL GRADE.

#### TEMPO

AREA REQUIRING TEMPORARY STAE

ANY DISTURBED AREA WITHIN 50 FEET STREAM OR A RIPARIAN SETBACK AREA AT FINAL GRADE.

FOR ALL CONSTRUCTION ACTIVITIES, A DISTURBED AREA, INCLUDING SOIL STO THAT WILL BE DORMANT FOR MORE TH BUT LESS THAN ONE YEAR.

DISTURBED AREAS THAT WILL BE IDLE WINTER.

**NOTE:** WHERE VEGETATIVE STABILIZATION TECHNIQUES MAY CAUSE STRUCTURAL INSTABILITY OR ARE OTHERWISE UNOBTAINABLE, ALTERNATIVE STABILIZATION TECHNIQUES MUST BE EMPLOYED. THESE TECHNIQUES MAY INCLUDE MULCHING OR EROSION MATTING.


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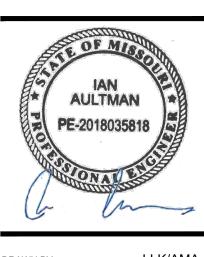
ms consultants, inc. engineers, architects, planners 2221 Schrock Road Columbus, Ohio 43229-1547 phone 614.898.7100 fax 614.898.7570

#### PROJECT

WHATABURGER PT20M BUILDING

1460 NE DOUGLAS ST. LEE'S SUMMIT, MO 64086

SHEET TITLE SWPPP NOTES

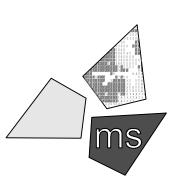

DRAWN BY:	LLK/AMA
CHECKED BY:	KEA
PROJECT NO:	40497-01

C-16

DRAWING

MAKE THE CALL...IT'S THE LAW

NENT STABILIZATION			
BILIZATION	TIME FRAME TO APPLY EROSION CONTROLS		
OR ONE YEAR	WITHIN 7 DAYS OF THE MOST RECENT DISTURBANCE.		
AM OR A L GRADE.	WITHIN 2 DAYS OF REACHING FINAL GRADE.		
	WITHIN 7 DAYS OF REACHING FINAL GRADE WITHIN THAT AREA.		


DRARY STABILIZATION			
BILIZATION	TIME FRAME TO APPLY EROSION CONTROLS		
T OF A EA AND NOT	WITHIN 2 DAYS OF THE MOST RECENT DISTURBANCE IF THAT AREA WILL REMAIN IDLE FOR MORE THAN 14 DAYS.		
ANY OCKPILES HAN 14 DAYS	WITHIN 7 DAYS OF THE MOST RECENT DISTURBANCE WITHIN THE AREA.		
OVER	PRIOR TO NOVEMBER 1.		




was established to help prevent damage to underground facilities and to promote safety. Missouri One Call operators are on duty 24 hours a day, seven days a week. Missouri One Call provides a telephone number for contractors and the general public to call for notification of their intent to use equipment for excavation, grading, blasting, boring, demolition or other types of similar work.

#### and the notificati equipme

#### 1-800-DIG-RITE or 811

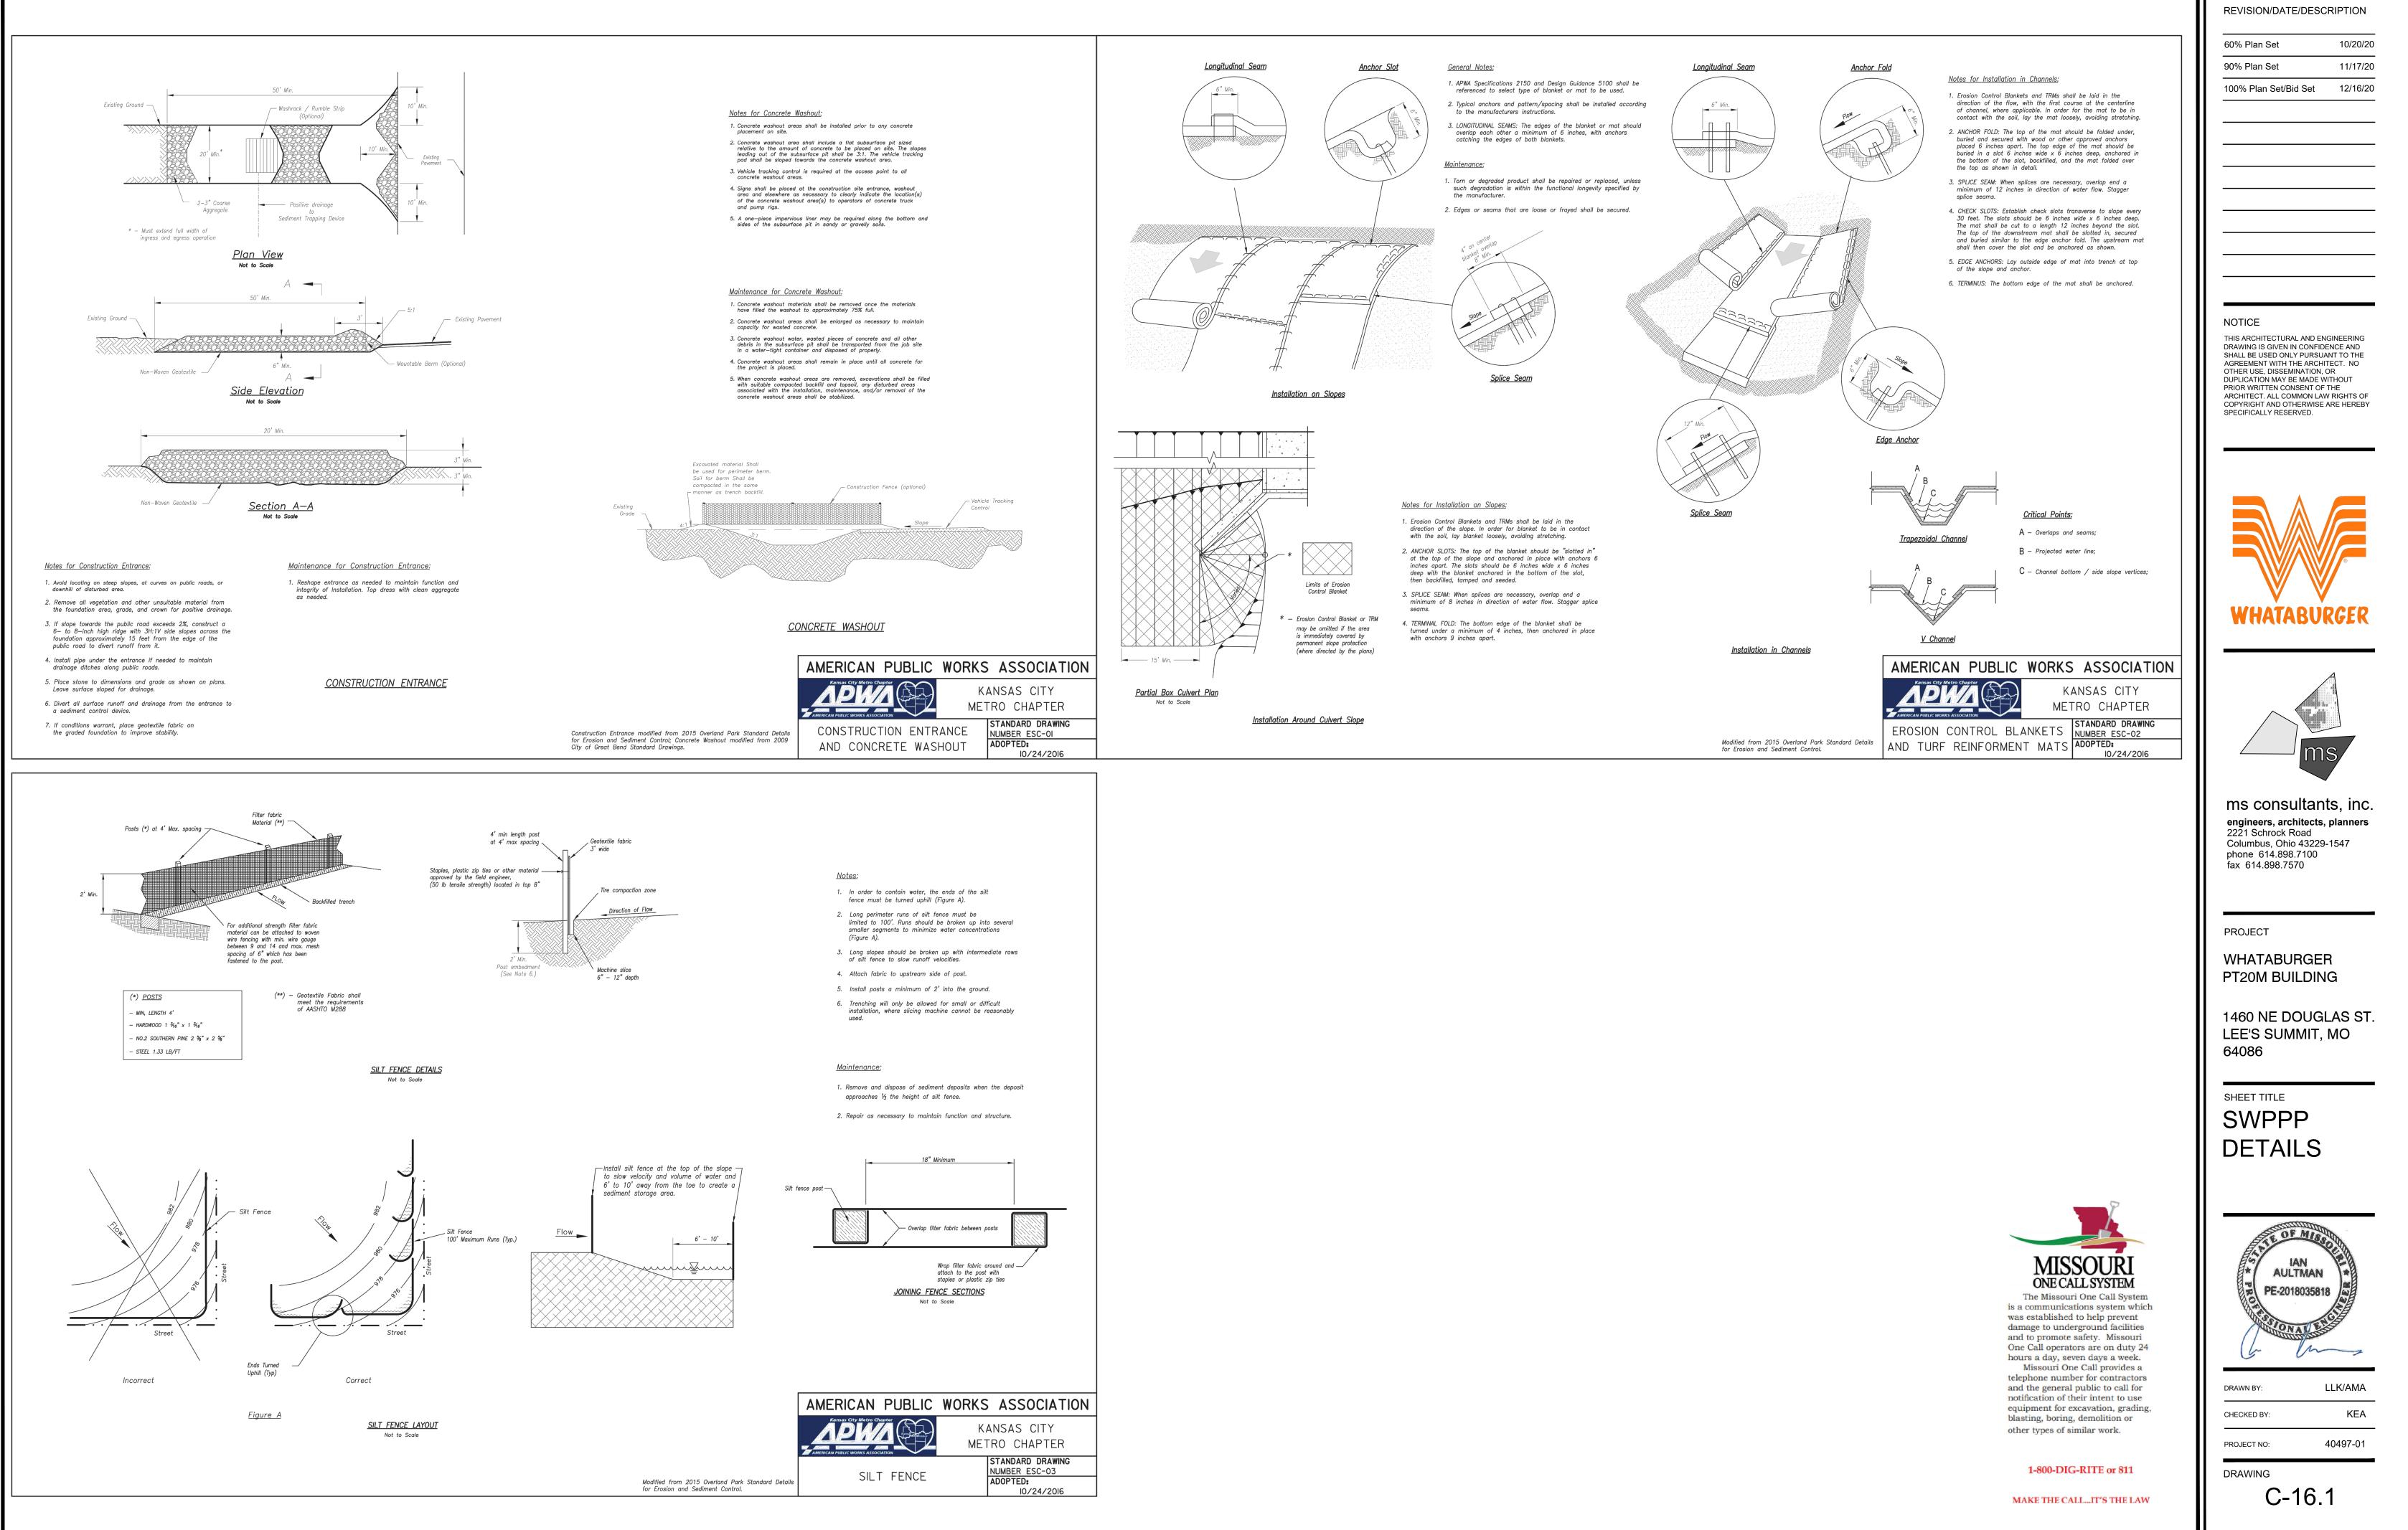

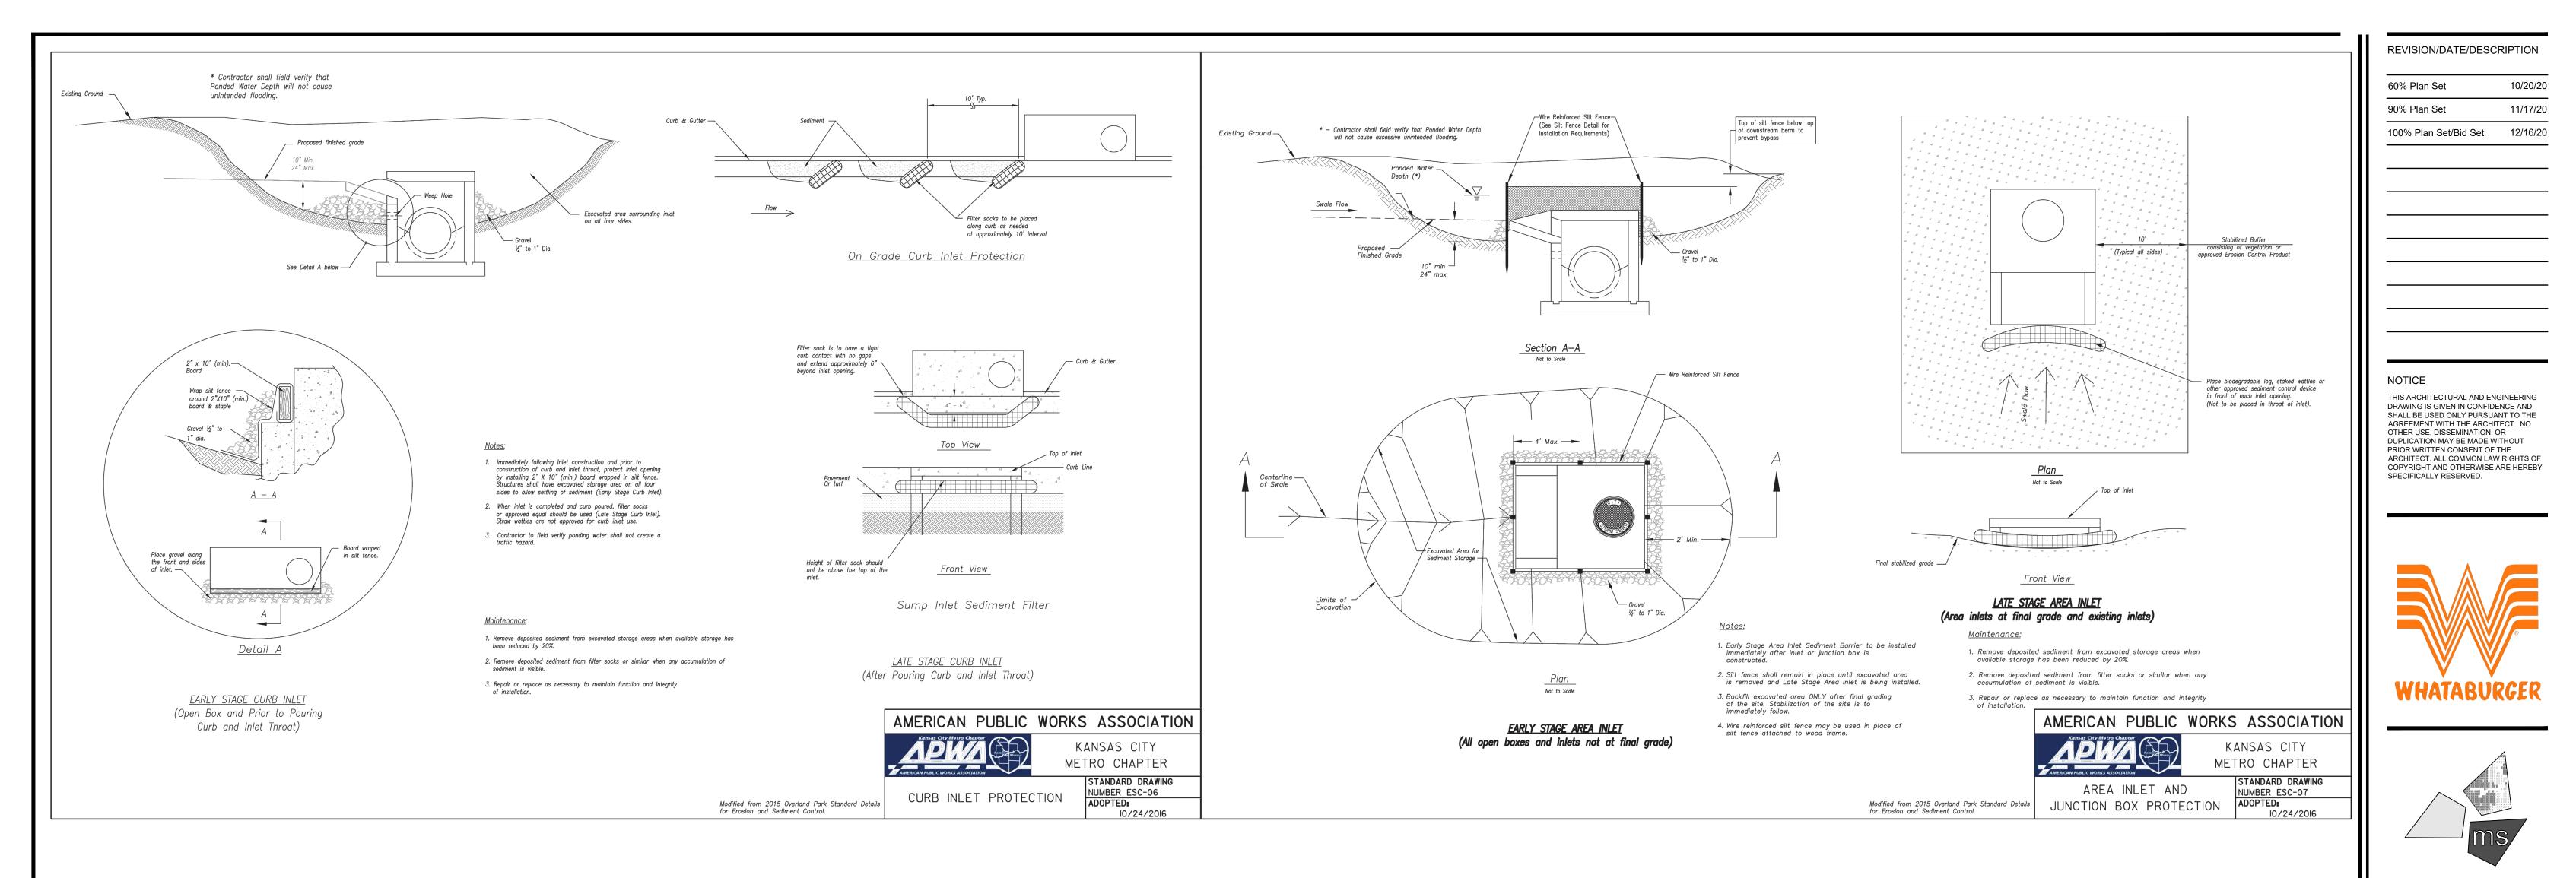


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#### PROJECT

WHATABURGER PT20M BUILDING

1460 NE DOUGLAS ST. LEE'S SUMMIT, MO 64086

SHEET TITLE SWPPP DETAILS

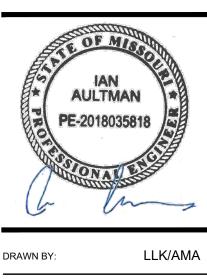

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PROJECT NO:	40497-01

C-16.2

DRAWING




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MISSOURI ONE CALL SYSTEM

The Missouri One Call System is a communications system which was established to help prevent damage to underground facilities and to promote safety. Missouri One Call operators are on duty 24 hours a day, seven days a week. Missouri One Call provides a telephone number for contractors

and the general public to call for

notification of their intent to use equipment for excavation, grading, blasting, boring, demolition or other types of similar work.

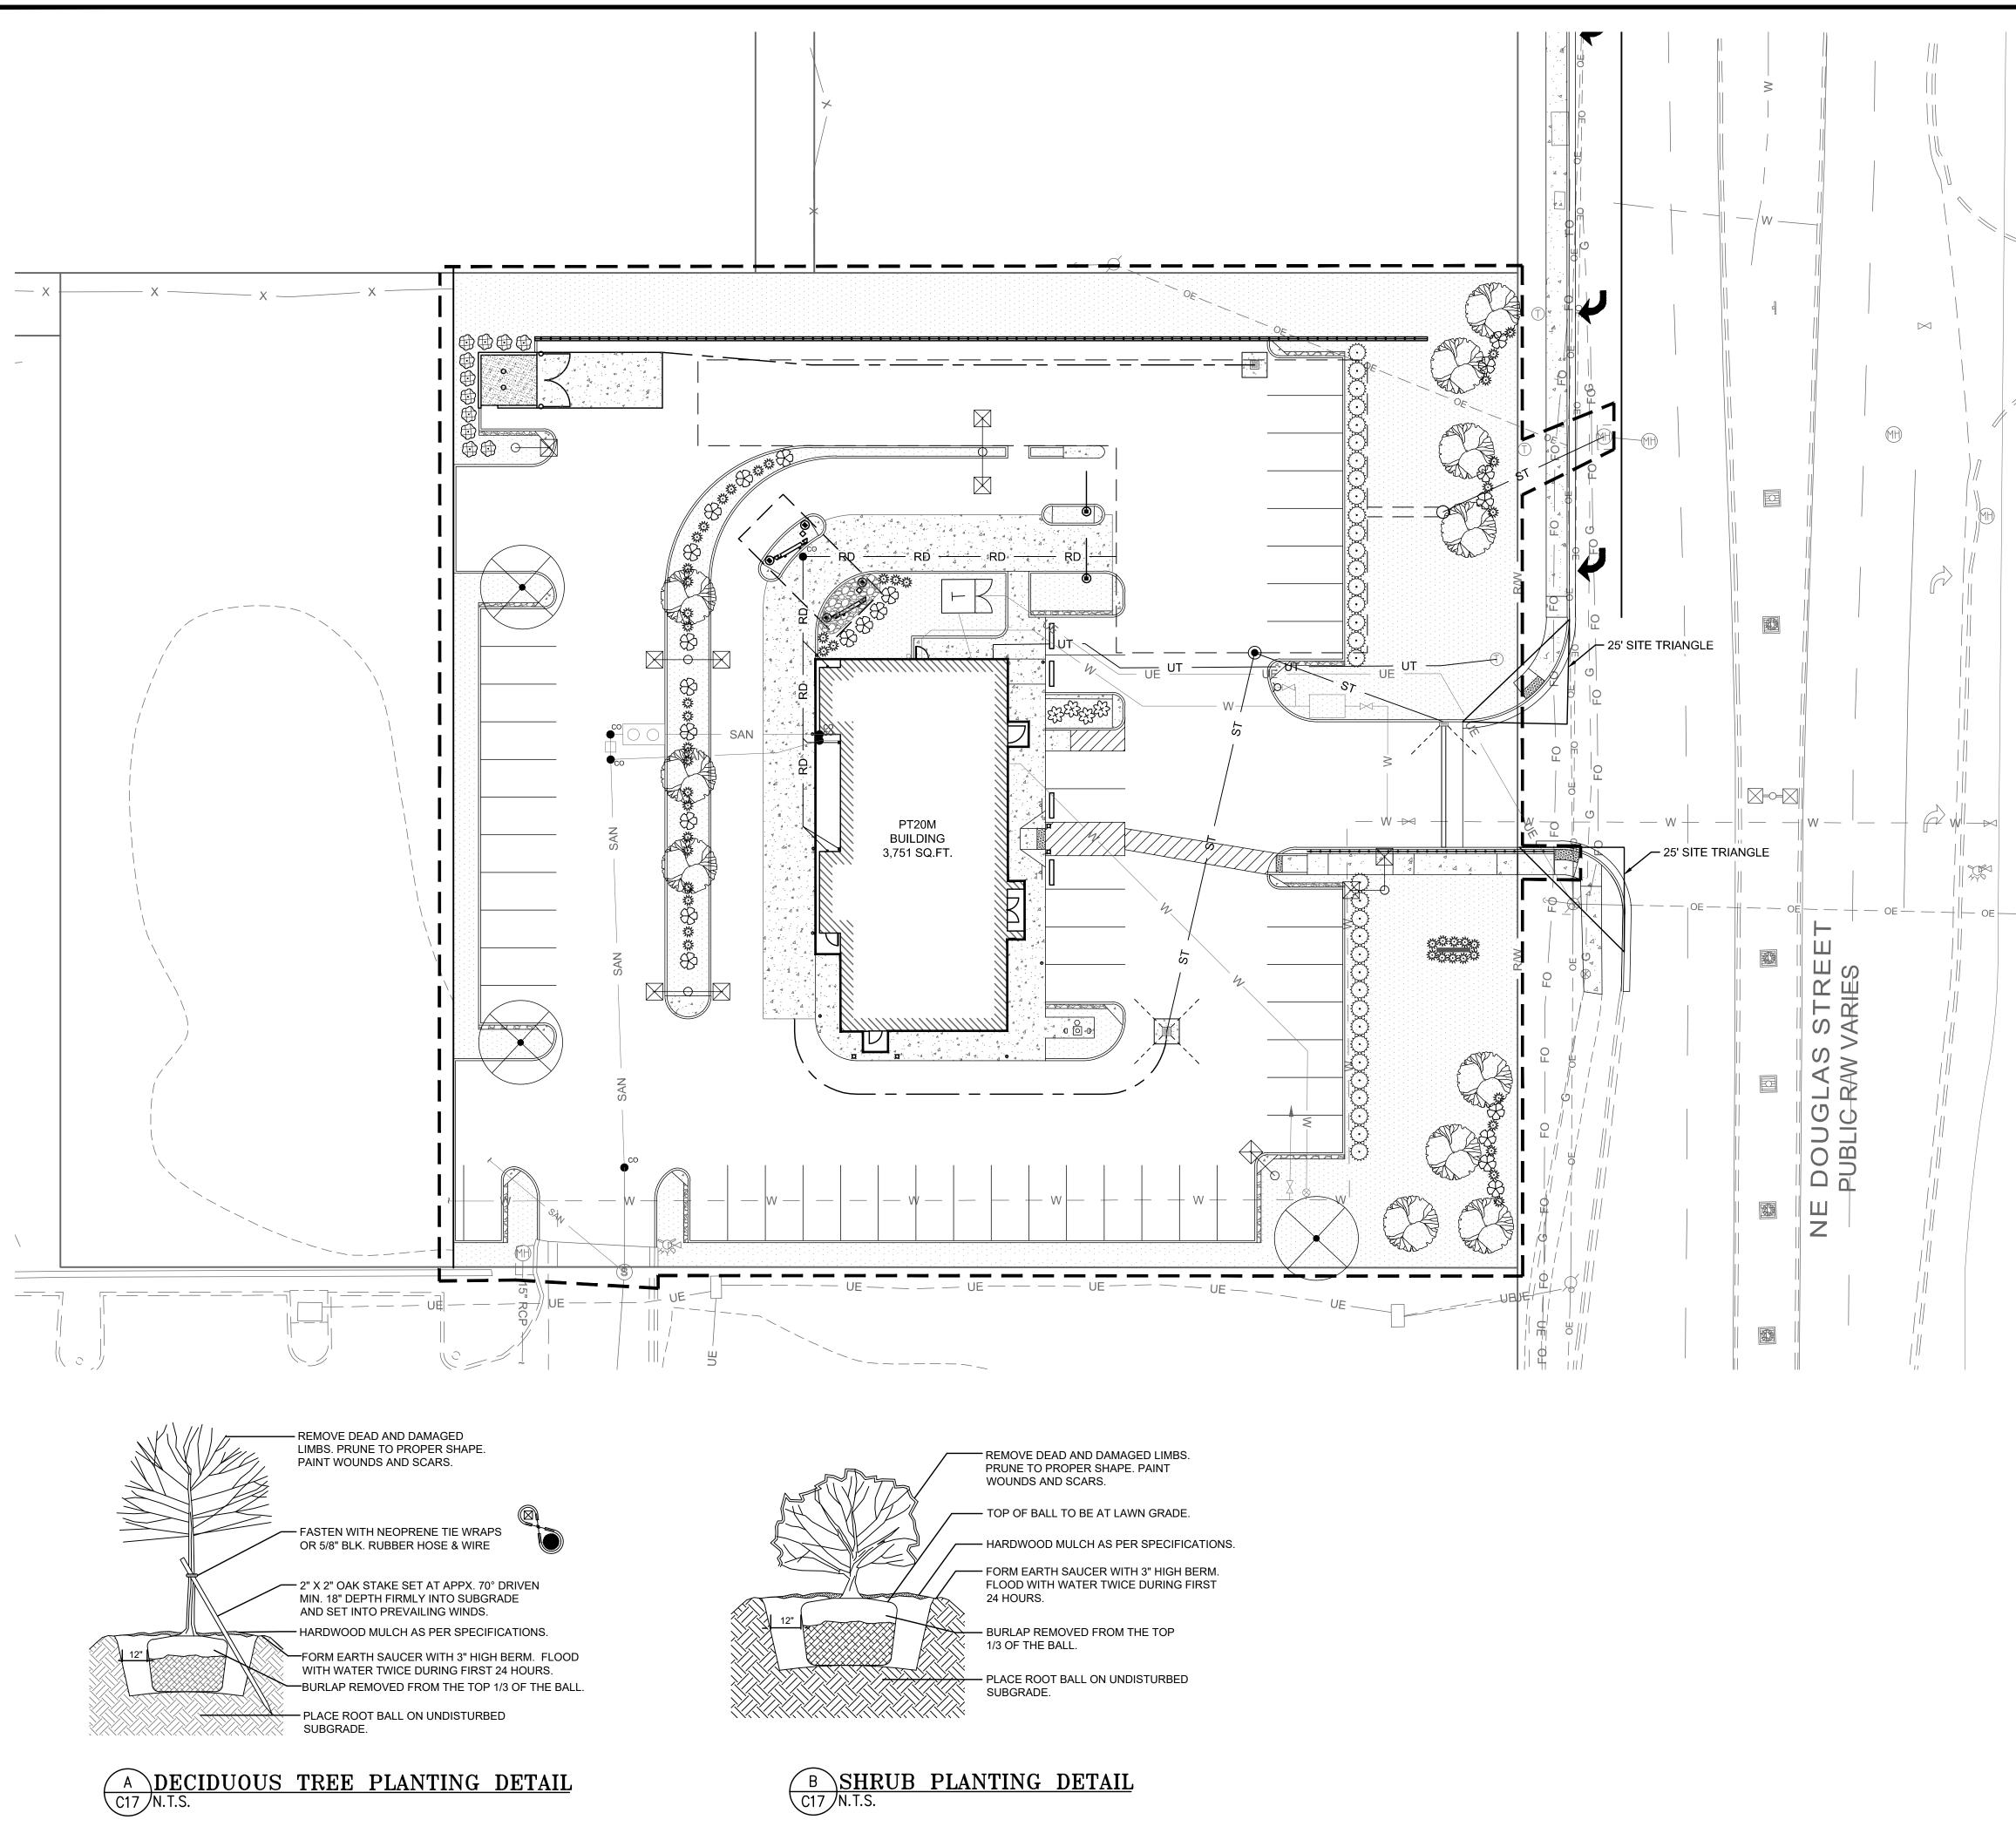


## **GENERAL NOTES:**

- A. ALL PLANT MATERIALS TO COMPLY WITH THE LATEST EDITION OF A.N.A. STANDARDS FOR NURSERY STOCK AND BE GUARANTEED UNTIL THE CERTIFICATE OF OCCUPANCY IS OBTAINED OR FOR A PERIOD OF ONE (1) YEAR FROM DATE OF FINAL ACCEPTANCE, WHICHEVER IS GREATER. ANY PLANTINGS NEEDING REPLACEMENT WILL BE GUARANTEED FROM THE TIME OF REPLACEMENT IF AFTER FINAL ACCEPTANCE.
- LANDSCAPE CONTRACTOR IS TO VERIFY LOCATION OF ALL UNDERGROUND UTILITIES AND RECEIVE APPROVAL FROM GENERAL CONTRACTOR OR SITE SUPERVISOR, IF NECESSARY, TO MAKE CHANGES IN PLANT LOCATIONS.
- LANDSCAPE CONTRACTOR MUST COORDINATE WITH GENERAL CONTRACTOR AND OTHER С SITE OPERATIONS.
- MINOR ADJUSTMENTS TO THE PLANT LOCATIONS ARE TO BE MADE IN THE CASE OF ANY CONFLICTS WITH PROPOSED UTILITIES.
- ALL PLANTING BEDS AND FREE STANDING TREES TO BE MULCHED WITH 4" OF SHREDDED HARDWOOD MULCH. BEDS ARE TO BE GRADED SMOOTH AND FREE OF SOIL CLODS AND STONES. ALL TREES TO BE STAKED AND WRAPPED WITH KRAFT TREE WRAP. ALL PLANTS ARE TO BE REMOVED FROM CONTAINERS, CAGES AND NON-BIODEGRADABLE MATERIALS.
- GENERAL CONTRACTOR IS RESPONSIBLE FOR FINISHED GRADES; LANDSCAPE CONTRACTOR G. IS RESPONSIBLE FOR FINE GRADING AND TO PROVIDE 4" OF AMENDED TOPSOIL FOR PLANTING BEDS.
- ALL ORGANIC MATTER AND DEBRIS ARE TO BE REMOVED FROM THE SITE BY THE LANDSCAPE CONTRACTOR. LAWN AREAS AND BEDS SHOULD BE FREE OF STONES GREATER THAN 2".
- PLANT QUANTITIES HAVE BEEN PROVIDED FOR CONVENIENCE ONLY; THE LANDSCAPE CONTRACTOR IS RESPONSIBLE FOR HIS OWN "TAKE OFFS". DRAWING PREVAILS OVER WRITTEN QUANTITIES. THE LANDSCAPE CONTRACTOR SHALL SUBMIT A ONE (1) YEAR MAINTENANCE CONTRACT FOR
- CONSIDERATION BY THE OWNER. CONTRACT SHALL BE SEPARATE FROM INSTALLATION CONTRACT.
- K. PLANTING BEDS SHALL BE TREATED WITH A PRE-EMERGENT HERBICIDE APPLIED AT PRODUCT SPECIFIED RATE UNLESS OTHERWISE NOTED. PLANTING SHALL BE FERTILIZED UPON INSTALLATION. RECOMMENDED FERTILIZER SHALL BE
- MIXED WITH BACKFILL AT PRODUCT SPECIFIED RATE. BED EDGE SHALL BE SMOOTH, CONSISTENT 4 1/2" DEEP AND HAND CUT, EDGES TO BE Μ. LOCATED BETWEEN ALL BEDS (INCLUDING TREES) AND LAWN AREAS.
- CONTRACTOR TO SEED ALL DISTURBED AREAS WITH A LOCALLY ADAPTIVE SEED MIX UNLESS OTHERWISE DIRECTED BY THE GENERAL CONTRACTOR.
- TOPSOIL SHALL BE BACK FILLED TO PROVIDE POSITIVE DRAINAGE OF ALL LANDSCAPE AREAS. 0 SEE GRADING AND DRAINAGE PLAN SHEET C-6.

## PROPOSED PLANT SCHEDULE

DECIDUOUS	TREES	BOTANICAL NAME	COMMON NAME	<u>QTY</u>	CAL	<u>CONT</u>
	AR	ACER RUBRUM	RED MAPLE	3	1.5"	B+B
	AC	AMELANCHIER CANADENSIS	SERVICEBERRY	11	1.0"	B+B
<u>SHRUE</u>	<u>85</u>	BOTANICAL NAME	COMMON NAME	<u>QTY</u>	<u>HEIGHT</u>	
×.	СР	CHAMAECYPARIS PISIFERA 'GOLDEN MOP'	GOLD MOP CYPRESS	49	18" MIN.	
\$	WF	WEIGELA FLORIDA 'ALEXANDRA'	WINE AND ROSES WEIGELA	22	18"-24"	
	RI	RHAPHIOLEPIS INDICA 'MAJESTIC BEAUTY'	MAJESTIC BEAUTY INDIAN HAWTHORN	11		
53	HP	HYDRANGEA PANICULATA 'LITTLE LIME'	LITTLE LIME HYDRANGEA	4		
یکنٹر ۲۰۰۶ ۲۰۰۲	IV	ILEX VOMITORIA 'NANA'	DWARF YAUPON	34		

## LEGEND

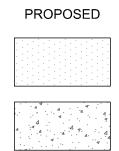

DESCRIPTION

GRASS/SEED AREA

CONCRETE



is a communications system which was established to help prevent damage to underground facilities and to promote safety. Missouri One Call operators are on duty 24 hours a day, seven days a week. Missouri One Call provides a telephone number for contractors and the general public to call for notification of their intent to use equipment for excavation, grading, blasting, boring, demolition or

#### 1-800-DIG-RITE or 811

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#### MAKE THE CALL ... IT'S THE LAW


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100% Plan Set/Bid Set	12/16/20

#### NOTICE

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ms consultants, inc. engineers, architects, planners 2221 Schrock Road Columbus, Ohio 43229-1547 phone 614.898.7100 fax 614.898.7570

#### PROJECT


WHATABURGER PT20M BUILDING

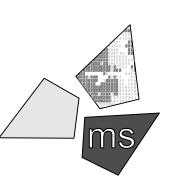1460 NE DOUGLAS ST. LEE'S SUMMIT, MO 64086


SHEET TITLE LANDSCAPE PLAN

DRAWN BY:	LLK/AMA
CHECKED BY:	KEA
PROJECT NO:	40497-01
DRAWING	

C-17

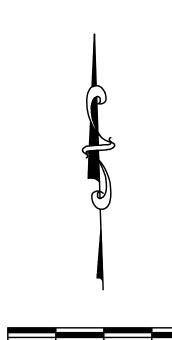

10 20 30 SCALE: 1"=20'

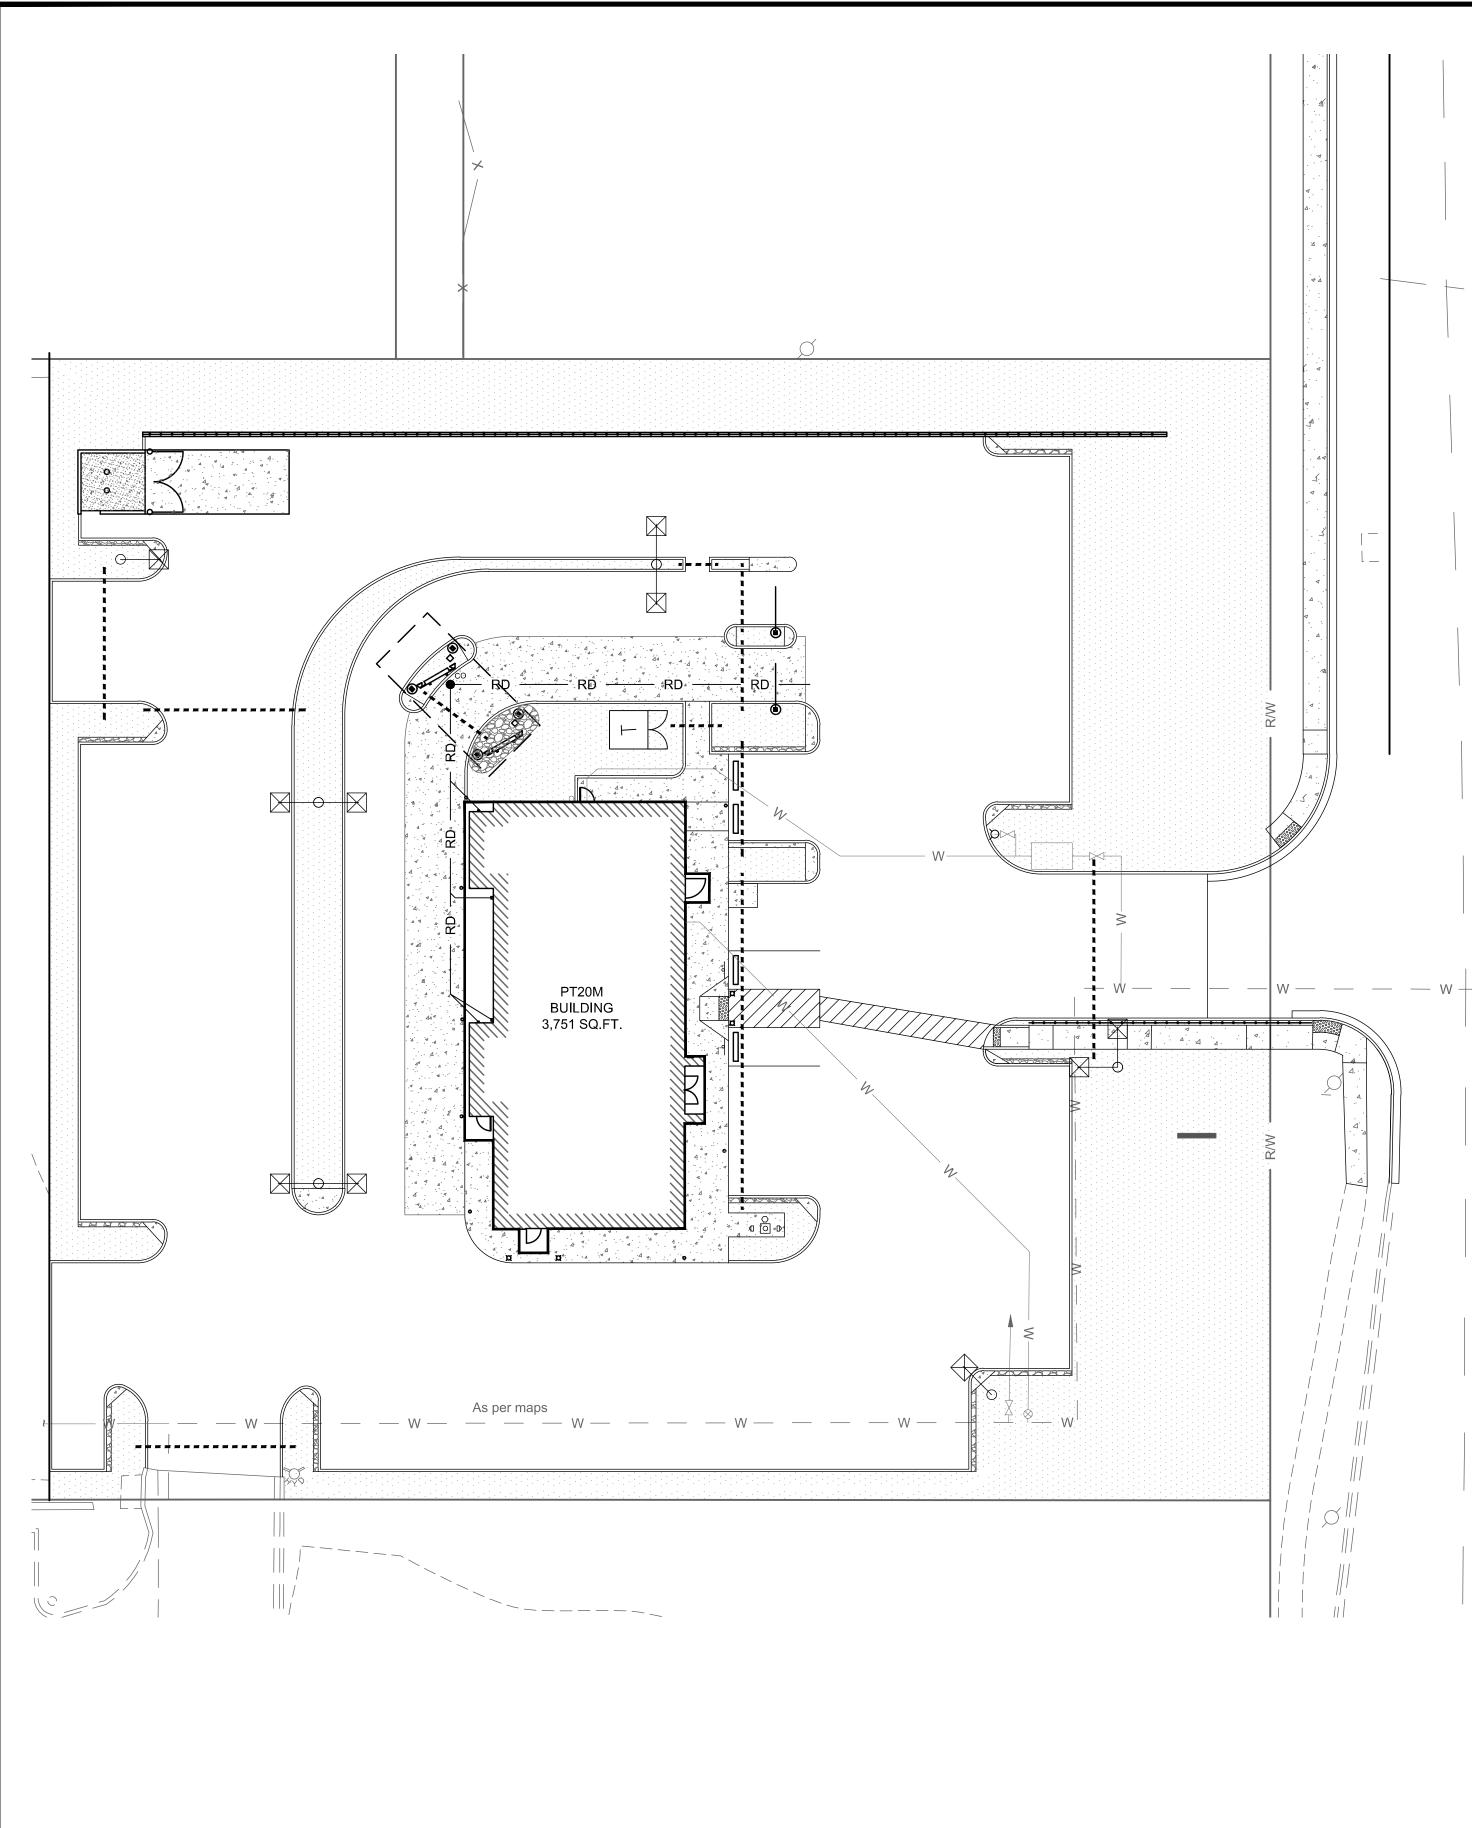

## GENERAL

- A. THE LANDSCAPE IRRIGATION SYSTEM SHALL IRRIGATE ALL PROPOSED LANDSCAPE AND GRASS AREAS ON THE PROPERTY. THE DESIGN, PERMITTING, AND INSTALLATION OF THE SYSTEM SHALL BE THE RESPONSIBILITY OF THE LANDSCAPE/IRRIGATION CONTRACTOR (CONTRACTOR).
- B. THE CONTRACTOR IS TO INSTALL EQUIPMENT NECESSARY TO PROVIDE A COMPLETE, FUNCTIONAL SYSTEM THAT IS IN COMPLIANCE WITH APPLICABLE CODES AND REGULATIONS.
- C. THE IRRIGATION CONTRACTOR SHALL SUBMIT SHOP DRAWINGS TO THE OWNER'S REPRESENTATIVE FOR APPROVAL, PRIOR TO CONSTRUCTION, WHICH WILL ILLUSTRATE TYPE OF HEADS, VALVES, CONTROLLER, PIPING AND ACCESSORIES. IRRIGATION HEADS, VALVES AND CONTROLLER ARE TO BE FROM A SINGLE MANUFACTURER. ALL EQUIPMENT MUST HAVE A MANUFACTURERS FIVE YEAR WARRANTY. THE CONTRACTOR SHALL BE RESPONSIBLE FOR PROPER INSTALLATION AND FIELD ADJUSTMENT OF THE ABOVE ITEMS.
- D. THE CONTRACTOR IS RESPONSIBLE FOR COORDINATING WITH THE OWNER THE FINAL LOCATION OF THE CONTROL PANEL(S). NO ADDITIONAL COSTS SHALL BE ALLOWED FOR ANY ADJUSTMENTS MADE TO THE FINAL LOCATION OF ALL EQUIPMENT.
- E. THE IRRIGATION CONTRACTOR SHALL SUBMIT A WARRANTY POLICY TO THE OWNER WHICH SHALL COVER THE FUNCTION OF THE ENTIRE SYSTEM FOR A PERIOD OF ONE YEAR AFTER THE ACCEPTANCE OF THE SYSTEM BY THE OWNER.
- CONTRACTOR WILL VERIFY STATIC PRESSURE AND VOLUME OF SITE WATER SUPPLY AND ADJUST ENTIRE IRRIGATION SYSTEM ACCORDINGLY. EACH ZONE OF IRRIGATION SYSTEM IS TO BE DESIGNED WITH A MINIMUM OPERATING PRESSURE OF 45 PSI. IF THE PRESSURE IS BELOW 45 PSI, A PROPERLY SIZED BOOSTER PUMP WILL BE REQUIRED. AS PART OF THE SHOP DRAWINGS, THE IRRIGATION CONTRACTOR WILL PROVIDE CALCULATIONS SHOWING PRESSURE LOSS FROM THE POINT OF CONNECTION TO THE FURTHEST HEAD (AND FOR THE FURTHEST HEAD ON THE LARGEST ZONE). ADJUST DESIGN TO MEET AVAILABLE PRESSURES AND VOLUMES. A CURRENT STATIC PRESSURE READING AT THE POINT OF CONNECTION WAS NOT AVAILABLE PRIOR TO DESIGN.
- G. THE CONTRACTOR IS TO INSTALL ALL EQUIPMENT SUCH THAT THE BUILDING, PARKING AREAS, AND SIDEWALKS ARE NOT SPRAYED OR SUBJECT TO EXCESSIVE RUNOFF. FIELD ADJUSTMENTS MAY BE NECESSARY TO AVOID UNFORESEEN OBSTACLES AND SIMPLIFY INSTALLATION. IRRIGATION SYSTEM ACCESSORIES SUCH AS QUICK COUPLER VALVES, ISOLATION VALVES, AND MANUAL DRAIN VALVES ARE TO BE LOCATED AS NECESSARY TO COMPLETE THE SYSTEM.
- H. THE IRRIGATION CONTROLLER IS TO BE A HYBRID SOLID STATE TYPE WITH PLASTIC LOCKABLE CABINET. CONTROLLER MUST HAVE DUAL PROGRAMMING FOR TURF SPRAY ZONES AND SHRUB SPRAY ZONES AND BE CAPABLE OF OPERATING MULTIPLE VALVES PER STATION.
- PROVIDE DESIGNATED PVC SLEEVES FOR IRRIGATION PIPES AND WIRING THAT CROSSES UNDER WALKS, STREETS AND CONCRETE PADS. COMBINE PIPING WHENEVER POSSIBLE TO REDUCE QUANTITY OF SLEEVING MATERIALS. WHEN INSTALLING IRRIGATION PIPE ALONG CURBS OR IN ISLANDS, PLACE PIPE AS CLOSE TO CURB AS POSSIBLE TO ALLOW FOR PLANTING OF FUTURE TREES AND SHRUBS.

#### PART 1 GENERAL

1.1 REFERENCES

- A. ASTM INTERNATIONAL:
- 1. ASTM B32 STANDARD SPECIFICATION FOR SOLDER METAL
- 2. ASTM B42 STANDARD SPECIFICATION FOR SEAMLESS COPPER PIPE, STANDARD SIZES.
- 3. ASTM B88 STANDARD SPECIFICATION FOR SEAMLESS COPPER WATER TUBE. 4. ASTM D2235 - STANDARD SPECIFICATION FOR SOLVENT CEMENT FOR ACRYLONITRILE-BUTADIENE-STYRENE (ABS) PLASTIC PIPE AND FITTINGS.
- 5. ASTM D2241 STANDARD SPECIFICATION FOR POLYETHYLENE (PE) PLASTIC PIPE (SIDR-PR) BASED ON CONTROLLED INSIDE DIAMETER.
- 6. ASTM D2564 STANDARD SPECIFICATION FOR SOLVENT CEMENTS FOR POLY (VINYL CHLORIDE) (PVC) PLASTIC PIPING SYSTEMS.
- B. NATIONAL ELECTRICAL MANUFACTURERS ASSOCIATION:
- 1. NEMA 250 ENCLOSURES FOR ELECTRICAL EQUIPMENT (1000 VOLTS MAXIMUM).
- 1.2 SYSTEM DESCRIPTION
- C. HYBRID SOLID STATE CONTROLLED UNDERGROUND IRRIGATION SYSTEM, WITH PRESSURE BLOW-OUT DRAIN.
- D. SOURCE POWER: 120 VOLT.
- 1.3 SUBMITTALS
- A. SHOP DRAWINGS: INDICATE PIPING LAYOUT TO WATER SOURCE, LOCATION OF SLEEVES UNDER PAVEMENT, LOCATION AND COVERAGE OF SPRINKLER HEADS, COMPONENTS, PLANT AND LANDSCAPING FEATURES, SITE STRUCTURES, SCHEDULE OF OUTLETS AND FITTINGS TO BE USED.
- B. PRODUCT DATA: SUBMIT COMPONENT AND CONTROL SYSTEM AND WIRING DIAGRAMS.
- 1.4 CLOSEOUT SUBMITTALS
- A. PROJECT RECORD DOCUMENTS: RECORD ACTUAL LOCATIONS OF CONCEALED COMPONENTS BY NORTHING AND EASTING.
- B. OPERATION AND MAINTENANCE DATA TO OWNER: 1. SUBMIT INSTRUCTIONS FOR OPERATION AND MAINTENANCE OF SYSTEM AND CONTROLS, SEASONAL
- ACTIVATION AND SHUTDOWN, AND MANUFACTURER'S PARTS CATALOG. . SUBMIT SCHEDULE INDICATING LENGTH OF TIME EACH VALVE IS REQUIRED TO BE OPEN TO DELIVER
- DETERMINED AMOUNT OF WATER. 1.5 QUALITY ASSURANCE
  - A. PERFORM WORK IN ACCORDANCE WITH MANUFACTURER'S STANDARDS.
- A. COORDINATE THE WORK WITH SITE BACKFILLING, PAVING, LANDSCAPE GRADING AND DELIVERY OF PLANT LIFE.

### PART 2 PRODUCTS

#### 2.1 PIPE MATERIALS

- A. PVC PIPE: ASTM D2241, SDR 26; 160 PSI SOLVENT WELDED SOCKETS.
- B. HDPE PIPE: ASTM D-2239, SDR-15, 100 PSI.
- C. COPPER TUBING: ASTM B88 TYPE K.
- D. FITTINGS: TYPE AND STYLE OF CONNECTION TO MATCH PIPE.
- E. SOLVENT CEMENT: [ASTM D2564 FOR PVC PIPE AND FITTINGS] [ASTM D2235 FOR ABS PIPE AND FITTINGS]. F. SLEEVE MATERIAL: PVC SCH 40.
- 2.2 OUTLETS
- A. OUTLETS: BRASS CONSTRUCTION.
- B. ROTARY TYPE SPRINKLER HEAD: POP-UP TYPE WITH SCREENS; FULLY ADJUSTABLE FOR FLOW AND PRESSURE; WITH LETTER OR SYMBOL DESIGNATING DEGREE OF ARC AND ARROW INDICATING CENTER OF SPRAY PATTERN.
- C. SPRAY TYPE SPRINKLER HEAD: POP-UP HEAD WITH FULL CIRCLE PATTERN.
- D. QUICK COUPLER: GALVANIZED.
- 2.3 MANUAL VALVES
- A. VALVES: HIGHLY CORROSION RESISTANT CONSTRUCTION (BRASS, STAINLESS STEEL, ETC.). ALL VALVES SHALL BE ACCESSIBLE FROM ABOVE THROUGH A VALVE BOX.
- B. BACKFLOW PREVENTERS: BRONZE BODY CONSTRUCTION, REDUCED PRESSURE TYPE OR AS DESIGNATED BY LOCAL PLUMBING CODE REQUIREMENTS.
- C. VALVE BOX AND COVER: HDPE RESIN THAT IS RESISTANT TO UV LIGHT, CORROSION, MOISTURE, AND CHEMICALS.
- 2.4 CONTROLS AND CONTROL VALVES
- A. CONTROLLER: MUST WORK WITH MANUFACTURER FLOW SENSOR, RAIN SENSOR, AND
- ****** [OR] ******
- B. CONTROLLER: AUTOMATIC CONTROLLER, MICROPROCESSOR SOLID STATE CONTROL WITH VISIBLE READOUT DISPLAY, TEMPORARY OVERRIDE FEATURE TO BYPASS CYCLE FOR INCLEMENT WEATHER, PROGRAMMABLE FOR 7 DAYS IN QUARTER HOUR INCREMENTS, WITH AUTOMATIC START AND SHUTDOWN.
- C. CONTROLLER HOUSING: NEMA 250 TYPE 3R; WEATHERPROOF, WATERTIGHT, WITH LOCKABLE ACCESS DOOR.
- D. VALVES: HYDRAULIC; NORMALLY CLOSED, INCLUDING REQUIRED FITTINGS AND ACCESSORIES.
- E. WIRE CONDUCTORS: COPPER CONDUCTOR, DIRECT BURIAL TYPE.
- F. RAIN SENSORS: PER SELECTED MANUFACTURER
- 2.5 ELECTRICAL CHARACTERISTICS AND COMPONENTS
- A. ELECTRICAL CHARACTERISTICS:

1. 120 VOLTS, SINGLE PHASE, 60 HZ.

B. DISCONNECT SWITCH: FACTORY MOUNT DISCONNECT SWITCH IN CONTROL PANEL.

- 1.6 COORDINATION

#### **PART 3 EXECUTION**

3.1 EXAMINATION

- A. VERIFY LOCATION OF EXISTING UTILITIES.
- B. VERIFY REQUIRED UTILITIES ARE AVAILABLE, IN PROPER LOCATION, AND READY FOR USE. **3.2 PREPARATION**
- A. ROUTE PIPING TO AVOID PLANTS, GROUND COVER, AND STRUCTURES.
- B. LAYOUT AND STAKE LOCATIONS OF SYSTEM COMPONENTS
- C. REVIEW LAYOUT REQUIREMENTS WITH OTHER AFFECTED WORK. COORDINATE LOCATIONS OF SLEEVES UNDER PAVING TO ACCOMMODATE SYSTEM.

3.3 TRENCHING

- A. TRENCH SIZE: 1. MINIMUM COVER OVER INSTALLED SUPPLY PIPING: 18 INCHES.
- 2. MINIMUM COVER OVER INSTALLED BRANCH PIPING: 15 INCHES.
- B. TRENCH TO ACCOMMODATE GRADE CHANGES AND SLOPE TO DRAIN(S).
- C. MAINTAIN TRENCHES FREE OF DEBRIS, MATERIAL, OR OBSTRUCTIONS DAMAGING TO PIPE.

3.4 INSTALLATION

A. CONNECT TO UTILITIES.

- B. SET OUTLETS AND BOX COVERS AT FINISH GRADE ELEVATIONS.
- C. PROVIDE FOR THERMAL MOVEMENT OF COMPONENTS IN SYSTEM.
- D. SLOPE PIPING FOR SELF DRAINAGE TO DAYLIGHT.
- E. USE THREADED NIPPLES FOR RISERS TO EACH OUTLET.
- F. INSTALL CONTROL WIRING IN ACCORDANCE WITH MANUFACTURER'S RECOMMENDED INSTALLATION PRACTICES. PROVIDE 10 INCH EXPANSION COIL AT EACH CONTROL VALVE, AND AT 100 FT INTERVALS. BURY WIRE BESIDE PIPE. MARK VALVES WITH NEOPRENE VALVE MARKERS CONTAINING LOCKING DEVICE. SET VALVE MARKERS IN VALVE BOXES SET TO FINISH GRADE.
- G. AFTER PIPING IS INSTALLED, BUT BEFORE OUTLETS ARE INSTALLED AND BACKFILLING COMMENCES, OPEN VALVES AND FLUSH SYSTEM WITH FULL HEAD OF WATER.

3.5 BACKFILLING


- A. BACKFILL WITH COMPACTED BACKFILL IN ACCORDANCE WITH DETAIL G ON SHEET C-11.
- B. INSTALL 3 INCH SAND BEDDING BELOW AND COVER OVER PIPING.
- C. PROTECT PIPING FROM DISPLACEMENT.
- 3.6 FIELD QUALITY CONTROL
- A. PRIOR TO BACKFILLING, TEST SYSTEM FOR LEAKAGE FOR WHOLE SYSTEM TO MAINTAIN 100 PSI PRESSURE FOR ONE HOUR.
- B. SYSTEM IS ACCEPTABLE WHEN NO LEAKAGE OR LOSS OF PRESSURE OCCURS DURING TEST PERIOD.
- C. PROVIDE ONE COMPLETE SPRING SEASON START-UP AND FALL SEASON SHUTDOWN.

3.7 ADJUSTING

- A. ADJUST CONTROL SYSTEM TO ACHIEVE TIME CYCLES REQUIRED
- B. ADJUST HEAD TYPES FOR FULL WATER COVERAGE AS DIRECTED BY OWNER'S REPRESENTATIVE. 3.8 DEMONSTRATION AND TRAINING
- A. INSTRUCT OWNER'S PERSONNEL IN OPERATION AND MAINTENANCE OF SYSTEM, INCLUDING ADJUSTING OF SPRINKLER HEADS. USE OPERATION AND MAINTENANCE MATERIAL AS BASIS FOR DEMONSTRATION.

## LEGEND

#### DESCRIPTION

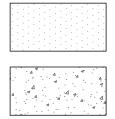


PROPOSED

CONCRETE

GRASS/LANDSCAPED

AREA TO BE IRRIGATED

4" SCHEDULE 40 PVC SLEEVE FOR FUTURE **IRRIGATION LINES.** CONTRACTOR TO MARK END OF SLEEVES.

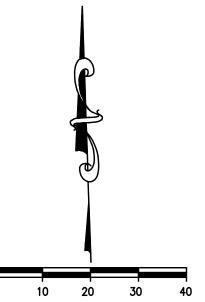

SCALE: 1"=20'



is a communications system which was established to help prevent damage to underground facilities and to promote safety. Missouri One Call operators are on duty 24 hours a day, seven days a week.

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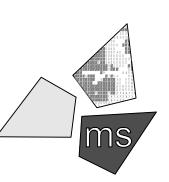
REVISION/DATE/DESCRIPTION

60% Plan Set	10/20/20
90% Plan Set	11/17/20
100% Plan Set/Bid	Set 12/16/20

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#### PROJECT

WHATABURGER PT20M BUILDING

1460 NE DOUGLAS ST. LEE'S SUMMIT, MO 64086

## SHEET TITLE IRRIGATION PLAN

AULTM PE-201803	AN
DRAWN BY:	LLK/AMA

CHECKED BY:	KEA
PROJECT NO:	40497-01

DRAWING C-18

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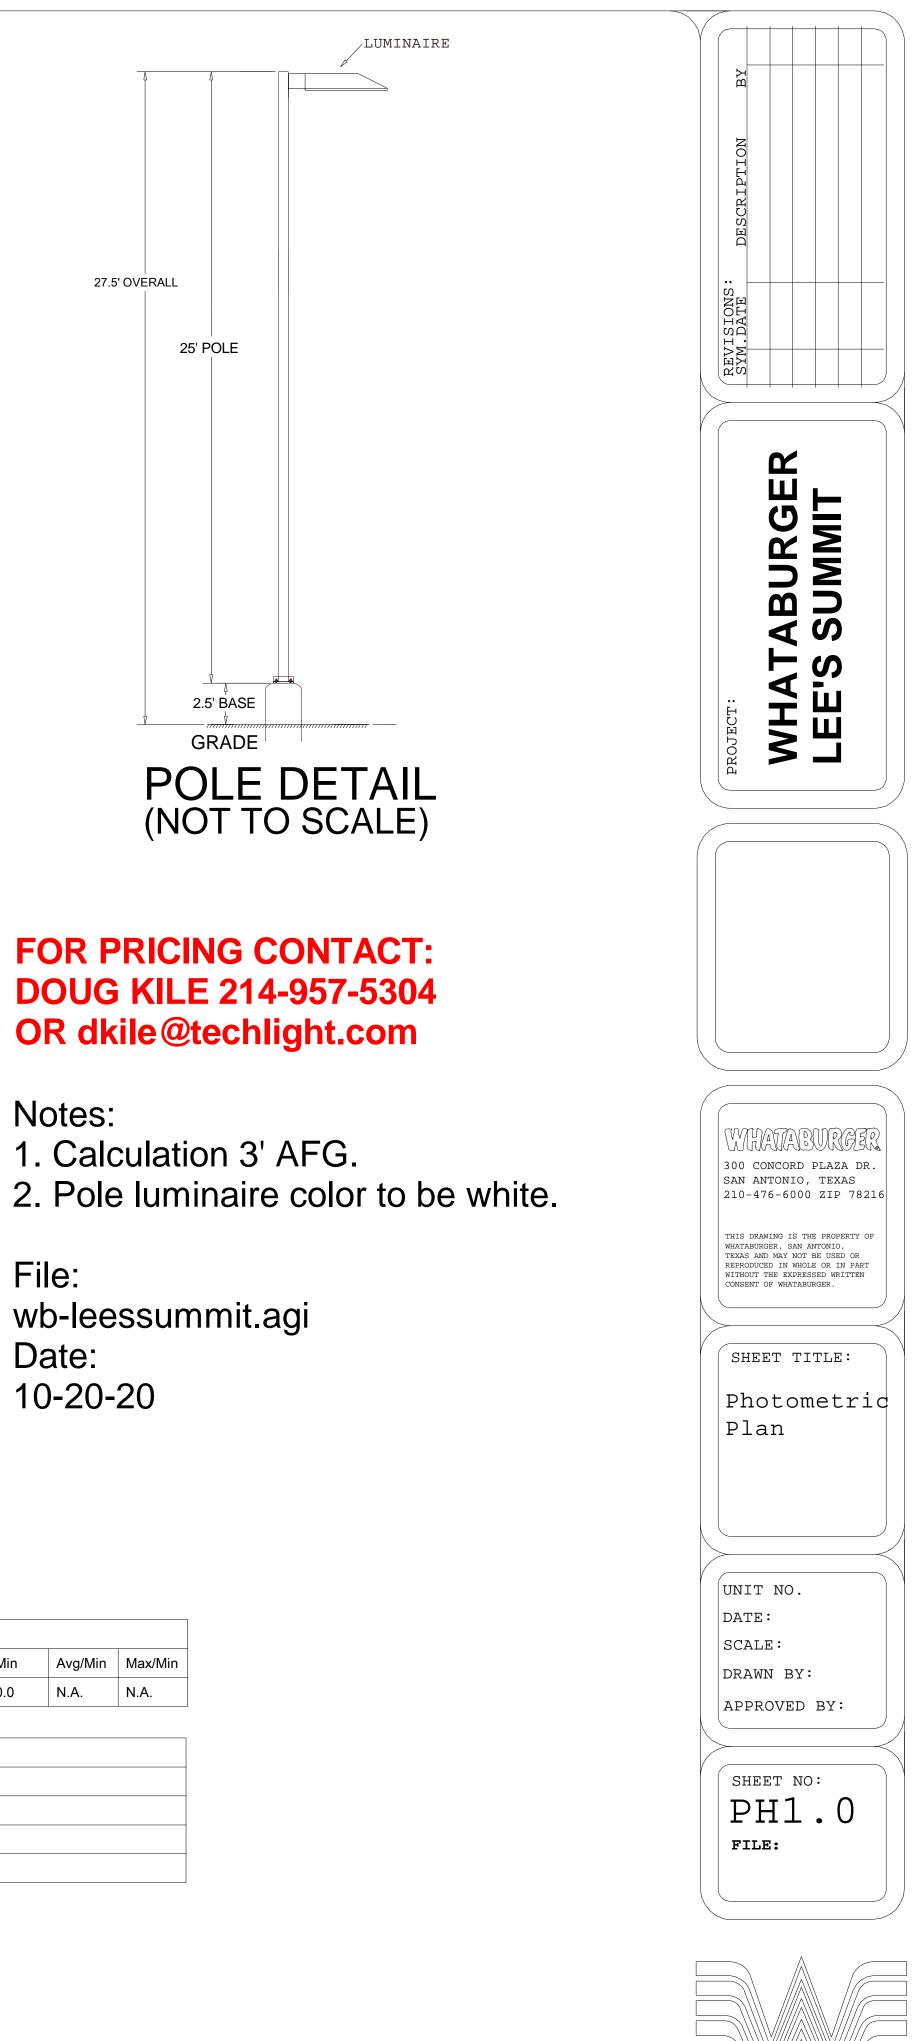
TECHLIGHT INC.

- DUE TO CHANGING LIGHTING ORDINANCES IT IS THE CONTRACTORS RESPONSIBILITY TO SUBMIT THE SITE PHOTOMETRICS AND LUMINAIRE SPECS TO THE LOCAL INSPECTOR BEFORE ORDERING TO ENSURE THIS PLAN COMPLIES WITH LOCAL LIGHTING ORDINACES.

- THIS LIGHTING DESIGN IS BASED ON INFORMATION SUPPLIED BY OTHERS. CHANGES IN ELECTRICAL SUPPLY, AREA GEOMETRY AND OBJECTS WITHIN THE LIGHTED AREA MAY PRODUCE ILLUMINATION VALUES DIFFERENT FROM THE PREDICTED RESULTS SHOWN ON THIS LAYOUT.

- THIS LAYOUT IS BASED ON .IES FILES THAT WERE LAB TESTED OR COMPUTER GENERATED. ACTUAL RESULTS MAY VARY.

Luminaire Schedule						
Symbol	Qty	Label	Lumens/Lamp	Arrangement	LLF	Description
	4	S3	N.A.	SINGLE	0.900	CTL-N-35L-T335,000 LUMEN TYPE 3 LED
	1	S3-29	N.A.	2 @ 90 DEGREES	0.900	CTL-N-20L-T320,000 LUMEN TYPE 3 LED
	3	S5-2	N.A.	D180	0.900	CTL-N-35L-T5W35,000 LUMEN TYPE 5 LED



WHATABURGER

File: wb-leessummit.agi Date: 10-20-20

g	Max	Min	Avg/Min	Max/Min
3	9.7	0.0	N.A.	N.A.