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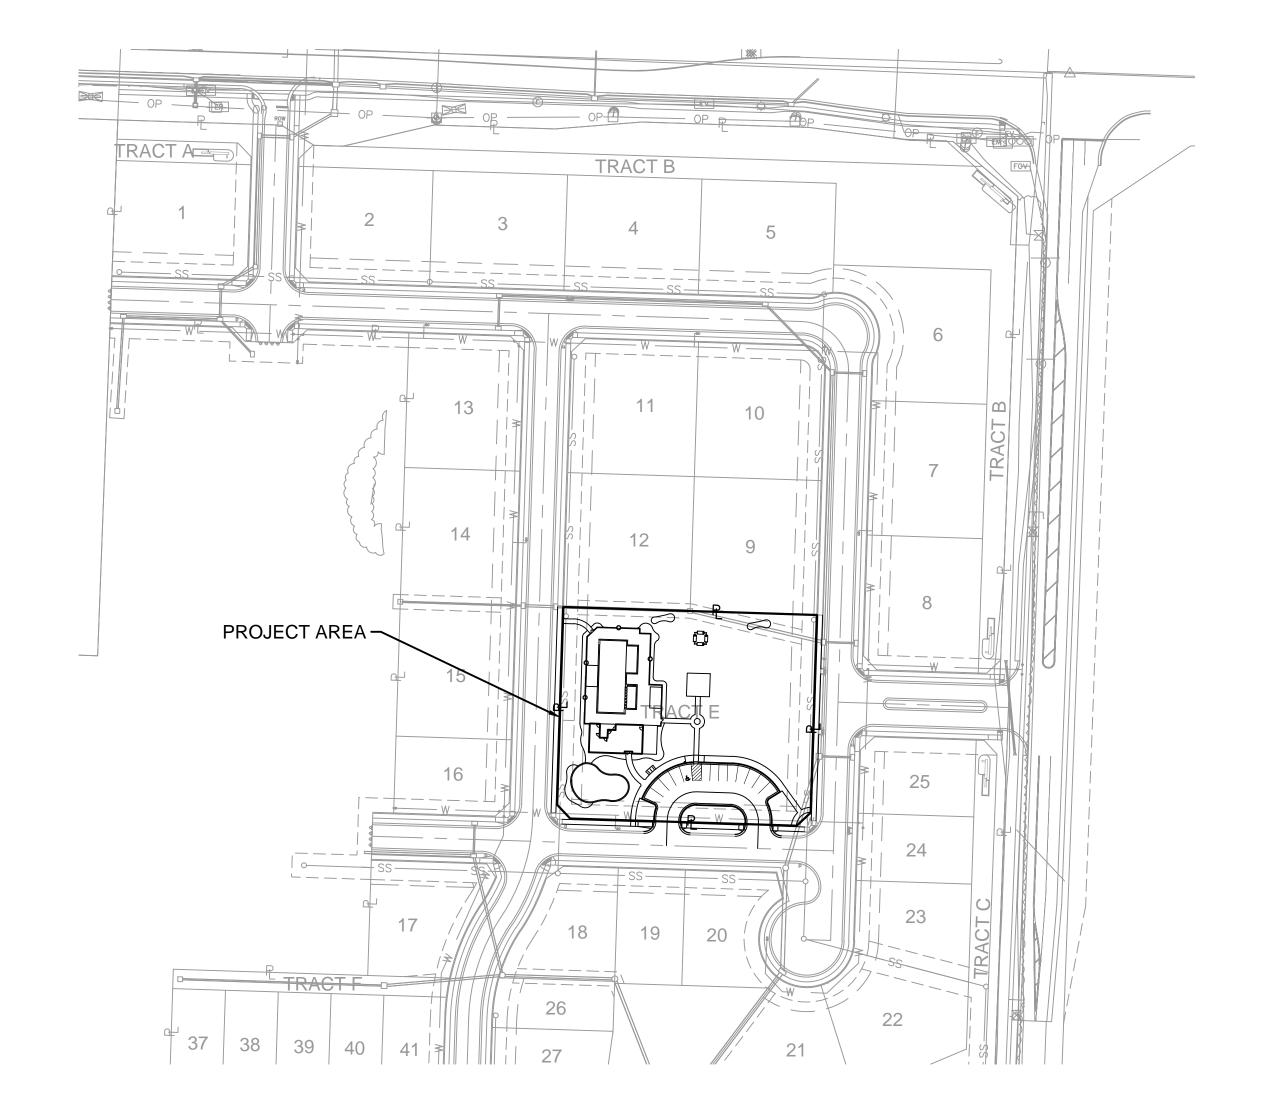
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designed by: QA/QC by: project no.: drawing no.: <u>C_TTL01_B192339</u>

SHEET

-OSAGE FIRST PLAT PLAT (TRACT E) NW 1/4 LOCATION MAP SEC. 35, TWP. 47N., RGE. 32W.

PROJECT TEAM & UTILITY CONTAC	T LIST
OWNER / DEVELOPER CLAYTON PROPERTIES GROUP, INC. D.B.A. SUMMIT HOMES 120 SE 30TH STREET CONTACT: VINCENT WALKER LEE'S SUMMIT, MO 64082 PHONE: 816.246.6700 EMAIL: VINCENT@SUMMITHOMESKC.COM	UTILITY SERVICE NUMBERS NAME: LEE'S SUMMIT PUBLIC WORKS PHONE: 816-969-1800 NAME: LEE'S SUMMIT WATER & SERVICES DEPARTMENT PHONE: 816-969-1940
ENGINEER OLSSON 1301 BURLINGTON ST. SUITE 100 NORTH KANSAS CITY, MO 64116 CONTACT: BROCK WORTHLEY PHONE: 816.361.1177 EMAIL: BWORTHLEY@OLSSON.COM	NAME: SPIRE (MGE) PHONE: 314-342-0500 NAME: AT&T PHONE: 800-286-8313 NAME: EVERGY PHONE: 816-471-5275
SURVEYOR OLSSON 1301 BURLINGTON ST. SUITE 100 NORTH KANSAS CITY, MO 64116 CONTACT: JASON ROUDEBUSH PHONE: 816.361.1177 EMAIL: JROUDEBUSH@OLSSON.COM	NAME: SPECTRUM (TWC) PHONE: 877-772-2253 NAME: GOOGLE FIBER PHONE: 877-454-6959



PROPERTY DESCRIPTION:

ALL OF TRACT E, OSAGE FIRST PLAT, A SUBDIVISION IN LEE'S SUMMIT, JACKSON COUNTY, MISSOURI

BENCHMARK

CHISELED PLUS ON THE EAST FLANGED BOLT OF THE FIRE HYDRANT ON THE WEST SIDE OF SW PRYOR ROAD ON ADJOINING PROPERTY SOUTH OF THE SOUTHWEST CORNER OF SUBJECT PROPERTY. ELEVATION = 1014.830

RAILROAD SPIKE IN THE NORTH FACE OF POWER POLE LOCATED ON THE SOUTH SIDE MISSOURI STATE HIGHWAY 150 AT THE WEST SIDE OF THE DRIVEWAY TO 2025 MISSOURI STATE HIGHWAY 150, LEE'S SUMMIT, MO. ELEVATION = 1031.313

NOTES:

ANY QUANTITIES SHOWN WITHIN THESE PLANS HAVE BEEN PROVIDED FOR PERMITTING PURPOSES ONLY AND ARE NOT INTENDED FOR USE IN PREPARATION OF CONTRACT DOCUMENTS. QUANTITIES INTENDED FOR, BUT NOT LIMITED TO, THE PREPARATION OF PROPOSALS AND BID DOCUMENTS SHALL BE INDEPENDENTLY EVALUATED BY THE ESTIMATING PARTY BASED UPON THE CONTENTS OF THESE PLANS.

OLSSON HAS BEEN RETAINED TO PROVIDE AS-BUILT DRAWINGS FOR THIS PROJECT.

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EL-1

JULIE E. SELLERS, P.E. **CIVIL ENGINEER** MO# PE-2017000367

HIGHWAYS.

ALL PAVING DIMENSIONS ARE TO BACK OF CURB UNLESS OTHERWISE NOTED.

. REFER TO DETAIL SHEET FOR INSTALLATION OF SIGNS.

PROVIDE SMOOTH SURFACE TRANSITIONS BETWEEN NEW ENTRANCE DRIVES AND EXISTING STREETS.

. CONTRACTOR SHALL MATCH EXISTING CURB & GUTTER IN GRADE, SIZE, TYPE, AND ALIGNMENT AT CONNECTIONS TO EXISTING STREETS.

. ALL WORK ON THIS PLAN SHALL BE DONE IN STRICT ACCORDANCE WITH THE OWNER'S SITE WORK SPECIFICATIONS.

6. ALL TRAFFIC CONTROL SIGNS SHALL BE FABRICATED AS SHOWN IN THE NATIONAL MANUAL ON UNIFORM TRAFFIC CONTROL DEVICES FOR STREET AND

7. CONTRACTOR SHALL REFER TO ARCHITECTURAL PLANS FOR EXACT LOCATIONS AND DIMENSIONS OF VESTIBULE, SLOPED PAVING, EXIT PORCHES, RAMPS, TRUCK DOCKS, PRECISE BUILDING DIMENSIONS, SIDEWALK AND SPECIFIC BUILDING AREA TREATMENTS AND IMPROVEMENTS. FOR EXACT BUILDING DIMENSIONS, SEE PARCHITECTURAL PLANS. CONTRACTOR TO STAKE AND CONSTRUCT FOUNDATIONS FOR REFERENCE ONLY.

ullet8. ALL DIMENSIONS SHOWN ON BUILDING ARE TO OUTSIDE FACE OF BUILDING.

9. CONTRACTOR SHALL COORDINATE PROTECTION OF BUILDING CORNERS TRANSFORMERS, AND ALL OTHER APPLICABLE STRUCTURES WITH GUARD POST PBOLLARDS WITHIN 5'OF THE BUILDINGS TO BE INSTALLED BY GENERAL CONTRACTOR.

10. PARKING LOT STRIPING SHALL BE INCLUDED IN PAVING CONTRACTOR'S SCOPE OF WORK. ALL STRIPING IS TO BE TWO LAYERS, 4" STROKE, REFLECTIVE PAINT, AND YELLOW ON CONCRETE.

11. ALL ACCESSIBLE PARKING SIGNAGE AND STRIPING SHALL BE IN ACCORDANCE WITH THE AMERICANS WITH DISABILITIES ACT (ADA) REQUIREMENTS.

12. THE CONTRACTOR SHALL SUPPLY THE OWNER WITH A LIST OF ALL SUBCONTRACTORS PRIOR TO COMMENCEMENT OF ANY CONSTRUCTION.

↑13. ALL ASPHALT PAVING SHALL BE IN ACCORDANCE WITH THE LATEST EDITION OF LEES SUMMIT DESIGN AND CONSTRUCTION MANUAL SECTION 2200.

14. THE GENERAL CONTRACTOR WILL BE HELD SOLELY RESPONSIBLE FOR, AND SHALL TAKE ALL PRECAUTIONS NECESSARY TO, AVOID PROPERTY DAMAGE TO ADJACENT PROPERTIES DURING THE CONSTRUCTION PHASES OF THIS PROJECT CONTRACTOR IS RESPONSIBLE FOR REPAIRS OF DAMAGE TO ANY EXISTING UTILITIES, PAVEMENT, STRIPING, CURB, ETC. ANY WORK IN CITY R.O.W. REPAIRS SHALL BE EQUAL TO OR BETTER THAN EXISTING CONDITIONS. CONTRACTOR IS RESPONSIBLE FOR PROTECTION OF ALL PROPERTY CORNERS AND SURVEY MONUMENTS AND IS RESPONSIBLE FOR RE-ESTABLISHMENT OF ANY PROPERTY CORNERS OR SURVEY MONUMENTS IF DISTURBED BY CONSTRUCTION ACTIVITIES.

RESPONSIBLE FOR CONDITIONS OF THE JOB SITE, INCLUDING SAFETY OF ALL WILL APPLY CONTINUOUSLY AND NOT BE LIMITED TO NORMAL WORKING HOURS. ulletAny construction observation by the engineer of the contractor's PERFORMANCE IS NOT INTENDED TO INCLUDE REVIEW OF THE ADEQUACY OF THE CONTRACTOR'S SAFETY MEASURES, IN, ON OR NEAR THE CONSTRUCTION SITE.

COORDINATED WITH THE HIGHWAY DEPARTMENT RESIDENT MAINTENANCE ENGINEER PRIOR TO START OF CONSTRUCTION. LATEST SPECIFICATIONS ADOPTED BY US DEPARTMENT OF TRANSPORTATION AND STATE HIGHWAY DEPARTMENT SHALL GOVERN ON THIS PROJECT.

17. ALL SITE WORK FOR THIS PROJECT SHALL MEET OR EXCEED THE SPECIFICATIONS OF THE RELEVANT UTILITY COMPANY OR REGULATORY AUTHORITY, AND THE SPECIFICATIONS FOR THE CONSTRUCTION OF THE EXISTING IMPROVEMENTS WHICH ARE BEING ALTERED OR REPLACED. CONTRACTOR SHALL CONTACT THE ENGINEER FOR SPECIFICATION SECTIONS FOR ITEMS SUCH AS LANDSCAPING AND SPECIFIED ON THESE PLANS.

18. ALL CONSTRUCTION WITHIN THE RIGHT-OF-WAY SHALL CONFORM TO THE CITY $\frac{2}{3}$: OF LEE'S SUMMIT, MISSOURI STANDARDS AND SPECIFICATIONS.

19. ALL CURB RETURN RADII ARE 4.0' UNLESS OTHERWISE NOTED.

WETLANDS NOTICE:

ANY DEVELOPMENT, EXCAVATION, CONSTRUCTION, OR FILLING IN A U.S. CORPS OF ENGINEERS DESIGNATED WETLAND IS SUBJECT TO LOCAL, STATE AND FEDERAL APPROVALS. THE CONTRACTOR SHALL COMPLY WITH ALL PERMIT REQUIREMENTS AND/OR RESTRICTIONS AND ANY VIOLATION WILL BE SUBJECT TO FEDERAL PENALTY. THE CONTRACTOR SHALL HOLD THE OWNER/DEVELOPER, THE ENGINEER AND THE CITY OF LEE'S SUMMIT HARMLESS AGAINST SUCH VIOLATION.

WARRANTY/DISCLAIMER:

. THE DESIGNS REPRESENTED IN THESE PLANS ARE IN ACCORDANCE WITH ESTABLISHED PRACTICES OF CIVIL ENGINEERING FOR THE DESIGN FUNCTIONS AND USES INTENDED BY THE OWNER AT THIS TIME. HOWEVER, NEITHER THE ENGINEER NOR ITS PERSONNEL CAN OR DO WARRANT THESE DESIGNS OR PLANS AS CONSTRUCTED EXCEPT IN THE SPECIFIC CASES WHERE THE ENGINEER INSPECTS AND CONTROLS THE PHYSICAL CONSTRUCTION ON A TEMPORARY BASIS AT THE

FLOOD CERTIFICATION:

. THE ENTIRE SITE IS LOCATED WITHIN ZONE X, "AREAS OUTSIDE THE 0.2% ANNUAL CHANCE FLOODPLAIN" AS DEPICTED ON THE FEMA FLOOD INSURANCE

OIL/GAS WELLS & UNDERMINED AREAS:

NO OIL OR GAS WELLS & UNDERMINED AREAS LOCATED WITHIN THE PROJECT

INFORMATION OBTAINED FROM THE MISSOURI DEPARTMENT OF NATURAL TOOL (GEOSTRAT).

DEMOLITION NOTES:

1. CONTRACTOR SHALL BE RESPONSIBLE FOR RAISING AND REMOVAL OF THE EXISTING STRUCTURES, RELATED UTILITIES, PAVING, PUBLIC SERVICE. SEE MECH. PLANS FOR ENTRANCE LOCATIONS. AND ANY OTHER EXISTING IMPROVEMENTS AS NOTED

2. CONTRACTOR IS TO REMOVE AND DISPOSE OF ALL DEBRIS, RUBBISH AND OTHER MATERIALS RESULTING FROM PREVIOUS AND PROPOSED METER. . CONTRACTOR SHALL MATCH EXISTING PAVEMENT IN GRADE AND ALIGNMENT TO CURRENT DEMOLITION OPERATIONS. DISPOSAL WILL BE IN ACCORDANCE WITH ALL LOCAL, STATE AND/OR FEDERAL REGULATIONS GOVERNING SUCH OPERATIONS.

3. ALL DEMOLITION WORK SHALL BE PERFORMED IN ACCORDANCE WITH THE OWNER'S SITE WORK SPECIFICATIONS.

4. CONTRACTOR IS RESPONSIBLE FOR REPAIRS OF DAMAGE AND ADJUSTMENTS DUE TO CONFLICTS OR GRADING TO ANY EXISTING STRUCTURES OR UNDERGROUND UTILITIES THAT ARE TO REMAIN IN PLACE.

5. ALL ITEMS DESIGNATED TO BE DEMOLISHED AND REMOVED FROM THE SITE SHALL BE DISPOSED OF IN AN APPROPRIATE LOCATION IN ACCORDANCE WITH STATE OR LOCAL GUIDELINES.

6. PUBLIC STREETS AND SIDEWALKS SHALL BE KEPT CLEAN AND CLEAR OF TRASH AND DEBRIS FROM DEMOLITION OPERATIONS

7. THE CONTRACTOR SHALL BE RESPONSIBLE FOR DUST AND EROSION CONTROL DURING DEMOLITION OPERATIONS.

8. THE CONTRACTOR SHALL COORDINATE WITH ALL APPLICABLE UTILITY COMPANIES PRIOR TO REMOVAL OR RELOCATION OF ANY UTILITIES AND TO SAFELY STOP SERVICES AND DISMANTLE SERVICE LINES PRIOR TO BEGINNING DEMOLITION OPERATIONS.

AND FOOTINGS FROM STRUCTURAL PLAN. BUILDING DIMENSIONS ON THIS PLAN ARE 9. CONTRACTOR IS TO REMOVE AND RE-USE SEWER PIPES, POWER POLES AND GUY WIRES, WATER LINES AND METERS, VEGETATION, ASPHALT, AND OTHER UNSUITABLE DEBRIS OR MATERIAL. SHOWN OR NOT SHOWN WITHIN CONSTRUCTION LIMITS AND WHERE NECESSARY TO ALLOW FOR CONSTRUCTION ACTIVITY. ALL MATERIAL TO BE REMOVED AS UNCLASSIFIED EXCAVATION.

> 10. ALL CAVITIES CREATED BY REMOVAL OF EXISTING FACILITIES IN THE AREA OF PROPOSED CONSTRUCTION SHALL BE FILLED AND COMPACTED IN ACCORDANCE WITH THE SITE WORK SPECIFICATIONS TO SUBGRADE ELEVATION.

> 11. THE CONTRACTOR SHALL EXERCISE EXTREME CAUTION WHEN WORKING IN THE VICINITY OF EXISTING OVERHEAD ELECTRICAL POWER LINES.

12. EXISTING UTILITIES ARE SHOWN AS LOCATED AND IDENTIFIED IN THE FIELD BY UTILITY COMPANY REPRESENTATIVE. THE OWNER AND THE ENGINEER MAKE NO ASSURANCE OF THE ACTUAL LOCATION, DEPTH, SIZE OR TYPE OF UTILITY LINES SHOWN. INCLUDING ADA SYMBOL AND HATCHING. PAINT COLOR TO BE WHITE ON ASPHALT THE OWNER AND THE ENGINEER MAKES NO ASSURANCE THAT ALL OF THE EXISTING UTILITY LINES ON THE SITE ARE SHOWN.

GRADING AND CLEARING NOTES:

1. EXISTING UTILITIES AS SHOWN ARE APPROXIMATE LOCATIONS ONLY. IT SHALL BE THE RESPONSIBILITY OF THE CONTRACTOR TO VERIFY THE LOCATIONS OF ALL EXISTING UTILITIES PRIOR TO THE START OF ANY CONSTRUCTION WORK. ANY DAMAGE TO EXISTING STRUCTURES, UTILITIES, FENCES AND/OR INCIDENTALS NOT DESIGNATED FOR REMOVAL SHALL BE REPAIRED AT THE CONTRACTORS EXPENSE.

2. CONTRACTOR SHALL ADHERE TO THE "DESIGN AND CONSTRUCTION MANUAL" SECTION 2100 AS ADOPTED BY THE CITY OF LEES SUMMIT, MISSOURI (LATEST EDITION), FOR EXCAVATION AND EMBANKMENT WORK WITHIN THE PROPOSED DRIVE LANES.

3. CONTRACTOR SHALL PROVIDE A LEVEL BUILDING PAD BASED UPON PROPOSED FINISHED FLOOR ELEVATION TO \pm 0.10' OR AS ESTABLISHED THROUGH ALTERNATIVE BID DOCUMENTS.

MMPROVEMENTS DURING CONSTRUCTION, SUCH AS, BUT NOT LIMITED TO: DRAINAGE 4. PRIOR TO FINAL ACCEPTANCE OF THE PROJECT, ALL SLOPES AND AREAS DISTURBED BY CONSTRUCTION SHALL BE GRADED SMOOTH A MINIMUM OF FOUR INCHES OF TOPSOIL APPLIED. IF ADEQUATE TOPSOIL IS NOT AVAILABLE ON SITE THE CONTRACTOR SHALL PROVIDE TOPSOIL, APPROVED BY THE OWNER, AS NEEDED. THE AREA SHALL THEN BE SEEDED, FERTILIZED, MULCHED, WATERED AND MAINTAINED UNTIL HARDY GRASS GROWTH IS ESTABLISHED IN ALL AREAS. ANY AREAS DISTURBED FOR ANY REASON PRIOR TO FINAL ACCEPTANCE OF THE PROJECT SHALL BE CORRECTED BY THE CONTRACTOR AT NO ADDITIONAL COST TO THE OWNER.

15. SAFETY NOTICE TO CONTRACTOR: IN ACCORDANCE WITH GENERALLY ACCEPTED 5. AREAS OF CONSTRUCTION SHALL BE STRIPPED OF ALL VEGETATION, ORGANIC MATTER AND TOPSOIL TO A DEPTH AS CONSTRUCTION PRACTICES, THE CONTRACTOR SHALL BE SOLELY AND COMPLETELY RECOMMENDED BY GEOTECHNICAL ENGINEER AND/ OR TESTING AGENCY. SOILS REMOVED DURING SITE STRIPPING SHOULD BE EVALUATED TO DETERMINE IF PORTIONS OF THE TOPSOIL STRATUM MAY BE UTILIZED AS STRUCTURAL FILL WITHIN PAVEMENT PERSONS AND PROPERTY DURING PERFORMANCE OF THE WORK. THIS REQUIREMENT AREAS. ANY MATERIAL NOT DEEMED AS SUITABLE FILL MATERIAL BY THE GEOTECHNICAL ENGINEER AND/ OR TESTING AGENCY SHALL BE REMOVED FROM THE JOB SITE BY THE CONTRACTOR AT HIS EXPENSE

6. ALL EMBANKMENT SHOULD BE PLACED IN CONTROLLED LIFTS HAVING A MAXIMUM LOOSE LIFT THICKNESS OF 9". EMBANKMENT PLACED WITHIN THE PAVEMENT AREAS SHOULD BE COMPACTED TO A MINIMUM OF 95% OF THE MATERIALS MAXIMUM DRY DENSITY AS DETERMINED BY ASTM D-698 (STANDARD PROCTOR COMPACTION). EMBANKMENT PLACED WITHIN THE BUILDING 16. ALL CONSTRUCTION IN STATE HIGHWAY DEPARTMENT RIGHT-OF-WAY SHALL BE AREAS SHOULD BE COMPACTED TO A MINIMUM OF 95% OF THE MATERIALS MAXIMUM DRY DENSITY AS DETERMINED BY ASTM D-698 (STANDARD PROCTOR COMPACTION). MOISTURE CONTENT OF THE FILL AT THE TIME OF COMPACTION SHALL BE WITHIN A RANGE OF 0 TO 4 PERCENT ABOVE OPTIMUM MOISTURE CONTENT AS DEFINED BY THE STANDARD PROCTOR COMPACTION PROCEDURE. ALL EMBANKMENT PLACED WITHIN 18" OF THE BUILDING SUBGRADE SHOULD HAVE A LIQUID LIMIT LESS THAN 60. THE GEOTECHNICAL REPORT SHALL SUPERSEDE RECOMMENDATIONS AS STATED IN THIS PLAN SET.

UTILITY CONSTRUCTION NOTES:

ARCHITECTURAL PLANS AND DETAILS.

1. PRIOR TO INSTALLATION OF ANY PROPOSED UTILITY THE CONTRACTOR SHALL EXCAVATE, VERIFY, AND CALCULATE ALL RENGINEER FOR SPECIFICATION SECTIONS FOR HEMS SUCH AS LANDSCAPING AND

CROSSINGS WITH EXISTING UTILITIES AND INFORM THE OWNER AND THE ENGINEER OF ANY CONFLICTS. THE ENGINEER WILL BE
SPECIFIED ON THESE PLANS

> THE CONTRACTOR IS SPECIFICALLY CAUTIONED THAT THE LOCATION AND/OR ELEVATION OF EXISTING UTILITIES AS SHOWN ON THESE PLANS IS BASED ON RECORDS OF THE VARIOUS UTILITY COMPANIES, AND WHERE POSSIBLE, MEASUREMENTS TAKEN IN THE FIELD. THE INFORMATION IS NOT TO BE RELIED ON AS BEING EXACT OR COMPLETE. THE CONTRACTOR MUST CALL THE APPROPRIATE UTILITY COMPANY AT LEAST 48 HOURS BEFORE ANY EXCAVATION TO REQUEST EXACT FIELD LOCATION OF UTILITIES. IT IS THE CONTRACTORS RESPONSIBILITY TO RELOCATE AND/OR ADJUST ALL EXISTING UTILITIES THAT CONFLICT WITH D) ADDITIONAL SITE MANAGEMENT PRACTICES WHICH SHALL BE ADHERED TO PROPOSED SITE IMPROVEMENTS.

3. UNLESS OTHERWISE SHOWN, CALLED OUT OR SPECIFIED HEREON OR WITHIN THE SPECIFICATIONS:

ALL STORM DRAIN PIPE BEDDING SHALL BE INSTALLED PER CITY STANDARD DETAILS.

ALL STORM DRAIN PIPES ARE MEASURED FROM CENTER OF STRUCTURES AND ENDS OF FLARED END SECTIONS.

4. IT SHALL BE THE RESPONSIBILITY OF THE CONTRACTOR TO CONTROL DOWNSTREAM EROSION AND SILTATION DURING ALL PHASES OF CONSTRUCTION. EROSION CONTROL MEASURES SHALL BE IN PLACE PRIOR TO CONSTRUCTION.

5. TELEPHONE CONDUIT SHALL HAVE A MINIMUM COVER OF 30". CONDUIT SHALL BE DUAL 4" SCHEDULE 40 PVC. CONTRACTOR SHALL COORDINATE LOCATION WITH THE UTILITY REPRESENTATIVE AND LOCATE PVC CROSSINGS AS NECESSARY. SEE ELEC. PLANS FOR ENTRANCE LOCATIONS.

6. FOR ALL SERVICE LINE ENTRANCE LOCATIONS WITHIN THE BUILDING, INCLUDING ROOF DRAIN CONNECTIONS, SEE

7. ALL WATER SERVICE LINES SHALL BE A MINIMUM OF 48" BELOW FINISHED GRADE.

8. ALL SANITARY SEWER LINES SHALL BE SDR-26 WITH 42" MIN. COVER.

9. CONTRACTOR SHALL COORDINATE ANY DISRUPTIONS TO EXISTING UTILITY SERVICES WITH ADJACENT PROPERTY OWNERS A MINIMUM OF 48 HOURS PRIOR TO DISRUPTION.

10. ALL ELECTRIC AND TELEPHONE, INCLUDING SERVICE LINES SHALL BE CONSTRUCTED TO THE APPROPRIATE UTILITY COMPANY SPECIFICATIONS. ALL UTILITY DISCONNECTION'S SHALL BE COORDINATED WITH THE DESIGNATED UTILITY COMPANIES.

11. PRIOR TO ORDERING PRECAST STRUCTURES, SHOP DRAWINGS SHALL BE SUBMITTED TO THE DESIGN ENGINEER FOR APPROVAL.

RATE MAP (FIRM) MAP NUMBER 29095C0531G, REVISION DATE JANUARY 20, 2017 12. ALL PRIVATE INSTALLATIONS SHALL CONFORM TO THE CURRENT STANDARDS AND SPECIFICATIONS AS ADOPTED BY THE CITY OF LEE'S SUMMMIT, MISSOURI.

> 13. EXTENSION OF BOTH DOMESTIC WATER SERVICE AND FIRE PROTECTION LINE MAY NOT BE PROVIDED UNTIL PUBLIC MAIN HAS BEEN TESTED AND ACCEPTED BY WRITTEN AUTHORIZATION FROM LEE'S SUMMIT WATER DEPARTMENT.

14. CONTRACTOR TO CONTACT LEE'S SUMMIT WATER SERVICES DEPARTMENT FOR MAIN LINE TAP AND METER SET A MINIMUM OF 48 HOURS PRIOR TO CONNECTION.

RESOURCES, GEOLOGICAL SURVEY GEOSCIENCES TECHNICAL RESOURCE ASSESSMENT 17. CONSTRUCTION SHALL NOT START ON ANY PUBLIC UTILITY SYSTEM UNTIL THE APPROPRIATE PERMITS HAVE BEEN PULLED FROM THE CITY OF LEE'S SUMMIT AND/OR JACKSON COUNTY AND CONTRACTOR HAS BEEN NOTIFIED BY THE ENGINEER.

18. ALL ELECTRICAL CONDUIT SHALL BE SCHEDULE 40 ELECTRICAL PVC, AS CALLED OUT AND HAVE AN AVERAGE OF 36" TO 42" COVER WITH A MINIMUM OF 30" CONFORMING TO THE CURRENT REGULATIONS SET FORTH BY MISSOURI) |

19. CONTRACTOR SHALL MAKE APPLICATION WITH SPIRE ENERGY FOR

 THE INTENT OF THIS EROSION CONTROL PLAN IS TO ASSIST THE CONTRACTOR IN THEIR RESPONSIBILITY TO PROVIDE ALL MATERIALS, TOOLS EQUIPMENT AND LABOR NECESSARY TO CONTROL EROSION, SILTATION AND DISCHARGES OF SOIL MATERIAL (SEDIMENT) INTO DOWNSTREAM SYSTEMS OR RECEIVING CHANNELS. THIS SHALL BE REQUIRED DURING ALL PHASES OF CONSTRUCTION AND UNTIL SUITABLE GROUND COVER IS ESTABLISHED FOR ALL DISTURBED AREAS. IF ANY METHOD OF CONTROL FAILS, THE CONTRACTOR SHALL NOTIFY THE OWNER IMMEDIATELY, SO THAT THE OWNER OR THEIR AGENT CAN REVIEW THE CONTRACTOR'S PROPOSED METHOD OF REPAIR.

THIS PLAN INDICATES THE CRITICAL AREA(S) OF CONCERN TO BE CONTROLLED AS A MINIMUM. THE CONTROL MAY CONSIST OF TEMPORARY CONTROL MEASURES AS SHOWN ON THE PLANS OR ORDERED BY THE OWNER DURING THE LIFE OF THE CONTRACT TO CONTROL EROSION OR WATER POLLUTION, THROUGH THE USE OF BERMS, DIKES, DAMS, SEDIMENT BASINS, FIBER MATS, NETTING, GRAVEL, MULCHES, GRASSES, SLOPE DRAINS, DIVERSION SWALES OR OTHER EROSION CONTROL DEVICES OR METHODS. THE OWNER HAS THE AUTHORITY TO LIMIT THE SURFACE AREA OF ERODIBLE EARTH MATERIAL EXPOSED BY THE CONSTRUCTION OPERATIONS AND TO DIRECT THE CONTRACTOR TO PROVIDE IMMEDIATE PERMANENT OR TEMPORARY POLLUTION CONTROL MEASURES TO PREVENT CONTAMINATION OF ADJACENT STREAMS OR OTHER WATER COURSES, LAKES, PONDS, OR OTHER AREAS OF WATER IMPOUNDMENT OR CONVEYANCES.

THE TEMPORARY POLLUTION CONTROL PROVISIONS CONTAINED HEREIN SHALL BE COORDINATED WITH ANY PERMANENT EROSION CONTROL FEATURES SPECIFIED ELSEWHERE IN THE CONTRACT TO THE EXTENT PRACTICAL TO ASSURE ECONOMICAL, EFFECTIVE AND CONTINUOUS EROSION CONTROL THROUGHOUT THE CONSTRUCTION AND POST CONSTRUCTION PERIOD.

THIS SEDIMENTATION CONTROL PLAN MAKES USE OF THE FOLLOWING **APPLICATIONS:**

PRESERVATION OF EXISTING VEGETATION SEDIMENT BARRIERS

SEDIMENT TRAPS _x__ INLET PROTECTION

OUTLET PROTECTION SOIL RETAINING SYSTEMS

SLOPE DRAINS SUBSURFACE DRAINS

PHYSICAL DESCRIPTION OF EACH SPECIFIC SEDIMENT CONTROL DEVICE TO BE UTILIZED IS CALLED OUT ON THE PLANS WITH INSTALLATION PROCEDURES, CONSTRUCTION SPECIFICATIONS AND MAINTENANCE ARRANGEMENT AS CALLED FOR ON THE DETAIL SHEET. IN ADDITION TO THE MEASURES SPECIFIED, THE FOLLOWING GENERAL PRACTICES SHALL BE ADHERED TO WHEN APPLICABLE.

A) CLEARING AND GRUBBING WITHIN 50' OF A DEFINED DRAINAGE COURSE SHOULD BE AVOIDED WHEN POSSIBLE. WHERE CHANGES TO A DEFINED DRAINAGE COURSE OCCUR, WORK SHOULD BE DELAYED UNTIL ALL MATERIALS AND EQUIPMENT NECESSARY TO PROTECT AND COMPLETE THE DRAINAGE CHANGE ARE ON SITE. CHANGES SHALL BE COMPLETED AS QUICKLY AS POSSIBLE ONCE THE WORK HAS BEEN INITIATED. THE AREA IMPACTED BY THE CONSTRUCTION ACTIVITIES SHALL BE REVEGETATED OR PROTECTED FROM EROSION AS SOON AS POSSIBLE, AREAS WITHIN 50' OF A DEFINED DRAINAGE WAY SHOULD BE RECONTOURED AS NEEDED OR OTHERWISE PROTECTED WITHIN FIVE (5) WORKING DAYS AFTER GRADING HAS CEASED.

B) WHERE SOIL DISTURBING ACTIVITIES CEASE IN AN AREA FOR MORE THAN 14 DAYS, THE DISTURBED AREAS SHALL BE PROTECTED FROM EROSION BY STABILIZING THE AREA WITH MULCH OR OTHER SIMILARLY EFFECTIVE EROSION CONTROL MEASURES. IF THE SLOPE OF THE AREA IS GREATER THAN 3:1 OR IF THE SLOPE IS GREATER THAN 3% AND GREATER THAN 150 FEET IN LENGTH, THEN THE DISTURBED AREAS SHALL BE PROTECTED FROM EROSION BY STABILIZING THE AREA WITH MULCH OR OTHER SIMILARLY EFFECTIVE EROSION CONTROL MEASURES IF ACTIVITIES CEASE FOR MORE THAN SEVEN (7) DAYS.

C) EXISTING VEGETATION SHALL BE PRESERVED TO THE EXTENT AND WHERE PRACTICAL. IN NO CASE SHALL DISTURBED AREAS REMAIN WITHOUT VEGETATIVE GROUND COVER FOR A PERIOD IN EXCESS OF 60 DAYS.

DURING THE CONSTRUCTION PROCESS SHALL INCLUDE:

SOLID AND HAZARDOUS WASTE MANAGEMENT INCLUDING PROVIDING TRASH CONTAINERS AND REGULAR SITE CLEAN UP FOR PROPER DISPOSAL OF SOLID WASTE SUCH AS BUILDING MATERIAL, PRODUCT/MATERIAL SHIPPING WASTE, FOOD CONTAINERS AND CUPS, AND PROVIDING CONTAINERS FOR THE PROPER DISPOSAL OF WASTE PAINTS SOLVENTS, AND CLEANING COMPOUNDS.

PROVISIONS OF PORTABLE TOILETS FOR PROPER DISPOSAL OF SANITARY SEWAGE.

STORAGE OF CONSTRUCTION MATERIALS AWAY FROM DRAINAGE COURSES AND LOW AREAS.

INSTALLATION OF CONTAINMENT BERMS AND USE OF DRIP PANS AT PETROLEUM PRODUCT AND LIQUID STORAGE TANKS AND CONTAINERS.

3. ALL DISTURBED AREAS SHALL BE SEEDED, FERTILIZED AND MULCHED, OR SODDED, IN ACCORDANCE WITH THE STANDARDS AND SPECIFICATIONS ADOPTED BY THE CITY OF LEE'S SUMMIT AND GOOD ENGINEERING PRACTICES. THIS SHALL BE COMPLETED WITHIN FOURTEEN (14) DAYS AFTER COMPLETING THE WORK, IN ANY AREA. IF THIS IS OUTSIDE OF THE SEEDING PERIOD, SILT BARRIERS OR OTHER SIMILARLY EFFECTIVE MEASURES

SHALL BE PROVIDED UNTIL SUCH TIME THAT THE AREAS CAN BE SEEDED.

4. THE CONSTRUCTION COVERED BY THESE PLANS SHALL CONFORM TO ALL CURRENT STANDARDS AND SPECIFICATIONS ADOPTED BY THE CITY OF LEE' SUMMIT. THE CONTRACTOR WILL BE RESPONSIBLE FOR DETERMINING ALL ADDITIONAL STANDARDS, SPECIFICATIONS OR REQUIREMENTS WHICH ARE REQUIRED BY GOVERNING AGENCIES (INCLUDING THE CITY OF LEE'S SUMMIT, STATE OF MISSOURI AND FEDERAL AUTHORITIES) HAVING JURISDICTION OVER THE WORK PROPOSED BY THESE CONSTRUCTION DRAWINGS.

5. ALL EROSION CONTROL MEASURES, TEMPORARY OR PERMANENT, REQUIRE MAINTENANCE TO PRESERVE THEIR EFFECTIVENESS. ALL EROSION CONTROL DEVICES SHALL BE INSPECTED ONCE EVERY SEVEN (7) CALENDAR DAYS AND WITHIN 24 HOURS OF THE OCCURRENCE OF A 2-YR, 24-HR STORM EVENT. OR ONCE EVERY FOURTEEN (14) CALENDAR DAYS AND WITHIN 24 HOURS OF THE OCCURRENCE OF A STORM EVENT OF 0.25-INCHES OF PRECIPITATION OR GREATER. ANY REQUIRED REPAIRS SHOULD BE MADE IMMEDIATELY. ALL COSTS ASSOCIATED WITH THE REPAIR WORK, INCLUDING RELATED INCIDENTALS ASSOCIATED WITH THE REPAIR WORK, WILL BE THE CONTRACTOR'S RESPONSIBILITY AND SHALL BE INCLUDED IN THE CONTRACTOR'S BID FOR THE PROPOSED WORK

		JEND
	GENERAL	
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•		50111
♠ ATR	ARROW TURN RIGHT	
♂ BLB	BILLBOARD	→ SCR
M BOV	BLOW OFF VALVE	● SET
⊙ BSH	BUSH	
O COL	COLUMN	
從 CTR	CONIFEROUS TREE	- EP
⊞ DRN	DRAIN GRATE	- P
O DTR	DECIDUOUS TREE	
O FLP	FLAG POLE	
	GUARD POST	FR/W
O GDP		D ()W
- GPL	GUY POLE	
	GREASE TRAP	
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🖒 HCP	ACCESSABLE PARKING MARKER	CV CAV
S LST	LIFT STATION	TVP TVP
Φ MLB	MAILBOX	© TVR
Ф МР	MILE POST MARKER	-ECTVOH-
MWL	MONITORING WELL	ECTV
∜ PIV	POST INDICATOR VALVE	-CTVOH-
O PPT	PROPANE TANK	
<u></u> RAT	RADIO TOWER	■ FOB
望 SAD	SATELLITE	® FOM
⋈ SCV	SPRINKLER CONTROL VALVE	₱ FOP
▼ SGN	SIGN	FOV FOV
SLB	STREET LIGHT BOX	—EFOOH—
SLC SLC	STREET LIGHT CABINET	— EFO
S SPB	SPRINKLER BOX	
O SPH	SPRINKLER HEAD	
P\ STP	STUMP	상 FDC
X SVL	SEWER VALVE	— EFP—
☐ TCB	TRAFFIC CONTROL BOX	
—TSA	TRAFFIC SIGNAL WITH MAST ARM	— EFL
TS TSC	TRAFFIC SIGNAL CABINET	
® TSMH	TRAFFIC SIGNAL MANHOLE	☐ GAR
∞ TSP	TRAFFIC SIGNAL POLE	© GMH
~~~	EXISTING TREELINE	• GMK
~~~	PROPOSED TREELINE	GM GMT
	EXISTING SIDEWALK	□ GRG
	PROPOSED SIDEWALK	X GVL
	FUTURE SIDEWALK	EG EG
	EXISTING BUILDINGS	
	PROPOSED BUILDINGS	TEC TEC
	FUTURE BUILDINGS	TP TEP
	EXISTING EDGE OF PAVEMENT	☐ TER
	PROPOSED EDGE OF PAVEMENT	TEV TEV
	FUTURE EDGE OF PAVEMENT	① TMH
	EXISTING ROADWAY CENTER LINE	-ETELOH-
	PROPOSED ROADWAY CENTER LINE	— ETEL—
	FUTURE ROADWAY CENTER LINE	-TELOH-
	EXISTING CURB & GUTTER	- TEL
	PROPOSED CURB & GUTTER	
	FUTURE CURB & GUTTER	☼ LTP
R	RADIUS	
L	ARC DISTANCE	■ TRF
D	DELTA / CENTRAL ANGLE	■ EBX
E A	ASEMENTS & SETBACKS	⊠ ELC
A.E.	ACCESS EASEMENT	ER ELR
B.M.P.	BEST MANAGEMENT PRACTICE EASEMENT	© EMH
B.L.	BUILDING SETBACK	EM EMT
C.T.V.E.	CABLE TV EASEEMNT	ES ESC
C.E.	CONSERVATION EASEMENT	EV EVT
C.G.E.	CONSTRUCTION GRADING EASEMENT	☆ YDL
		•
F.P.E.	FLOOD PLAIN EASEMENT	—EEOH—
F.O.E.	FIBER OPTIC EASEMENT	EE
F.P.S.E.	FIRE PROTECTION SYSTEM EASEMENT	● SCO
F.L.E.	FUEL LINE EASEMENT	③ SSMH
L.S.E.	LANDSCAPE EASEMENT	ESS
G.E.	NATURAL GAS EASEMENT	==\$\$==
T.E.	TELEPHONE EASEMENT	FSS
E.E.	POWER\ELECTRIC EASEMENT	— ESL
P.S.	PARKING SETBACK	- SL
S.B.	STREAM BUFFER	© SDMH
	SURFACE DRAINAGE EASEMENT	☐ FES
	SIGHT DISTANCE EASEMENT	O RDN
S.E.	SANITARY SEWER EASEMENT	
S.L.E.	STEAM LINE EASEMENT	
D.E.	STORM DRAINAGE EASEMENT	1
	STORM WATER MANAGEMENT EASEMENT	-Ó FH
T.C.D.S.E.	TEMPORARY CUL-DE-SAC EASEMENT	w WMH
EMP. ESMT.	TEMPORARY EASEMENT	• WMK
	TRAIL\PATH EASEMENT	WM WMT
U.E.	UTILITY EASEMENT	X WVL
W.E.	WATER EASEMENT	
F.Y.S	FRONT YARD SETBACK	
R.Y.S.	REAR YARD SETBACK	v v ———
S.Y.S.		
٥.١.٥.	SIDE YARD SETBACK	
_100	CONTOURS EXISTING INDEX CONTOURS	
	EXISTING INDEX CONTOURS	
	EXISTING INTERMEDIATE CONTOURS	
<u>100</u>	PROPOSED INDEX CONTOURS	
100	PROPOSED INTERMEDIATE CONTOURS	

LEGEND

SURVEY MARKERS

BENCHMARK

CONTROL POINT


FOUND MONUMENT


ROW | ROW MARKER SECTION CORNER SET MONUMENT BOUNDARIES — | SECTION LINE EXISTING PROPERTY BOUNDARY PROPOSED PROPERTY BOUNDARY EXISTING LOT LINE ---- PROPOSED LOT LINE EXISTING RIGHT-OF-WAY W-- | PROPOSED RIGHT-OF-WAY UTILITIES CAB | CABLE BOX CABLE VAULT TVP | TELEVISION PEDESTAL TVR | TELEVISION RISER EXISTING CABLE TV, OVERHEAD EXISTING CABLE TV, UNDERGROUND 'OH- | PROPOSED CABLE TV, OVERHEAD V − | PROPOSED CABLE TV, UNDERGROUND FOB FIBER OPTIC BOX FOM | FIBER OPTIC MANHOLE FOP | FIBER OPTIC PEDESTAL JULIE ELAINE FIBER OPTIC VAULT SELLERS 1 EXISTING FIBER OPTIC, OVERHEAD NUMBER EXISTING FIBER OPTIC, UNDERGROUND PE-2017000367 DH - PROPOSED FIBER OPTIC, OVERHEAD 1/31/21) --- | PROPOSED FIBER OPTIC, UNDERGROUND FIRE DEPT. CONNECTION EXISTING FIRE PROTECTION SYSTEM LINE PROPOSED FIRE PROTECTION SYSTEM LINE EXISTING FUEL LINE 'L--- | PROPOSED FUEL LINE GAS RISER GAS MANHOL GAS MARKER GMT GAS METER GAS REGULATOR GAS VALVE EXISTING NATURAL GAS LINE ---- PROPOSED NATURAL GAS LINE TELEPHONE CABINET | TELEPHONE PEDESTAL TELEPHONE RISER | TELEPHONE VAULT TELEPHONE MANHOLE EXISTING TELEPHONE LINE, OVERHEAD EXISTING TELEPHONE LINE, UNDERGROUND OH- | PROPOSED TELEPHONE LINE, OVERHEAD PROPOSED TELEPHONE LINE, UNDERGROUND GROUND LIGHT LIGHT POLE PWP | POWER POLE | ELECTRIC TRANSFORMER EBX | ELECTRIC BOX | ELECTRIC CABINET ELR | ELECTRIC RISER EMH | ELECTRIC MANHOLE | ELECTRIC METER ELECTRIC SECTIONALIZER EVT | ELECTRIC VAULT YDL | YARD LIGHT EXISTING POWER\ELECTRIC LINE, OVERHEAD EXISTING POWER\ELECTRIC LINE, UNDERGROUND SCO | SEWER CLEANOUT SSMH | SANITARY MANHOLE EXISTING SANITARY SEWER S--- PROPOSED SANITARY SEWER FUTURE SANITARY SEWER EXISTING STEAM LINE └── | PROPOSED STEAM LINE SDMH STORM SEWER MANHOLE FES | FLARED END SECTION RDN ROOF DRAIN NOTES PMENT F EXISTING STORM SEWER ₱── | PROPOSED STORM SEWER | FIRE HYDRANT NERAL | EVELOP WMH | WATER MANHOLE WMK | WATER MARKER WMT | WATER METER WVL | WATER VALVE EXISTING WATER LINE --- PROPOSED WATER LINE


6. THE CONTRACTOR SHALL CONTACT THE CITY'S DEVELOPMENT SERVICES ENGINEERING INSPECTORS 48 HOURS PRIOR TO ANY LAND DISTURBANCE WORK AT 816.969.1200.


> drawn by: designed by: approved by BMW QA/QC by: project no.: B19-2339 drawing no.: C_GEN01_B192339


> > SHEET

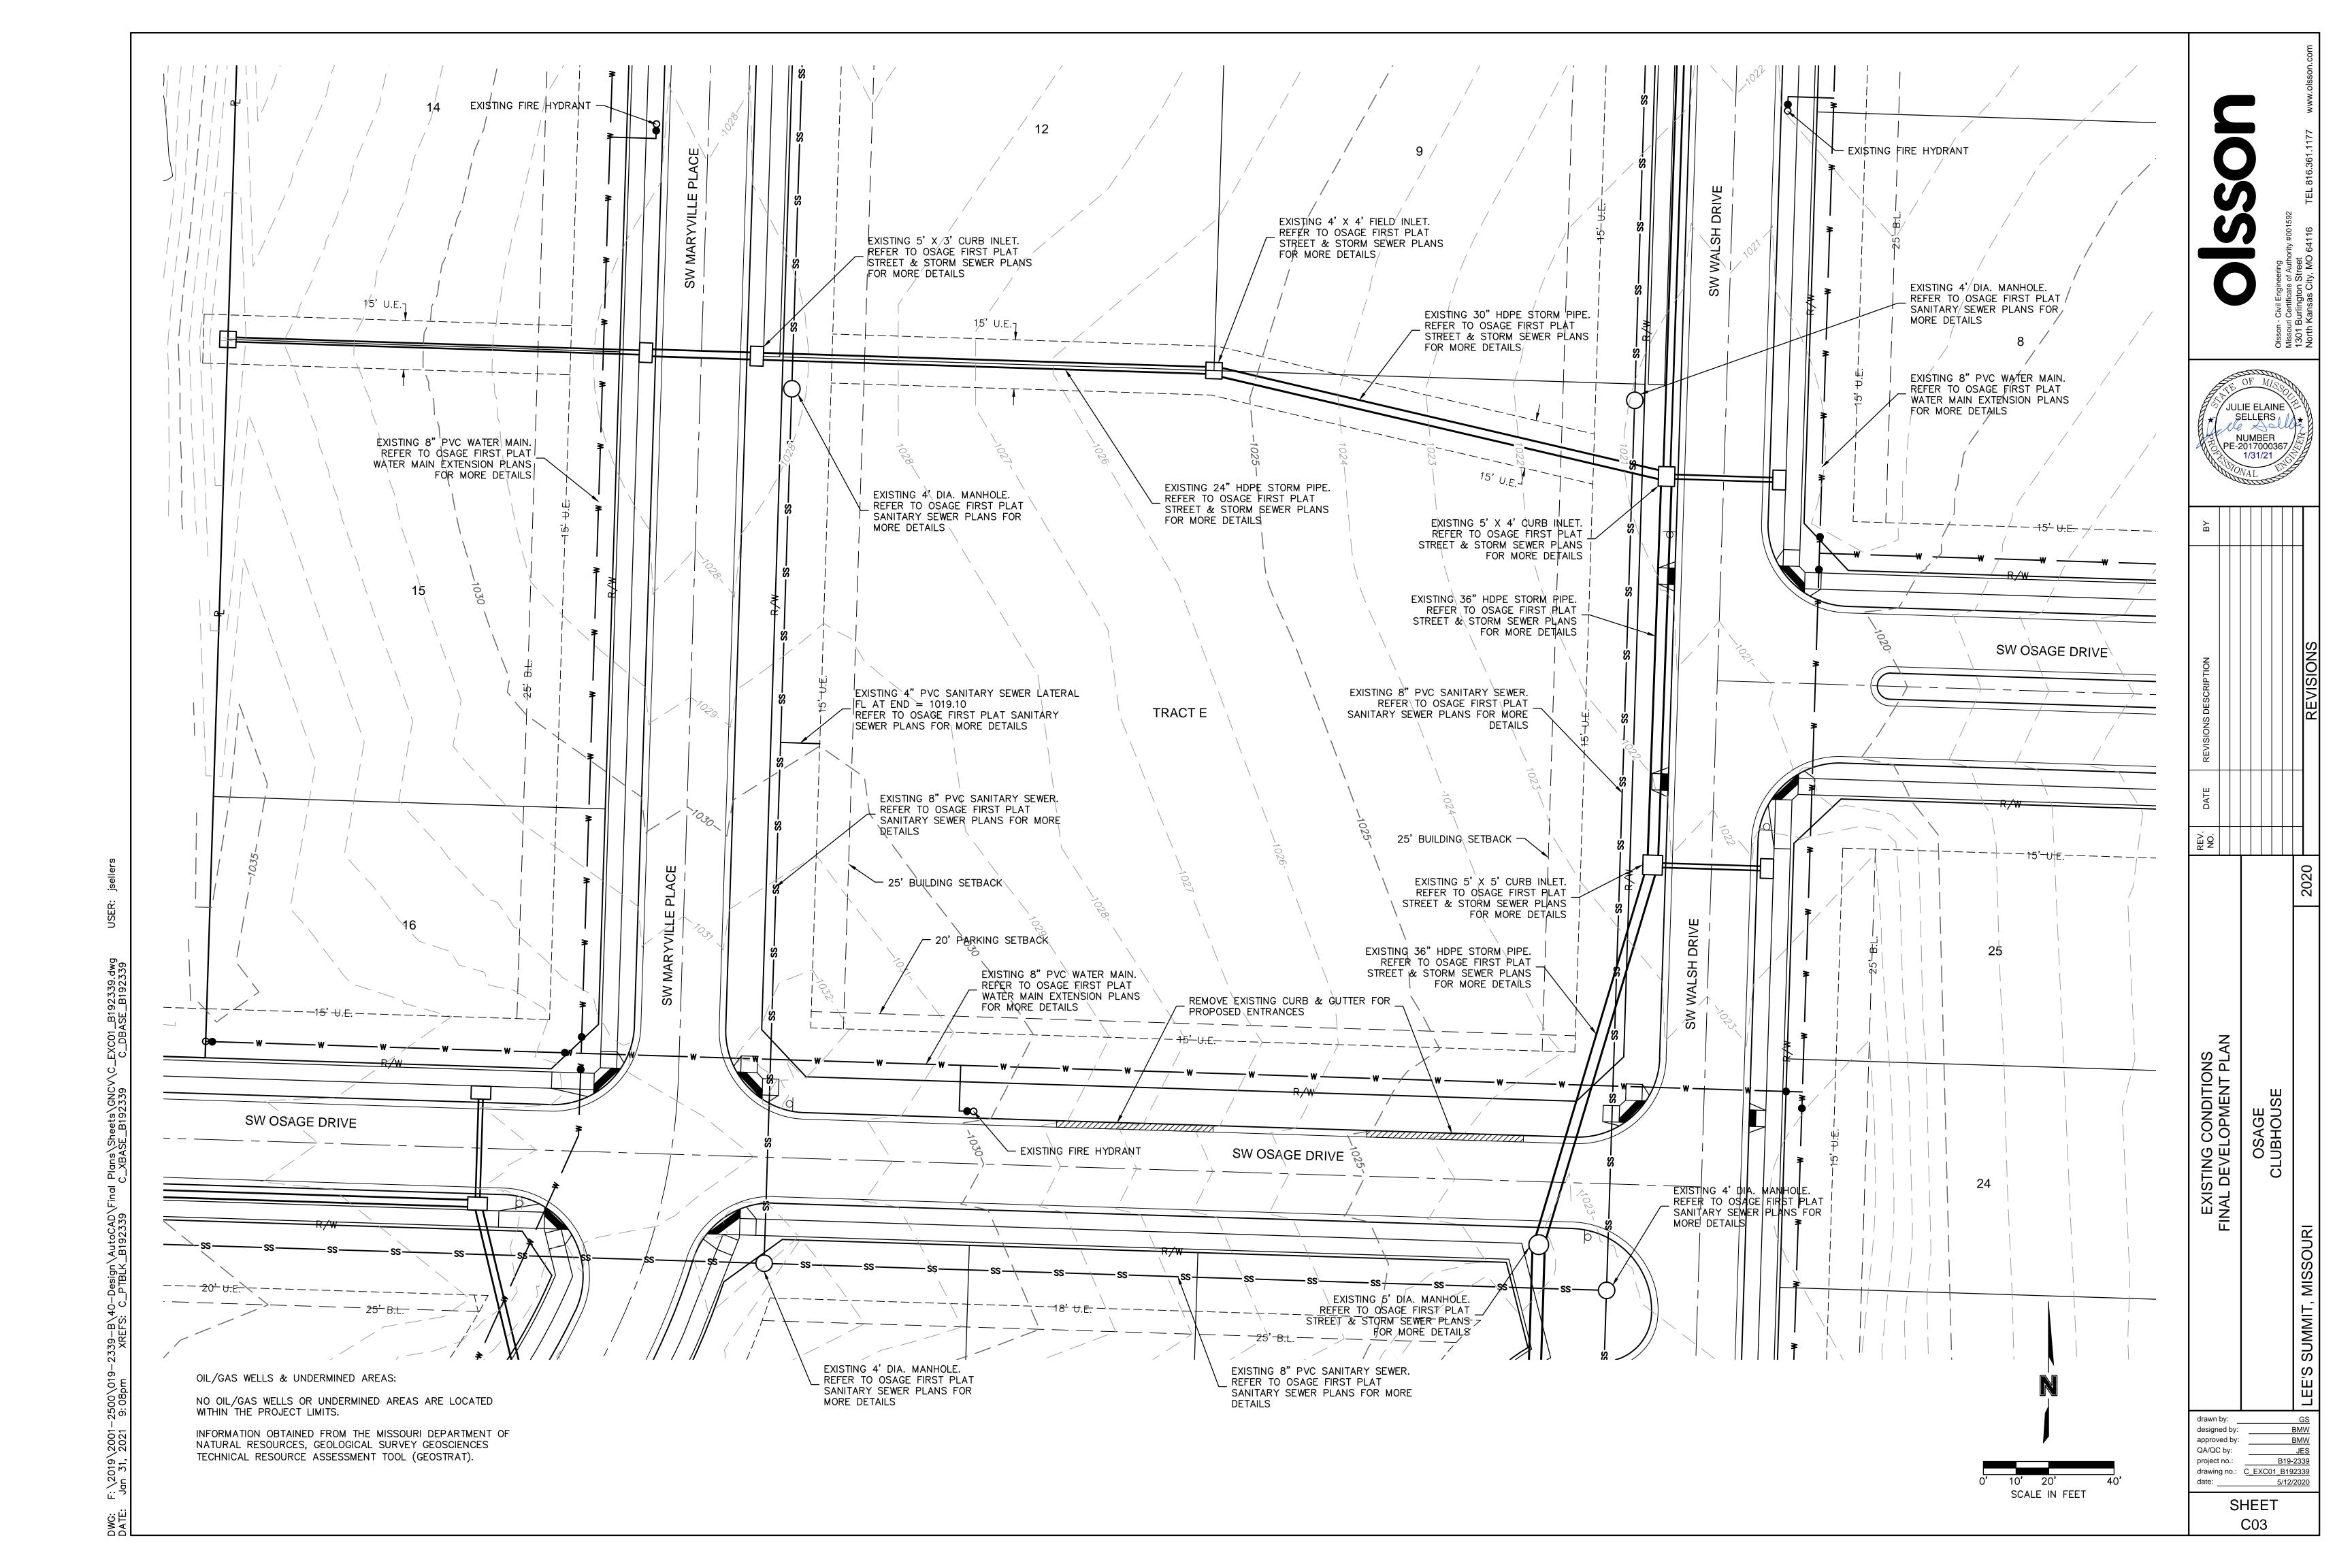


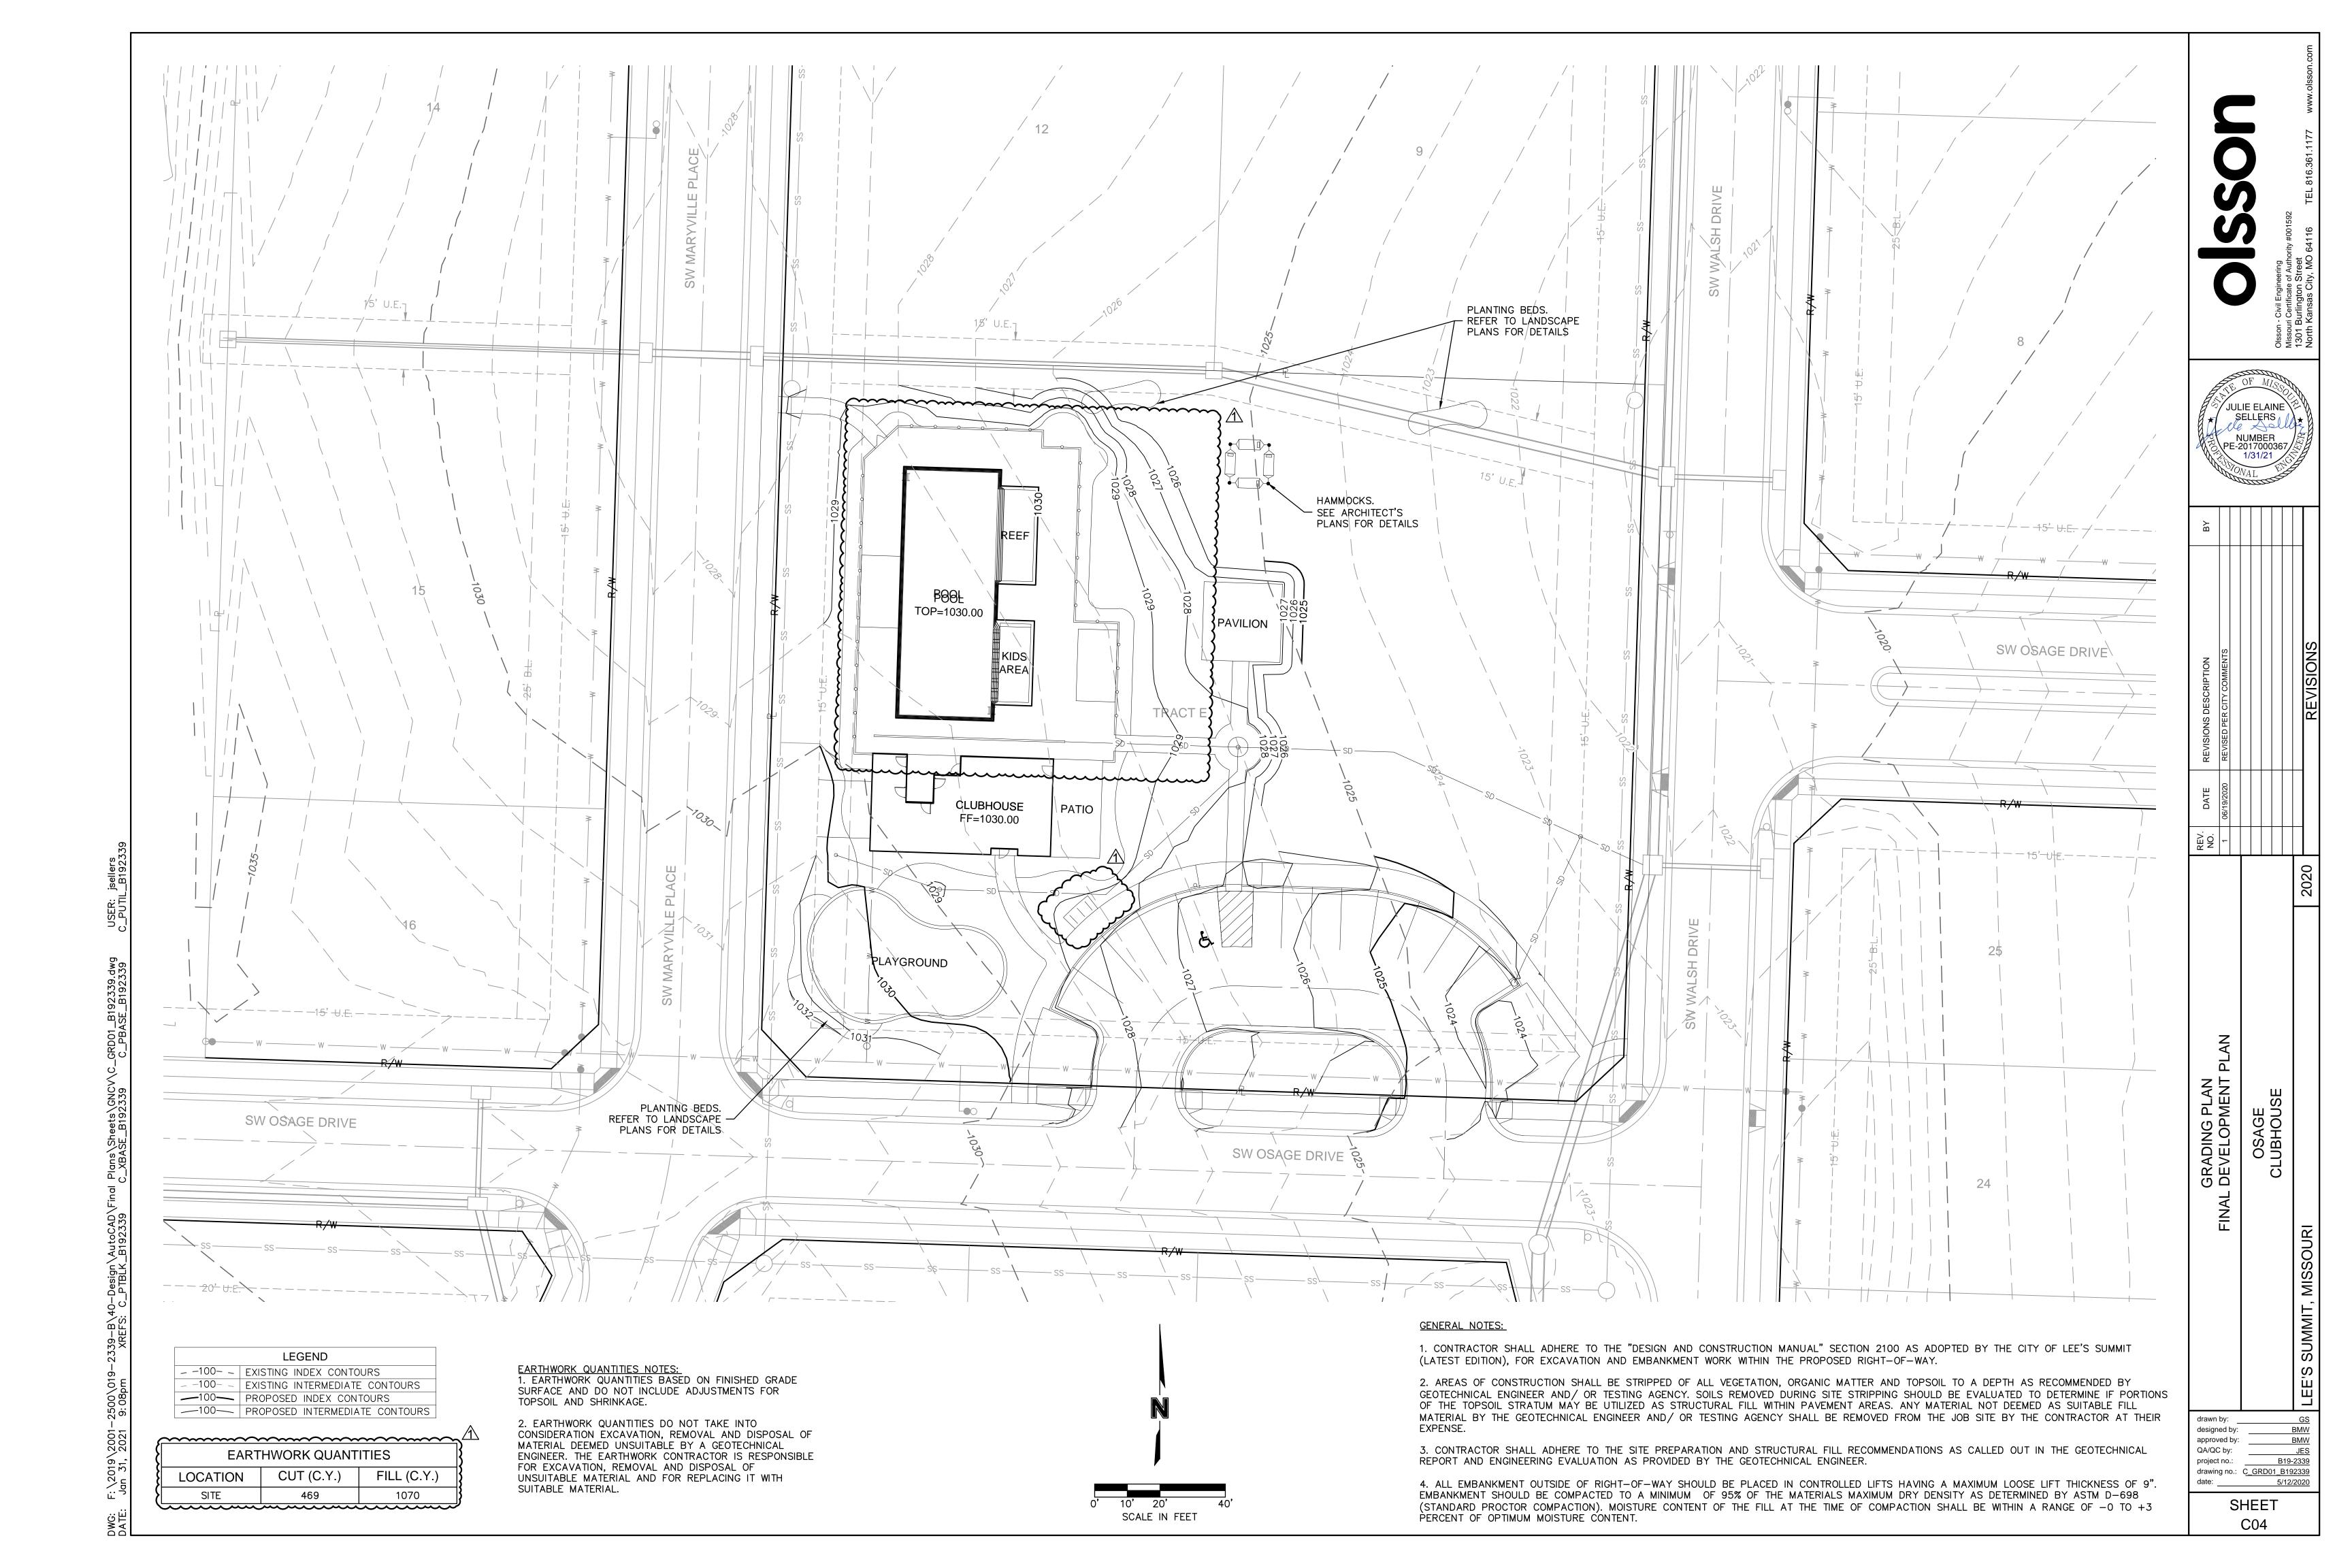


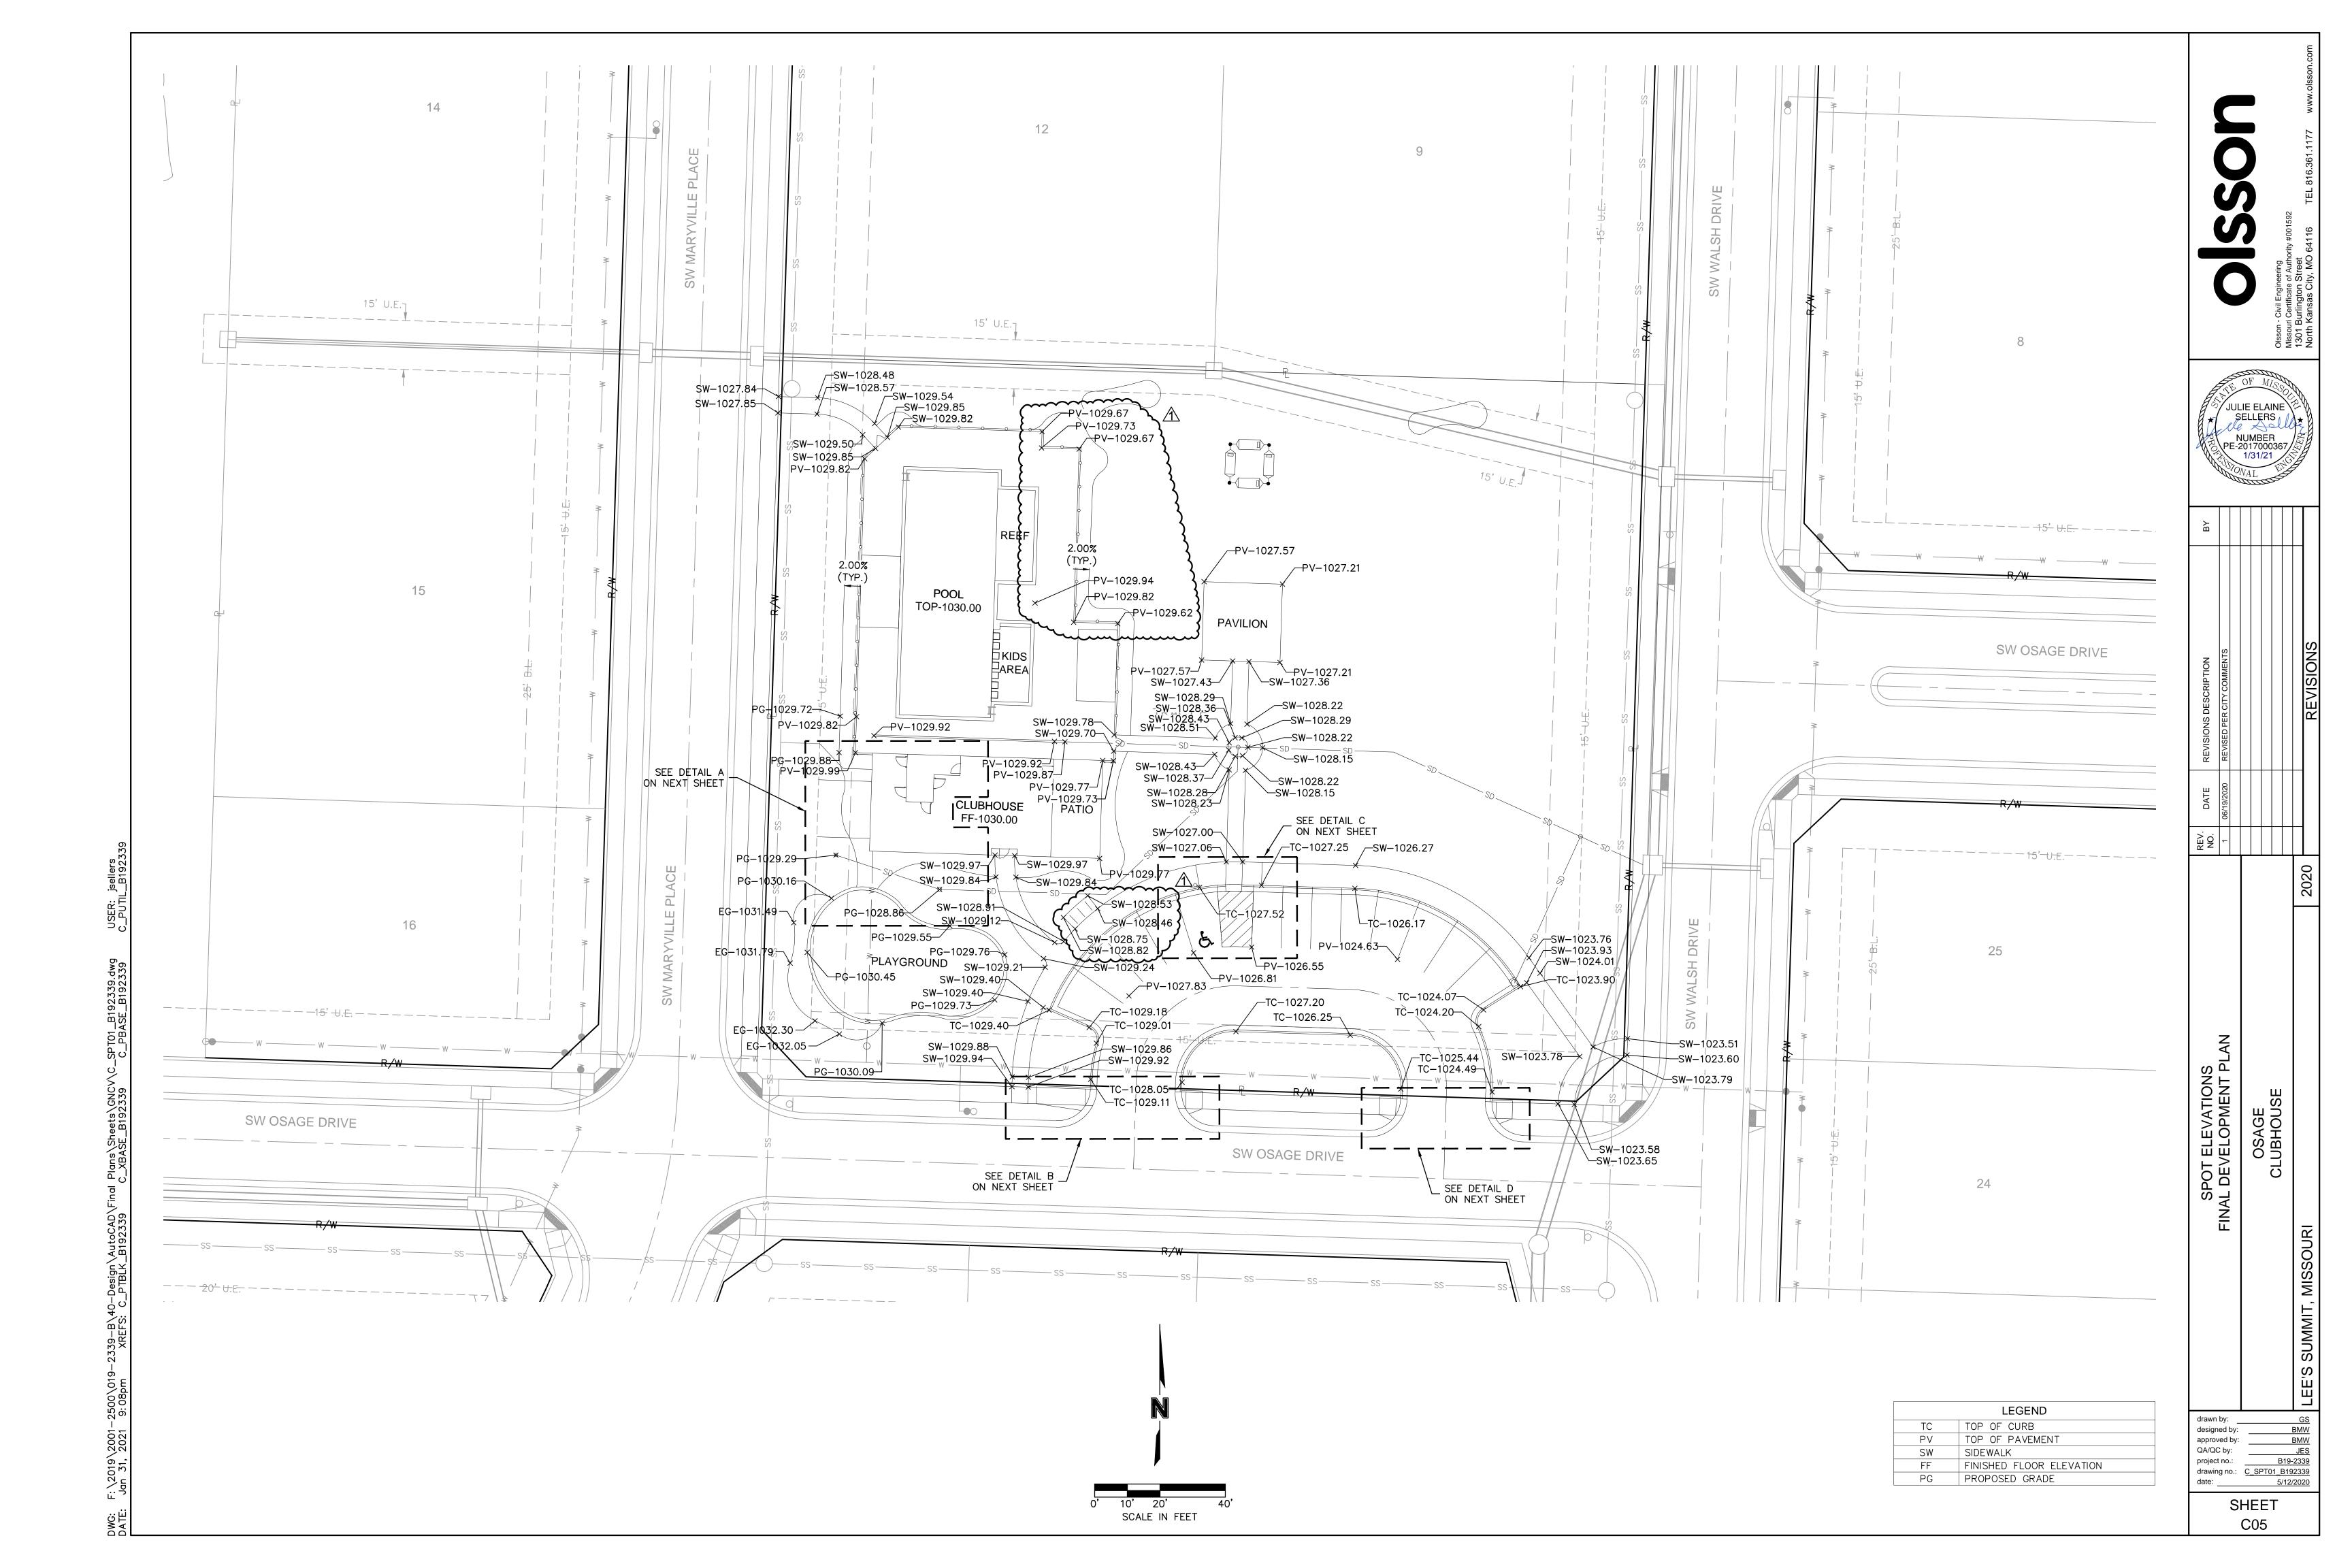


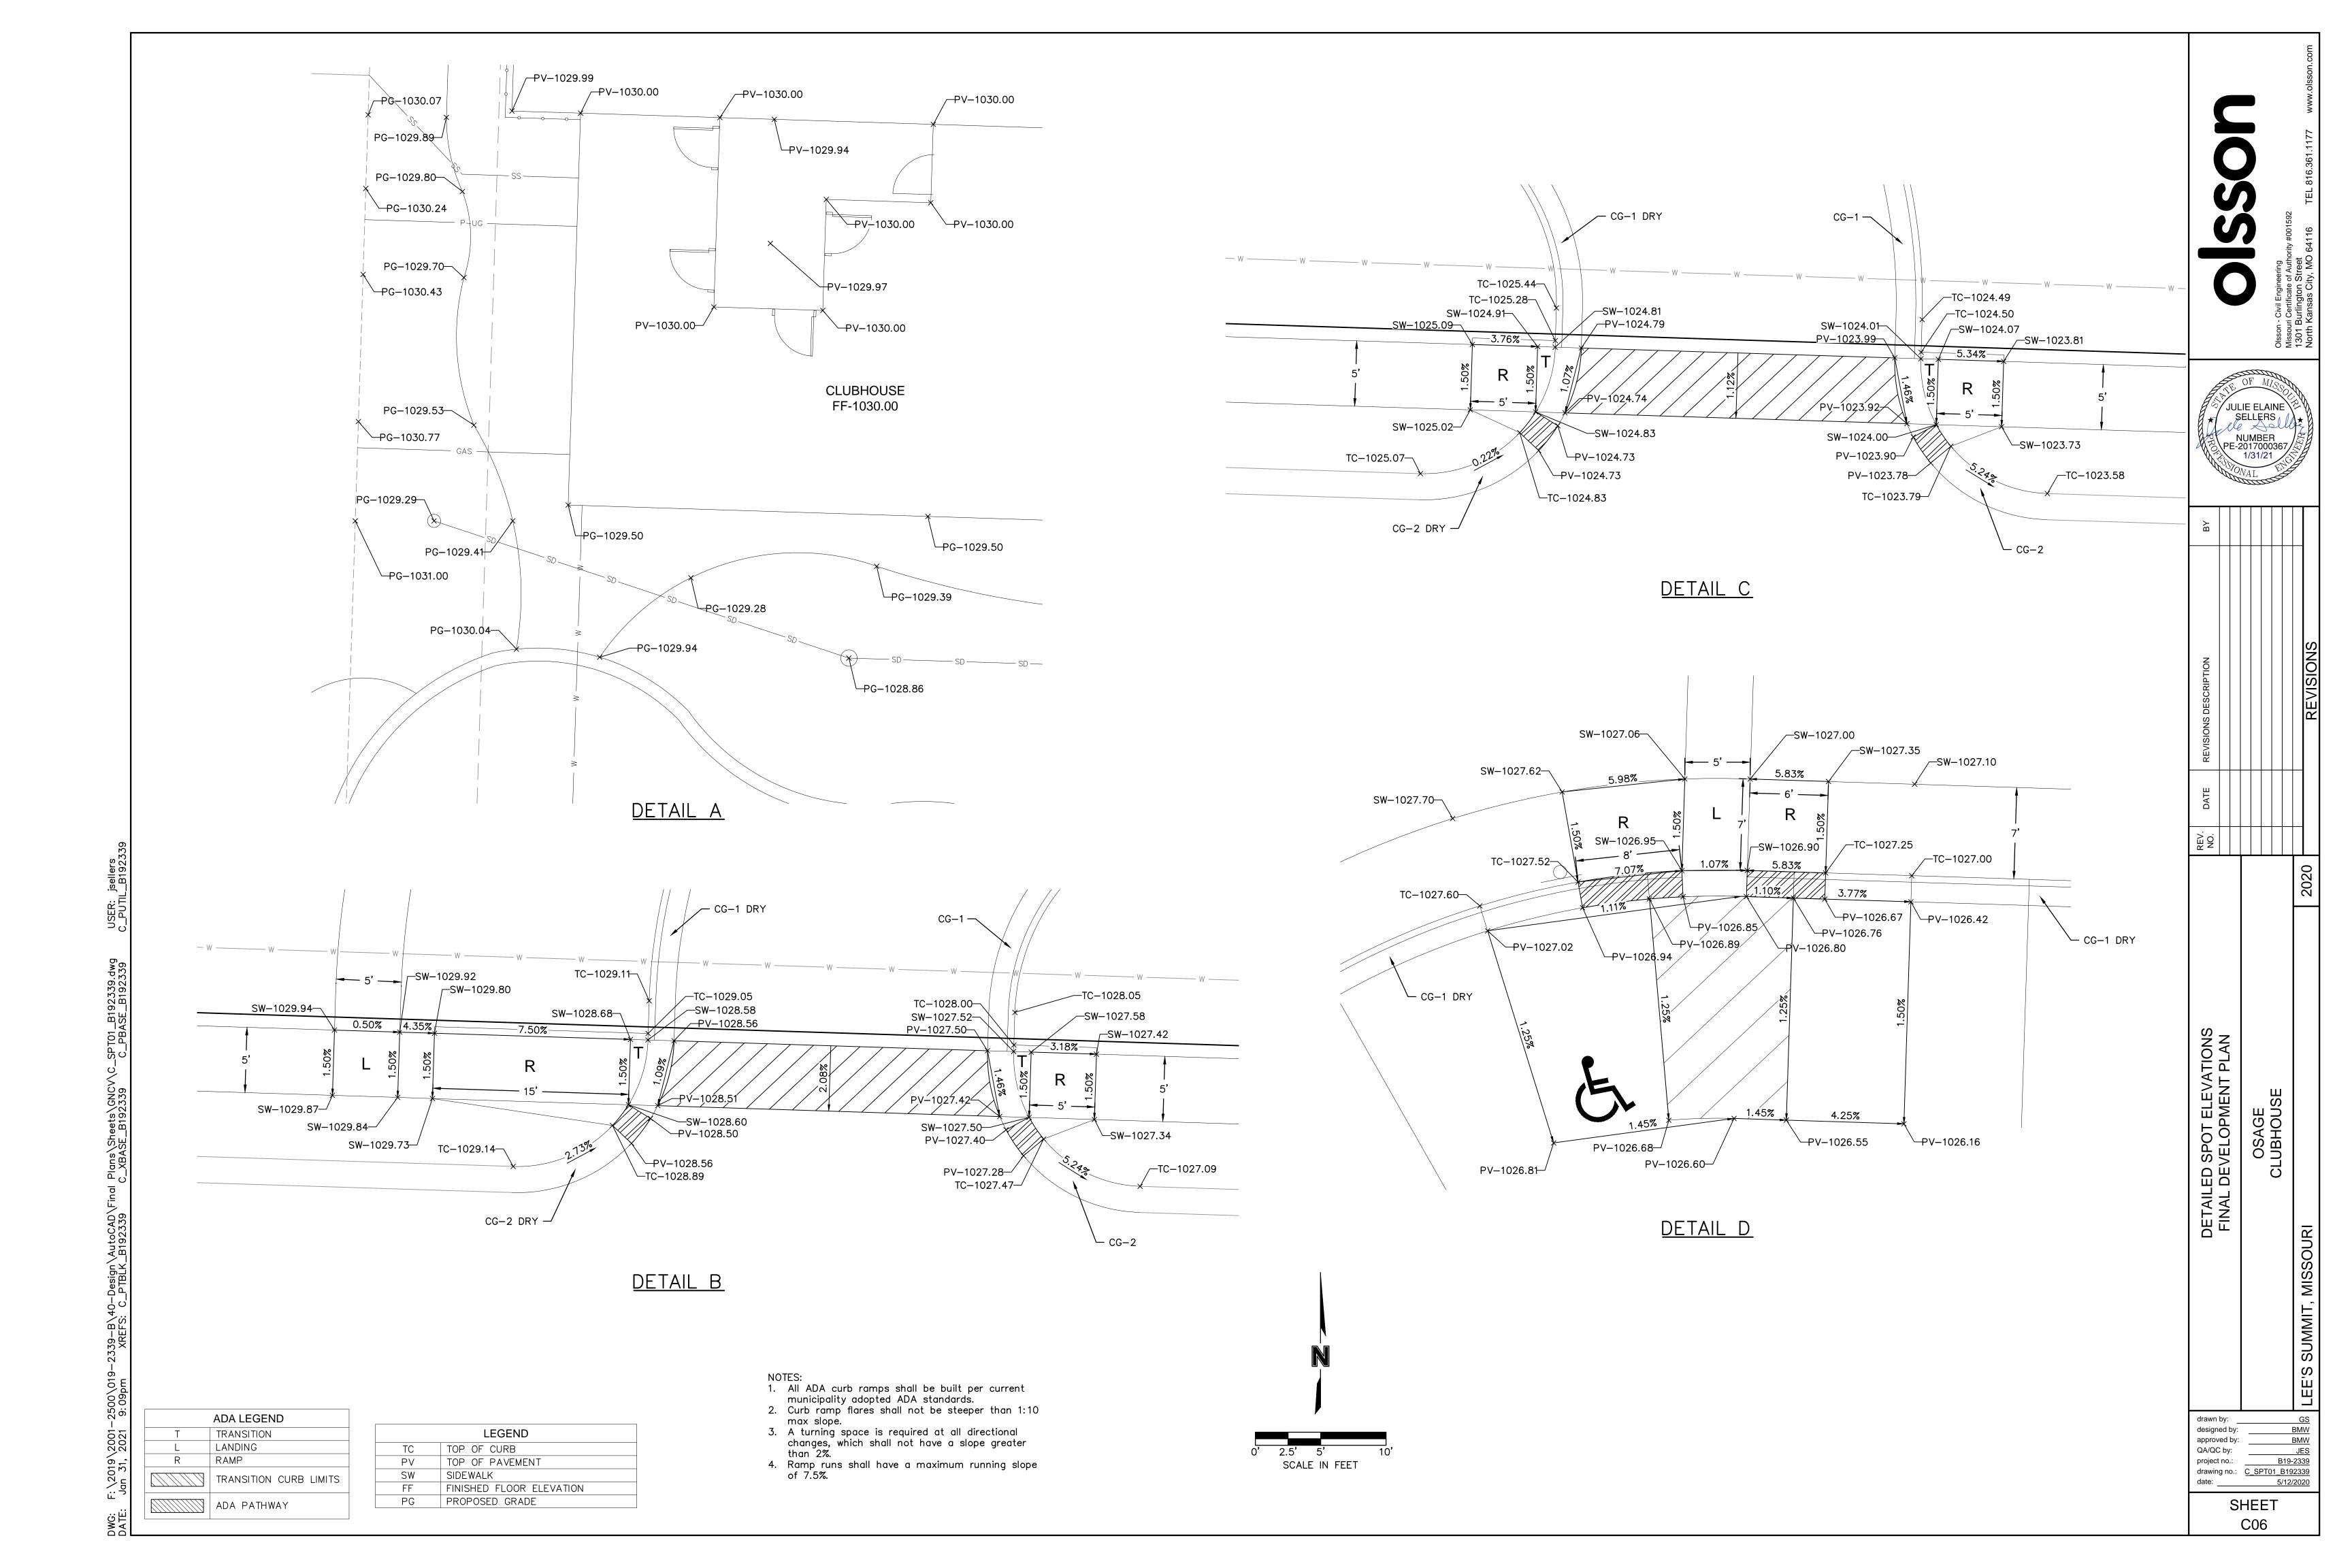

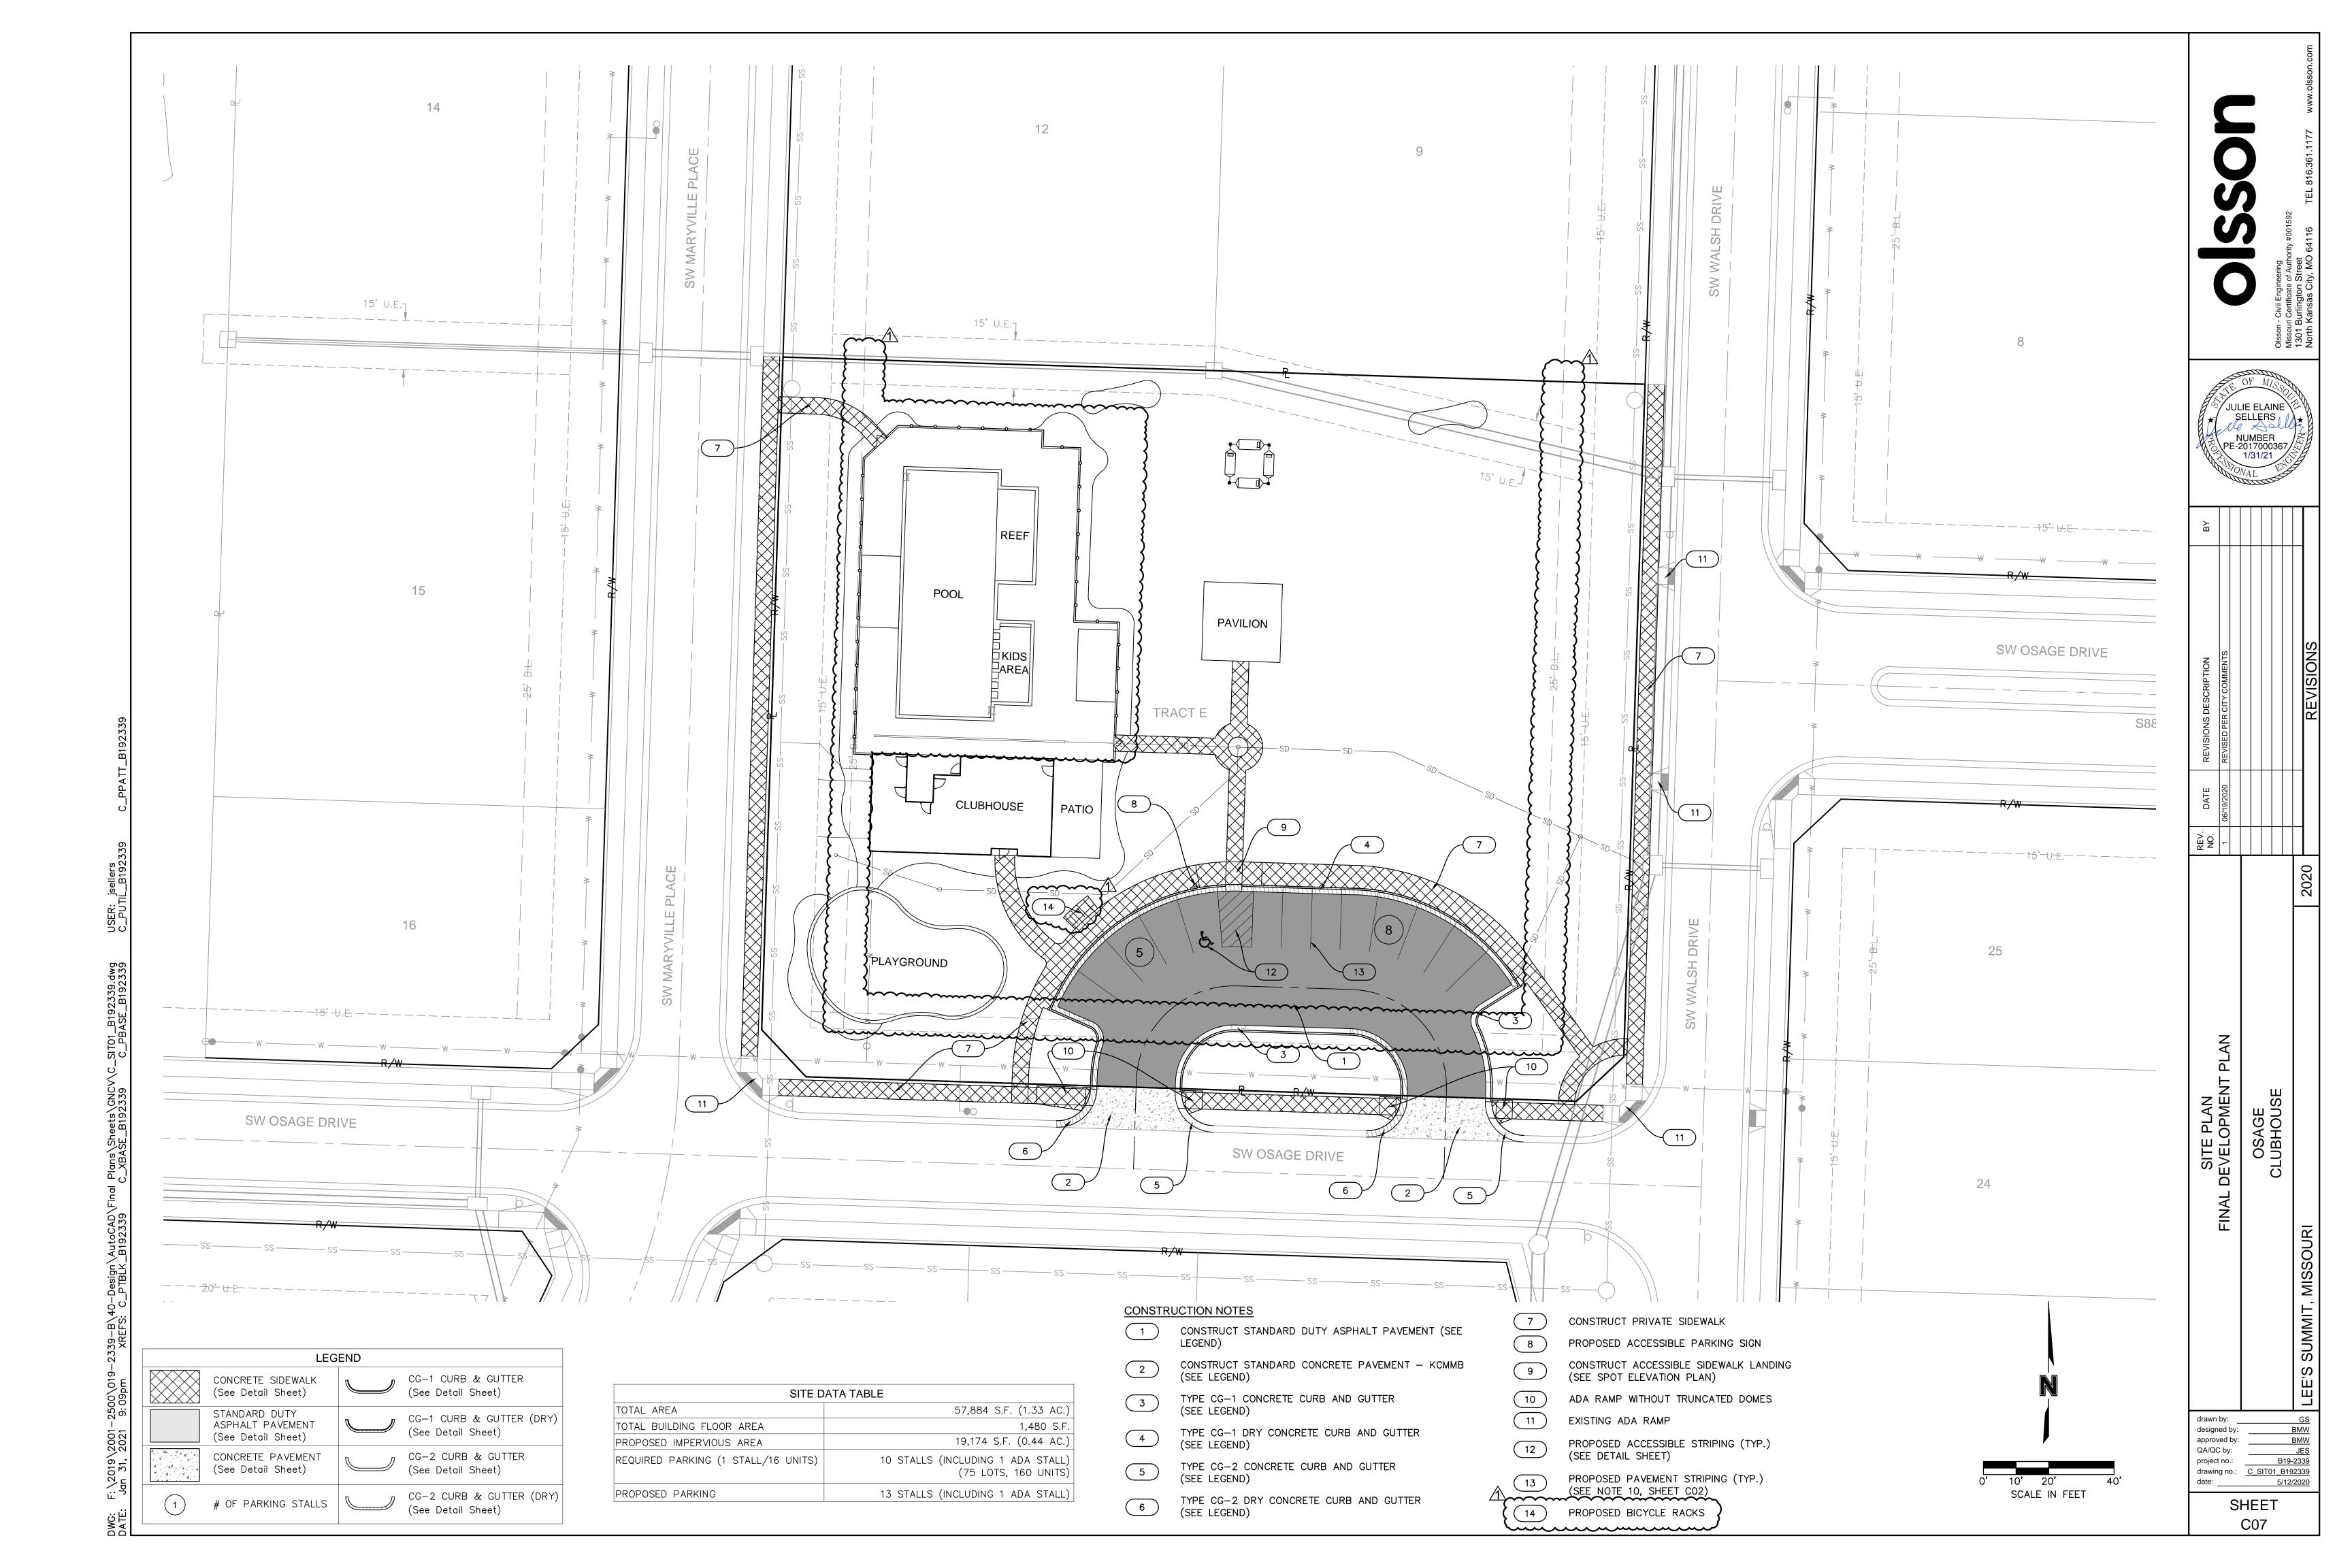


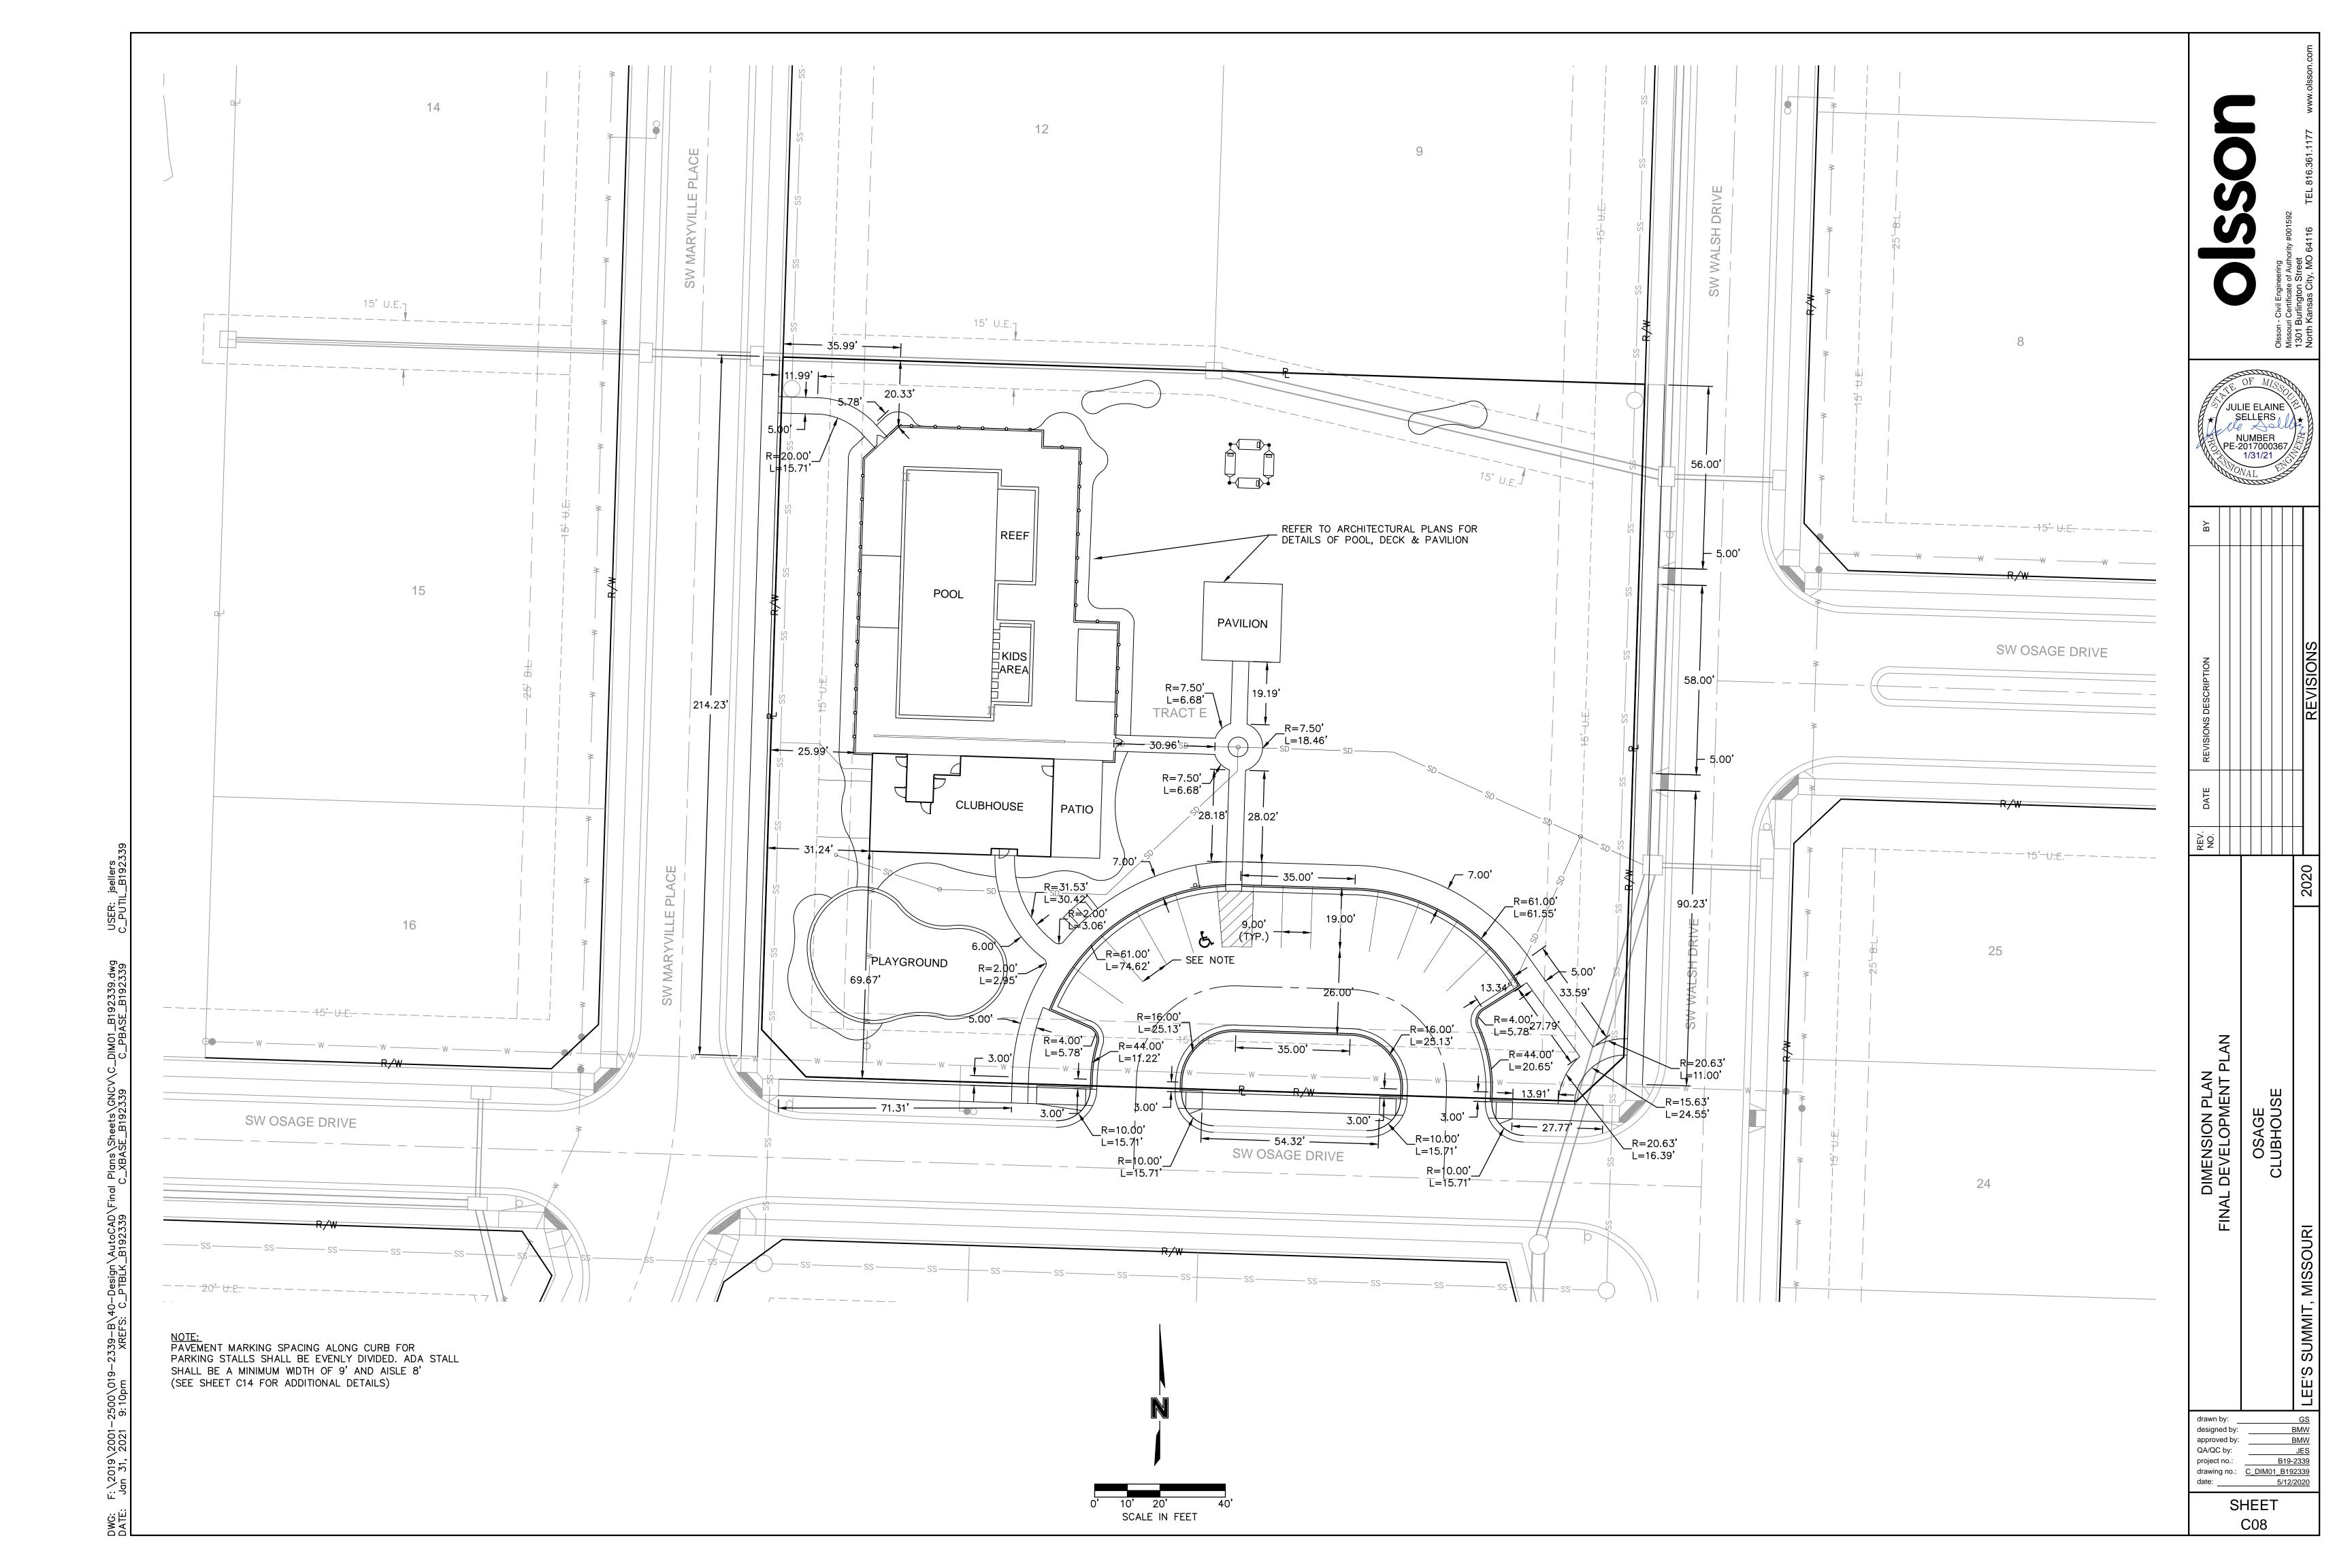

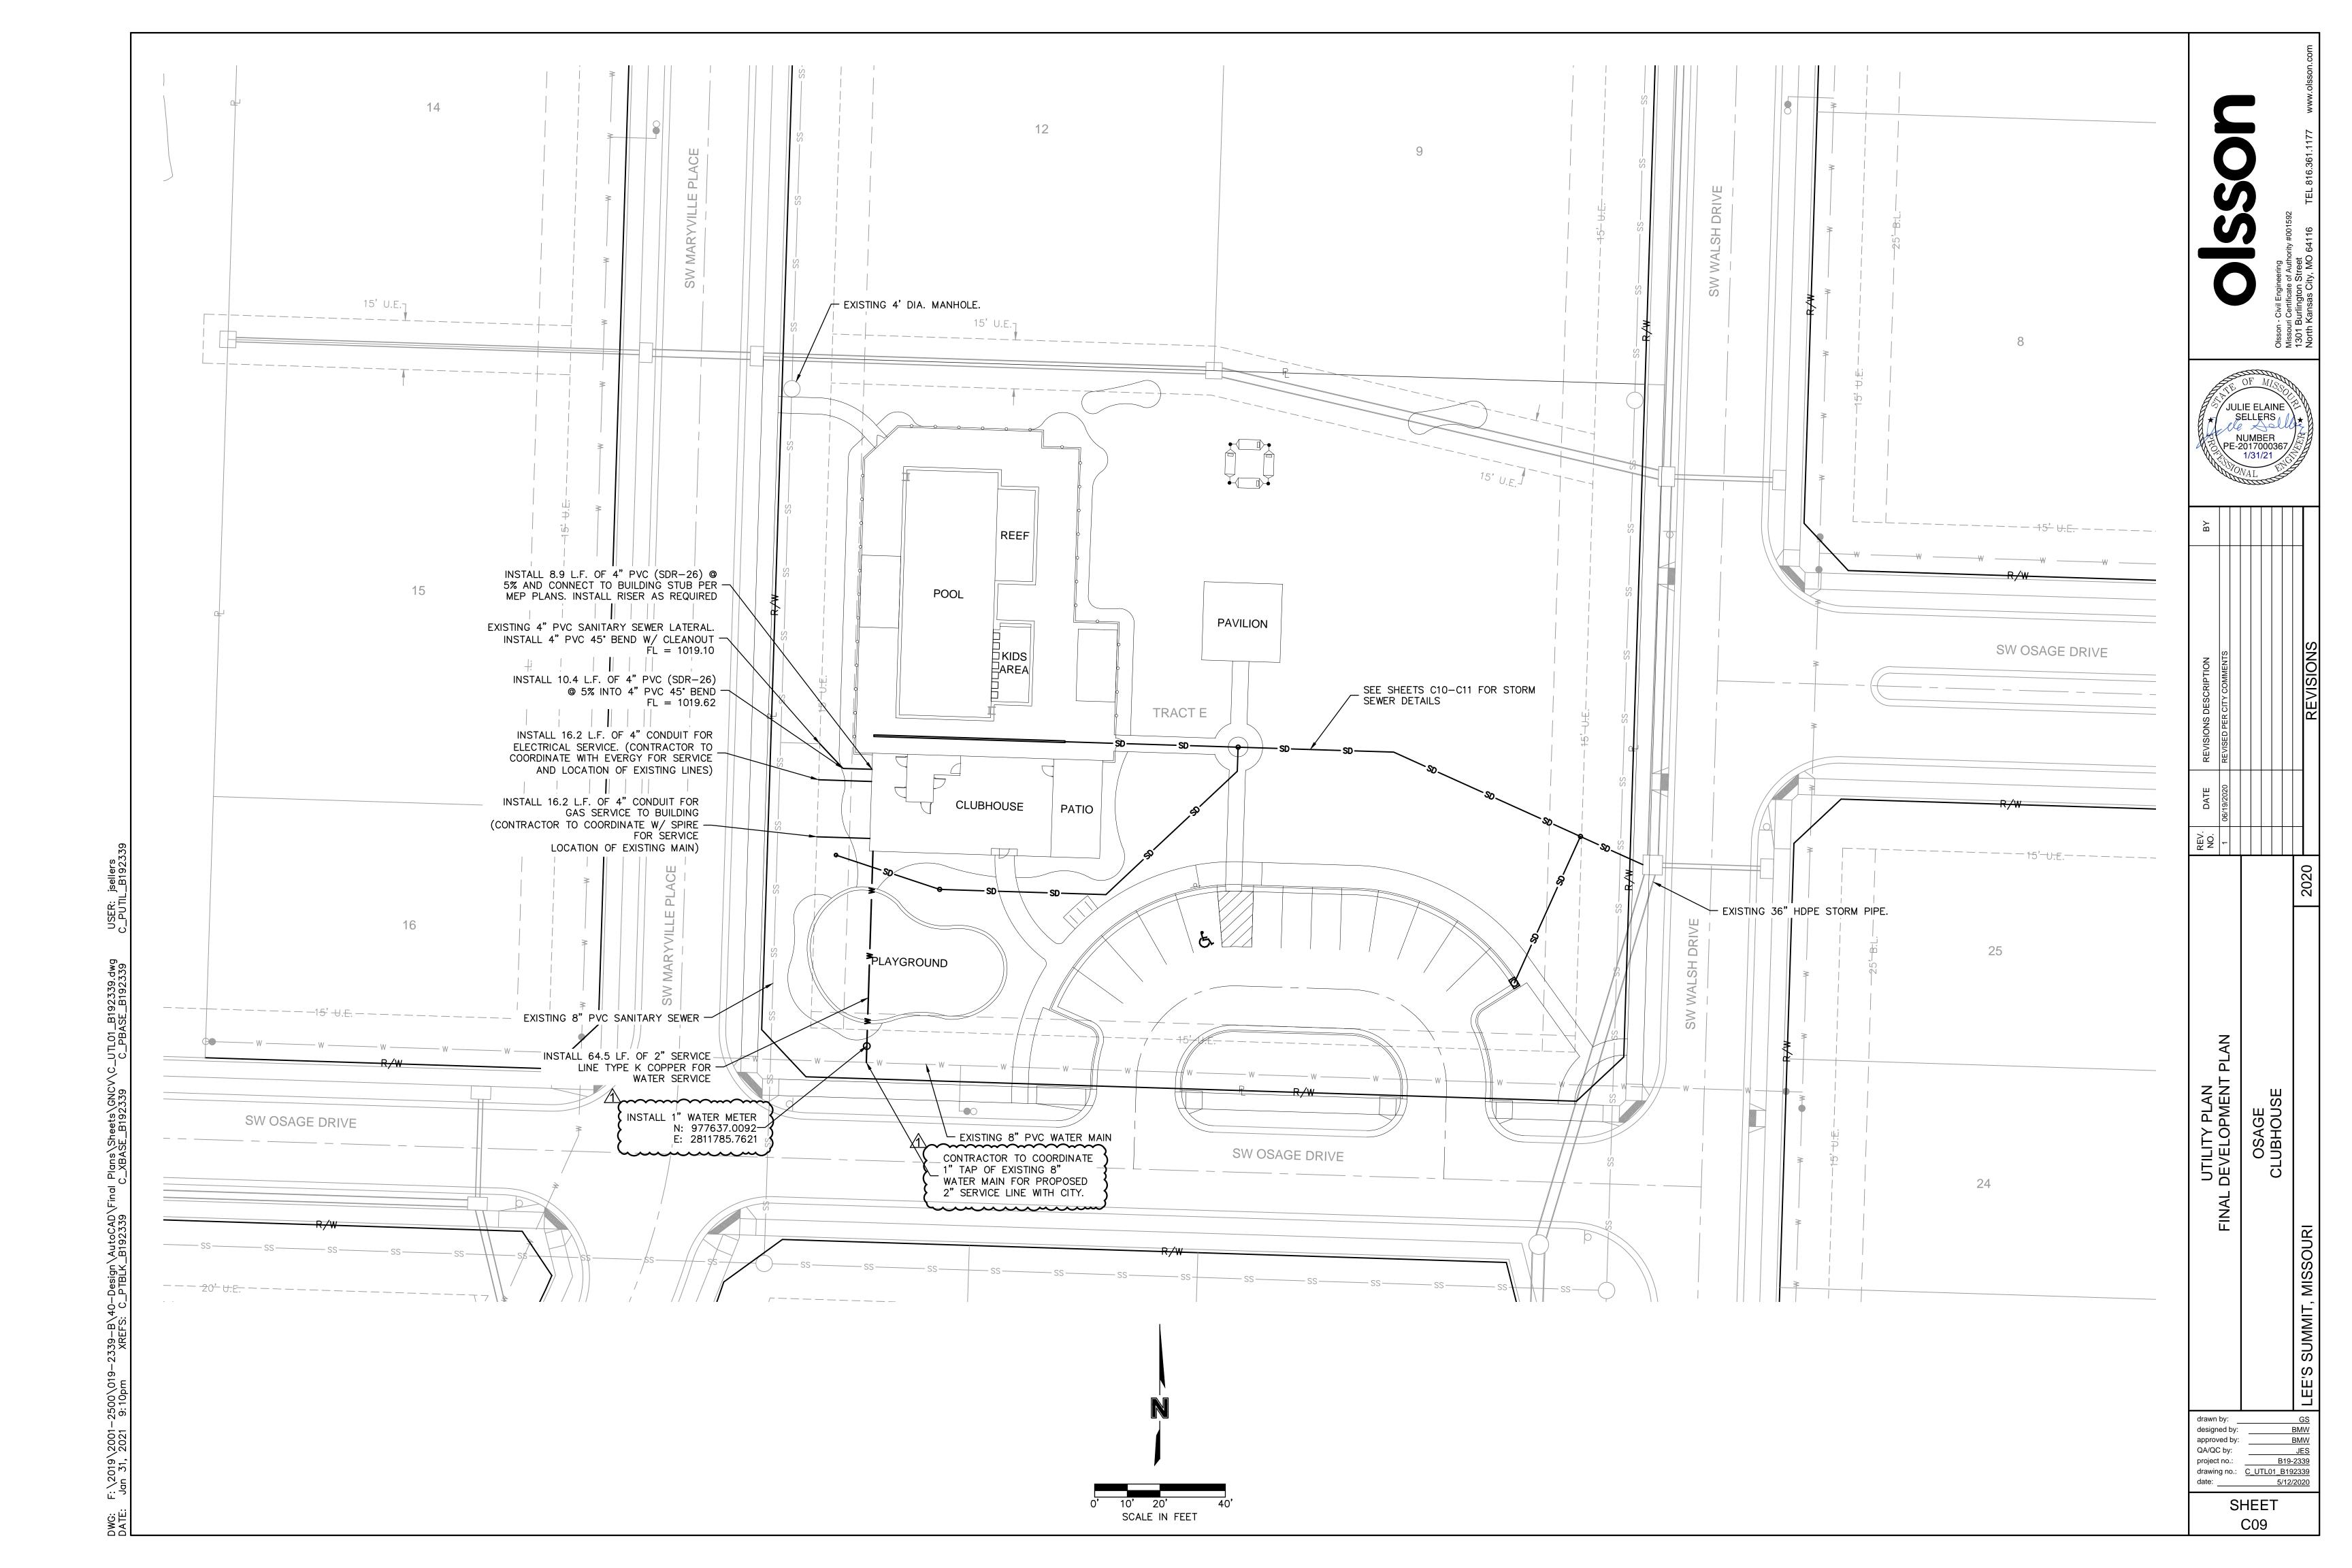

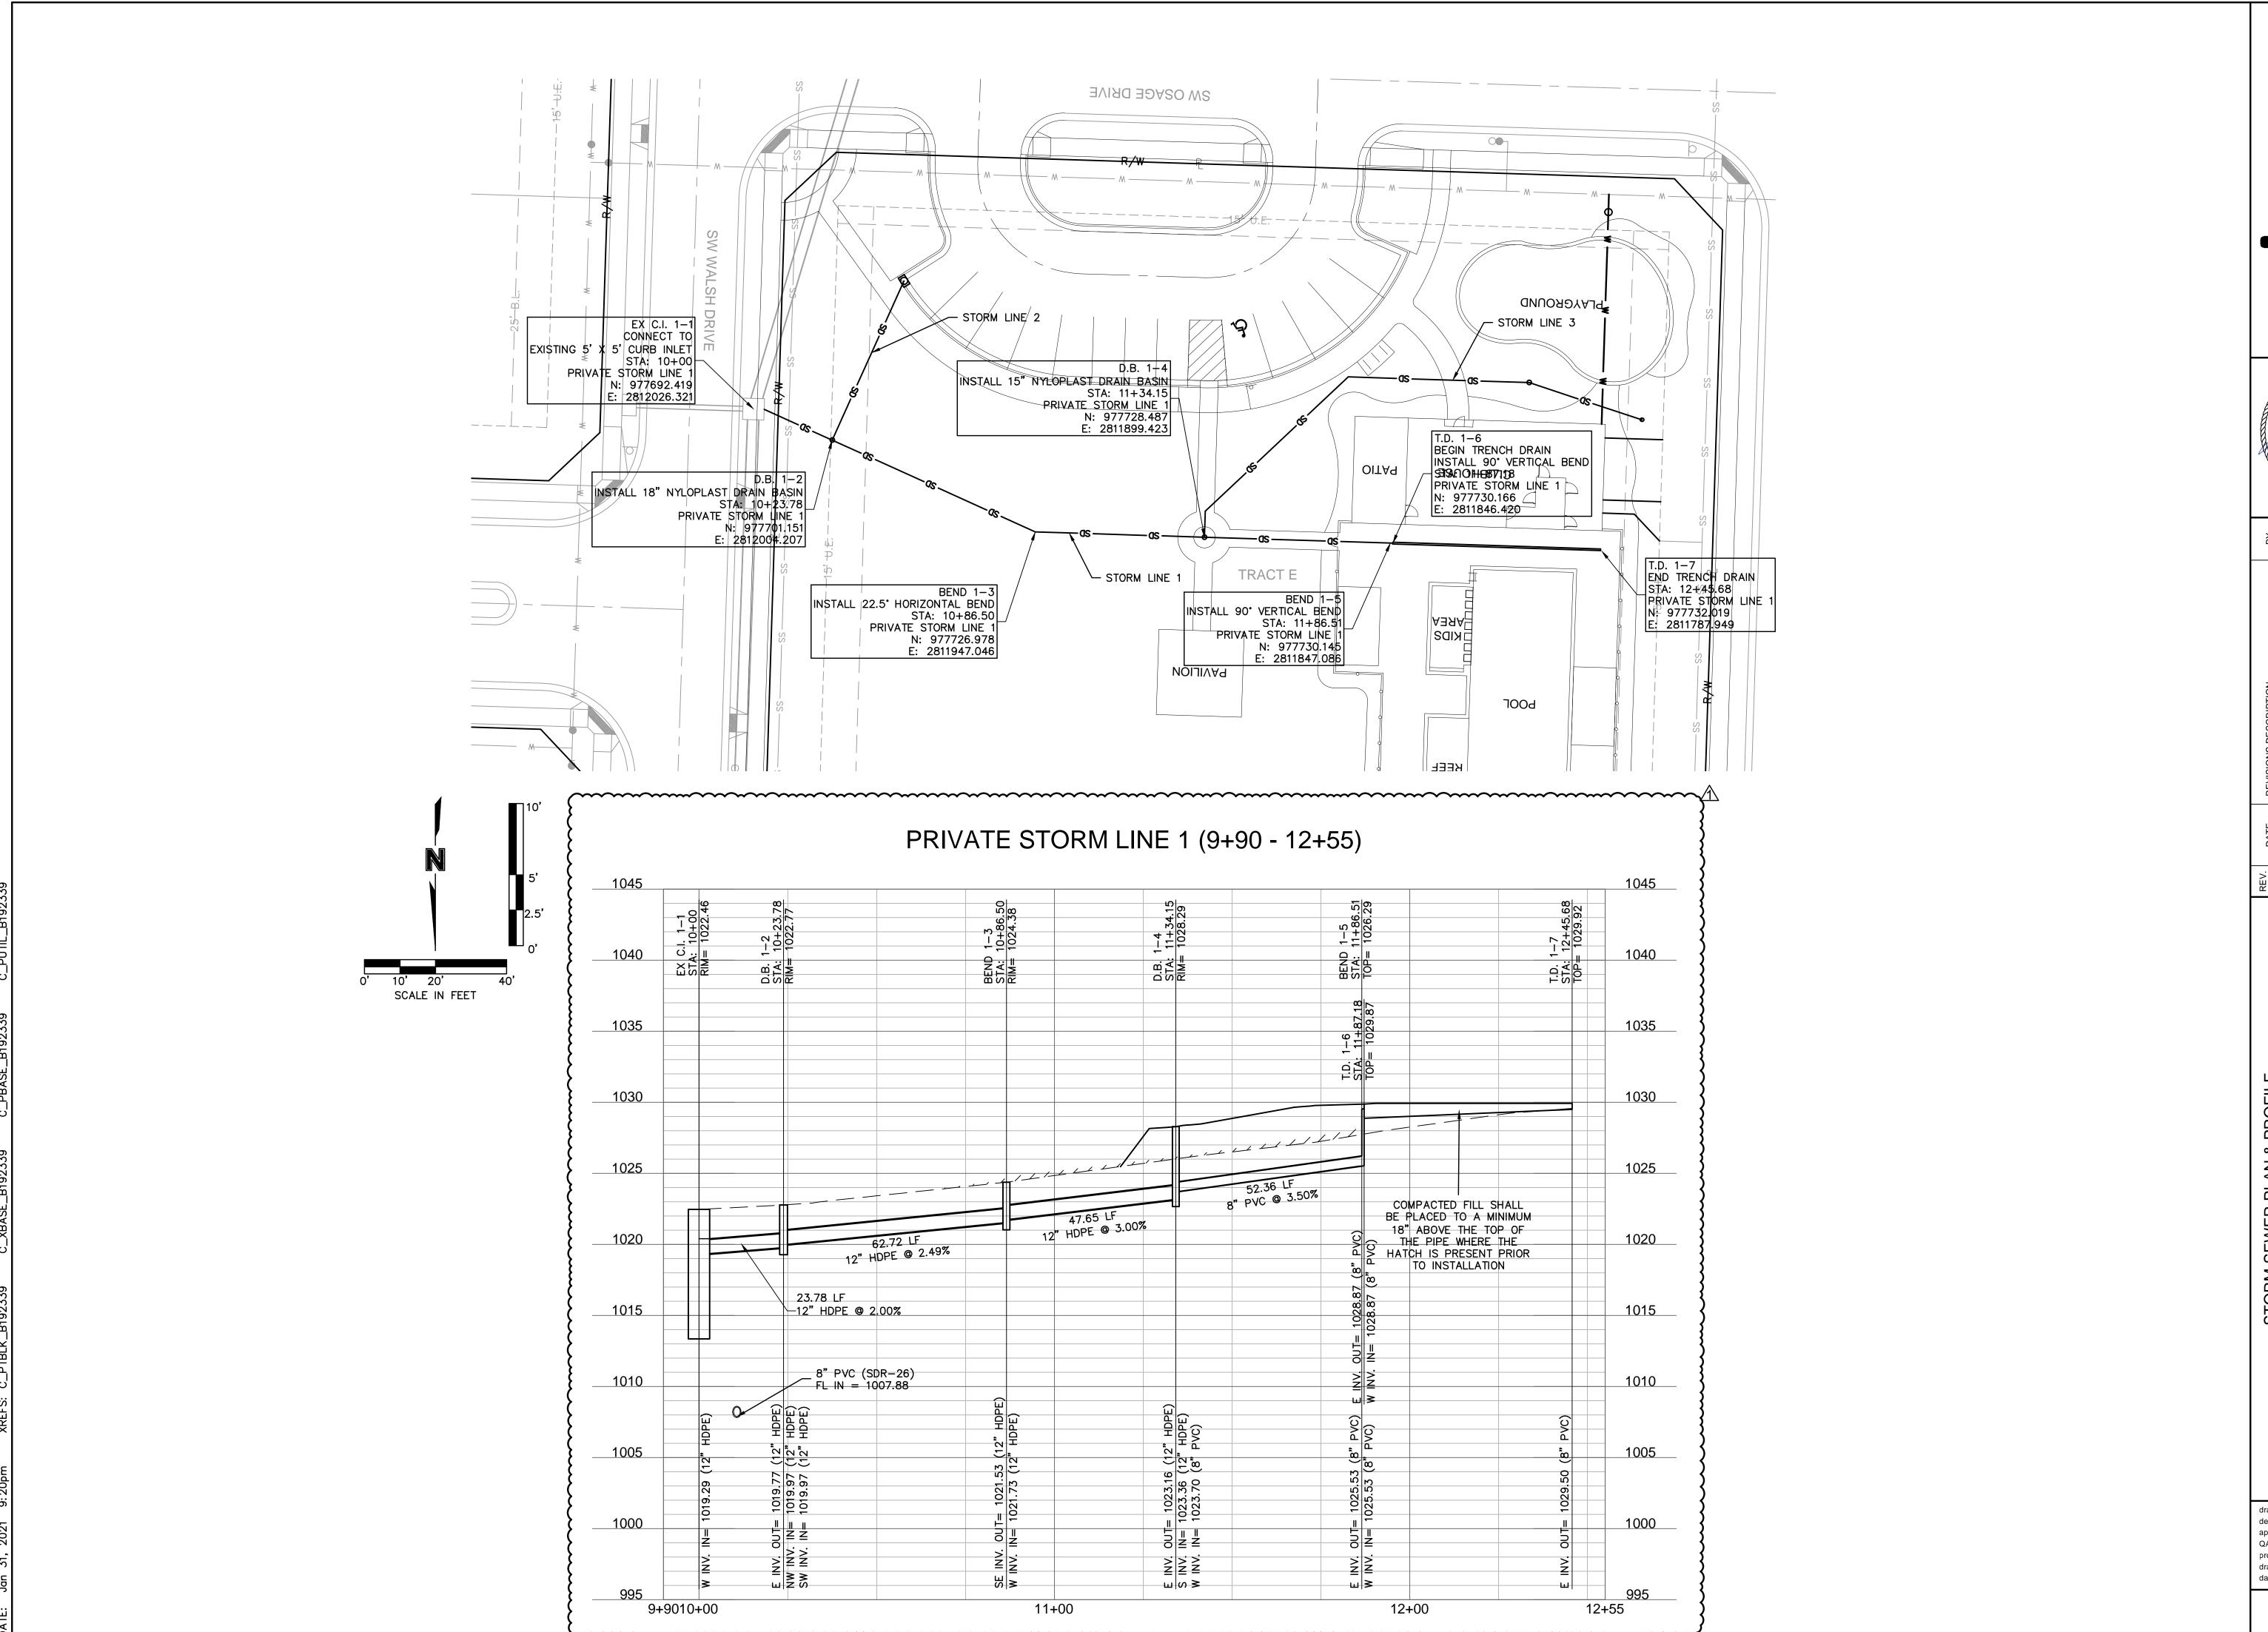


n - Civil Engineering uni Certificate of Authority #001592

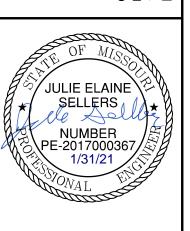



STORM SEWER PLAN & PROFILE FINAL DEVELOPMENT PLAN OSAGE CLUBHOUSE


drawn by: GS
designed by: BMW
approved by: BMW
QA/QC by: JES
project no.: B19-2339
drawing no.: C_STM01_B192339
date: 5/12/2020


SHEET C10

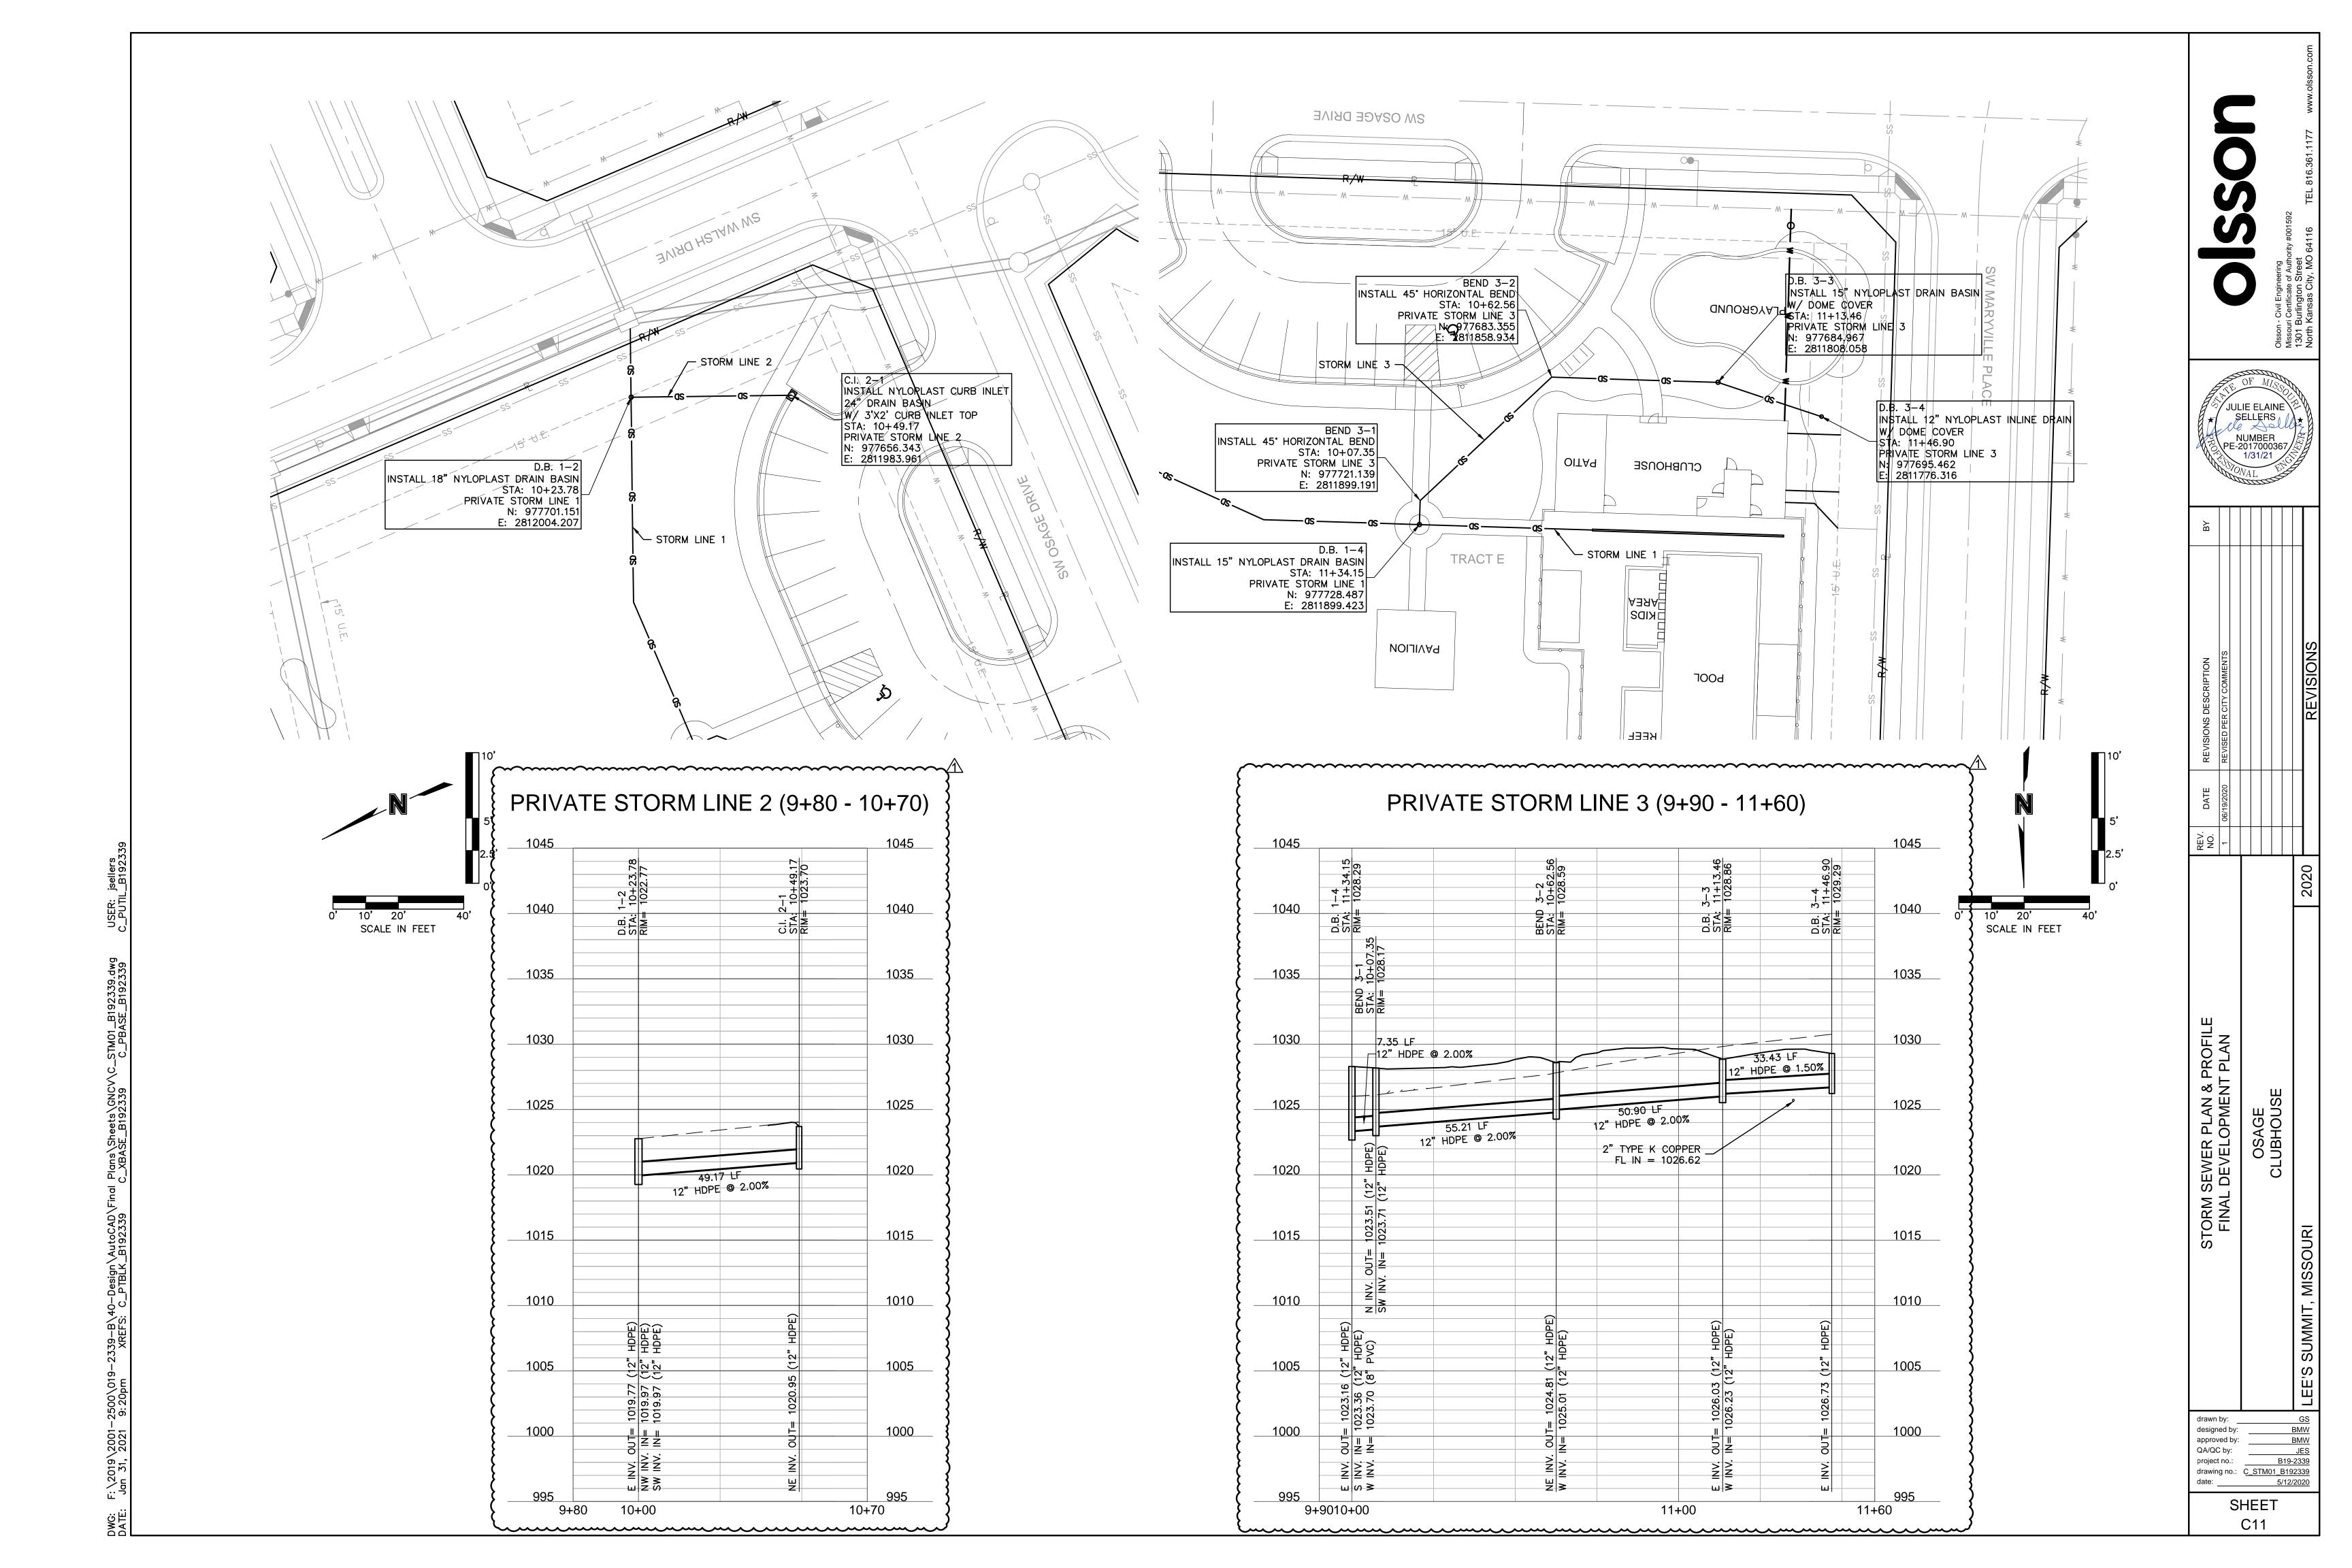


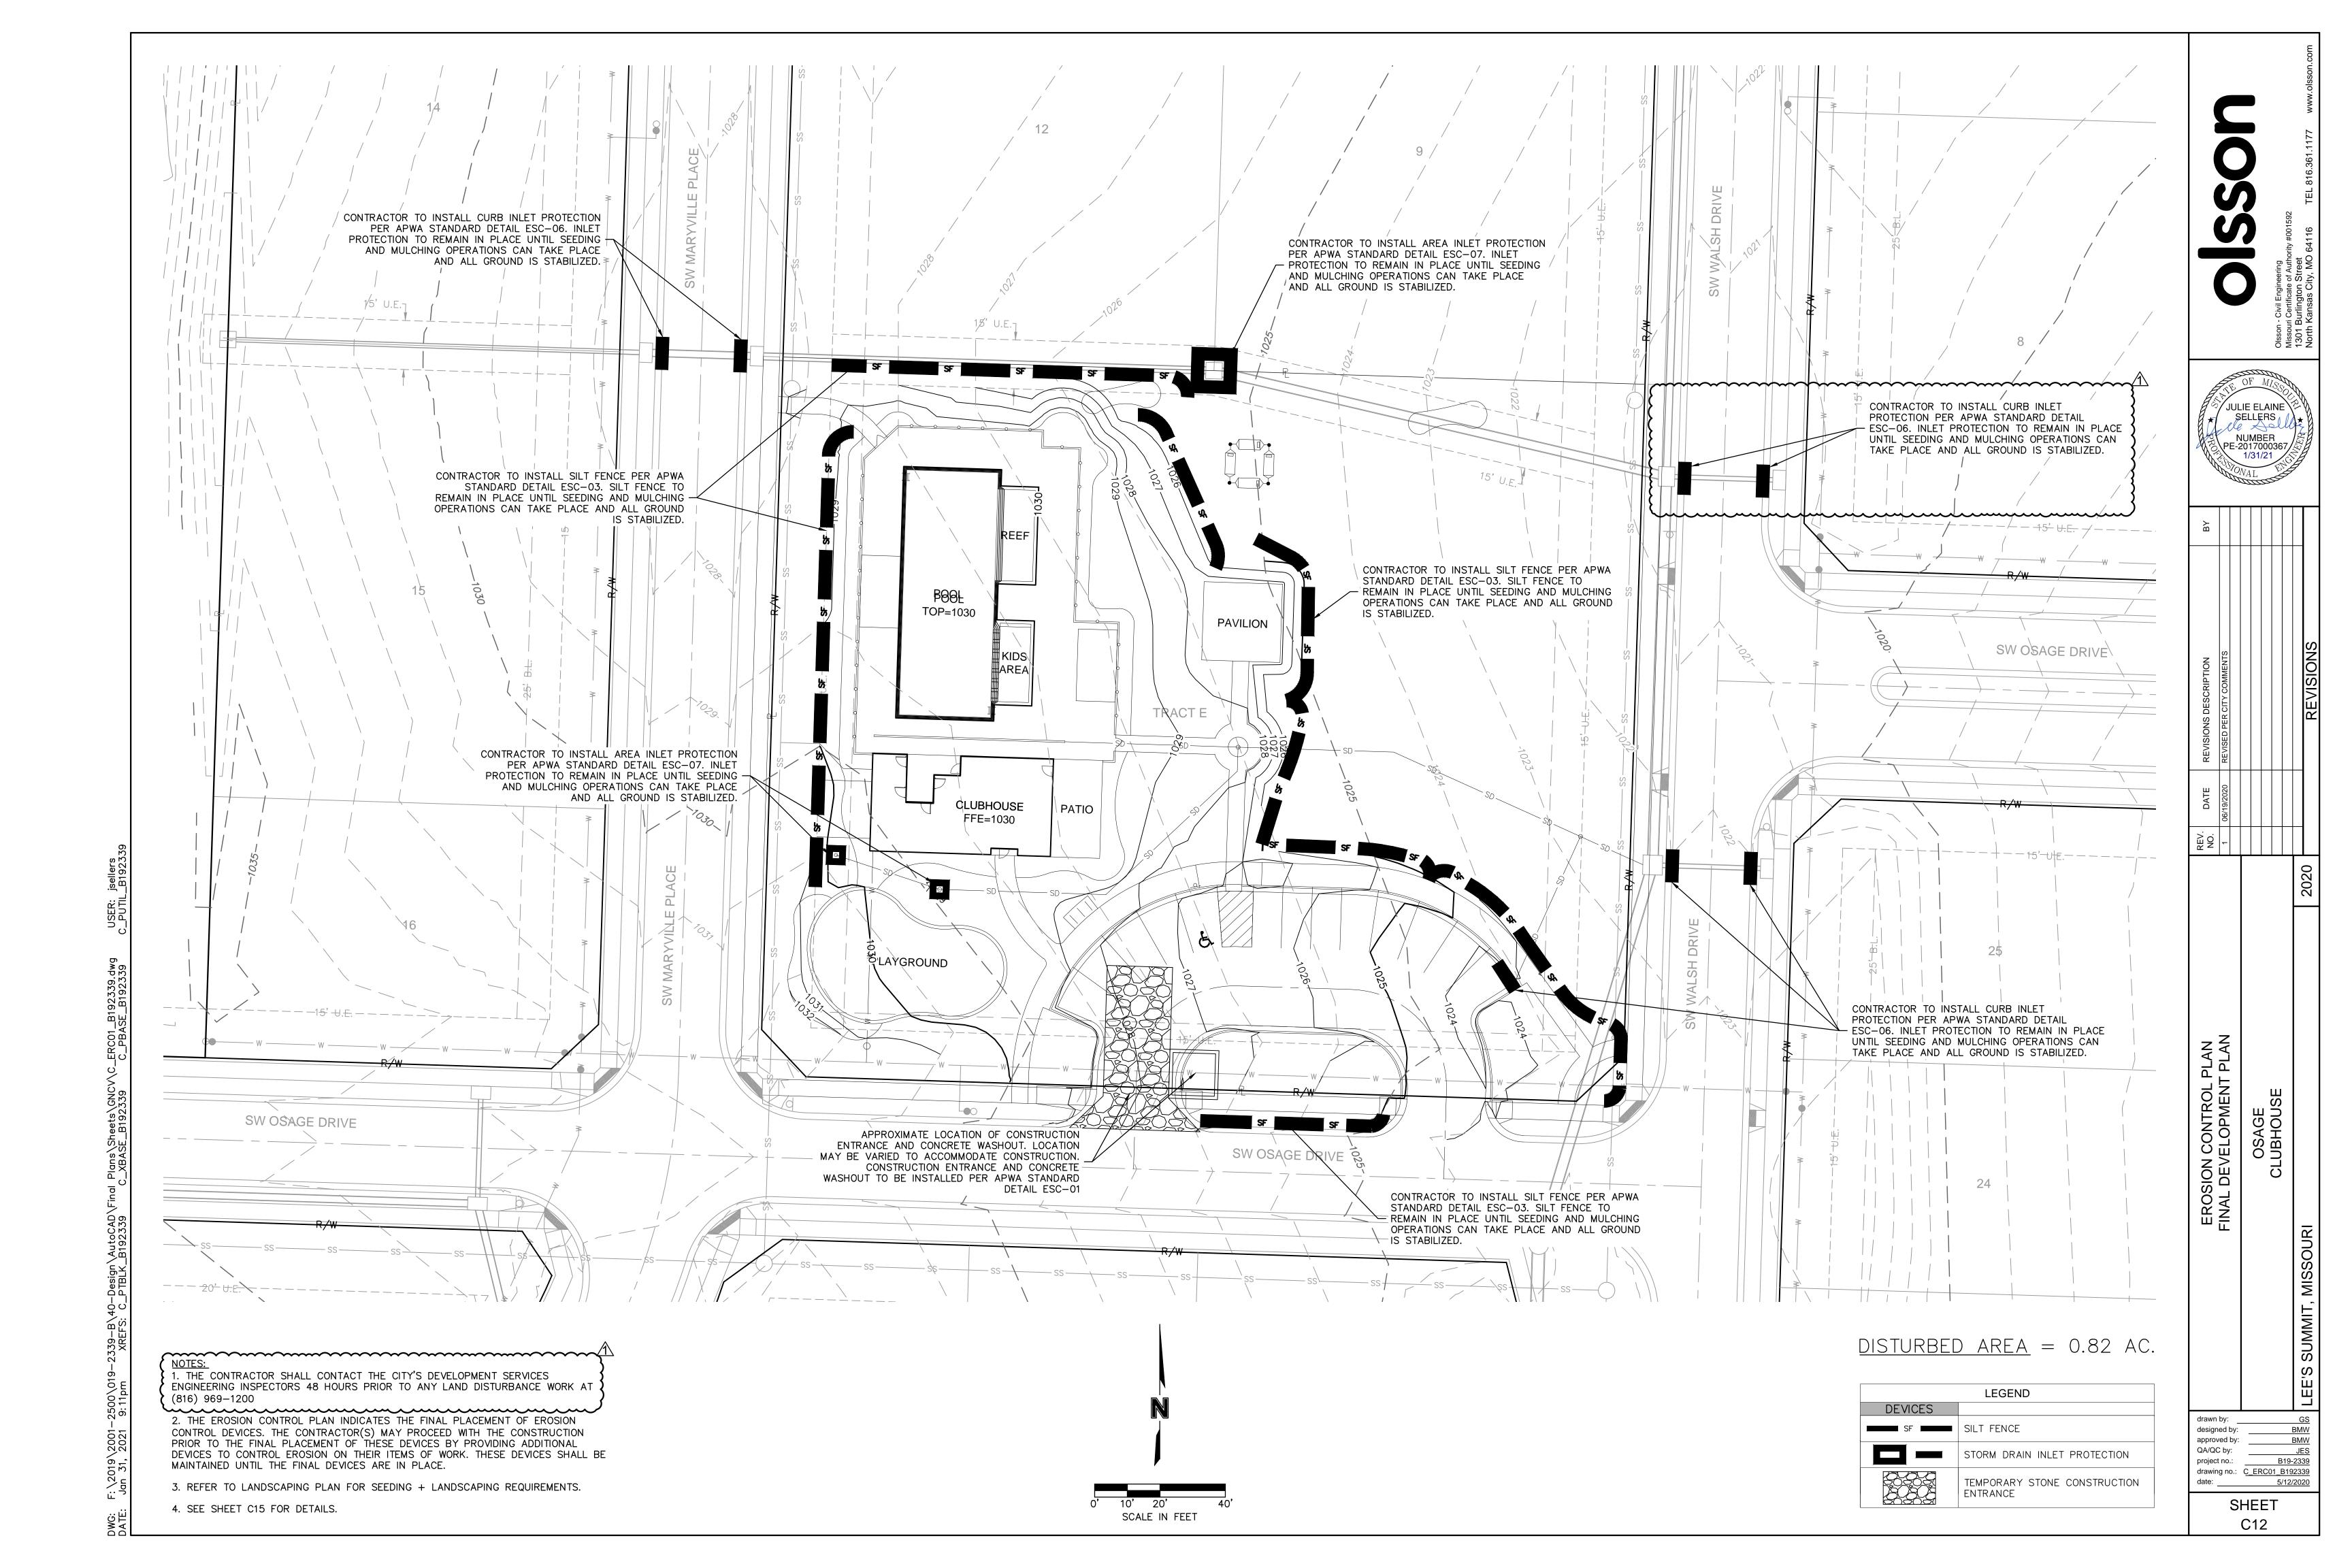

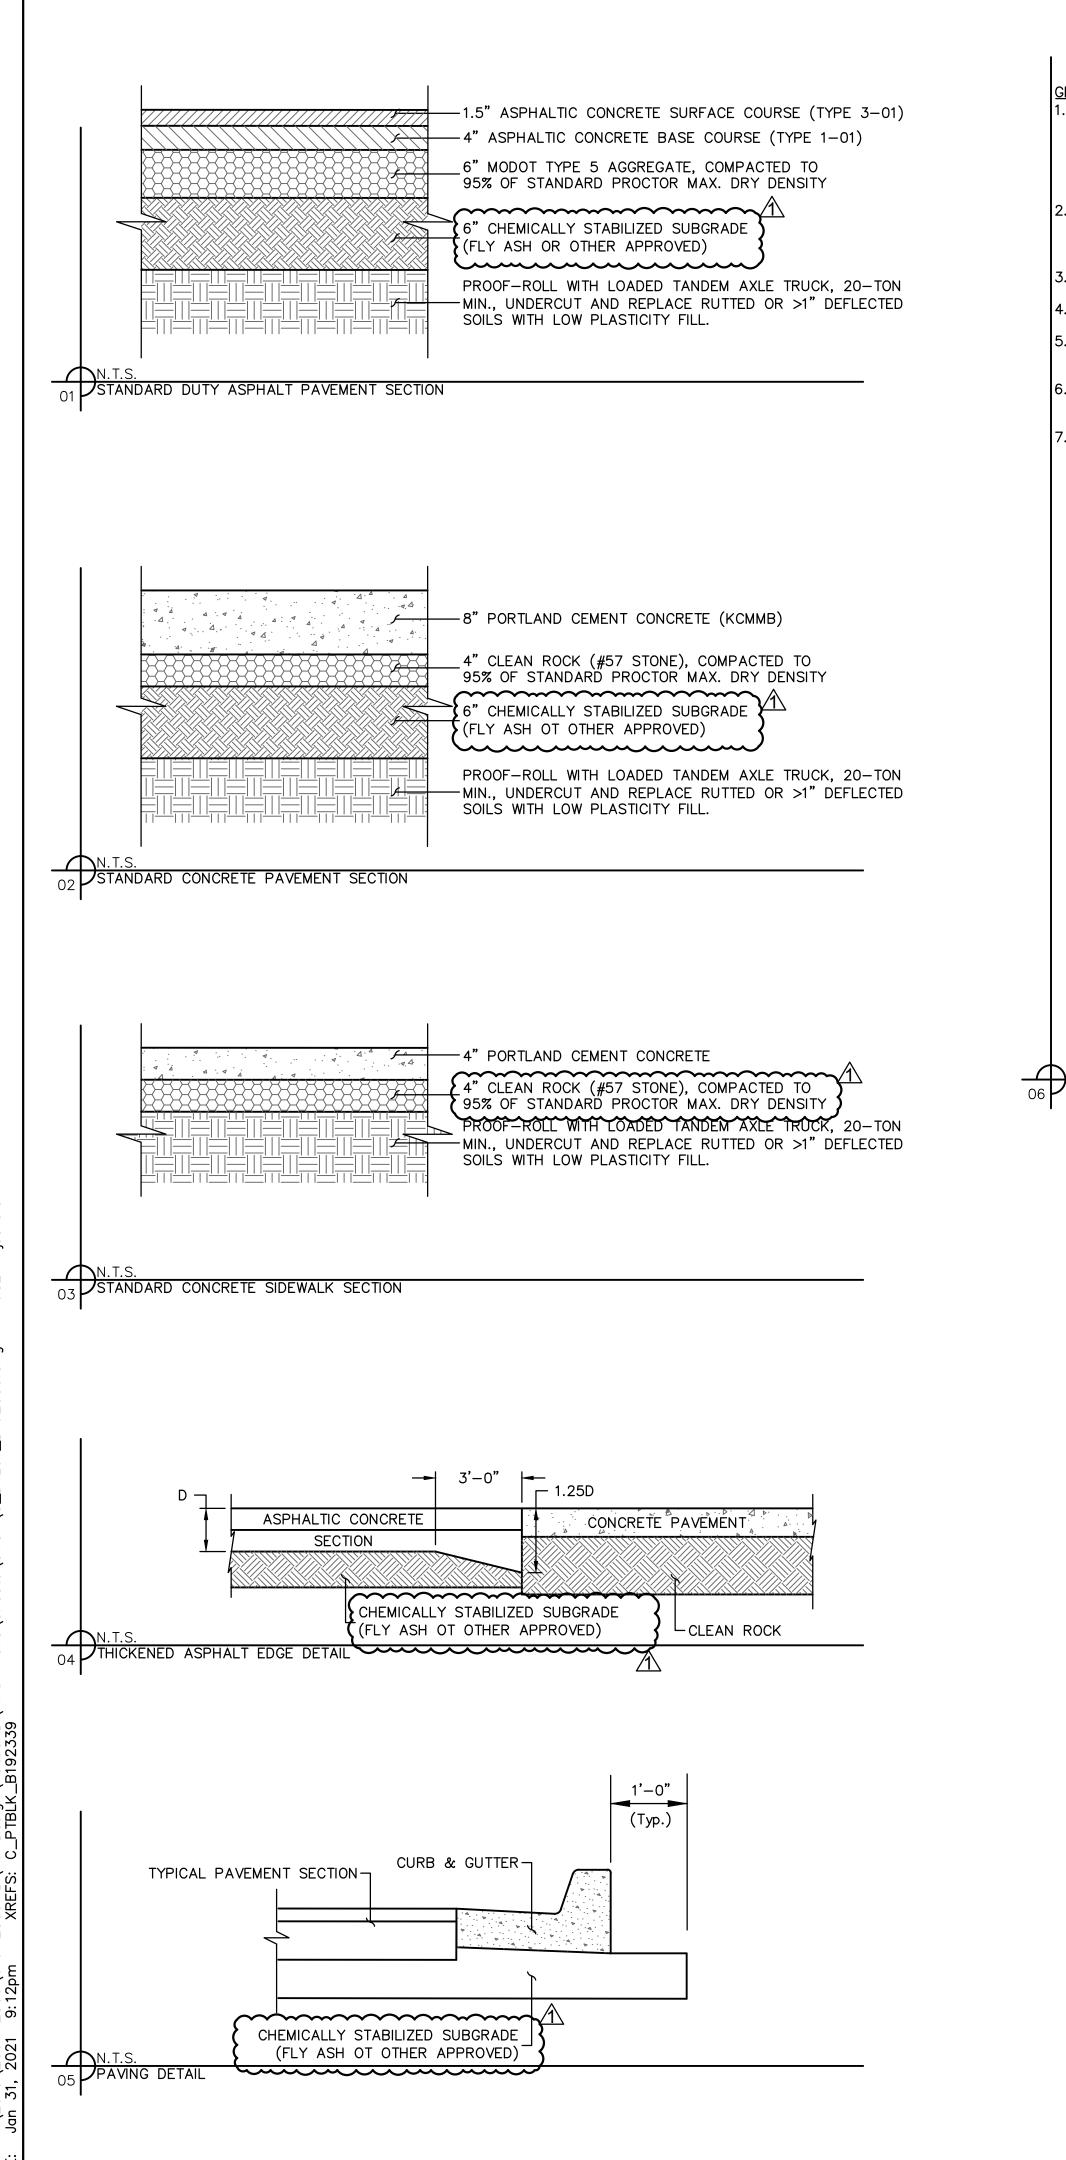

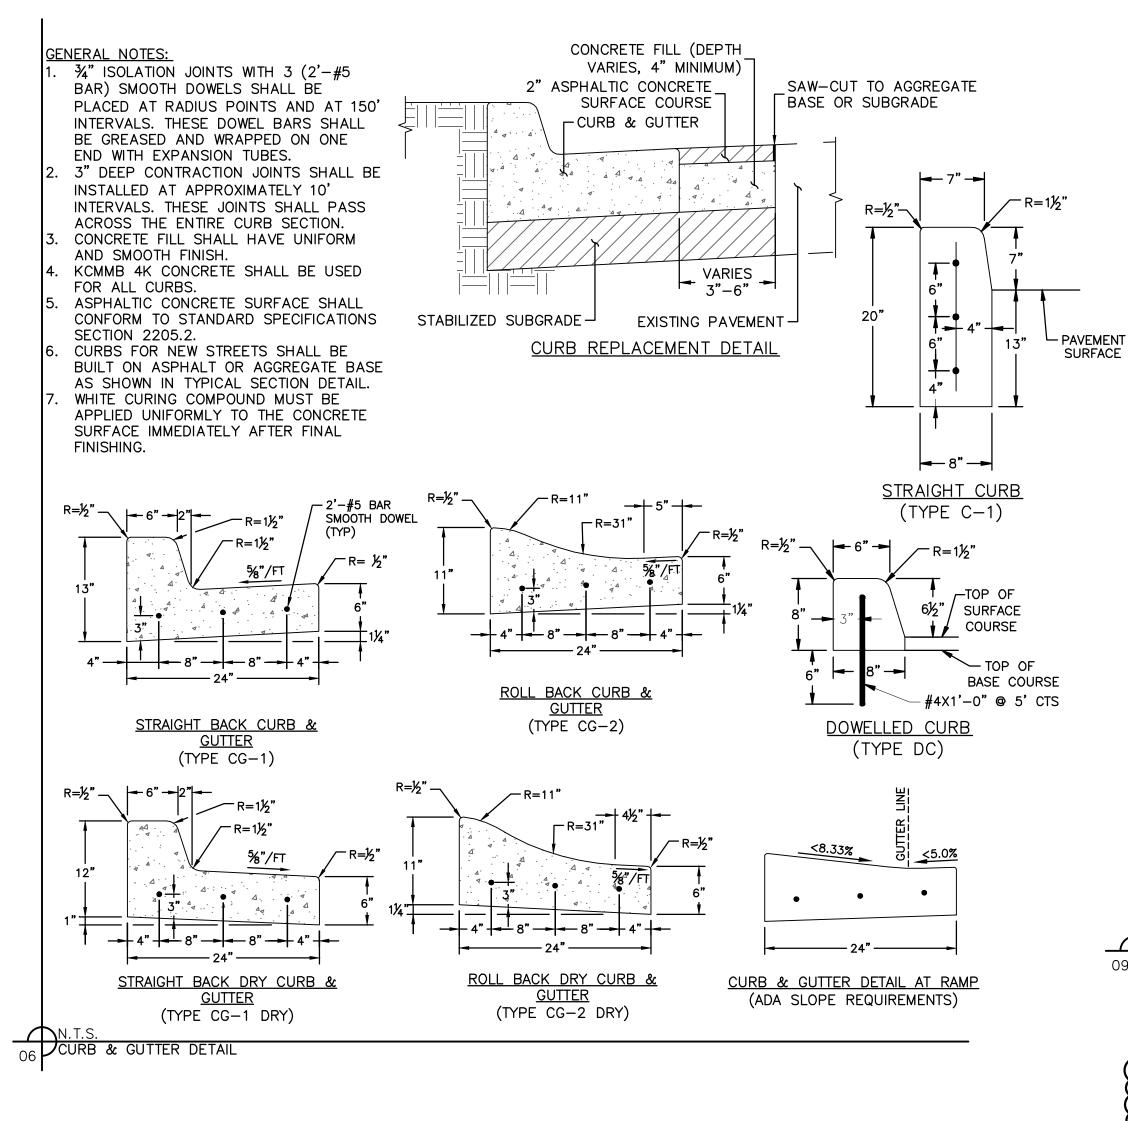

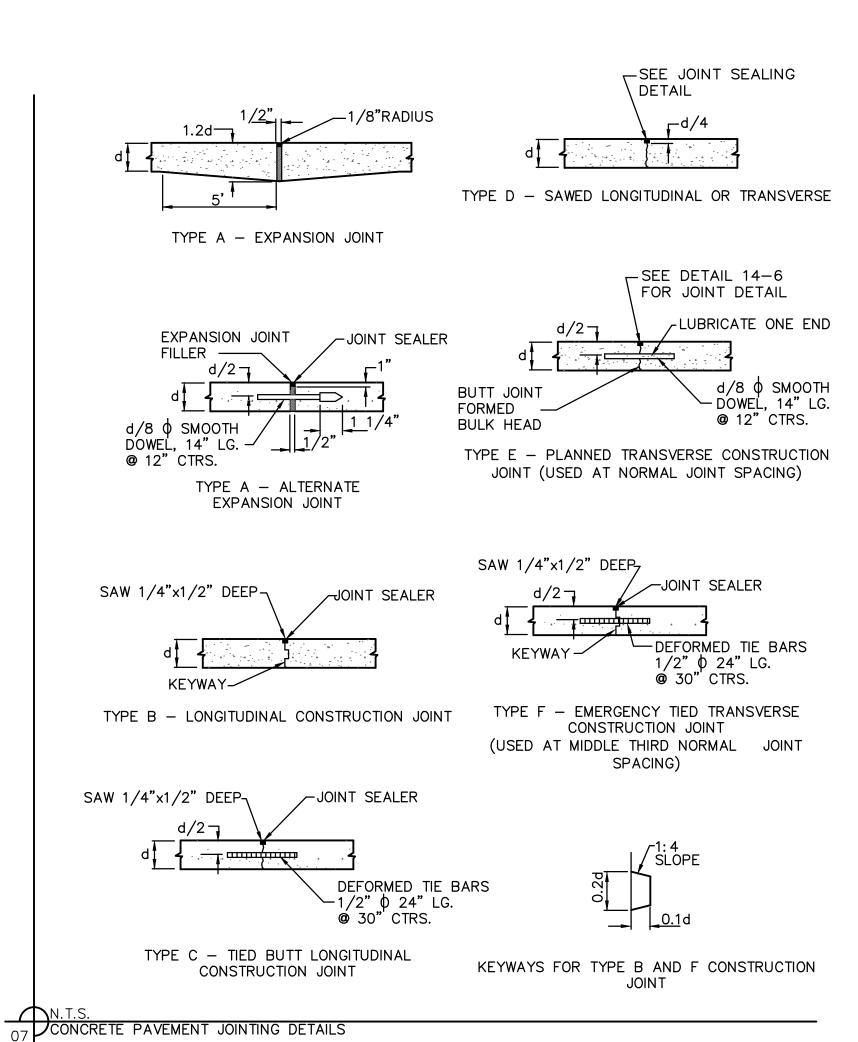

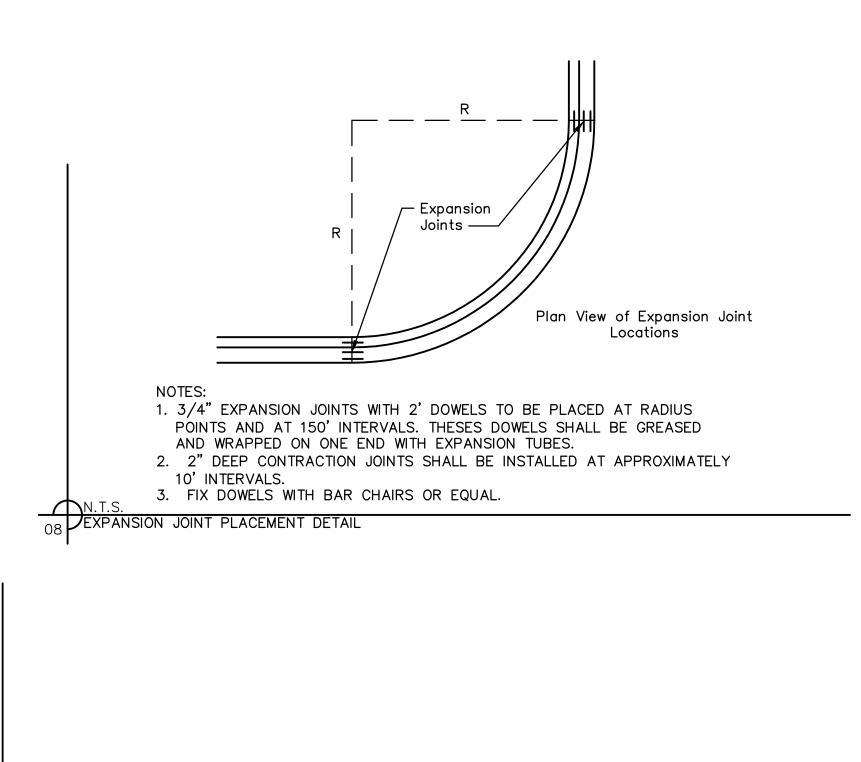


Top of Curb

`—Gutter Line

5'-0" MAX.

Pavement –

09 CURB TERMINUS DETAIL

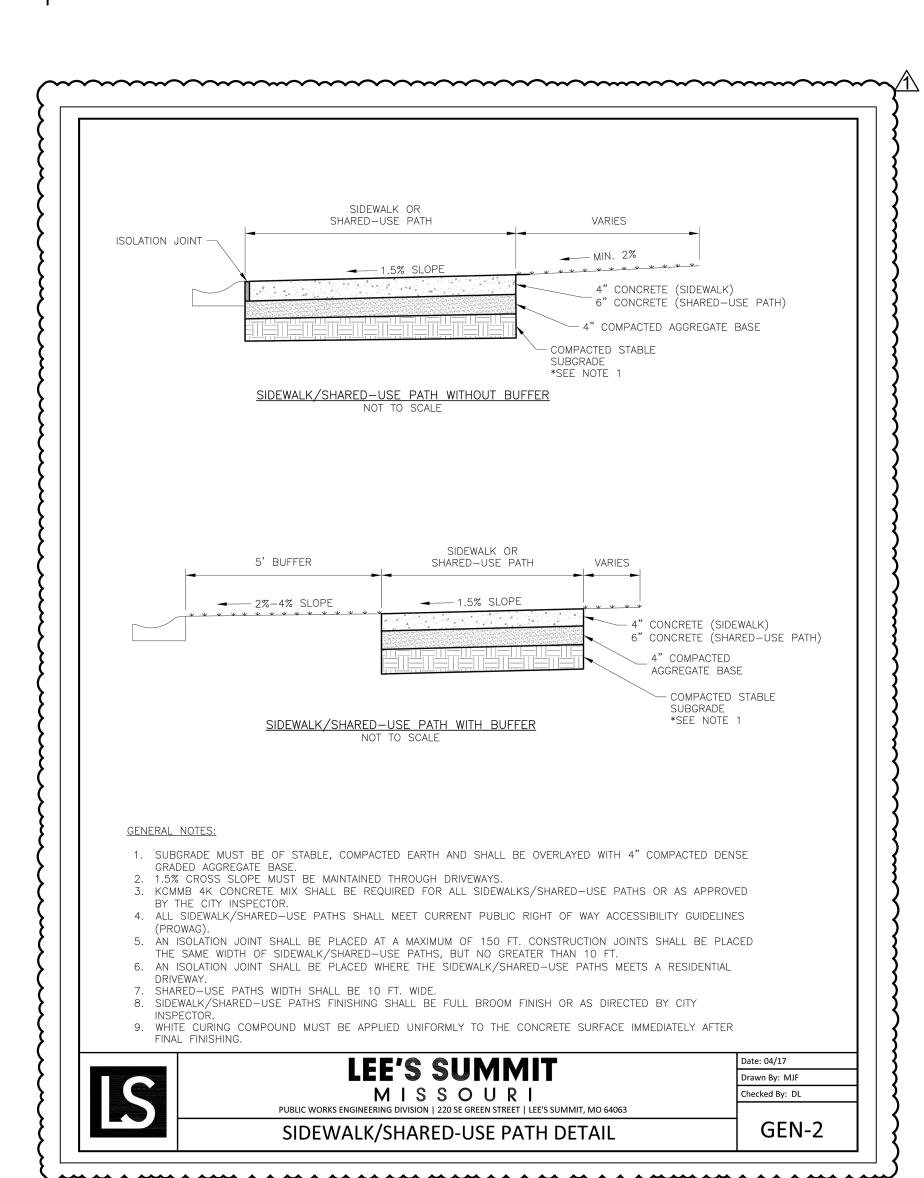

JULIE ELAINE SELLERS NUMBER \PE-2017000367

DETAIL SHEET DEVELOPMENT

designed by: QA/QC by: project no.: B19-2339

SHEET


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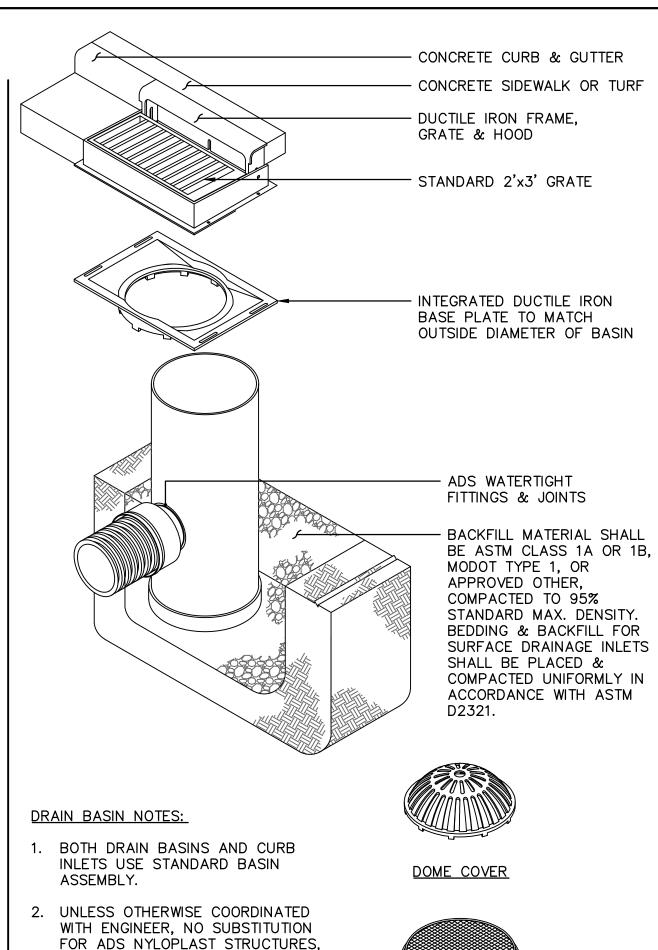
PIPE DIA.	MIN. TRENCH WIDTH*
<4"	O.D.+15"
4"	21"
6"	23"
8"	26"
10"	28"
12"	30"
15"	34"
18"	39"
24"	48"
30"	56"
36"	64"
42"	72"
48"	80"
54"	88"
60"	96"
TRENCH CENT	ERED ON PIPI

NOTES:

- 1. ALL HDPE AND PVC PIPE SYSTEMS SHALL BE INSTALLED IN ACCORDANCE WITH ASTM D2321, "STANDARD PRACTICE FOR UNDERGROUND INSTALLATION OF THERMOPLASTIC PIPE FOR SEWERS AND OTHER GRAVITY FLOW APPLICATIONS", LATEST EDITION.
- 2. IF TRENCH IS EXCAVATED IN ROCK OR HIGH-BEARING STRENGTH SOILS, TRENCH WIDTHS FOR 24" 60" DIA. MAY BE REDUCED, FROM
- VALUES IN TABLE 1, TO THE PIPE OD PLUS 12". 3. MEASURES SHOULD BE TAKEN TO PREVENT MIGRATION OF NATIVE FINES INTO BACKFILL MATERIAL, WHEN REQUIRED.
- 4. <u>FOUNDATION:</u> WHERE THE TRENCH BOTTOM IS UNSTABLE, THE CONTRACTOR SHALL EXCAVATE TO A DEPTH REQUIRED BY THE GEOTECHNICAL ENGINEER AND REPLACE WITH SUITABLE MATERIAL AS SPECIFIED BY THE GEOTECHNICAL ENGINEER. AS AN ALTERNATIVE AND AT THE DISCRETION OF THE DESIGN ENGINEER, THE TRENCH BOTTOM MAY BE STABILIZED USING A GEOTEXTILE MATERIAL.
- 5. <u>BEDDING:</u> SUITABLE MATERIAL SHALL BE ASTM CLASS 1A OR 1B, MODOT TYPE 1, OR APPROVED OTHER, COMPACTED TO 95% STANDARD MAX. DENSITY.. THE CONTRACTOR SHALL PROVIDE DOCUMENTATION FOR MATERIAL SPECIFICATION TO ENGINEER. UNLESS OTHERWISE NOTED BY THE ENGINEER, MINIMUM BEDDING THICKNESS SHALL BE 4" (100mm) FOR PIPE 24" DIAMETER AND LESS; 6" FOR 30"-60"
- 6. <u>INITIAL BACKFILL:</u> SUITABLE MATERIAL SHALL BE ASTM CLASS 1A OR 1B, MODOT TYPE 1, OR APPROVED OTHER, COMPACTED TO 95% STANDARD MAX. DENSITY IN THE PIPE ZONE EXTENDING NOT LESS THAN 6" ABOVE CROWN OF PIPE. MATERIAL SHALL BE INSTALLED AS REQUIRED IN ASTM D2321, LATEST EDITION. INSTALL AND COMPACT IN 6" MAXIMUM LIFTS.
- 7. <u>FINAL BACKFILL:</u> EXCEPT WHERE SUPERCEDED BY CITY REQUIREMENTS FOR RIGHT-OF-WAY CONSTRUCTION, GEOTECHNICAL REQUIREMENTS FOR UTILITY TRENCH BACKFILL, AND OTHER CONSIDERATIONS, SUITABLE MATERIAL MAY BE SITE SOILS COMPACTED TO 95% STANDARD MAX. DENSITY TO WITHIN 12" OF THE PAVEMENT SUBGRADE, AND TO SUBGRADE ELEVATION FOR NON-PAVED AREAS.
- 3. <u>MINIMUM COVER:</u> MINIMUM COVER, H, IN NON-TRAFFIC RATED APPLICATIONS (GRASS OR LANDSCAPE AREAS) IS 12" FROM THE TOP OF PIPE TO GROUND SURFACE. ADDITIONAL COVER MAY BE REQUIRED PER CITY AND/OR UTILITY STANDARDS AND/OR TO PREVENT FLOTATION. FOR TRAFFIC APPLICATIONS, MINIMUM COVER, H, IS 12" FOR UP TO 48" DIAMETER PIPE AND 24" OF COVER FOR UP TO 60" DIAMETER PIPE, MEASURED FROM TOP OF PIPE TO BOTTOM OF FLEXIBLE OR TO TOP OF RIGID PAVEMENT.





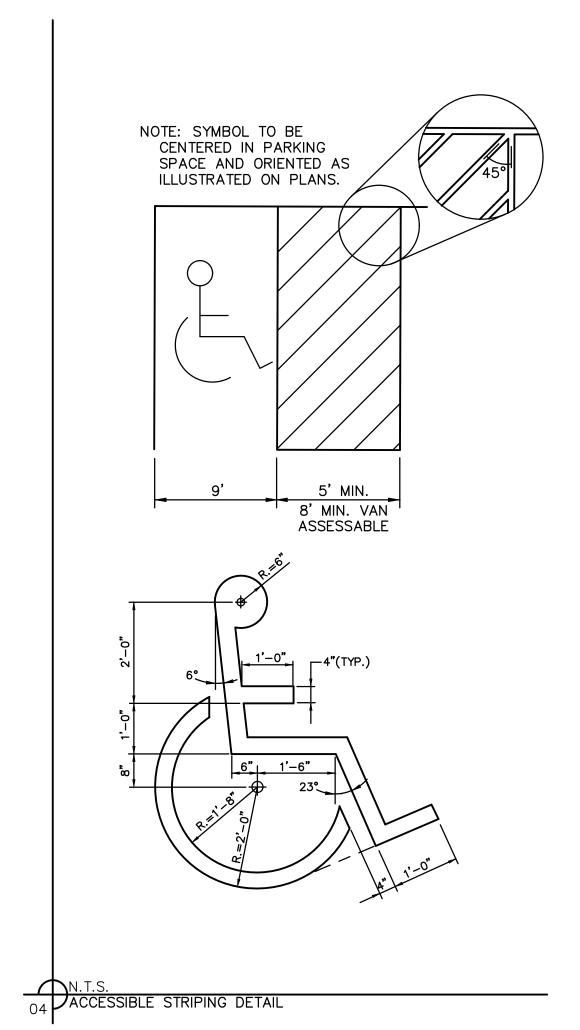

2. UNLESS OTHERWISE COORDINATED WITH ENGINEER, NO SUBSTITUTION FOR ADS NYLOPLAST STRUCTURES, INCLUDING ALL PARTS. ALL CONSTRUCTION SHALL BE PER MANUFACTURER'S STANDARDS AND RECOMMENDATIONS.





SOLID COVER


02 ADS NYLOPLAST STRUCTURES

1. ALL SIGNS SHALL COMPLY WITH THE U.S. DEPARTMENT OF TRANSPORTATION, FEDERAL HIGHWAY ADMINISTRATION'S "MANUAL OF UNIFORM TRAFFIC CONTROL DEVICES", LOCAL CODES AND AS SPECIFIED. MOUNT SIGNS TO POST IN ACCORDANCE WITH MANUFACTURER'S INSTRUCTIONS

2. GALVANIZED SQUARE TUBE:
POST TUBES — 2"X2"X¾6" 12GA.
POST TUBE SHALL MEET ASTM A1011 GRADE 50.
POST TUBE GALVANIZED AS PER ASTM A653 GRADE 90.
ANCHOR TUBE — 2—¼"x2—¼"x¾6" 12GA.
HEAVY DUTY ANCHOR TUBE SHALL MEET ASTM A500 GRADE B.
STRUCTURAL TUBE AND STEEL SHALL BE HOT DIP GALVANIZED PER ASTM A123
THE UPPER SIGN POST SHALL TELESCOPE INSIDE THE ANCHOR TUBE A MINIMUM OF 12". THE ANCHOR TUBE SHALL BE A MINIMUM 27" DEEP WITH 3" MIN., 4"
MAX. EXPOSED ABOVE FINISH GRADE.

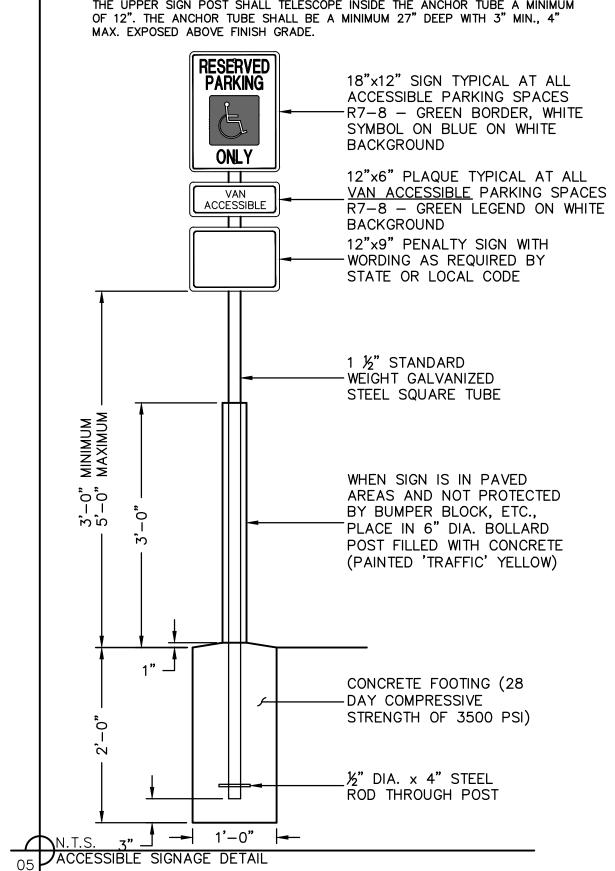

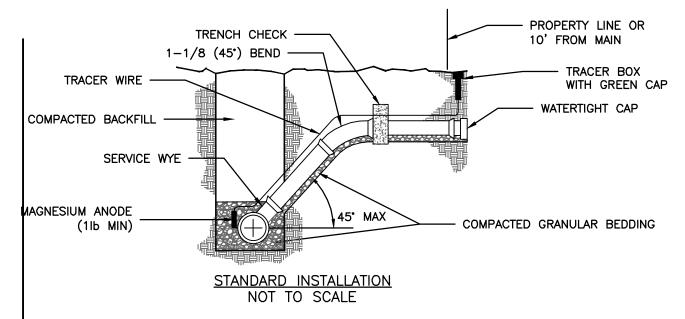

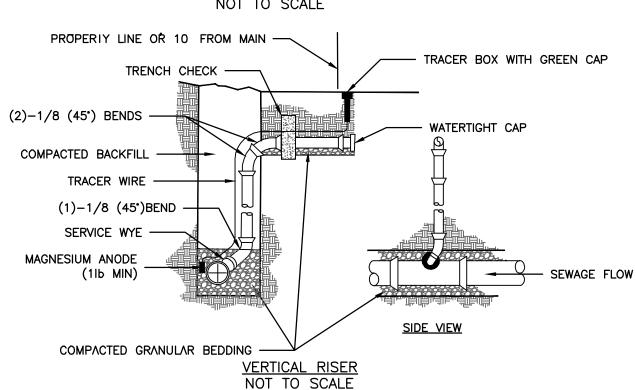

1. ALL SEWER STUBS SHALL BE CONSTRUCTED TO PROPERTY LINE OR 10' MINIMUM FROM THE MAIN.
WHERE SIDEWALKS ARE PRESENT, CONTRACTOR SHALL EXTEND SERVICE LINE UNDER EXISTING
SIDEWALK TO TWO FEET BEYOND.

- 2. ALL NEW CONSTRUCTION OFF SEWER STUBS SHALL BE TEMPORARILY MARKED WITH A MARKING STAKE, 36" ABOVE GROUND AND PAINTED GREEN.
- 3. IMPERVIOUS TRENCH CHECKS SHALL BE PLACED ON BUILDING SEWER STUBS (AT LEAST 5' AWAY FROM THE SANITARY SEWER MAIN).
- 4. TRENCH CHECKS ON THE BUILDING SEWER STUBS SHALL EXTEND 6" BELOW THE BOTTOM OF THE PIPE. LENGTH SHALL BE A MINIMUM OF 12". THE HEIGHT OF THE TRENCH CHECK SHALL EXTEND 12" ABOVE THE TOP OF THE PIPE. THE WIDTH OF THE TRENCH CHECK SHALL BE THE WIDTH OF
- THE TRENCH.

 5. SEE SPECIFICATION SECTION 2100 FOR SEWER MAIN BEDDING AND BACKFILL.

 6. #12 GAUGE GREEN INSULATED COPPER TRACER WIRE SHALL BE INSTALLED. TRACER WIRE
- TERMINAL BOXES SHALL BE INSTALLED DIRECTLY ABOVE THE SEWER SERVICE OR AS DETERMINED BY THE ENGINEER.
- 7. FOR SERVICES, TRACER WIRE SHALL RUN FROM THE WYE AND TERMINATE IN A FLUSH MOUNTED TRACER BOX WITH A GREEN CAST IRON LOCKABLE TOP. WIRE SHALL BE TAPED OR TIED TO THE PIPE AT 5' INTERVALS.
- 8. TRACER WIRE BOX SHALL BE INSTALLED WITHIN 1.0' OF PROPERTY LINE.
 9. THE TRACER WIRE SHALL REMAIN CONTINUOUS TO THE GREATEST EXTENT POSSIBLE. SPLICES IN THE TRACER WIRE SHOULD BE MADE WITH SPLIT BOLT CONNECTORS. WIRE NUTS SHALL NOT BE

USED. A WATER-PROOF CONNECTION IS NECESSARY TO PREVENT CORROSION.

N.T.S.


BUILDING SEWER STUB AND RISER


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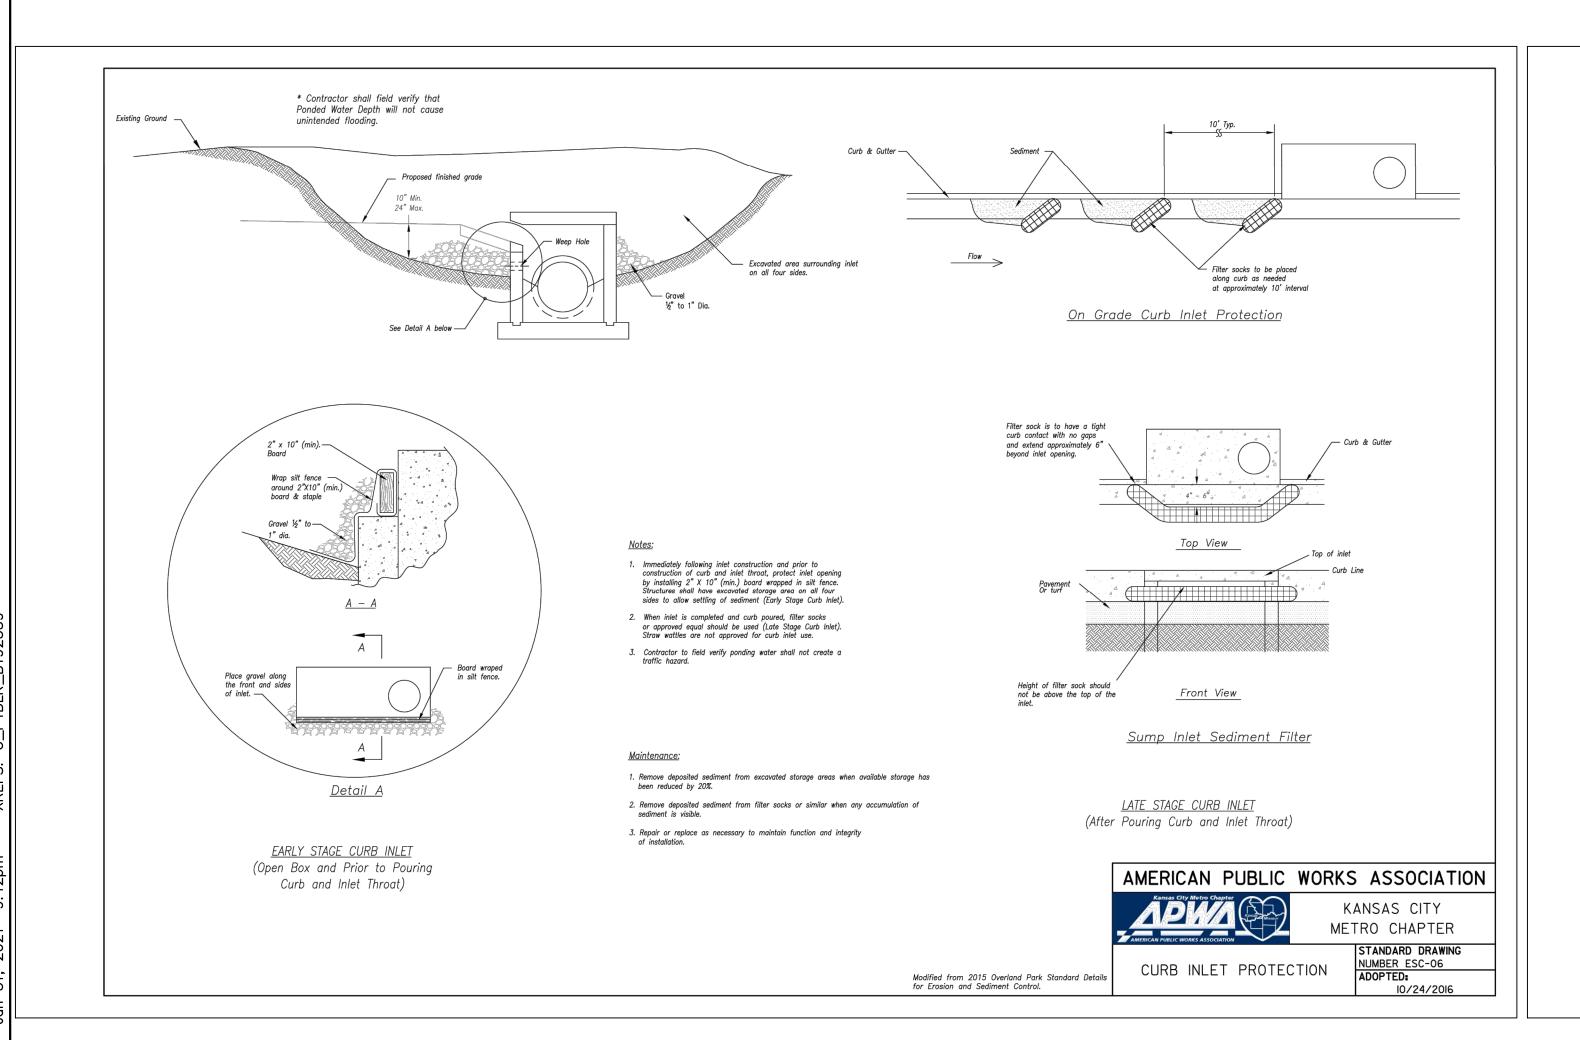
JULIE ELAINE
SELLERS
NUMBER
PE-2017000367
1/31/21


DETAIL SHEET DEVELOPMENT drawn by: designed by: approved by: BMW QA/QC by: project no.: B19-2339 drawing no.: <u>C_DTL01_B192339</u>

> SHEET C14



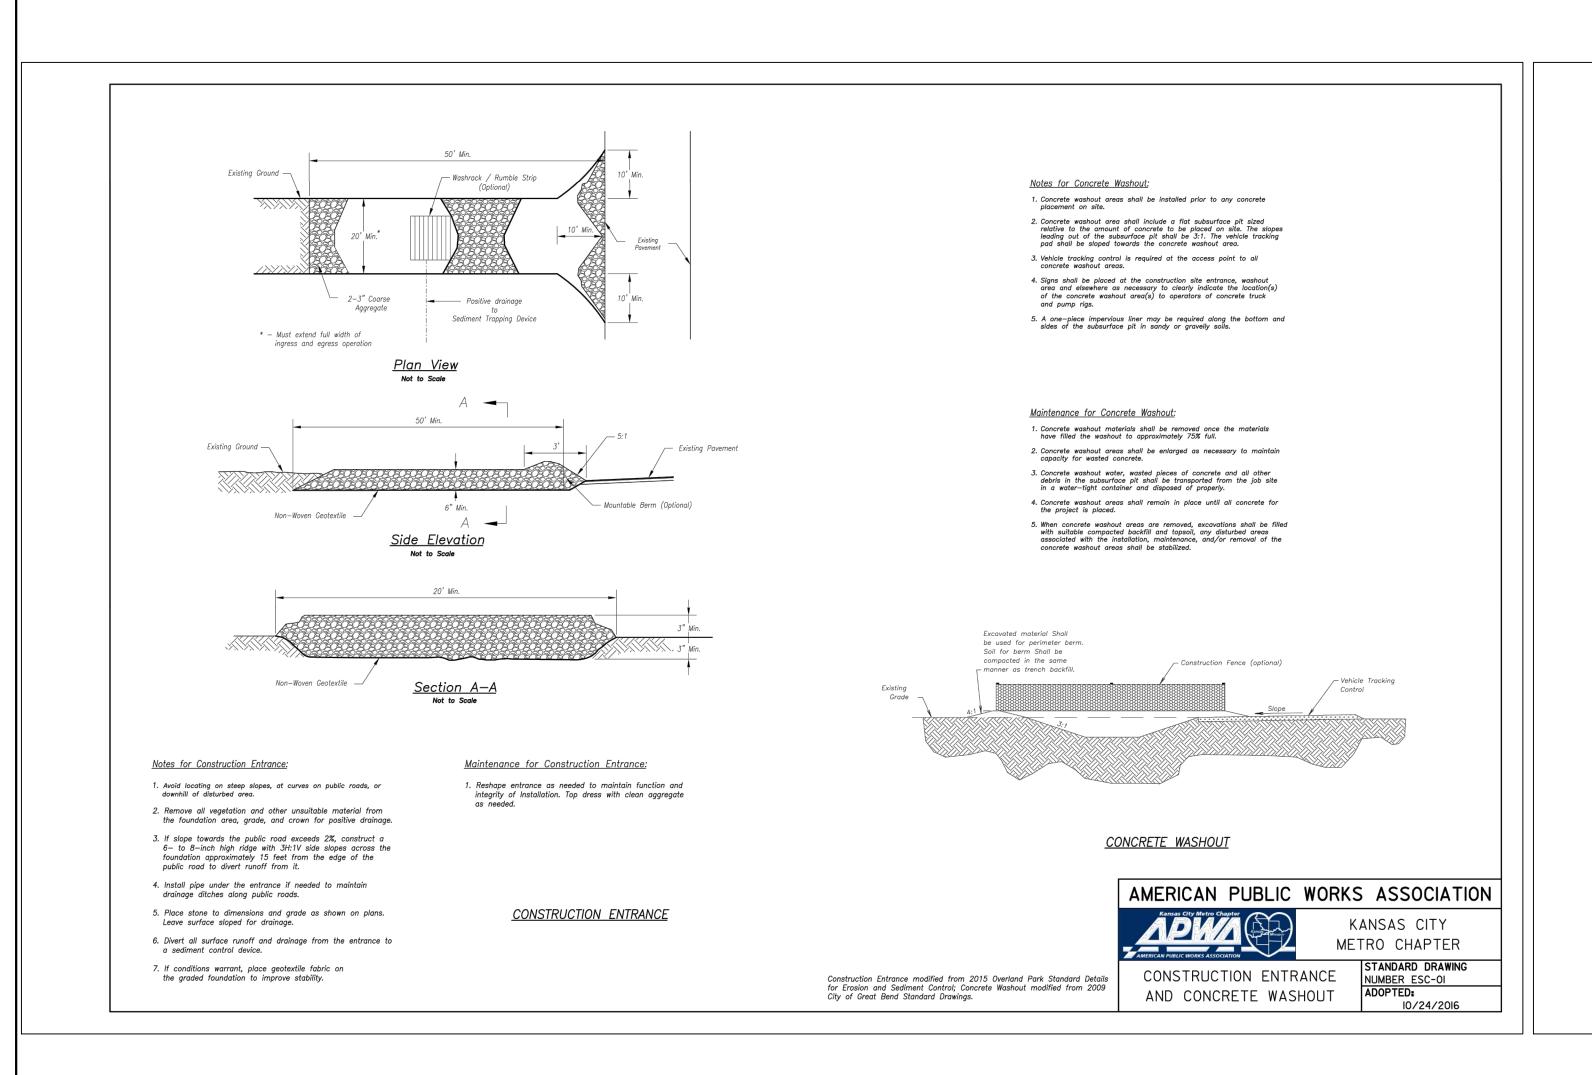

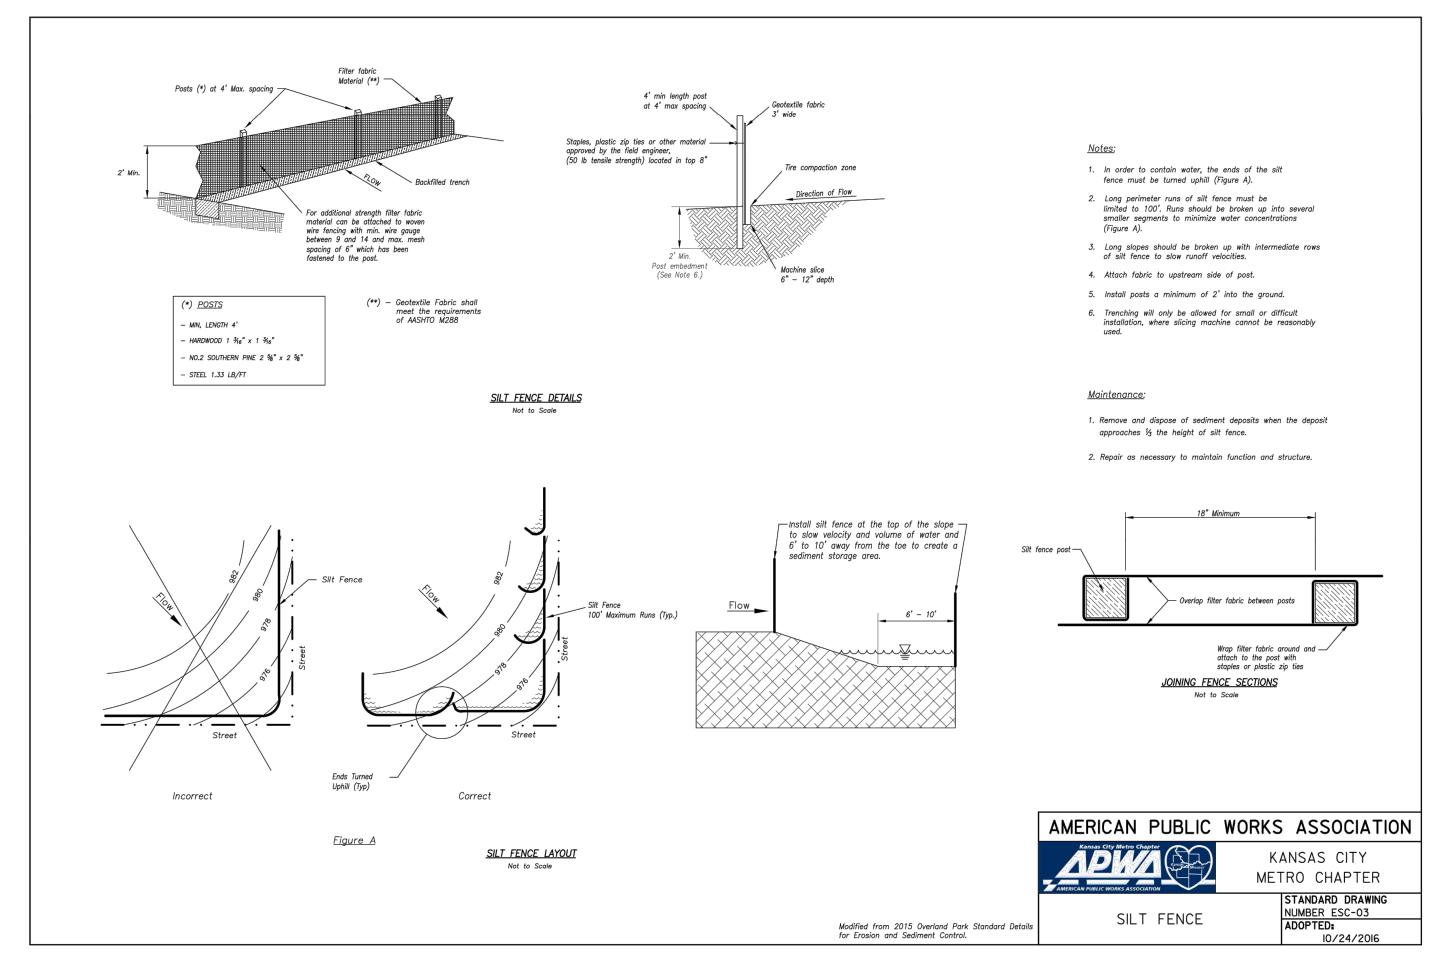

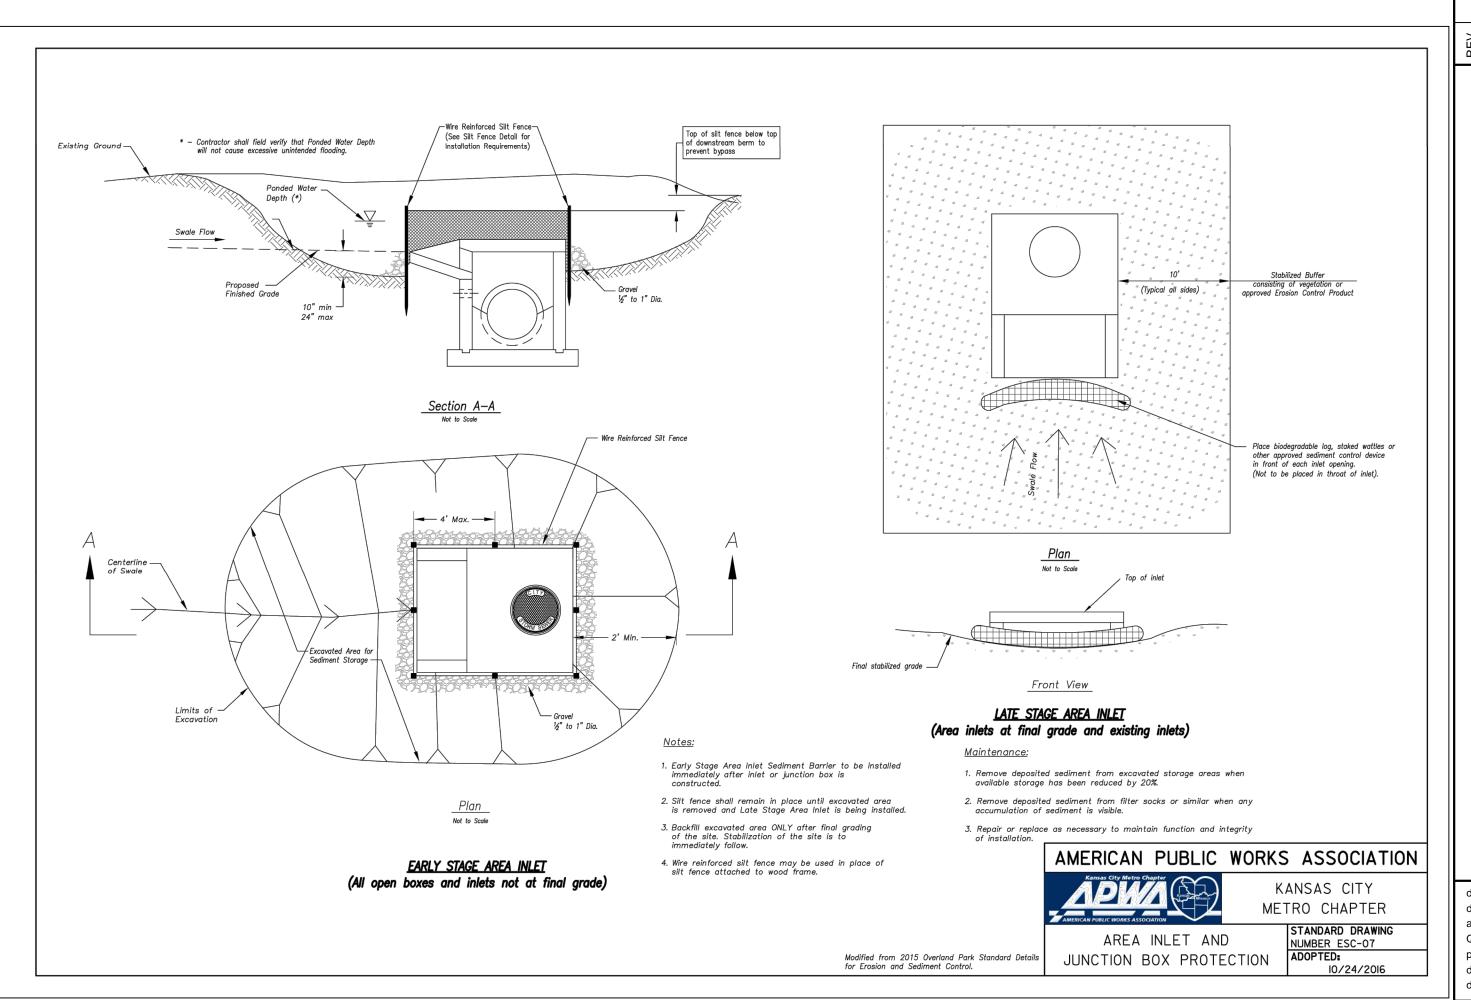


SELLERS NUMBER PE-2017000367 1/31/21

FINAL DEVELOPMENT PLAN

OSAGE
CLUBHOUSE

drawn by: GS
designed by: BMW
approved by: BMW
QA/QC by: JES
project no.: B19-2339
drawing no.: C_DTL01_B192339

SHEET C15

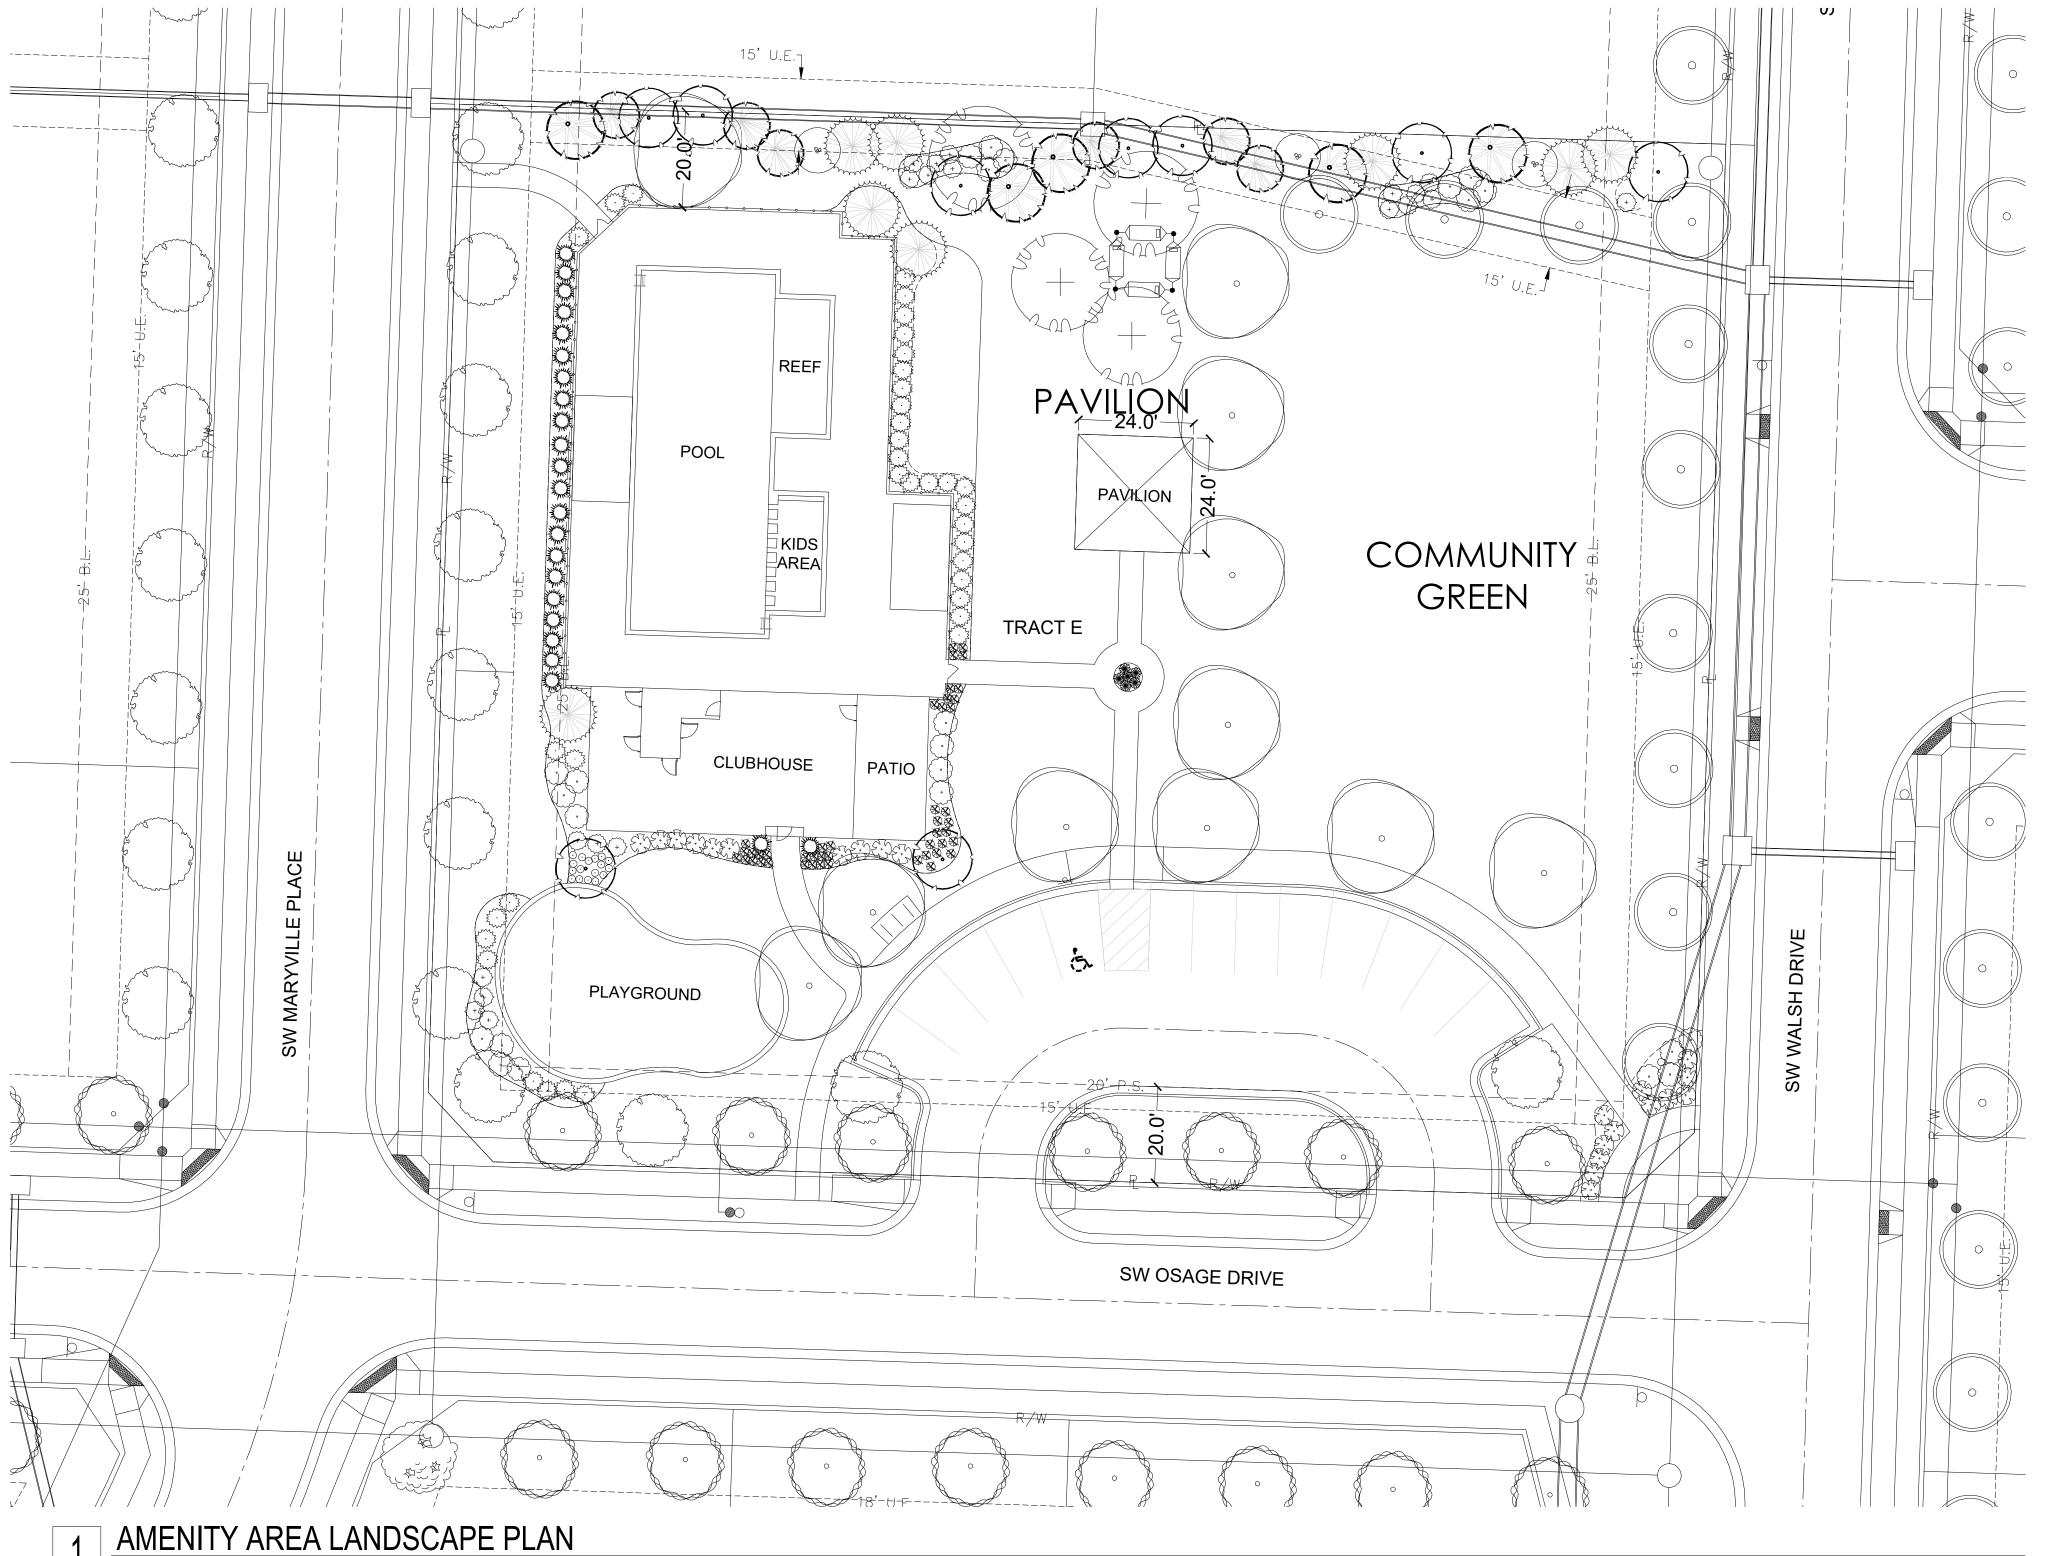

Landscape Schedule (Amenity area only)

Symbol	Qty.	Botanical Name	Common Name	Min.Root	Min.Size	Caliper	Remarks
OVERST	TORY TREE	S					
+ 2	4	Platanus x acerifolia	London Plane Tree			3"	6' min. clear., ground to canopy
	11	Acer x truncatum 'Warrenred'	Pacific Sunset Maple			3"	6' min. clear., ground to canopy
) 0	Quercus bicolor	Swamp White Oak			3"	6' min. clear., ground to canopy
EVERGR	REEN TREE	S					
	9	Juniperus chinensis Keteleeri	Keteleeri Juniper		8' ht.		symmetrical pyramidal form
	5	Picea abies	Norway Spruce		8' ht.		symmetrical pyramidal form
	6	Picea pungens	Colorado Blue Spruce		6' ht.		symmetrical pyramidal form
ORNAME	ENTAL TREE	S					
(\cdot)	9	Cercis canadensis	Eastern Redbud			3"	
80	2	Cornus florida 'Cloud Nine'	Cloud 9 Dogwood			3"	
ORNAME	ENTAL STRE	ET TREES					
	10	Acer truncatum	Shantung Maple			2"	
$\mathcal{A} \cdot \mathcal{A}$	7	Zelkova serrata 'Schmidtlow'	Wireless Zelkova			2"	
	11	Acer buergerianum	Trident Maple			2"	
	0	Syringa reticulata 'Ivory Silk'	Japanese Tree Lilac			2"	
DECIDU	IOUS SHRI	 JBS/GRASSES					
\odot	17	Liriope spicata 'Silver Dragon'	Silver Dragon Liriope	1 gal.			Plant @ 18" O.C.
	45	Festuca ovina glauca	Dwarf Blue Fescue	1 gal.			Plant @ 18" O.C.
	22	Hydrangea paniculata 'Quick Fire'	Little Quick Fire Hydrangea	3 gal.	18" ht. min		Plant @ 4' O.C.
	6	Equisetum hyemale	Horsetail Reed	1 gal.			Plant @ 18" O.C.
(·)	24	Syringa X 'Penda'	Bloomerang Purple Lilac	5 gal.			Plant @ 5' O.C.
EVERGF	REEN SHR	UBS					
in white the same of the same	23	Juniperus chinensis 'Spartan'	Spartan Juniper		5' ht.		Symmetrical pyramidal form
£ · }	37	Juniperus chinensis 'Sea Green'	Sea Green Juniper	3 gal.			Plant @ 4' O.C.
month	20	Juniperus chinensis 'Gold Coast'	Gold Coast Juniper	3 gal.			Plant @ 4' O.C.

Lee's Summit, MO 64082

Summit Homes

120 SE 30th St

CLIENT

PROJECT

LANDSCAPE

ARCHITECTURE

15245 Metcalf Ave. Overland Park, KS 66223 913.787.2817

Osage Highway 150 and Pryor Road Lee's Summit, MO

Landscape Calculations/Requirements

Street Frontage: (For all Districts) One (1) tree shall be planted for each thirty (30) feet of street frontage, within 20' setback. (Totals shown below combine both sides of the road, minus intersecting

SW Walsh Drive.= 205 LF. SW Osage Drive= 235 LF.

7 Trees required. 8 Trees required. 7 Trees required.

7 Trees provided. 8 Trees provided. 7 Trees provided.

(For all Districts) One (1) shrub shall be planted for each twenty (20) feet of street frontage, within the landscaped setback abutting such frontage. (Totals shown below combine both sides of the road, minus

intersecting streets/driveways) SW Walsh Drive.= 205 LF. SW Osage Drive= 235 LF.

SW Maryville Place= 205 LF REQUIREMENTS MET

SW Maryville Place= 205 LF.

10 Shrubs required. 12 Shrubs required. 10 Shrubs required.

10 Shrubs provided. 12 Shrubs provided. 38 Shrubs provided.

Amentiy Parking: (For all Districts) One parking stall per every 16 units. 160 total units. 10 Stalls required. 13 stalls provided. REQUIREMENTS MET

Open Yard Tree Requirement: In addition to the trees required based upon street frontage, additional trees shall be required at a ratio of 1 tree for every 5,000 square feet of total landscaped open space. 36,612 sf total landscaped open space. 7 trees required. 7 Trees Provided Min. Requirement Met.

Buffer Landscape: Medium Density Buffer (type B) provided on North of amenity area. REQUIREMENT MET

Planting Notes

1. Location of all existing utilities needs to done before commencing work. 2. The planting plan graphically illustrates overall plant massings. Each plant species massing shall be placed in the field to utilize the greatest coverage of ground plane. The following applies for individual plantings: a. Creeping groundcover shall be a minimum of 6" from paving edge.

b. All trees shall be a minimum of 3' from paving edge.

c. All plants of the same species shall be equally spaced apart and placed for best aesthetic viewing.

5. All landscaped areas in ROW shall be sodded and irrigated unless otherwise specified.

d. All shrubs shall be a minimum of 2' from paved edge. 3. Mulch all planting bed areas to a minimum depth of 3". Mulch individual trees to a minimum depth of 4". 4. Note: If plants are not labeled - they are existing and shall remain.

substances.

1. Plant material shall be healthy, vigorous, and free of disease and insects as per AAN standards. 2. Shredded bark mulch installed at trees shall be finely chipped and shredded hardwood chips, consisting of pure wood products and free of all other foreign substances. Pine bark compost mulch installed at planting bed areas shall be free of all other foreign


1. All planting beds shall be amended with 1 cubic yard of peat moss per 1,000 square feet. Till peat moss into soil to a 6" depth. A 10-10-10 fertilizer shall be spread over all planting areas prior to planting, at a rate of 50 pounds per 2,000 square feet. 2. After plants have been installed, all planting beds shall be treated with Dacthal pre-emergent herbicide prior to mulch application.


3. Plant pit backfill for trees and shrubs shall be 50% peat or well composted manure and 50% topsoil. 4. Plant material shall be maintained and guaranteed for a period of one year after Owner's acceptance of finished job. All dead or damaged plant material shall be replaced at Landscape Contractor's expense. 6. Landscape contractor shall maintain all plant material until final acceptance, at which point the one year guarantee begins.

UNDCOVER OR 60.00°	Inches Between Plants	Plant Quantities Per Square Foot
UB PIT	10"	Square Feet x 1.50
TAINER XXX	12"	Square Feet x 1.00
(**************************************	18"	Square Feet x .44
SHREDDED	30"	Square Feet x .16
BARK MULCH	36"	Square Feet x .11


NOTES: 1. SPACING FOR GROUNDCOVERS, SHRUBS, AND PERENNIALS NOTED ON PLANS. 2. TILL SOIL IN BED TO A 12" MINIMUM DEPTH AND THOROUGHLY MIX IN SOIL AMENITIES AS NOTED ON PLANS.

GROUNDCOVER/SHRUB DETAIL

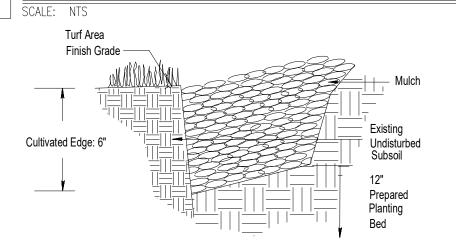

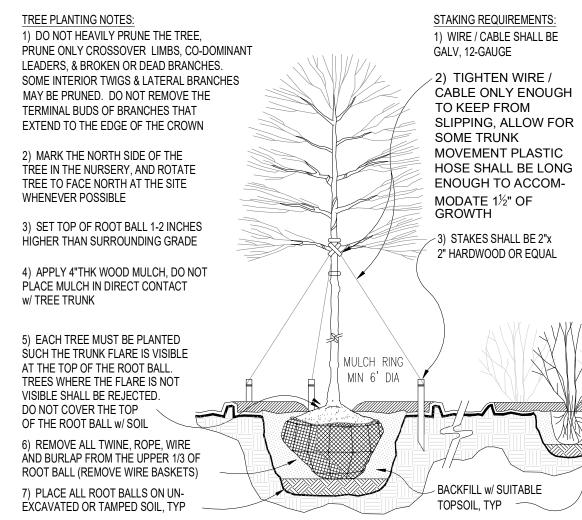


PLANTING INSTALLATION DETAILS

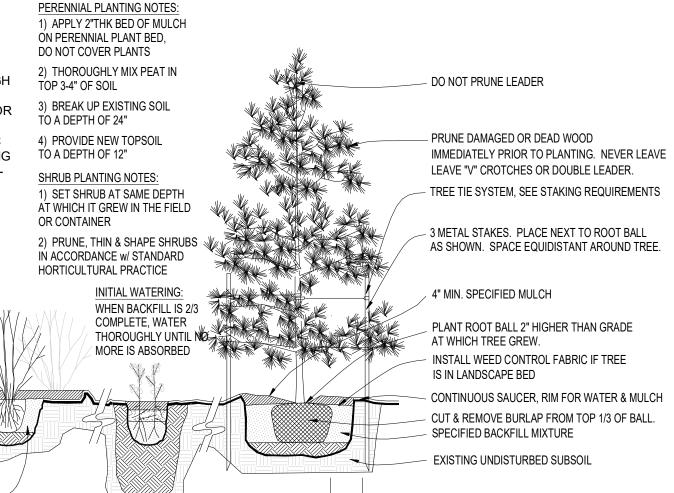

SCALE: 1"=20' NORTH

Date: 7.23.2020 Project #: 482 Amenity Area Landscape Plan

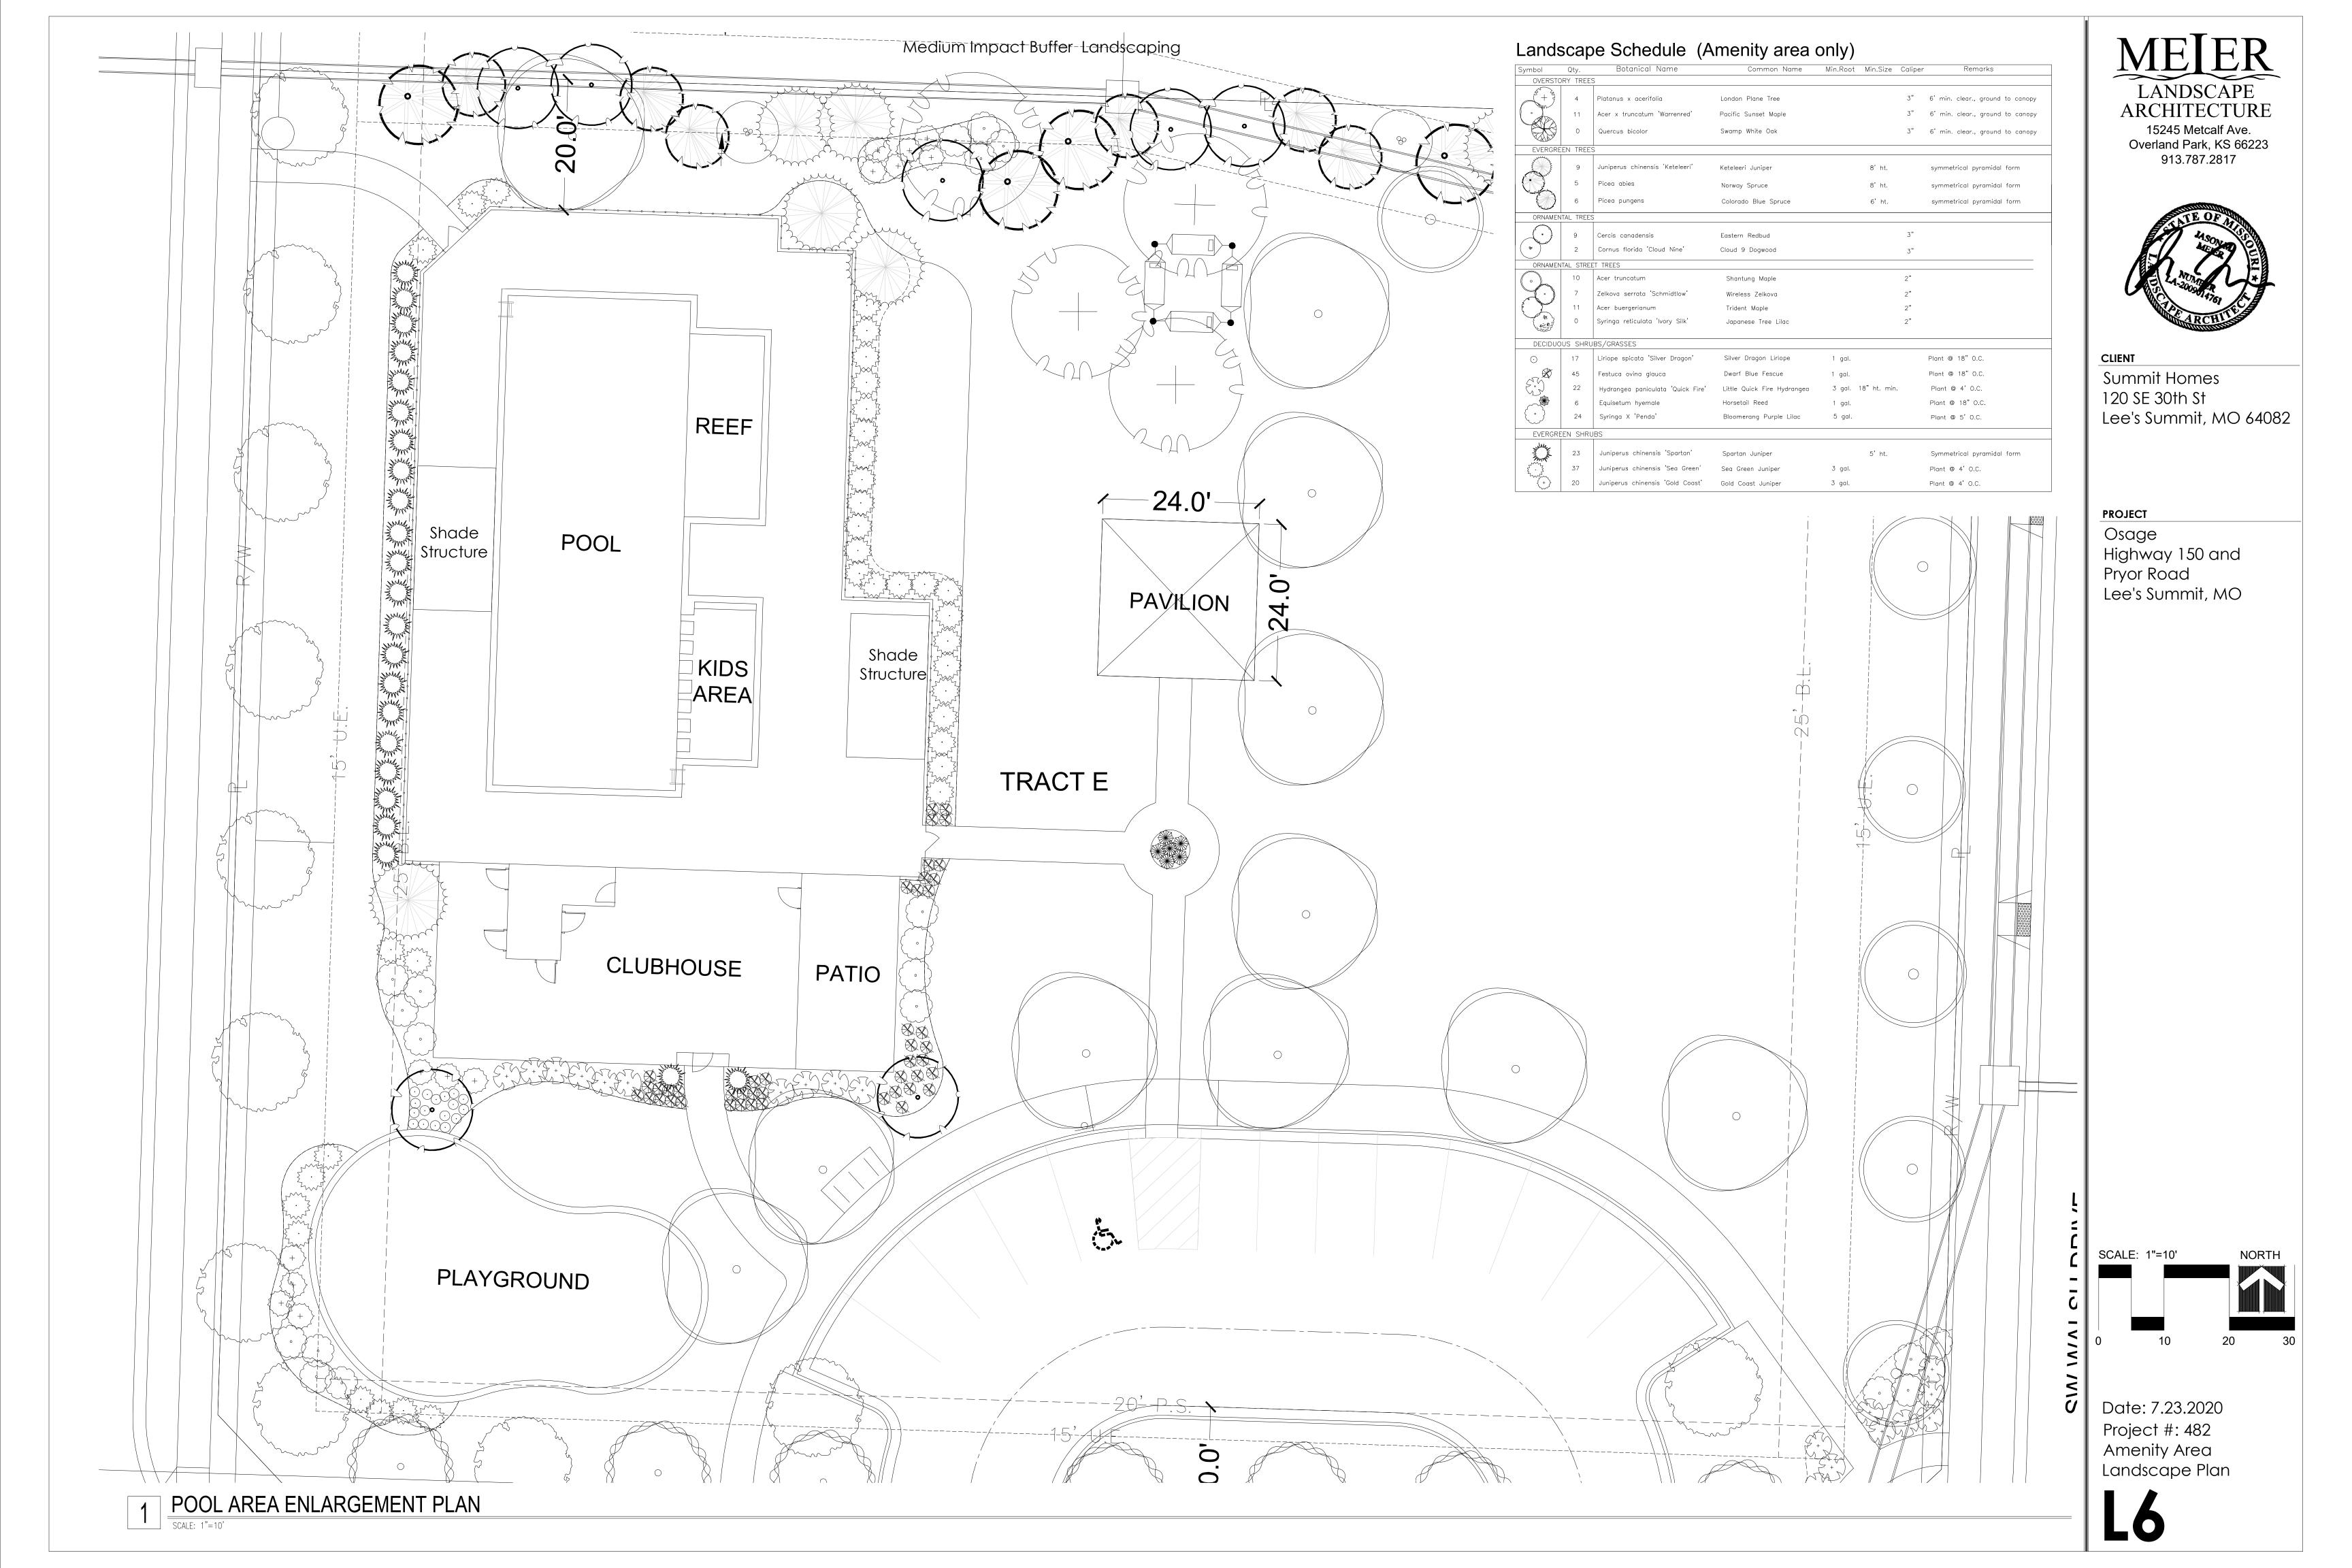



OSAGE CLUBHOUSE


2025 SW M 150 HWY LEE'S SUMMIT, MISSOURI

FINAL DEVELOPMENT PLAN: MAY 5, 2020 REVISION #1- CITY COMMENTS: JULY 27, 2020





AERIAL VIEW

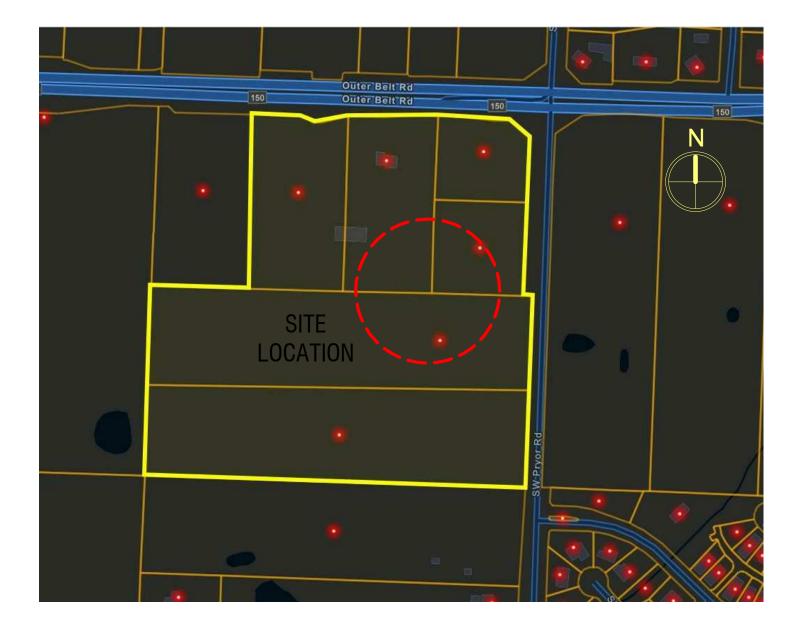

SITE MAP



ARCHITECT

B + A ARCHITECTURE

00 W 31ST STREET, SUITE 100

(ANSAS CITY, MO 64108
PH: 816-753-6100

CIVIL ENGINEER

OLSSON

1301 BURLINGTON STREET, SUITE 100

NORTH KANSAS CITY, MO 64116

PH: 816-361-1177

LANDSCAPE ARCHITECT

JASON MEIER

15245 METCALF AVE.

OVERLAND PARK, KS 66223
PH: 913-787-2817

DEVELOPER
SUMMIT HOMES
120 SE 30TH STREET
LEE'S SUMMIT, MO 64082
PH: 816-246-6700

<u>INDEX</u>

A100 FLOOR PLAN A101 ROOF PLAN A200 ELEVATIONS A201 ELEVATIONS

EL-1 EXTERIOR LIGHTING PLAN

U.N.O.
SEE FINISH SCHEDULE ON SHEET A800 FOR MATERIAL INFORMATION

5. SEE FINISH SCHEDULE ON SHEET A800 FOR MATE 5. SEE DOOR/WINDOW SCHEDULE ON SHEET A600 6. SEE SHEET A400 FOR ENLARGED FLOOR PLANS

WALL TYPES

E1 EXTERIOR WALL, 2X6 WOOD STUD,

RE: DETAIL 1 / A002

EXTERIOR WALL, 2X6 WOOD STUD,
STONE VENEER FINISHING, INSULATED
RE: DETAIL 2 / A002

STUCCO FINISHING, INSULATED

RE: DETAIL 2 / A002

EXTERIOR COLUMN WRAP, WOOD
COLUMN, STUCCO FINISHING / STONE
VENEER BASE
RE: DETAILS 3 & 4 / A002

P1 TYPICAL INTERIOR WALL, 2X4 WOOD STUD, GYP. BOARD FINISHING

RE: DETAIL 5 / A002

TYPICAL INTERIOR WALL, 2X4 WOOD STUD, 1 SIDE GYP. BOARD FINISHING RE: DETAIL 6 / A002

RE: DETAIL 7 / A002

TYPICAL INTERIOR WALL, 2X6 WOOD STUD, GYP. BOARD FINISHING - PLUMBING RE: DETAIL 8 / A002

P3 TYPICAL INTERIOR WALL, 2X6 WOOD

STUD, GYP. BOARD FINISHING




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B+A ARCHITECTURE
100 W 31ST STREET, SUITE 100
KANSAS CITY, MO 64108
PH: 816-753-6100


CIVIL ENGINEER
OLSSON
1301 BURLINGTON STREET, SUITE 100
NORTH KANSAS CITY, MO 64116
PH: 816-361-1177

LANDSCAPE ARCHITECT JASON MEIER 15245 METCALF AVE. OVERLAND PARK, KS 66223 PH: 913-787-2817

> CLUBHOUSE 5 SW M 150 HWY SUMMIT, MISSOURI

OSAGE 2025 LEE'S SI

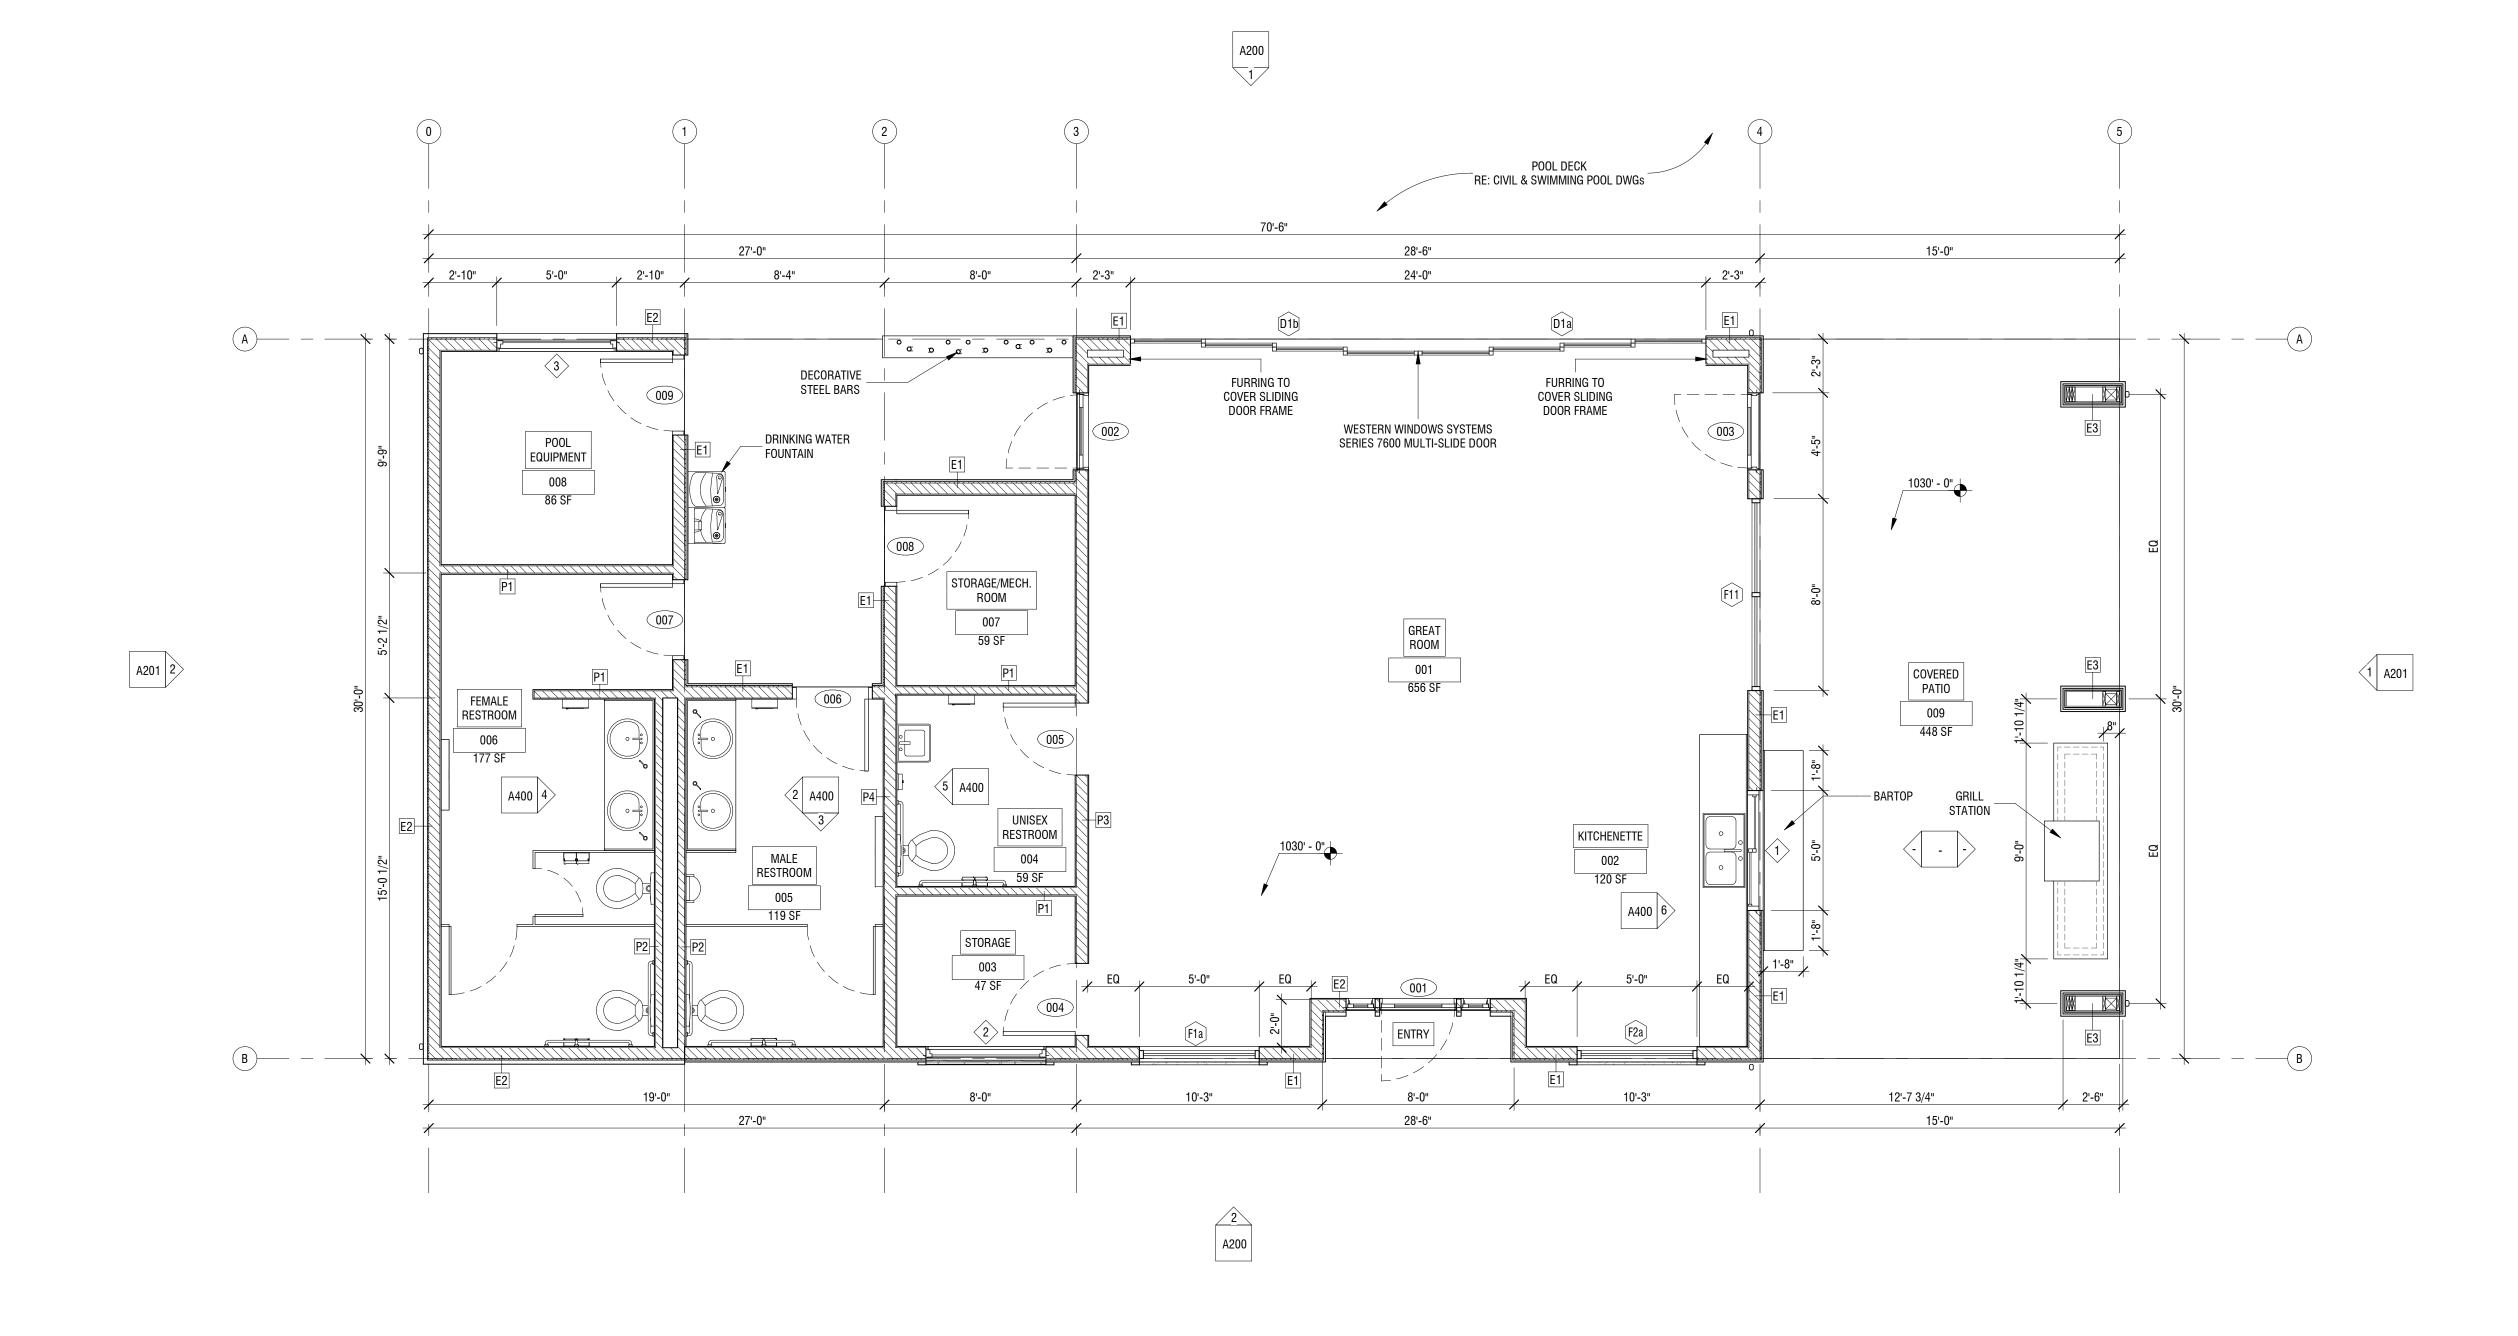

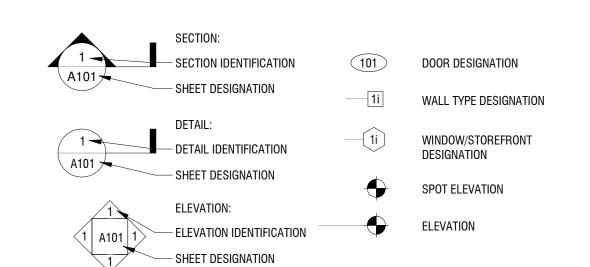



DATE ISS	UED: MAY 5, 2020	
NO.	REVISION	DATE

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A100

GENERAL NOTES

- REFER TO STRUCTURAL DRAWINGS FOR FRAMING INFORMATION
 INSTALL ALL ROOF PENETRATIONS AND EQUIPMENT (IE, VENT PIPES,
- ROOF VENTILATORS) ON THE REAR SIDE OF THE ROOF, TO THE GREATEST EXTENT POSSIBLE
 . REFER TO PLUMBING DRAWINGS FOR ROOF DRAINS AND OVERFLOW


ARCHITECTURE


ARCHITECT
B+A ARCHITECTURE
100 W 31ST STREET, SUITE 100
KANSAS CITY, MO 64108
PH: 816-753-6100

CIVIL ENGINEER
OLSSON
1301 BURLINGTON STREET, SUITE 100
NORTH KANSAS CITY, MO 64116
PH: 816-361-1177

LANDSCAPE ARCHITECT JASON MEIER 15245 METCALF AVE. OVERLAND PARK, KS 66223 PH: 913-787-2817

> CLUBHOUSE 5 SW M 150 HWY SUMMIT, MISSOURI

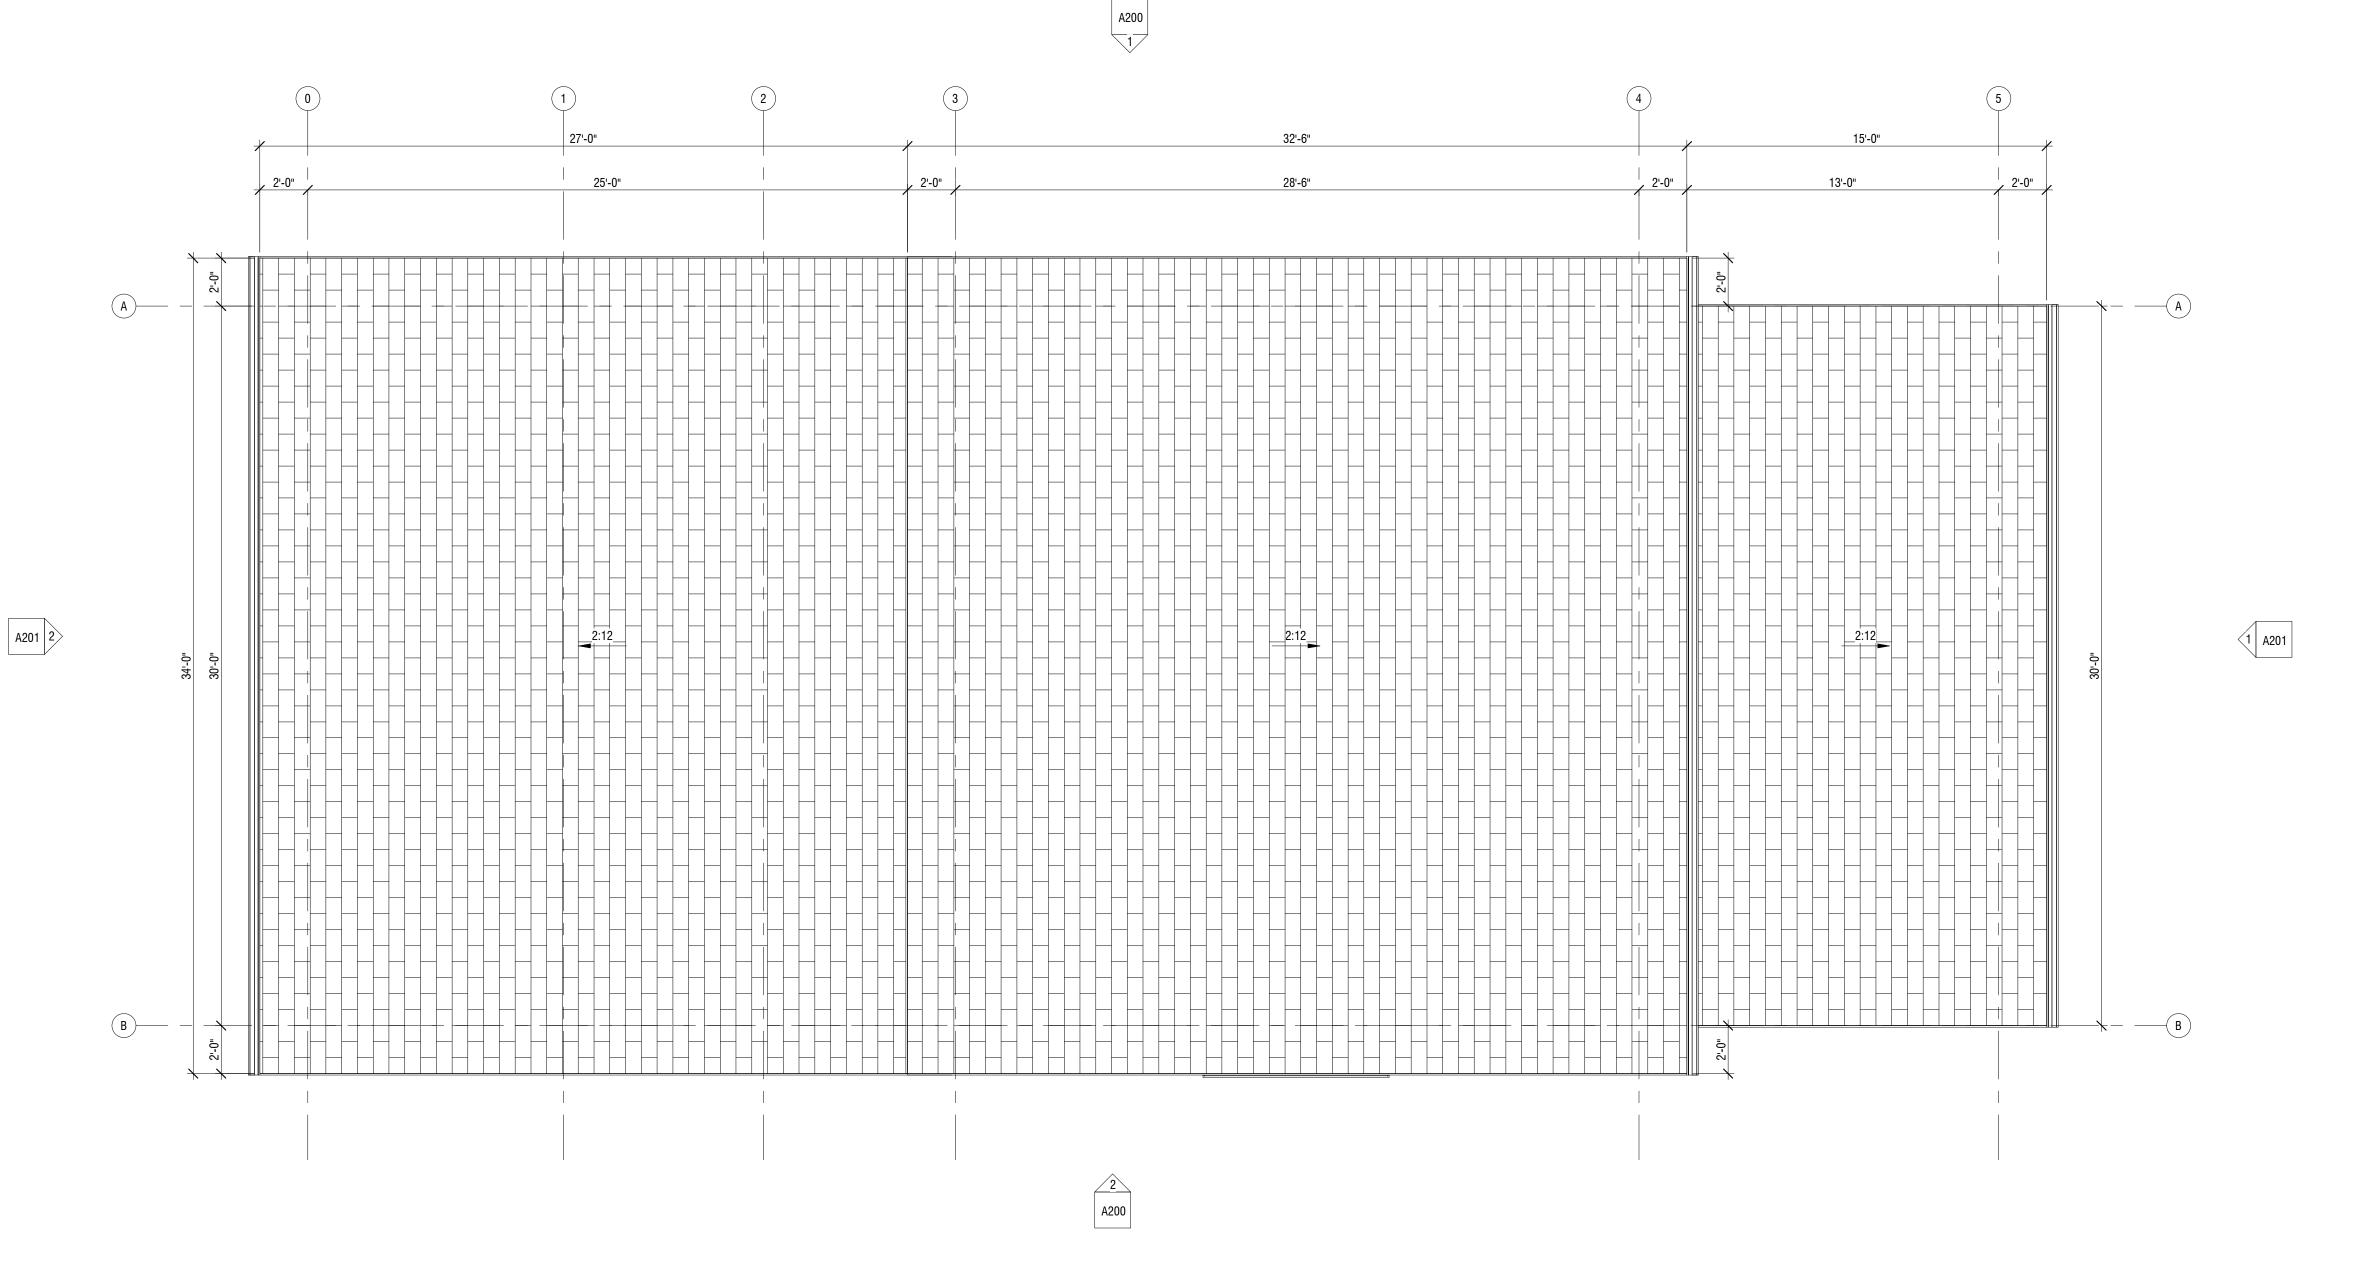

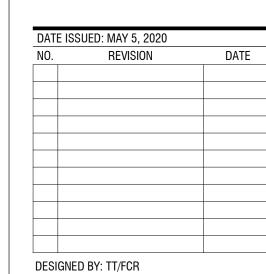

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ROOF PLAN

GREATEST EXTENT POSSIBLE

INSTALL ALL ROOF PENETRATIONS AND EQUIPMENT (IE; VENT PIPES;

ROOF VENTILATORS) ON THE REAR SIDE OF THE ROOF, TO THE



SHINGLES











STONE VENEER COMPOSITION PT-1: SW9170 PT-2: SW7020 PT-3: SW7068

EXTERIOR FINISHING SCHEDULE

NO.	MATERIAL/ITEMS	DESCRIPTION	COLOR/FINISH
1	COMPOSITION SHINGLES	TAMKO, HERITAGE PREMIUM OR EQUAL	WEATHERED WOOD
2	STONE VENEER	CANYON STONE OR EQUAL	CANYON LEDGE/ COLOR: MOUNTAIN
3	CEMENTITIOUS STUCCO	DRYVIT, "OUTSULATION PLUS" OR EQUAL	PT-1: ACIER SW9170
4	FASCIA	SMART TRIM, LP OR EQUAL	PT-2: BLACK FOX SW7020
5	SOFFIT	SMART TRIM, LP OR EQUAL	COLOR: PT-2
6	TRIM	STUCCO FOAM TRIM	PT-3: GRIZZLE GRAY SW7068
7	GUTTER	24 GA. STEEL	MATCH TO WINDOW COLOR
8	WINDOWS	ANDERSEN ARCH. COLLECTION OR EQUAL	METAL - MATTE BLACK
9	EXTERIOR DOORS	METAL PANEL, PAINTED	MATCH TO WINDOW COLOR

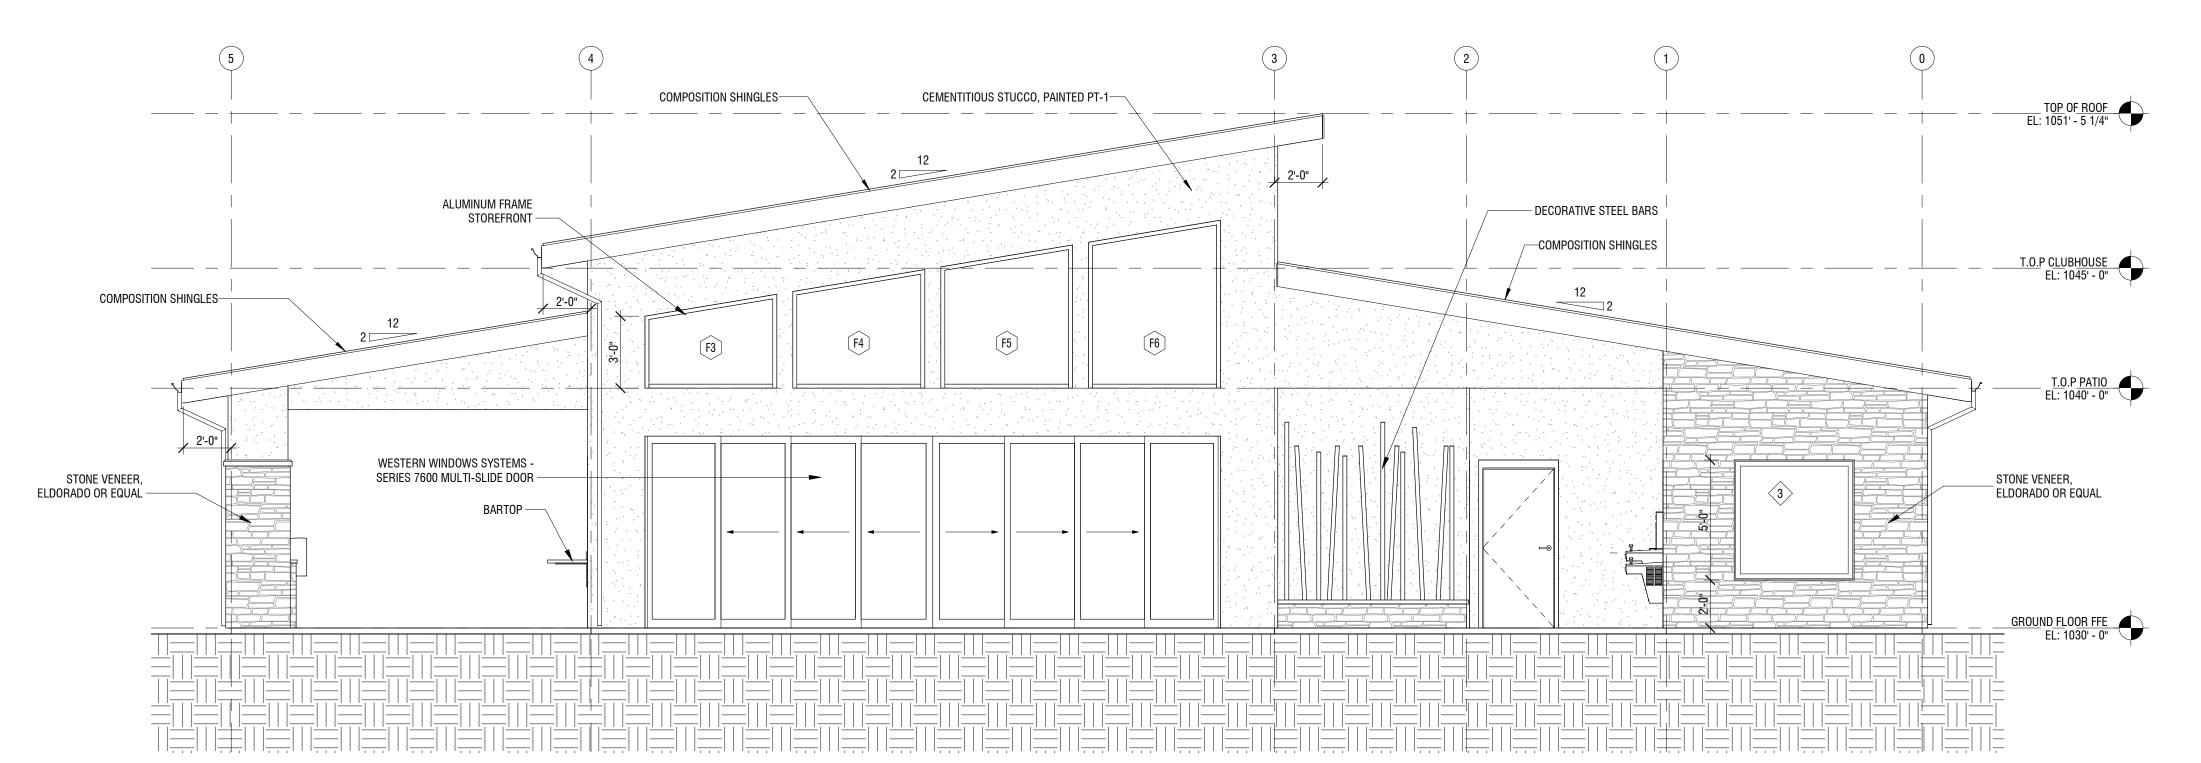

NORTH ELEVATION 1/4" = 1'-0"

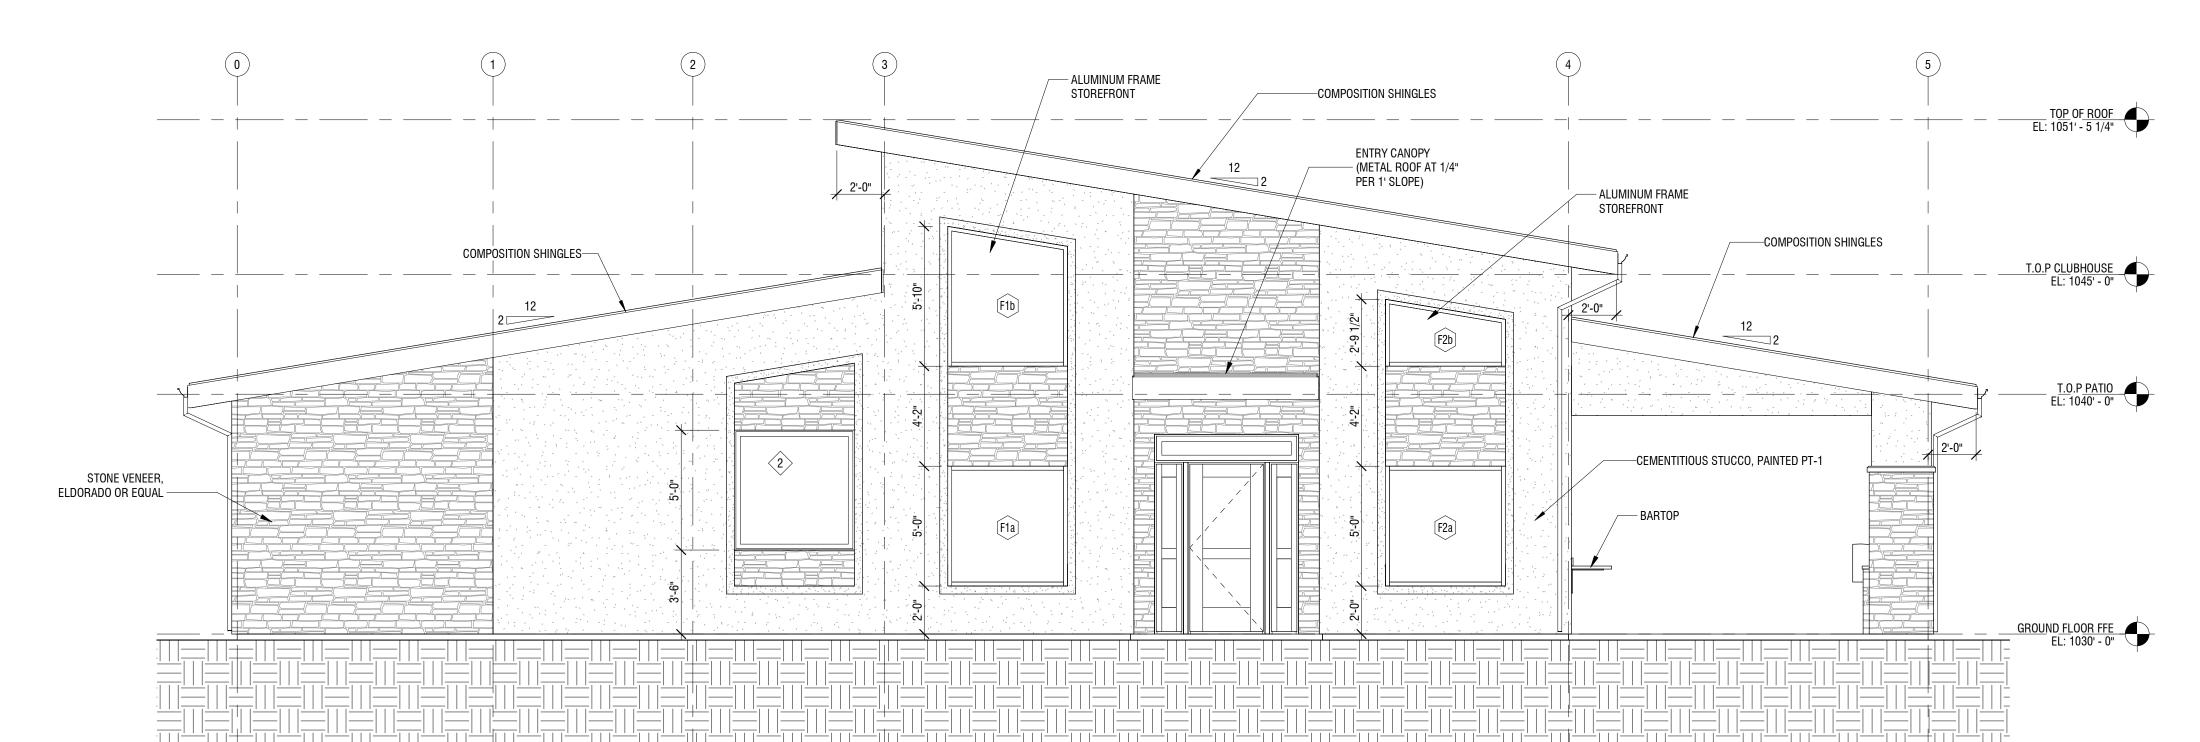



UBHOUSE OSAGE 2025 LEE'S SI

ARCHITECT

CIVIL ENGINEER OLSSON

PH: 816-361-1177

PH: 913-787-2817

LANDSCAPE ARCHITECT JASON MEIER 15245 METCALF AVE. OVERLAND PARK, KS 66223

B+A ARCHITECTURE

100 W 31ST STREET, SUITE 100 KANSAS CITY, MO 64108 PH: 816-753-6100

1301 BURLINGTON STREET, SUITE 100 NORTH KANSAS CITY, MO 64116

DAT	TE ISSUED: MAY 5, 2020	
NO.	REVISION	DATE
1	City Comments - FDP	06/16/2020

DESIGNED BY: TT/FCR DRAWN BY: FCR CHECKED BY: TT/DMB

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GREATEST EXTENT POSSIBLE

SPLIT SYSTEM W/ GROUND MOUNTED CONDENSORS TO BE SCREENED FROM VIEWS BY LANDSCAPING INSTALL ALL ROOF PENETRATIONS AND EQUIPMENT (IE; VENT PIPES; ROOF VENTILATORS) ON THE REAR SIDE OF THE ROOF, TO THE













STONE VENEER COMPOSITION SHINGLES


PT-1: SW9170 PT-2: SW7020 PT-3: SW7068

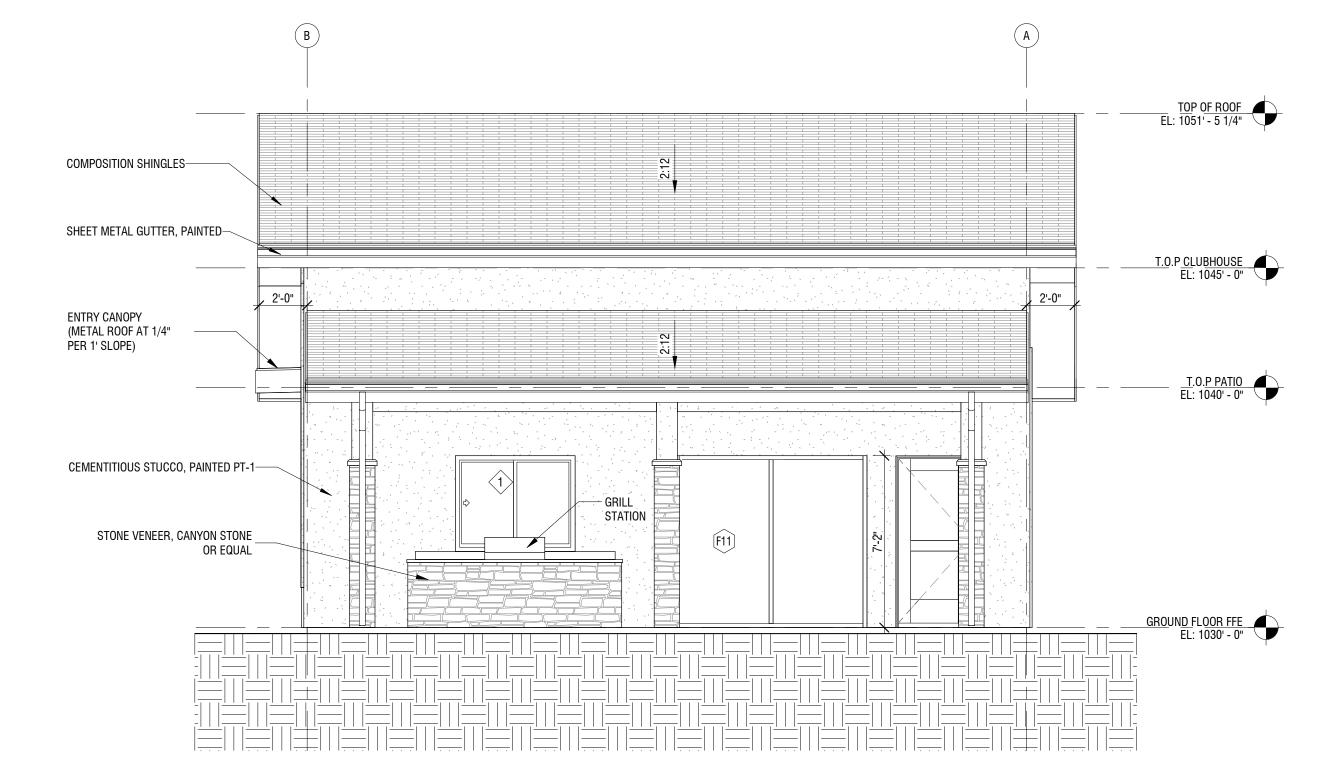

EAST ELEVATION

1/4" = 1'-0"

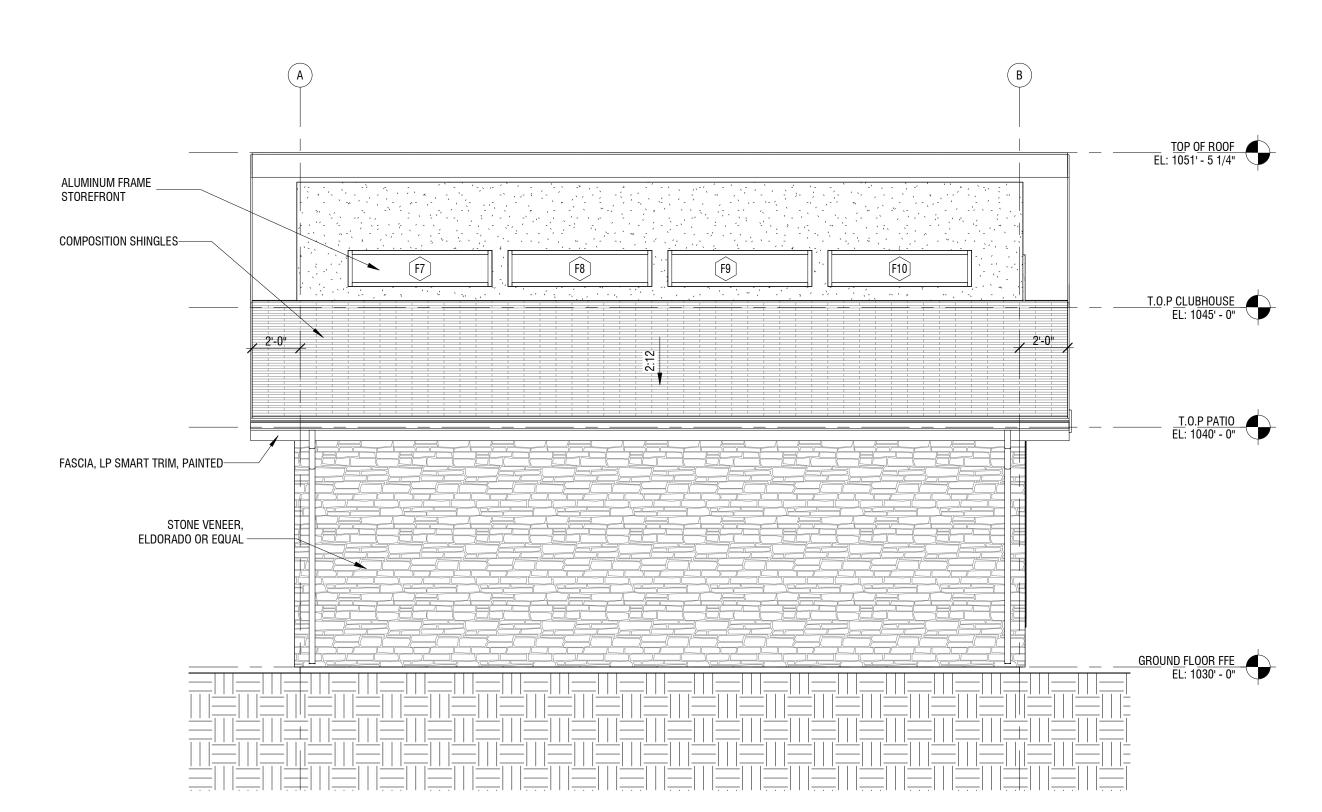

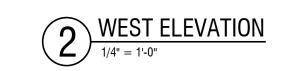

EXTERIOR FINISHING SCHEDULE

10.	MATERIAL/ITEMS	DESCRIPTION	COLOR/FINISH
	COMPOSITION SHINGLES	TAMKO, HERITAGE PREMIUM OR EQUAL	WEATHERED WOOD
2	STONE VENEER	CANYON STONE OR EQUAL	CANYON LEDGE/ COLOR: MOUNTAIN
3	CEMENTITIOUS STUCCO	DRYVIT, "OUTSULATION PLUS" OR EQUAL	PT-1: ACIER SW9170
	FASCIA	SMART TRIM, LP OR EQUAL	PT-2: BLACK FOX SW7020
j i	SOFFIT	SMART TRIM, LP OR EQUAL	COLOR: PT-2
6	TRIM	STUCCO FOAM TRIM	PT-3: GRIZZLE GRAY SW7068
,	GUTTER	24 GA. STEEL	MATCH TO WINDOW COLOR
3	WINDOWS	ANDERSEN ARCH. COLLECTION OR EQUAL	METAL - MATTE BLACK
)	EXTERIOR DOORS	METAL PANEL, PAINTED	MATCH TO WINDOW COLOR

B+A ARCHITECTURE

CIVIL ENGINEER OLSSON

PH: 816-361-1177

PH: 913-787-2817

LANDSCAPE ARCHITECT JASON MEIER 15245 METCALF AVE. OVERLAND PARK, KS 66223

100 W 31ST STREET, SUITE 100 KANSAS CITY, MO 64108 PH: 816-753-6100

1301 BURLINGTON STREET, SUITE 100 NORTH KANSAS CITY, MO 64116

ARCHITECT

CLUBHOUSE 5 SW M 150 HWY SUMMIT, MISSOURI OSAGE 2025 LEE'S SI

REVISION

1 City Comments - FDP

DESIGNED BY: TT/FCR DRAWN BY: FCR

CHECKED BY: TT/DMB


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DATE

06/16/2020





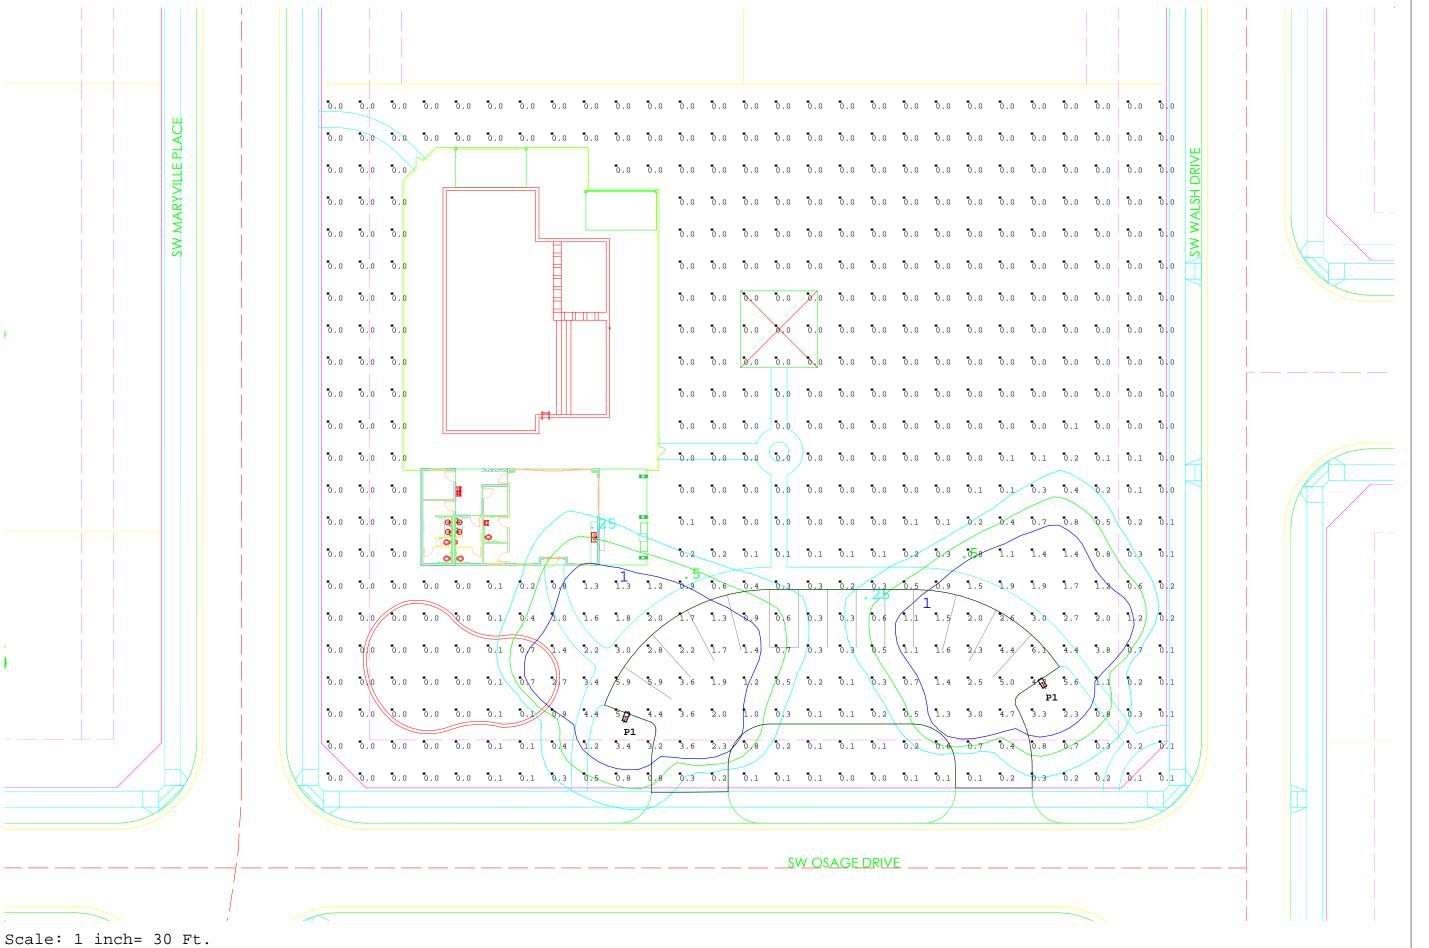

Calculated By: Kevin Hooey	Co	Light Loss Factor	0.91
Requested By:	alc	Calculation plane 0'-00"	.00-0
Date:3/11/2020	. In	Reflectances	٧Z
Scale: N/A	fo	o Mounting height	15'

Summit Homes
Osage Pool
Site-Galleon 1

Page 1 of 2



Galleon

DISCLAIMER:

These calculations have been performed according to IES standards and good practice. There may be differences between measured values and the results presented herin, based on the extent in which field conditions deviate from the input data. These conditions include room dimensions, luminaire position, surface reflectances, architectural elements and furniture, temperature, voltage, measurement techniques and equipment tolerances. All attached drawings and images are for photometric reference only they are not made for construction.

AREA INFORMATION:

Area label: Wall height: 0'-00" Mounting height: 15' Reflectences: NA

Calculation Summary						
Label	Units	Avg	Max	Min	Avg/Min	Max/Min
Site_Surface	Fc	0.43	6.1	0.0	N.A.	N.A.
Parking Lot	Fc	1.65	6.1	0.1	16.50	61.00

Lumi	naire Sc	chedule					
Symb	ool	Qty	Label	Description	Lum. Watts	Lum. Lumens	LLF
	-	2	P1	GLEON-AF-02-LED-E1-T4FT	113	12533	0.910

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	DOLO

\vdash				
	Comments			
	Date			
	#			
	Re	vis	io	ns

Calculated By: Kevin Hooey
Requested By:
Date:3/11/2020
♦ /☑: <u>•</u> ☑ ∪ ∪

Summit Homes Osage Pool Site-Galleon 1

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