


Public Street and Storm For Sequoia Residential

Lee's Summit, Jackson County, Missouri
Total Project Area: 3.78 Acres (164,565.80 SF)

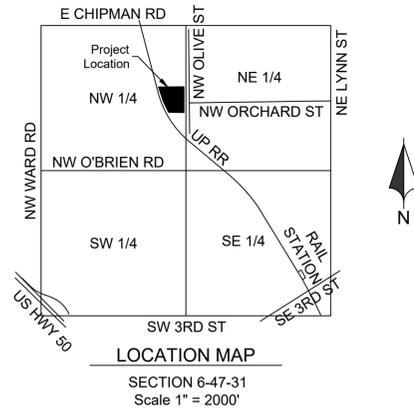

Sheet List Table

Sheet Number	Sheet Title
01	Title Sheet
02	General Notes & Quantities
03	Roadway Typical Section
04	General Layout
05	Grading Plan
06	Utility Plan
07	Signing Plan
08	Drainage Plan
09	Street Plan & Profile
10	Storm Plan & Profile
11	Sanitary Plan
12	Sanitary Plan & Profile
13	Waterline Plan & Profile
14	Erosion Control Phase I
15	Erosion Control Phase II
16	Erosion Control Phase III
17	Standard Details
18	Standard Details
19	Standard Details
20	Standard Details

Public Street And Storm Plans
18-0251
Sequoia Residential
Lee's Summit, Jackson County, MO

Title Sheet

LEGAL DESCRIPTION
Lot 1, 2, and 3, EXCEPT the North 140 feet of the East 150 feet of Lot 3, HEARNE'S ADDITION, (aka/ HEARNES FIRST ADDITION) and the North Half of vacated Orchard Street lying South and adjacent, a subdivision in Lee's Summit, Jackson County, Missouri.

Lot 22, and 23, HEARNE'S ADDITION, a subdivision in Lee's Summit, Jackson County, Missouri, EXCEPT the South 8 feet of the West 50 feet of Lot 22 and also EXCEPT, the South 8 feet of Lot 23, and ALSO EXCEPT the South 88 feet of the East 150 feet of Lot 22, together with the South 1/2 of vacated Orchard Street lying North of and Adjacent to the said premises in question.


BENCHMARK:
BM-A: 1.0 mi NW along the Missouri Pacific Railroad from the station at Lee's Summit, at the crossing of Sheer Road, 86 ft southeast of the center line of Sheer Road, 36 ft northeast of the northwest rail, 28.4 ft southeast of a telephone pole, 697 ft southwest of a fence, 1.8 ft west of a witness post, set in the top of a concrete post which projects 0.3 ft above the ground. Elev: 994.87
BM-B: 1.3 mi N along the Missouri Pacific Railroad from the station at Lee's Summit, Jackson County, at semaphore 2611, on the top of the concrete base, and 10 ft east of the track. A chiseled square. Elev: 971.80

Oil / Gas Well Note:
There is no visible evident, this date, of abandoned oil or gas wells located within the property boundary, as identified in "Environmental Impact Study of Abandoned Oil and Gas Wells in Lee's Summit, Missouri." (Figure B-4, pg. 91)

Flood Plain Note
We have reviewed the F.E.M.A. Flood Insurance Rate Map Number 29095C0417G, revised January 20, 2017, this tract graphically lies in OTHER AREAS, ZONE X, defined as areas determined to be outside the 0.2% annual chance floodplain.

UTILITIES

WATER & SANITARY SEWER City of Lee's Summit Water Utilities 220 SE Green St Lee's Summit, MO Phone: 816.969.1900	TELEPHONE AT&T Phone: 800.288.2020 Time Warner Cable Phone: 816.222.5952
ELECTRICITY Kansas City Power and Light Phone: 816.471.5275	CABLE TV Comcast Phone: 816.795.1100
GAS Missouri Gas Energy PO Box 219255 Kansas City, Missouri 64141 Phone: 816.756.5252	Time Warner Cable Phone: 816.358.8833

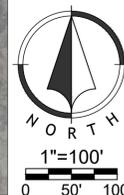

LEGEND

--- Existing Section Line	--- Proposed Right-of-Way
--- Existing Right-of-Way Line	--- Proposed Property Line
--- Existing Lot Line	--- Proposed Lot Line
----- Existing Easement Line	----- Proposed Easement
--- Existing Curb & Gutter	--- Proposed Curb & Gutter
--- Existing Sidewalk	--- Proposed Sidewalk
--- Existing Storm Sewer	--- Proposed Storm Sewer
□ Existing Storm Structure	□ Proposed Storm Structure
--- W/L --- Existing Waterline	A Proposed Fire Hydrant
--- GAS --- Existing Gas Main	--- WATER --- Proposed Waterline
--- Existing Sanitary Sewer	--- SS --- Proposed Sanitary Sewer
⊙ Existing Sanitary Manhole	⊙ Proposed Sanitary Manhole
--- Existing Contour Major	--- Proposed Contour Major
--- Existing Contour Minor	--- Proposed Contour Minor
----- Proposed Asphaltic Pavement	----- Future Curb & Gutter

APPLICATION/OWNER:
Dick Burton
Cherokee Flight LLC
8 SW AA Highway
Kingsville, MO 64061
daburton@mail.com


CIVIL ENGINEER:
Mick Slutter, P.E.
1815 McGee St, #200
Kansas City, MO 64116
msslutter@ric-consult.com

LANDSCAPE ARCHITECT:
Andy Gabbert, PLA
5015 NW Canal St, #100
Riverside, MO 64150
agabbert@ric-consult.com



GENERAL NOTES

- All construction shall follow the City of Lee's Summit Design and Construction Manual as adopted by Ordinance 5813. Where discrepancies exist between the Construction Document and the Design and Construction Manual, the Design and Construction Manual shall govern.
- The contractor will be responsible for securing all bonds, and insurance required by the contract documents, City of Lee's Summit, Mo., and all other governing agencies (including local, county, state, and federal authorities) having jurisdiction over the work proposed by these construction documents. The cost for all bonds, and insurance shall be the contractor's responsibility and shall be included in the bid for the work.
- All existing utilities indicated on the drawings are according to the best information available to the engineer; however, all utilities actually existing may not be shown. The contractor shall be responsible for contacting all utility companies for an exact field location of each utility prior to any construction. All utilities, shown and un-shown, damaged through the negligence of the contractor shall be repaired or replaced by the contractor at his/her expense.
- The contractor will be responsible for all damages to existing utilities, pavement, fences, structures, and other features not designated for removal. The contractor shall repair all damages at his/her expense.
- The demolition of existing pavement, curbs, structures, and all other features necessary to construct the proposed improvements, shall be performed by the contractor. All waste material removed during construction shall be disposed off the project site. The contractor shall be responsible for all permits for hauling and disposing of waste material. The disposal of waste material shall be in accordance with all local, state, and federal regulations.
- By use of these construction documents the contractor hereby agrees that he shall be solely responsible for the safety of the construction workers and the public. The contractor agrees to hold the engineer and owner harmless for any and all injuries, claims, losses, or damages related to the project.
- The contractor will be responsible for providing all signage, barricades, lighting, etc., as required for temporary traffic control during the construction of this project. Maintenance of the temporary traffic control devices will be the contractor's responsibility. All traffic control in conduction with construction in the right-of-way shall be in conformance with the City Traffic Control Requirements.
- Contractor shall furnish evidence that his/her insurance meets the requirements of the City of Lee's Summit, Missouri Municipal Code.
- Prior to installing, constructing, or performing any work on the public storm sewer line (including connecting private drainage systems to the storm sewer), contact Lee Summit Inspections.
- Connections to the public storm sewers between structures will not be permitted.
- Contractor shall verify and accept existing topography shown herein. Contractor shall notify Engineer if any discrepancies are found prior to any earthwork activities.
- Planning and Codes Administration will require a retaining wall design by a registered engineer in the State of Missouri.
- Geogrid, footings, or other elements of the retaining wall(s) cannot encroach into the right of way or public easements.
- A Knox Box shall be provided for Each Building.
- All building and life safety issues shall comply with the 2012 International Fire Code and local amendments as adopted by the City of Lee's Summit.

Renaissance Infrastructure Consulting
1815 MCGEE STREET, SUITE 200
KANSAS CITY, MISSOURI 64108
WWW.RIC-CONSULT.COM

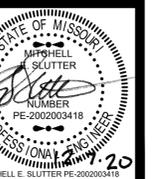


Roadway Typical
Section

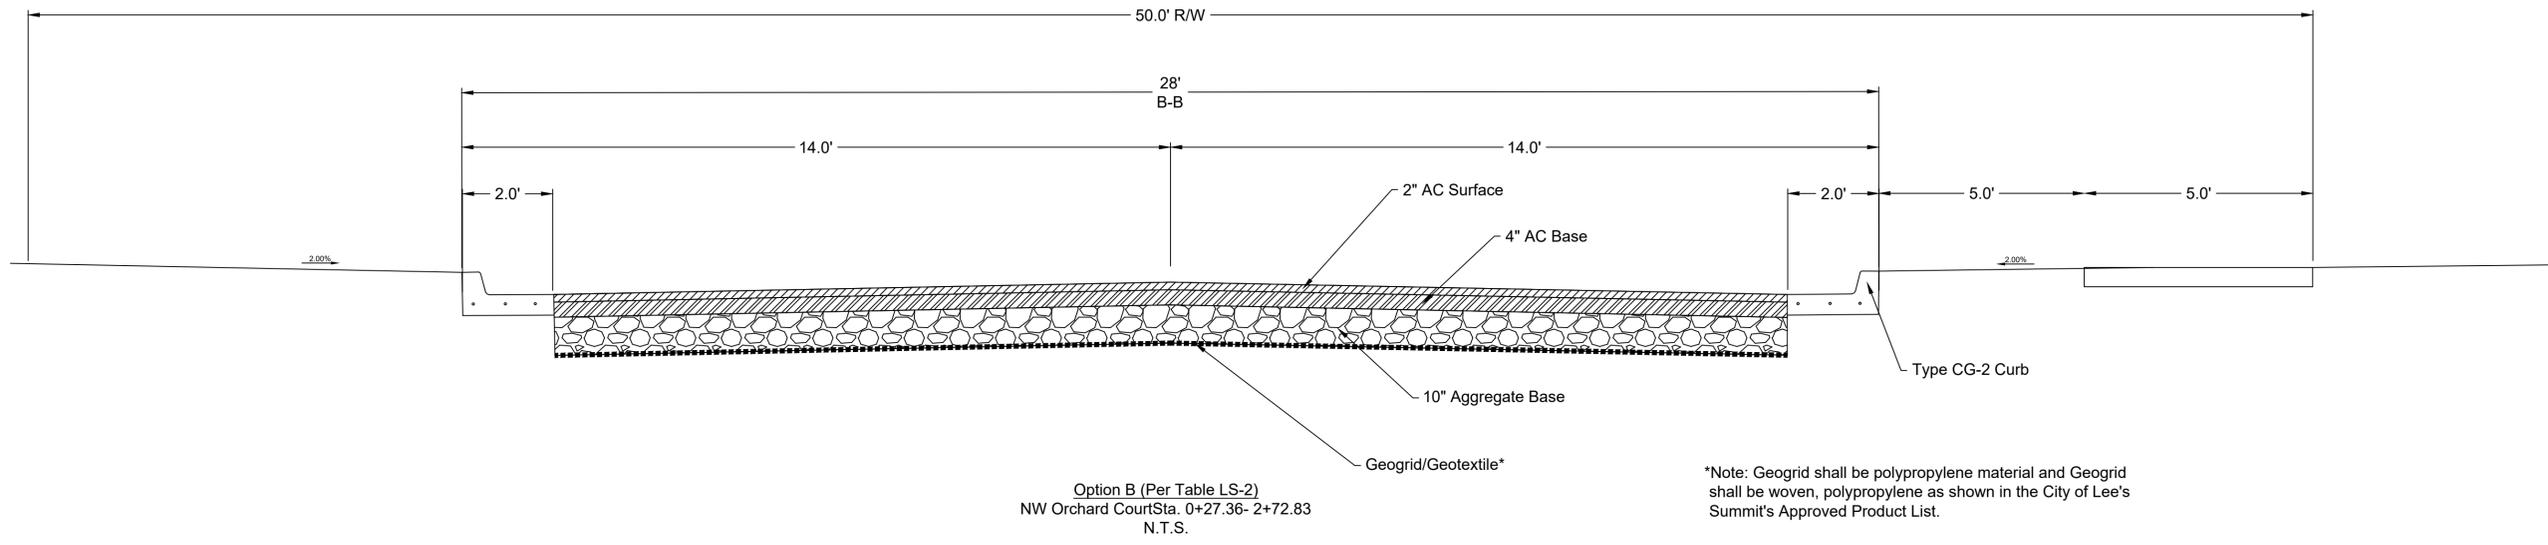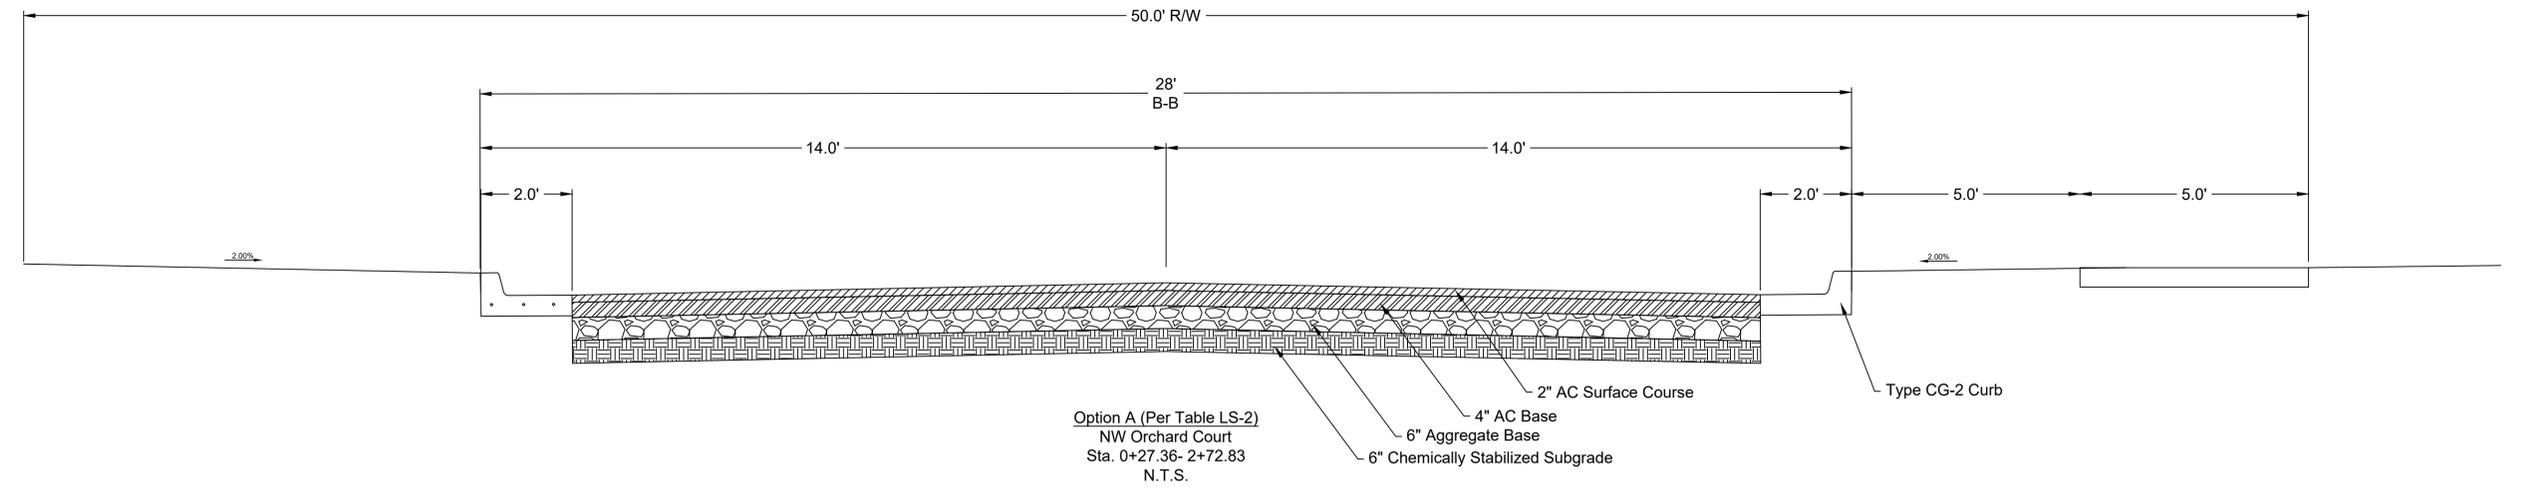


*Note: Geogrid shall be polypropylene material and Geogrid shall be woven, polypropylene as shown in the City of Lee's Summit's Approved Product List.

NO.	BY	CD	DATE	ORIGINAL SUBMISSION	REVISION
1	JGD	MES	06/11/20	PER CITY COMMENT	
2	JGD	MES	06/08/20	PER CITY COMMENT	
3	JGD	MES	08/15/20	PER CITY COMMENT	
4	JGD	MES	10/01/20	PER CITY COMMENT	
5	JGD	MES	12/07/20	WATERLINE REVISION	

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816.800.0950
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KANSAS CITY, MISSOURI 64108
WWW.RIC-CONSULT.COM

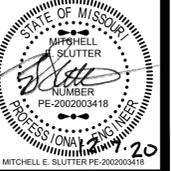

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NO.	BY	DATE	ORIGINAL SUBMISSION	REVISION
1	JDG	06/11/20	ORIGINAL SUBMISSION	
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5	JDG	12/07/20	WATERLINE REVISION	


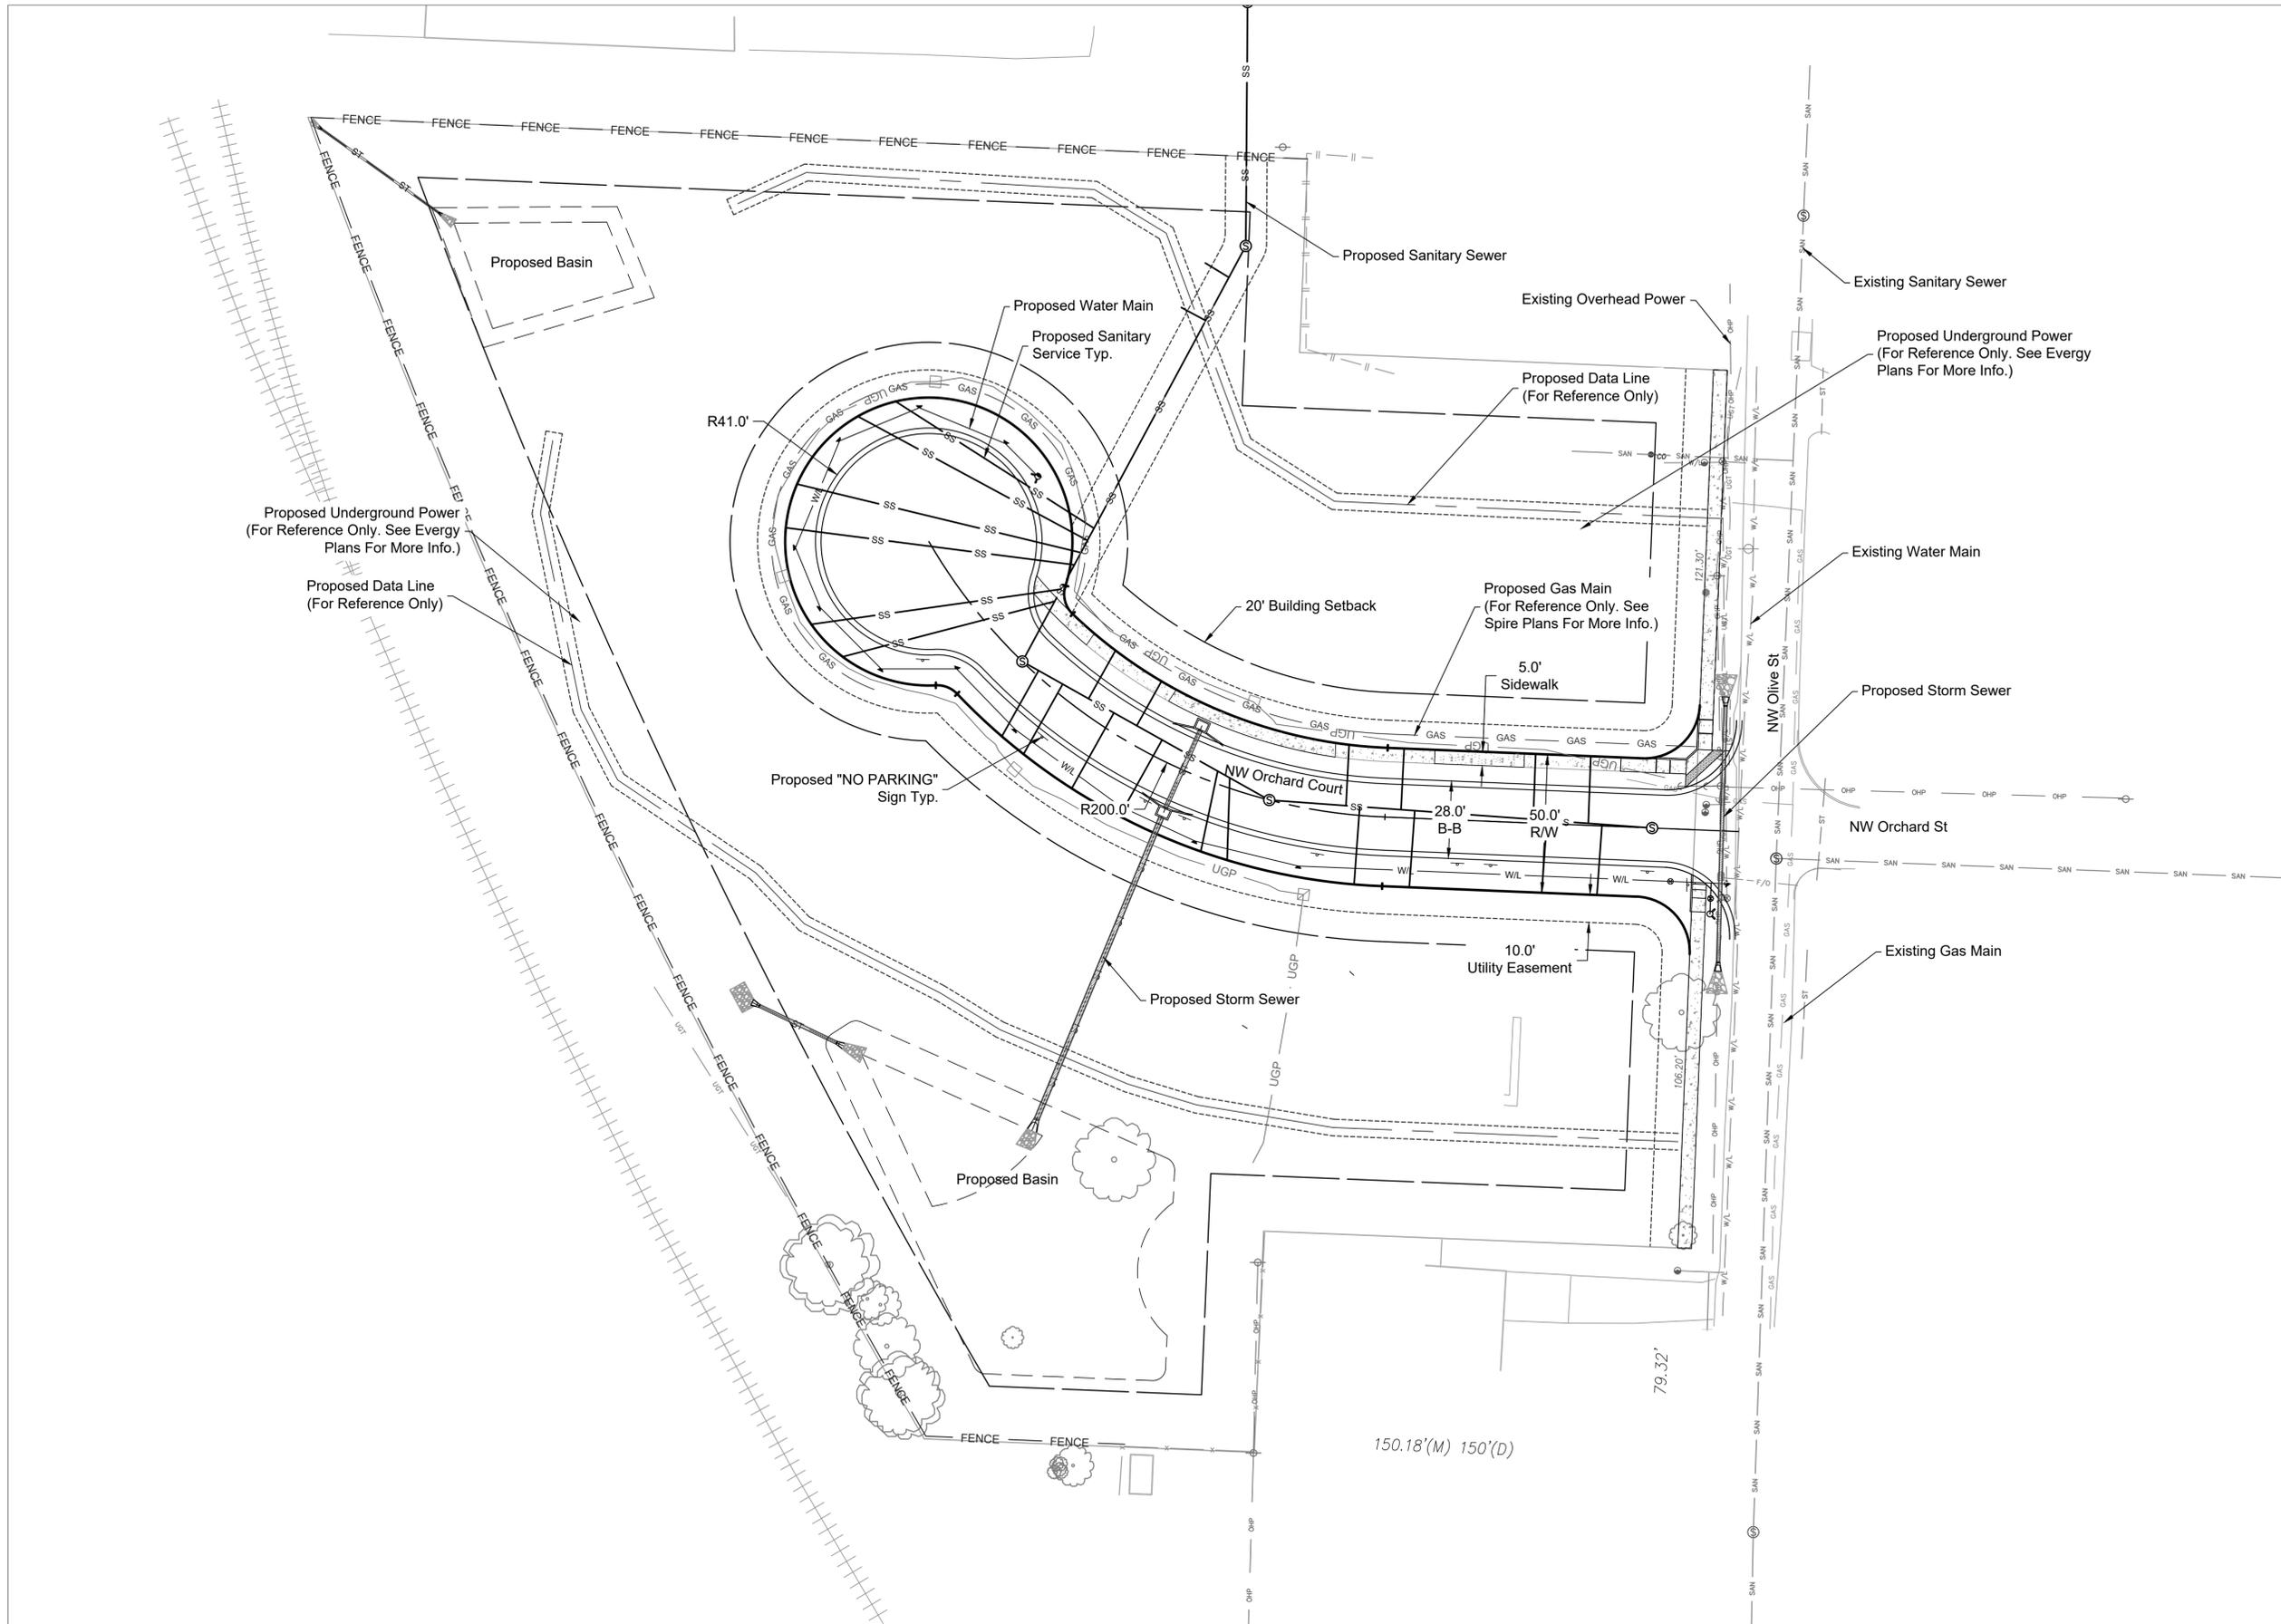
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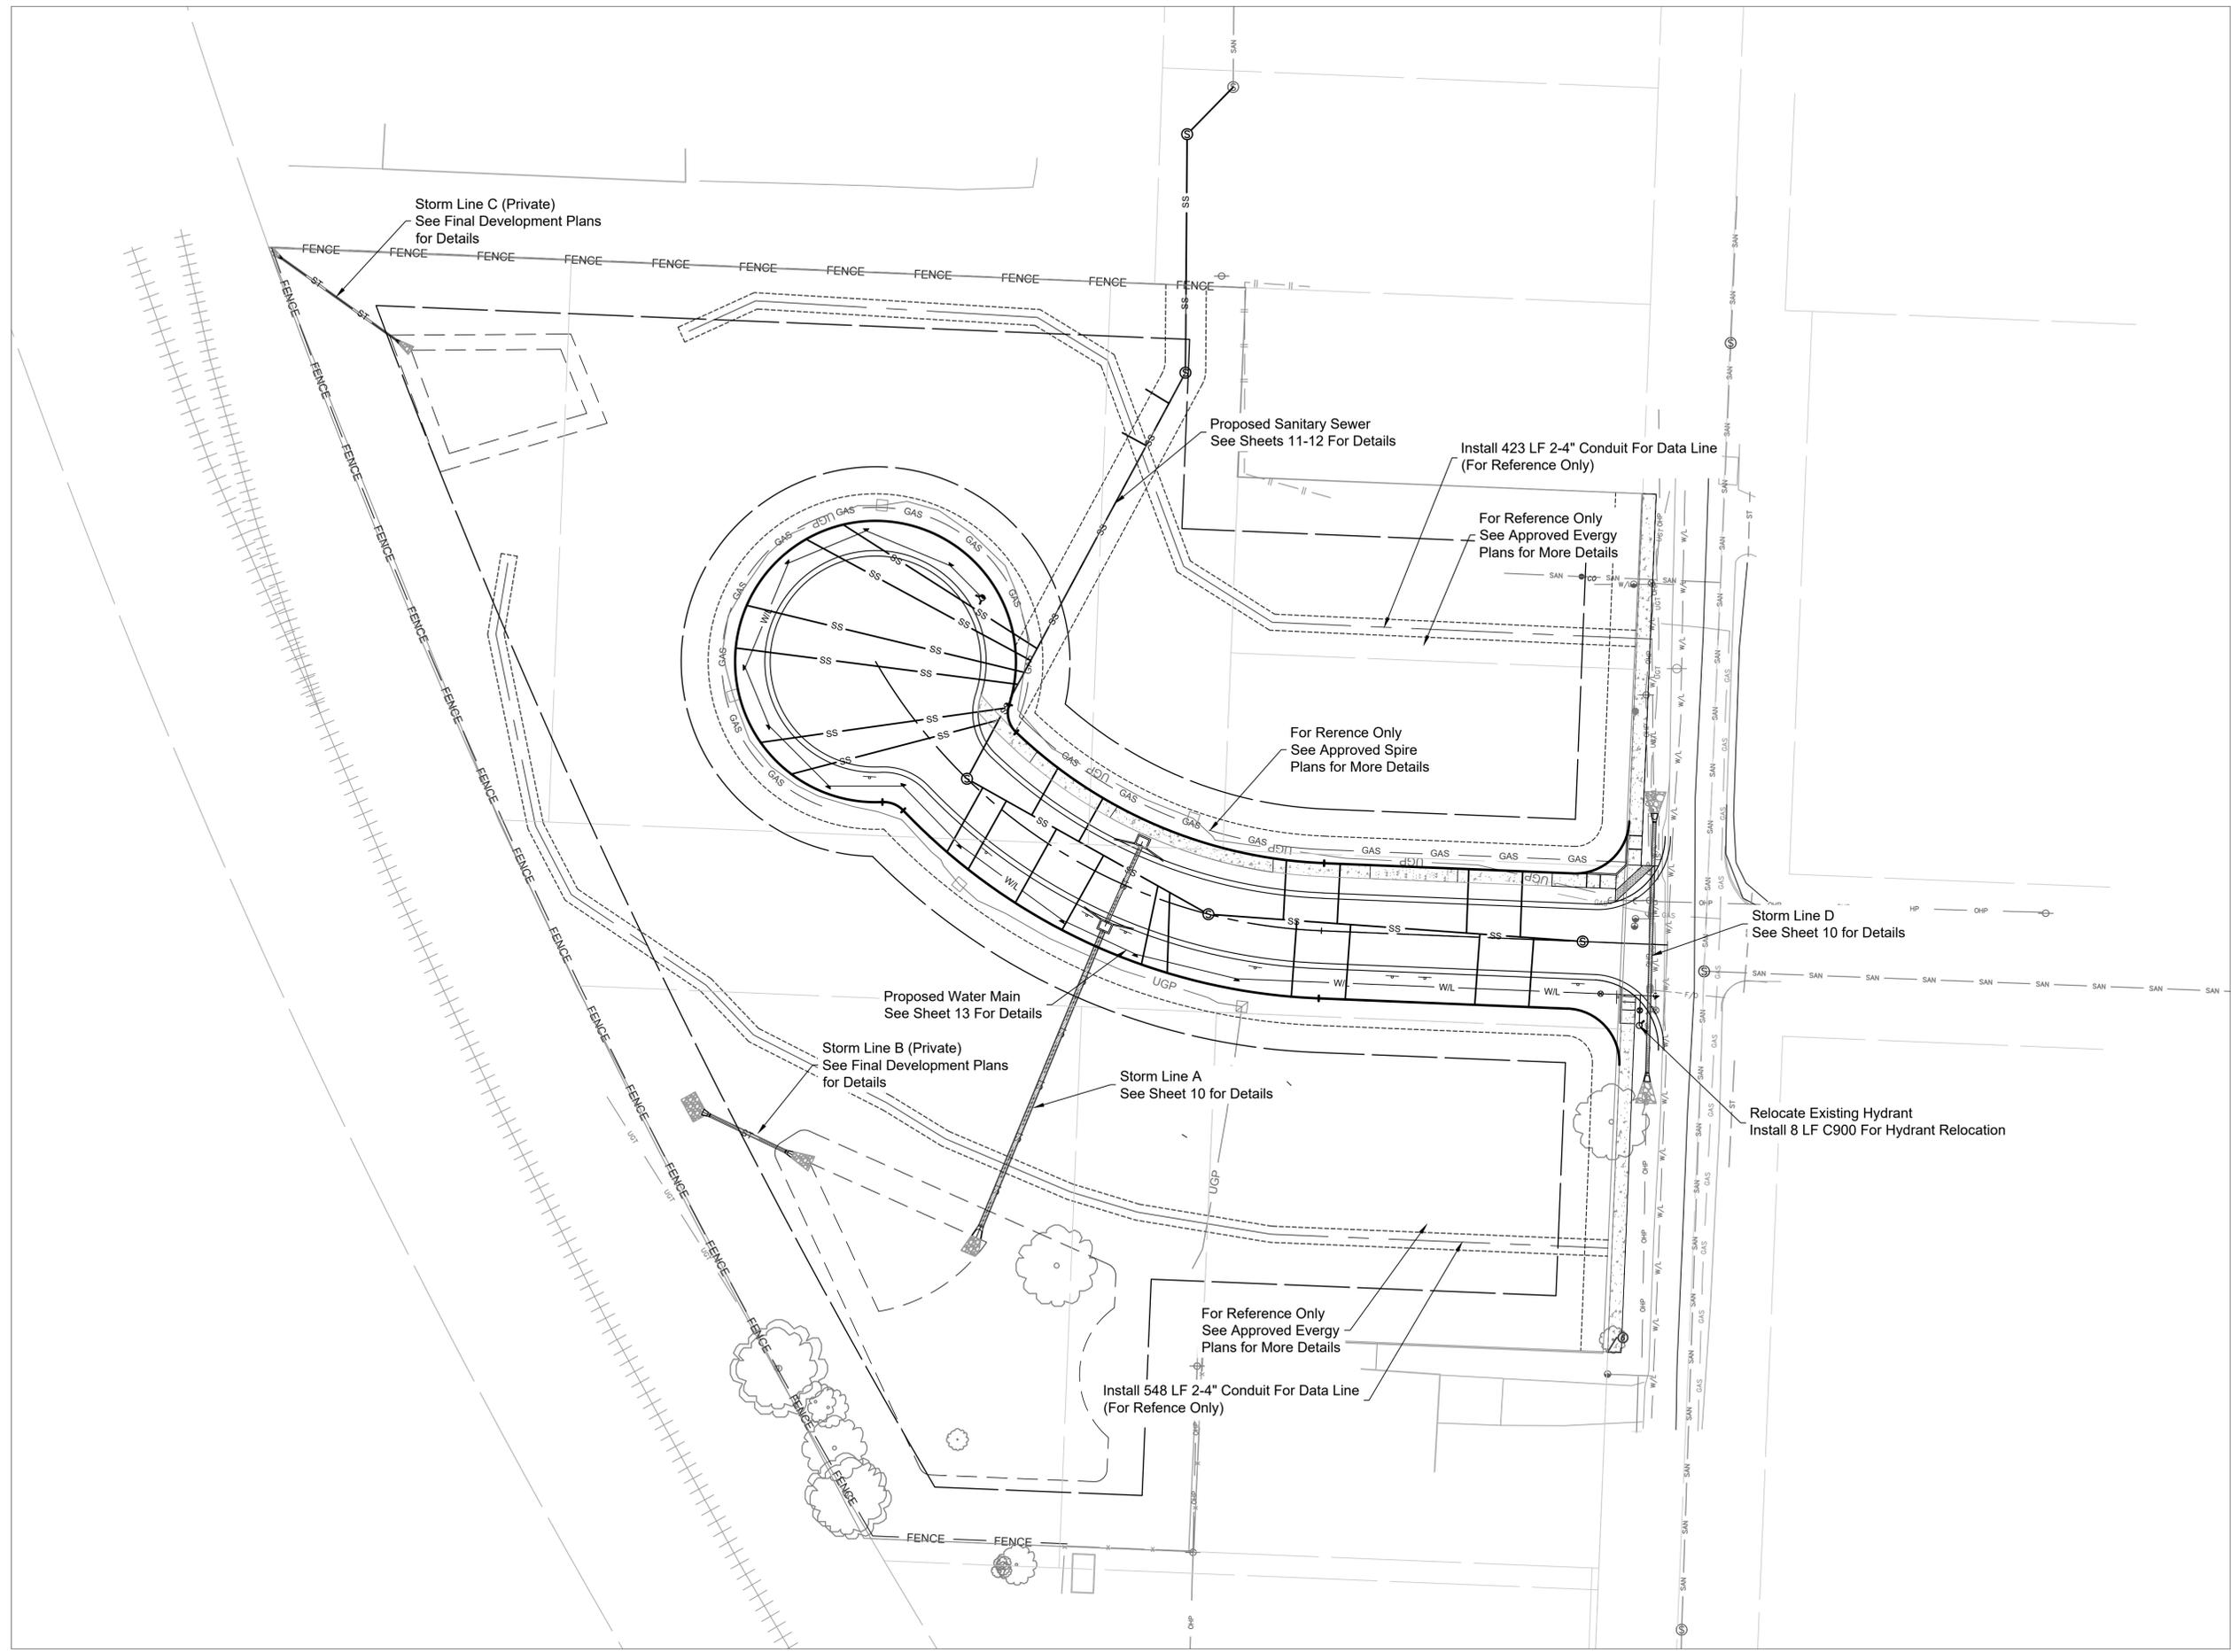


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4	JGD	MES 10/01/20	PER CITY COMMENT	
5	JGD	MES 12/07/20	WATERLINE REVISION	

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Utility Plan



NO.	BY	DATE	DESCRIPTION
1	JGD	06/11/20	ORIGINAL SUBMISSION
2	JGD	06/11/20	PER CITY COMMENT
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4	JGD	10/01/20	PER CITY COMMENT
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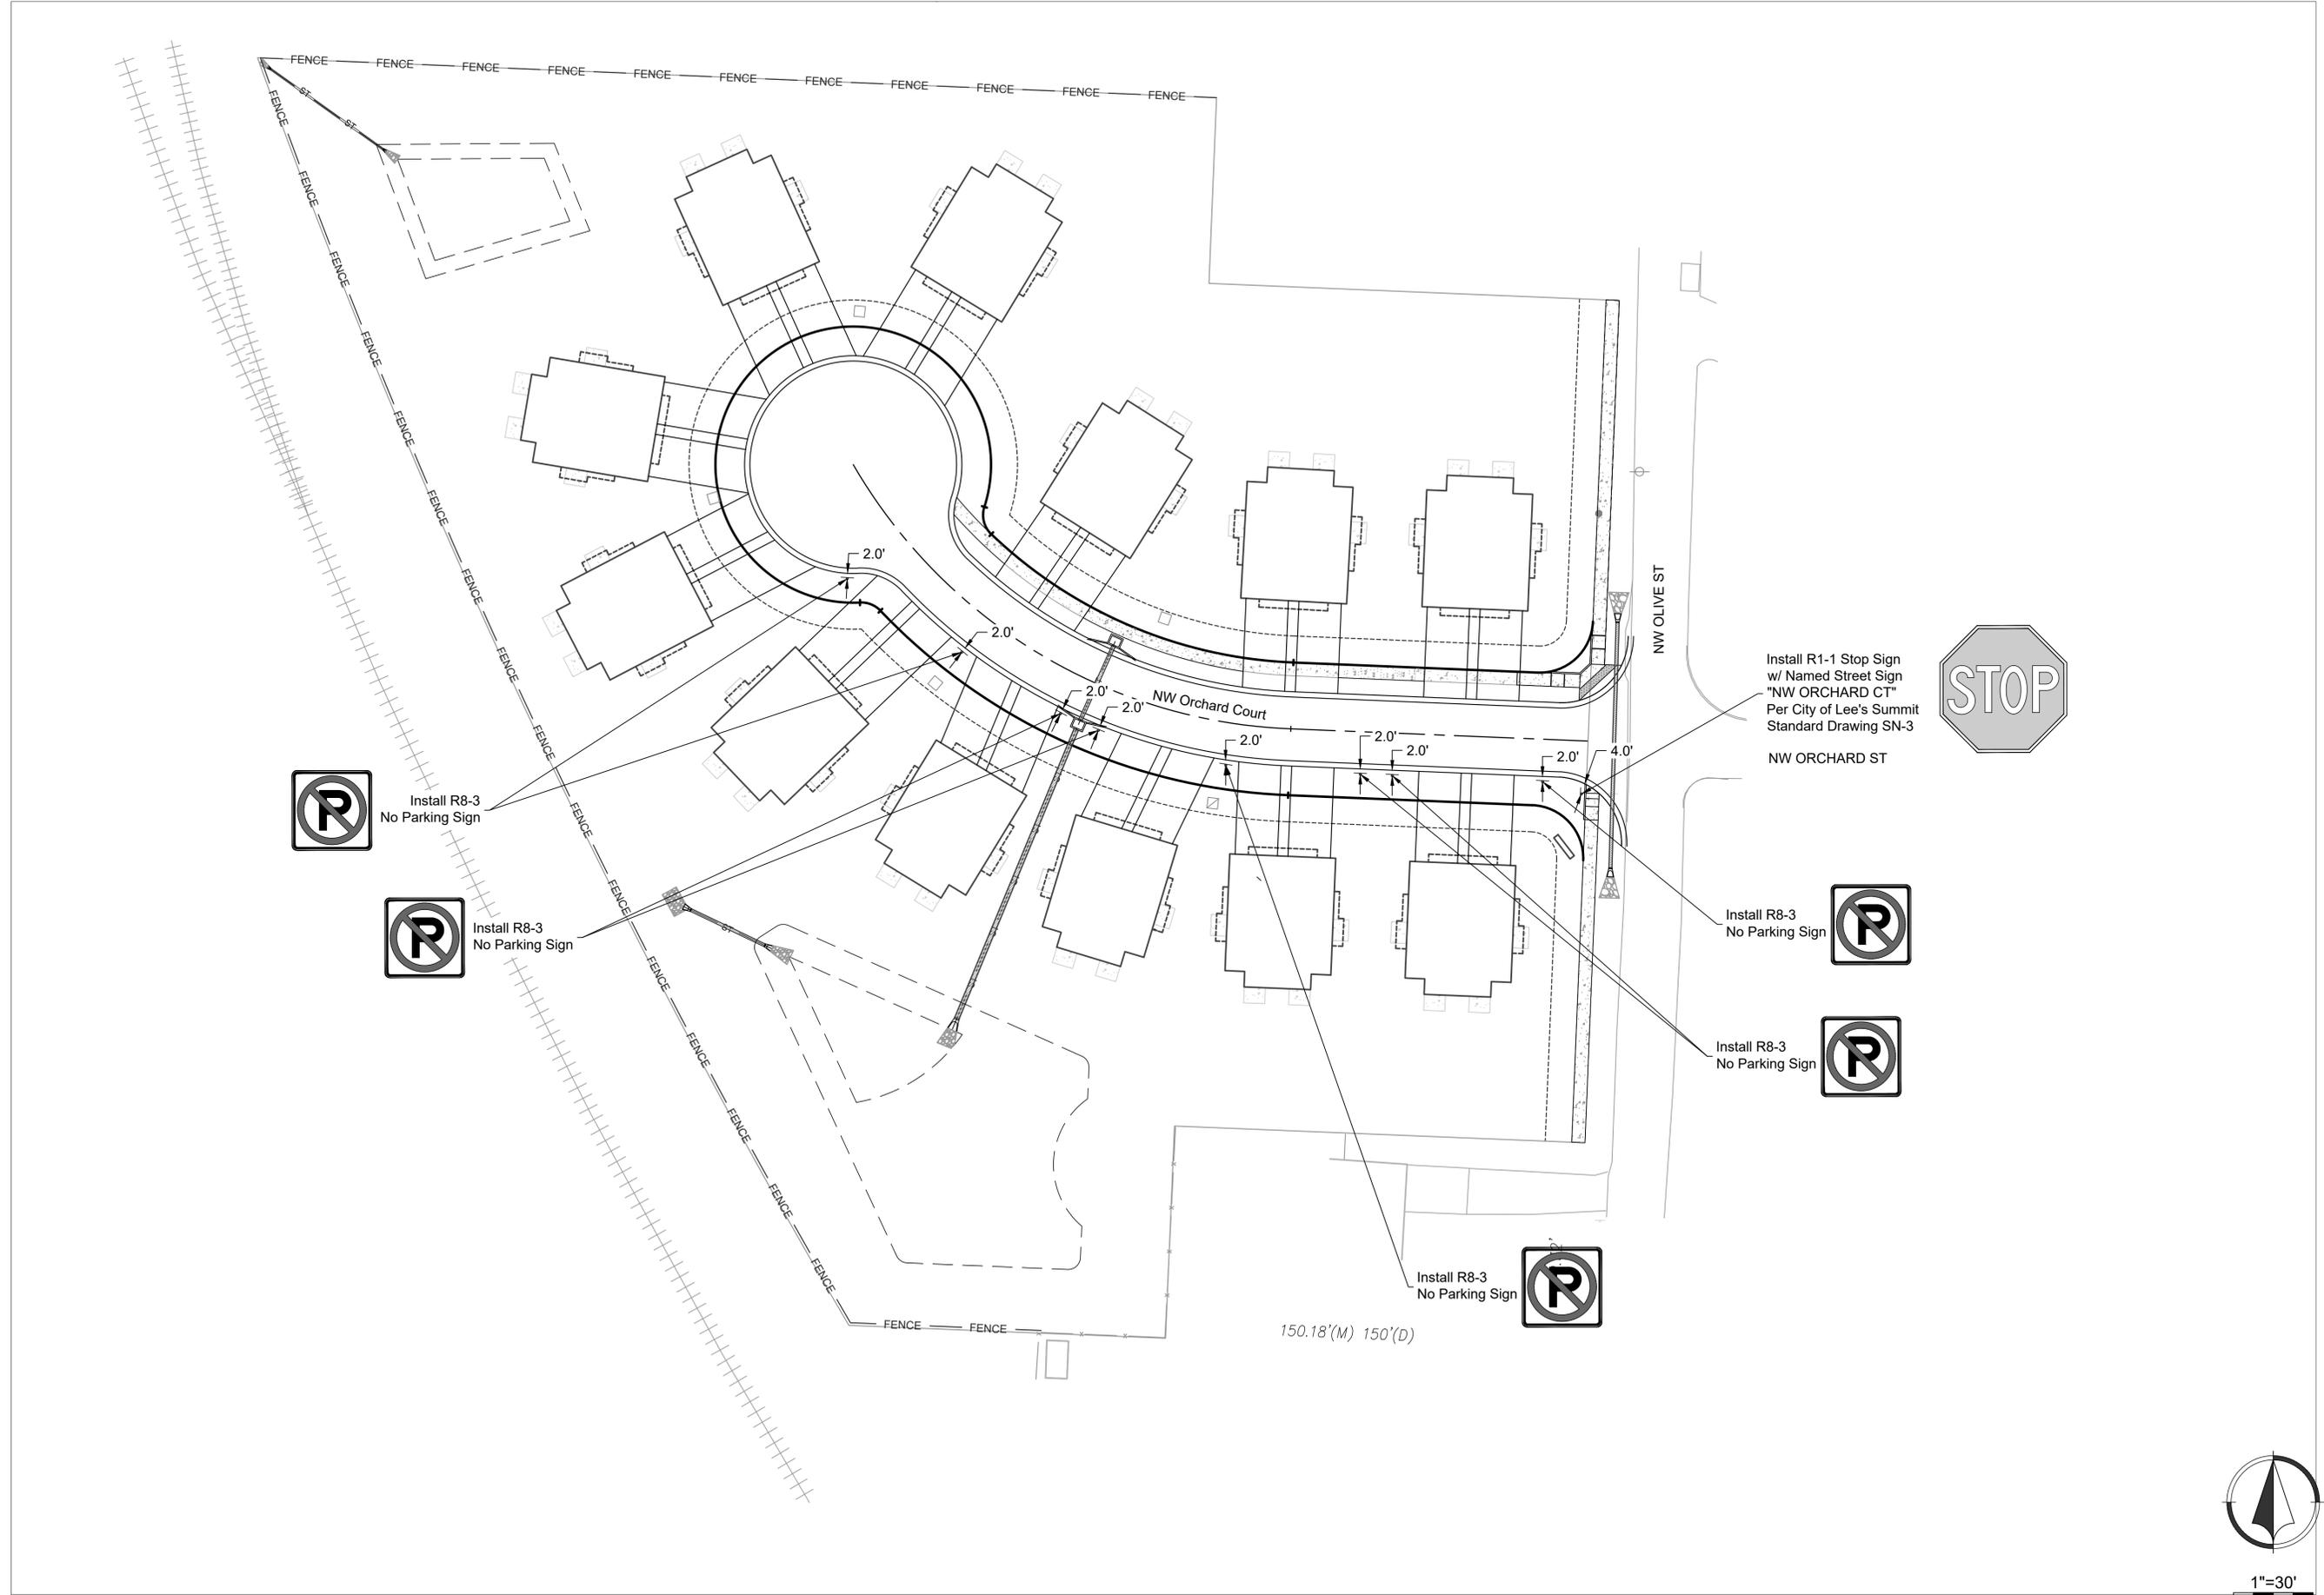
Signing Plan

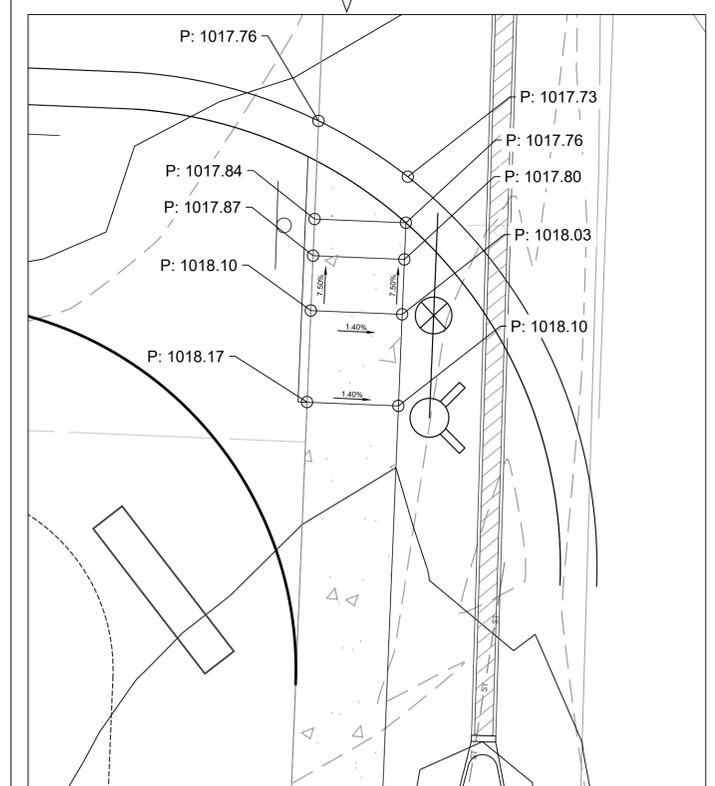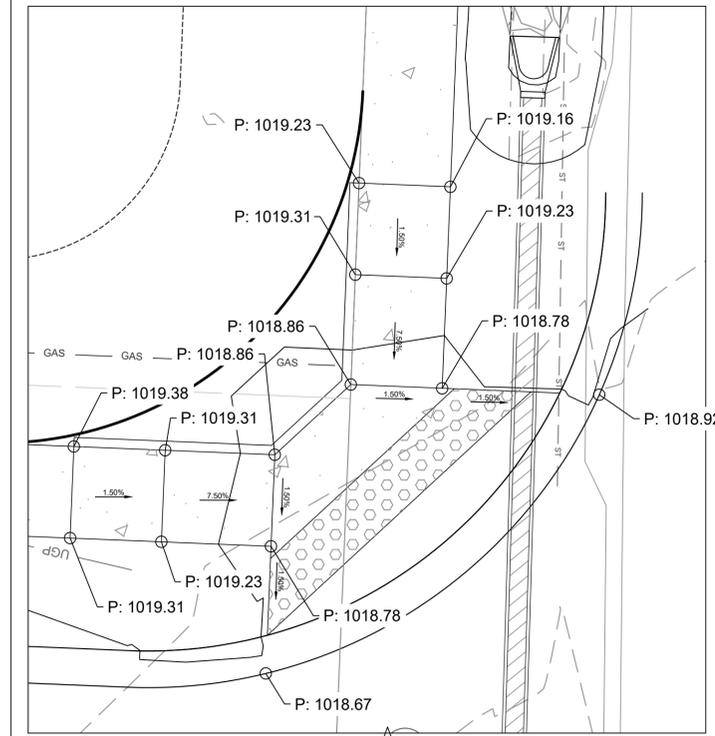NO.	BY	DATE	REVISION
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2	JGD	06/11/20	PER CITY COMMENT
3	JGD	06/15/20	PER CITY COMMENT
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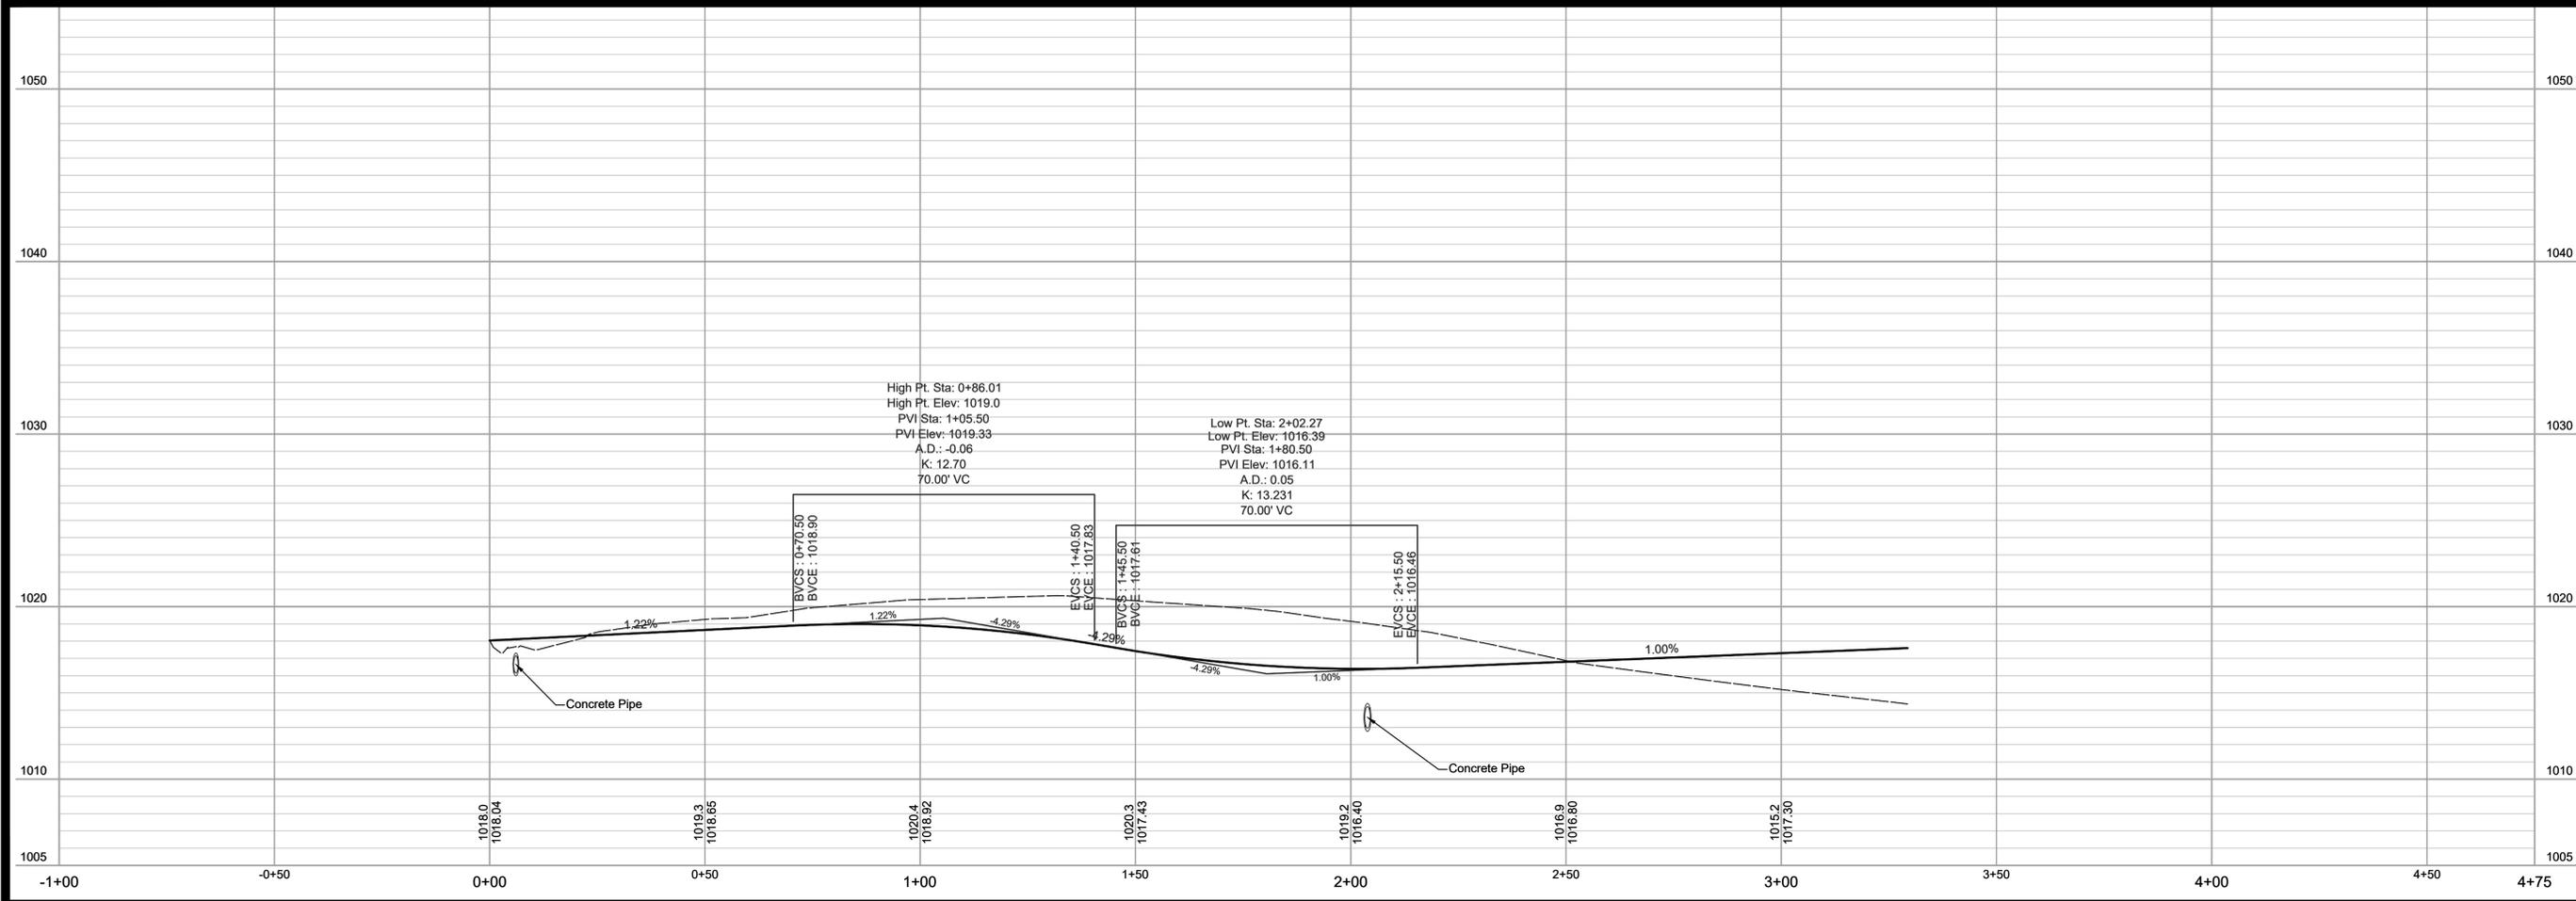
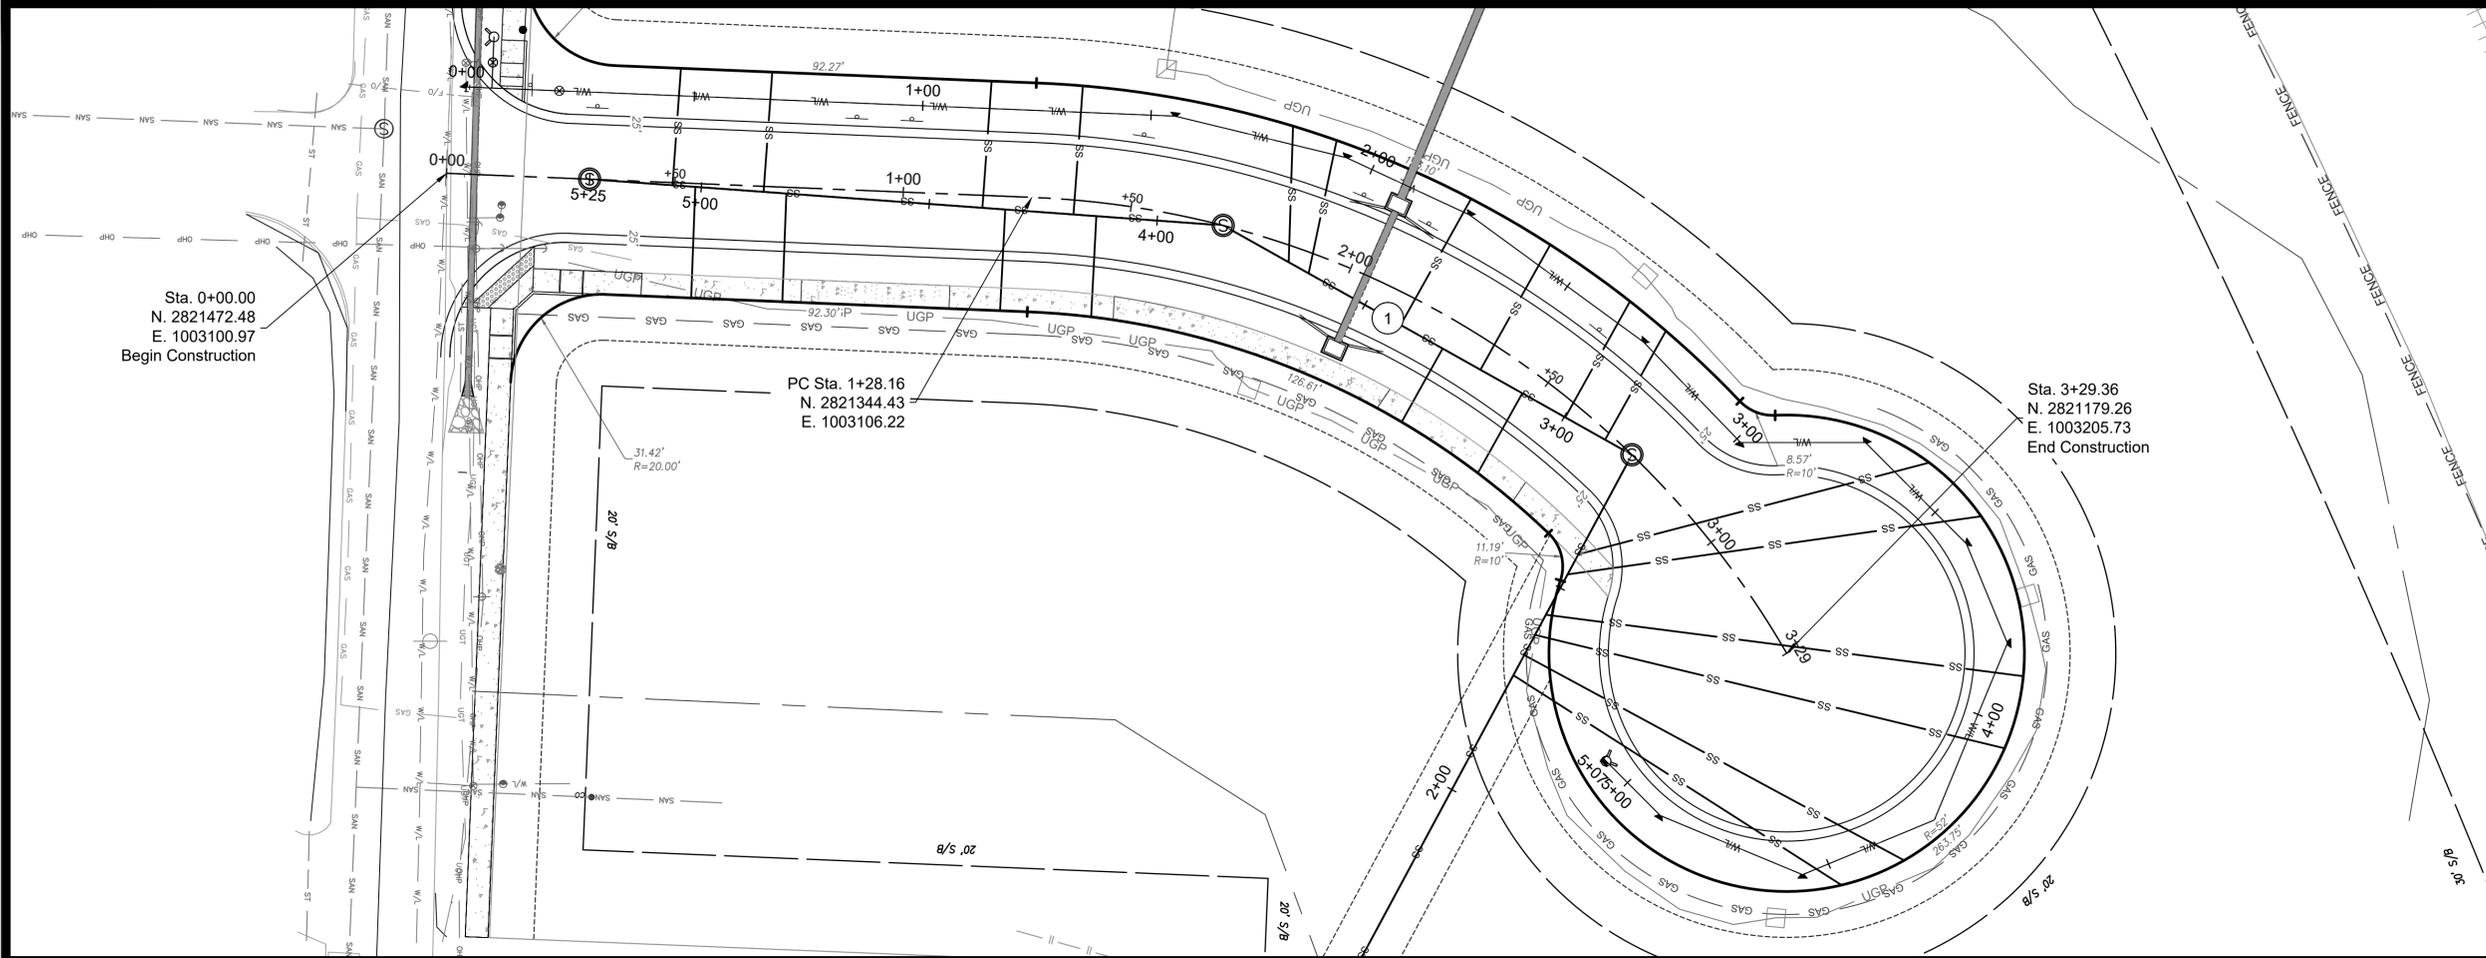
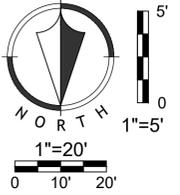


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Horizontal Curve Data:
PC Sta. 1+28.16
PT Sta. 3+29.36
Radius: 200'
Chord Length: 192.83'
L: 201.20
Delta Angle: 57.64°



NO.	BY	DATE	REVISION
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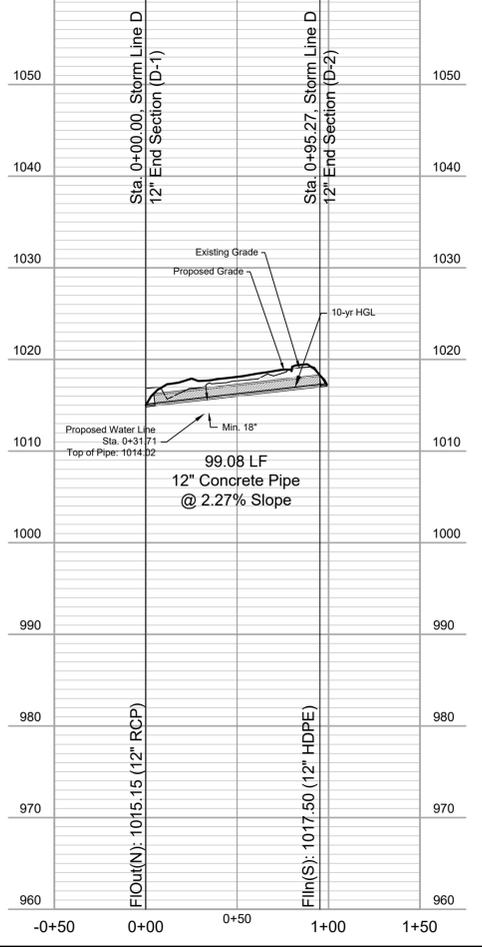
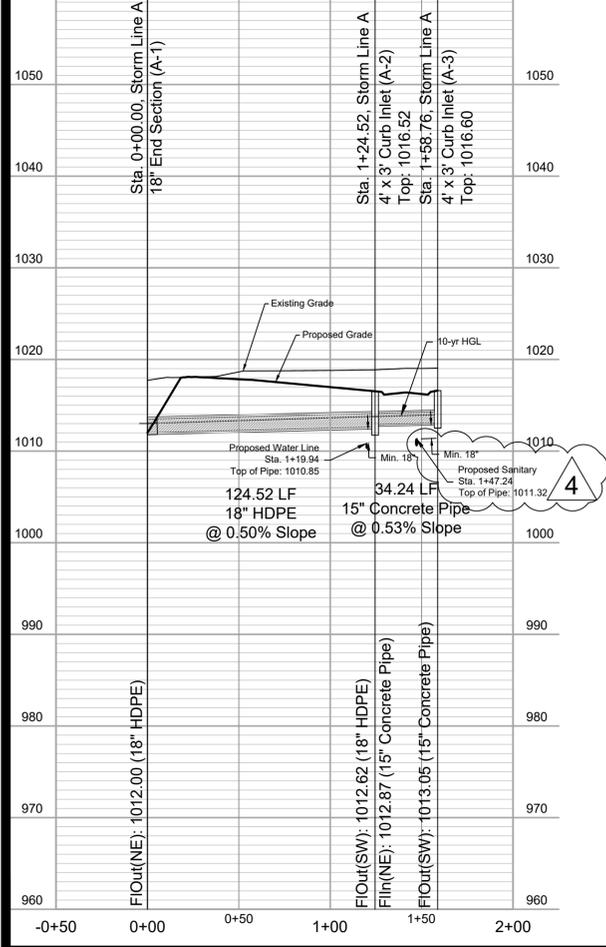
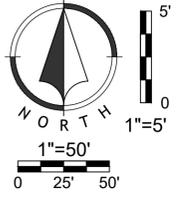
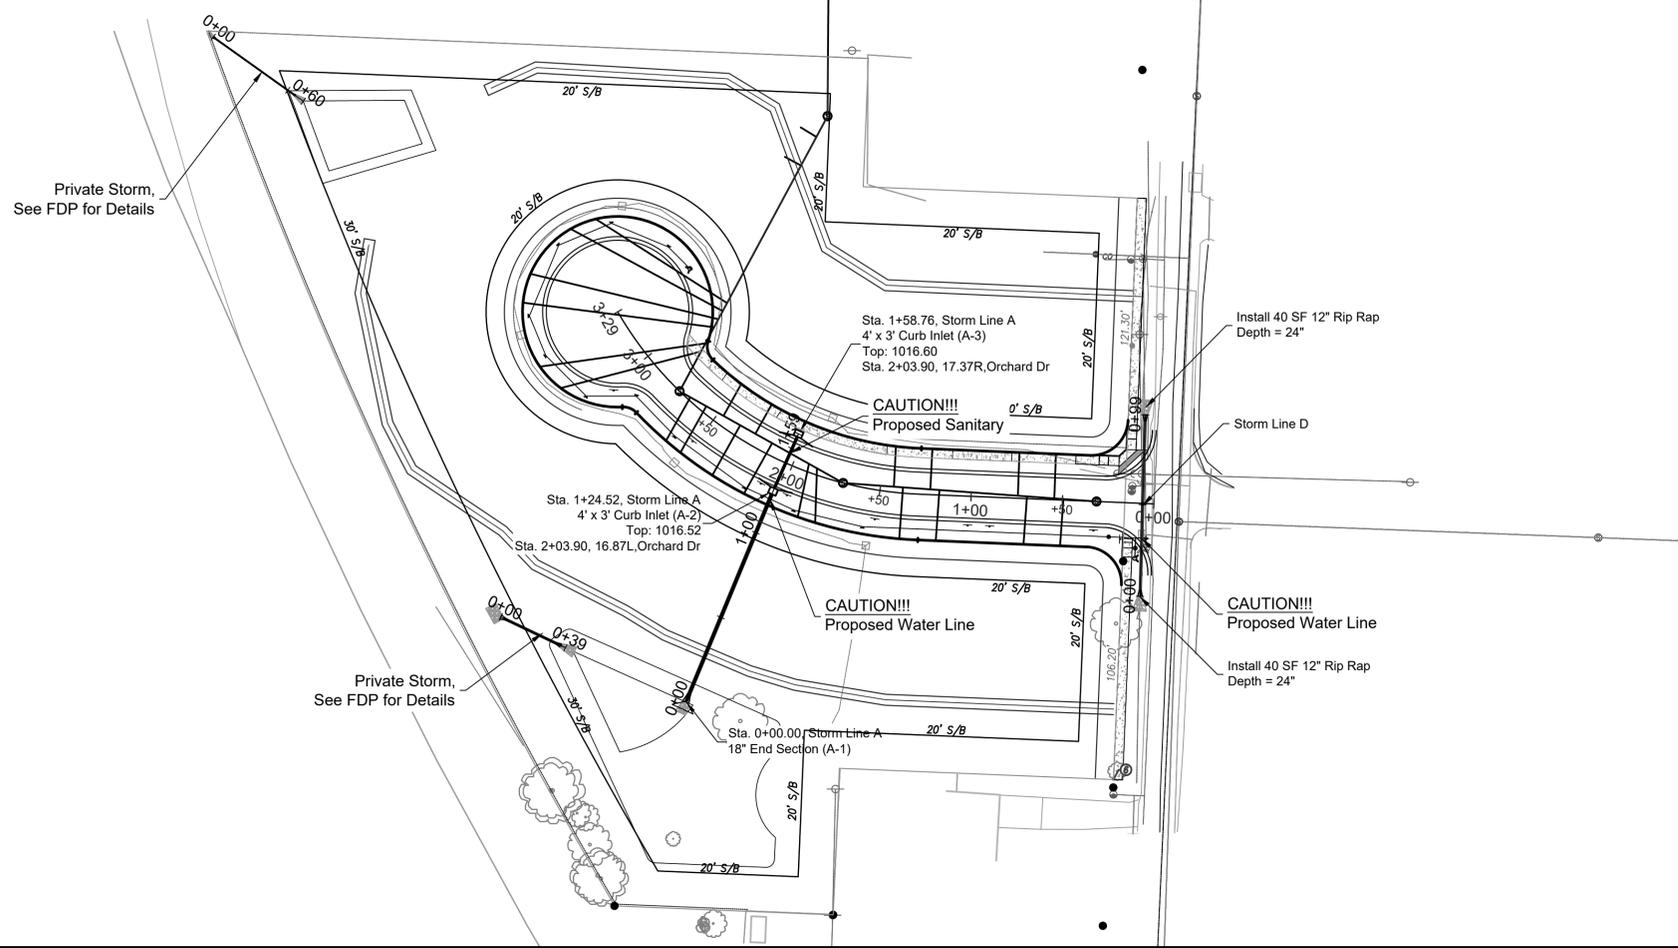
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GENERAL NOTES

- All construction materials and procedures on this project shall conform to the following requirements:
 - City of Lee's Summit, Missouri Standard Specifications: Section 3500 - Sanitary Sewers
- The contractor will be responsible for securing all bonds, and insurance required by the Final Development Plans, City of Lee's Summit, and all other governing agencies (including local, county, state, and federal authorities) having jurisdiction over the work proposed by these construction documents. The cost for all bonds, and insurance shall be the contractor's responsibility and shall be included in the bid for the work.
- All existing utilities indicated on the drawings are according to the best information available to the engineer; however, all utilities actually existing may not be shown. The contractor shall be responsible for contacting all utility companies for an exact field location of each utility prior to any construction. All utilities, shown and un-shown, damaged through the negligence of the contractor shall be repaired or replaced by the contractor at his expense.
- The contractor will be responsible for all damages to existing utilities, pavement, fences, structures, and other features not designated for removal. The contractor shall repair all damages at his expense.
- The demolition of existing pavement, curbs, structures, and all other features necessary to construct the proposed improvements, shall be performed by the contractor. All waste material removed during construction shall be disposed off the project site. The contractor shall be responsible for all permits for hauling and disposing of waste material. The disposal of waste material shall be in accordance with all local, state, and federal regulations.
- By use of these Final Development Plans the contractor hereby agrees that he shall be solely responsible for the safety of the construction workers and the public. The contractor agrees to hold the engineer and owner harmless for any and all injuries, claims, losses, or damages related to the project.
- The contractor will be responsible for providing all signage, lighting, etc., as required for temporary traffic control during the construction of this project. Maintenance of the temporary traffic control devices will be the contractor's responsibility. All traffic control in conduction with construction in the right-of-way shall be in conformance with the City Traffic Control Requirements.
- Contractor shall furnish evidence that his/her insurance meets the requirements of the City of Lee's Summit Municipal Code.
- Prior to installing, constructing, or performing any work on the public storm sewer line (including connecting private drainage systems to the storm sewer), contact Inspections.
- The Developer (not the contractor) to pick up all permits.


Summary of Quantities

Item	Description	Qty.	Unit
1	8" (SDR-26)PVC	525	LF
2	4" (SDR-26) PVC	1000	LF
3	4" Dia. Concrete Manhole	5	EA
4	8" x 4" PVC Wye	24	EA
5	Erosion Control	1	LS

Proposed Service Line Design Table

Service Line	Sta @ Main (ft)	D.D.S (ft)	Install Pipe (LF)	N @ EOS	E @ EOS	N @ Wye	E @ Wye	FI @ Main	FI @ EOS
SL-1	1+25.05	12.87	10.00	1003306.35	2821279.37	1003301.15	2821287.93	1008.66	1009.53
SL-2	1+43.31	30.62	10.00	1003290.28	2821270.71	1003285.53	2821279.51	1008.78	1009.65
SL-3	2+28.53	115.84	85.19	1003256.32	2821167.25	1003210.52	2821239.07	1009.33	1011.70
SL-4	2+33.53	120.84	94.45	1003250.93	2821153.56	1003206.12	2821236.70	1009.36	1011.92
SL-5	2+38.53	125.84	105.69	1003226.47	2821131.58	1003201.71	2821234.33	1009.39	1012.17
SL-6	2+43.53	130.84	105.31	1003210.72	2821127.50	1003197.31	2821231.96	1009.42	1012.20
SL-7	2+53.53	140.84	91.37	1003175.82	2821136.72	1003188.51	2821227.21	1009.49	1011.99
SL-8	2+58.53	145.84	79.32	1003164.12	2821148.08	1003184.11	2821224.84	1009.52	1011.78
SL-9	2+89.92	6.72	27.23	1003135.36	2821205.70	1003159.12	2821219.00	1010.22	1011.43
SL-10	2+99.92	16.72	29.00	1003128.92	2821213.55	1003154.23	2821227.72	1010.33	1011.58
SL-11	3+10.68	27.48	19.94	1003166.37	2821246.85	1003148.98	2821237.11	1010.36	1011.43
SL-12	3+21.20	37.99	31.28	1003116.54	2821231.00	1003143.84	2821246.29	1010.43	1011.73
SL-13	3+30.66	47.46	18.36	1003155.24	2821263.52	1003139.21	2821254.55	1010.49	1011.53
SL-14	3+41.20	58.00	31.57	1003106.52	2821248.32	1003134.07	2821263.74	1010.56	1011.86
SL-15	3+64.26	81.06	29.67	1003093.77	2821277.72	1003122.80	2821283.87	1010.71	1011.97
SL-16	3+69.26	86.06	29.72	1003090.66	2821287.28	1003120.36	2821288.23	1010.74	1012.00
SL-17	4+13.30	27.84	22.02	1003132.31	2821331.45	1003110.32	2821330.32	1011.23	1012.34
SL-18	4+18.52	32.84	28.16	1003081.87	2821333.26	1003109.96	2821335.31	1011.26	1012.49
SL-19	4+33.50	47.82	22.11	1003130.95	2821351.39	1003108.87	2821350.25	1011.36	1012.47
SL-20	4+38.50	52.82	27.74	1003080.84	2821353.23	1003108.51	2821355.24	1011.39	1012.61
SL-21	4+81.51	95.83	23.63	1003129.00	2821399.01	1003105.38	2821398.13	1011.67	1012.81
SL-22	4+86.51	100.83	26.22	1003078.87	2821401.21	1003105.02	2821403.12	1011.70	1012.89
SL-23	5+01.49	115.82	24.27	1003128.12	2821418.96	1003103.93	2821418.07	1011.80	1012.96
SL-24	5+06.50	120.82	25.59	1003078.05	2821421.19	1003103.57	2821423.05	1011.83	1013.01

Segment	Peak Base Flow (Residential)			Peak Infiltration			Peak Inflow			Design Peak Flow, cfs	Pipe Full Capacity, cfs	Pipe Dia. Inches	Pipe Length, ft	Pipe Slope, %	Pipe Vel Full, fps	Design Vel, fps		
	U/S MH	D/S MH	Area, acres	PDWF, gpd/ac	Flow, cfs	Area, acres	Infiltration Rate, gpd/ac	Flow, cfs	Tributary Area, acres								Rainfall Intensity, iph	Inflow Factor
5-A	4-A	0.000	1500	0.000	0.000	500.000	0.000	0.000	5.490	0.006	0.000	0.000	0.907	8.000	139.000	0.650	2.599	0.000
4-A	3-A	1.050	1500	0.002	1.050	500.000	0.001	0.000	5.490	0.006	0.000	0.003	0.907	8.000	102.480	0.650	2.599	0.577
3-A	2-A	1.390	1500	0.003	1.390	500.000	0.001	1.040	5.490	0.006	0.034	0.039	0.907	8.000	170.500	0.650	2.599	1.287
2-A	1-A	1.340	1500	0.003	1.340	500.000	0.001	2.440	5.490	0.006	0.080	0.119	0.907	8.000	88.140	0.650	2.599	1.779
1-A	Existing	1.300	1500	0.003	1.300	500.000	0.001	3.780	5.490	0.006	0.125	0.209	0.914	8.000	24.390	0.660	2.619	2.105
Existing	Existing	0.000	1500	0.000	0.000	500.000	0.000	3.780	5.490	0.006	0.125	0.249	0.900	8.000	323.770	0.470	2.578	2.173

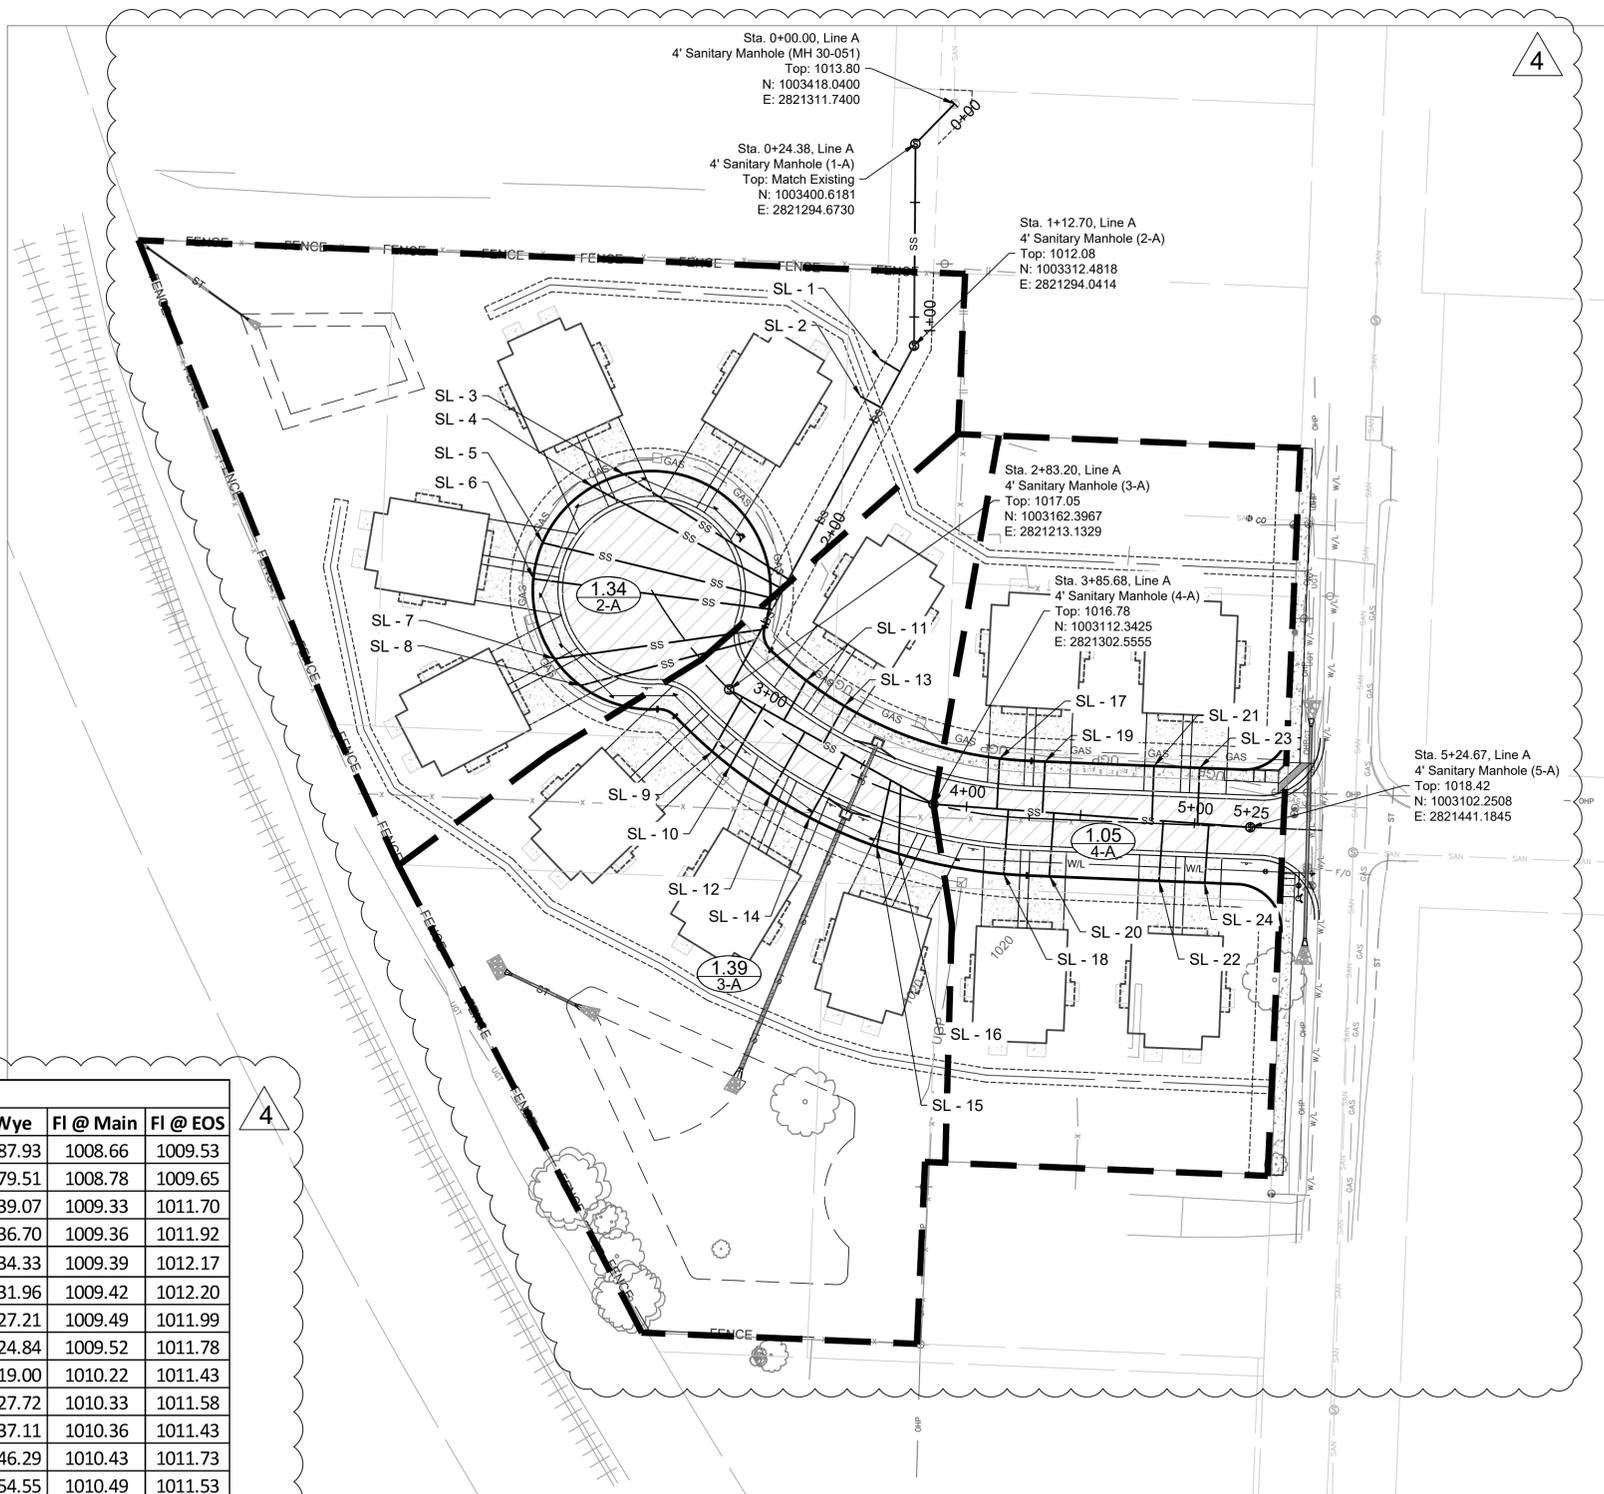


NO.	BY	DATE	REVISION
5	JGD	MES 12/07/20	WATERLINE REVISION
4	JGD	MES 10/01/20	PER CITY COMMENT
3	JGD	MES 09/15/20	PER CITY COMMENT
2	JGD	MES 06/11/20	PER CITY COMMENT
1	JGD	MES 05/08/20	ORIGINAL SUBMISSION

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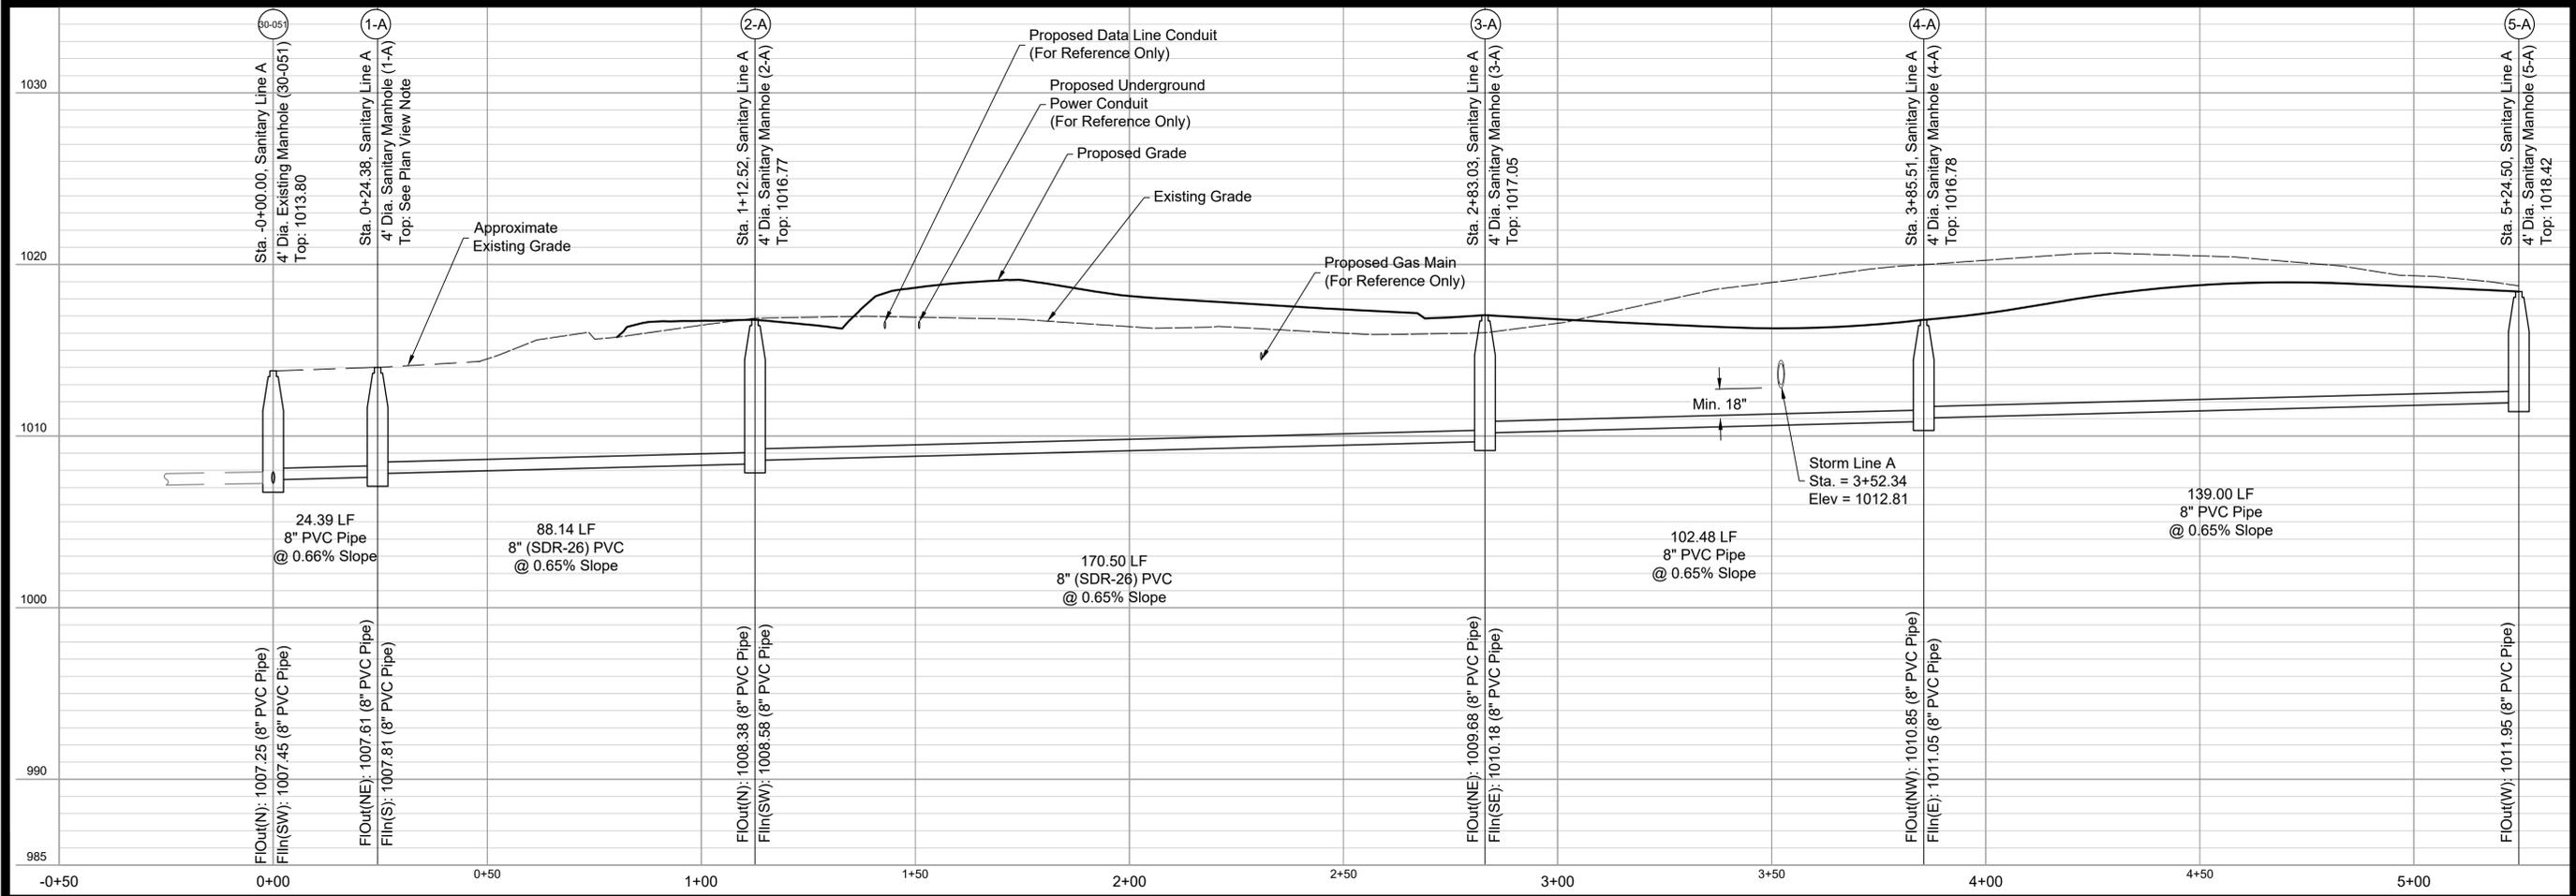
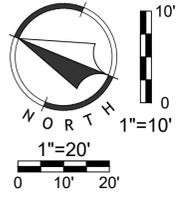
Dec 07, 2020 3:03pm
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Contractor shall verify existing elevation and match top of structure elevation with existing grade.

Contractor shall coordinate with existing property owner for access and construction of sanitary main and connection to existing manhole

Note:
The City of Lee's Summit shall not accept any construction of the sanitary sewer less than 0.60% slope per City of Lee's Summit Design Criteria Section 6501 D.2.d.



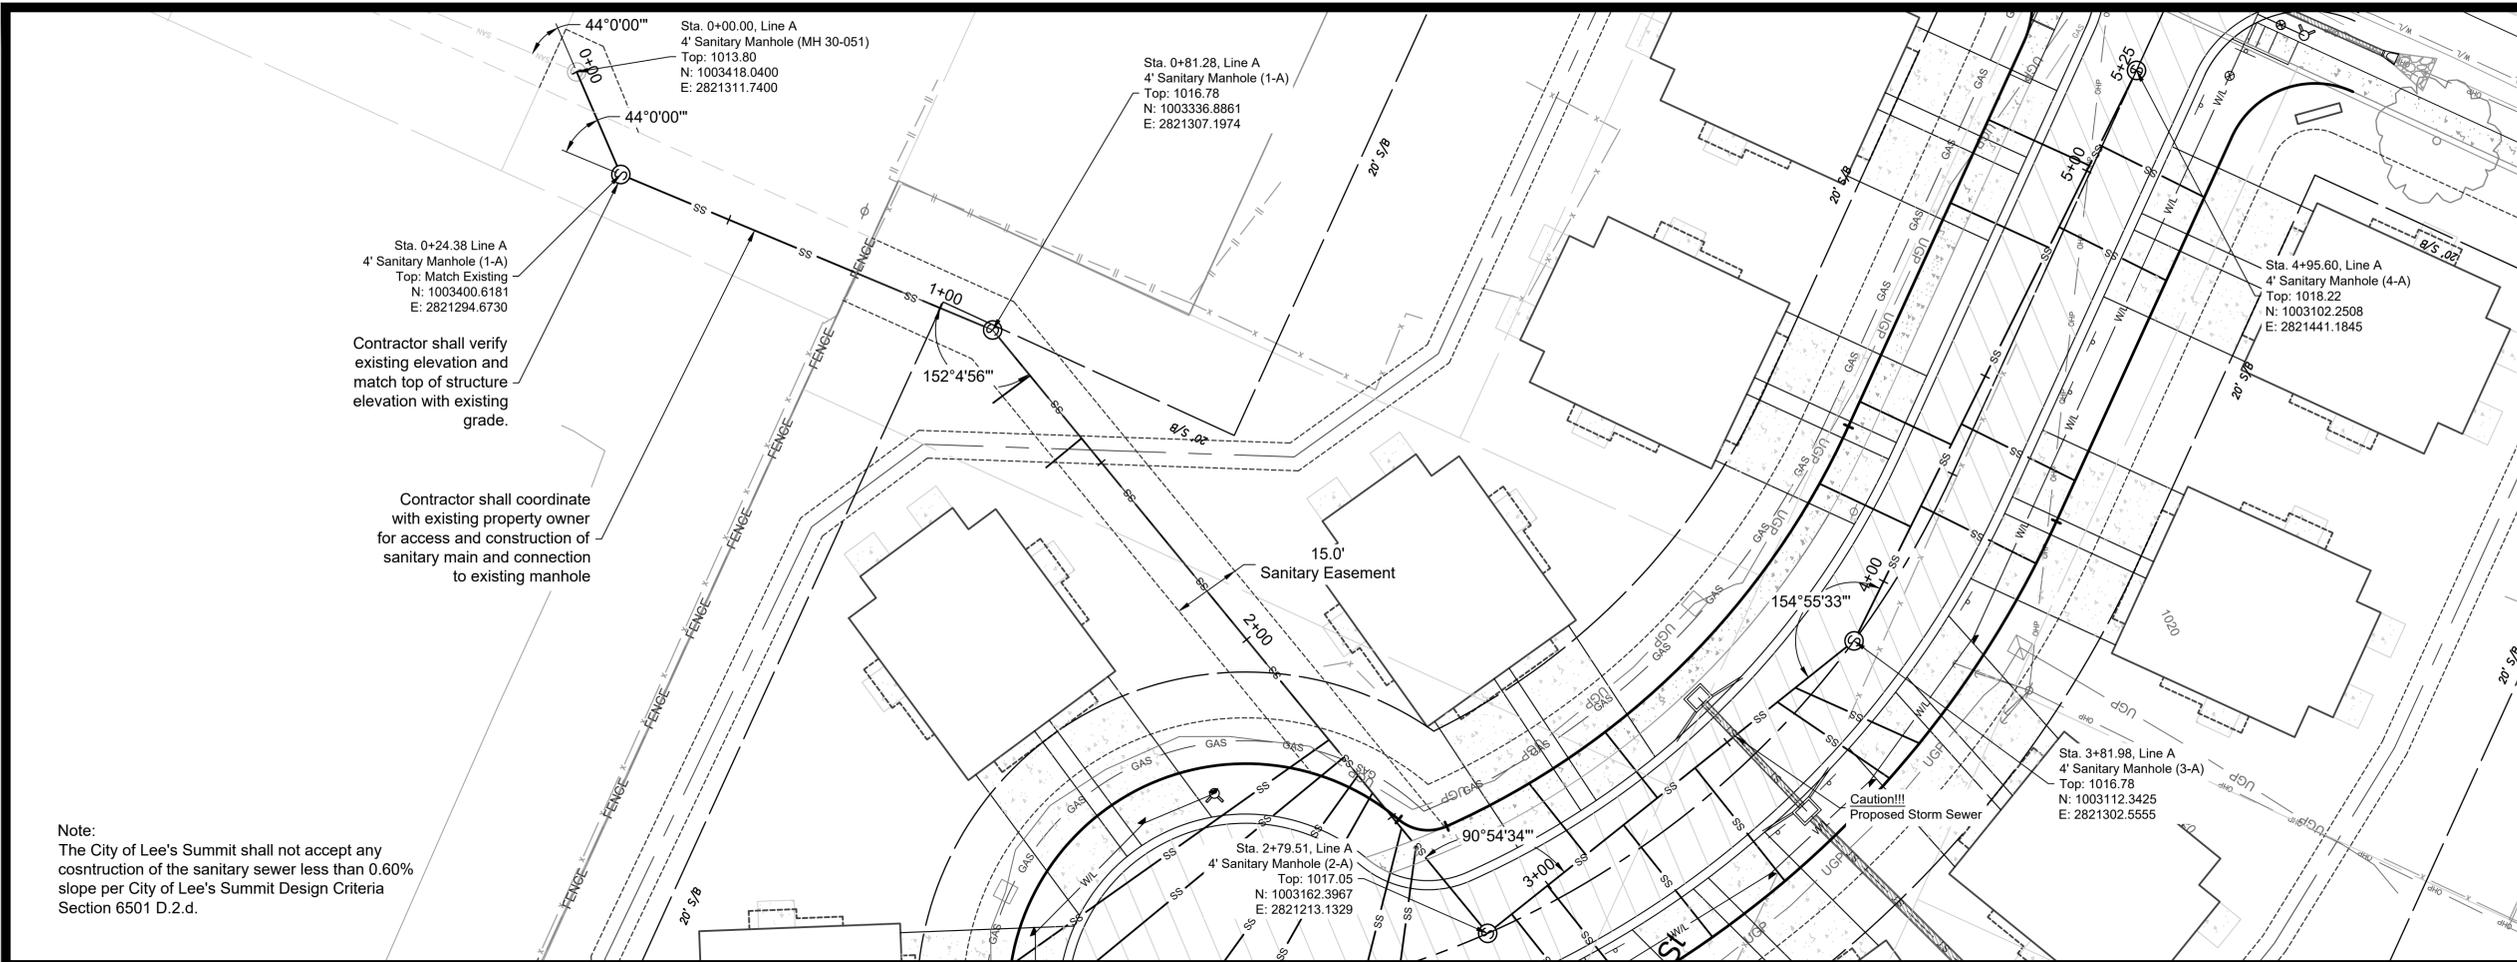


NO.	BY	DATE	ORIGINAL SUBMISSION
1	JDG	06/11/20	ORIGINAL SUBMISSION
2	JDG	06/11/20	PER CITY COMMENT
3	JDG	06/15/20	PER CITY COMMENT
4	JDG	10/01/20	PER CITY COMMENT
5	JDG	12/07/20	WATERLINE REVISION

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816.800.0950
1815 MCGEE STREET, SUITE 200
KANSAS CITY, MISSOURI 64108
WWW.RIC-CONSULT.COM

Professional Engineer Seal for Mitchell E. Slutter, License Number PE-2002003418, State of Missouri.

Dec 07, 2020 3:03pm Z:\R\C\Design\2018\18-0251_Burton_Townhomes_Lee's Summit\DWG\Street & Storm Plans\18-0251_CDS\NCC01.dwg

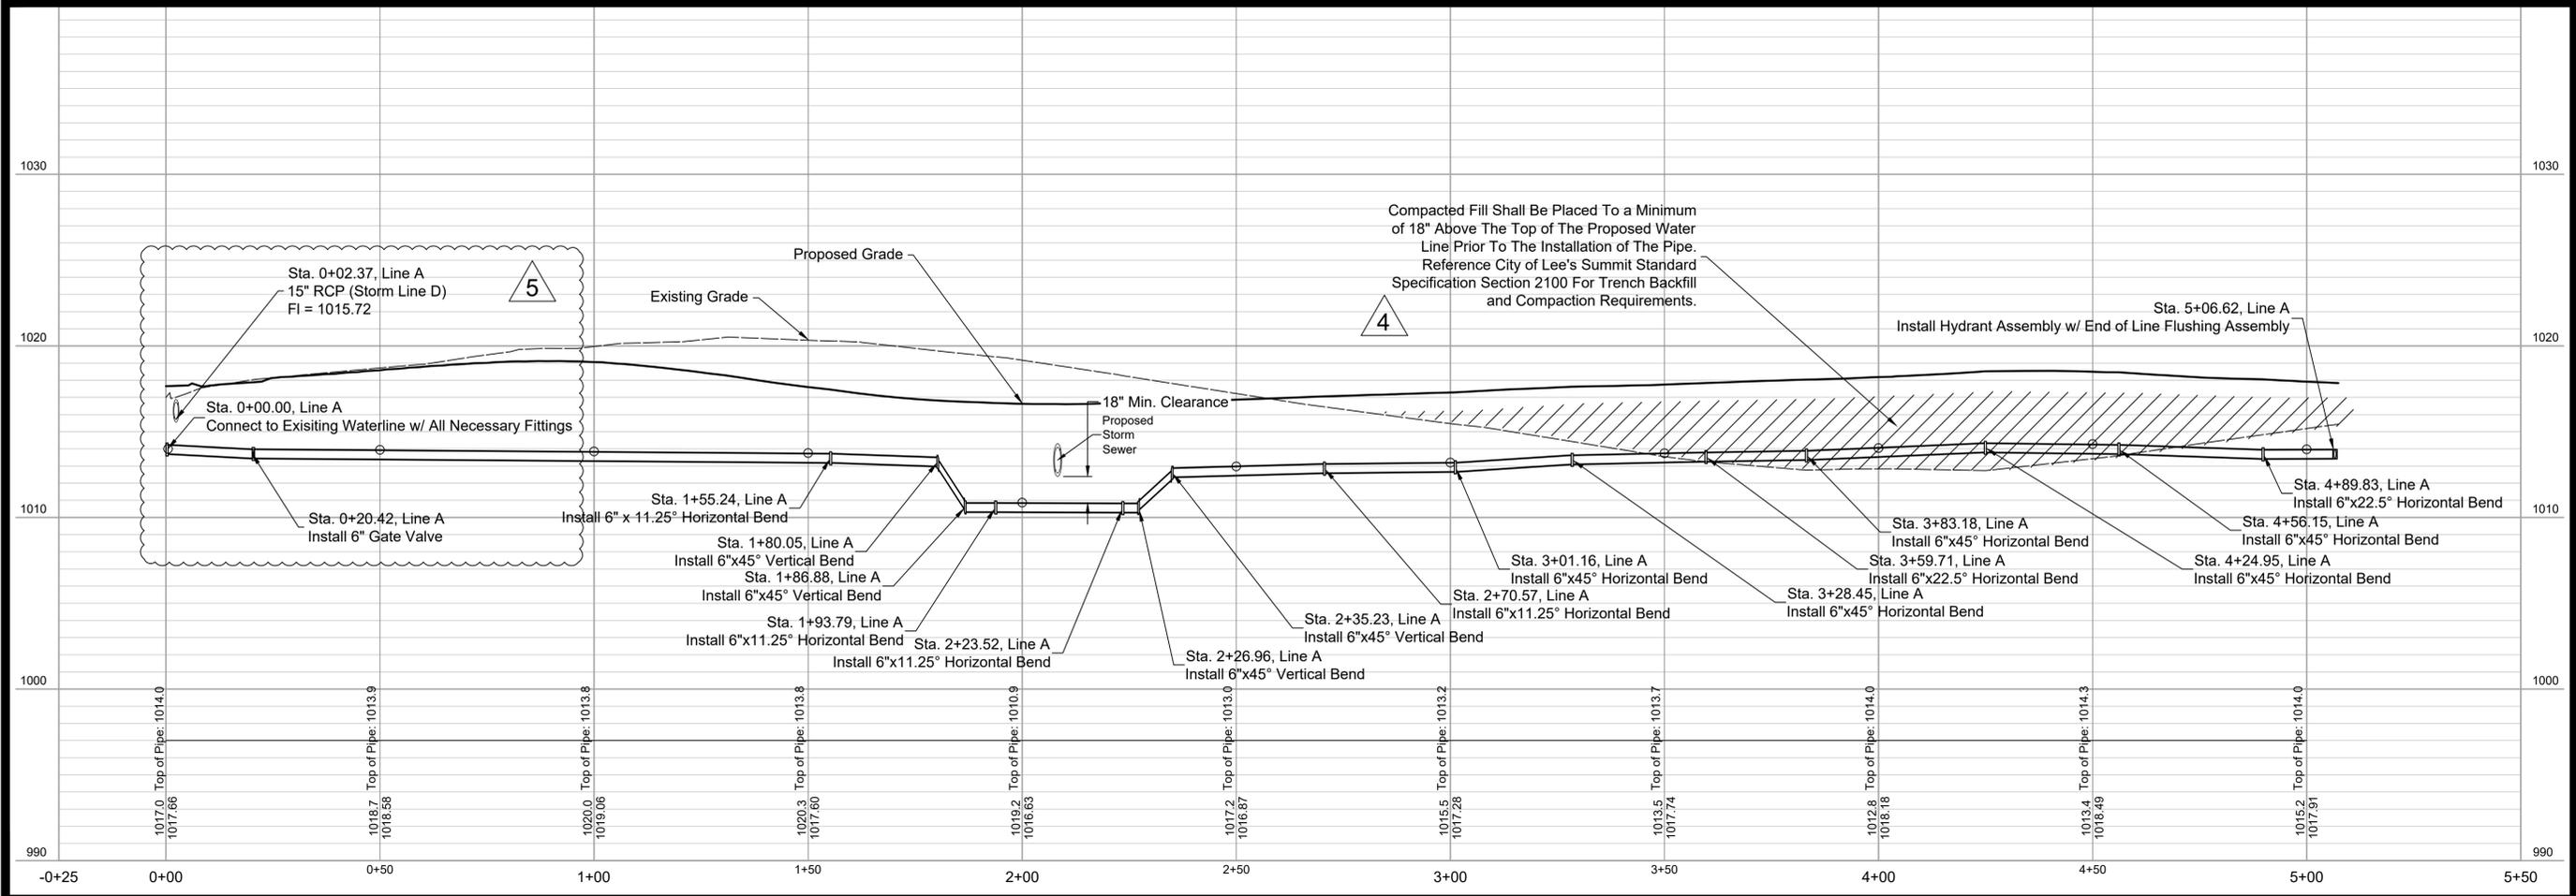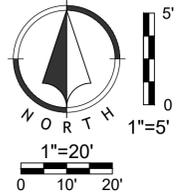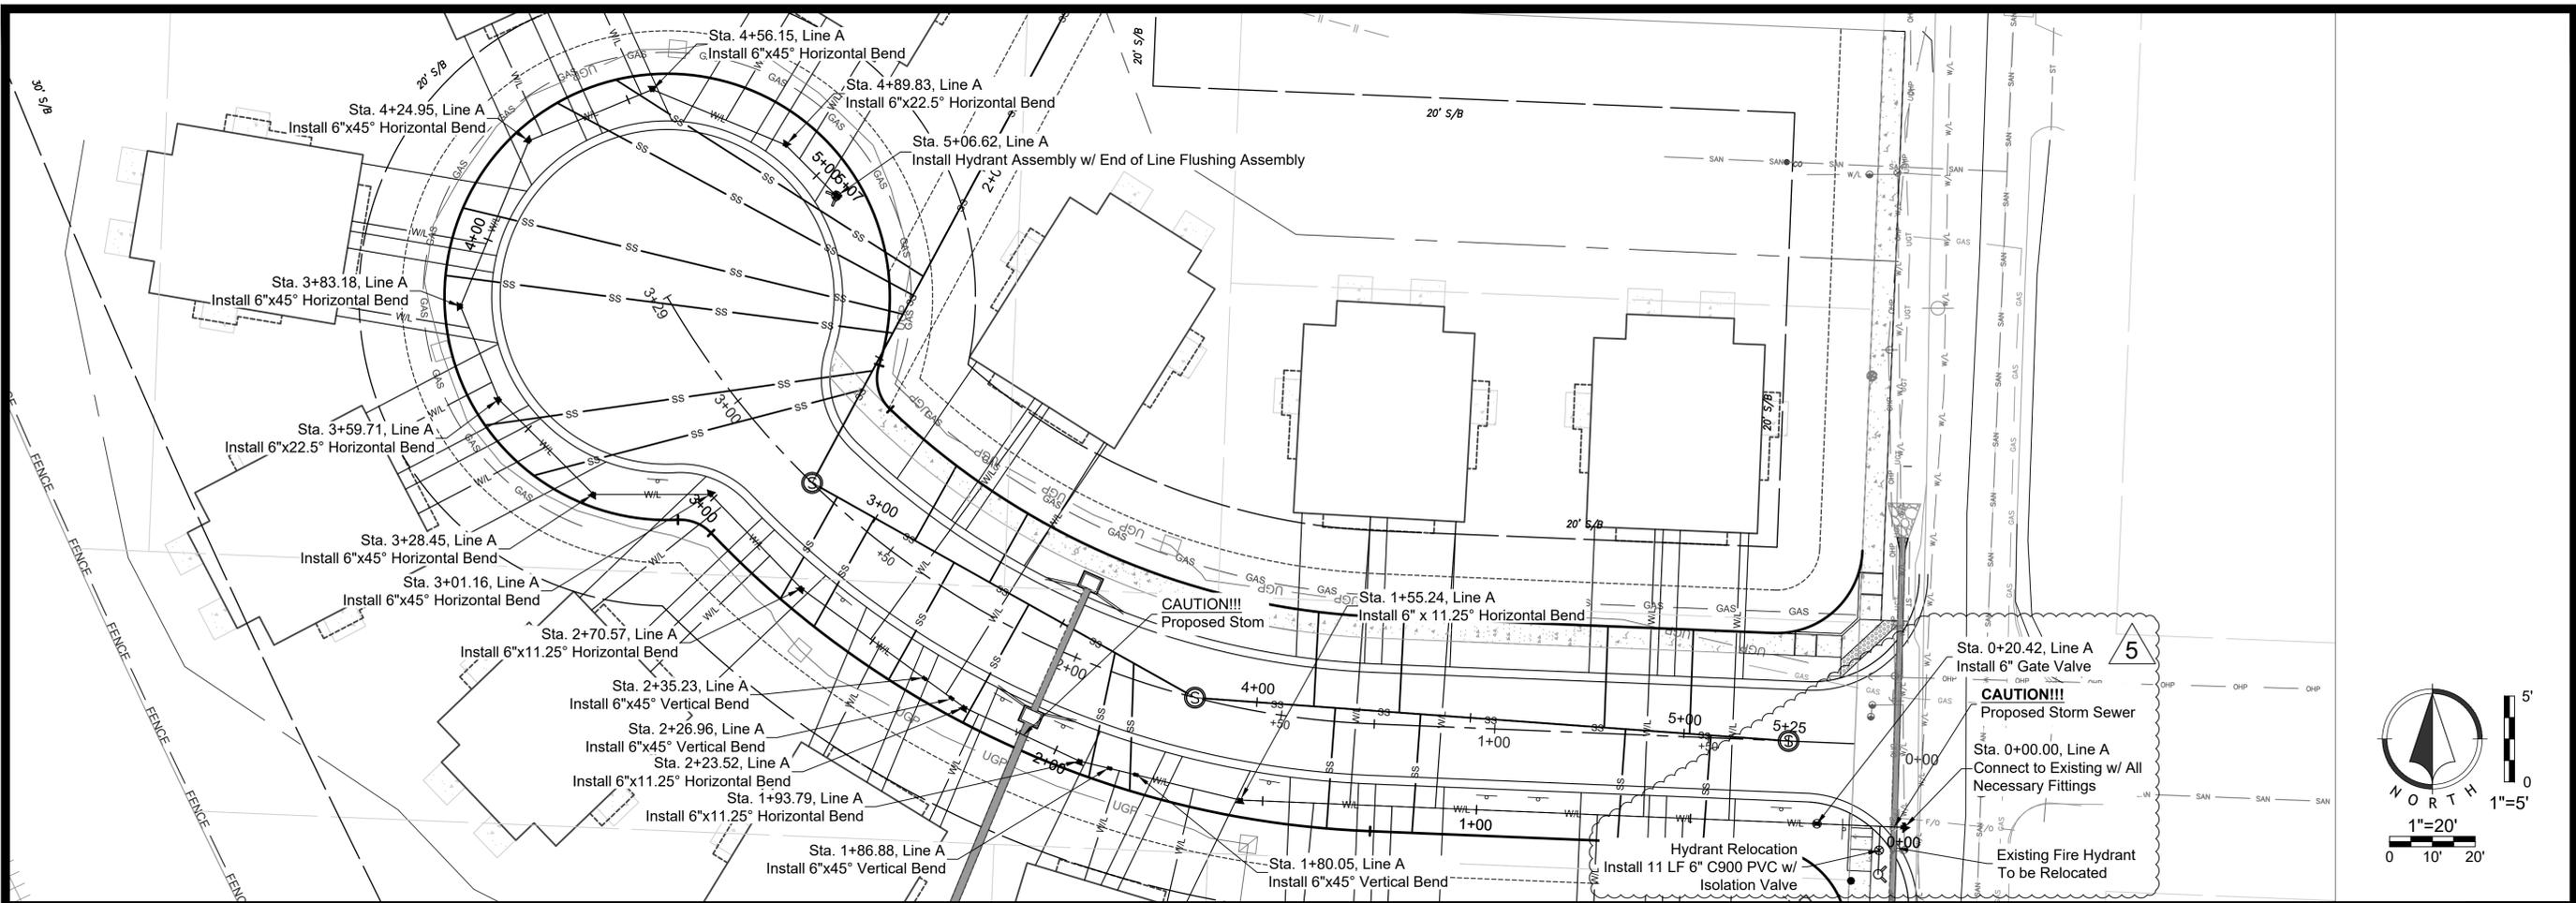


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2	JDG	MES 06/11/20	PER CITY COMMENT	
3	JDG	MES 08/15/20	PER CITY COMMENT	
4	JDG	MES 10/01/20	PER CITY COMMENT	
5	JDG	MES 12/07/20	WATERLINE REVISION	

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Dec 07, 2020 3:03pm
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EROSION CONTROL LEGEND




WRITTEN SEQUENCING


- Implement Pre-Clearing Plan:**
All temporary structural BMP's shown on the pre-clearing plan must be in place before the general clearing operations. Clearing necessary to place temporary structural BMP's is the minimum required for installation. Coordinate clearing necessary to place temporary structural BMP's with local weather forecast so that clearing and placement may be completed within a forecast dry period. Stabilize all erosion control measures after installation. Temporary Barrier Fence shall be in Place, around areas not to be disturbed, prior to any construction activities. This area includes Stream Corridor.
- Clear and Stabilize Work Areas:**
Grade contractor areas and place all-weather surface on contractor areas.
- Clearing and Grubbing:**
After Phase I BMP's are installed, contractor may clear, grub, and demo required areas as necessary.

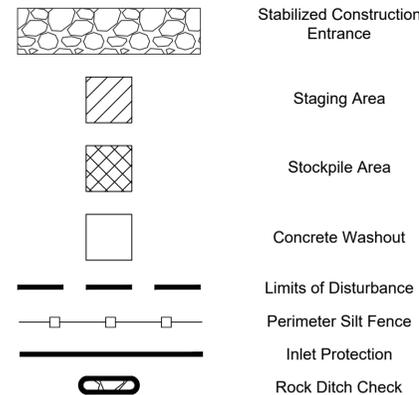EROSION CONTROL NOTES

- Erosion control plan modifications shall be required if the plan fails to substantially control erosion and offsite sedimentation.
- The retention of access controls and sediment controls shall be required for areas where seed has not established 70% cover.
- The contractor shall temporarily seed and mulch all disturbed areas if there has been no construction activity on them for a period of fourteen (14) calendar days.
- Install "J" Hooks on silt fence every 100 LF

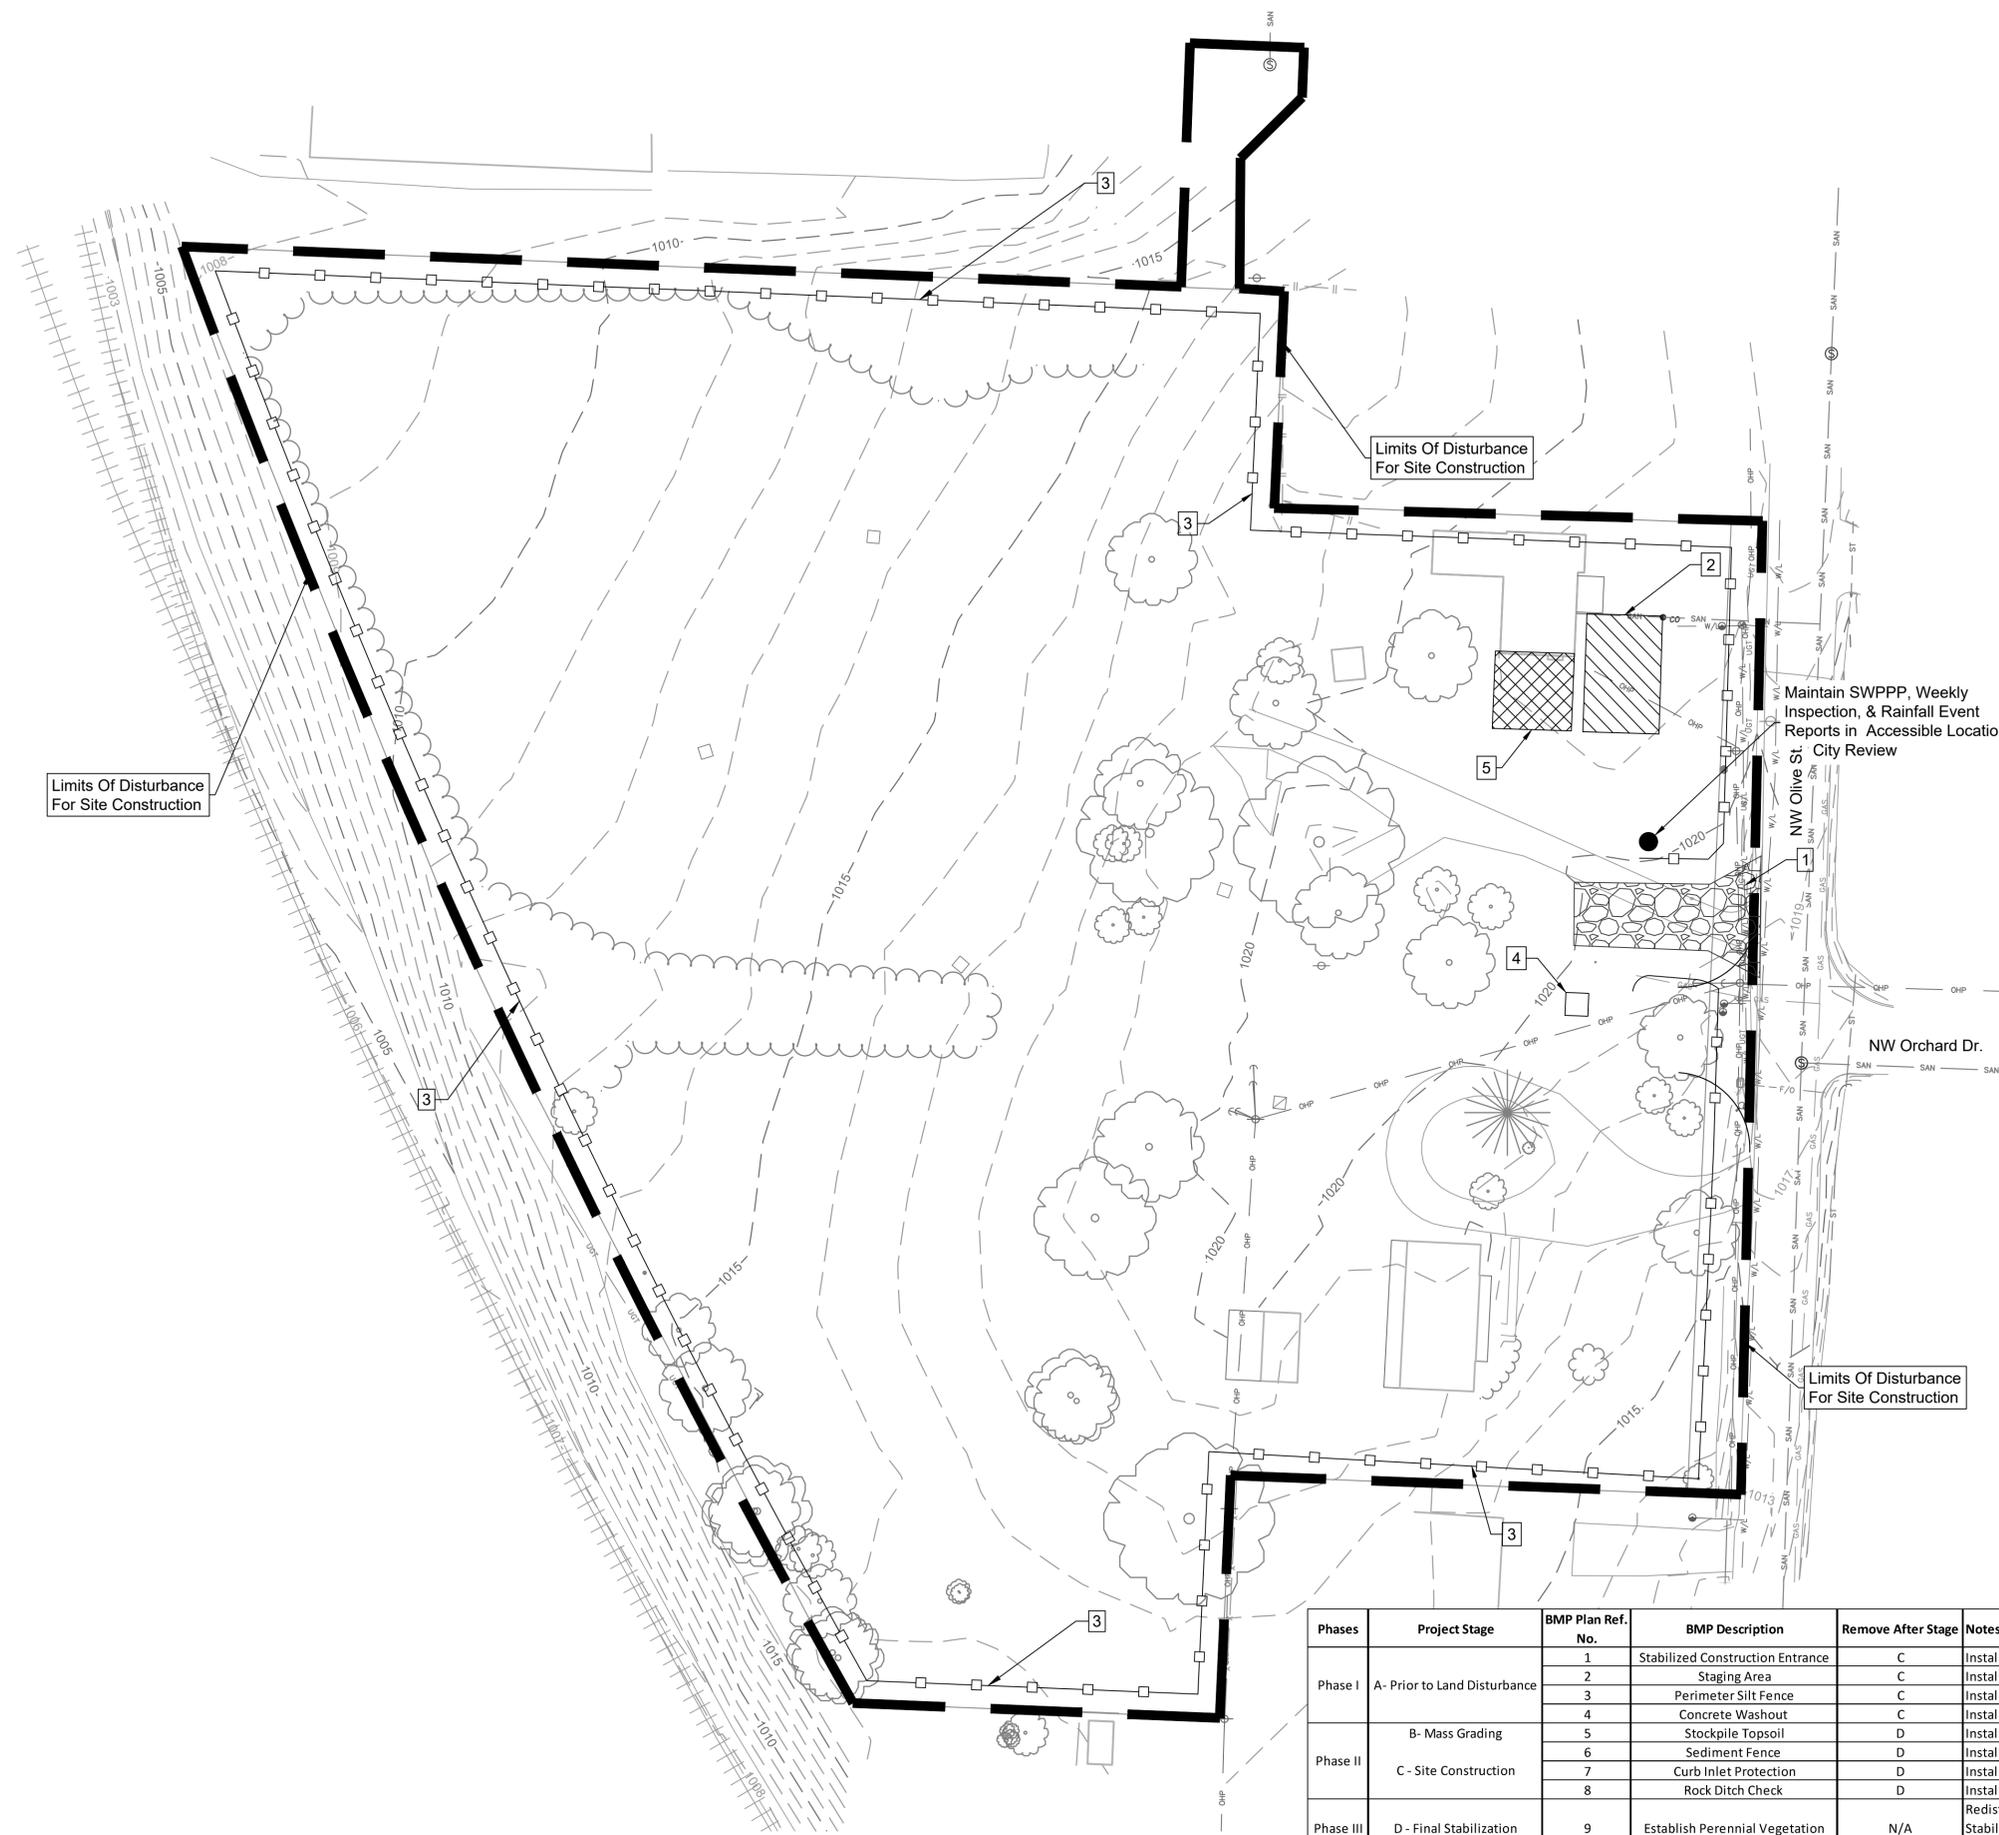

Phases	Project Stage	BMP Plan Ref. No.	BMP Description	Remove After Stage	Notes
Phase I	A- Prior to Land Disturbance	1	Stabilized Construction Entrance	C	Install Construction Entrance, as shown on Plans.
		2	Staging Area	C	Install Staging Area
		3	Perimeter Silt Fence	C	Install Perimeter Silt Fence, as Shown on Plans.
		4	Concrete Washout	C	Install Concrete Washout as shown on plans prior to pouring any concrete
Phase II	B- Mass Grading	5	Stockpile Topsoil	D	Install Sediment Fence a Minimum of 5' Beyond Toe of Slope
		6	Sediment Fence	D	Install Sediment Fence, as Shown on Plans
		7	Curb Inlet Protection	D	Install Filter Bags around Proposed Curb Inlets
		8	Rock Ditch Check	D	Install Rock Ditch Check, as Shown on Plans
Phase III	D- Final Stabilization	9	Establish Perennial Vegetation	N/A	Redistribute topsoil and seed and mulch all disturbed areas. Sod right-of-way. Stabilization complete when 100% disturbed area is established with perennial vegetation with a density of 70%.

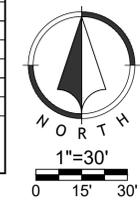


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MO Certificate of Authority: E-2010033630


NO.	BY	DATE	ORIGINAL SUBMISSION	REVISION
1	JGD	MES 06/11/20	PER CITY COMMENT	
2	JGD	MES 06/11/20	PER CITY COMMENT	
3	JGD	MES 08/15/20	PER CITY COMMENT	
4	JGD	MES 10/01/20	PER CITY COMMENT	
5	JGD	MES 12/07/20	WATERLINE REVISION	

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EROSION CONTROL LEGEND





WRITTEN SEQUENCING

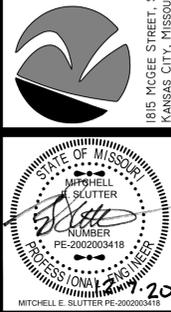- Implement Pre-Clearing Plan:**
All temporary structural BMP's shown on the pre-clearing plan must be in place before the general clearing operations. Clearing necessary to place temporary structural BMP's is the minimum required for installation. Coordinate clearing necessary to place temporary structural BMP's with local weather forecast so that clearing and placement may be completed within a forecast dry period. Stabilize all erosion control measures after installation. Temporary Barrier Fence shall be in Place, around areas not to be disturbed, prior to any construction activities. This area includes Stream Corridor.
- Clear and Stabilize Work Areas:**
Grade contractor areas and place all-weather surface on contractor areas.
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After Phase I BMP's are installed, contractor may clear, grub, and demo required areas as necessary.

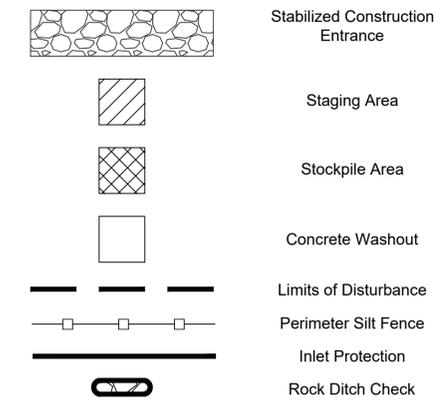EROSION CONTROL NOTES

- Erosion control plan modifications shall be required if the plan fails to substantially control erosion and offsite sedimentation.
- The retention of access controls and sediment controls shall be required for areas where seed has not established 70% cover.
- The contractor shall temporarily seed and mulch all disturbed areas if there has been no construction activity on them for a period of fourteen (14) calendar days.
- Install "J" Hooks on silt fence every 100 LF

Phases	Project Stage	BMP Plan Ref. No.	BMP Description	Remove After Stage	Notes
Phase I	A- Prior to Land Disturbance	1	Stabilized Construction Entrance	C	Install Construction Entrance, as shown on Plans.
		2	Staging Area	C	Install Staging Area
		3	Perimeter Silt Fence	C	Install Perimeter Silt Fence, as Shown on Plans.
		4	Concrete Washout	C	Install Concrete Washout as shown on plans prior to pouring any concrete
Phase II	B- Mass Grading	5	Stockpile Topsoil	D	Install Sediment Fence a Minimum of 5' Beyond Toe of Slope
		6	Sediment Fence	D	Install Sediment Fence, as Shown on Plans
		7	Curb Inlet Protection	D	Install Filter Bags around Proposed Curb Inlets
		8	Rock Ditch Check	D	Install Rock Ditch Check, as Shown on Plans
Phase III	D- Final Stabilization	9	Establish Perennial Vegetation	N/A	Redistribute topsoil and seed and mulch all disturbed areas. Sod right-of-way. Stabilization complete when 100% disturbed area is established with perennial vegetation with a density of 70%.

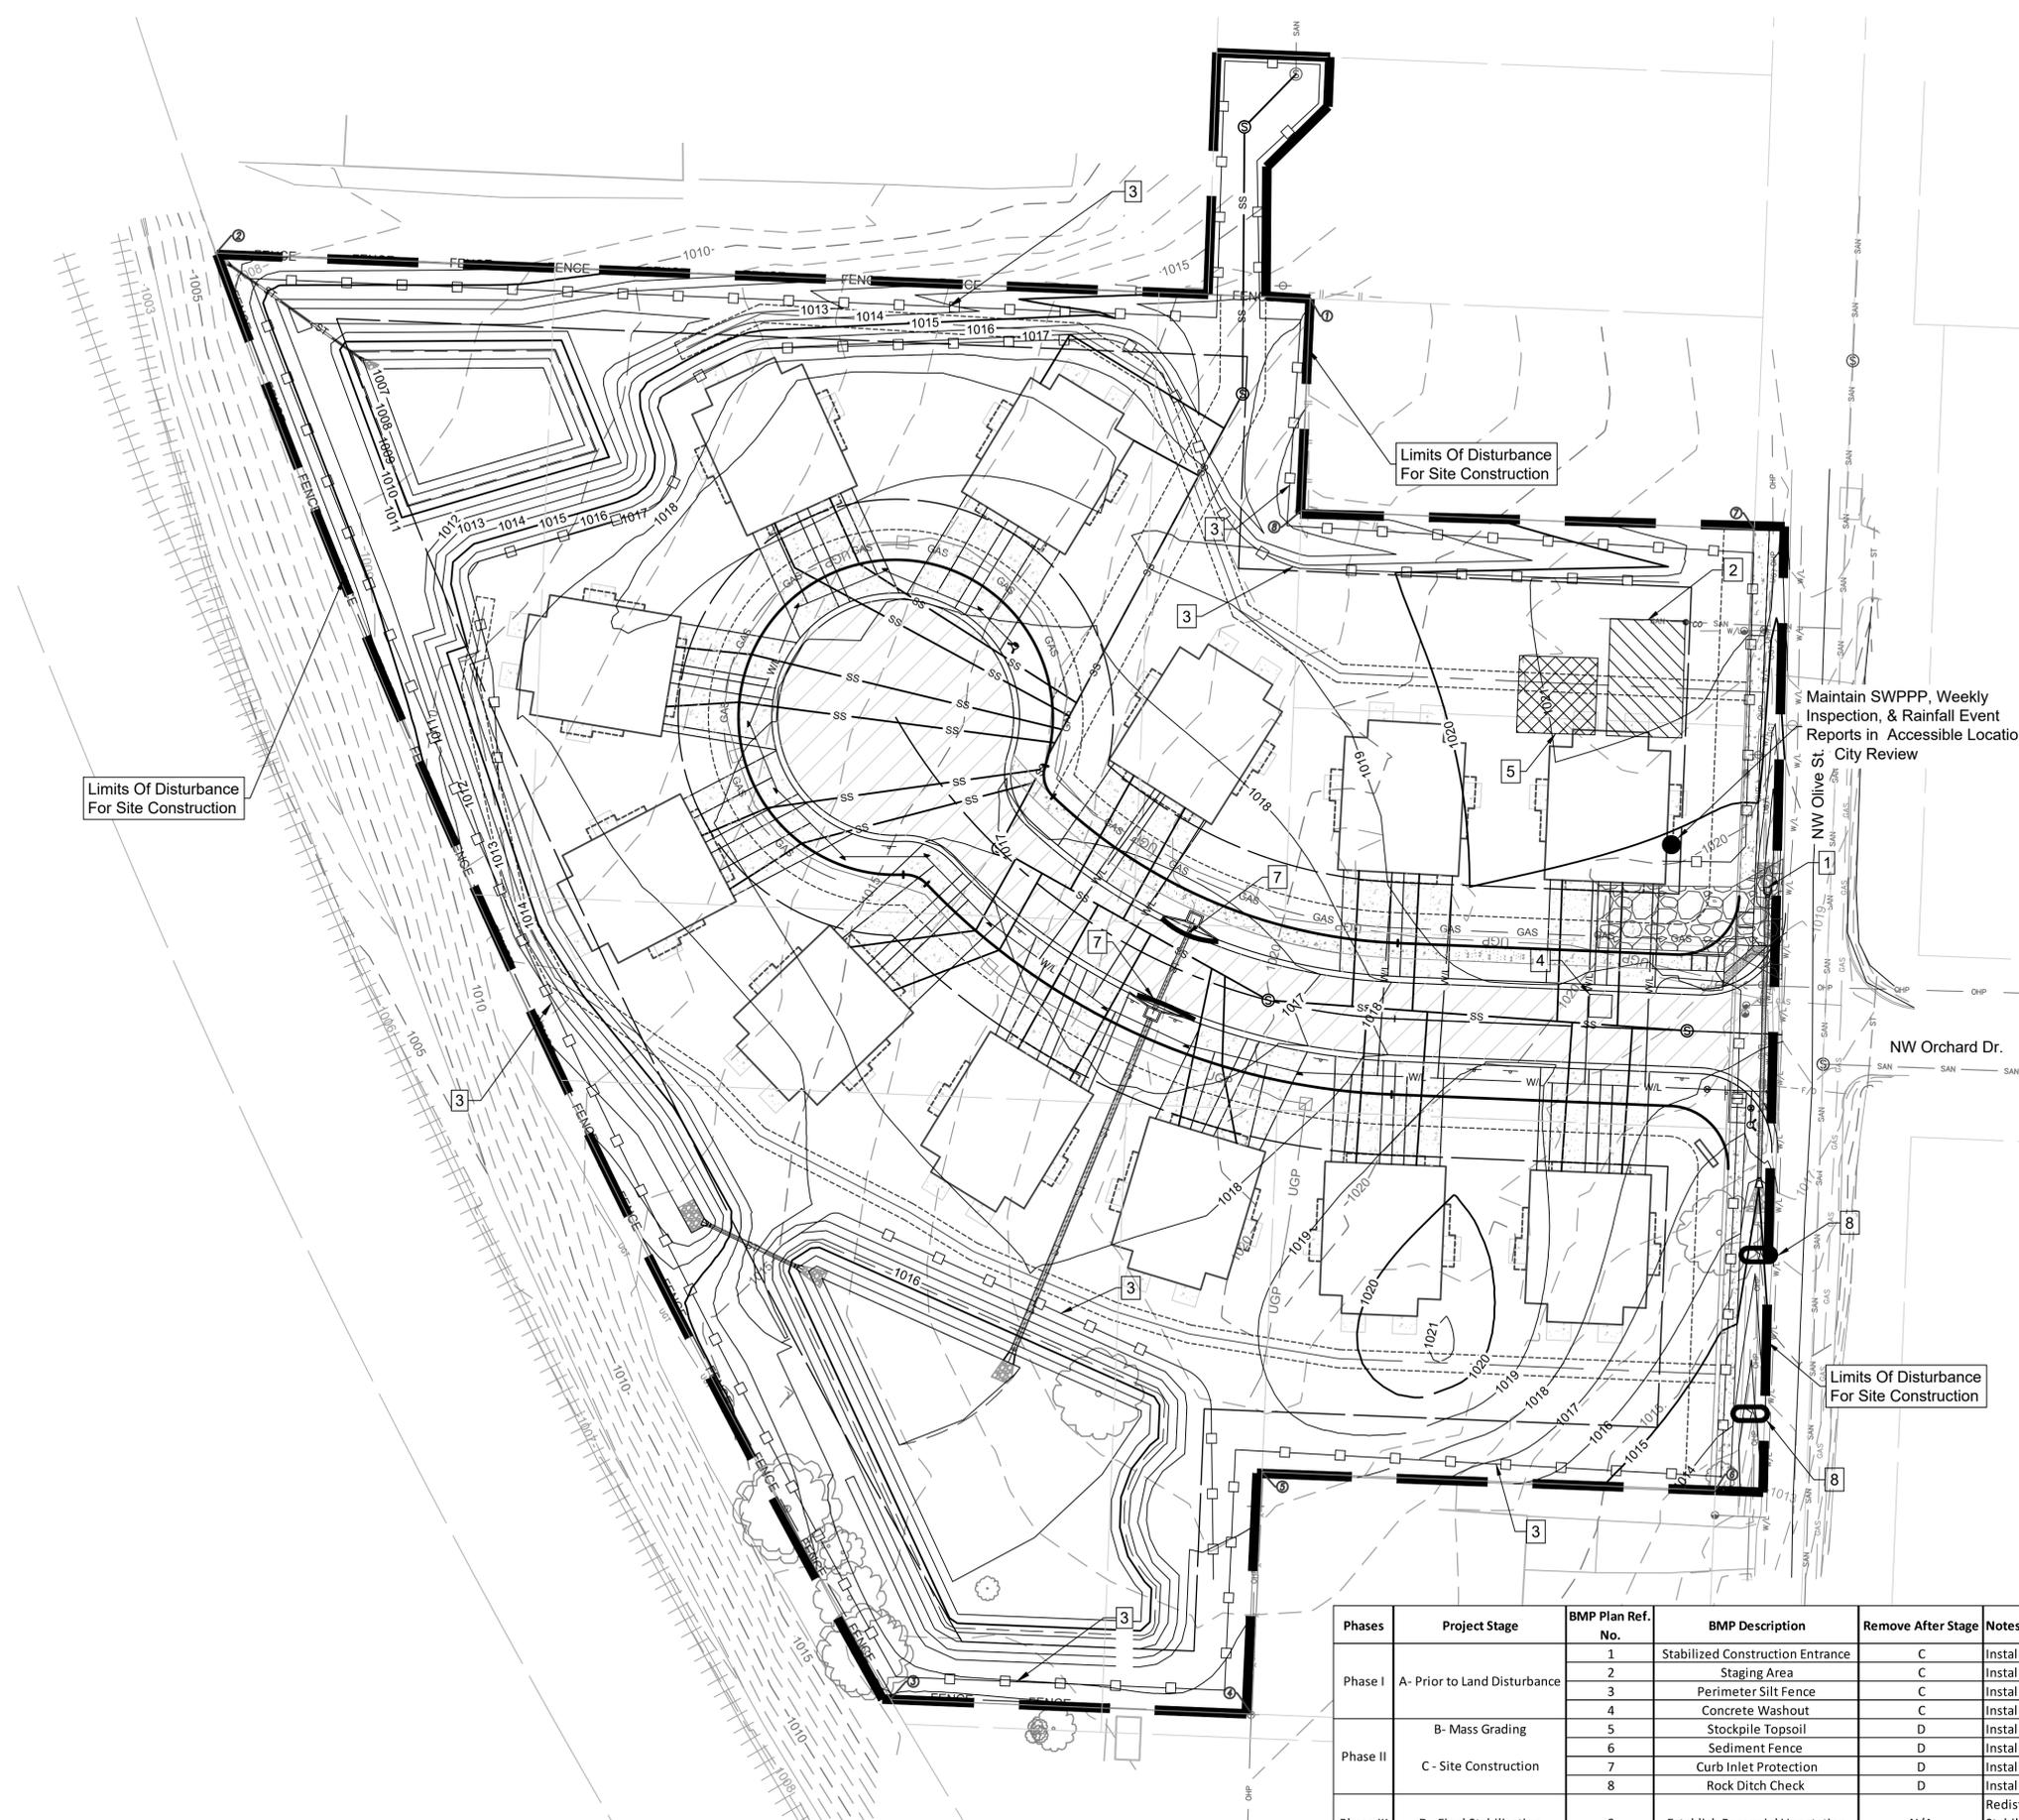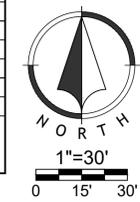

Dec 07, 2020, 3:03pm
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NO.	BY	DATE	ORIGINAL SUBMISSION	REVISION
1	JGD	MES 06/11/20	PER CITY COMMENT	
2	JGD	MES 06/08/20	PER CITY COMMENT	
3	JGD	MES 08/15/20	PER CITY COMMENT	
4	JGD	MES 10/01/20	PER CITY COMMENT	
5	JGD	MES 12/07/20	WATERLINE REVISION	

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EROSION CONTROL LEGEND

Establish Perennial Vegetation


WRITTEN SEQUENCING

- Implement Pre-Clearing Plan:**
All temporary structural BMP's shown on the pre-clearing plan must be in place before the general clearing operations. Clearing necessary to place temporary structural BMP's is the minimum required for installation. Coordinate clearing necessary to place temporary structural BMP's with local weather forecast so that clearing and placement may be completed within a forecast dry period. Stabilize all erosion control measures after installation. Temporary Barrier Fence shall be in Place, around areas not to be disturbed, prior to any construction activities. This area includes Stream Corridor.
- Clear and Stabilize Work Areas:**
Grade contractor areas and place all-weather surface on contractor areas.
- Clearing and Grubbing:**
After Phase I BMP's are installed, contractor may clear, grub, and demo required areas as necessary.

EROSION CONTROL NOTES

- Erosion control plan modifications shall be required if the plan fails to substantially control erosion and offsite sedimentation.
- The retention of access controls and sediment controls shall be required for areas where seed has not established 70% cover.
- The contractor shall temporarily seed and mulch all disturbed areas if there has been no construction activity on them for a period of fourteen (14) calendar days.
- Install "J" Hooks on silt fence every 100 LF

Phases	Project Stage	BMP Plan Ref. No.	BMP Description	Remove After Stage	Notes
Phase I	A- Prior to Land Disturbance	1	Stabilized Construction Entrance	C	Install Construction Entrance, as shown on Plans.
		2	Staging Area	C	Install Staging Area
		3	Perimeter Silt Fence	C	Install Perimeter Silt Fence, as Shown on Plans.
		4	Concrete Washout	C	Install Concrete Washout as shown on plans prior to pouring any concrete
Phase II	B- Mass Grading	5	Stockpile Topsoil	D	Install Sediment Fence a Minimum of 5' Beyond Toe of Slope
		6	Sediment Fence	D	Install Sediment Fence, as Shown on Plans
		7	Curb Inlet Protection	D	Install Filter Bags around Proposed Curb Inlets
Phase II	C- Site Construction	8	Rock Ditch Check	D	Install Rock Ditch Check, as Shown on Plans
		9	Establish Perennial Vegetation	N/A	Redistribute topsoil and seed and mulch all disturbed areas. Sod right-of-way. Stabilization complete when 100% disturbed area is established with perennial vegetation with a density of 70%.

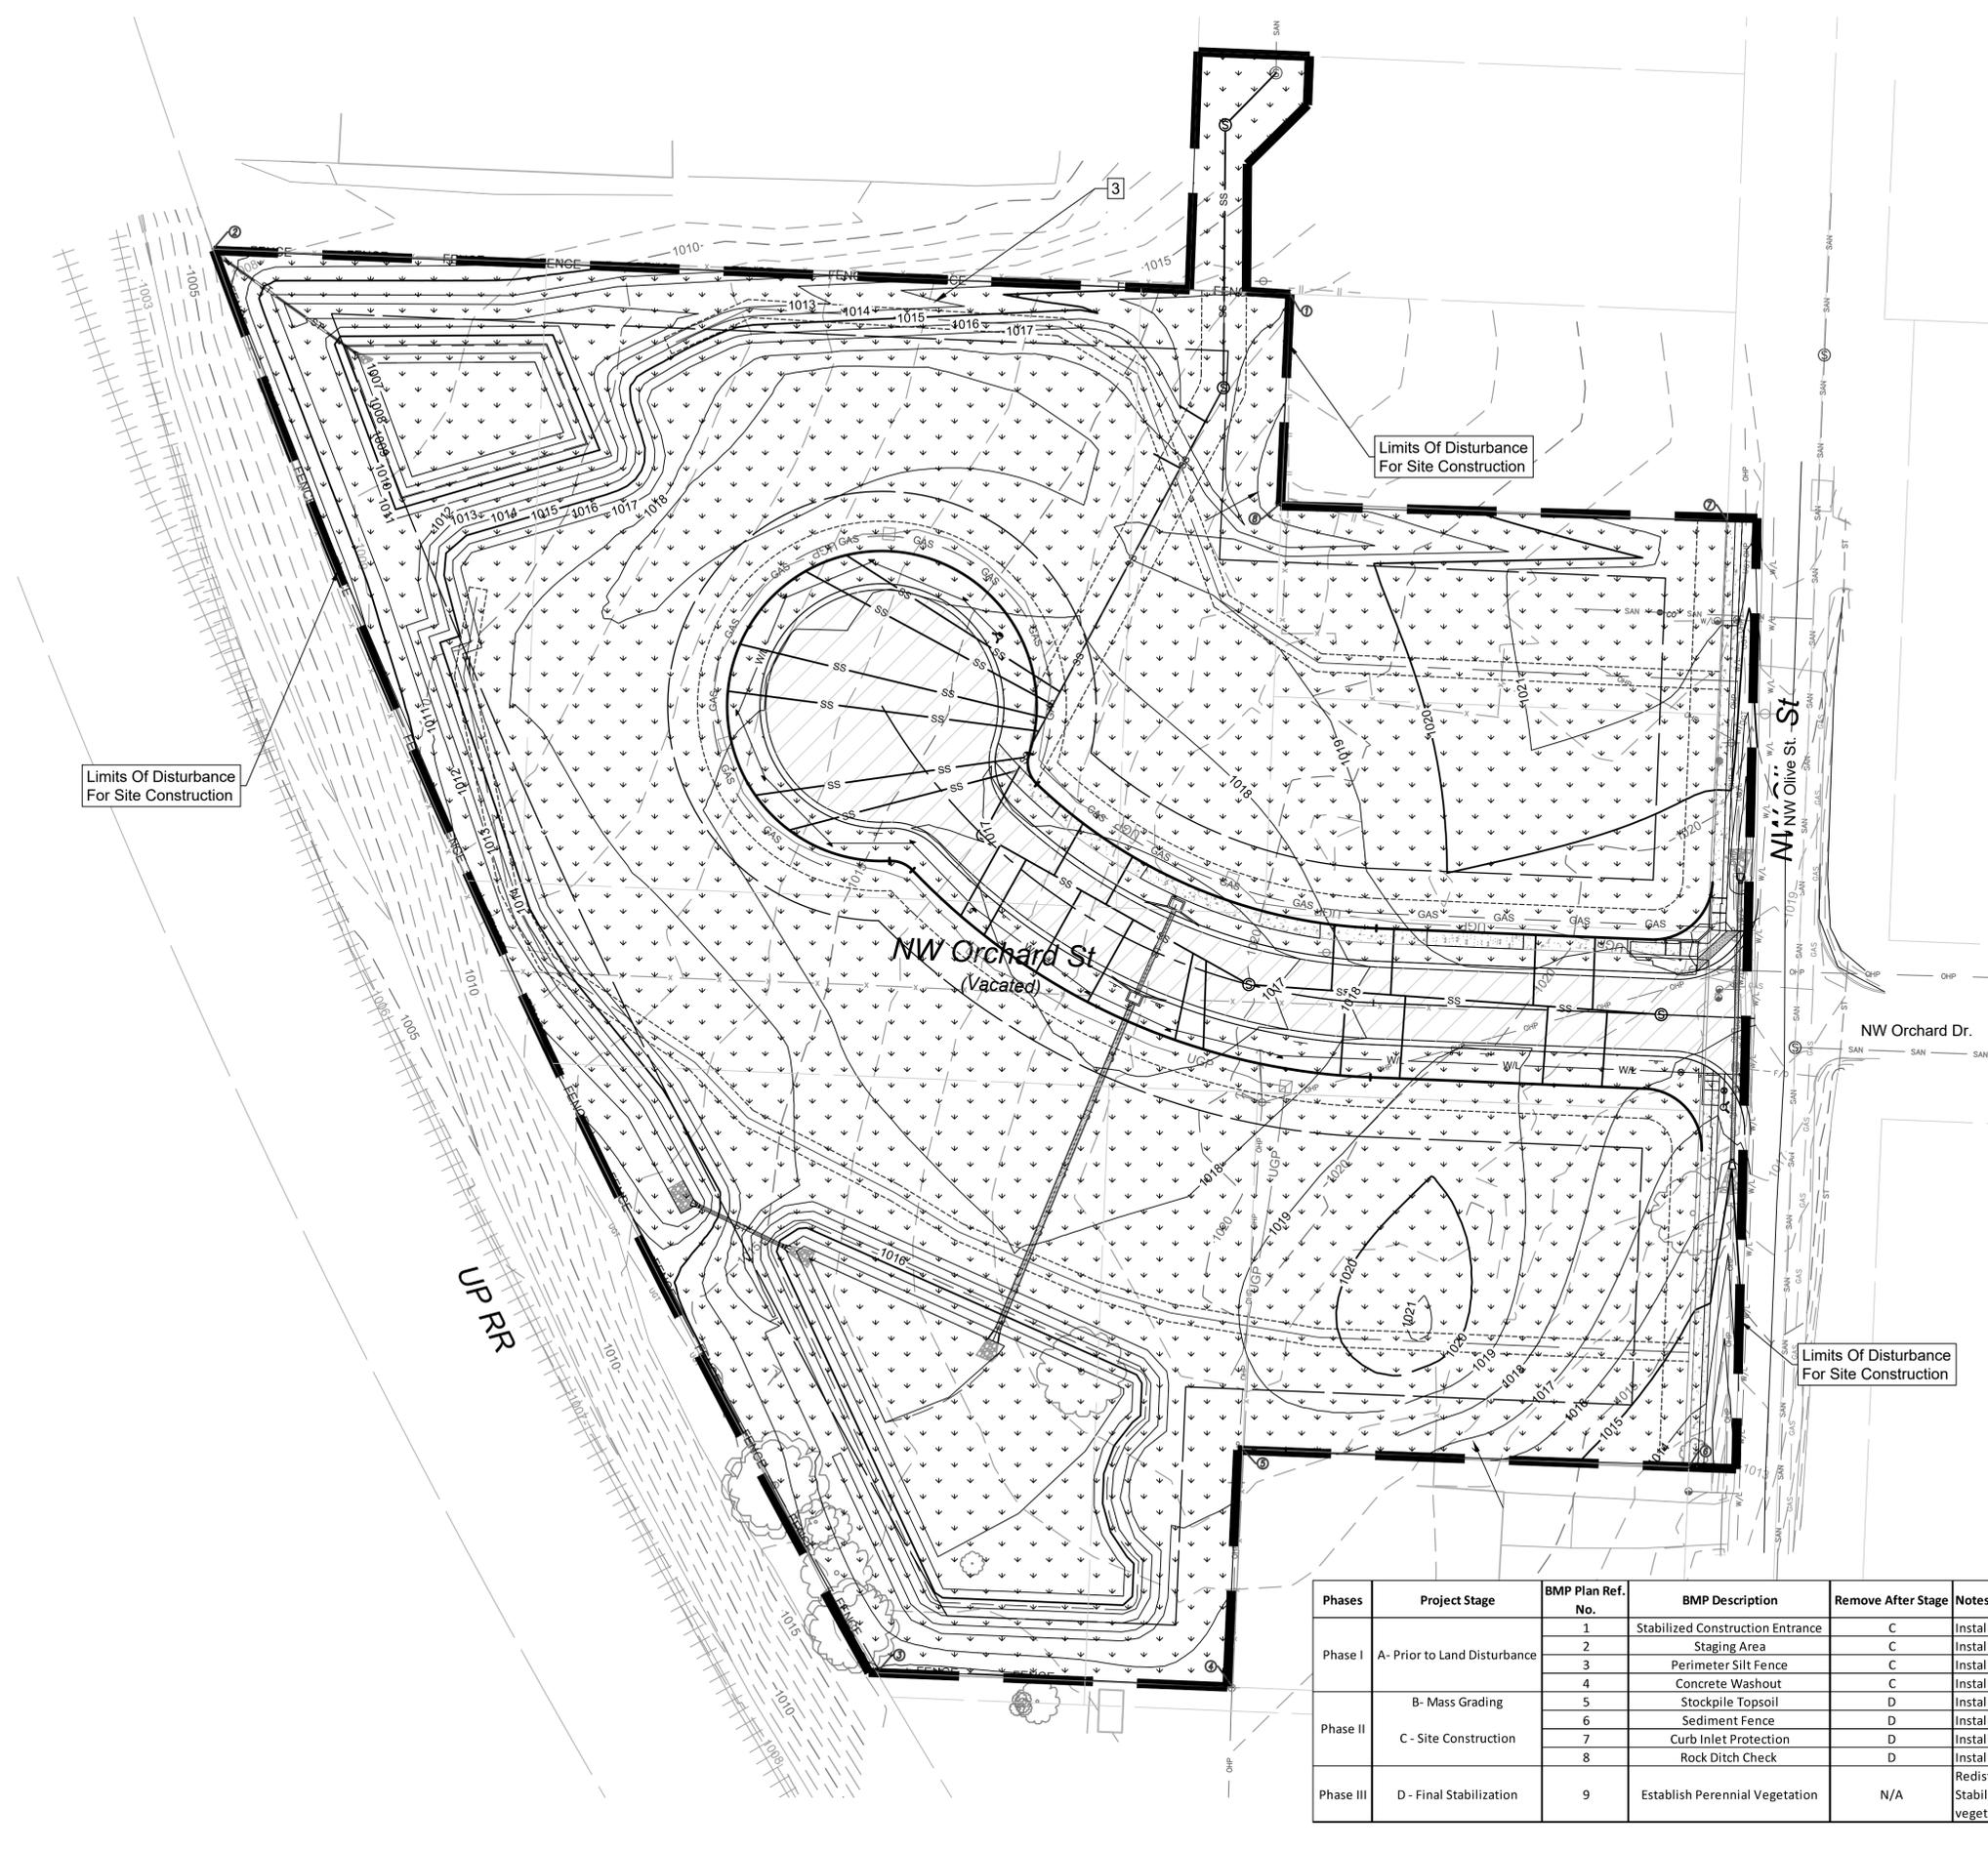

Dec 07, 2020, 3:04pm
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STANDARD INSTALLATION
NOT TO SCALE

VERTICAL RISER
NOT TO SCALE

NOTES:

- ALL SEWER STUBS SHALL BE CONSTRUCTED TO PROPERTY LINE OR 10' MINIMUM FROM THE MAIN, WHERE SIDEWALKS ARE PRESENT, CONTRACTOR SHALL EXTEND SERVICE LINE UNDER EXISTING SIDEWALK TO TWO FEET BEYOND.
- IMPERVIOUS TRENCH CHECKS SHALL BE PLACED ON BUILDING SEWER STUBS (AT LEAST 5' AWAY FROM THE SANITARY SEWER MAIN).
- TRENCH CHECKS ON THE BUILDING SEWER STUBS SHALL EXTEND 6" BELOW THE BOTTOM OF THE PIPE. LENGTH SHALL BE A MINIMUM OF 12". THE HEIGHT OF THE TRENCH CHECK SHALL EXTEND 12" ABOVE THE TOP OF THE PIPE. THE WIDTH OF THE TRENCH CHECK SHALL BE THE WIDTH OF THE TRENCH.
- SEE SPECIFICATION SECTION 2100 FOR SEWER MAIN BEDDING AND BACKFILL.
- #12 GAUGE GREEN INSULATED COPPER TRACER WIRE SHALL BE INSTALLED. TRACER WIRE TERMINAL BOXES SHALL BE INSTALLED DIRECTLY ABOVE THE SEWER SERVICE OR AS DETERMINED BY THE ENGINEER.
- FOR SERVICES, TRACER WIRE SHALL RUN FROM THE WYE AND TERMINATE IN A FLUSH MOUNTED TRACER BOX WITH A GREEN CAST IRON LOCKABLE TOP. WIRE SHALL BE TAPED OR TIED TO THE PIPE AT 5' INTERVALS.
- TRACER WIRE BOX SHALL BE INSTALLED WITHIN 1.0' OF PROPERTY LINE.
- THE TRACER WIRE SHALL REMAIN CONTINUOUS TO THE GREATEST EXTENT POSSIBLE. SPLICES IN THE TRACER WIRE SHOULD BE MADE WITH SPLIT BOLT CONNECTORS. WIRE NUTS SHALL NOT BE USED. A WATER-PROOF CONNECTION IS NECESSARY TO PREVENT CORROSION.

LEE'S SUMMIT MISSOURI
PUBLIC WORKS ENGINEERING DIVISION | 220 SE GREEN STREET | LEE'S SUMMIT, MO 64063
BUILDING SEWER STUB AND RISER

Date: 12/13
Drawn By: SC
Checked By: DL
FILE: SAN-1
Rev: 10/15
Rev: 12/15

STANDARD PRECAST MANHOLE - SANITARY SEWER

NOTES:

- PRECAST CONCRETE MANHOLES SHALL CONFORM TO ASTM C478 EXCEPT AS MODIFIED BY THE SPECIFICATIONS.
- A WALL THICKNESS NOT LESS THAN ONE-TWELFTH (1/12) OF THE INSIDE DIAMETER OR 4", WHICHEVER IS GREATER, SHALL BE USED WHEN THE MANHOLE DEPTH IS LESS THAN 15'.
- WATERPROOFING SHALL BE REQUIRED ON THE OUTSIDE OF MANHOLES. THE WATERPROOFING SHALL CONSIST OF A TOTAL DRY FILM THICKNESS OF NOT LESS THAN 14 MILS OF BITUMINOUS COATING.
- ONLY ECCENTRIC MANHOLE CONES WILL BE ALLOWED UNLESS OTHERWISE APPROVED BY THE CITY ENGINEER.
- THE FILL CONCRETE FLOW CHANNEL FOR SIDE BRANCHES SHALL BE PLACED TO PROVIDE A SMOOTH TRANSITION INTO THE FLOW LINE.
- REFER TO THE APPROVED PRODUCTS LIST FOR WATER UTILITIES FOR APPROVED MANHOLE GASKET MODELS.
- REFER TO THE APPROVED PRODUCTS LIST FOR APPROVED STEPS.

LEE'S SUMMIT MISSOURI
PUBLIC WORKS ENGINEERING DIVISION | 220 SE GREEN STREET | LEE'S SUMMIT, MO 64063
STANDARD PRECAST MANHOLE - SANITARY SEWER

Date: 02/13
Drawn By: JN
Checked By: DL
FILE: SAN-2
Rev: 1/14
Rev:

SLAB MANHOLE FRAME
LEE'S SUMMIT PART NO.: LS103A
MINIMUM WEIGHT = 145 LB

STANDARD 24" MANHOLE FRAME
LEE'S SUMMIT PART NO.: LS101A
MINIMUM WEIGHT = 250 LB

*COVER AND FRAME MODEL INFORMATION REFER TO THE STORMWATER APPROVED PRODUCTS LIST.

LEE'S SUMMIT MISSOURI
PUBLIC WORKS ENGINEERING DIVISION | 220 SE GREEN STREET | LEE'S SUMMIT, MO 64063
STORM MANHOLE FRAME DETAIL

Date: 04/17
Drawn By: MJF
Checked By: DL
STM-7

NEW MANHOLE

EXISTING MANHOLE

MANHOLE WALL CONNECTIONS

LEE'S SUMMIT MISSOURI
PUBLIC WORKS ENGINEERING DIVISION | 220 SE GREEN STREET | LEE'S SUMMIT, MO 64063
MANHOLE WALL CONNECTIONS

Date: 02/13
Drawn By: JN
Checked By: DL
FILE: SAN-5
Rev: 1/14
Rev:

FLARED END SECTION SUPPORT DETAIL

LEE'S SUMMIT MISSOURI
PUBLIC WORKS ENGINEERING DIVISION | 220 SE GREEN STREET | LEE'S SUMMIT, MO 64063
FLARED END SECTION SUPPORT DETAIL

Date: 04/17
Drawn By: MJF
Checked By: DL
STM-5

CURB INLET DETAIL

LEE'S SUMMIT MISSOURI
PUBLIC WORKS ENGINEERING DIVISION | 220 SE GREEN STREET | LEE'S SUMMIT, MO 64063
CURB INLET DETAIL

GENERAL NOTES:

- ALL WELDS SHALL BE PERFORMED IN ACCORDANCE WITH APPROPRIATE AWS SPECIFICATIONS AND PROCEDURES.
- ALL WELDS ON EXPOSED SURFACES SHALL BE DRESSED SO AS TO PROVIDE A PLEASING FINISHED APPEARANCE.
- THE ENTIRE FRAME SHALL BE PAINTED A SINGLE COAT OF CHEM-PRIME #37H-78 PRIMER (GRAY) OR EQUAL.

STEEL FRAME NOTES:

- ALL WELLS SHALL BE CENTERED VERTICALLY AND HORIZONTALLY.
- ALL WELLS SHALL BE PERFORMED IN ACCORDANCE WITH APPROPRIATE AWS SPECIFICATIONS AND PROCEDURES.
- ALL WELDS ON EXPOSED SURFACES SHALL BE DRESSED SO AS TO PROVIDE A PLEASING FINISHED APPEARANCE.
- THE ENTIRE FRAME SHALL BE PAINTED A SINGLE COAT OF CHEM-PRIME #37H-78 PRIMER (GRAY) OR EQUAL.

LEE'S SUMMIT MISSOURI
PUBLIC WORKS ENGINEERING DIVISION | 220 SE GREEN STREET | LEE'S SUMMIT, MO 64063
CURB INLET DETAIL

Date: 04/17
Drawn By: MJF
Checked By: DL
STM-1

NO.	BY	DATE	REVISION
1	JGD	MES 12/07/20	WATERLINE REVISION
2	JGD	MES 10/01/20	PER CITY COMMENT
3	JGD	MES 08/15/20	PER CITY COMMENT
2	JGD	MES 06/11/20	PER CITY COMMENT
1	JGD	MES 05/08/20	ORIGINAL SUBMISSION

Renaissance Infrastructure Consulting

1815 MCCOY STREET, SUITE 200
KANSAS CITY, MISSOURI 64108
816.800.0950
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MO Certificate of Authority: E-2010033630



Dec 07 - 2020 - 3:04pm
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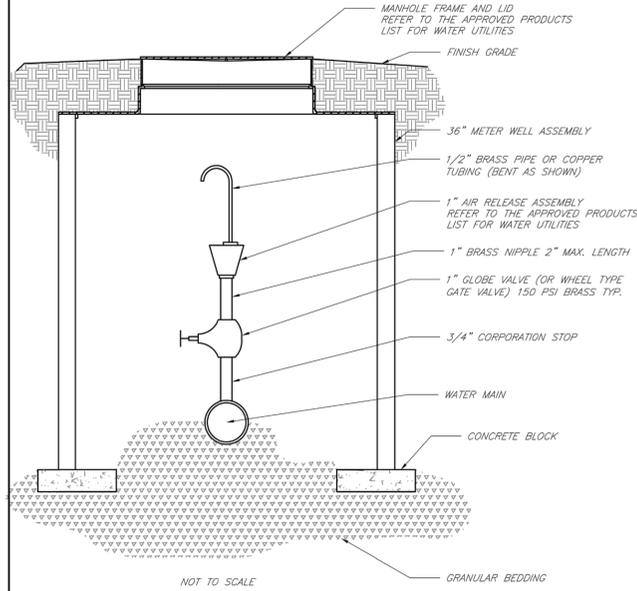


STANDARD 24" MANHOLE COVER
MINIMUM WEIGHT = 160 LB
NOTE: PICK HOLES NOT SHOWN
*COVER AND FRAME MODEL INFORMATION REFER TO
THE STORMWATER APPROVED PRODUCT LIST.



**LEE'S SUMMIT
MISSOURI**
PUBLIC WORKS ENGINEERING DIVISION | 220 SE GREEN STREET | LEE'S SUMMIT, MO 64063
STORM MANHOLE COVER DETAIL

Date: 04/17
Drawn By: MIF
Checked By: DL
STM-6



NOT TO SCALE




**LEE'S SUMMIT
MISSOURI**
PUBLIC WORKS ENGINEERING DIVISION | 220 SE GREEN STREET | LEE'S SUMMIT, MO 64063
AIR RELEASE ASSEMBLY

Date: 02/13
Drawn By: JN
Checked By: DL
FILE: WAT-10
Rev: 1/14

REQUIRED CONCRETE BEARING AREA (SQ. FEET - SF)


NOM. DIA. (INCHES)	TEE, PLUG	90 BEND	45 BEND	22.5 BEND	11.25 BEND
6	4.7	6.7	4.0	4.0	4.0
8	8.4	11.8	6.4	4.0	4.0
10	13.1	18.5	10.0	5.1	4.0
12	18.8	26.7	14.4	7.4	4.0
14	25.7	36.3	19.6	10.0	5.0
16	33.5	47.4	25.6	13.1	6.6
18	42.4	60.1	32.5	16.5	8.3
20	REST. JT.	REST. JT.	REST. JT.	20.4	10.3
24	REST. JT.	REST. JT.	REST. JT.	29.4	14.8

- NOTES:
1. ALL BENDS WITHOUT RESTRAINED JOINTS SHALL HAVE CONCRETE THRUST BLOCKS INSTALLED FOR RESTRAINT.
2. MEGA LUGS MAY BE USED ONLY IN CONJUNCTION WITH CONCRETE THRUST BLOCKING.
3. BEARING AREA MUST BE AGAINST UNDISTURBED SOIL.
4. DO NOT COVER JOINTS OR BOLTS (WHERE APPLICABLE) WITH CONCRETE.

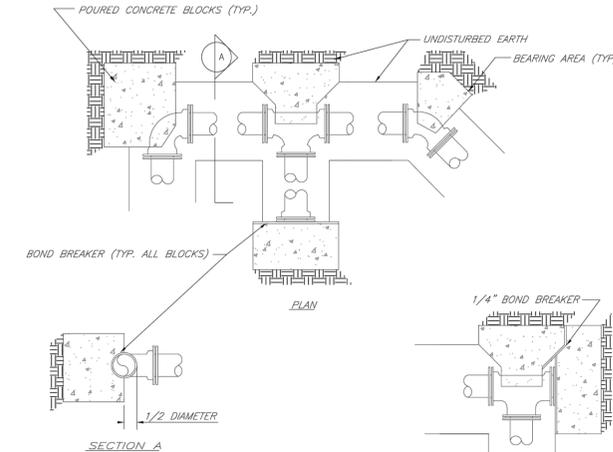

**LEE'S SUMMIT
MISSOURI**
PUBLIC WORKS ENGINEERING DIVISION | 220 SE GREEN STREET | LEE'S SUMMIT, MO 64063
HORIZONTAL THRUST BLOCKS

Date: 02/13
Drawn By: JN
Checked By: DL
FILE: WAT-1
Rev: 1/14

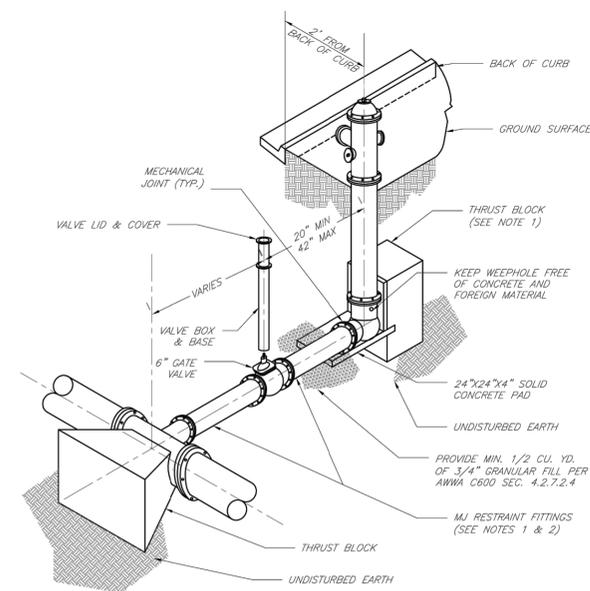


- NOTES:
1. WHEN RETAINER GLANDS ARE USED IN LIEU OF MECHANICAL JOINT (MJ) RESTRAINT FITTINGS, HORIZONTAL THRUST BLOCKS ARE REQUIRED.
2. GATE VALVE MAY BE BOLTED DIRECTLY TO MJ RESTRAINT TEE.
3. SEE APPROVED PRODUCTS LIST FOR WATER UTILITIES FOR FIRE HYDRANT, VALVES, VALVE BOX LID, AND COVER.
4. BOTTOM HYDRANT FLANGE SHALL BE 2" TO 6" ABOVE FINISHED GRADE.
5. FOR STREETS WITHOUT CURBS FIRE HYDRANTS SHALL BE PLACED WITHIN 1 FOOT OF THE R/W LINE, BUT NOT MORE THAN 10" FROM EDGE OF PAVEMENT. FIRE HYDRANT SHALL NOT BE PLACED IN BOTTOM OF DITCH.
6. HYDRANT SHALL BE ROTATED AS DIRECTED BY INSPECTOR.



**LEE'S SUMMIT
MISSOURI**
PUBLIC WORKS ENGINEERING DIVISION | 220 SE GREEN STREET | LEE'S SUMMIT, MO 64063
HYDRANT INSTALLATION - STRAIGHT SET

Date: 02/13
Drawn By: JN
Checked By: DL
FILE: WAT-7
Rev: 1/14

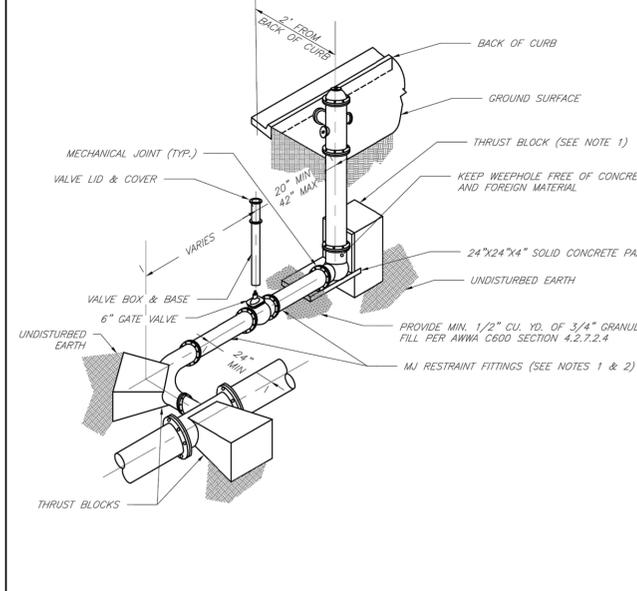

- NOTES:
1. WHEN RETAINER GLANDS ARE USED IN LIEU OF MECHANICAL JOINT (MJ) RESTRAINT FITTINGS, HORIZONTAL THRUST BLOCKS ARE REQUIRED.
2. GATE VALVE MAY BE BOLTED DIRECTLY TO MJ RESTRAINT TEE.
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6. HYDRANT SHALL BE ROTATED AS DIRECTED BY INSPECTOR.




**LEE'S SUMMIT
MISSOURI**
PUBLIC WORKS ENGINEERING DIVISION | 220 SE GREEN STREET | LEE'S SUMMIT, MO 64063
HYDRANT WITH 90 DEGREE BEND

Date: 02/13
Drawn By: JN
Checked By: DL
FILE: WAT-8
Rev: 1/14

REQUIRED CONCRETE VOLUME (CUBIC FEET - CF)

NOM. DIA. (INCHES)	TEE, PLUG	90 BEND	45 BEND	22.5 BEND	11.25 BEND
6	50.5	71.4	38.6	19.7	8.9
8	89.8	126.9	68.7	35.0	17.6
10	140.2	198.3	107.3	54.7	27.5
12	202.0	287.1	154.6	78.8	39.6
14	REST. JT.	REST. JT.	REST. JT.	107.3	51.9
16	REST. JT.	REST. JT.	REST. JT.	140.1	70.4
18	REST. JT.	REST. JT.	REST. JT.	177.3	89.1
20	REST. JT.	REST. JT.	REST. JT.	210.4	110.0
24	REST. JT.	REST. JT.	REST. JT.	258.4	130.4

- NOTES:
1. ALL BENDS WITHOUT RESTRAINED JOINTS SHALL HAVE CONCRETE THRUST BLOCKS INSTALLED FOR RESTRAINT.
2. MEGA LUGS MAY BE USED ONLY IN CONJUNCTION WITH CONCRETE THRUST BLOCKING.
3. BEARING AREA MUST BE AGAINST UNDISTURBED SOIL.
4. DO NOT COVER JOINTS OR BOLTS (WHERE APPLICABLE) WITH CONCRETE.

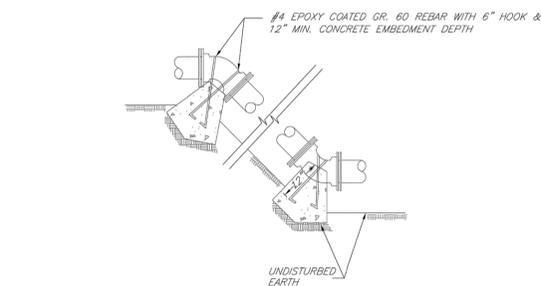


**LEE'S SUMMIT
MISSOURI**
PUBLIC WORKS ENGINEERING DIVISION | 220 SE GREEN STREET | LEE'S SUMMIT, MO 64063
VERTICAL THRUST BLOCKS

Date: 02/13
Drawn By: JN
Checked By: DL
FILE: WAT-2
Rev: 1/14

NO.	BY	DATE	ORIGINAL SUBMISSION	PER CITY COMMENT	PER CITY COMMENT	WATERLINE REVISION
1	JGD	MES 06/11/20				
2	JGD	MES 06/11/20				
3	JGD	MES 08/15/20				
4	JGD	MES 10/01/20				
5	JGD	MES 12/07/20				

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KANSAS CITY, MISSOURI 64108
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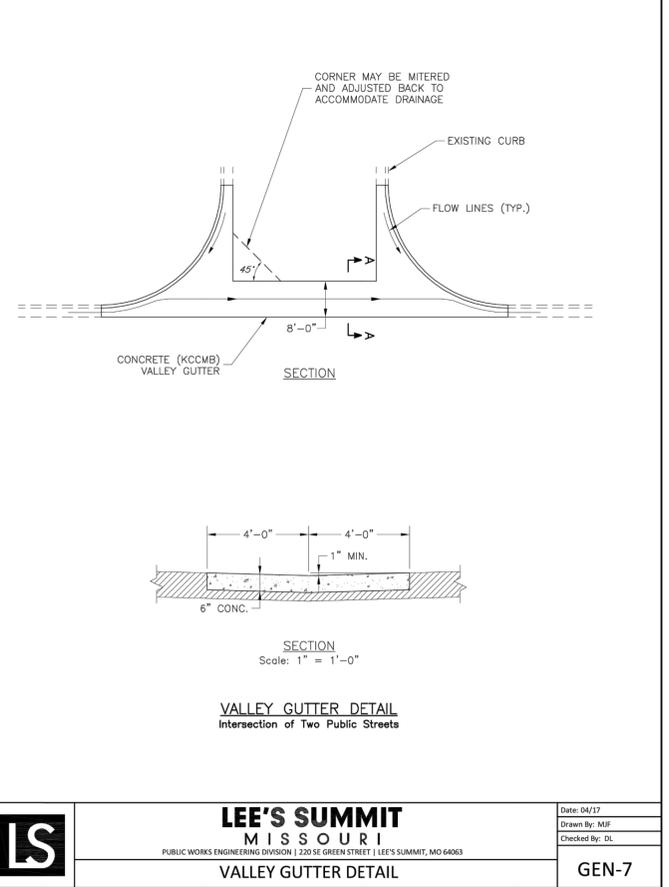
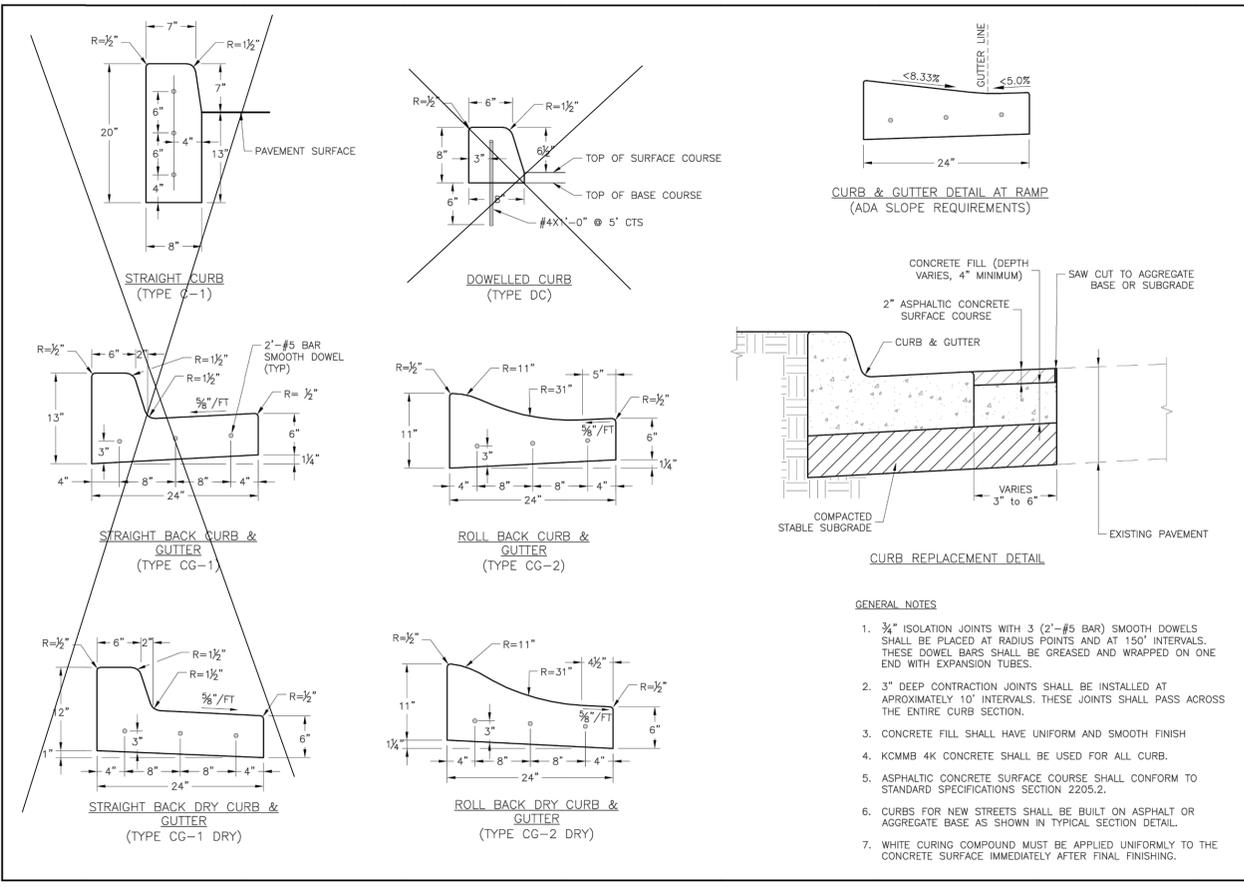
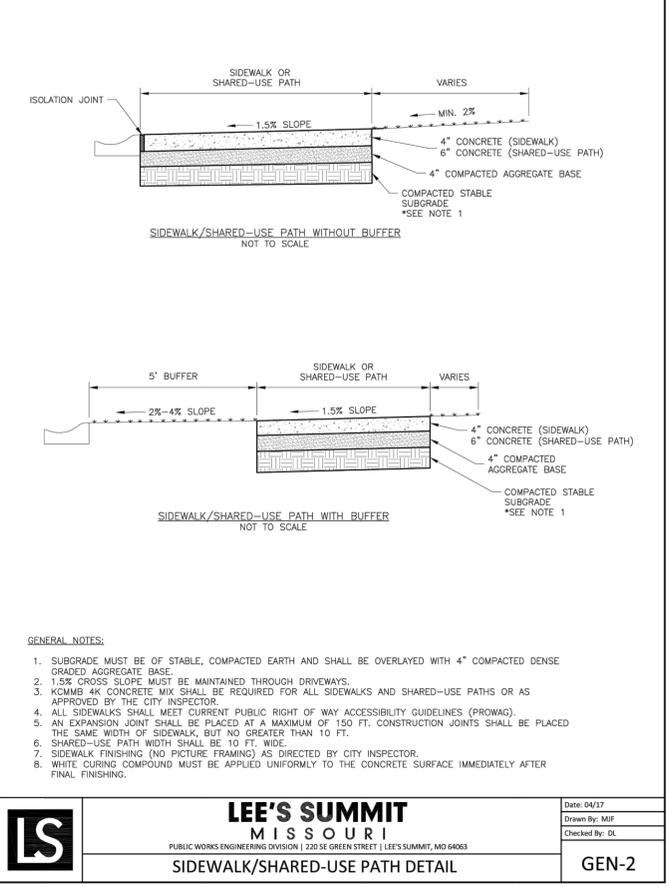


LEE'S SUMMIT MISSOURI
PUBLIC WORKS ENGINEERING DIVISION | 220 SE GREEN STREET | LEE'S SUMMIT, MO 64083

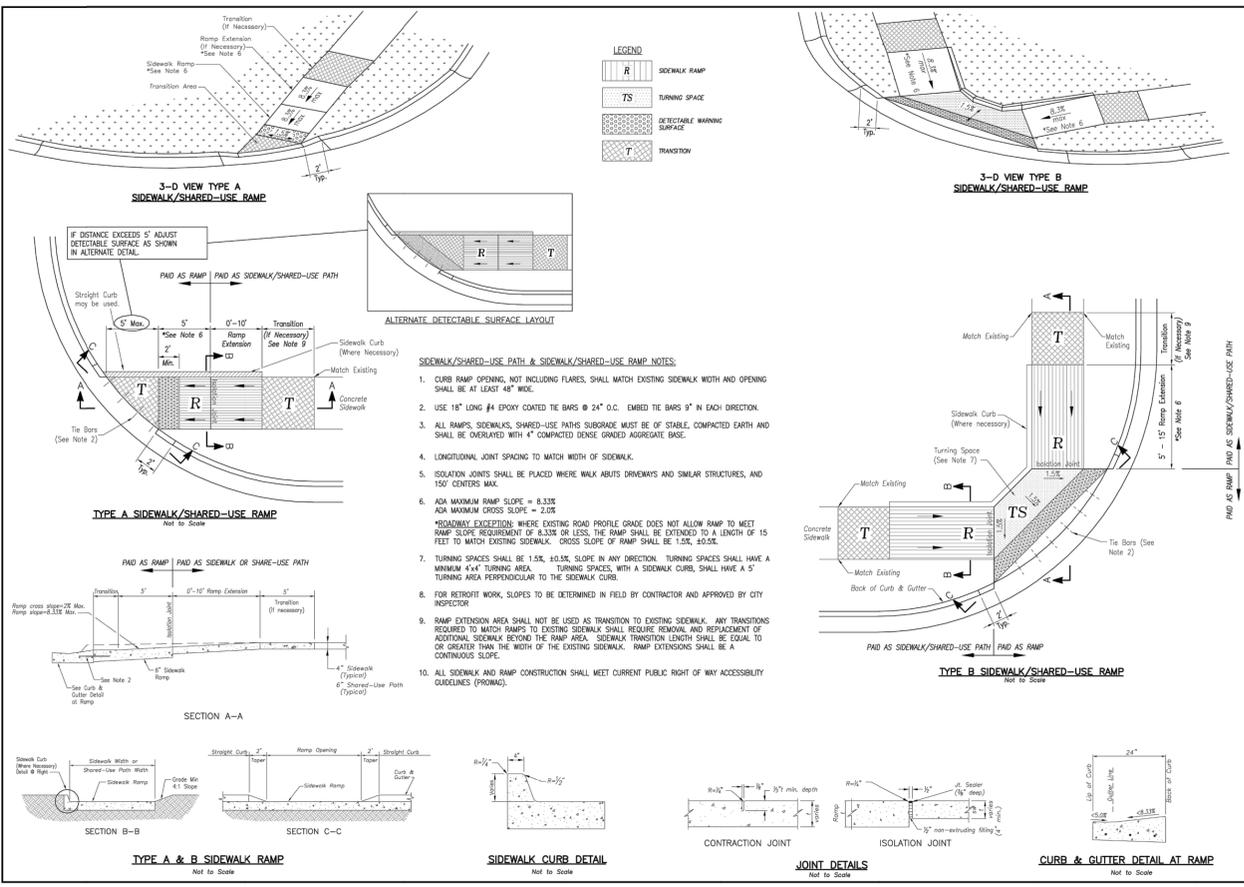STANDARD DETAILS
CITY OF LEE'S SUMMIT, MO
LEE'S SUMMIT, JACKSON COUNTY, MO


GEN-3A
CURB & GUTTER DETAIL

Drawn By: MIF
Checked By: DL
Date: 04/17
Scale: 1/8" = 1'-0"



NO.	BY	DATE	REVISION
1	JGD	06/11/20	ORIGINAL SUBMISSION
2	JGD	06/11/20	PER CITY COMMENT
3	JGD	08/15/20	PER CITY COMMENT
4	JGD	10/01/20	PER CITY COMMENT
5	JGD	12/07/20	WATERLINE REVISION

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NO.	BY	DATE	REVISION
1	JGD	08/11/20	ORIGINAL SUBMISSION
2	JGD	06/11/20	PER CITY COMMENT
3	JGD	08/15/20	PER CITY COMMENT
4	JGD	10/01/20	WATERLINE REVISION
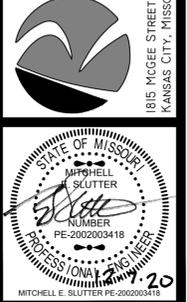
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PE-2002003418
E-20100033630

Professional Engineer Seal for Mitchell E. Slutter, Missouri License No. PE-2002003418

SIGN MOUNTING DETAILS

NOTE: * The height to the bottom of a sign when it is located in a pedestrian walkway or extends into a walkway shall be a minimum of 80 inches above the walkway.

NOTE: 1. Generally, the sign mounting height should not be more than 1' greater than the minimum mounting height.

CONTROL SIGN LOCATION

MEDIAN SIGN LOCATION

NOTES:
1. A 4" V.C. slope shall be installed in new concrete medians at each location where a sign is to be installed.
2. For existing concrete medians, a 4" hole shall be covered into the concrete.

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Sheet Name: STANDARD DRAWING SN-1
Drawn By: RS, Checked By: JW, Date: 08/28/2009, Project: 18-0251, 1 OF 1

U-STEEL POST DETAILS

U-STEEL POST NOTES:
1. Sign post shall be positioned entirely between finished grade line and 18" above finished grade line. Only one splice will be allowed per post.
2. U-Steel post shall be 3.0 ft. galvanized according to ASTM A153.
3. U-Steel post can be used for installation of signs with an area of less than 2.5 square feet.
4. All posts shall be embedded a minimum of 3 feet.

STRAP TYPE SIGN SUPPORT DETAILS

METAL POLE SIGN MOUNTING NOTES:
1. Signs on metal poles shall be attached with two brackets and stainless steel bands.
2. Holes in sign for attachment to the mounting brackets shall be offset a minimum of 2 inches from the edge of the sign.
3. Holes in sign shall be located such that the sign is level.
4. All strap, brackets, and seal materials should be Type 304 stainless steel.

SQUARE STEEL POST DETAILS

SQUARE STEEL POST NOTES:
1. Square steel sign posts and break-away anchor shall consist of the following materials:
Sign Post - 14 Ga. 2" x 2" Square Steel Post
Post Anchor - 12 Ga. 2 1/2" x 1/2" x 36" Square Steel Post
Anchor Sleeve - 12 Ga. 2 1/2" x 2 1/2" x 18" Square Steel Post
2. 14 Gauge posts must meet certified minimum yield strength of 60,000 psi.
3. In all installations the first hole above the finished grade line on the sign post, anchor, and anchor sleeve must be in line for the insertion of the corner bolt.
4. The maximum area for one sign post is 9.0 square feet. A sign or combination of signs with an area greater than 9.0 square feet will require two posts. Also, signs with a width greater than 36" (not including 36" x 36" diamond shaped signs) will require two posts.

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Sheet Name: STANDARD DRAWING SN-2
Drawn By: RS, Checked By: JW, Date: 08/28/2009, Project: 18-0251, 2 OF 2

STANDARD ABBREVIATION LISTS

Named Streets	AVE
Boulevard	BLVD
Circle	CR
Creek	CR
Court	CT
Crossing	XING
Drive	DR
Highway	HWY
Lane	LN
Parkway	PKWY
Place	PL
Road	RD
Street	ST
Terrace	TER
Trail	TRL
Way	WAY

STREET NAME SIGN QUANTITIES

Sign Designation	Sign Size	Sign Area (Sq. Ft.)	Number	Quantity (Sq. Ft.)
D3-1 (SP-1)	8" x 36"	Sq. Ft.	1	1
D3-1 (SP-2)	8" x 48"	Sq. Ft.	1	1
D3-1 (SP-3)	8" x 36"	Sq. Ft.	1	1
D3-1 (SP-4)	8" x 48"	Sq. Ft.	1	1
D3-1 (SP-5)	8" x 36"	Sq. Ft.	1	1
D3-1 (SP-6)	8" x 48"	Sq. Ft.	1	1

STREET NAME SIGN FACE DETAILS

Notes:
1. For all street name signs, the legend shall be white and the background shall be green.
2. Arrows shall be added to street name signs where the name of a street changes at an intersection. Street name signs with arrows are to be installed on each side of the intersection to indicate the change in names. Arrows shall be white.
3. The "PRIVATE STREET" tag should be added to the end of street name signs to indicate where a street that is outside the right-of-way intersects a public street. The background for the "PRIVATE STREET" tag shall be yellow.

PROJECT SIGN DETAILS

STREET NAME SIGN TAG DETAIL

WING BRACKET MOUNTING DETAILS

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Sheet Name: STANDARD DRAWING SN-3
Drawn By: RS, Checked By: JW, Date: 08/28/2009, Project: 18-0251, 3 OF 3