
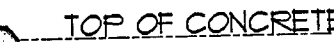


G-GRILLS T-TEMPERD A-ARCHED

\*\*\*This condition shall supersede note E2 listed under "Elevation Notes" on this drawing.

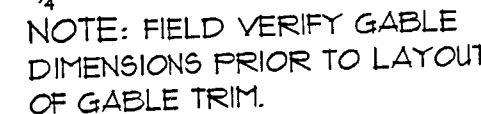

ALL MANUFACTURED ITEMS, MATERIALS, AND EQUIPMENT SHALL BE INSTALLED, ERECTED, APPLIED, USED, CONDITIONED, ADJUSTED, AND CLEANED IN ACCORDANCE WITH THE CURRENT DIRECTIONS, INSTRUCTIONS, AND RECOMMENDATIONS OF THE MANUFACTURER AND WITH CURRENT PRINTED STANDARD SPECIFICATIONS WHICH ARE ISSUED AND RECOMMENDED BY ORGANIZED ASSOCIATIONS OF MANUFACTURERS, CRAFTS, AND TRADES.

PROVIDE 1/4" SPARK-EROSION-RESISTANT WIRE MESH

STUCCO ON METAL LATH ON 30" FELT OVER 1/2" O.S.B. (CONTINUOUS SHEATHING)  
EXTEND STUCCO TO WITHIN 8" OF FINISHED GRADE.

CAST STONE VENEER IN ACCORDANCE WITH MANUFACTURER'S INSTRUCTIONS. STALL PER MANUFACTURER'S

NOT USED.

TIGHT BARGE

- E.1 EXTEND FLOOR FRAMING AND INSULATE SOFFIT
- E.2 NOT USED.
- E.3 NOT USED.
- E.10 NOT USED.
- E.11 NOT USED.
- E.12 NOT USED.
- E.B 2- 5/4" x6" SMART TRIM W/ FLASHING BEHIND.

Development Services

**1 EVANSTON 'D'**  
**FRONT ELEVATION**  
1/4" = 1'-0"

**GENTRY DESIGN STUDIO**  
128 SOUTH CHESTNUT • OLATHE, KS 66061  
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OVERLAND PARK, KANSAS 66201

DRAWN BY: LG  
DATE: 11-01-2018  
PROJECT NO: 02PUG10

SHEET NO. **A1**



## GENERAL NOTES

PLANS COMPLY WITH 2012 INTERNATIONAL RESIDENTIAL CODE.

A. GLAZING: GLAZING IN THE FOLLOWING LOCATIONS SHALL BE OF APPROVED SAFETY GLAZING MATERIALS: DOORS, GLAZING ADJACENT TO DOORS WHERE THE NEAREST VERTICAL EDGE IS WITHIN A 24" ARC OF THE DOOR IN A CLOSED POSITION AND WHERE THE EXPOSED AREA OF A PANEL IS LARGER THAN 9 SF. AND THE BOTTOM EDGE IS LESS THAN 18" AFF. AND THE TOP EDGE IS MORE THAN 36" AFF. AND A WALKING SURFACE IS WITHIN 36" OF THE GLAZING. GLAZING IN GUARDS AND RAILINGS, GLAZING ENCLOSING WET ACTIVITIES WHERE THE BOTTOM EDGE OF GLAZING IS LESS THAN 60" ABOVE ANY STANDING SURFACE, GLAZING ADJACENT TO STAIRS, LANDINGS (INCLUDING LANDING AT BOTTOM OF STAIRS), AND RAMPS WHEN THE BOTTOM OF THE GLAZING IS LESS THAN 36" ABOVE THE PLANE OF THE ADJACENT WALKING SURFACE.

B. SMOKE DETECTORS: PROVIDE SMOKE ALARMS IN EACH SLEEPING ROOM, OUTSIDE OF EACH SLEEPING AREA AND ON EACH STORY, INCLUDING BASEMENTS AND HABITABLE ATTICS. ALARMS SHALL BE INTERCONNECTED SO THAT THE ACTIVATION OF ONE ALARM WILL ACTIVATE ALL ALARMS IN THE DWELLING AND SHALL BE HARD-WIRED WITH BATTERY BACK-UP.

C. CARBON MONOXIDE ALARMS SHALL BE PROVIDED IN DWELLING UNITS WHERE FUEL FIRED APPLIANCES ARE INSTALLED OR WHICH HAVE ATTACHED GARAGES. ALARMS SHALL BE PROVIDED OUTSIDE EACH SEPARATE SLEEPING AREA IN THE IMMEDIATE VICINITY OF THE BEDROOMS. ALARMS SHALL COMPLY WITH CODE REQUIREMENTS, SHALL BE PERMANENT INSTALLATIONS AND SHALL BE INSTALLED PER MANUFACTURER'S INSTRUCTIONS.

D. PROTECTION OF WOOD & WOOD BASED PRODUCTS AGAINST DECAY: PER SECTION 311 OF 2012 IRC.

E. PROTECTION AGAINST TERMITES: PER SECTION 318 OF 2012 IRC.

F. SITE ADDRESS: MIN. 4" HIGH LETTERS WITHIN STROKE WIDTH OF 1/2". ADDRESS SHALL BE CLEARLY LEGIBLE FROM THE STREET. (R313)

G. DESIGN CRITERIA:

WIND LOAD, EXPOSURE B, 30 MPH, SEISMIC CATEGORY A

DEAD LOAD

LIVE LOAD

ROOMS-NON SLEEPING 10 PSF 40 PSF

ROOMS-SLEEPING 10 PSF 30 PSF

EXTERIOR BALCONIES 10 PSF 60 PSF

EXTERIOR DECK 10 PSF 40 PSF

STAIRS 10 PSF 40 PSF/200 LBS.

GUARDRAILS/HANDRAILS 200 LBS.

CEILING-NO STORAGE 10 PSF 10 PSF

(SCUTTLE ACCESS ONLY)

CEILING-STORAGE 10 PSF 20 PSF

CONCRETE TILE OR 20 PSF 20 PSF

SLATE ROOF 20 PSF SNOW LOAD

ASPHALT, WOOD OR 10 PSF 20 PSF

COMPOSITION ROOF 20 PSF SNOW LOAD

H. ASSUMED ALLOWABLE SOIL PRESSURE 5000 PSF.

I. ATTIC VENTILATION: THE NET FREE VENTILATING AREA SHALL BE NOT LESS THAN 1/60 OF THE AREA OF THE SPACE VENTILATED, EXCEPT THAT THE AREA MAY BE 1/300, PROVIDED AT LEAST 50 PERCENT OF THE REQUIRED VENTILATING AREA IS PROVIDED BY VENTILATOR LOCATED IN THE UPPER PORTION OF THE SPACE TO BE VENTILATED, AT LEAST 3 FEET ABOVE EAVES OR CORNICE VENTS, WITH THE BALANCE OF THE REQUIRED VENTILATION PROVIDED BY EAVE OR CORNICE VENTS. RAFTERS SPACES ENCLOSED BY CEILING DIRECTLY APPLIED TO UNDERSIDE OF RAFTERS SHALL BE SIZED TO ALLOW A MINIMUM 1 INCH CLEAR VENTED AIR SPACE ABOVE THE INSULATION. ATTICS WITH A MAXIMUM VERTICAL CLEAR HEIGHT OF LESS THAN 30" NEED NOT BE PROVIDED WITH ACCESS OPENING.

K. ALL ELECTRICAL RECEPTACLES SHALL BE TAMPER RESISTANT EXCEPT THOSE THAT ARE MORE THAN 66" AFF. THOSE THAT ARE PART OF A LIGHT FIXTURE OR APPLIANCE OR THOSE DEDICATED TO AN APPLIANCE.

L. GROUND FAULT CIRCUIT INTERRUPTER PROTECTION (GFCI) SHALL BE INSTALLED IN RECEPTACLES IN BATHROOMS, KITCHENS, GARAGES, UNFINISHED BASEMENTS, OUTDOORS, WITHIN 6' OF ANY SINK AND IN CRAWL SPACES. BATHROOM RECEPTACLES REQUIRE SEPARATE 20-Amp CIRCUIT.

M. ALL BRANCH CIRCUITS THAT SUPPLY 125-VOLT SINGLE-PHASE, 15 & 20- AMPERE OUTLETS SHALL BE PROTECTED BY AN ARC-FAULT CIRCUIT INTERRUPTER. THIS REQUIREMENT IS EXEMPTED FOR CIRCUITS IN KITCHENS, BATHROOMS, UNFINISHED BASEMENTS, GARAGES, EXTERIOR OUTLETS, & THOSE SUPPLYING SMOKE ALARMS AND CO DETECTORS.

N. EXTERIOR DECKS, WALKING DECKS, PORCHES, ETC. ARE MORE THAN 30" ABOVE GRADE: PROVIDE GUARDRAIL NOT LESS THAN 36" HIGH WITH INTERMEDIATE MEMBERS SPACED WITH NOT MORE THAN 4" BETWEEN.

O. FLASH AND COUNTERFLASH ROOF RIDGES AND VALLEYS, ROOF PENETRATIONS, CHANGES IN ROOF PITCHES, RAFTERS, CHIMNEYS, CLOSURES, ALL EXPOSED FLASHING TO BE 26 GAUGE ALUMINUM. COUNTERFLASHING SHALL BE FABRICATED FROM 40" TERNE METAL.

P. LOT SHALL BE GRADED TO DRAIN SURFACE WATER AWAY FROM FOUNDATION WALLS. THE GRADE SHALL FALL A MINIMUM OF 6" WITHIN THE FIRST 10' PATIOS, SIDEWALKS, AND DRIVEWAYS SHALL SLOPE A MINIMUM OF 1% WITHIN THE FIRST 10' OF FOUNDATION.

## ABBREVIATIONS

AFF.	ABOVE FINISH FLOOR	MFR.	MANUFACTURER
BD'S.	BOARD/BOARDS	MIN.	MINIMUM
CANT.	CANTILEVER	MICRO.	MICROWAVE OVEN
CJ.	CONTRACTION JOINT	M.O.	MASONRY OPENING
CL.	CENTER LINE	N.I.C.	NOT IN CONTRACT
CLG.	CEILING	NO.	NUMBER
C.O.	CASED OPENING	N.T.S.	NOT TO SCALE
CONC.	CONCRETE	O.C.	OVERHEAD OVERHANG
CONT.	CONTINUOUS	OPF.	OPPOSITE
C.S.	CONTINUOUSLY SHEATHED	OPF.	OPPOSITE
D.	DRY	FR.	FAIR
D.F.	DOUGLAS FIR	FSI.	POUNDS SQUARE INCH
D.H.	DOUBLE HUNG	FSF.	POUNDS SQUARE FOOT
DIA.	DIAMETER	P.T.	PRESSURE TREATED
D.N.	DOWN	R.	RISER
D.S.	DOWNSPOUT	RE:	REFER (TO)
D.W.	DISHWASHER	REQD.	REQUIRED
DURS.	DRAWERS	REF.	REFRIGERATOR
E.A.	EACH	RM.	ROOM
E.C.	EXTERIOR CONDITION	R.O.	ROUGH OPENING
E.I.F.S.	EXTERIOR INSULATION	S.C.	SOLID CORE
	FINISH SYSTEM ("DRY-VIT")	SCUD	SOLID CORE WOOD DOOR
E.J.	EXPANSION JOINT	S.D.	SMOKE DETECTOR
ELEV.	ELEVATION	S.F.	SQUARE FEET
EQU.	EQUAL	S.G.	SAFETY GLAZING
E.W.	EACH WAY	SIM.	SIMILAR
F.B.O.	FURNISHED BY OWNER	SQ.	SQUARE
F.D.	FLOOR DRAIN	S.S.	STAINLESS STEEL
F.O.C.	FACE OF CONCRETE	STD.	STANDARD
F.O.S.	FACE OF STUD	T.	TREAD
FR.	FIRE-RETARDANT	T.O.B.	TOP OF BEAM - STEEL
GA.	GAUGE OR GAGE	T.O.C.	TOP OF CONCRETE
GFCI	GROUND FAULT CIRCUIT INTERRUPTER	T.O.W.	TOP OF WALL
GYP. BD.	GYP. BOARD	T.S.L.	TRIANGULAR STAND LUMBER
H.B.	HOSE BIB	T.V.	TELEVISION
H.C.	HOLLOW CORE	TYP.	TYPICAL
H.M.	HOLLOW METAL	U.N.O.	UNLESS NOTED OTHERWISE
HT.	HEIGHT	W.	WASHER
ID.	INSIDE DIAMETER	W/	WITH
JT.	JOINT	W.I.C.	WALK IN CLOSET
K.S.	KNEE SPACE	W.H.	WATER HEATER
		W.R.	WATER RESISTANT
L.B. (P)	POUND		
	MINIATED VENEER LUMBER	W.W.F.	WELDED WIRE FABRIC

## ENERGY REQUIREMENTS:

THE BUILDING THERMAL ENVELOPE SHALL MEET THE REQUIREMENTS OF TABLE N102.1.1 OF THE 2012 IRC FOR CLIMATE ZONE 4.

CEILING: R-49 (ATTIC ACCESS HATCHES TO BE WEATHER STRIPPED AND SEALED TO A LEVEL EQUIVALENT TO THE SURROUNDING INSULATION) CATHEDRAL CEILINGS: R-30 (MIN. 1" AIRSPACE ABOVE INSULATION) 500 SF MAXIMUM AREA FOR CATHEDRAL CEILING INSULATION VALUES. FLOORS OVER UNHEATED SPACES OR CRAWL SPACES: R-19 BASEMENT WALLS: R-20 (R-10 FOR CONTINUOUS INSULATION ON THE INTERIOR OR EXTERIOR OF THE HOIE, R-13 FOR CAVITY INSULATION AT THE INTERIOR OF THE BASEMENT WALL.) EXTERIOR WALLS: R-20 MIN. OR B + 5 (B FOR CAVITY, 5 FOR CONTINUOUS INSULATION) CRAWL SPACE WALLS: R-10/13 (R-10 FOR CONTINUOUS INSULATION, R-13 FOR CAVITY INSULATION) PENETRATION: U ≤ 0.35 (DEFAULT U-FACTOR FOR DOUBLE PANEL, ARGON FILLED LOW-E IS U-0.235) GLAZED PENETRATION SHGC: U ≤ 0.40 SKYLIGHT: U ≤ 0.35 SLAB ON GRADE: 4 WALK-OUT BASEMENTS: R-10 INSULATION FOR 2' DOWN FROM THE BOTTOM OF THE SLAB. THIS MAY BE PROVIDED ON THE INSIDE OF THE FOUNDATION WALL. A THERMAL BREAK IS NOT REQUIRED AT THE INTERSECTION OF THE FOUNDATION WALL & SLAB. DUCTWORK: SUPPLY DUCTS IN ATTIC MIN. R-8, ALL OTHER DUCTS MIN. R-30. FLOOR OVER OUTSIDE AIR: R-30. A SEAL ALL DUCTS, AIR HANDLERS, FILTER BOXES, AND BUILDING CAVITIES USED AS DUCTS PER 2012 IRC M1602.3, N11-521, AND N1023.2. SUPPLY AND RETURN AIR DUCTS NOT LOCATED ENTIRELY WITHIN THE BUILDING ENVELOPE SHALL BE INSULATED TO A MIN. OF R-8. B. A PERMANENT CERTIFICATE SHALL BE POSTED ON OR IN THE ELECTRICAL DISTRIBUTION PANEL INDICATING PREDOMINANT R-VALUES OF ALL INSULATION INSTALLED, U-FACTORS FOR PENETRATION, & TYPES AND EFFICIENCIES OF HEATING, COOLING, AND SERVICE WATER HEATING EQUIPMENT. C. BUILDING ENVELOPE TO BE SEALED TO LIMIT INFILTRATION. SEALING METHODS BETWEEN DISSIMILAR MATERIALS SHALL ALLOW FOR DIFFERENTIAL EXPANSION AND CONTRACTION. REQUIRED SEALANT LOCATIONS LISTED IN IRC N102.4.1. D. RECESSED LIGHTING INSTALLED IN THE BUILDING THERMAL ENVELOPE SHALL BE SEALED WITH A GASKET OR CAULK, IC-RATED AND LABELED AS HAVING AN AIR LEAKAGE RATE NOT MORE THAN 2.0 CFM. E. PROVIDE PROGRAMMABLE THERMOSTAT. F. PIPING: PROVIDE MIN. R-3 INSULATION FOR SYSTEM PIPING CAPABLE OF CARRYING FLUIDS ABOVE 105° F OR BELOW 55° F. ALL CIRCULATING SERVICE HOT WATER PIPING SHALL BE INSULATED TO AT LEAST R-2. HOT WATER CIRCULATING PUMP SHALL INCLUDE AN AUTOMATIC OR READILY ACCESSIBLE MANUAL CUT-OFF SWITCH. G. MECHANICAL VENTILATION: OUTDOOR AIR INTAKES AND EXHAUSTS SHALL HAVE AUTOMATIC OR GRAVITY DAMPERS THAT CLOSE WHEN SYSTEM IS NOT OPERATING. H. EQUIPMENT SIZING: AS SPECIFIED IN IRC SECTION M1401.3

NOTE:

CLIMATE ZONE 4A

6° F & 5249 HEATING DEGREE DAYS

AIR FREEZING INDEX 1000

MEAN ANNUAL TEMP 54.1° F.

## ELEVATION NOTES

- (E1) ROOFING TO BE COMPOSITION SHINGLES ON 30° FELT ON 5/8" CDX PLYWOOD SHEATHING OR 1/2" OSB, (CLIPPED).
- (E2) SIDING TO BE "INNERSEAL" (OR SIMILAR) OVER MIN. 1/4" APA RATED OSB OR 1/2" CDX PLYWOOD-CONTINUOUS AND AIR/WATER RESISTANT BARRIER. INSTALL PER CODE AND MANUFACTURER'S INSTRUCTIONS. SIDING TO LAP RIM.
- (E3) SHINGLE SIDING OVER MIN. 1/4" APA RATED OSB OR 1/2" CDX PLYWOOD-CONTINUOUS AND AIR/WATER RESISTANT BARRIER. INSTALL PER CODE AND MANUFACTURER'S INSTRUCTIONS. SIDING TO LAP RIM.
- (E4) 2" MANUFACTURED STONE, INSTALL PER MANUFACTURER
- (E5) SET RAFTERS ON TOP OF FLOOR JOISTS. FURR DOWN BOTTOM OF SOFFIT TO ALIGN W/BOTTOM OF CANTILEVER.
- (E6) WOOD BRACKET, SEE DETAIL 3/A1.
- (E7) TIGHT BARGE
- (E8) SHUTTERS TO MATCH LENGTH OF WINDOW. SEE DETAIL 4/A1.
- (E9) NOT USED.
- (E10) NOT USED.
- (E11) NOT USED.
- (E12) 8"x8" SQUARE COLUMN.
- (E13) EXTEND FLOOR JOISTS AND INSULATE SOFFIT
- (E14) HOLD WINDOW TIGHT TO SOFFIT.
- (E15) WOOD DENTILS, SEE DETAIL 2/A1.

## ENERGY REQUIREMENT ALTERNATIVE:

USE OF A CERTIFIED HERS ENERGY RATER IS AN ALTERNATIVE TO PRESCRIPTIVE ENERGY COMPLIANCE. WHERE THE AIR INFILTRATION RATE IS LESS THAN 3 AIR CHANGES PER HOUR WHEN TESTED WITH A BLOWER DOOR TEST AT A PRESSURE OF 0.2 INCH WATER COLUMN (50 PA) IN ACCORDANCE WITH SECTION 402.4.12 OF THE INTERNATIONAL ENERGY CONSERVATION CODE, THE DWELLING UNITS SHALL BE VENTILATED BY MECHANICAL MEANS IN ACCORDANCE WITH SECTION 403.

SHOULD THE CONTRACTOR FIND DISCREPANCIES OR AMBIGUITIES IN, OR OMISSIONS FROM THE DRAWINGS, NOTIFY THE ARCHITECT FOR CLARIFICATION PRIOR TO CONSTRUCTION.


VERIFY ALL ROUGH OPENING DIMENSIONS FOR SELECTED DOORS, WINDOWS, AND MECHANICAL REQUIREMENTS BEFORE CONSTRUCTION BEGINS.

ALL MANUFACTURED ITEMS, MATERIALS, AND EQUIPMENT SHALL BE INSTALLED, ERECTED, APPLIED, USED, CONDITIONED, ADJUSTED, AND CLEANED IN ACCORDANCE WITH THE CURRENT DIRECTIONS, INSTRUCTIONS, AND RECOMMENDATIONS OF THE MANUFACTURER AND WITH CURRENT PRINTED STANDARD SPECIFICATIONS WHICH ARE ISSUED AND RECOMMENDED BY ORGANIZED ASSOCIATIONS OF MANUFACTURERS, CRAFTS, AND TRADES.

## SQUARE FOOTAGE TABLE

LOCATION	AREA (S.F.)
RESIDENTIAL, LIVING AREA	2232
RESIDENTIAL, UNFINISHED BASEMENT	565
RESIDENTIAL, FINISHED BASEMENT	1041
RESIDENTIAL, DECKS	117
RESIDENTIAL, GARAGE	680
RESIDENTIAL, FRONT PORCH	31

ROOFING MATERIAL	COMPOSITION SHINGLES	NUMBER OF BATHROOMS	4
NUMBER OF BEDROOMS	5	NUMBER OF STORIES	2-BASEMENT FINISH
NUMBER OF LIVING UNITS	1	TOTAL LIVING AREA	3273
SEWER CONNECTION FEE			
RESIDENTIAL, GARAGE			
RESIDENTIAL, FRONT PORCH			

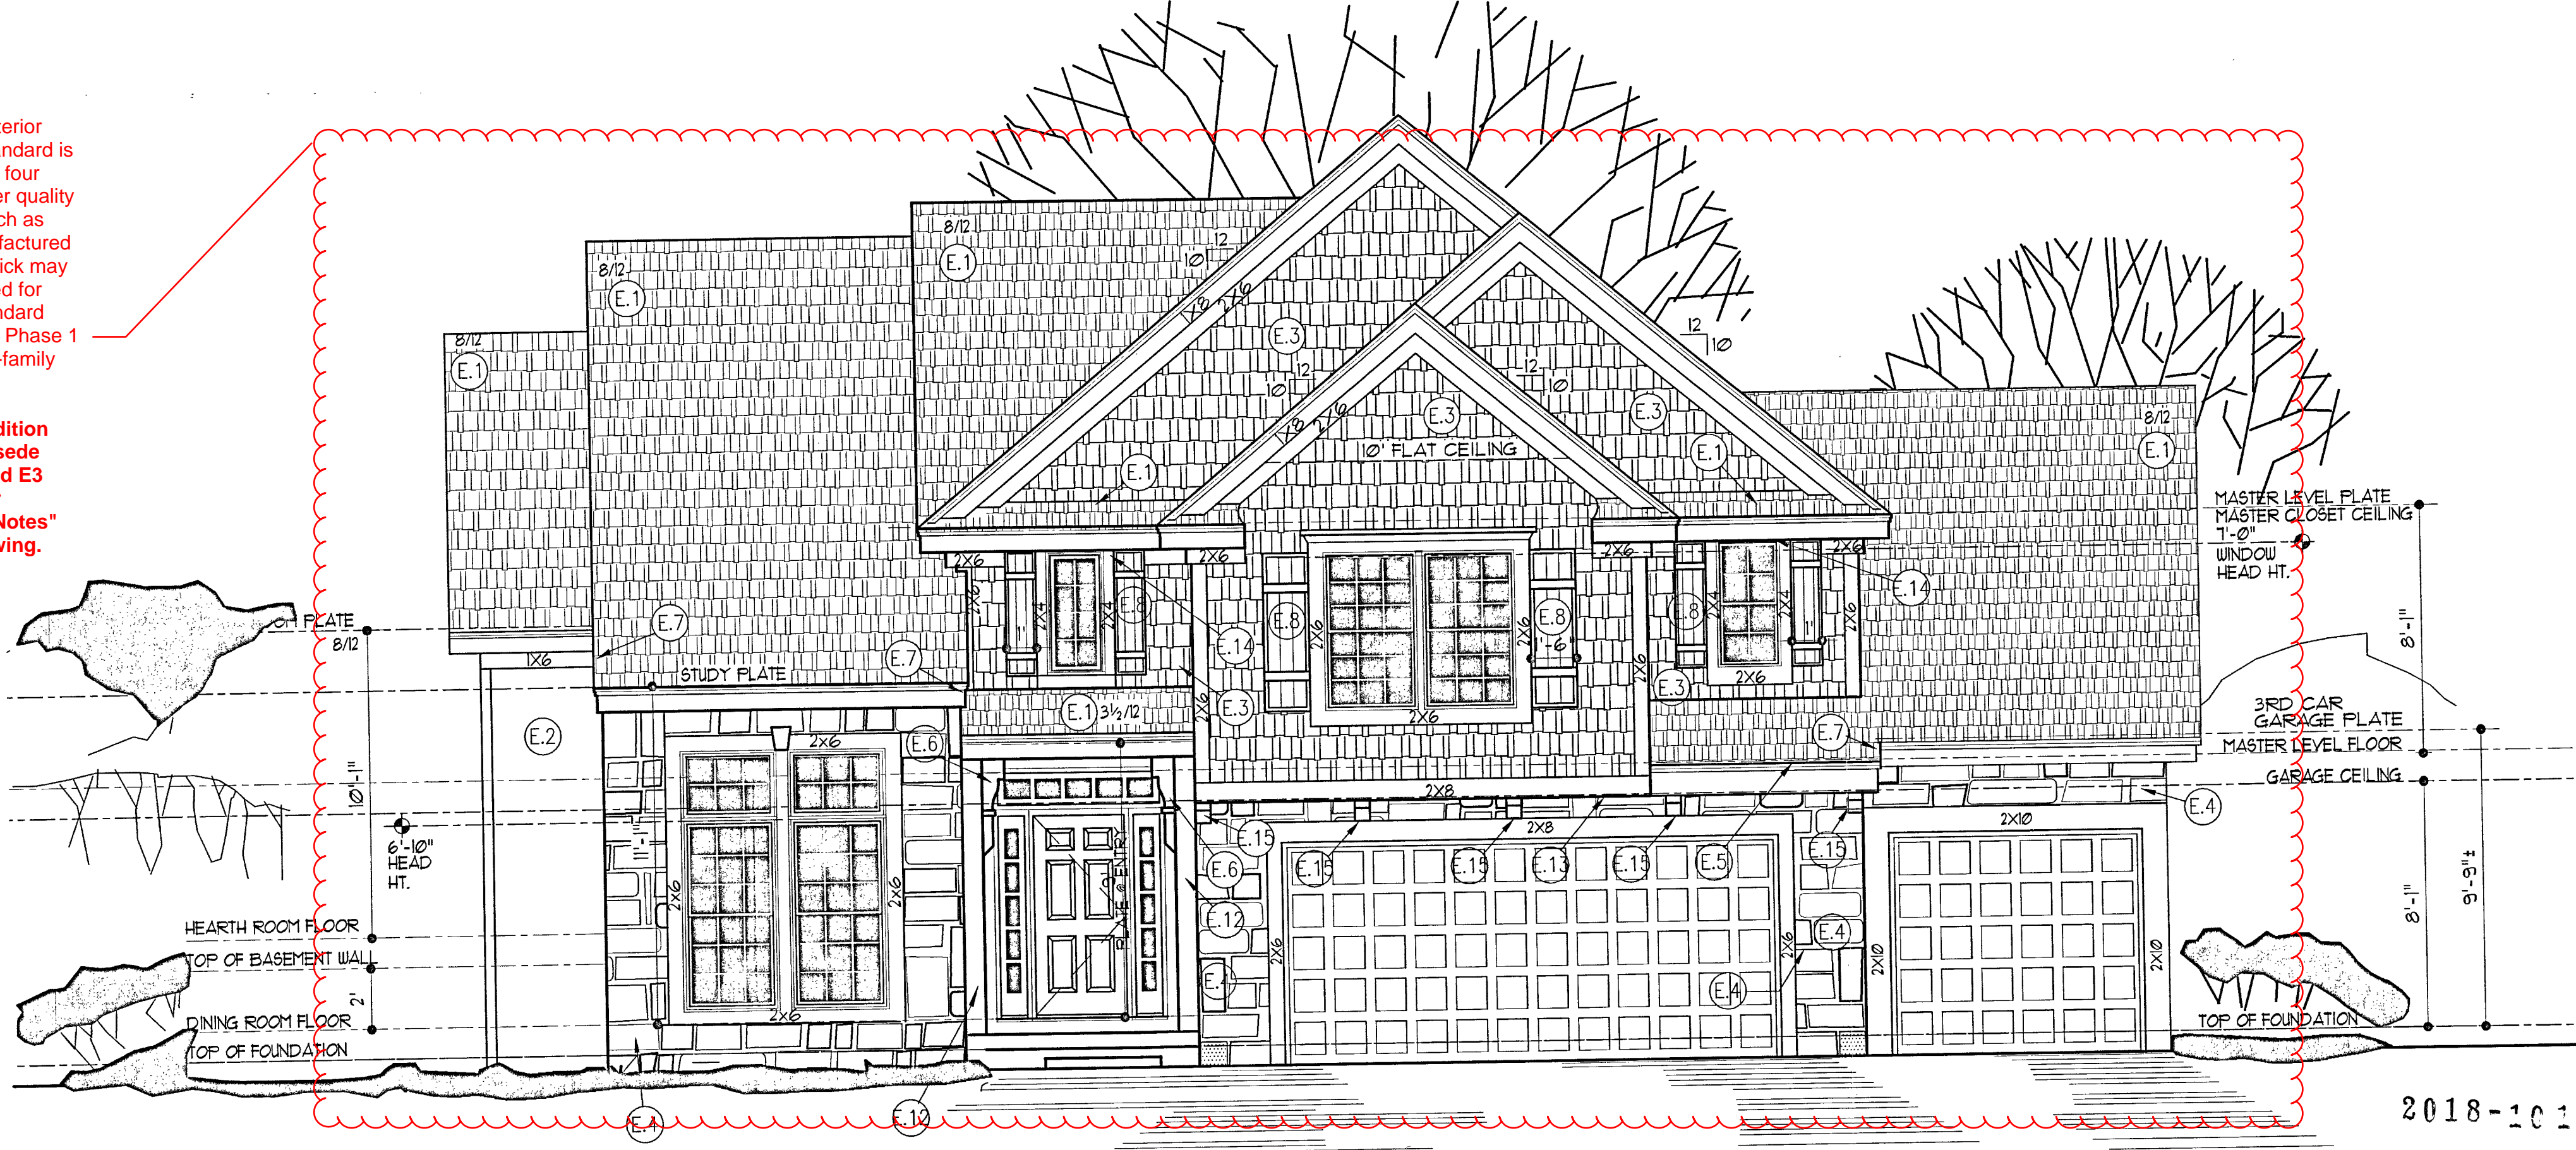

## 1 FRONT ELEVATION

ADDRESS:

LOT #:

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DATE: 11-19-2018  
PROJECT NO: 18DUG01

SHEET NO. A1


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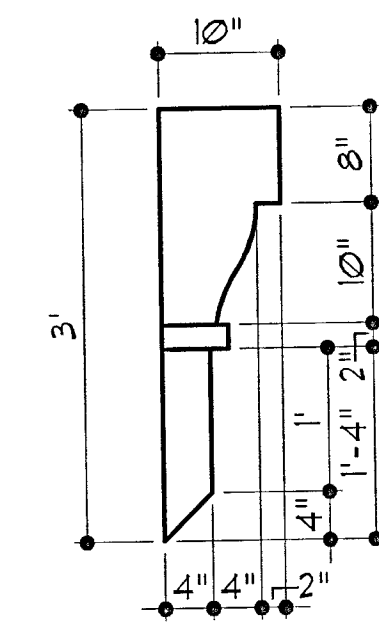


WINDOW SCHEDULE		WEATHERSEAL WINDOW (FIXED)	
SIZE:	LOCATION:	SIZE:	LOCATION:
2-3060G	DINING	6036G	DOOR TRANSOM
3060	GREAT	3030G	FRONT
3060T	BREAKFAST	3030TG	FRONT
3060	KITCHEN	3030	STAIRS
2-3050	OFFICE	3030T	FRONT
3050	BASEMENT EGRESS	3-3060T	GREAT
3050	BEDROOM #2	3-3060T	BREAKFAST
3050G	BEDROOM #3	3020	BREAKFAST
2-3050G	BEDROOM #4	2640T	STAIRS
3050	MASTER	2660T	STAIRS
3050	MASTER	2040TG	BEDROOM #4 CL
2-2050	MASTER	4040T	MASTER BATH
2030	MASTER BATH		

LETTER NOTATIONS:  
G-GRILLS T-TEMPERED A-ARCHED




2 WOOD BRACKETS  
3/4" = 1'-0"

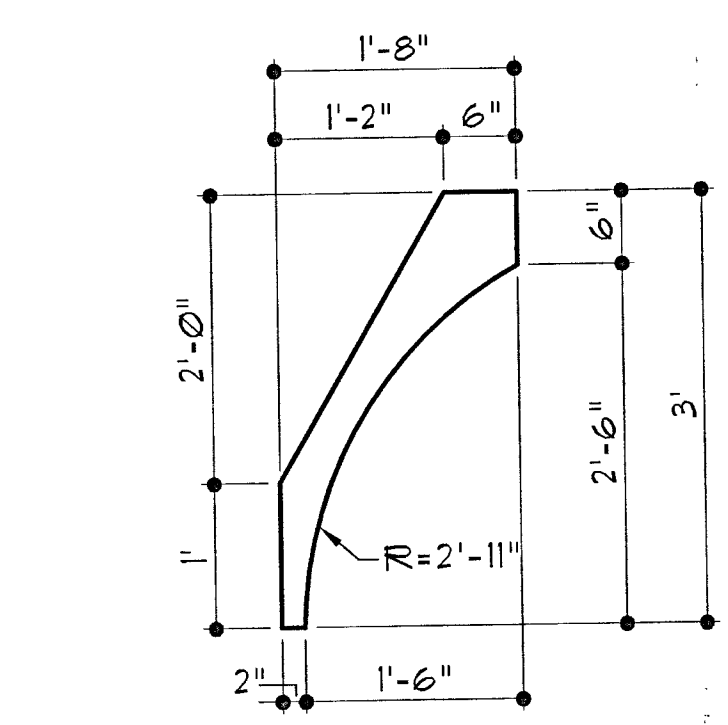

3 WOOD BRACKET  
3/4" = 1'-0"

Minimum exterior materials standard is stucco on all four sides. Higher quality materials such as stone, manufactured stone and brick may be substituted for stucco. Standard applies to all Phase 1 and 2 single-family homes.\*\*\*  
\*\*\*This condition shall supersede note E2 listed under "Elevation Notes" on this drawing.

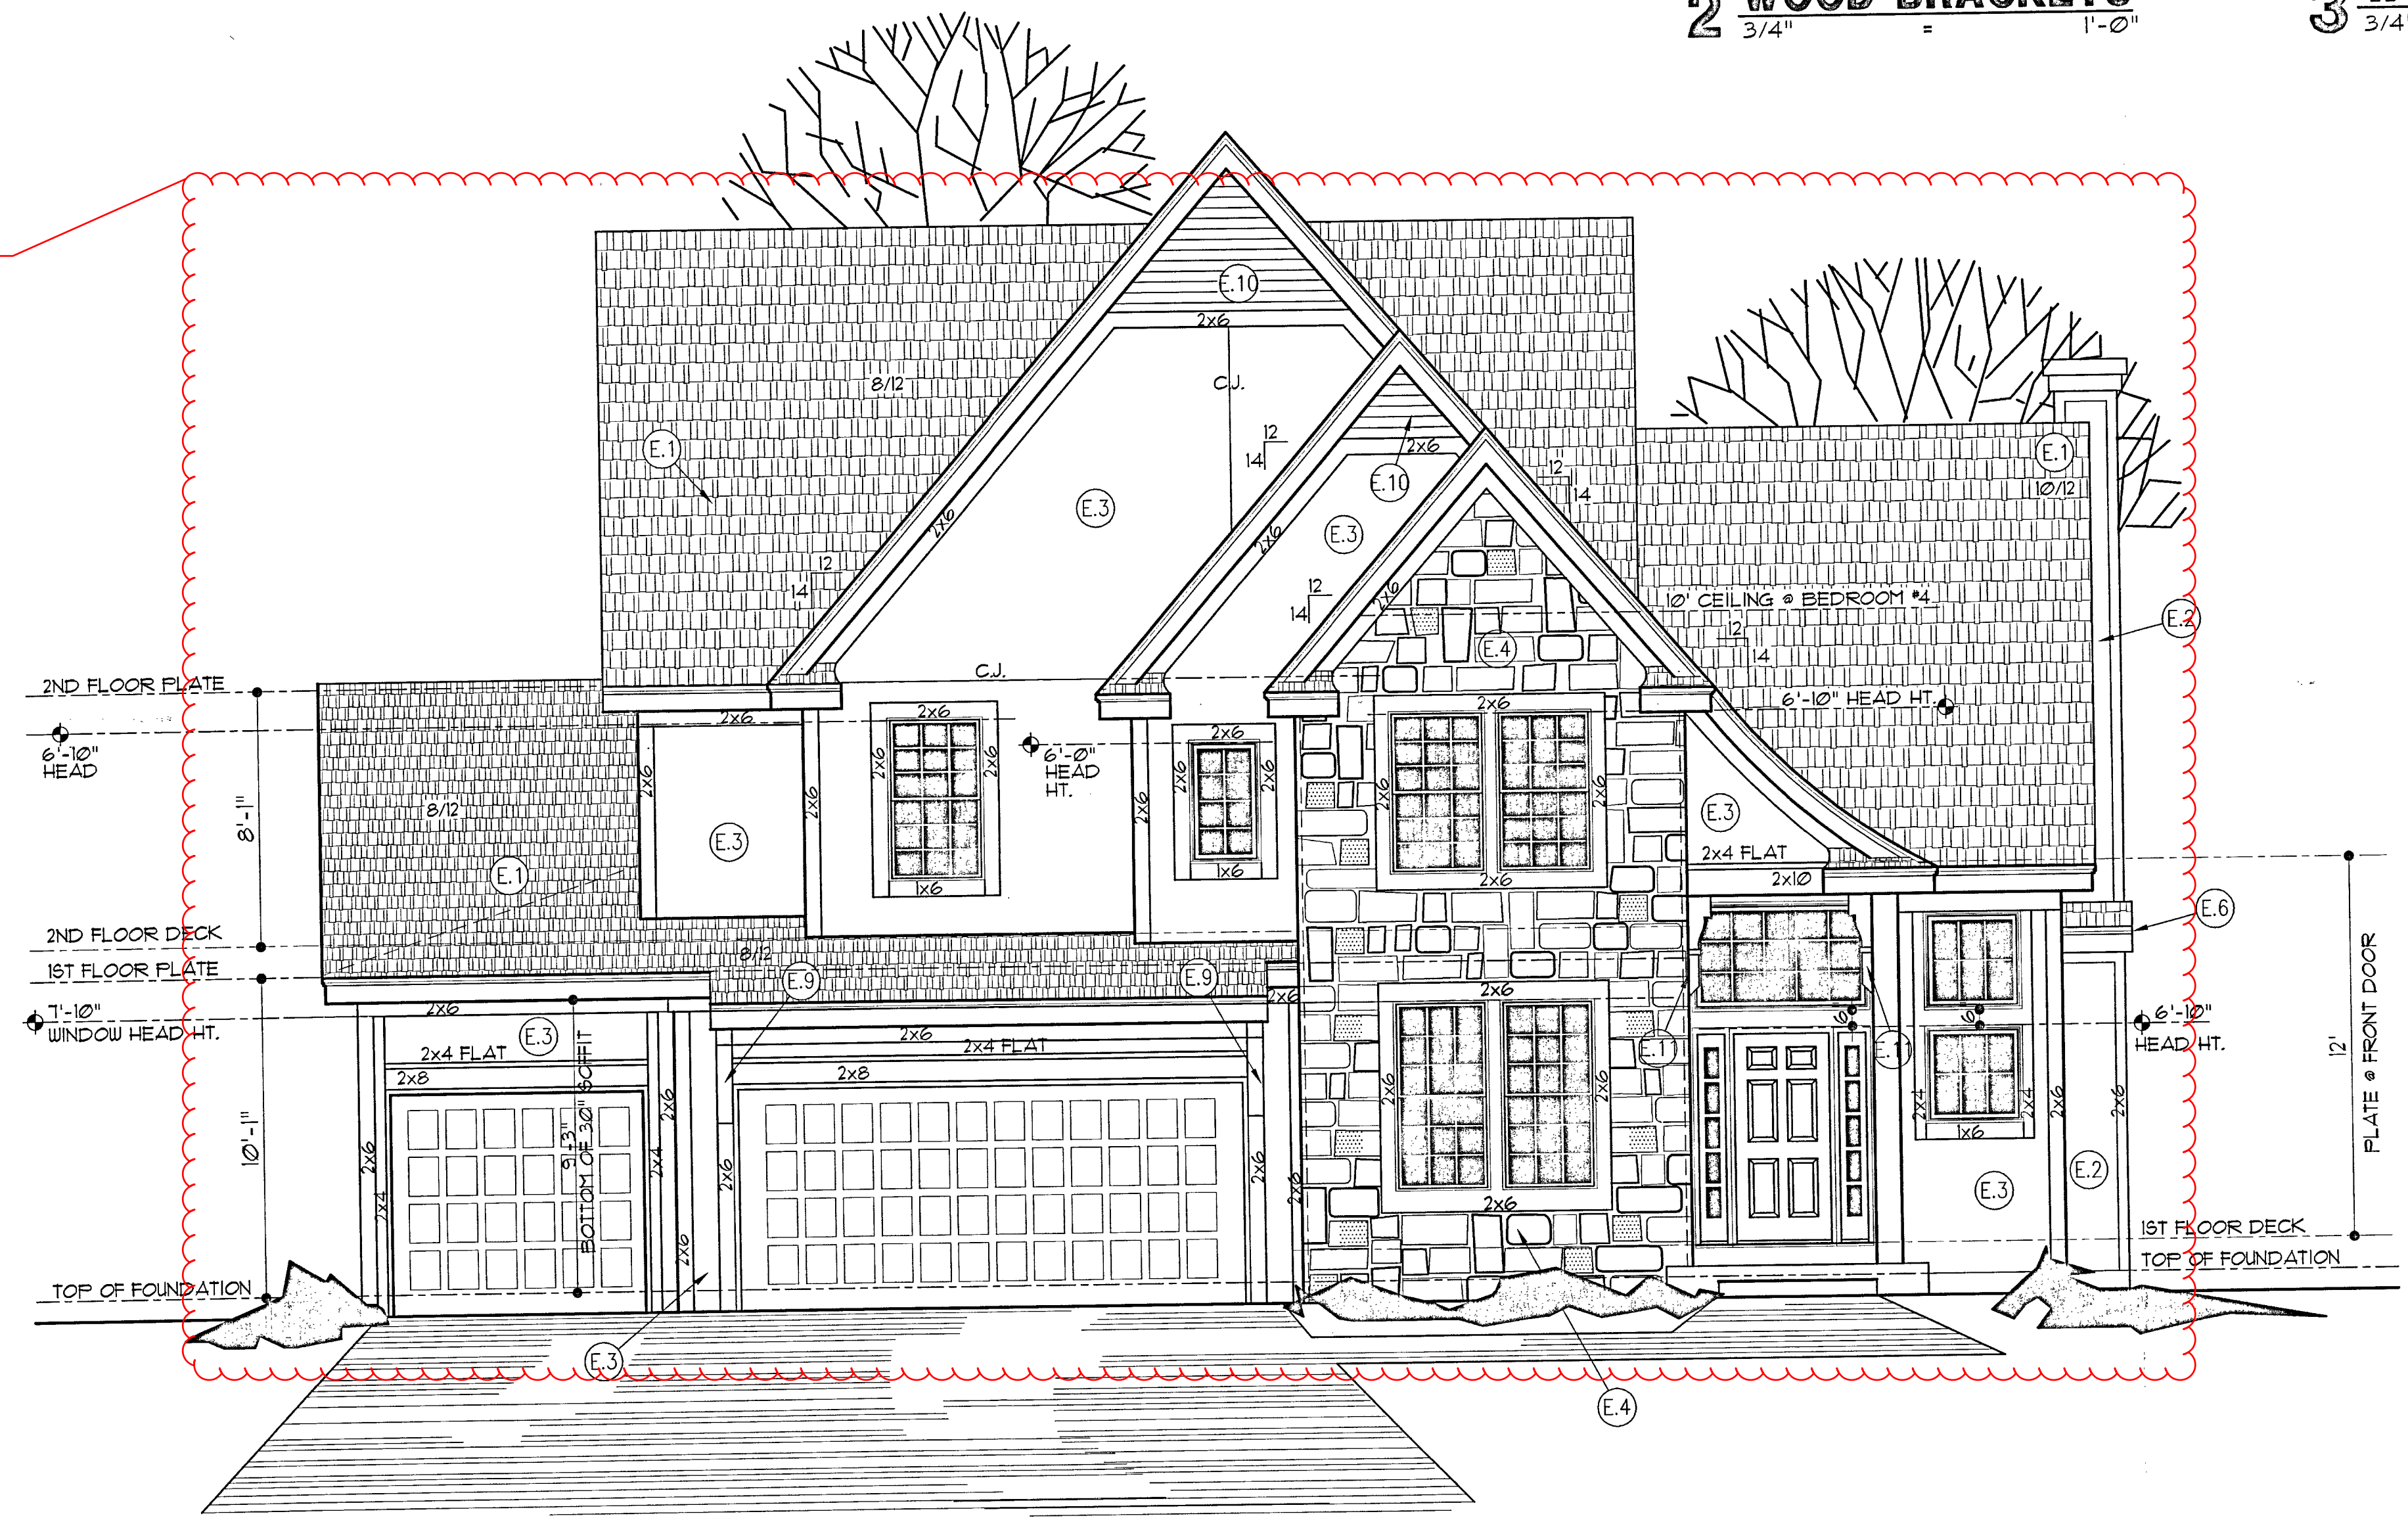

**ELEVATION NOTES**

- ① ROOFING TO BE COMPOSITION SHINGLES ON 30" FELT ON 3/4" CDX PLYWOOD SHEATHING OR 5/8" OSB. (CLIFFED)
- ② SIDING ON REAR AND SIDES TO BE "INNERSEAL" ON 1/8" OSB. W/ 1/4" SMART TRIM AT ALL CORNERS. INSTALL PER MANUFACTURER'S INSTRUCTIONS. PROVIDE 1/4" SMART TRIM AROUND WINDOWS.
- ③ STUCCO ON METAL LATH AND 30" FELT ON 1/8" OSB. EXTEND STUCCO TO WITHIN 8" OF FINISHED GRADE.
- ④ 2" MANUFACTURED STONE VENEER. INSTALL PER MANUFACTURER'S INSTRUCTIONS.
- ⑤ NOT USED.
- ⑥ TIGHT BARGE
- ⑦ NOT USED.
- ⑧ NOT USED.
- ⑨ 36" LONG x 6" WIDE BRACKET, RE: DETAIL 2/A1.
- ⑩ LAP SIDING W/ 4" REVEAL.
- ⑪ 36" LONG x 6" WIDE BRACKET, RE: DETAIL 3/A1.

SHOULD THE CONTRACTOR FIND DISCREPANCIES OR AMBIGUITIES IN, OR OMISSIONS FROM THE DRAWINGS, NOTIFY THE ARCHITECT FOR CLARIFICATION PRIOR TO CONSTRUCTION.  
VERIFY ALL ROUGH OPENING DIMENSIONS FOR SELECTED DOORS, WINDOWS, AND MECHANICAL REQUIREMENTS BEFORE CONSTRUCTION BEGINS.  
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2018-101--

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**EVANSTON 'C'**  
**1 FRONT ELEVATION**  
1/4" = 1'-0"

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DATE DESCRIPTION

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DATE: 11-21-2018  
PROJECT NO: 20DUG15-M16

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