# BUILDING RENOVATION

LOT 1, RAINTREE 150 CENTER A SUBDIVISION IN LEE'S SUMMIT, JACKSON COUNTY, MISSOURI, AS SHOWN ON PLAT ENTITLED MINOR PLAT OF RAINTREE 150 CENTER RECORDED APRIL 21, 2004 IN PLAT BOOK 181, PAGE 12 OF THE JACKSON COUNTY, MISSOURI RECORDER OF DEEDS OFFICE

## FINAL DEVELOPMENT PLAN

#### **CONSTRUCTION NOTES**

- 1. ALL CONTOURS SHOWN ON THESE PLANS ARE BASED ON U.S.G.S. DATA.
- 2. ALL GRADING SHALL BE IN ACCORDANCE WITH THE REQUIREMENTS OF THE CITY OF LEE'S SUMMIT IT SHALL BE THE RESPONSIBILITY OF THE CONTRACTOR TO RESTORE THE GRADE TO THE DESIGN ELEVATIONS.
- 4. NO SLOPES SHALL BE GRADED STEEPER THAN 3:1 (HORIZONTAL: VERTICAL), AND SHALL BE SEEDED AND MULCHED.
- 5. ONLY THE DESIGNATED CONSTRUCTION ACCESS ROÙTE MAY BE USED TO MOVE EQUIPMENT IN AND OUT. NO OTHER ACCESS POINT 6. ALL SILTATION MEASURES MUST BE IN PLACE BEFORE ANY OPERATIONS THAT DISTURB THE NATURAL GRADE COMMENCES. THIS INCLUDES GRUBBING OR STUMP REMOVAL. THE CITY OF LEE'S SUMMIT SHALL BE NOTIFIED UPON COMPLETION OF ALL SILTATION AND EROSION FACILITIES AND SHALL INSPECT AND APPROVE SUCH FACILITIES PRIOR TO THE COMMENCEMENT OF ANY CLEARING OR
- 7. SILTATION AND CONTROL FACILITIES MUST BE MAINTAINED THROUGHOUT THE ENTIRE CONSTRUCTION PERIOD. THIS INCLUDES REMOVAL OF MUD FROM SILTATION BASINS AND REPLACEMENT OF THE CITY OF LEE'S SUMMIT APPROVED EROSION CONTROL DEVICES. MUD SHALL NOT BE PERMITTED TO MIGRATE OFF THE SITE. DAMAGE OR FAILURE OF SILTATION AND EROSION CONTROL FACILITIES SHALL BE REPAIRED. DAMAGE OR FAILURE OF SILTATION AND EROSION CONTROL FACILITIES SHALL BE REPAIRED IMMEDIATELY BUT NOT LONGER THAN 24 HOURS AFTER NOTIFICATION. IF PROPOSED MEASURES FAIL TO ADEQUATELY PROTECT THE ADJOINING PROPERTY ADDITIONAL
- FACILITIES SHALL BE INSTALLED AS DIRECTED. 8. THE ENGINEER SHALL NOT BE RESPONSIBLE FOR THE MEANS, METHODS, TECHNIQUES, SEQUENCES OR PROCEDURES OF CONSTRUCTION SELECTED BY THE CONTRACTOR TO PROTECT OFF—SITE PROPERTY FROM EROSION OR SILTATION. THE ENGINEER SHALL NOT BE
- LIABLE FOR DAMAGE CAUSED BY EROSION OR SILTATION DUE TO DEFECTIVE SILTATION CONTROL DEVICES. 9. MUD WILL NOT BE PERMITTED TO BE CARRIED OFF SITE ONTO PUBLIC STREETS. A TEMPORARY WASH FACILITY SHALL BE PROVIDED TO REMOVE MUD FROM VEHICLE TIRES BEFORE ENTERING THE PUBLIC STREETS.
- 10. MEASURES SHALL BE TAKEN TO CONTROL DUST AS NECESSARY 11. IT SHALL BE THE GRADING CONTRACTOR'S RESPONSIBILITY TO NOTIFY THE SOILS ENGINEER OF WORK IN PROGRESS AND TO COMPLY WITH SPECIFICATIONS SET BY THE SOILS ENGINEER WITH REGARD TO COMPACTION, SURFACE PREPARATION AND PLACEMENT OF FILL. 12. ALL STUMPS, LIMBS, AND OTHER DEBRIS ARE TO BE REMOVED FROM THE SITE.
- 14. ALL FILL AREAS, INCLUDING TRENCH BACKFILLS, UNDER BUILDINGS, PROPOSED STORM AND SANITARY SEWER LINES, PUBLIC RIGHT OF WAY AND PAVED AREAS SHALL BE COMPACTED TO 90% OF MAXIMUM DENSITY AS DETERMINED BY THE MODIFIED AASHO T-180 COMPACTION TEST", (A.S.T.M. D- 1557) UNLESS OTHERWISE REQUIRED IN THE SOILS REPORT FOR THIS PROJECT.

#### TABLE OF ABBREVIATIONS

13. ALL DRAINAGE SWALES SHALL BE SODDED.


	NOTE: NOT ALL ABBREVIATIONS USED		
Al	AREA INLET	N	NORTH
ASPH	ASPHALT	NE	NORTHEAST
ATG	ADJUST TO GRADE	NW	NORTHWEST
BC	BOTTOM OF CURB ELEVATION	PB	PLAT BOOK
BFP	BACKFLOW PREVENTER	PERM	PERMANENT
BLDG	BUILDING	PG	PAGE
BM	BENCHMARK	PGS	PAGES
BOT	BOTTOM	PL	PROPERTY LINE
BS	BOTTOM OF SLOPE ELEVATION	PR	PROPOSED
BW	BOTTOM OF WALL ELEVATION	PVC	POLYVINYL CHLORIDE
CI	CURB INLET	PVMT	PAVEMENT
CMP	CORRUGATED METAL PIPE	R	RADIUS
CO	CLEAN OUT	RCP	REINFORCED CONCRETE PIPE
CONC	CONCRETE	REC	RECORD
	DEED BOOK	ROW	RIGHT OF WAY
DB			
DIP	DUCTILE IRON PIPE	R/W	RIGHT OF WAY
DS	DOWNSPOUT	S	SOUTH
E E	EAST	SE	SOUTHEAST
ELEV	ELEVATION	SF	SQUARE FEET
EM	ELECTRIC METER	SURV	SURVEY
EOP	EDGE OF PAVEMENT	SW	SOUTHWEST
ESMT	EASEMENT	TBR	TO BE REMOVED
EX	EXISTING	TC	TOP OF CURB ELEVATION
FF	FINISHED FLOOR ELEVATION	TFP	TRANSFORMER PAD
FL	FLOW LINE ELEVATION	TS	TOP OF SLOPE ELEVATION
FO	FIBER OPTIC	TW	TOP OF WALL ELEVATION
GEN	GENERATOR	TYP	TYPICAL
GTI	GRATE TOP INLET	UGFO	UNDERGROUND FIBER OPTIC LINE
HC	HANDICAPPED	UIP	USE IN PLACE
HHE	ELECTRIC HAND HOLE	VCP	VITRIFIED CLAY PIPE
HHTS	TRAFFIC SIGNAL HAND HOLE	W	WEST
HHSL	SIGNAL LIGHT HAND HOLE		
ICVR	IRRIGATION CONTROL VALVE RECLAIMED		
MAX	MAXIMUM		
MH	MANHOLE		

METROPOLITAN ST. LOUIS SEWER DISTRICT

#### **GENERAL NOTES**

CONSTRUCTION.

- 1. THE SITEWORK ON THIS PROJECT SHALL MEET OR EXCEED ALL STANDARDS AND SPECIFICATIONS REQUIRED BY THE CITY OF LEE'S 2. CASCO DIVERSIFIED CORPORATION HAS NOT PERFORMED ANY INVESTIGATION REGARDING UNDERGROUND CONDITIONS, HAZARDOUS WASTES, OR UTILITIES AFFECTING THE SITE SHOWN HEREIN.
- 3. ALL DIMENSIONS ARE FROM THE FACE OF CURB UNLESS OTHERWISE NOTED. 4. ALL DISTURBED AREAS OUTSIDE OF PAVEMENT AND BUILDING PAD AREAS SHALL RECEIVE 4" OF SUITABLE TOPSOIL. CONTRACTOR SHALL SEED, MULCH, FERTILIZE AND MAINTAIN ALL DISTURBED AREAS OUTSIDE OF PAVEMENT UNTIL SUFFICIENT VEGETATIVE GROWTH HAS BEEN ESTABLISHED PER THE SWPPP. CONTRACTOR SHALL BE RESPONSIBLE FOR ALL MEANS AND METHODS REQUIRED TO
- ESTABLISH PERMANENT SOIL STABILIZATION. 5. ALL SURVEY MONUMENTS DISTURBED DURING CONSTRUCTION SHALL BE REPLACED BY A LICENSED PROFESSIONAL SURVEYOR IN THE STATE OF MISSOURI AT THE CONTRACTOR'S OWN EXPENSE.
- 6. ALL TRENCHES EXCAVATED UNDERNEATH AREAS TO BE PAVED SHALL BE BACKFILLED WITH COMPACTED GRANULAR MATERIAL AND COMPACTED TO MEET REQUIREMENTS OF THE GEOTECHNICAL REPORT AND CITY OF LEE'S SUMMIT REQUIREMENTS.
- 7. CONTRACTOR SHALL INSTALL ALL UNDERGROUND PIPING AND CONDUITS PER THE REQUIREMENTS OF THE RESPECTIVE MANUFACTURERS AND THE CITY OF LEE'S SUMMIT
- 8. IN ACCORDANCE WITH GENERALLY ACCEPTED CONSTRUCTION PRACTICES, NEITHER THE OWNER NOR THE ENGINEER WILL BE RESPONSIBLE FOR COMPLIANCE WITH ALL LOCAL, STATE, AND FEDERAL SAFETY MEASURES AND REGULATIONS. CONTRACTOR SHALL COMPLY WITH ALL OSHA REGULATIONS AND SAFETY MEETING REQUIREMENTS. THE CONTRACTOR SHALL BE COMPLETELY AND SOLELY RESPONSIBLE FOR JOB SITE CONDITIONS, INCLUDING SAFETY OF ALL PROPERTY AND PERSONS AT ALL TIMES DURING THE PERFORMANCE OF THE WORK. THIS REQUIREMENT APPLIES CONTINUOUSLY AND IS NOT LIMITED TO NORMAL WORKING HOURS. CONTRACTOR SHALL BE RESPONSIBLE FOR PROVIDING, MAINTAINING, AND IMPLEMENTING ALL SAFETY DEVICES AND PRACTICES DURING
- 9. CONTRACTOR SHALL BE RESPONSIBLE FOR THE PROTECTION OF ALL PUBLIC AND PRIVATE PROPERTY ADJACENT TO THE WORK. CONTRACTOR SHALL EXERCISE DUE CARE AND CAUTION TO AVOID DAMAGE TO SUCH PROPERTY. CONTRACTOR SHALL REPLACE OR RESTORE TO EQUAL OR BETTER CONDITION THAN THE ORIGINAL CONDITION AT THE CONTRACTOR'S OWN EXPENSE, ALL IMPROVEMENTS WITHIN OR ADJACENT TO THE AREA OF WORK WHICH ARE NOT DESIGNATED FOR REMOVAL OR ADJUSTMENT AND WHICH ARE DAMAGED OR REMOVED AS A RESULT OF THE CONTRACTOR'S ACTIONS.
- 10. CONTRACTOR SHALL CONTINUALLY MONITOR JOB SITE CONDITIONS. CONDITIONS REQUIRING CONSTRUCTION DIFFERENT THAN THAT SHOWN ON ON THE PLANS SHALL BE REPORTED TO THE ENGINEER PRIOR TO PROCEEDING WITH THE AFFECTED WORK.
- 11. CONTRACTOR SHALL BE RESPONSIBLE FOR FIELD VERIFYING PRESENCE AND LOCATIONS (VERTICALLY AND HORIZONTALLY) OF ALL UTILITIES. IN NO WAY DOES THE ENGINEER OR THE OWNER SUGGEST, IMPLY, OR CONFIRM THAT UTILITIES SHOWN ARE INCLUSIVE OF ALL UTILITIES WITHIN THE PROJECT AREA. THE CONTRACTOR SHALL BE RESPONSIBLE FOR PROTECTING IN PLACE ALL UTILITIES. ANY DAMAGE OR LOSS TO EXISTING UTILITIES SHALL BE THE SOLE RESPONSIBILITY OF THE CONTRACTOR. SHOULD ANY DAMAGE OCCUR AS A RESULT OF THE CONSTRUCTION ACTIVITIES, THE CONTRACTOR SHALL REPLACE OR REPAIR THE DAMAGES TO THE FULL SATISFACTION OF THE UTILITY OWNER AT THE CONTRACTOR'S OWN EXPENSE. THE CONTRACTOR SHALL AGREE TO DEFEND, INDEMNIFY, AND HOLD HARMLESS THE OWNER AND THE ENGINEER FROM ANY AND ALL DAMAGES OR LOSS.

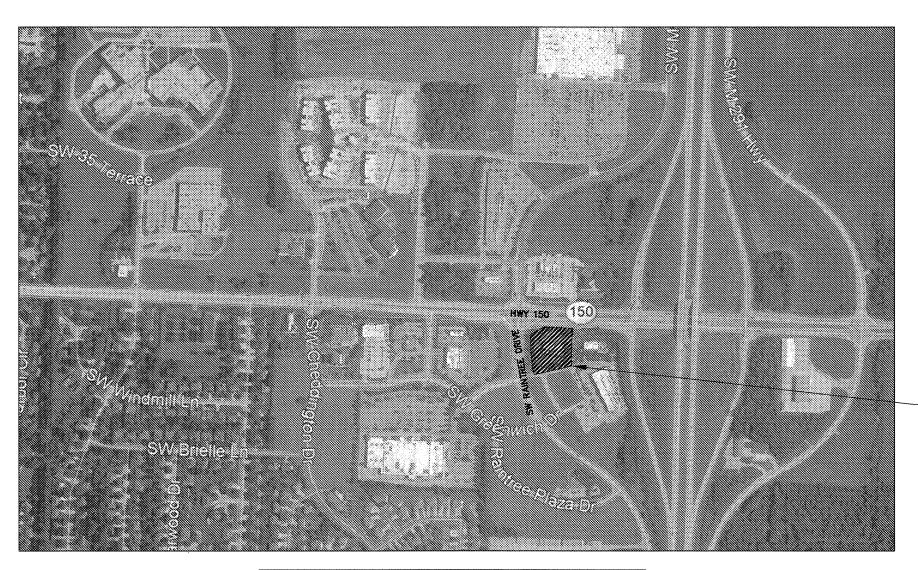

#### PERTINENT INFORMATION

155 SW M-150 HIGHWAY CITY OF LEE'S SUMMIT MUNICIPALITY: TOTAL SITE AREA: 1.405 ACRES (61,187± SF) AREA OF DISTURBANCE: 0.496 ACRES (21,592± SF) CP-2 CORRIDOR DEVELOPMENT OVERLAY DISTRICT CP-2 CORRIDOR DEVELOPMENT INTENDED USE: OVERLAY DISTRICT

### SHEET INDEX

PARCEL ID:

CO.O — COVER

C1.0 - DEMOLITION PLAN

C2.0 - SITE & UTILITY PLAN

C3.0 - GRADING PLAN

C4.0 - SITE DETAILS

C5.0 - EROSION & SEDIMENT CONTROL PLAN

C5.1 - EROSION & SEDIMENT CONTROL DETAILS

70-820-03-02-00-0-00-000

#### LAND DISTURBANCE NOTE

THE CONTRACTOR SHALL CONTACT THE CITY'S DEVELOPMENT SERVICES ENGINEERING INSPECTORS 48 HOURS PRIOR TO ANY LAND DISTURBANCE WORK: (816) 969-1200 

#### FLOOD ZONE NOTE

ACCORDING TO THE FIRM FLOOD INSURANCE RATE MAP 29095C0532G ZONE X. FLOOD ZONE X IS DETERMINED TO BE AN AREA OF MINIMAL SOLID GROUND ENVIRONMENTAL DATED MAY 12, 2020. FLOOD HAZARD, OUTSIDE THE 0.2% ANNUAL CHANCE FLOOD HAZARD.

#### TITLE DESCRIPTION

LOT 1, RAINTREE 150 CENTER, A SUBDIVISION IN LEE'S SUMMIT, JACKSON COUNTY, MISSOURI, AS SHOWN ON PLAT ENTITLED MINOR PLAT OF RAINTRÉE, 150 CÉNTER, RECORDED APRIL 21, 2004 IN PLAT BOOK 181, PAGE 12 OF THE JACKSON COUNTY, MISSOURI RECORDER OF DEEDS OFFICE.

THIS SURVEY AND LEGAL DESCRIPTION ARE THE SAME AS THAT SHOWN ON A TITLE REPORT PREPARED BY FIRST AMERICAN TITLE INSURANCE COMPANY, FILE NO.: NCS-401470620A-NC, FIRST AMENDMENT, EFFECTIVE DATE. EFFECTIVE DATE: JUNE 26, 2019.

#### SIGN NOTE


ALL PROPOSED SIGNS SHALL COMPLY WITH THE UDO REQUIREMENTS, AND SIGNS WILL BE APPROVED BY SEPARATE

### OIL AND GAS NOTE

THERE ARE NO OIL AND/OR GAS WELLS PRESENT WITHIN THE DATED JANUARY 20, 2017, THIS DEVELOPMENT IS LOCATED IN FLOOD ( SUBJECT PROPERTY PER THE ENVIRONMENTAL REPORT PREPARED BY )

#### **SURVEY NOTE**

THE TOPOGRAPHIC INFORMATION IN THIS PLAN SET IS BASED OFF A SURVEY PROVIDED BY AYLETT SURVEYING & ENGINEERING ON MAY 13, 2020 AND A BOUNDARY SURVEY PROVIDED BY COMMERCIAL DUE DILIGENCE SERVICES ON MARCH 25, 2020. ACTUAL FIELD CONDITIONS ARE TO BE VERIFIED PRIOR TO COMMENCEMENT OF WORK.

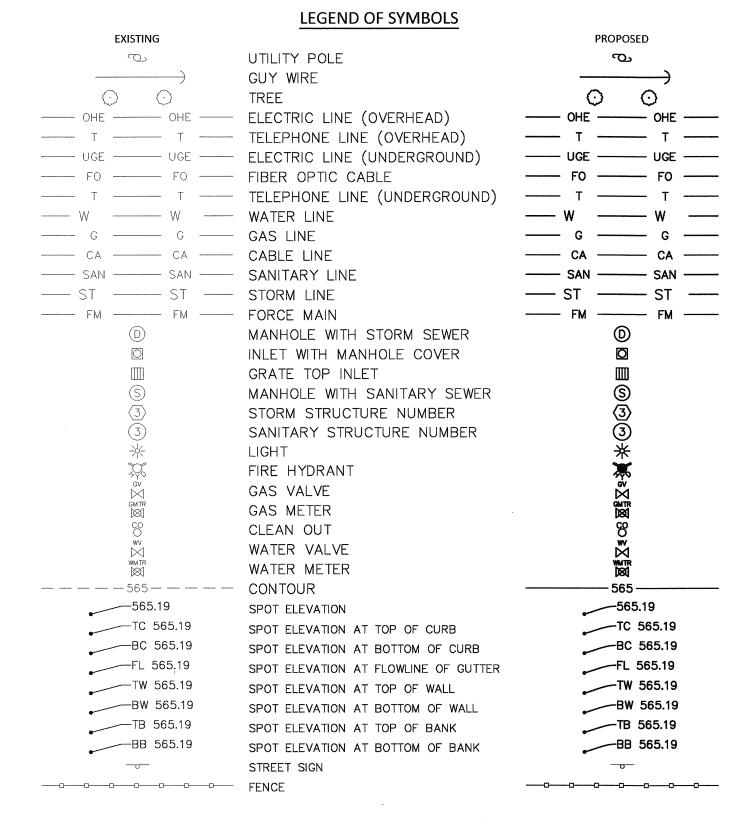

#### PROJECT CONTACTS

LOCATION

DEVELOPERS: 4653 TRUEMAN BOULEVARD HILLIARD, OH 43026 (614) 586-3303 NPALMER@EQUITY.NET MIDLAND PROPERTIES OF ILLINOIS, LLC 716 WINDSOR ROAD

LOVES PARK, IL 61111 (815) 988-9600 BRENT@MIDLANDGENERALCONTRACTORS.COM

BUILDING DESIGN:
CASCO DIVERSIFIED CORPORATION 12 SUNNEN DR. SUITE 100 ST. LOUIS, MO 63143 (314) 821-1100

CIVIL ENGINEER: CASCO CIVIL 12 SUNNEN DR. SUITE 100 ST. LOUIS, MO 63143 (314) 821-1100 TOM.BUERK@CASCOCORP.COM

KANSAS CITY POWER & LIGHT (888) 471-5275 LEE'S SUMMIT PUBLIC WORKS 220 SE GREEN LEE'S SUMMIT, MO 64063 (816) 969-1800 (816) 756-5252 SANITARY & WATER:


LEE'S SUMMIT WATER UTILITIES 12 SE HAMBLEN ROAD LEE'S SUMMIT, MO 64081 (816) 969-1900 FIRE DEPARTMENT: LEE'S SUMMIT FIRE STATION 5

3650 SW WINDEMERE ROAD LEE'S SUMMIT, MO 64062 PHONE

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CASCO DIVERSIFIED CORPORATION CERTIFICATE OF AUTHORITY #000613 12/31/21




PROFESSIONAL OF RECORD License NO. PE-2018000174 Expiration Date 12/31/20

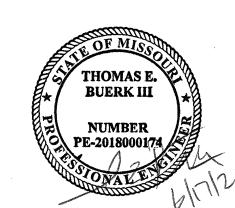Drawn By/Checked By: MEB/TEB Project Number Permit Date 06-17-20

COVER





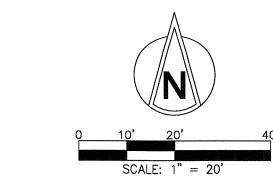




BUILDING RENOVATION 155 SW M-150 HIGHWAY LEE'S SUMMIT, MO 64082

06-17-20

DP Developme

CASCO DIVERSIFIED CORPORATION CERTIFICATE OF AUTHORITY #000613 12/31/21

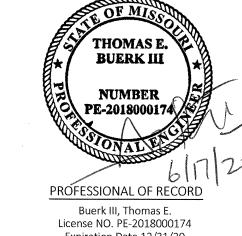


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Project Number 320488


Project Number320488Permit Date06-17-20

DEMOLITION PLAN

C<sub>1.0</sub>

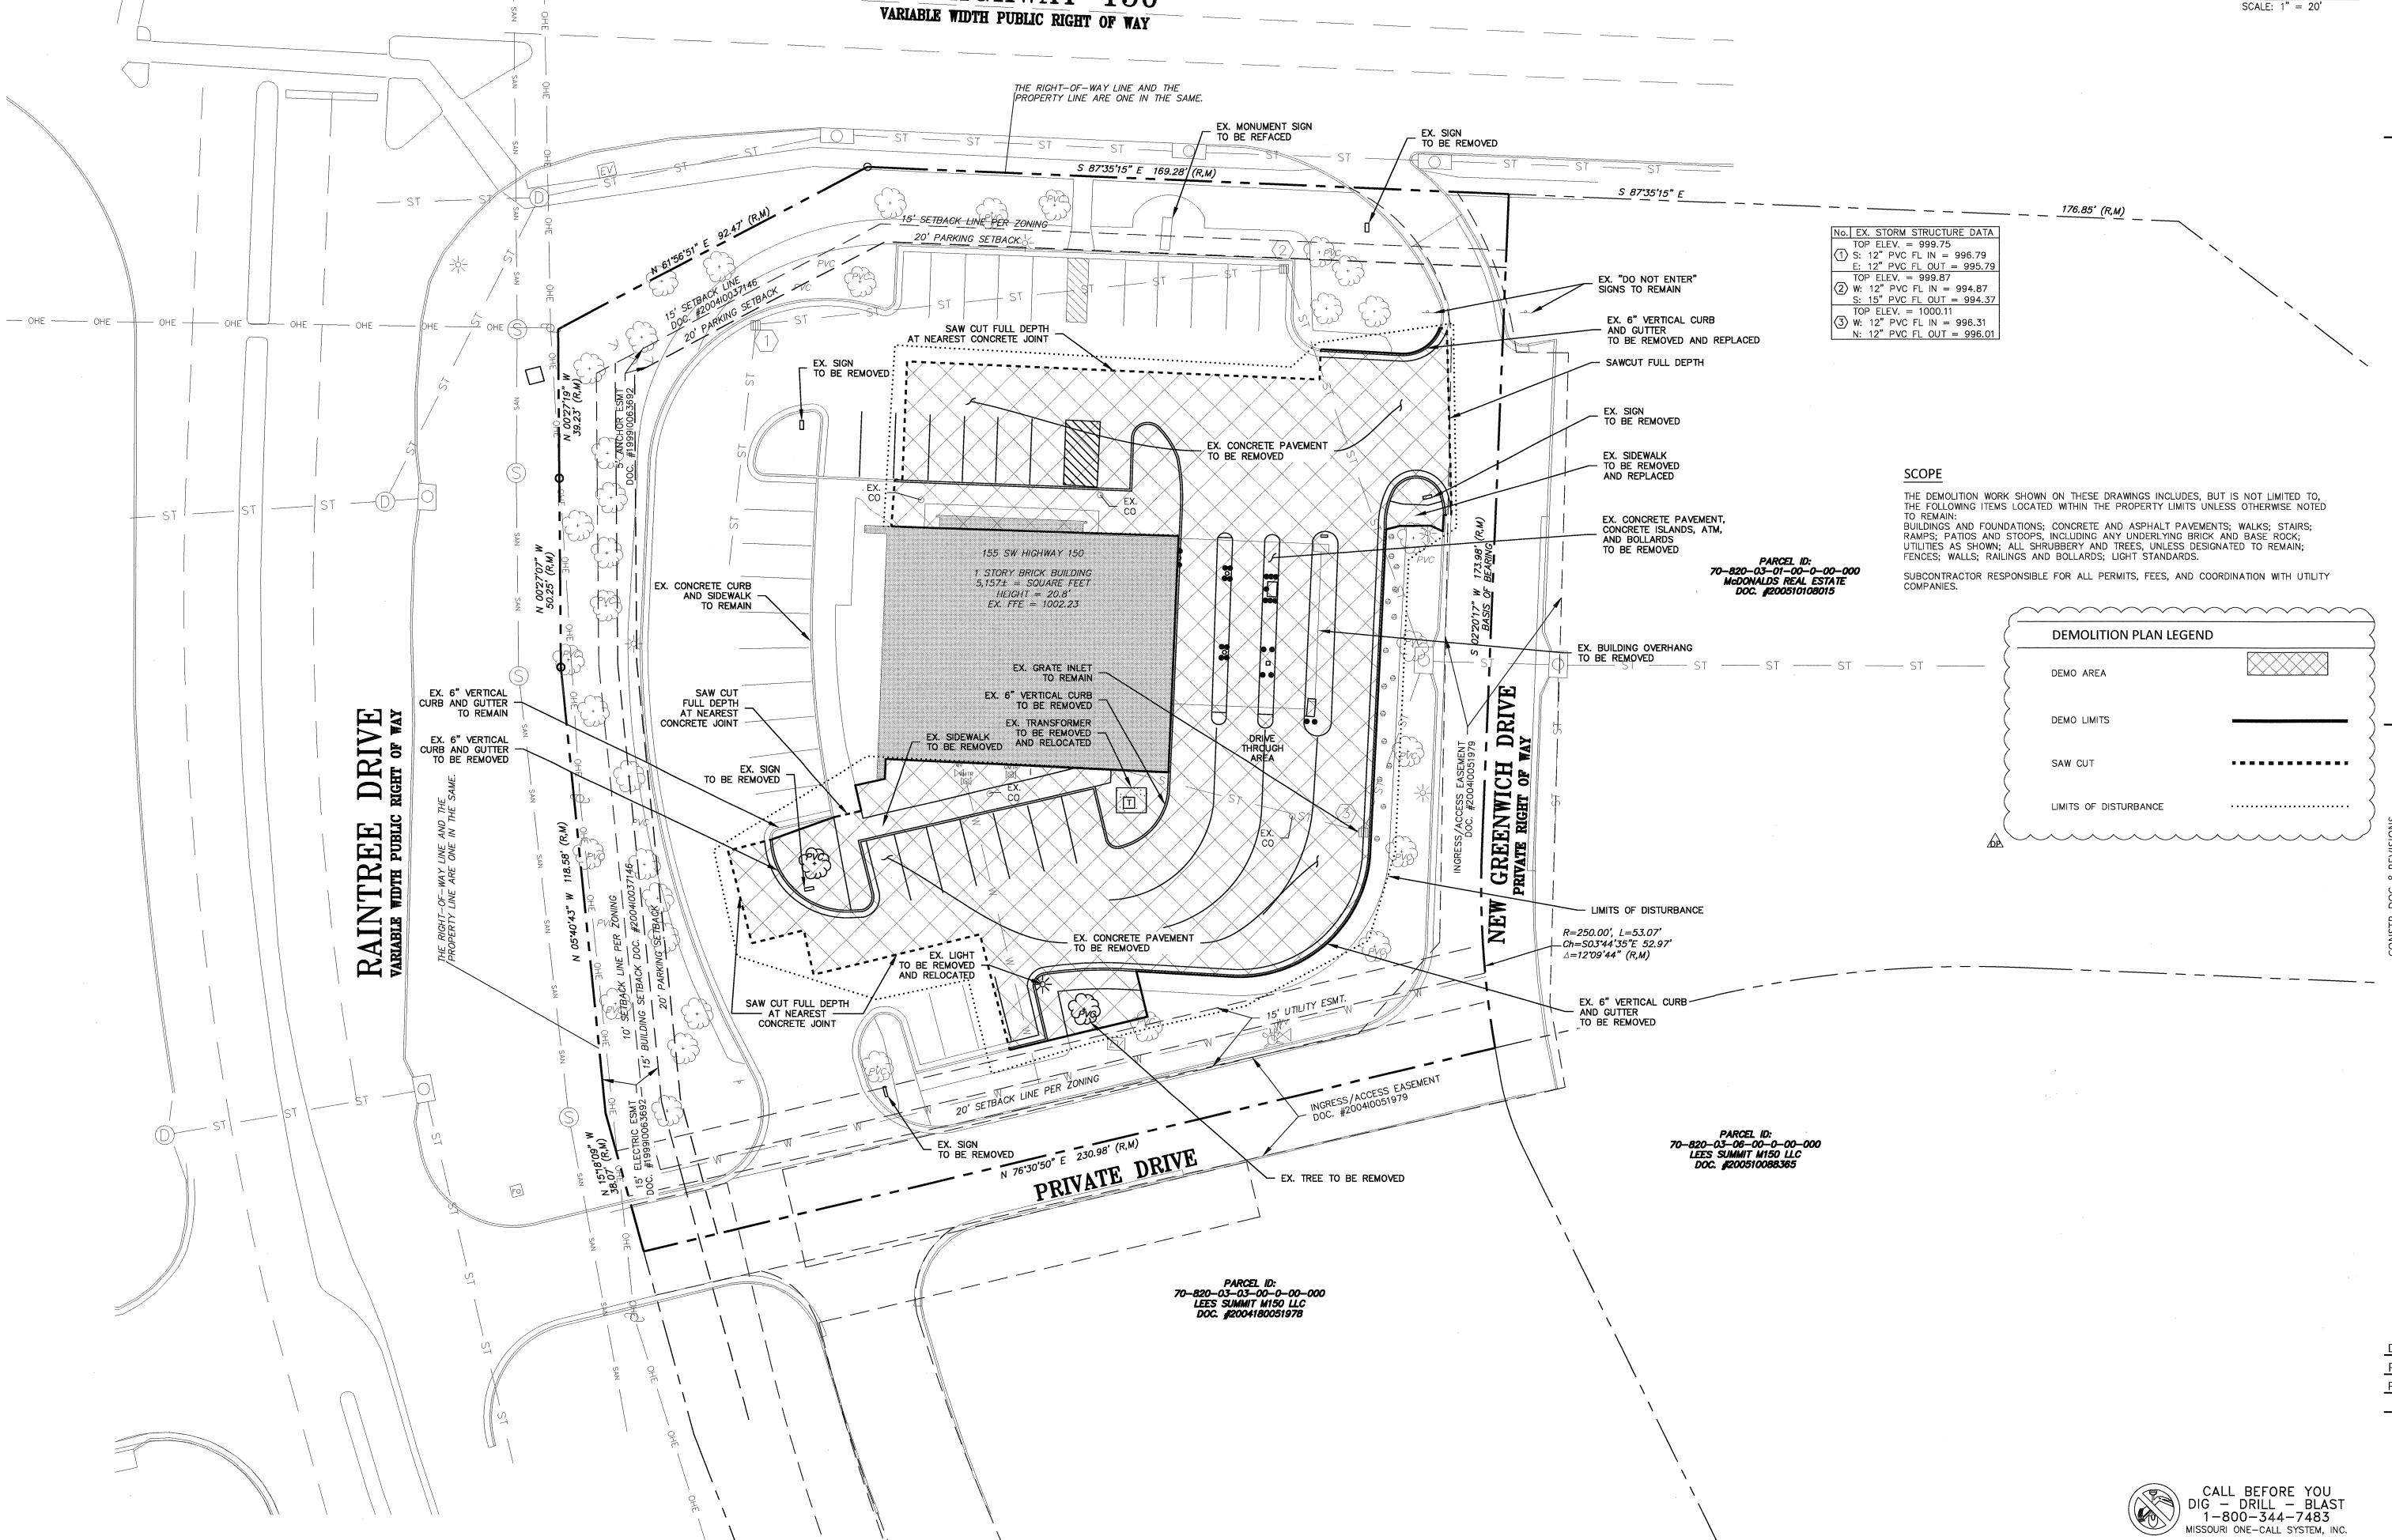

SW HIGHWAY 150

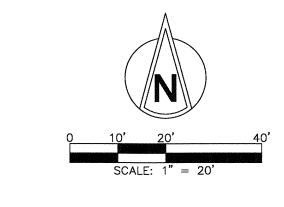



W M-150 SUMMIT,

CASCO DIVERSIFIED CORPORATION CERTIFICATE OF AUTHORITY #000613 12/31/21


THOMAS E BUERK III NUMBER () PE-2018000174


> PROFESSIONAL OF RECORD Buerk III, Thomas E. License NO. PE-2018000174 Expiration Date 12/31/20

Drawn By/Checked By: MEB/TEB **Project Number** Permit Date 06-17-20

SITE & UTILITY **PLAN** 

MISSOURI ONE-CALL SYSTEM, INC.

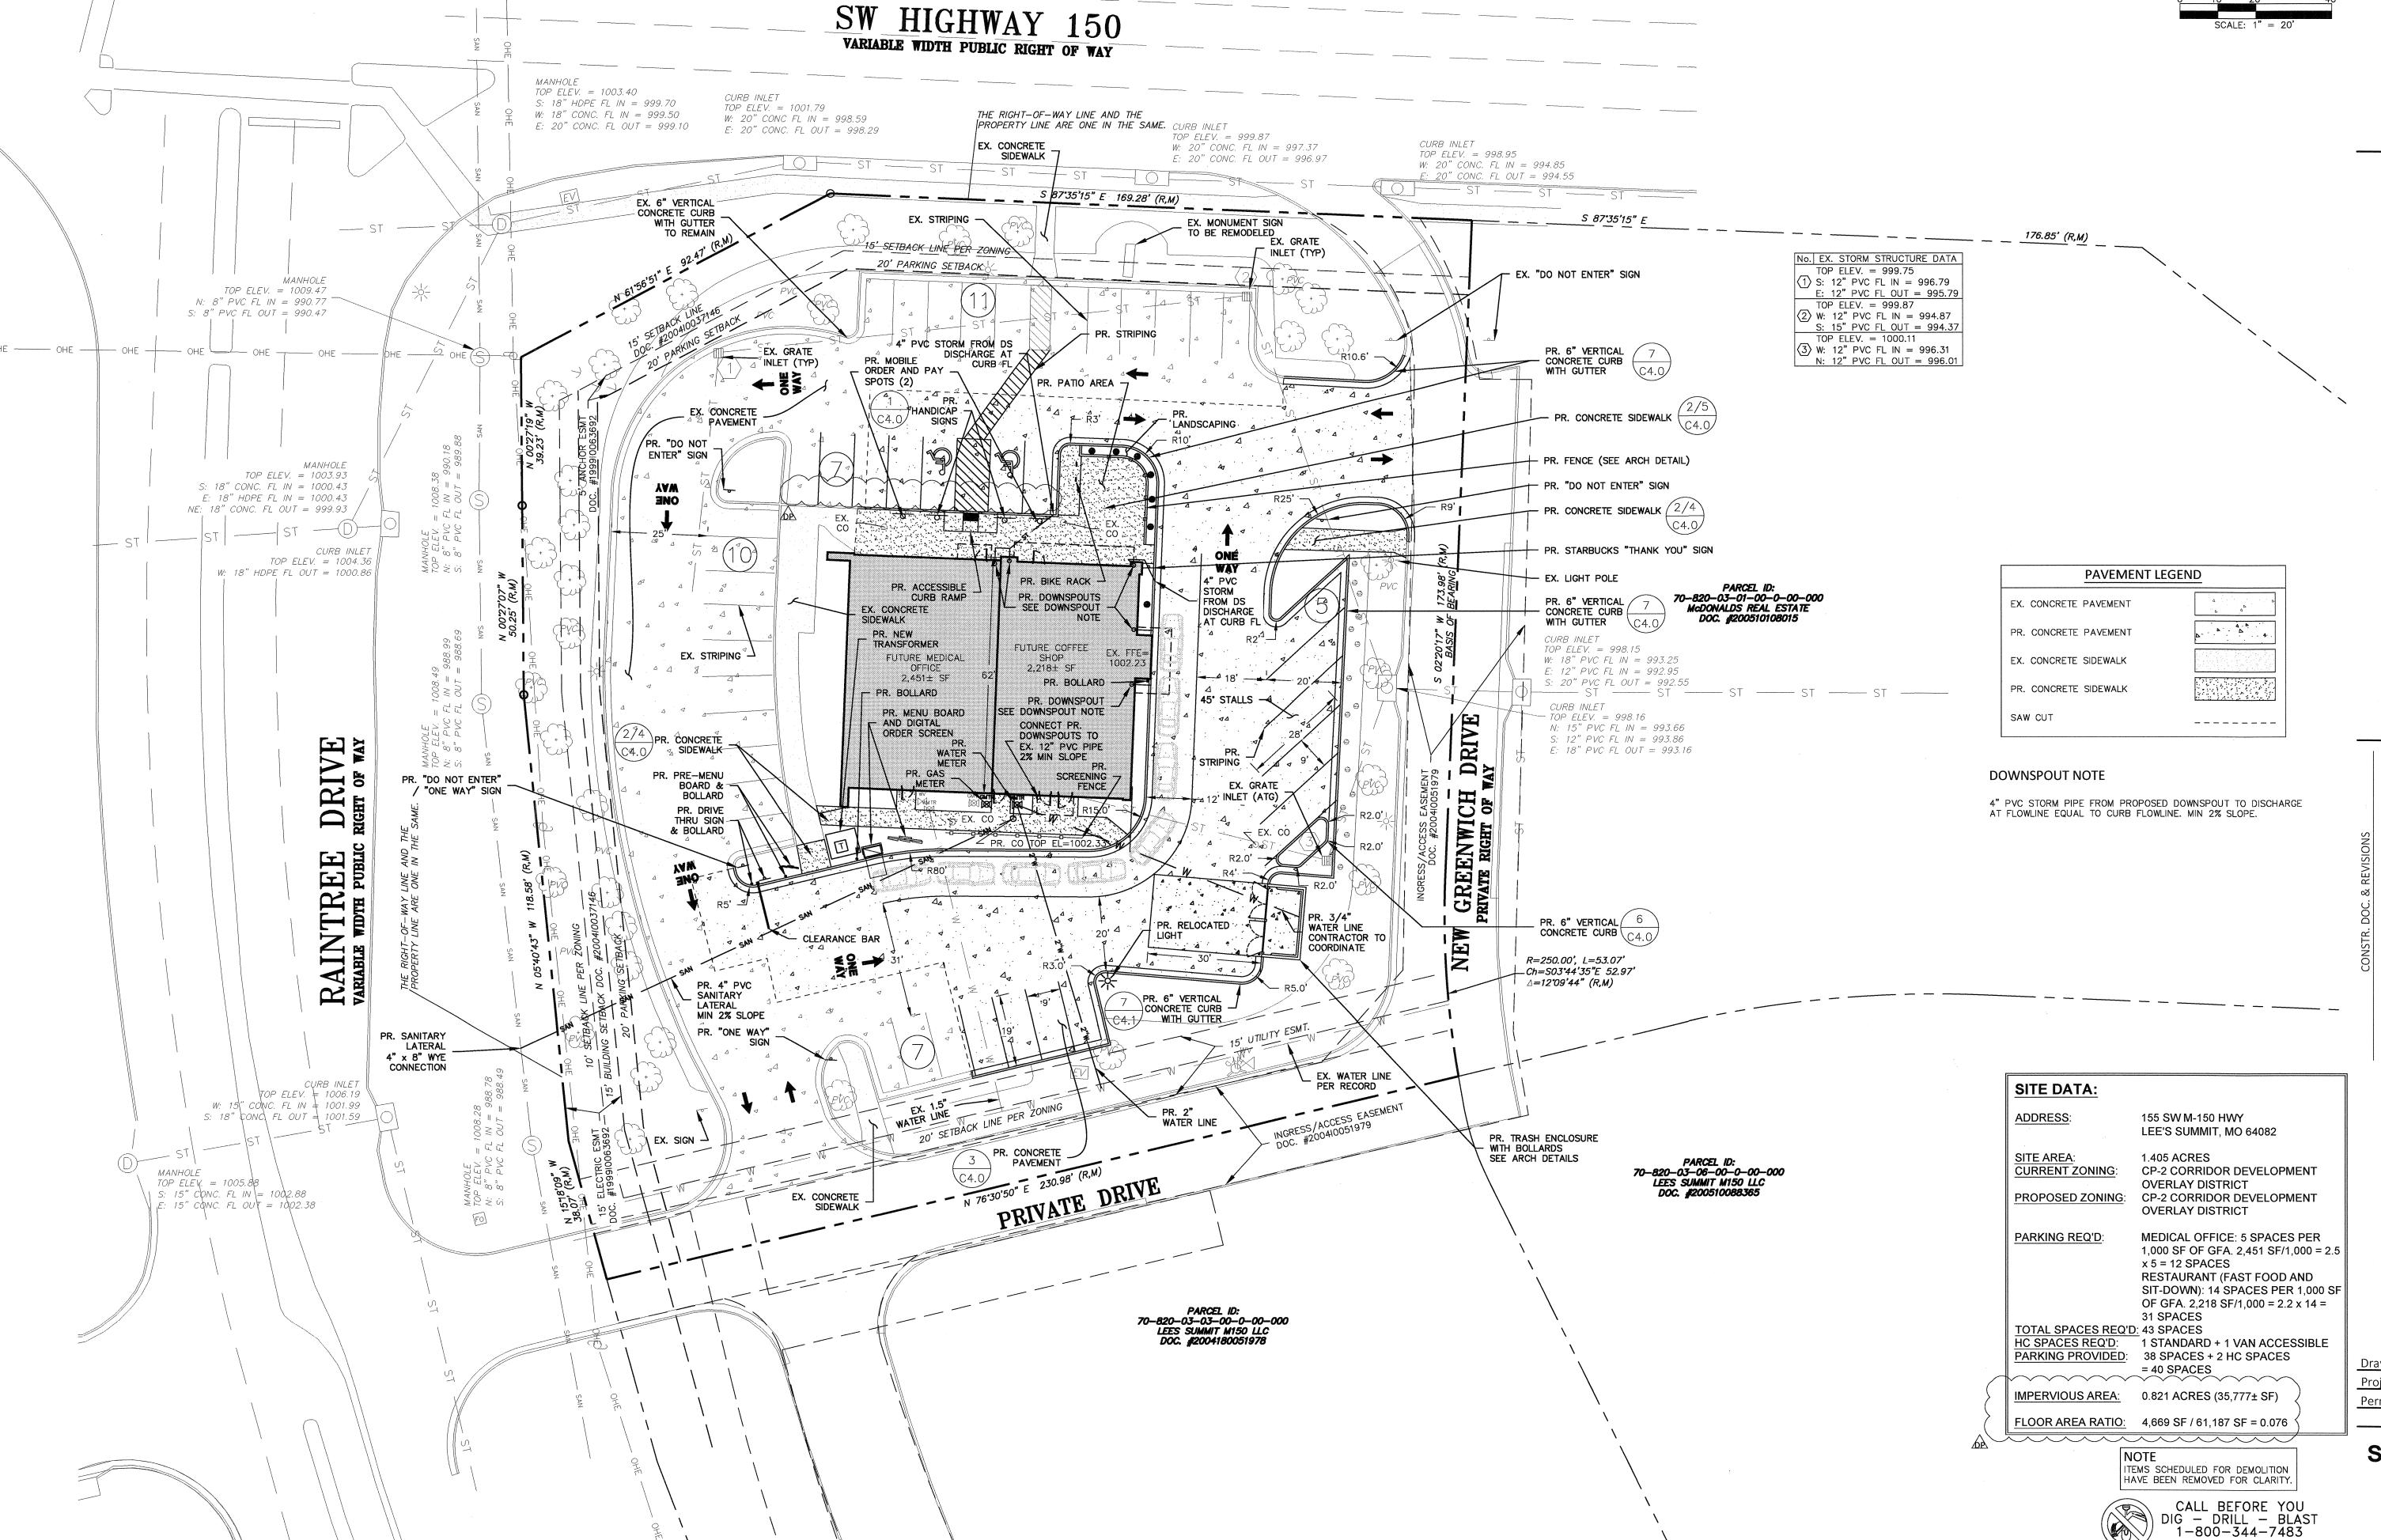

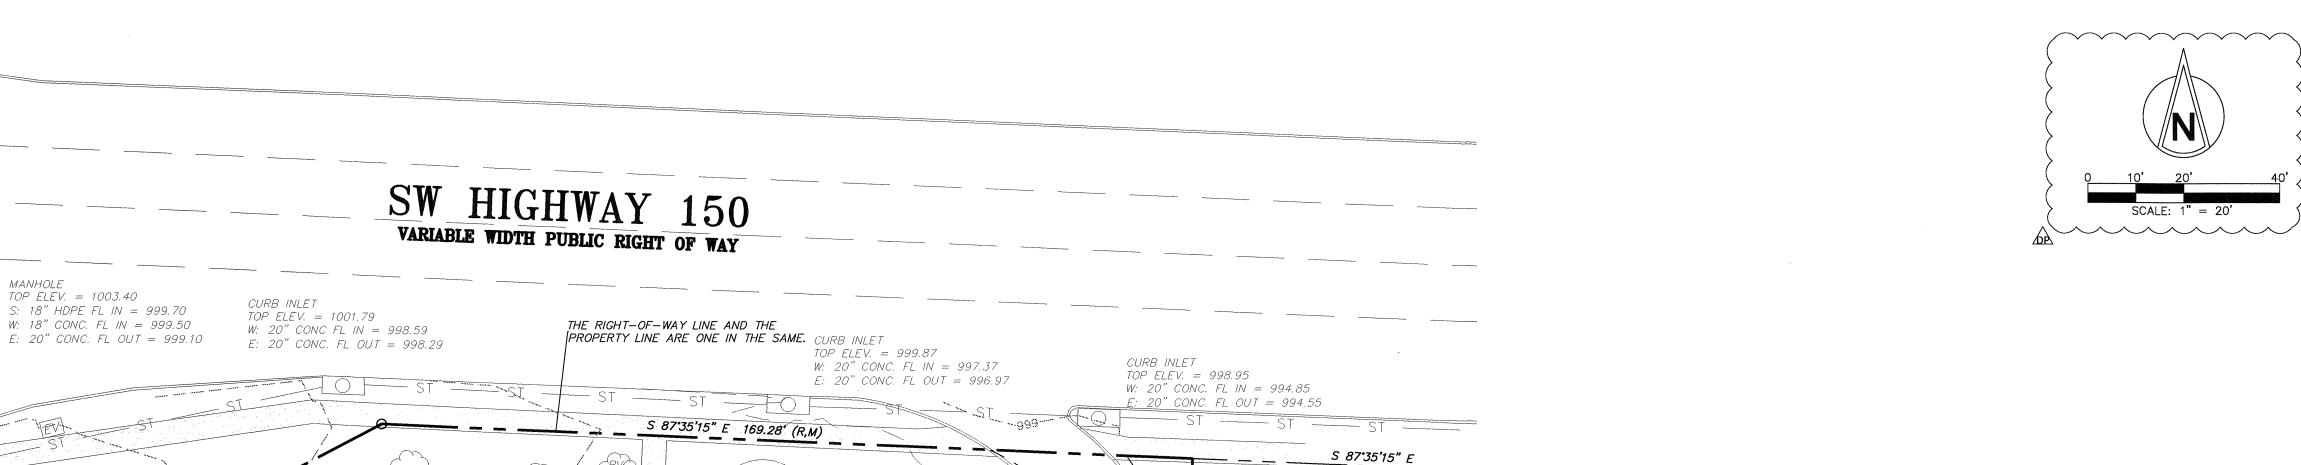

TOP ELEV. = 1009.47 N: 8" PVC FL IN = 990.77

TOP ELEV. = 1003.93

W: 18" HDPE FL OUT = 1000.86

CURB INLET

RAINTREE VARIABLE WIDTH PUBLIC

CURB INLET | TOP ELEV. = 1006.19 " COVC. FL IN = 1001.99

MAA TO A Si Si

S: 18" CONC FL OUT = 1001.59

TOP ELEV. = 1005.88


S: 15" CONC. FL IN = 1002.88 E: 15" CONC. FL OUT = 1002.38


TOP ELEV. = 1004.36

S: 18" CONC. FL IN = 1000.43 E: 18" HDPE FL IN = 1000.43

NE: 18" CONC. FL OUT = 999.93

S: 8" PVC FL OUT = 990.47

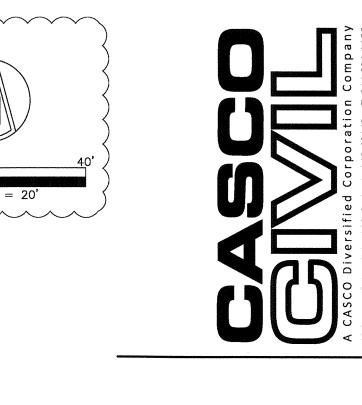

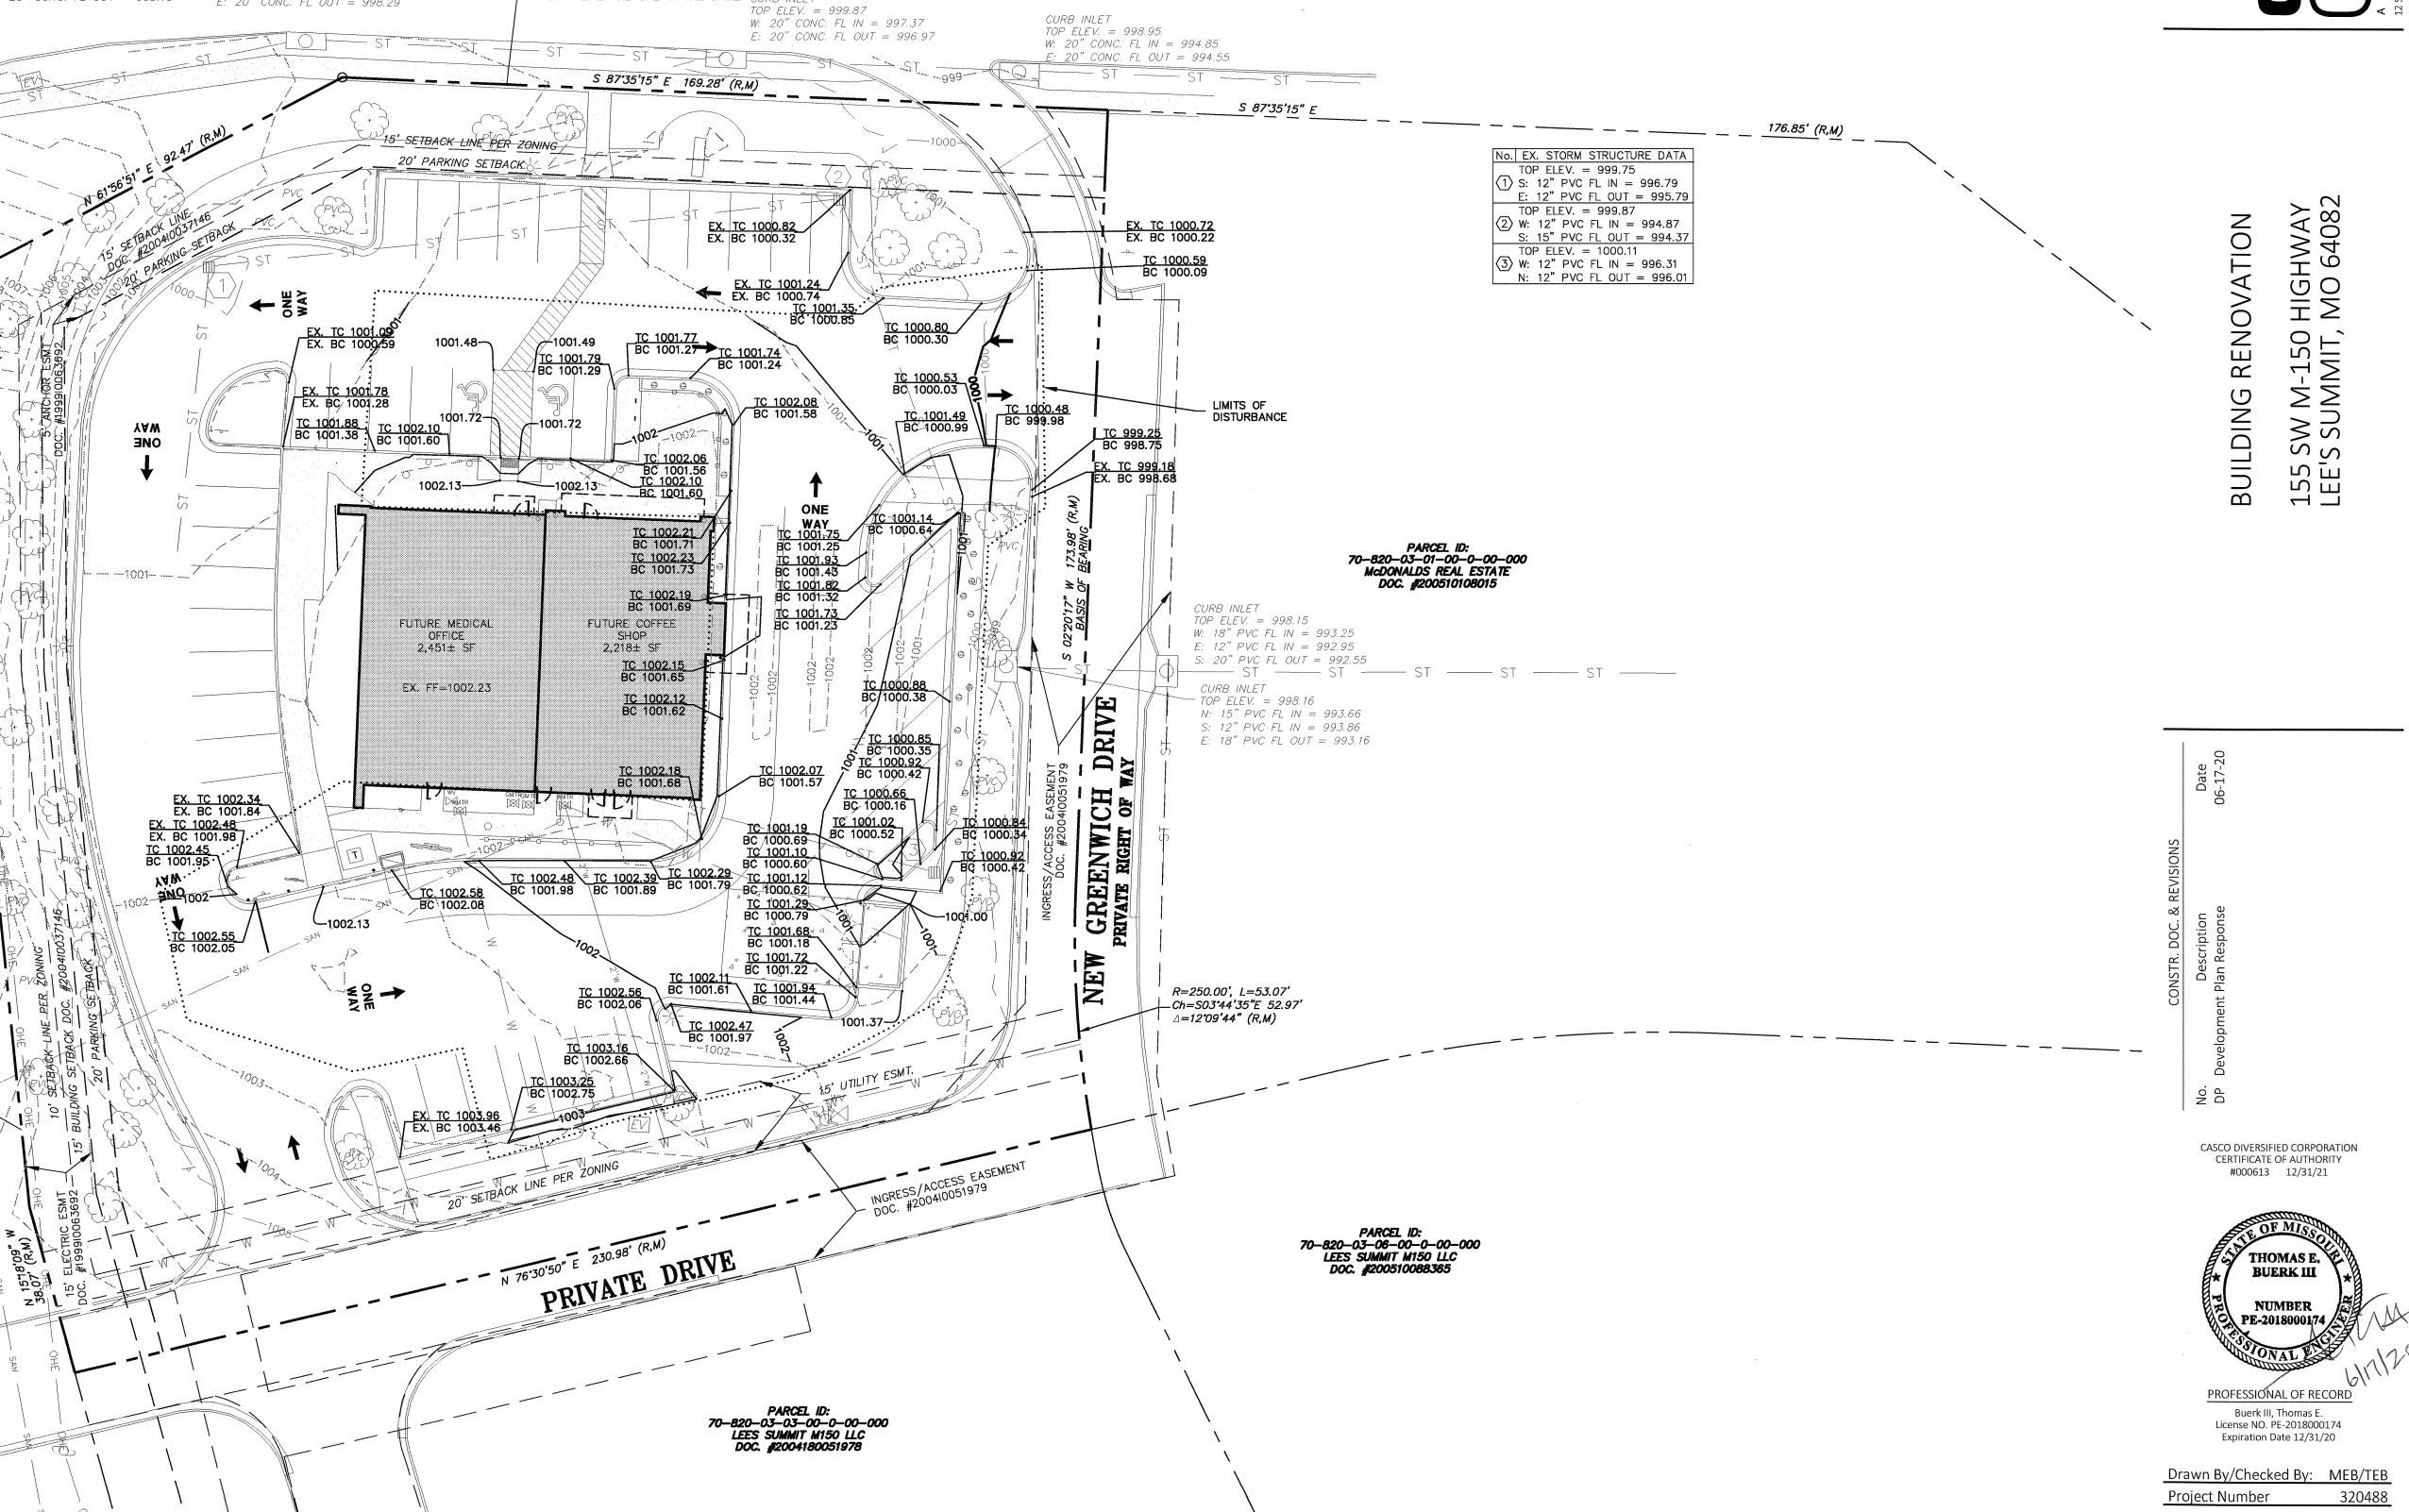


06-17-20 Permit Date

**GRADING PLAN** 


CALL BEFORE YOU
DIG - DRILL - BLAST
1-800-344-7483
MISSOURI ONE-CALL SYSTEM, INC.

ITEMS SCHEDULED FOR DEMOLITION HAVE BEEN REMOVED FOR CLARITY.

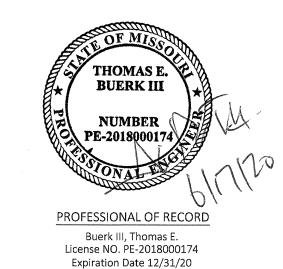

Drawn By/Checked By: MEB/TEB Project Number Permit Date

SITE DETAILS

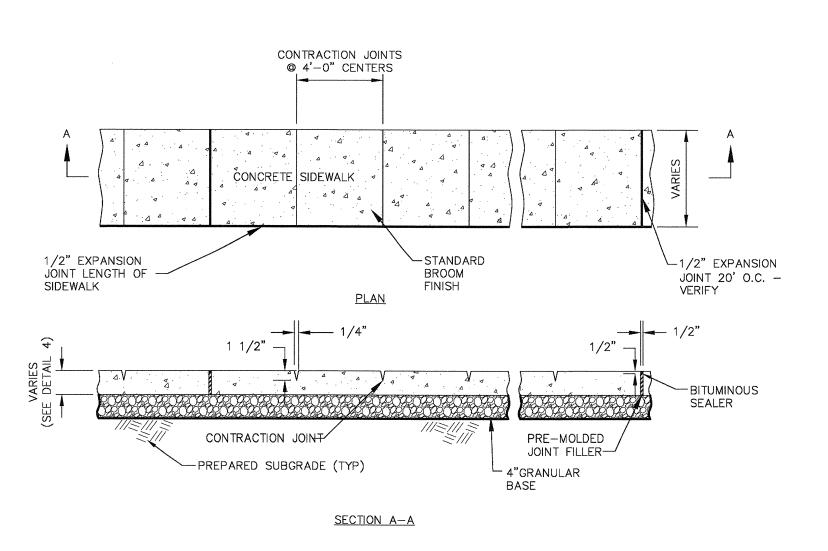

# 2 TYPICAL SLAB JOINT DETAILS

#### SUBGRADE PREPARATION NOTE

12"

VAN ACCESSIBLE

3'-0"

GRADE

- <u>SIGNAGE:</u>
ONLY APPROVED ADA SIGN TYPE IS

- <u>SIGNAGE</u>: ONLY APPROVED ADA SIGN TYPE IS R7-8a. ATTACH EACH SIGN TO

BOLLARDS W/ GALV. MOUNTING

-4'-0" X 1 1/2"

┌─ 6" MINIMUM

BOLLARDS MUST BE STEEL PIPE (6" MINIMUM) AND FILLED WITH CONCRETE.

BOLLARD DETAIL

1 HANDICAP PARKING SIGN C4.0) NO SCALE

SCALE: NO SCALE


DIAMETER GÁLVANIZED POLE SET INSIDE

BOLLARD W/ CONCRETE.

- <u>BOLLARD</u>: REFER TO DETAIL BELOW.

R7-8. ATTACH EACH SIGN TO BOLLARDS W/ GALV. MOUNTING

> ALL EXPOSED AND/OR DISTURBED GRANULAR BASE AREAS SHALL BE COMPACTED TO A MINIMUM OF 95% OF OPTIMUM DENSITY IN ACCORDANCE W/ASTM D 1557 AT OPTIMUM MOISTURE CONTENT AND TO A MINIMUM DEPTH OF 8" - ALL SUBGRADE SOIL AREAS EXPOSED BY EXCAVATIONS AND GRADING SHALL BE COMPACTED TO A MINIMUM OF 95% OF OPTIMUM DENSITY IN ACCORDANCE W/ASTM D 1557 AT OPTIMUM MOISTURE CONTENT AND TO A MINIMUM DEPTH OF 12" - FILL WHERE REQUIRED SHALL BE PLACED IN LIFTS NOT TO EXCEED 8" LOOSE MEASURE AND SHALL BE COMPACTED AS OUTLINED ABOVE —
> THE ON SITE TESTING COMPANY SHALL PROVIDE TESTING AND INSPECTION OF THE SOIL
> WORK PRIOR TO PLACING CONCRETE

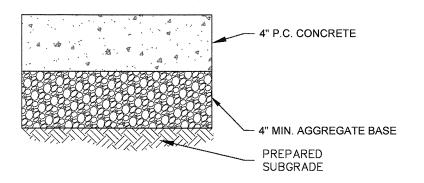


PREPARED

3 CONCRETE PAVEMENT DETAIL

- 7" P.C. CONCRETE

4" MIN. AGGREGATE BASE


4 CONCRETE SIDEWALK DETAIL C4.0 NO SCALE

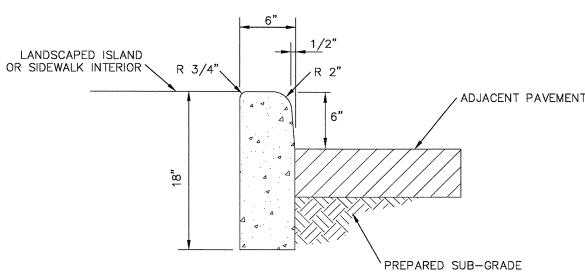


DESIGN AND CONSTRUCTION MANUAL LS SECTION 2604.2.A. ALL CONSTRUCTION MATERIALS AND METHODS OF CONSTRUCTION SHALL BE IN ACCORDANCE WITH LOCAL MUNICIPAL ORDINANCES.

NOTE: PROVIDE CONTROL JOINTS AT 15' CENTERS


ANY UNSUITABLE SOIL (AS DETERMINED BY SOILS ENGINEER) BELOW STRUCTURE SHALL BE REMOVED AND REPLACED WITH SELECT EARTHEN MATERIAL COMPACTED IN PLACE WITH VIBRATORY TAMPER.

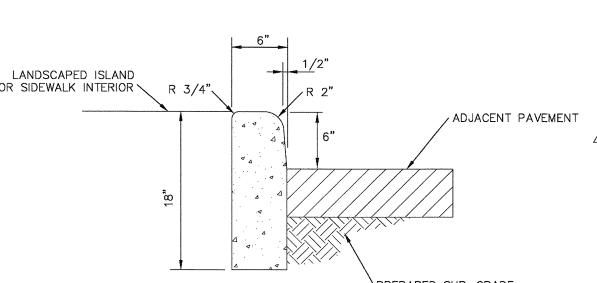



6 BARRIER CURB DETAIL
C4.0 NO SCALE

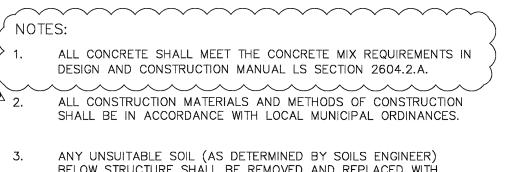



4. PROVIDE 1/2" EXPANSION JOINTS AT 20' CENTERS.

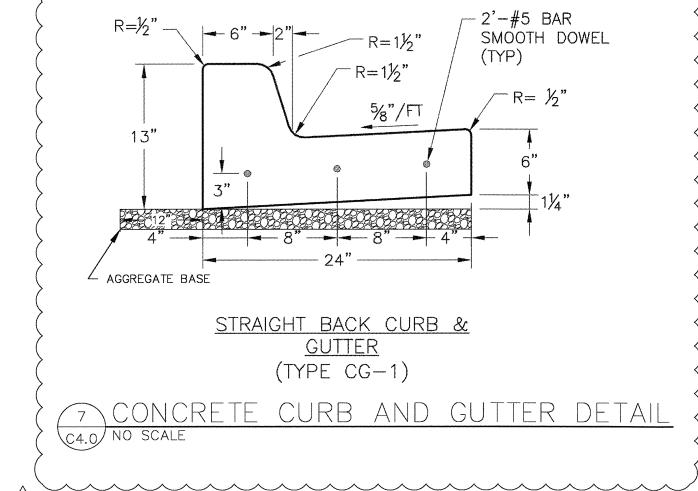


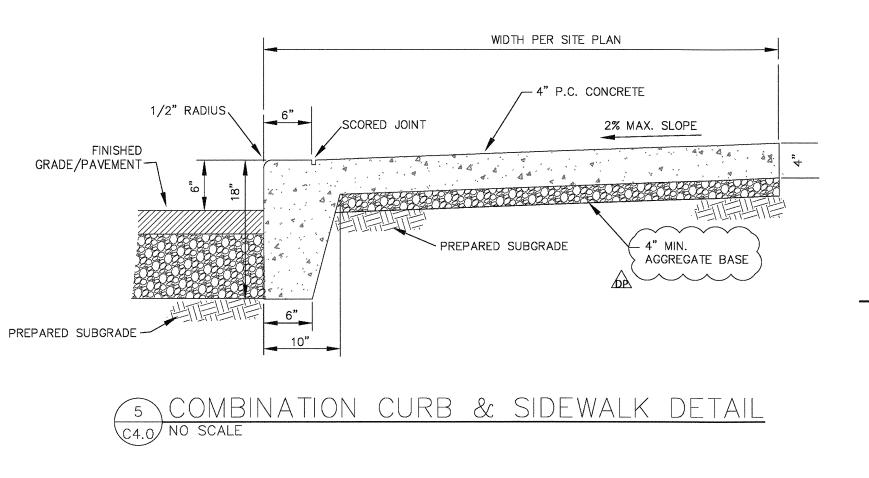

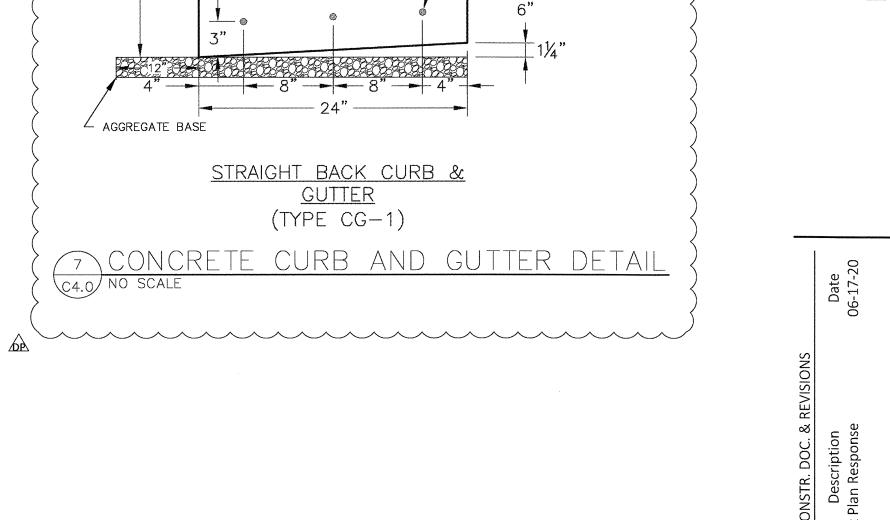

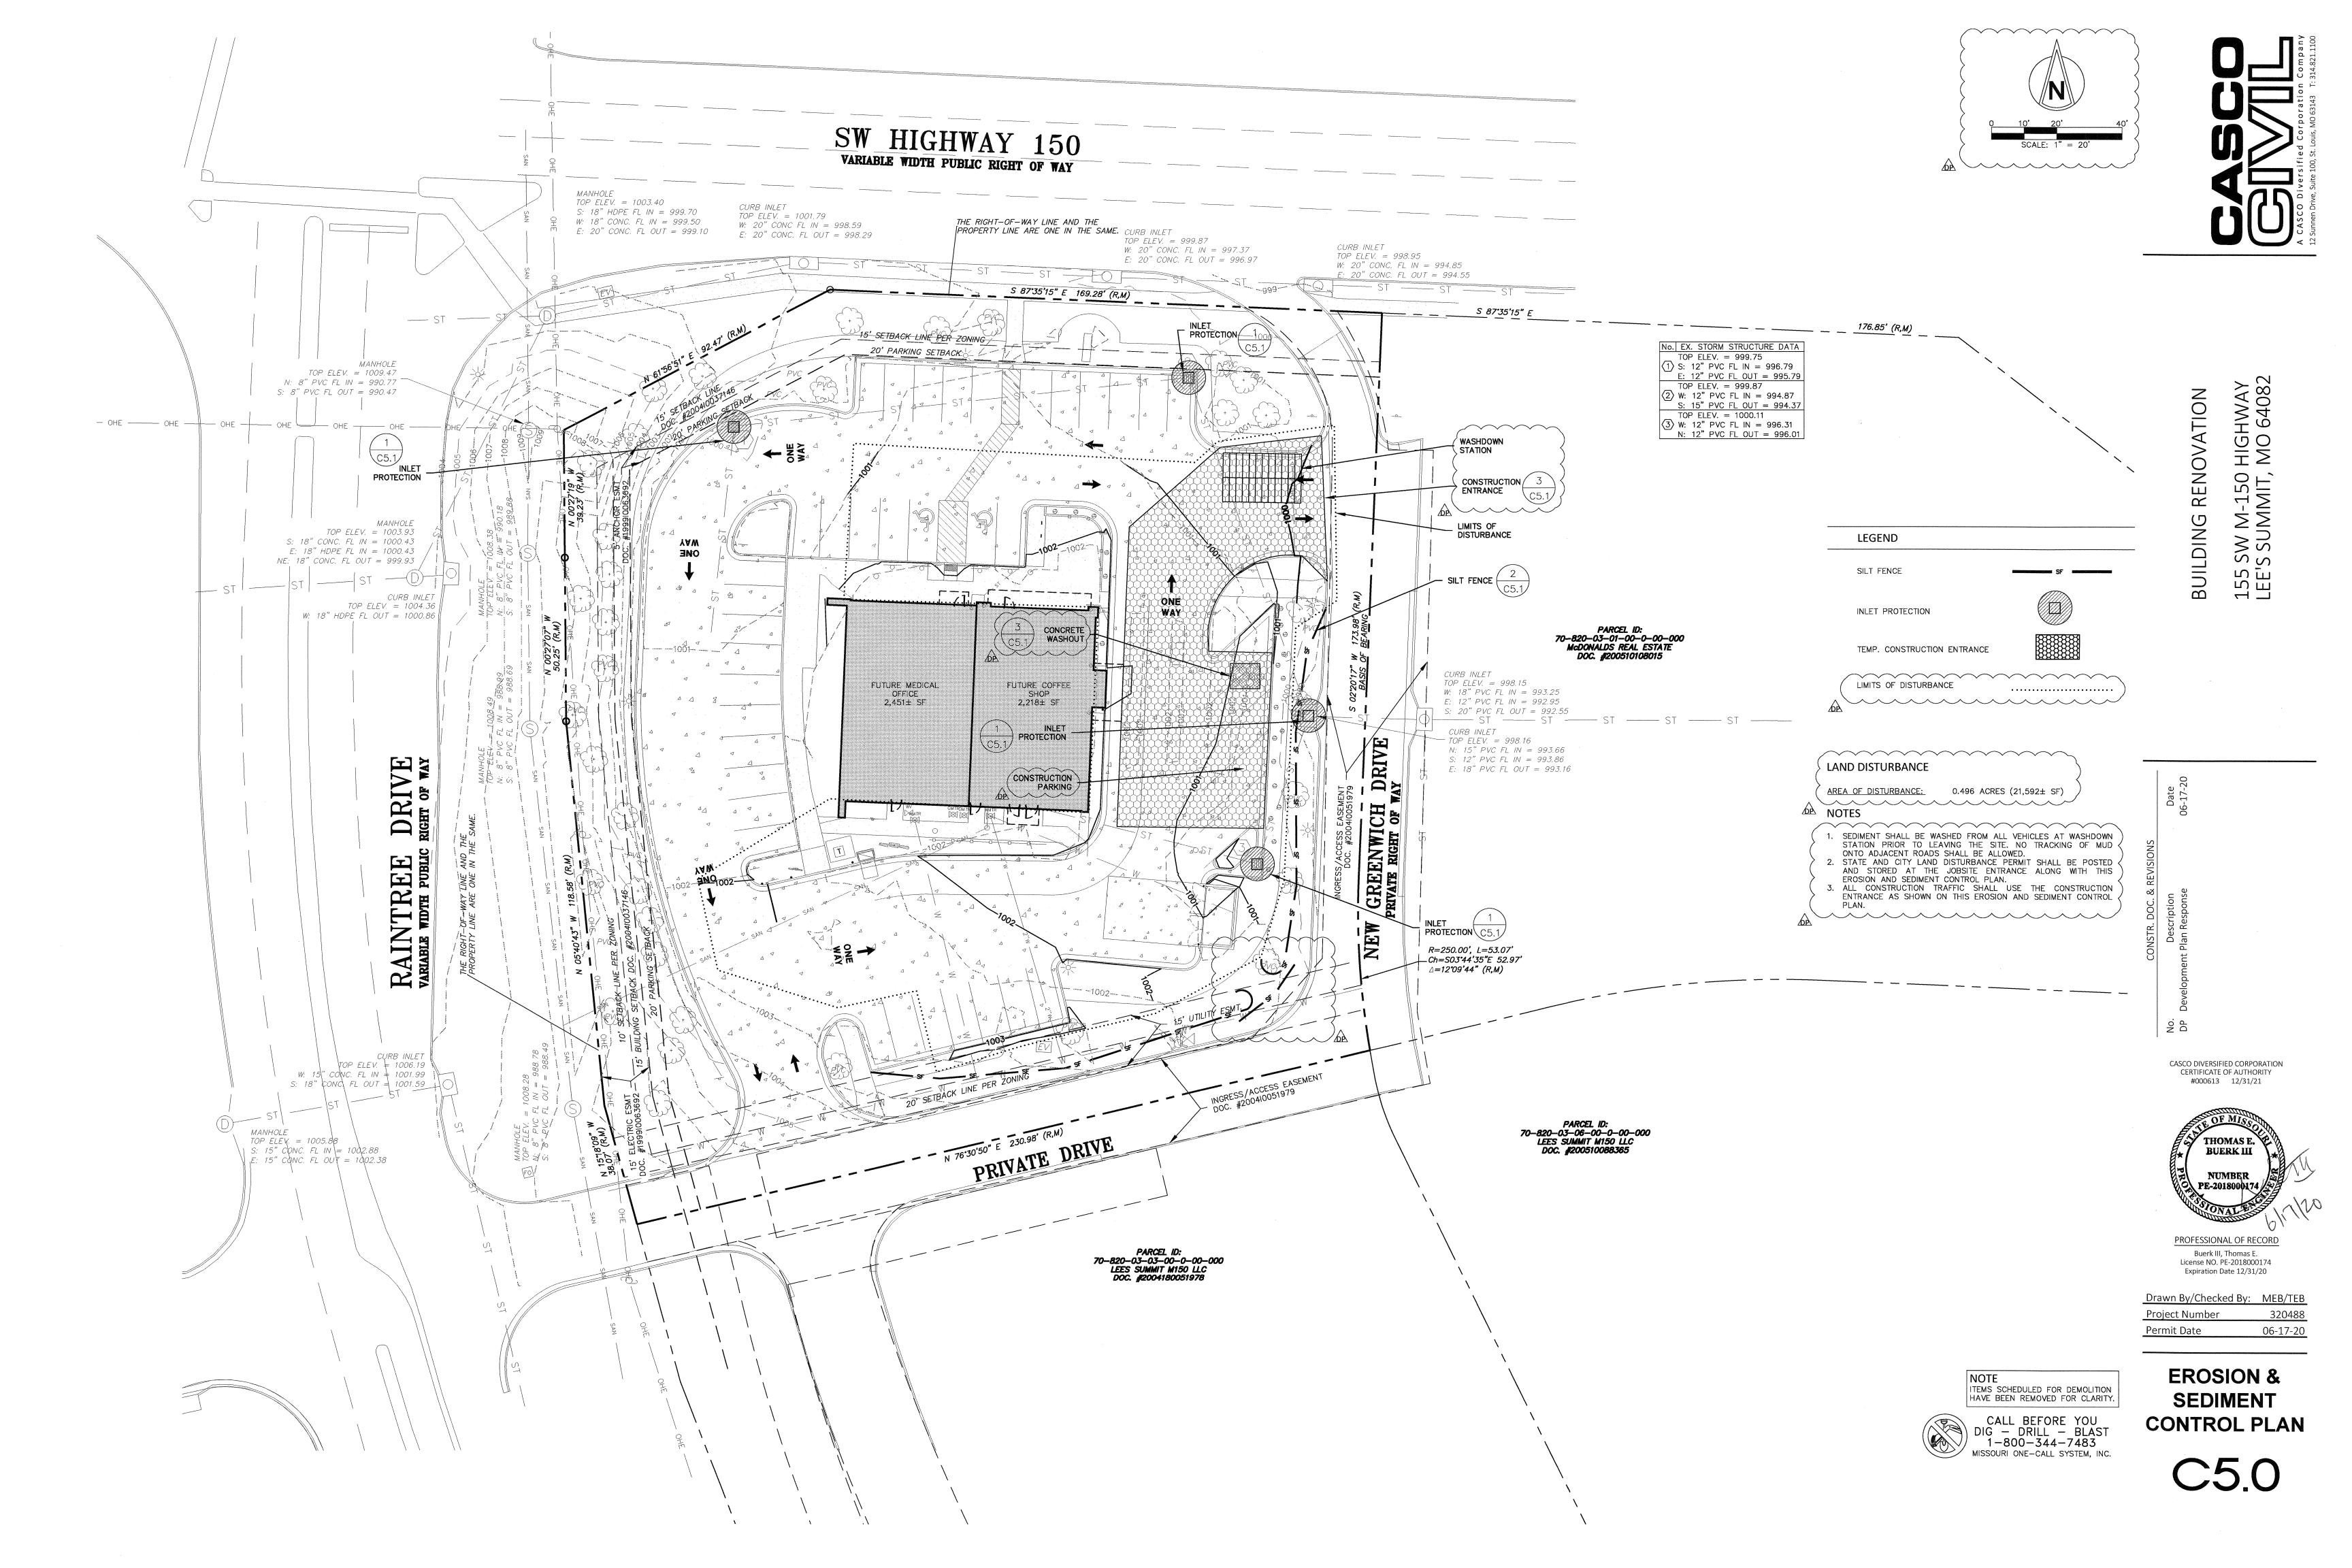

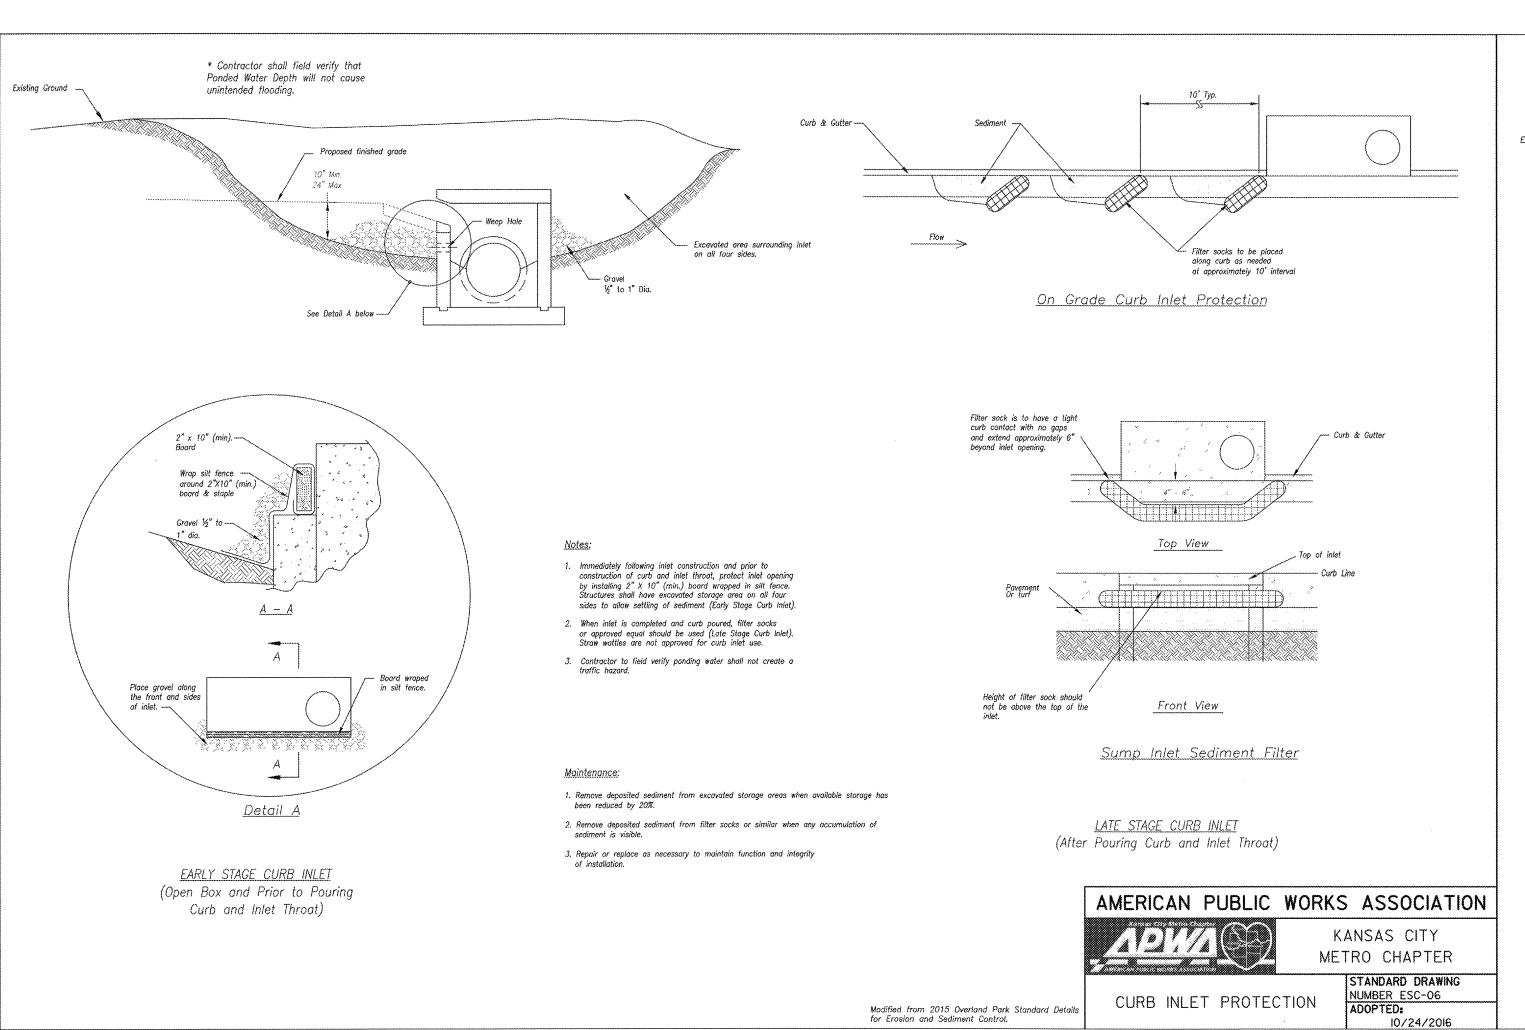


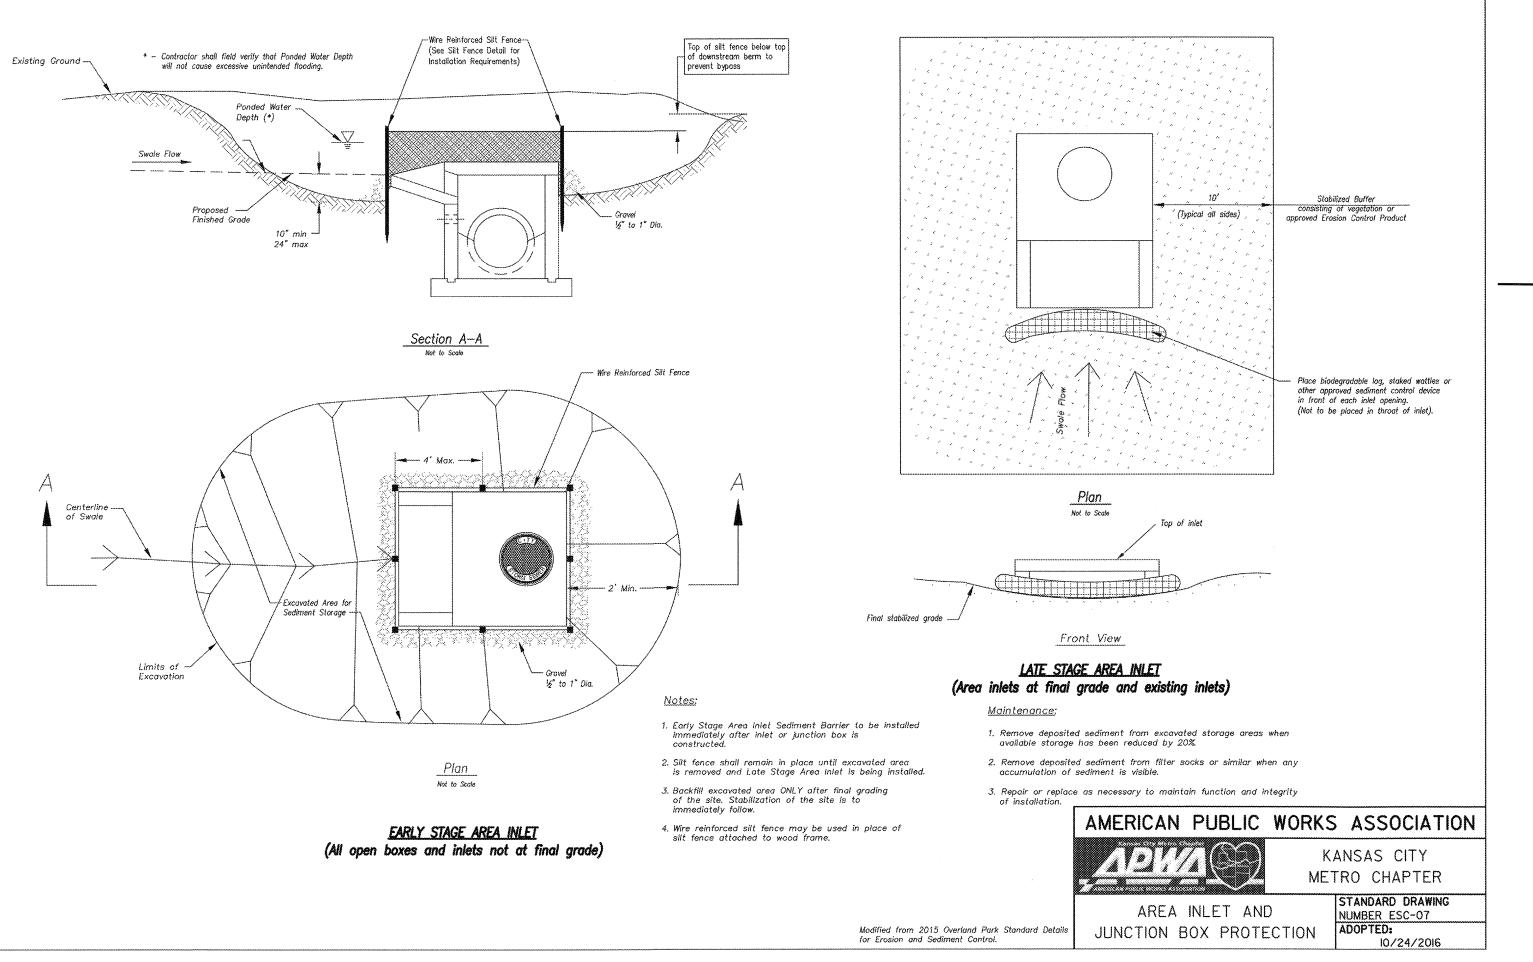




RENOVATION M-150 | W SU



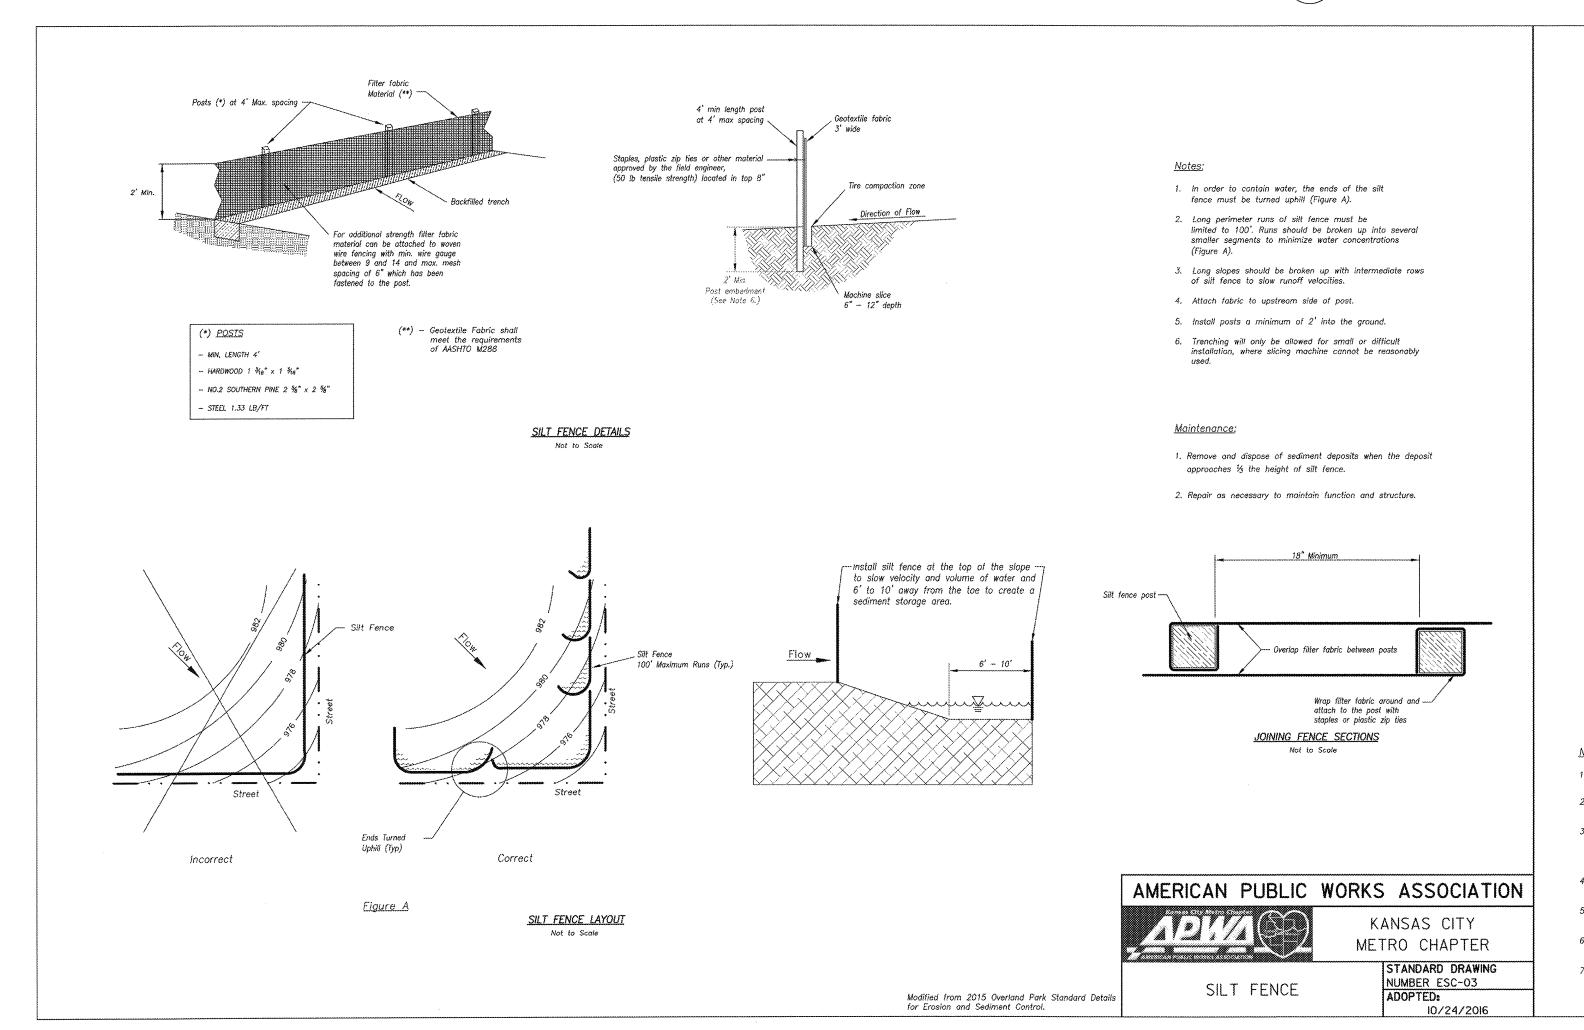

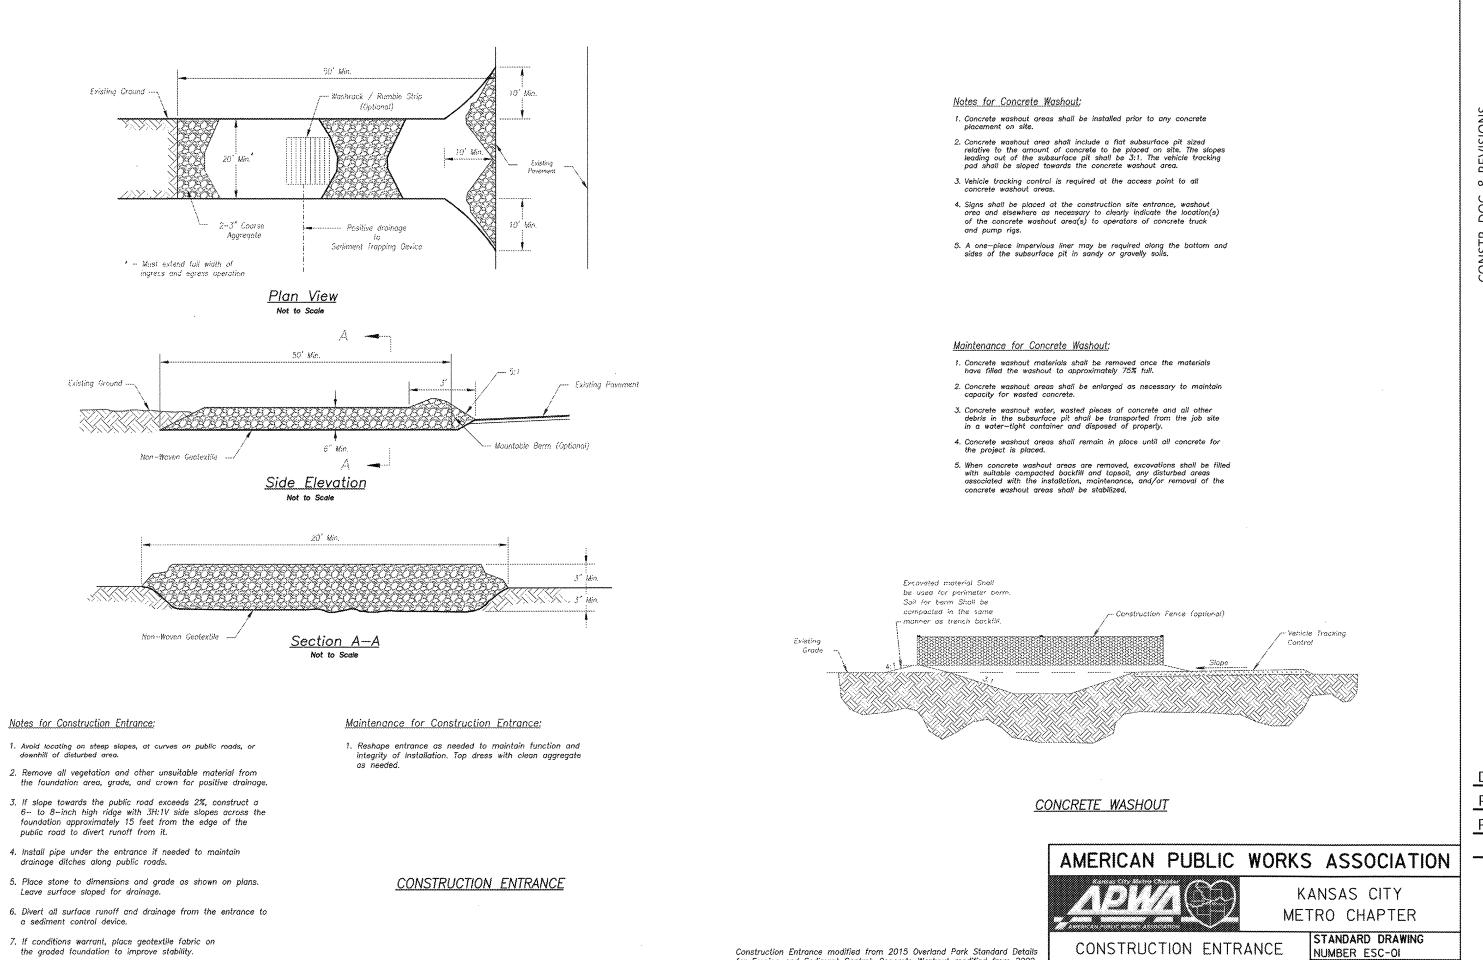

CASCO DIVERSIFIED CORPORATION CERTIFICATE OF AUTHORITY #000613 12/31/21 THOMAS E. **BUERK III** NUMBER X PE-201800017 PROFESSIONAL OF RECORD Buerk III, Thomas E. License NO. PE-2018000174 Expiration Date 12/31/20 Drawn By/Checked By: MEB/TEB **Project Number** 06-17-20 Permit Date

CONSTRUCTION ENTRANCE & CONCRETE WASHOUT DETAIL

On Scale

for Erosion and Sediment Control; Concrete Washout modified from 2009

City of Great Bend Standard Drawings.

**EROSION & SEDIMENT** CONTROL **DETAILS** 


ADOPTED:

AND CONCRETE WASHOUT

#### LOW USE IRRIGATION SYSTEM:

- 1. PROVIDE LAWN IRRIGATION SYSTEM CONSISTING OF MINI JETS, MISTERS, POP-UP RISERS, ADJUSTABLE BUBBLERS, ADJUSTABLE SPRAYERS, DRIPPER NOZZLES (EMITTERS). BACKFLOW PREVENTERS, AUTOMATIC CONTROL VALVES, TIMER, CONTROLLERS AND ALL RELATED ACCESSORIES FOR THE AREAS INDICATED ON THE DRAWINGS AND AS REQUIRED
- TO COMPLY WITH LOCAL CODES AND REGULATIONS. 2. LAWN IRRIGATION CONTRACTOR SHALL PAY ALL ONE-TIME FEES AND CHARGES RELATED TO THIS WORK, INCLUDING WATER SUPPLY AND METERING.
- COORDINATE WITH THE WATER COMPANY AS REQUIRED FOR SERVICE ARRANGEMENTS. 4. LAWN IRRIGATION CONTRACTOR SHALL PROVIDE ALL WORK, INCLUDING ALL POWER AND CONTROL WIRING, TESTING, ADJUSTING, AND START-UP AS REQUIRED FOR A COMPLETE, PROPERLY FUNCTIONING SYSTEM.
- 5. AFTER ALL SPRINKLER HEADS AND PLANTINGS ARE INSTALLED, ADJUST SYSTEM FOR OPTIMUM COVERAGE AND COORDINATION WITH PLANTINGS. ADJUST ALL VALVES. ALIGNMENTS, AND COVERGE FOR OPTIMUM PERFORMANCE FOR FINAL APPROVAL BY THE OWNER'S REPRESENTATIVE.
- 6. LAWN IRRIGATION CONTRACTOR SHALL RECOMMEND AND SET THE PROGRAM ON THE CONTROLLER, PROVIDE THOROUGH, DETAILED OPERATING INSTRUCTIONS FOR THIS SPECIFIC SYSTEM, AND GIVE VERBAL OPERATING INSTRUCTIONS TO THE OWNER'S **OPERATING PERSONNEL**
- 7. LAWN IRRIGATION CONTRACTOR SHALL PROVIDE LAYOUT AND SHOP DRAWINGS FOR APPROVAL BY STATE AND LOCAL BULDING OFFICIALS AND/OR OTHER AGENCIES. LAWN IRRIGATION CONTRACTOR SHALL OBTAIN AND PAY FOR ALL NECESSARY PERMITS AND APPROVALS RELATED TO THIS WORK AND SUBMIT COPIES OF SAME FOR THE OWNER'S

PLANTING SCHEDULE									
TYPE	BOTANICAL NAME	COMMON NAME	SIZE	SPACING	MISC. NOTES				
	EUONYMUS ALATUS 'COMPACTUS'	DWARF BURNING BUSH	#5 CONT.	AS SHOWN	B&B ACCEPTABLE				
SHRUBS	NANDINA DOMESTICA	HEAVENLY BAMBOO	#5 CONT.	AS SHOWN	B&B ACCEPTABLE				
	SPIRAEA x BUMALDA 'ANTHONY WATERER'	RED SPIREA	#3 CONT.	AS SHOWN	B&B ACCEPTABLE				
MULCH	DOUBLE SHREDDED BARK MULCH - FROI	M LOCAL SOURCES (FREE	OF DELETERIC	OUS MATERIALS	)				

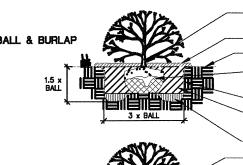


- SET TOP OF ROOT CROWN 1" ABOVE FINISHED GRADE

- 3"-4" MULCH AS SPEC'D FINISHED GRADE REMOVE TOP 1/3 OF BURLAP, TWINE,

ROPE AND BASKET FROM ROOTBALL -SCARIFY SIDES OF PLANTING HOLE BACKFILL WITH SOIL FROM PLANT PIT (REMOVE ALL DEBRIS, SEE NOTE) - BREAK 6" SUB-SOIL AS NECESSARY SET TOP OF ROOT CROWN 1" ABOVE FINISHED GRADE

- 3"-4" MULCH AS SPEC'D - FINISHED GRADE SCARIFY SIDES OF PLANTING HOLE BACKFILL WITH SOIL FROM PLANT PIT

**GENERAL NOTES:** 1. PRUNE ROOTS IF BALL IS ROONTBOHRIDBS AT SAME GROUND LEVEL 2. REMOVE ALL CONTAINERS AND NON-BIODEGRADEABLE BURLAP. 3. WHEN BACKFILLING PLANT PIT, PLACE PLANTING SOIL IN TWO LIFT'S. AFTER FIRST LIFT, PUDDLE SOIL IN WITH WATER TO REMOVE ALL AIR POCKETS. PLACE SECOND LIFT AND REPEAT. CONTINUE TO PUDDLE AND FILL AS NECCESSARY.

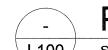


# PLANTING DTL.: SHRUBS

#### PLANTING SPECIFICATIONS AND GENERAL NOTES:

- 1. PLANTING BED PREPARATION: ALL MASS PLANTING BEDS SHALL BE TILLED TO A MINIMUM DEPTH OF 10". AMENDMENTS (LEAF MOLD OR SPHAGNUM PEAT MOSS) SHALL BE APPLIED DURING CULTIVATION. ALL BEDS ARE TO BE GRADED SMOOTH BEFORE PLANTING. PLANT GROUNDCOVER TO WITHIN 12" OF TREES OR SHRUBS. REMOVE ALL STONES LARGER THAN 2", ALL STICKS, ROOTS, RUBBISH AND ANY OTHER EXTRANEOUS MATERIALS.
- 2. BACKFILL SOIL: USE SOIL EXCAVATED FROM PLANTING HOLES AND PROVIDE AMENDMENTS (1 PART LEAF MOLD OR SPHAGNUM PEAT MOSS AND 3 PARTS EXCAVATED SOIL). ALL NEW TOPSOIL USED SHALL BE FREE OF WEEDS AND OTHER FOREIGN VEGETATION, AS WELL AS, STONES LARGER THAN 2", ALL STICKS, ROOTS, RUBBISH AND ANY OTHER EXTRANEOUS MATERIALS.
- 3. FERTILIZATION: ALL PLANT MATERIALS SHALL BE FERTILIZED UPON INSTALLATION WITH DRIED BONE MEAL OR OTHER SPECIFIED FERTILIZER MIXED IN WITH THE PLANTING SOIL PER THE MANUFACTURER'S INSTRUCTIONS. UNLESS NOTED OTHERWISE.
- 4. MULCH MATERIAL: CRUSHED VOLCANIC CINDERS COLOR TO BE REDDISH BLACK BLEND. MULCH ALL PLANTINGS TO A 3"-4" DEPTH.
- 5. FERTILIZER: JUMP-SHOT ROOT STIMULATOR AS MANUFACTURED BY GORDON OR APPROVED EQUAL, SHALL BE APPLIED TO THE SOIL BACKFILL OF EACH PLANT DURING INSTALLATION.
- 6. ALL PLANT MATERIAL SHALL COMPLY WITH THE LATEST EDITION OF THE AMERICAN STANDARD FOR NURSERY STOCK, AMERICAN ASSOCIATION OF NURSERYMEN.
- 7. LANDSCAPE CONTRACTOR SHALL GUARANTEE NEW PLANT MATERIALS THROUGH ONE CALENDAR YEAR FROM THE DATE OF OWNER ACCEPTANCE WITH ALL REPLACEMENTS TO BE PROVIDED AT NO ADDITIONAL COST TO THE OWNER.
- 8. LANDSCAPE CONTRACTOR IS RESPONSIBLE FOR ON-GOING MAINTENANCE OF ALL NEWLY INSTALLED MATERIALS UNTIL TIME OF OWNER ACCEPTANCE. ANY ACTS OF VANDALISM OR DAMAGE WHICH MAY OCCUR PRIOR TO OWNER ACCEPTANCE SHALL BE THE RESPONSIBILITY
- 9. WARRANTY FOR LANDSCAPE MATERIALS SHALL BEGIN ON THE DATE OF ACCEPTANCE BY THE OWNER'S REPRESENTATIVE AFTER THE COMPLETION OF PLANTING OF ALL LANDSCAPE MATERIALS. NO PARTIAL ACCEPTANCE WILL BE CONSIDERED. LANDSCAPE CONTRACTOR SHALL PROVIDE A WRITTEN REQUEST FOR THE OWNER'S ACCEPTANCE INSPECTION. REMOVE AND REPLACE DEAD PLANT MATERIAL (25% + DEAD) IMMEDIATELY UNLESS REQUIRED TO PLANT IN THE SUCCEEDING PLANTING SEASON. A LIMIT OF ONE REPLACEMENT OF EACH TREE AND SHRUB WILL BE REQUIRED, EXCEPT FOR LOSSES CAUSED BY CONTRACTOR'S ERRORS.
- 10. LANDSCAPE CONTRACTOR SHALL BE RESPONSIBLE FOR CLEAN-UP OF SITE AT THE COMPLETION OF LANDSCAPING EACH DAY. AT ALL TIMES SHALL THE SIDEWALKS BE MAINTAINED CLEAN AND FREE OF DEBRIS. REMOVE SURPLUS SOIL AND WASTE MATERIAL, TRASH AND DEBRIS FROM THE SITE AND LEGALLY DISPOSE OF SAME IN ACCORDANCE WITH FEDERAL, STATE AND LOCAL CODES AND REGULATIONS.
- 11. ALL PLANTS TO BE INSTALLED AS PER PLANTING DETAILS. PLANT MATERIALS ARE TO BE PLANTED IN THE SAME RELATIONSHIP TO GRADE AS WAS GROWN IN NURSERY CONDITIONS. IF WET, CLAY SOILS OR POOR DRAINING SOILS ARE EVIDENT, PLANT HIGHER. REMOVE ALL TWINE, WIRE AND BURLAP FROM TOP 1/3 OF ROOT BALL AND FROM TREE TRUNKS.
- 12. MULCHING AND WATERING OF ALL PLANTS & TREES SHALL BE IMMEDIATELY OR WITHIN 16




PLANTING NOTES SCALE: N.T.S.

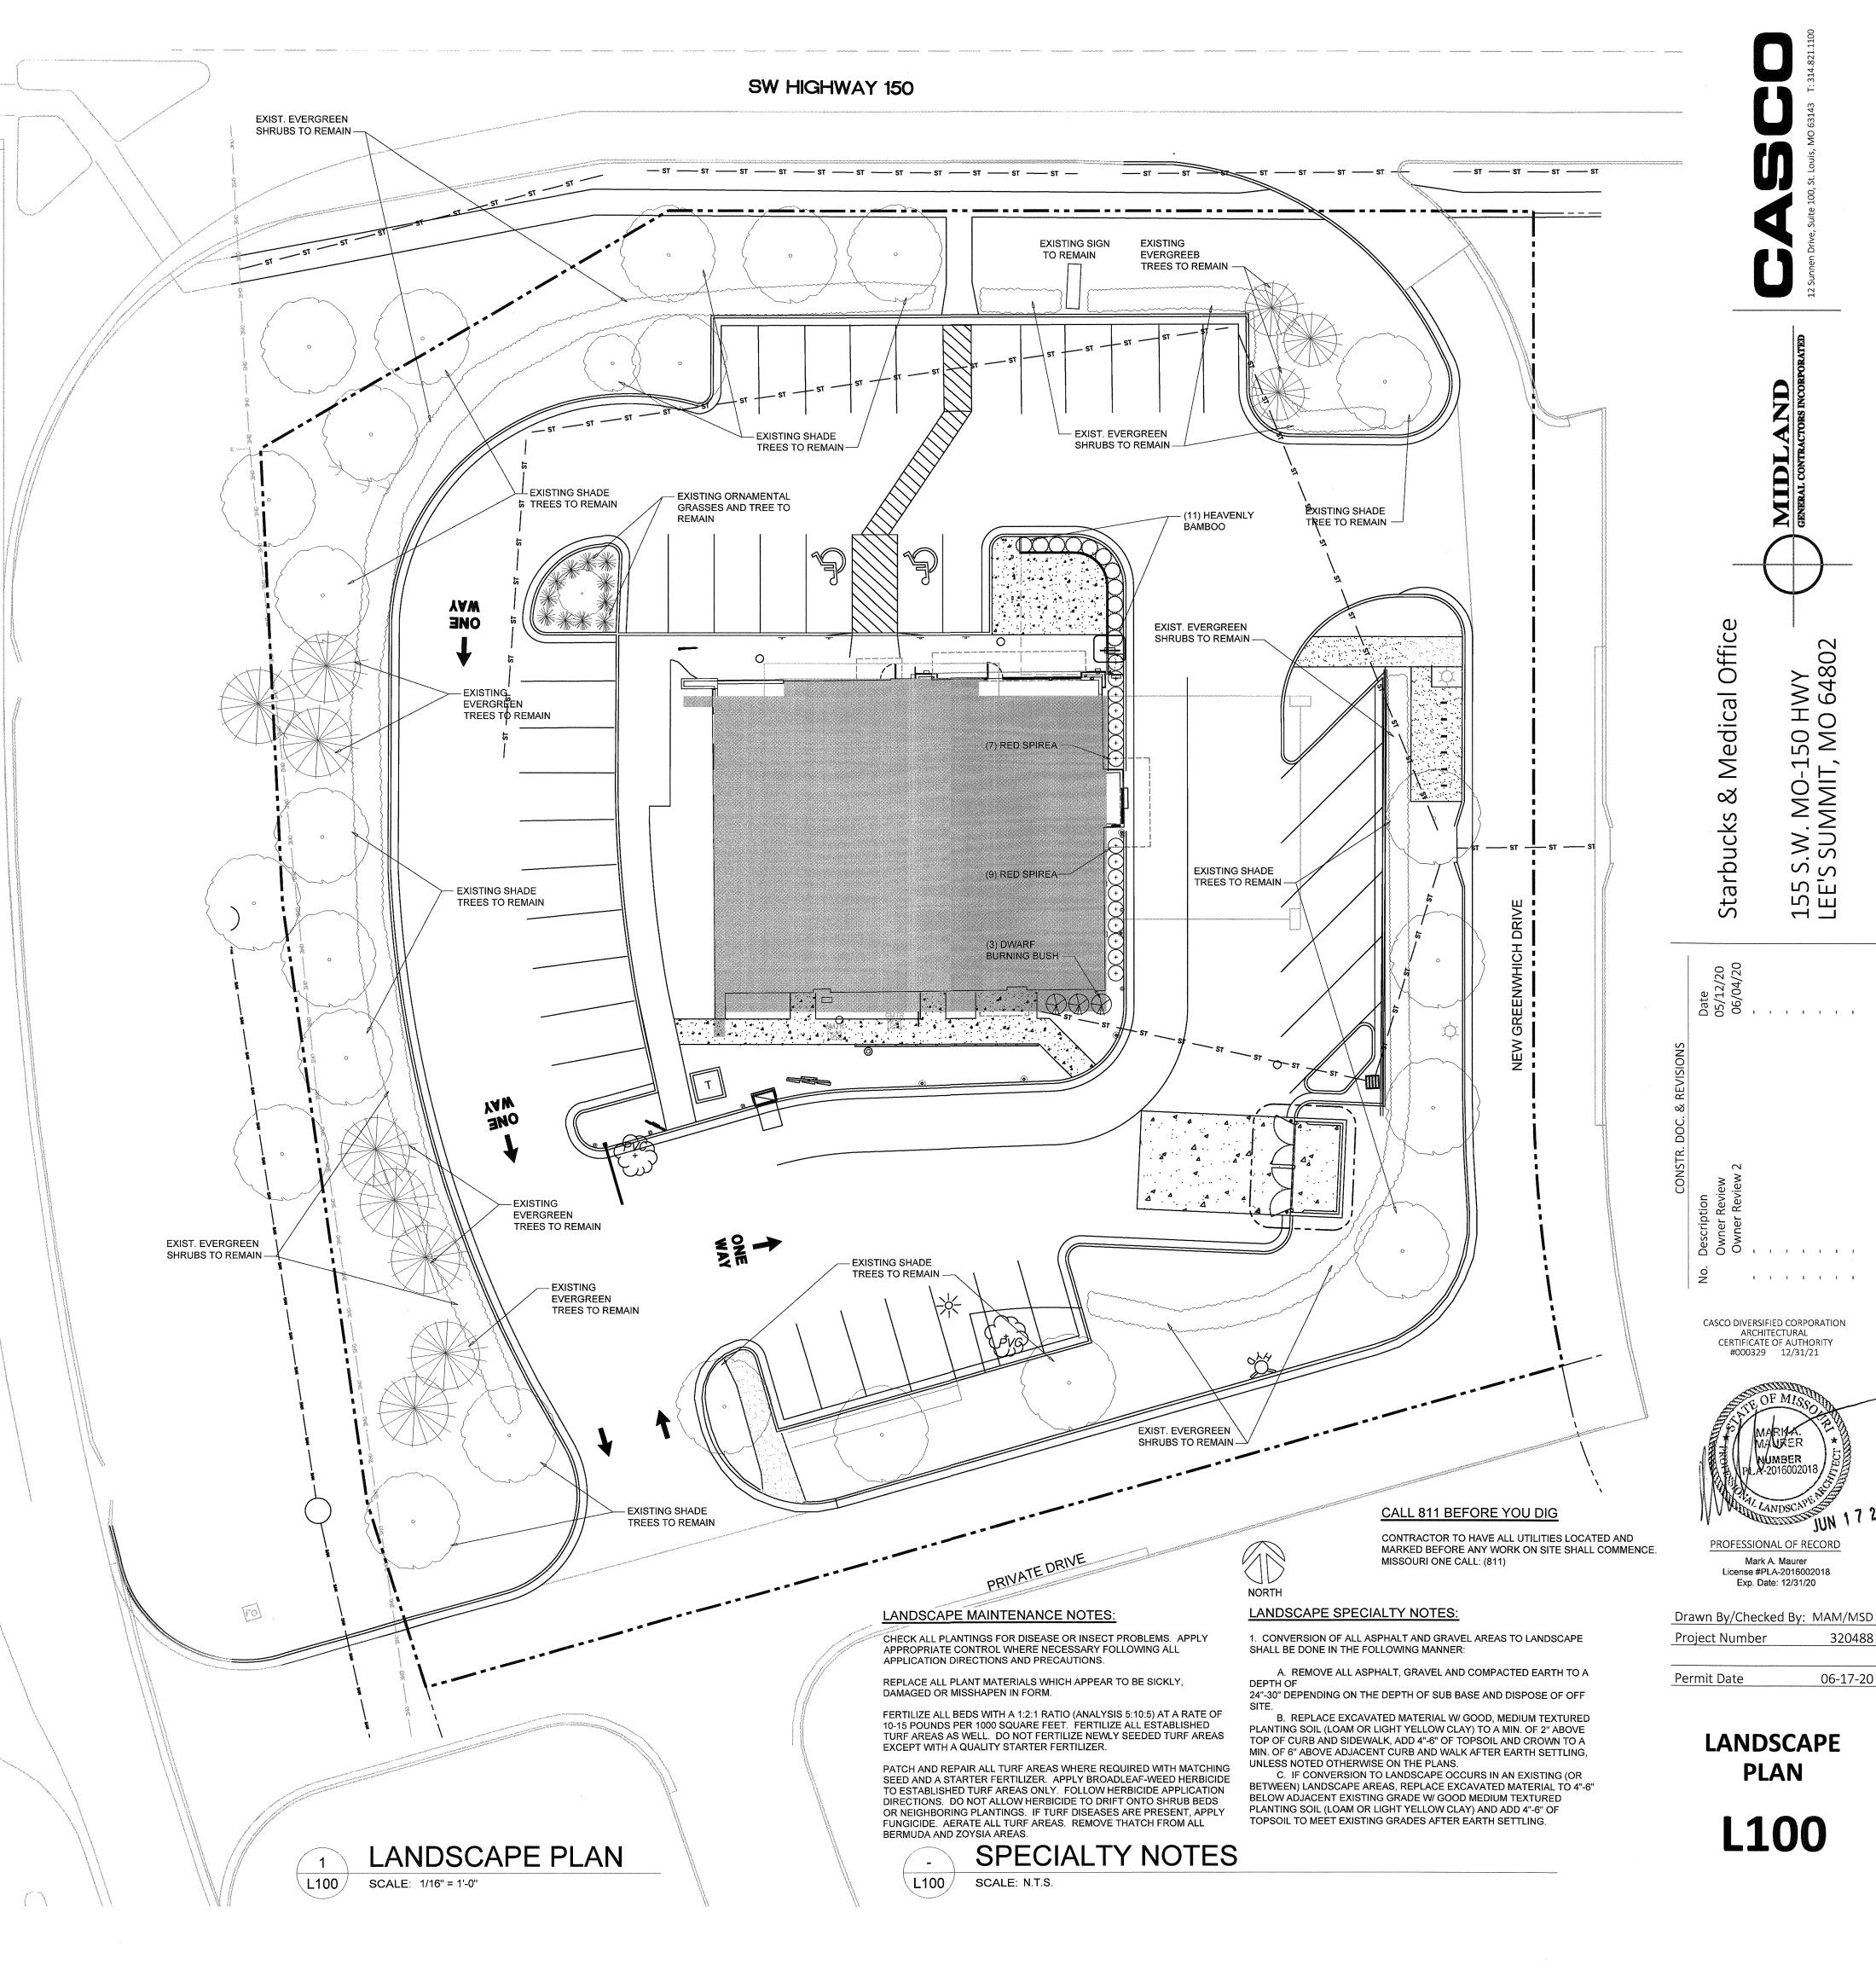

C I

06-17-20

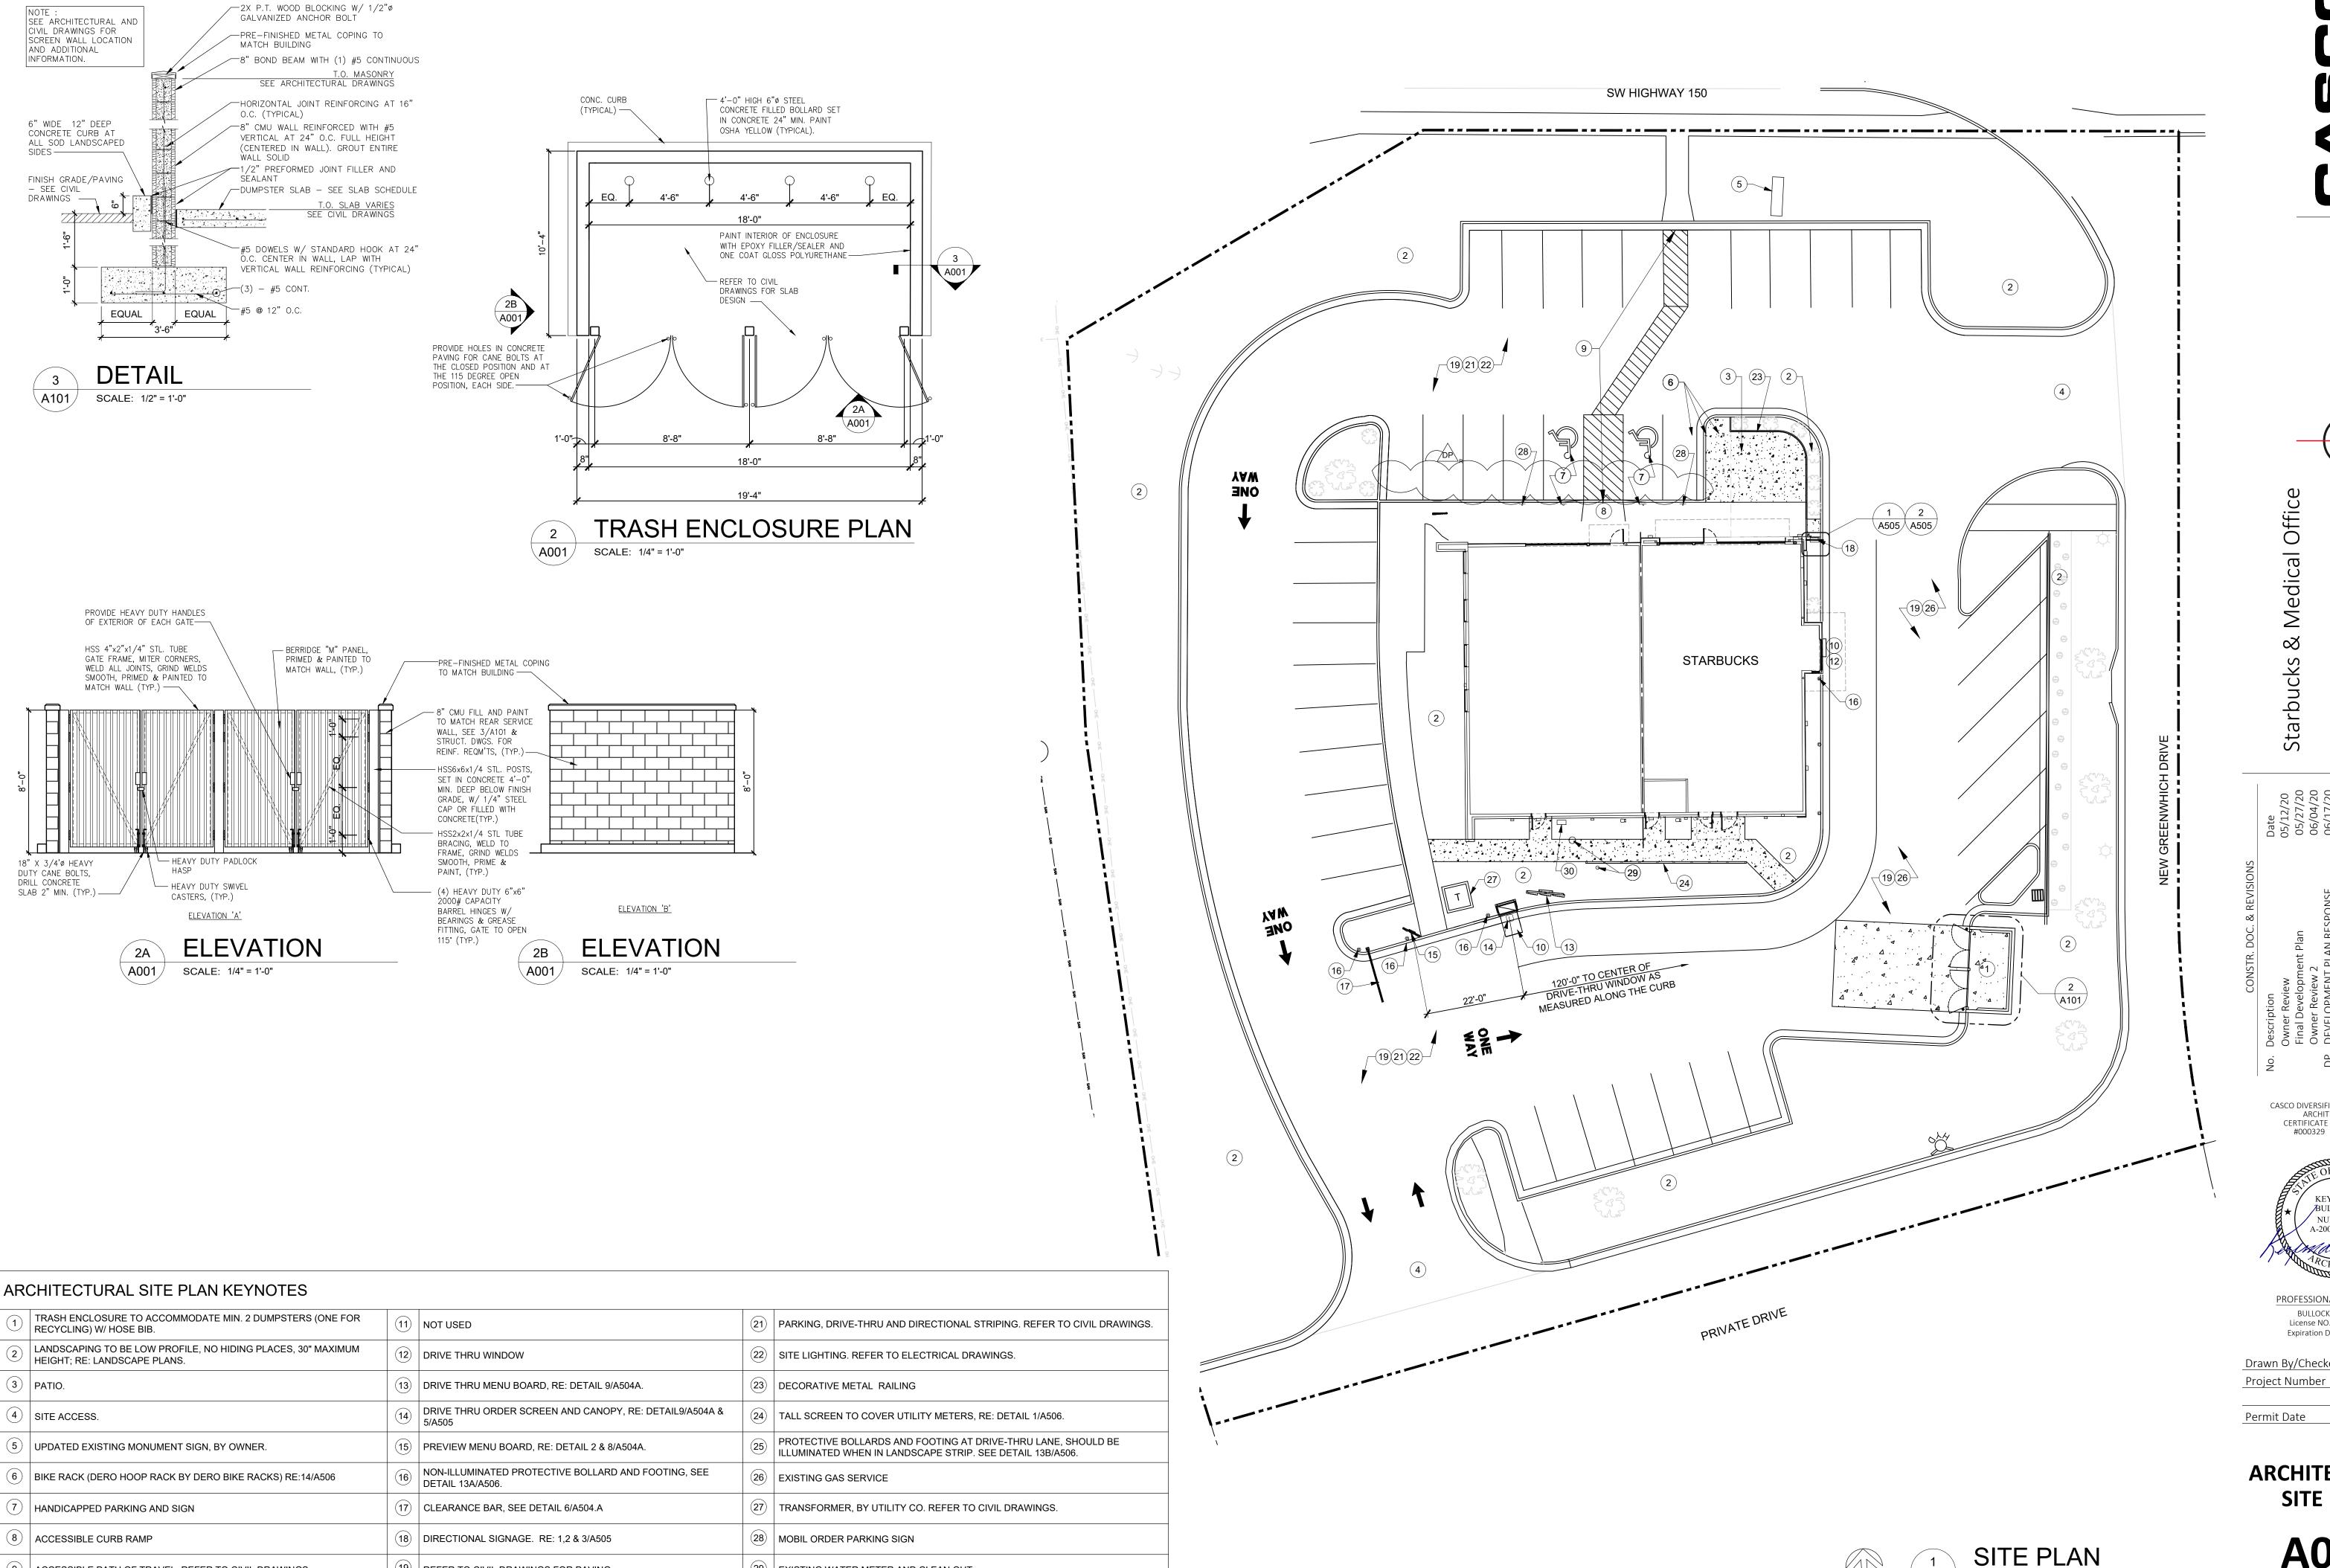

(9) ACCESSIBLE PATH OF TRAVEL. REFER TO CIVIL DRAWINGS

WIRELESS COMMUNICATION, AND MONITORS.

DRIVE-THRU EQUIPMENT INCLUDING VEHICLE DETECTION LOOP,

(19) REFER TO CIVIL DRAWINGS FOR PAVING.

20 NOT USED

(29) EXISTING WATER METER AND CLEAN OUT

(30) | EXISTING IRRIGATION VAULT

155 S.W. MO-150 HWY LEE'S SUMMIT, MO 6480

CASCO DIVERSIFIED CORPORATION ARCHITECTURAL CERTIFICATE OF AUTHORITY #000329 12/31/21



PROFESSIONAL OF RECORD BULLOCK, KEYMA L. License NO. 2004011669 Expiration Date 12/31/20


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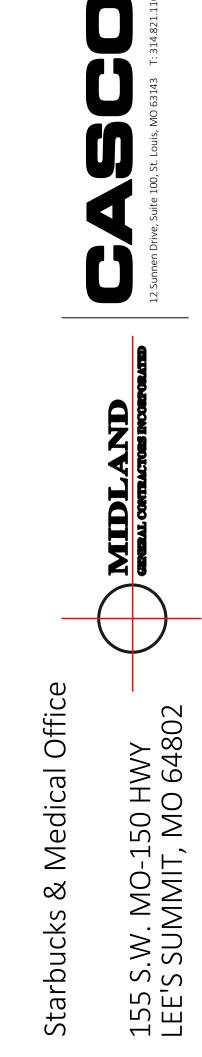
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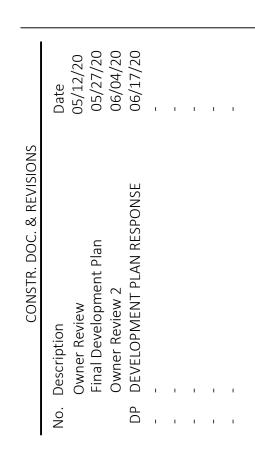
NORTH

**ARCHITECTURAL SITE PLAN** 

06-17-20





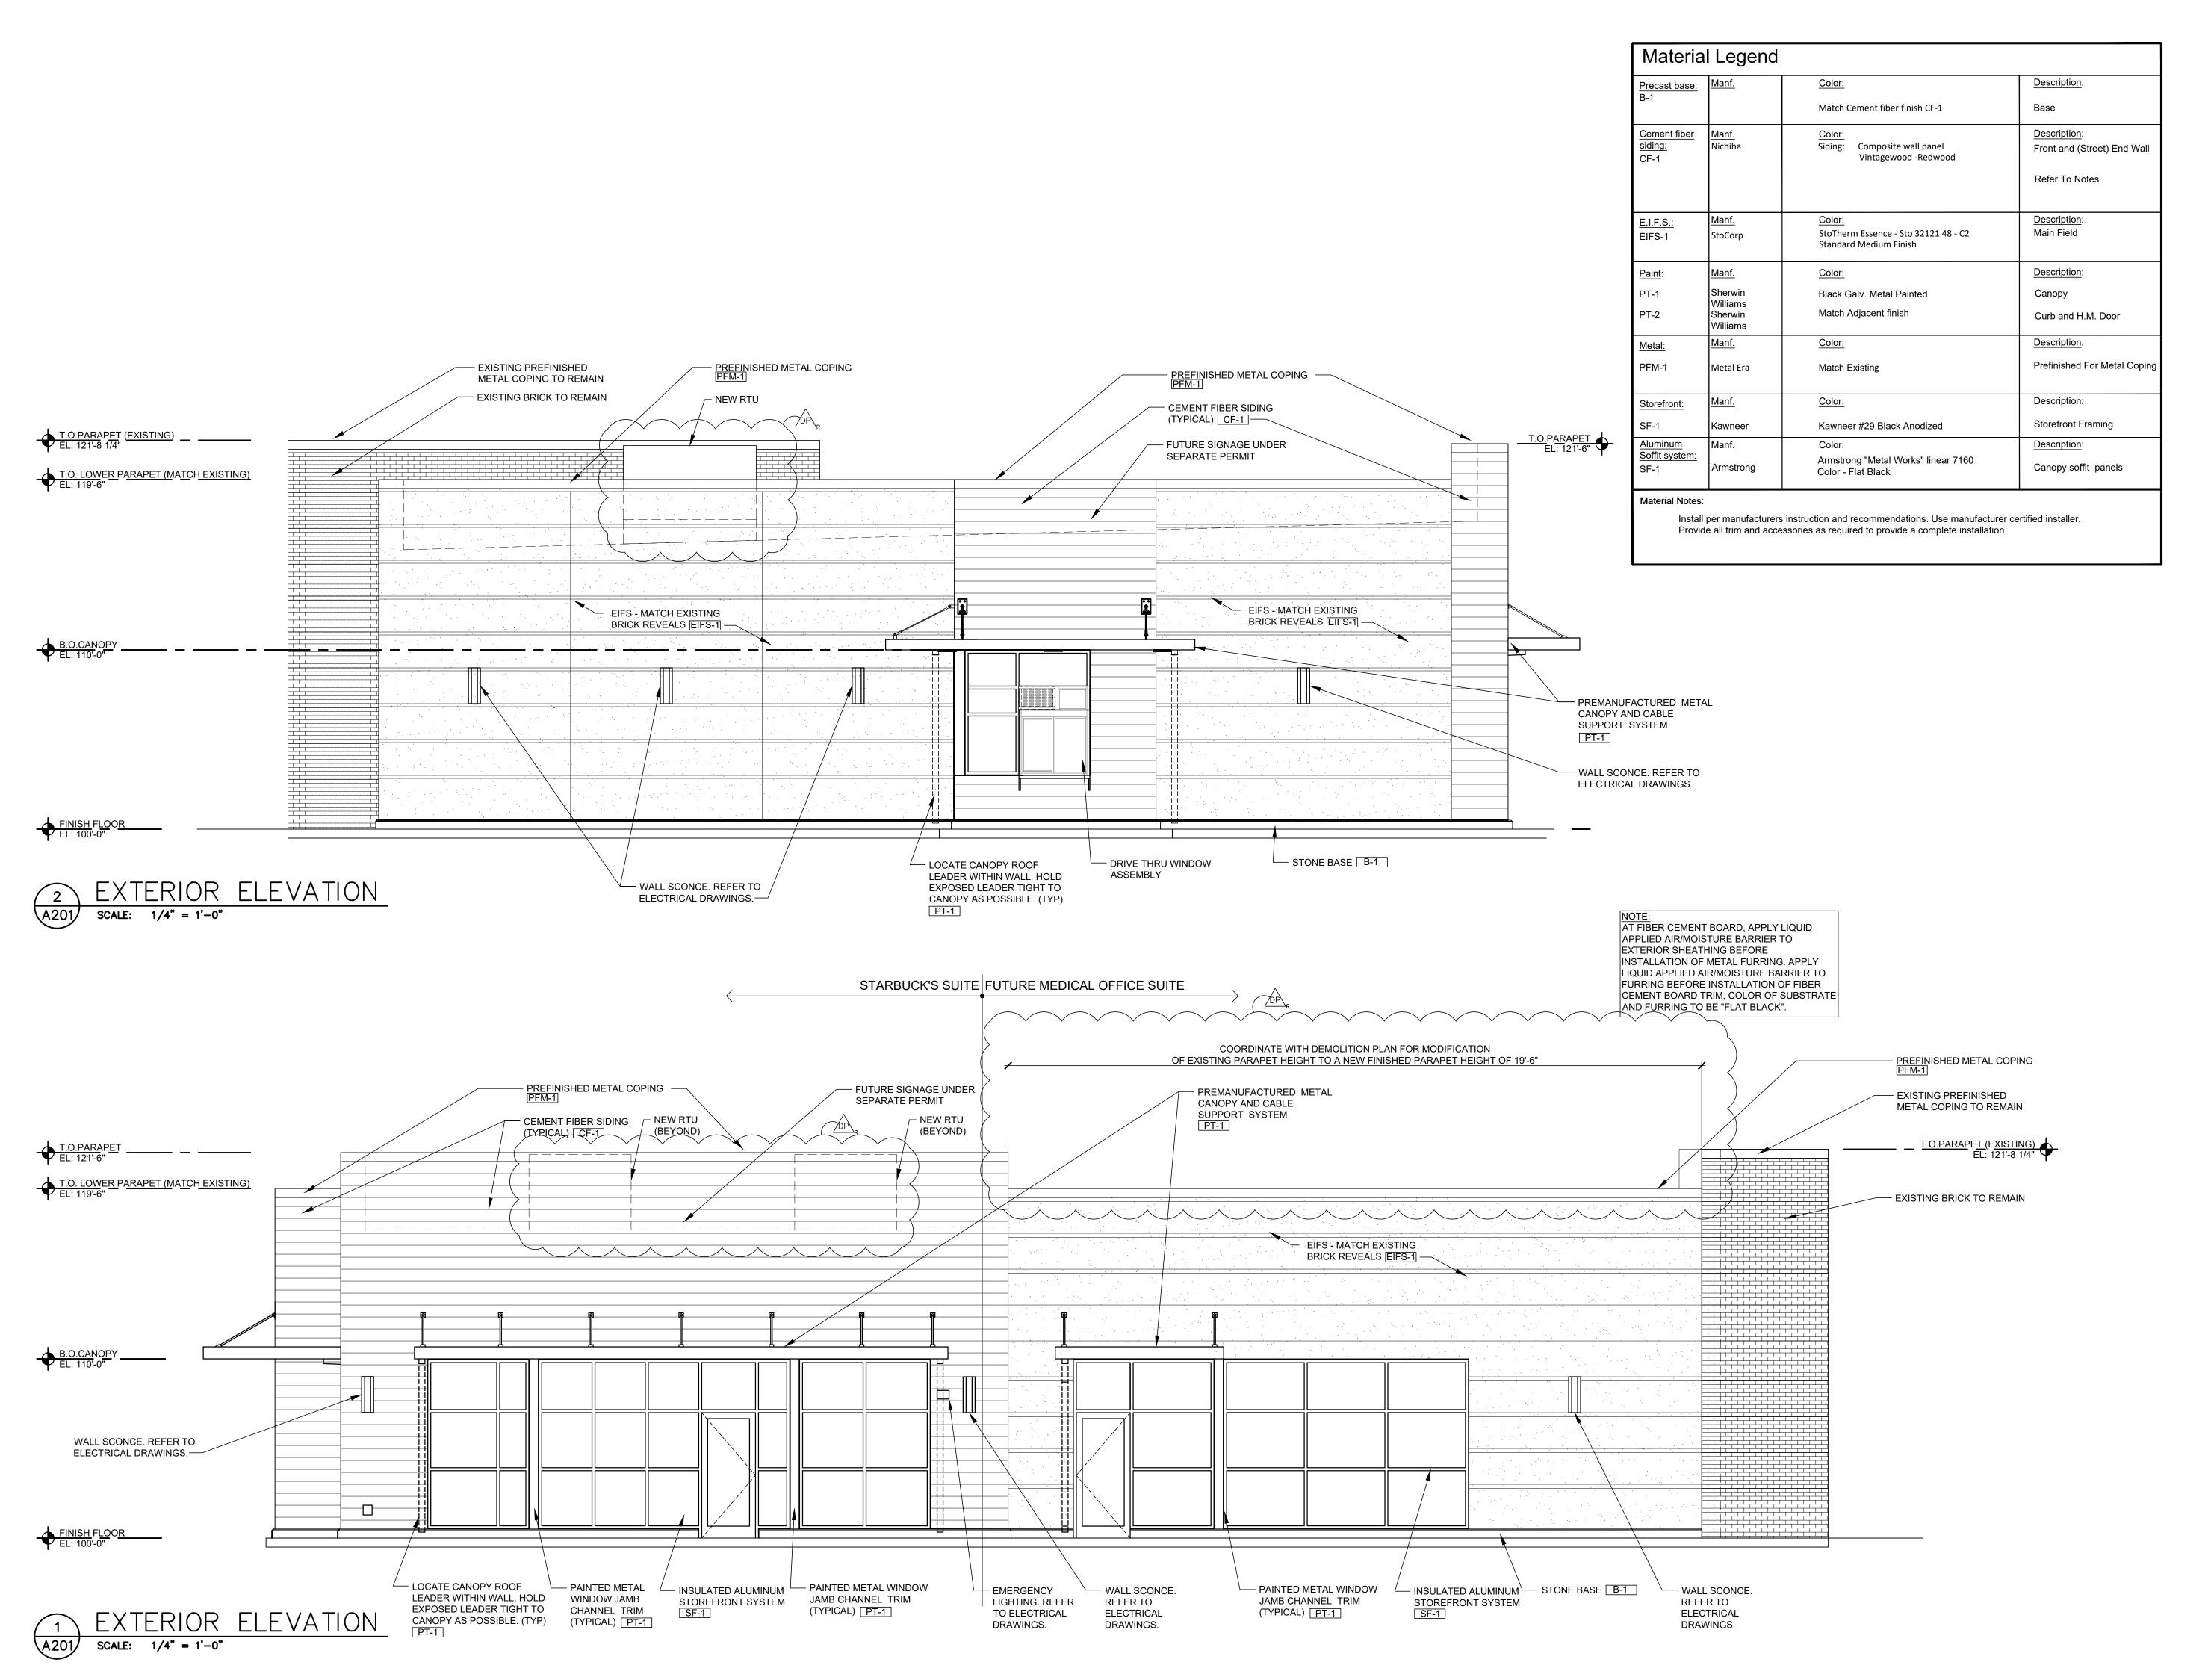

CASCO DIVERSIFIED CORPORATION ARCHITECTURAL CERTIFICATE OF AUTHORITY #000329 12/31/21



PROFESSIONAL OF RECORD

BULLOCK, KEYMA L.
License NO. 2004011669
Expiration Date 12/31/20


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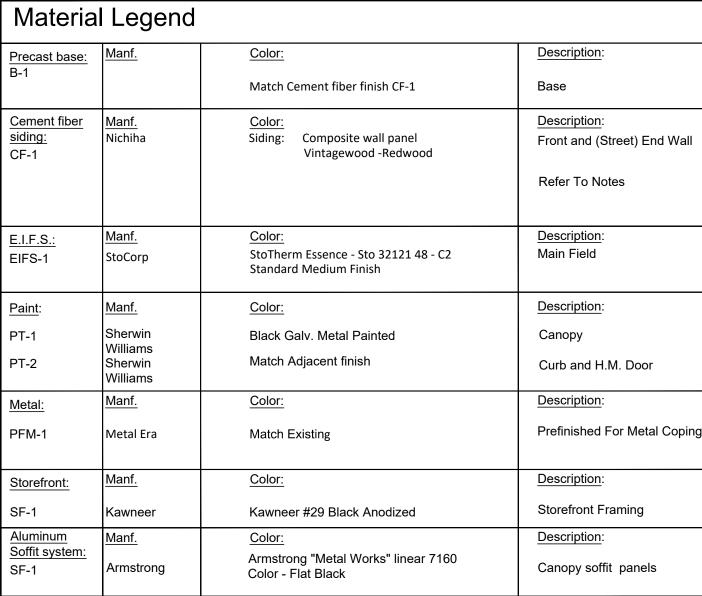
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**EXTERIOR ELEVATIONS** 


06-17-20

A201



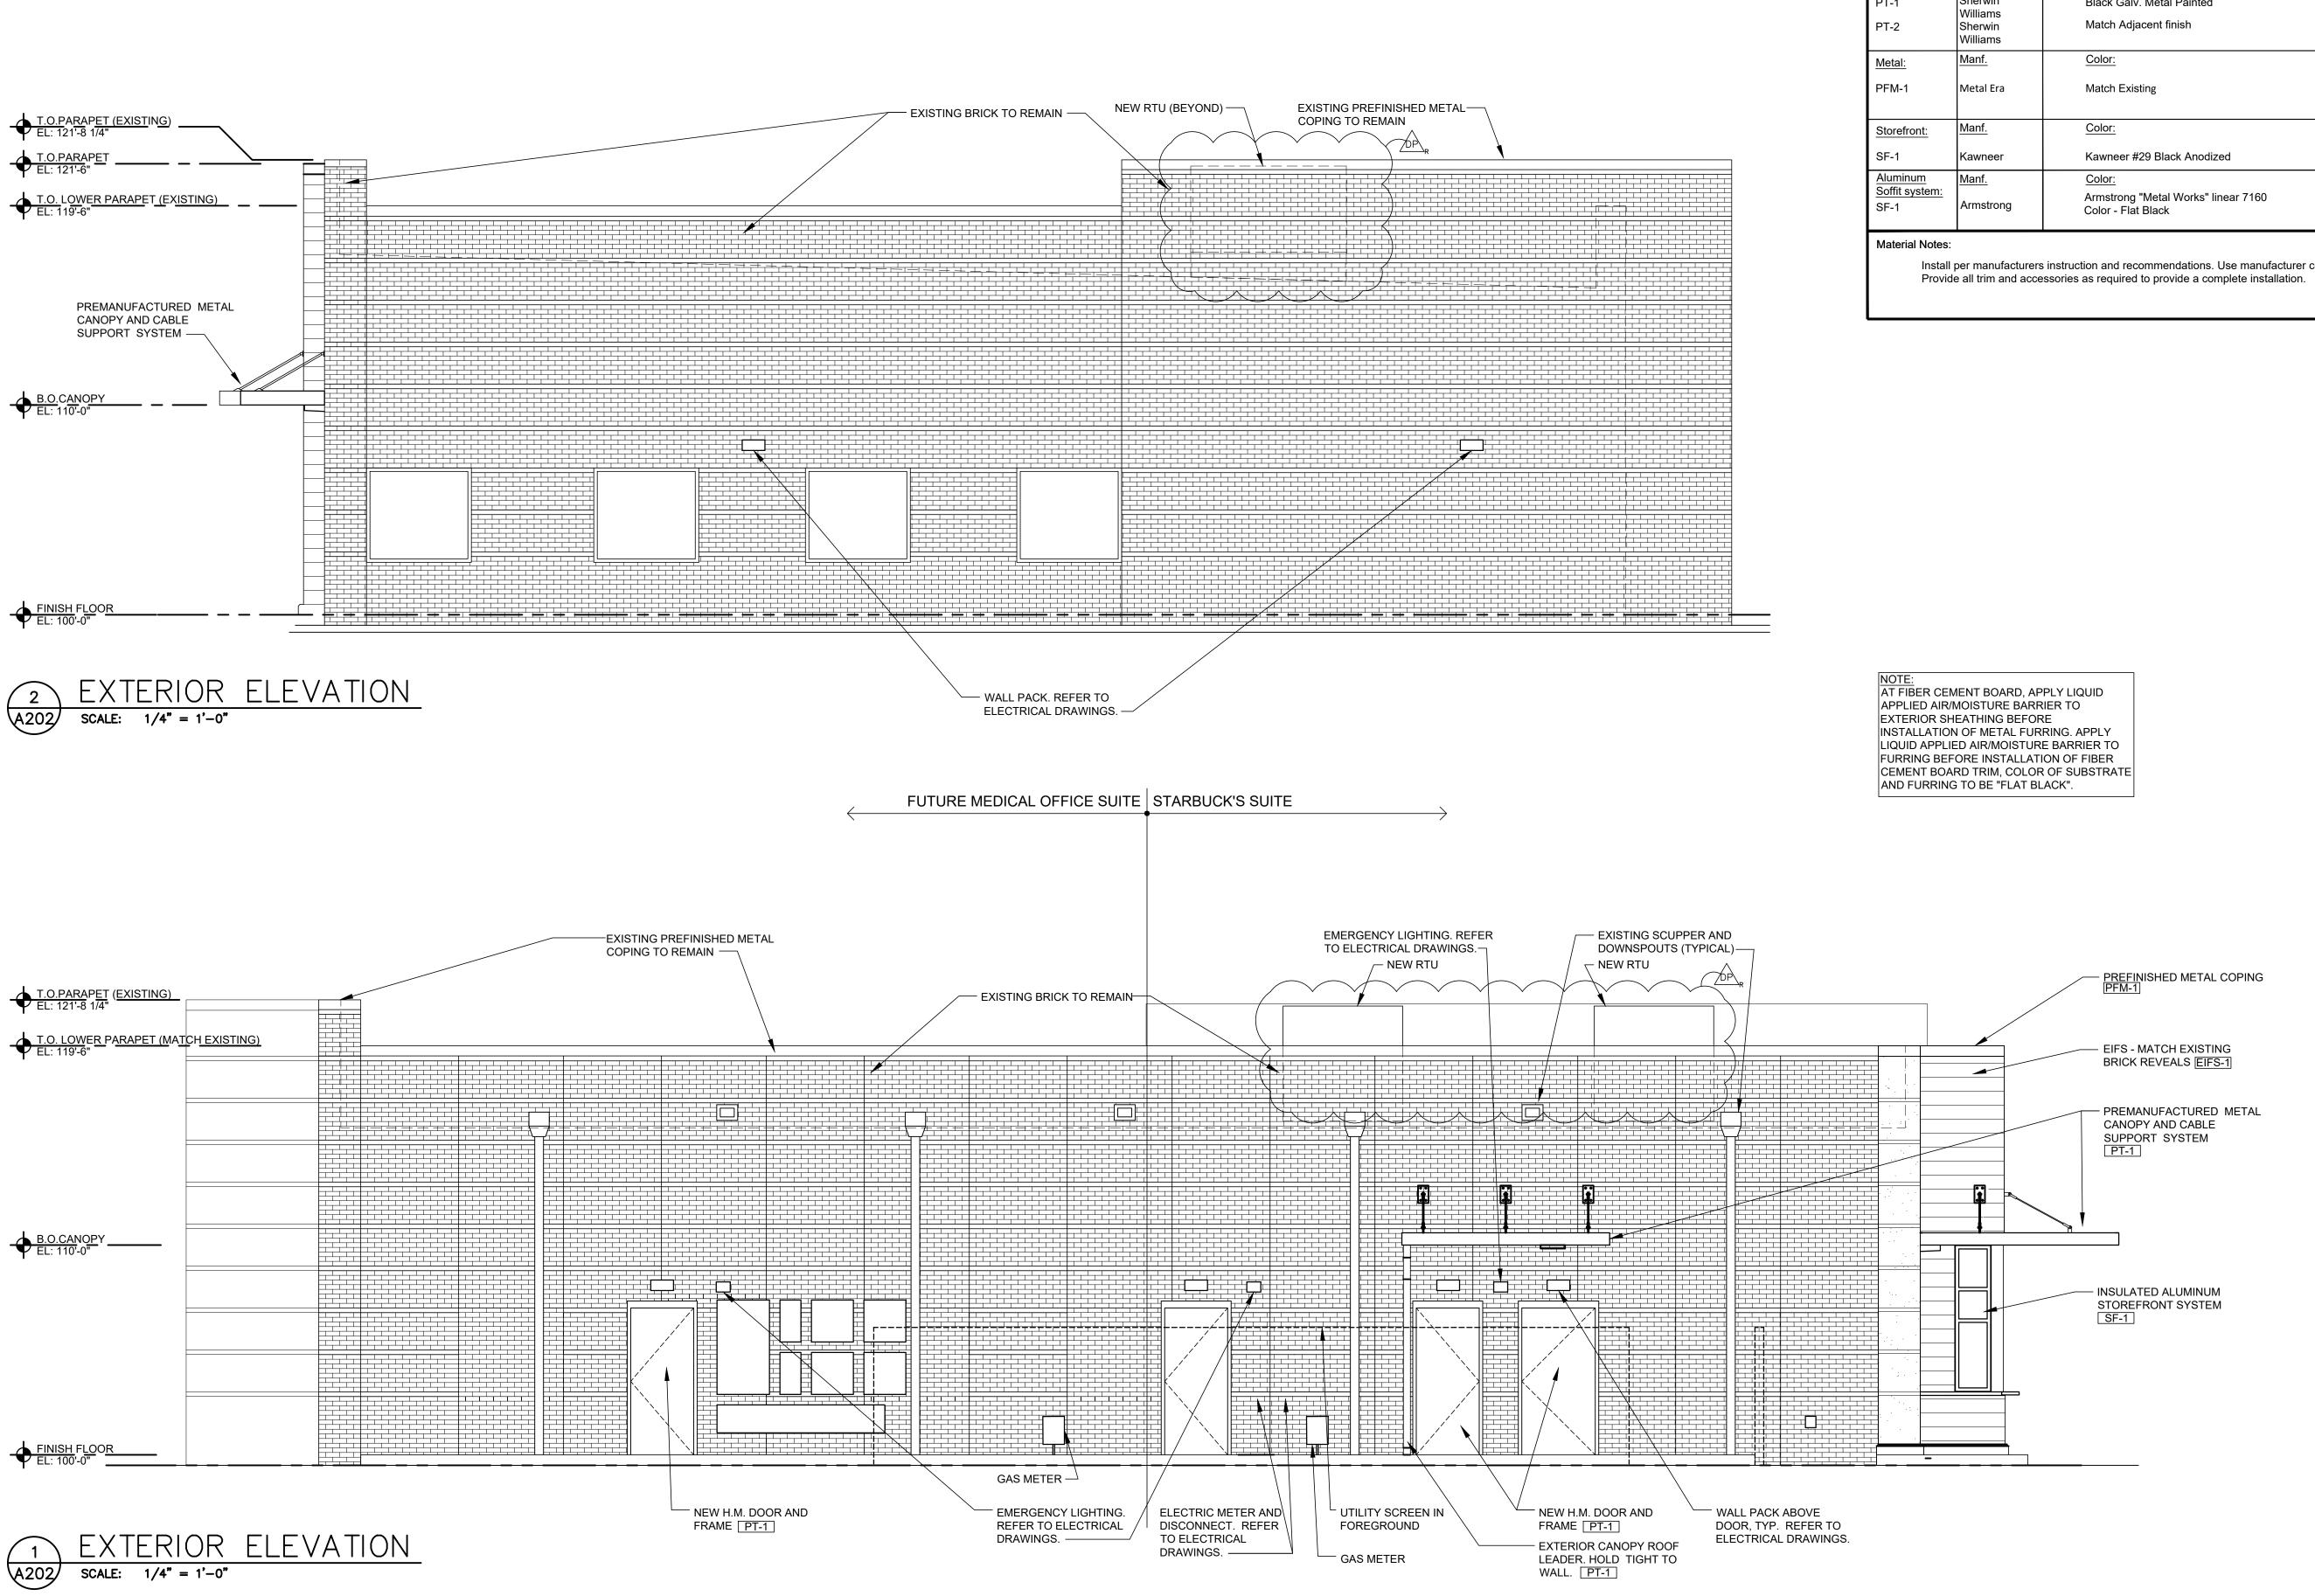


Install per manufacturers instruction and recommendations. Use manufacturer certified installer.

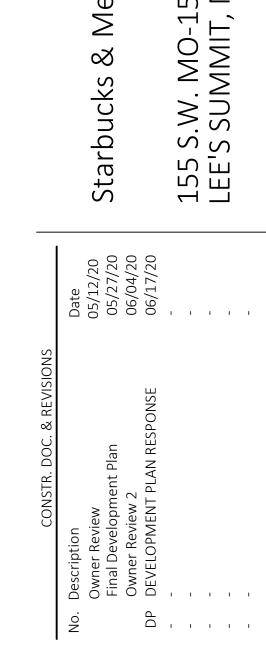

Medical Office

CASCO DIVERSIFIED CORPORATION ARCHITECTURAL CERTIFICATE OF AUTHORITY #000329 12/31/21

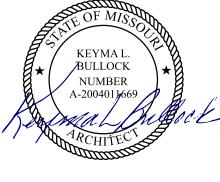

PROFESSIONAL OF RECORD BULLOCK, KEYMA L. License NO. 2004011669 Expiration Date 12/31/20


Drawn By/Checked By: RMT/MSD 320488 Project Number

06-17-20

Permit Date


**EXTERIOR ELEVATIONS** 

**A202** 

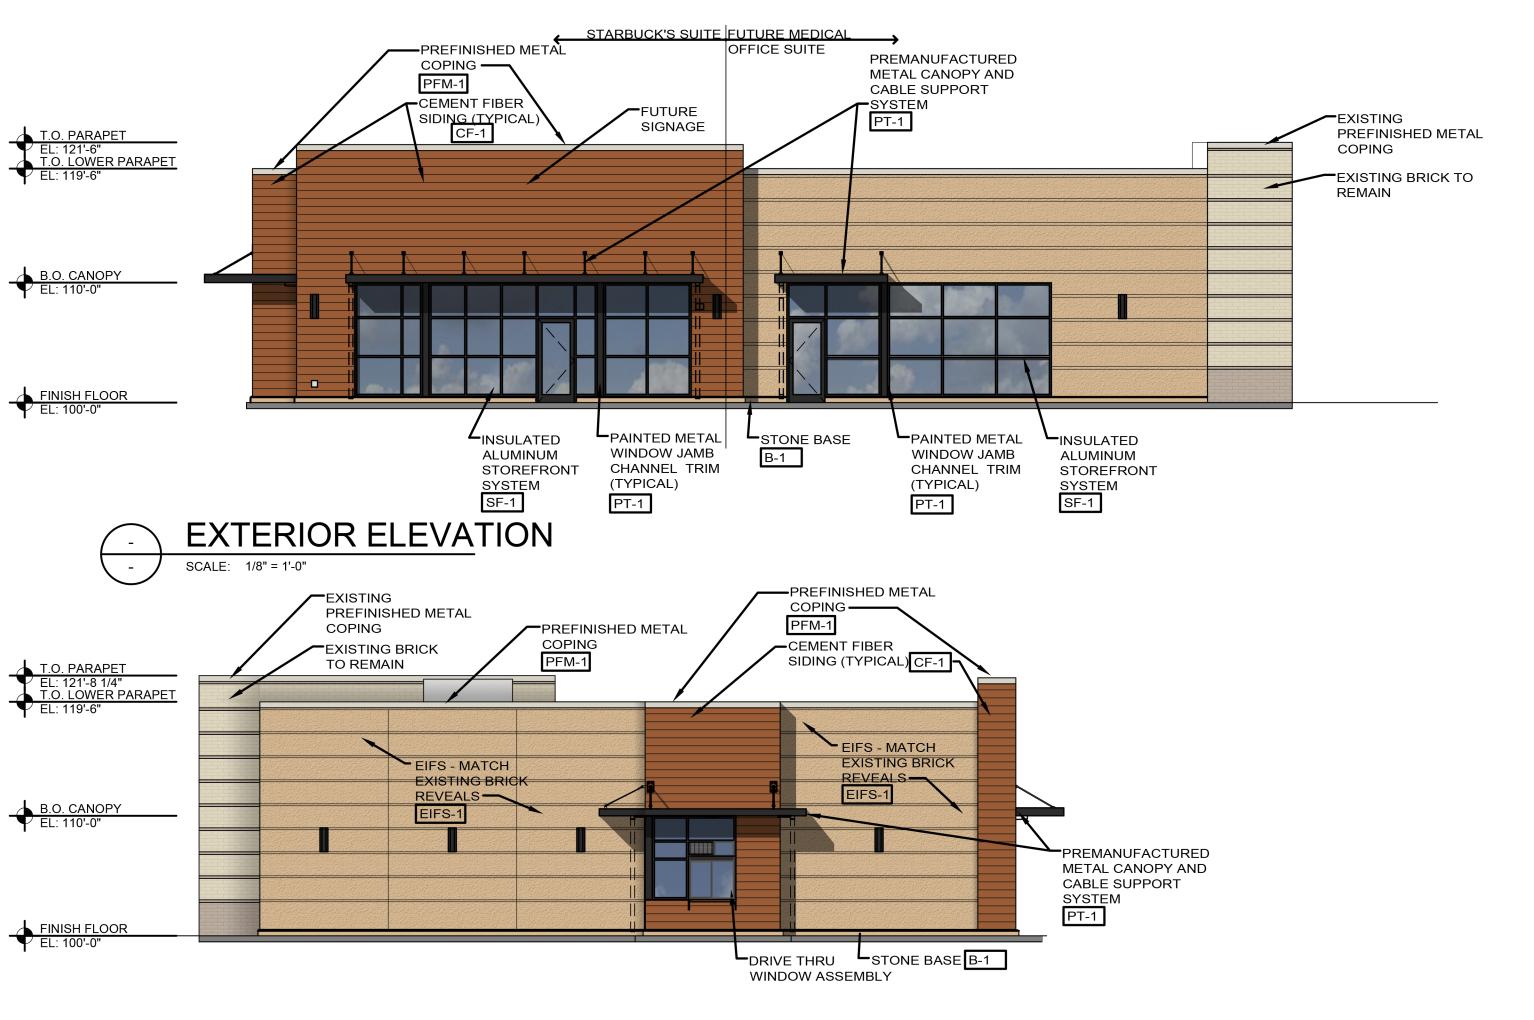


Precast base:	Manf.	Color:	Description:	
B-1		Match Cement fiber finish CF-1	Base	
Cement fiber siding: CF-1	Manf. Allura	Color: Siding: Allura 8" trim- 4/4 textured fiber cement board trim (8"x12') (Wood grain exposed) Stain: Two coats of exterior stain over exterior faux glazing. (see notes below)	Description: Front and (Street) End Wall Refer To Notes	
E.I.F.S.:	Manf.	Color:	Description:	
EIFS-1	StoCorp	StoTherm Essence - Sto 32121 48 - C2 Standard Medium Finish	Main Field	
<u>Paint</u> :	Manf.	Color:	Description:	
PT-1	Sherwin	Black Galv. Metal Painted	Canopy	
PT-2	Williams Sherwin Williams	Match Adjacent finish	Curb and H.M. Door	
Metal:	Manf.	Color:	Description:	
PFM-1	Metal Era	Match Existing	Prefinished For Metal Coping	
Storefront:	Manf.	Color:	Description:	
SF-1	Kawneer	Kawneer #29 Black Anodized	Storefront Framing	
Aluminum	Manf.	Color:	Description:	
Soffit system: SF-1 Armstrong		Armstrong "Metal Works" linear 7160 Color - Flat Black	Canopy soffit panels	
Provid -	per manufacturers in the all trim and accessions. Fill screw holes in fibe cement. Wipe off exceptions is siding:  Apply exterior faux globers.	nstruction and recommendations. Use manufacturer of sories as required to provide a complete installation. For cement board trim with wood putty. Wood putty to be cless putty with a damp rag before it hardens.  azing over the entire surface.  Serior Behr stain "Behr Chocolate" with a brush.		



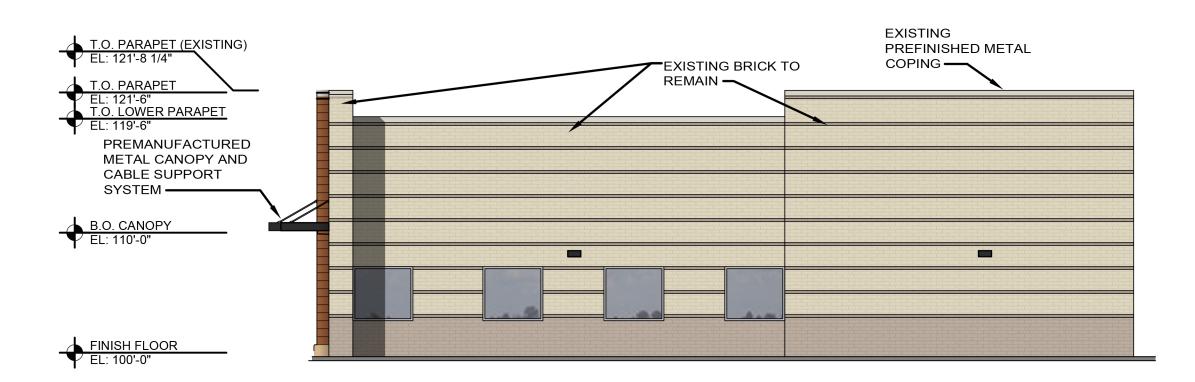



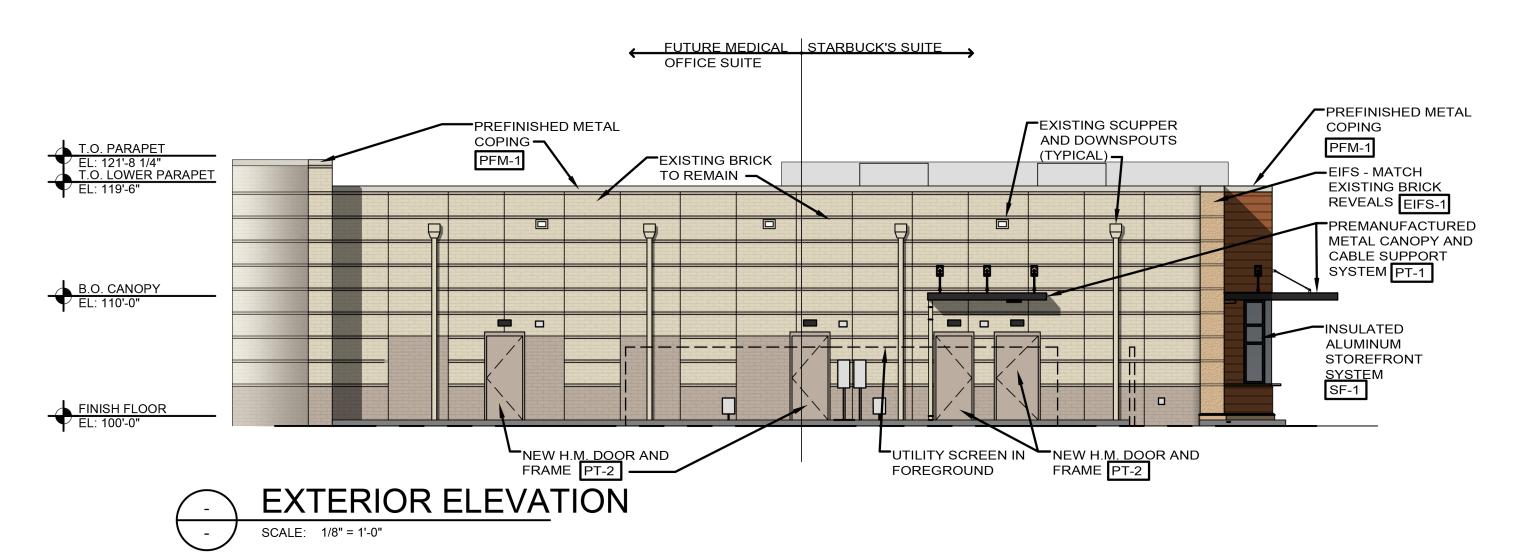

At hrrizontal siding:

Paint per manufacturers recomendations.

Project Number 320488


Starbucks & Medical Office


155 S.W. M-150 HWY LEE'S SUMMIT, MO 64802


CONSTR. DOC. & REVISIONS

No. Description

Date

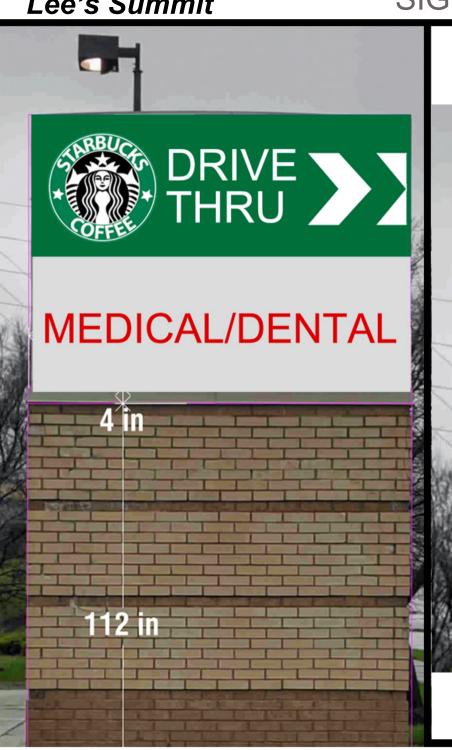

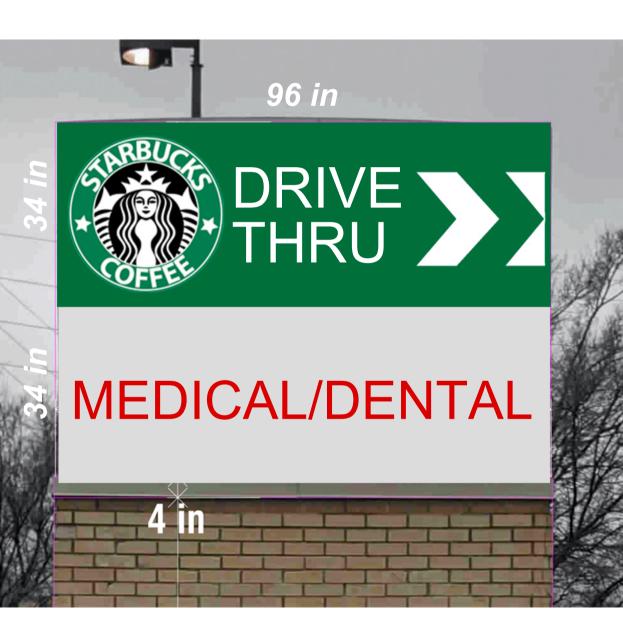

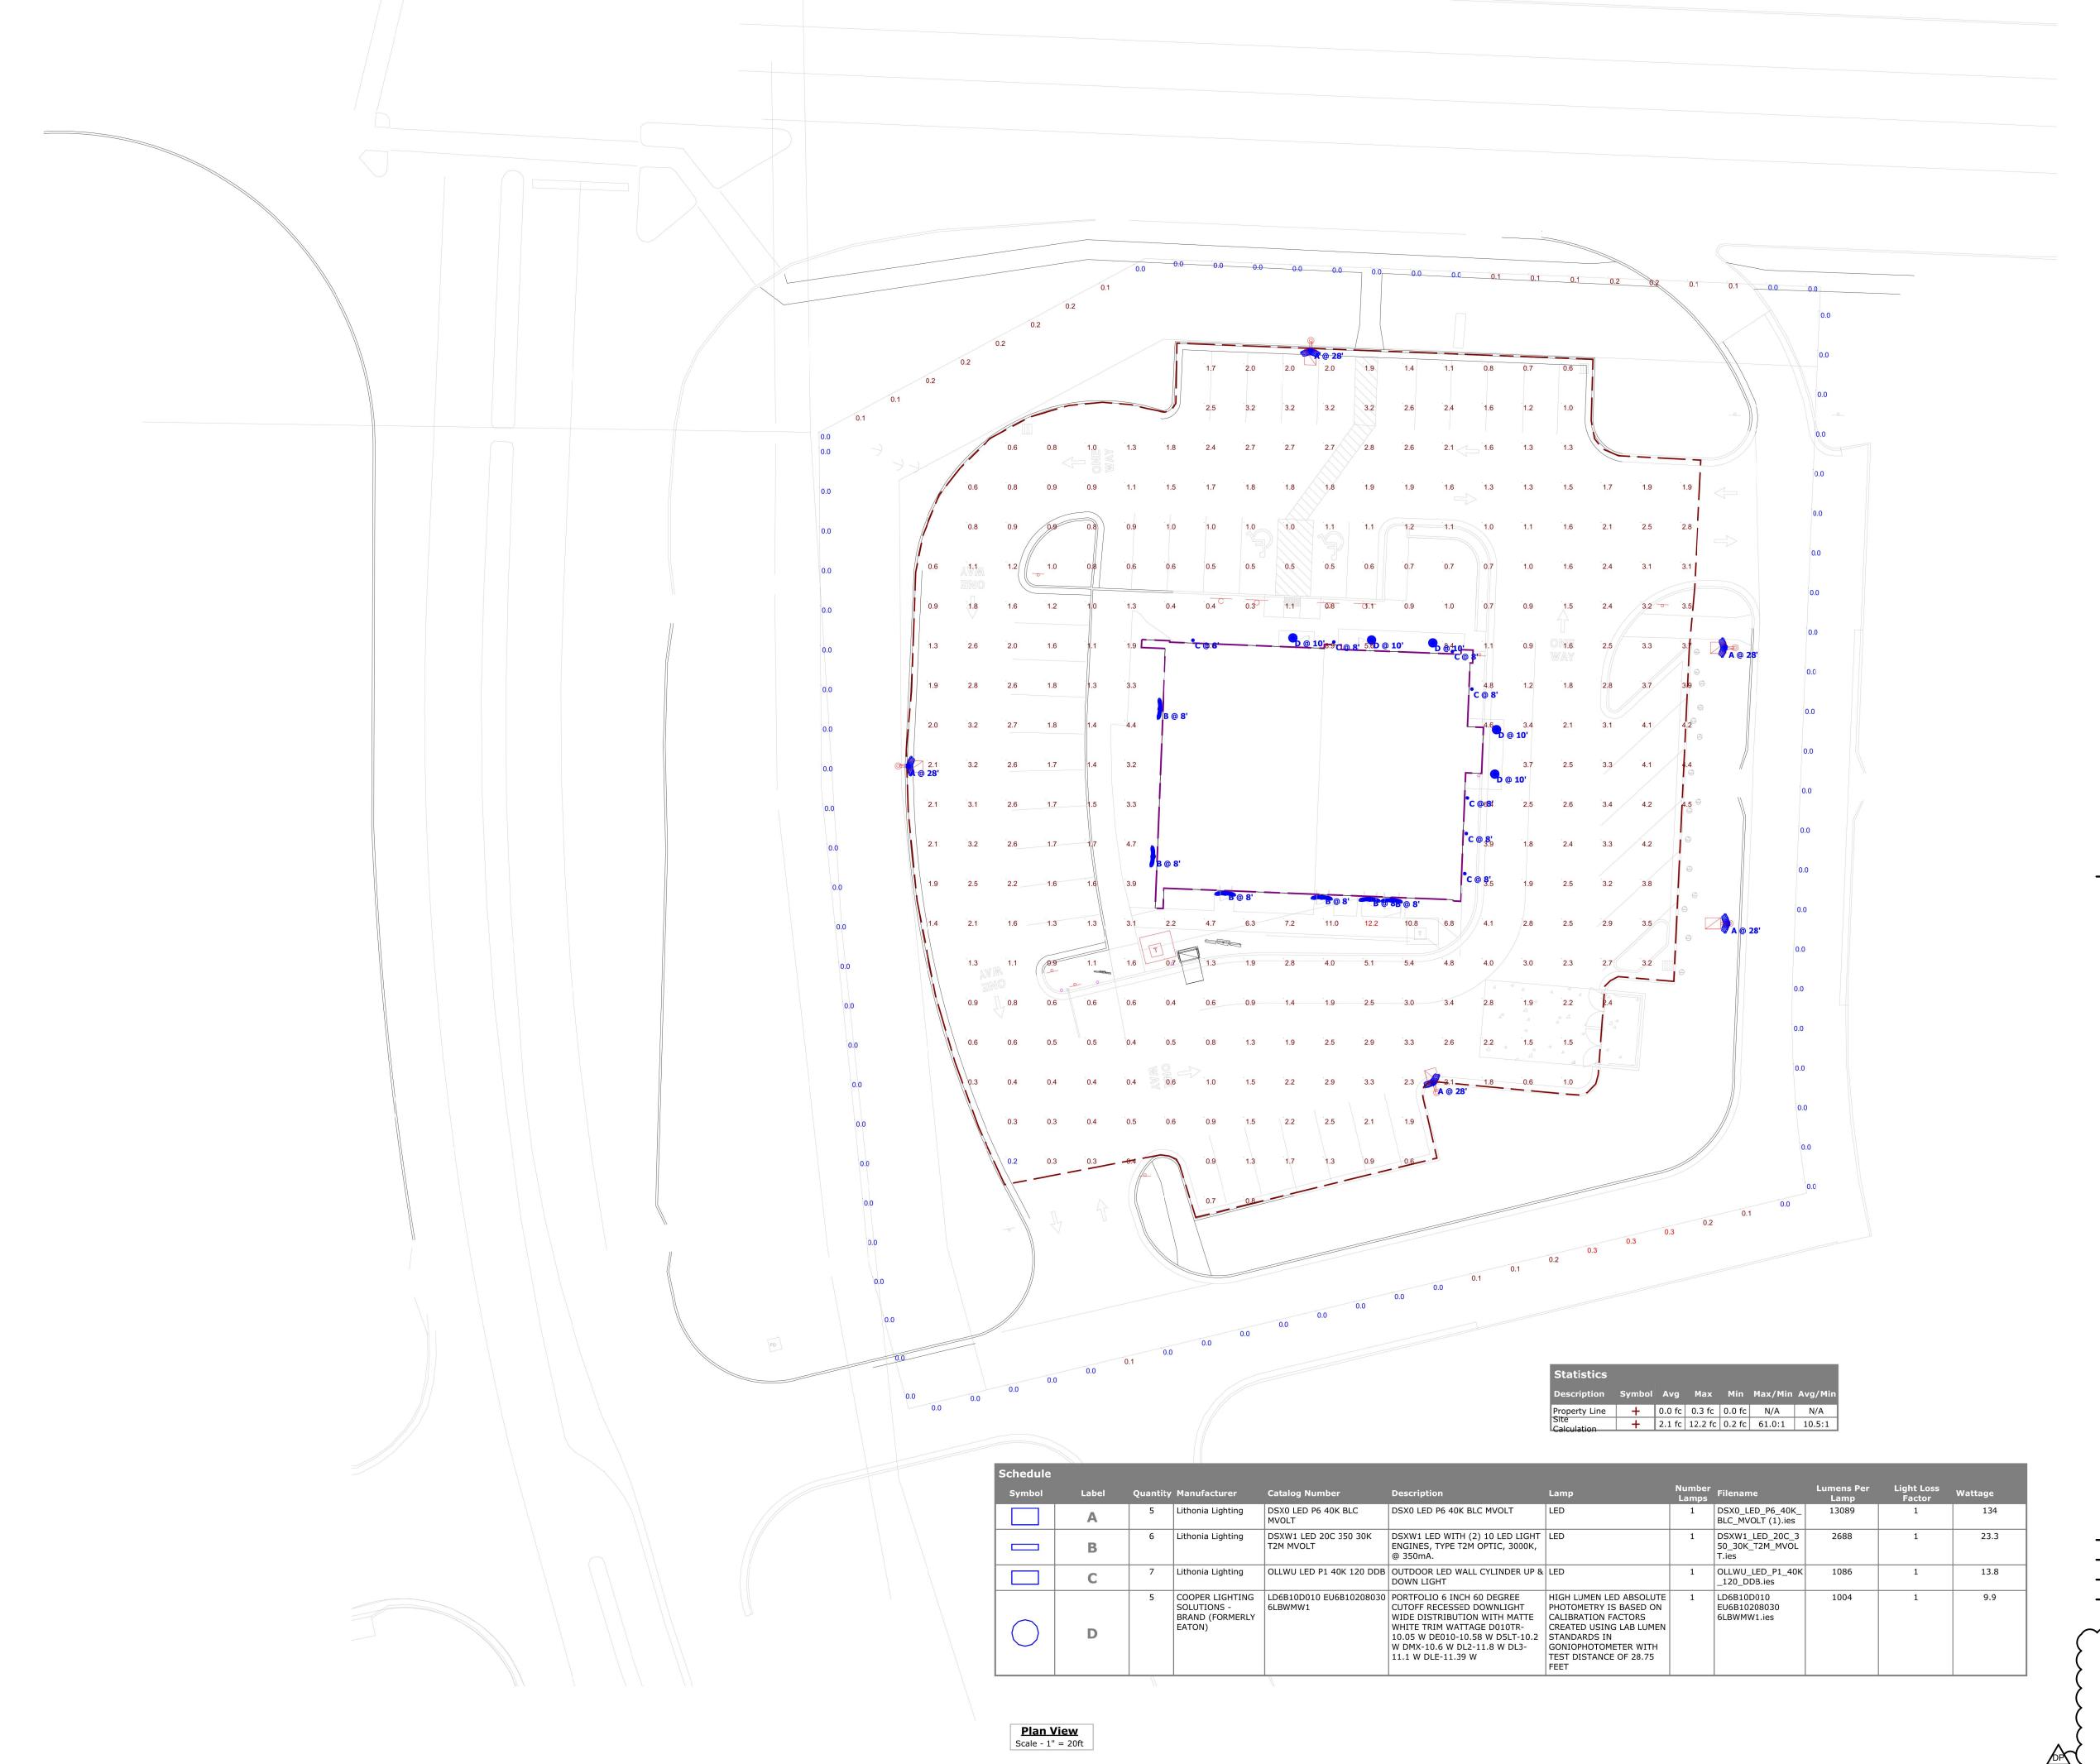

CASCO DIVERSIFIED AUTHORITY #000613

Date 05/12/20 06/04/20 06/17/20 --

CORPERATION PROFESSIONAL ENGINEERING CERTIFICATE OF EXP. 12/31/21

> HARRY J. AUMAN LIC. #E16827

EXP. 12/31/20

Drawn By/Checked By: EAV/DAW Project Number

06-17-20 Permit Date 

SITE **PHOTOMETRICS**