CONSTRUCTION NOTES

I. ALL CONTOURS SHOWN ON THESE PLANS ARE BASED ON U.S.G.S. DATA.

ALL GRADING SHALL BE IN ACCORDANCE WITH THE REQUIREMENTS OF THE CITY OF LEE'S SUMMIT IT SHALL BE THE RESPONSIBILITY OF THE CONTRACTOR TO RESTORE THE GRADE TO THE DESIGN ELEVATIONS.

NO SLOPES SHALL BE GRADED STEEPER THAN 3:1 (HORIZONTAL: VERTICAL), AND SHALL BE SEEDED AND MULCHED.

5. ONLY THE DESIGNATED CONSTRUCTION ACCESS ROUTE MAY BE USED TO MOVE EQUIPMENT IN AND OUT. NO OTHER ACCESS POINT

6. ALL SILTATION MEASURES MUST BE IN PLACE BEFORE ANY OPERATIONS THAT DISTURB THE NATURAL GRADE COMMENCES. THIS INCLUDES GRUBBING OR STUMP REMOVAL. THE CITY OF LEE'S SUMMIT SHALL BE NOTIFIED UPON COMPLETION OF ALL SILTATION AND EROSION FACILITIES AND SHALL INSPECT AND APPROVE SUCH FACILITIES PRIOR TO THE COMMENCEMENT OF ANY CLEARING OR

GRADING ACTIVITIES. 7. SILTATION AND CONTROL FACILITIES MUST BE MAINTAINED THROUGHOUT THE ENTIRE CONSTRUCTION PERIOD. THIS INCLUDES REMOVAL OF MUD FROM SILTATION BASINS AND REPLACEMENT OF THE CITY OF LEE'S SUMMIT APPROVED EROSION CONTROL DEVICES. MUD SHALL NOT BE PERMITTED TO MIGRATE OFF THE SITE. DAMAGE OR FAILURE OF SILTATION AND EROSION CONTROL FACILITIES SHALL BE REPAIRED. DAMAGE OR FAILURE OF SILTATION AND EROSION CONTROL FACILITIES SHALL BE REPAIRED IMMEDIATELY BUT NOT LONGER

THAN 24 HOURS AFTER NOTIFICATION. IF PROPOSED MEASURES FAIL TO ADEQUATELY PROTECT THE ADJOINING PROPERTY ADDITIONAL FACILITIES SHALL BE INSTALLED AS DIRECTED. 8. THE ENGINEER SHALL NOT BE RESPONSIBLE FOR THE MEANS, METHODS, TECHNIQUES, SEQUENCES OR PROCEDURES OF CONSTRUCTION SELECTED BY THE CONTRACTOR TO PROTECT OFF-SITE PROPERTY FROM EROSION OR SILTATION. THE ENGINEER SHALL NOT BE

LIABLE FOR DAMAGE CAUSED BY EROSION OR SILTATION DUE TO DEFECTIVE SILTATION CONTROL DEVICES. MUD WILL NOT BE PERMITTED TO BE CARRIED OFF SITE ONTO PUBLIC STREETS. A TEMPORARY WASH FACILITY SHALL BE PROVIDED TO REMOVE MUD FROM VEHICLE TIRES BEFORE ENTERING THE PUBLIC STREETS.

10. MEASURES SHALL BE TAKEN TO CONTROL DUST AS NECESSARY. 11. IT SHALL BE THE GRADING CONTRACTOR'S RESPONSIBILITY TO NOTIFY THE SOILS ENGINEER OF WORK IN PROGRESS AND TO COMPLY

WITH SPECIFICATIONS SET BY THE SOILS ENGINEER WITH REGARD TO COMPACTION, SURFACE PREPARATION AND PLACEMENT OF FILL. 12. ALL STUMPS, LIMBS, AND OTHER DEBRIS ARE TO BE REMOVED FROM THE SITE. 13. ALL DRAINAGE SWALES SHALL BE SODDED.

14. ALL FILL AREAS, INCLUDING TRENCH BACKFILLS, UNDER BUILDINGS, PROPOSED STORM AND SANITARY SEWER LINES. PUBLIC RIGHT OF WAY AND PAVED AREAS SHALL BE COMPACTED TO 90% OF MAXIMUM DENSITY AS DETERMINED BY THE MODIFIED AASHO T-180 COMPACTION TEST", (A.S.T.M. D- 1557) UNLESS OTHERWISE REQUIRED IN THE SOILS REPORT FOR THIS PROJECT.

```
TABLE OF ABBREVIATIONS
            NOTE: NOT ALL ABBREVIATIONS USED
              AREA INLET
              ASPHALT
              ADJUST TO GRADE
              BOTTOM OF CURB ELEVATION
              BACKFLOW PREVENTER
              BENCHMARK
              CURB INLET
              CLEAN OUT
              CONCRETE
              ELEVATION
              ELECTRIC METER
              EASEMENT
              FXISTING
              FINISHED FLOOR ELEVATION
             FLOW LINE ELEVATION
              GRATE TOP INLET
              HANDICAPPED
              ELECTRIC HAND HOLE
              TRAFFIC SIGNAL HAND HOLE
 HHSL
ICVR
MAX
              SIGNAL LIGHT HAND HOLE
              IRRIGATION CONTROL VALVE RECLAIMED
              MAXIMLIM
              MANHOLE
 MSD
              METROPOLITAN ST. LOUIS SEWER DISTRICT
              NORTHEAST
              NORTHWEST
NW
              PLAT BOOK
              PERMANENT
 PGS
              PAGES
              PROPERTY LINE
              POLYVINYL CHLORIDE
 PVMT
             PAVEMENT
 RCP
              REINFORCED CONCRETE PIPE
 REC
ROW
             RIGHT OF WAY
 R/W
              RIGHT OF WAY
             SOUTHEAST
              SQUARE FEET
              SURVEY
              SOUTHWEST
              TO BE REMOVED
              TOP OF CURB ELEVATION
              TRANSFORMER PAD
 UGFO
              UNDERGROUND FIBER OPTIC LINE
              USE IN PLACE
              VITRIFIED CLAY PIPE
```

GENERAL NOTES

- 1. THE SITEWORK ON THIS PROJECT SHALL MEET OR EXCEED ALL STANDARDS AND SPECIFICATIONS REQUIRED BY THE CITY OF LEE'S
- 2. CASCO DIVERSIFIED CORPORATION HAS NOT PERFORMED ANY INVESTIGATION REGARDING UNDERGROUND CONDITIONS, HAZARDOUS WASTES, OR UTILITIES AFFECTING THE SITE SHOWN HEREIN.

3. ALL DIMENSIONS ARE FROM THE FACE OF CURB UNLESS OTHERWISE NOTED.

- 4. ALL DISTURBED AREAS OUTSIDE OF PAVEMENT AND BUILDING PAD AREAS SHALL RECEIVE 4" OF SUITABLE TOPSOIL. CONTRACTOR SHALL SEED, MULCH, FERTILIZE AND MAINTAIN ALL DISTURBED AREAS OUTSIDE OF PAVEMENT UNTIL SUFFICIENT VEGETATIVE GROWTH HAS BEEN ESTABLISHED PER THE SWPPP. CONTRACTOR SHALL BE RESPONSIBLE FOR ALL MEANS AND METHODS REQUIRED TO ESTABLISH PERMANENT SOIL STABILIZATION.
- 5. ALL SURVEY MONUMENTS DISTURBED DURING CONSTRUCTION SHALL BE REPLACED BY A LICENSED PROFESSIONAL SURVEYOR IN THE STATE OF MISSOURI AT THE CONTRACTOR'S OWN EXPENSE. 6. ALL TRENCHES EXCAVATED UNDERNEATH AREAS TO BE PAVED SHALL BE BACKFILLED WITH COMPACTED GRANULAR MATERIAL AND
- COMPACTED TO MEET REQUIREMENTS OF THE GEOTECHNICAL REPORT AND CITY OF LEE'S SUMMIT REQUIREMENTS. CONTRACTOR SHALL INSTALL ALL UNDERGROUND PIPING AND CONDUITS PER THE REQUIREMENTS OF THE RESPECTIVE MANUFACTURERS
- AND THE CITY OF LEE'S SUMMIT. 8. IN ACCORDANCE WITH GENERALLY ACCEPTED CONSTRUCTION PRACTICES, NEITHER THE OWNER NOR THE ENGINEER WILL BE RESPONSIBLE FOR COMPLIANCE WITH ALL LOCAL, STATE, AND FEDERAL SAFETY MEASURES AND REGULATIONS. CONTRACTOR SHALL COMPLY WITH ALL OSHA REGULATIONS AND SAFETY MEETING REQUIREMENTS. THE CONTRACTOR SHALL BE COMPLETELY AND SOLELY RESPONSIBLE FOR JOB SITE CONDITIONS, INCLUDING SAFETY OF ALL PROPERTY AND PERSONS AT ALL TIMES DURING THE PERFORMANCE OF THE WORK. THIS REQUIREMENT APPLIES CONTINUOUSLY AND IS NOT LIMITED TO NORMAL WORKING HOURS. CONTRACTOR SHALL BE RESPONSIBLE FOR PROVIDING, MAINTAINING, AND IMPLEMENTING ALL SAFETY DEVICES AND PRACTICES DURING
- 9. CONTRACTOR SHALL BE RESPONSIBLE FOR THE PROTECTION OF ALL PUBLIC AND PRIVATE PROPERTY ADJACENT TO THE WORK CONTRACTOR SHALL EXERCISE DUE CARE AND CAUTION TO AVOID DAMAGE TO SUCH PROPERTY. CONTRACTOR SHALL REPLACE OR RESTORE TO EQUAL OR BETTER CONDITION THAN THE ORIGINAL CONDITION AT THE CONTRACTOR'S OWN EXPENSE, ALL IMPROVEMENTS WITHIN OR ADJACENT TO THE AREA OF WORK WHICH ARE NOT DESIGNATED FOR REMOVAL OR ADJUSTMENT AND WHICH ARE DAMAGED OR REMOVED AS A RESULT OF THE CONTRACTOR'S ACTIONS.
- 10. CONTRACTOR SHALL CONTINUALLY MONITOR JOB SITE CONDITIONS, CONDITIONS REQUIRING CONSTRUCTION DIFFERENT THAN THAT SHOWN ON ON THE PLANS SHALL BE REPORTED TO THE ENGINEER PRIOR TO PROCEEDING WITH THE AFFECTED WORK. 11. CONTRACTOR SHALL BE RESPONSIBLE FOR FIELD VERIFYING PRESENCE AND LOCATIONS (VERTICALLY AND HORIZONTALLY) OF ALL UTILITIES. IN NO WAY DOES THE ENGINEER OR THE OWNER SUGGEST, IMPLY, OR CONFIRM THAT UTILITIES SHOWN ARE INCLUSIVE OF ALL UTILITIES WITHIN THE PROJECT AREA. THE CONTRACTOR SHALL BE RESPONSIBLE FOR PROTECTING IN PLACE ALL UTILITIES. ANY DAMAGE OR LOSS TO EXISTING UTILITIES SHALL BE THE SOLE RESPONSIBILITY OF THE CONTRACTOR. SHOULD ANY DAMAGE OCCUR AS A RESULT OF THE CONSTRUCTION ACTIVITIES, THE CONTRACTOR SHALL REPLACE OR REPAIR THE DAMAGES TO THE FULL SATISFACTION OF THE UTILITY OWNER AT THE CONTRACTOR'S OWN EXPENSE. THE CONTRACTOR SHALL AGREE TO DEFEND, INDEMNIFY, AND HOLD HARMLESS THE OWNER AND THE ENGINEER FROM ANY AND ALL DAMAGES OR LOSS.

BUILDING RENOVATION

LOT 1, RAINTREE 150 CENTER

A SUBDIVISION IN LEE'S SUMMIT, JACKSON COUNTY, MISSOURI, AS SHOWN ON PLAT ENTITLED MINOR PLAT OF RAINTREE 150 CENTER, RECORDED APRIL 21, 2004 IN PLAT BOOK 181, PAGE 12 OF THE JACKSON COUNTY, MISSOURI RECORDER OF DEEDS OFFICE

FINAL DEVELOPMENT PLANS



PERTINENT	INFORMATION
	

PROPERTY ADDRESS: ZIP CODE: MUNICIPALITY: TOTAL SITE AREA: AREA OF DISTURBANCE: CURRENT ZONING: INTENDED USE: PARCEL ID:	155 SW M-150 HIGHWAY 64082 CITY OF LEE'S SUMMIT 1.4047 ACRES (61,187± SF) 0.5405 ACRES (23,546± SF) CP-2 CORRIDOR DEVELOPMENT OVERLAY DISTRICT CP-2 CORRIDOR DEVELOPMENT OVERLAY DISTRICT 70-820-03-02-00-0-00-000
--	--

SHEET INDEX

CO.O - COVER

C1.0 - DEMOLITION PLAN

C2.0 - SITE & UTILITY PLAN

C3.0 - GRADING PLAN

C4.0 - SITE DETAILS

C4.1 — SITE DETAILS

C5.0 - EROSION & SEDIMENT CONTROL PLAN

C5.1 - EROSION & SEDIMENT CONTROL DETAILS

SURVEY NOTE

THE TOPOGRAPHIC INFORMATION IN THIS PLAN SET IS BASED OFF A SURVEY PROVIDED BY AYLETT SURVEYING & ENGINEERING ON MAY 13, 2020 AND A BOUNDARY SURVEY PROVIDED BY COMMERCIAL DUE DILIGENCE SERVICES ON MARCH 25, 2020.

ACTUAL FIELD CONDITIONS ARE TO BE VERIFIED PRIOR TO COMMENCEMENT OF WORK.

TITLE DESCRIPTION

LOT 1, RAINTREE 150 CENTER, A SUBDIVISION IN LEE'S SUMMIT, JACKSON COUNTY, MISSOURI, AS SHOWN ON PLAT ENTITLED MINOR PLAT OF RAINTREE, 150 CENTER, RECORDED APRIL 21, 2004 IN PLAT BOOK 181, PAGE 12 OF THE JACKSON COUNTY, MISSOURI RECORDER OF DEEDS OFFICE.

THIS SURVEY AND LEGAL DESCRIPTION ARE THE SAME AS THAT SHOWN ON A TITLE REPORT PREPARED BY FIRST AMERICAN TITLE INSURANCE COMPANY, FILE NO.: NCS-401470620A-NC, FIRST AMENDMENT, EFFECTIVE DATE. EFFECTIVE DATE: JUNE 26, 2019.

FLOOD ZONE NOTE

ACCORDING TO THE FIRM FLOOD INSURANCE RATE MAP 29095C0532G DATED JANUARY 20, 2017, THIS DEVELOPMENT IS LOCATED IN FLOOD ZONE X. FLOOD ZONE X IS DETERMINED TO BE AN AREA OF MINIMAL FLOOD HAZARD, OUTSIDE THE 0.2% ANNUAL CHANCE FLOOD HAZARD.

TITLE INFORMATION


THE TITLE DESCRIPTION AND THE SCHEDULE B ITEMS HEREON ARE FROM A TITLE REPORT PREPARED BY FIRST AMERICAN TITLE INSURANCE COMPANY, FILE NO.: NCS-401470620A-NC, FIRST AMENDMENT, EFFECTIVE DATE. EFFECTIVE DATE: JUNE 26, 2019.



RENOVATION

DING.

CASCO DIVERSIFIED CORPORATION CERTIFICATE OF AUTHORITY #000613 12/31/21

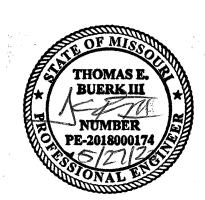

PROFESSIONAL OF RECORD Buerk III. Thomas E. License NO. PE-2018000174 Expiration Date 12/31/20

Drawn By/Checked By: MEB/TEB Project Number Permit Date 05-27-20



LEGEND OF SYMBOLS

MANHOLE WITH STORM SEWER

INLET WITH MANHOLE COVER

STORM STRUCTURE NUMBER

SPOT ELEVATION AT TOP OF CURB

SPOT ELEVATION AT TOP OF WALL

SPOT ELEVATION AT TOP OF BANK

SPOT ELEVATION AT BOTTOM OF WALL

SPOT ELEVATION AT BOTTOM OF BANK

SPOT ELEVATION AT BOTTOM OF CURB

SPOT ELEVATION AT FLOWLINE OF GUTTER

MANHOLE WITH SANITARY SEWER

SANITARY STRUCTURE NUMBER

GRATE TOP INLET

UTILITY POLE

GUY WIRE TREE

--- OHE --- OHE --- ELECTRIC LINE (OVERHEAD)

--- FO --- FO FIBER OPTIC CABLE

--- SAN --- SANITARY LINE

--- ST --- ST --- STORM LINE

--- FM --- FORCE MAIN

TC 565.19

BC 565.19

FL 565.19

TW 565.19

BW 565.19

____TB 565.19

____BB 565.19

565.19

TELEPHONE LINE (OVERHEAD) ---- UGE ----- UGE ---- ELECTRIC LINE (UNDERGROUND)

---- T ---- T TELEPHONE LINE (UNDERGROUND)

---- WATER LINE

LIGHT

FIRE HYDRANT

GAS VALVE

GAS METER

CLEAN OUT

CONTOUR

STREET SIGN

PROJECT CONTACTS

4653 TRUEMAN BOULEVARD HILLIARD, OH 43026

MIDLAND PROPERTIES OF ILLINOIS, LLC

CASCO DIVERSIFIED CORPORATION

12 SUNNEN DR. SUITE 100

12 SUNNEN DR. SUITE 100

TOM.BUERK@CASCOCORP.COM

ELECTRIC: KANSAS CITY POWER & LIGHT

LEE'S SUMMIT PUBLIC WORKS

LEE'S SUMMIT WATER UTILITIES

LEE'S SUMMIT FIRE STATION 5

3650 SW WINDEMERE ROAD

LEE'S SUMMIT, MO 64062

12 SE HAMBLEN ROAD

LEE'S SUMMIT, MO 64081

LEE'S SUMMIT, MO 64063

ST. LOUIS, MO 63143

ST. LOUIS, MO 63143

CIVIL ENGINEER:

(314) 821-1100

(888) 471-5275

220 SE GREEN

(816) 969-1800

(816) 756-5252

(816) 969-1900

FIRE DEPARTMENT:

SANITARY & STORM:

EMAIL

BRENT@MIDLANDGENERALCONTRACTORS.COM

(614) 586-3303

NPALMER@EQUITY.NET

716 WINDSOR ROAD

(815) 988-9600

LOVES PARK, IL 61111

WATER VALVE

WATER METER

SPOT ELEVATION

PROPOSED

മ

565.19

TC 565.19

BC 565.19

FL 565.19


____TW 565.19

BW 565.19

____TB 565.19

___BB 565.19

EXISTING

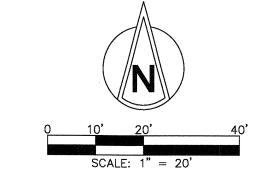



HIGHWAY MO 64082 RENOVATION SW M-150 I SUMMIT, 155 SV LEE'S


CASCO DIVERSIFIED CORPORATION CERTIFICATE OF AUTHORITY


BUERK III NUMBER PE-2018000174

PROFESSIONAL OF RECORD Buerk III, Thomas E. License NO. PE-2018000174 Expiration Date 12/31/20

Drawn By/Checked By: MEB/TEB Project Number Permit Date 05-27-20

DEMOLITION PLAN

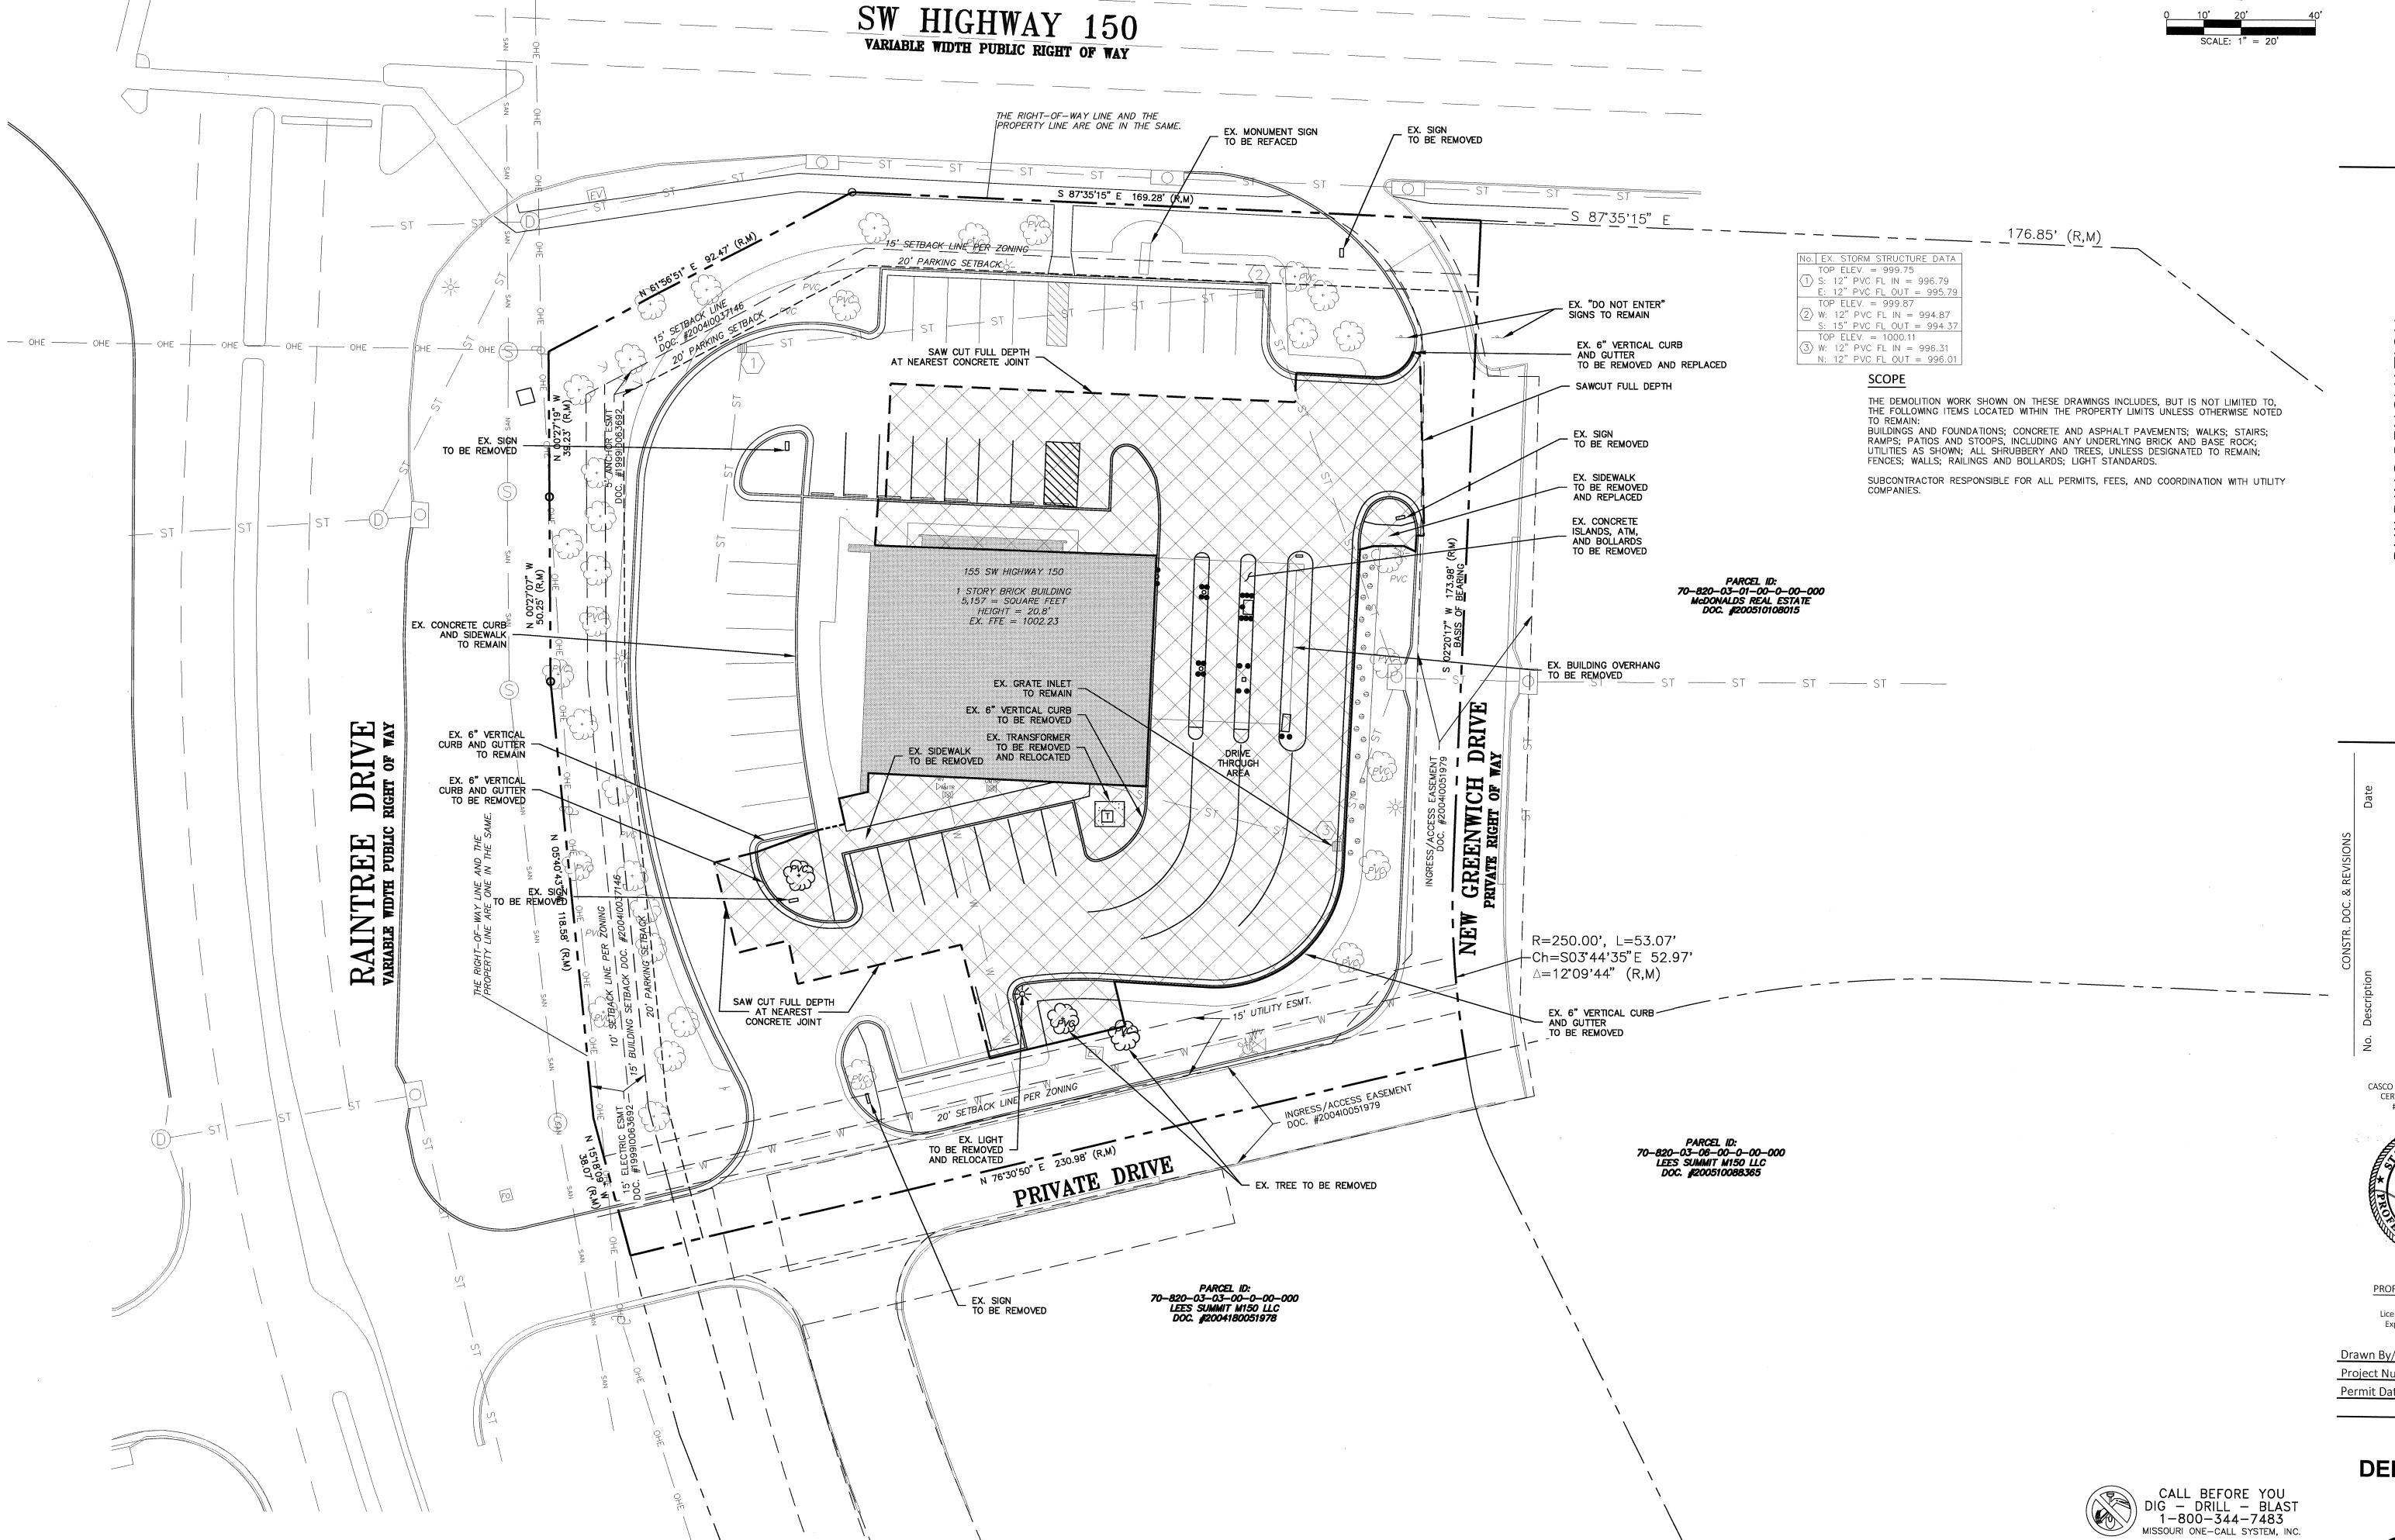


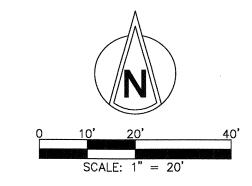



HIGHWAY MO 64082 SW M-150 I SUMMIT, SS 155 LEE'

SW HIGHWAY 150 VARIABLE WIDTH PUBLIC RIGHT OF WAY THE RIGHT-OF-WAY LINE AND THE PROPERTY LINE ARE ONE IN THE SAME. CURB INLET TOP ELEV. = 999.87 EX. CONCRETE W: 20" CONC. FL IN = 997.37

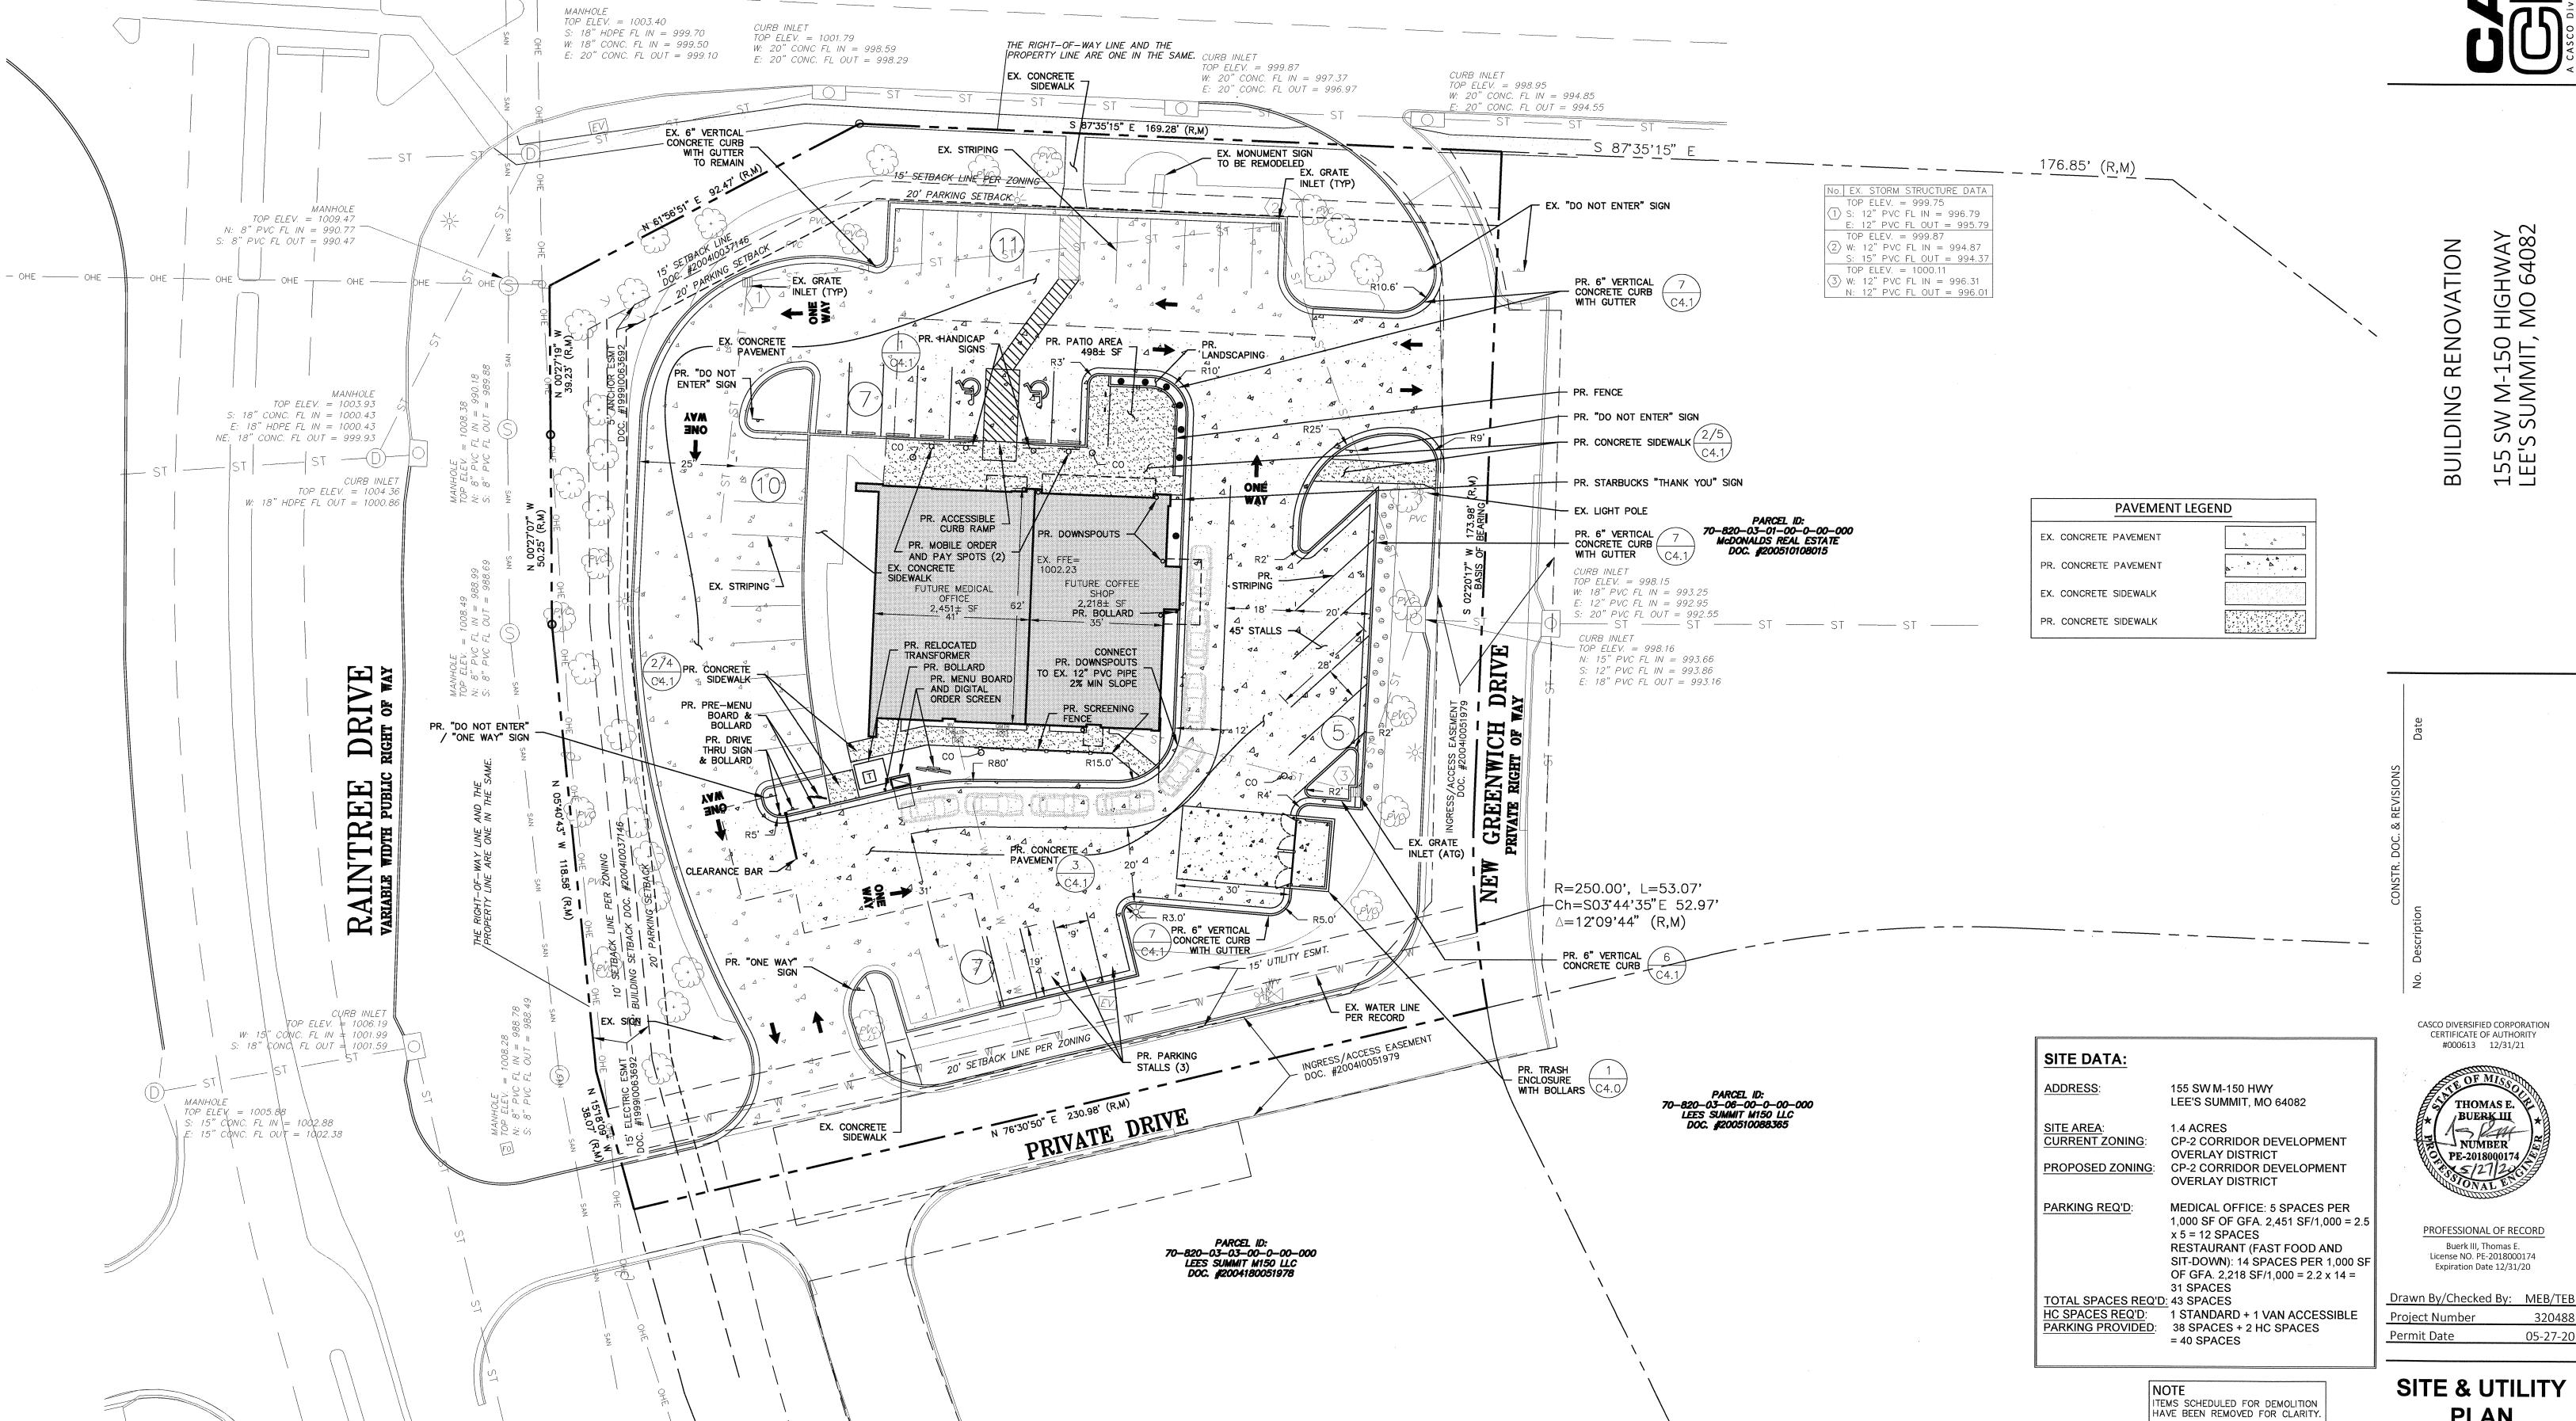





CALL BEFORE YOU
DIG - DRILL - BLAST
1-800-344-7483
MISSOURI ONE-CALL SYSTEM, INC.

SITE & UTILITY **PLAN**

05-27-20

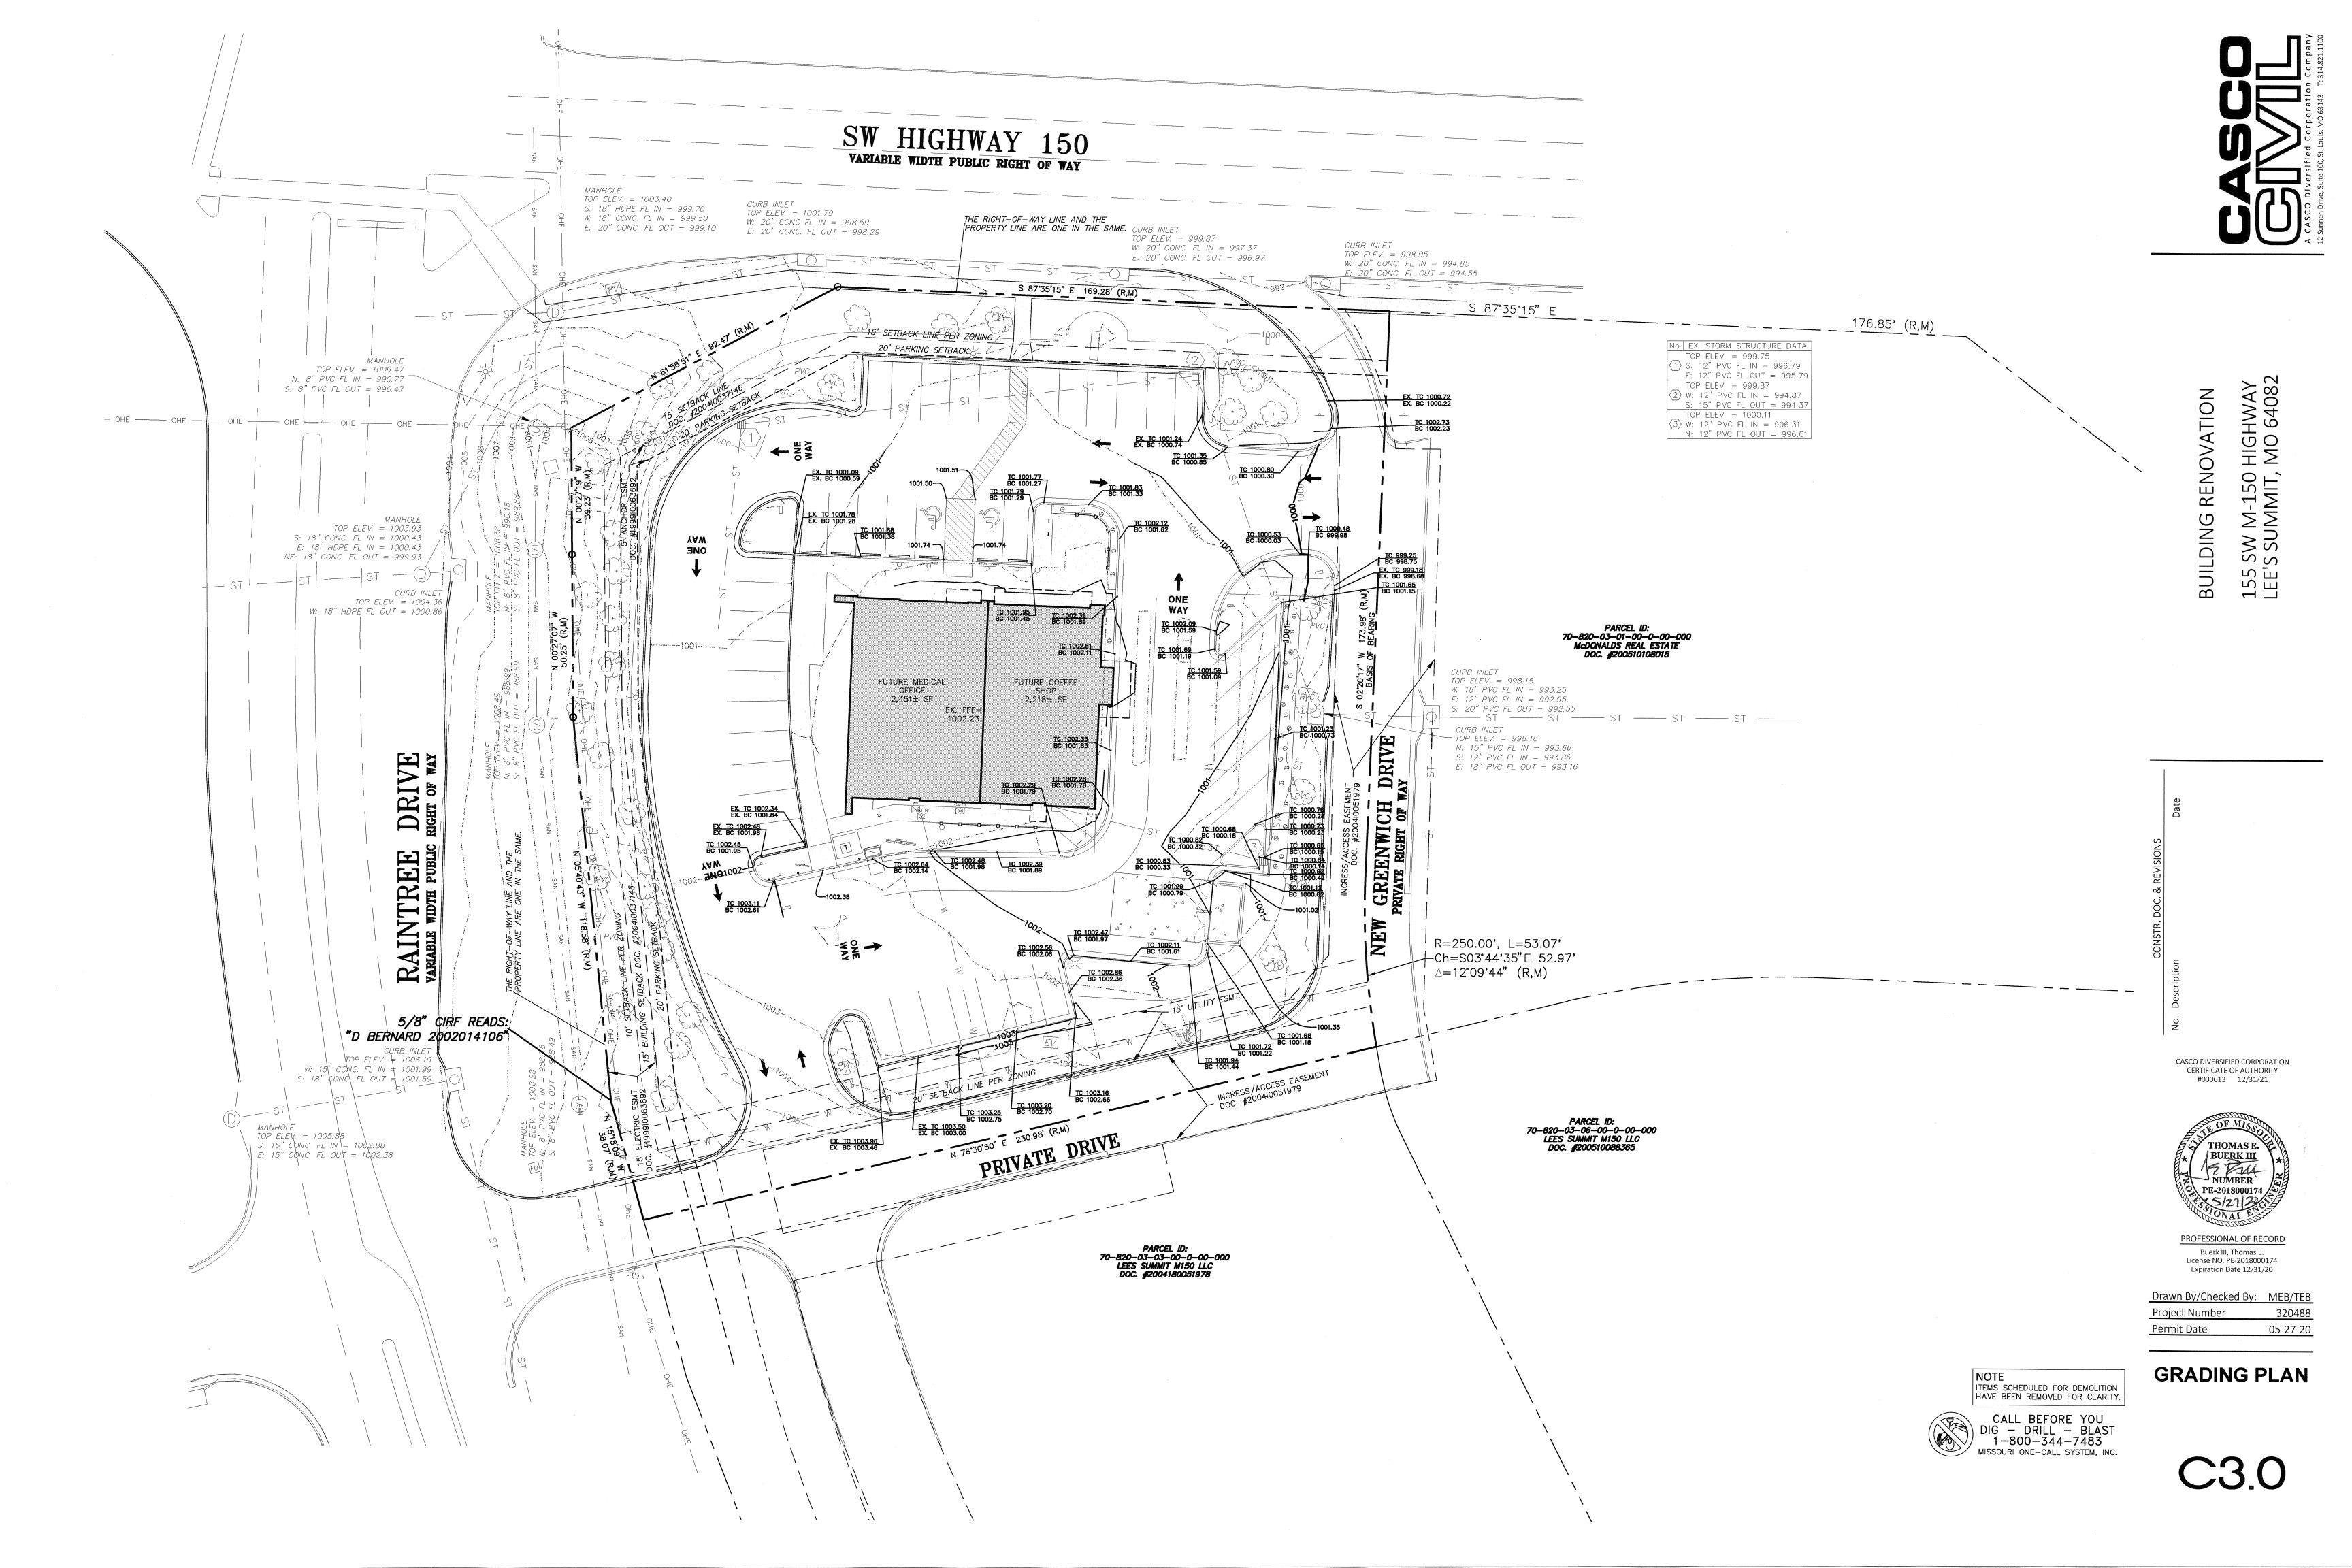

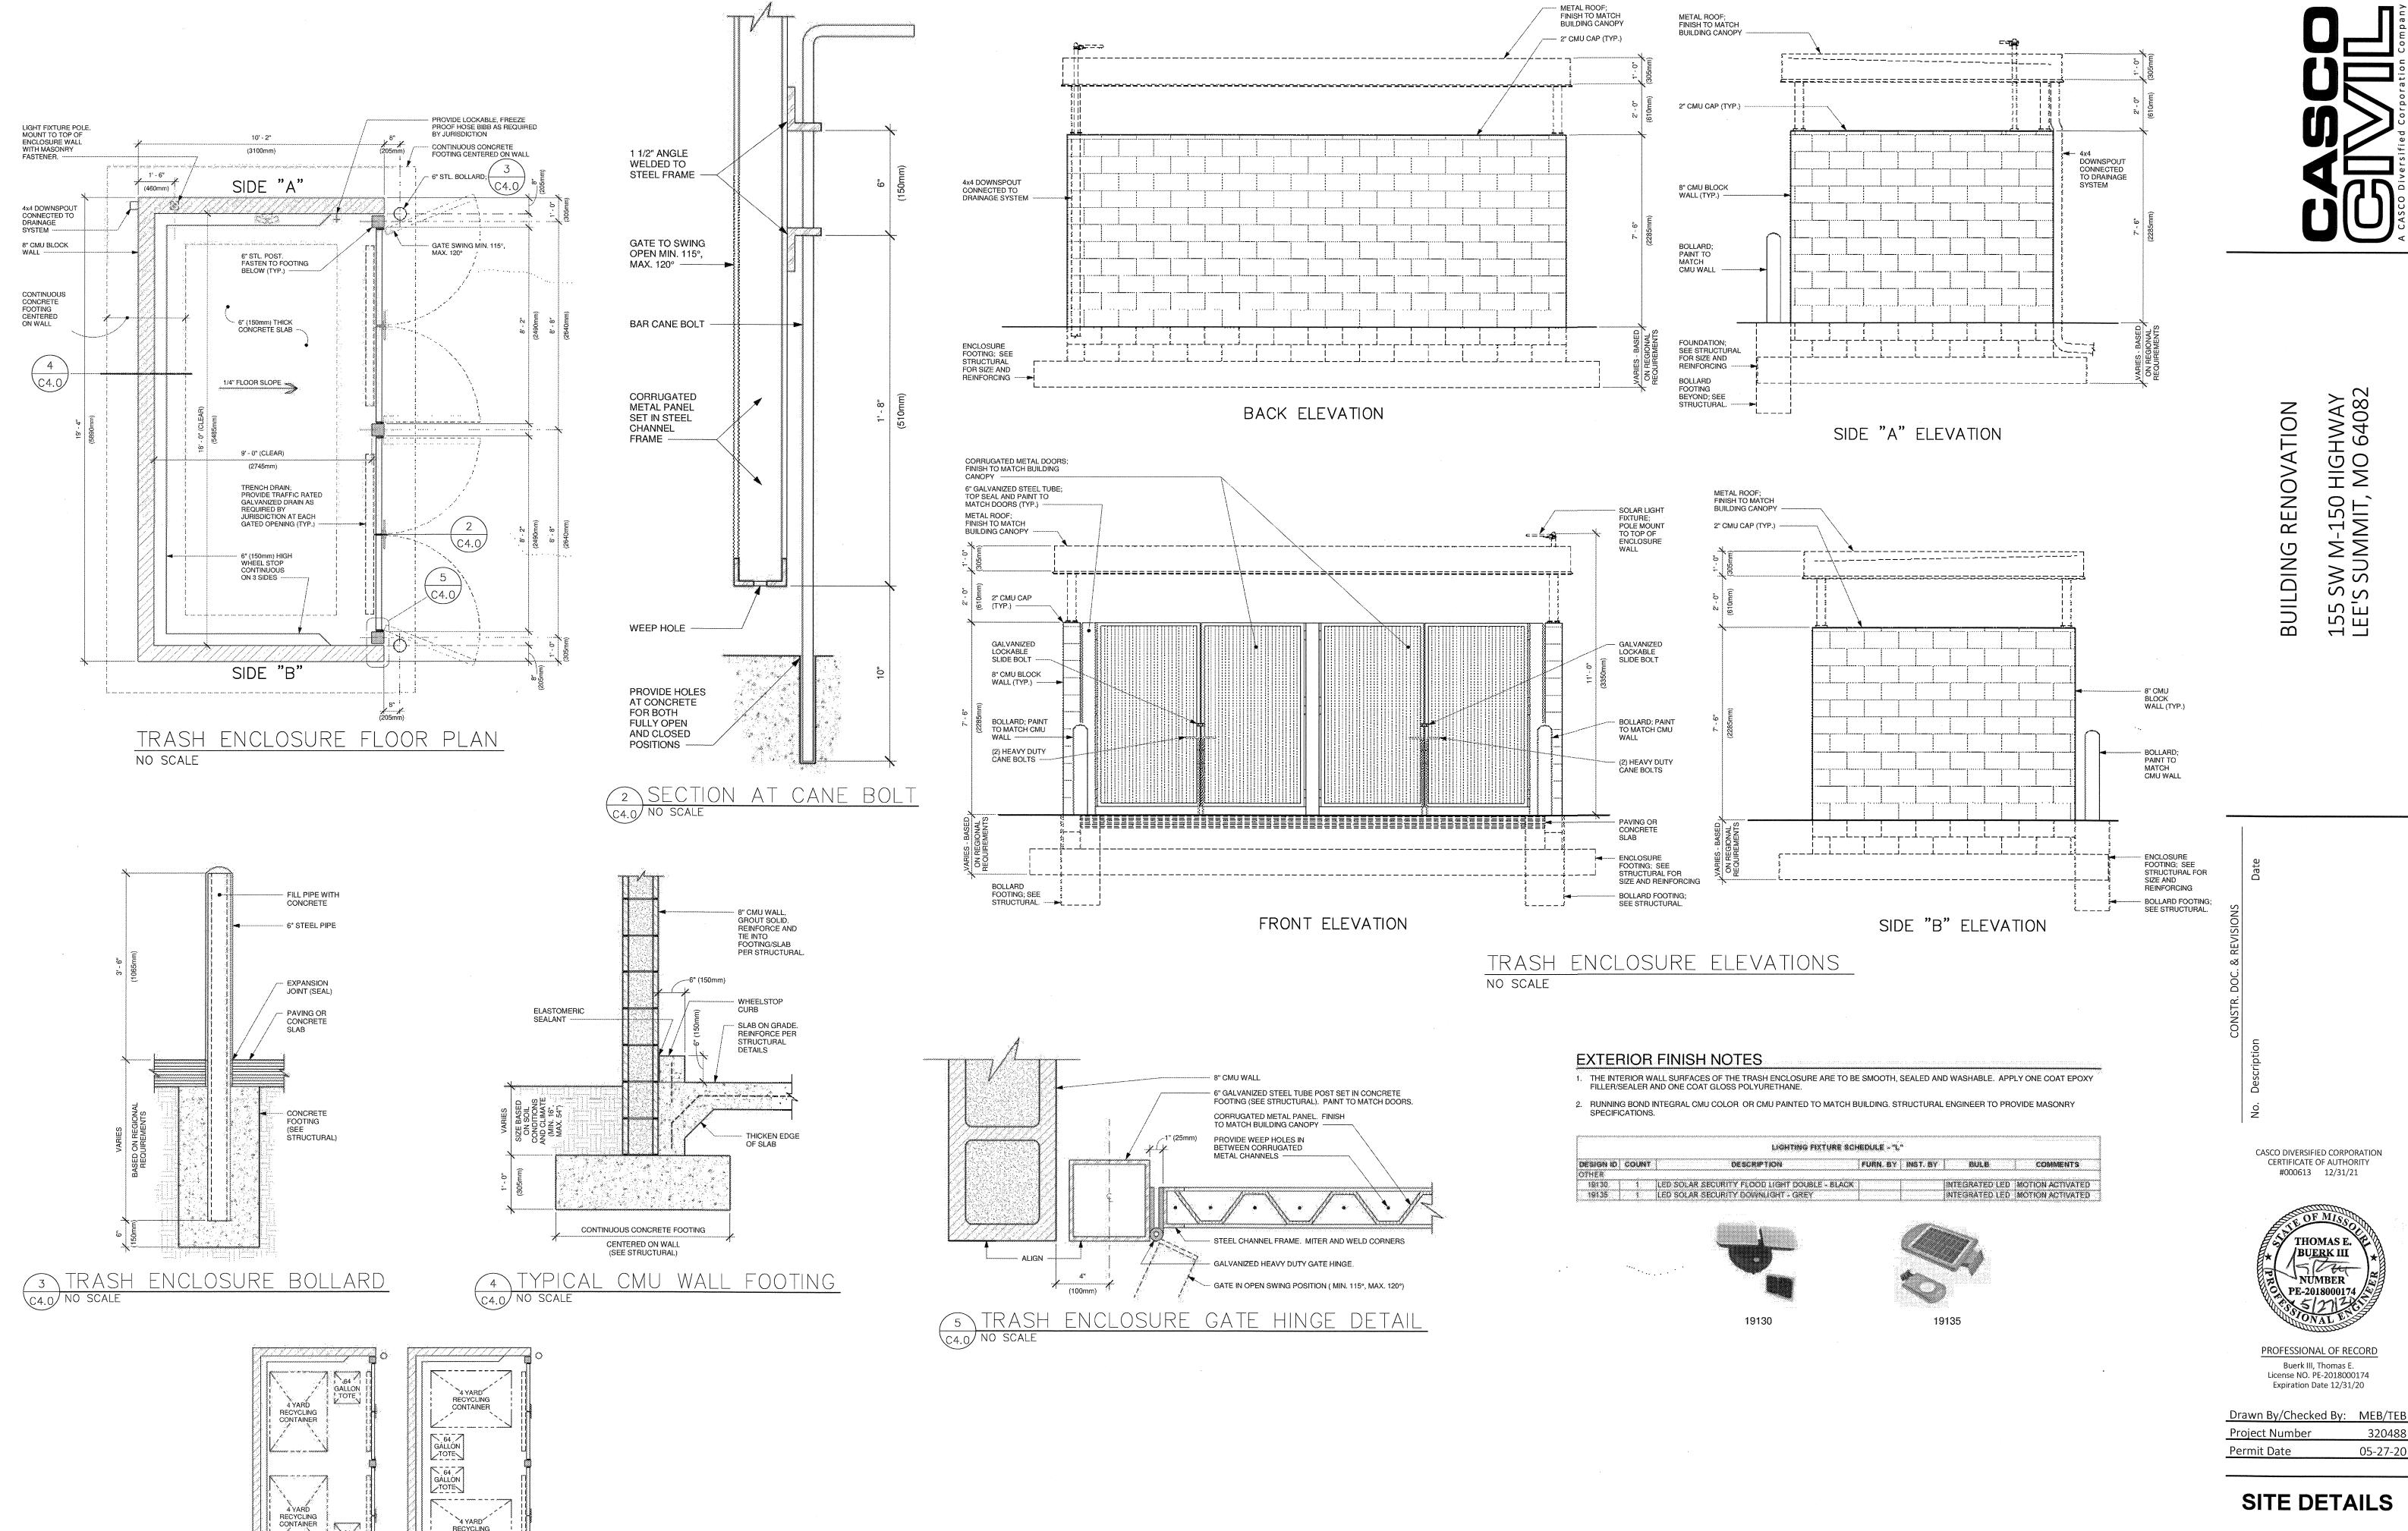

SITE DETAILS

05-27-20

CERTIFICATE OF AUTHORITY

#000613 12/31/21

THOMAS E.


PROFESSIONAL OF RECORD Buerk III, Thomas E. License NO. PE-2018000174 Expiration Date 12/31/20


BUERK III
NUMBER


BUILDING RENOVATION

RECYCLING CONTAINER

TRASH ENCLOSURE LAYOUT OPTIONS

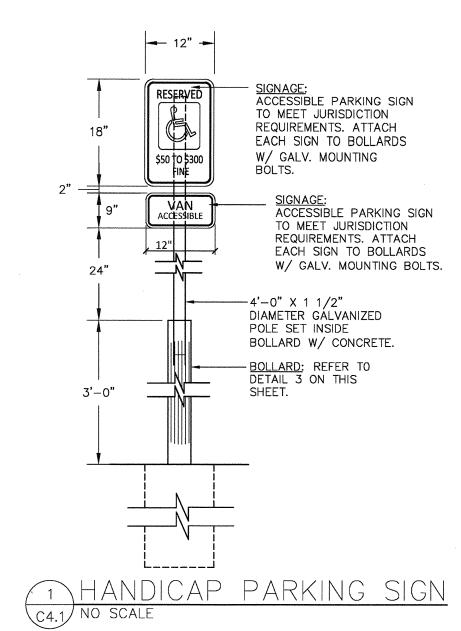

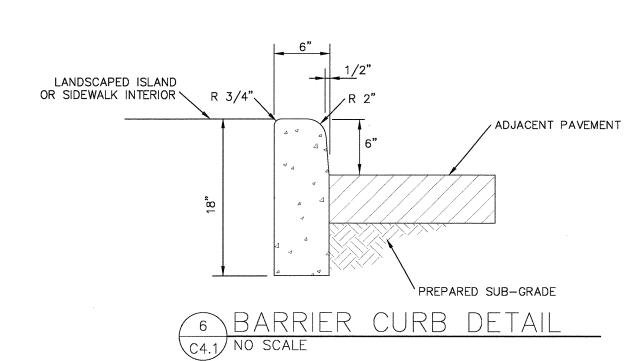

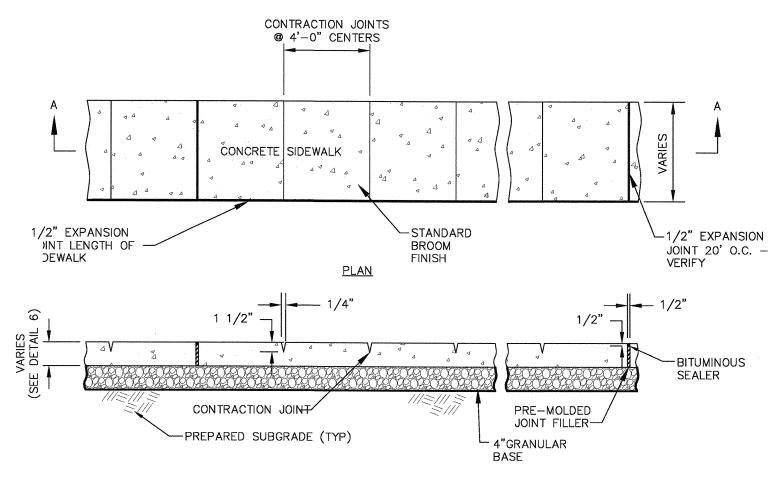

SECTION A-A


TYPICAL SLAB JOINT DETAILS (2) TYPICAL SLAB JOINT DETAILS

SUBGRADE PREPARATION NOTE


ALL EXPOSED AND/OR DISTURBED GRANULAR BASE AREAS SHALL BE COMPACTED TO A MINIMUM OF 95% OF OPTIMUM DENSITY IN ACCORDANCE W/ASTM D 1557 AT OPTIMUM MOISTURE CONTENT AND TO A MINIMUM DEPTH OF 8" — ALL SUBGRADE SOIL AREAS EXPOSED BY EXCAVATIONS AND GRADING SHALL BE COMPACTED TO A MINIMUM OF 95% OF OPTIMUM DENSITY IN ACCORDANCE W/ASTM D 1557 AT OPTIMUM MOISTURE CONTENT AND TO A MINIMUM DEPTH OF 12" — FILL WHERE REQUIRED SHALL BE PLACED IN LIFTS NOT TO EXCEED 8" LOOSE MEASURE AND SHALL BE COMPACTED AS OUTLINED ABOVE — THE ON SITE TESTING COMPANY SHALL PROVIDE TESTING AND INSPECTION OF THE SOIL WORK PRIOR TO PLACING CONCRETE

NOTES:


- 1. ALL CONCRETE SHALL BE MIN. FC.=3000 P.S.I.
- ALL CONSTRUCTION MATERIALS AND METHODS OF CONSTRUCTION SHALL BE IN ACCORDANCE WITH LOCAL MUNICIPAL ORDINANCES.
- 3. ANY UNSUITABLE SOIL (AS DETERMINED BY SOILS ENGINEER)
 BELOW STRUCTURE SHALL BE REMOVED AND REPLACED WITH
 SELECT EARTHEN MATERIAL COMPACTED IN PLACE WITH
 VIBRATORY TAMPER.
- 4. PROVIDE 1/2" EXPANSION JOINTS AT 20' CENTERS.

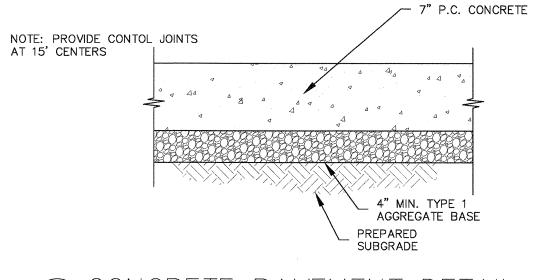




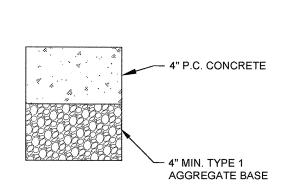

4 CONCRETE SIDEWALK DETAIL
C4.1) NO SCALE

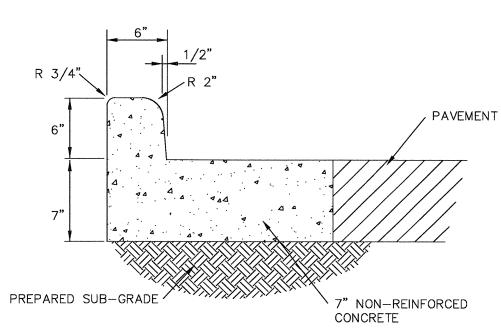


7 CONCRETE CURB AND GUTTER DETAIL
C4.1 NO SCALE

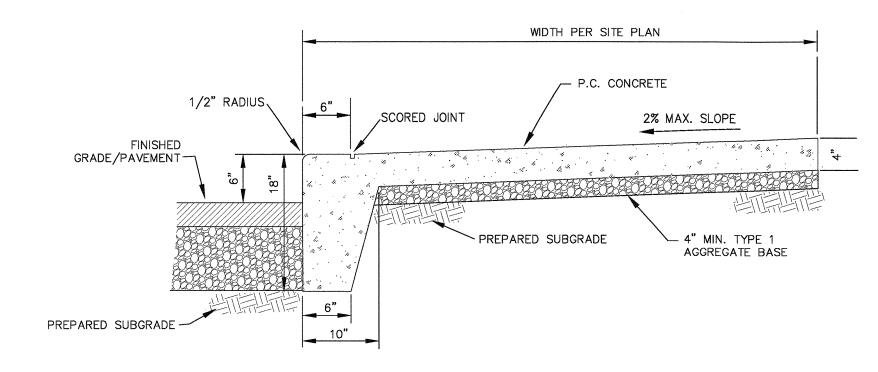




5 COMBINATION CURB & SIDEWALK DETAIL
C4.1 NO SCALE

BUILDING RENOVATION 155 SW M-150 HIGHWAY LEE'S SUMMIT, MO 64082

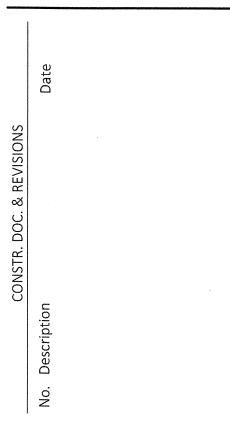

CASCO DIVERSIFIED CORPORATION CERTIFICATE OF AUTHORITY #000613 12/31/21

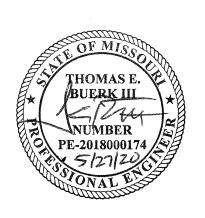

Buerk III, Thomas E. License NO. PE-2018000174 Expiration Date 12/31/20

Drawn By/Checked By:MEB/TEBProject Number320488Permit Date05-27-20

SITE DETAILS

C41




SW M-150 HIGHWAY S SUMMIT, MO 64082

CASCO DIVERSIFIED CORPORATION CERTIFICATE OF AUTHORITY




MEB/TEB
320488
05-27-20

EROSION & SEDIMENT **CONTROL PLAN**

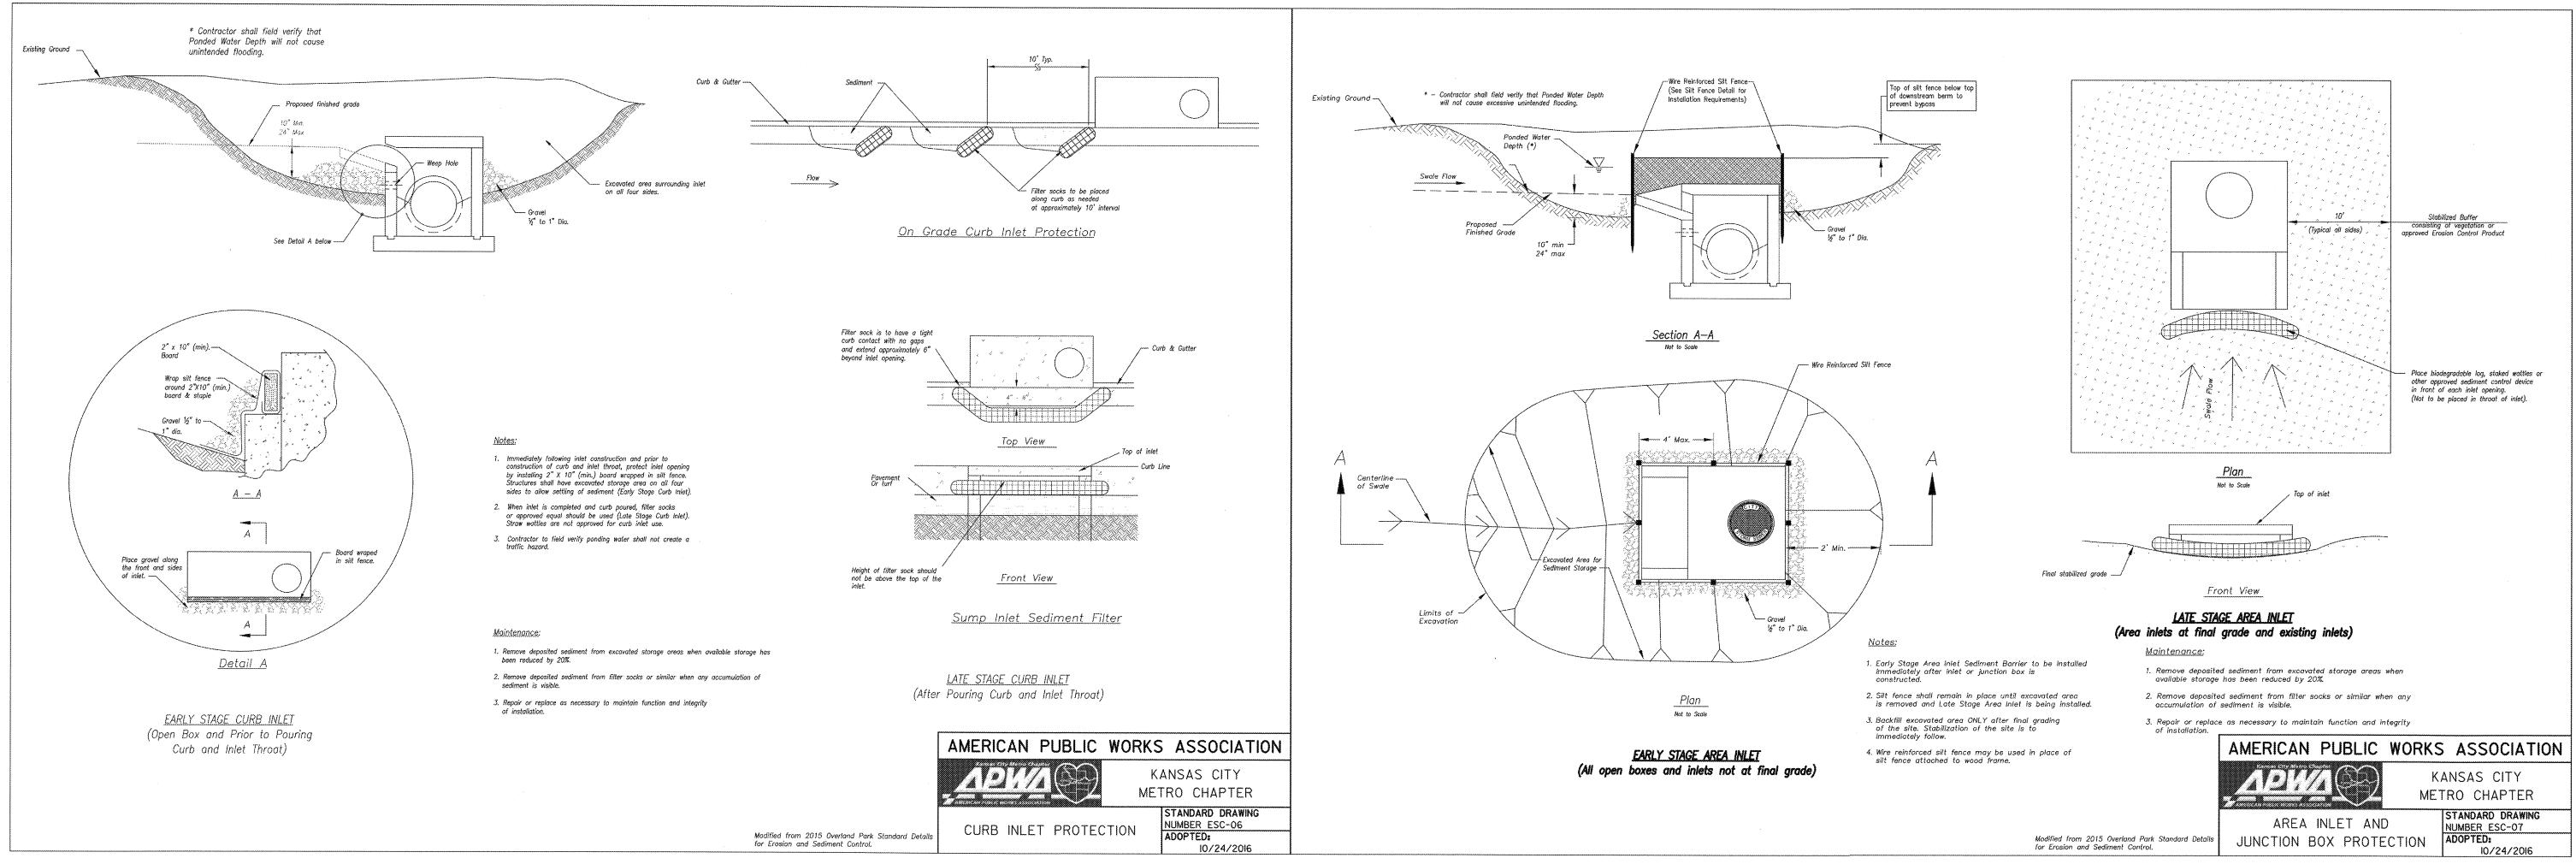



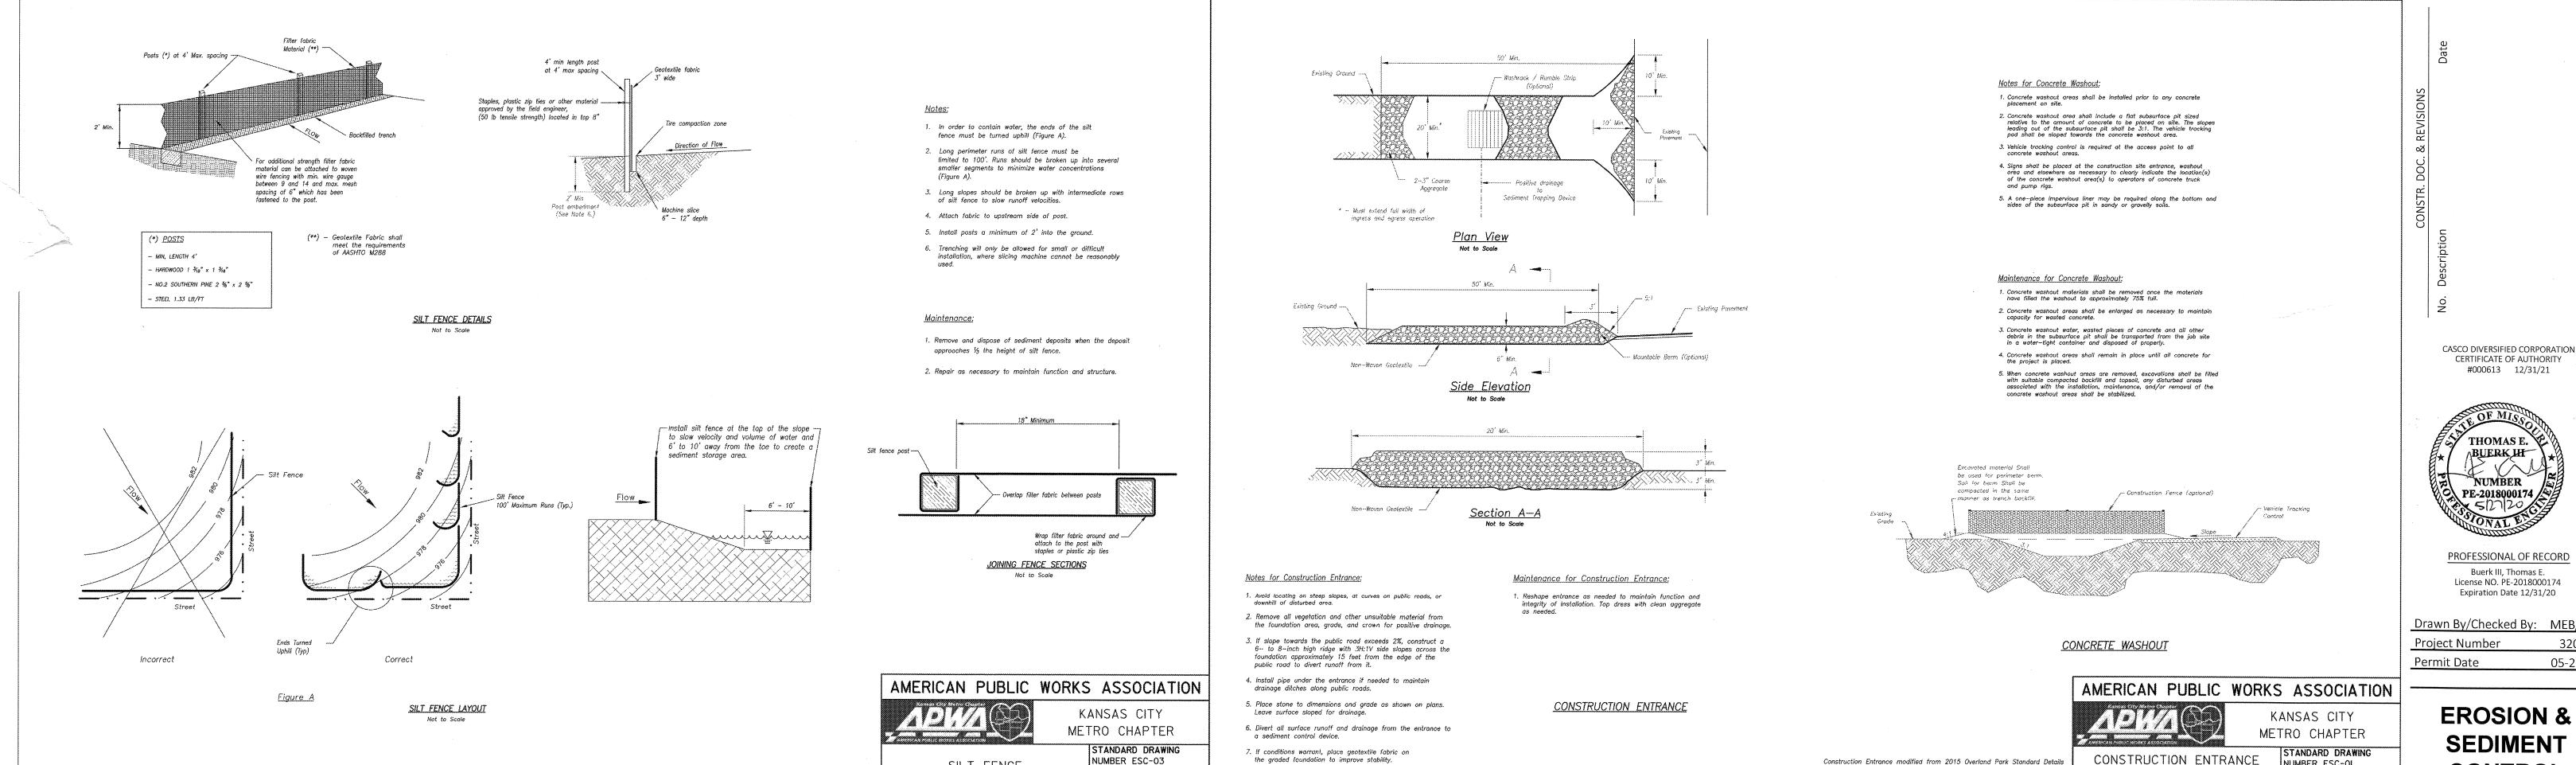

the graded foundation to improve stability.

NUMBER ESC-03

10/24/201

SILT FENCE

Modified from 2015 Overland Park Standard Details

for Erosion and Sediment Control.

2 SILT FENCE DETAIL
C5.1 NO SCALE

CONSTRUCTION ENTRANCE & CONCRETE WASHOUT DETAIL


C5.1 NO SCALE

Construction Entrance modified from 2015 Overland Park Standard Details

for Erosion and Sediment Control; Concrete Washout modified from 2009

HIGHWAY MO 64082 RENOVATION W M-150 SUMMIT, BUILDING 2 C I

CASCO DIVERSIFIED CORPORATION CERTIFICATE OF AUTHORITY #000613 12/31/21

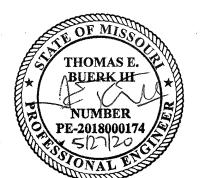

PROFESSIONAL OF RECORD Buerk III, Thomas E. License NO. PE-2018000174

Drawn By/Checked By: MEB/TEB


05-27-20

SEDIMENT CONTROL **DETAILS**

NUMBER ESC-OI

10/24/2016

AND CONCRETE WASHOUT

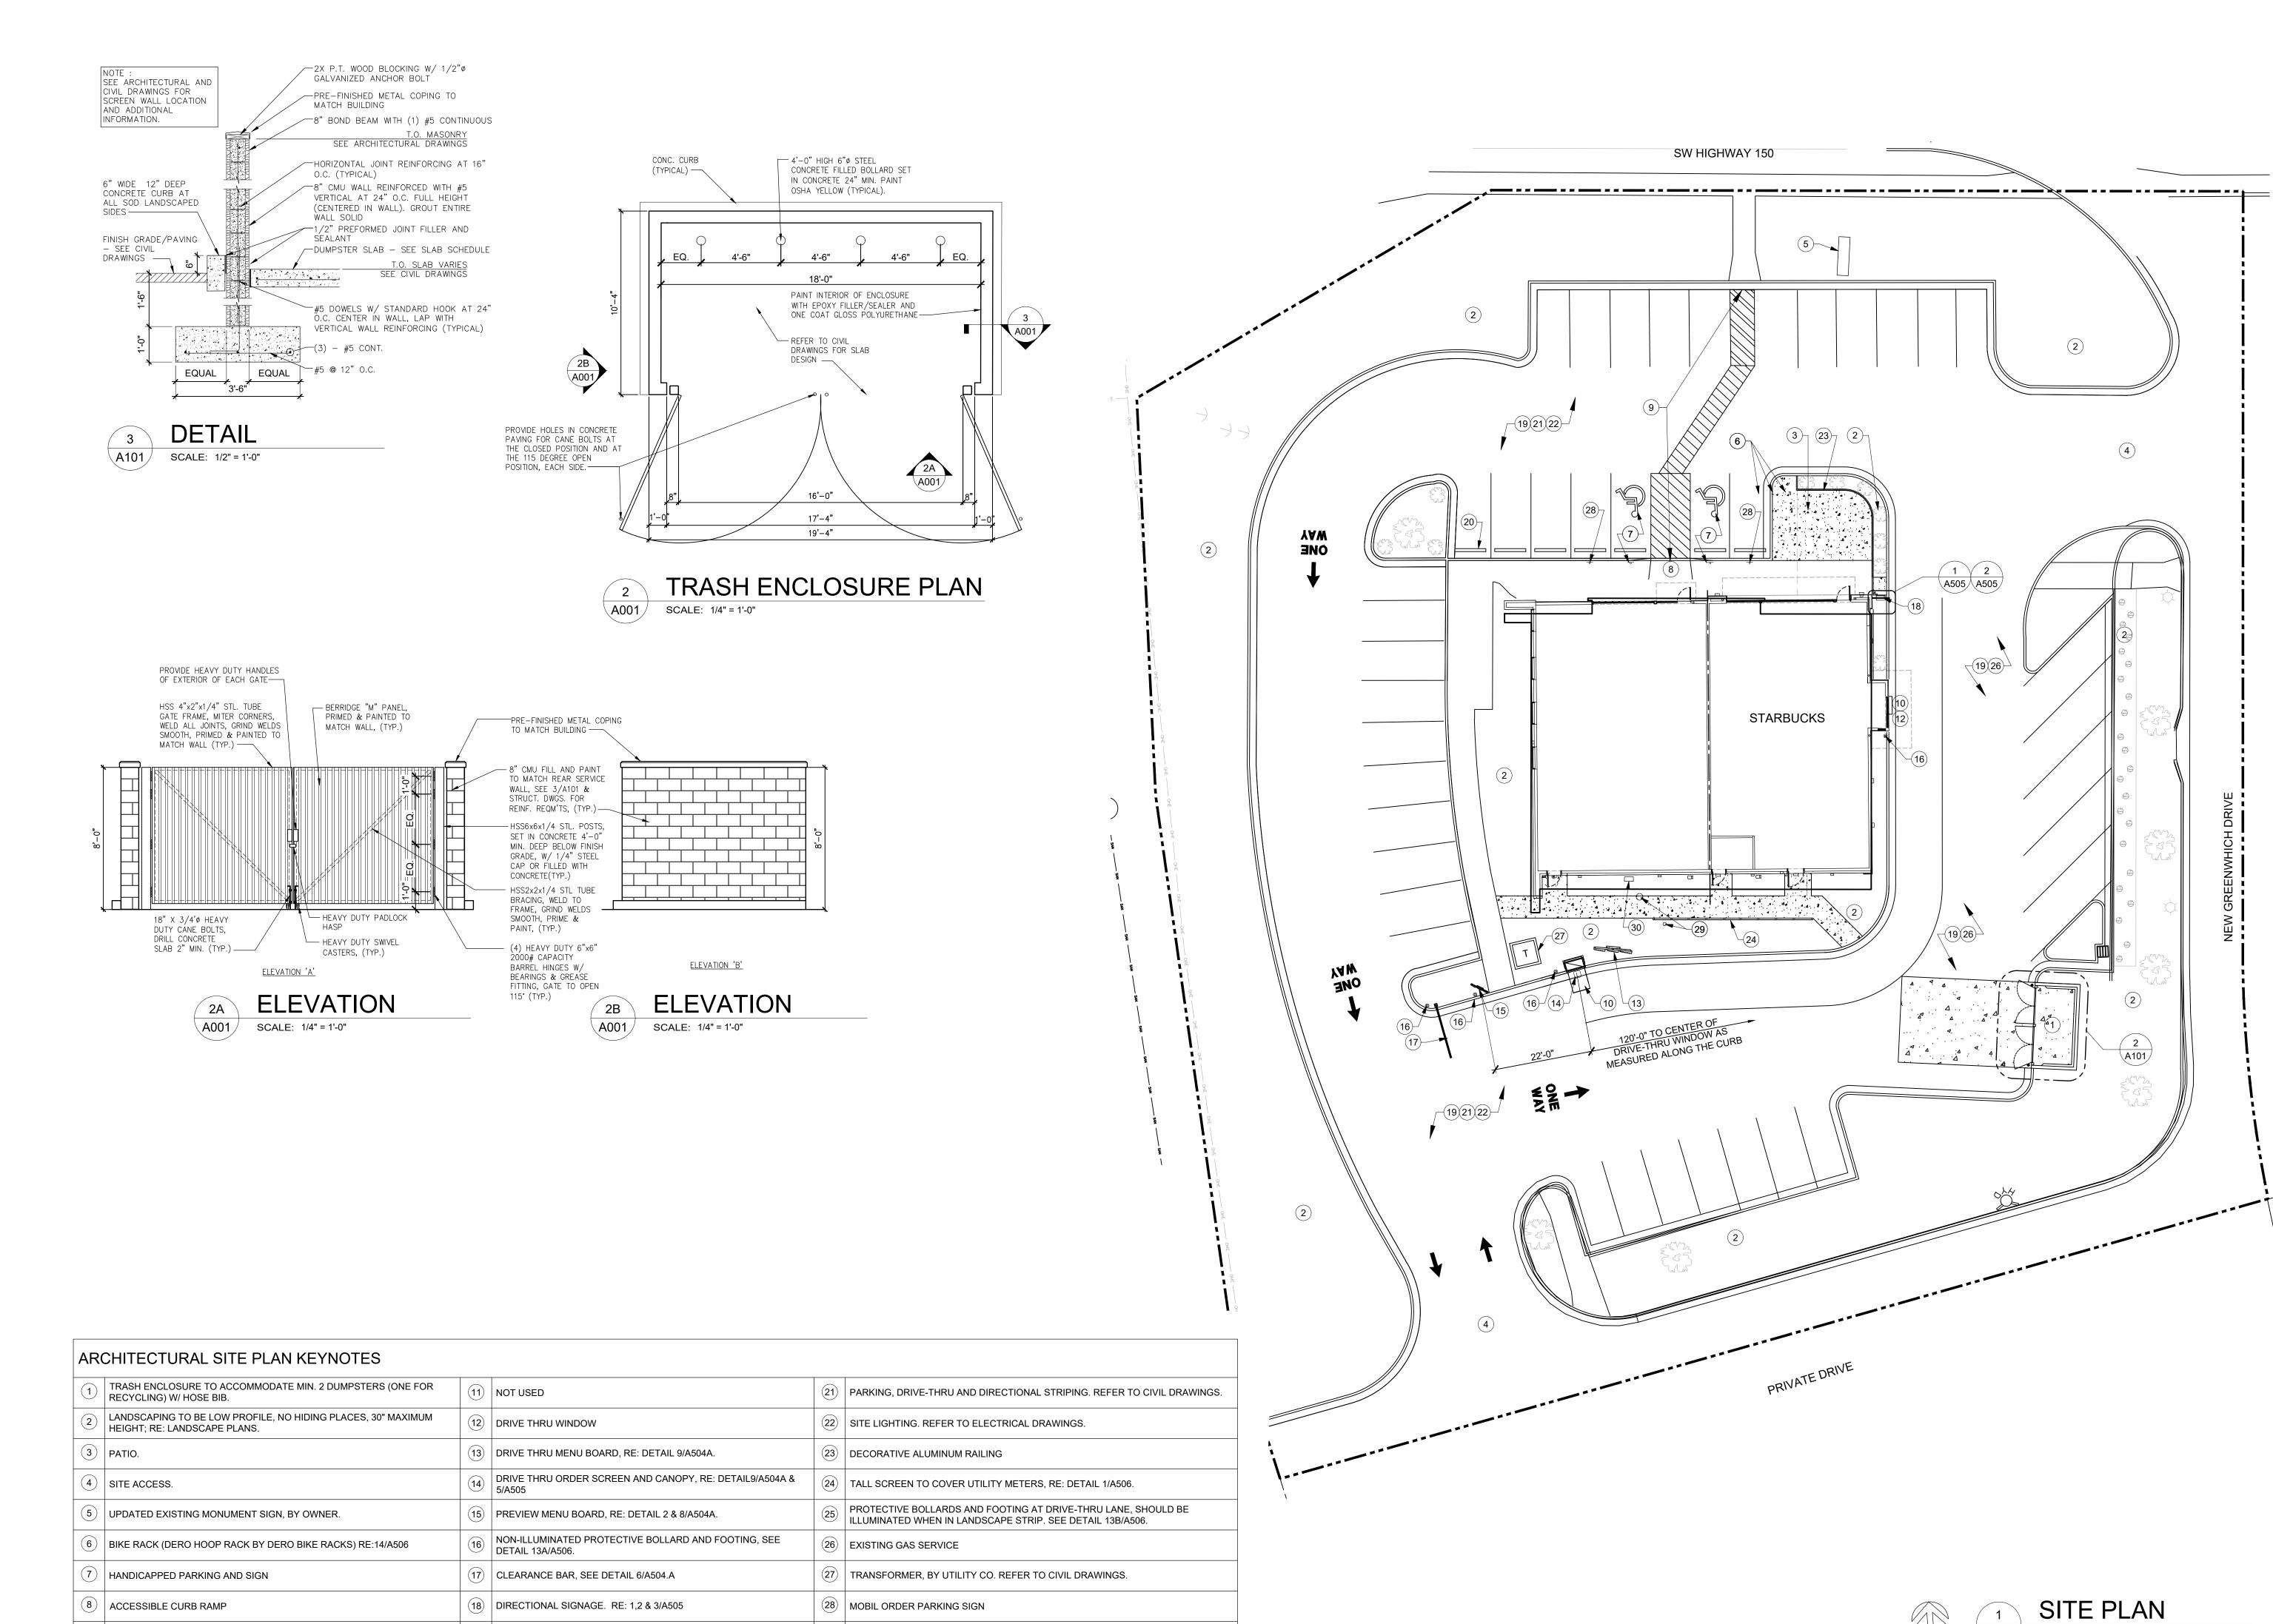

(9) ACCESSIBLE PATH OF TRAVEL. REFER TO CIVIL DRAWINGS

DRIVE-THRU EQUIPMENT INCLUDING VEHICLE DETECTION LOOP,

(19) REFER TO CIVIL DRAWINGS FOR PAVING.

wheel stops refer to civil drawings.

(29) EXISTING WATER METER AND CLEAN OUT

(30) RELOCATED IRRIGATION VALUET

12 Sunnen Drive, Suite 100, St. Louis, MO 63143 T: 314.821.11

GENERAL CONTRACTORS INCO

Starbucks & Medical Office 155 S.W. M-150 HWY LEE'S SUMMIT, MO 64802

CASCO DIVERSIFIED CORPORATION ARCHITECTURAL CERTIFICATE OF AUTHORITY #000329 12/31/21



PROFESSIONAL OF RECORD

BULLOCK, KEYMA L.
License NO. 2004011669
Expiration Date 12/31/20

Drawn By/Checked By: RMT/MSD
Project Number 320488


Permit Date

NORTH

ARCHITECTURAL SITE PLAN

00-00-00

A001

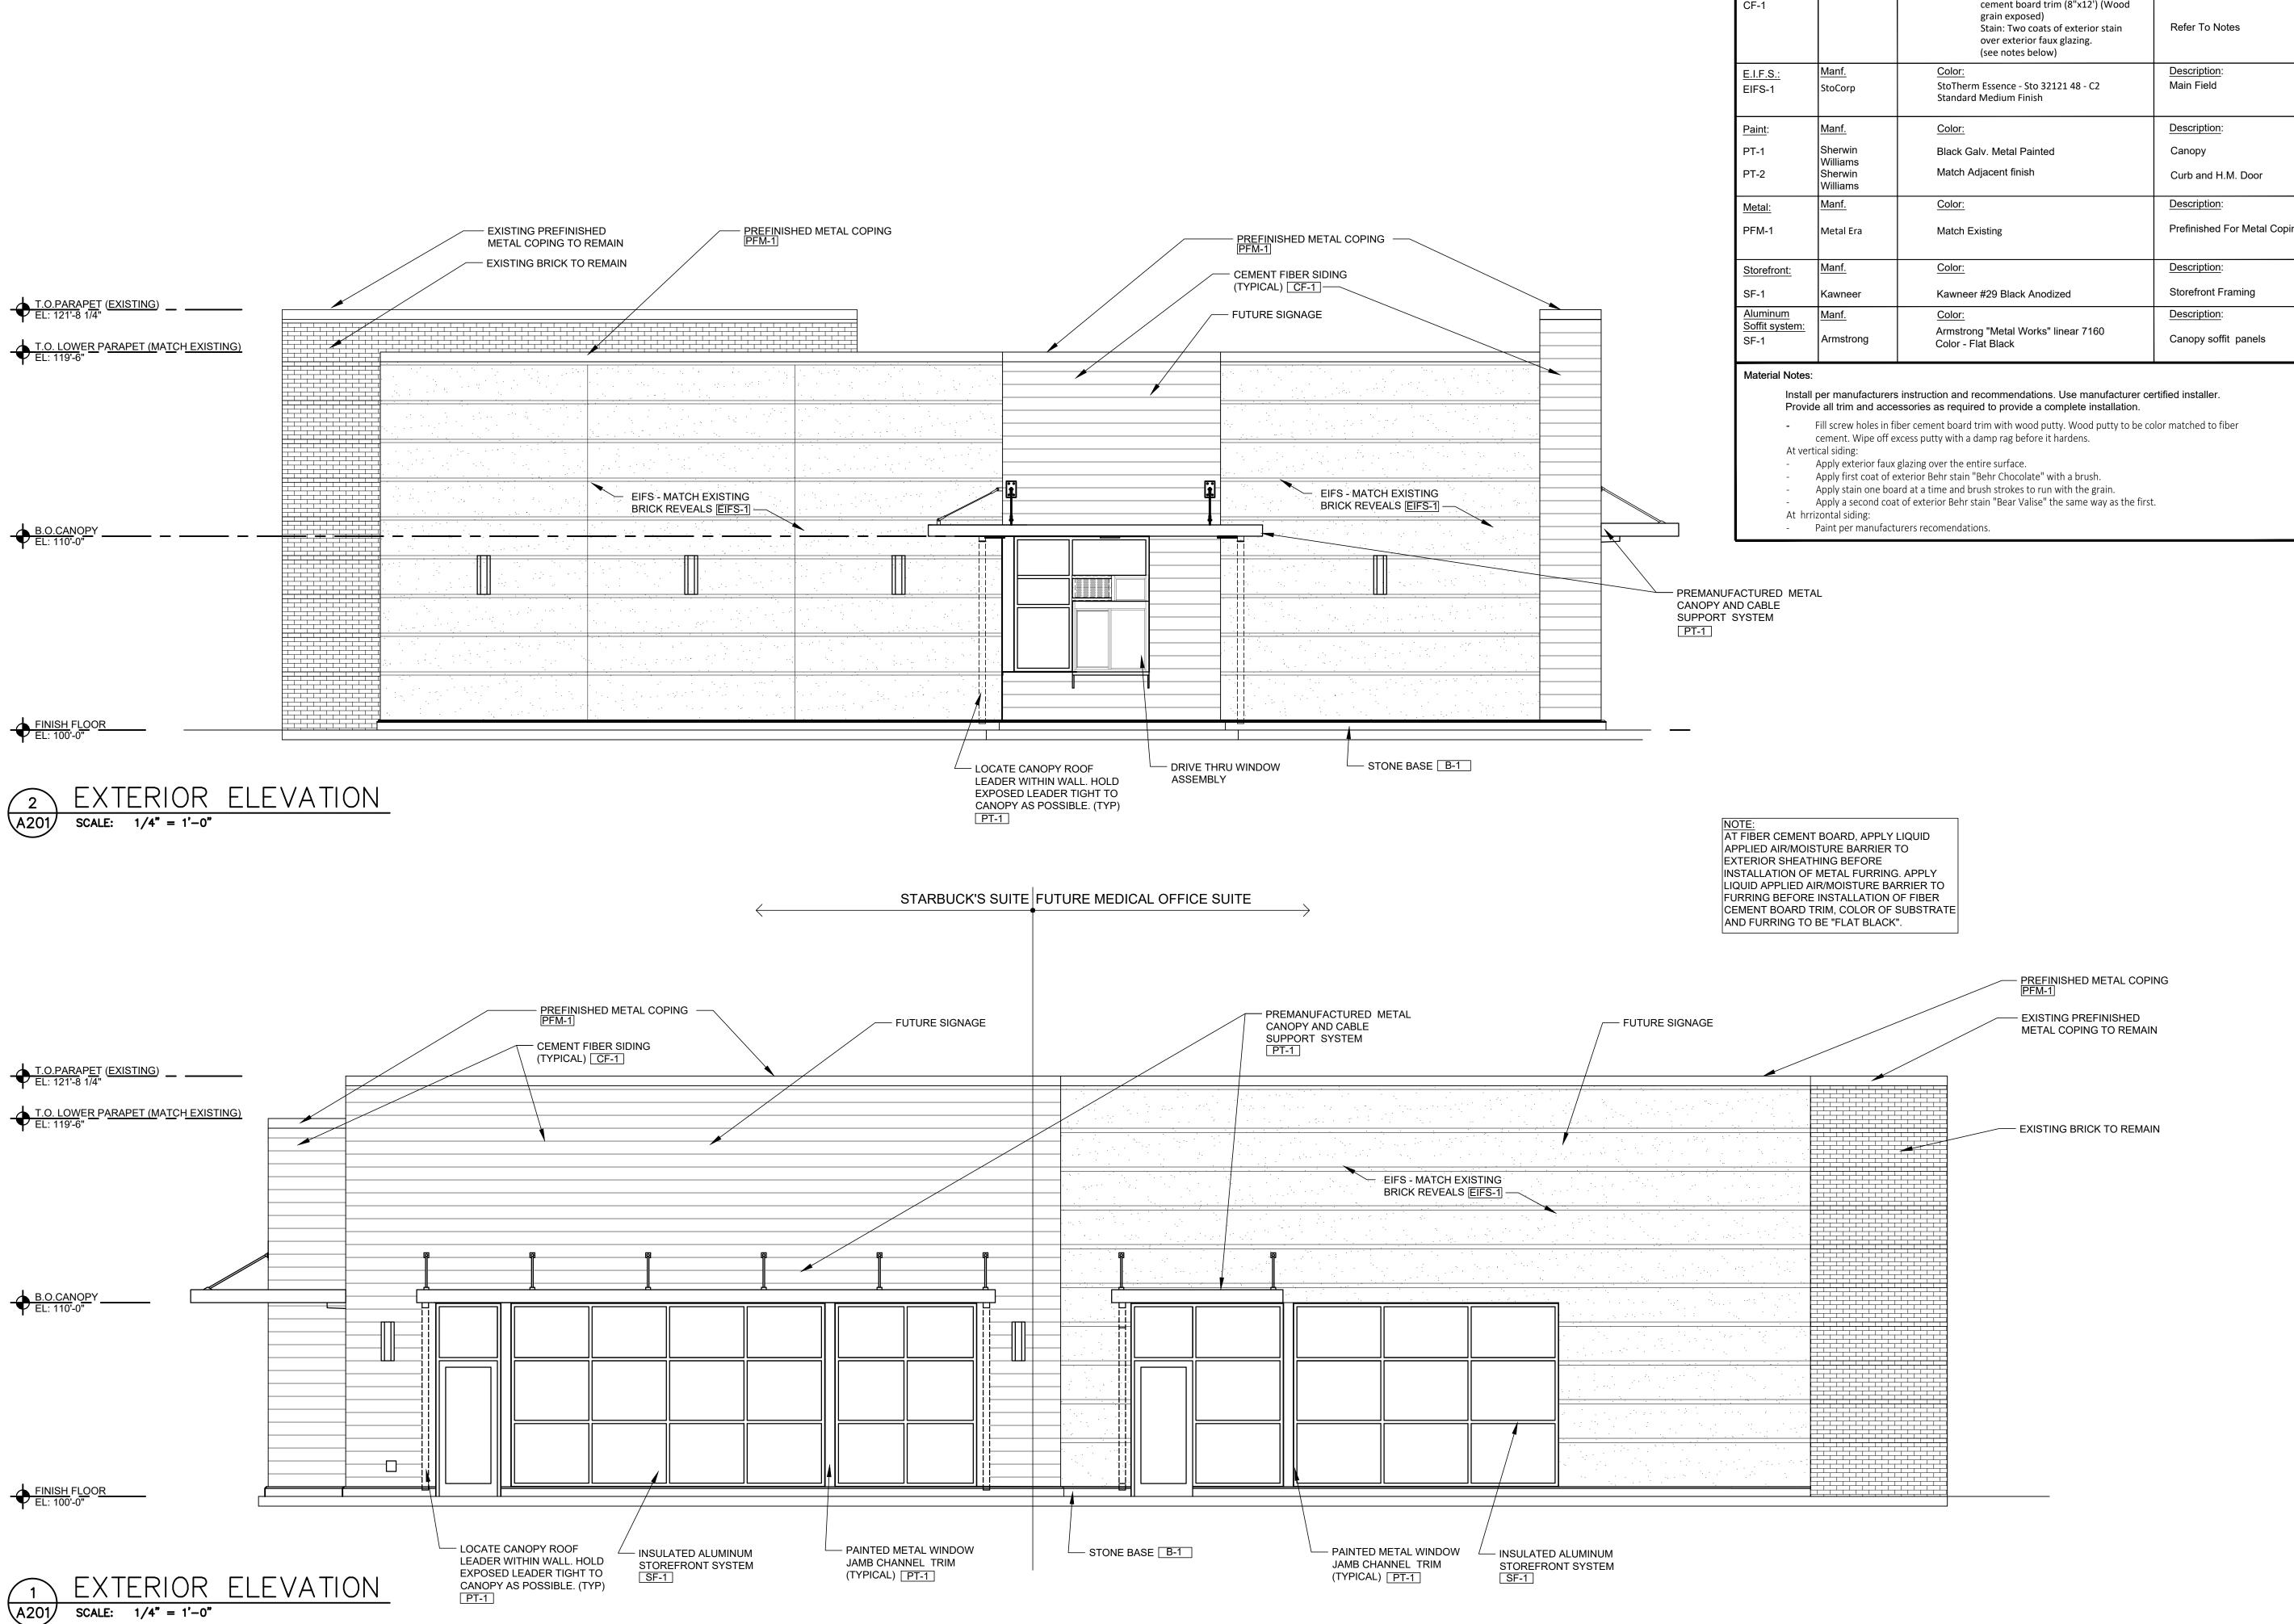

Material Legend Description: Precast base: Manf. Match Cement fiber finish CF-1 Base Cement fiber Description: siding: Siding: Allura 8" trim- 4/4 textured fiber Front and (Street) End Wall CF-1 cement board trim (8"x12') (Wood Prefinished For Metal Coping

> Date 05/12/20 05/27/20 ---1 1 1 1 1 1

Medical Office

Starbucks &

.55 S.W. M-150 HWY EE'S SUMMIT, MO 64802

CASCO DIVERSIFIED CORPORATION ARCHITECTURAL CERTIFICATE OF AUTHORITY #000329 12/31/21

/ BULLOCK A-2004011669

PROFESSIONAL OF RECORD BULLOCK, KEYMA L. License NO. 2004011669 Expiration Date 12/31/20


Drawn By/Checked By: RMT/MSD

00-00-00

Permit Date

EXTERIOR ELEVATIONS

A201

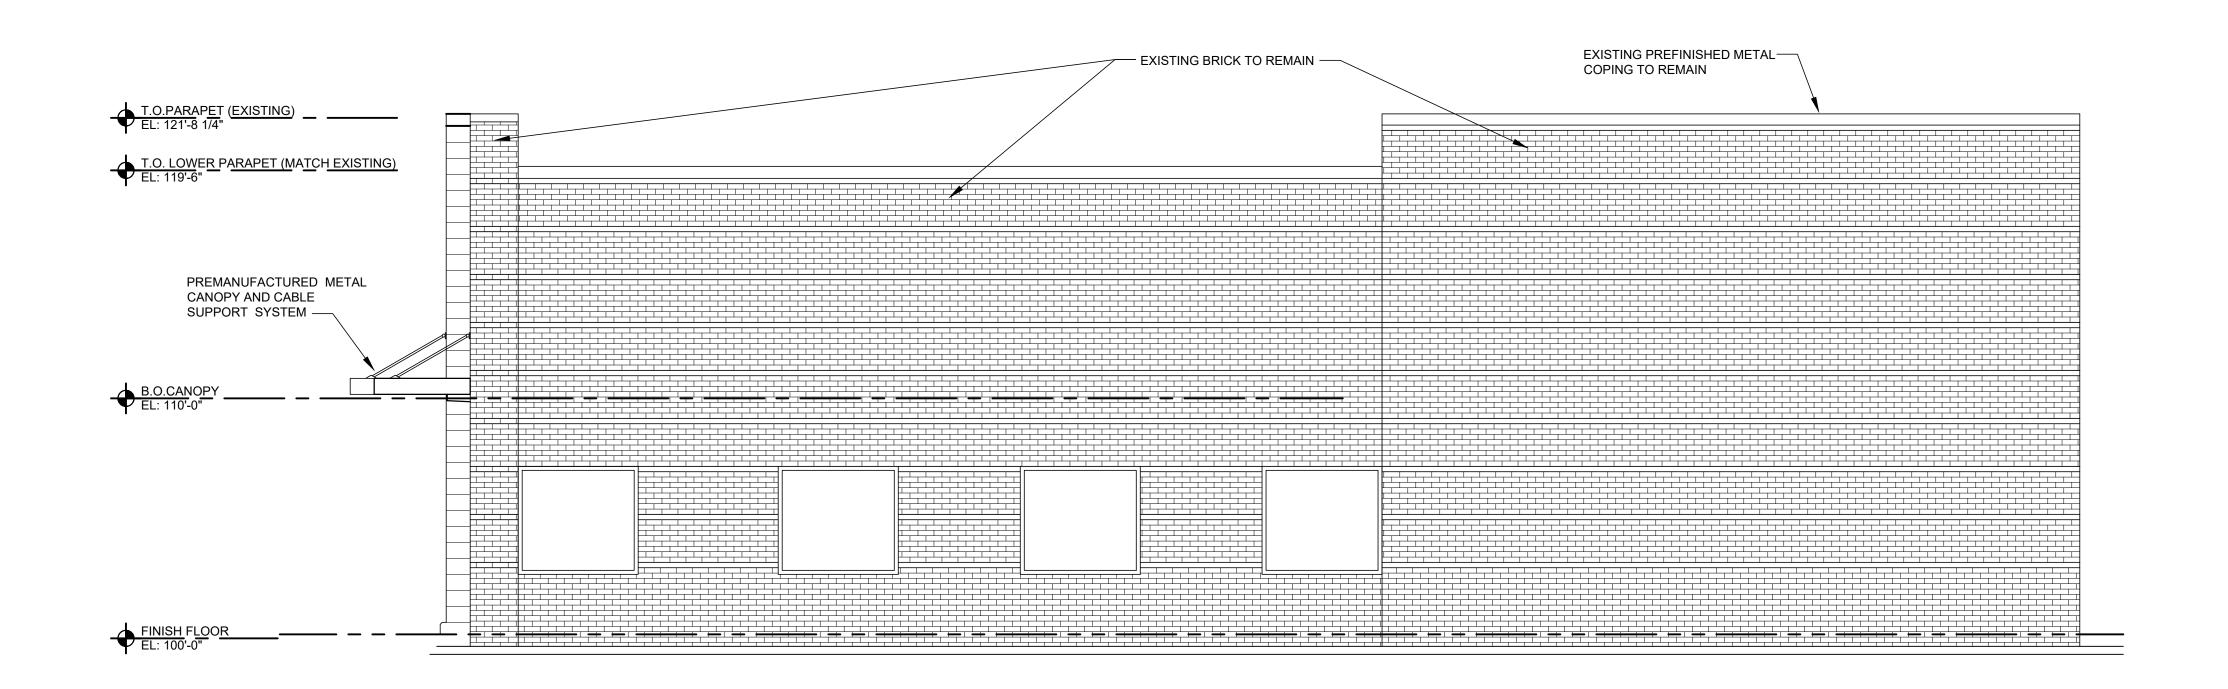

EXTERIOR ELEVATION

SCALE: 1/4" = 1'-0"


Material Legend Precast base: Manf. Color: Description: Match Cement fiber finish CF-1 Base Cement fiber Manf. siding: Siding: Allura 18"- fiber cement cut panel Front and (Street) End Wall (5/16"x 8"x10' cut panel- traditional) Pre finished color: Red Rock Falls Refer To Notes (Wood grain exposed) Trim: Easytrim (Or Equal) Color to match. Description: <u>E.I.F.S.:</u> StoTherm Essence - Sto 32121 48 - C2 Main Field EIFS-1 StoCorp Standard Medium Finish Color: Description: <u>Paint</u>: Sherwin Black Galv. Metal Painted Canopy Williams Match Adjacent finish Sherwin Curb and H.M. Door Williams Manf. Color: Description: Metal: Prefinished For Metal Coping PFM-1 Metal Era Match Existing Description: Color: Storefront: Storefront Framing Kawneer #29 Black Anodized <u>Aluminum</u> Description: Soffit system: Armstrong "Metal Works" linear 7160 Canopy soffit panels Color - Flat Black

Material Notes:

Install per manufacturers instruction and recommendations. Use manufacturer certified installer. Provide all trim and accessories as required to provide a complete installation.

- Fill screw holes in fiber cement board trim with wood putty. Wood putty to be color matched to fiber cement. Wipe off excess putty with a damp rag before it hardens.

NOTE:
AT FIBER CEMENT BOARD, APPLY LIQUID
APPLIED AIR/MOISTURE BARRIER TO
EXTERIOR SHEATHING BEFORE
INSTALLATION OF METAL FURRING. APPLY
LIQUID APPLIED AIR/MOISTURE BARRIER TO
FURRING BEFORE INSTALLATION OF FIBER
CEMENT BOARD TRIM, COLOR OF SUBSTRATE
AND FURRING TO BE "FLAT BLACK"

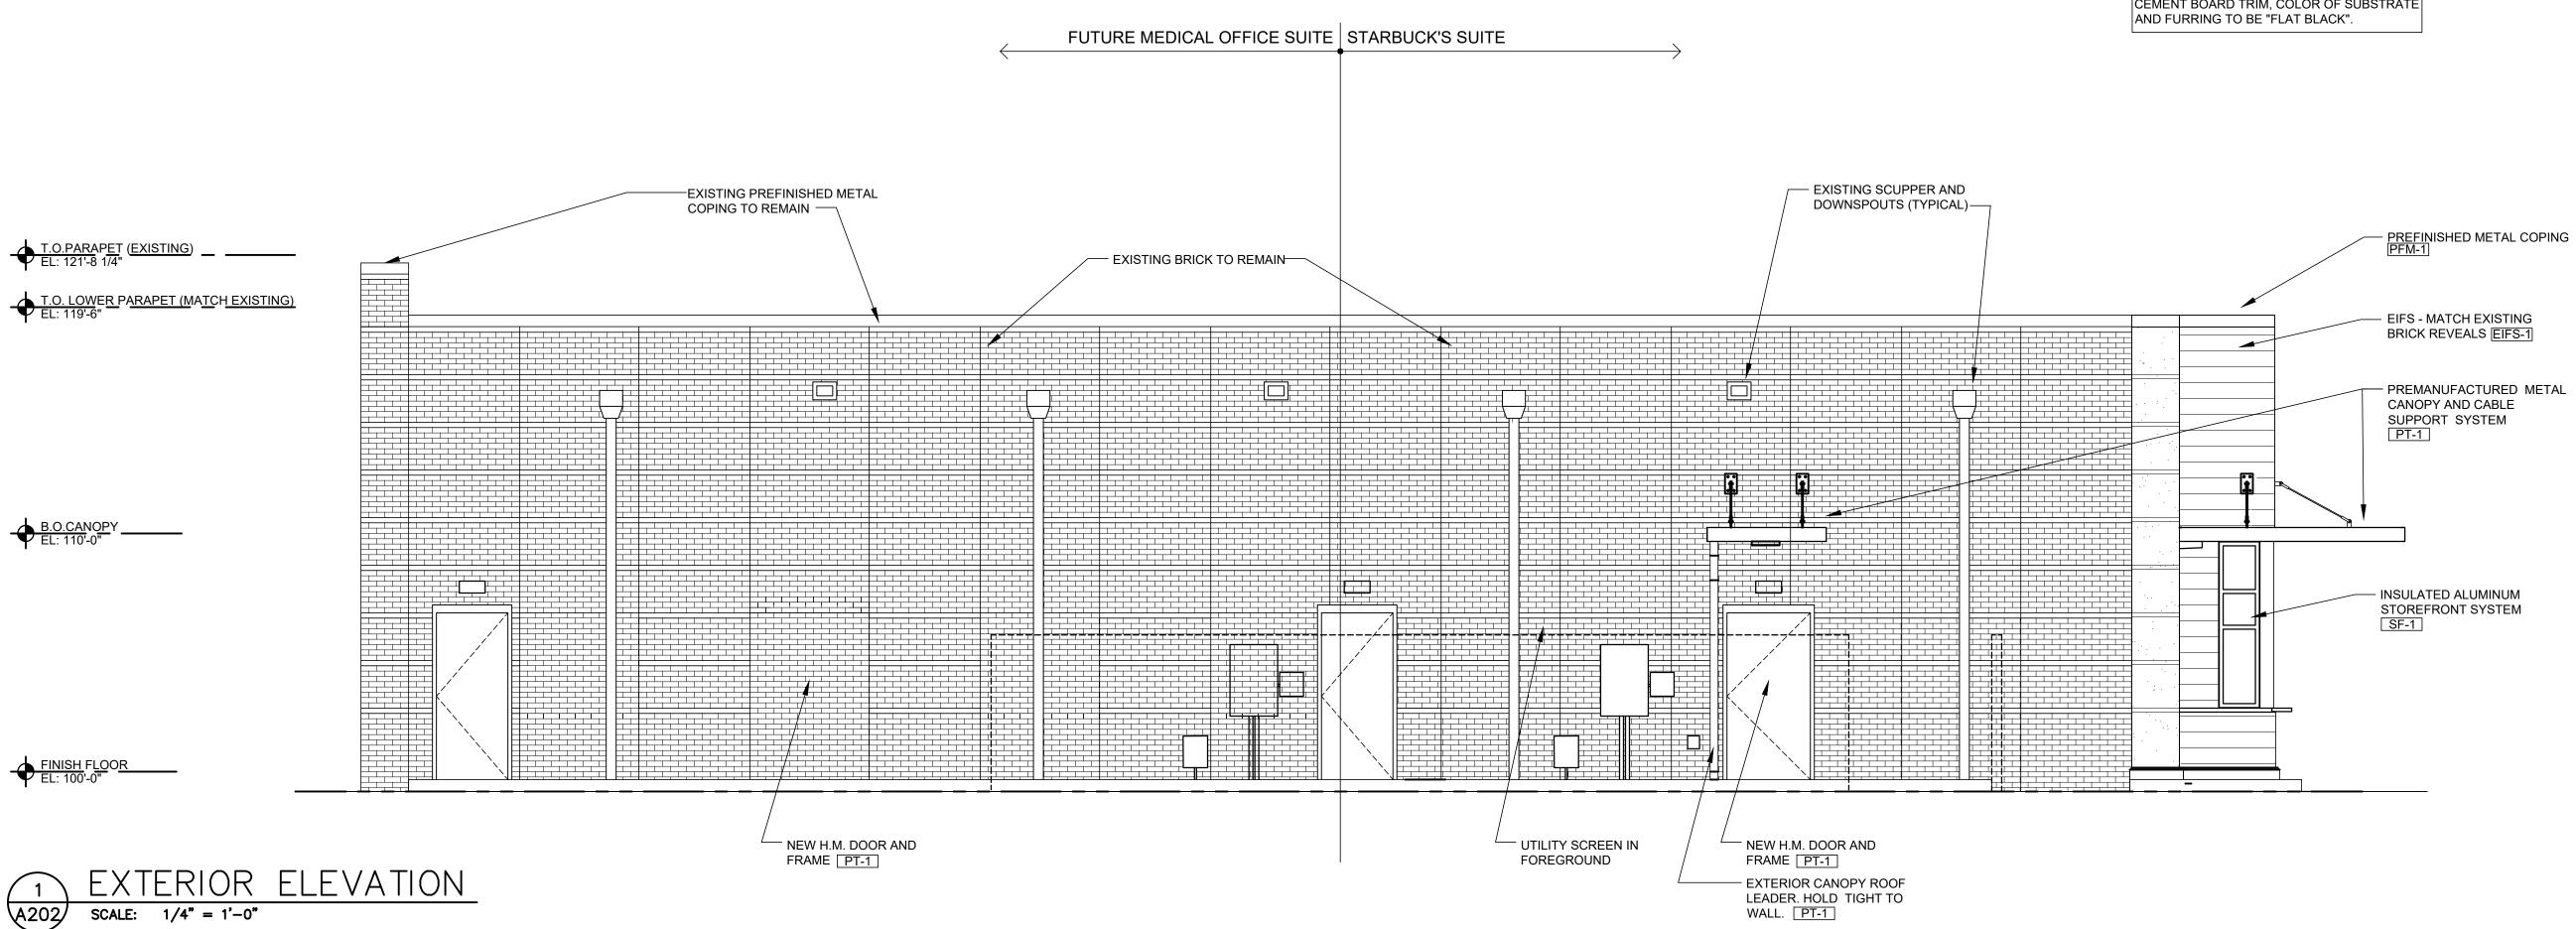

No. Description

No. Description

No. Description

Owner Review
Final Development Plan

Owner Review
Final Development Plan

Owner Review
Final Development Plan

OS/12/20

OS/27/20

OS/2

CASCO DIVERSIFIED CORPORATION ARCHITECTURAL CERTIFICATE OF AUTHORITY #000329 12/31/21



PROFESSIONAL OF RECORD

BULLOCK, KEYMA L.
License NO. 2004011669
Expiration Date 12/31/20

Drawn By/Checked By: RMT/MSD
Project Number 320488

00-00-00

Permit Date

EXTERIOR ELEVATIONS


A202

LOW USE IRRIGATION SYSTEM:

- 1. PROVIDE LAWN IRRIGATION SYSTEM CONSISTING OF MINI JETS, MISTERS, POP-UP RISERS, ADJUSTABLE BUBBLERS, ADJUSTABLE SPRAYERS, DRIPPER NOZZLES (EMITTERS), BACKFLOW PREVENTERS, AUTOMATIC CONTROL VALVES, TIMER, CONTROLLERS AND ALL RELATED ACCESSORIES FOR THE AREAS INDICATED ON THE DRAWINGS AND AS REQUIRED TO COMPLY WITH LOCAL CODES AND REGULATIONS.
- 2. LAWN IRRIGATION CONTRACTOR SHALL PAY ALL ONE-TIME FEES AND CHARGES RELATED TO THIS WORK, INCLUDING WATER SUPPLY AND METERING.
- COORDINATE WITH THE WATER COMPANY AS REQUIRED FOR SERVICE ARRANGEMENTS 4. LAWN IRRIGATION CONTRACTOR SHALL PROVIDE ALL WORK, INCLUDING ALL POWER AND CONTROL WIRING, TESTING, ADJUSTING, AND START-UP AS REQUIRED FOR A COMPLETE, PROPERLY FUNCTIONING SYSTEM.
- 5. AFTER ALL SPRINKLER HEADS AND PLANTINGS ARE INSTALLED, ADJUST SYSTEM FOR OPTIMUM COVERAGE AND COORDINATION WITH PLANTINGS. ADJUST ALL VALVES, ALIGNMENTS, AND COVERGE FOR OPTIMUM PERFORMANCE FOR FINAL APPROVAL BY THE OWNER'S REPRESENTATIVE.
- 6. LAWN IRRIGATION CONTRACTOR SHALL RECOMMEND AND SET THE PROGRAM ON THE CONTROLLER, PROVIDE THOROUGH, DETAILED OPERATING INSTRUCTIONS FOR THIS SPECIFIC SYSTEM, AND GIVE VERBAL OPERATING INSTRUCTIONS TO THE OWNER'S
- 7. LAWN IRRIGATION CONTRACTOR SHALL PROVIDE LAYOUT AND SHOP DRAWINGS FOR APPROVAL BY STATE AND LOCAL BULDING OFFICIALS AND/OR OTHER AGENCIES. LAWN IRRIGATION CONTRACTOR SHALL OBTAIN AND PAY FOR ALL NECESSARY PERMITS AND APPROVALS RELATED TO THIS WORK AND SUBMIT COPIES OF SAME FOR THE OWNER'S

	PLANTING SCHEDULE				
TYPE	BOTANICAL NAME	COMMON NAME	SIZE	SPACING	MISC. NOTES
	EUONYMUS ALATUS 'COMPACTUS'	DWARF BURNING BUSH	#5 CONT.	AS SHOWN	B&B ACCEPTABLE
SHRUBS	NANDINA DOMESTICA	HEAVENLY BAMBOO	#5 CONT.	AS SHOWN	B&B ACCEPTABLE
	SPIRAEA x BUMALDA 'ANTHONY WATERER'	RED SPIREA	#3 CONT.	AS SHOWN	B&B ACCEPTABLE

MULCH DOUBLE SHREDDED BARK MULCH - FROM LOCAL SOURCES (FREE OF DELETERIOUS MATERIALS)

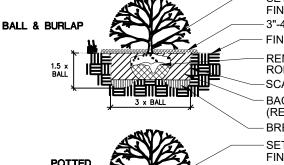

- SET TOP OF ROOT CROWN 1" ABOVE FINISHED GRADE 3"-4" MULCH AS SPEC'D

FINISHED GRADE REMOVE TOP 1/3 OF BURLAP, TWINE

ROPE AND BASKET FROM ROOTBALL SCARIFY SIDES OF PLANTING HOLE BACKFILL WITH SOIL FROM PLANT PIT

(REMOVE ALL DEBRIS, SEE NOTE) BREAK 6" SUB-SOIL AS NECESSARY SET TOP OF ROOT CROWN 1" ABOVE FINISHED GRADE - 3"-4" MULCH AS SPEC'D

- FINISHED GRADE SCARIFY SIDES OF PLANTING HOLE BACKFILL WITH SOIL FROM PLANT PIT (REMOVE ALL DEBRIS, SEE NOTE)


GENERAL NOTES: 1. PRUNE ROOTS IF BALL IS **ROANTBSHIRID**BS AT SAME GROUND LEVEL 2. REMOVE ALL CONTAINERS AND NON-BIODEGRADEABLE BURLAP. 3. WHEN BACKFILLING PLANT PIT, PLACE PLANTING SOIL IN TWO LIFTS. AFTER FIRST LIFT, PUDDLE SOIL IN WITH WATER TO REMOVE ALL AIR POCKETS. PLACE SECOND LIFT AND REPEAT. CONTINUE TO PUDDLE AND FILL AS NECCESSARY.


PLANTING DTL.: SHRUBS

PLANTING SPECIFICATIONS AND GENERAL NOTES:

- 1. PLANTING BED PREPARATION: ALL MASS PLANTING BEDS SHALL BE TILLED TO A MINIMUM DEPTH OF 10". AMENDMENTS (LEAF MOLD OR SPHAGNUM PEAT MOSS) SHALL BE APPLIED DURING CULTIVATION. ALL BEDS ARE TO BE GRADED SMOOTH BEFORE PLANTING. PLANT GROUNDCOVER TO WITHIN 12" OF TREES OR SHRUBS. REMOVE ALL STONES LARGER THAN 2", ALL STICKS, ROOTS, RUBBISH AND ANY OTHER EXTRANEOUS MATERIALS.
- 2. BACKFILL SOIL: USE SOIL EXCAVATED FROM PLANTING HOLES AND PROVIDE AMENDMENTS (1 PART LEAF MOLD OR SPHAGNUM PEAT MOSS AND 3 PARTS EXCAVATED SOIL). ALL NEW TOPSOIL USED SHALL BE FREE OF WEEDS AND OTHER FOREIGN VEGETATION, AS WELL AS, STONES LARGER THAN 2", ALL STICKS, ROOTS, RUBBISH AND ANY OTHER EXTRANEOUS
- 3. FERTILIZATION: ALL PLANT MATERIALS SHALL BE FERTILIZED UPON INSTALLATION WITH DRIED BONE MEAL OR OTHER SPECIFIED FERTILIZER MIXED IN WITH THE PLANTING SOIL PER THE MANUFACTURER'S INSTRUCTIONS. UNLESS NOTED OTHERWISE.
- 4. MULCH MATERIAL: CRUSHED VOLCANIC CINDERS COLOR TO BE REDDISH BLACK BLEND. MULCH ALL PLANTINGS TO A 3"-4" DEPTH.
- 5. FERTILIZER: JUMP-SHOT ROOT STIMULATOR AS MANUFACTURED BY GORDON OR APPROVED EQUAL, SHALL BE APPLIED TO THE SOIL BACKFILL OF EACH PLANT DURING INSTALLATION.
- 6. ALL PLANT MATERIAL SHALL COMPLY WITH THE LATEST EDITION OF THE AMERICAN STANDARD FOR NURSERY STOCK, AMERICAN ASSOCIATION OF NURSERYMEN.
- 7. LANDSCAPE CONTRACTOR SHALL GUARANTEE NEW PLANT MATERIALS THROUGH ONE CALENDAR YEAR FROM THE DATE OF OWNER ACCEPTANCE WITH ALL REPLACEMENTS TO BE PROVIDED AT NO ADDITIONAL COST TO THE OWNER.
- 8. LANDSCAPE CONTRACTOR IS RESPONSIBLE FOR ON-GOING MAINTENANCE OF ALL NEWLY INSTALLED MATERIALS UNTIL TIME OF OWNER ACCEPTANCE. ANY ACTS OF VANDALISM OR DAMAGE WHICH MAY OCCUR PRIOR TO OWNER ACCEPTANCE SHALL BE THE RESPONSIBILITY OF THE CONTRACTOR.
- 9. WARRANTY FOR LANDSCAPE MATERIALS SHALL BEGIN ON THE DATE OF ACCEPTANCE BY THE OWNER'S REPRESENTATIVE AFTER THE COMPLETION OF PLANTING OF ALL LANDSCAPE MATERIALS. NO PARTIAL ACCEPTANCE WILL BE CONSIDERED. LANDSCAPE CONTRACTOR SHALL PROVIDE A WRITTEN REQUEST FOR THE OWNER'S ACCEPTANCE INSPECTION. REMOVE AND REPLACE DEAD PLANT MATERIAL (25% + DEAD) IMMEDIATELY UNLESS REQUIRED TO PLANT IN THE SUCCEEDING PLANTING SEASON. A LIMIT OF ONE REPLACEMENT OF EACH TREE AND SHRUB WILL BE REQUIRED, EXCEPT FOR LOSSES CAUSED BY CONTRACTOR'S ERRORS.
- 10. LANDSCAPE CONTRACTOR SHALL BE RESPONSIBLE FOR CLEAN-UP OF SITE AT THE COMPLETION OF LANDSCAPING EACH DAY. AT ALL TIMES SHALL THE SIDEWALKS BE MAINTAINED CLEAN AND FREE OF DEBRIS. REMOVE SURPLUS SOIL AND WASTE MATERIAL, TRASH AND DEBRIS FROM THE SITE AND LEGALLY DISPOSE OF SAME IN ACCORDANCE WITH FEDERAL, STATE AND LOCAL CODES AND REGULATIONS.
- 11. ALL PLANTS TO BE INSTALLED AS PER PLANTING DETAILS. PLANT MATERIALS ARE TO BE PLANTED IN THE SAME RELATIONSHIP TO GRADE AS WAS GROWN IN NURSERY CONDITIONS. IF WET, CLAY SOILS OR POOR DRAINING SOILS ARE EVIDENT, PLANT HIGHER. REMOVE ALL TWINE, WIRE AND BURLAP FROM TOP 1/3 OF ROOT BALL AND FROM TREE TRUNKS.
- 12. MULCHING AND WATERING OF ALL PLANTS & TREES SHALL BE IMMEDIATELY OR WITHIN 16 HOURS AFTER INSTALLATION.



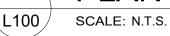

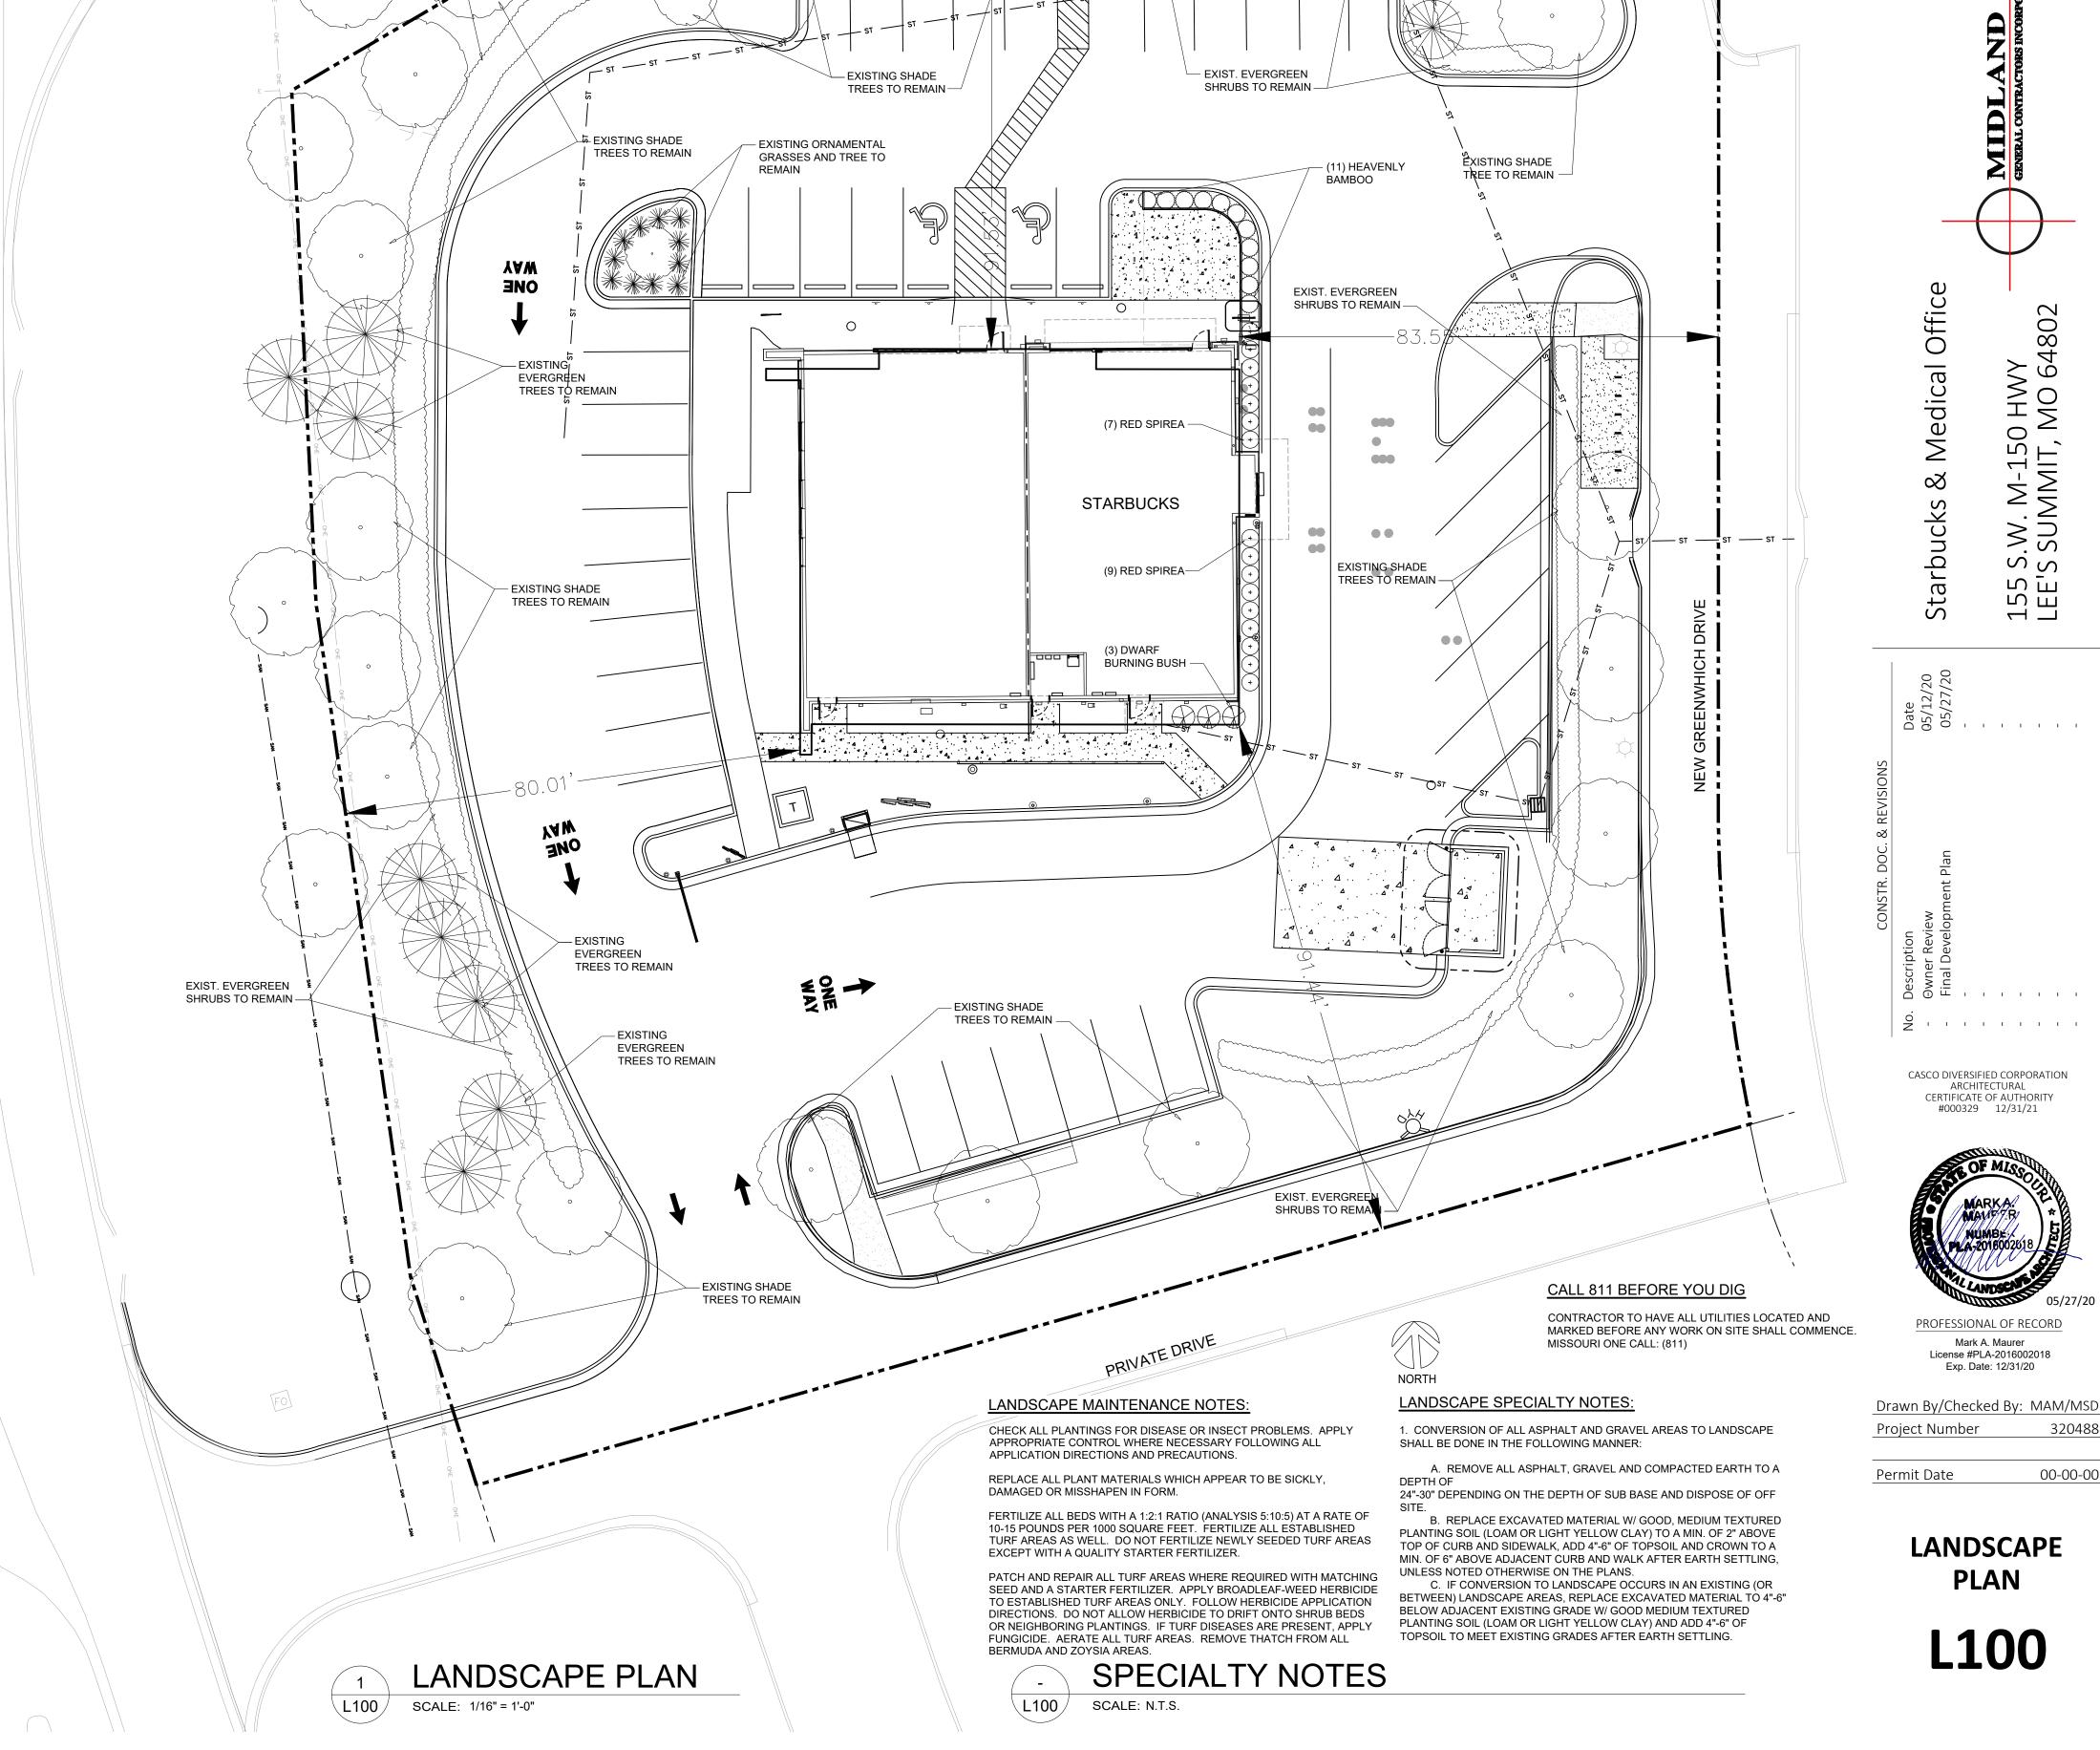

SW HIGHWAY 150

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CASCO DIVERSIFIED CORPORATION ARCHITECTURAL

CERTIFICATE OF AUTHORITY

#000329 12/31/21

PROFESSIONAL OF RECORD

Mark A. Maurer

License #PLA-2016002018

Exp. Date: 12/31/20

LANDSCAPE

00-00-00

EXISTING


TO REMAIN

EVERGREEB

TREES TO REMAIN -

EXIST. EVERGREEN


SHRUBS TO REMAIN -

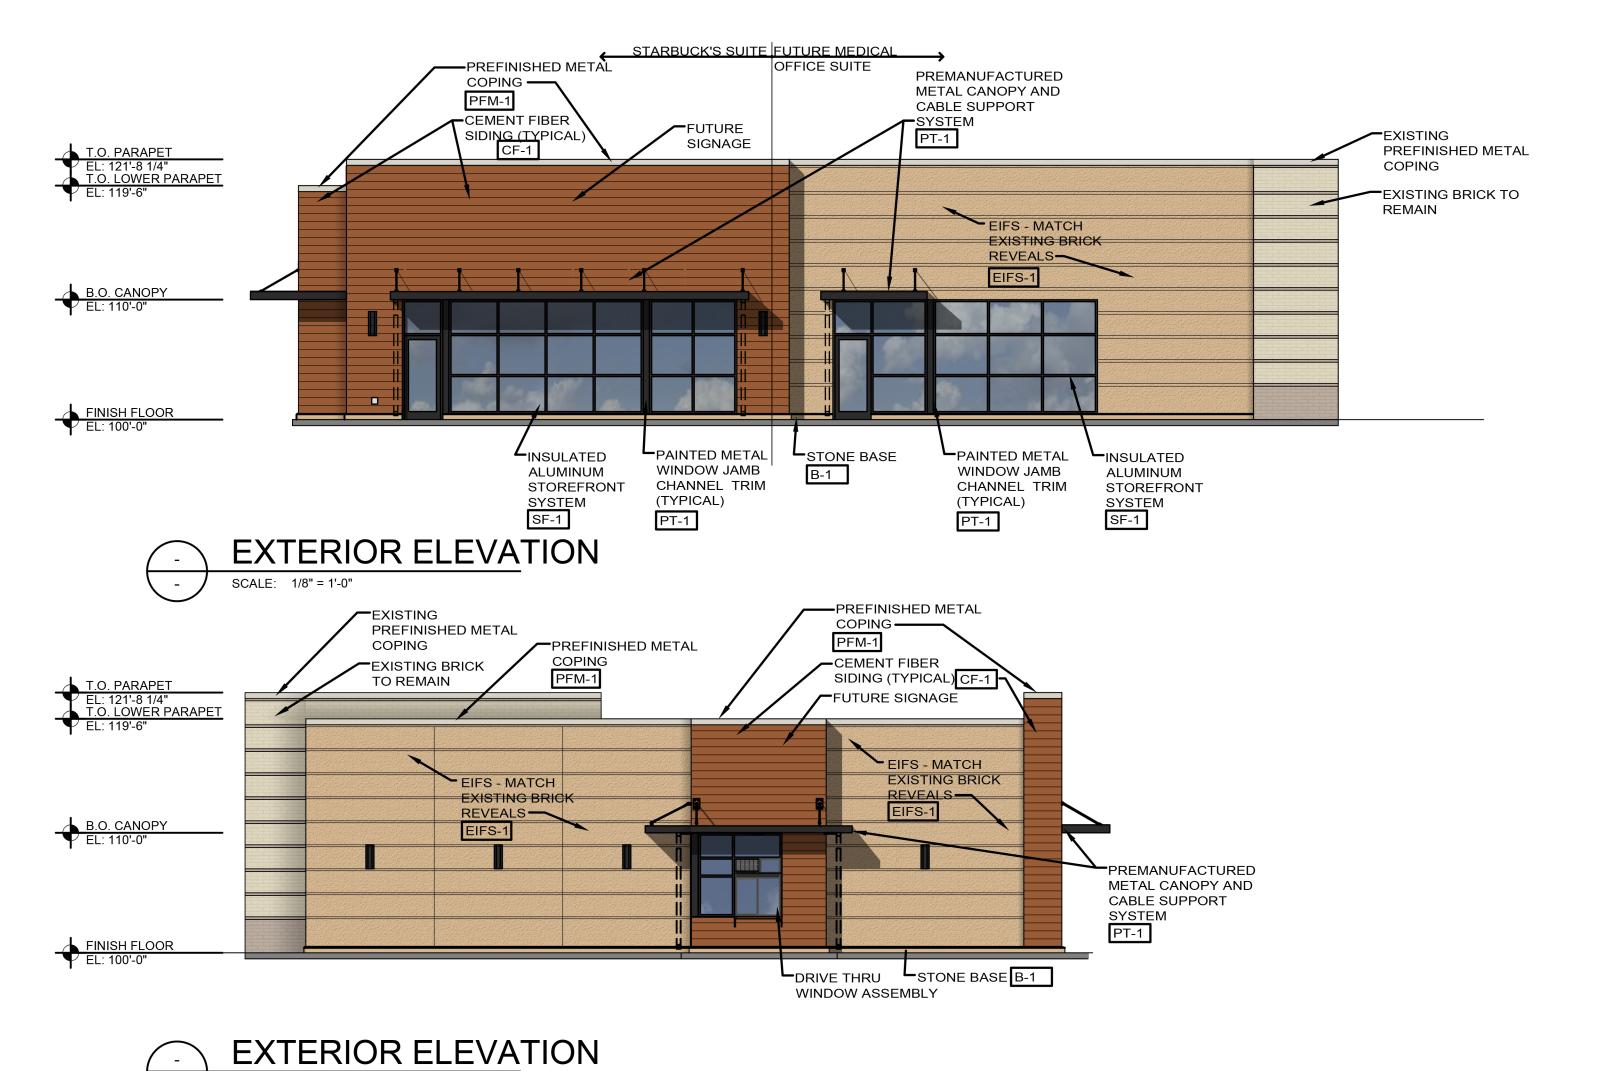

EXISTING PREFINISHED METAL

COPING —

Precast base:	Manf.	Color:	Description:	
B-1		Match Cement fiber finish CF-1	Base	
Cement fiber siding: CF-1	Manf. Allura	Color: Siding: Allura 8" trim- 4/4 textured fiber cement board trim (8"x12") (Wood grain exposed) Stain: Two coats of exterior stain over exterior faux glazing. (see notes below)	Description: Front and (Street) End Wall Refer To Notes	
E.I.F.S.:	Manf.	Color:	Description:	
EIFS-1	StoCorp	StoTherm Essence - Sto 32121 48 - C2 Standard Medium Finish	Main Field	
Paint:	Manf.	Color:	Description:	
PT-1	Sherwin	Black Galv. Metal Painted	Canopy	
PT-2	Williams Sherwin Williams	Match Adjacent finish	Curb and H.M. Door	
Metal:	Manf.	Color:	Description:	
PFM-1	Metal Era	Match Existing	Prefinished For Metal Coping	
Storefront:	Manf.	Color:	Description:	
SF-1	Kawneer	Kawneer #29 Black Anodized	Storefront Framing	
Aluminum	Manf.	Color:	Description:	
SF-1 Armstrong		Armstrong "Metal Works" linear 7160 Color - Flat Black	Canopy soffit panels	
Provid -	per manufacturers i de all trim and acces Fill screw holes in fibe	nstruction and recommendations. Use manufacturer consories as required to provide a complete installation. The rement board trim with wood putty. Wood putty to be conserved by the construction of the const		

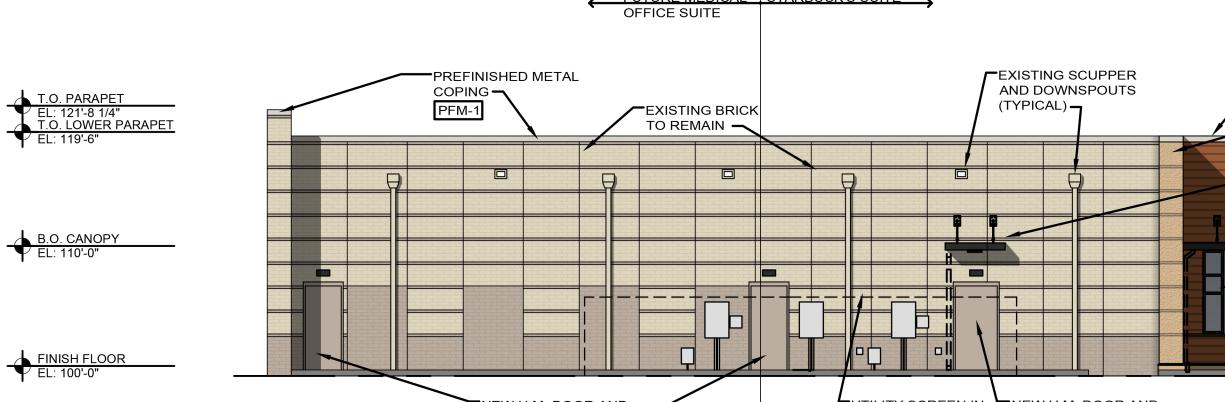

At hrrizontal siding:

Paint per manufacturers recomendations.

FUTURE MEDICAL STARBUCK'S SUITE PREFINISHED METAL COPING PFM-1 EIFS - MATCH EXISTING BRICK REVEALS EIFS-1 PREMANUFACTURED
METAL CANOPY AND
CABLE SUPPORT
SYSTEM PT-1 ALUMINUM STOREFRONT SYSTEM SF-1 NEW H.M. DOOR AND FRAME PT-2

EXTERIOR ELEVATION

SCALE: 1/8" = 1'-0" UTILITY SCREEN IN NEW H.M. DOOR AND FOREGROUND FRAME PT-2

Apply a second coat of exterior Behr stain "Bear Valise" the same way as the first.

320488 Project Number

Starbucks & Medical Office

155 S.W. M-150 HWY LEE SUMMIT, MO 64802

PREMANUFACTURED METAL CANOPY AND CABLE SUPPORT SYSTEM -B.O. CANOPY EL: 110'-0" FINISH FLOOR EL: 100'-0"

EXISTING BRICK TO

EXTERIOR ELEVATION SCALE: 1/8" = 1'-0"

T.O. PARAPET
EL: 121'-8 1/4"
T.O. LOWER PARAPET