

AN ORDINANCE APPROVING A PRELIMINARY DEVELOPMENT PLAN LOCATED ON LOT 3B DEERBROOK COMMERCIAL PARK IN DISTRICT CP-2, PROPOSED ATTIC STORAGE, INDOOR CLIMATE CONTROLLED STORAGE FACILITY IN ACCORDANCE WITH THE PROVISIONS OF CHAPTER 33, THE UNIFIED DEVELOPMENT ORDINANCE OF LEE'S SUMMIT CODE OF ORDINANCES, FOR THE CITY OF LEE'S SUMMIT, MISSOURI.

WHEREAS, Application #PL2018-121, submitted by Strickland Construction, requesting approval of a preliminary development plan in District CP-2 (Planned Community Commercial District) on land located on *Lot 3B, Deerbrook Commercial Park* was referred to the Planning Commission to hold a public hearing; and,

WHEREAS, the Unified Development Ordinance provides for the approval of a preliminary development plan by the City following public hearings by the Planning Commission and City Council; and,

WHEREAS, after due public notice in the manner prescribed by law, the Planning Commission held a public hearing for the consideration of the preliminary development plan on February 14, 2019, and rendered a report to the City Council recommending that the preliminary development plan be approved; and,

WHEREAS, after due public notice in the manner prescribed by law, the City Council held a public hearing on March 5, 2019, and approved a motion for a second ordinance reading to approve the preliminary development plan for said property.

NOW, THEREFORE, BE IT ORDAINED BY THE COUNCIL OF THE CITY OF LEE'S SUMMIT, MISSOURI, as follows:

SECTION 1. That a preliminary development plan is hereby approved in District CP-2 on the following described property:

Section 32, Township 48 North, Range 31 West, in Lee's Summit, Jackson County, Missouri, being described as follows:

*LOT 3B, DEERBROOK COMMERCIAL PARK, LOTS 3A & 3B, A SUBDIVISION IN LEE'S SUMMIT, JACKSON COUNTY, MISSOURI.*

SECTION 2. That the following conditions of approval apply:

1. A modification shall be granted to the maximum allowable 0.55 FAR in the CP-2 district, to allow 0.92 FAR.
2. The pilaster located on the northeast corner of the building shall incorporate more architectural detail, adding depth and interest as it wraps around towards the interior of the building.
3. The glass windows on the second and third stories shall be opaque.
4. Development shall be in accordance with the preliminary development plan date stamped January 22, 2019.

5. The shared private driveway shall be designated as a fire lane in accordance with City Ordinances.

SECTION 3. That development shall be in accordance with the preliminary development plan, date stamped January 22, 2019.

SECTION 4. Nonseverability. All provisions of this ordinance are so essentially and inseparably connected with, and so dependent upon, each other that no such provision would be enacted without all others. If a court of competent jurisdiction enters a final judgment on the merits that is not subject to appeal and that declares any provision or part of this ordinance void, unconstitutional, or unenforceable, then this ordinance, in its collective entirety, is invalid and shall have no legal effect as of the date of such judgment.


SECTION 5. That failure to comply with all of the provisions contained in this ordinance shall constitute violations of both this ordinance and Chapter 33, the City's Unified Development Ordinance, of the Code of Ordinances for the City of Lee's Summit.

SECTION 6. That this ordinance shall be in full force and effect from and after the date of its passage and adoption, and approval by the Mayor.

PASSED by the City Council of the City of Lee's Summit, Missouri, this 19<sup>th</sup> day of March, 2019.

  
\_\_\_\_\_  
Mayor William A. Baird

ATTEST:

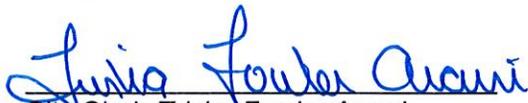  
\_\_\_\_\_  
City Clerk *Trisha Fowler Arcuri*

APPROVED by the Mayor of said city this 20<sup>th</sup> day of March, 2019.

  
\_\_\_\_\_  
Mayor William A. Baird

ATTEST:

  
\_\_\_\_\_  
City Clerk Trisha Fowler Arcuri

APPROVED AS TO FORM:

  
\_\_\_\_\_  
Nancy K. Yendes, Chief Counsel  
Infrastructure and Planning



# LEE'S SUMMIT MISSOURI

## DEVELOPMENT REVIEW FORM TRANSPORTATION IMPACT

**DATE:** February 6, 2019  
**CONDUCTED BY:** Michael K Park, PE, PTOE  
**SUBMITTAL DATE:** January 22, 2019  
**PHONE:** 816.969.1800  
**APPLICATION #:** PL2018121  
**EMAIL:** Michael.Park@cityofls.net  
**PROJECT NAME:** ATTIC STORAGE  
**PROJECT TYPE:** Prel Dev Plan (PDP)

### SURROUNDING ENVIRONMENT *(Streets, Developments)*

The proposed development is located north of Deerbrook Street, east of M-291 Highway. An existing fitness center is located to the immediate south of the proposed development along Deerbrook Street. M-291 Highway is located to the west, there is undevelopable land to the immediate north without access to Mulberry Street due to topography impediments, and residential property to the east.

### ALLOWABLE ACCESS

The proposed development will be accessed from an existing shared driveway and parking areas that were planned and built in association with the neighboring business. The shared driveway has access to Deerbrook Street. Deerbrook Street intersects M-291 Highway.

### EXISTING STREET CHARACTERISTICS *(Lanes, Speed limits, Sight Distance, Medians)*

Deerbrook Street is a two-lane, undivided, collector with a 25 mph speed limit. The intersection of Deerbrook Street at M-291 Highway is traffic signal controlled with turn lanes upon each approach. M-291 Highway is a four-lane, limited access, median divided state highway owned and managed by the Missouri Department of Transportation (MoDOT). M-291 Highway has a 45 mph speed limit near the proposed development. There are no sight distance concerns within the study area.

**ACCESS MANAGEMENT CODE COMPLIANCE?**      **Yes**       **No**

The proposed development plan and access is in compliance with the City's Access Management Code. The proposed development has no direct access to the public street network.

### TRIP GENERATION

Time Period	Total	In	Out
Weekday	256	128	128
A.M. Peak Hour	14	8	6
P.M. Peak Hour	27	13	14

The trip generation shown above was determined based on the proposed development using the ITE Trip Generation Manual, 10th Edition.

**TRANSPORTATION IMPACT STUDY REQUIRED?**

YES

NO

The proposed development will not likely generate more than 100 vehicle trips to the surrounding street system during any given peak hour, a condition that requires a traffic impact study based on the Access Management Code.

Considering the amount of traffic likely generated by the proposed development during peak hours and the existing roadway conditions, capacity and other factors of future growth near the proposed development that provide access, there are no concerns regarding the impact of the proposed development to traffic safety or traffic operations.

**LIVABLE STREETS (Resolution 10-17)**

COMPLIANT

EXCEPTIONS

The proposed preliminary development plan includes all Livable Streets elements identified in the City's adopted Comprehensive Plan, associated Greenway Master Plan and Bicycle Transportation Plan attachments, and elements otherwise required by ordinances and standards, including but not limited to sidewalk, connectivity and accessibility. No exceptions to the Livable Streets Policy adopted by Resolution 10-17 have been proposed.

**RECOMMENDATION:**

APPROVAL

DENIAL


N/A

STIPULATIONS

*Recommendations for Approval refer only to the transportation impact and do not constitute an endorsement from City Staff.*

Staff recommends approval of the proposed preliminary development plan.



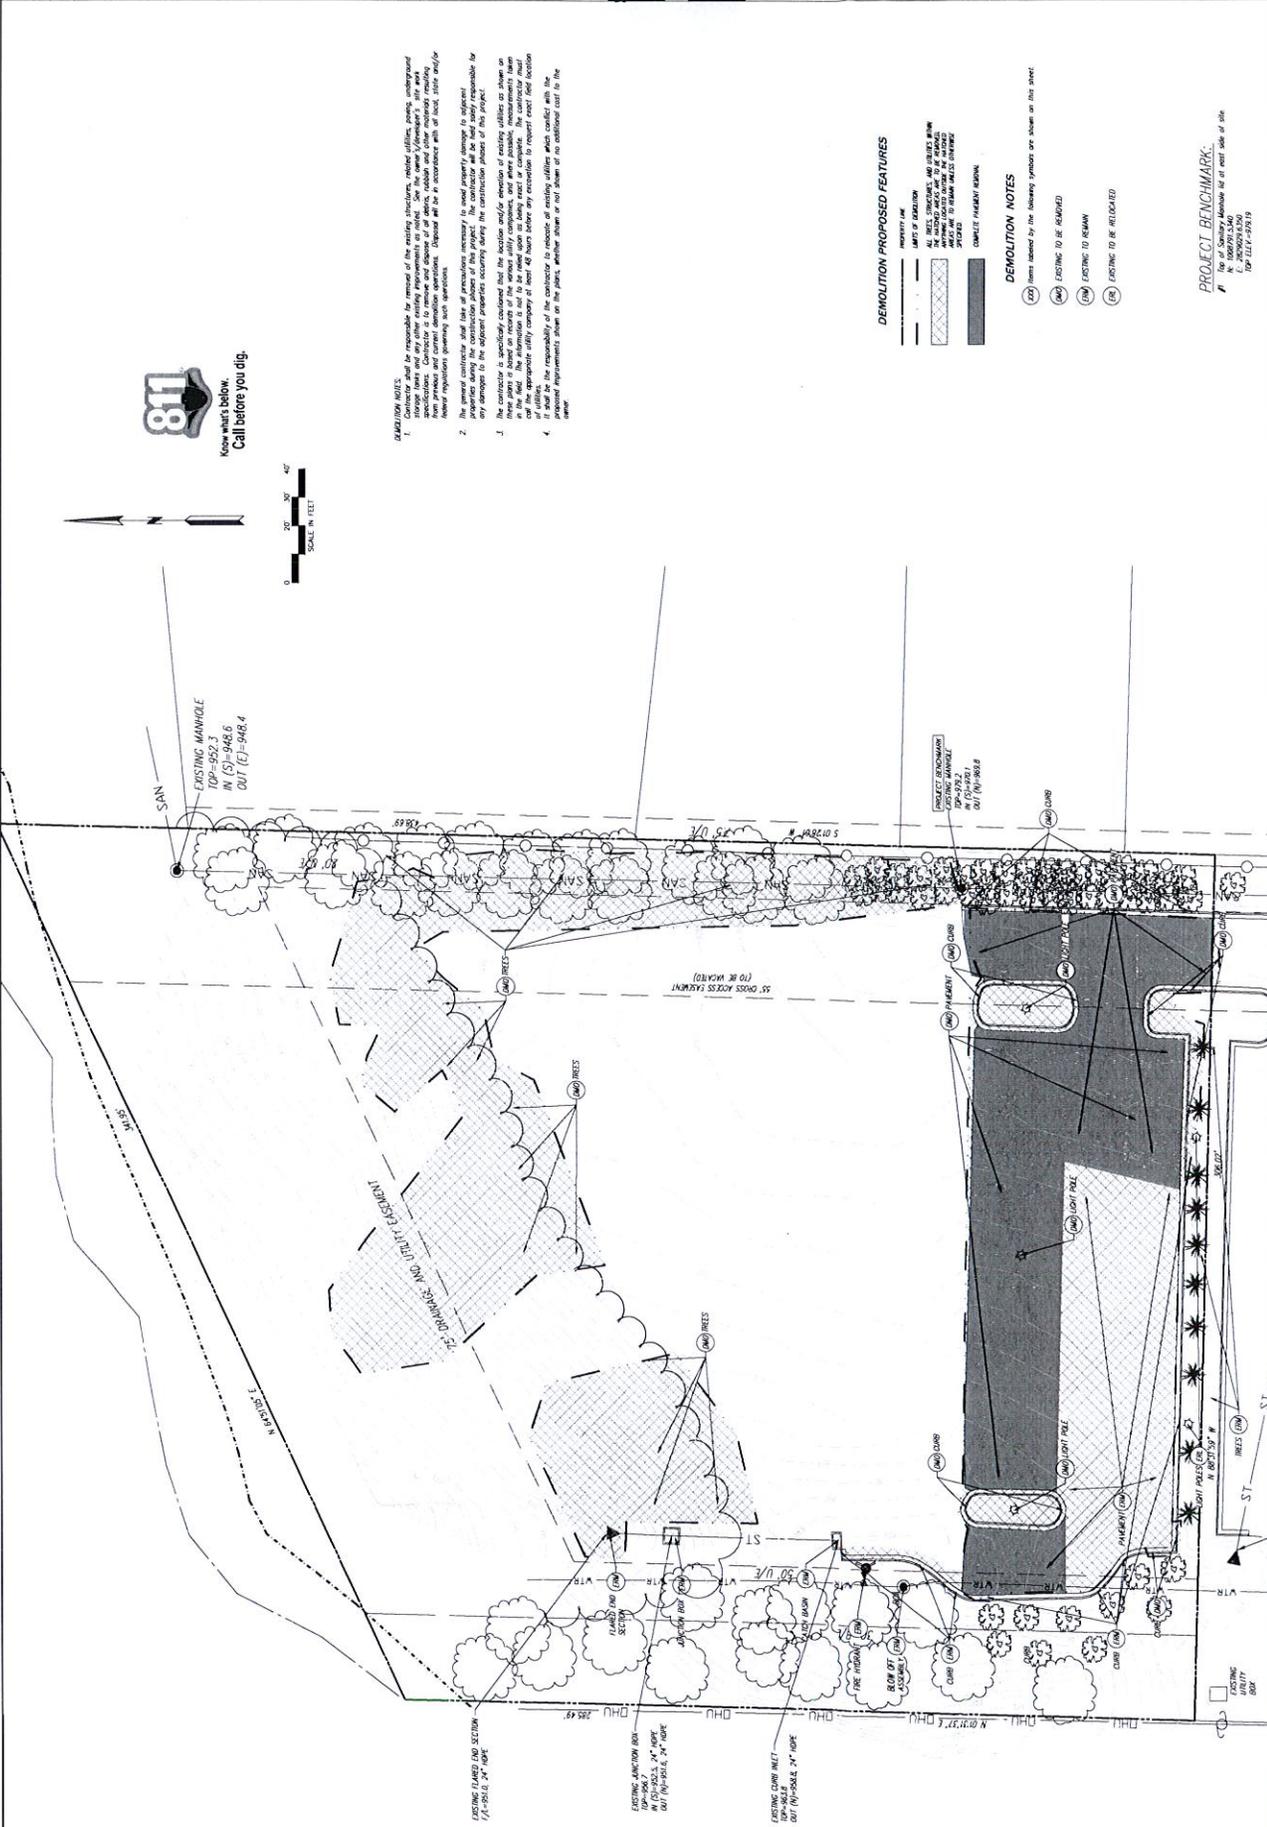

811  
Know what's below.  
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0 20 40  
SCALE IN FEET

**811 CALL NOTES:**

- Contractor shall be responsible for removal of the existing structures, related utilities, ponds, underground storage tanks and any other existing improvements on record. See the owner's/contractor's site work from previous and current demolition operations. Disposal will be in accordance with all local, state and/or federal regulations governing such operations.
- Contractor shall be responsible for any damage to the adjacent properties occurring during the construction phases of this project. The contractor shall be held solely responsible for any damage to the adjacent properties occurring during the construction phases of this project.
- The contractor is specifically cautioned that the location and/or elevation of existing utilities as shown on the plan is not a guarantee of their location and/or depth. The contractor shall be responsible for locating and/or marking all utilities in the field. The contractor shall be held solely responsible for any damage to the adjacent properties occurring during the construction phases of this project. The contractor shall be held solely responsible for any damage to the adjacent properties occurring during the construction phases of this project.
- It shall be the responsibility of the contractor to relocate or remove all existing utilities which conflict with the proposed improvements shown on the plan, whether shown or not shown on any additional call to the owner.

**DEMOLITION PROPOSED FEATURES**





- PROPERTY LINE
- LIMITS OF EXISTENCE
- ALL REEL, STRUCTURAL AND OTHER WORK TO BE REMOVED SHALL BE SHOWN WITH A HATCH PATTERN AS SHOWN BELOW.
- EXISTING TO REMAIN
- COMPLETE EXISTING IMPROVEMENT

**DEMOLITION NOTES**

- (AD) Items shown by the following symbols are shown on this sheet.
- (RM) EXISTING TO BE REMOVED
- (RM) EXISTING TO REMAIN
- (RM) EXISTING TO BE RELOCATED

**PROJECT BENCHMARK:**  
Top of Survey Marker set at east side of site  
N 1006979.540  
E 1000000.000  
TOP 1211-2378



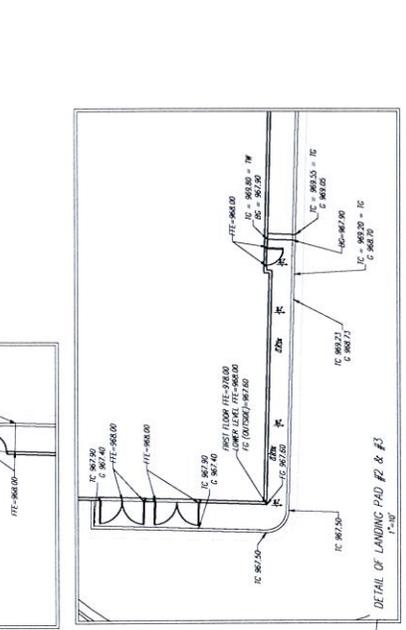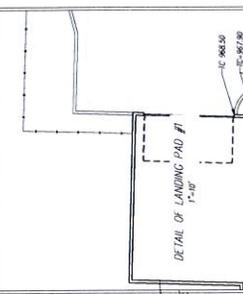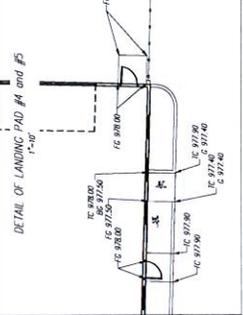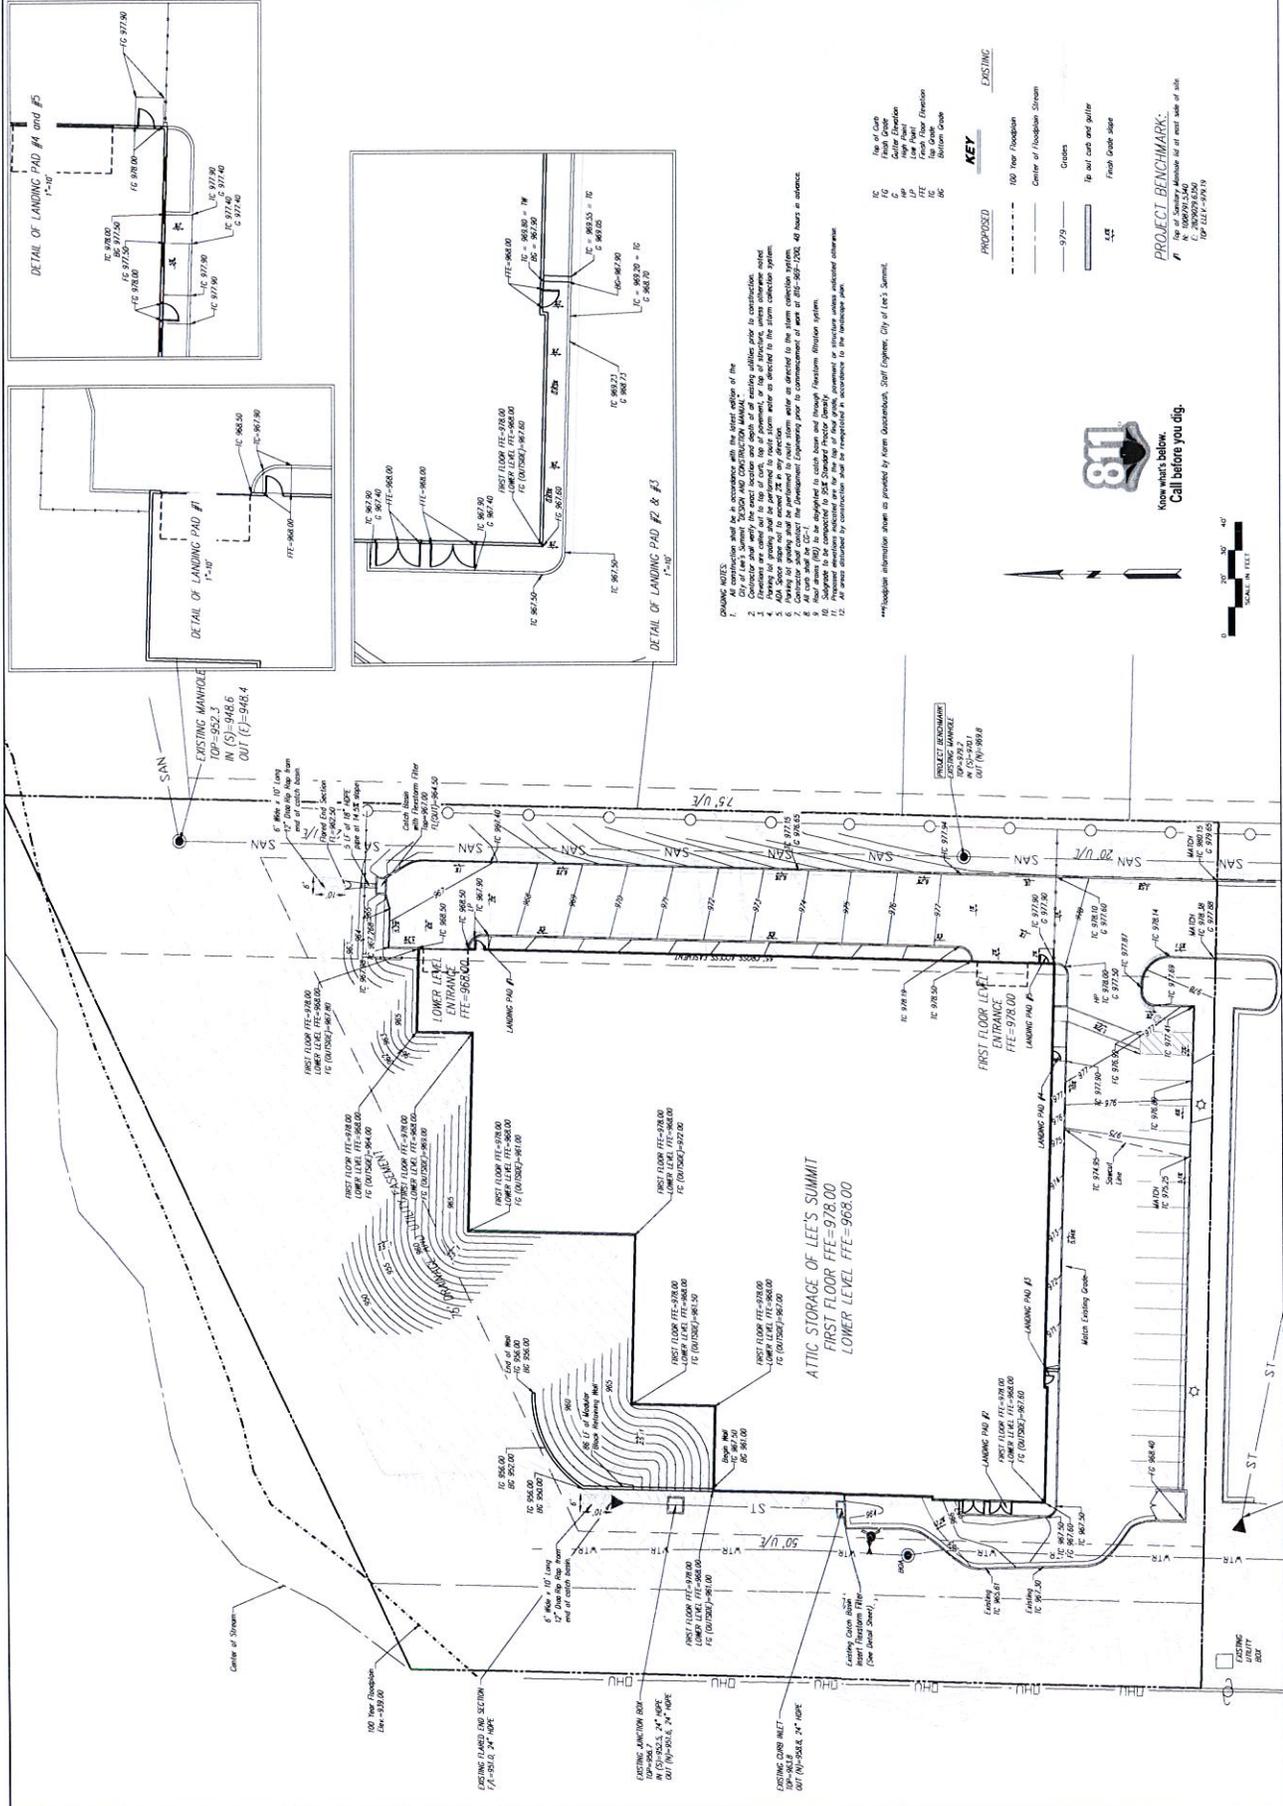

- EXISTING NOTES:**
1. All construction shall be in accordance with the latest edition of the International Building Code.
  2. City of Lee Summit requires all construction to be completed prior to construction.
  3. Elevation are called out to top of curb, top of pavement, or top of structure, unless otherwise noted.
  4. All elevations are in feet and inches.
  5. All dimensions are in feet and inches.
  6. All work shall be in accordance with the International Building Code.
  7. All work shall be in accordance with the International Building Code.
  8. All work shall be in accordance with the International Building Code.
  9. All work shall be in accordance with the International Building Code.
  10. All work shall be in accordance with the International Building Code.
  11. All work shall be in accordance with the International Building Code.
  12. All work shall be in accordance with the International Building Code.

Proprietary information shown as provided by Koenig Construction, Staff Engineer, City of Lee's Summit.

PROPOSED	EXISTING
100 Year Floodplain	Top of Curb
Center of Footing	Center of Footing
9'-9"	Top of Pavement
TC	Finish Floor Elevation
C	Bottom Grade
FF	Tip out curb and gutter
IC	Finish Grade Slope



**PROJECT BENCHMARK:**  
 Top of Survey Monument at east side of site  
 ELEVATION: 978.00  
 DATE: 12/11/19  
 TOP SURVEY MONUMENT



DATE	REVISION	BY	CHKD



**H8 Inc**  
**Consult**  
**engineers**  
**planners**


CONSULT LICENSE NO. E01006973  
 LICENSE EXPIRES 12/31/2019

PRELIMINARY DEVELOPMENT  
 DRAINAGE AREA MAP  
 ATTIC STORAGE OF LEES SUMMIT  
 LEES SUMMIT - JACKSON COUNTY - MISSOURI


DATE PLOTTED	10/11/18
SCALE	AS SHOWN
PROJECT NO.	1808705.040
DATE	JAN. 1, 2018
PROJECT	ATTIC STORAGE
DESIGNER	JHS
CHECKER	JHS
DATE	10/11/18

6 12

PRE DRAINAGE AREA CALCULATIONS:  
 O = 0.4  
 C = 0.40  
 A = 1.25 ac  
 S = 2.24 in  
 Q<sub>100</sub> = 0.46 x 2.24 x 2.24 = 2.44 cfs  
 Q<sub>10</sub> = 0.46 x 10.0 x 2.24 = 10.40 cfs

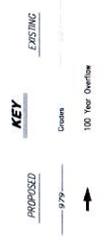

**PROJECT BENCHMARK:**  
 1' = 100' (100 Year Overflow)  
 1' = 100' (100 Year Overflow)  
 1' = 100' (100 Year Overflow)

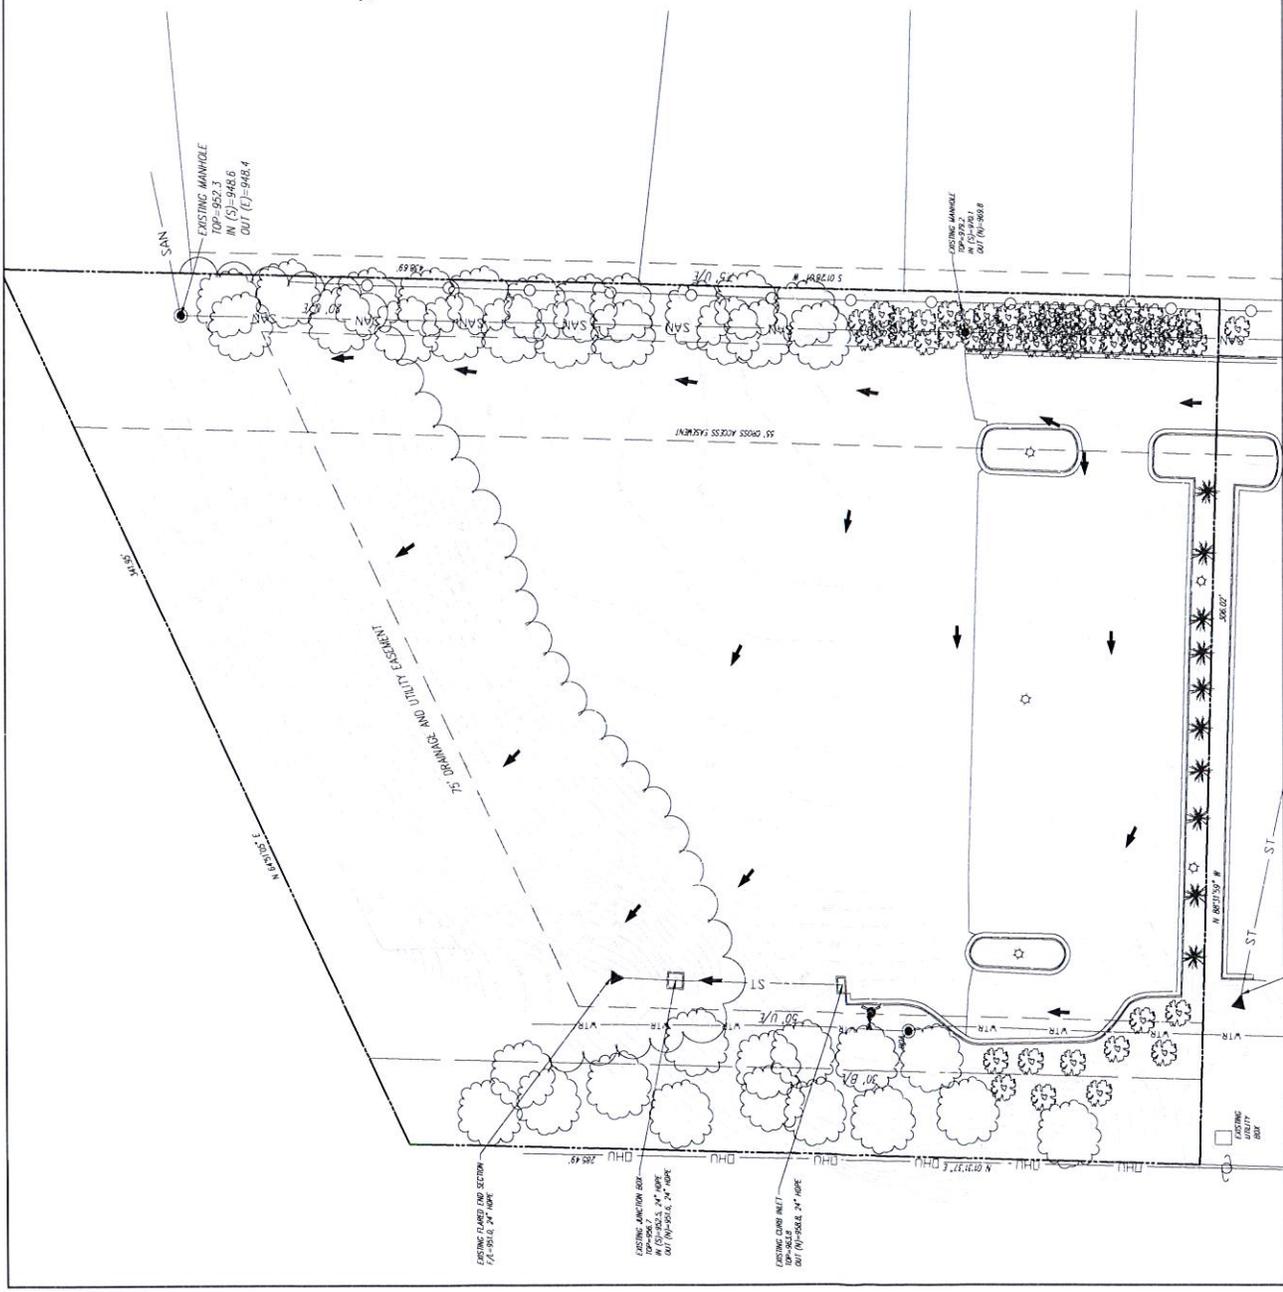

NO.	BY	DATE	REVISION



**H&E Inc. Engineers**  
 CONSULTING ENGINEERS  
 1000 W. STATE ST. SUITE 200  
 JACKSON, MISSOURI 64501

POST DEVELOPMENT  
 DRAINAGE AREA MAP  
 ATTIC STORAGE OF LEE'S SUMMIT  
 LEE'S SUMMIT, JACKSON COUNTY - MISSOURI

DATE PLOTTED	11/11/2011
DATE PRINTED	11/11/2011
DATE	11/11/2011
PROJECT	11/11/2011
NO.	11/11/2011

POST DRAINAGE AREA CALCULATIONS:  
 O = DA  
 C = 0.75  
 A = 2.24 ac  
 Q<sub>100</sub> = 0.59 cfs @ 2.24 ac = 13.17 cfs  
 Q<sub>100</sub> = 0.59 cfs @ 2.24 ac = 13.17 cfs




Know what's below.  
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**KEY**  
 PROPOSED: 0.75"  
 EXISTING: 100 Year Overflow  
 100 Year Overflow  
 100 Year Overflow  
 100 Year Overflow

NOTE: Storm sewer piping is designed to carry the 100 year overflow. Storm sewer piping is not covered by storm sewer piping is located elsewhere in parking lot.

PROJECT BENCHMARK:  
 # 1000703.540  
 # 1000703.540  
 TOP 1117-975.9



EXISTING MANHOLE  
 TOP=952.3  
 IN (S)=948.6  
 OUT (C)=946.4

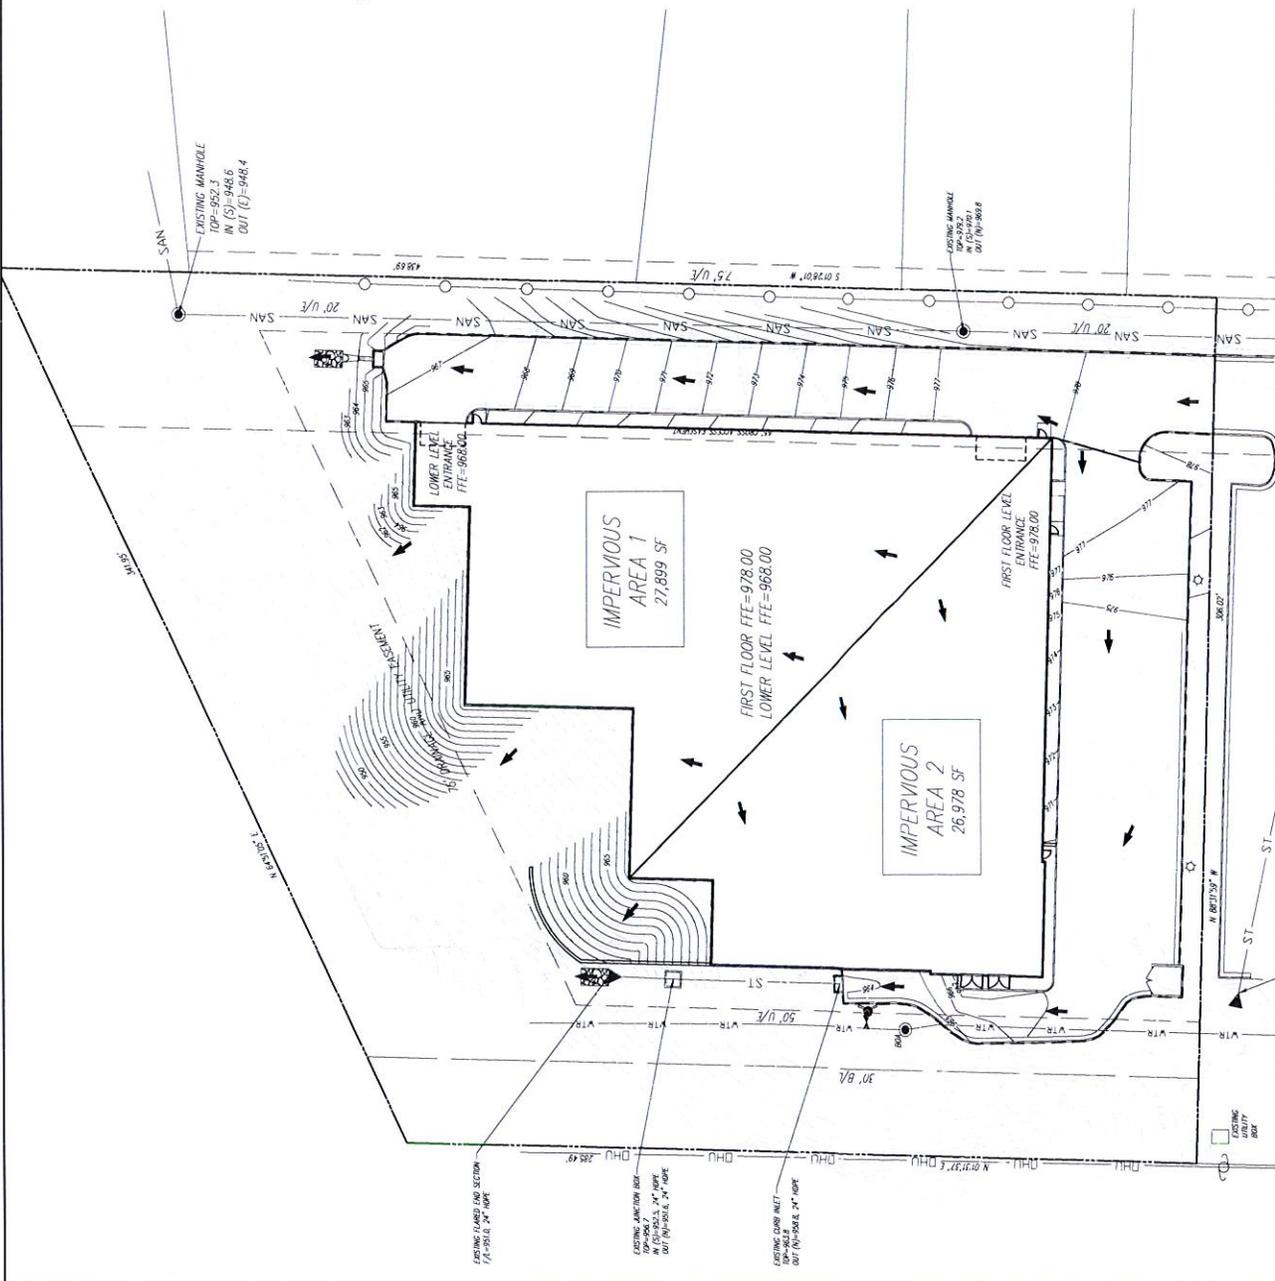EXISTING MANHOLE  
 TOP=979.2  
 IN (S)=975.0  
 OUT (C)=968.8

EXISTING CURB AND GUTTER  
 1/4" RADIUS, 24" HIGH

EXISTING MANHOLE  
 TOP=960.7  
 IN (S)=956.5  
 OUT (C)=952.3

EXISTING CURB AND GUTTER  
 1/4" RADIUS, 24" HIGH

EXISTING UTILITY LINE











- ELECTRICAL SPECIFICATIONS**
1. ALL CONDUCTORS SHALL BE THREE COPPER AWG. SIZE-2 BELOW GRADE, MINIMUM #12 OR LARGER AS REQUIRED OR SHOWN.
  2. ALL SERVICE WIRING EXPOSED TO WEATHER OR WIRING BELOW GRADE SHALL BE IN RIGID DRAINAGE CONDUIT OR SCH 40 PVC CONDUIT.
  3. ALL WIRING SHALL BE IN RIGID DRAINAGE CONDUIT OR SCH 40 PVC CONDUIT. ALL WIRING SHALL BE PROPERLY GROUNDED. WIRING SHALL BE IN RIGID DRAINAGE CONDUIT OR SCH 40 PVC CONDUIT. ALL WIRING SHALL BE PROPERLY GROUNDED. WIRING SHALL BE IN RIGID DRAINAGE CONDUIT OR SCH 40 PVC CONDUIT. ALL WIRING SHALL BE PROPERLY GROUNDED.
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  5. ALL 120V, 240V LIGHTING AND RECEPTACLE CIRCUITS REMAINING ABOVE GROUND SHALL BE IN RIGID DRAINAGE CONDUIT OR SCH 40 PVC CONDUIT. ALL WIRING SHALL BE PROPERLY GROUNDED. WIRING SHALL BE IN RIGID DRAINAGE CONDUIT OR SCH 40 PVC CONDUIT. ALL WIRING SHALL BE PROPERLY GROUNDED.

- KEYED PLAN NOTES**
1. PER LEE'S SUMMIT GROUND DESIGN STANDARDS SECTION 7.29A, LIGHTING FIXTURES TO BE ACCORD TO BELOW.



SYMBOL	QTY	DESCRIPTION	HEIGHT	INSTALLATION	HEIGHT	INSTALLATION	HEIGHT	INSTALLATION
1	2	EXISTING FIXTURE	4.00'	30'	4.00'	30'	4.00'	30'
2	1	NEW FIXTURE	4.00'	30'	4.00'	30'	4.00'	30'

DESCRIPTION	QTY	HEIGHT	INSTALLATION	HEIGHT	INSTALLATION	HEIGHT	INSTALLATION
EXISTING FIXTURE	2	4.00'	30'	4.00'	30'	4.00'	30'
NEW FIXTURE	1	4.00'	30'	4.00'	30'	4.00'	30'

DESCRIPTION	QTY	HEIGHT	INSTALLATION	HEIGHT	INSTALLATION	HEIGHT	INSTALLATION
EXISTING FIXTURE	2	4.00'	30'	4.00'	30'	4.00'	30'
NEW FIXTURE	1	4.00'	30'	4.00'	30'	4.00'	30'



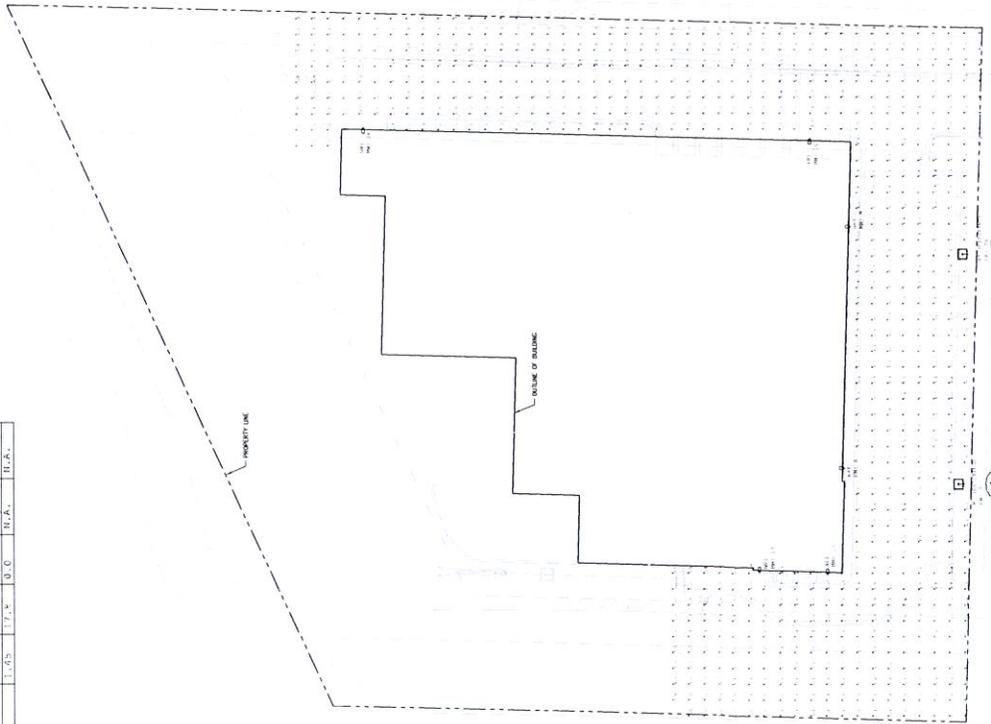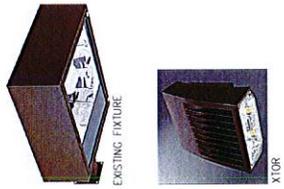

SHEET INDEX	
NUMBER	NAME
01.0	CONTRACT
02.0	GENERAL NOTES
03.0	FOUNDATION
04.0	FLOORING
05.0	MECHANICAL
06.0	ELECTRICAL
07.0	PLUMBING
08.0	PAINTING
09.0	ARCHITECTURAL SITE PLAN

PROJECT NAME: ATTIC STORAGE  
 PROJECT DESCRIPTION: PROPOSED SELF STORAGE FACILITY WITH  
 SHEDS AND OFFICES  
 PROJECT LOCATION: 920 NE DEERBROOK ST., LEE'S SUMMIT,  
 MISSOURI  
 CONTRACTOR: STRICKLAND CONSTRUCTION  
 ARCHITECT: HERMLEY ASSOCIATES, INC.  
 1100 RHODE ISLAND ST.  
 LAWRENCE, KS 66044  
 P) 785-749-5806  
 F) 785-749-1515

**PROJECT INFORMATION**



**PROJECT LOCATION**

**ARCHITECT**  
**Hermley Associates, Inc.**  
 1100 Rhode Island St.  
 Lawrence, KS 66044  
 P) 785-749-5806  
 F) 785-749-1515

**GENERAL CONTRACTOR**  
**Strickland Construction**  
 720 S. Rogers Road, Suite 'B'  
 Olathe, KS 66062  
 P) 913-764-7000



ATTIC STORAGE OF LEE'S SUMMIT  
 920 NE DEERBROOK ST., LEE'S SUMMIT, MISSOURI



1100 Rhode Island St.  
 Lawrence, KS 66044  
 P) 785-749-5806  
 F) 785-749-1515

COVER SHEET

Date: \_\_\_\_\_  
 Drawn by: WCTJ  
 Checked by: \_\_\_\_\_  
 Permitted: \_\_\_\_\_

**A0.0**

ATTIC STORAGE OF LEE'S SUMMIT  
920 NE DEERBROOK ST., LEE'S SUMMIT, MISSOURI

**Hernly**  
ARCHITECTS  
1148 Blue Bell Blvd.  
Lee's Summit, Missouri  
781-247-1884  
Fax: 781-247-1155

UNIT MIX - LEVEL 1	Date:	Issue Date:	WCT1
	Drawn by:	Checked by:	Checked by:
		Approved:	

A1.0

UNIT #	UNIT NAME	CHAM.	AREA	UNIT TYPE/STANDARD
51	51	51	51	51
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54	54	54	54	54
55	55	55	55	55
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ATTIC STORAGE OF LEE'S SUMMIT  
920 NE DEERBROOK ST., LEE'S SUMMIT, MISSOURI



11000 N. 100th St., Suite 100  
Lee's Summit, MO 64086  
781-794-7888  
781-794-1515

UNIT MIX - LEVEL 2


UNIT	DATE	ISSUED	BY	REVISION
1000	10/10/10	10/10/10	WCT	1
1001	10/10/10	10/10/10	WCT	1
1002	10/10/10	10/10/10	WCT	1
1003	10/10/10	10/10/10	WCT	1
1004	10/10/10	10/10/10	WCT	1
1005	10/10/10	10/10/10	WCT	1
1006	10/10/10	10/10/10	WCT	1
1007	10/10/10	10/10/10	WCT	1
1008	10/10/10	10/10/10	WCT	1
1009	10/10/10	10/10/10	WCT	1
1010	10/10/10	10/10/10	WCT	1

A1.1

2ND LEVEL  
33,600 S.F.


UNIT MIX SCHEDULE - LEVEL 2

UNIT	DATE	ISSUED	BY	REVISION
1000	10/10/10	10/10/10	WCT	1
1001	10/10/10	10/10/10	WCT	1
1002	10/10/10	10/10/10	WCT	1
1003	10/10/10	10/10/10	WCT	1
1004	10/10/10	10/10/10	WCT	1
1005	10/10/10	10/10/10	WCT	1
1006	10/10/10	10/10/10	WCT	1
1007	10/10/10	10/10/10	WCT	1
1008	10/10/10	10/10/10	WCT	1
1009	10/10/10	10/10/10	WCT	1
1010	10/10/10	10/10/10	WCT	1

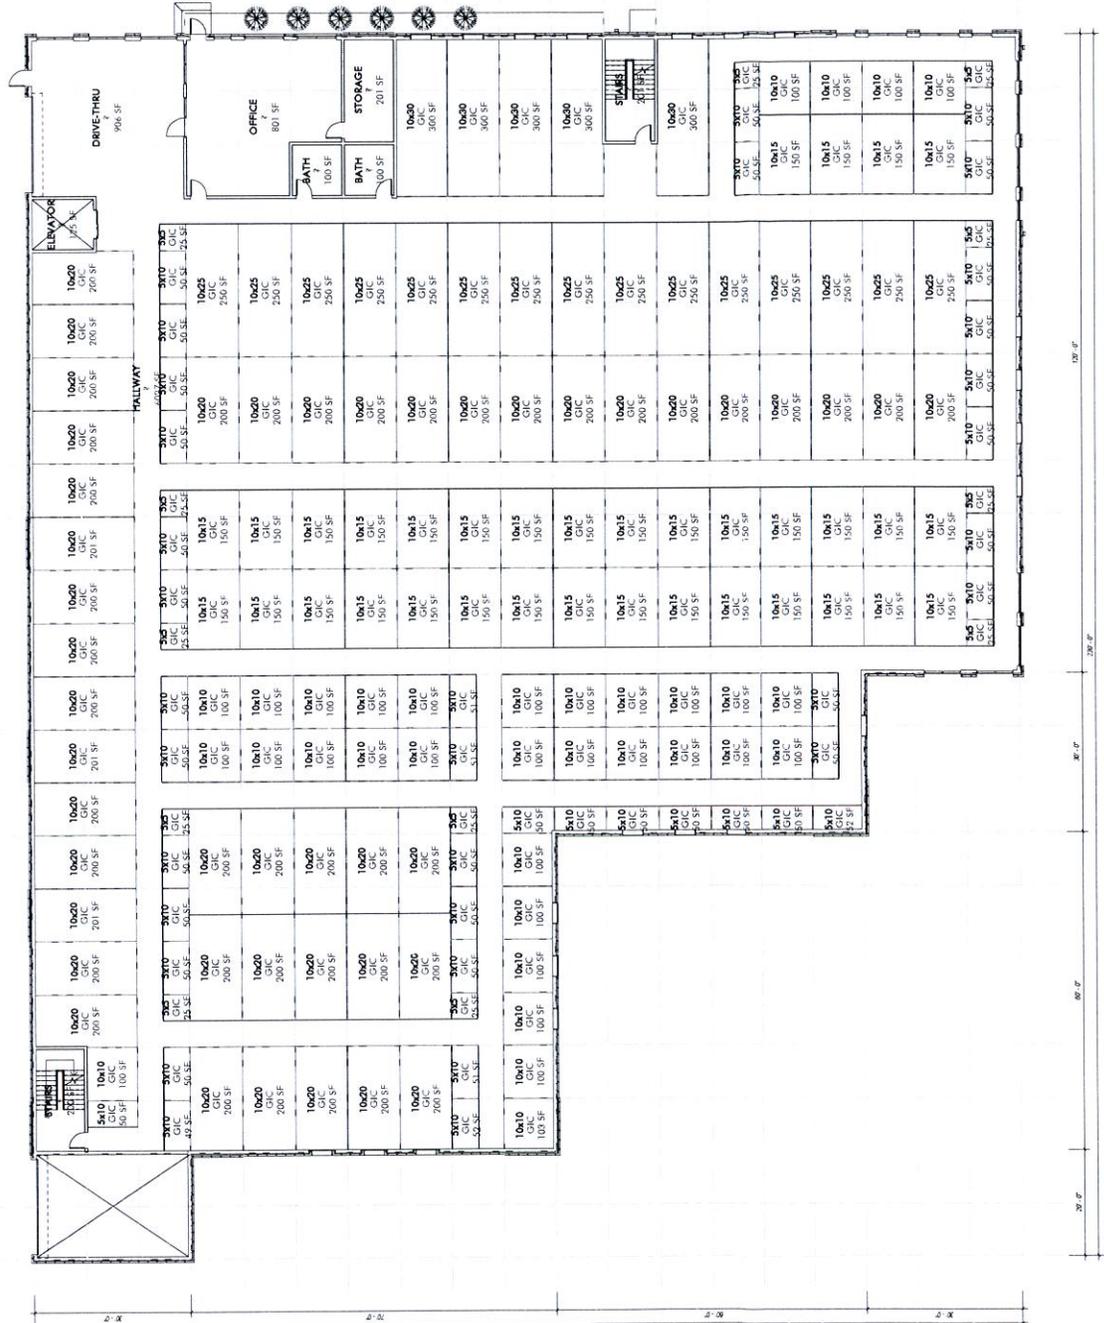


1 UNIT MIX - LEVEL 2  
3/32" = 1'-0"




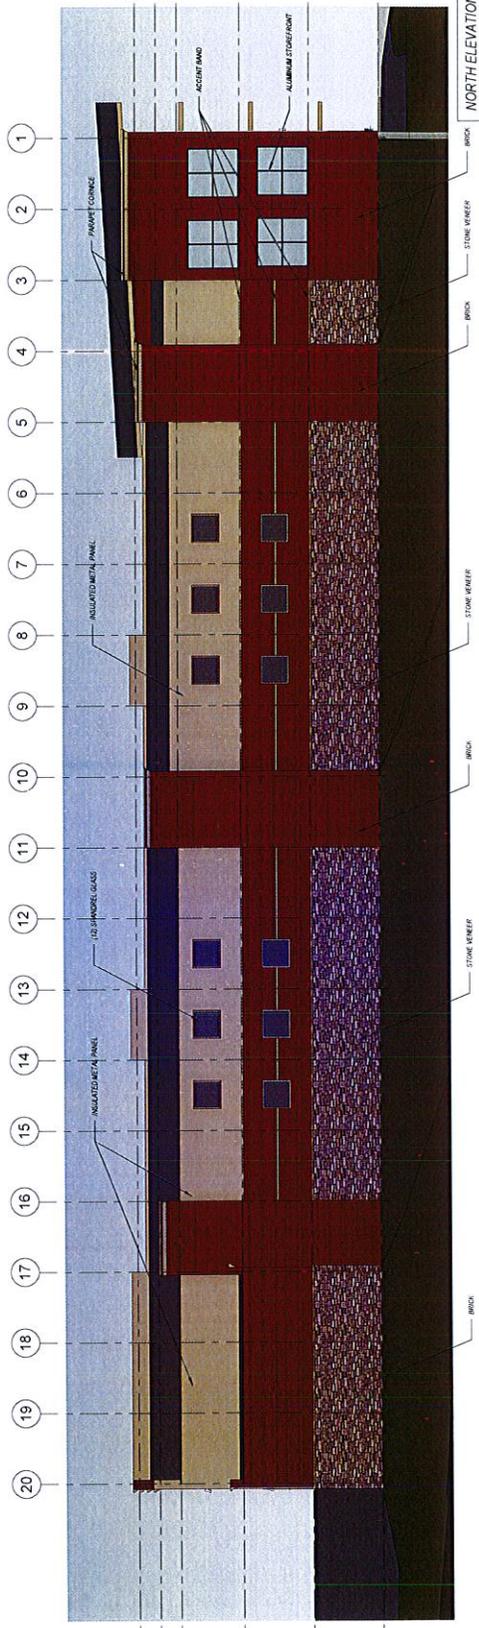


**1 NORTH ELEVATION**  
1/8" = 1'-0"  
SOLID: 4,738 S.F. / 5,973 S.F. = 79%  
METAL: 1,235 S.F. / 5,973 S.F. = 21%

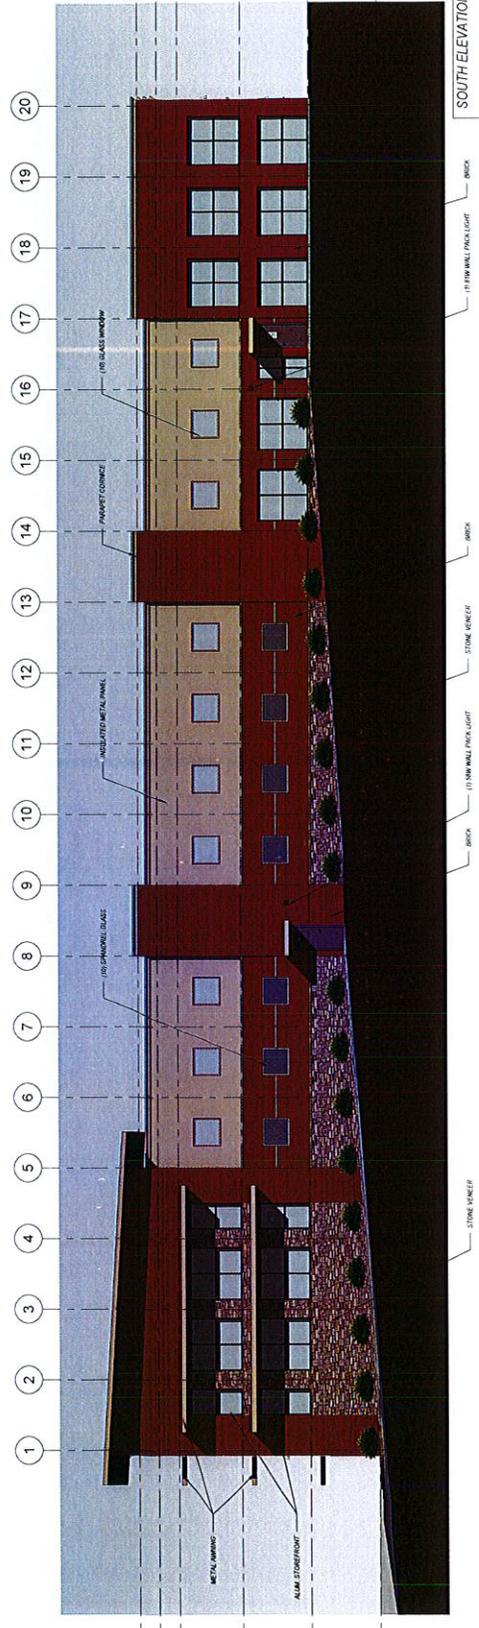


**2 SOUTH ELEVATION**  
1/8" = 1'-0"  
SOLID: 4,389 S.F. / 5,630 S.F. = 78%  
METAL: 1,241 S.F. / 5,630 S.F. = 22%

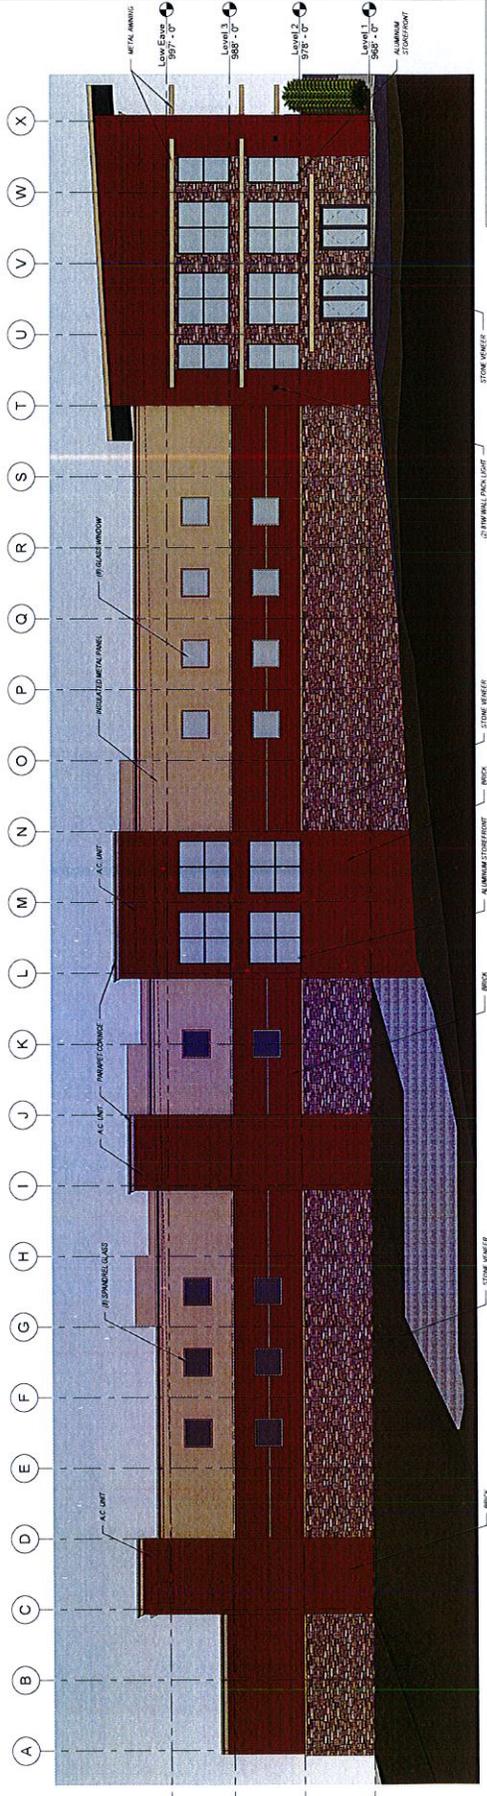


**1 WEST ELEVATION**  
 1/8" = 1'-0"

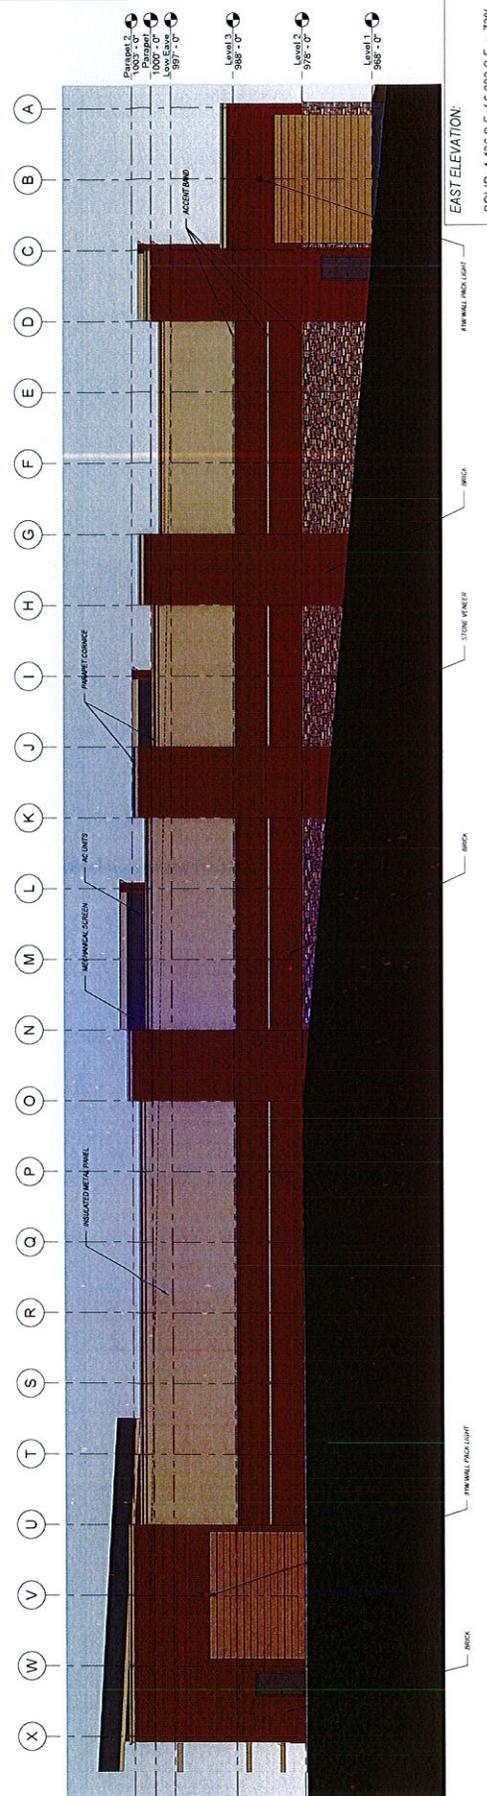


**2 EAST ELEVATION**  
 1/8" = 1'-0"

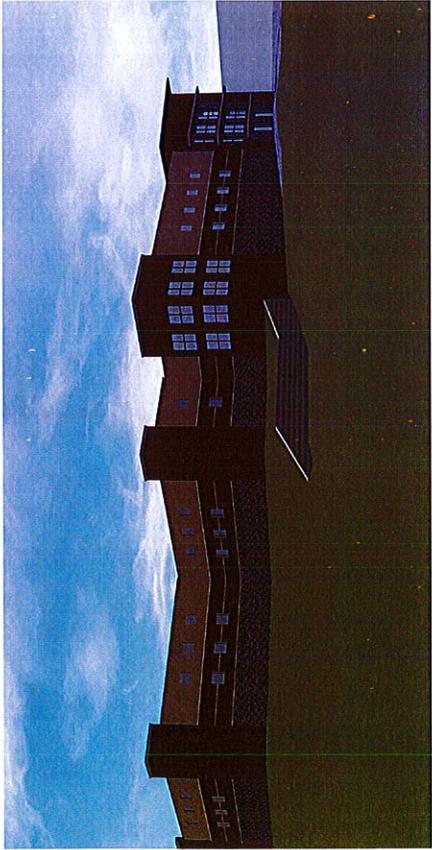


1 3D View 1

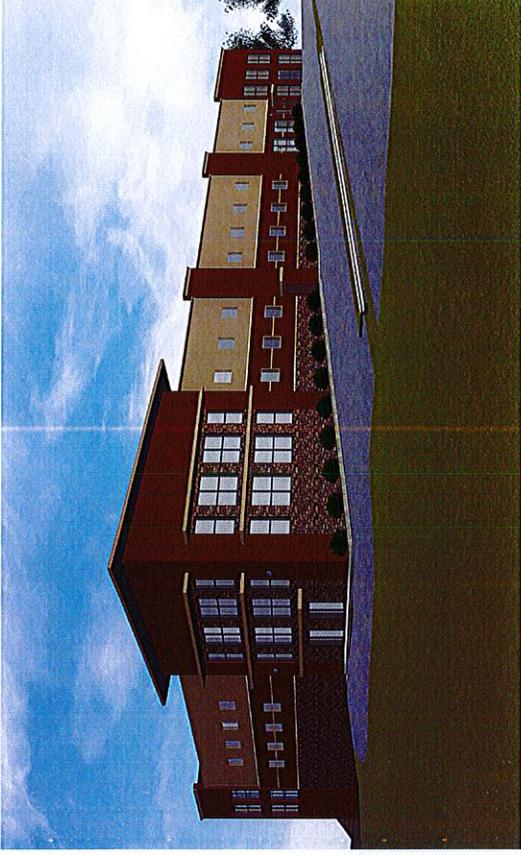

2 3D View 2

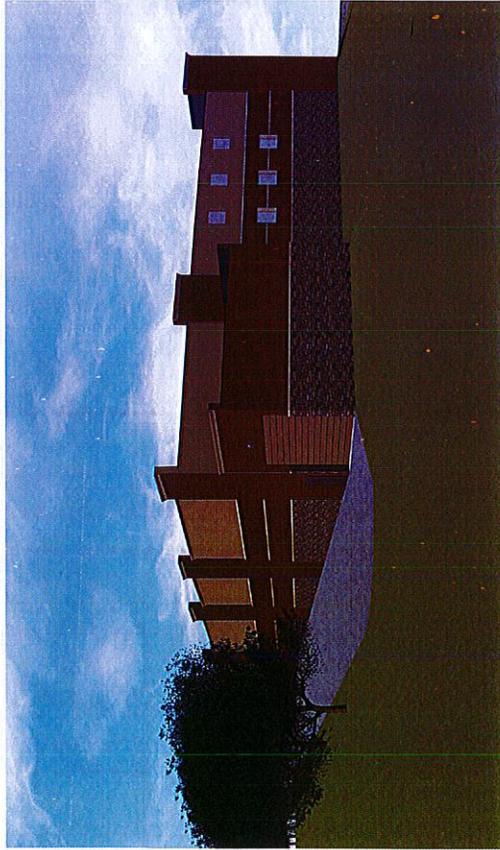

3 3D View 3

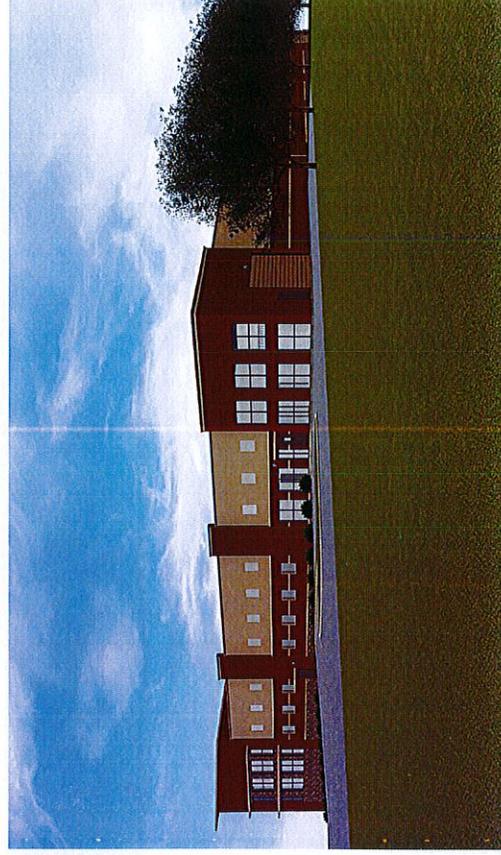

4 3D View 4

ATTIC STORAGE OF LEE'S SUMMIT  
920 NE DEERBROOK ST., LEE'S SUMMIT, MISSOURI

**Hernly** ARCHITECTS  
ARCHITECTS

1100 Wood Island Dr  
Lee's Summit, MO 64081  
Tel: 816-488-1100  
Fax: 816-488-1105

PERIPHERIES:

Drawn: \_\_\_\_\_  
Scale: \_\_\_\_\_  
Checked: \_\_\_\_\_  
Reviewed: \_\_\_\_\_

A3.0




11000 N. 10th St.  
Lees Summit, Missouri  
781-244-3884  
Fax: 781-244-3333

ARCHITECTURAL SITE  
PLAN

Date: \_\_\_\_\_  
Drawn by: WCT  
Checked by: \_\_\_\_\_  
Approved: \_\_\_\_\_

ASI.0

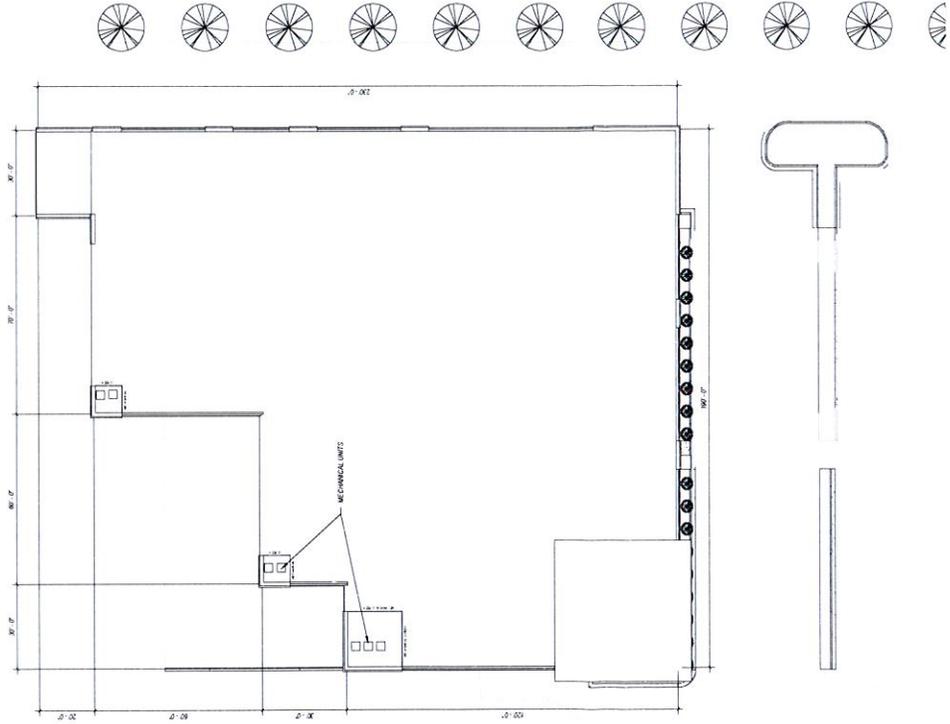

**PL#2018-121- PREL DEV PLAN & SPECIAL USE PERMIT  
ATTIC STORAGE, 920 NE DEERBROOK ST.  
STRICKLAND CONSTRUCTION, APPL.**

