


07-31-19

**PERGOLA PARK 4TH PLAT
STREET, STORMWATER, MASTER DRAINAGE
PLAN AND EROSION AND SEDIMENT
- LEE'S SUMMIT, MISSOURI**

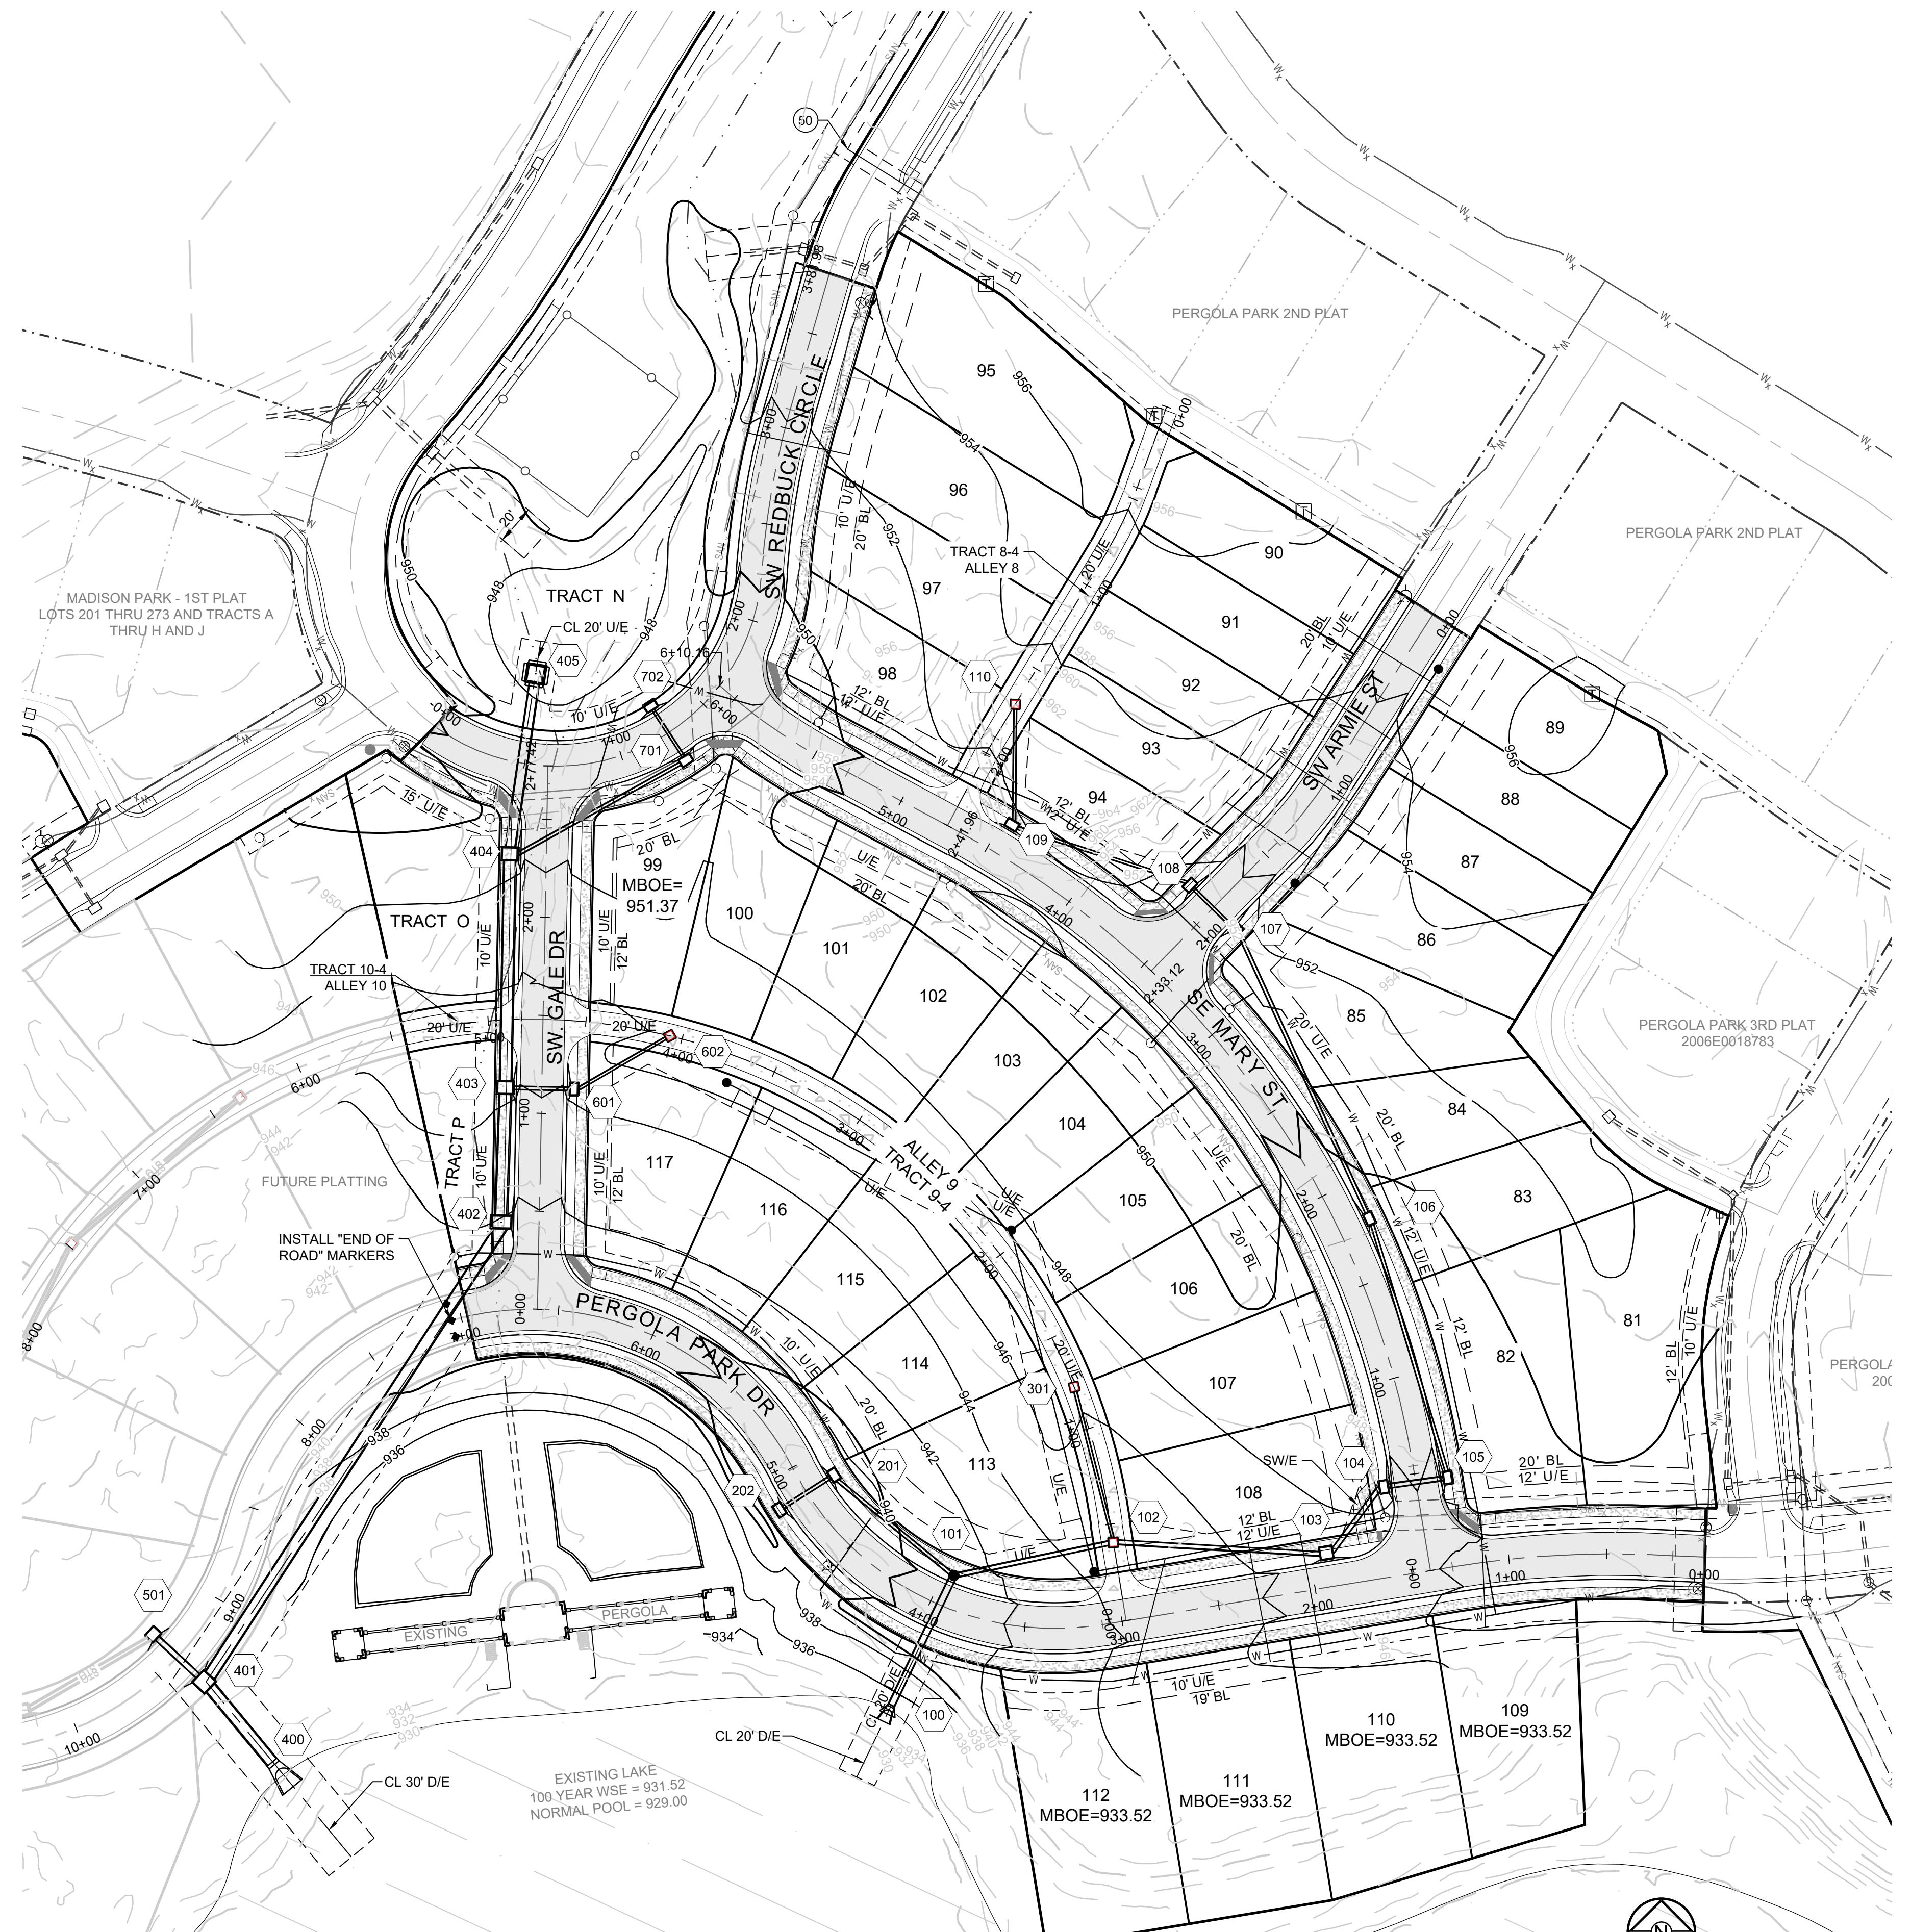

**MISSOURI GEOGRAPHIC REFERENCE SYSTEM
BENCH MARK:**

BM JA-148, IS A STAMPED KC METRO DISK SET IN CONCRETE LOCATED 2 MILES WEST OF THE INTERSECTION OF HIGHWAY 50 AND 3RD ST. IT IS 44 FT NORTH OF THE CENTER OF 3RD ST. AND 102.5 FT WEST OF THE CENTER OF THE EXIT FROM THE ADJACENT PARKING LOT.

ELEV. 935.18

PROJECT BENCHMARK:

CHISELED "SQUARE" ON STORM CURB INLET AT NORTHWEST
INTERSECTION OF SW. TOWER PARK DRIVE AND SW. LONGVIEW
BOULEVARD.

NORTHING: 098893.4148
EASTING: 2803318.5413
ELEV. 1004.09

3

OF 28

MASTER
DRAINAGE PLAN
- GRADING PLAN

SHEET

19-002

0 50' 100'

SCALE: 1" = 50'



100 YEAR OVERFLOW SWALES											
SECTION	DRAINAGE AREA (AC.)	Q100 (CFS)	Q10 (CFS)	DESIGN OVERFLOW (CFS)	BED SLOPE (%)	BASE WIDTH (FT.)	SIDE SLOPE	TOP WIDTH (FT.)	NORMAL DEPTH (FT.)	VELOCITY (FPS)	VELOCITY HEAD (FT.)
A-A	2.16	18.39	-	18.3900	2.13	5	3:1	8.68	0.61	4.39	0.30
B-B	6.93	59.00	-	59.0000	7.25	10	3:1	13.55	0.59	8.48	1.12

RUNOFF CALCULATIONS:
 $Q = K * C * I * A$
 $K_{10} = 1.0 \quad K_{100} = 1.25 \quad C = 0.51 \quad I = \text{INTENSITY}$
 DESIGN OVERFLOW = $Q_{\text{OVERFLOW}} = Q_{100} - Q_{10}$
 MANNINGS "n" = .030 FOR SWALES

LOT TYPE TABLE		
LOT #	BASEMENT TYPE	MBOE
81	STANDARD	953.00
82	STANDARD	952.50
83	STANDARD	953.00
84	STANDARD	953.00
85	STANDARD	954.00
86	STANDARD	955.00
87	STANDARD	956.00
88	STANDARD	957.00
89	STANDARD	957.00
90	STANDARD	958.00
91	STANDARD	957.50
92	STANDARD	957.00
93	STANDARD	956.50
94	STANDARD	955.50
95	STANDARD	957.50
96	STANDARD	957.00
97	STANDARD	955.00
98	STANDARD	953.50
99	STANDARD	951.37
100	STANDARD	951.50
101	STANDARD	952.00
102	STANDARD	952.00
103	STANDARD	952.00
104	STANDARD	952.00
105	STANDARD	952.00
106	STANDARD	951.50
107	STANDARD	950.50
108	STANDARD	949.50
109	WALKOUT	933.52
110	WALKOUT	933.52
111	WALKOUT	933.52
112	DAYLIGHT	933.52
113	STANDARD	947.50
114	STANDARD	948.50
115	STANDARD	949.00
116	STANDARD	948.50
117	STANDARD	948.00

- A A
DENOTES OVERFLOW SWALE
EL:000.00
DENOTES FINISHED GRADE ELEVATION
EL:000.00 (EX)
DENOTES EXISTING GRADE ELEVATION
HP 000.00
DENOTES LOT HIGH POINT ELEVATION
DENOTES RETAINING WALL

MISSOURI GEOGRAPHIC REFERENCE SYSTEM BENCH MARK:


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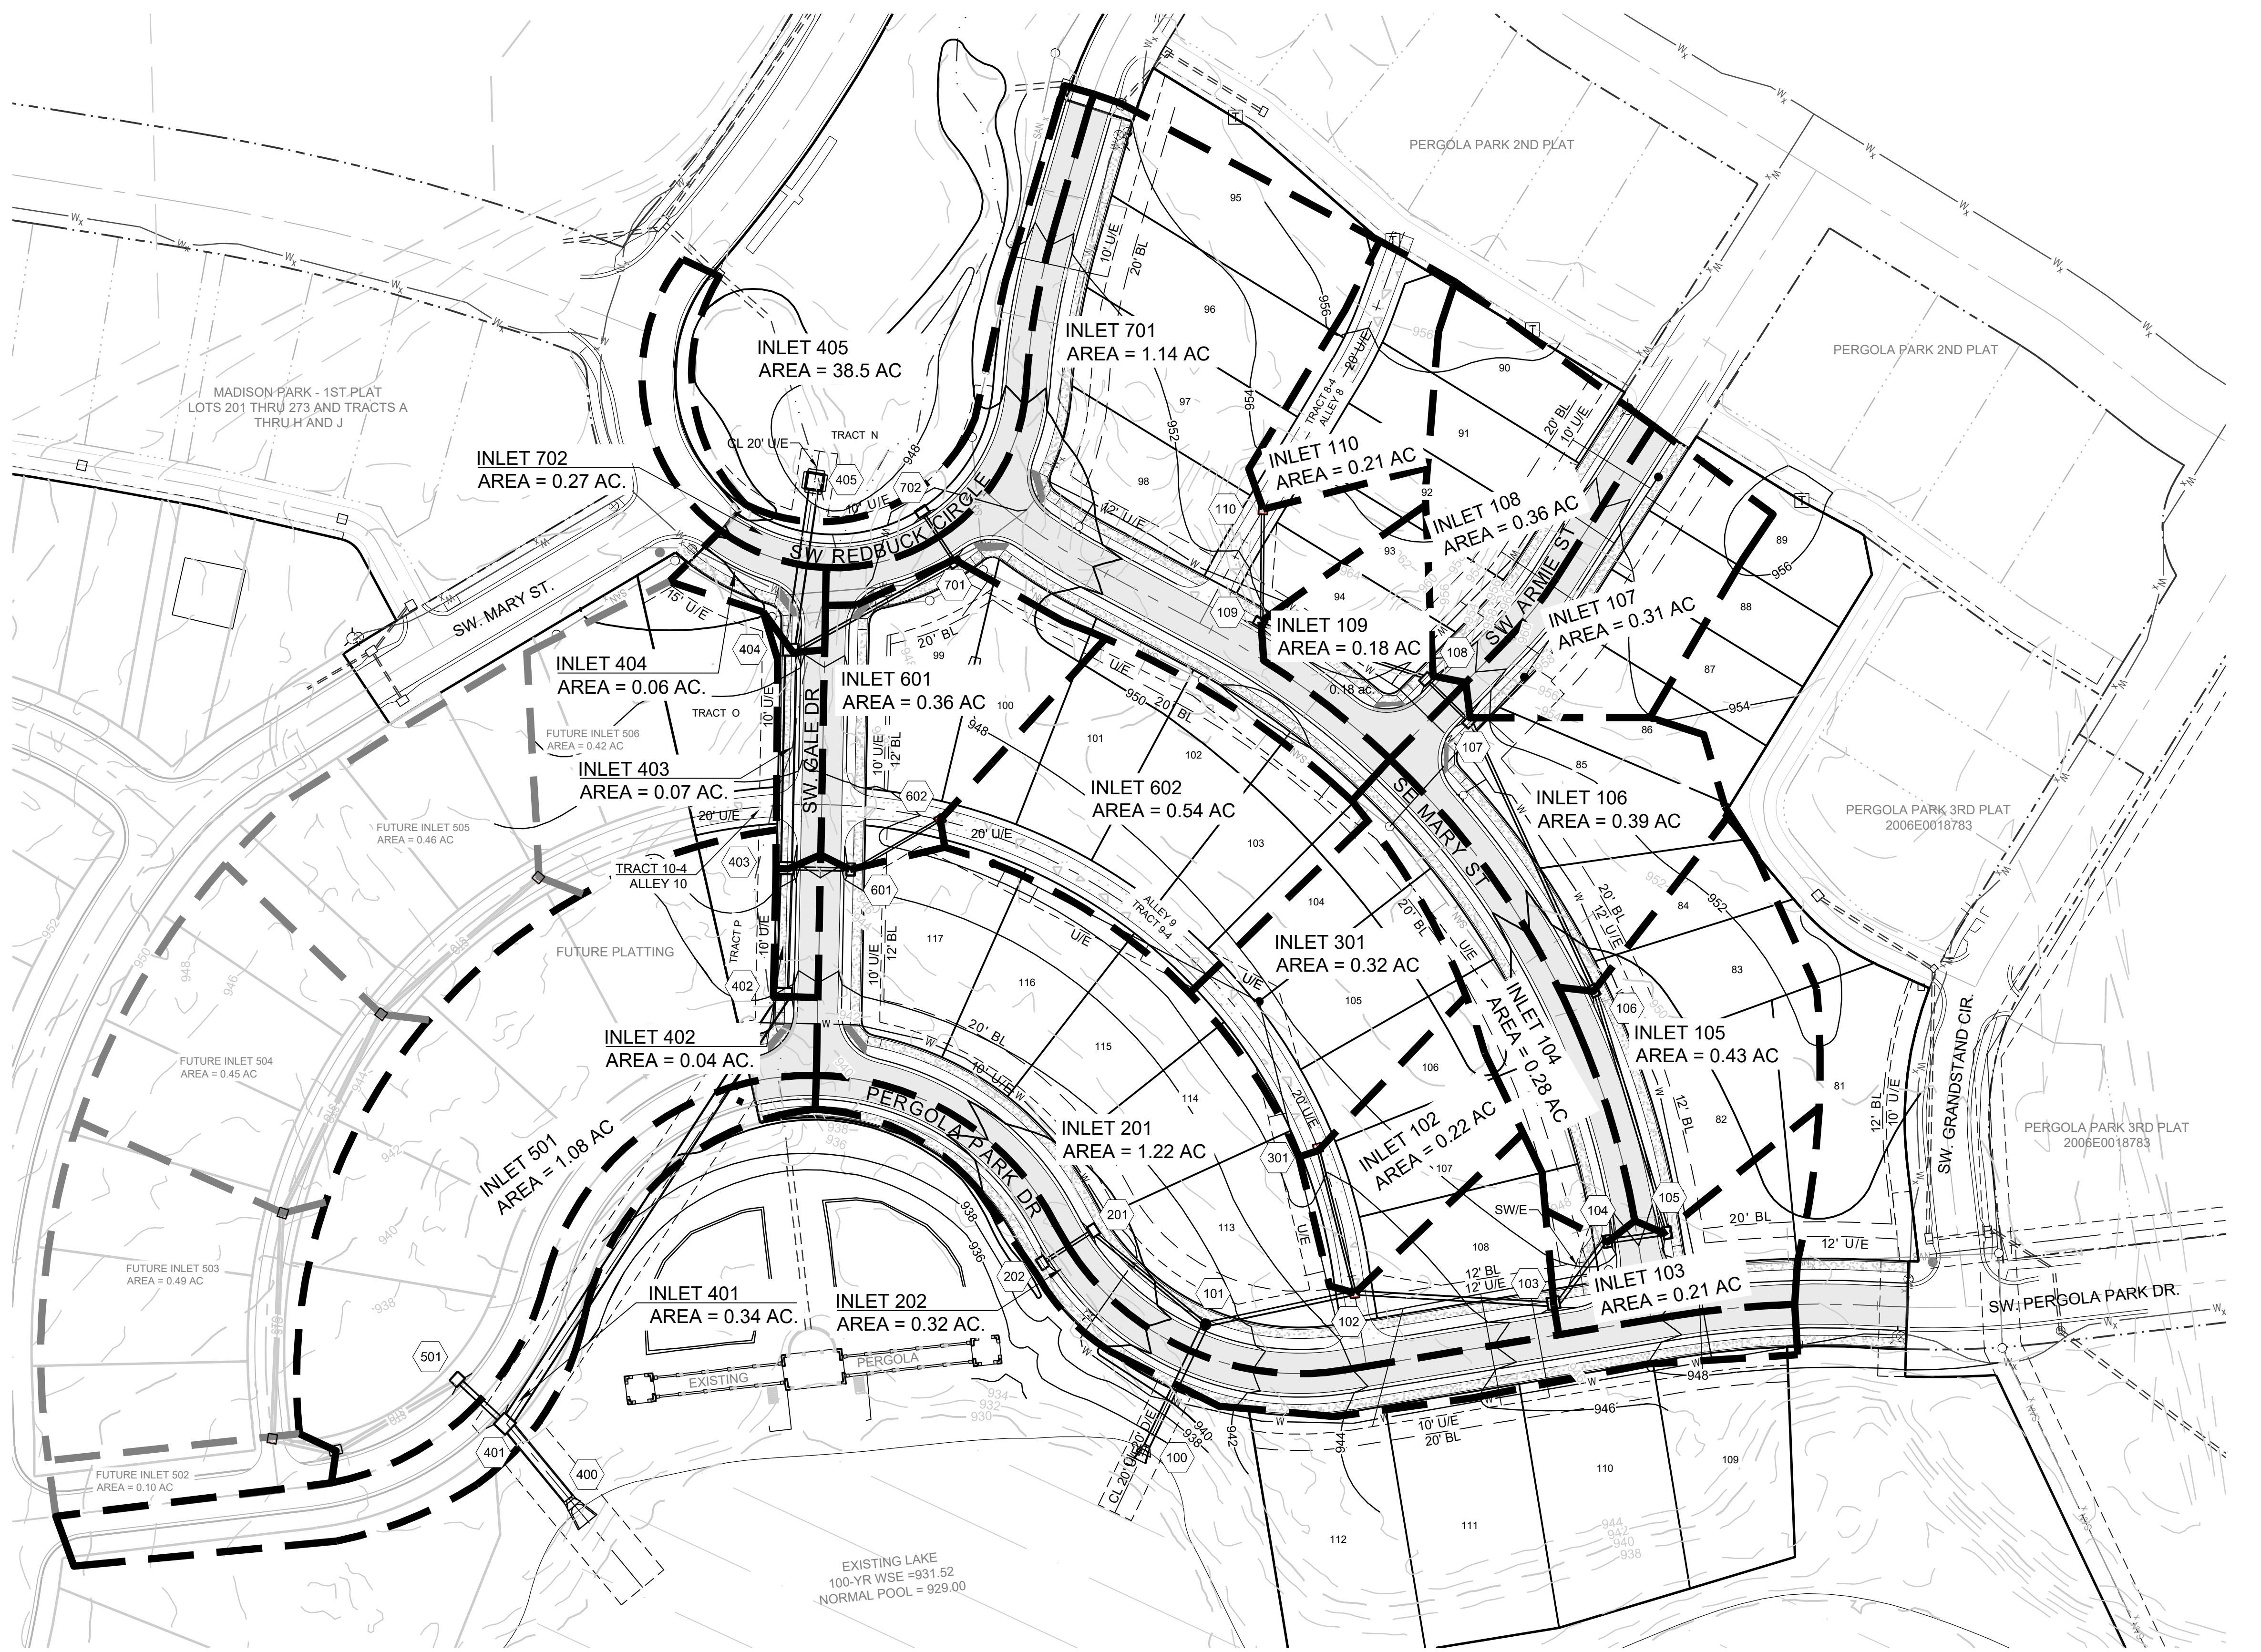


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14920 West 107th Street • Lenexa, Kansas 66215
(913) 492-5155 • Fax: (913) 492-8400
www.schlagelassociates.com
#E202003000F BLCC201000237 MS202009859-F



PERGOLA PARK 4TH PLAT STREET, STORMWATER, MASTER DRAINAGE PLAN AND EROSION AND SEDIMENT - LEE'S SUMMIT, MISSOURI

MASTER DRAINAGE PLAN - LOT INFO	
REVISION DATE:	DESCRIPTION
BAL: A-26-19	CITY COMMENTS
CHECKED BY:	CITY COMMENTS
MAB: A	
DATE PREPARED:	
PROJ. NUMBER:	
19-02	
SHEET	
4	
OF 28	

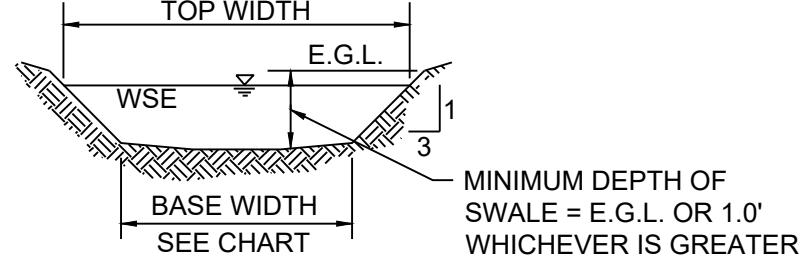


**PERGOLA PARK 4TH PLAT
STREET, STORMWATER, MASTER DRAINAGE
PLAN AND EROSION AND SEDIMENT**

- LEE'S SUMMIT, MISSOURI




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Missouri State Certifications of Authority
#E202003800 F #LAC201000237 #S202009859-F

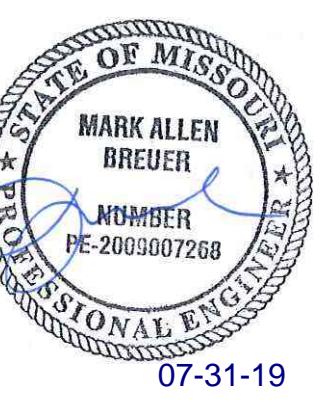

07-31-19

MASTER
DRAINAGE PLAN
- DRAINAGE MAP
SHEET
5
OF 28

5

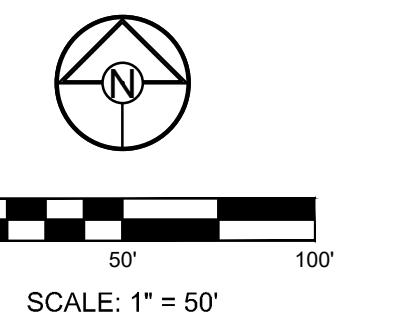

0 50' 100'

SCALE: 1" = 50'

5

OF 28

Project CS201910492030 Design3.0 DWG Plan 6.0 SS116-002 SSDRANGE AREA.Dwg 7/30/2019 4:23:32 PM, 1:1

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LEGEND	
	TEMP. CONSTRUCTION ENTRANCE AND STAGING AREA
	SUPER SEDIMENT SILT FENCE (PRIOR TO LAND DISTURBANCE)
	SILT FENCE (PRIOR TO LAND DISTURBANCE)
	SILT FENCE (DURING CONSTRUCTION)
	LIMITS OF DISTURBANCE
	EXISTING CONTOURS
	PROPOSED CONTOURS
	BMP PLAN REF. NO.
	SILT FOAM DIKE - STAKED & INSTALL PER MFR'S RECOMMENDATIONS
	SILT FENCE FOR INLET PROTECTION PRIOR TO STRUCTURE TOP
	GRAVEL FILTER FOR STORM SEWER STRUCTURES ONLY

DISTURBED AREA = 9.01 A.C.

SITE SPECIFIC NOTES:


- THE CONTRACTOR IS RESPONSIBLE FOR VERIFYING ALL EXISTING UTILITY LOCATIONS PRIOR TO EXCAVATION.
- THERE ARE NO WETLANDS, NATURAL OR ARTIFICIAL WATER STORAGE DETENTION AREAS IN THE PROJECT AREA.
- NO PART OF THE PROJECT LIES WITHIN THE 100 YEAR FLOOD PLAIN PER FEMA FLOOD INSURANCE RATE MAP NUMBER 29095C0414G DATED JANUARY 20TH, 2017.
- ALL EROSION AND SEDIMENTATION CONTROL MEASURES SHALL BE IMPLEMENTED ACCORDING TO THE BMP STAGING CHART.
- ADDITIONAL EROSION CONTROL MAY BE REQUIRED BY THE CITY ENGINEER AT ANY TIME EXISTING MEASURES ARE FOUND TO BE INEFFECTIVE OR PROBLEMATIC AREAS ARE NOTED IN THE FIELD.
- STABILIZATION OF DISTURBED AREAS MUST, AT A MINIMUM, BE INITIATED IMMEDIATELY WHENEVER ANY CLEARING, GRADING, EXCAVATING, OR OTHER SOIL DISTURBING ACTIVITIES HAVE PERMANENTLY CEASED ON ANY PORTION OF THE SITE, OR TEMPORARILY CEASED ON ANY PORTION EXCEEDING 14 CALENDAR DAYS, THE DISTURBED AREAS SHALL BE PROTECTED FROM EROSION BY STABILIZING THE AREA WITH MULCH OR OTHER SIMILARLY EFFECTIVE SOIL STABILIZING BMP'S. INITIAL STABILIZATION ACTIVITIES MUST BE COMPLETED WITHIN 14 DAYS AFTER SOIL DISTURBING ACTIVITIES CEASE.
- ALL PERIMETER SILT FENCE, EARTH DIKES, SEDIMENT BASINS, AND ROCK CONSTRUCTION ENTRANCES WILL BE INSTALLED BEFORE GRADING OPERATIONS BEGIN.
- SILT FENCE AND EARTH DIKES THAT ARE PLACED BEFORE GRADING BEGINS WILL BE MAINTAINED BY THE GRADING CONTRACTOR.
- AREAS WITHIN PUBLIC RIGHT-OF-WAY SHALL BE SODDED IMMEDIATELY AFTER CONSTRUCTION IS COMPLETE.

EROSION AND SEDIMENT CONTROL STAGING CHART				
PROJECT STAGE	BMP PLAN REF. NO.	BMP DESCRIPTION	REMOVE AFTER STAGE	NOTES:
A - PRIOR TO LAND DISTURBANCE	1	CONSTRUCTION ENTRANCE & STAGING AREA	D	Maintain, repair, or replace as necessary
	2	SUPER SEDIMENT FENCE	E	Place where indicated, repair or replace as necessary and remove only when graded areas have sufficient ground cover established
	3	SILT FENCE (PRIOR TO LAND DISTURBANCE)	E	Place where indicated, repair or replace as necessary and remove only when graded areas have sufficient ground cover established
B - MASS GRADING	4	SILT FENCE (DURING CONSTRUCTION)	E	Place where indicated, repair or replace as necessary and remove only when graded areas have sufficient ground cover established
	5	CONCRETE WASHOUT AREA	E	Maintain, repair, or replace as necessary
C - UTILITY CONSTRUCTION	6	INLET PROTECTION (SILT FENCE)	D/E	Place silt fence around all storm sewer structures / yard area storm structures to have silt fence removed only when graded areas have sufficient ground cover established Boards shall be placed in front of inlet opening from the time silt fence is removed until such time that the curb / throat is poured. Place gravel filter bags at the opening of all curb inlets immediately after the inlet throats are poured
	7	INLET PROTECTION (GRAVEL FILTER BAGS)	E	Boards shall be placed in front of inlet opening from the time silt fence is removed until such time that the curb / throat is poured. Place gravel filter bags at the opening of all curb inlets immediately after the inlet throats are poured
	8	SILT FENCE (AFTER CURB CONSTRUCTION)	E	Place where indicated, repair or replace as necessary and remove only when graded areas have sufficient ground cover established
	9	SEEDING AND MULCHING	E	All disturbed areas after 14 days of construction inactivity
				Additional sediment and erosion control measures may be required any time current measures are found to be ineffective.
E - UNTIL CLOSURE OF LAND DISTURBANCE PERMIT				

PERGOLA PARK 4TH PLAT STREET, STORMWATER, MASTER DRAINAGE PLAN AND EROSION AND SEDIMENT

- LEE'S SUMMIT, MISSOURI



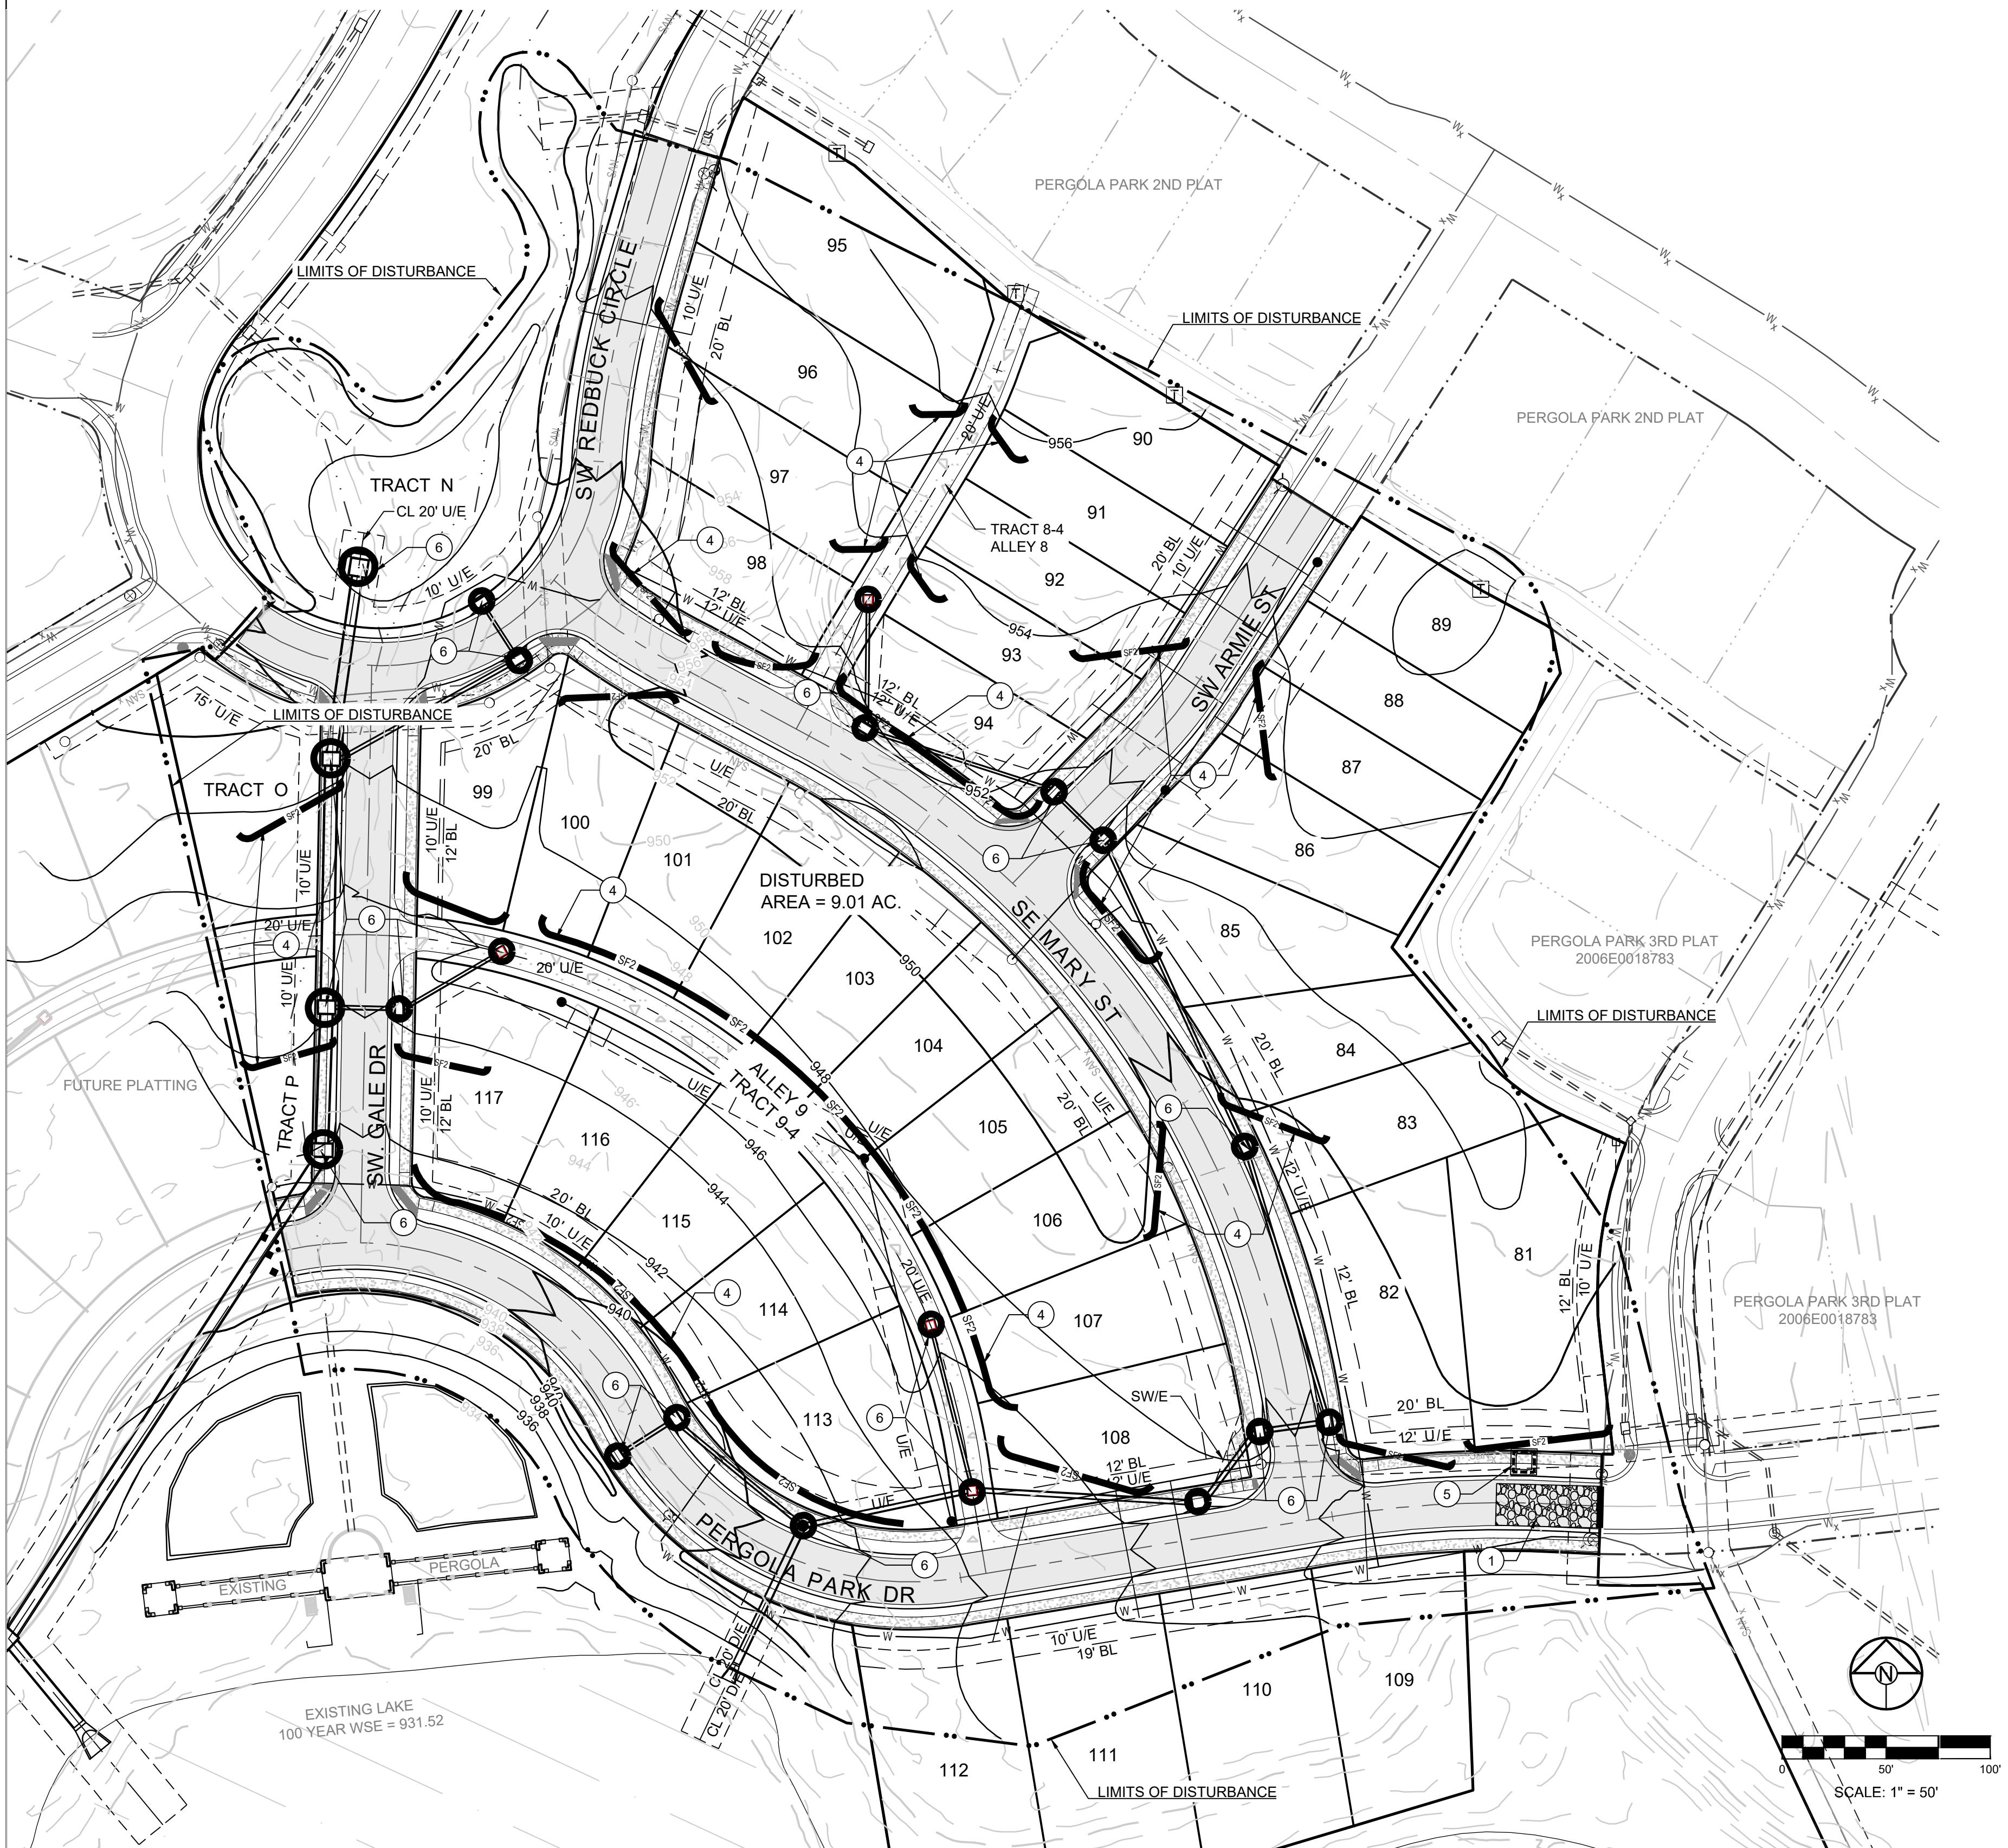

EROSION AND SEDIMENT CONTROL STAGING CHART				
PROJECT STAGE	BMP PLAN REF. NO.	BMP DESCRIPTION	REMOVE AFTER STAGE	NOTES:
A - PRIOR TO LAND DISTURBANCE	1	CONSTRUCTION ENTRANCE & STAGING AREA	D	MANTAIN, REPAIR, OR REPLACE AS NECESSARY
	2	SUPER SEDIMENT FENCE	E	PLACE WHERE INDICATED, REPAIR OR REPLACE AS NECESSARY AND REMOVE ONLY WHEN GRADED AREAS HAVE SUFFICIENT GROUND COVER ESTABLISHED
	3	SILT FENCE (PRIOR TO LAND DISTURBANCE)	E	PLACE WHERE INDICATED, REPAIR OR REPLACE AS NECESSARY AND REMOVE ONLY WHEN GRADED AREAS HAVE SUFFICIENT GROUND COVER ESTABLISHED
B - MASS GRADING	4	SILT FENCE (DURING CONSTRUCTION)	E	PLACE WHERE INDICATED, REPAIR OR REPLACE AS NECESSARY AND REMOVE ONLY WHEN GRADED AREAS HAVE SUFFICIENT GROUND COVER ESTABLISHED
	5	CONCRETE WASHOUT AREA	E	MANTAIN, REPAIR, OR REPLACE AS NECESSARY
C - UTILITY CONSTRUCTION	6	INLET PROTECTION (SILT FENCE)	D/E	PLACE SILT FENCE AROUND ALL STORM SEWER STRUCTURES / YARD AREA STORM STRUCTURES TO HAVE SILT FENCE REMOVED ONLY WHEN GRADED AREAS HAVE SUFFICIENT GROUND COVER ESTABLISHED
	7	INLET PROTECTION (GRAVEL FILTER BAGS)	E	BOARDS SHALL BE PLACED IN FRONT OF INLET OPENING FROM THE TIME SILT FENCE IS REMOVED UNTIL SUCH TIME THAT THE CURB / THROAT IS Poured. PLACE GRAVEL FILTER BAGS AT THE OPENING OF ALL CURB INLETS IMMEDIATELY AFTER THE INLET THROATS ARE Poured
	8	SILT FENCE (AFTER CURB CONSTRUCTION)	E	PLACE WHERE INDICATED, REPAIR OR REPLACE AS NECESSARY AND REMOVE ONLY WHEN GRADED AREAS HAVE SUFFICIENT GROUND COVER ESTABLISHED
	9	SEEDING AND MULCHING	E	ALL DISTURBED AREAS AFTER 14 DAYS OF CONSTRUCTION INACTIVITY
				ADDITIONAL SEDIMENT AND EROSION CONTROL MEASURES MAY BE REQUIRED ANY TIME CURRENT MEASURES ARE FOUND TO BE INEFFECTIVE.
E - UNTIL CLOSURE OF LAND DISTURBANCE PERMIT				

**PERGOLA PARK 4TH PLAT
STREET, STORMWATER, MASTER DRAINAGE
PLAN AND EROSION AND SEDIMENT**

- LEE'S SUMMERTIME, MISSOURI





LEGEND	
TEMP. CONSTRUCTION ENTRANCE AND STAGING AREA	SF SUPER SEDIMENT SILT FENCE (PRIOR TO LAND DISTURBANCE)
CONCRETE WASHOUT AREA	SF1 SILT FENCE (PRIOR TO LAND DISTURBANCE)
SILT FOAM DIKE - STAKED & INSTALL PER MFR'S RECOMMENDATIONS	SF2 SILT FENCE (DURING CONSTRUCTION)
BMP PLAN REF. NO.	-- LIMITS OF DISTURBANCE
SILT FENCE FOR INLET PROTECTION PRIOR TO STRUCTURE TOP	965 EXISTING CONTOURS
	965 PROPOSED CONTOURS
	GRAVEL FILTER FOR STORM SEWER STRUCTURES ONLY

DISTURBED AREA = 9.01 A.C.

SITE SPECIFIC NOTES:

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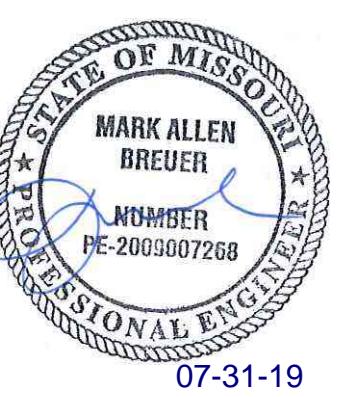
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PROJECT STAGE	BMP PLAN REF. NO.	BMP DESCRIPTION	REMOVE AFTER STAGE	NOTES:
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	8	SILT FENCE (AFTER CURB CONSTRUCTION)	E	Place where indicated, repair or replace as necessary and remove only when graded areas have sufficient ground cover established
	9	SEEDING AND MULCHING	E	All disturbed areas after 14 days of construction inactivity
E - UNTIL CLOSURE OF LAND DISTURBANCE PERMIT				Additional sediment and erosion control measures may be required any time current measures are found to be ineffective.

PERGOLA PARK 4TH PLAT STREET, STORMWATER, MASTER DRAINAGE PLAN AND EROSION AND SEDIMENT

- LEE'S SUMMIT, MISSOURI



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9

OF 28

POST
CONSTRUCTION
EROSION
CONTROL

SHEET





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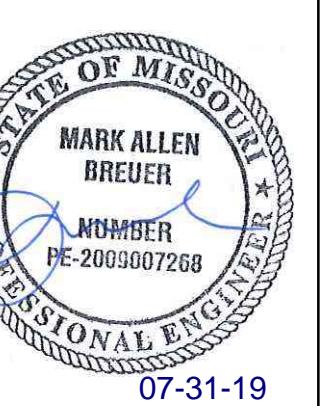


07-31-19

PERGOLA PARK 4TH PLAT STREET, STORMWATER, MASTER DRAINAGE PLAN AND EROSION AND SEDIMENT





- LEE'S SUMMIT, MISSOURI



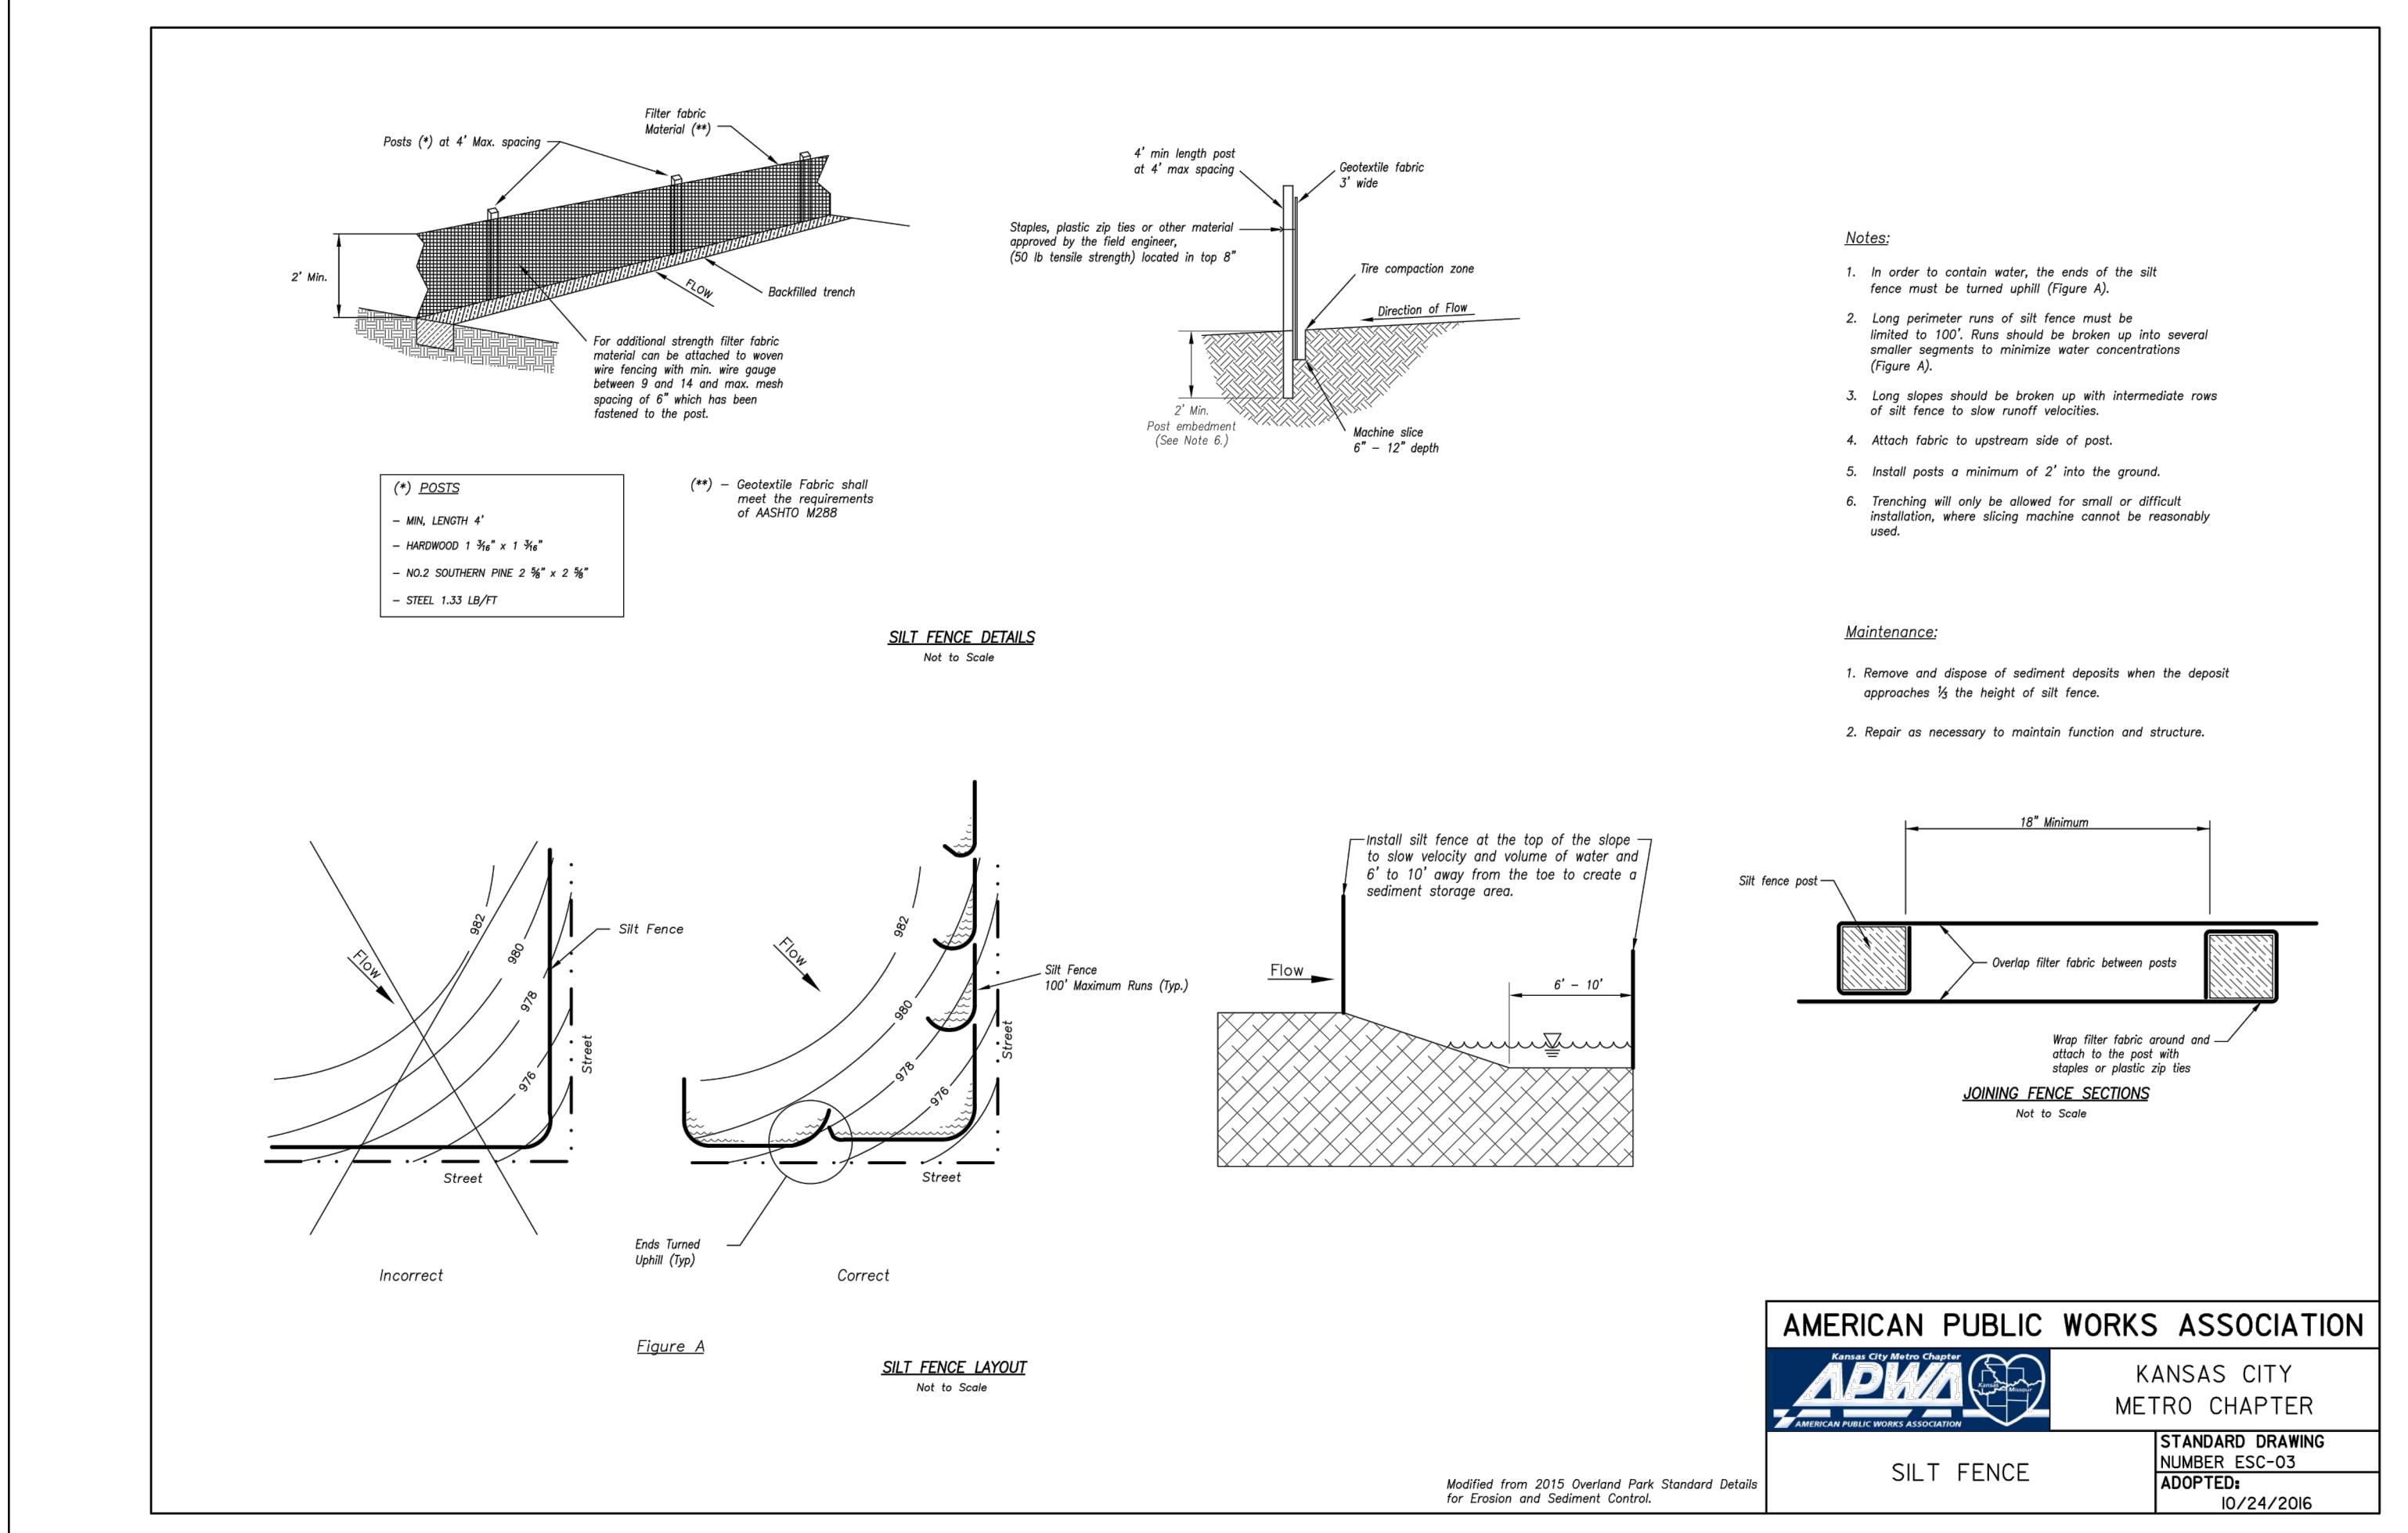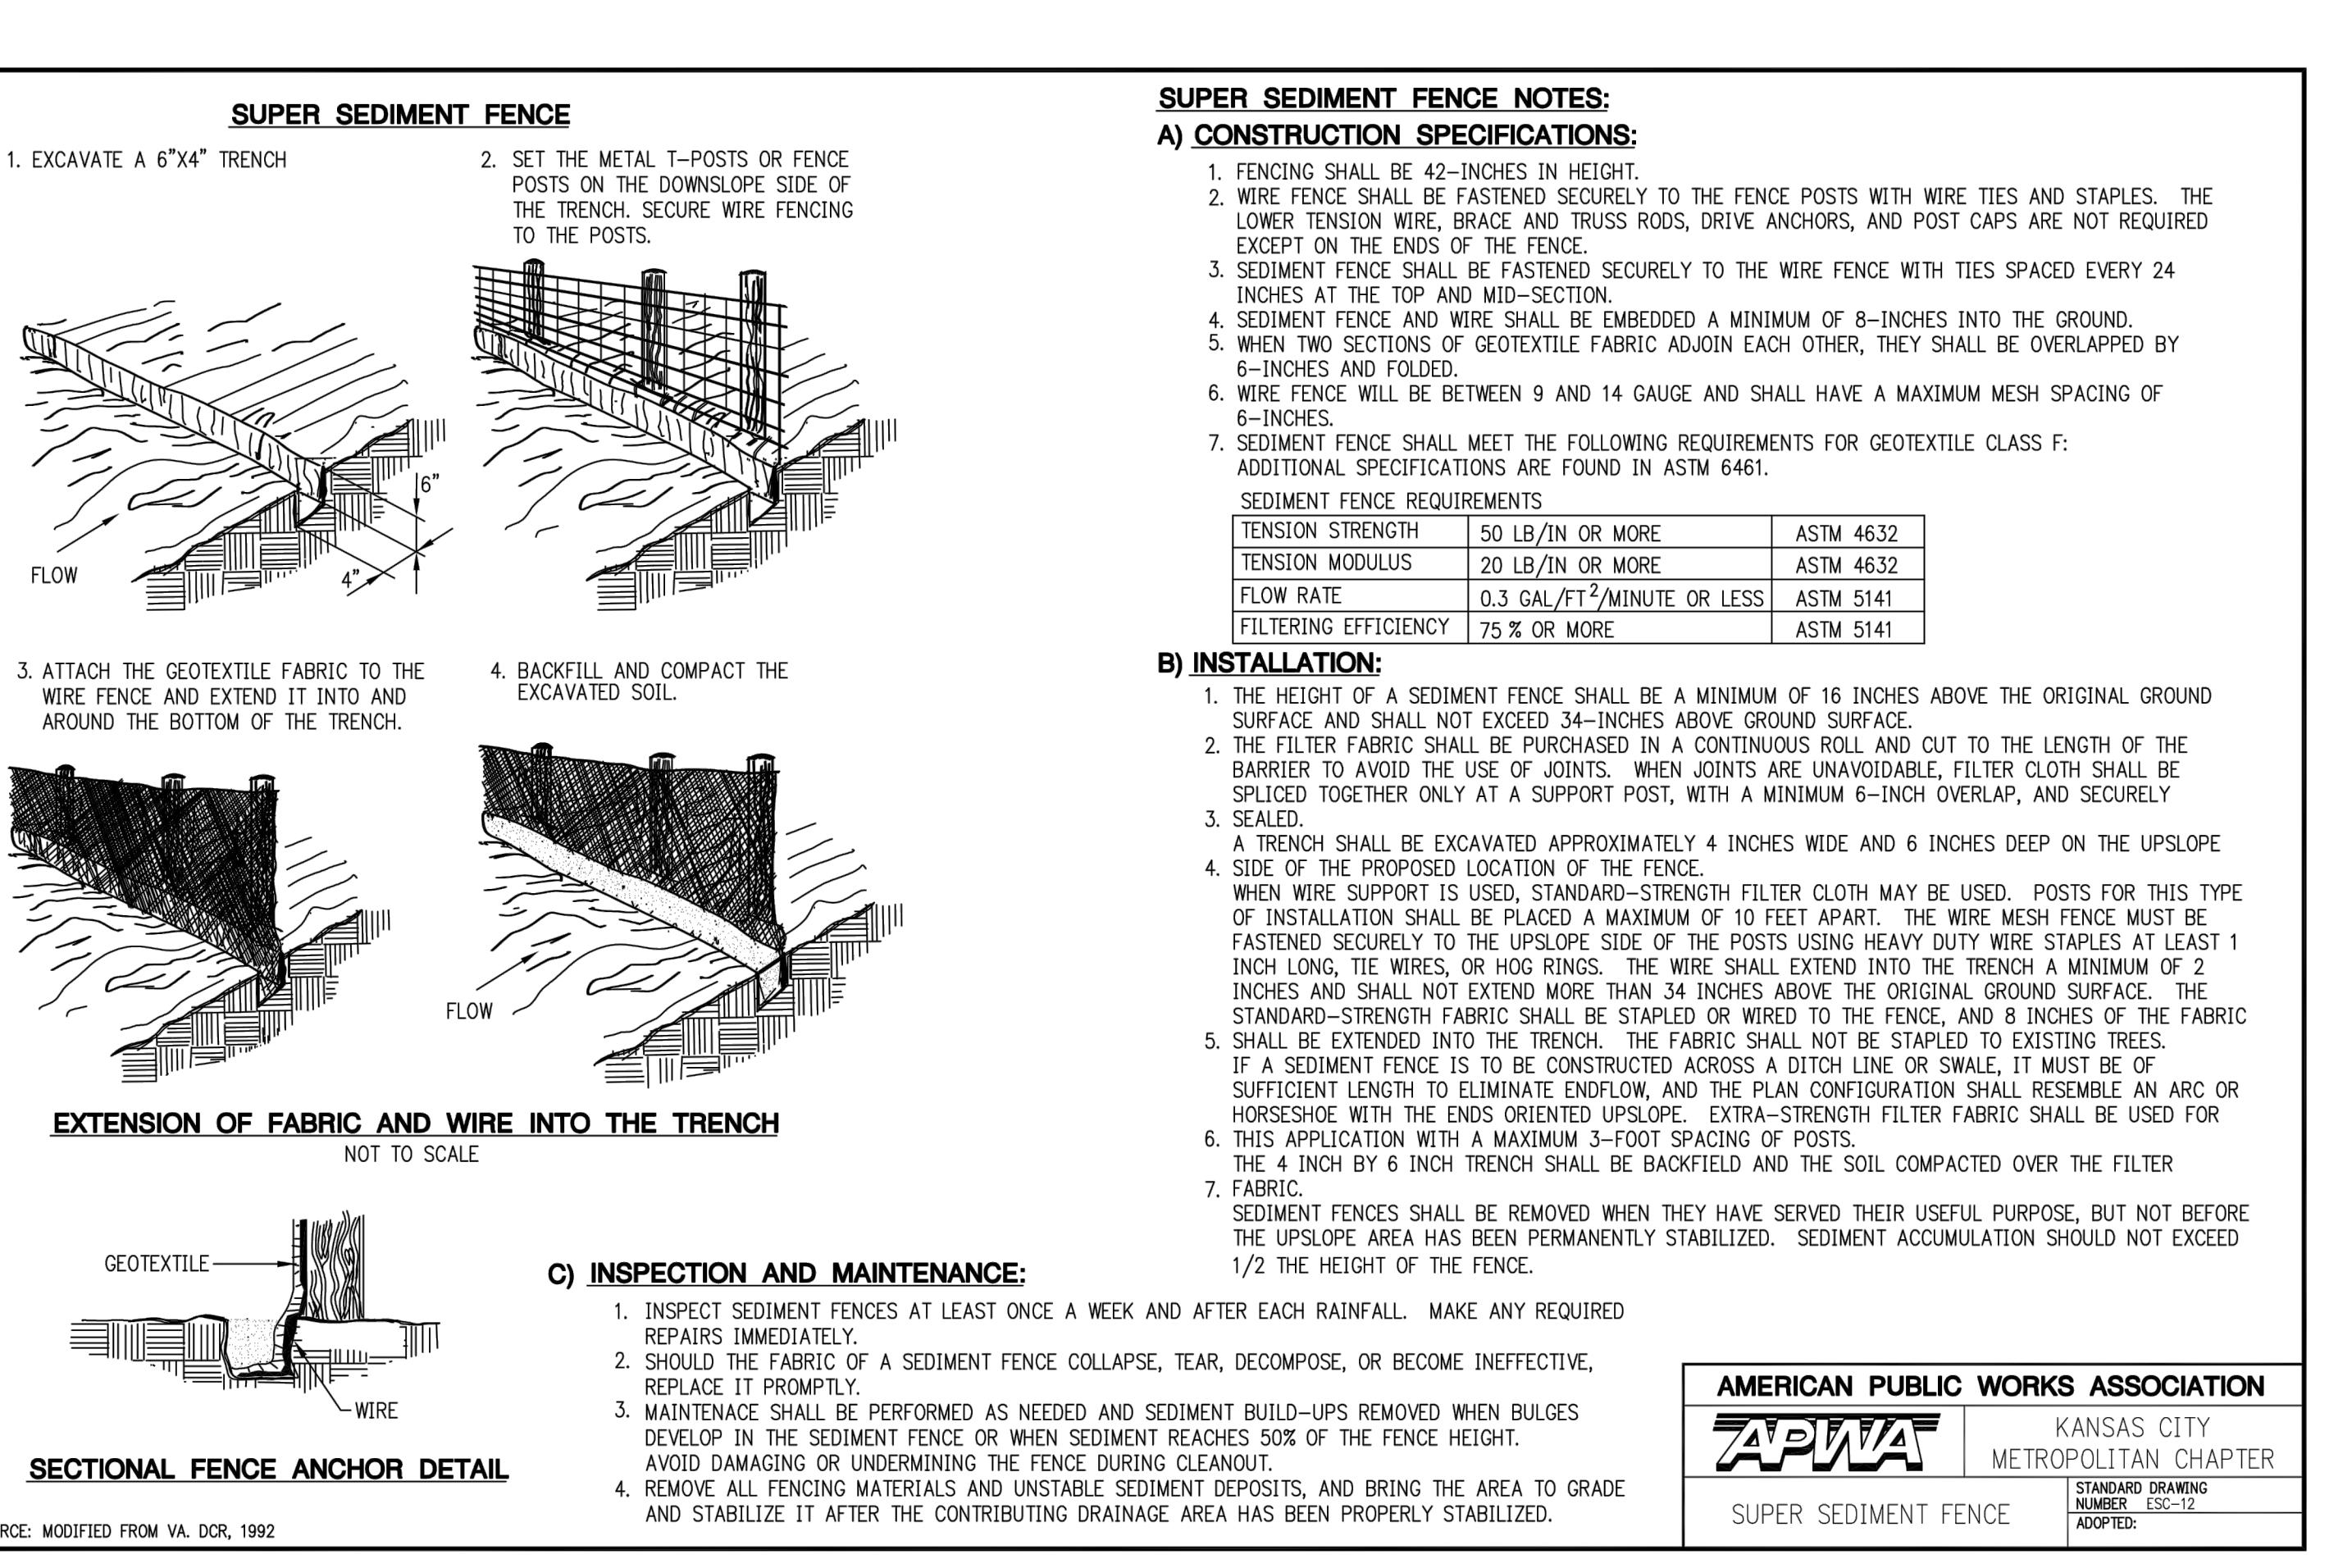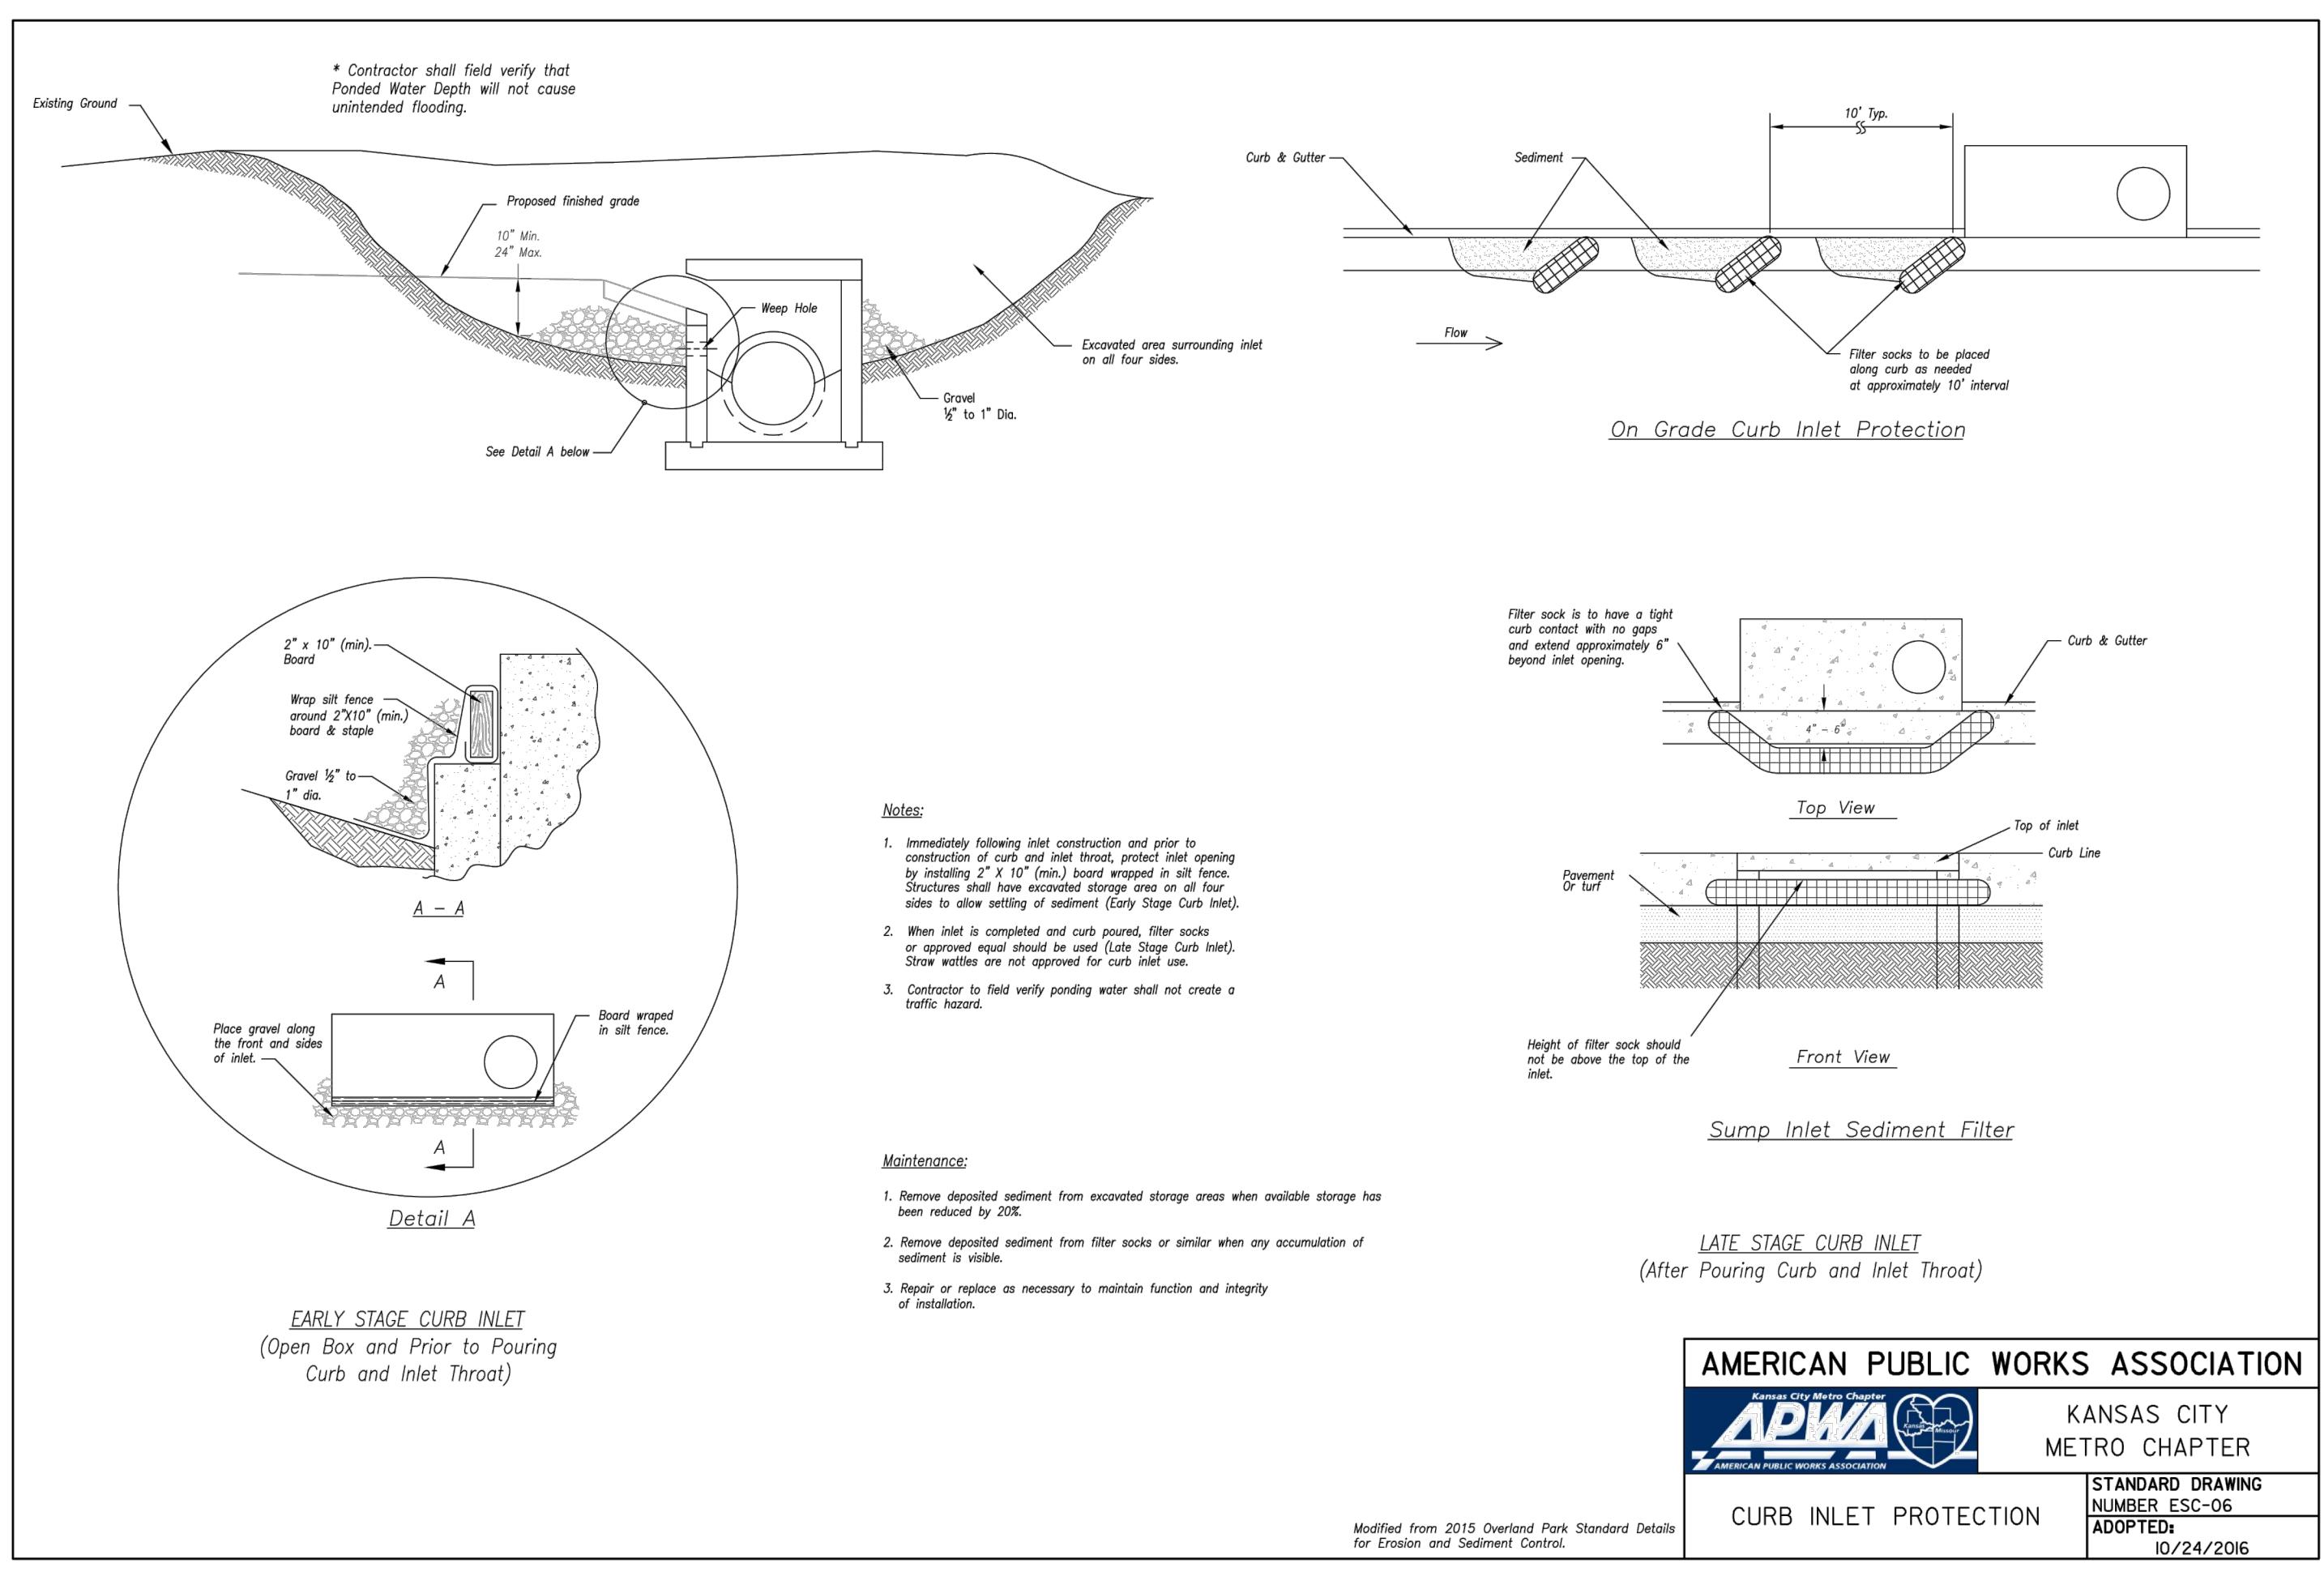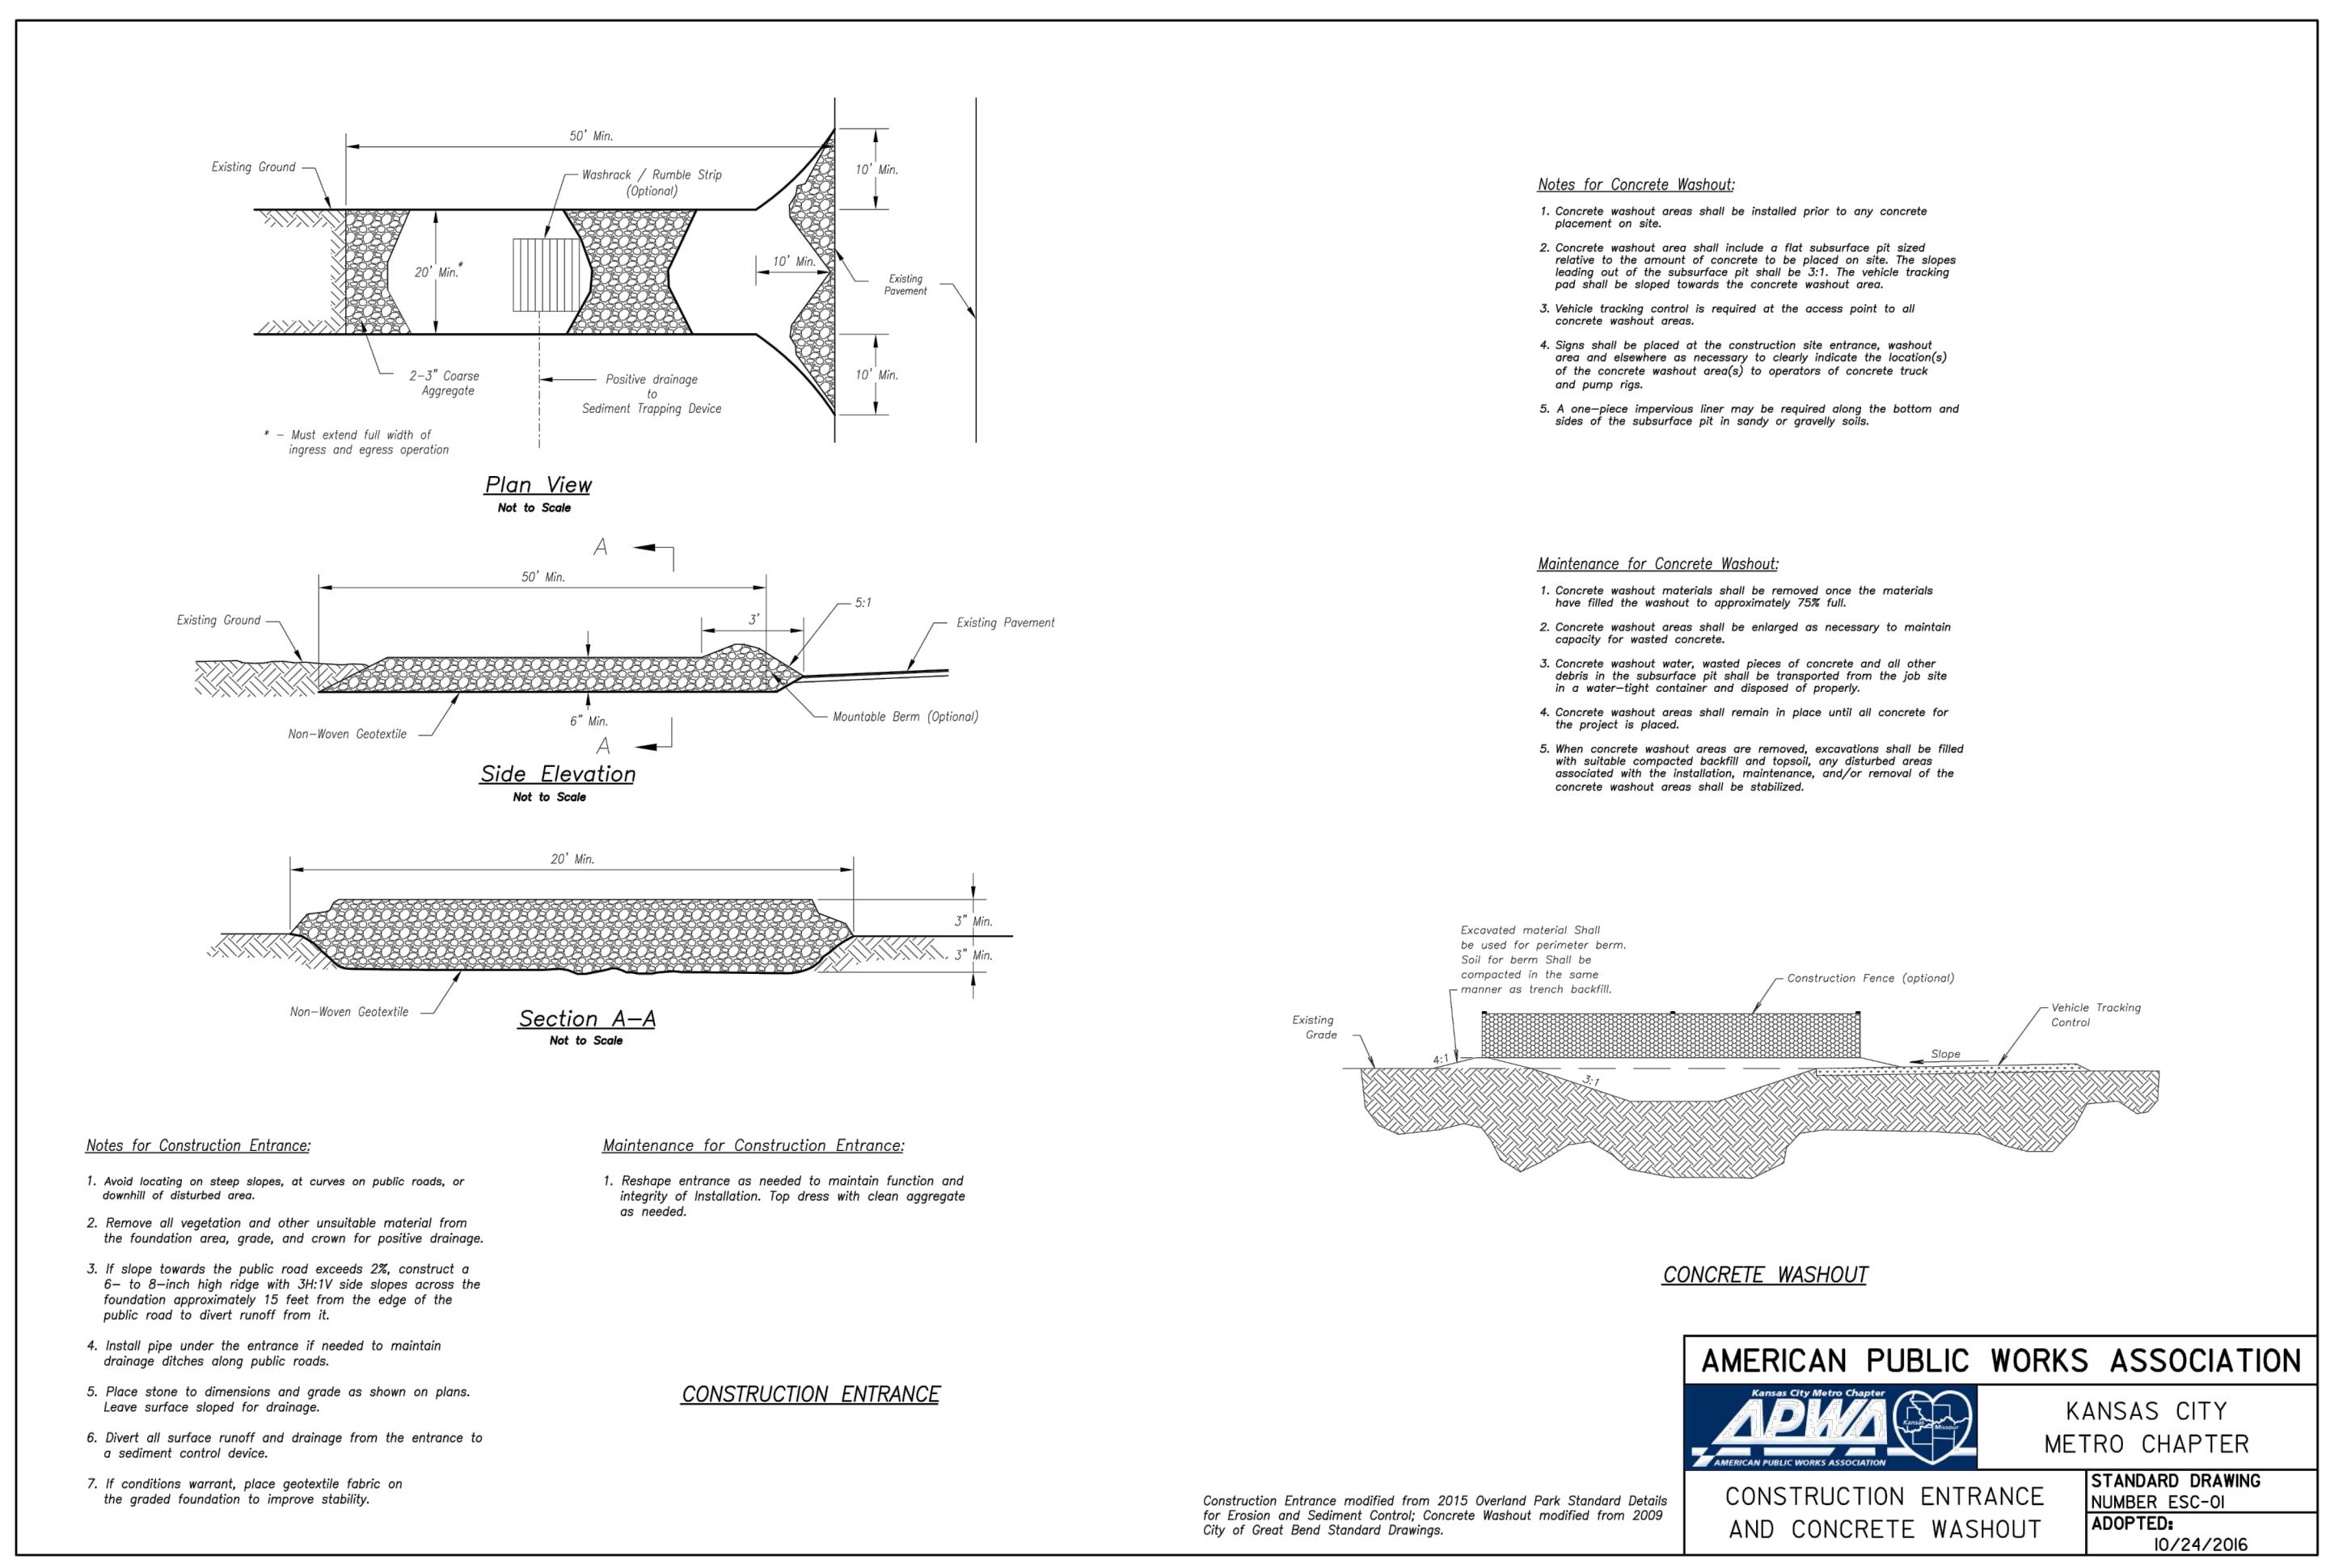

07-31-19

PERGOLA PARK 4TH PLAT STREET, STORMWATER, MASTER DRAINAGE PLAN AND EROSION AND SEDIMENT CONTROL, SUMMERTIME, MISSOURI

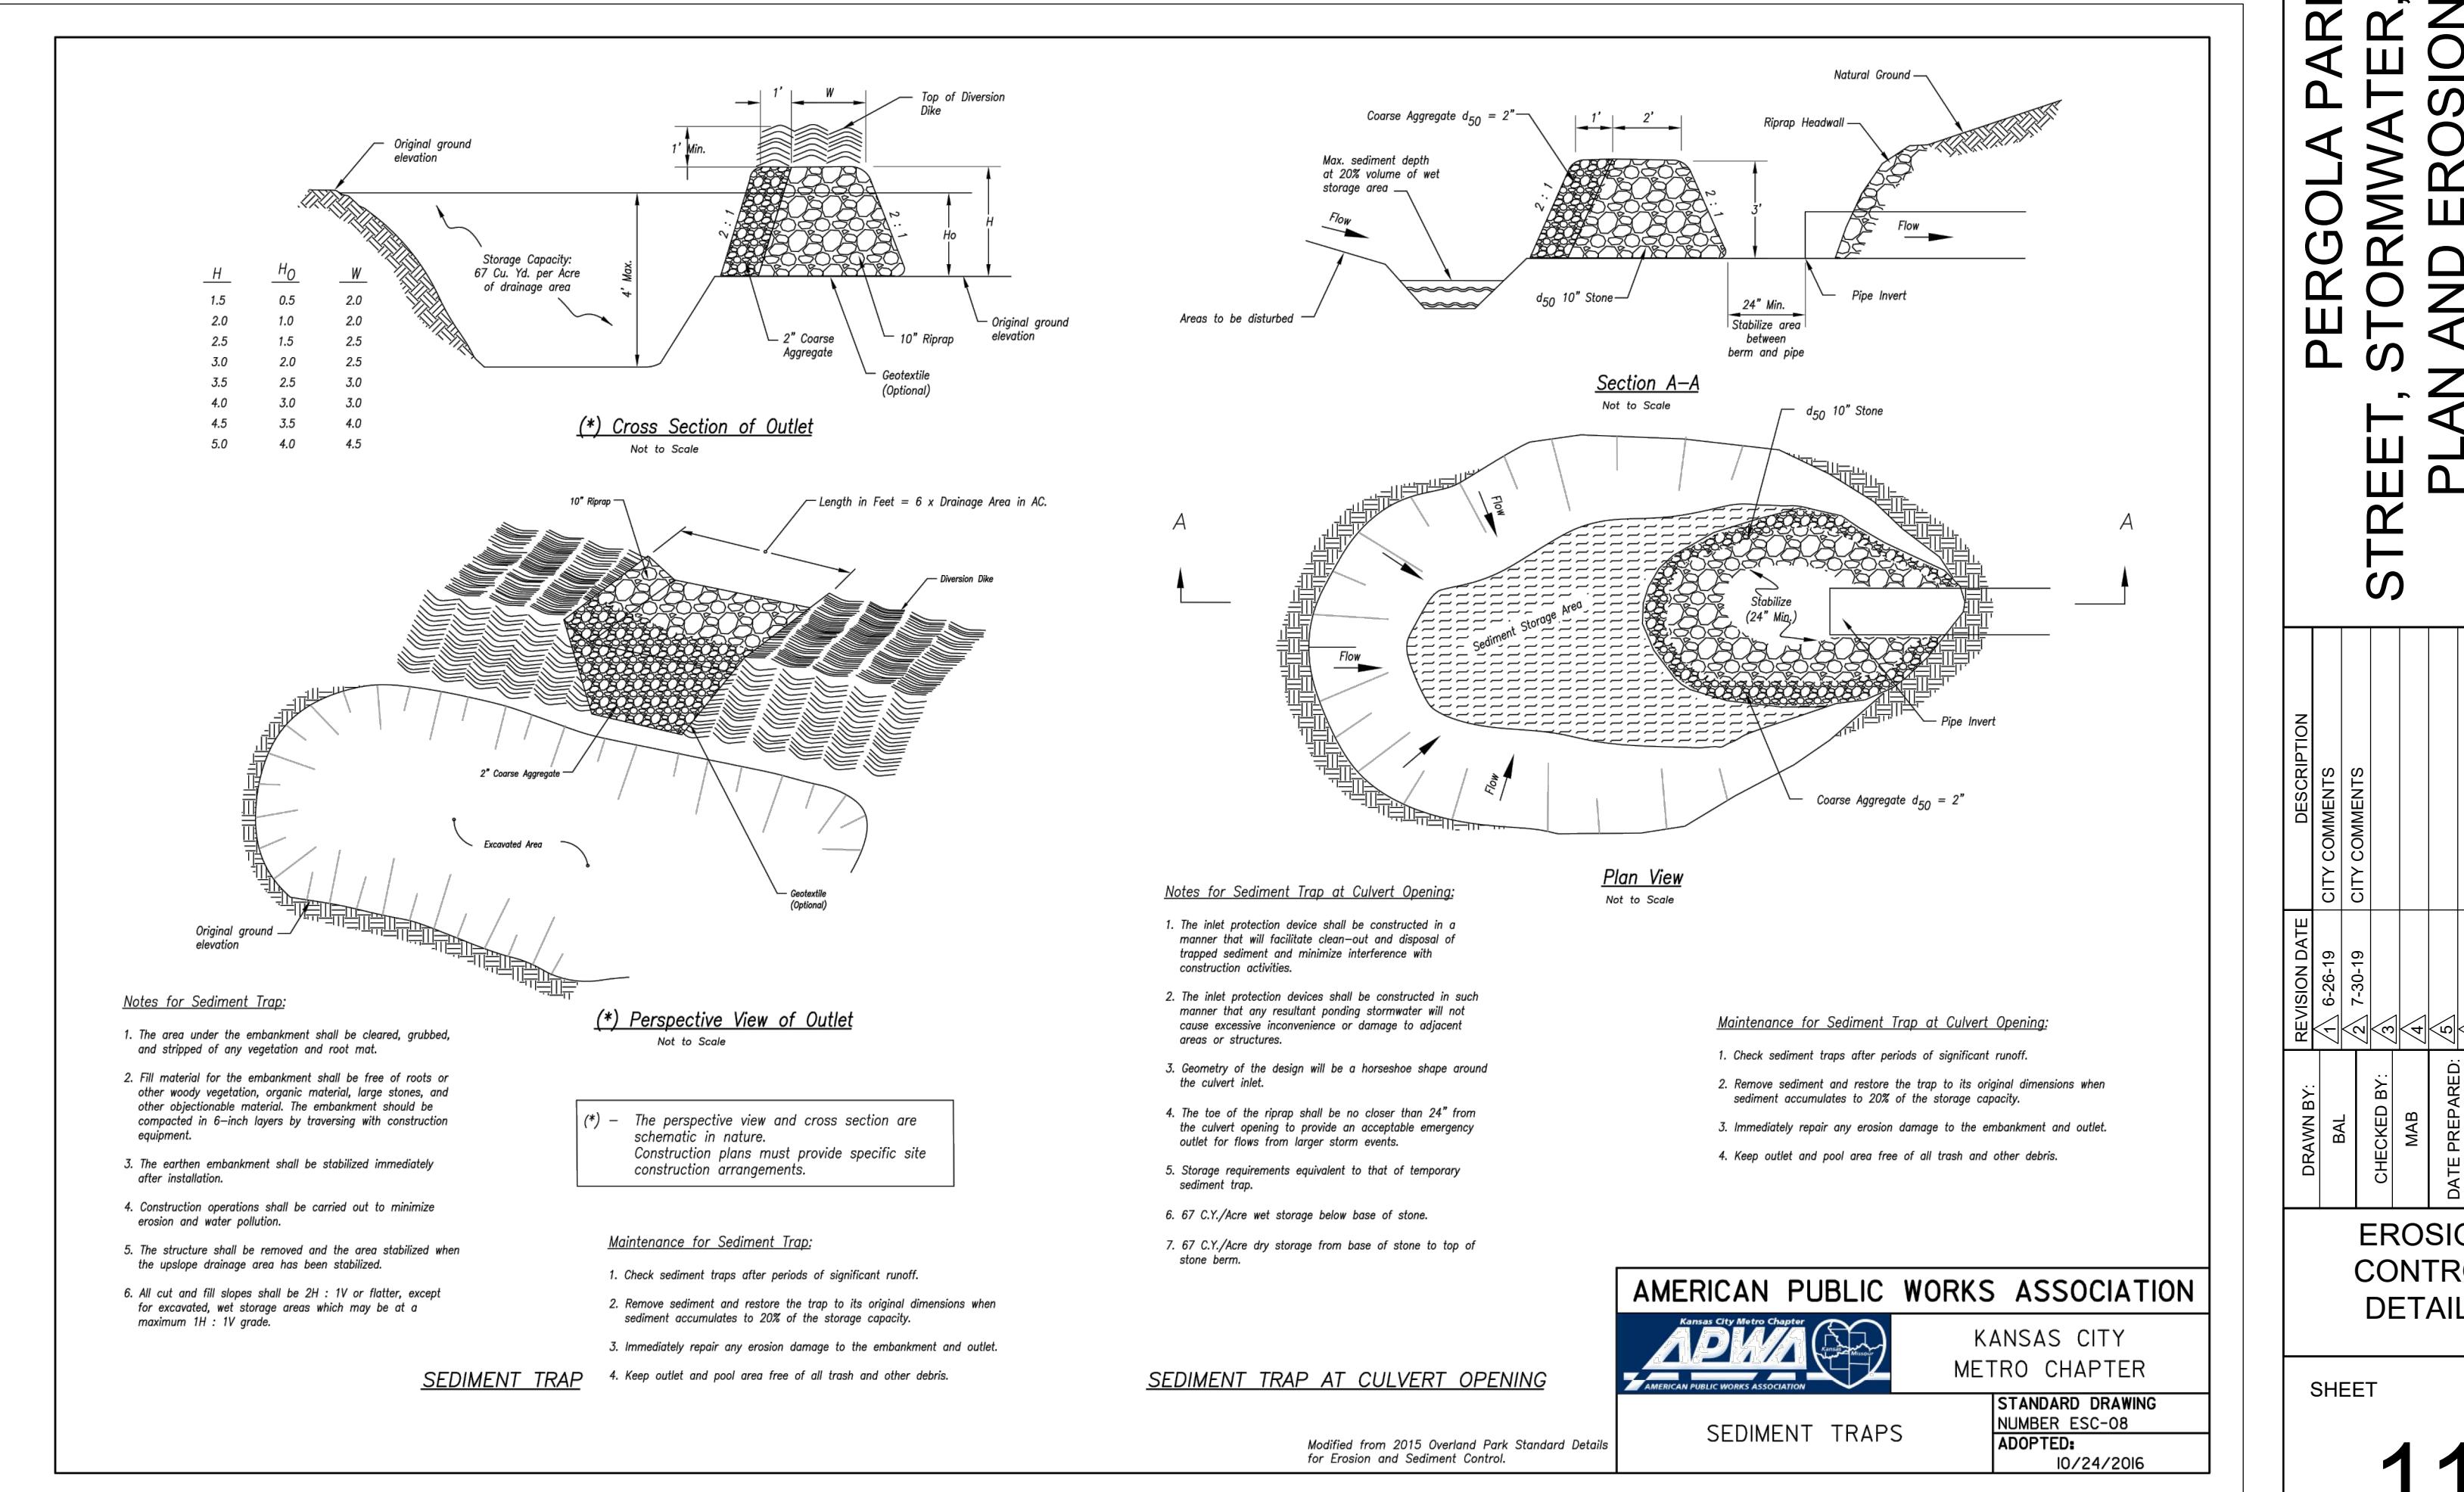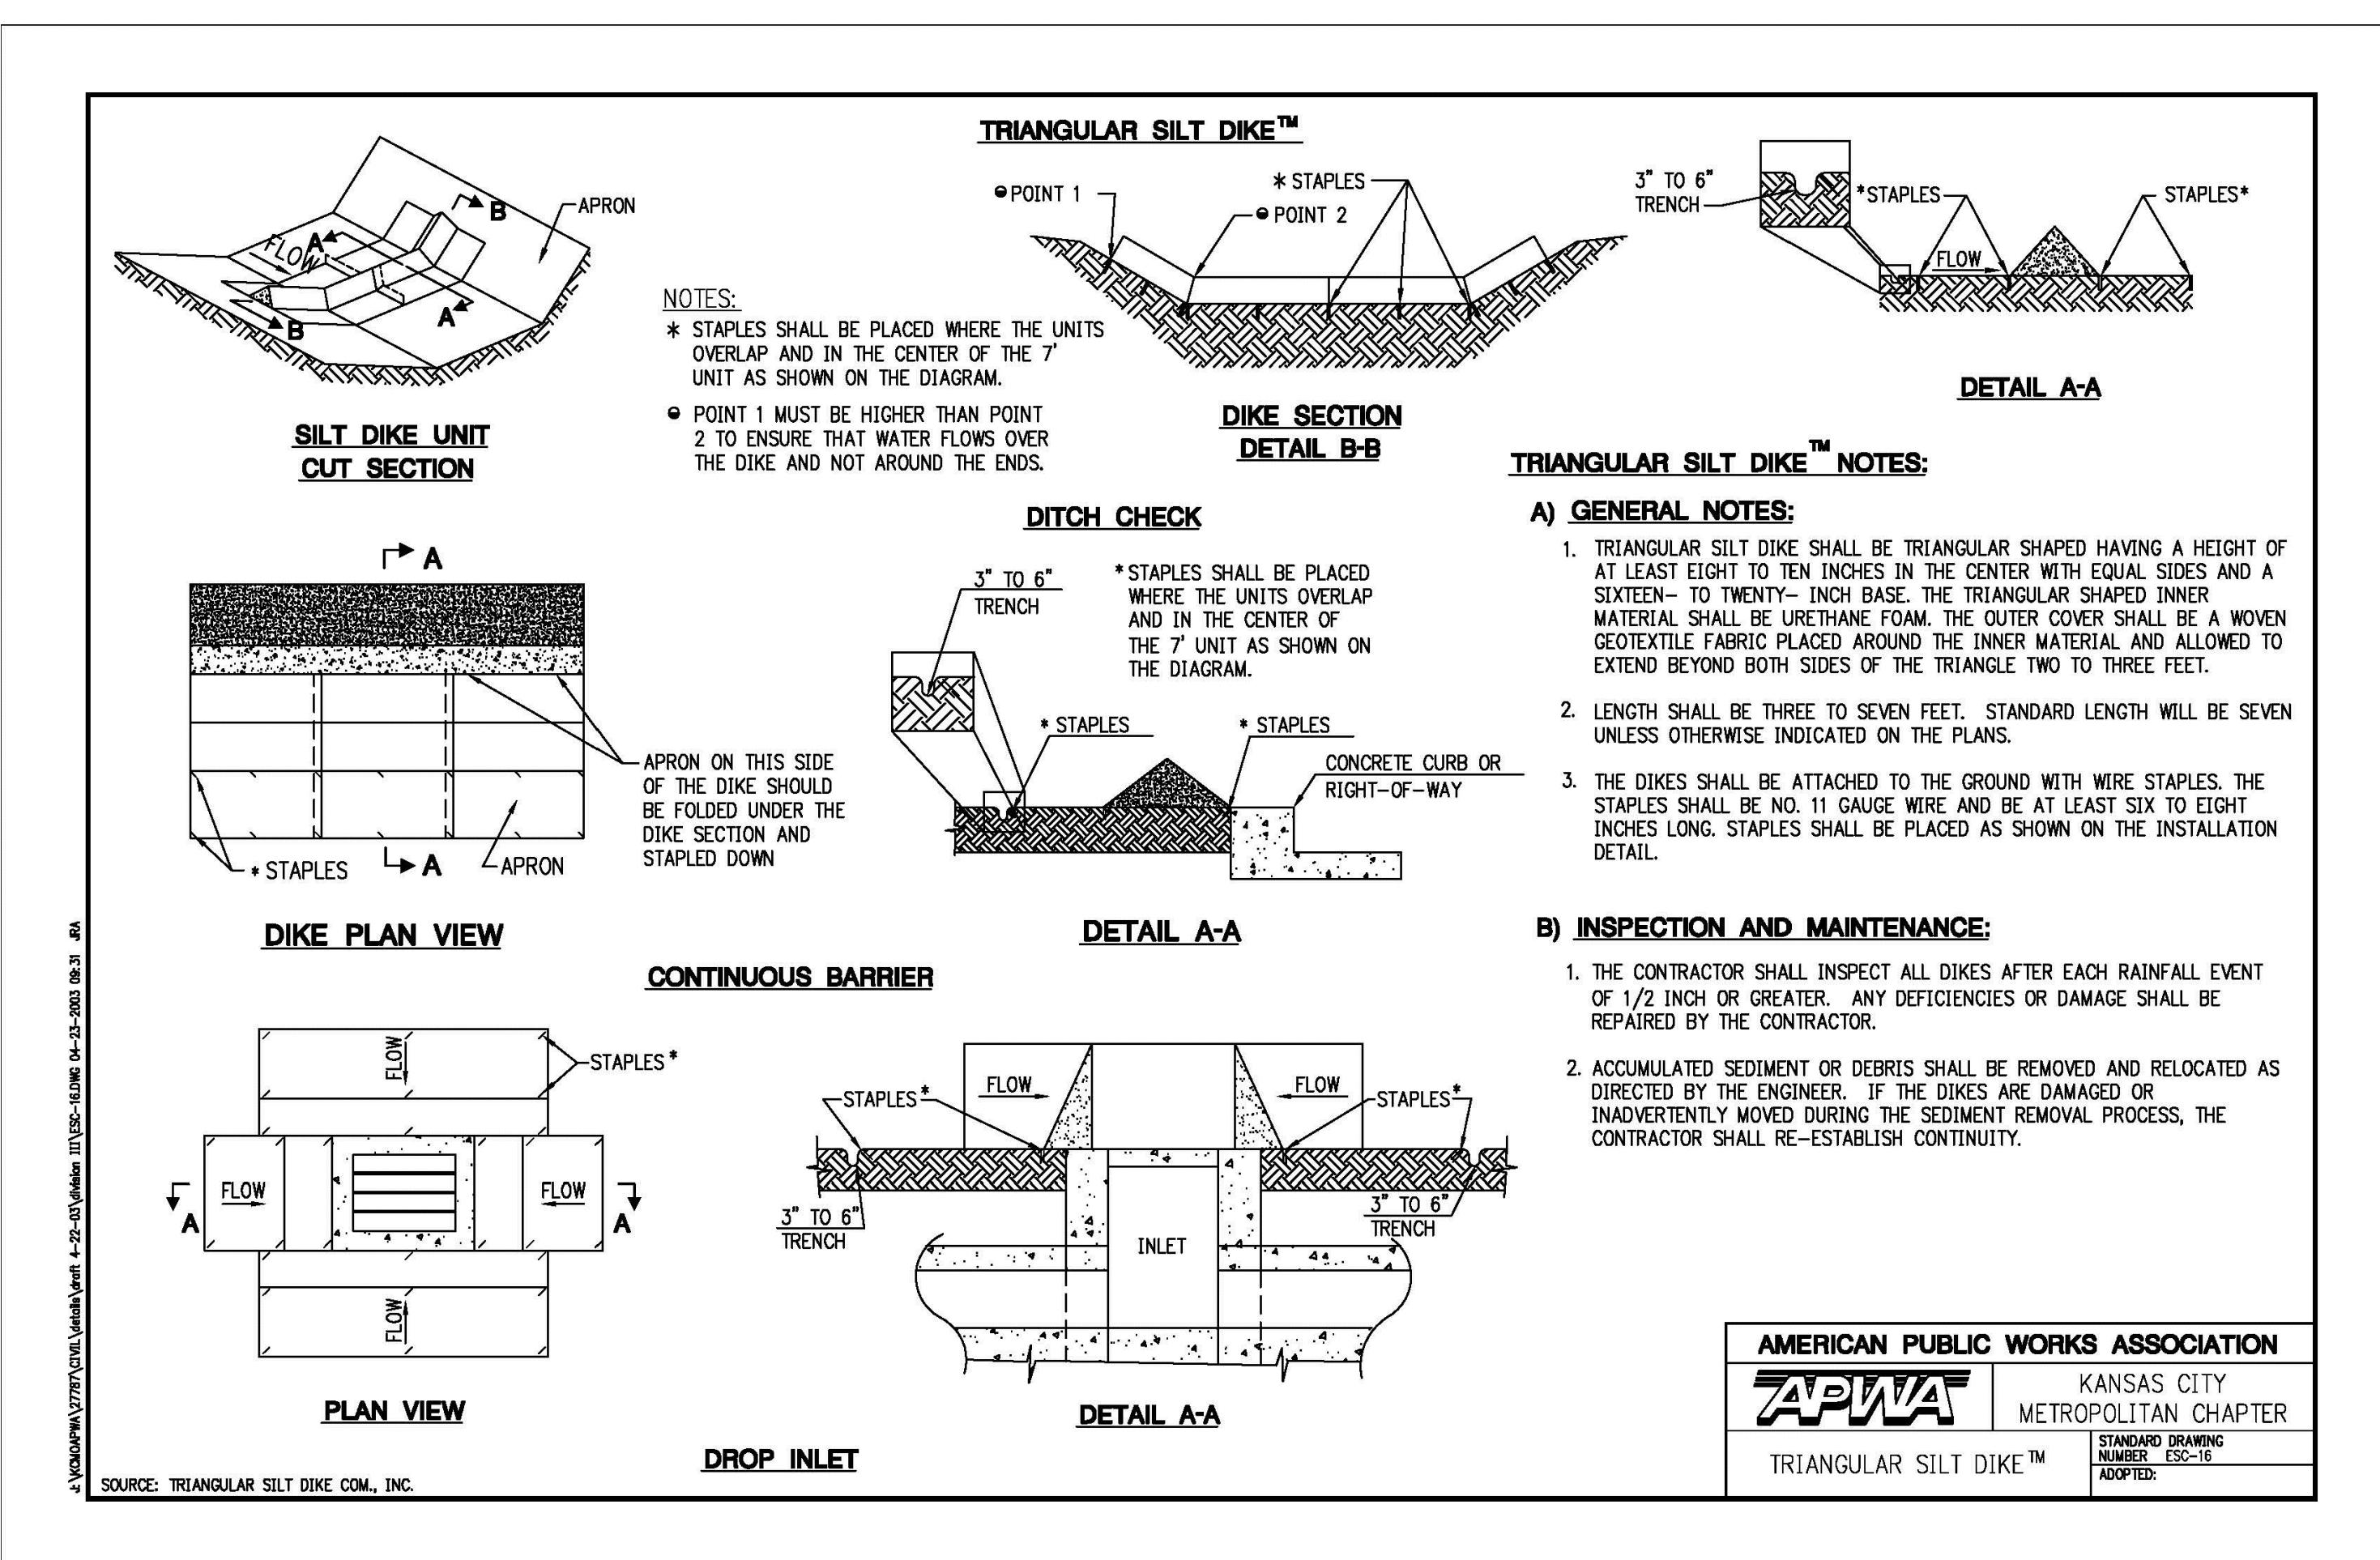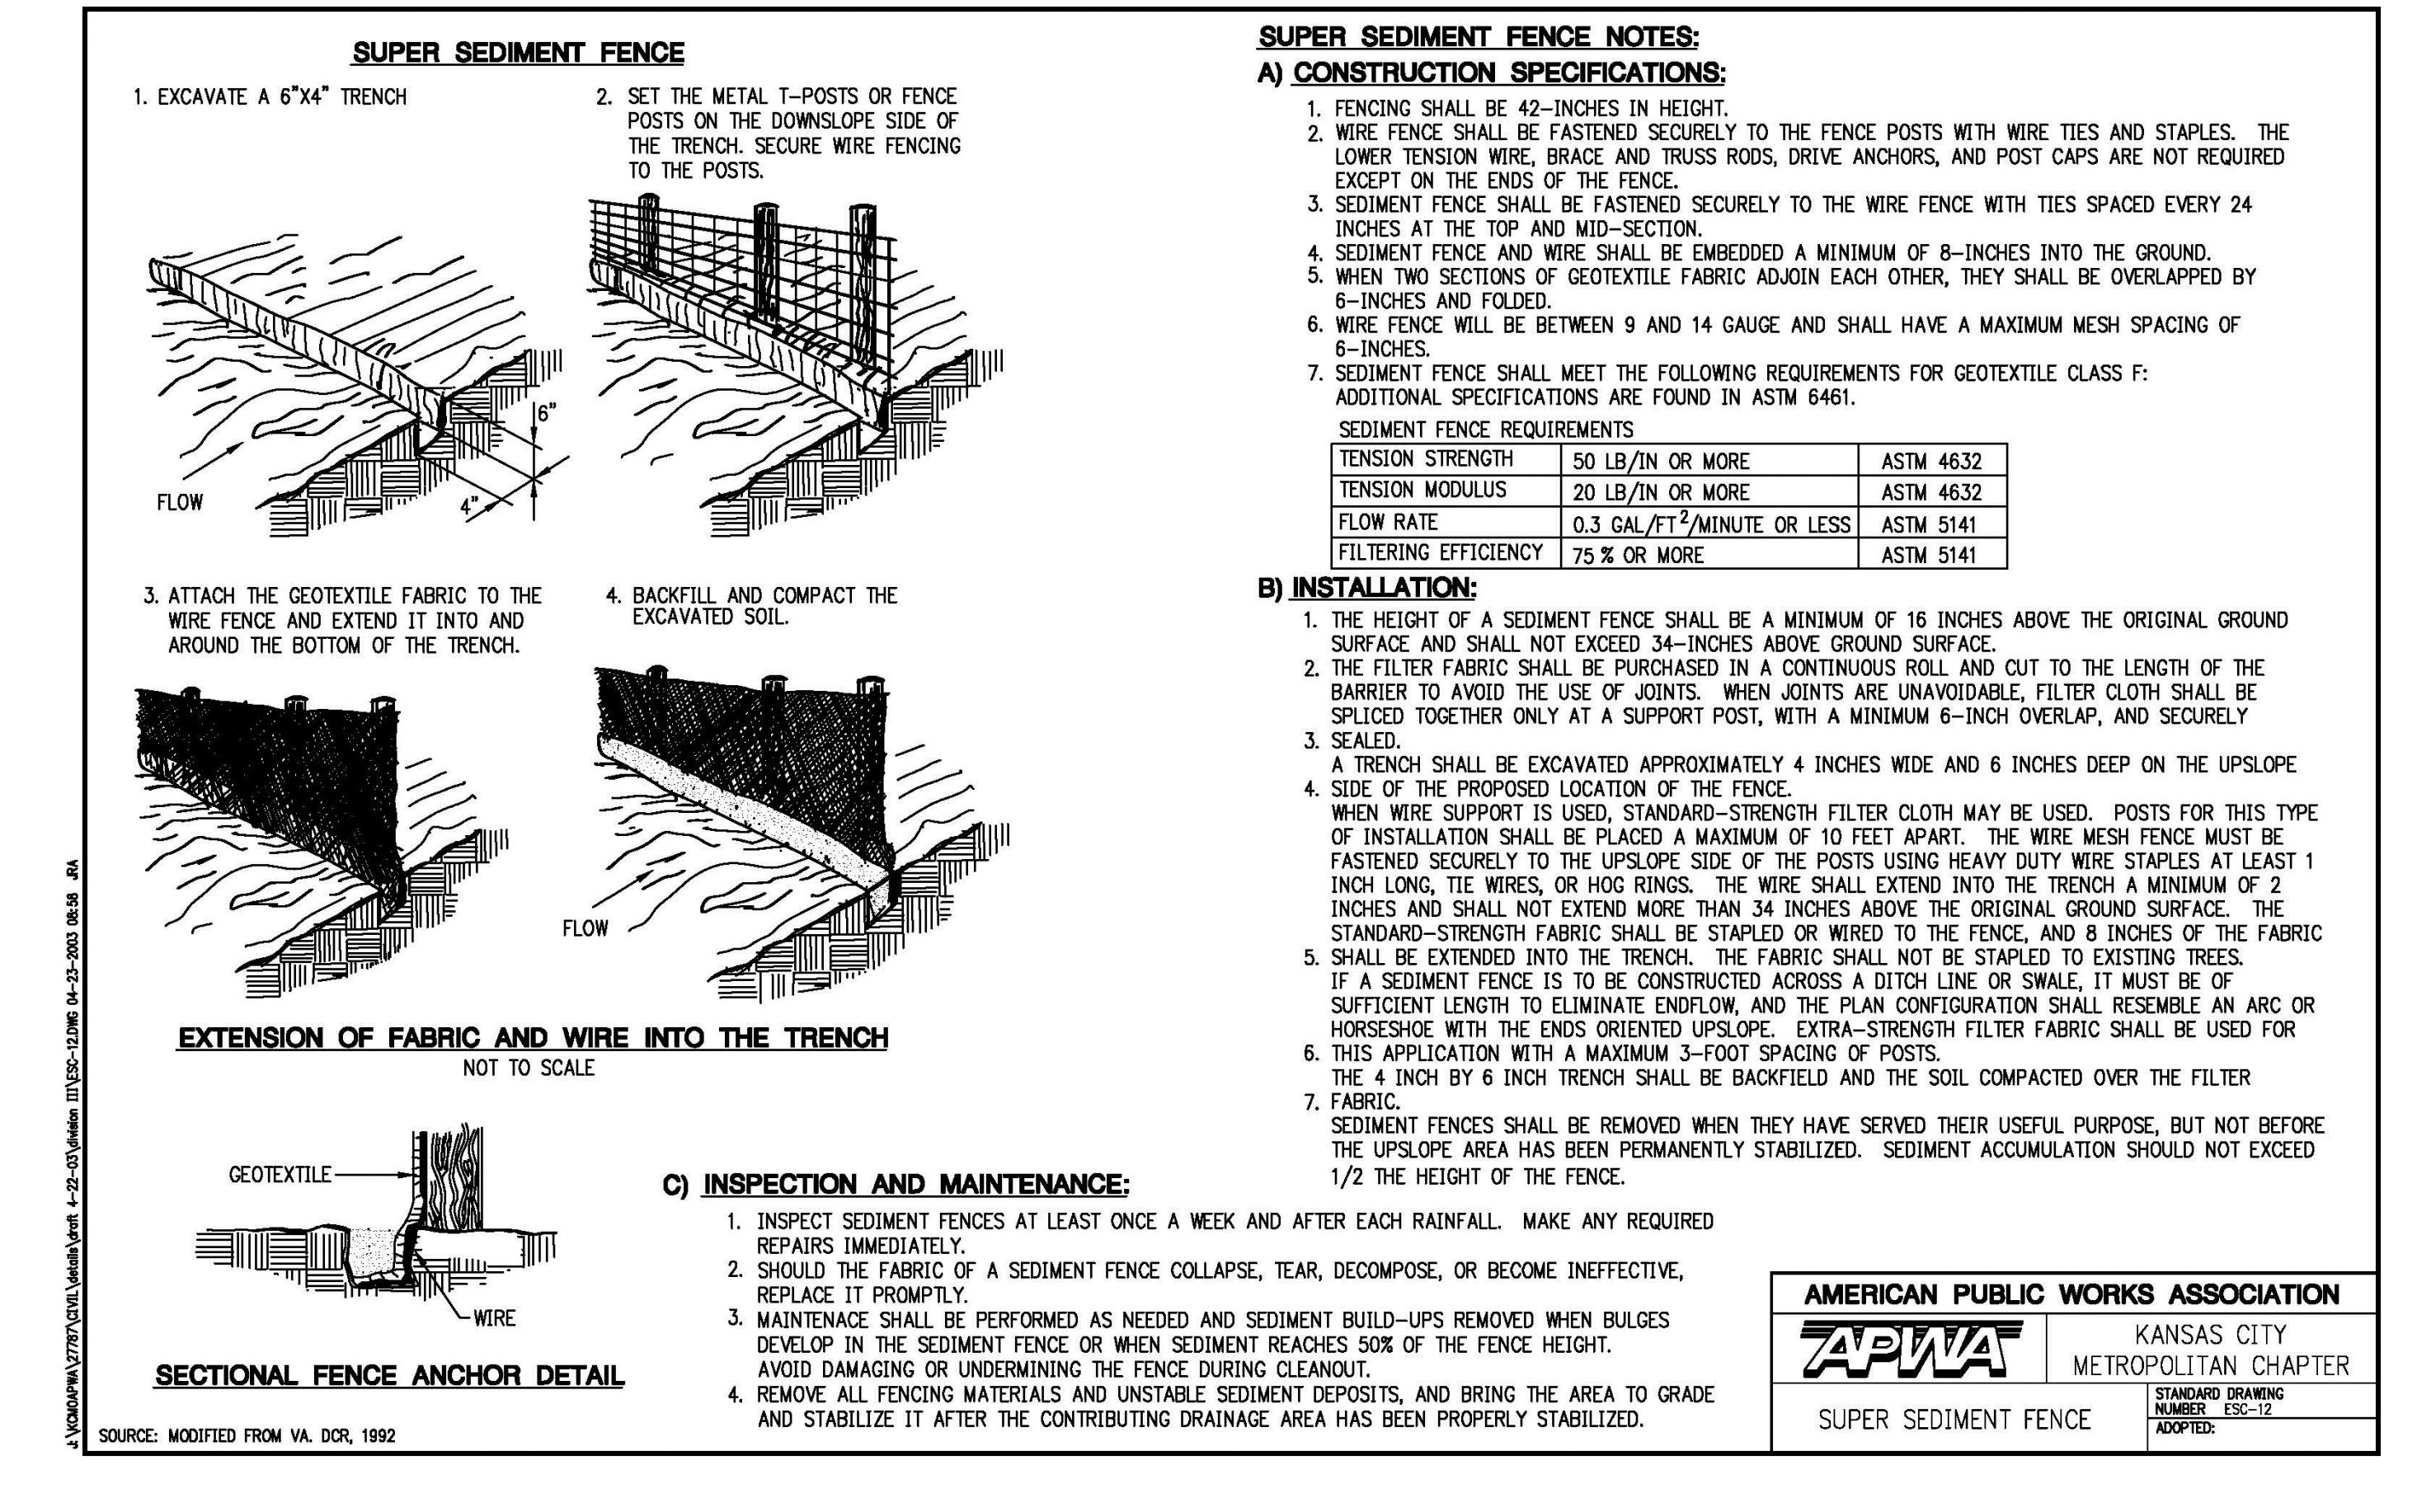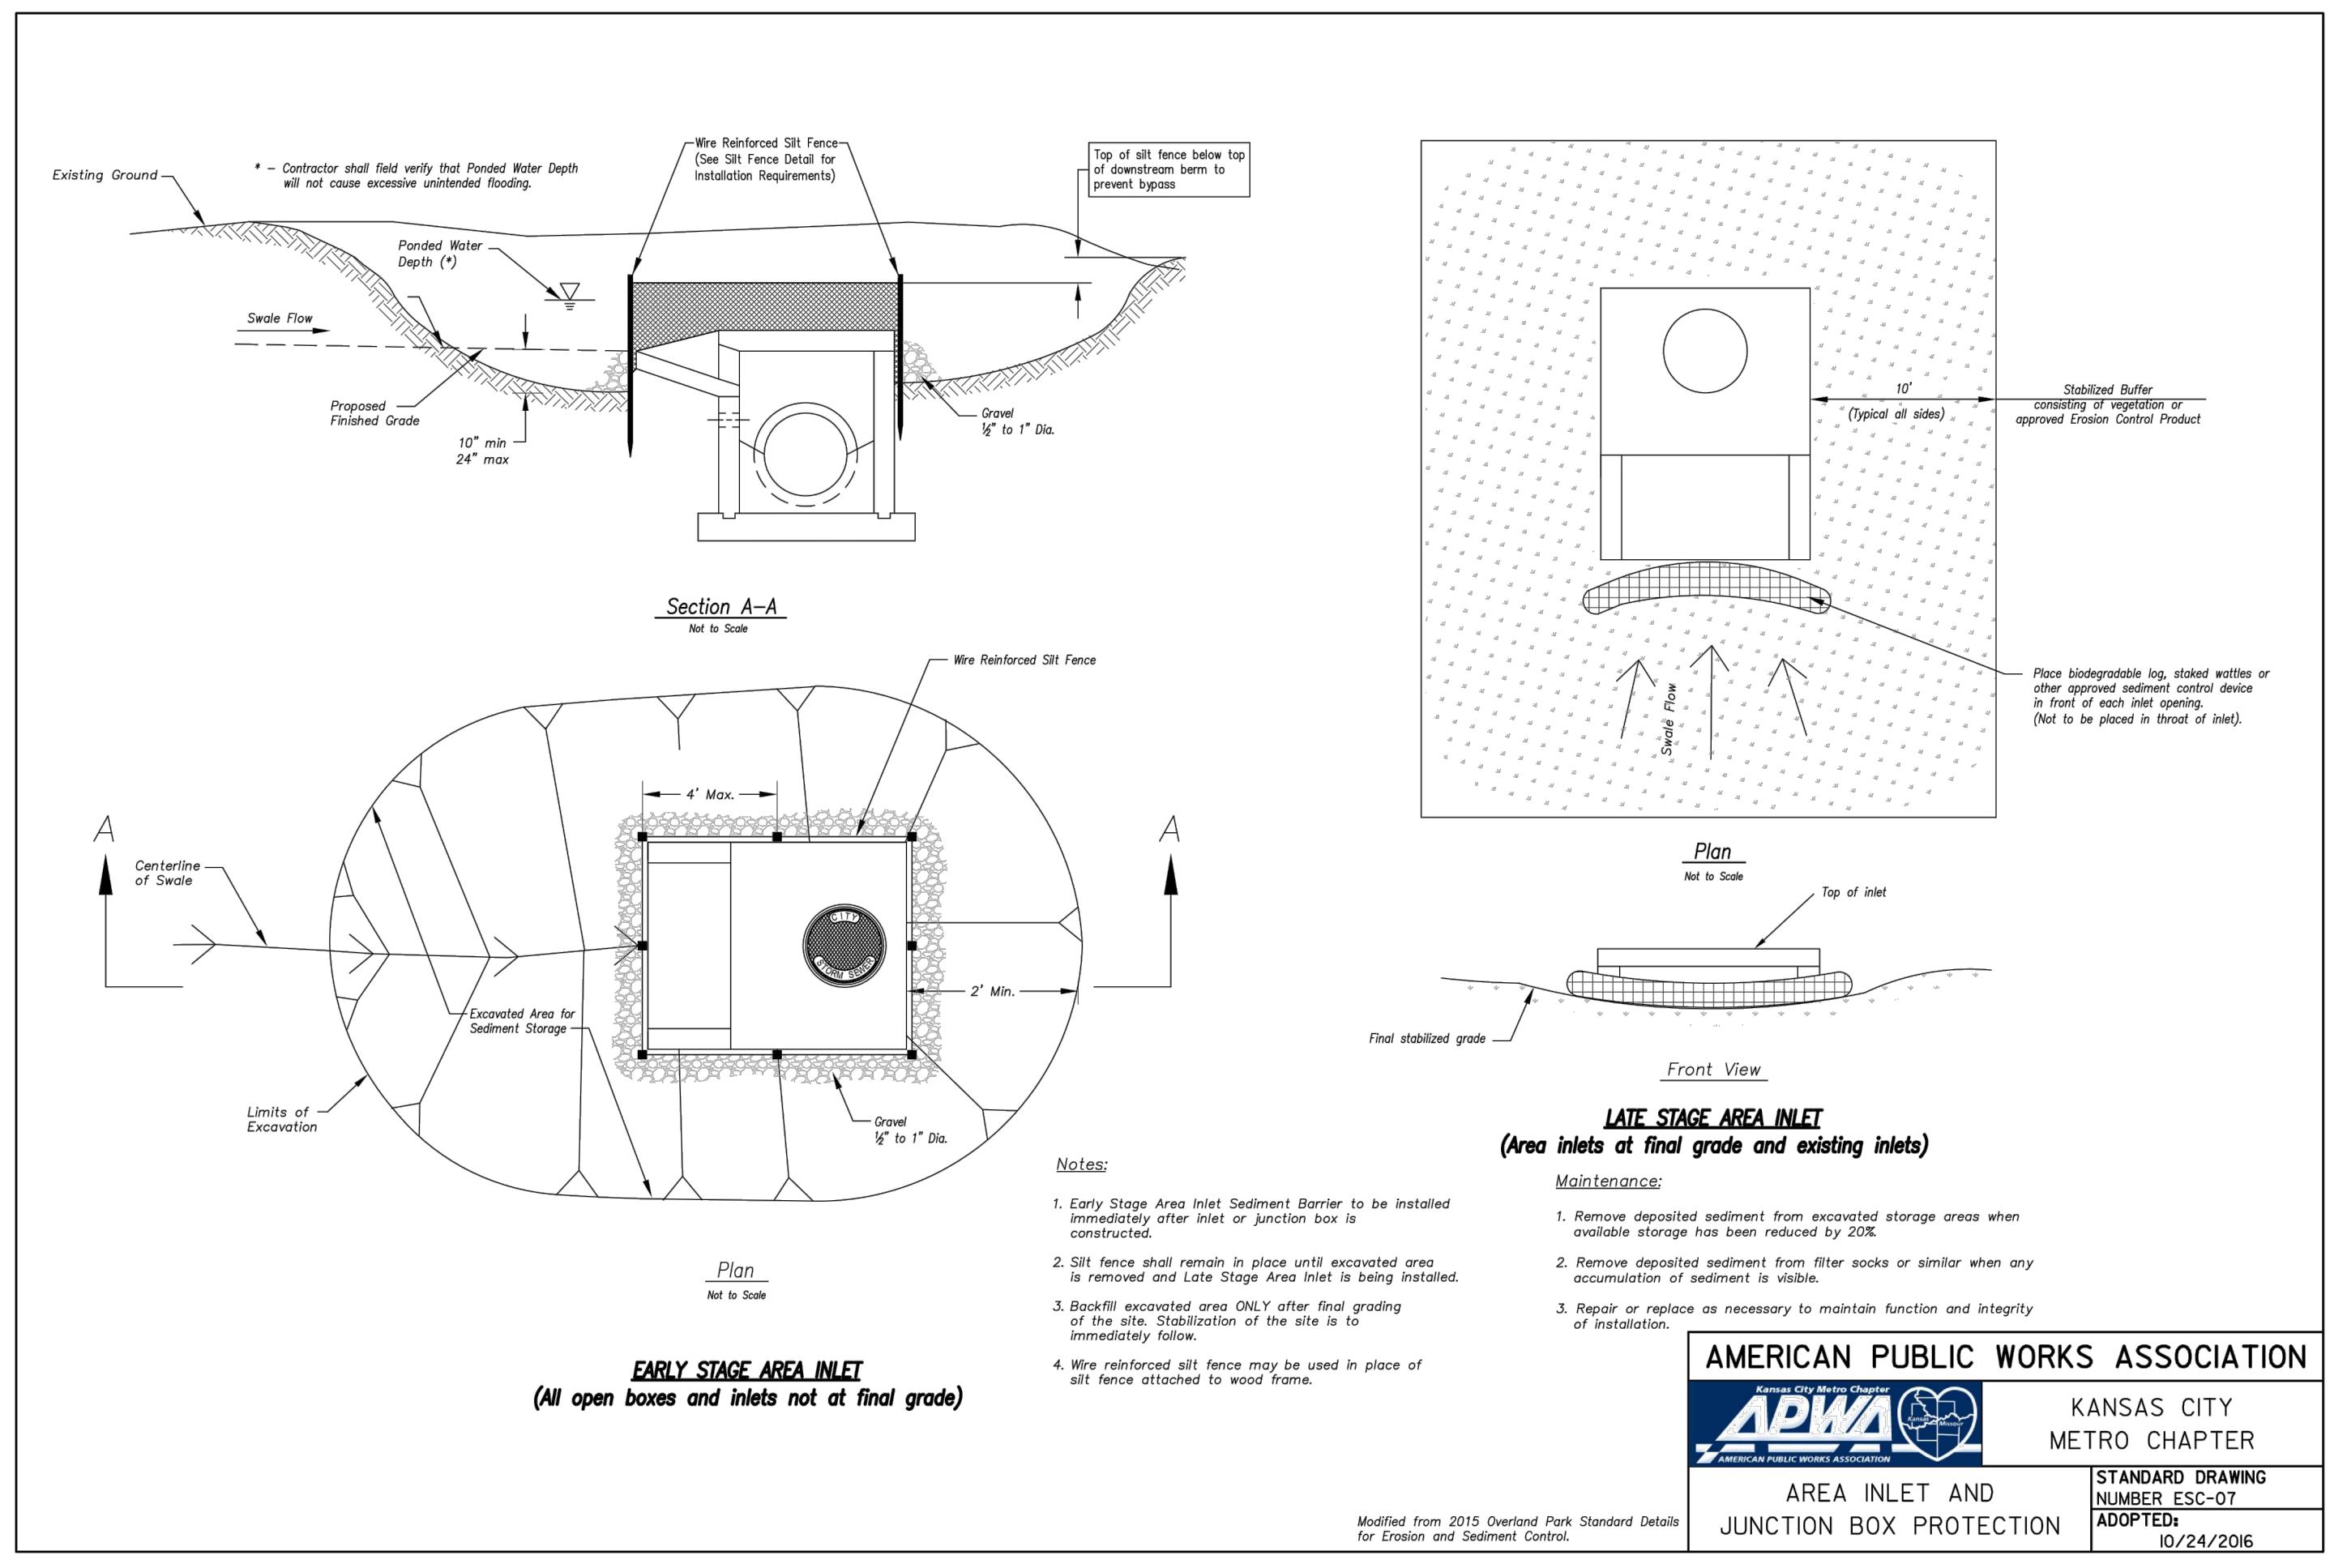

NOTE:

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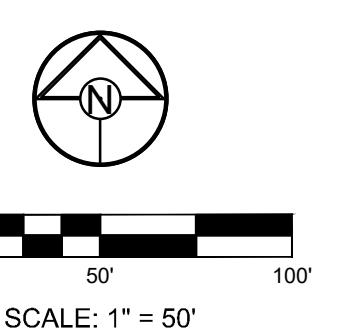
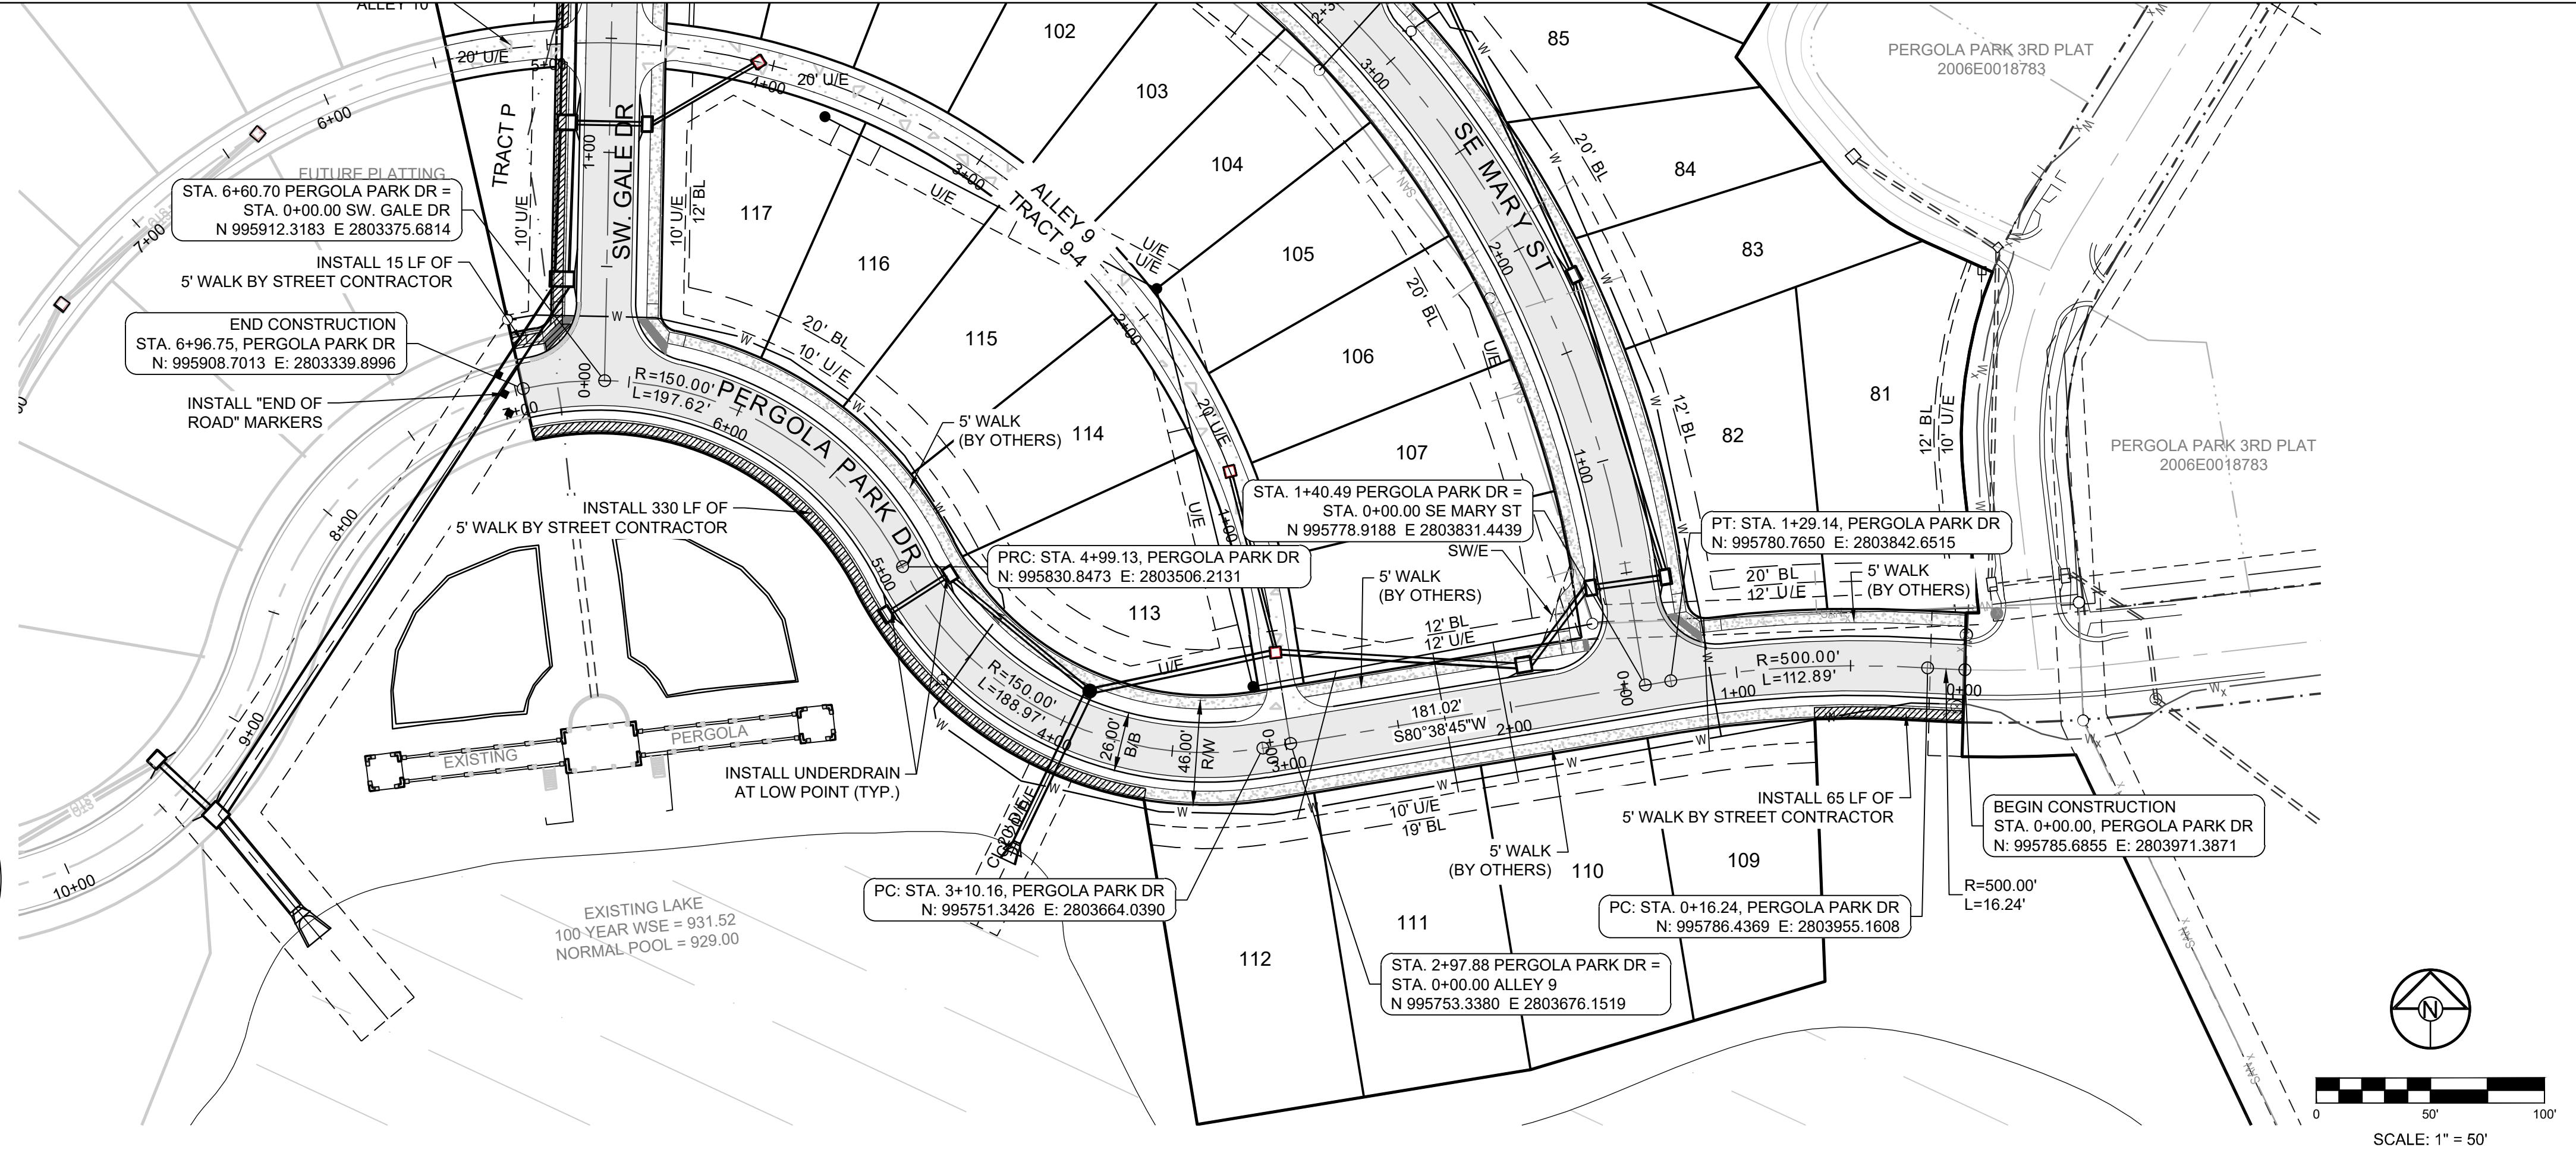
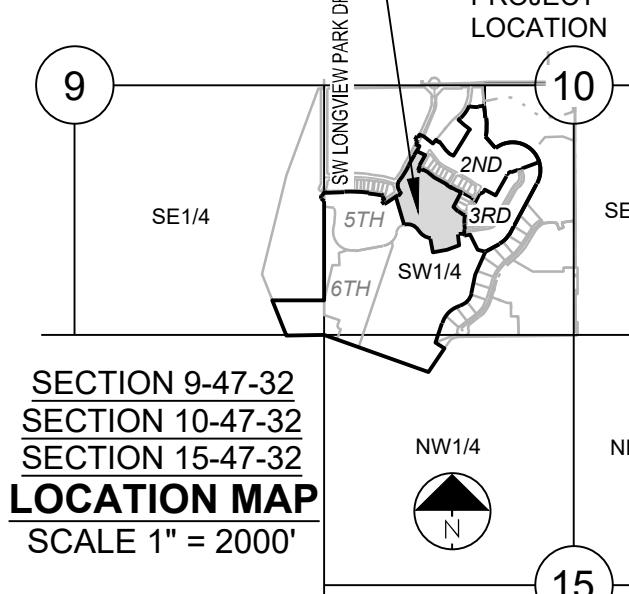
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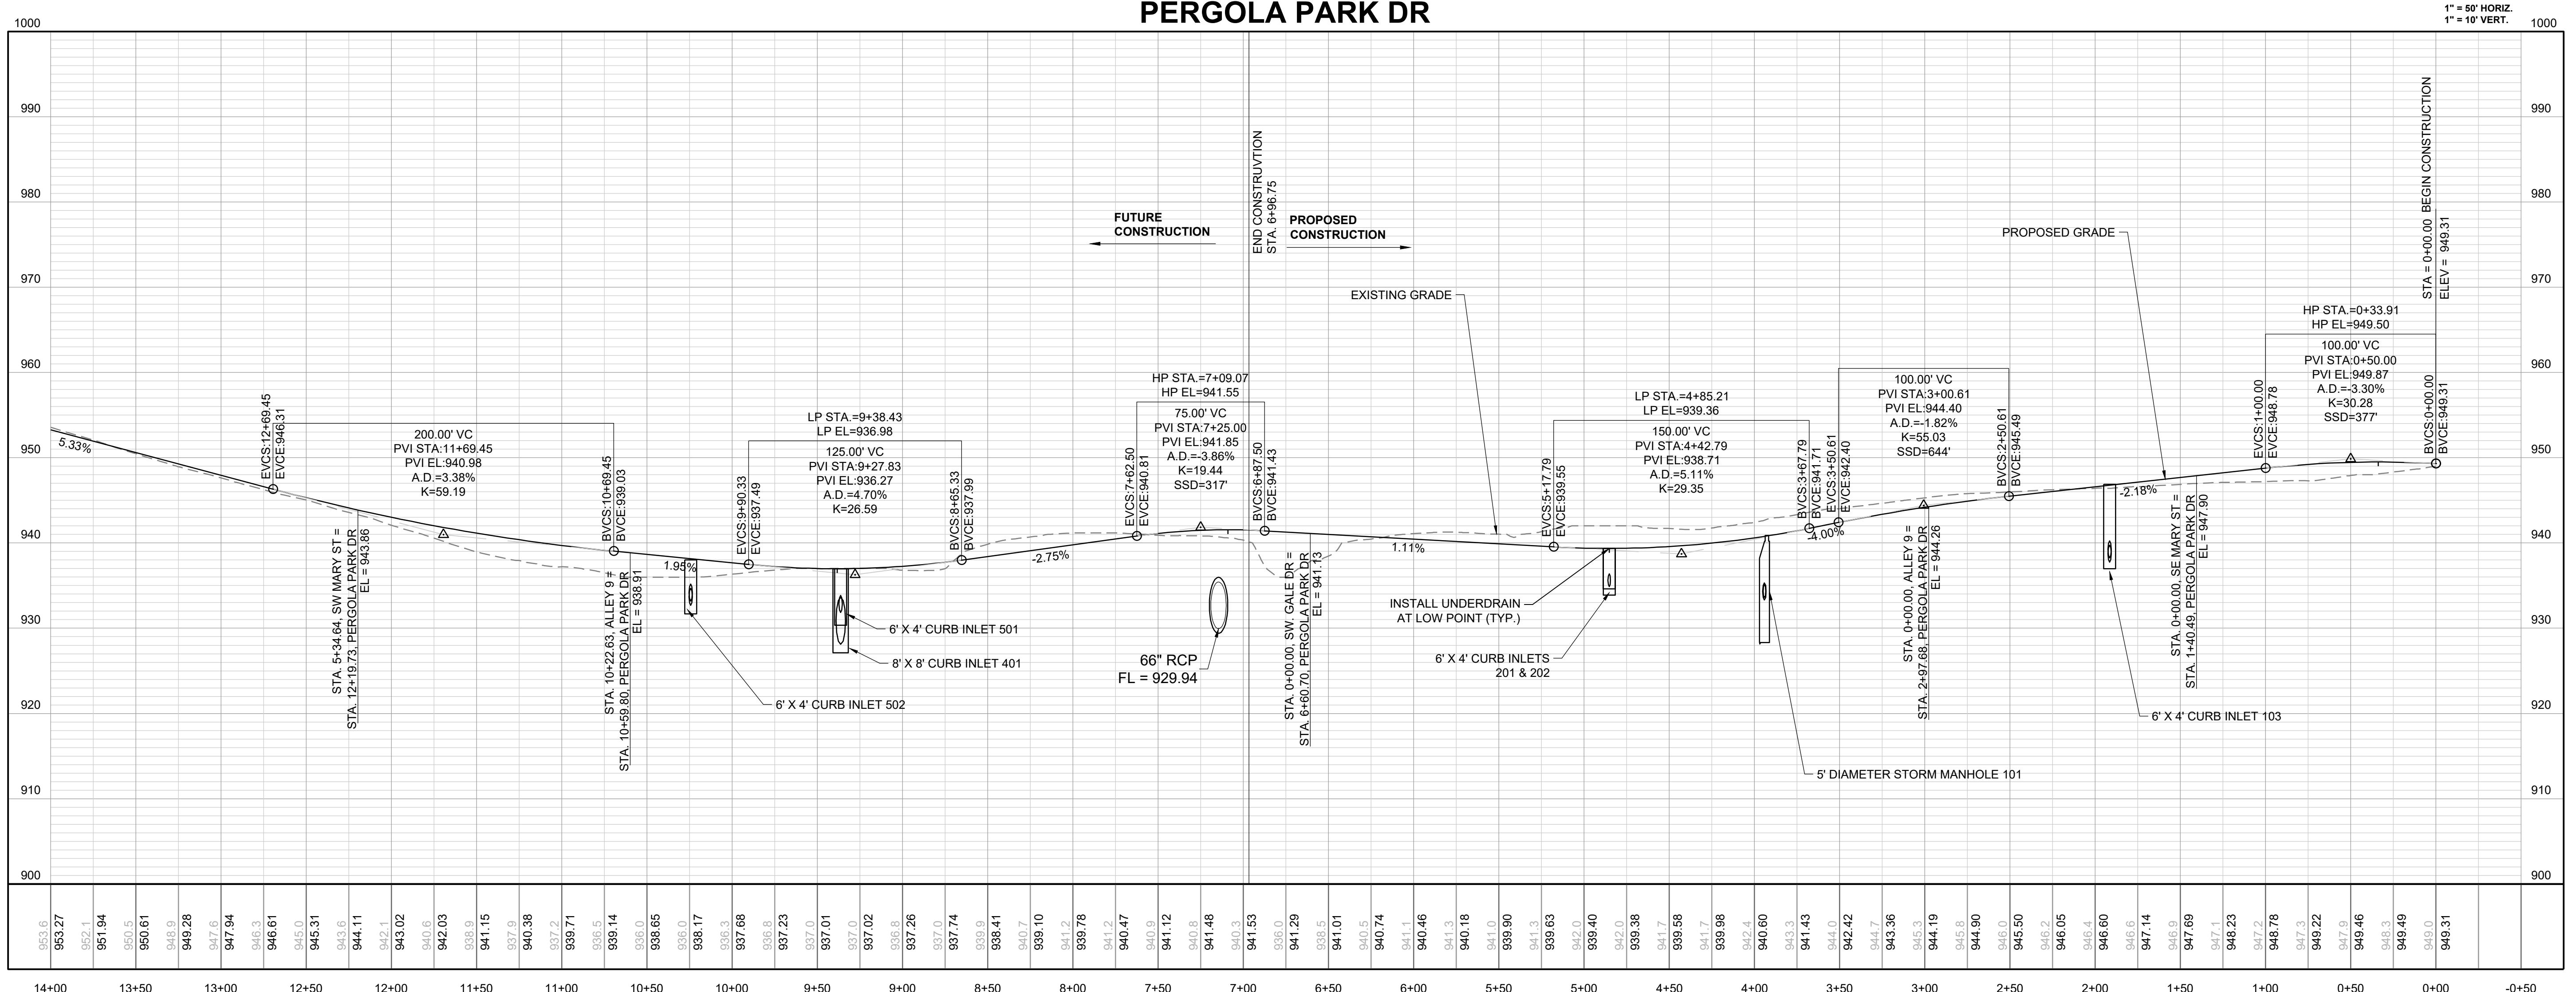
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NORTHING: 998893.4148
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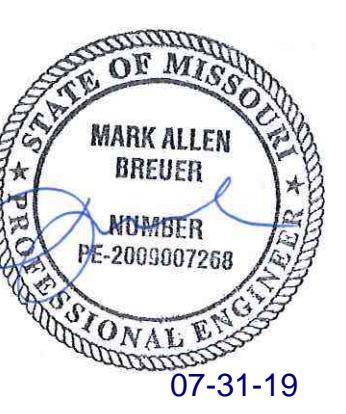
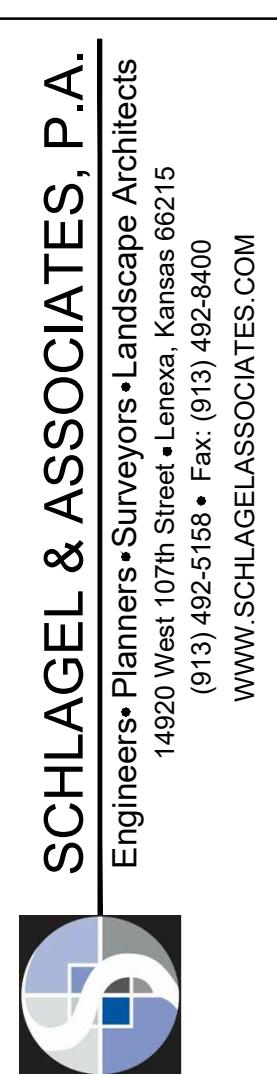


SCALE: 1" = 50'

PERGOLA PARK DR



PERGOLA PARK 4TH PLAT
STREET, STORMWATER, MASTER DRAINAGE
PLAN AND EROSION AND SEDIMENT
- LEE'S SUMMIT, MISSOURI




07-31-19

PERGOLA PARK DR

SHEET	DRAWN BY:	REVISION DATE:	DESCRIPTION
12	BAL	4-15-19	CITY COMMENTS
	MAH	3-30-19	CITY COMMENTS
	MAB		
	DATE PREPARED:		
	4-15-19		
	PROJ. NUMBER:		
	19-02		

OF 28


19-02

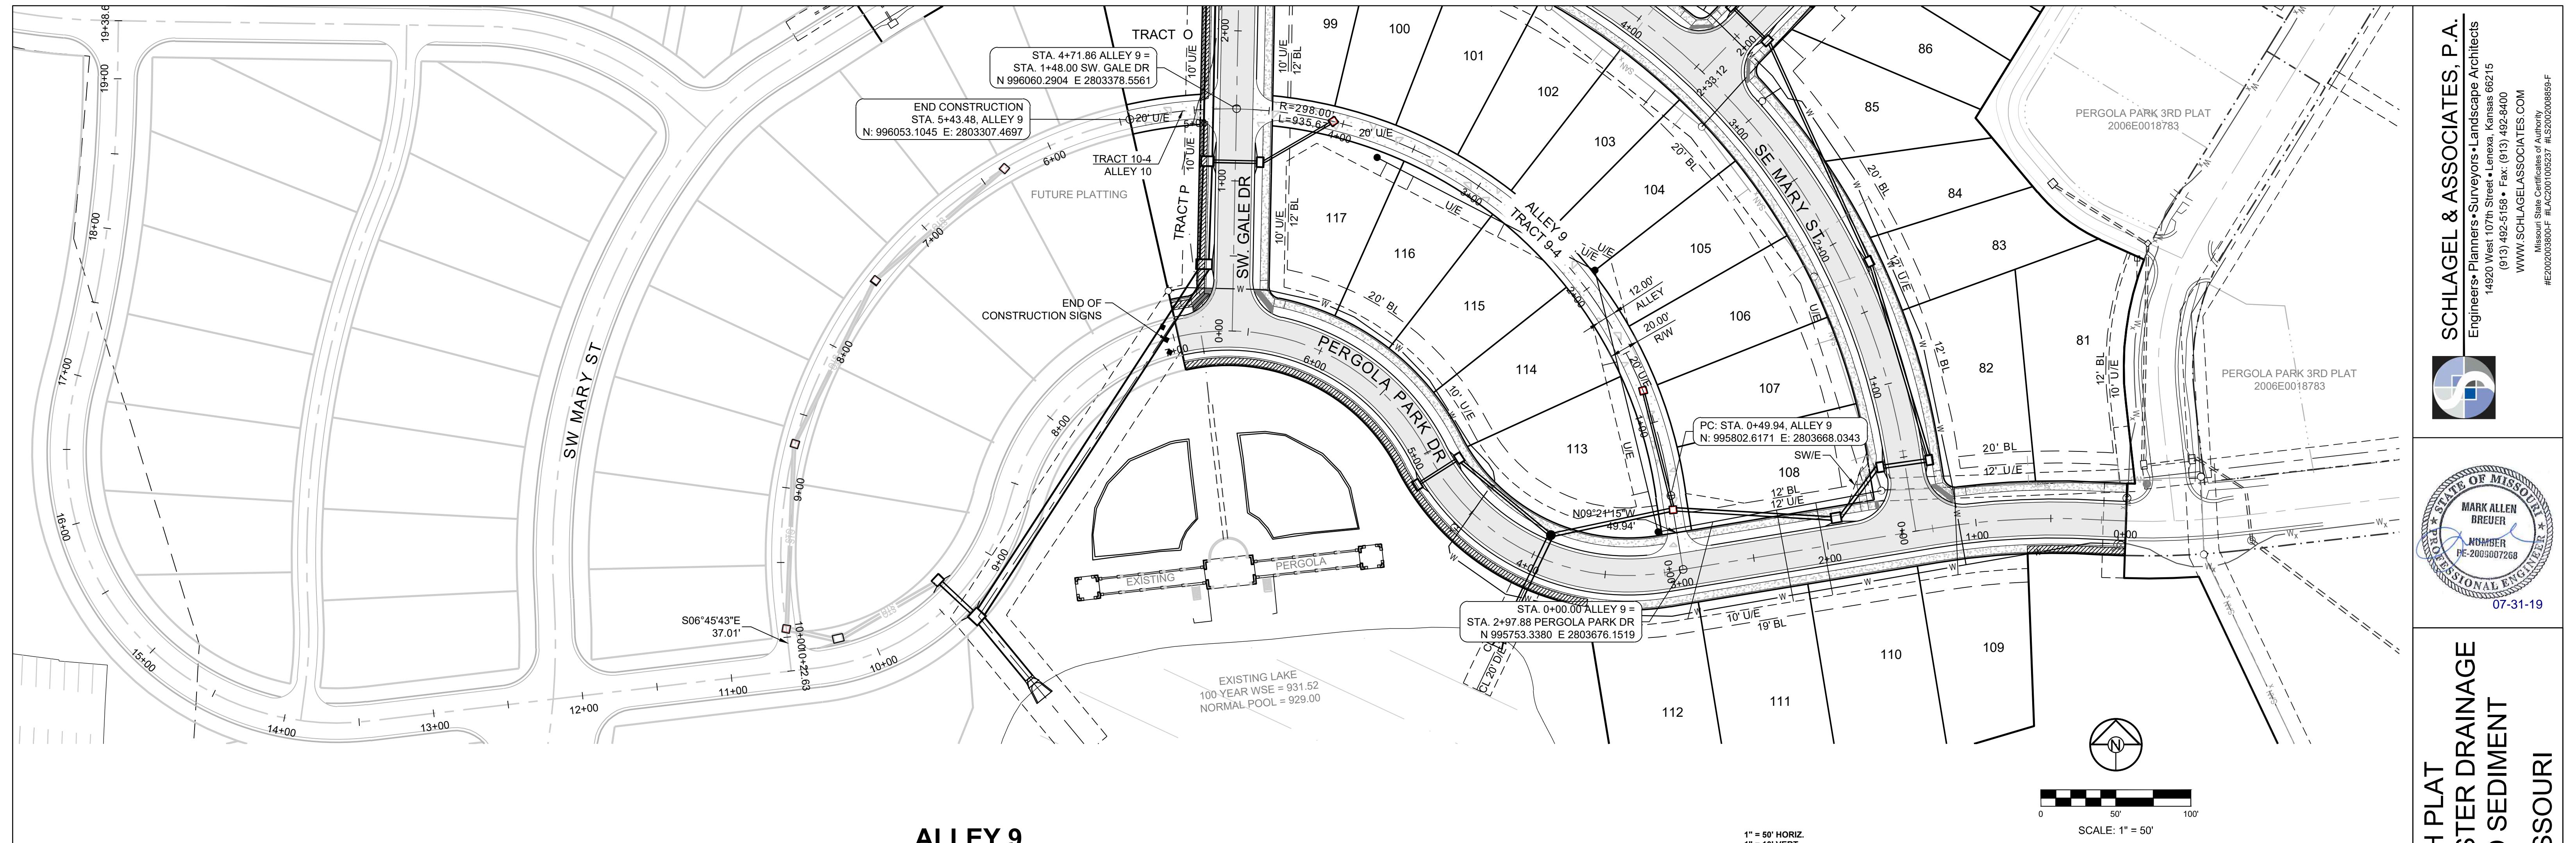

0 50' 100'
SCALE: 1" = 50'

1" = 50' HORIZ.
1" = 10' VERT.

NOTE:
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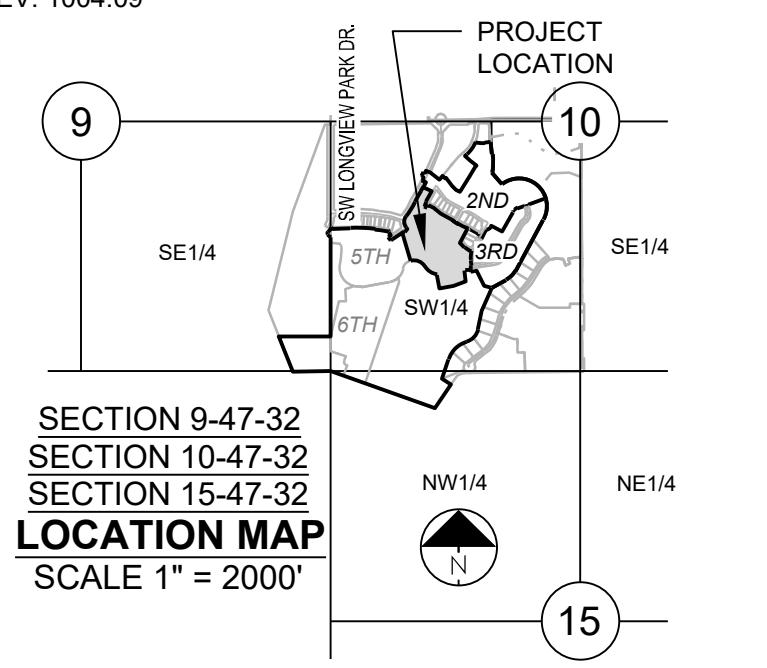
MISSOURI GEOGRAPHIC REFERENCE SYSTEM BENCH MARK:

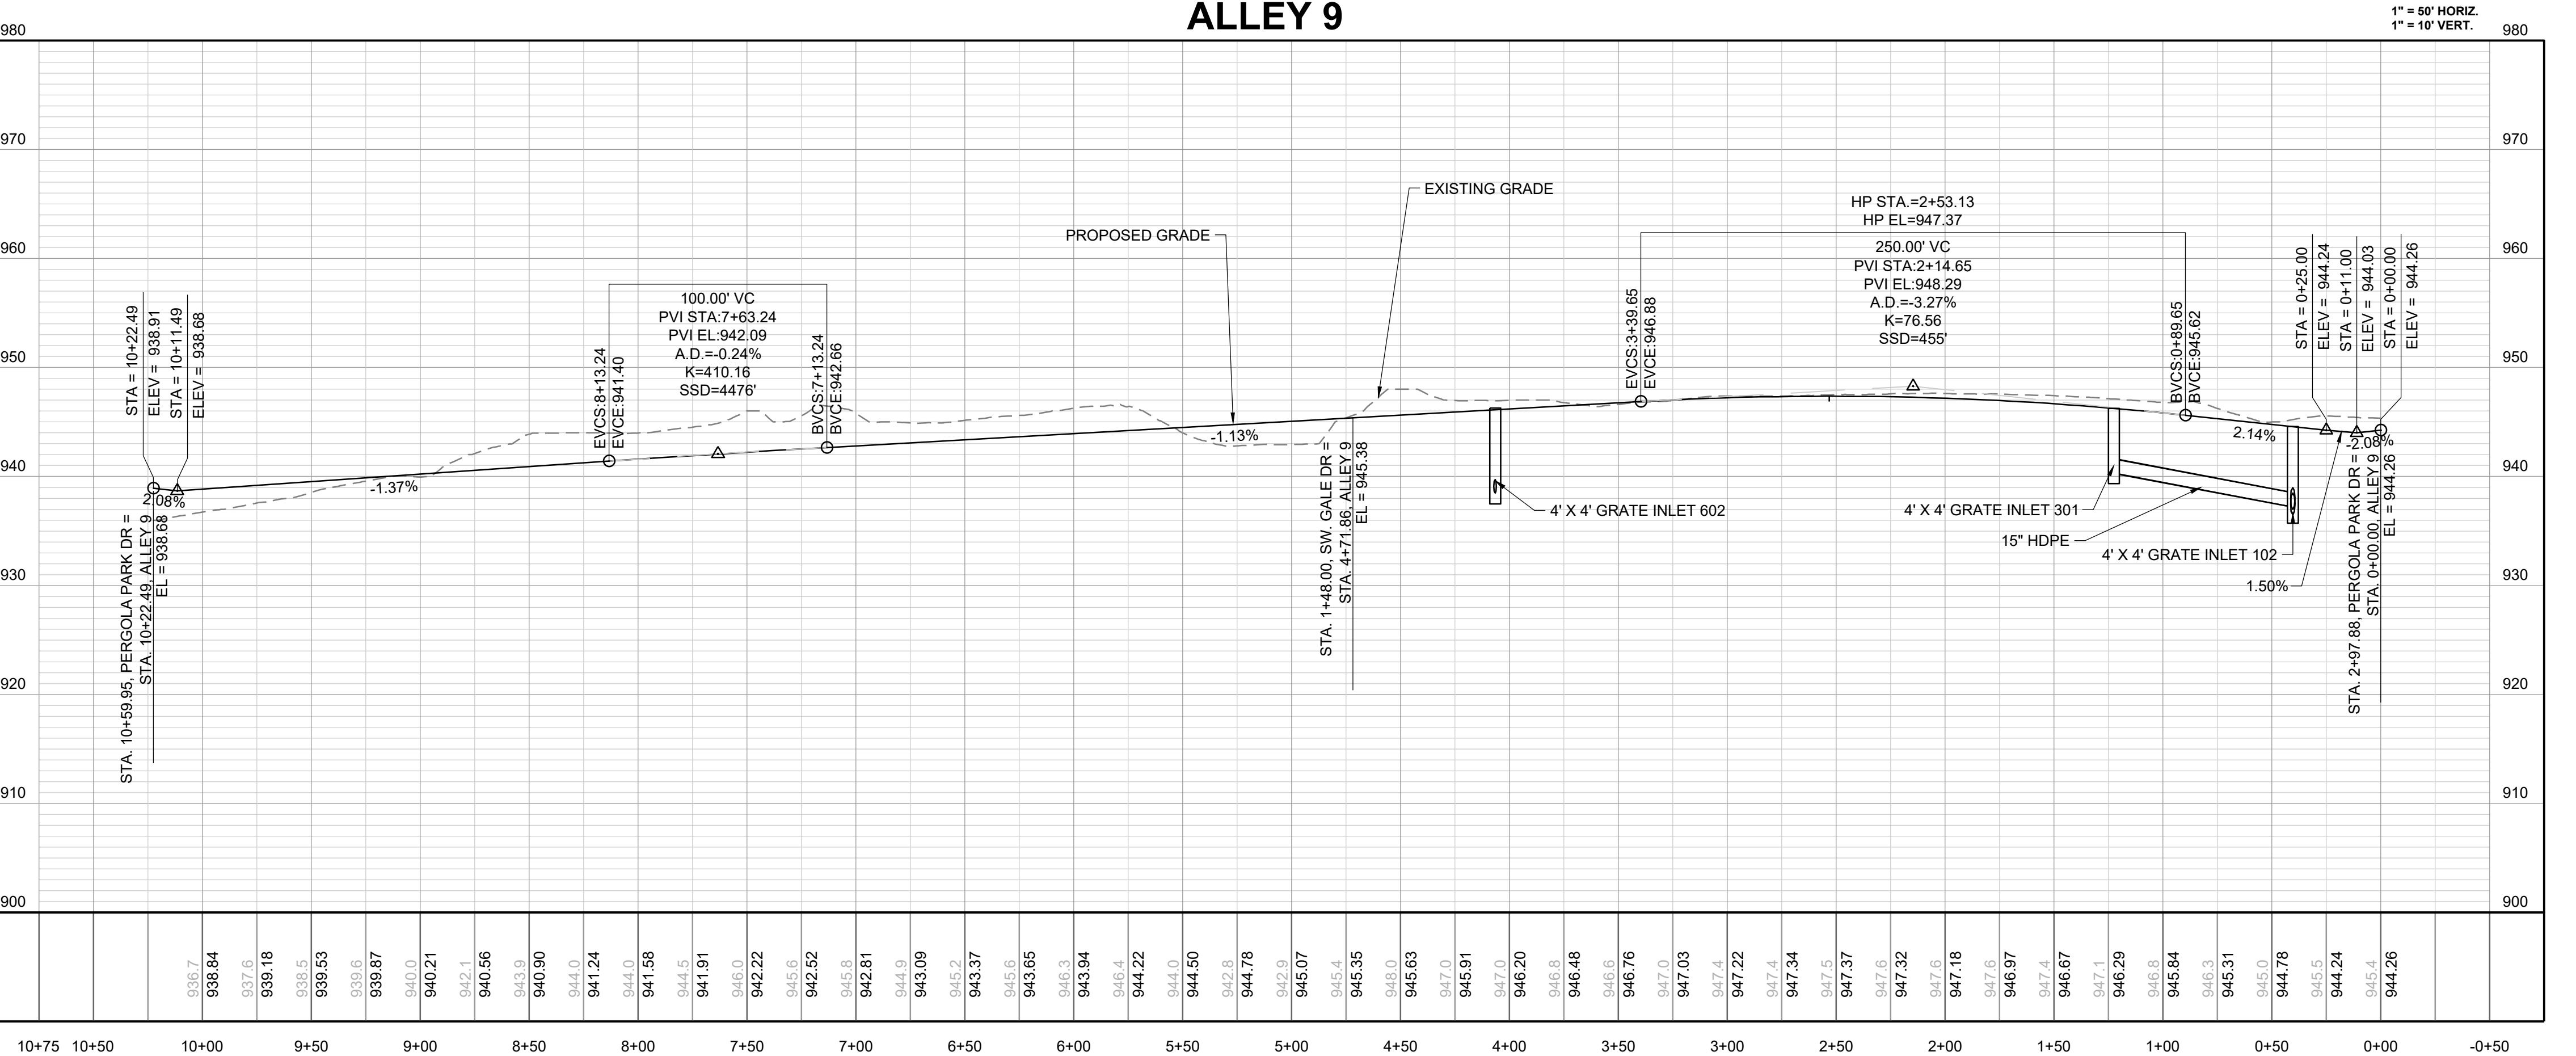BM JA-148, IS A STAMPED KC METRO DISK SET IN CONCRETE LOCATED 2 MILES WEST OF THE INTERSECTION OF HIGHWAY 50 AND 3RD ST. IT IS 44 FT NORTH OF THE CENTER OF 3RD ST. AND 102.5 FT WEST OF THE CENTER OF THE EXIT FROM THE ADJACENT PARKING LOT.

PROJECT BENCHMARK:

CHISELED "SQUARE" ON STORM CURB INLET AT NORTHWEST INTERSECTION OF SW. TOWER PARK DRIVE AND SW. LONGVIEW BOULEVARD.

NORTHING: 998893.4148
EASTING: 2803318.5413
ELEV. 1004.09




PERGOLA PARK 4TH PLAT STREET, STORMWATER, MASTER DRAINAGE PLAN AND EROSION AND SEDIMENT CONTROL - LEE'S SUMMIT, MISSOURI



ALLEY 9

SHEET

13



OF 28

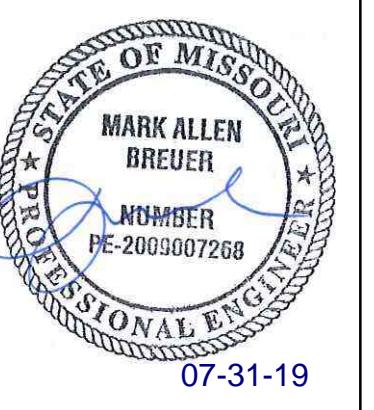

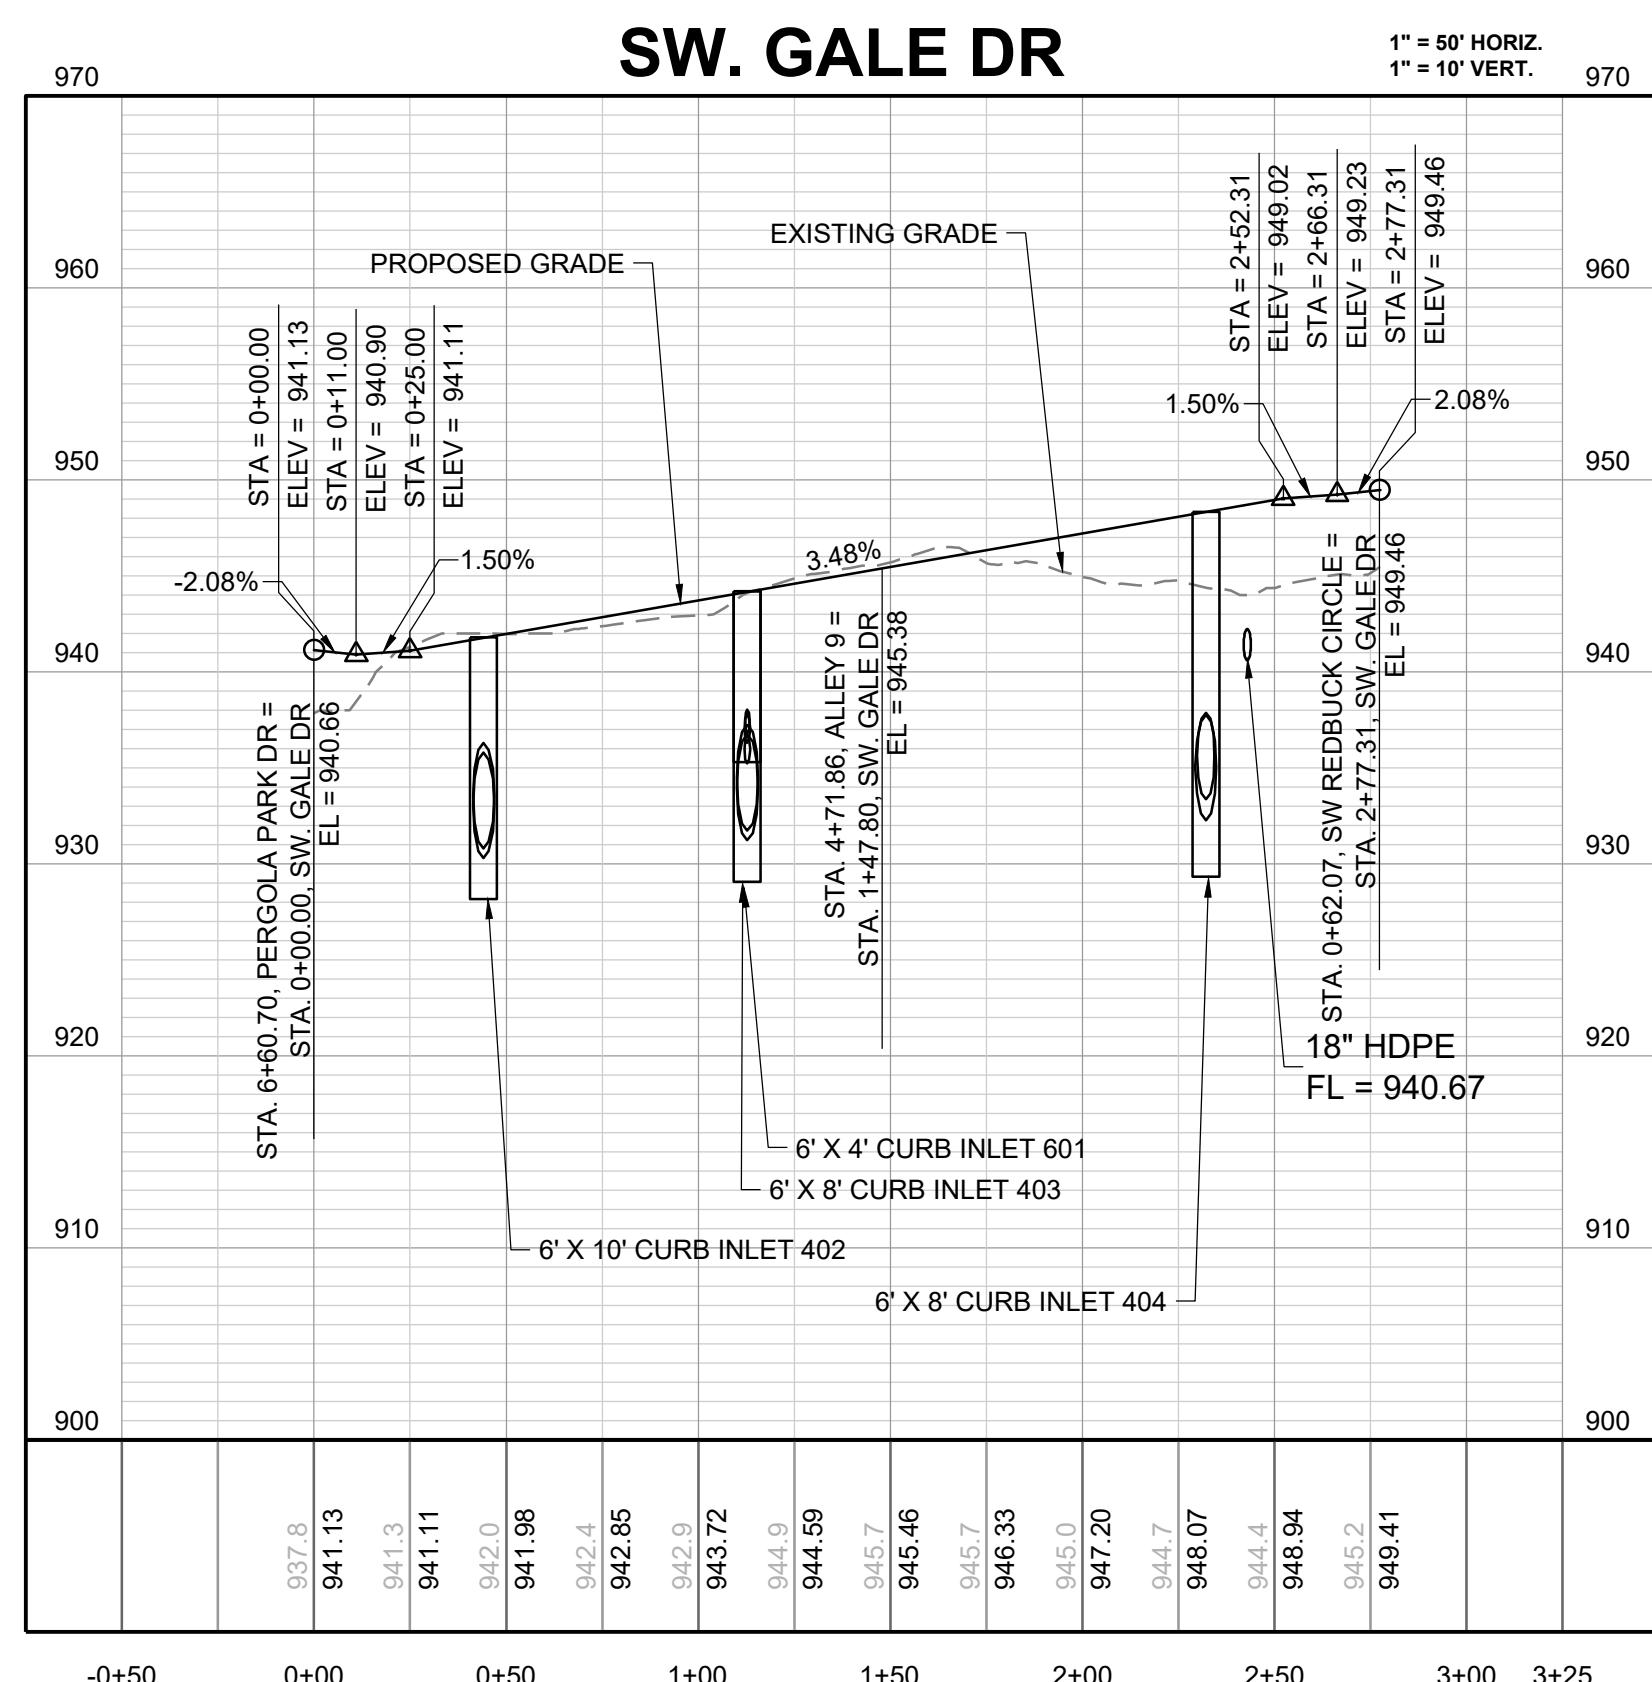
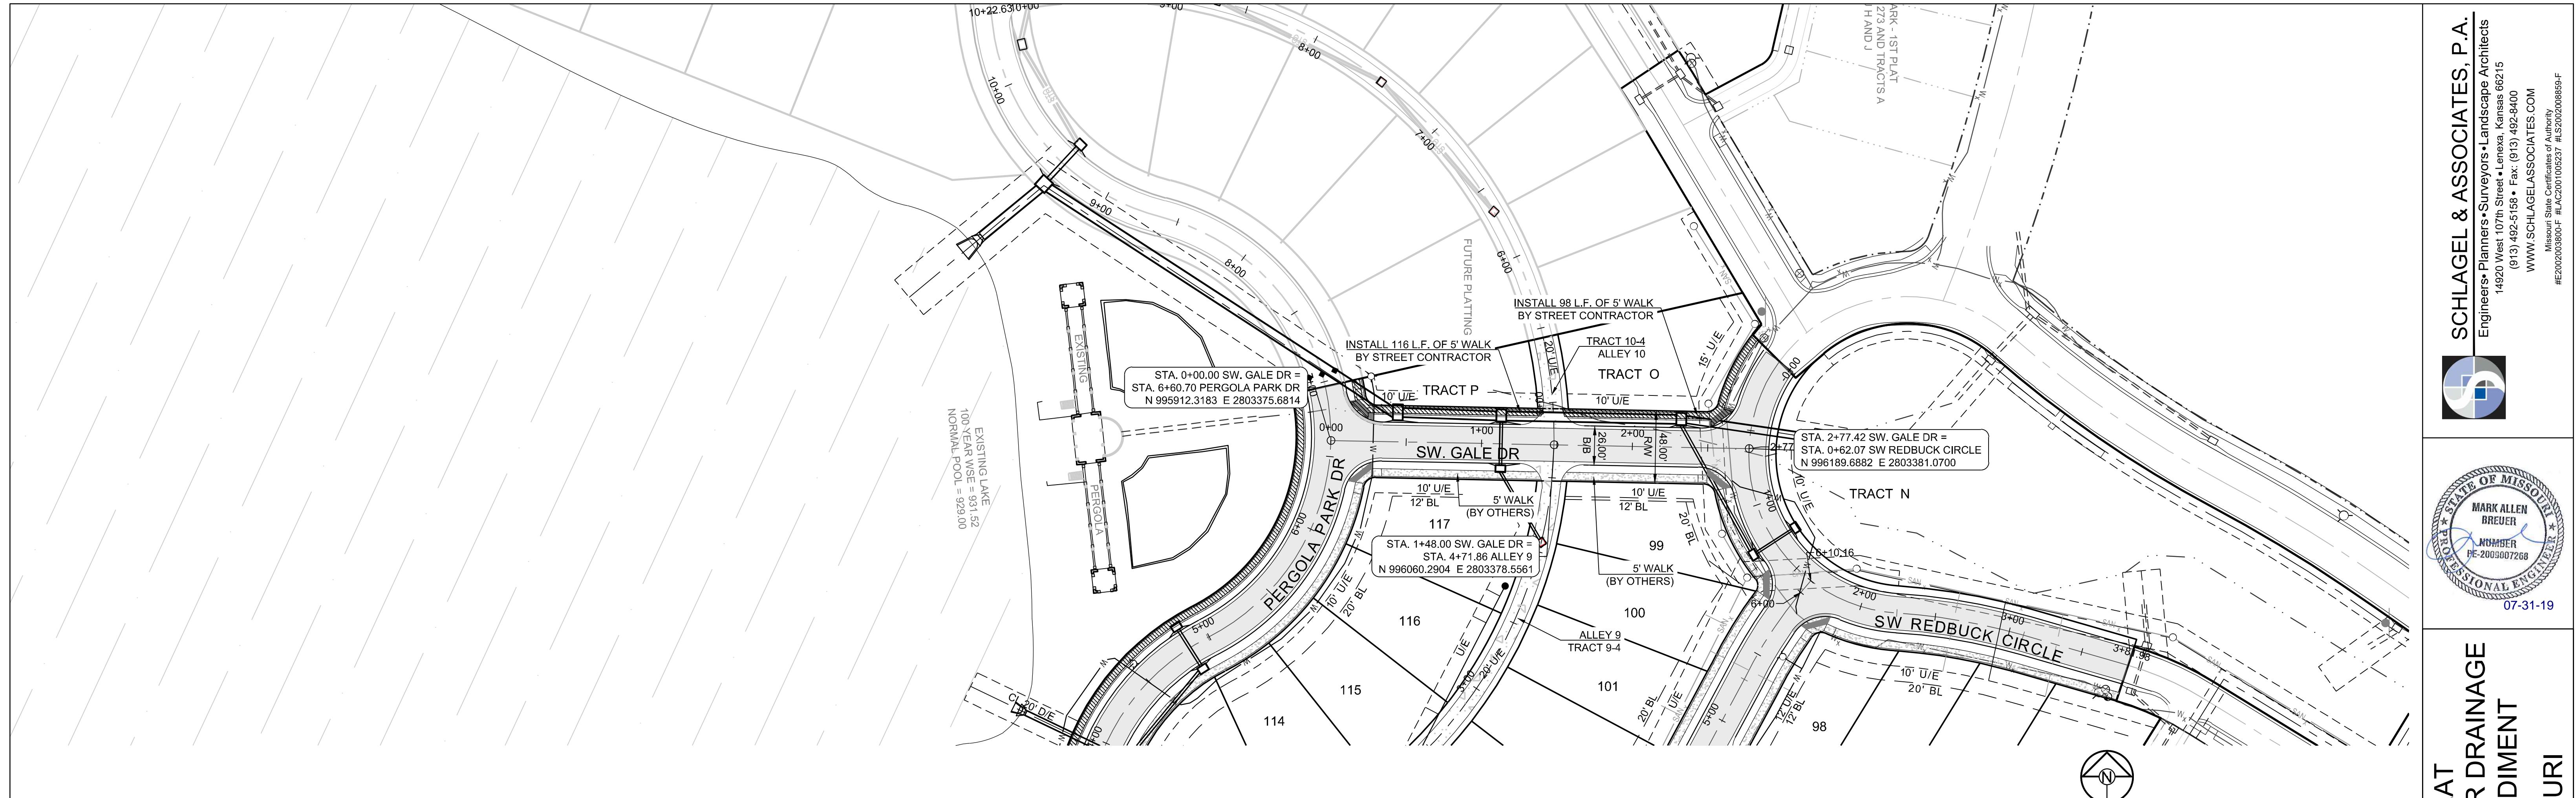


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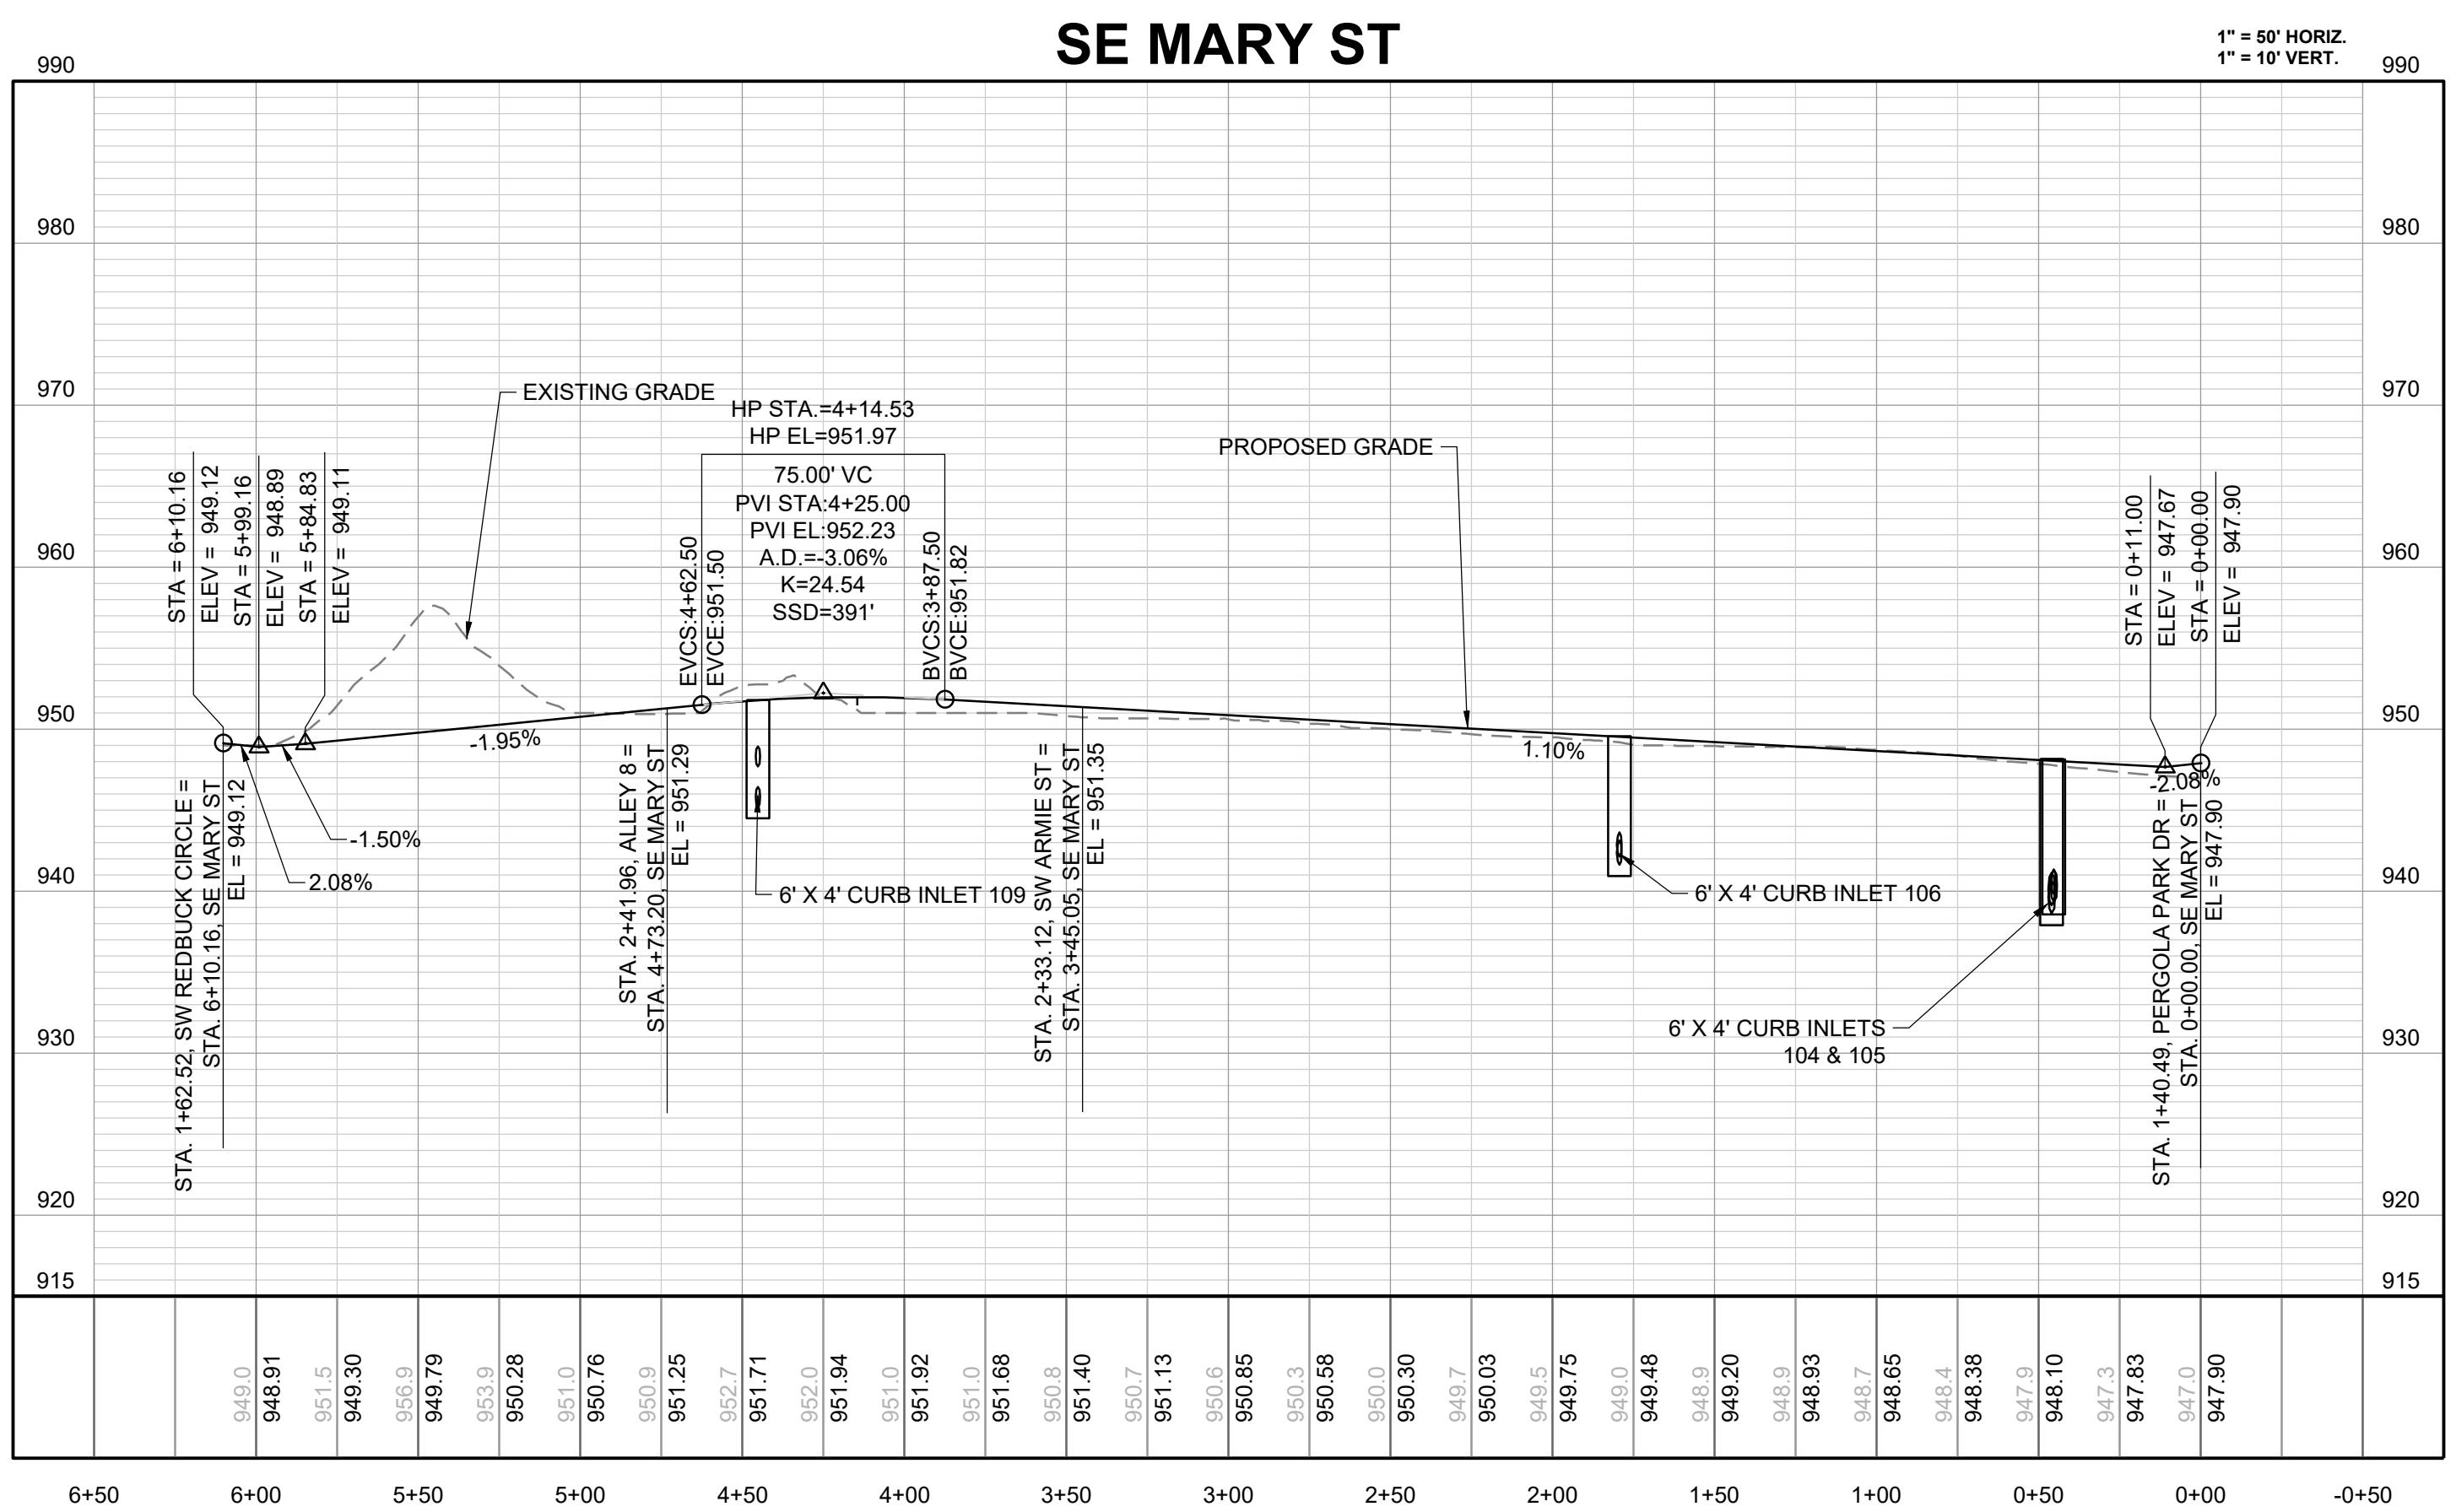
PERGOLA PARK 4TH PLAT STREET, STORMWATER, MASTER DRAINAGE PLAN AND EROSION AND SEDIMENT - LEE'S SUMMIT, MISSOURI

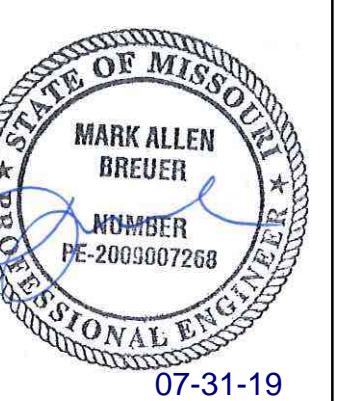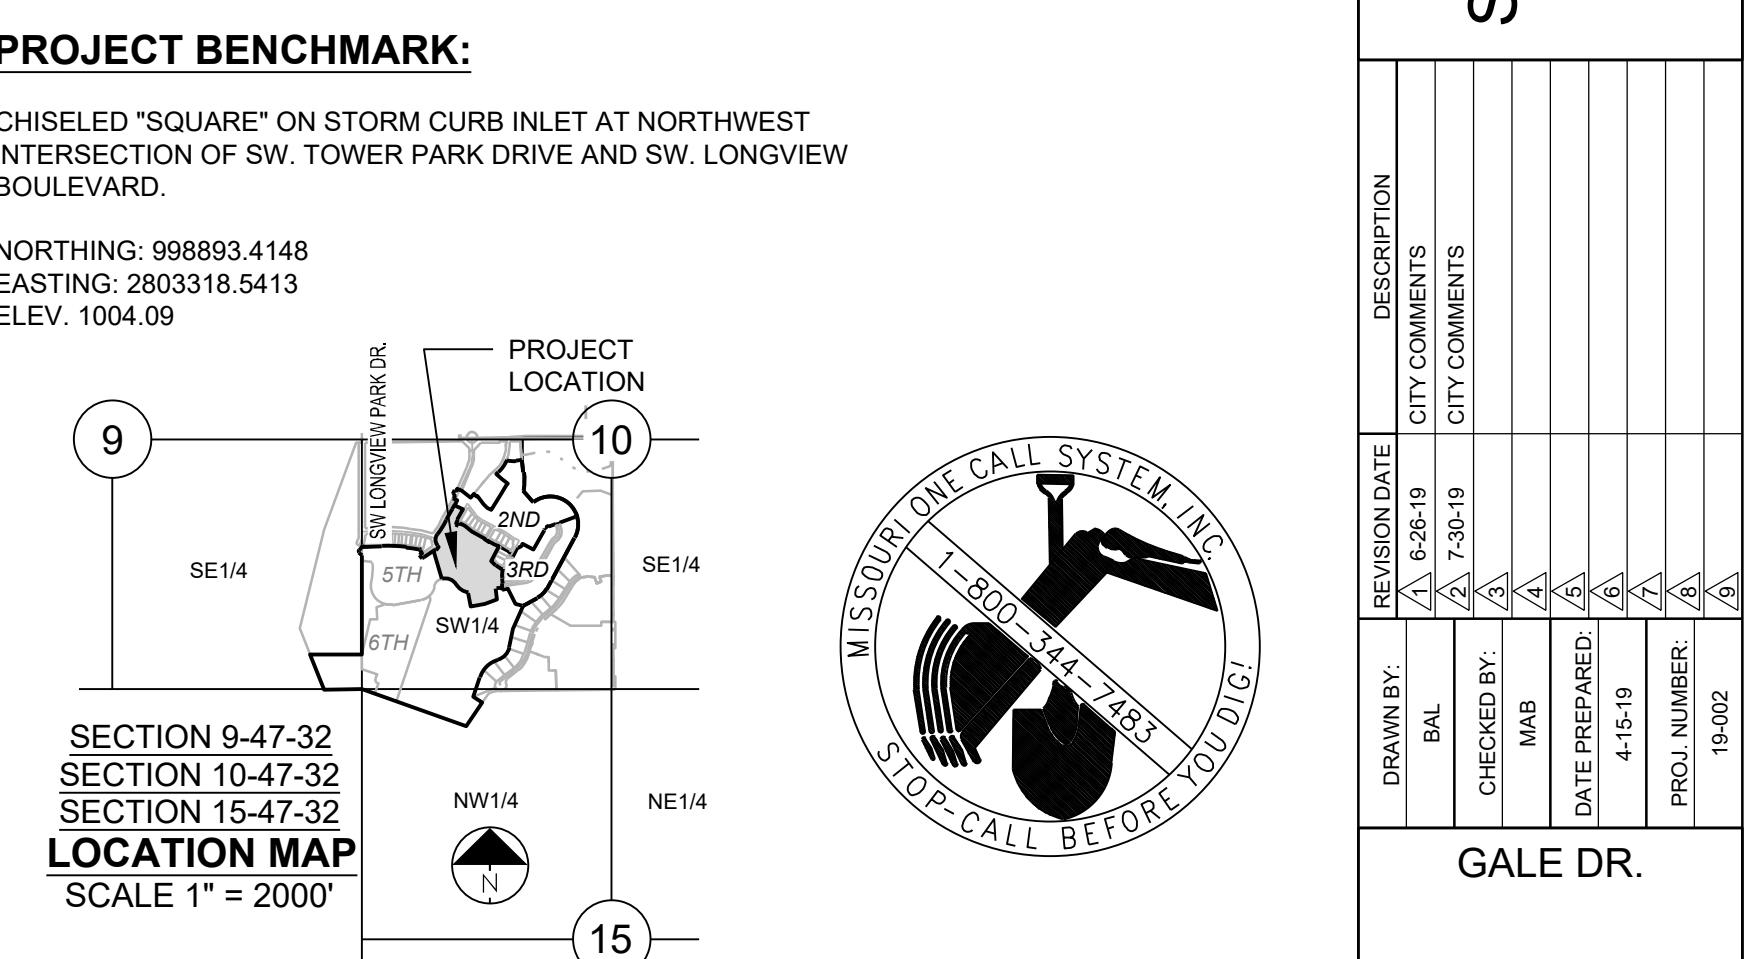

NOTE:

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SE MARY ST

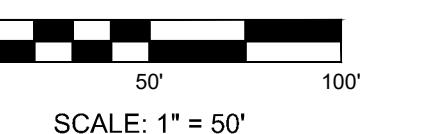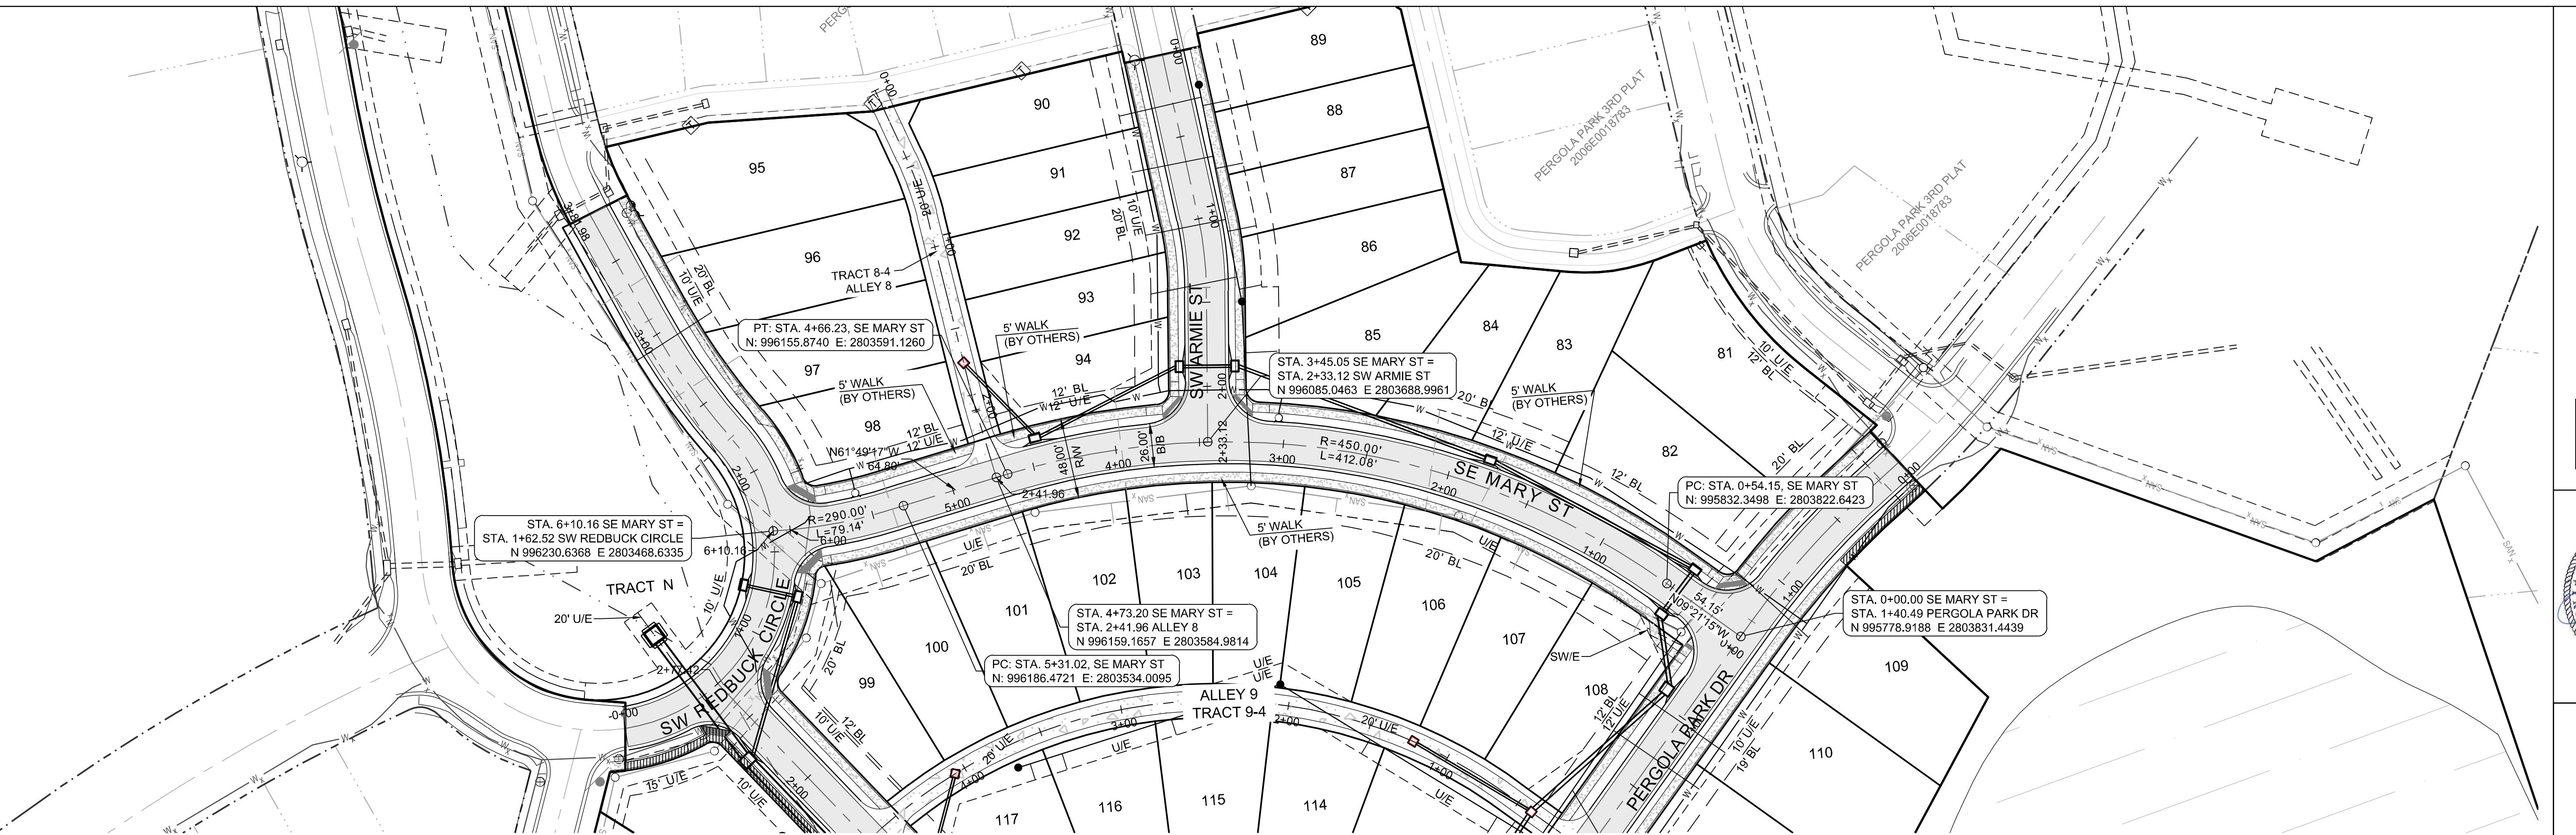


MISSOURI GEOGRAPHIC REFERENCE SYSTEM BENCH MARK:

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PROJECT BENCHMARK:

CHISELED "SQUARE" ON STORM CURB INLET AT NORTHWEST INTERSECTION OF SW. TOWER PARK DRIVE AND SW. LONGVIEW BOULEVARD.


NORTHING: 998893.4148
EASTING: 2803318.5413
ELEV. 1004.09

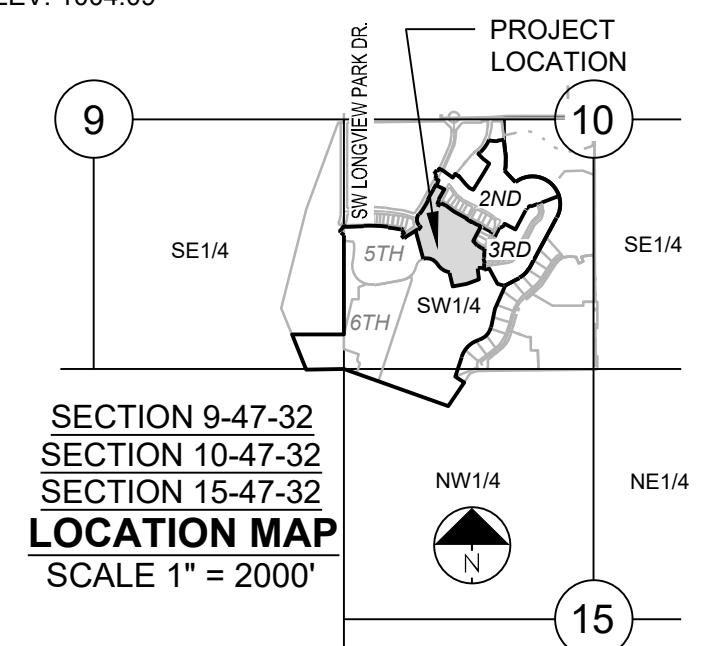


PERCOLA PARK 4TH PLAT STREET, STORMWATER, MASTER DRAINAGE PLAN AND EROSION AND SEDIMENT - LEE'S SUMMIT, MISSOURI

SE MARY ST


15
OF 28

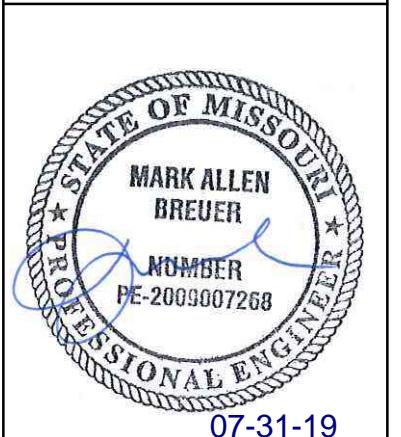

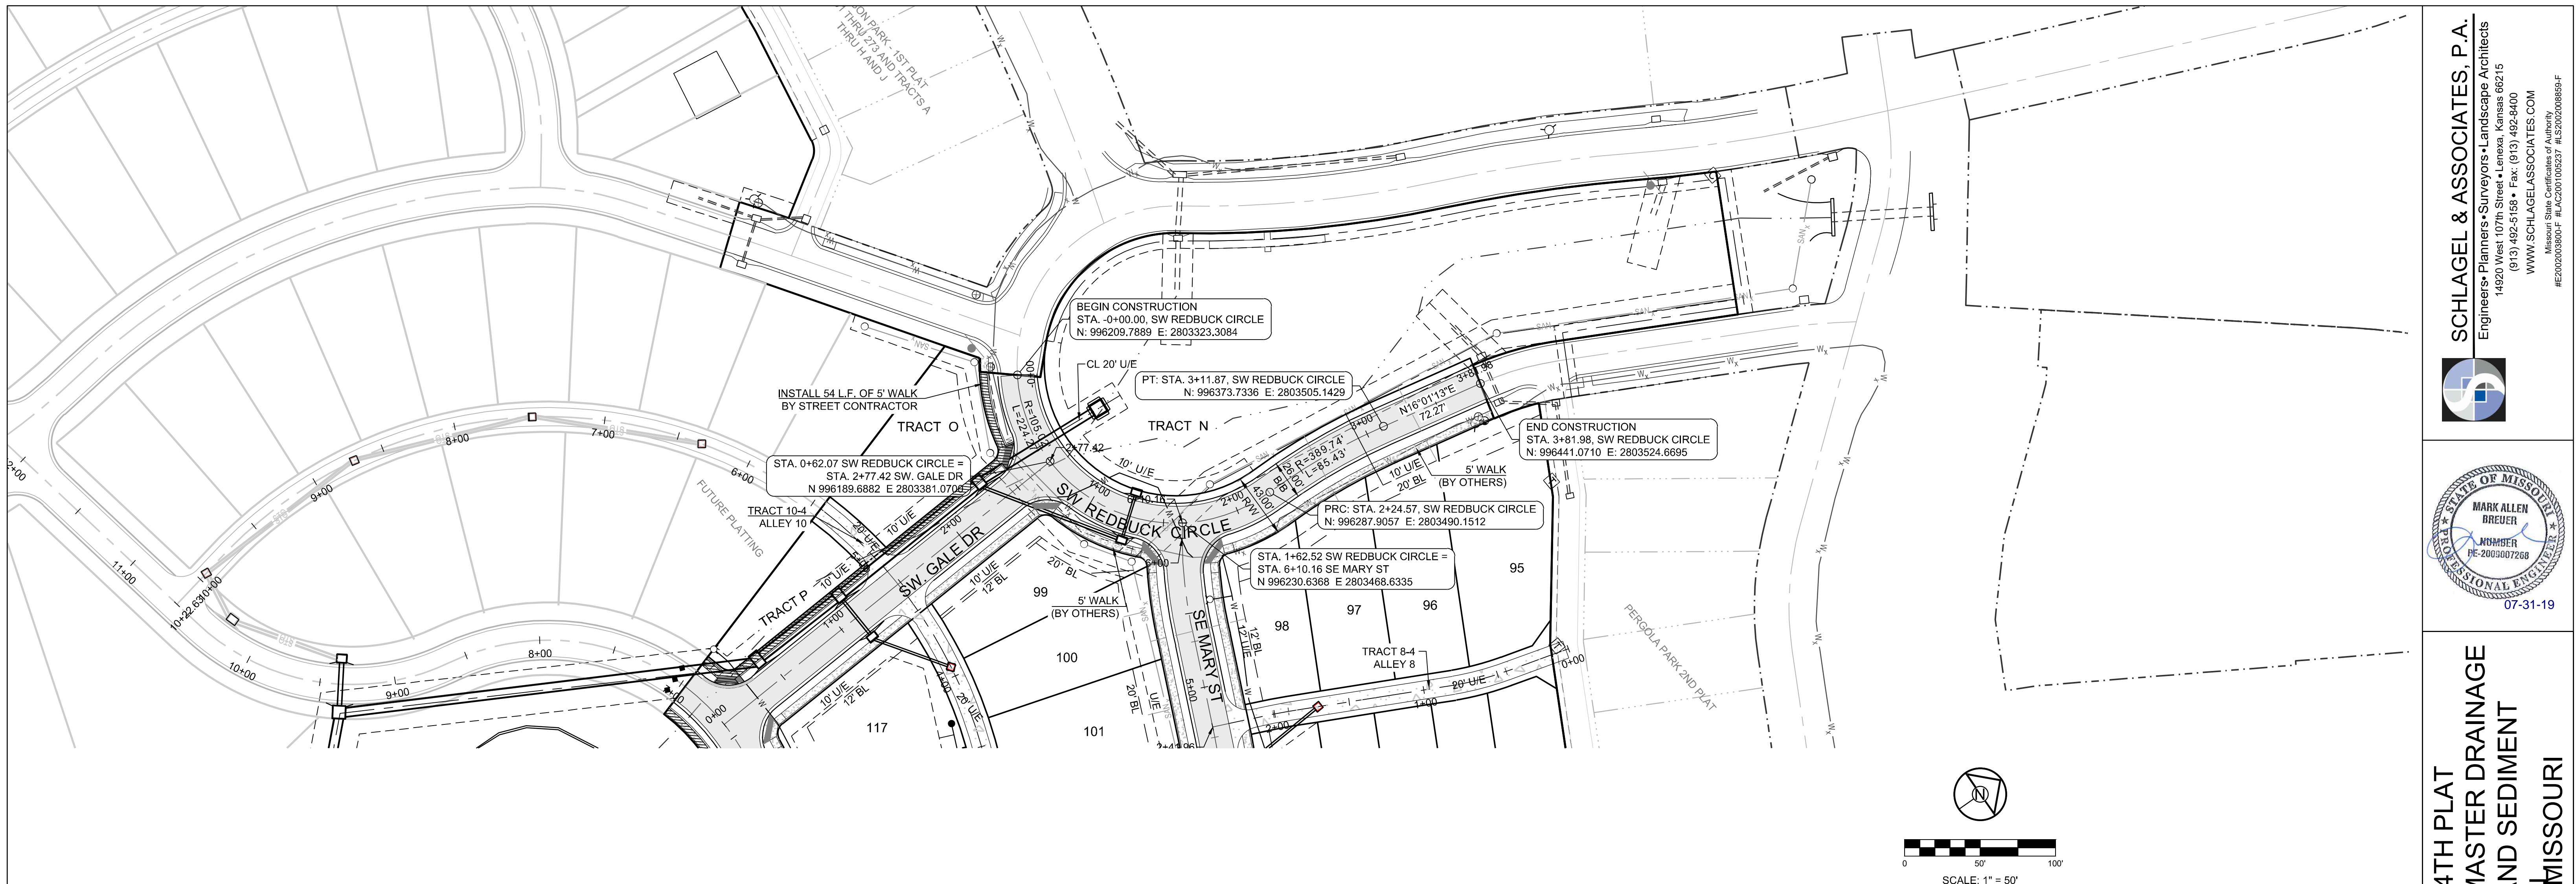

NOTE:

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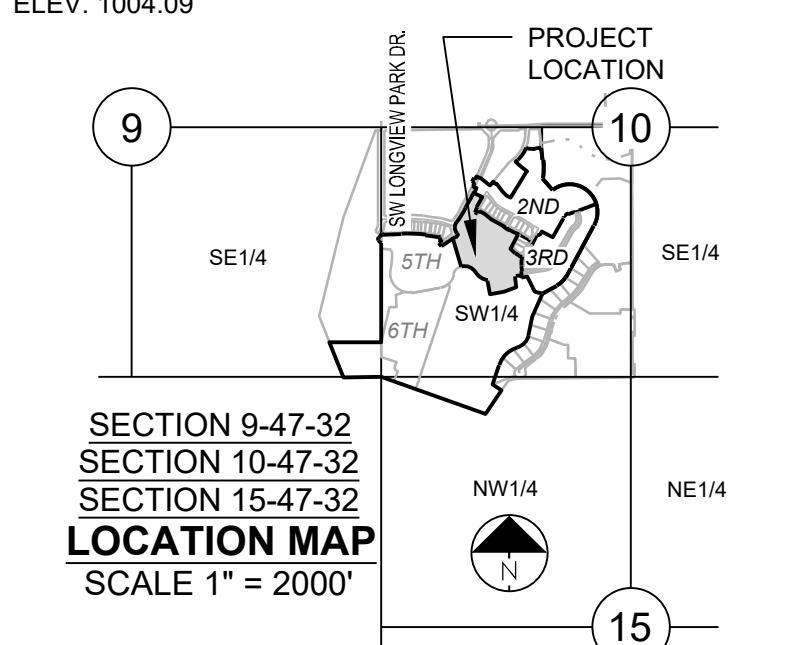
**MISSOURI GEOGRAPHIC REFERENCE SYSTEM
BENCH MARK:**
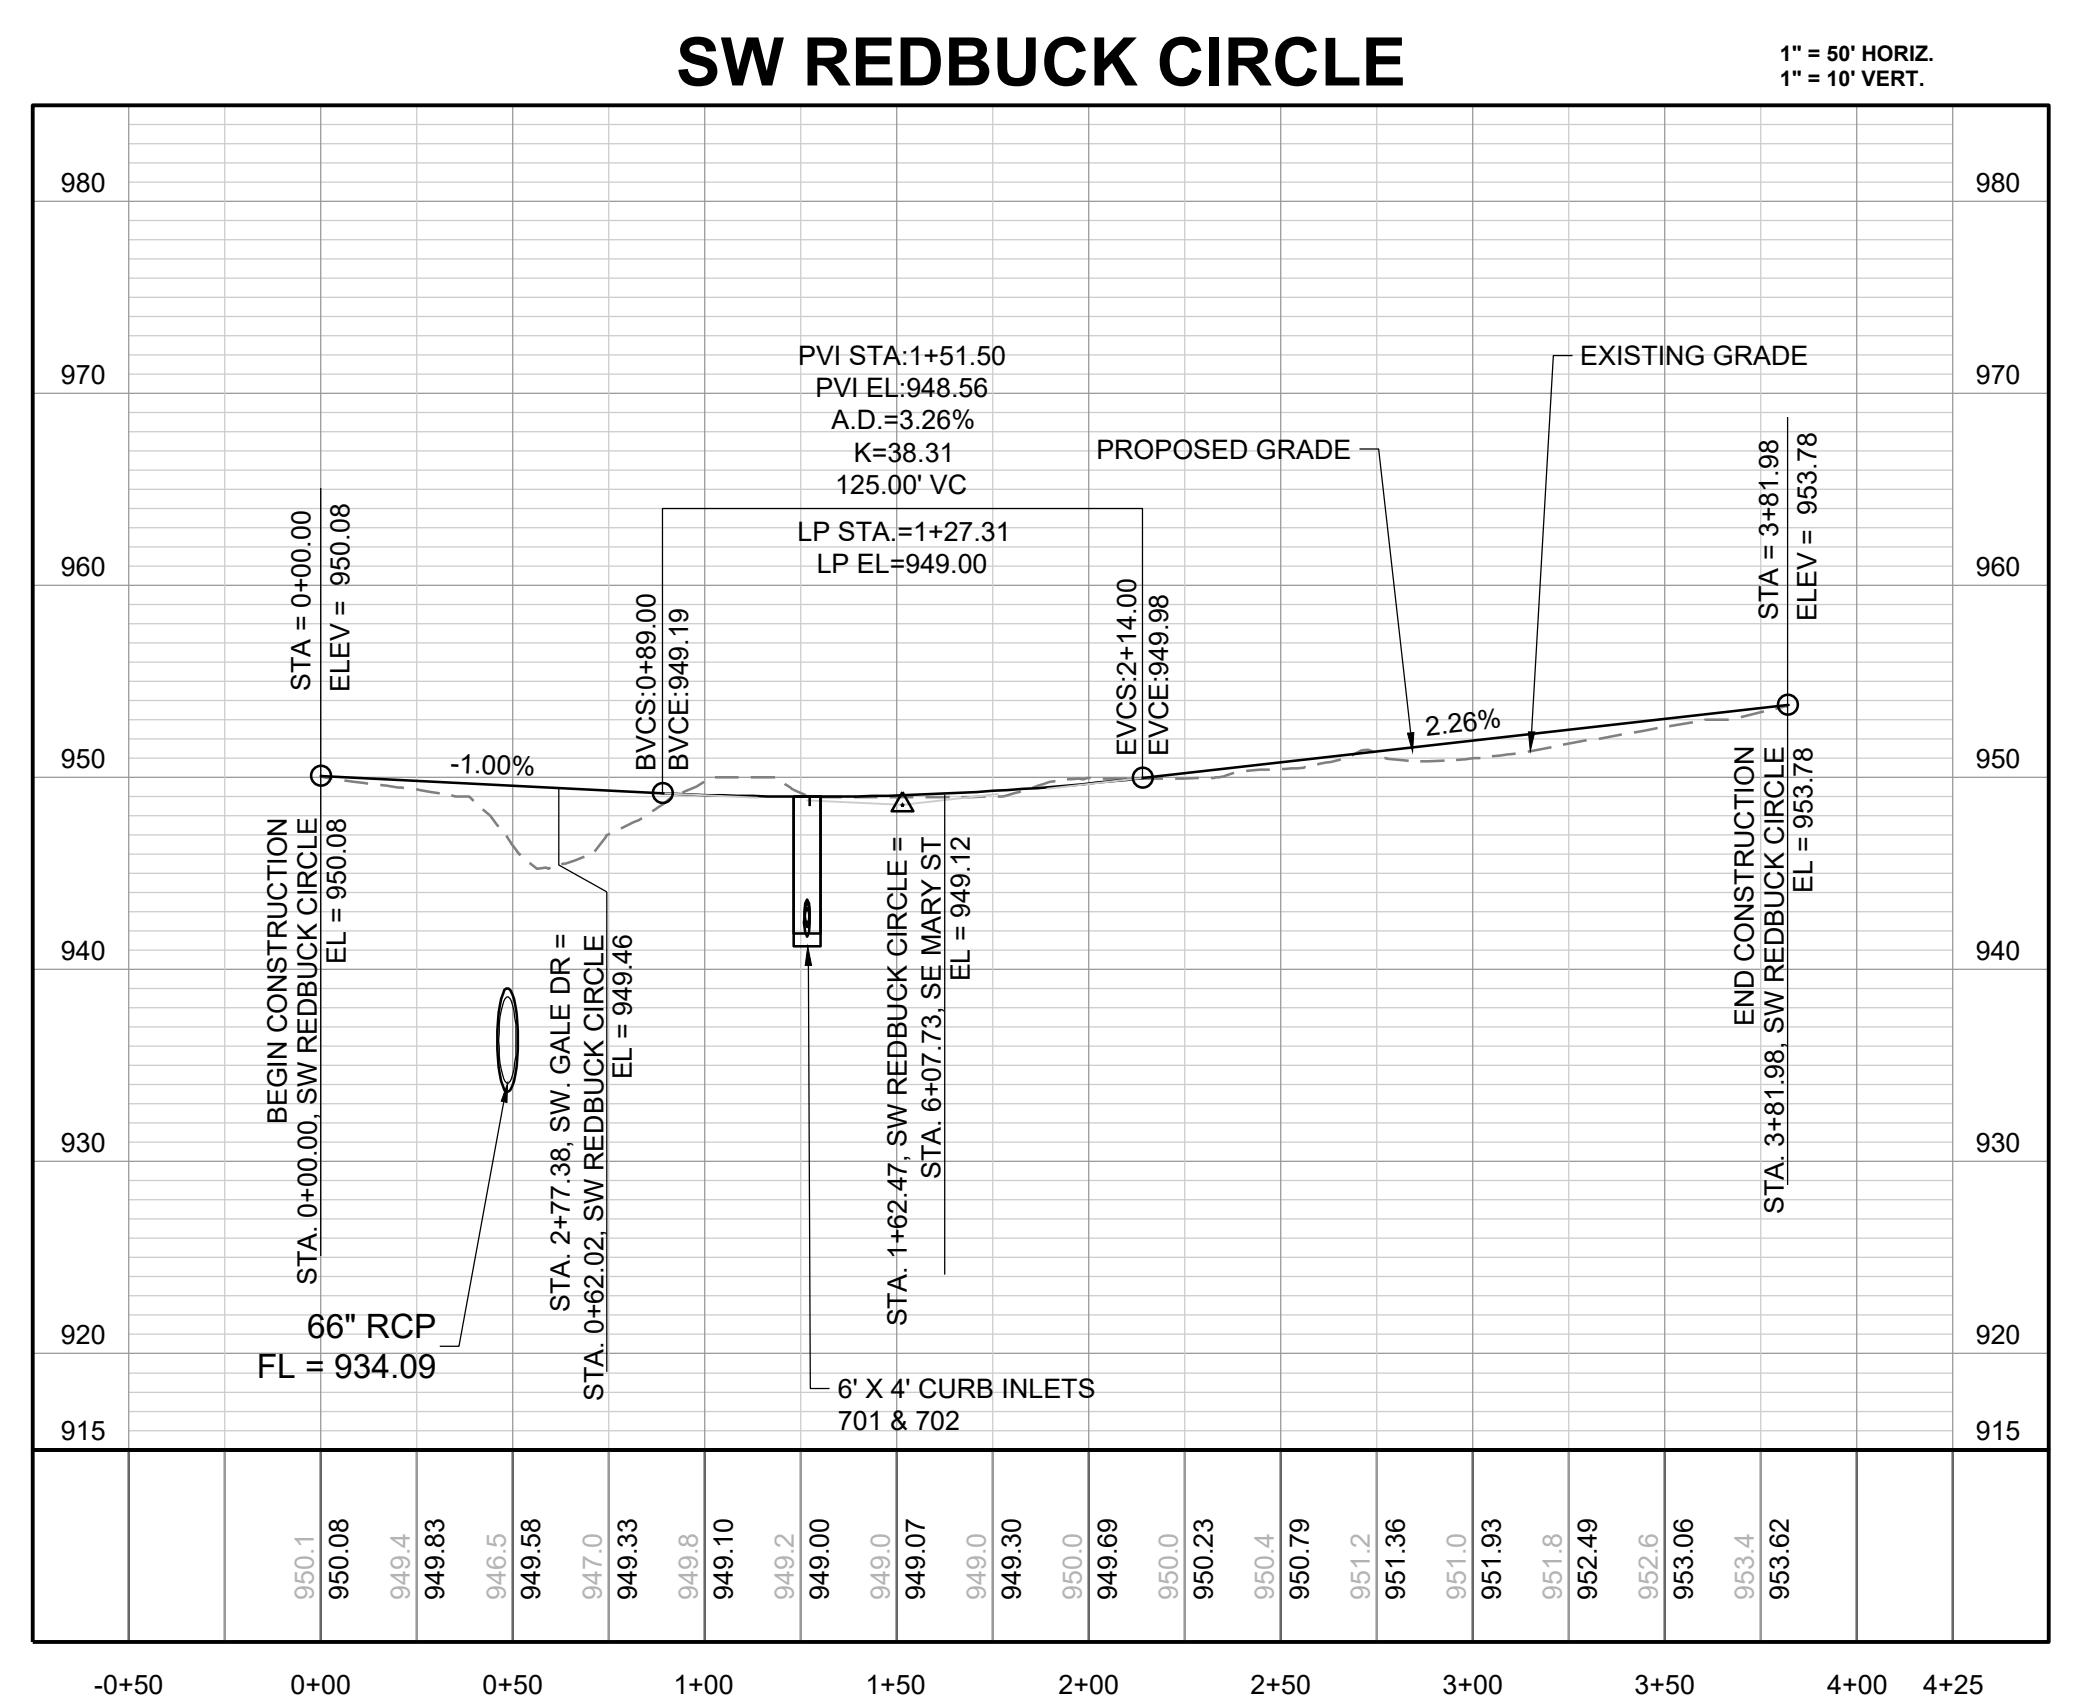
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NORTHING: 998893.4148
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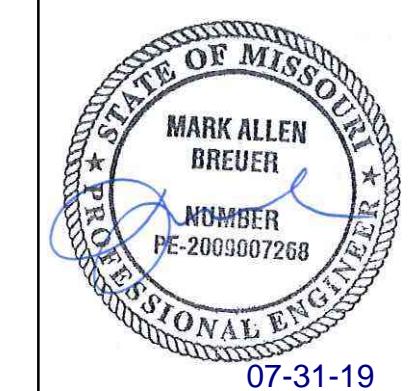


**PERGOLA PARK 4TH PLAT
STREET, STORMWATER, MASTER DRAINAGE
PLAN AND EROSION AND SEDIMENT**

- LEE'S SUMMIT, MISSOURI




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07-31-19


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SCALE: 1" = 50'




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NORTHING: 998893.4148
EASTING: 2803318.5413
ELEV: 1004.09

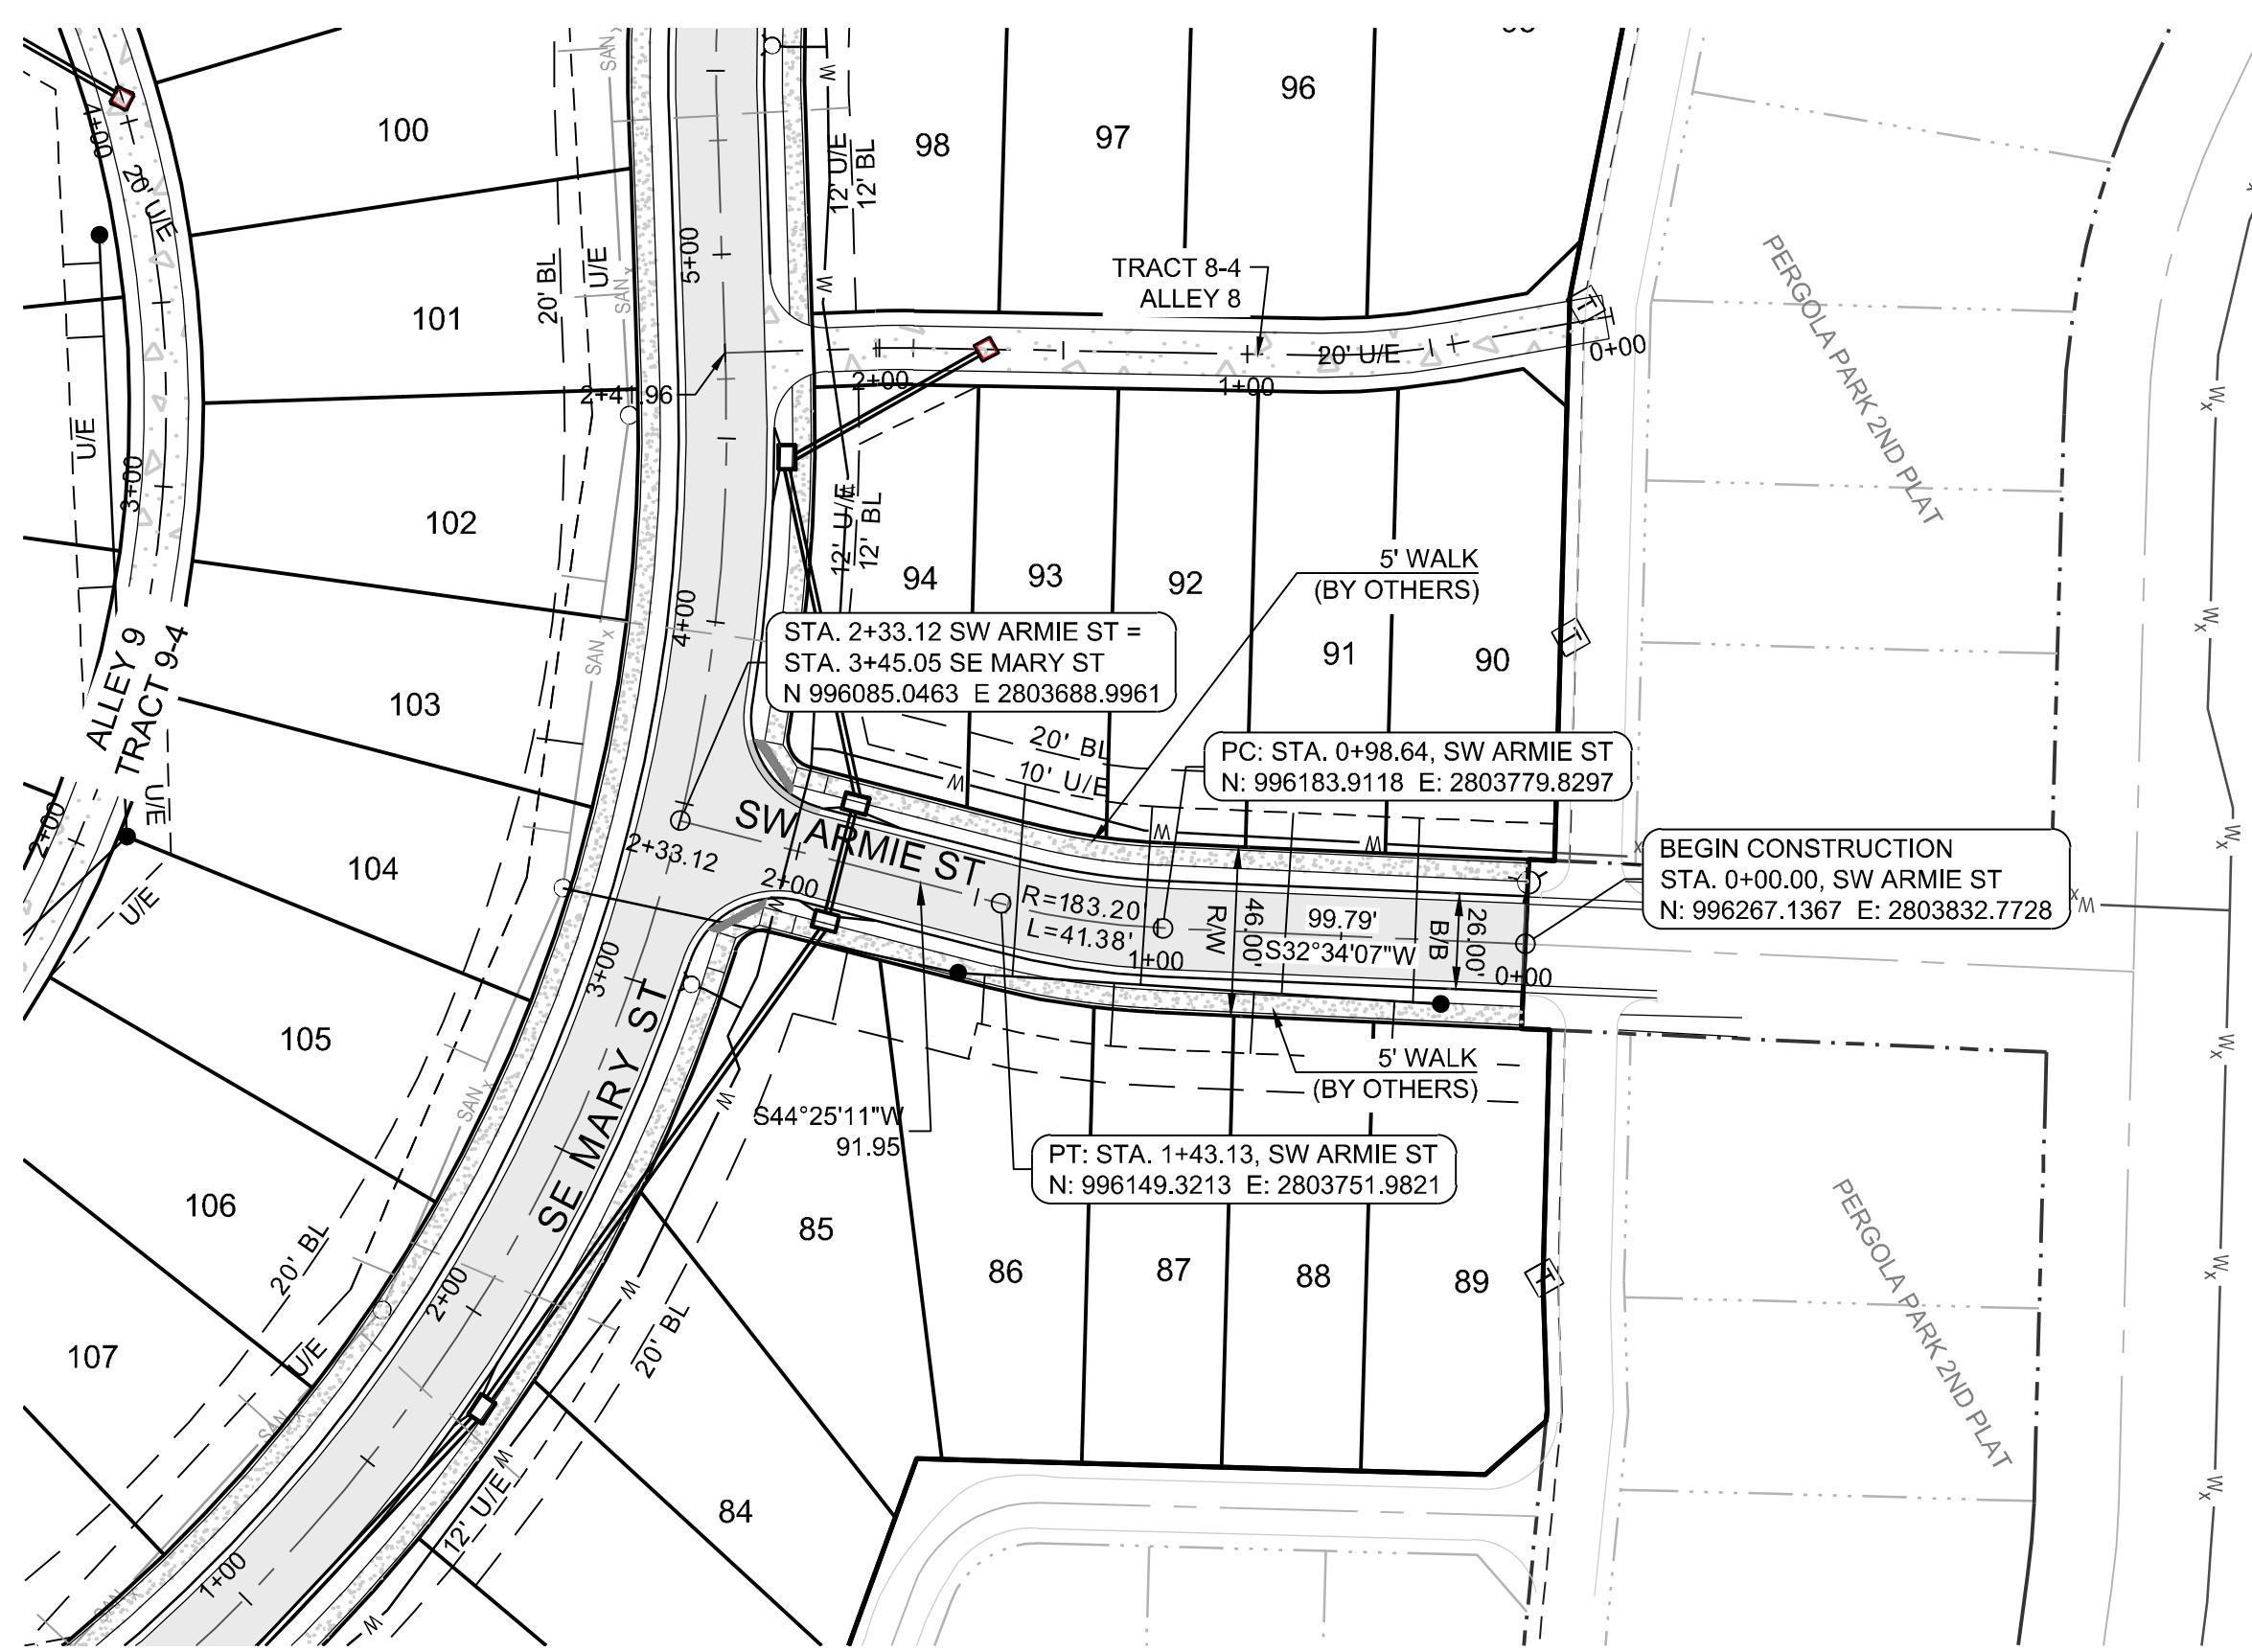

SECTION 9-47-32
SECTION 10-47-32
SECTION 15-47-32

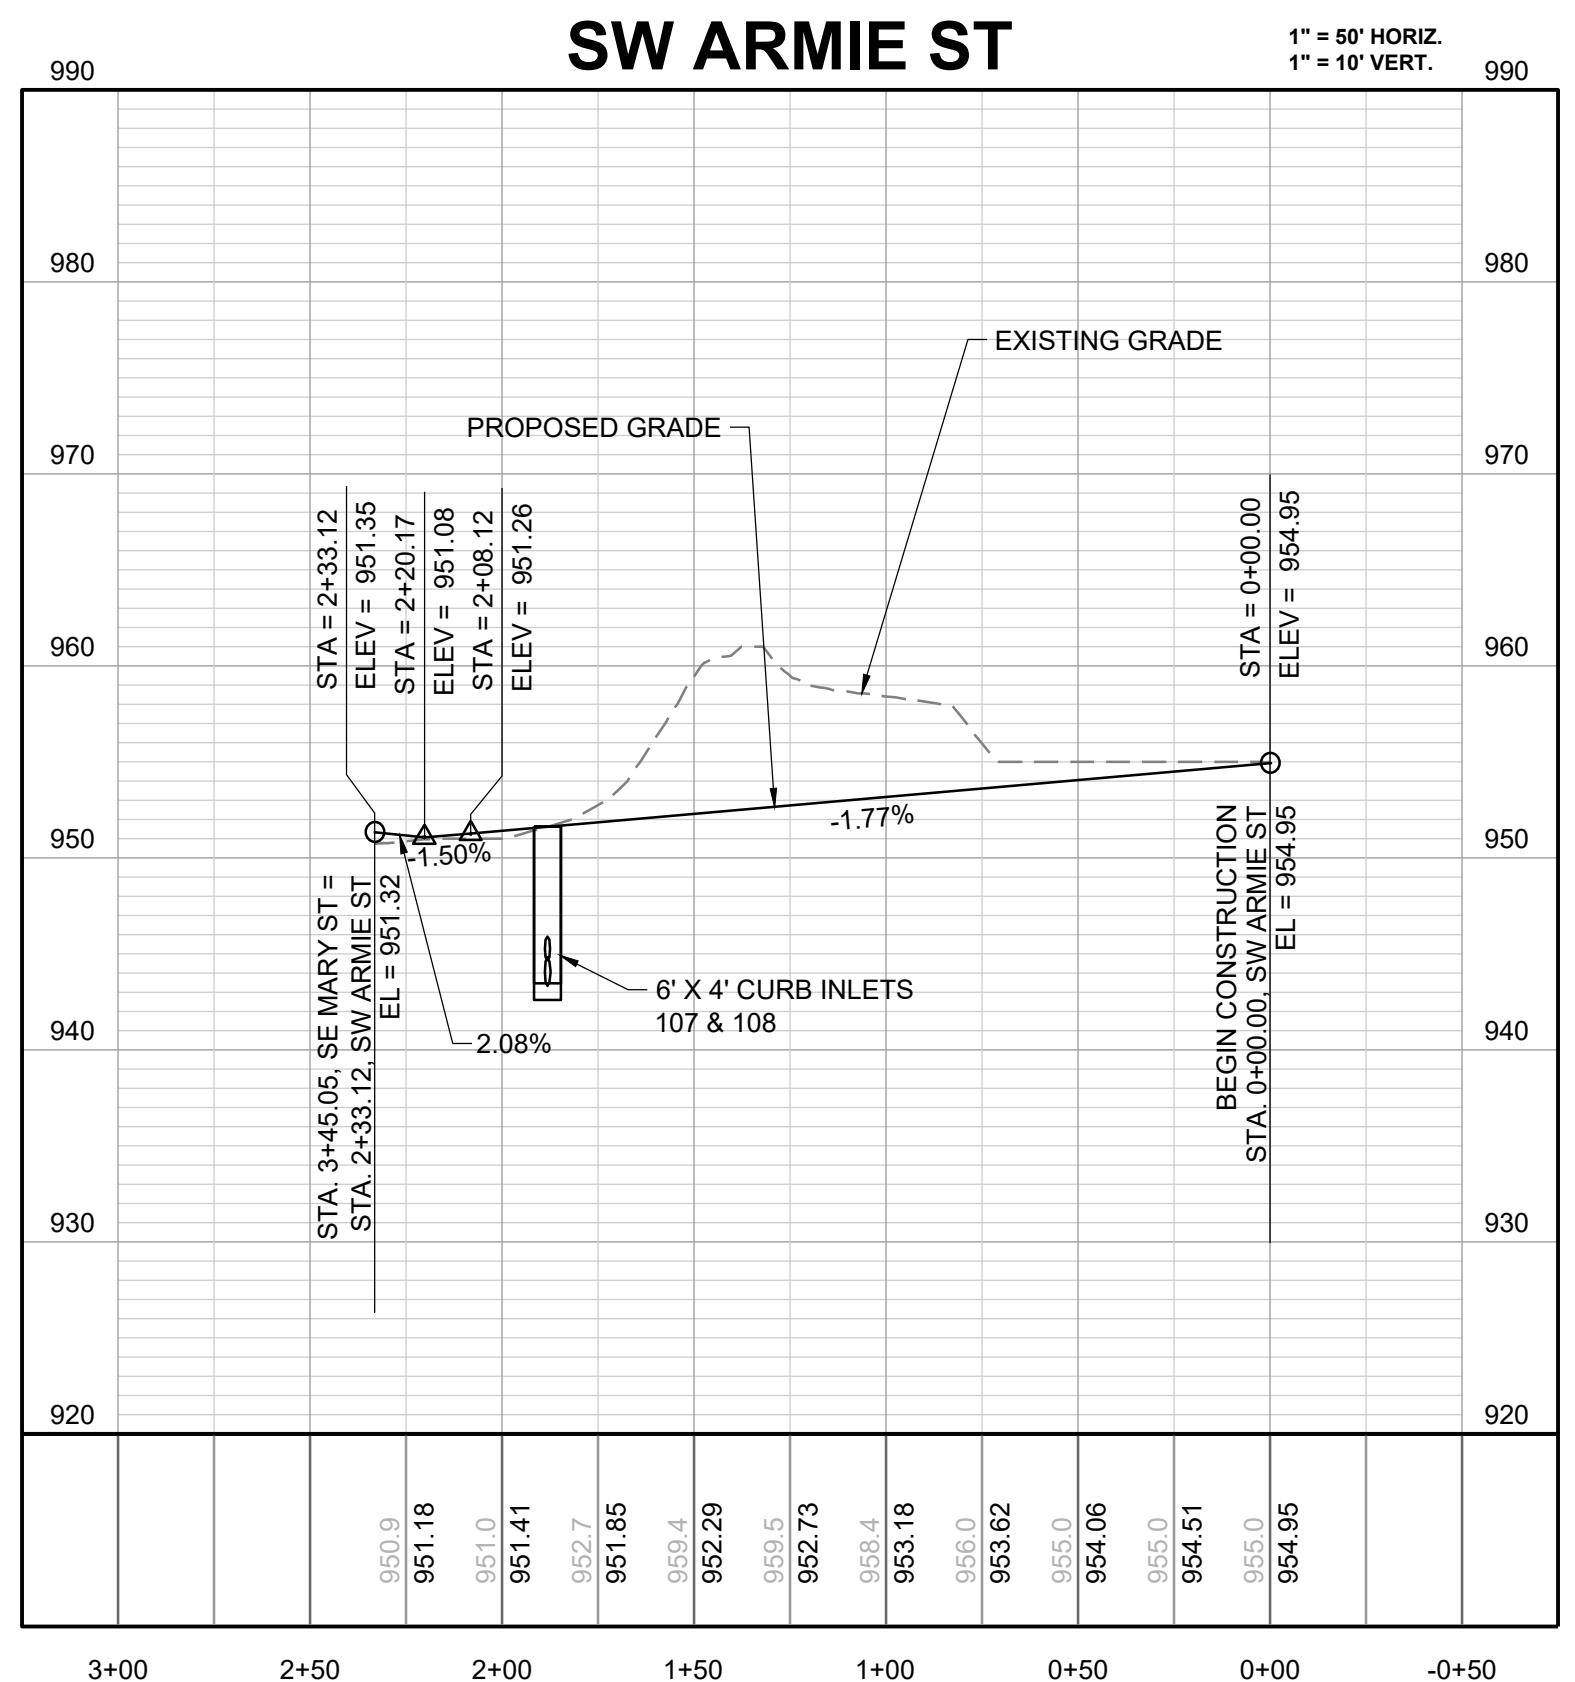
LOCATION MAP
SCALE 1" = 2000'

**PERGOLA PARK 4TH PLAT
STREET, STORMWATER, MASTER DRAINAGE
PLAN AND EROSION AND SEDIMENT**
- LEE'S SUMMIT, MISSOURI

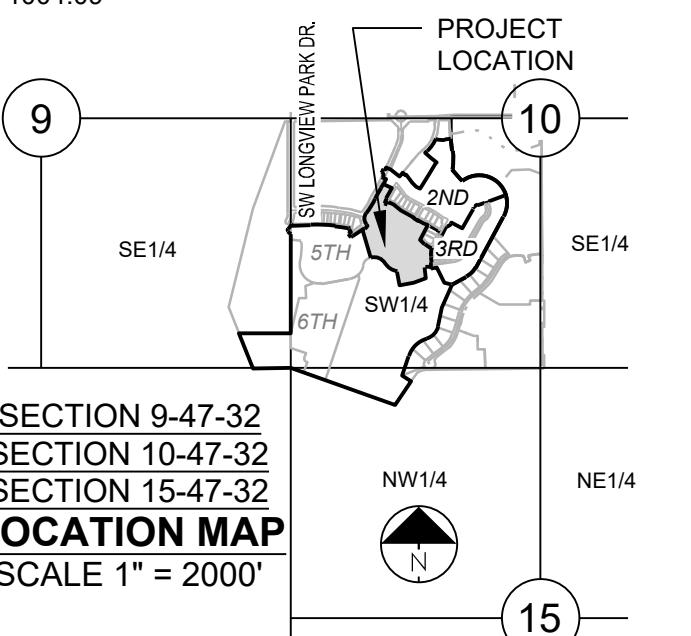
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ALLEY 8



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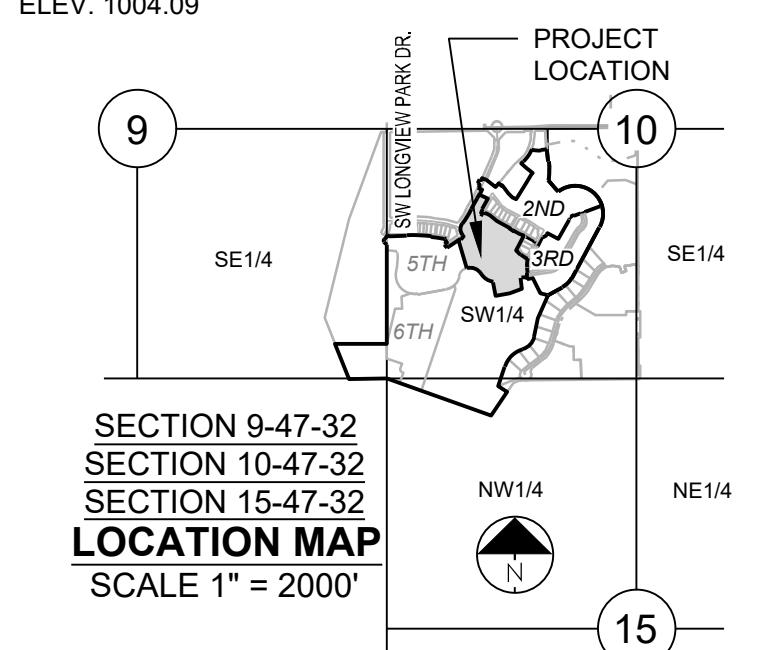
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NORTHING: 998893.4148
EASTING: 2803318.5413
ELEV. 1004.09

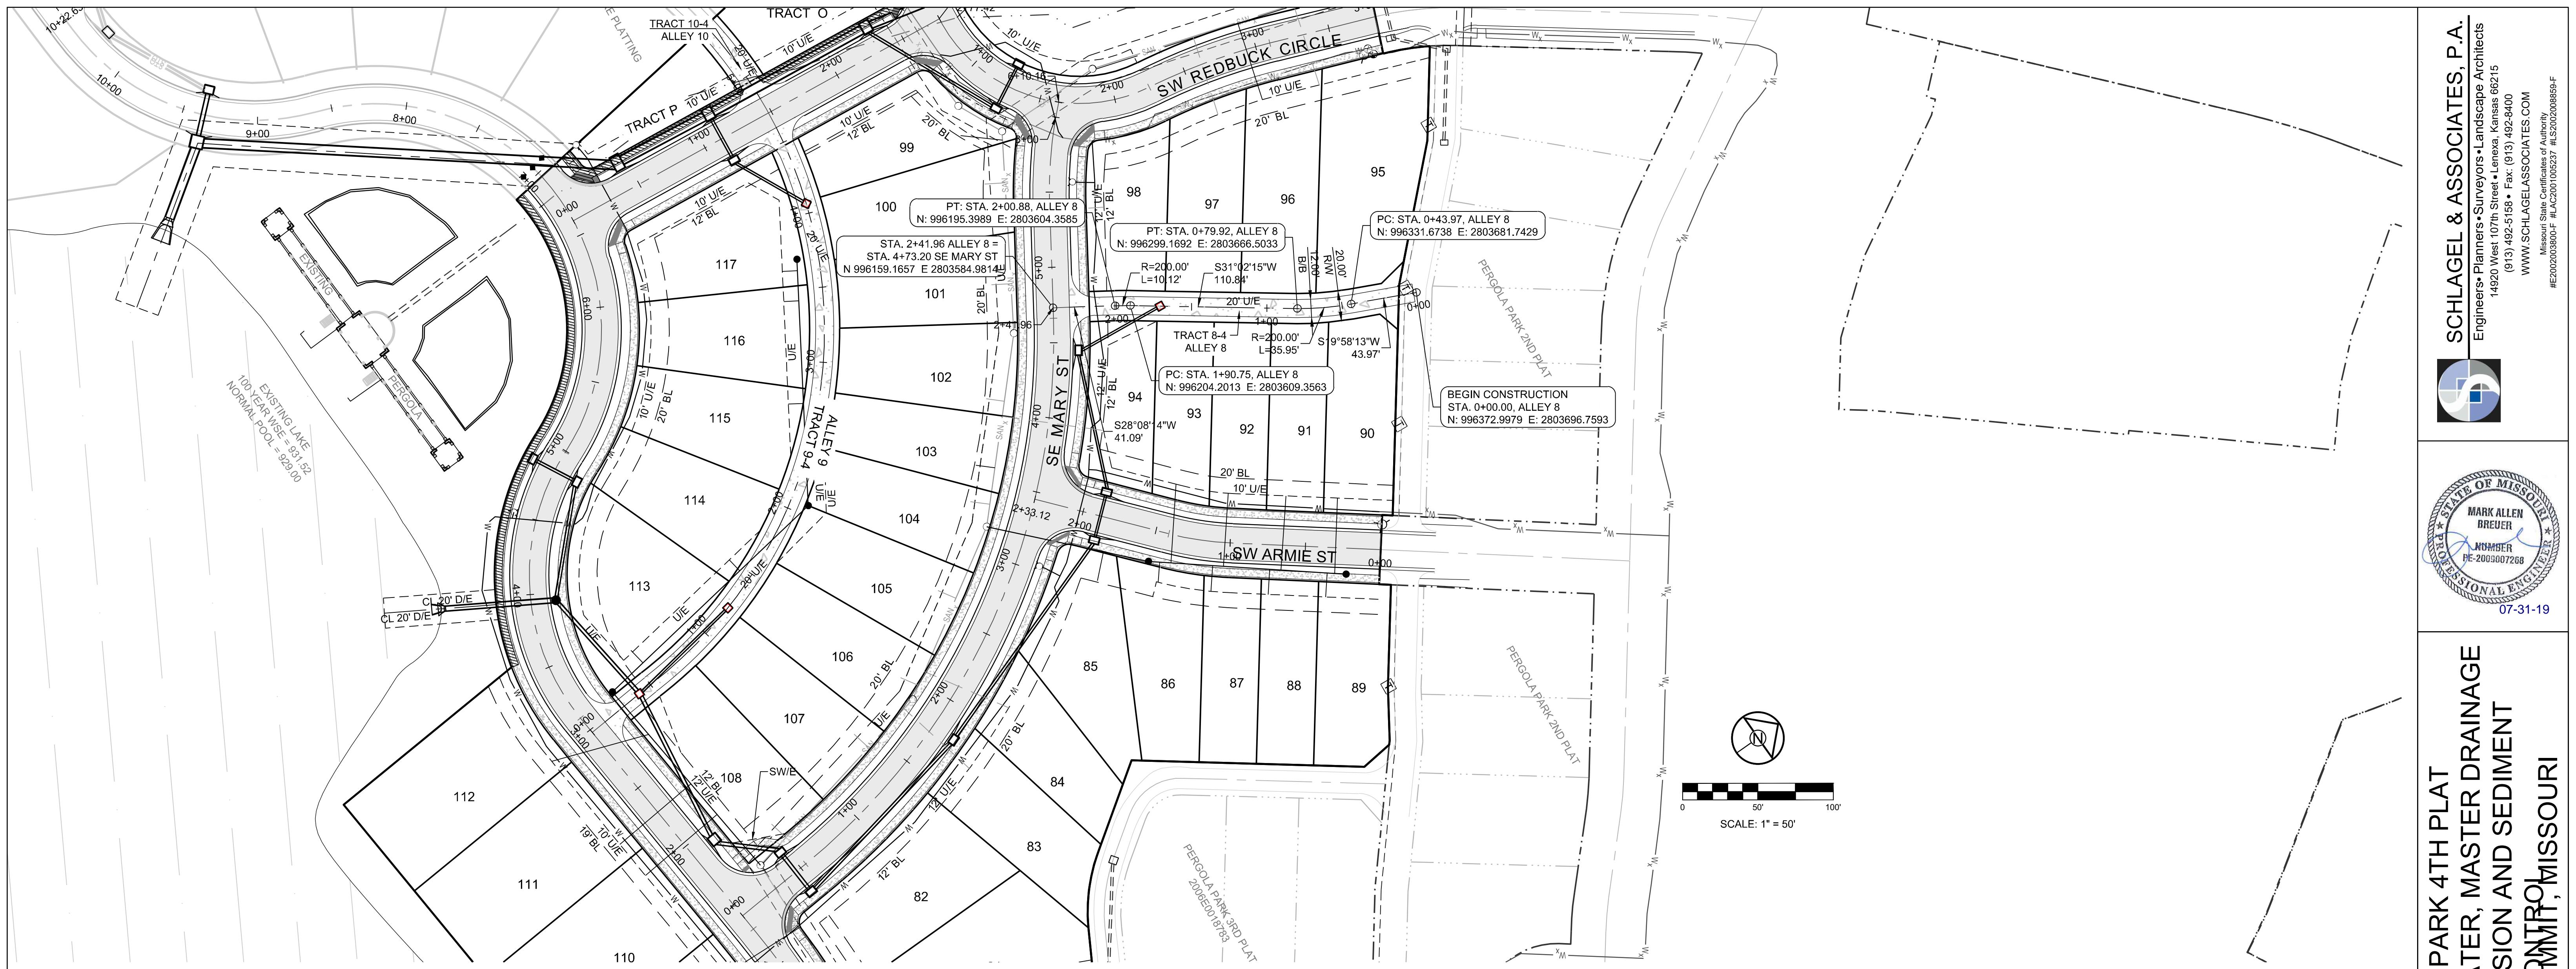


PERGOLA PARK 4TH PLAT STREET, STORMWATER, MASTER DRAINAGE PLAN AND EROSION AND SEDIMENT - LEE'S SUMMIT, MISSOURI
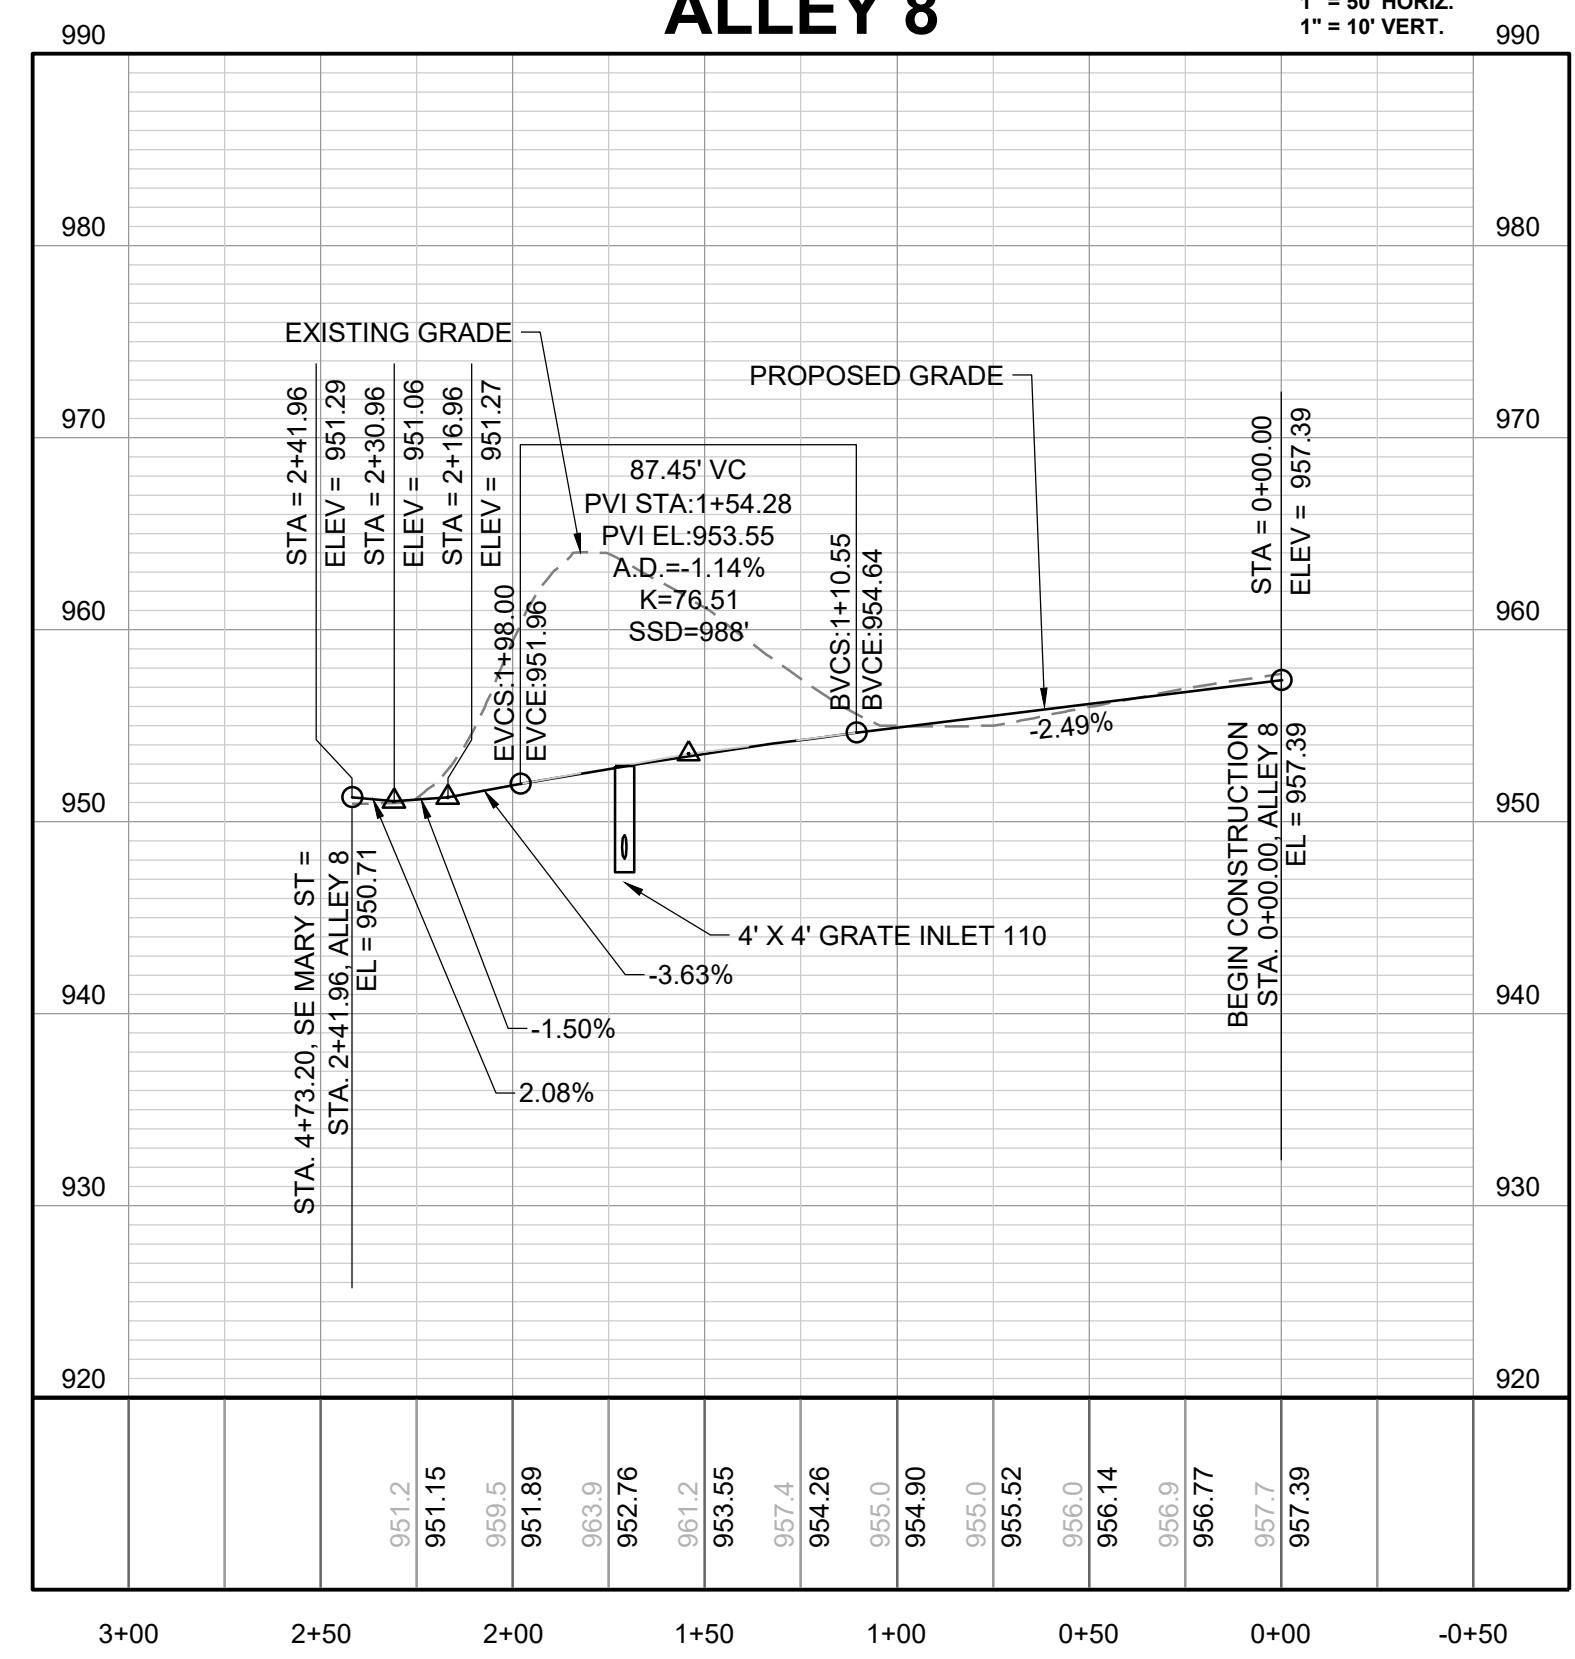
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OF 28



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MARK ALLEN BREWER
NUMBER PE-2069007268
08.16.19


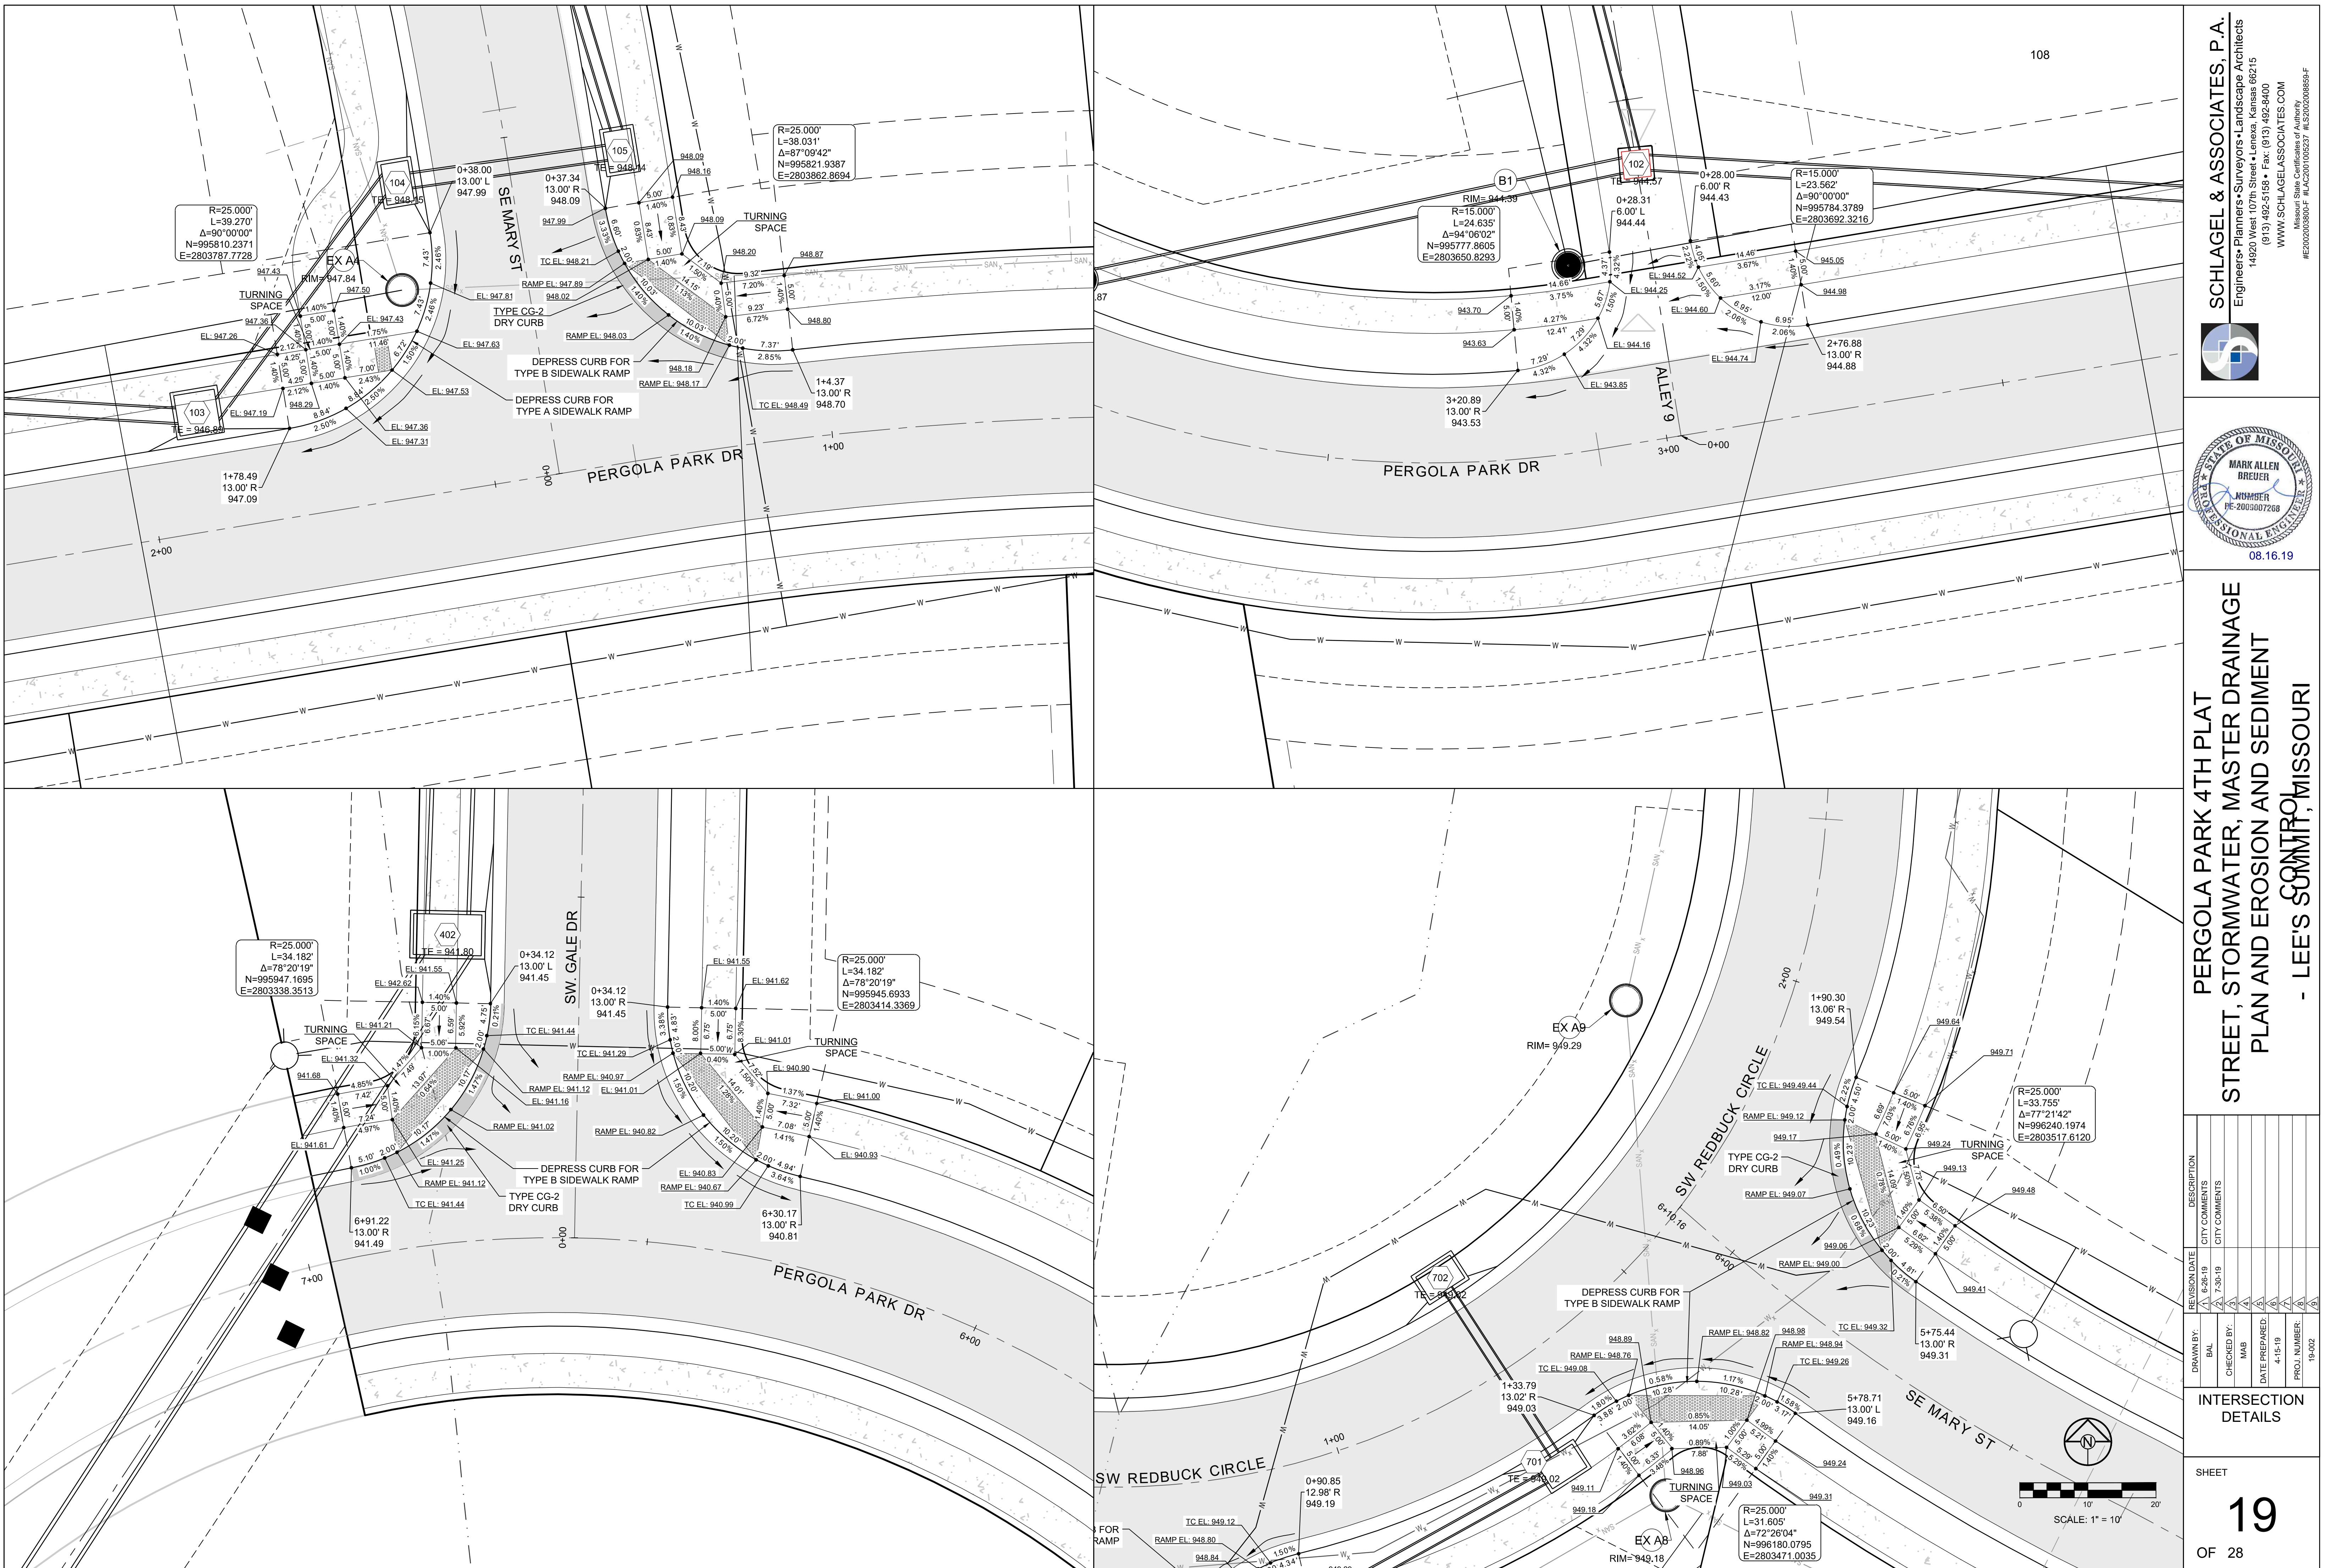
**PERGOLA PARK 4TH PLAT
STREET, STORMWATER, MASTER DRAINAGE
PLAN AND EROSION AND SEDIMENT
- LEE'S SUMMIT, MISSOURI**


INTERSECTION DETAILS

SHEET

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OF 28



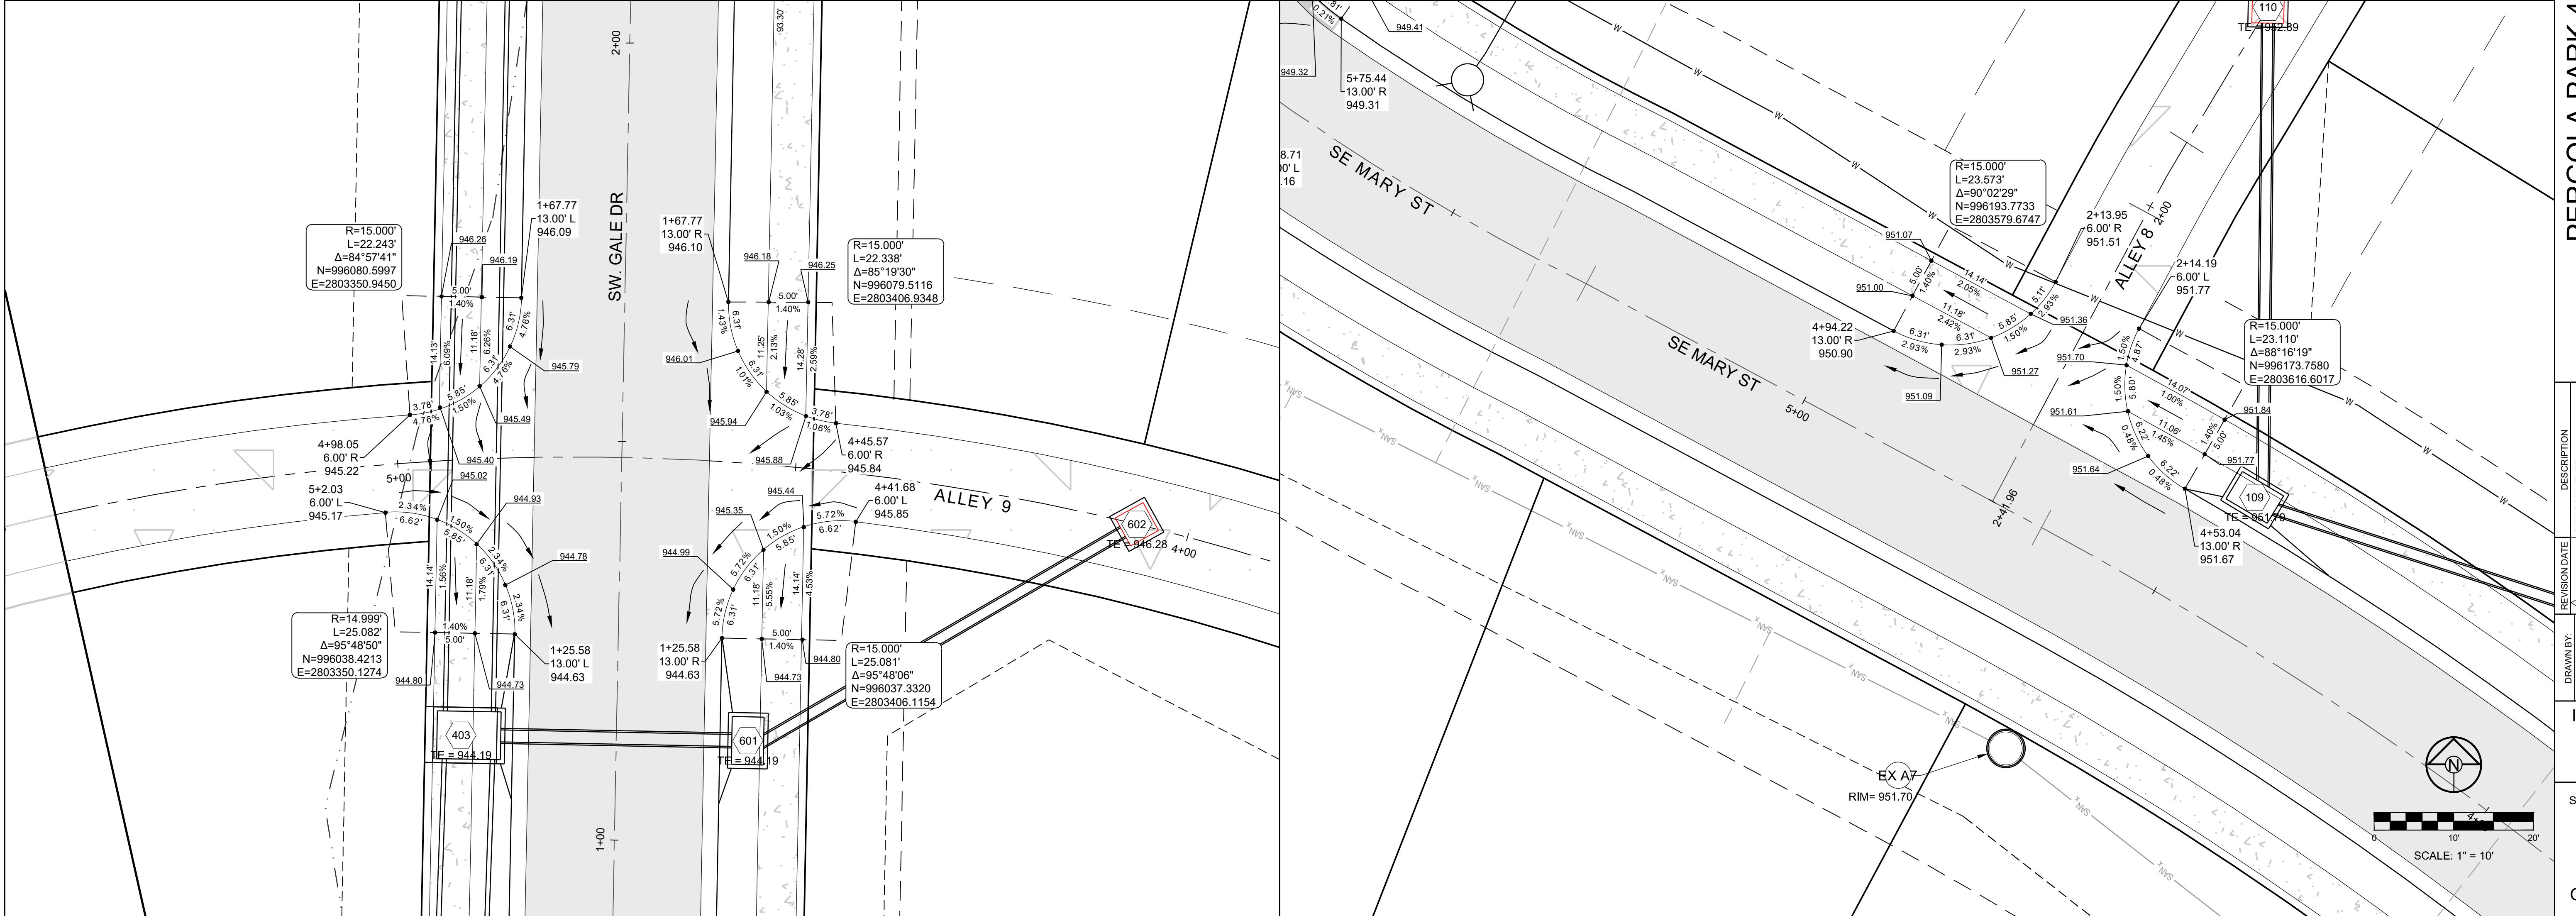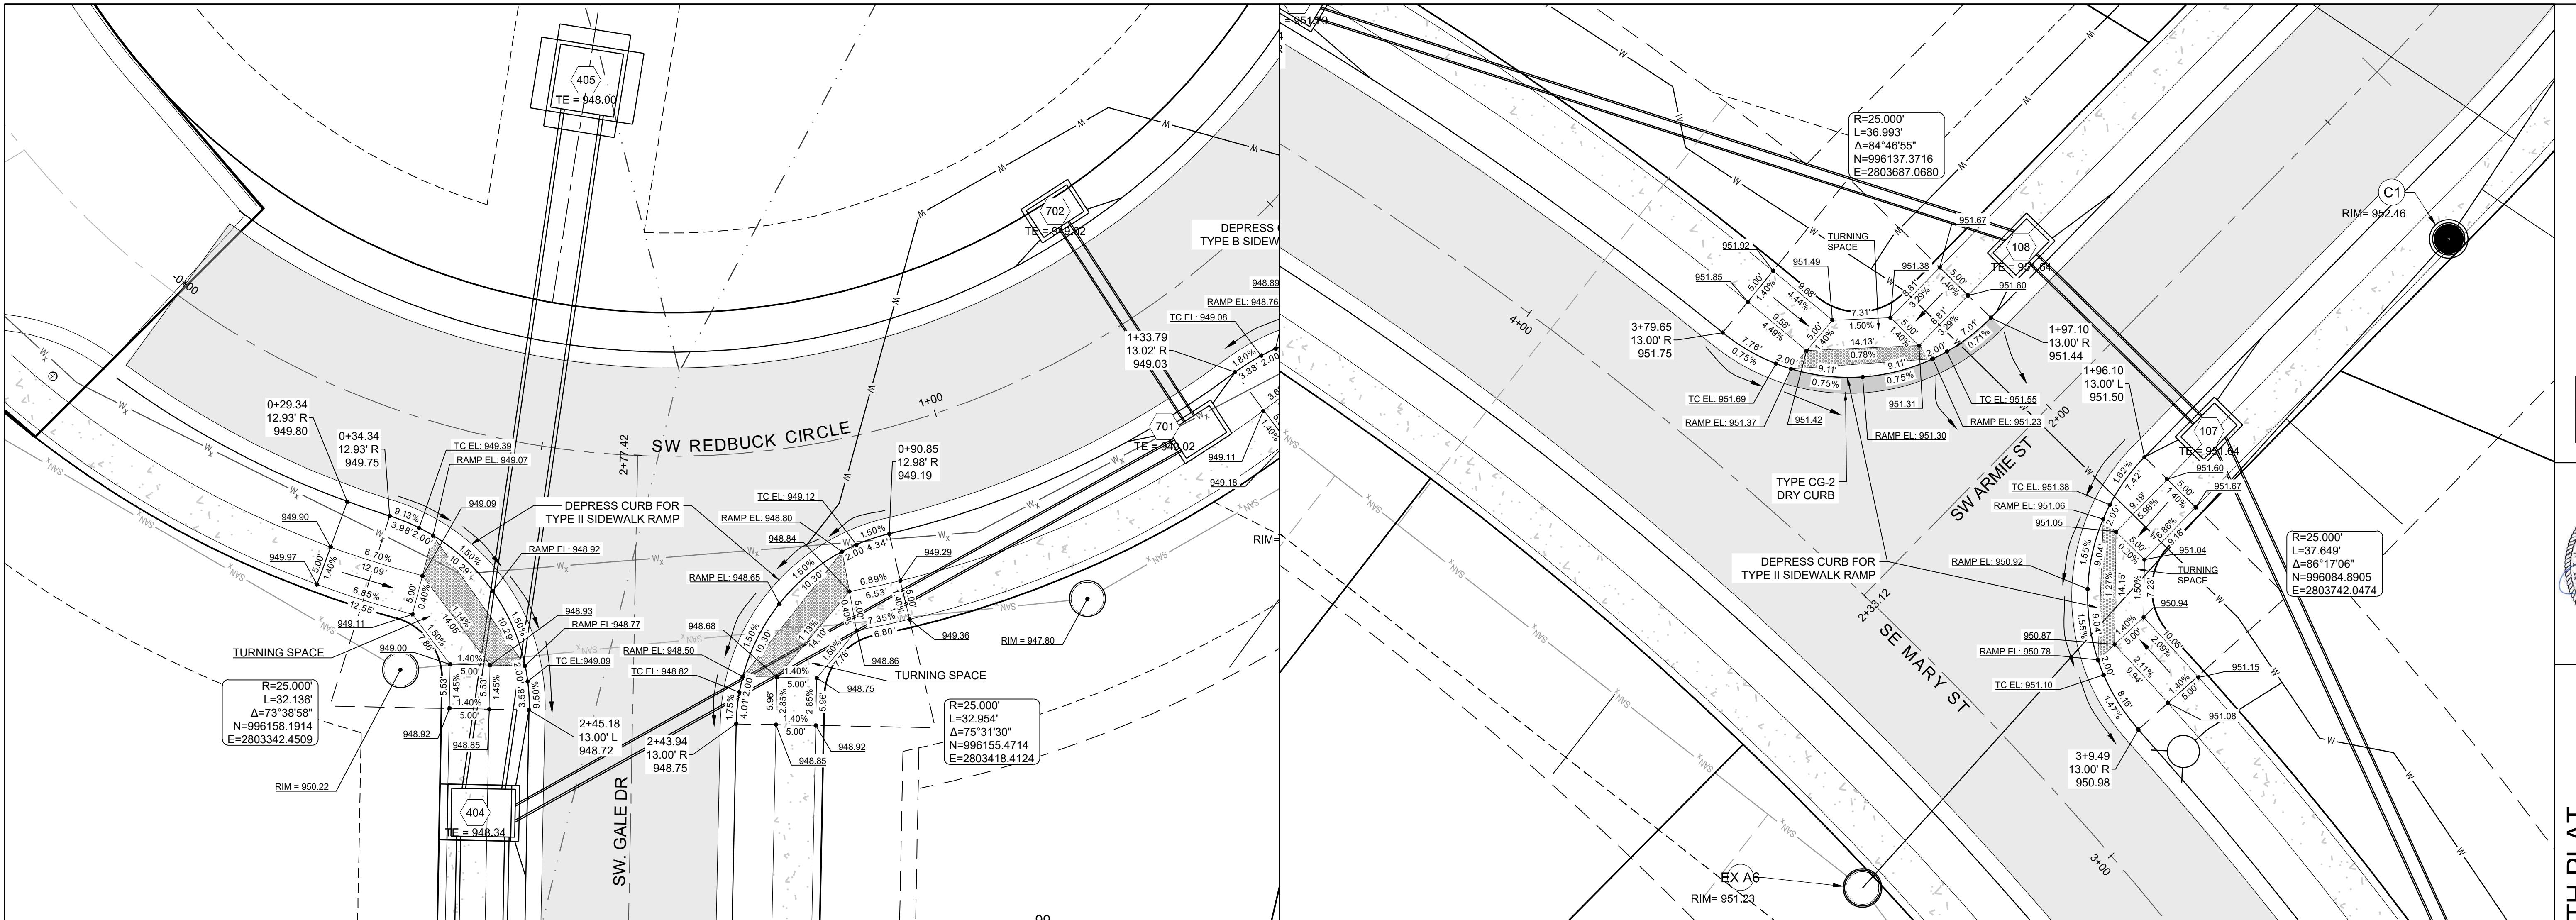

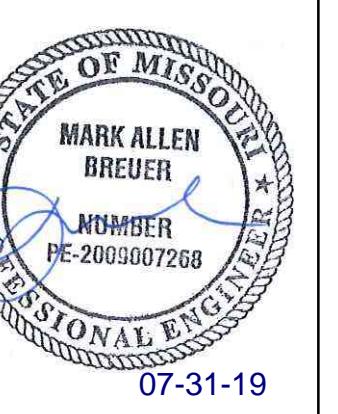07-31-19

**PERGOLA PARK 4TH PLAT
STREET, STORMWATER, MASTER DRAINAGE
PLAN AND EROSION AND SEDIMENT**

- LEE'S SUMMIT, MISSOURI

STORM PLAN

SHEET

21

OF 28

PROJ NUMBER:	19-02	DRAWN BY:	A-26-19	REVISION DATE:	A-26-19
DATE PREPARED:	4-15-19	CHECKED BY:	A-30-19	CITY COMMENTS:	CITY COMMENTS
PROJ NUMBER:	19-02	MAB	A	MAB	A




EXISTING LAKE
100 YEAR WSE = 931.52
NORMAL POOL = 929.00




Storm Sewer Construction Notes	
Structure	Notes
FUT 502	STA 0+76.93, FUTURE LINE 500 INSTALL STA 0+76.93, FUTURE LINE 500 INSTALL 6 X 4 CURB INLET 193°25'14" N 995707.5662 E 280313.0569
FUT 503	STA 1+12.08, FUTURE LINE 500 INSTALL STA 1+12.08, FUTURE LINE 500 INSTALL 4 X 4 GRATE INLET 169°43'04" N 995713.8518 E 2803078.4775
FUT 504	STA 2+35.43, FUTURE LINE 500 INSTALL STA 2+35.43, FUTURE LINE 500 INSTALL 4 X 4 GRATE INLET 72°05'54" N 995837.0622 E 2803084.2863
FUT 505	STA 3+56.69, FUTURE LINE 500 INSTALL STA 3+56.59, FUTURE LINE 500 INSTALL 4 X 4 GRATE INLET 52°37'51" N 995945.8094 E 2803137.9371
FUT 506	STA 4+70.52, FUTURE LINE 500 INSTALL STA 4+70.52, FUTURE LINE 500 INSTALL 4 X 4 GRATE INLET 50°25'10" N 996020.4745 E 2803223.8584
100	STA 0+00.00, LINE 100 INSTALL 36 INCH RCP END SECTION 245°32'19" N 995710.1628 E 2803556.3233
101	STA 0+73.29, LINE 100 INSTALL STANDARD 5 DIA ECCENTRIC MANHOLE 64°18'24" N 995776.2064 E 2803588.0987
102	STA 1+56.53, LINE 100 INSTALL 4 X 4 GRATE INLET 3°50'59" N 995793.2103 E 2803669.5838
103	STA 2+65.35, LINE 100 INSTALL 6 X 6 CURB INLET 9°57'32" N 995787.8967 E 2803778.2777
104	STA 3+10.10, LINE 100 INSTALL 6 X 4 CURB INLET 97°24'23" N 995821.6253 E 2803807.6866

Storm Sewer Construction Notes	
Structure	Notes
105	STA 3+43.11, LINE 100 INSTALL 6 X 4 CURB INLET 280°10'20" N 995826.3378 E 2803840.3550
106	STA 4+81.26, LINE 100 INSTALL 6 X 4 CURB INLET 118°45'35" N 995958.5759 E 2803800.3782
107	STA 6+43.33, LINE 100 INSTALL 6 X 4 CURB INLET 44°50'34" N 996105.6524 E 2803732.2907
108	STA 6+76.33, LINE 100 INSTALL 6 X 4 CURB INLET 44°4'16" N 996128.7494 E 2803708.7210
109	STA 7+72.27, LINE 100 INSTALL 6 X 4 CURB INLET 150°45'35" N 996159.6705 E 2803617.9003
110	STA 8+33.78, LINE 100 INSTALL 4 X 4 GRATE INLET 88°27'08" N 996221.1611 E 2803619.5619
201	STA 0+79.83, LINE 200 INSTALL 6 X 4 CURB INLET 121°29'35" N 995827.6413 E 2803527.0512
202	STA 1+12.83, LINE 200 INSTALL 6 X 4 CURB INLET 302°29'18" N 995809.9160 E 2803499.2157
301	STA 0+81.86, LINE 300 INSTALL 4 X 4 GRATE INLET 14°06'51" N 995872.6005 E 2803649.6217
400	STA 0+05.04, LINE 400 INSTALL 66 INCH RCP END SECTION 310°08'56" N 995680.9362 E 2803240.2414


LINE 100

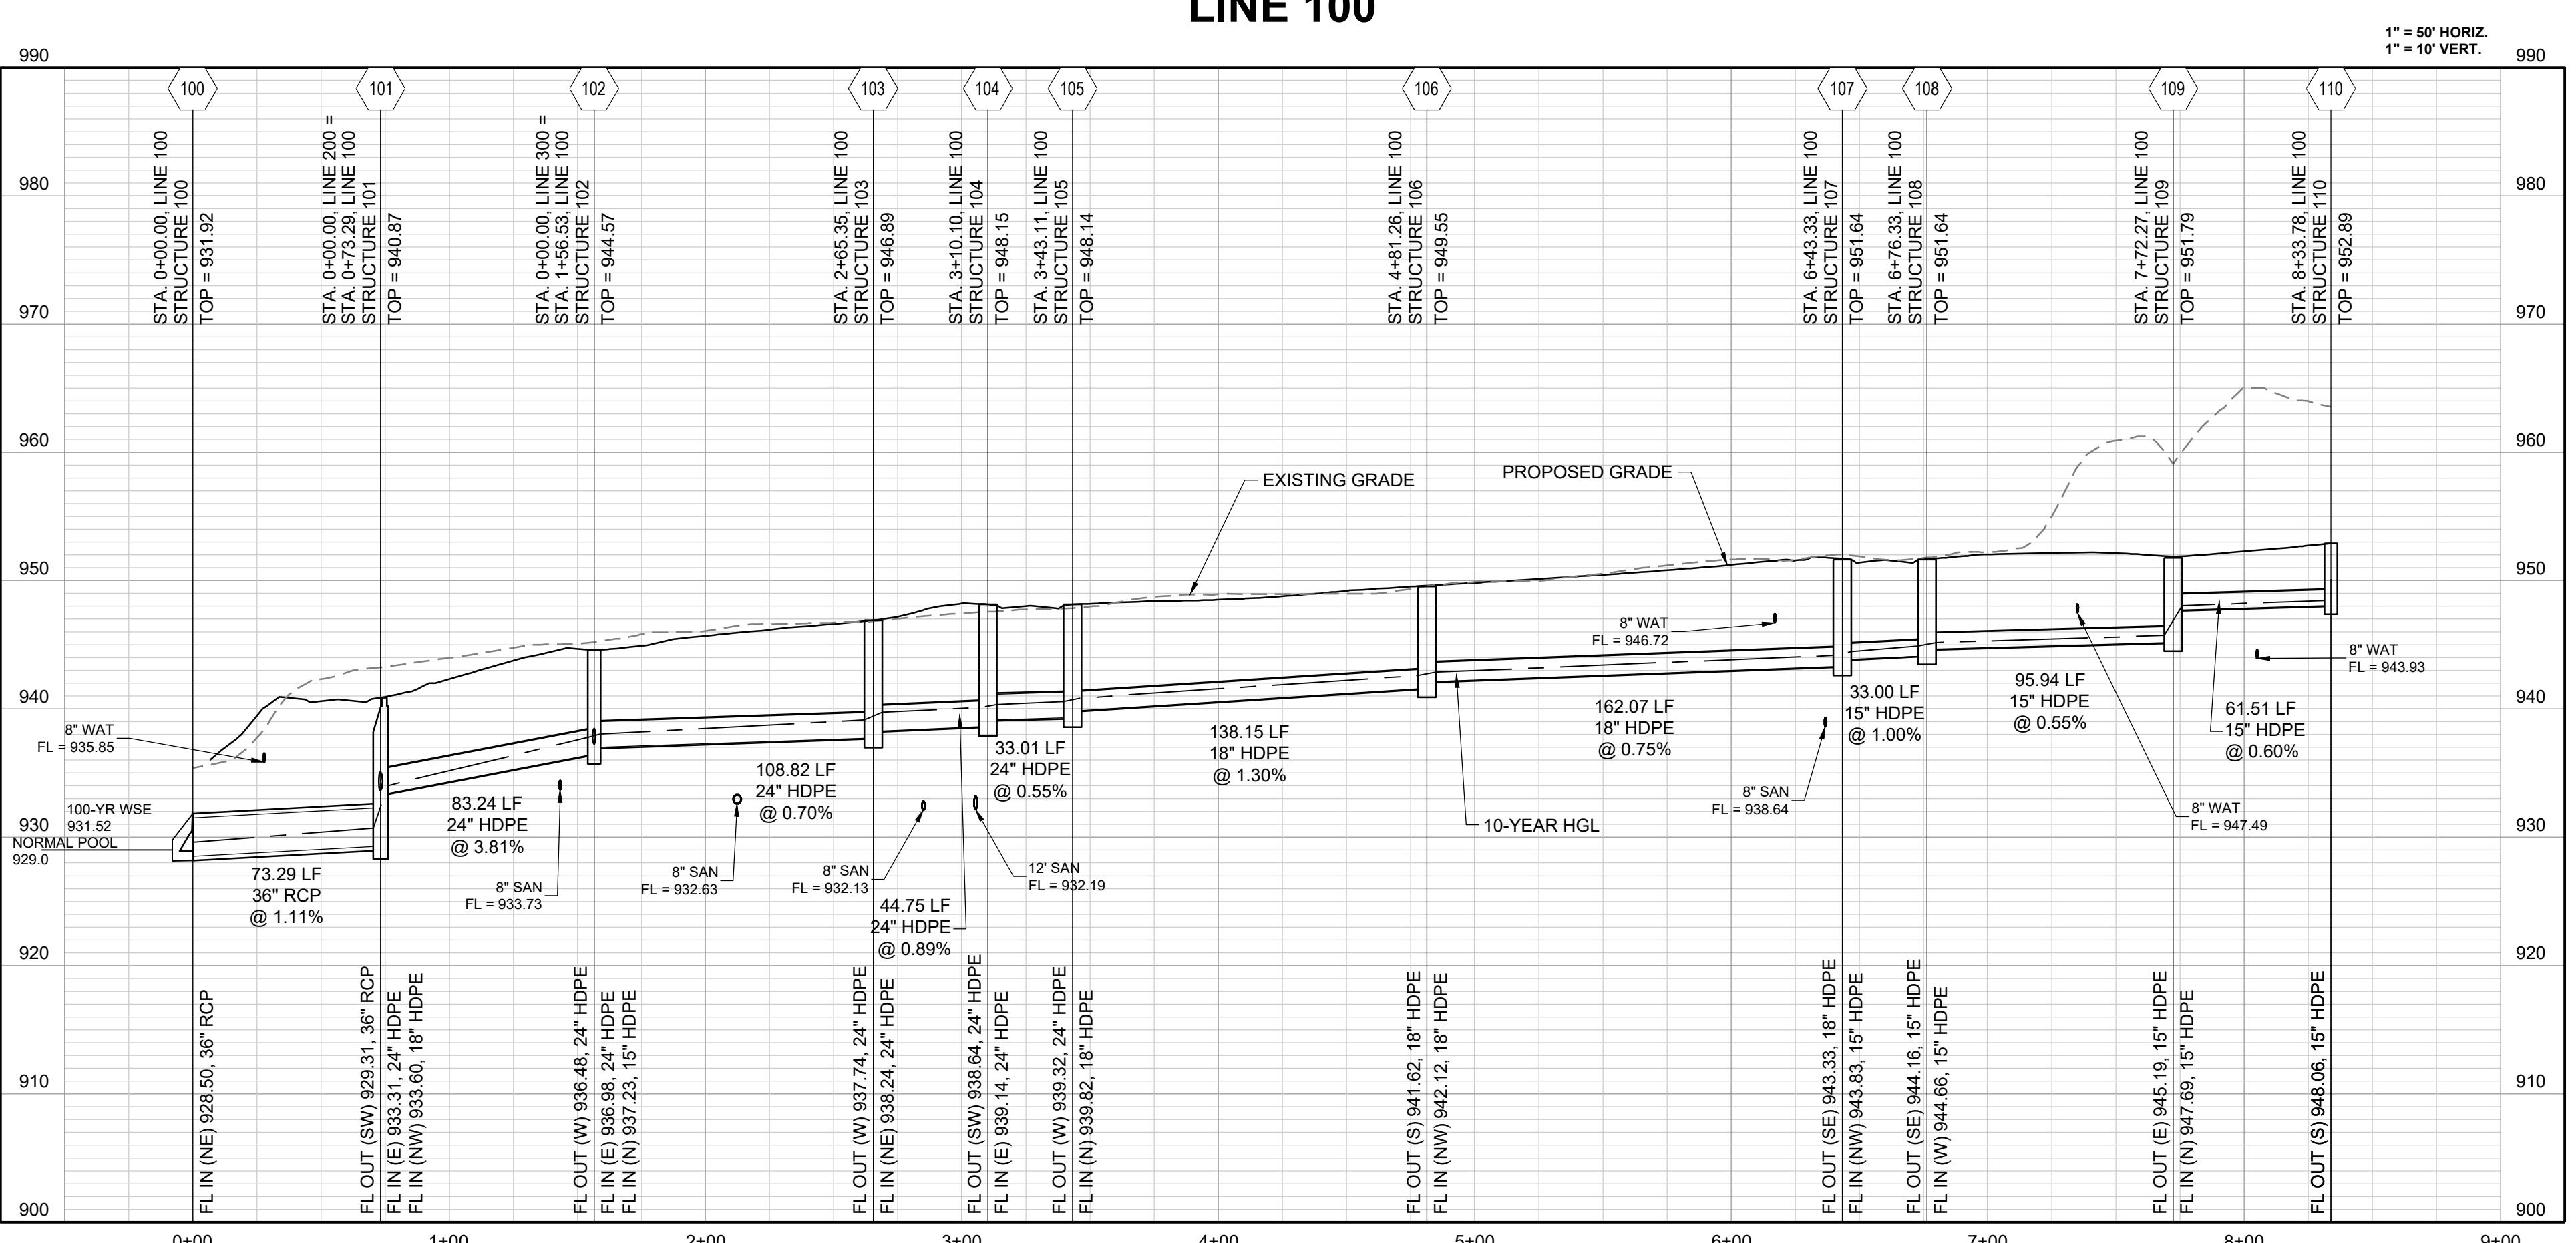


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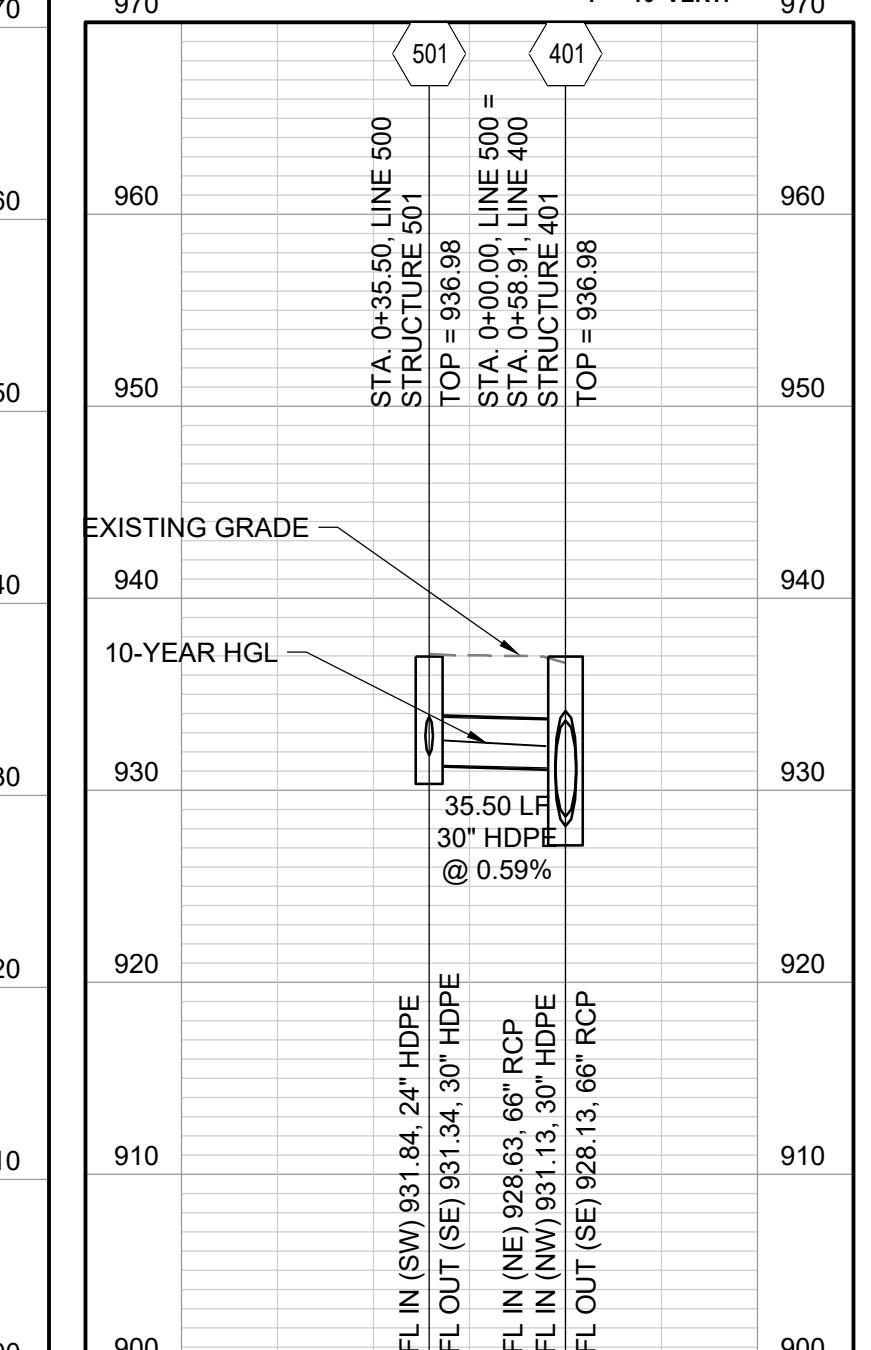
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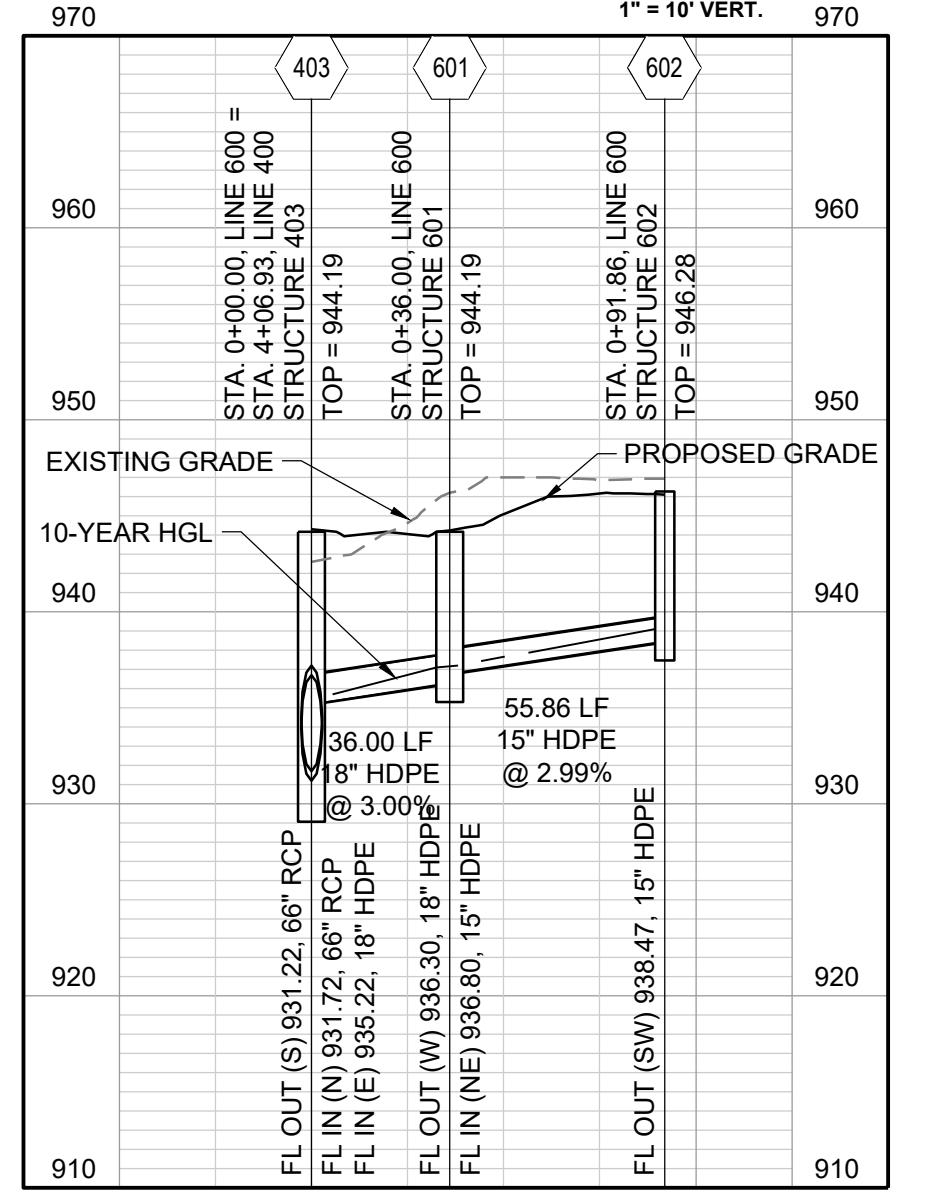
LINE 400

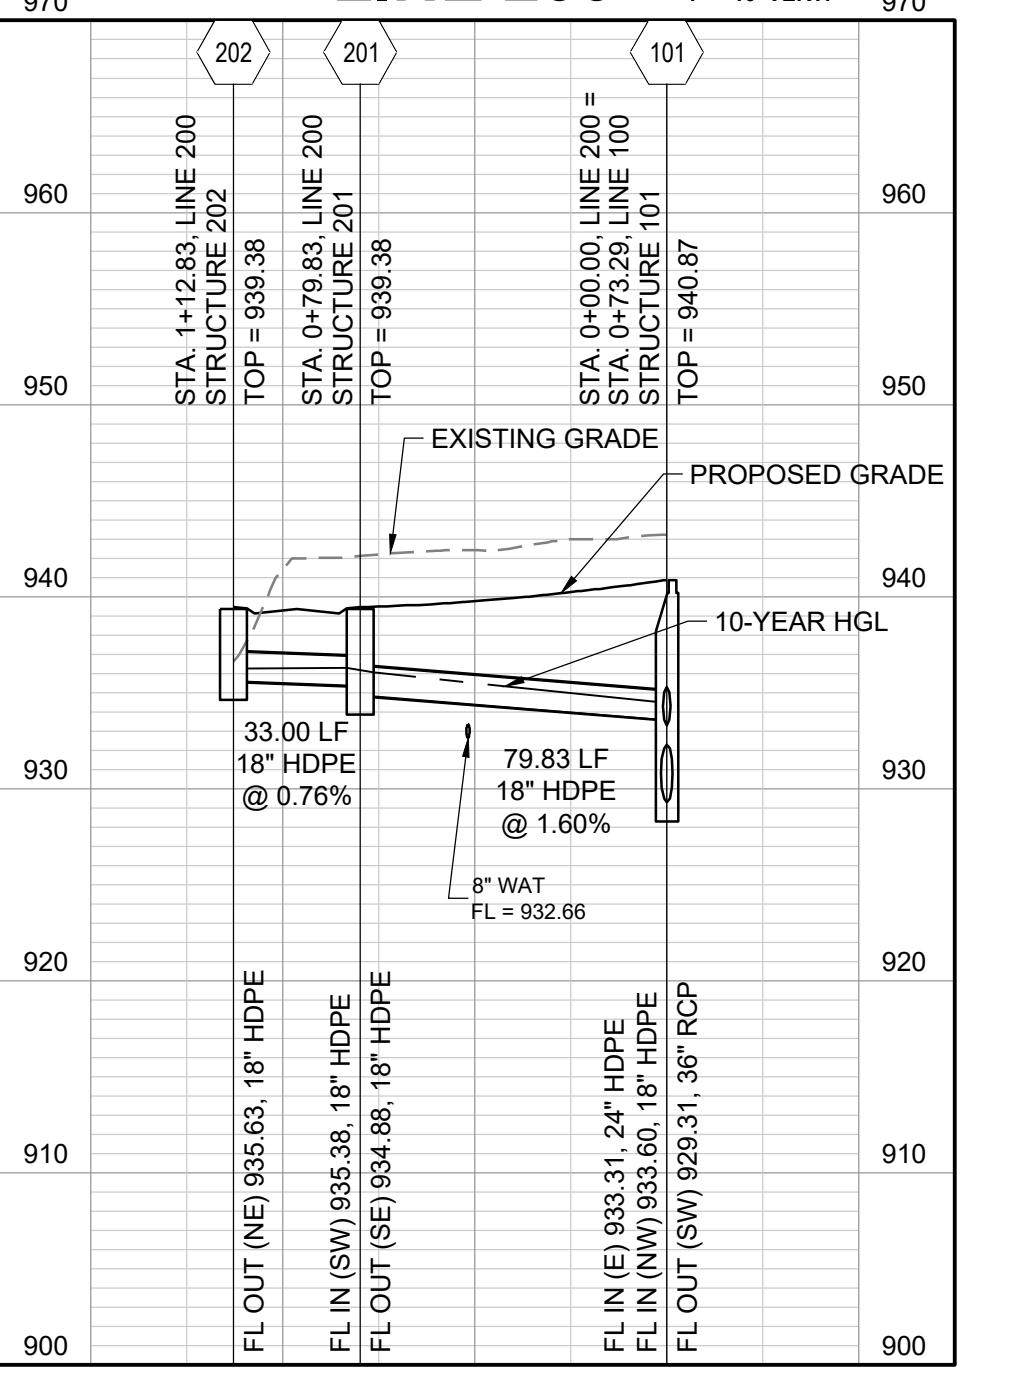


LINE 500

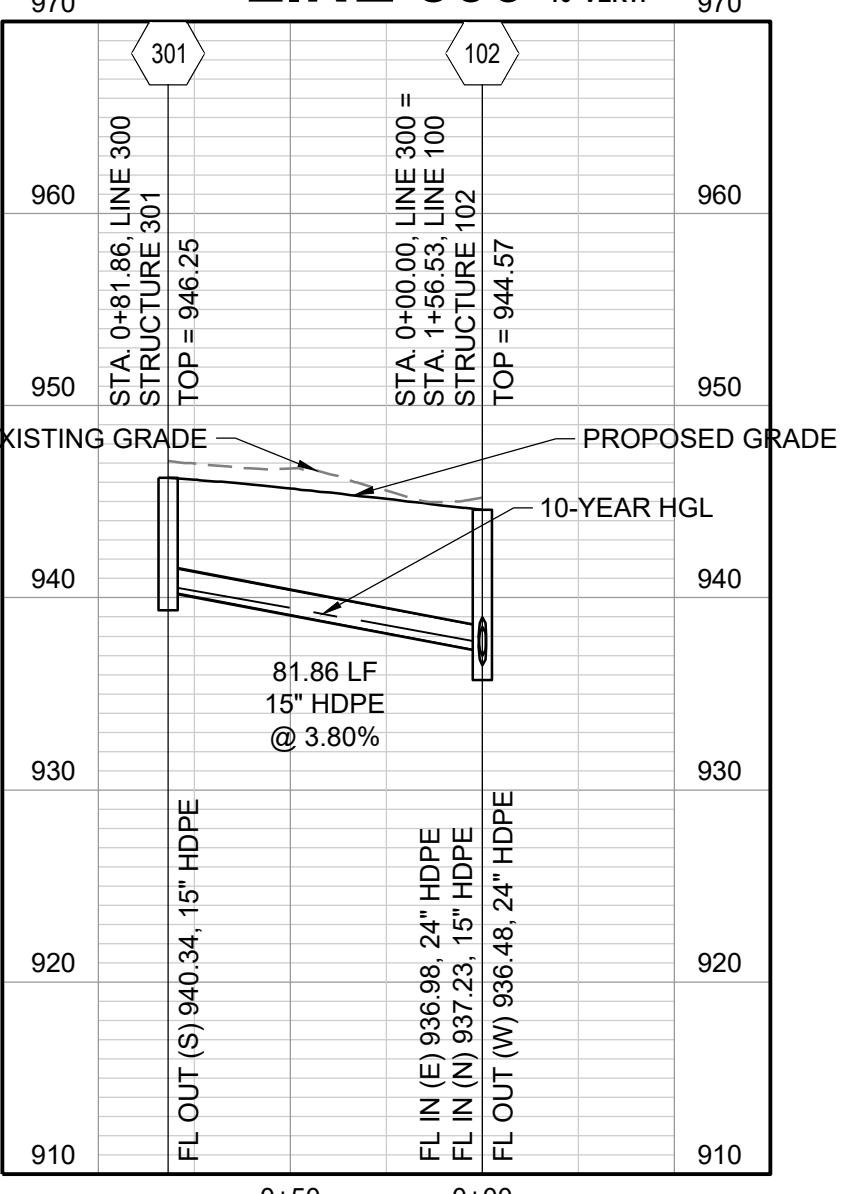

LINE 600

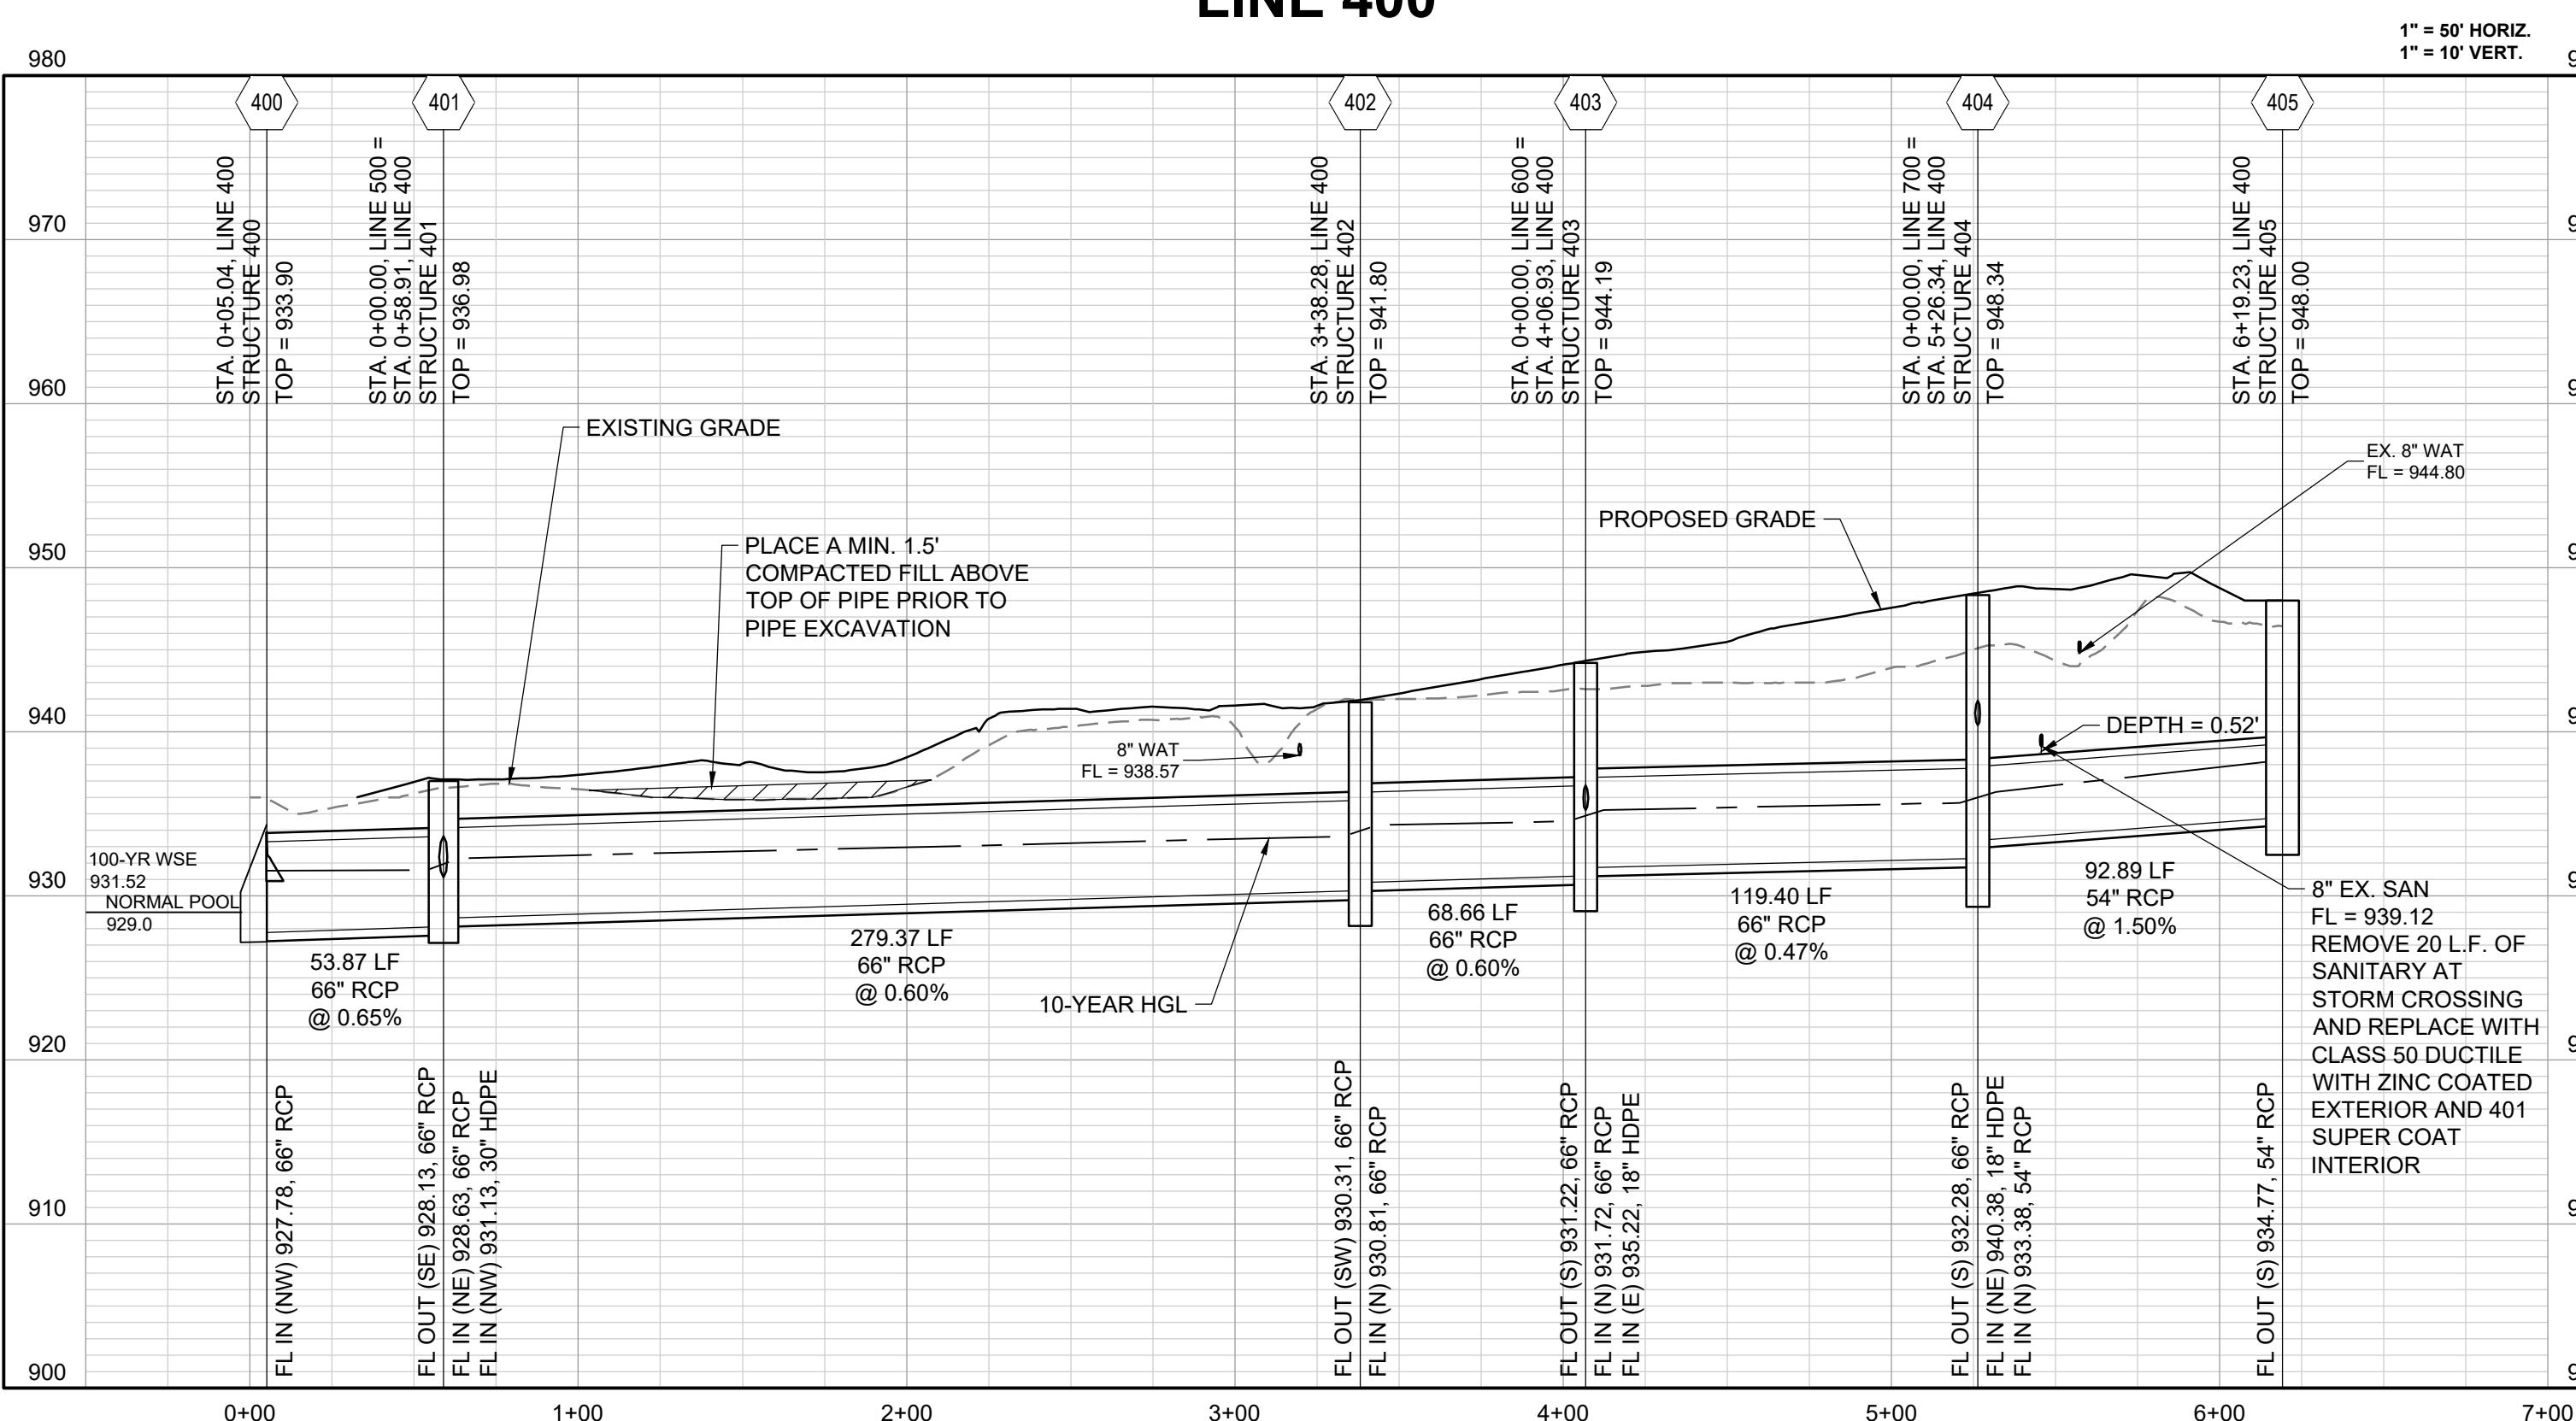

LINE 700

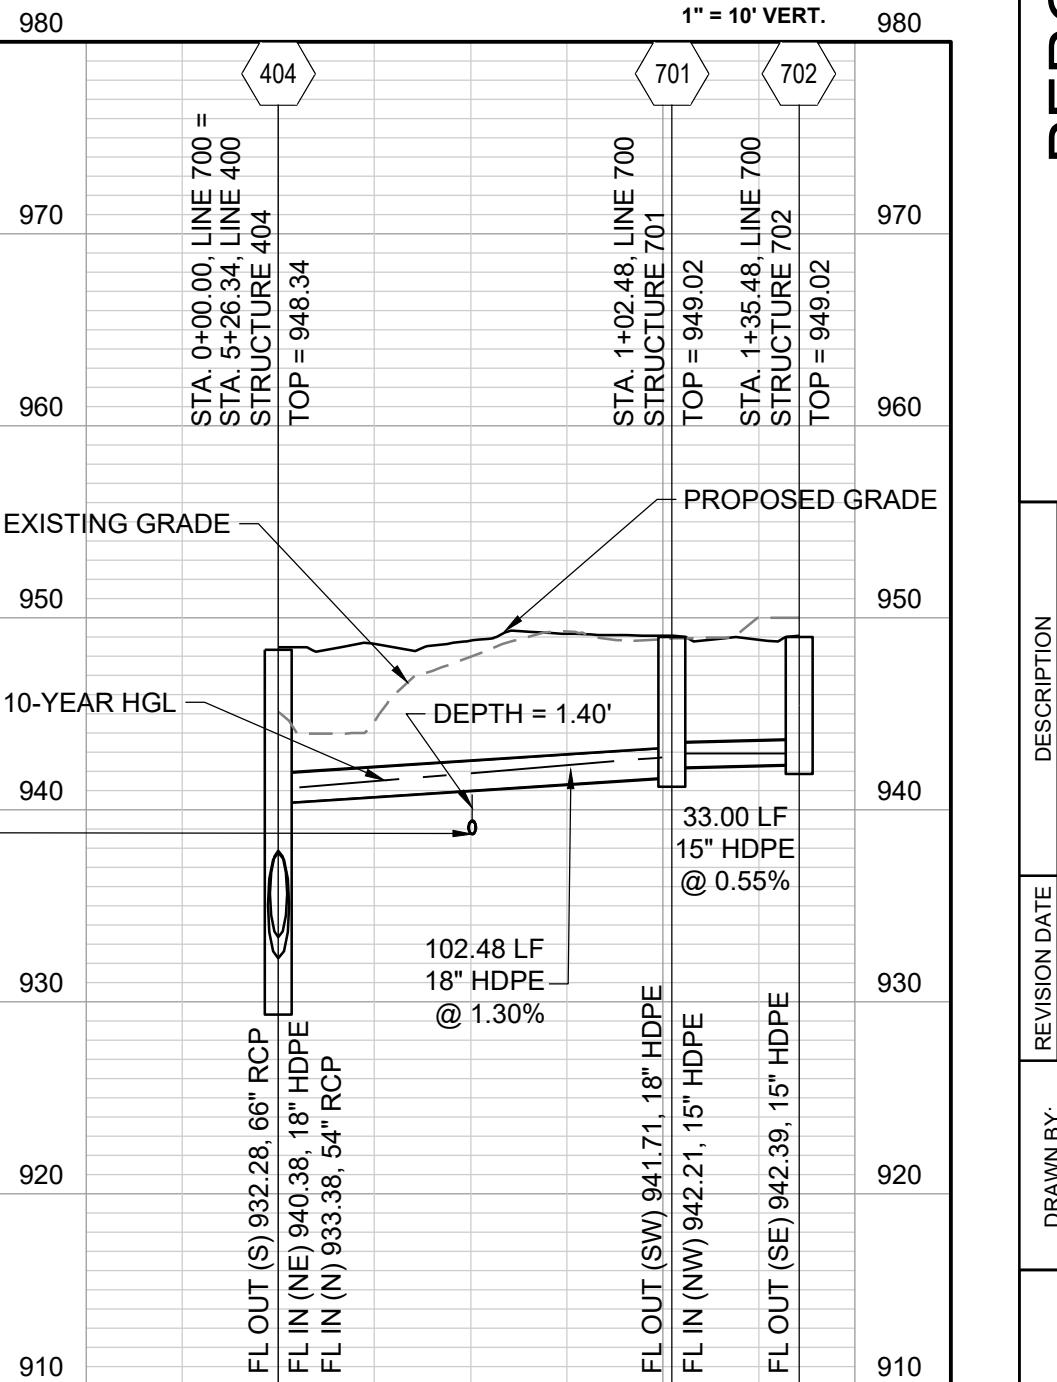

**PERGOLA PARK 4TH PLAT
STREET, STORMWATER, MASTER DRAINAGE
PLAN AND EROSION AND SEDIMENT**

- LEE'S SUMMIT, MISSOURI







**STATE OF MISSOURI
MARK ALLEN BREUER
NUMBER
07-31-19**

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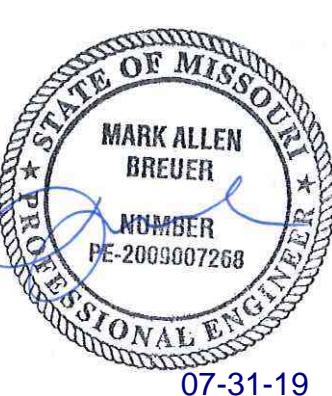
Missouri State Certifications of Integrity
#E20203000F #LAC2020100237 #LS202009859-F

SHEET	STORM PROFILES		
	DRAWN BY: BAL CITY COMMENTS CHECKED BY: JRW CITY COMMENTS	DESCRIPTION	REVISION DATE: E-26-19
701	FL OUT (SW) 931.22, 18" HDPE FL IN (N) 932.28, 18" HDPE FL IN (E) 932.28, 18" HDPE FL IN (NW) 932.28, 18" HDPE FL IN (NE) 932.28, 18" HDPE FL IN (W) 932.28, 18" HDPE	EX. 8" WAT FL = 944.80	1" = 50' HORIZONTAL 1" = 10' VERTICAL
702	FL OUT (SW) 931.22, 18" HDPE FL IN (N) 932.28, 18" HDPE FL IN (E) 932.28, 18" HDPE FL IN (NW) 932.28, 18" HDPE FL IN (NE) 932.28, 18" HDPE FL IN (W) 932.28, 18" HDPE	DEPTH = 0.52'	1" = 50' HORIZONTAL 1" = 10' VERTICAL
703	FL OUT (SW) 931.22, 18" HDPE FL IN (N) 932.28, 18" HDPE FL IN (E) 932.28, 18" HDPE FL IN (NW) 932.28, 18" HDPE FL IN (NE) 932.28, 18" HDPE FL IN (W) 932.28, 18" HDPE	REMOVAL OF 20 LF OF SANITARY AT STORM CROSSING AND REPLACE WITH CLASS 50 DUCTILE EXTERIOR AND 401 SUPER COAT INTERIOR	1" = 50' HORIZONTAL 1" = 10' VERTICAL



PERGOLA PARK 4TH PLAT
STREET, STORMWATER, MASTER DRAINAGE
PLAN AND EROSION AND SEDIMENT
- LEE'S SUMMIT, MISSOURI

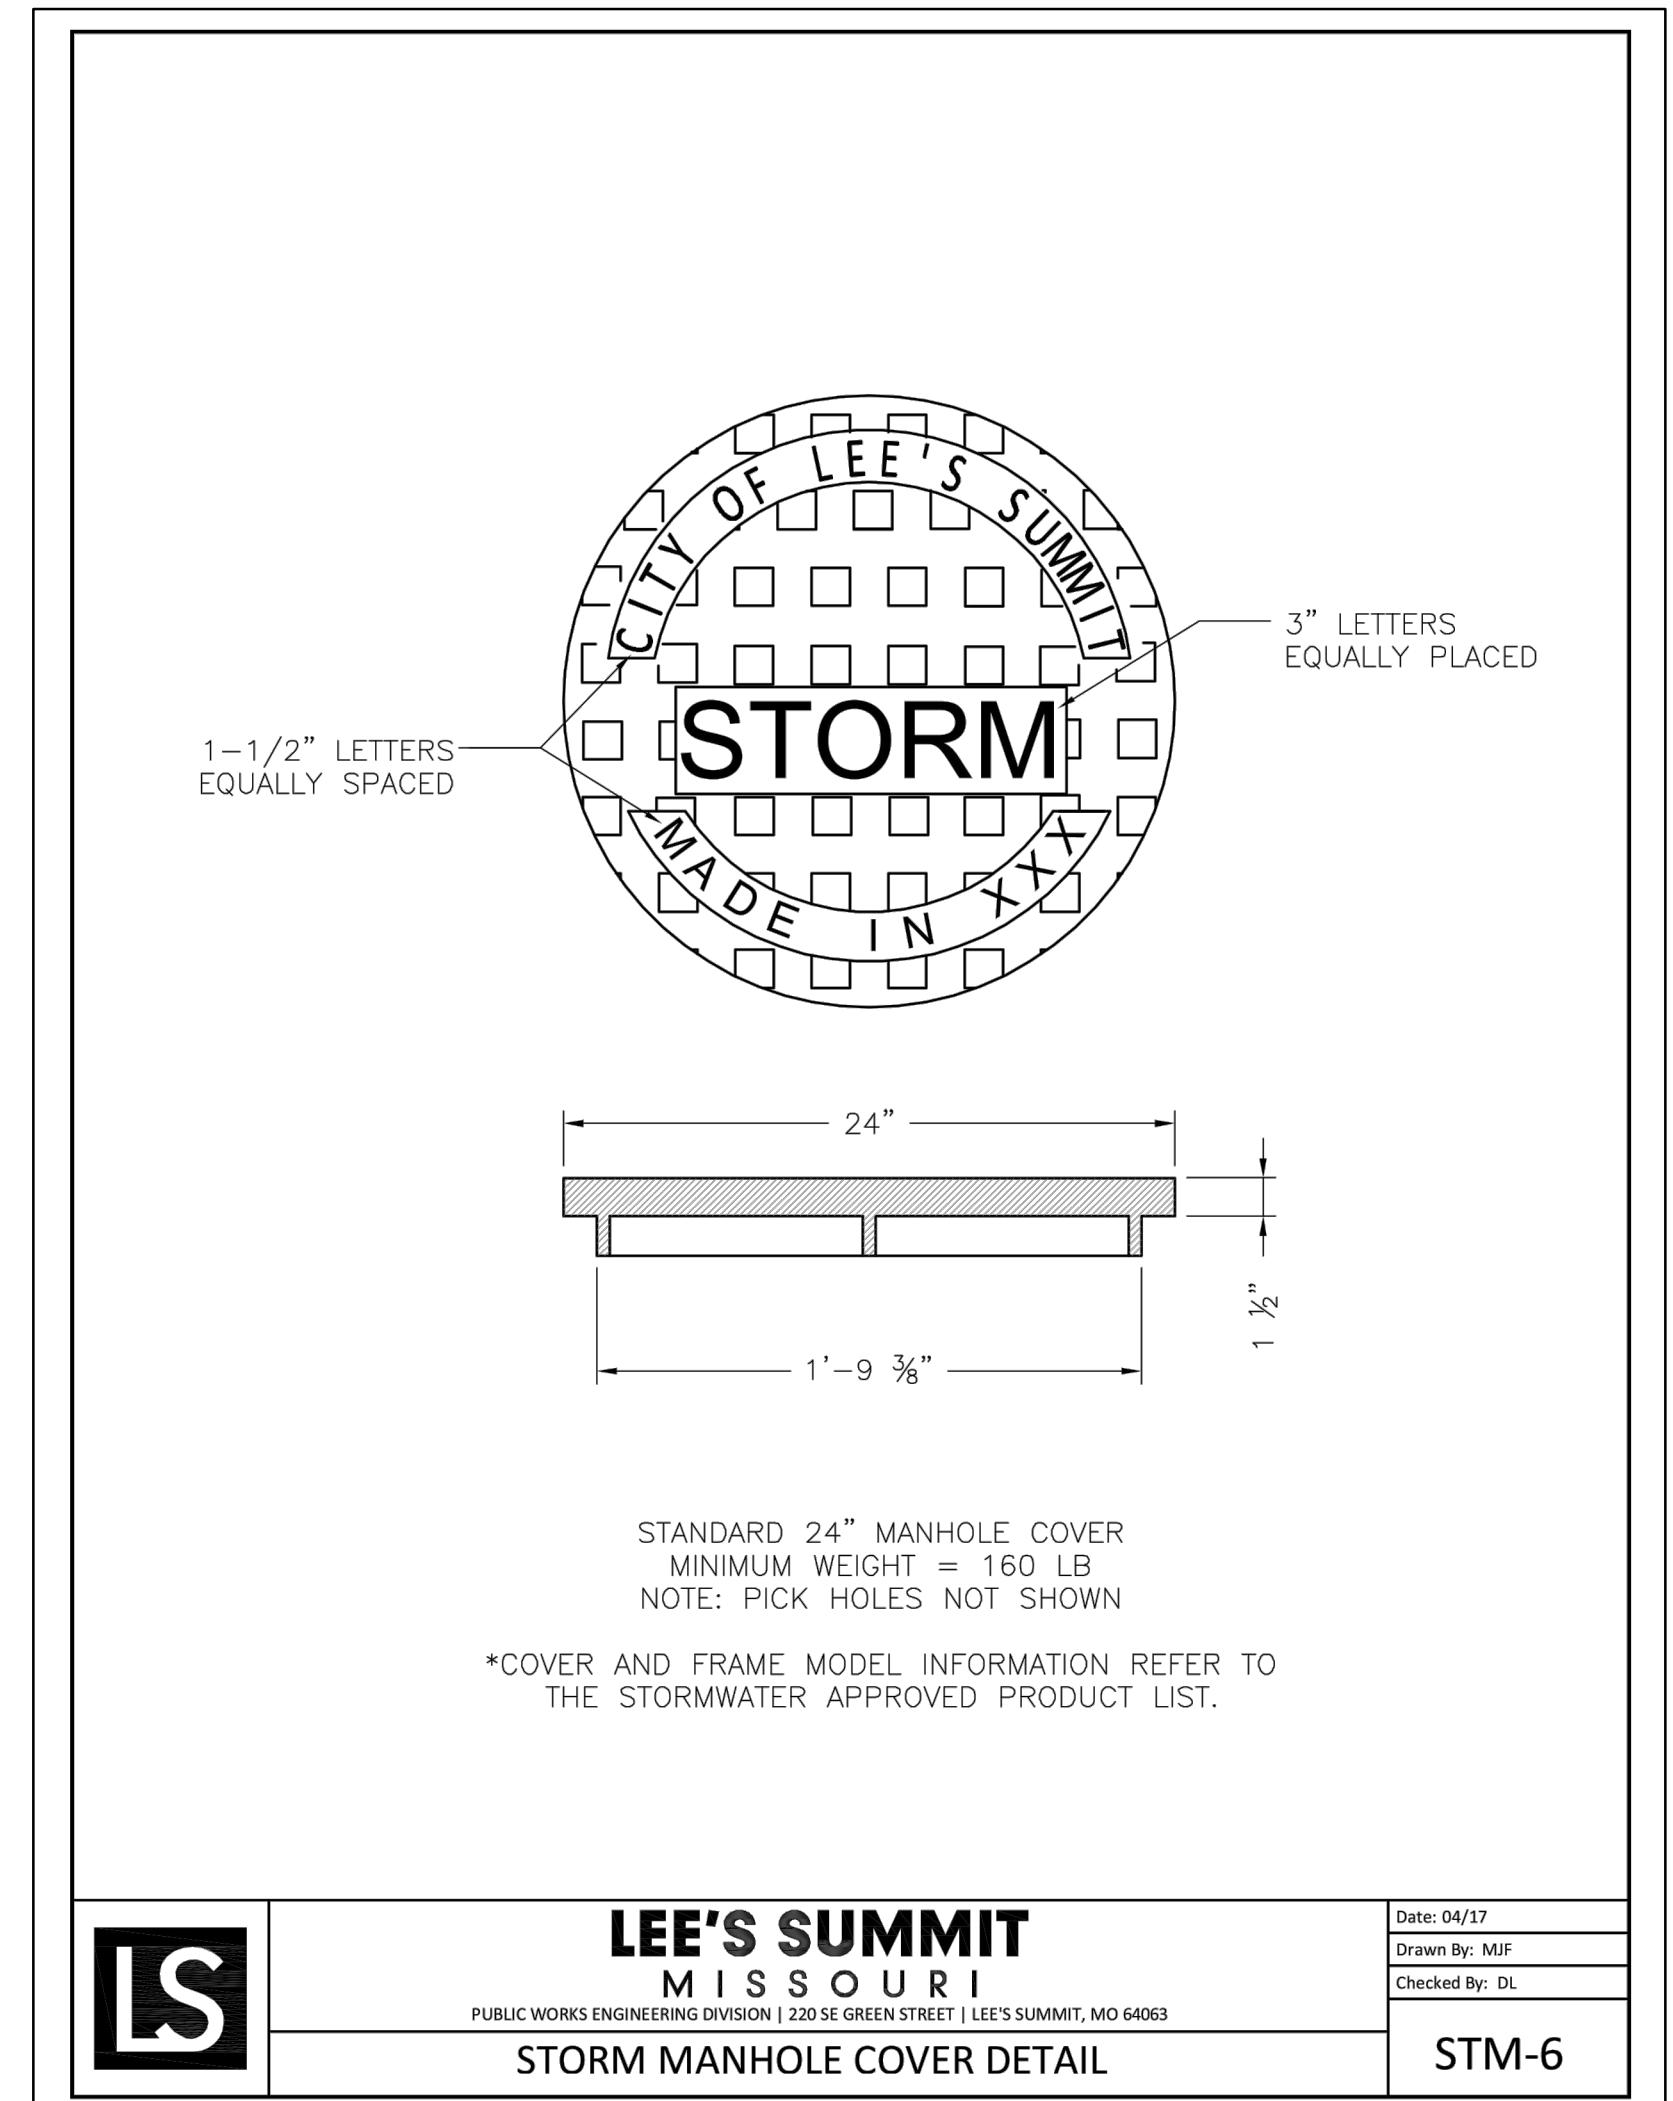
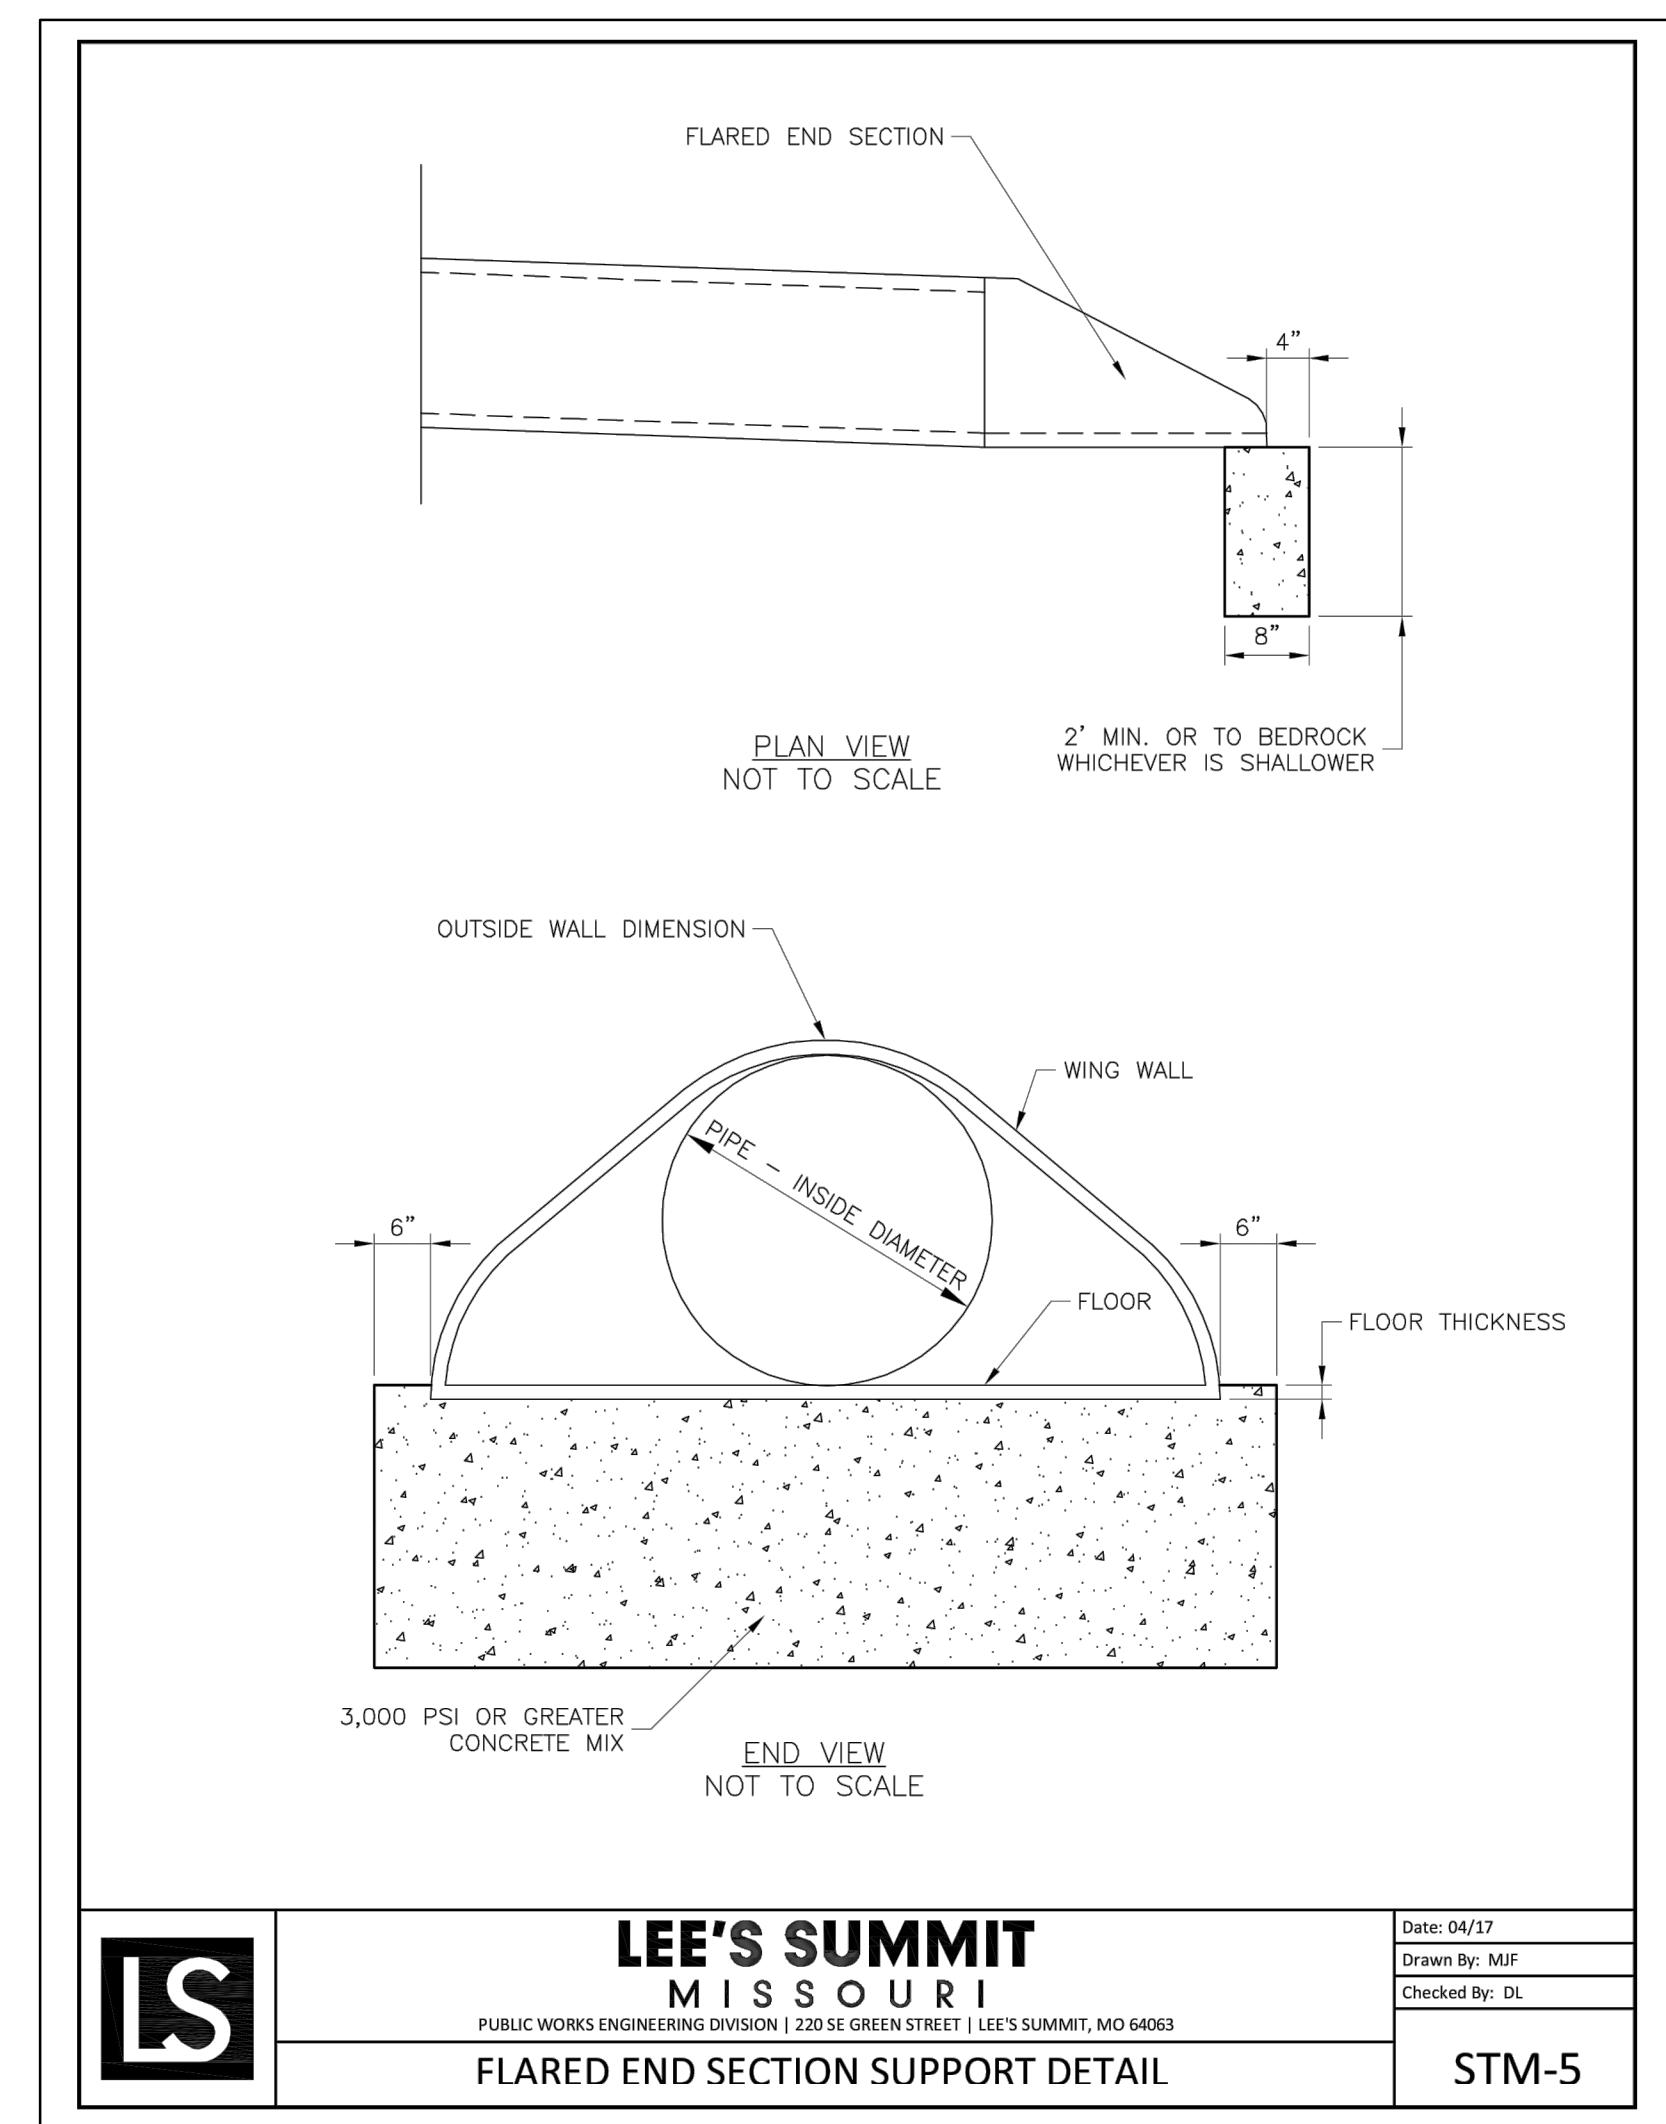
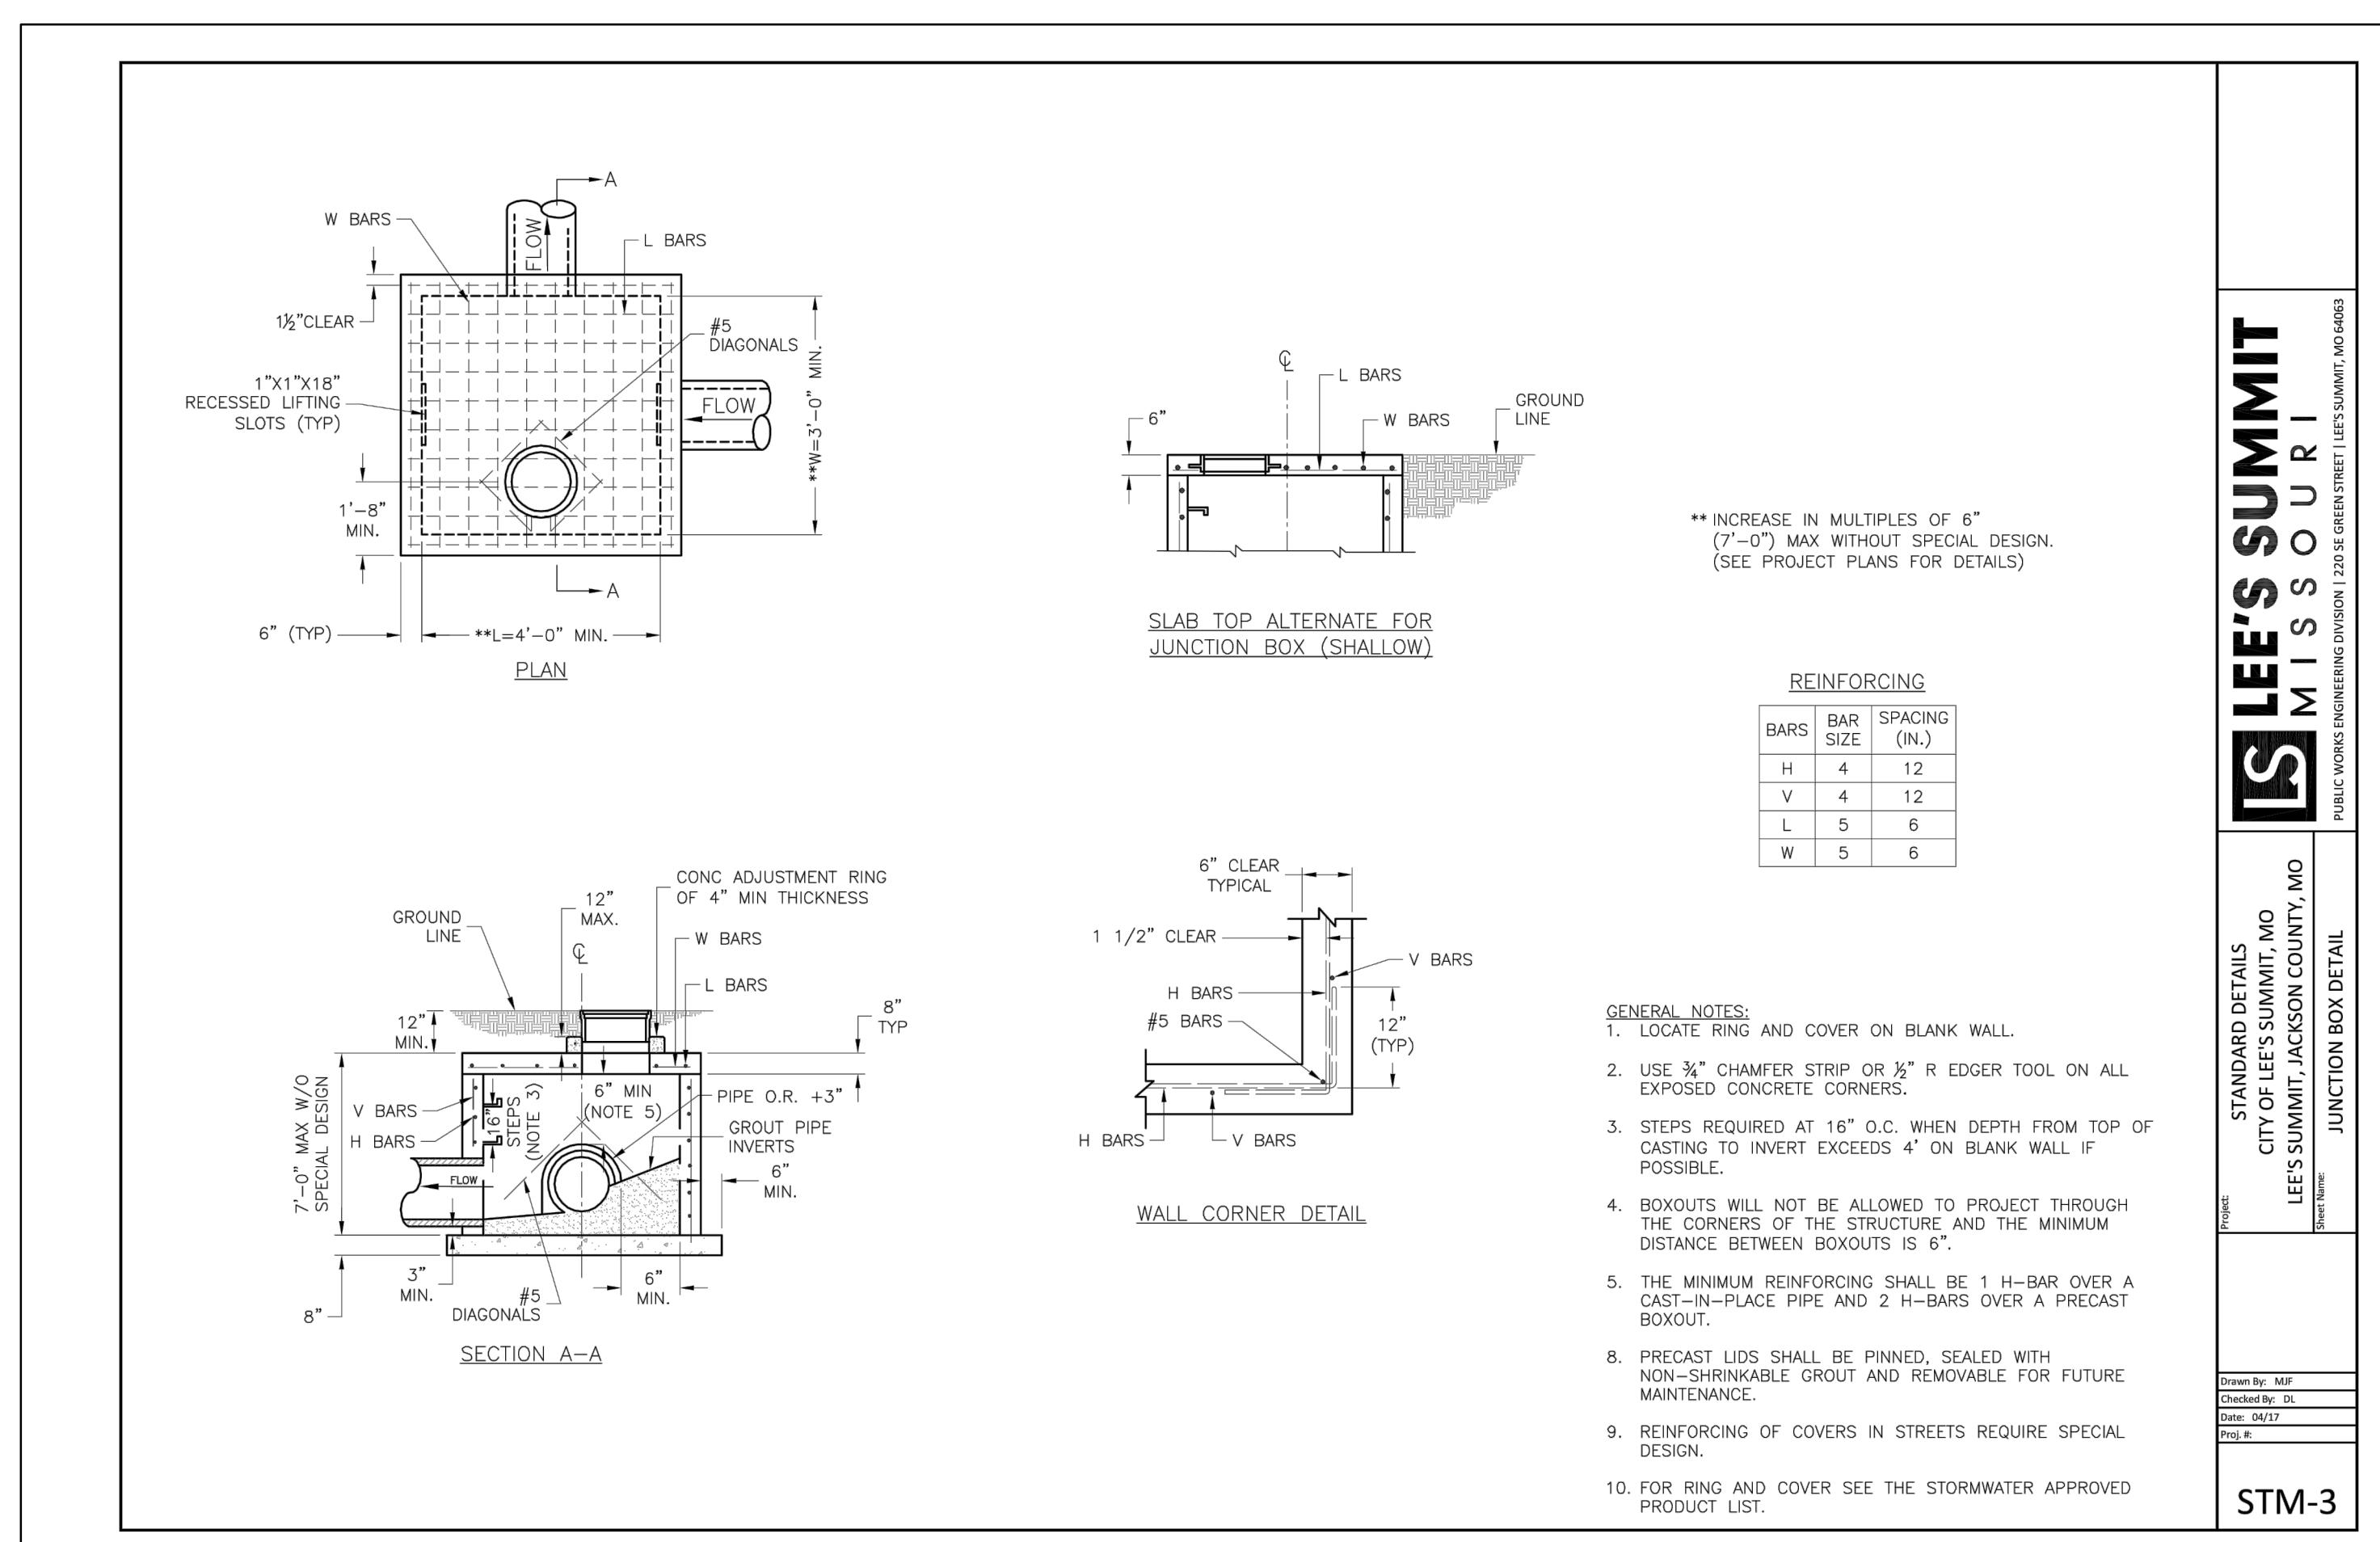
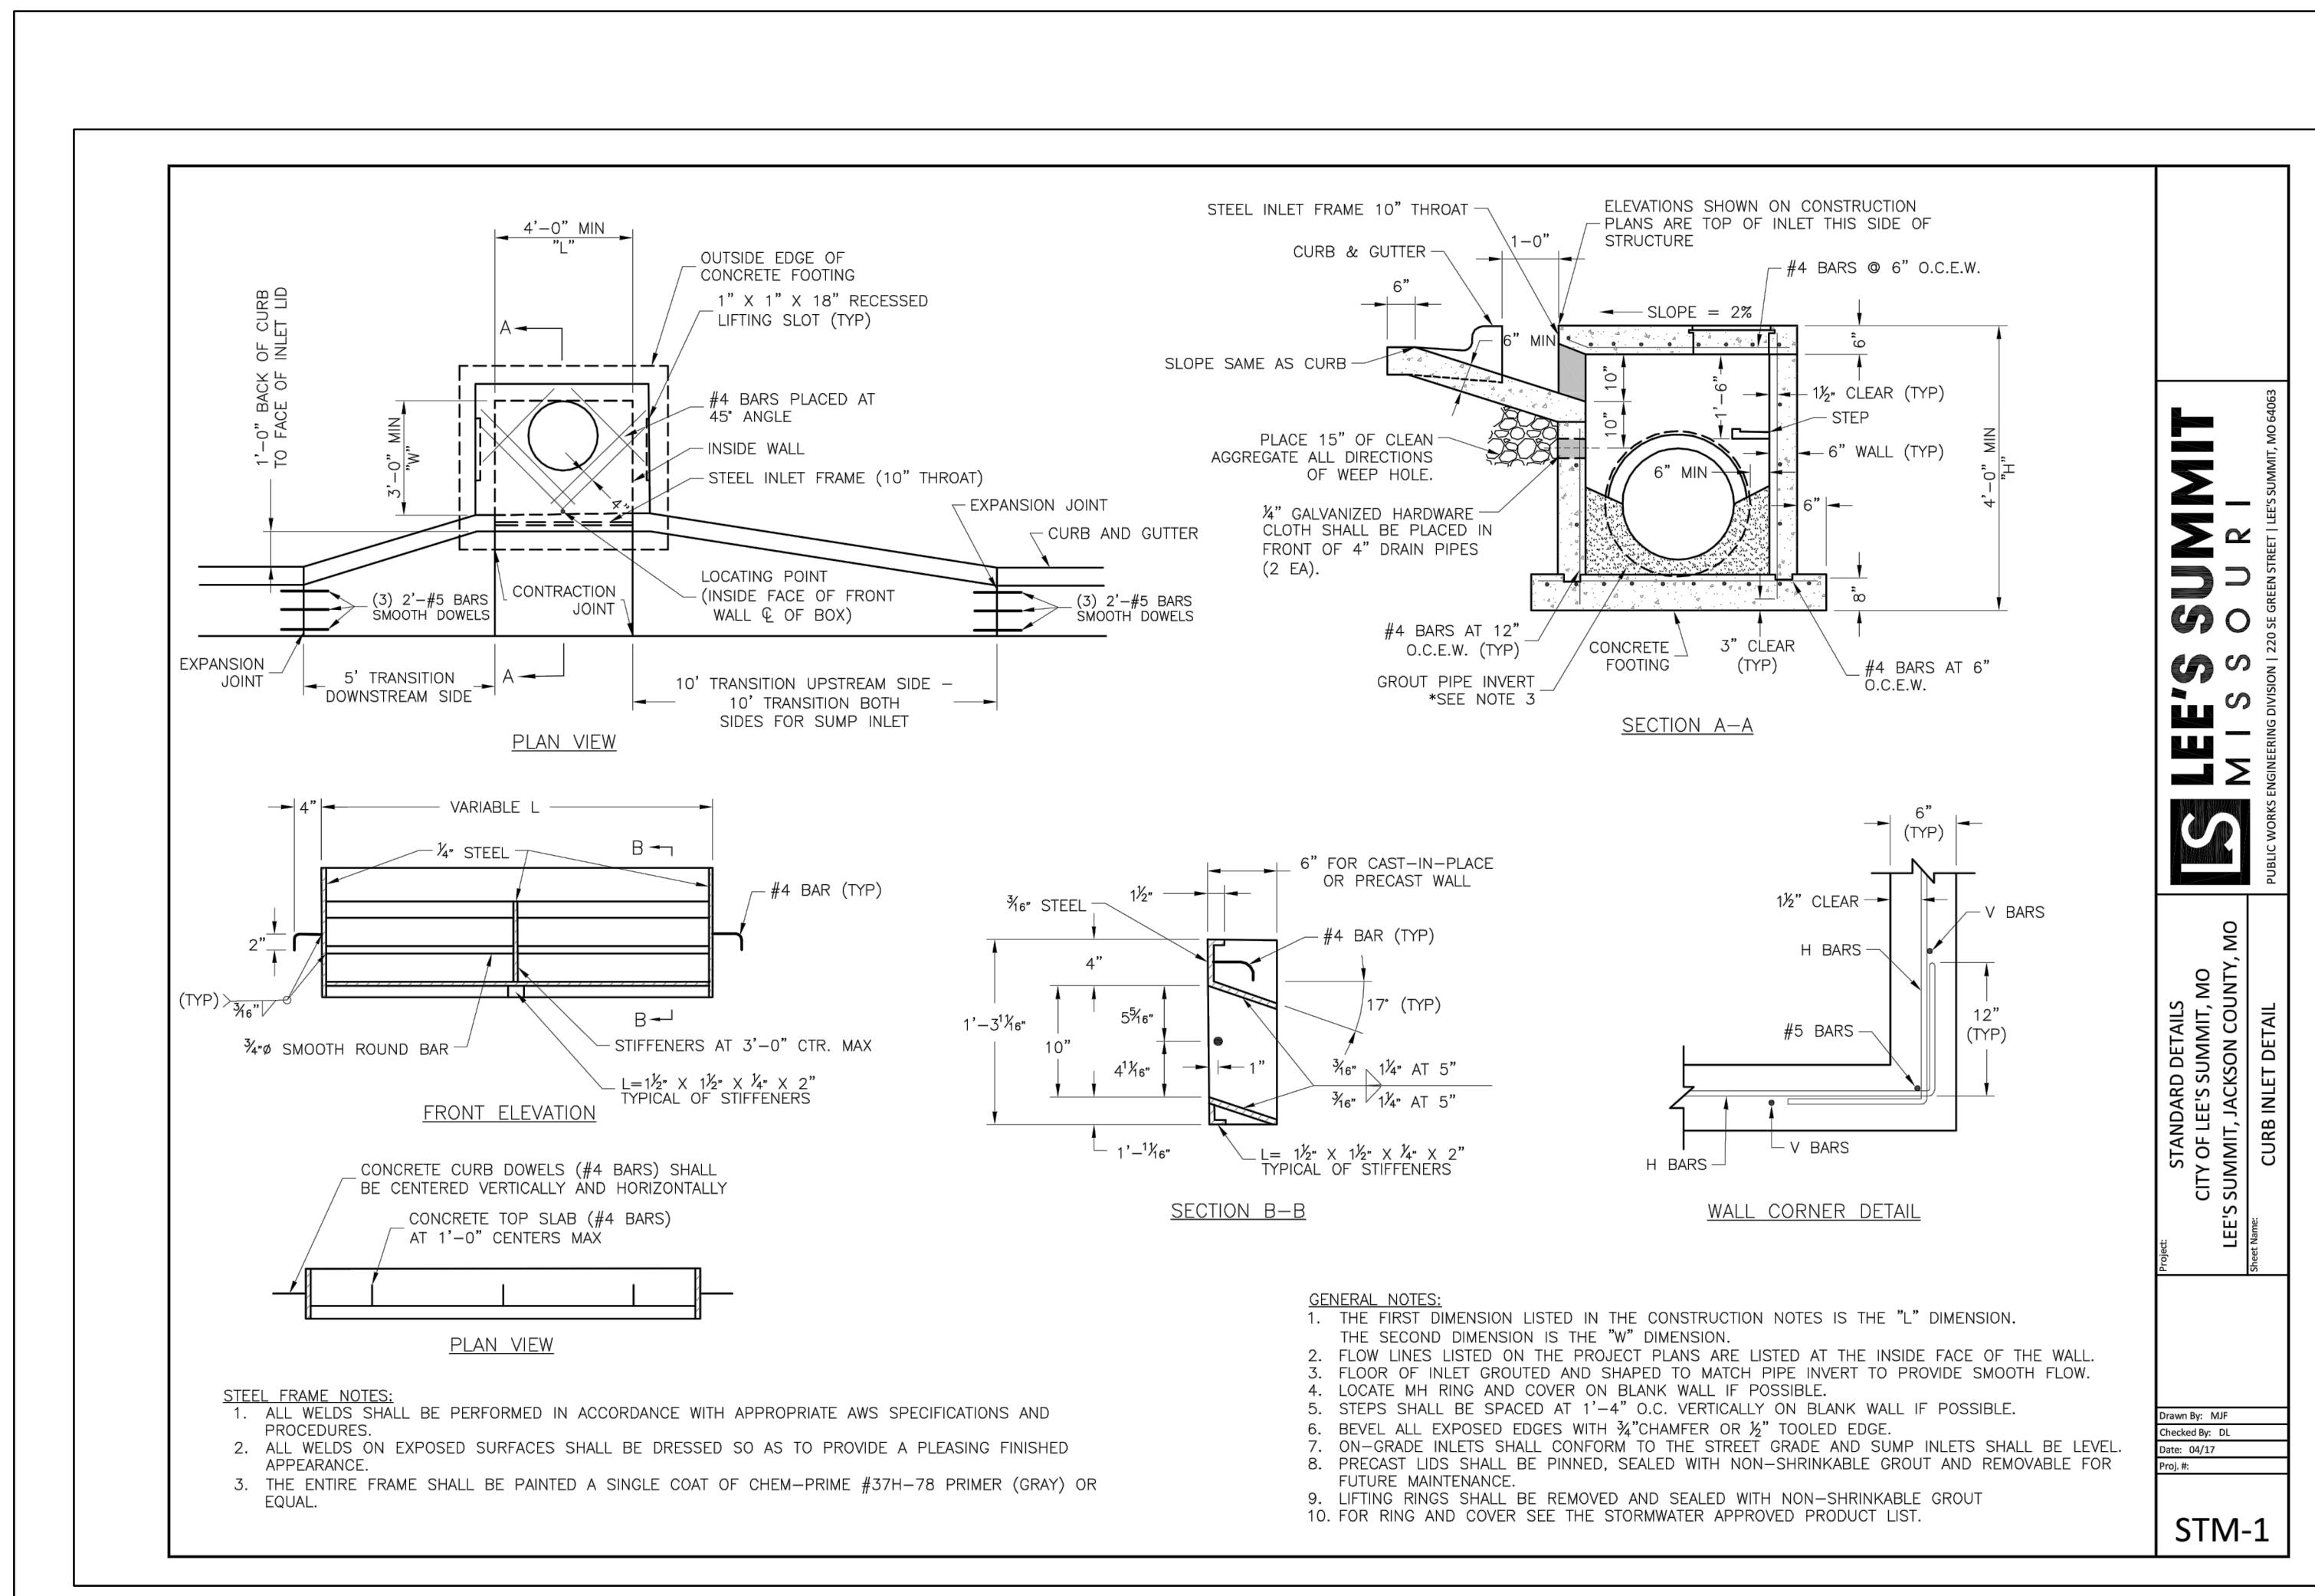
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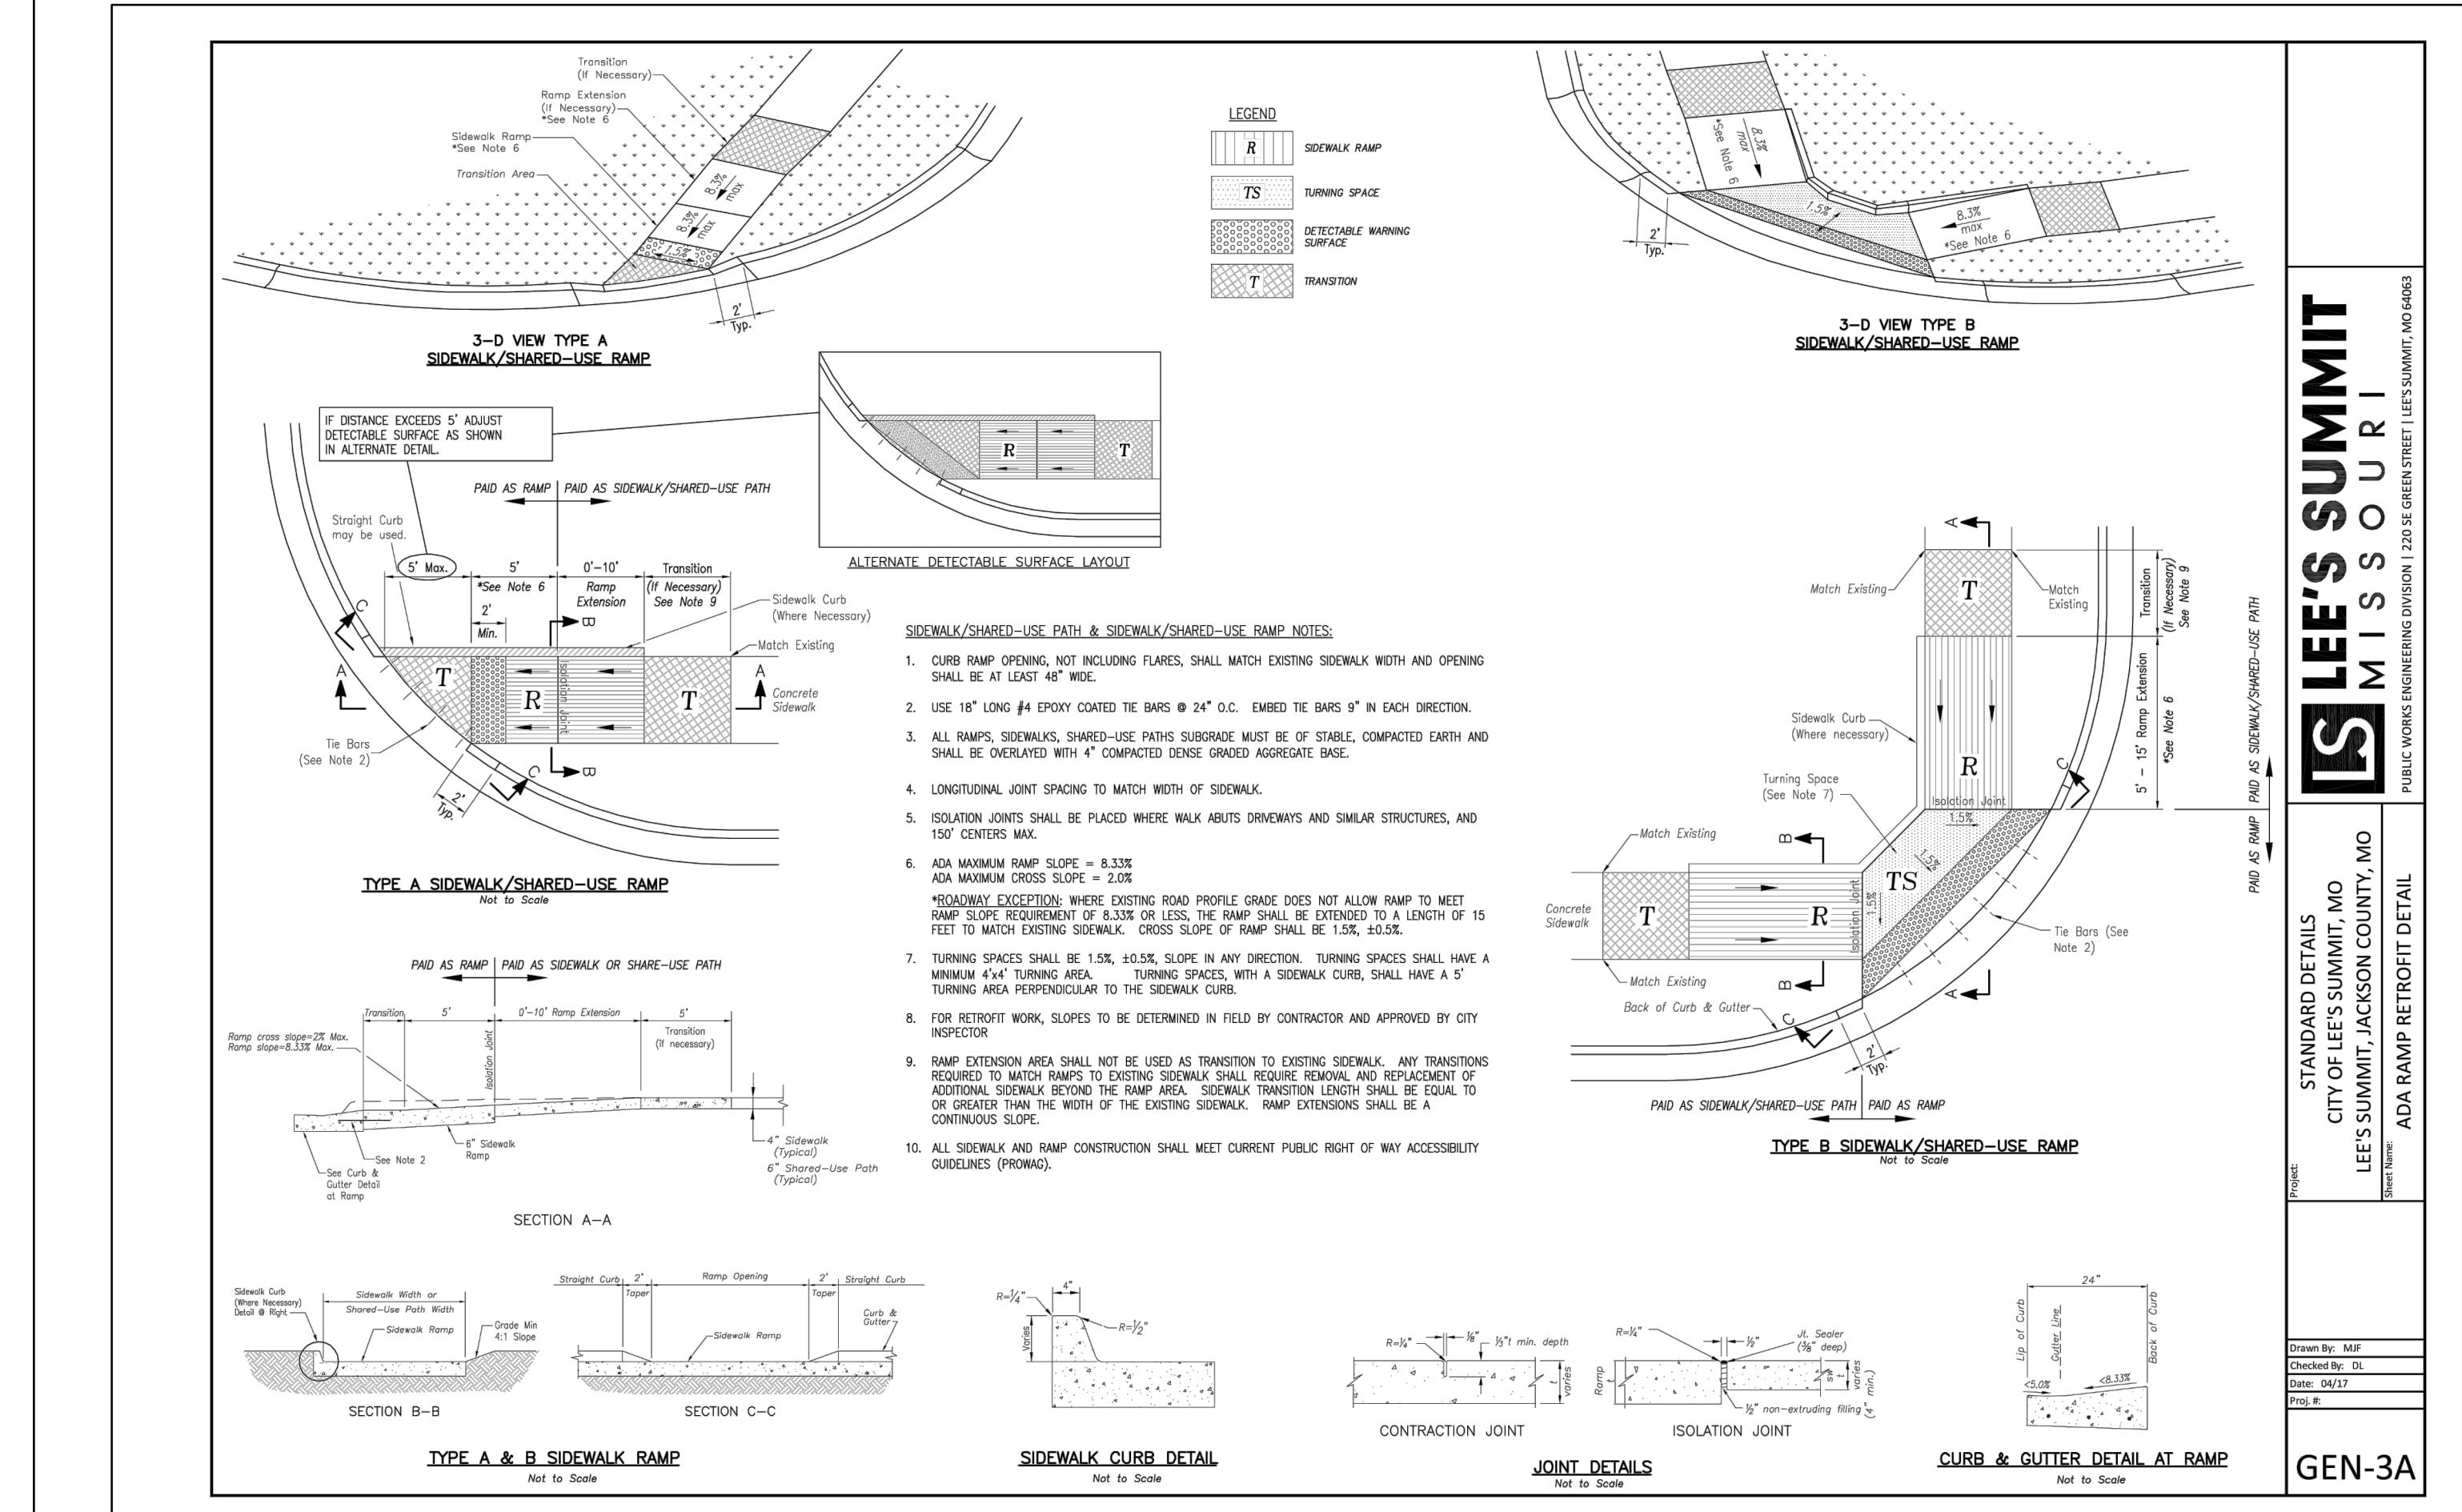
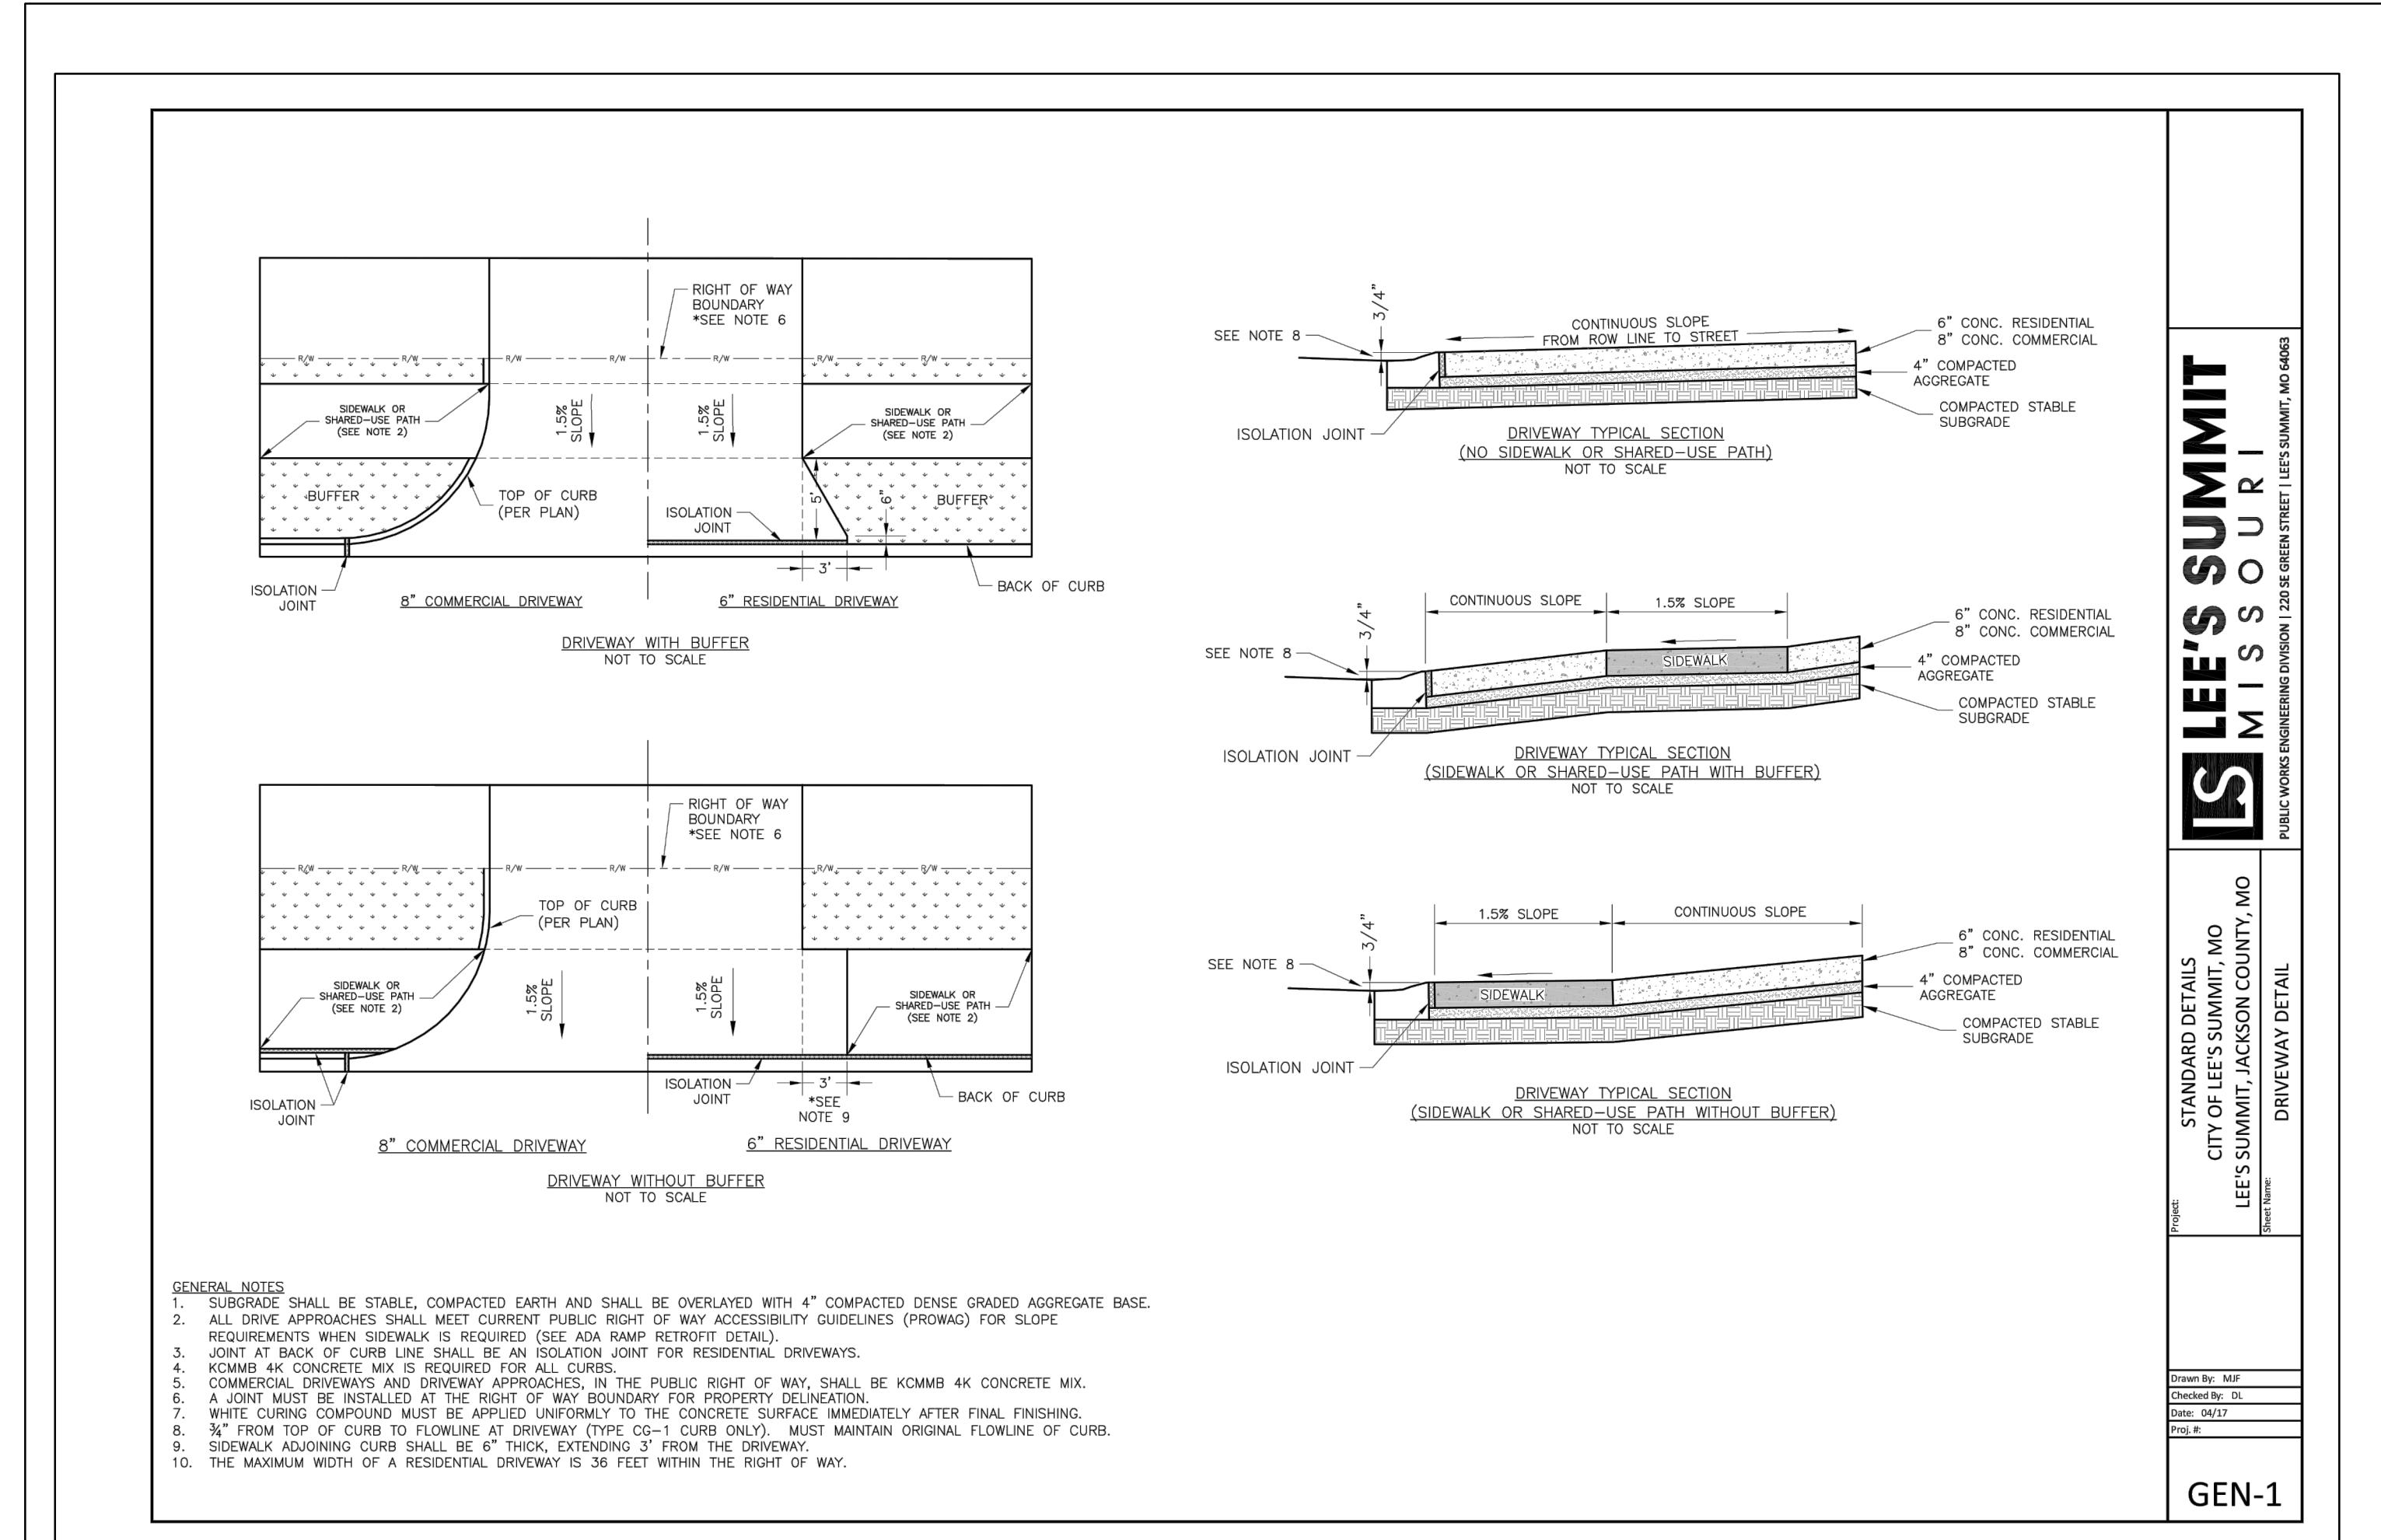
19-02

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OF 28





PERGOLA PARK 4TH PLAT
STREET, STORMWATER, MASTER DRAINAGE
PLAN AND EROSION AND SEDIMENT
- LEE'S SUMMIT, MISSOURI

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PERGOLA PARK 4TH PLAT STREET, STORMWATER, MASTER DRAINAGE PLAN AND EROSION AND SEDIMENT - LEE'S SUMMIT, MISSOURI

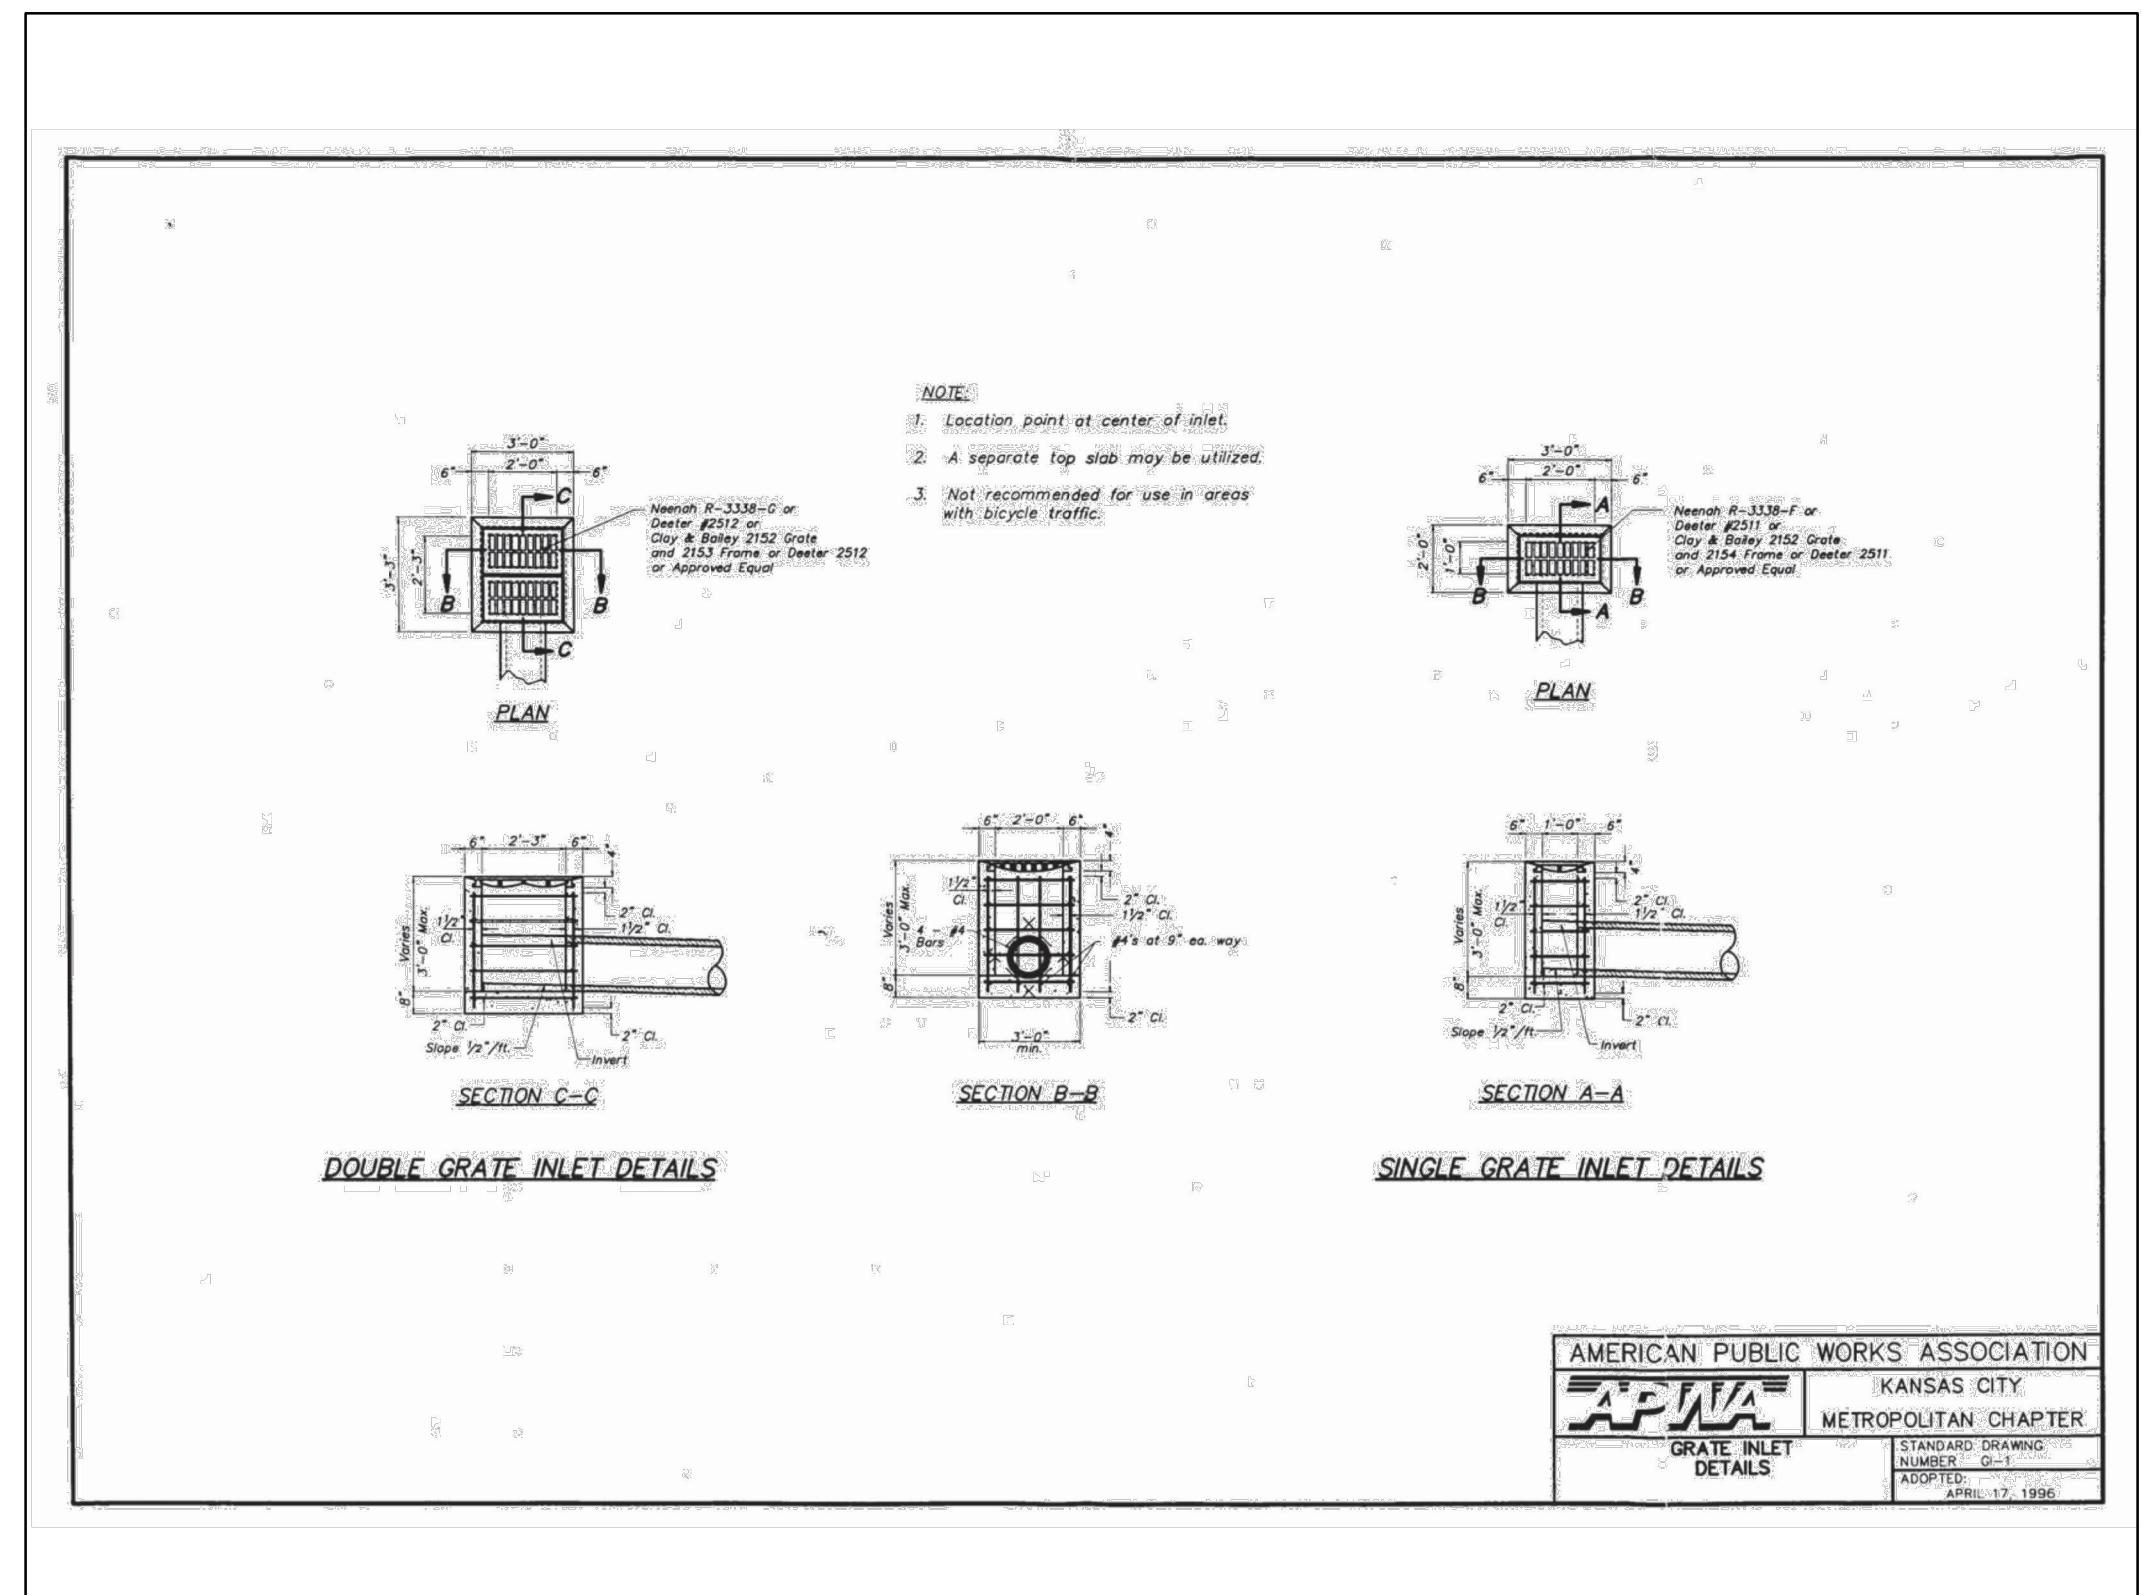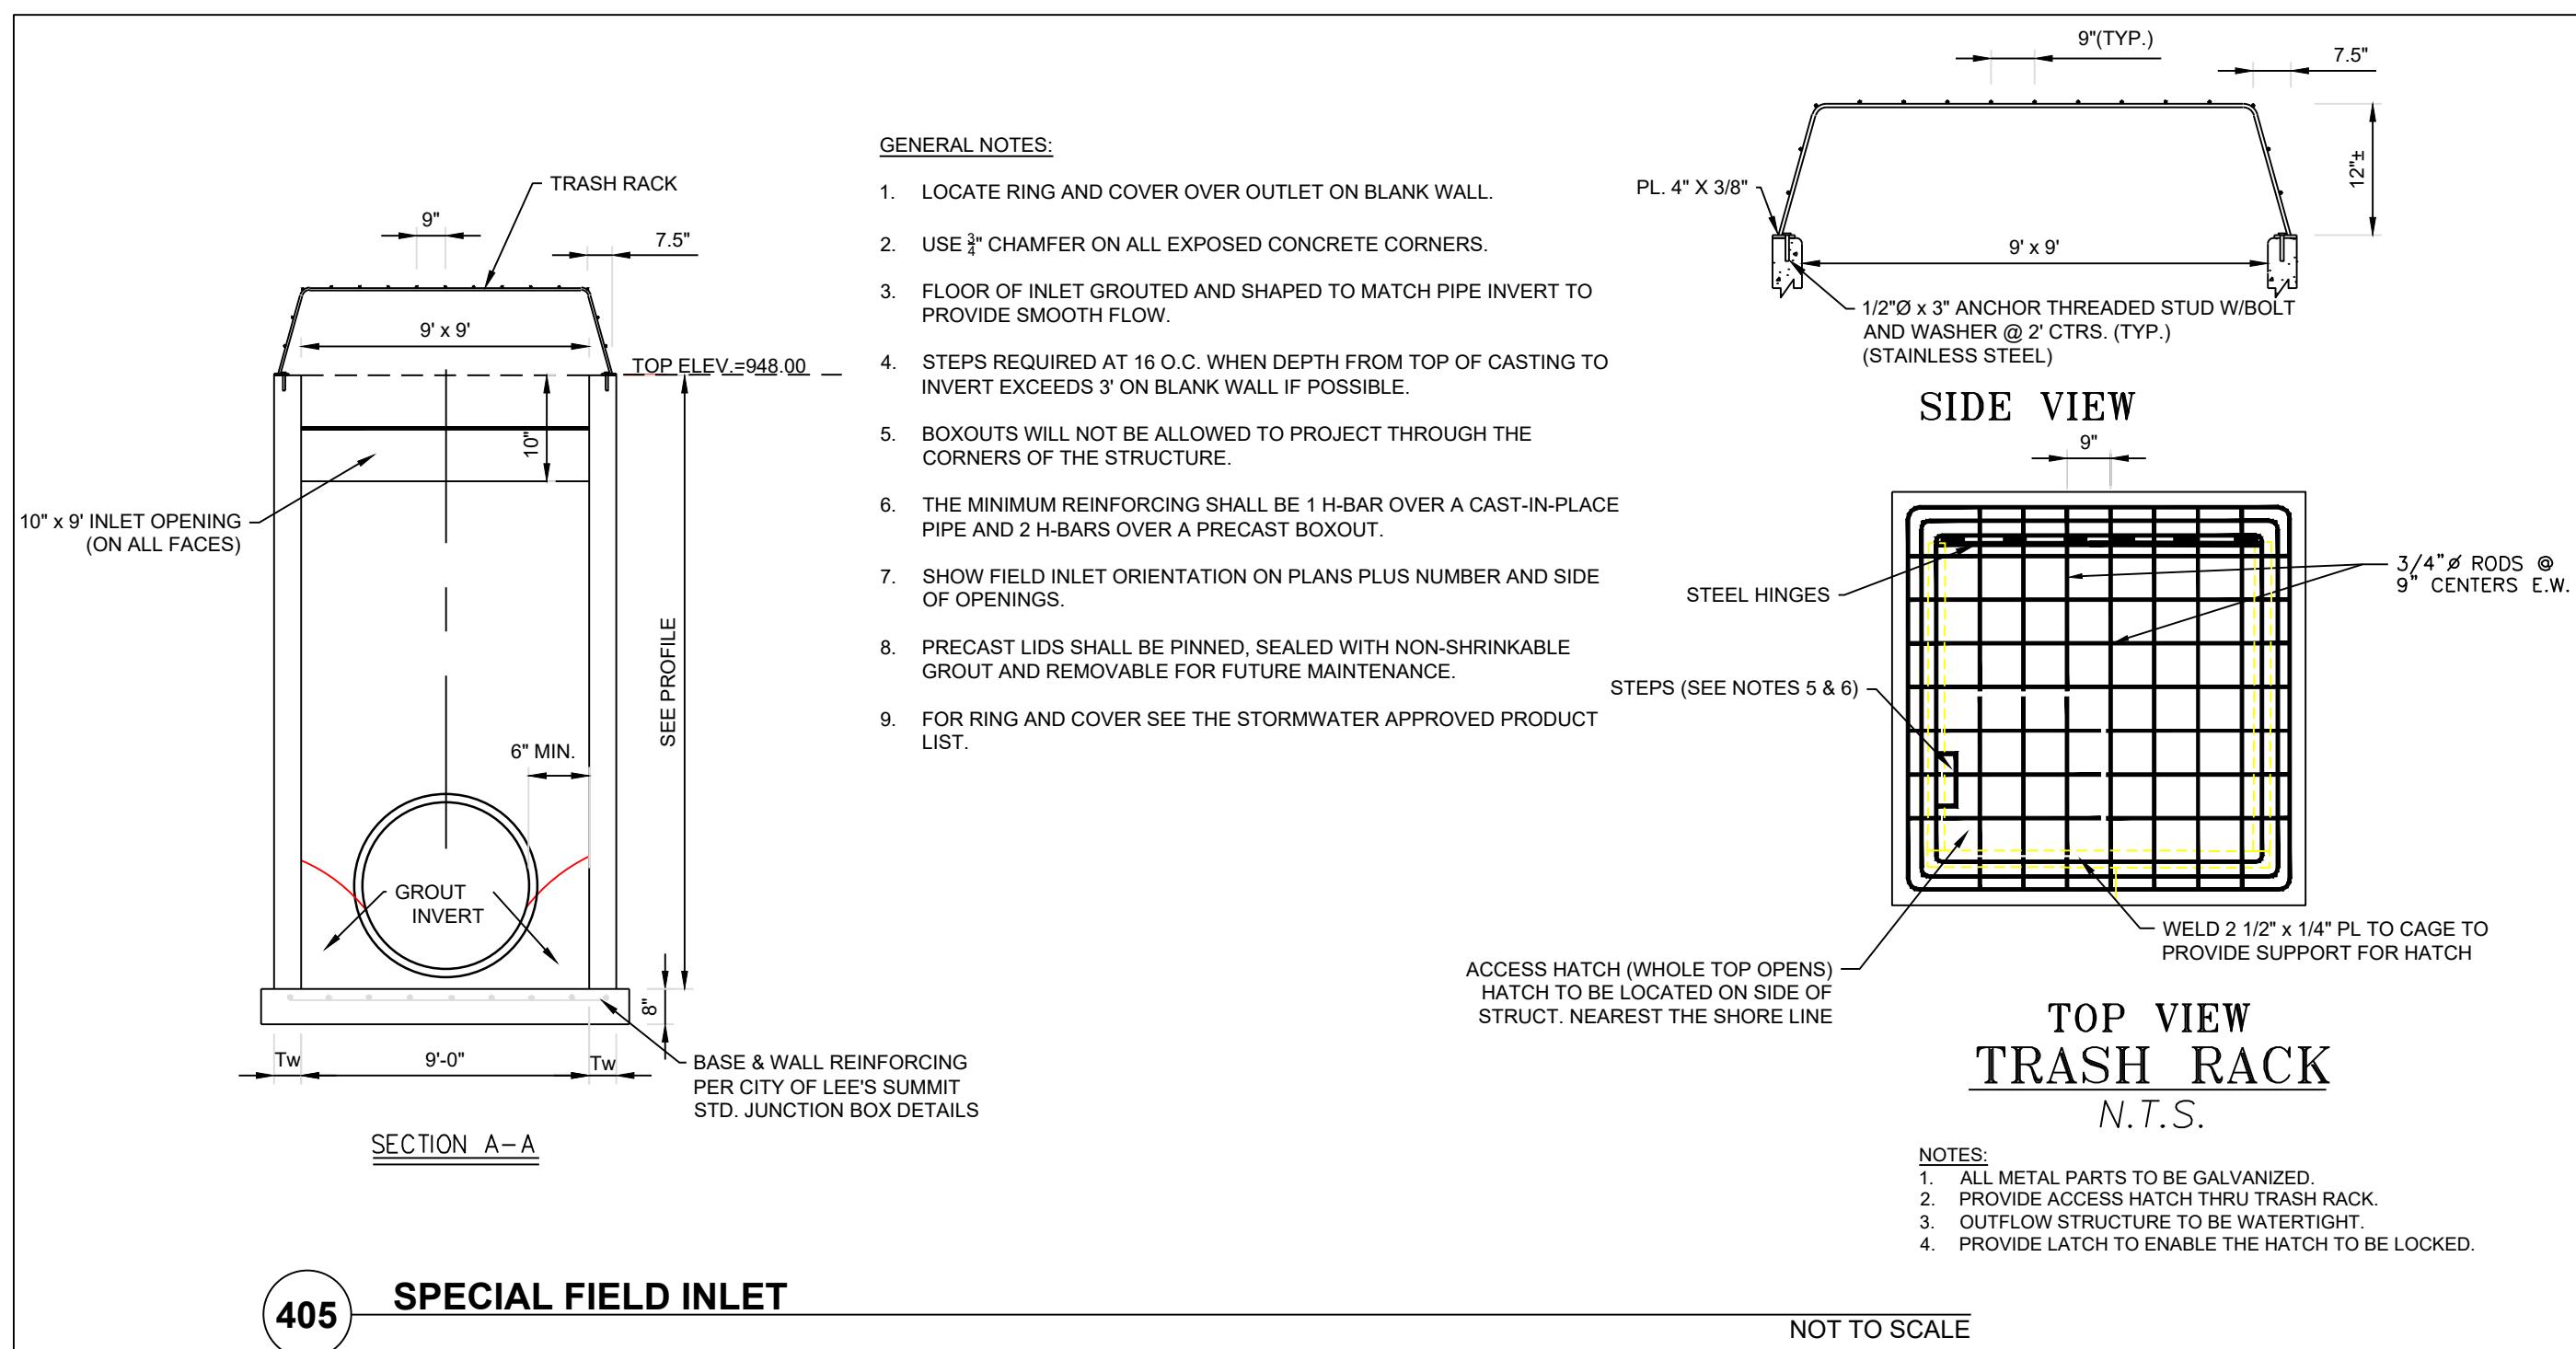
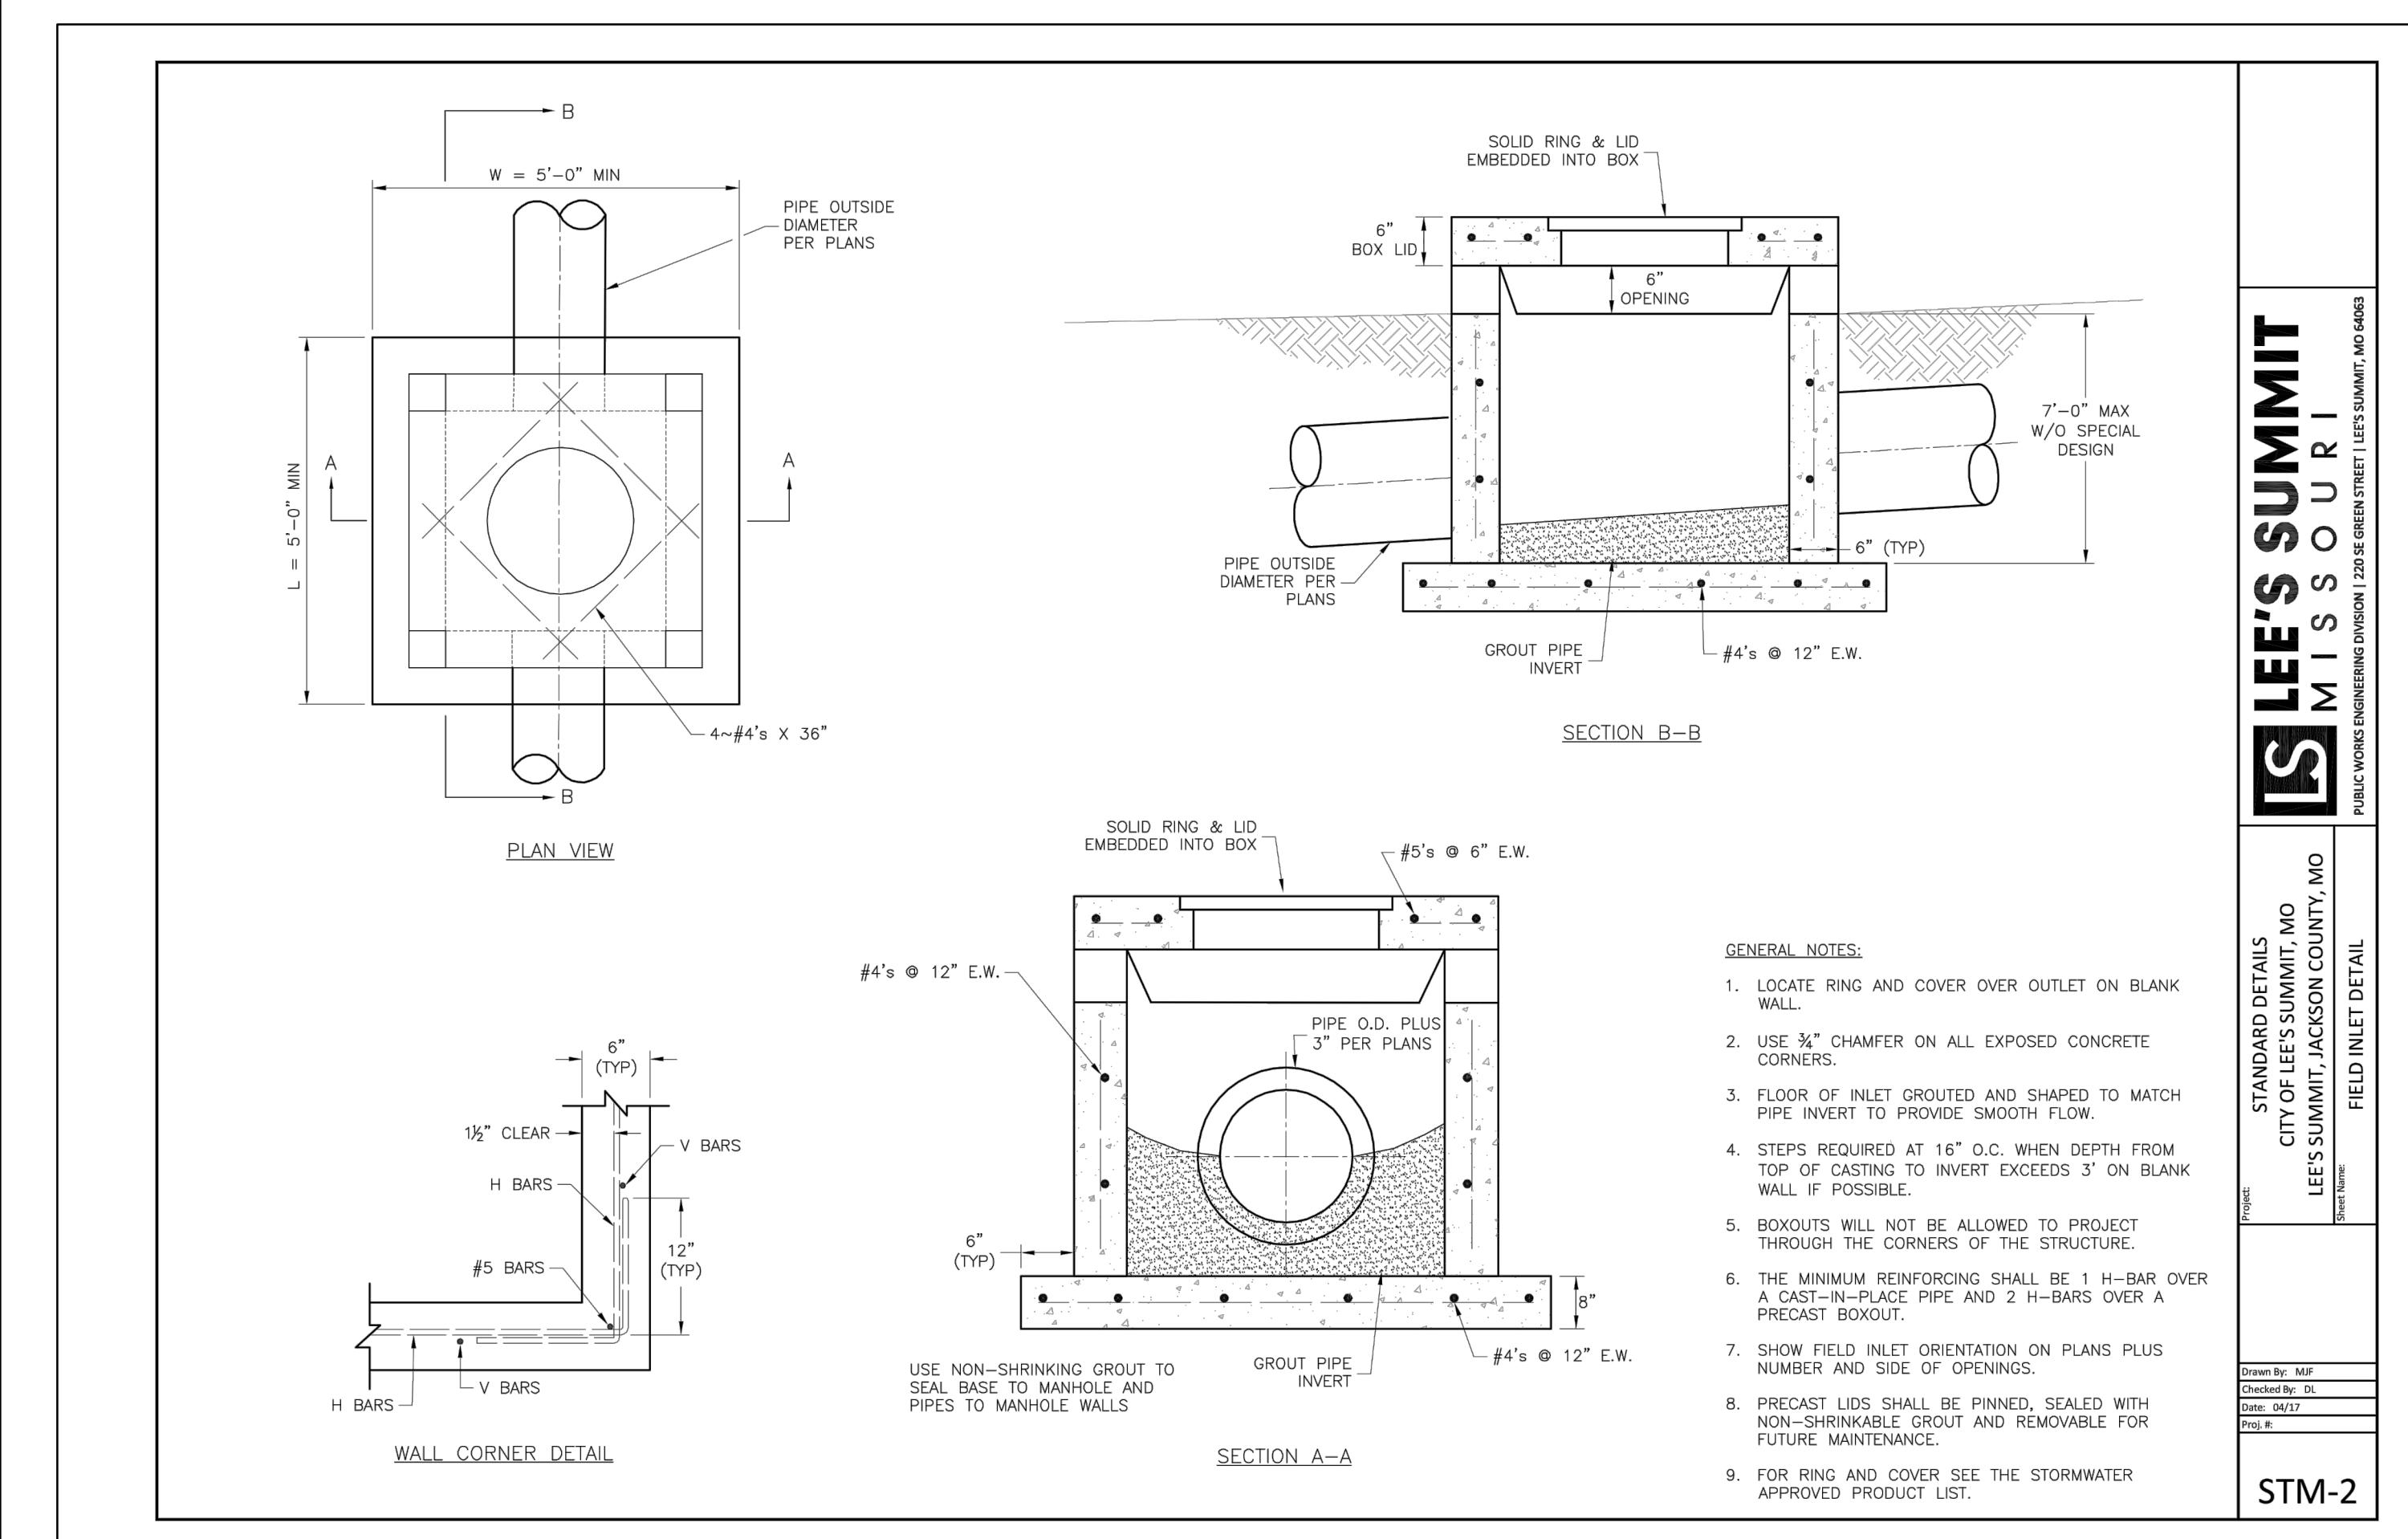
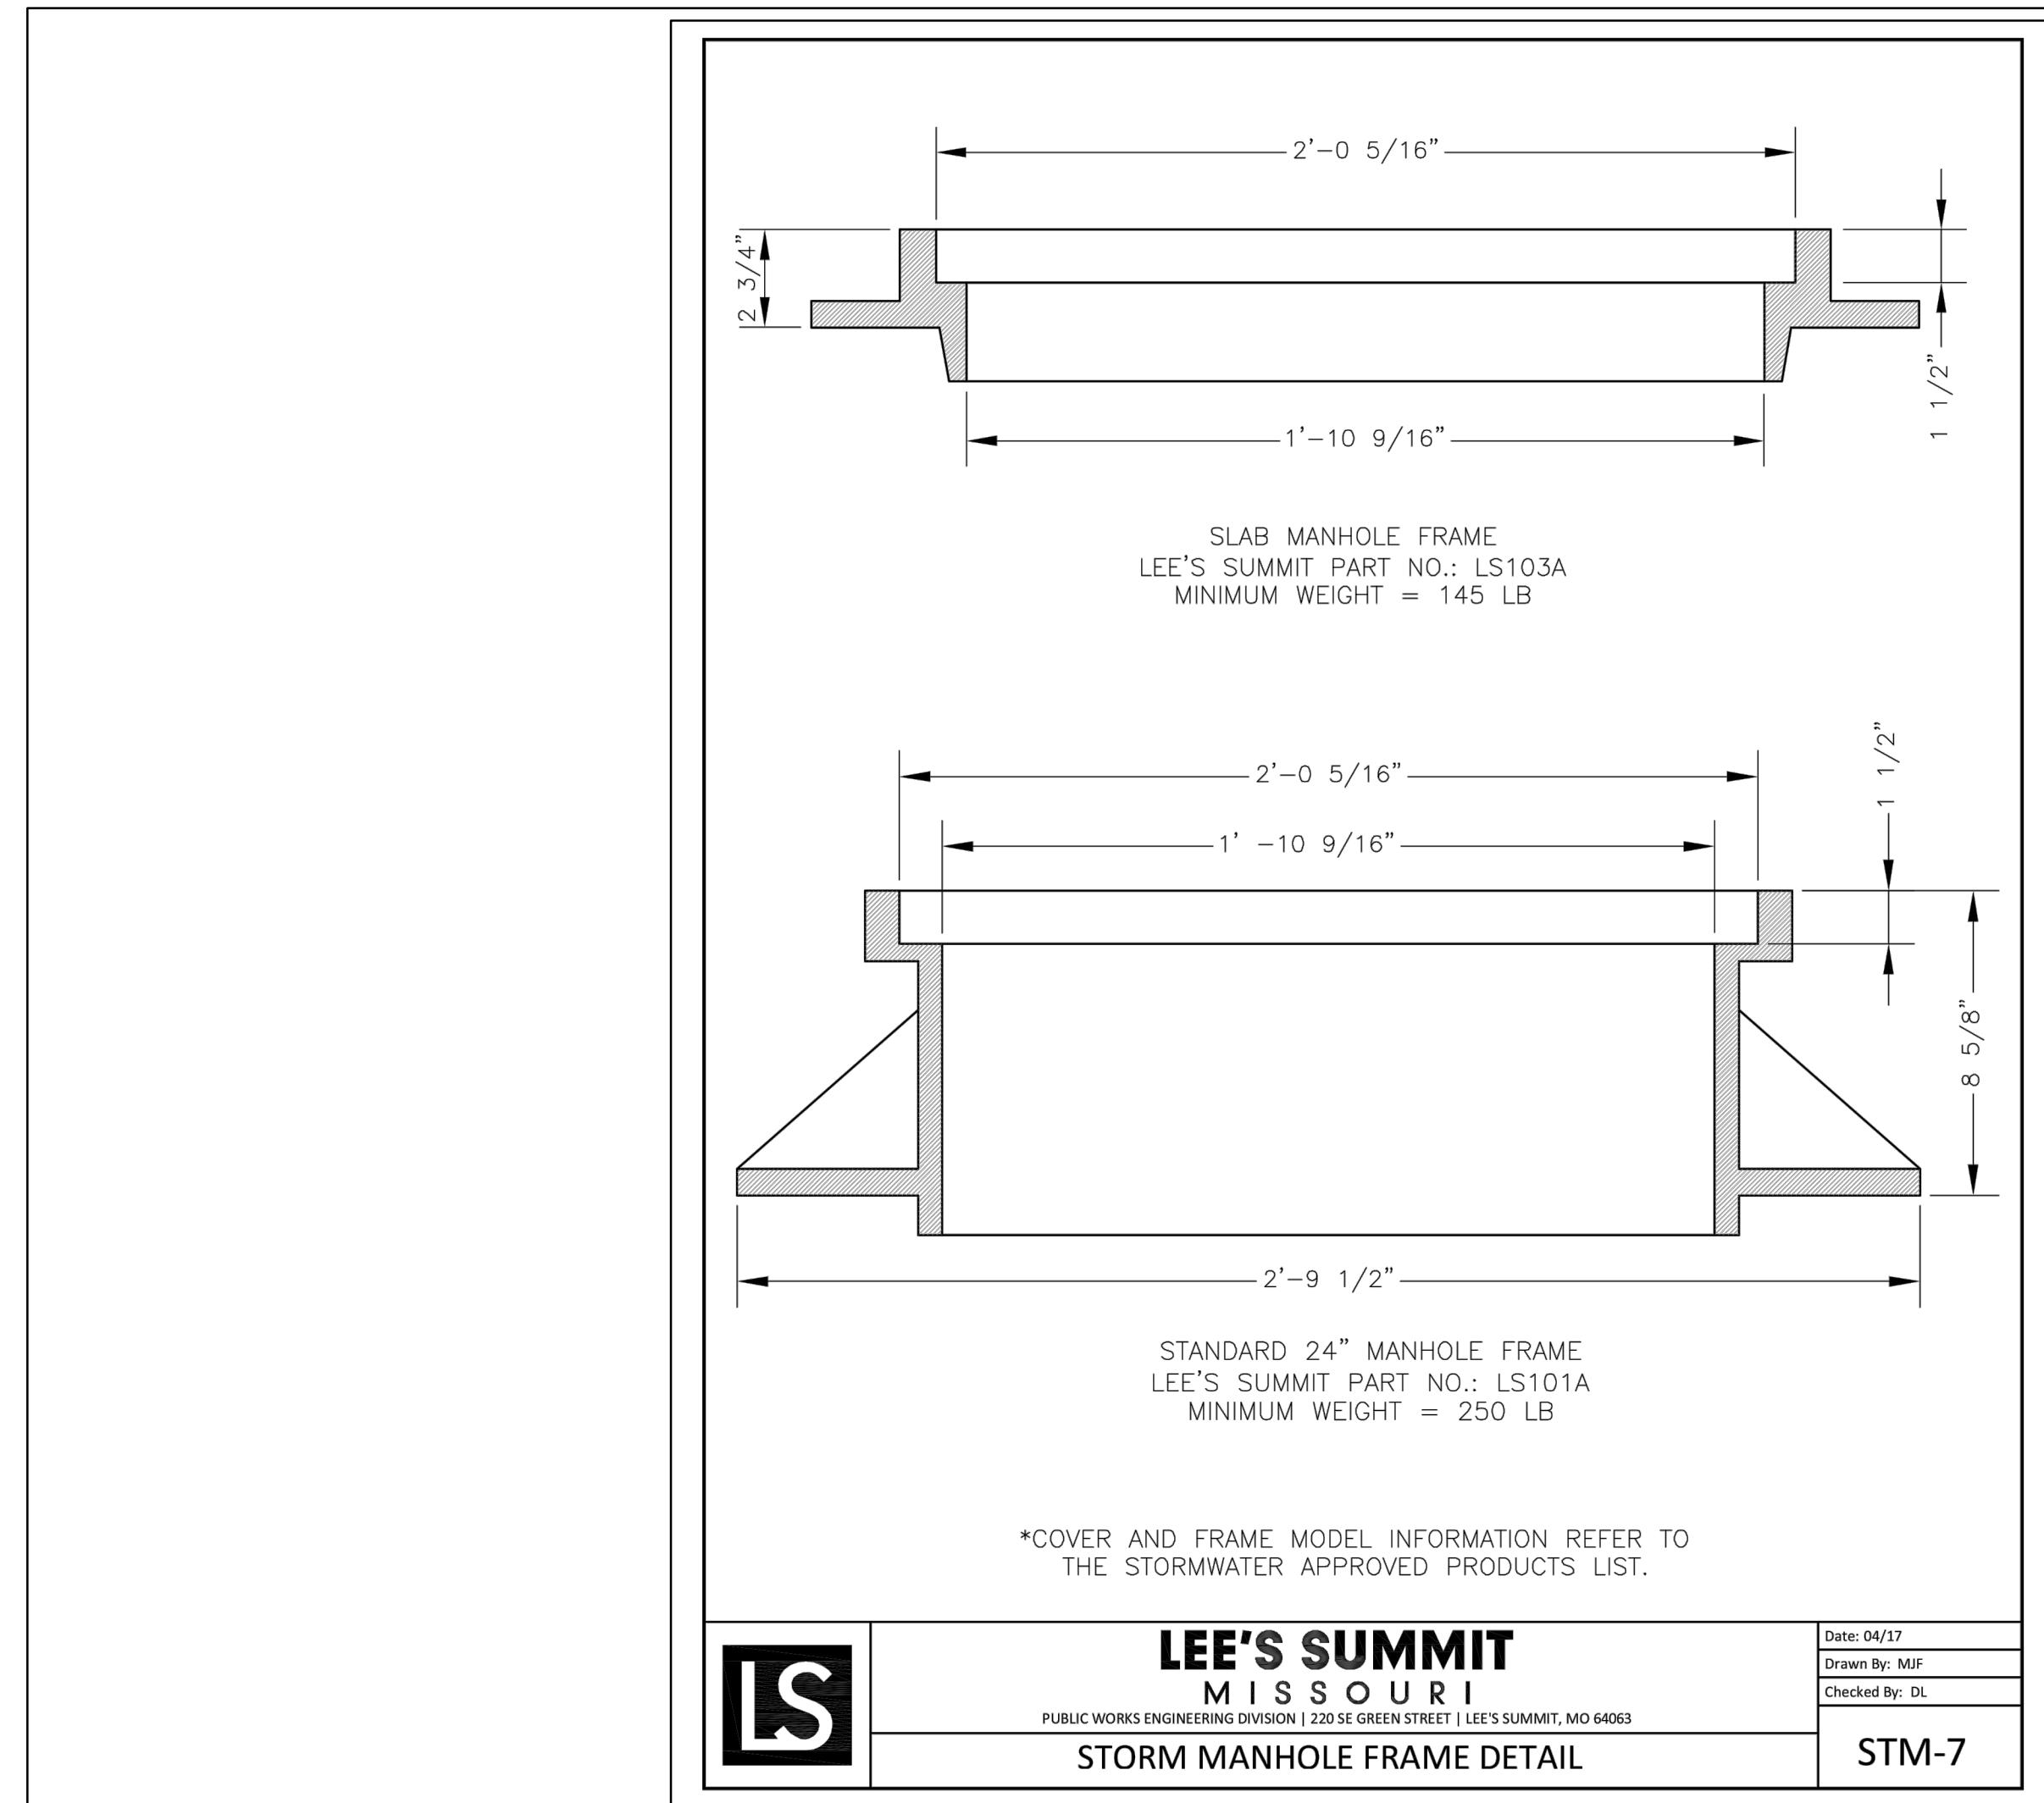


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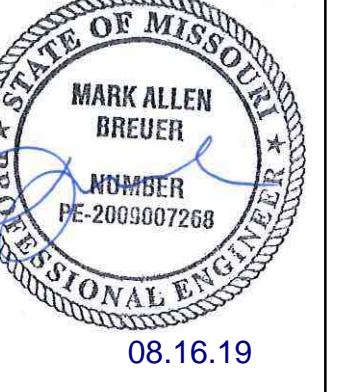

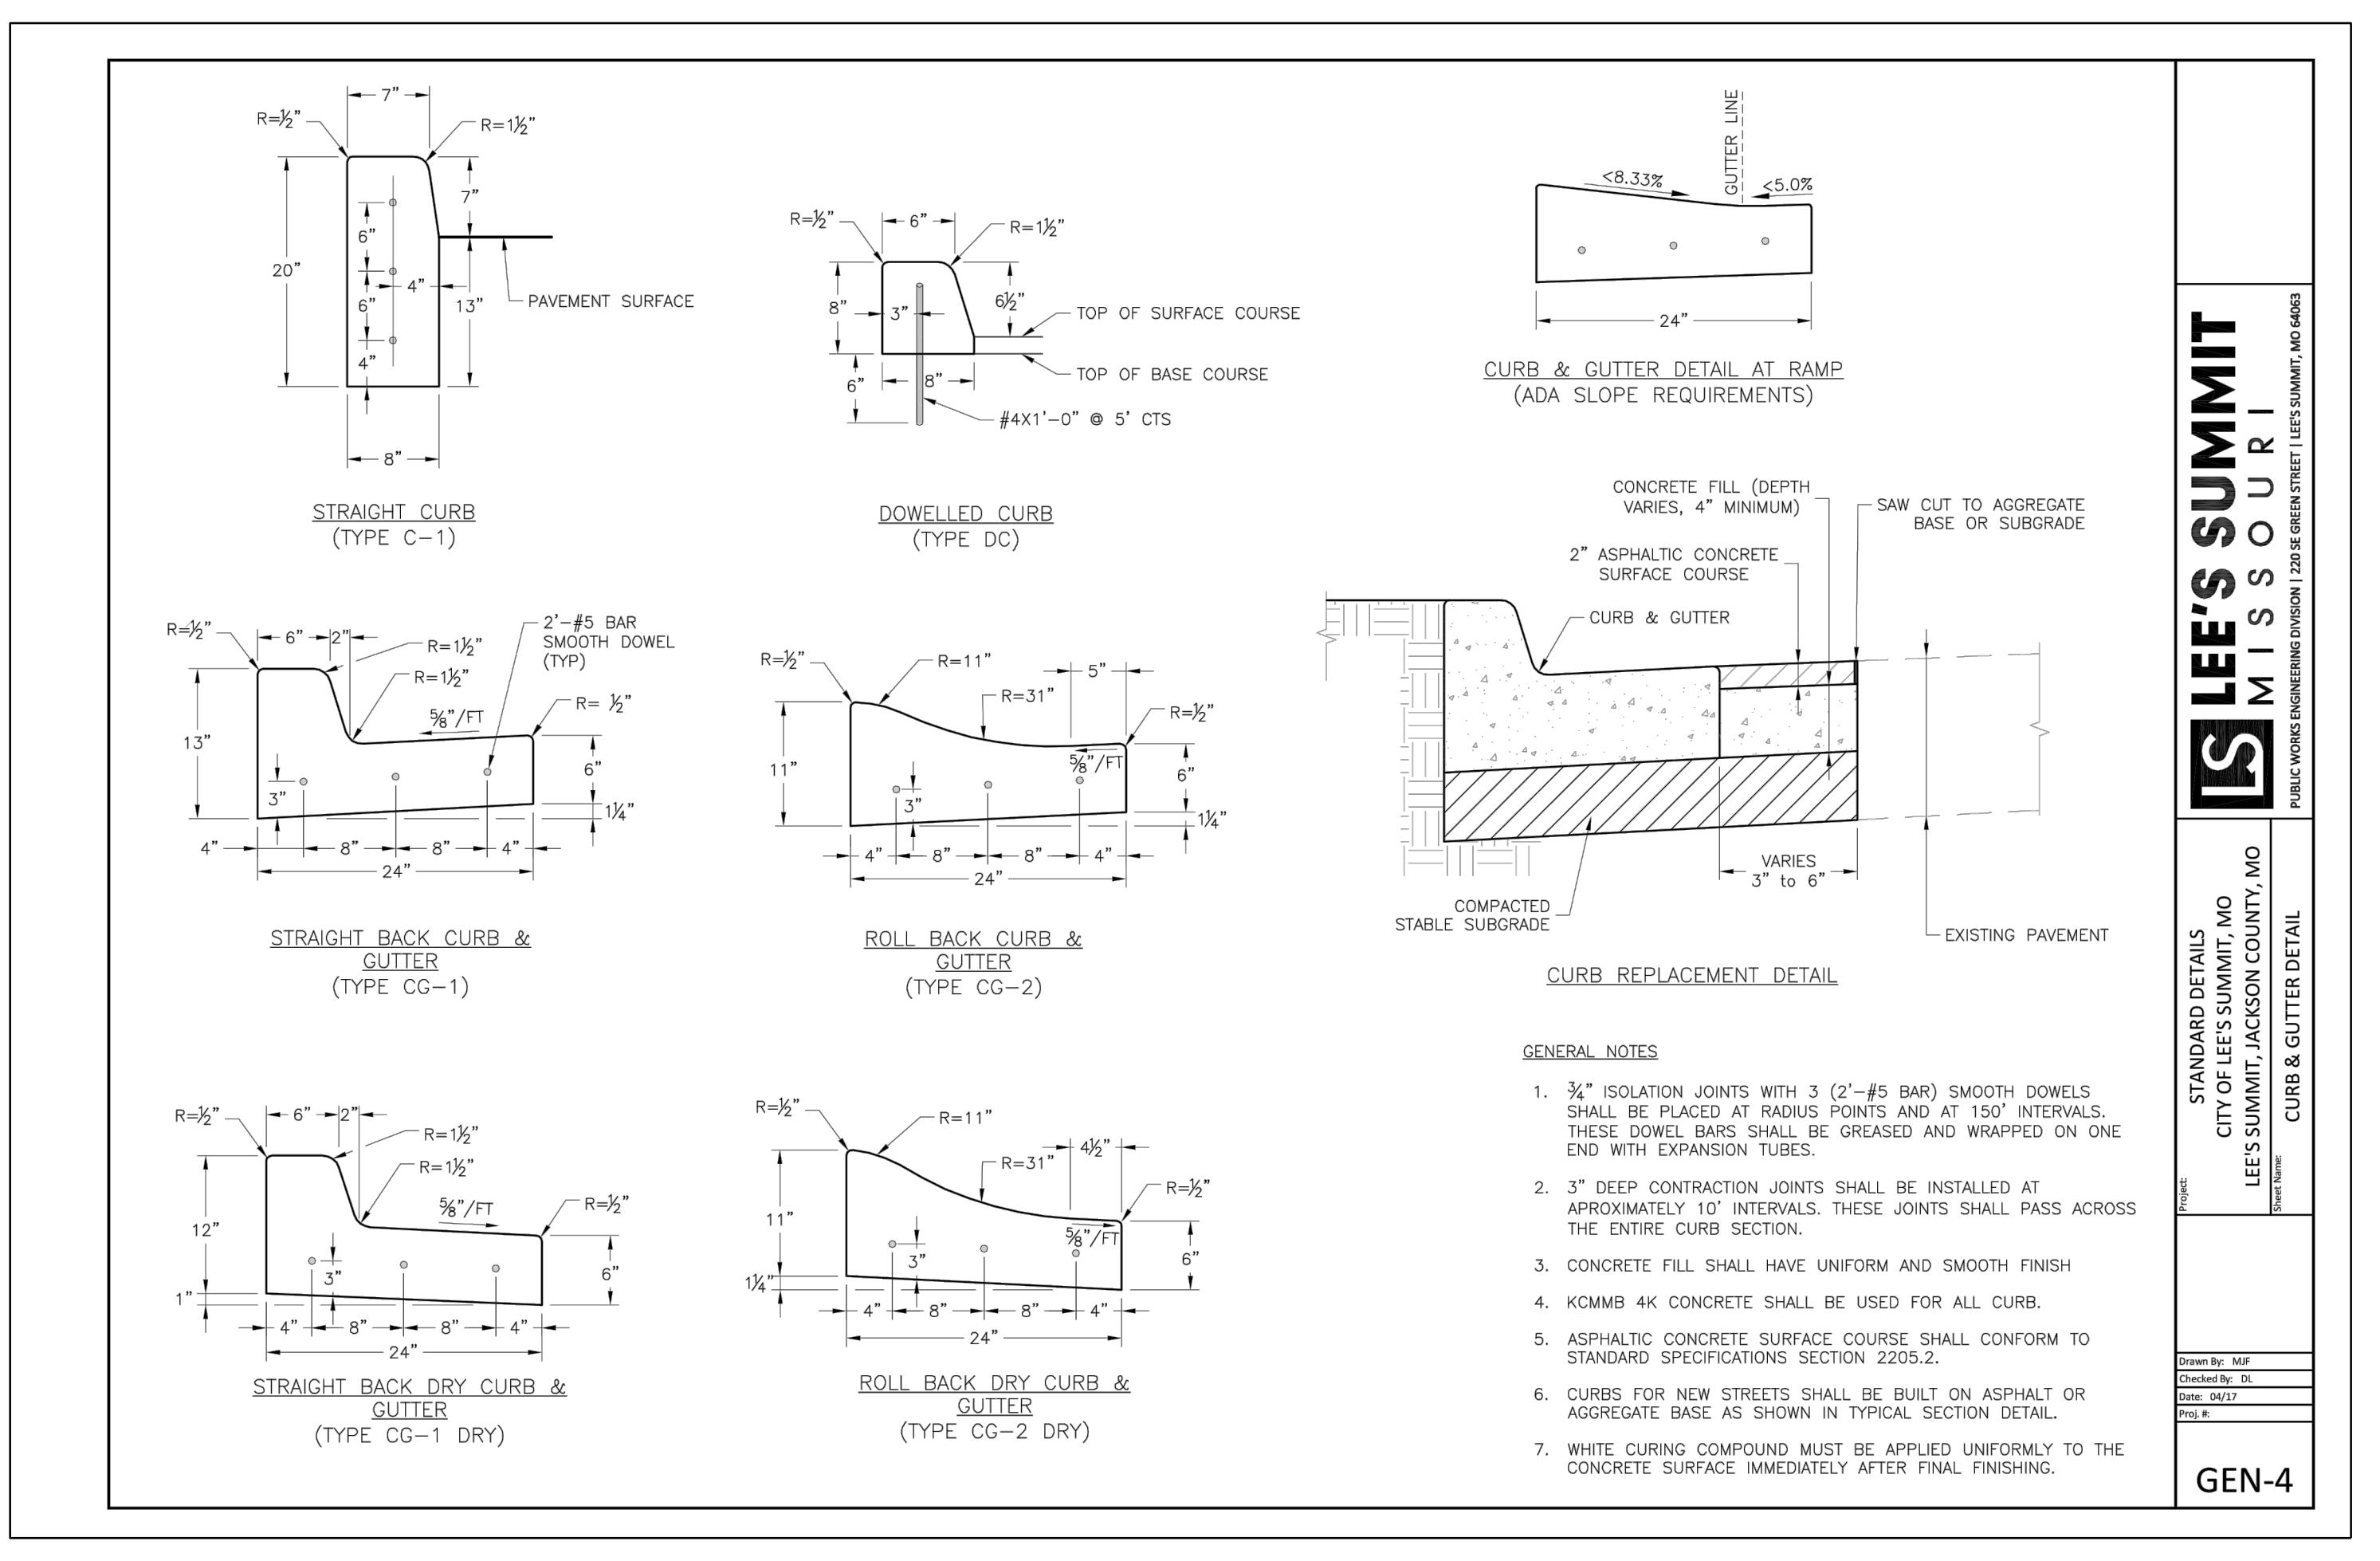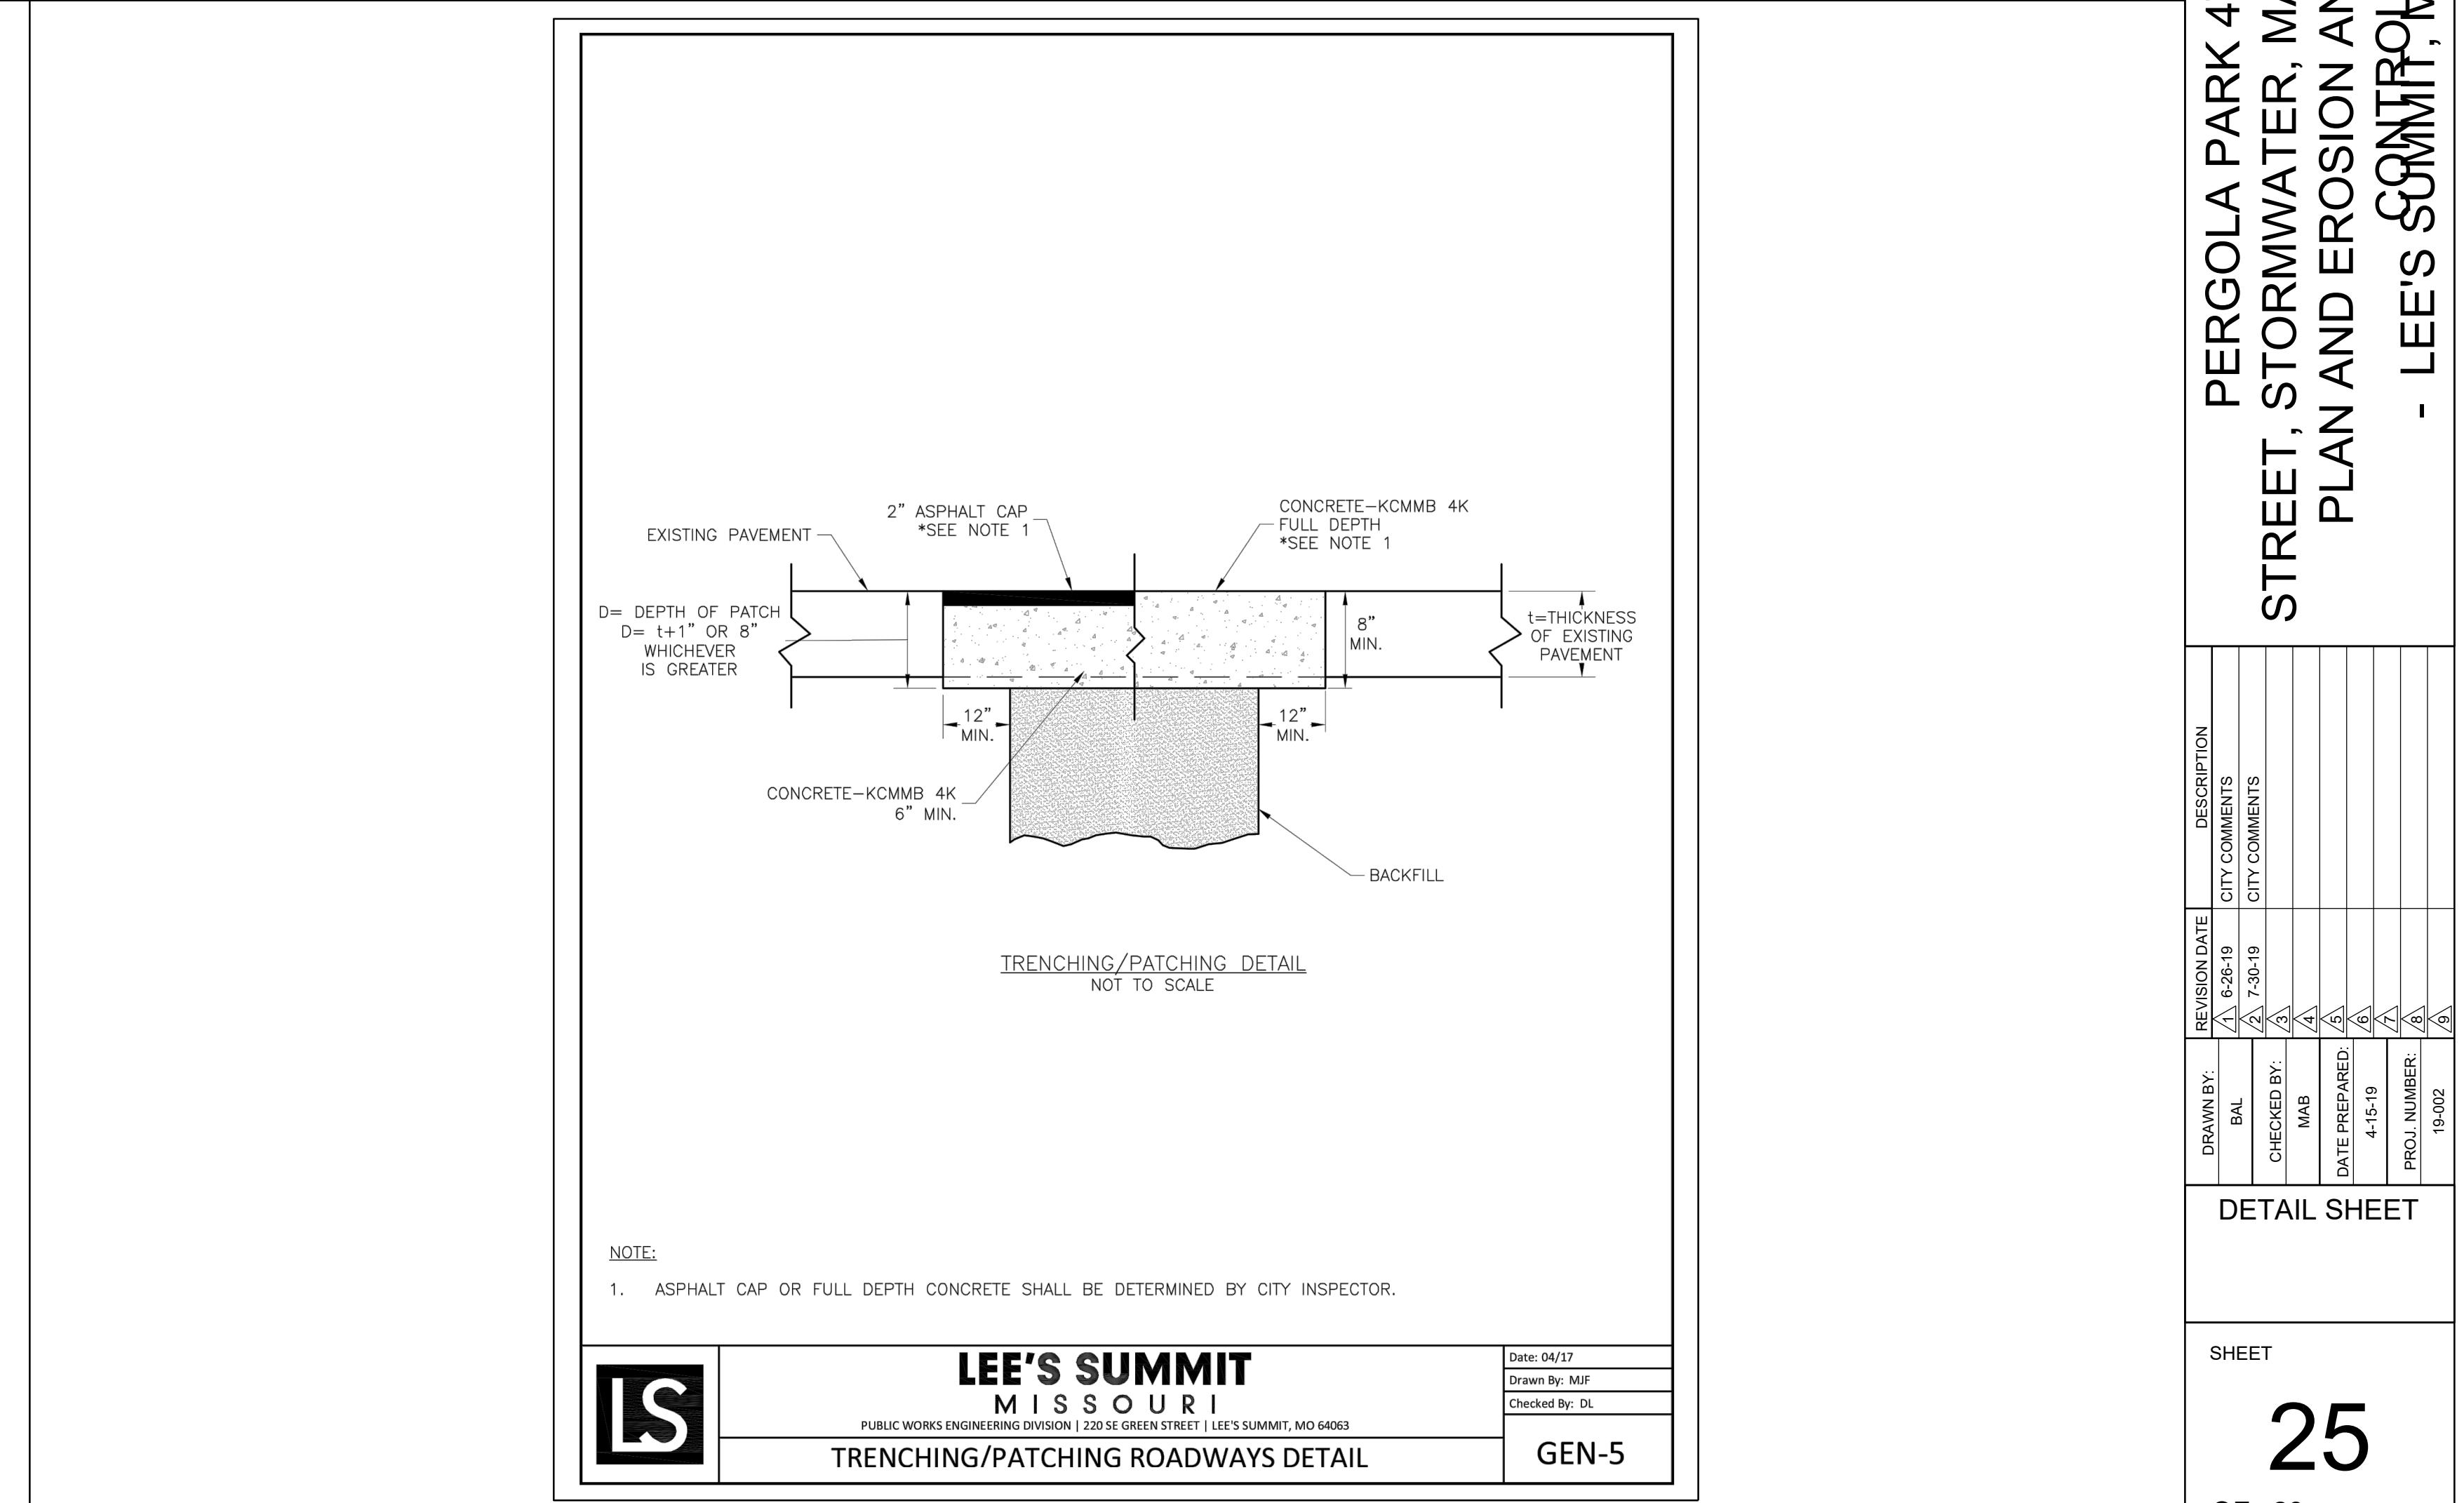
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	MARK ALLEN BREUER NUMBER PE-2009007268 07-31-19	
DETAIL SHEET	REVISION DATE CITY COMMENTS CITY COMMENTS CHECKED BY: MAB DATE PREPARED: 4-15-19 PROJ NUMBER: 19-02	
26 OF 28		




**PERGOLA PARK 4TH PLAT
STREET, STORMWATER, MASTER DRAINAGE
PLAN AND EROSION AND SEDIMENT**

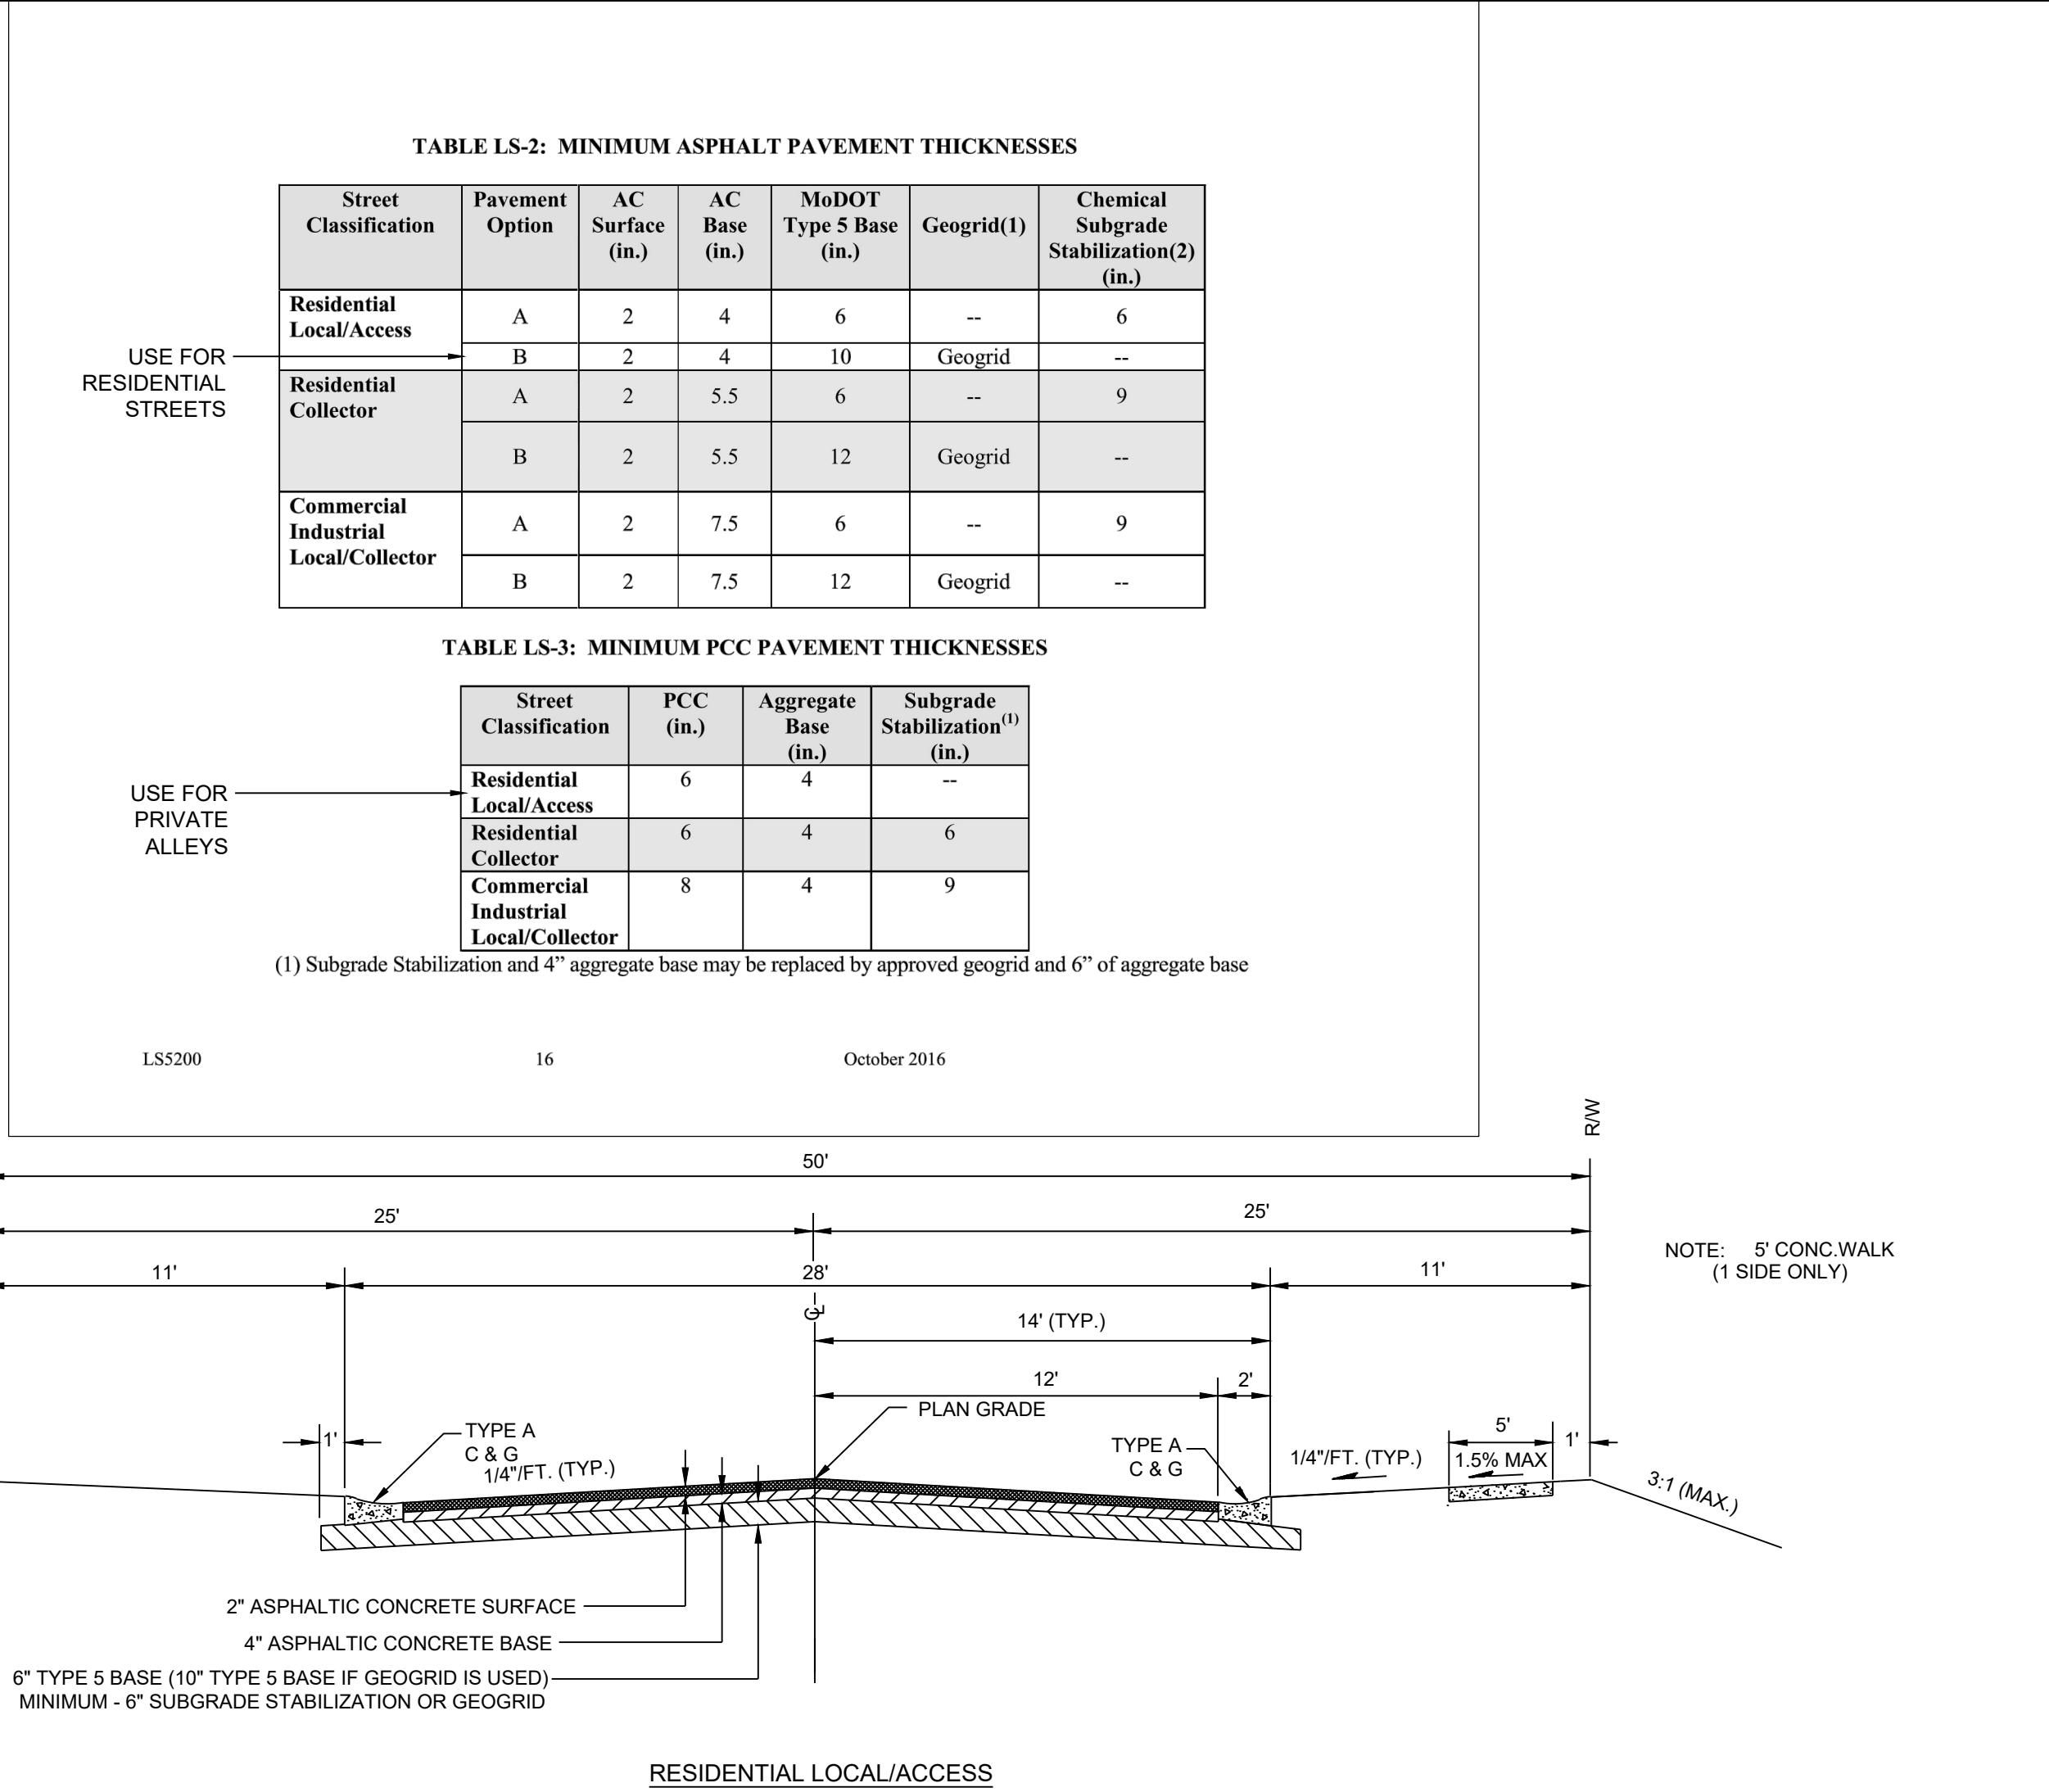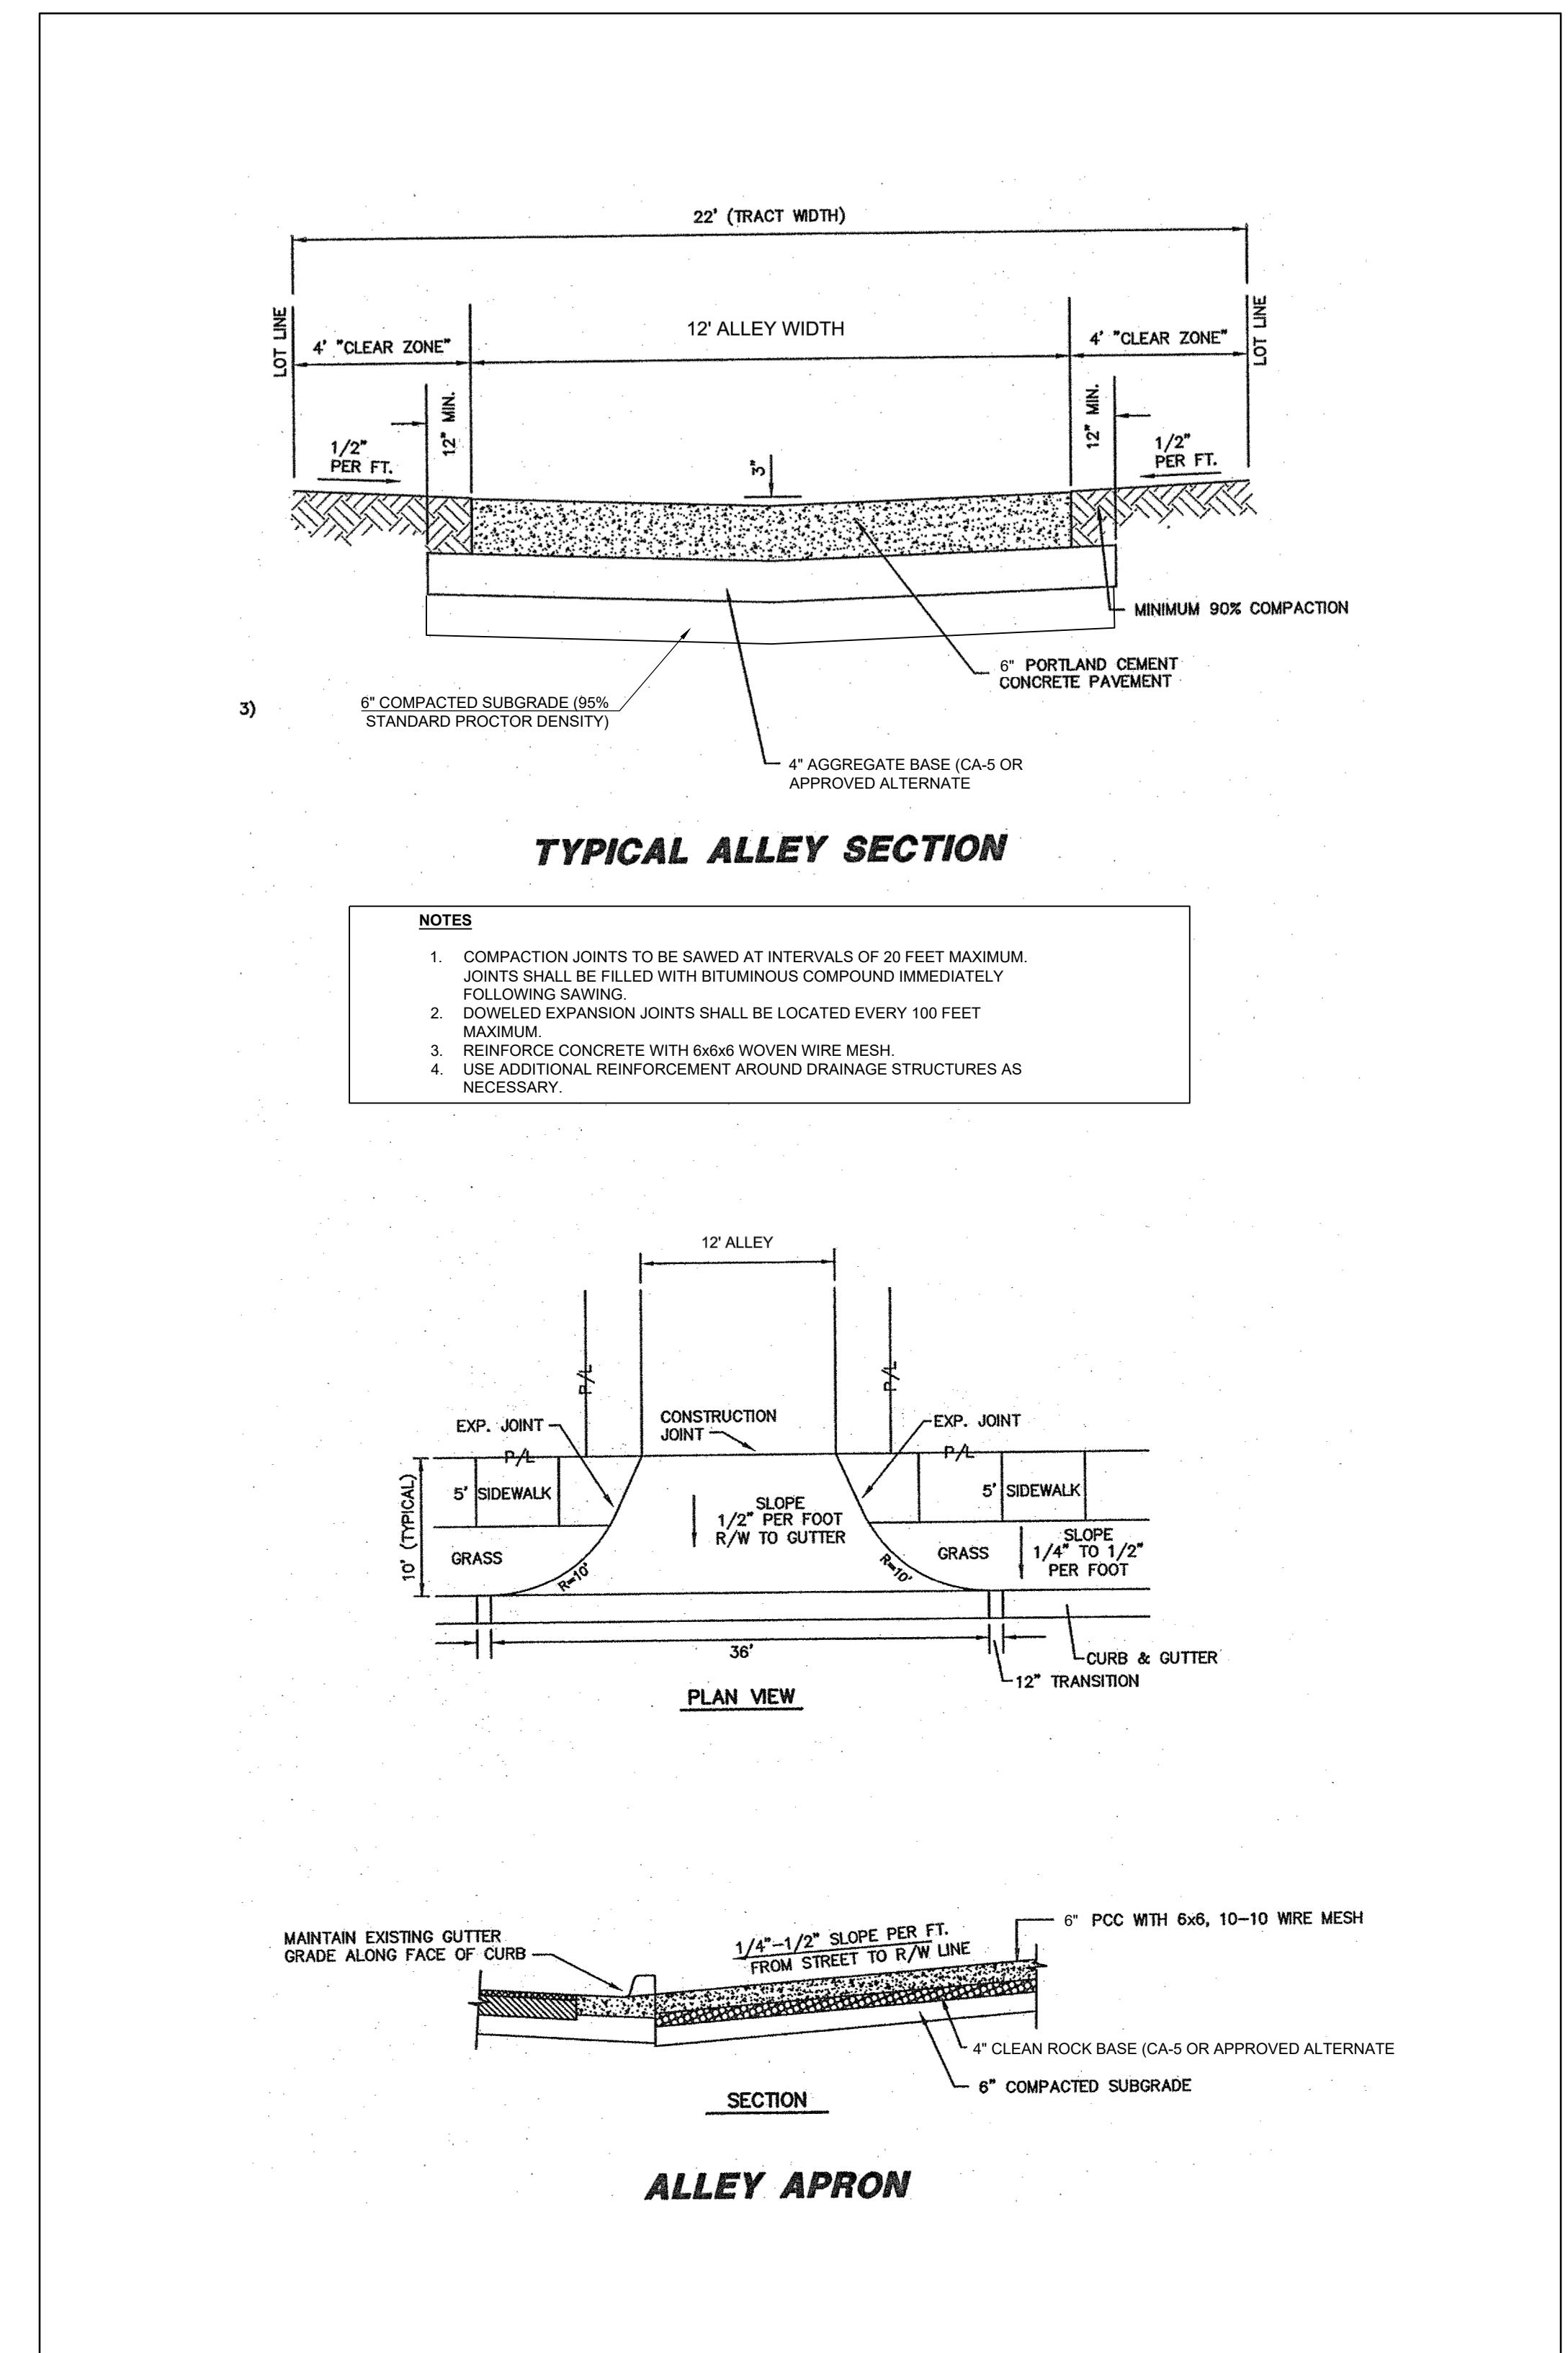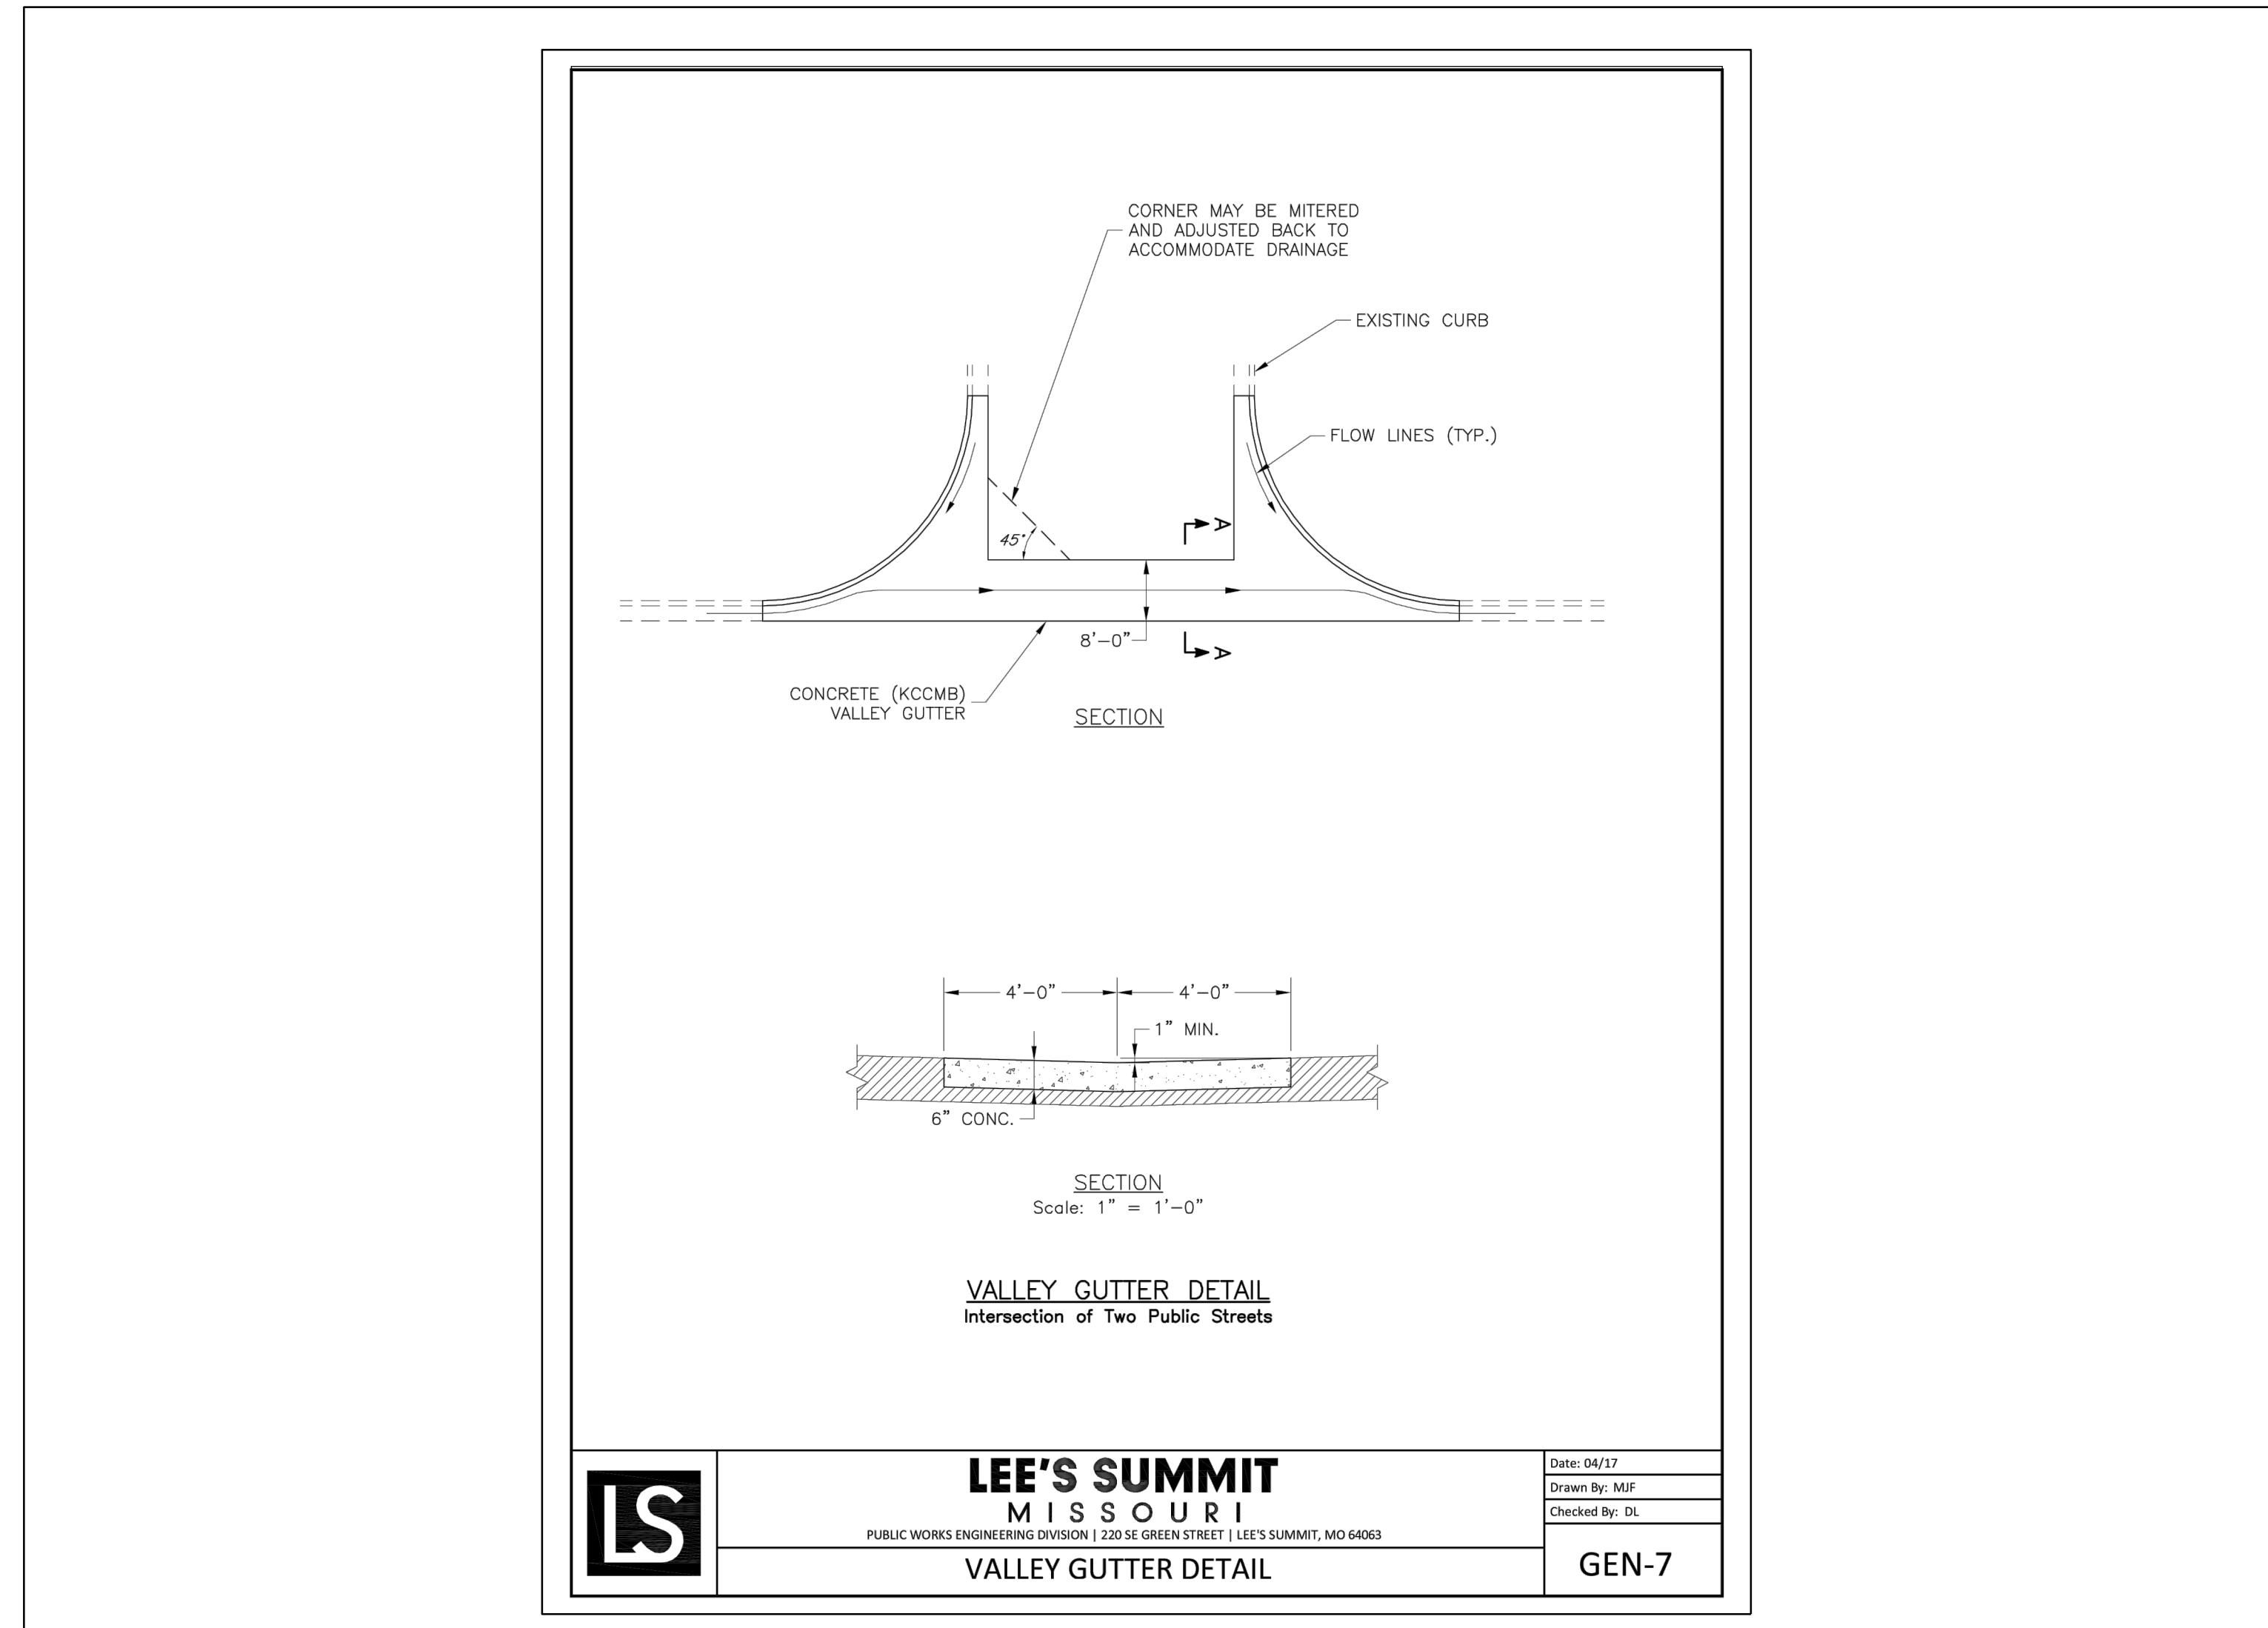- LEE'S SUMMIT, MISSOURI




27

STREET SIGN PLAN	
SHEET	27 OF 28

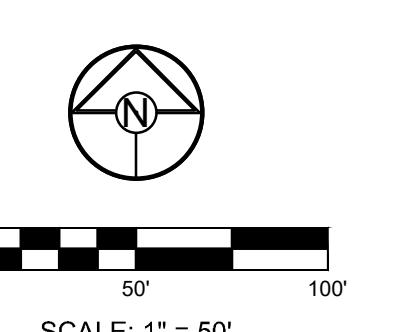

SCALE: 1" = 50'





DRAWN BY:	REVISION DATE	DESCRIPTION
BAL	8-16-19	CITY COMMENTS
	8-30-19	CITY COMMENTS
CHECKED BY:		
MAB		
DATE PREPARED:		
4-15-19		
PROJ NUMBER:		
19-002		

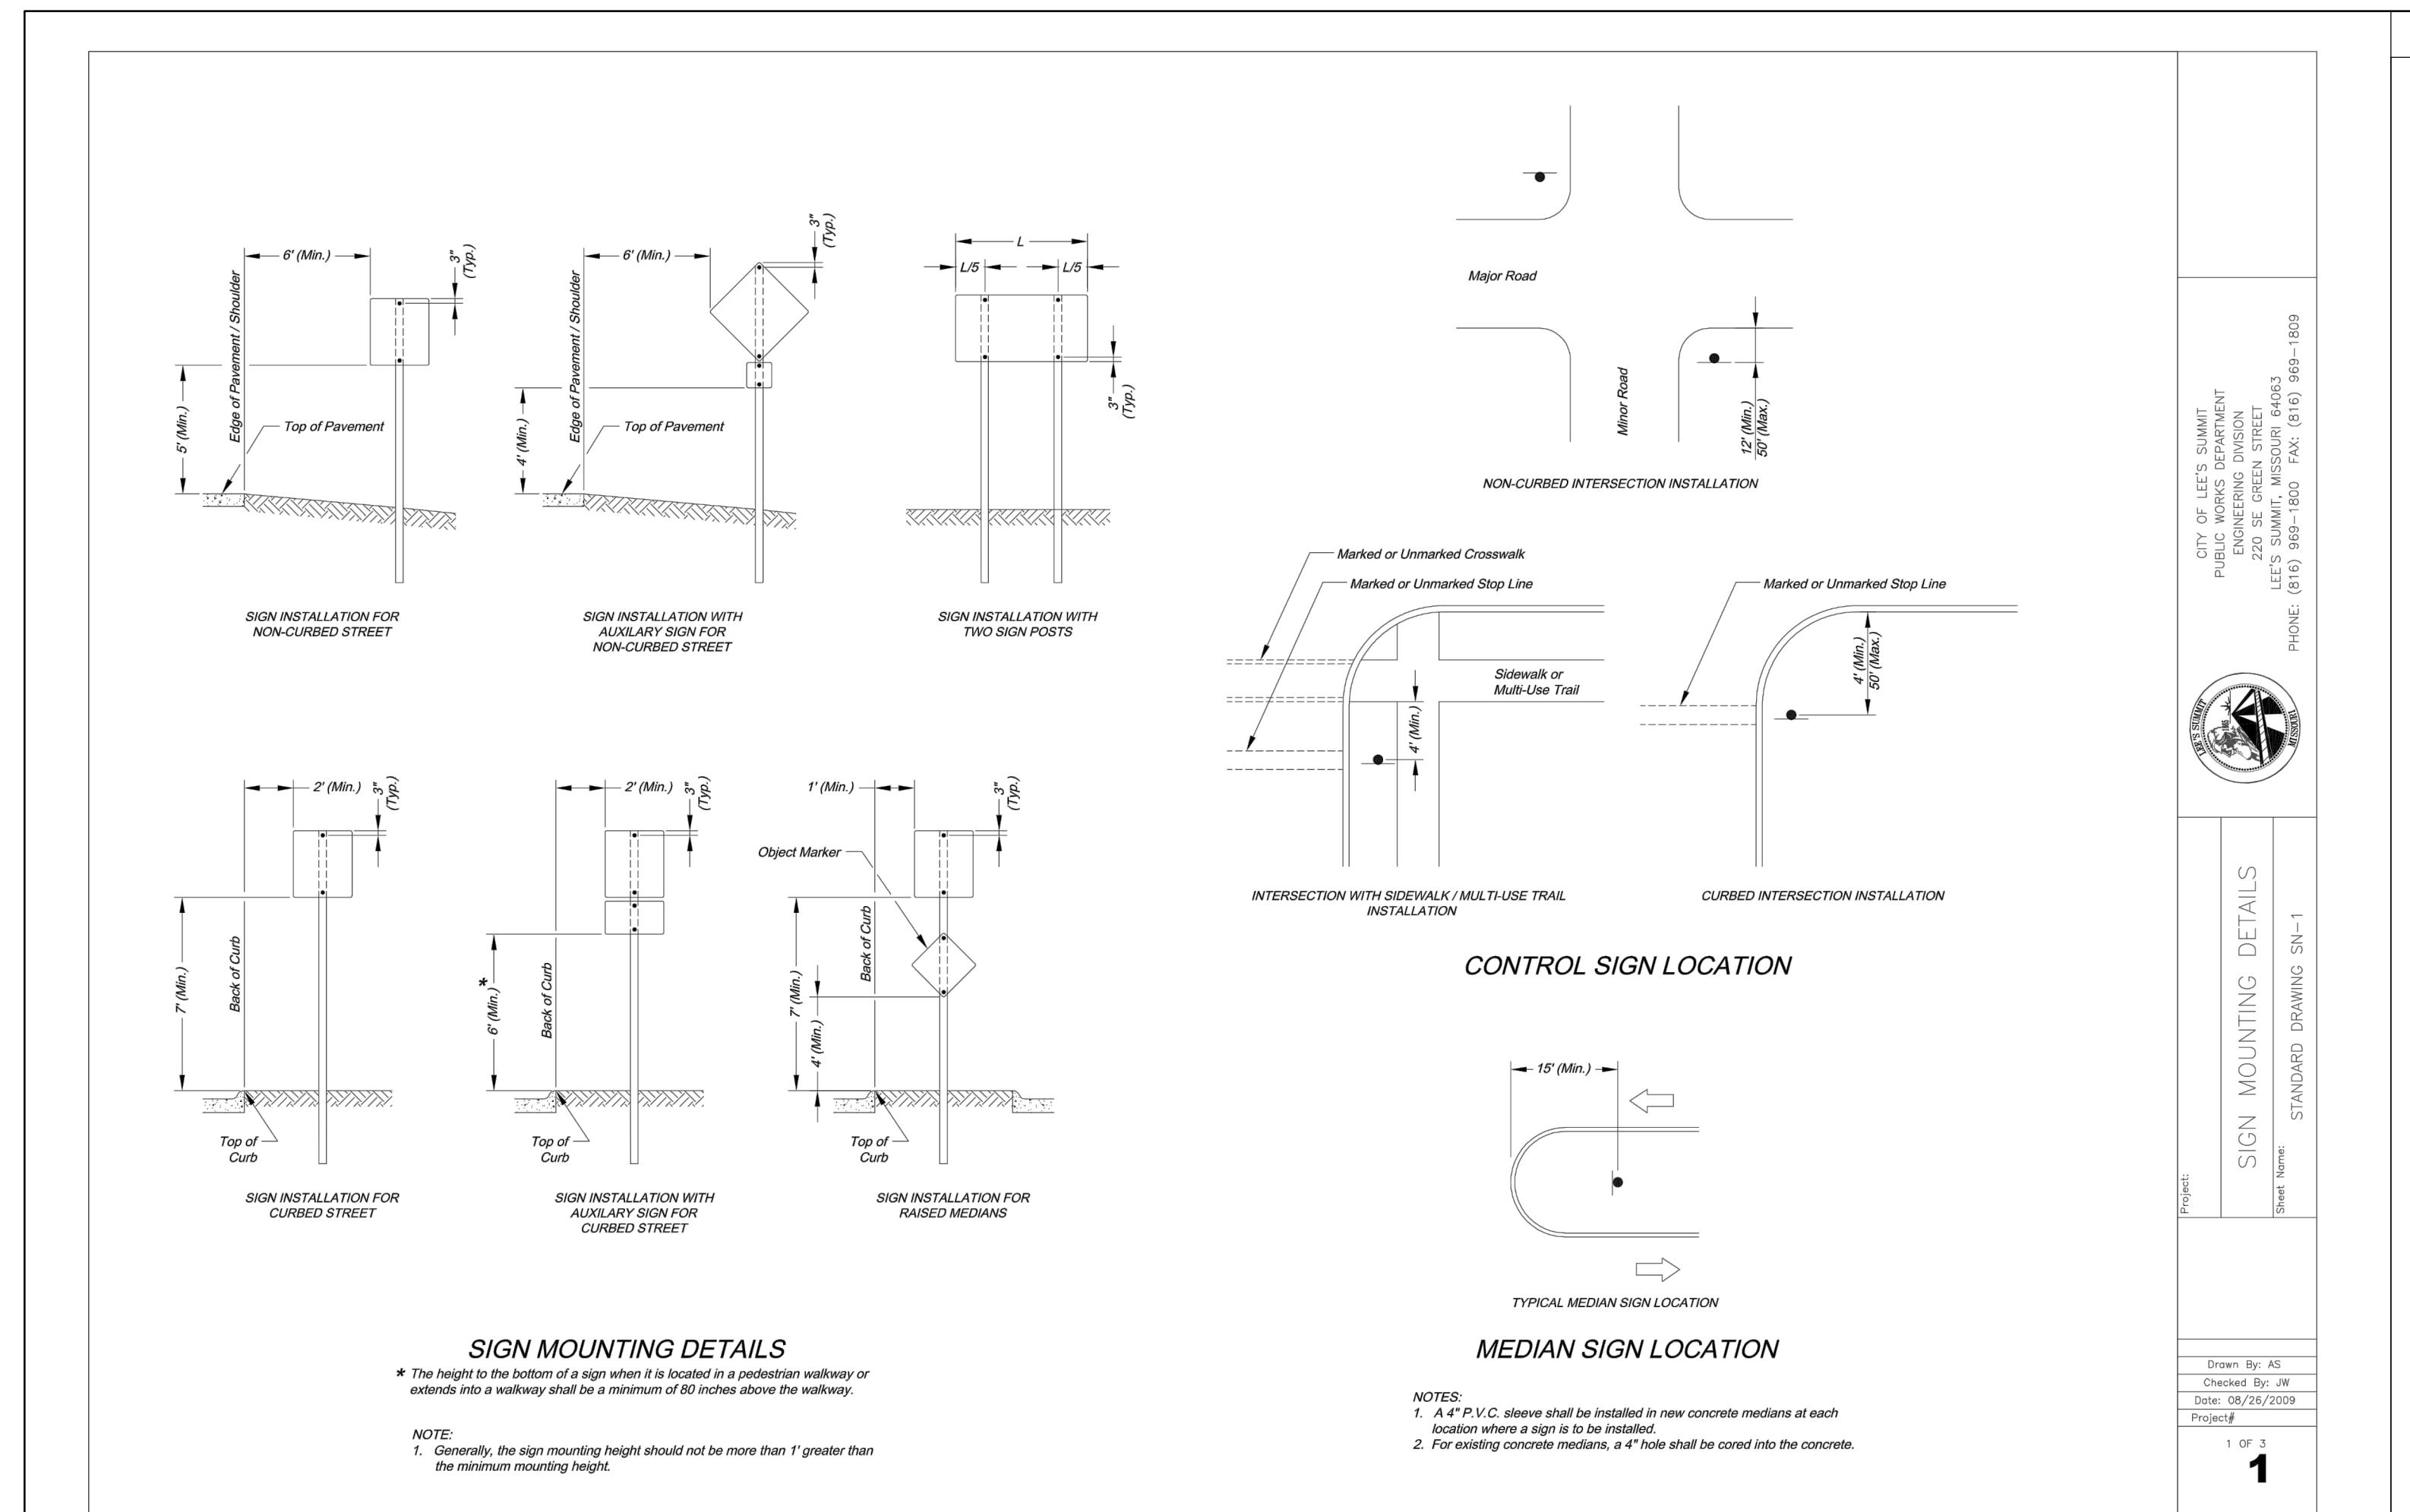

SIGN MOUNTING DETAILS

* The height to the bottom of a sign when it is located in a pedestrian walkway or extends into a walkway shall be a minimum of 80 inches above the walkway.

NOTE: 1. Generally, the sign mounting height should not be more than 1' greater than the minimum mounting height.

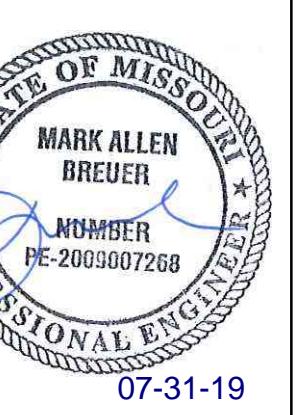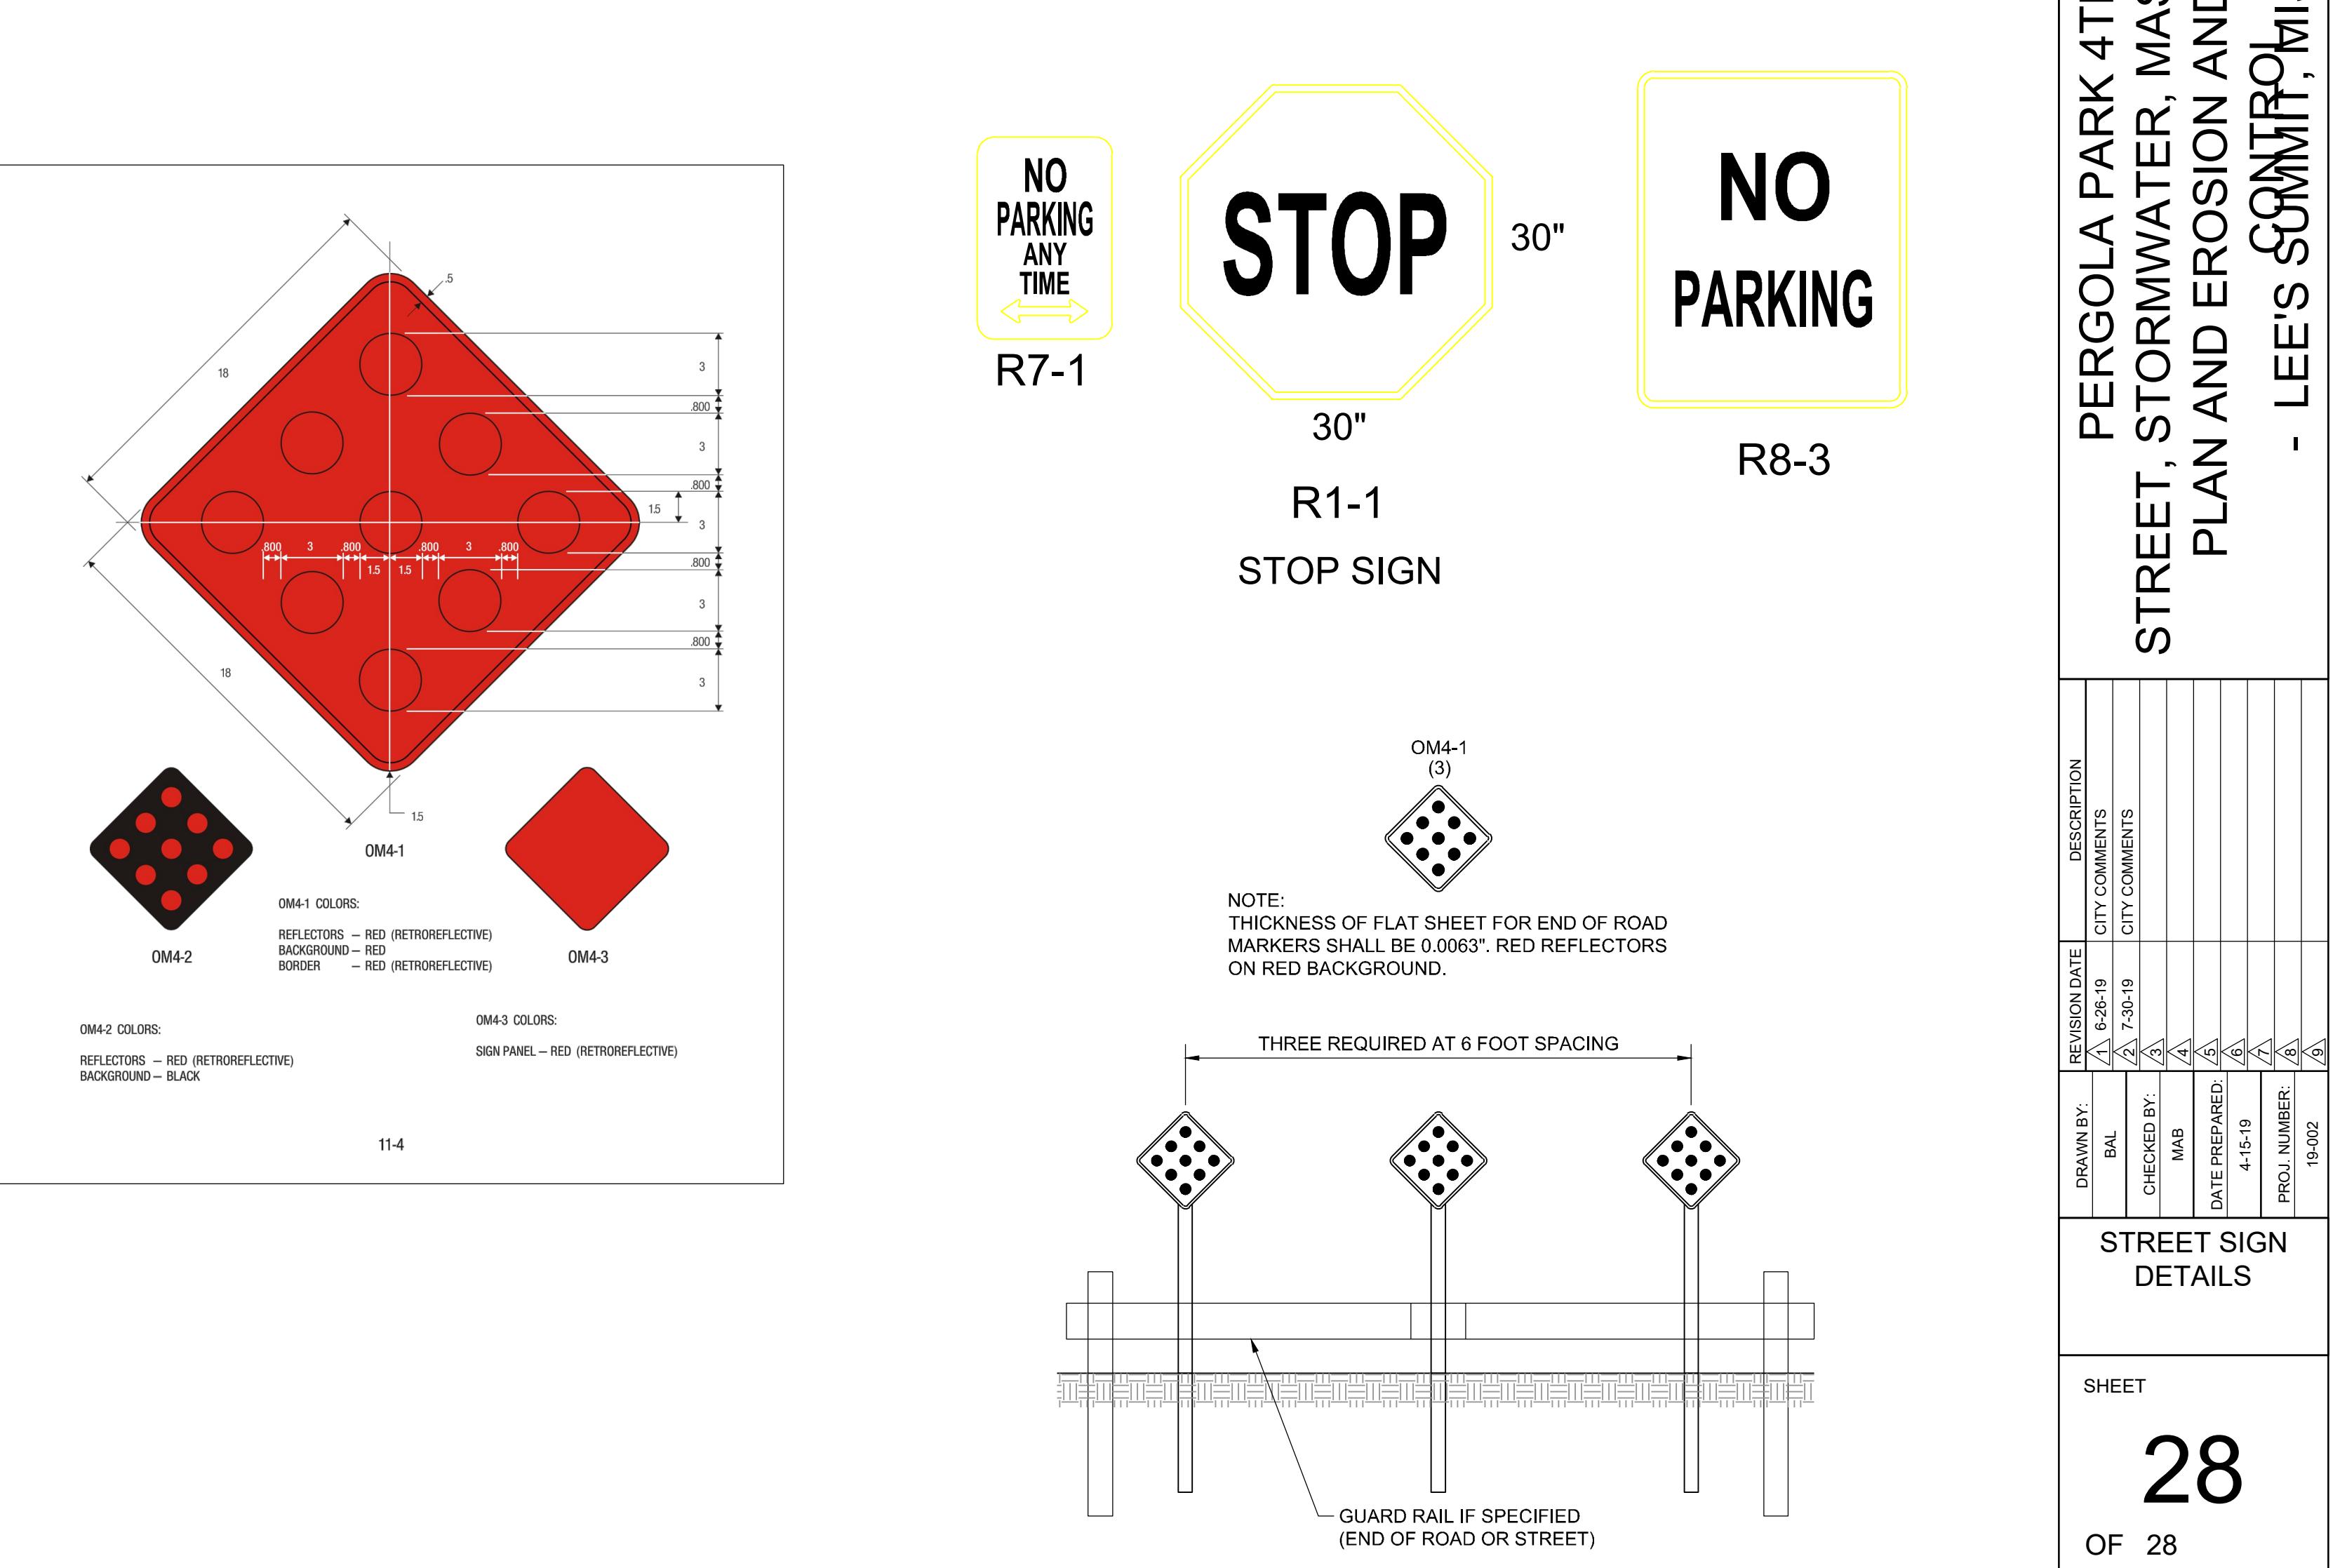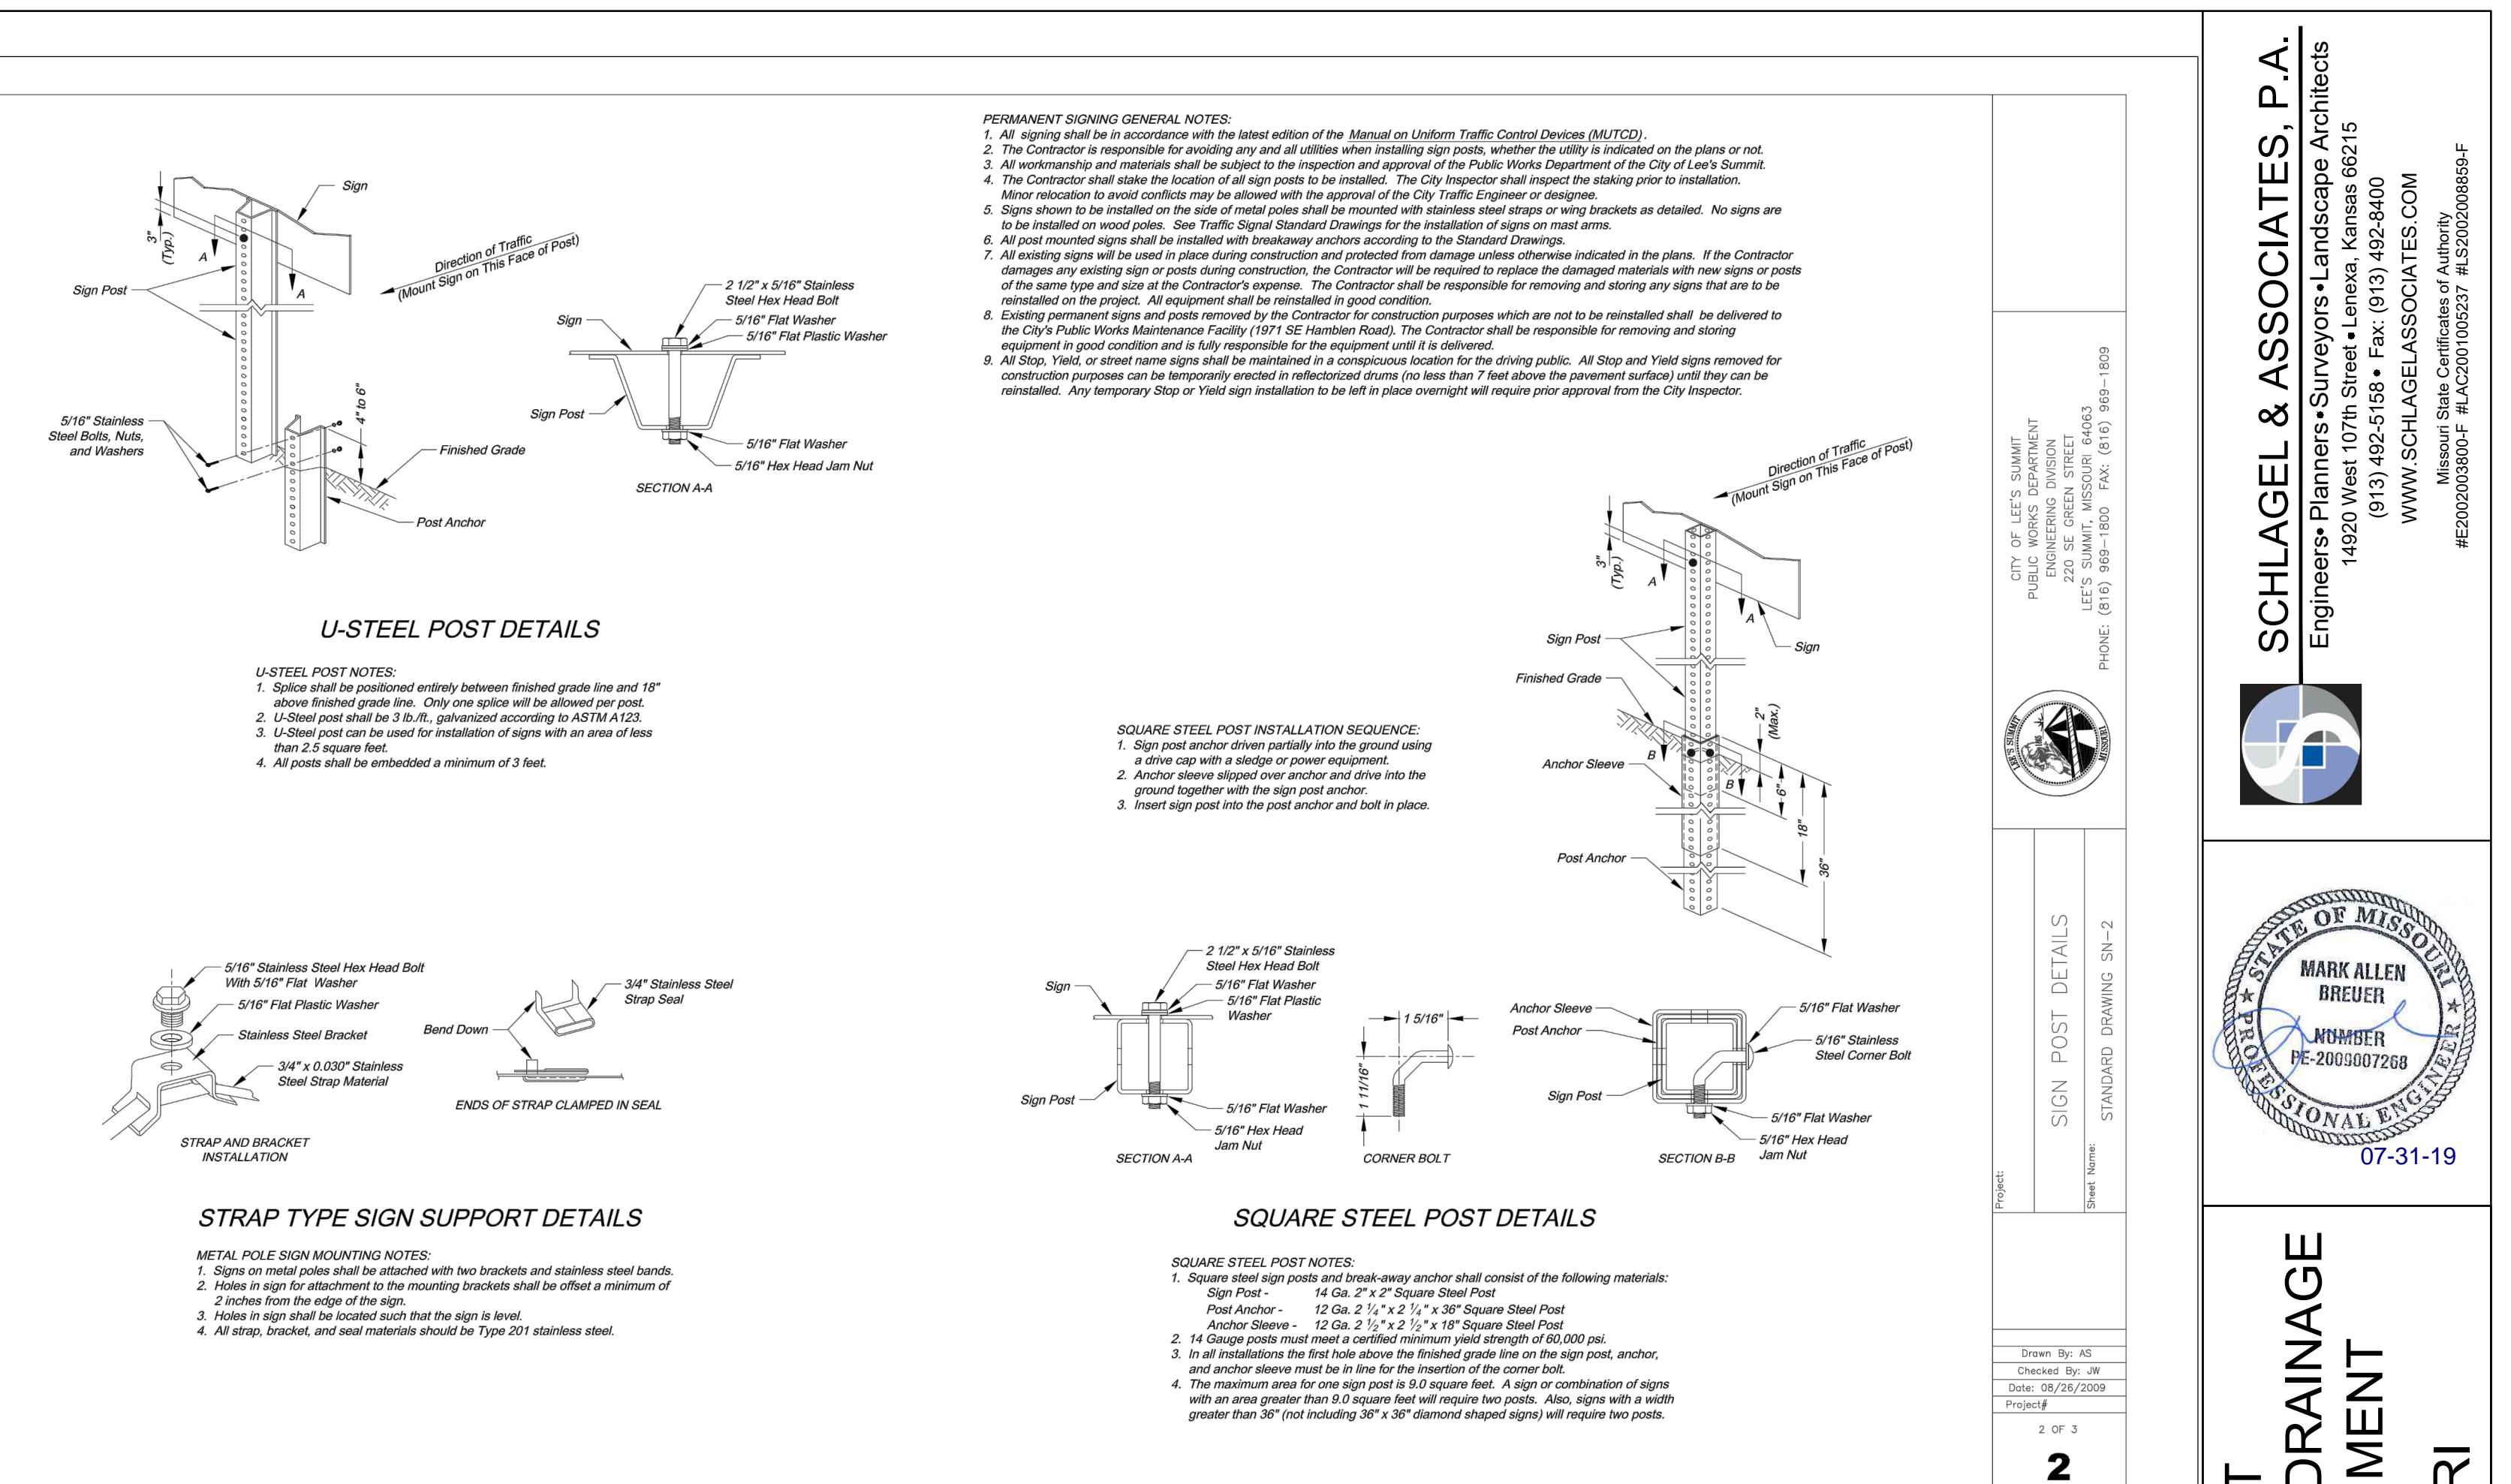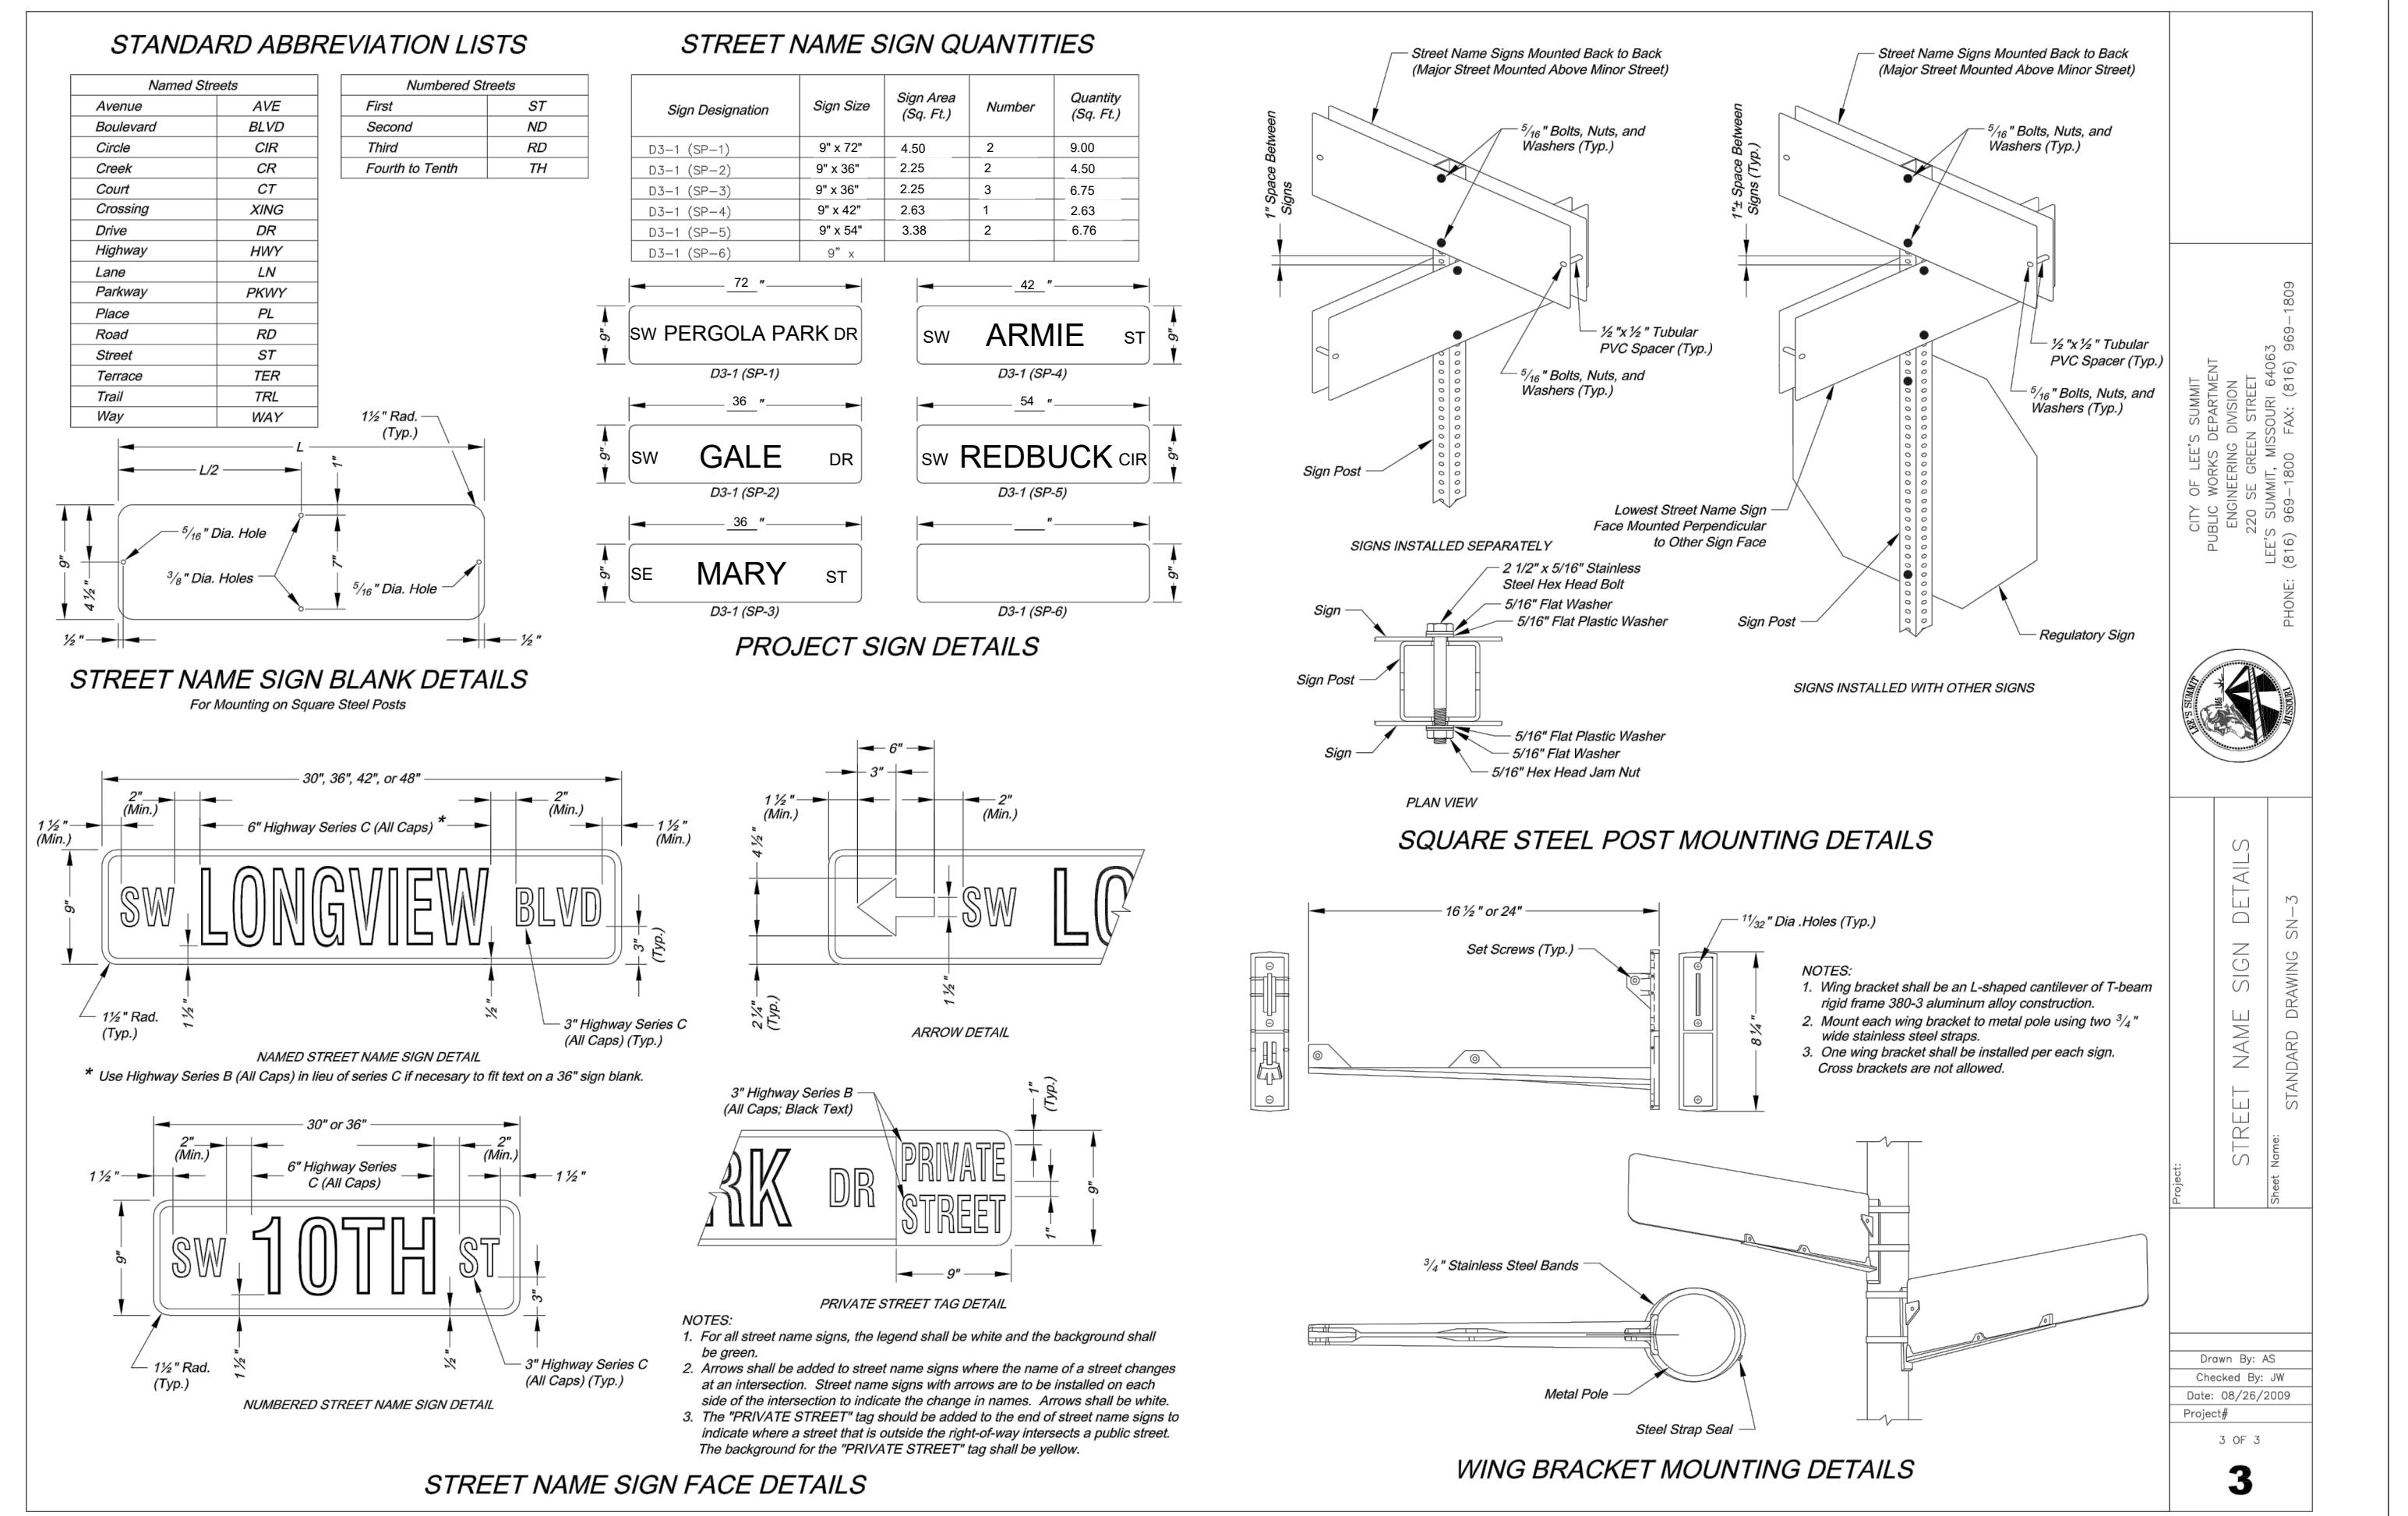

07-31-19