



EXISTING ZONING	P-MIX
PROPOSED ZONING	P-MIX
SITE AREA	2.93 ACRES
PROPOSED BUILDING USE	WAREHOUSE, TRANSFER
BUILDING HEIGHT	40 FEET (ELEV. 980.0)
FINISHED FLOOR ELEV.	940.0

PARKING REQUIRED	
WAREHOUSE FLOOR AREA	18,000 S.F. = 18 SPACES
OFFICE FLOOR AREA	6,000 S.F. = 24 SPACES (4
TOTAL REQUIRED	42 SPACES

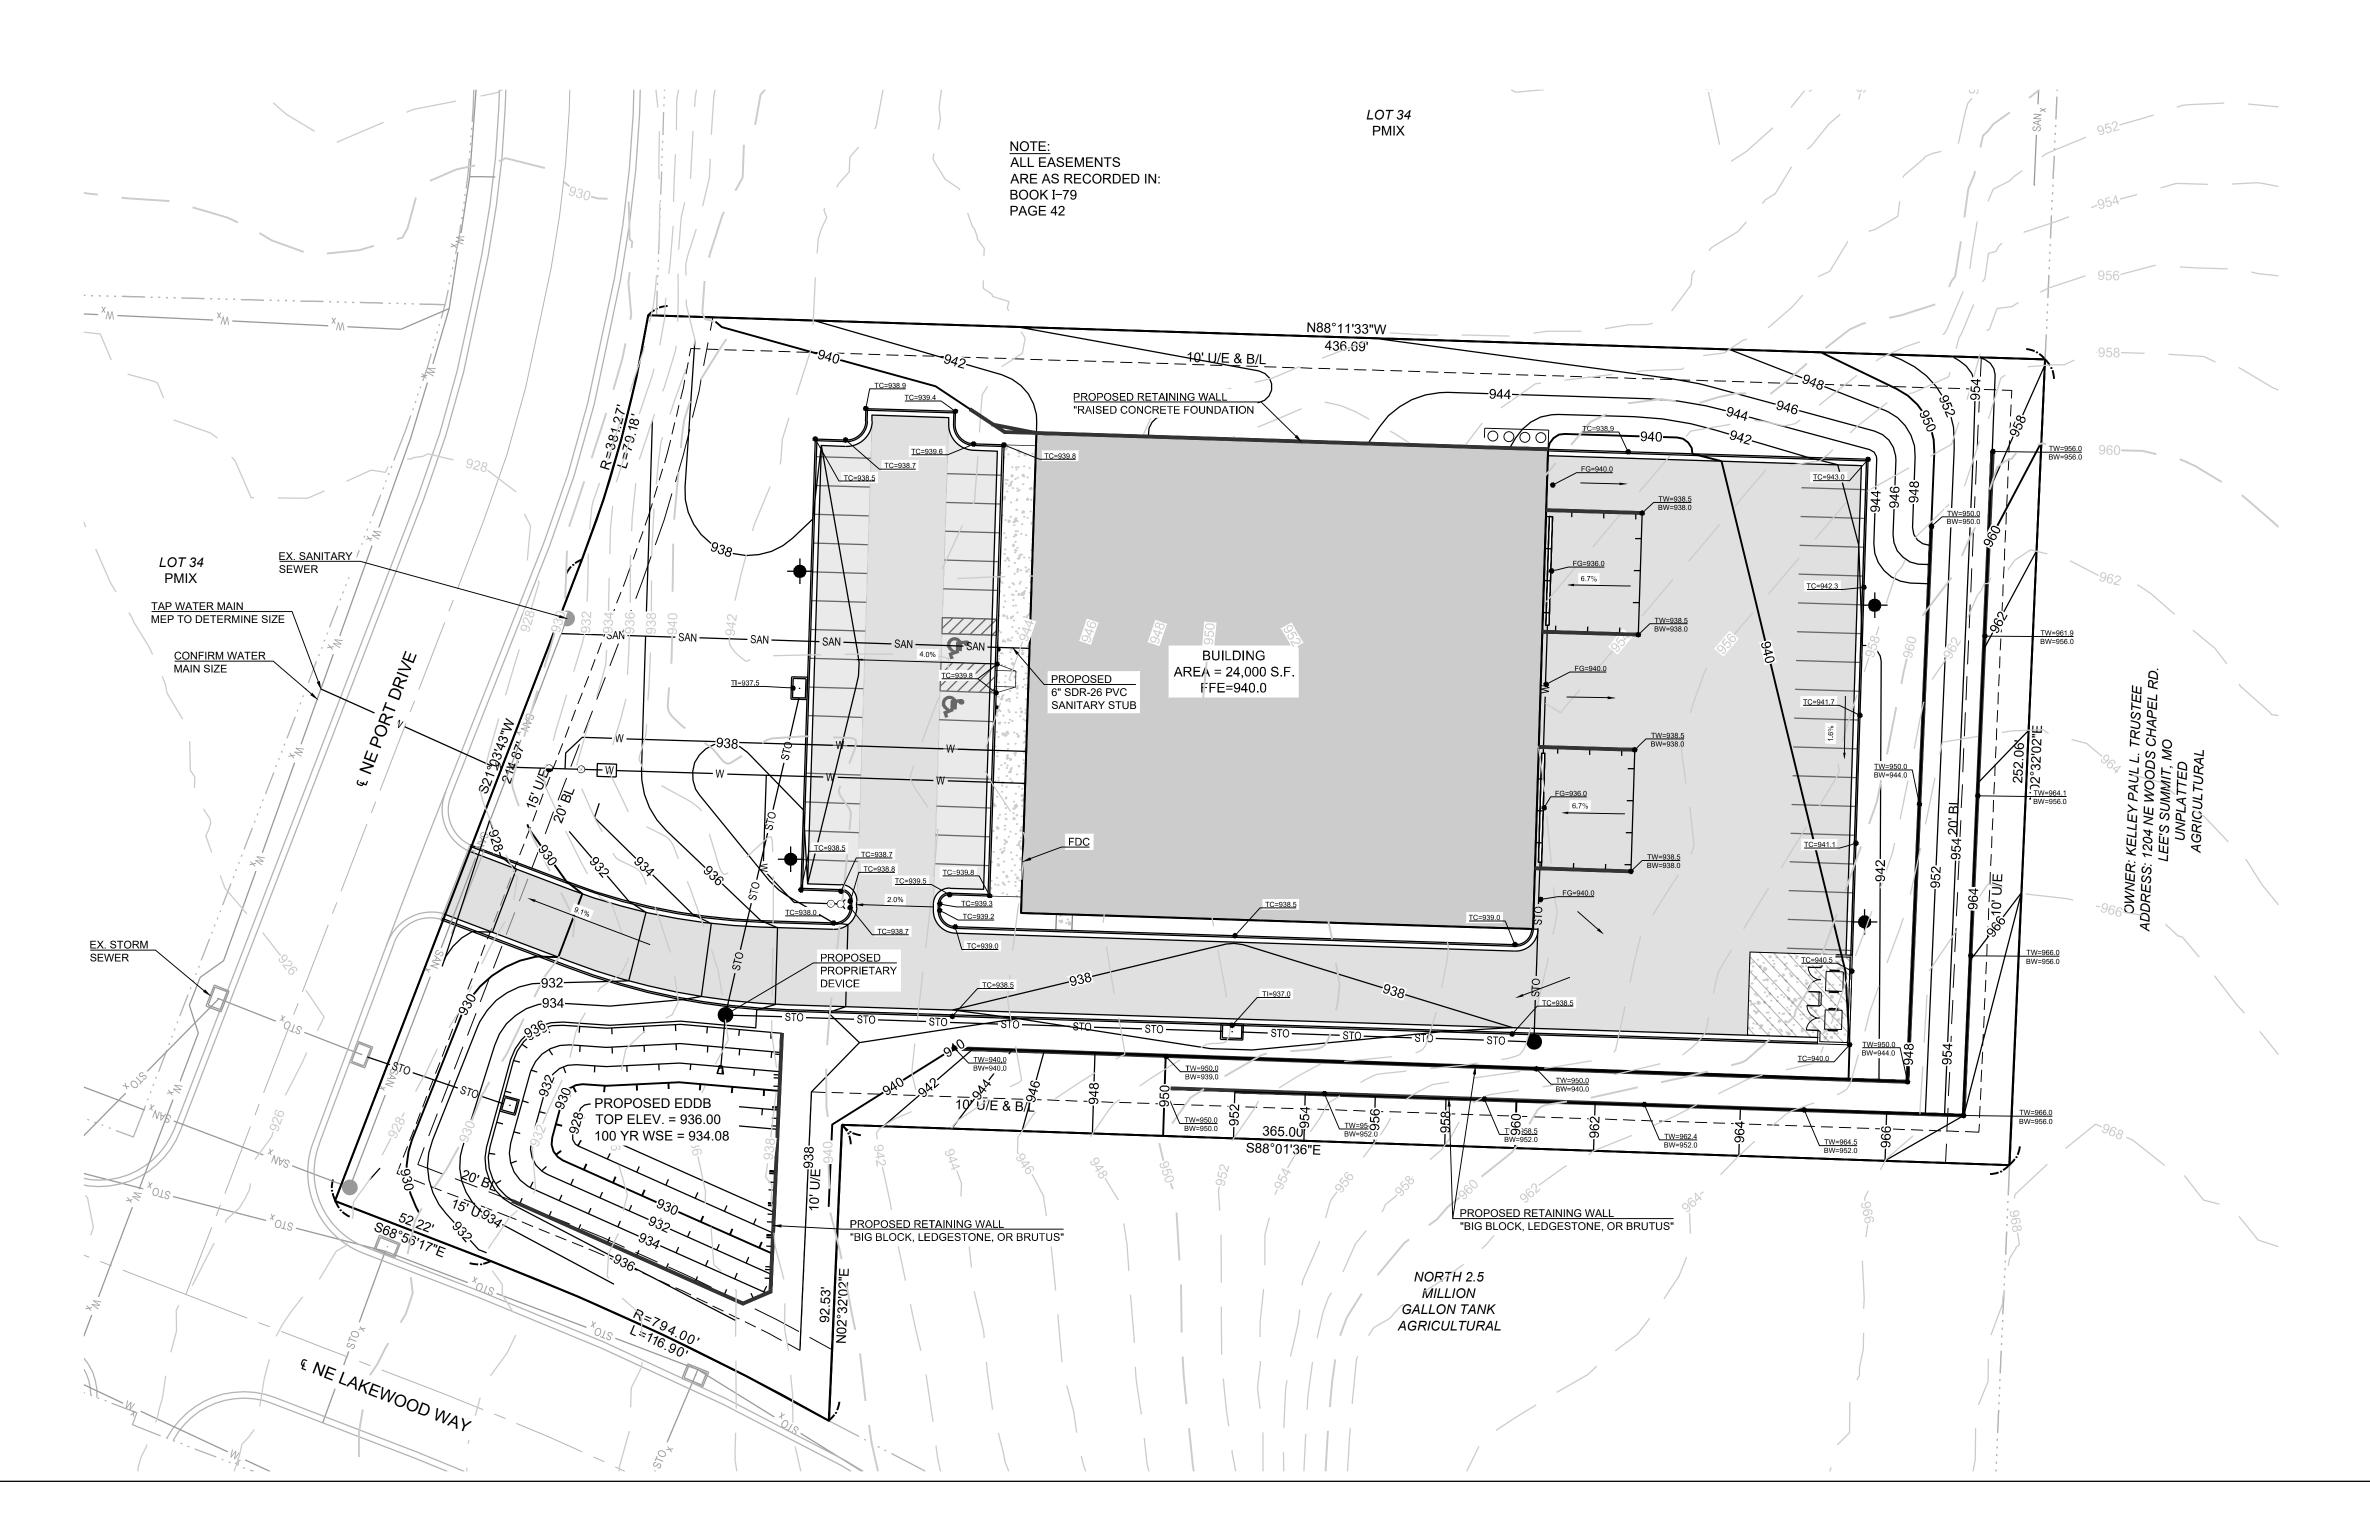

GRADING NOTES:


- NO EDGE DRAINS OR UNDERDRAINS ARE INDICATED BEHIND THE CURBS. OWNER SHOULD CONSIDER THE INSTALLATION OF UNDERDRAINS DUE TO THE IRRIGATION OF GREENSPACE AREAS OF THE SITE.
- 2. RECOMMEND A GEOTECHNICAL ENGINEER REVIEW ALL EARTHWORK ACTIVITY TO MAKE SURE RECOMMENDATIONS IN GEOTECHNICAL REPORT ARE FOLLOWED.
- 3. PRIOR TO PLACEMENT OF CURB AND GUTTER AND PAVEMENT, GEOTECHNICAL ENGINEER MUST APPROVE SUBGRADE IN WRITTEN FORM TO THE OWNER AND PROJECT ENGINEER.
- 4. ALL UTILITY INSTALLATIONS UNDER PAVED AREAS MUST BE COMPACTED AS PER THE RECOMMENDATIONS OF THE GEOTECHNICAL ENGINEER AND/OR GEOTECHNICAL REPORT.
- 5. ALL CONSTRUCTION SHALL COMPLY WITH THE CITY OF LEE'S SUMMIT TECHNICAL SPECIFICATIONS.
- 6. EXISTING TOPOGRAPHY SHOWN AS ESTABLISHED FROM BASE SURVEY PREPARED BY SUMMIT SURVEY COMPANY VERIFY GRADES PRIOR TO COMMENCEMENT OF GRADING AND CONSTRUCTION ACTIVITIES. NO ADDITIONAL MONEY WILL BE PAID FOR HAUL-IN OR HAUL-OFF OF MATERIAL.
- 7. ALL ROCK, CONCRETE, ASPHALT, TREE, BRUSH, ETC. TO BE REMOVED AS A PART OF THE PROJECT CONSTRUCTION SHALL BE DISPOSED OF BY THE GRADING CONTRACTOR AND SHALL BE A SUBSIDIARY OBLIGATION OF THE CONTRACT. THE GRADING CONTRACTOR IS ALSO RESPONSIBLE FOR ALL GRADING ON THE SITE INCLUDING THE MANIPULATION OF THE EXCESS DIRT MATERIAL THAT WAS LEFT ALONG THE SEWER TRENCHES. THE COST FOR THIS WORK WILL BE INCLUDED IN THE LUMP SUM FEE FOR GRADING.
- ENTIRE PROJECT SHALL BE LEFT IN A MOWABLE CONDITION. ALL DISTURBED AREAS SHALL BE SEEDED & MULCHED AS PER PROJECT REQUIREMENTS. ALL DISTURBED AREAS WITHIN THE PUBLIC STREET RIGHT-OF-WAY SHALL BE SODDED IN COMPLIANCE WITH THE CITY OF LEE'S SUMMIT TECHNICAL SPECIFICATIONS AND MUNICIPAL CODE.
- 9. THE CONTRACTOR SHALL PROVIDE FOR POSITIVE DRAINAGE AWAY FROM BUILDINGS AND SIDEWALKS AT ALL TIMES.
- 10. THE CONTRACTOR IS RESPONSIBLE FOR PROTECTION OF ALL PROPERTY CORNERS. ANY PROPERTY CORNERS DISTURBED OR DAMAGED BY GRADING ACTIVITIES SHALL BE RESET BY A PROFESSIONAL LAND SURVEYOR LICENSED IN THE STATE OF MISSOURI, AT THE CONTRACTOR'S EXPENSE.

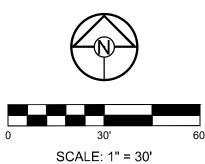


SCHLAGEL & ASSOCIATES, P.A.	Engineers• Planners•Surveyors•Landscape Architects 14920 West 107th Street • Lenexa, Kansas 66215 (913) 492-5158 • Fax: (913) 492-8400	WWW.SCHLAGELASSOCIATES.COM Missouri State Certificates of Authority #E2002003800-F #LAC2001005237 #LS2002008859-F

DRAWN BY: REVISION DATE DESCRIPTION DRAWN BY: REVISION DATE DESCRIPTION RPM 7 02/19/2019 CITY COMMENTS RPM 2 0 10/2019 CITY COMMENTS RPM 2 1 0 1 1 OLI 0 1 1 1 1 1 RPM 2 1			PRFIIMINARY DEVELOPMENT PLANS			4101 NE LAKEWOOD WAY			
BRAMNBY: RPM RY RPM RY RPM RY RPM RY RPM RY CHECKED BY OU-18-2019 OU-18-200 OU-18-200 OU-18-		CITY COMMENTS							
GRADING PLAN	REVISION DATE	<u>/1</u> 02/19/2019	<u>/2</u>	4	5	<u>6</u>	A state of the	<u>/8</u>	6
SHEET 2	DRAWN BY:	RPM	CHECKED BY:	JPB	DATE PREPARED	01-18-2019		PROJ. NUMBER:	18-222
2	(GR		IN	G	PL		N	
	S	SHEI	ET)				
	(ЭF							



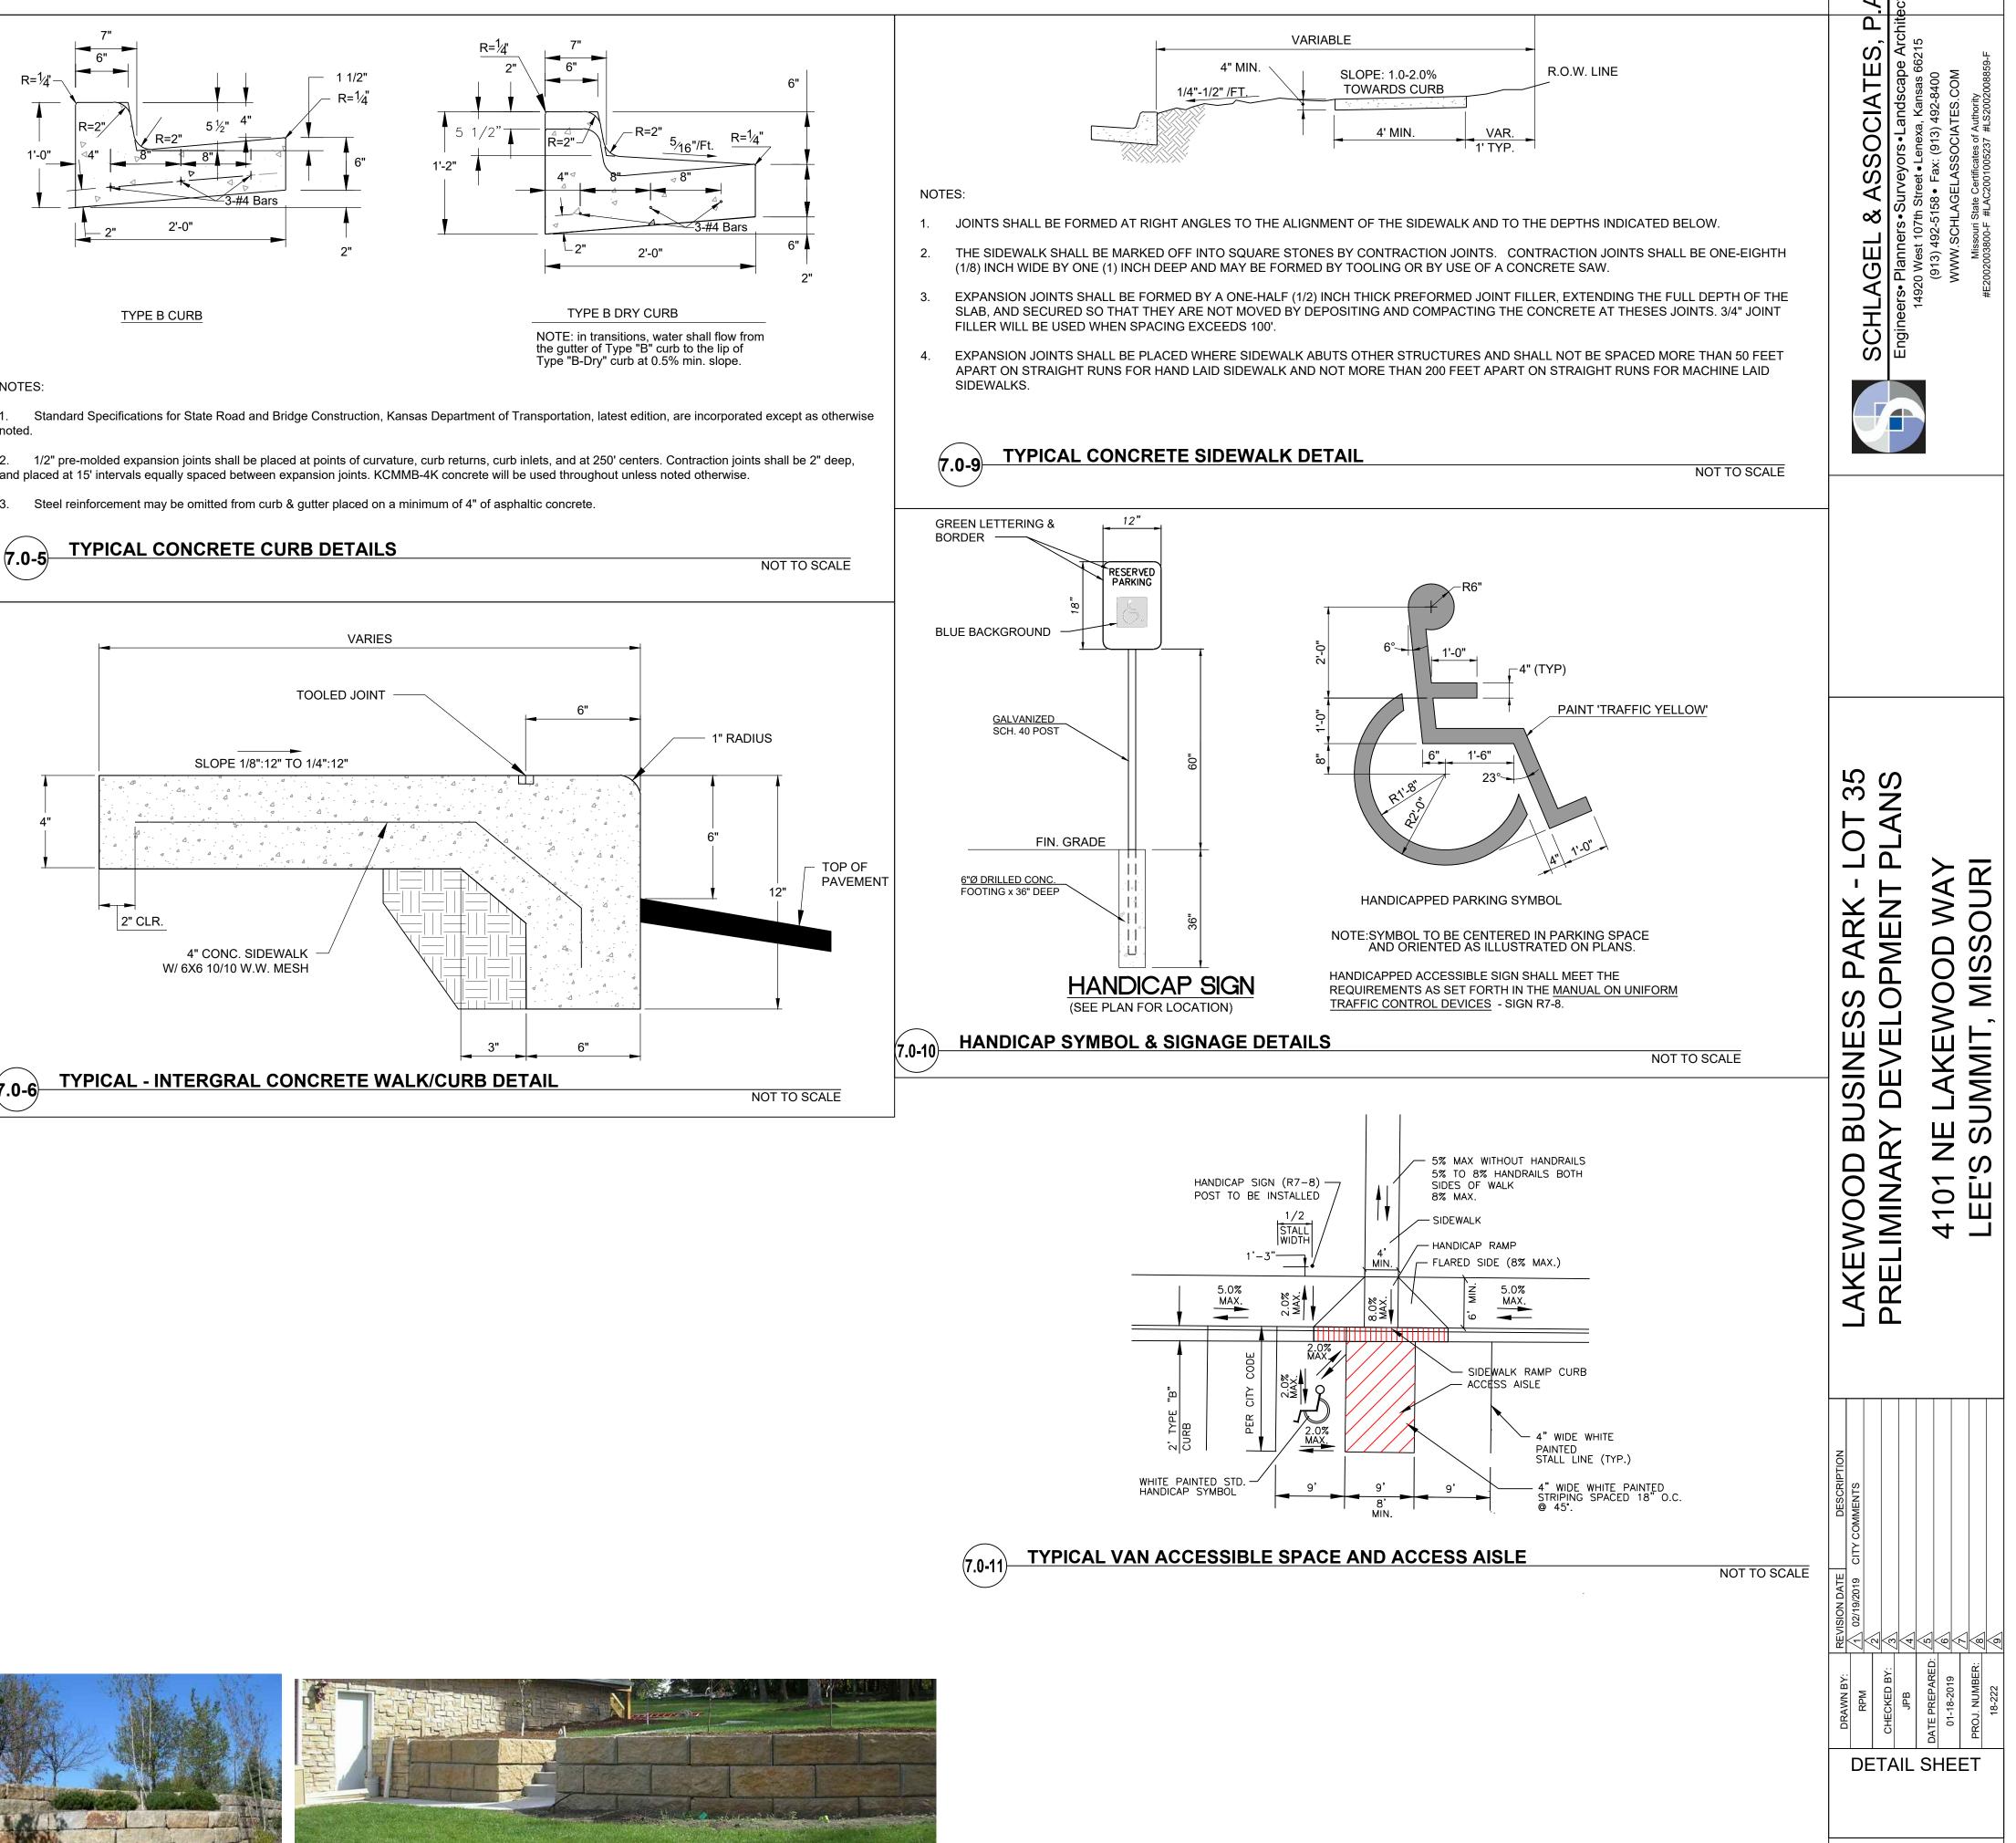

WALL DETAIL <u>(7.0-8)</u>

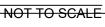


1

J PLAN REVIEW/BID SET

SHEET

SHADE TREES

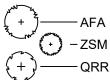

12 EA.

14 EA.

10 EA.


5 EA.

Acer x freemanii 'Armstrong' Zelkova serrata 'Musashino' Quercus robur x bicolor(aka x warei) 'Long'

SHRUBS

0	BSW
Θ	VCK

55 EA. Buxus sinica var. insularis 'Wintergreen' fka a microphylla var. Wintergreen Boxwood Viburnum carlesii 'Korean Spice'

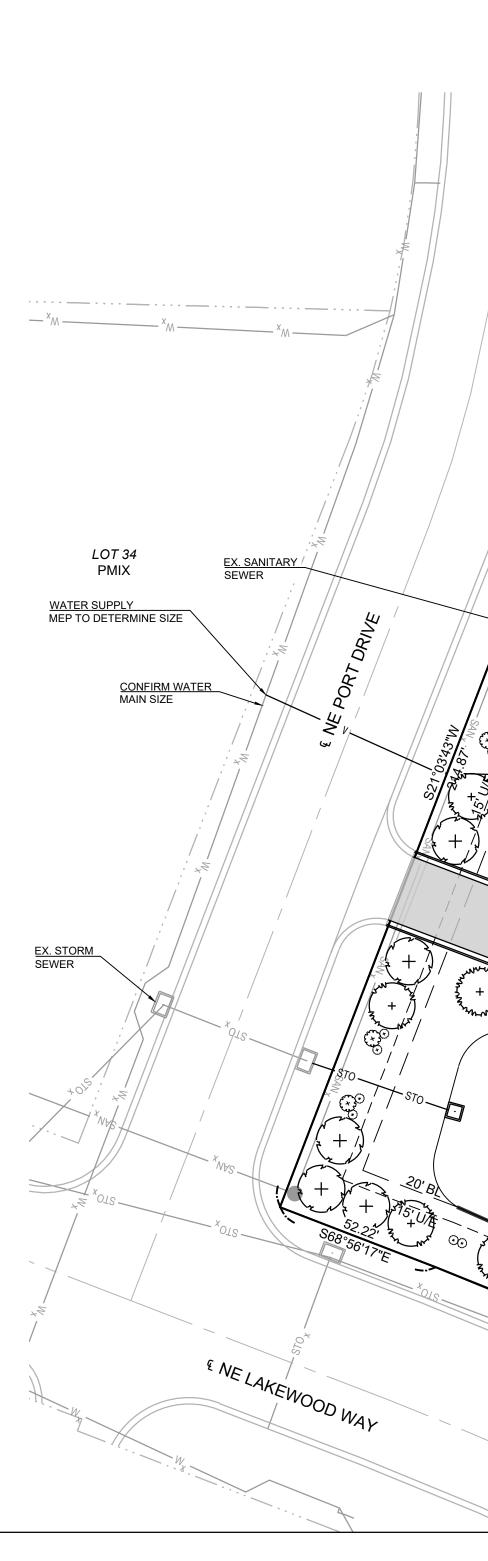

NOTES:

- 1. UTILITY INFORMATION SHOWN IS DESIGNED LOCATION OR LOCATIONS BASED ON UTILITY LOCATES. AS BUILT LOCATIONS MAY VARY. CONTRACTOR SHALL BE RESPONSIBLE FOR LOCATING ALL UTILITIES PRIOR TO COMMENCING LANDSCAPE INSTALLATION. NOTIFY THE LANDSCAPE ARCHITECT OF ANY CONFLICTS OR OBSTRUCTIONS.
- 2. QUANTITIES INDICATED ON THE PLAN ARE FOR CONVENIENCE ONLY. CONTRACTOR SHALL VERIFY ALL PLANT QUANTITIES PRIOR TO PLANTING. NOTIFY THE LANDSCAPE ARCHITECT OF ANY DISCREPANCIES. THE PLAN QUANTITIES AND NUMBER OF SYMBOLS SHALL SUPERSEDED QUANTITIES IN THE SCHEDULE 3. ALL PLANT MATERIAL SHALL COMPLY WITH THE CITY OF LEE'S SUMMIT STANDARDS AND ANSI A60.1 THE AMERICAN STANDARD FOR NURSERY STOCK.
- 4. ALL TREES SHALL MEET THE SIZE REQUIREMENTS OF THE LEE'S SUMMIT ORDINANCE. ALL TREES SHALL BE CALLIPERED AND UNDERSIZED TREES SHALL BE REJECTED. 5. ALL SHRUBS TO BE UTILIZED FOR SCREENING SHALL BE 24" HEIGHT AT TIME OF PLANTING.
- 6. ALL PLANTING BEDS CONTAINING SHRUBS, GROUND COVER, PERENNIALS, ANNUALS SHALL BE IN A PLANTING BED WITH 3" MIN. DEPTH OF MULCH AND A "V-CUT" EDGE.
- ALL TREES SHALL HAVE A MIN. 3 FT. DIA. AREA THAT HAS 3" MIN. DEPTH OF WOOD MULCH. 8. ALL TURF AREAS SHALL BE SODDED UNLESS INDICATED ON THE PLANS. 9. ANY DEVIATION FROM THE APPROVED LANDSCAPE PLAN SHALL REQUIRE WRITTEN APPROVAL OF THE
- LANDSCAPE ARCHITECT AND THE CITY OF LEE'S SUMMIT, PRIOR TO INSTALLATION. 10. THE LANDSCAPE ARCHITECT AND OWNER SHALL APPROVE GRADES AND CONDITION OF SITE PRIOR TO SODDING OPERATIONS.
- 11. INSTALLATION AND MAINTENANCE OF LANDSCAPING SHALL COMPLY WITH THE CITY OF LEE'S SUMMIT STANDARDS
- 12. ALL PLANT MATERIAL SHALL BE INSTALLED TO ALLOW A MINIMUM CLEARANCE BETWEEN PLANT AND ADJACENT PAVEMENT OF 1 FT. FOR PERENNIALS AND GROUNDCOVER AND 1.5 FT. FOR SHRUBS. A 2 FT. CLEARANCE(4 FEET FROM BACK OF CURB TO THE CENTER OF SHRUB)FOR CAR OVERHANG IS REQUIRED AT ALL PARKING ISLANDS AND PERIMETERS.
- 13. AFTER COMPLETE INSTALLATION OF ALL PLANT MATERIAL AND SOD THE CONTRACTOR SHALL NOTIFY THE LANDSCAPE ARCHITECT THAT THE WORK IS COMPLETE AND READY FOR REVIEW. THE LANDSCAPE ARCHITECT SHALL REVIEW THE LANDSCAPE INSTALLATION TO DETERMINE COMPLIANCE WITH THE APPROVED PLANS. WHEN THE LANDSCAPE INSTALLATION MEETS THE REQUIREMENTS OF THE APPROVED PLAN, THE LANDSCAPE ARCHITECT SHALL PROVIDE A SIGNED AND SEALED LETTER TO THE CITY STATING THAT ALL LANDSCAPE PLANTINGS HAVE BEEN INSTALLED PER THE APPROVED PLAN.
- 14. ALL EXTERIOR GROUND OR BUILDING MOUNTED EQUIPMENT (MECHANICAL, ELECTRICAL AND/OR TELEPHONE CABINETS), TRANSFORMERS, AIR CONDITIONING UNITS, ETC. SHALL BE SCREENED FROM PUBLIC VIEW BY INSTALLING FIVE SEA GREEN JUNIPERS EVENLY SPACED AROUND THE PERIMETER. FINAL LOCATION OF ANY EQUIPMENT SHALL BE DETERMINED AND VERIFIED WITH THE FINAL DESIGN AND PERMITTING OF THE PROJECT.
- 15. ALL ROOFTOP EQUIPMENT SHALL BE SCREENED FROM PUBLIC VIEW WITH AN ARCHITECTURAL TREATMENT COMPATIBLE WITH THE BUILDING AND INTEGRAL TO THE OVERALL APPEARANCE OF THE BUILDING.

LANDSCAPE DATA LOT 1 ONLY


LAKEWOOD WAY SHRUBS REQUIRED(1 PER 20')(160.55'/20') LAKEWOOD WAY SHRUBS PROVIDED PORT DRIVE SHRUBS REQUIRED(1 PER 20')(286.13'/20') PORT DRIVE SHRUBS PROVIDED

TREES REQUIRED (1 PER 5,000 S.F OF OPEN SPACE)(124,458.3-24,000/5000) TREES PROVIDED

SHRUBS REQUIRED (2 PER 5,000 S.F. OF LOT AREA)(124,458.3-24,000/5000X2) SHRUBS PROVIDED

PARKING LOT LANDSCAPE

LANDSCAPE AREA REQUIRED(5% OF PARKING AREA)(9499.0X.05) LANDSCAPE AREA PROVIDED TREES REQUIRED(1 PER ISLAND) TREES PROVIDED SCREENING(2.5 FT. HT ALONG ENTIRE FRONTAGE ADJ. TO STREET)

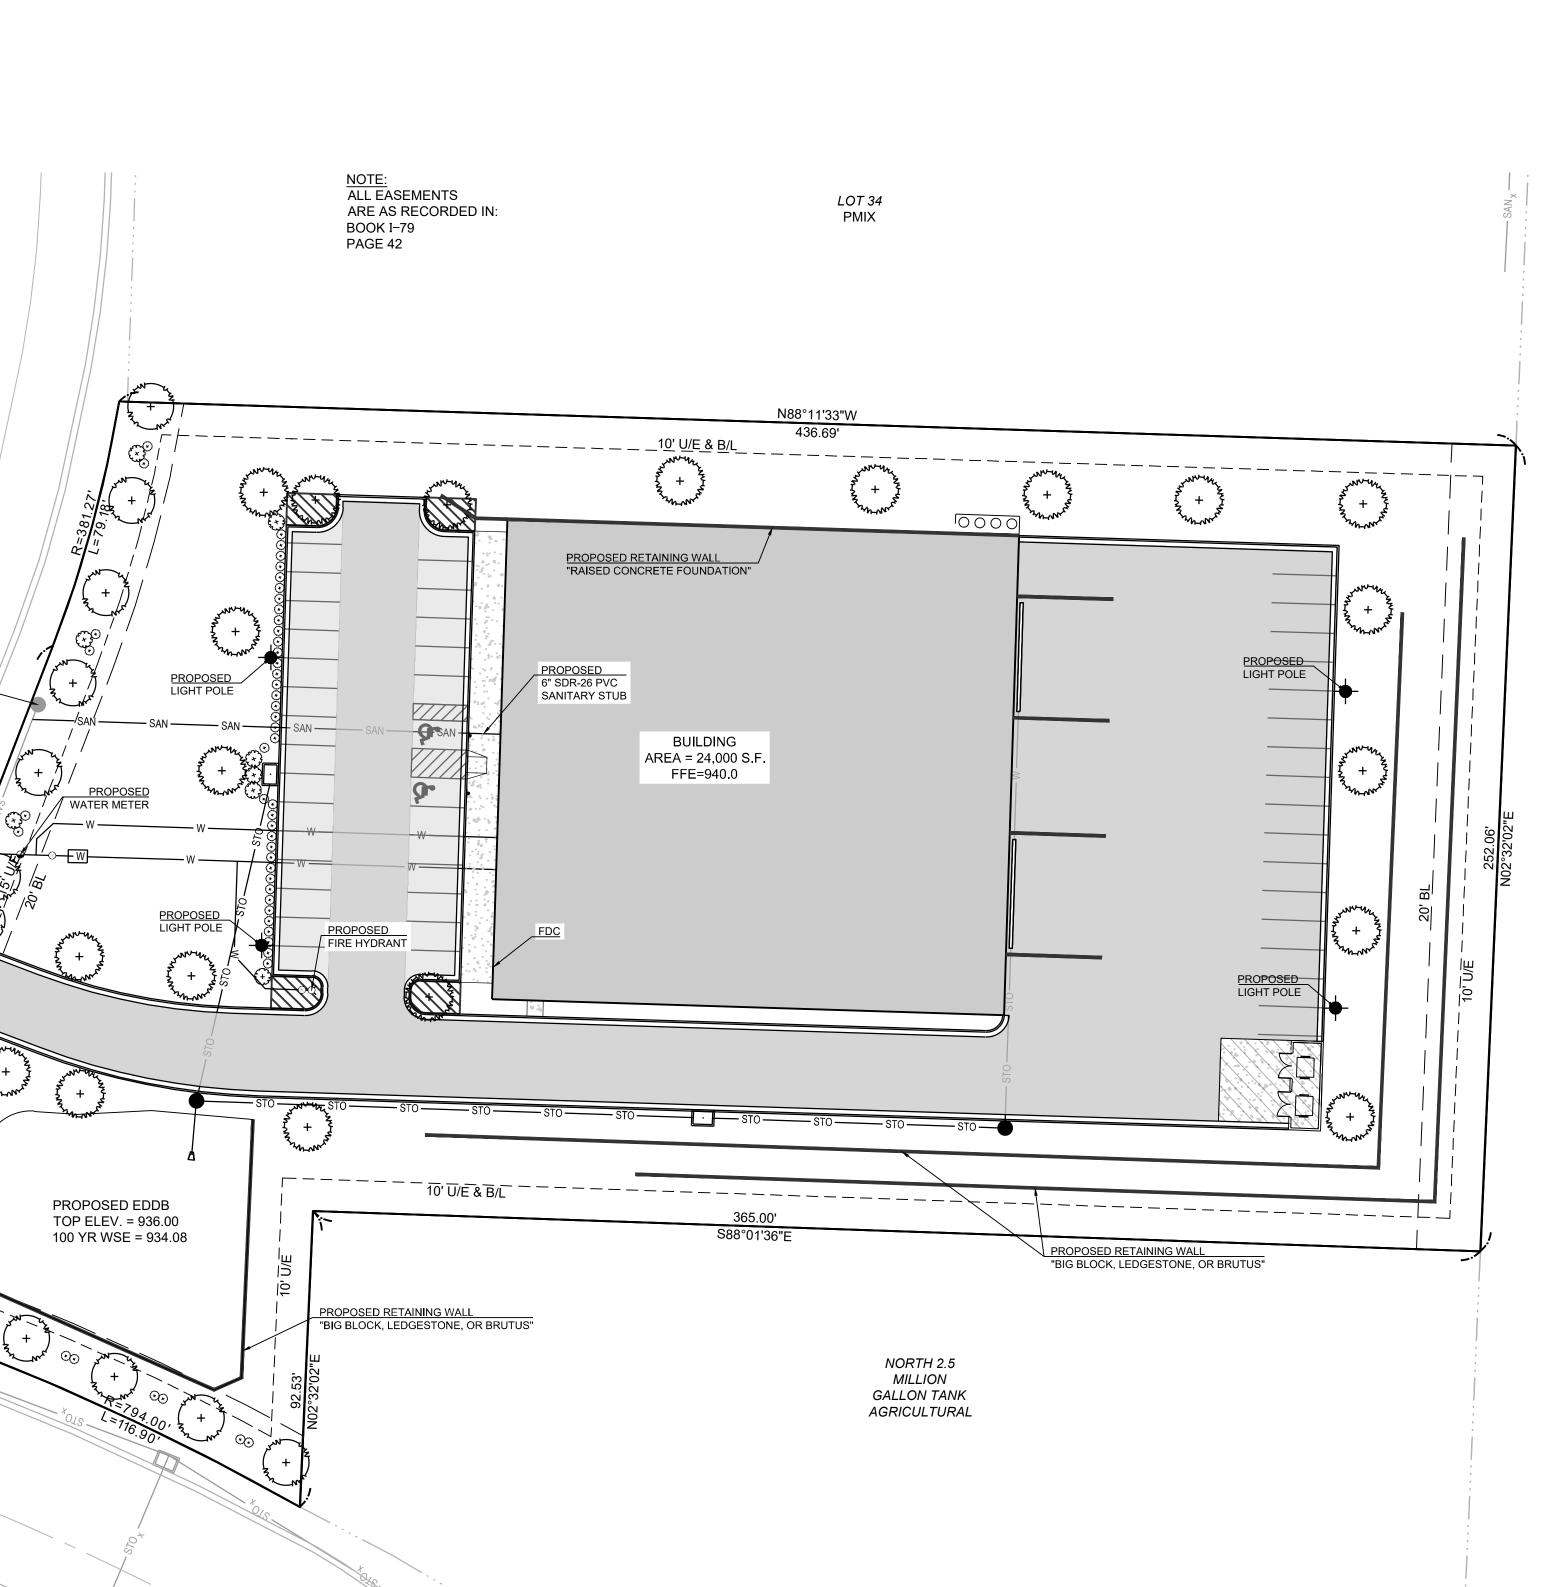

Armstrong Maple 3" Cal. B&B Musashino Columnar Zelkova 3" Cal. B&B Regal Prince Oak 3" Cal. B&B Cont. 5 gal. Cont. Hughes Juniper 5 gal. Koreanspice Viburnum 5 gal. Cont.

STREET FRONTAGE LANDSCAPE

LAKEWOOD WAY TREES REQUIRED(1 PER 30')(160.55'/30') LAKEWOOD WAY TREES PROVIDED PORT DRIVE TREES REQUIRED(1 PER 30')(286.13'/30') PORT DRIVE TREES PROVIDED

SITE LANDSCAPE REQUIRED

6 TREES 6 NEW TREES 10 TREES 11 NEW TREES


8 SHRUBS 8 SHRUBS(PARKING LOT SCREEN) 15 SHRUBS 15 SHRUBS(PARKING LOT SCREEN)

20 TREES 20 TREES 40 SHRUBS 58 SHRUBS(58 FOR PARKING LOT SCREEN)

475.0 S.F 650.0 S.F 4 TREES 4 TREES 43 SHRUBS



KELLEY 1204 NE LEE'S SU

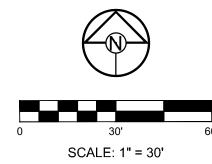




S S ς Σ Υ \vdash 1 Ó ר ר WAY - ARK -MENT ΟŇ NIS: Δ SO LAKEWOOD BUSINES PRELIMINARY DEVEL VE LAKEW SUMMIT, َ کُ _{اِلْ} $\overline{}$ 101 EE 4




4 OF

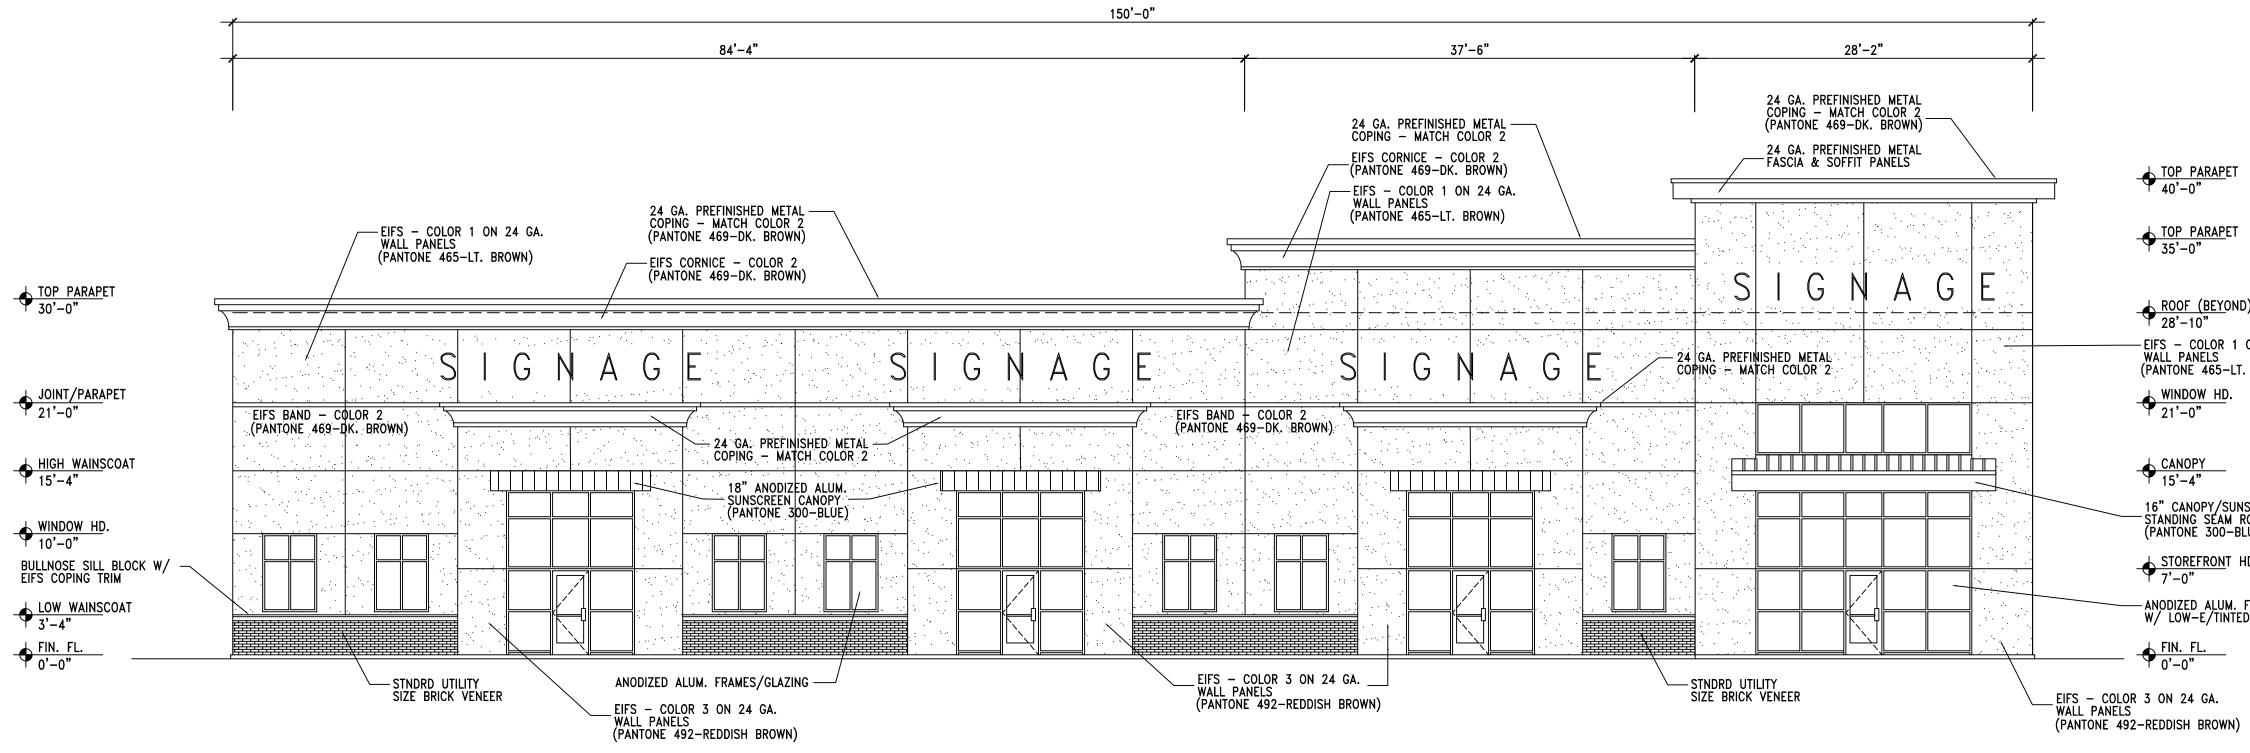


WEST ELEVATION

1/8" = 1'-0"


TOP PARAPET + ROOF (BEYOND) 28'−10" — EIFS — COLOR 1 ON 24 GA. WALL PANELS (PANTONE 465—LT. BROWN) ← CANOPY 15'-4" 16" CANOPY/SUNSCREEN W/ — STANDING SEAM ROOF PANELS (PANTONE 300-BLUE) — ANODIZED ALUM. FRAME STOREFRONT W/ LOW-E/TINTED GLAZING ← FIN. FL. 0'-0"

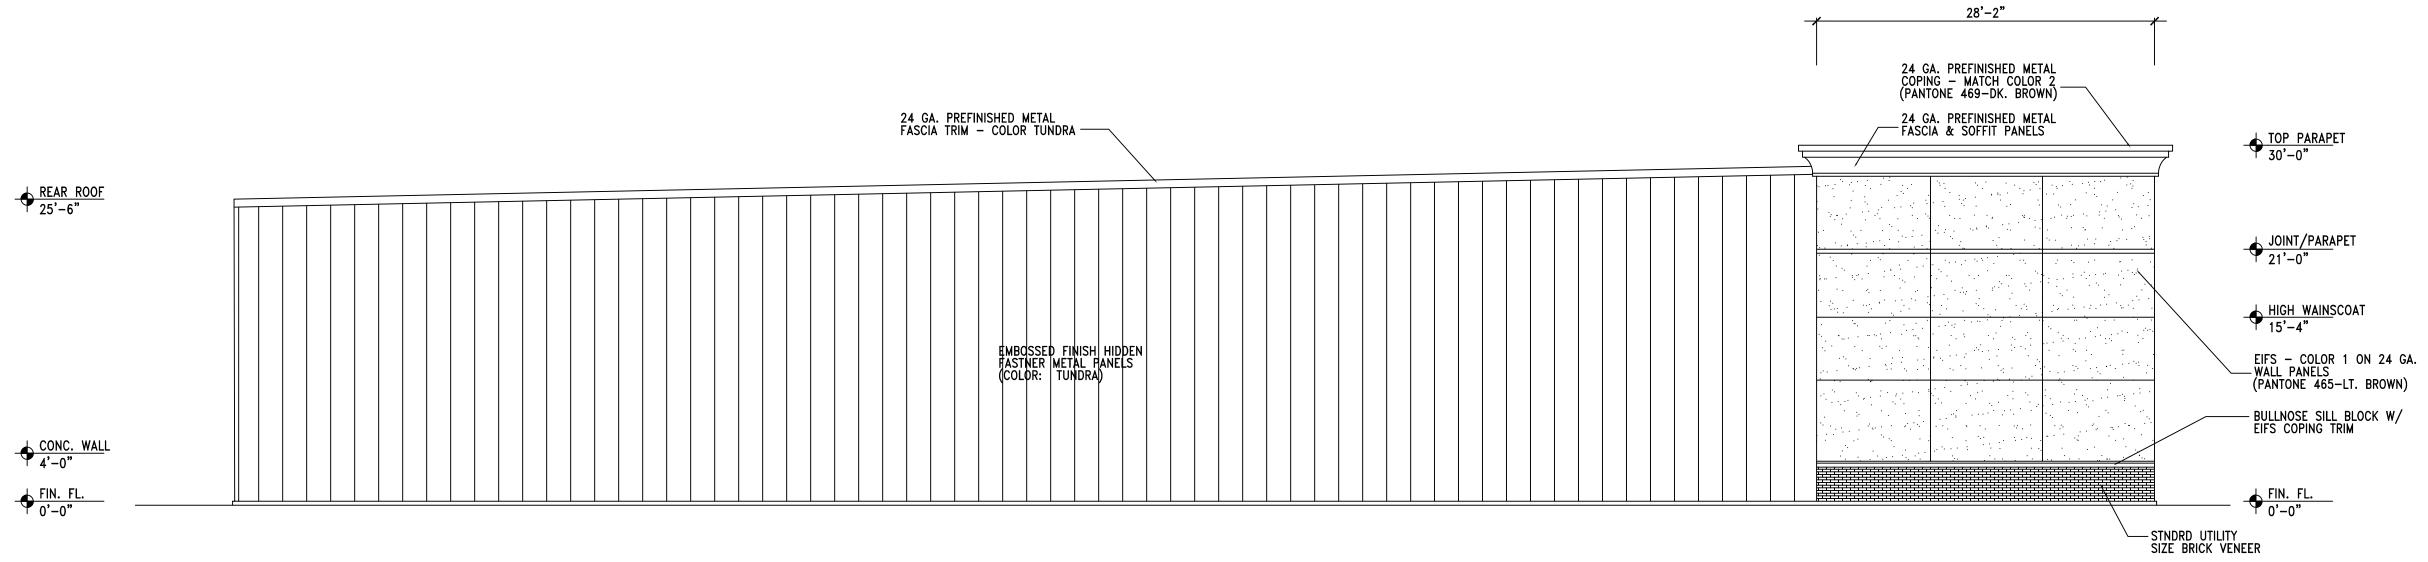



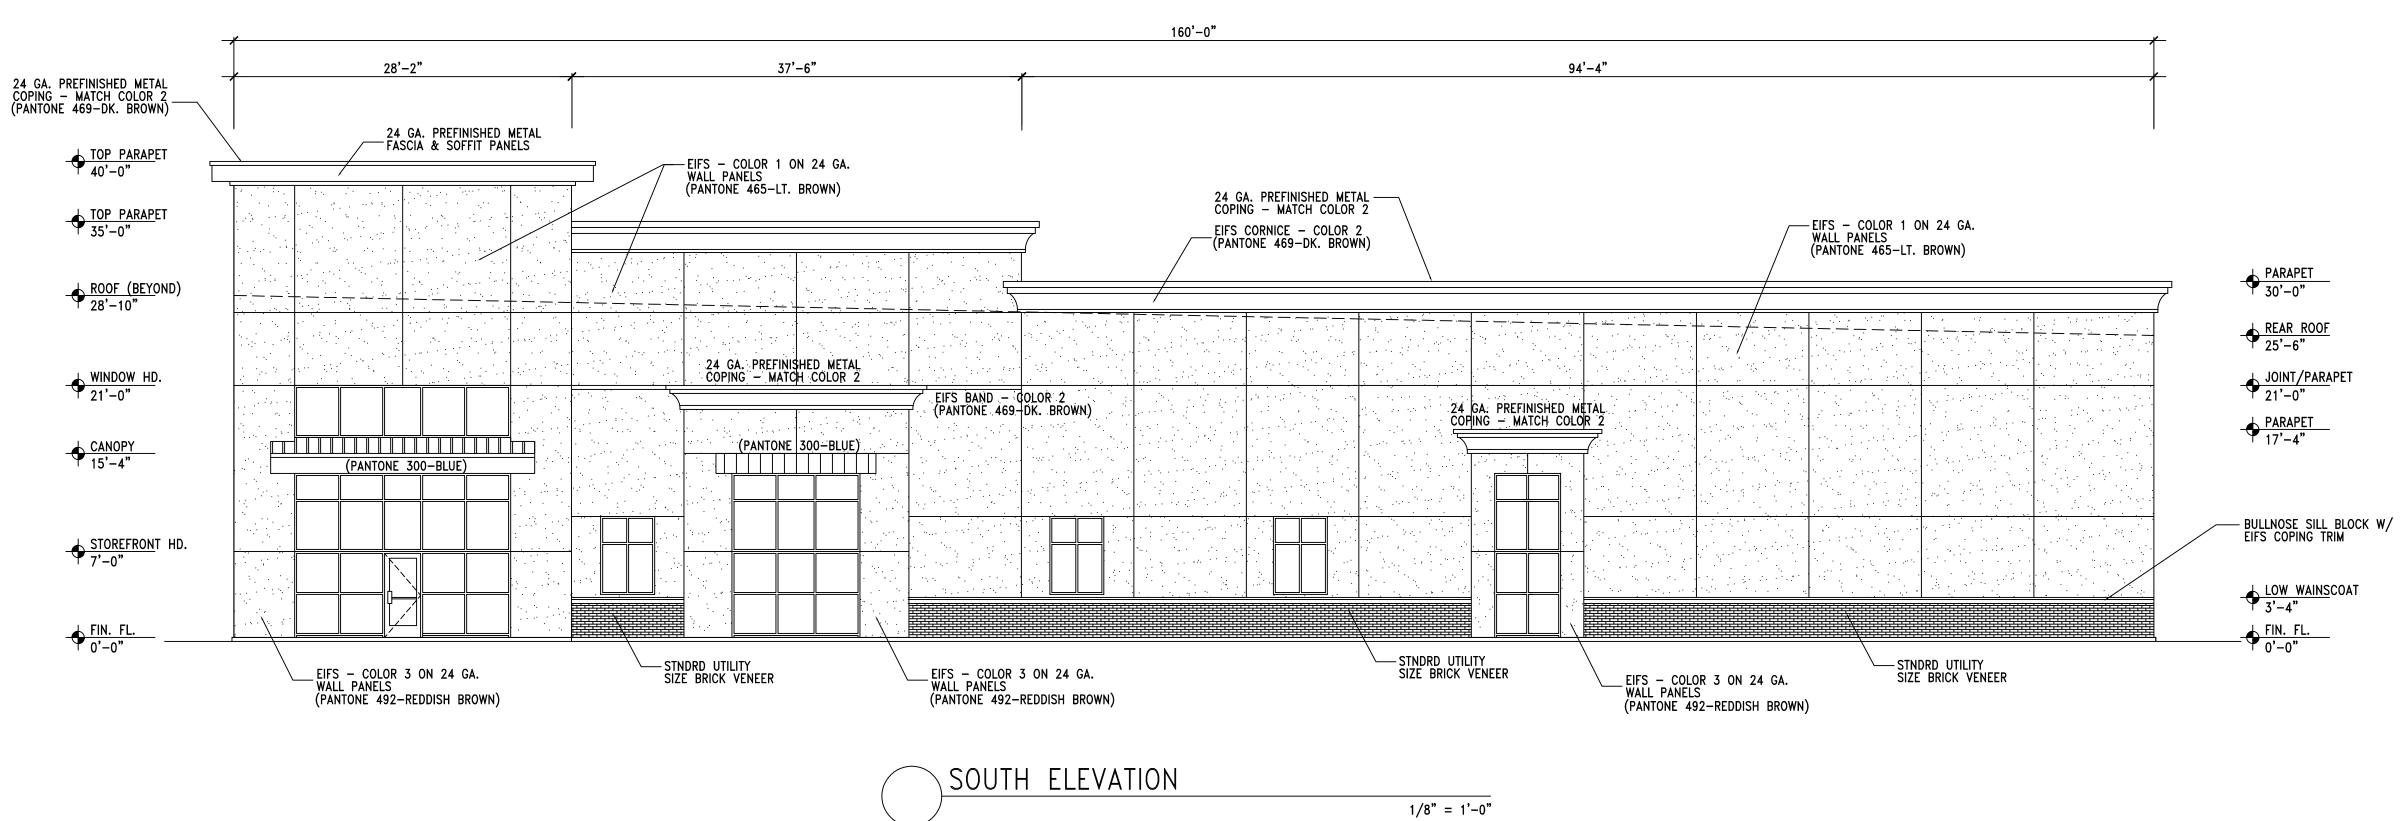




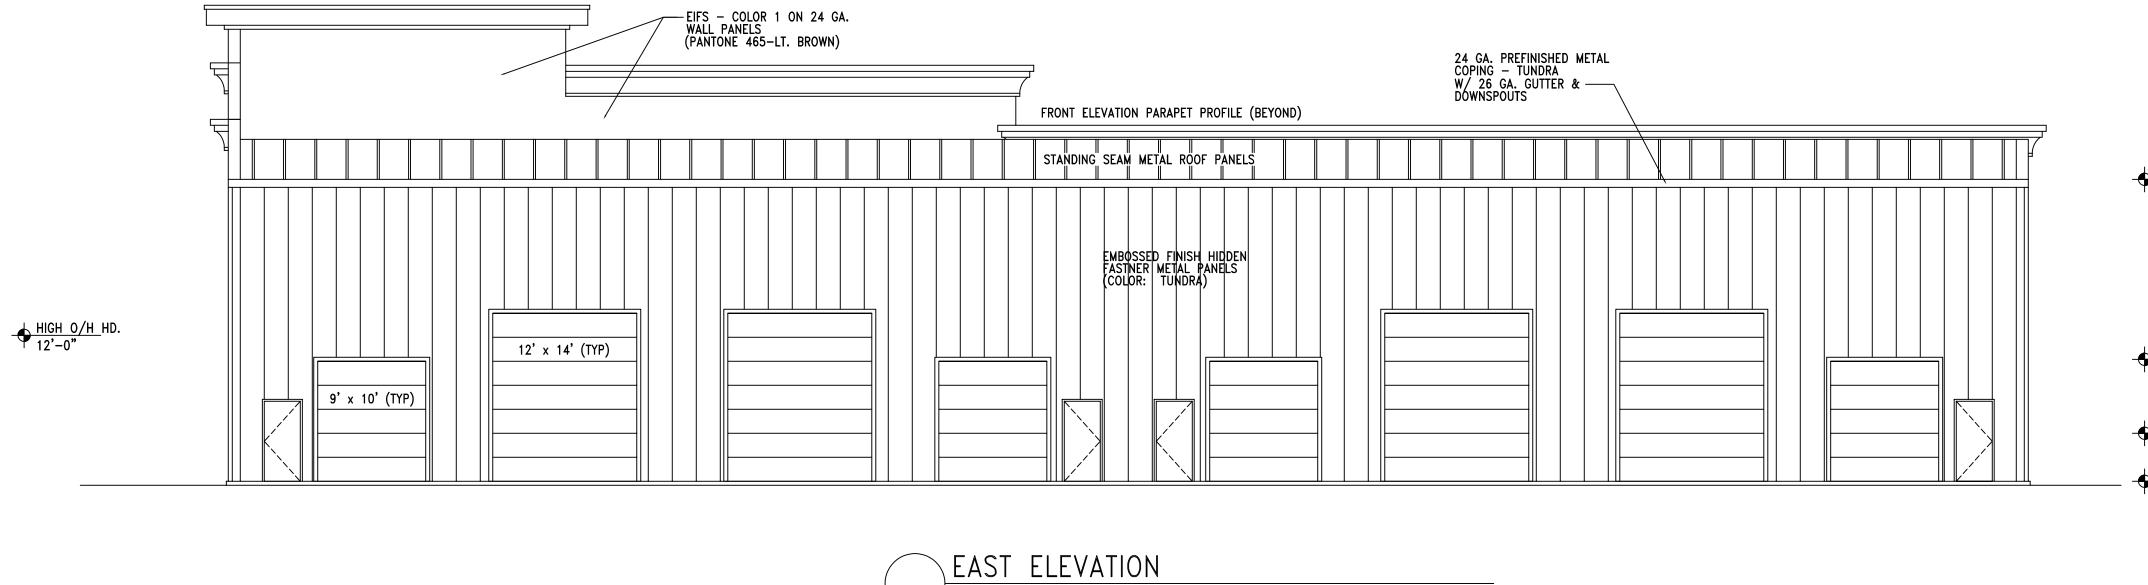


1/8" = 1'-0"


<u>↓ LOW 0/H H</u>D. 10'-0"

REAR ROOF 25'-6"

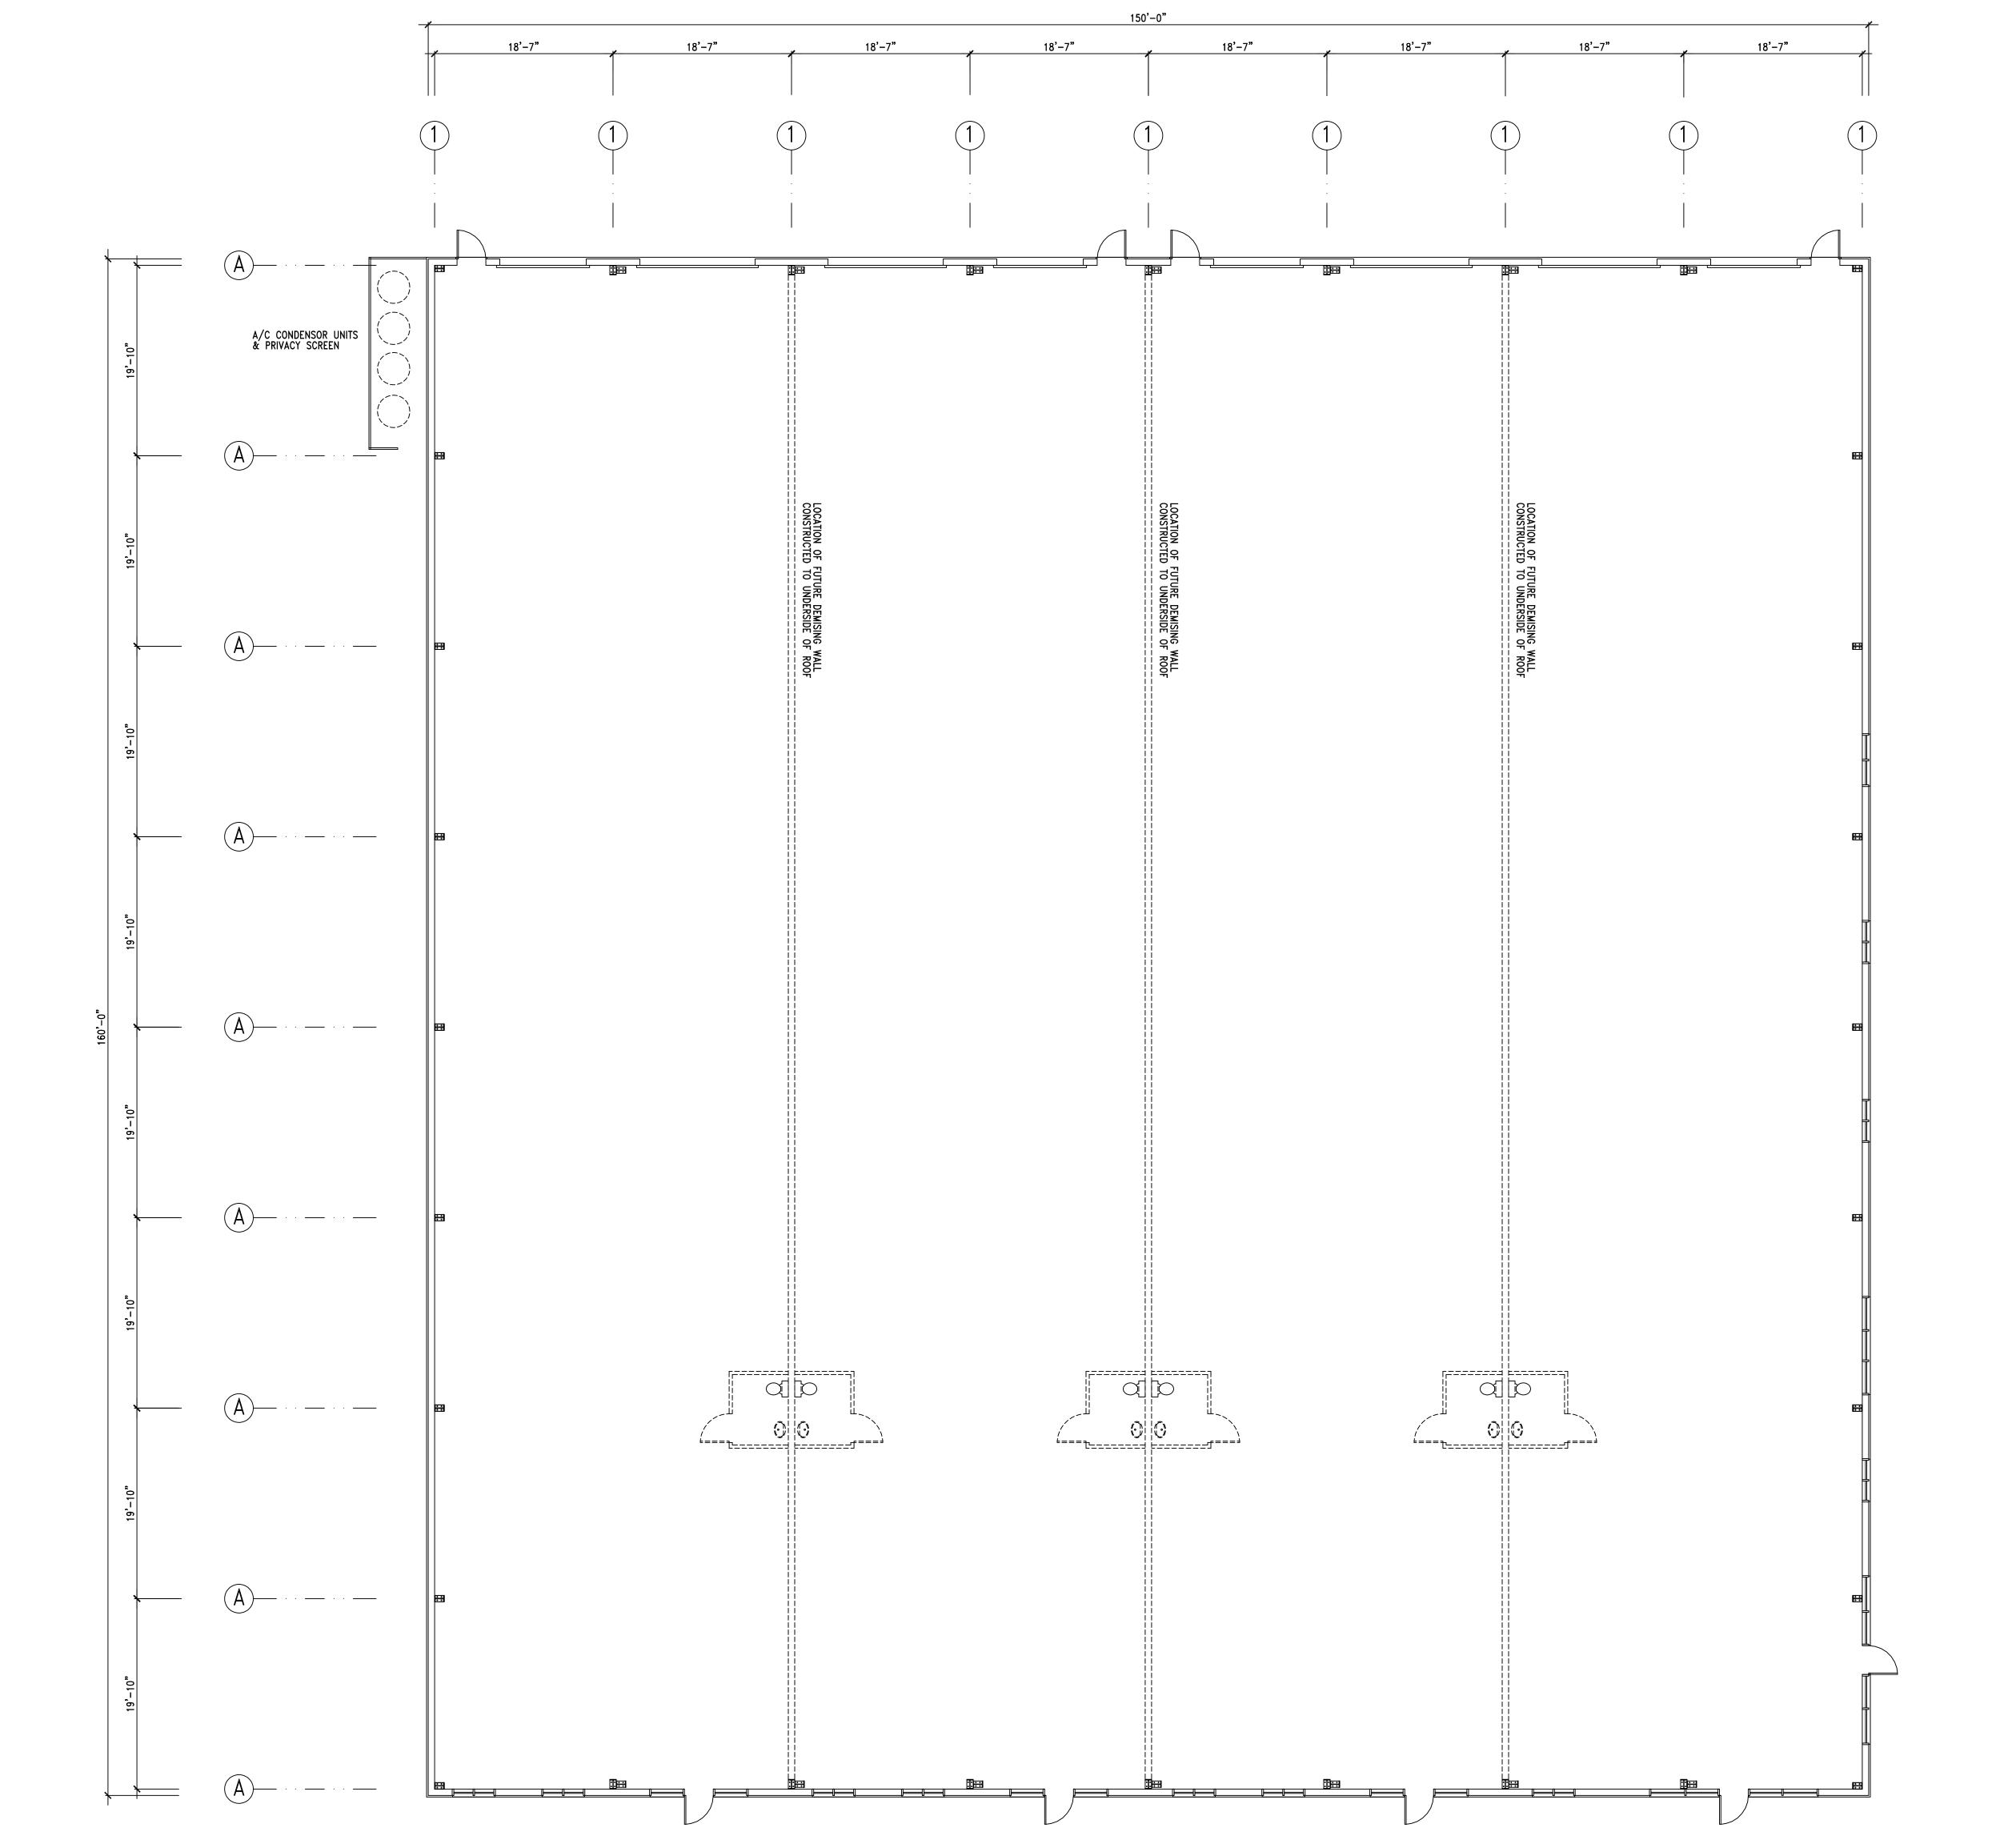


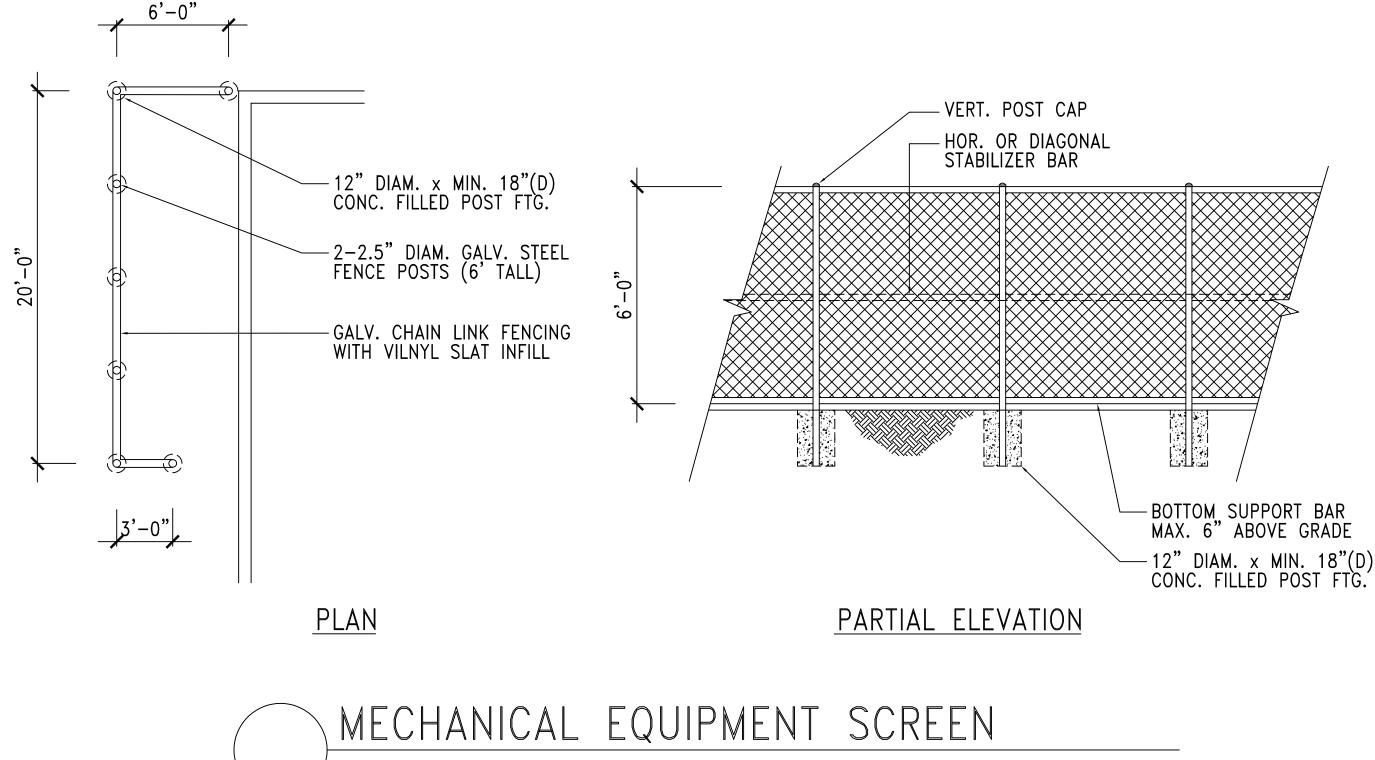

1/4" = 1'-0"

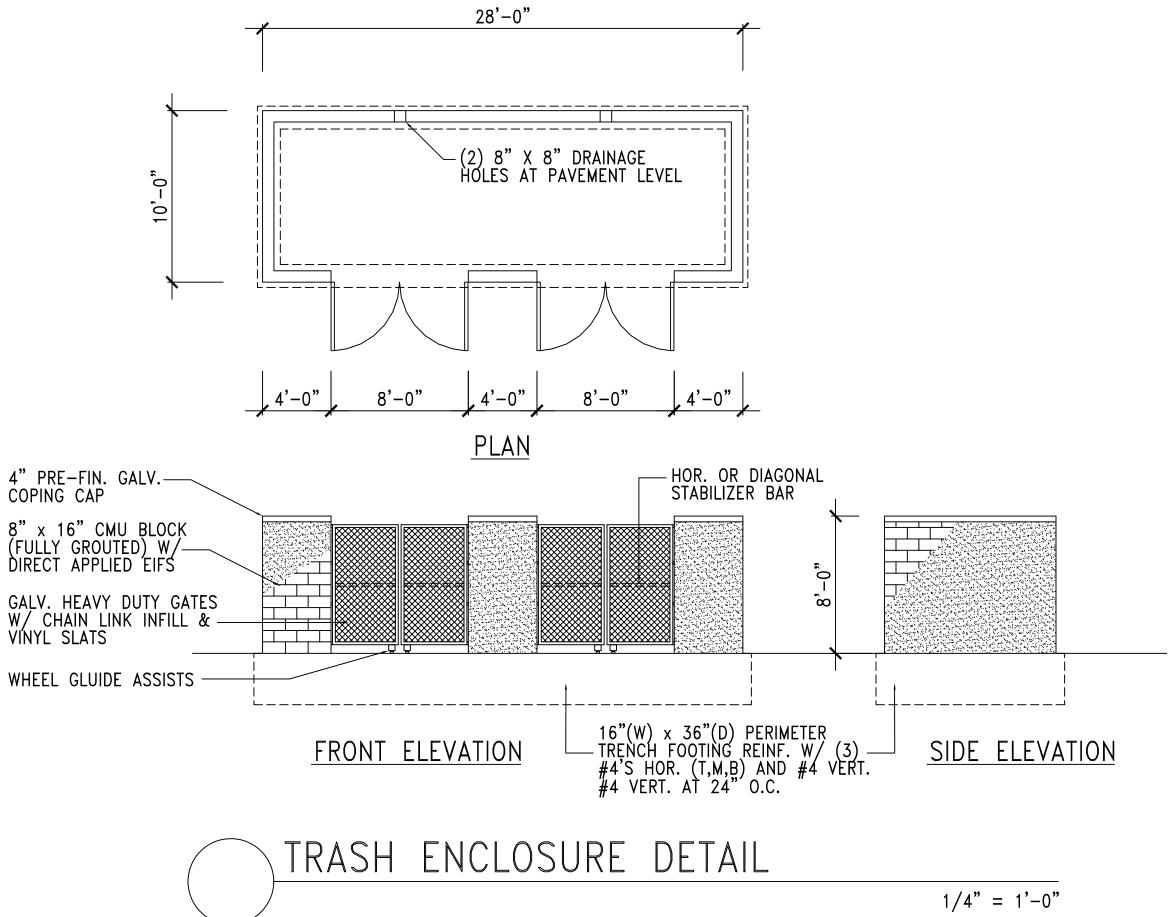

0.0 •0.1/ /^{*}0.1 / •0.2 / ^{*}0.3 •0.3 •0.3 •0.6 •1.8 || ^{**}1.9 ^{**}2.0 ^{**}1.7 ^{**}1.4 || ^{**}1.1 ^{**}1.8 *****0.1 / *****0.7/ *****0.2 / *****0.3 / *****0.5 *****0.7 *****0.8 *****1.6 *****3.4 *****3.5 *****3.2 *****2.5 *****1.8 *****1.3 *****0.8 [•]0.1⁄∕/[•]0.2 [•]0.2/[•]0.3 [•]0.6 [•]0.9 [•]1.5 [•]2.1 [•]4.7 [•]4.4 [•]3.5 ^{*}2.6 ^{*}1.9 [•]1.3 [•]0.8 *****0.1 /*****0.2 // *****0.2 *****0/3 / *****0.4 *****0.7 *****0.9 *****1.3 *****1.9 *****4.3 *****4.2 *****3.5 *****2.6 *****1.9 *****1.3 *****0.9 • 0.1 / • 0.2 / / • 0.3 / • 0.4 • 0.6 • 0.7 • 0.8 • 0.8 • 1.1 • 2 2 • 2.3 • 2.3 • 2.0 • 1.6 • 1.3 •0.1/ /^{*}0.2 •0.3 / ^{*}0.4 •0.5 •0.6 •0.8 •0.9 •1.0 •1.3 ^{*1}2.0 ^{*1}2.0 ^{*1}2.0 ^{*1}1.7 ^{*1}1.4 ^{*1}1.1 [•]0.1 */*0.1 *// /*0.2 [•]0,3 */*[•]0.4 [•]0,6 [•]0.7 [•]0.9 [•]1.0 [•]1.1 [•]1.4 [•]∦.9 [•]1.9 ^{||}[•]1.8 [•]1.6 [•]1,3 [•]1.1 / to.1 / to/1 / to.2 / to.3 to.4 / to.6 to.8 to.0 to.1 to.2 to.5 to.8 to.7 1.2 to.5 to.8 to.7 1.5 to.7 0.1 10.1 10.1 10.2 10.3 10.4 10.6 10.8 1.1 1.2 1.5 1.9 12.1 1.8 1.5 1.4 1.1 10.8 •0.1 •0.1 **•**0.1 **•**0.2 •0.3 •0.4 •0.6 •0.8 •1.0 •1.2 •1.7 •2.2 **•**2.3 **•**1.8 **•**1.4 **•**1.2 **•**1.0 **•**0.8 0.1 10.1 0.1 0.2 0.3 0.4 0.6 0.8 1.0 1.2 1.6 2.0 2.0 1.3 1.1 0.9 0.7 0.0 1.0 1.1 0.1 0.2 0.3 0.4 0.6 0.8 1.0 1.1 1.3 1.6 1.6 1.6 1.4 1.3 1.2 1.4 1.0 1.1

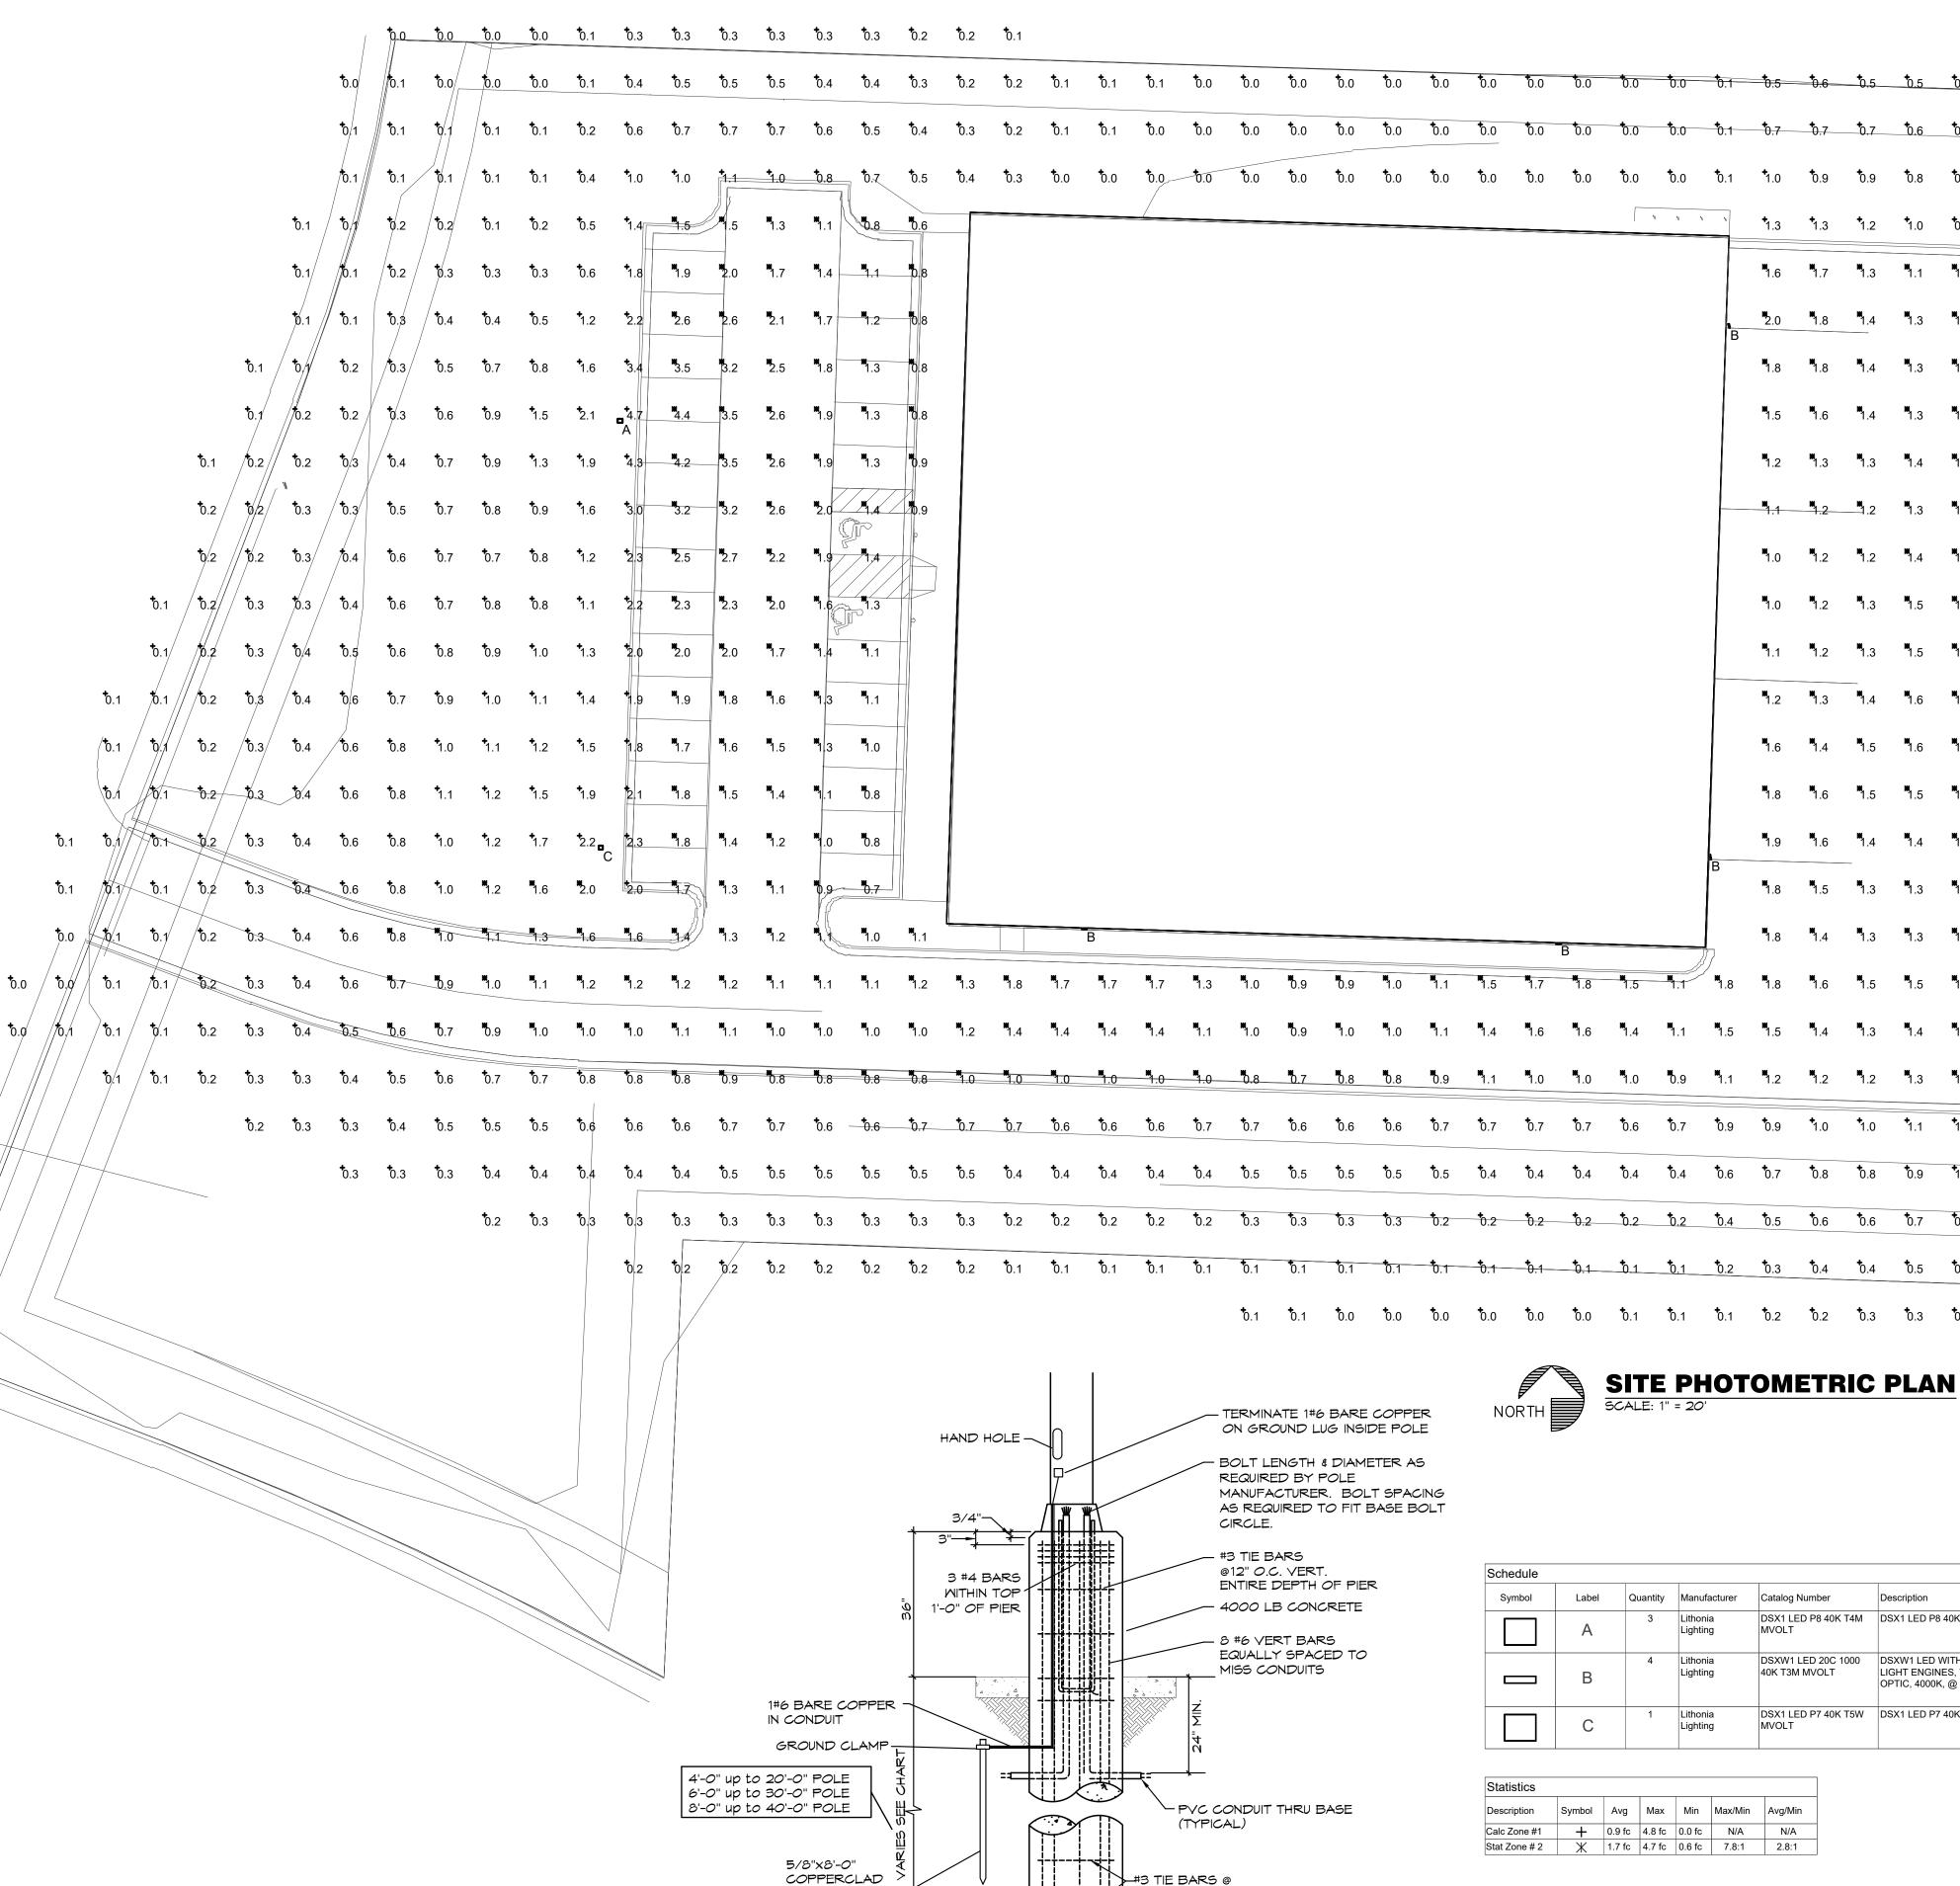

POLE FOUNDATION DETAIL SCALE: NONE

—24" —

12"0.C. VERT. -----

GROUND ROD -

3" CLEAR COVER (TYP.) ---

5	* 0.6	* 0.5	† 0.5	† 0.5	* 0.4	* 0.4	† 0.3	† 0.3	* 0.3	* 0.2	* 0.1				
.7—	* 0.7	* 0.7	† 0.6	* 0.6	* 0.6	† 0.5	• 0.5	† 0.5	* 0.5	* 0.3	* 0.1	* 0.0	* 0.0	* 0.0	* 0.1
.0	* 0.9	† 0.9	* 0.8	* 0.8	* 0.7	* 0.7	* 0.8	* 0.7	* 0.7	* 0.4	* 0.1	* 0.1	* 0.1	* 0.1	* 0.1
.3	* 1.3	* 1.2	* 1.0	* 0.9	* 0.9	* 1.0	* 1.1	* 1.1	* 1.0	• 0 .6	* 0.1	* 0.1	* 0.1	• 0.1	* 0.1
.6	* 1.7	* 1.3	* 1.1	# 1.1	* 1.1	* 1.2	** 1.4	* 1.5	* 1.5	* 1.0	• 0.2	• 0.2	* 0.1	• 0.2	• 0.1
.0	* 1.8	** 1.4	** 1.3	** 1.3	** 1.5	** 1.7	* 1.9	* 2.0	* 1.8	* 1.2	* 0.4	• 0.2	* 0.2	* 0.2	• 0.1
.8	* 1.8	** 1.4	** 1.3	** 1.4	** 1.7	* 2.1	* 2.5	* 2.7	2.4	* 1.7	* 0.6	* 0.4	0 .3	• 0.3	• 0.1
.5	# 1.6	** 1.4	* 1.3	# 1.5	# 1.8	* 2.3	* 3.1	3 .5	*3 .5	* 2.4	* 0.9	* 0.7	0.5	* 0.3	* 0.1
.2	# 1.3	# 1.3	** 1.4	# 1.5	* 1.9	** 2.4	* 3.2	** 4.1	[#] 4.7 A	* 3.2	* 1.1	* 0.9	† 0.5	* 0.3	* 0.1
.1	# 1.2	* 1.2	* 1.3	# 1.6	* 2.0	* 2.6	** 3.3	# 4.0	* 4.3	* 2.7	* 1.0	* 0.9	† 0.5	* 0.3	* 0.1
.0	# 1.2	* 1.2	** 1.4	# 1.7	** 2.2	* 2.6	* 3.1	3 .2	3 .0	* 2.0	* 0.7	* 0.5	* 0.4	* 0.3	* 0.1
.0	* 1.2	# 1.3	* 1.5	# 1.8	* 2.1	** 2.4	* 2.7	2.7	2.4	* 1.2	0.5	* 0.4	† 0.3	•0.3	* 0.1
.1	* 1.2	* 1.3	* 1.5	* 1.7	* 1.9	* 2.2	* 2.4	* 2.4	2 .3	* 1.1	0 .3	* 0.2	* 0.3	• 0.3	• 0.2
.2	# 1.3	* 1.4	* 1.6	* 1.7	* 1.9	* 2.1	* 2.3	* 2.3	* 2.2	* 1.1	* 0.2	* 0.2	* 0.2	* 0.2	
.6	* 1.4	* 1.5	** 1.6	* 1.7	* 1.9	* 2.1	* 2.4	** 2.4	* 2.3	* 1.0	* 0.3	* 0.2	* 0.2	•0.2	
.8	* 1.6	* 1.5	# 1.5	* 1.7	* 2.0	* 2.3	* 2.6	* 2.6	* 2.3	* 0.9	* 0.4	 ₽_0.3	* 0.3	t 0.3	
.9	* 1.6	** 1.4	** 1.4	# 1.7	* 2.1	* 2.5	* 3.0	** 3.0	* 2.6	* 1.4	† 0.5	• 0 .4	* 0.4	• 0.3	
.8	* 1.5	# 1.3	* 1.3	** 1.6	* 2.1	* 2.7	* 3.4	* 3.8	* 3.7	* 1.7	• 0.8	† 0.6	• 0.5	0.3	
.8	* 1.4	# 1.3	* 1.3	** 1.5	* 2.0	* 2.6	3.5	* 4.4	4 ∎8 A	* 2.1	* 1.4	0 .8	0.5	0.2	
.8	* 1.6	# 1.5	* 1.5	** 1.6	* 2.0	* .6	3.3	* 3.9	* 4.0	* 1.7	* 1.1	† 0.7	0.5	0.2	
.5	¤ 1.4	# 1.3	** 1.4	** 1.6	* 2.0	* 2.3	2.8	2.8	* 2.6	* 1.2	• 0.6	† 0.5	* 0.4	* 0.2	
.2	# 1.2	* 1.2	* 1.3	# 1.5	** 1.7	* 1.9	2.3	<u>*</u> 2.1	† 1.9	* 0.7	* 0.3	* 0.3	† 0.3	* 0.2	
.9	* 1.0	* 1.0	* 1.1	* 1.2	* 1.4	† 1.5	* 1.7	* 1.6	† 1.6	* 0.4	* 0.2	* 0.2	* 0.2	* 0.2	
.7	† 0.8	† 0.8	* 0.9	* 1.0	• 1.1	† 1.2	• 1.2	* 1.2	+ 1.1	* 0.4	* 0.1	* 0.1	•0.1	* 0.1	
.5	† 0.6	† 0.6	† 0.7	* 0.7	0 .8	• 0.9	• 0.9	* 0.8	+ 0.7	† 0.2	* 0.1	t 0.1	•0.1	* 0.1	
.3	• 0.4	* 0.4	† 0.5	† 0.5	• 0.6	* 0.6	• 0.6	• 0.6	† 0.5	* 0.1	t 0.0	0.0	* 0.1	• 0.1	
.2	† 0.2	* 0.3	* 0.3	* 0.4	* 0.4	* 0.4	† 0.4	† 0.4	* 0.3	* 0.1	* 0.0	† 0.0	* 0.0	† 0.0	

atalog Number	Description	Lamp	Number Lamps	Mounting Height	Lumens Per Lamp	Light Loss Factor	Wattage
SX1 LED P8 40K T4M VOLT	DSX1 LED P8 40K T4M MVOLT	LED	1	25'-0"	23740	0.9	207
SXW1 LED 20C 1000 K T3M MVOLT	DSXW1 LED WITH (2) 10 LED LIGHT ENGINES, TYPE T3M OPTIC, 4000K, @ 1000mA.	LED	1	20'-0"	7572	0.9	73.2
SX1 LED P7 40K T5W VOLT	DSX1 LED P7 40K T5W MVOLT	LED	1	25'-0"	21384	0.9	183

S 2/14/2019 35 NS $\vdash \Sigma$ လဝ 1 NE PORT SUMMIT, I LAKEWOOD BUSINES PRELIMINARY DEVEL 410⁻ EE'S ¹/ PHOTOMETRIC SITE PLAN SHEET NGINEERS PH-' INCORPORATED OF 1

5720 Reeder Shawnee, Ks. 66203 (913)262-1772

This drawing has been prepared by the Engineer, or under his supervision. This drawing is provided as

an instrument of service by the Designer/Indiana is intended for use on this project only. Pursuant to the Architectural Works Copyright Protection Act of 1990, all drawings, specifications, ideas and

designs, including the overall form, arrangement and composition of spaces and elements appearing herein, constitute the original, copyrighted work of the Designer/Engineer. Any reproduction, use, or disclosure of information contained herein without prior written consent of the Engineer is strictly prohibited. © 2019 BC Engineers, Inc.

PE COA #2009003629

MISSOURI