

PROJECT INFORMATION:

TOWER INFORMATION

LAT: 38° 54' 49.83" N
LONG: 94° 22' 34.78" W
ELEV: 1,024'
SITE TYPE: MONOPOLE
COUNTY: JACKSON
JURISDICTION: CITY OF LEE'S SUMMIT
LANDLORD SITE ID #: 877803

APPLICANT

SPRINT
6580 SPRINT PARKWAY
OVERLAND PARK, KANSAS 66251
PHONE:

LANDLORD

CROWN CASTLE
2000 CORPORATE DR
CANONSBURG, PA 15317

TOWER SCOPE OF WORK

THE PURPOSE OF THIS PROJECT IS TO ENHANCE BROADBAND CONNECTIVITY AND CAPACITY TO THE EXISTING ELIGIBLE WIRELESS FACILITY


- INSTALL (3) ANTENNAS
- INSTALL (6) RRUS
- INSTALL (1) FIBER LINE
- INSTALL (2) MW ANTENNAS
- INSTALL (2) FIBER IP-20C
- INSTALL (2) BELDEN 7919A CABLES

A&E FIRM


IRISH TOWER
4603 BERMUDA DRIVE
SUGARLAND, TX 77479
PHONE: (281) 796-2651



VICINITY MAP:

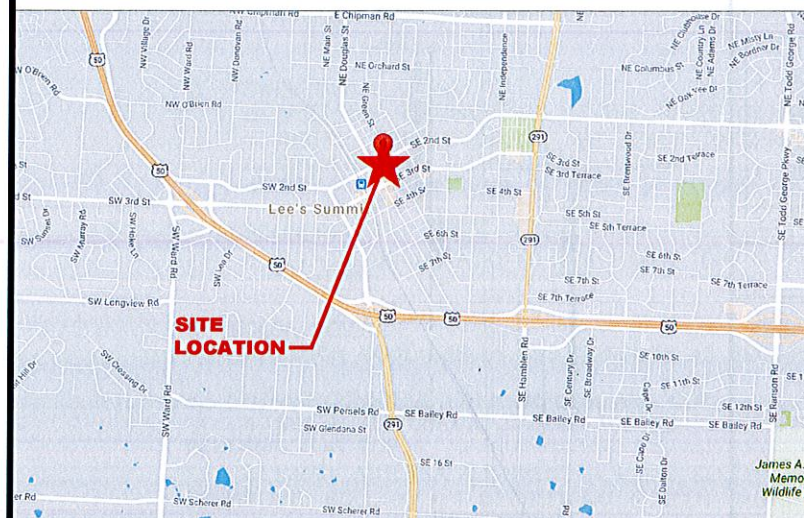

AERIAL MAP:

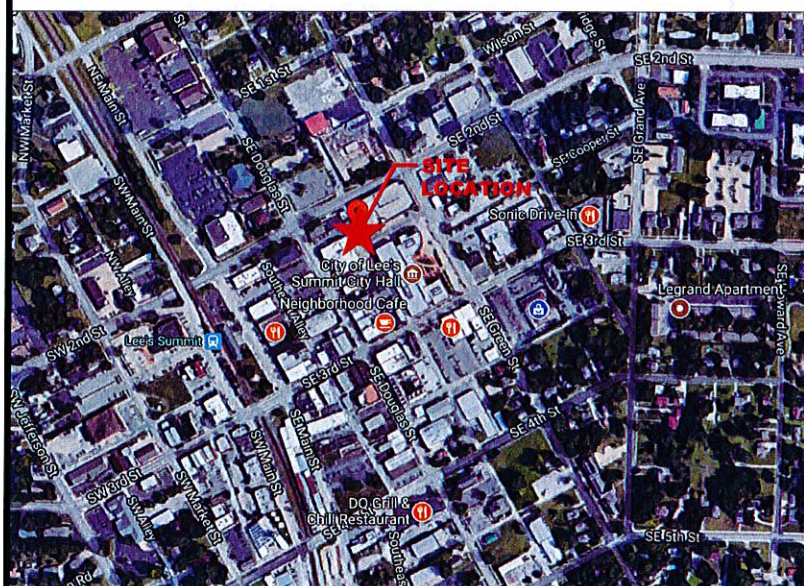

SHEET INDEX:

SHEET NUMBER	SHEET DESCRIPTION	REVISION
T-1	COVER SHEET & SITE PLAN	A
AE-1	TOWER ELEVATION & EQUIPMENT DETAILS	A
SP-1	INSTALLATION SPECS & EQUIPMENT	A

CODE COMPLIANCE:

ALL WORK SHALL BE PERFORMED AND MATERIALS INSTALLED IN ACCORDANCE WITH THE CURRENT EDITIONS OF THE FOLLOWING CODES AS ADOPTED BY THE LOCAL GOVERNING AUTHORITIES. NOTHING IN THESE PLANS IS TO BE CONSTRUED TO PERMIT WORK NOT CONFORMING TO THESE CODES.

- INTERNATIONAL BUILDING CODE
- INTERNATIONAL MECHANICAL CODE
- ANSI/TIA-222 STRUCTURAL STANDARD
- NFPA 780 - LIGHTNING PROTECTION CODE
- UNIFORM PLUMBING CODE
- NATIONAL ELECTRICAL CODE



SPRINT DO MACRO UPGRADE (REGIONAL PROGRAM)

SITE CASCADE:
KC03XC202


PLANS PREPARED FOR:



PLANS PREPARED BY:



ENGINEERING LICENSE & SEAL:

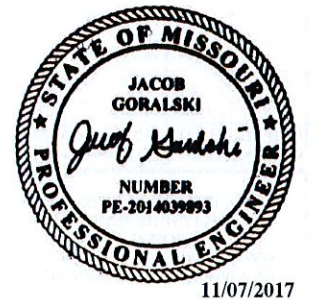

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REVISIONS:

DESCRIPTION	DATE	BY	REV
PRELIMINARY CD	10/07/17	JAJ	A
FINAL CD	11/07/17	JAJ	0

SITE CASCADE:

KC03XC202

SITE ADDRESS:

207 SE DOUGLAS
LEE'S SUMMIT, MO
64063

PROJECT:

SPRINT DO
MACRO UPGRADE

SHEET DESCRIPTION:


COVER SHEET
& SITE PLAN

DWG INFORMATION:

DRAWN BY:
CHECKED BY:

SHEET NUMBER:

T-1

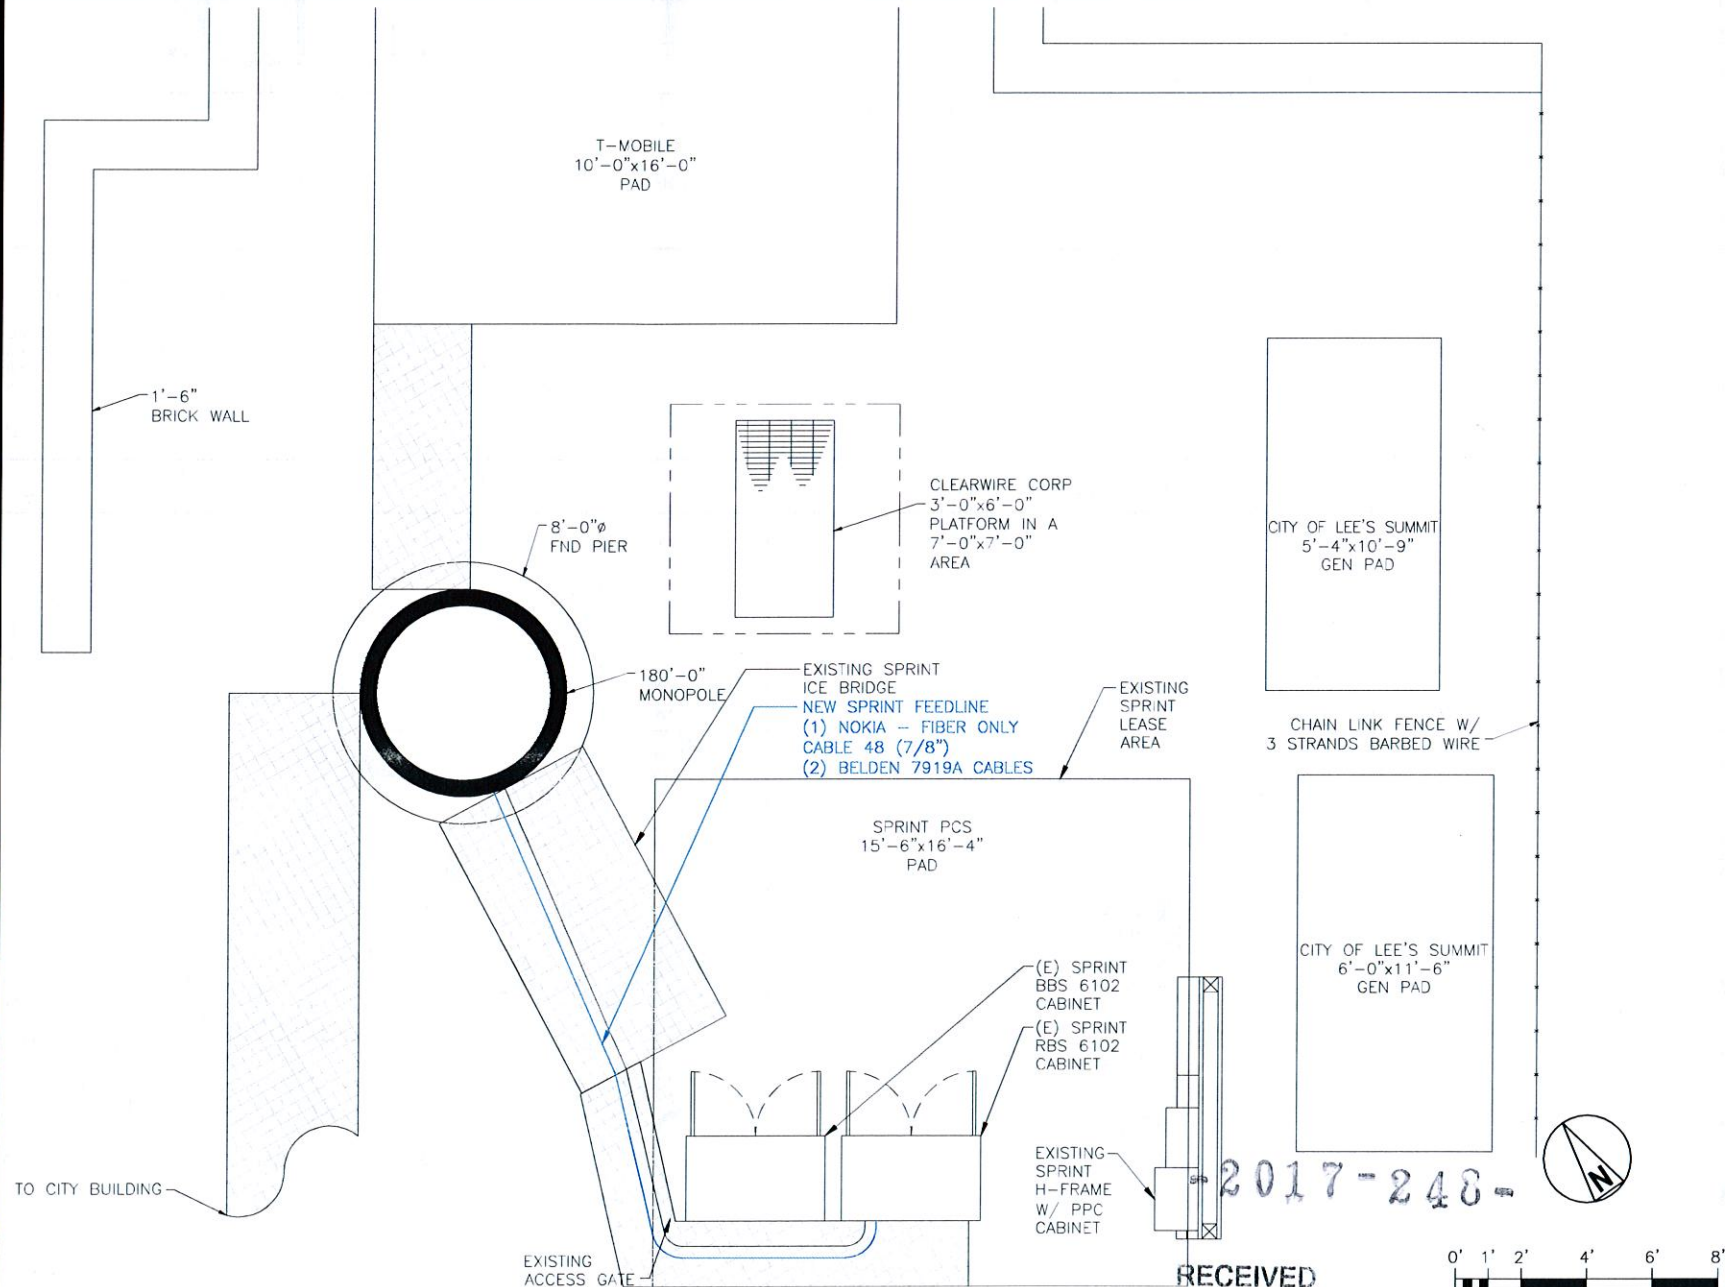

OVERALL SITE PLAN

NOV 21 2017

3/8" = 1'-0"

A

Development Services

(3) INSTALL SPRINT PANEL ANTENNAS
@ ELEVATION 180'-0" AGL

TOP OF TOWER
@ ELEVATION 180'-0" ± AGL

NEW SPRINT EQUIPMENT
(3) PANEL ANTENNAS
(6) RRUS
(2) MW ANTENNAS
(2) FIBER IP-20C
MOUNTED TO (E) MOUNTS

NEW SPRINT FEEDLINE
(1) NOKIA - FIBER ONLY
CABLE 48 (7/8")
(2) BELDEN 7919A CABLES

EXISTING
MONOPOLE

REFER TO STRUCTURAL EVALUATION
BY OTHERS

SEE DETAIL B THIS SHEET FOR
ENLARGED EQUIPMENT VIEW

SITE ELEVATION

NO SCALE

D

NEW SPRINT ANTENNA
COMMScope-TTT90AP-1XR
(3 TOTAL, 1 PER SECTOR)
NEW SPRINT RRU
ERICSSON - RRUS-82
W/SOLAR SHIELD
(3 TOTAL, 1 PER SECTOR)

EXISTING (1)
SPRINT MW
ANTENNA
VHLP800-11-2GR
3E
(AZ 340°)

NEW SPRINT RRU
ERICSSON - RRUS-11
(3 TOTAL, 1 PER SECTOR)

EXISTING SPRINT ANTENNA
SECTOR FRAME MOUNTS

NEW (1) SPRINT MW
ANTENNA
DRAGONWAVE
A-ANT-23G-1-C WITH
(1) FIBER IP-20C

NOTE:
NOTIFY SPRINT CM IF ANY ANTENNA IS MORE THAN
30 DEGREES OFF PLANE FROM THE MOUNT FACE.

SECTOR 1

1A (AZ 0°) 1B (AZ 340°) 1C (AZ 340°)

NEW (1) SPRINT MW
ANTENNA
DRAGONWAVE
A-ANT-18G-2-C WITH
(1) FIBER IP-20C


2A (AZ 122°)

SECTOR 2

(E) SPRINT RRU
ERICSSON - RRUS 11
800MHZ (3 TOTAL, 1
PER SECTOR)

(E) SPRINT RRU
ERICSSON - RRUS 31
B25 (6 TOTAL, 2 PER
SECTOR)

(E) SPRINT ANTENNA
RFS/CELWAVE
APXVRR18C (3 TOTAL
1 PER SECTOR)

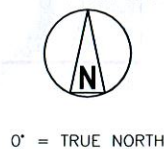

ANTENNA & EQUIPMENT PLAN -
SPRINT LEASED RAD CENTER

NO SCALE

C

ANTENNA MOUNTING ELEVATION


NO SCALE

A

CONDUIT NOTES:

1. SECURE CONDUITS TO EXISTING EQUIPMENT PAD WITH CONDUIT CLAMPS AS REQUIRED. CONTRACTOR SHALL INSTALL CONDUITS IN A MANNER TO REDUCE TRIPPING HAZARDS. PAINT ROUTED COMMON ACCESS PATHS YELLOW & BLACK AS REQUIRED.
2. CONDUIT FILL: (2A) - 9/C #12 AWG SOOW CABLE
(4) - (3) ETHERNET & (3) FIBER CABLES

NEW SPRINT FEEDLINE
(1) NOKIA - FIBER ONLY
CABLE 48 (7/8")
(2) BELDEN 7919A CABLES

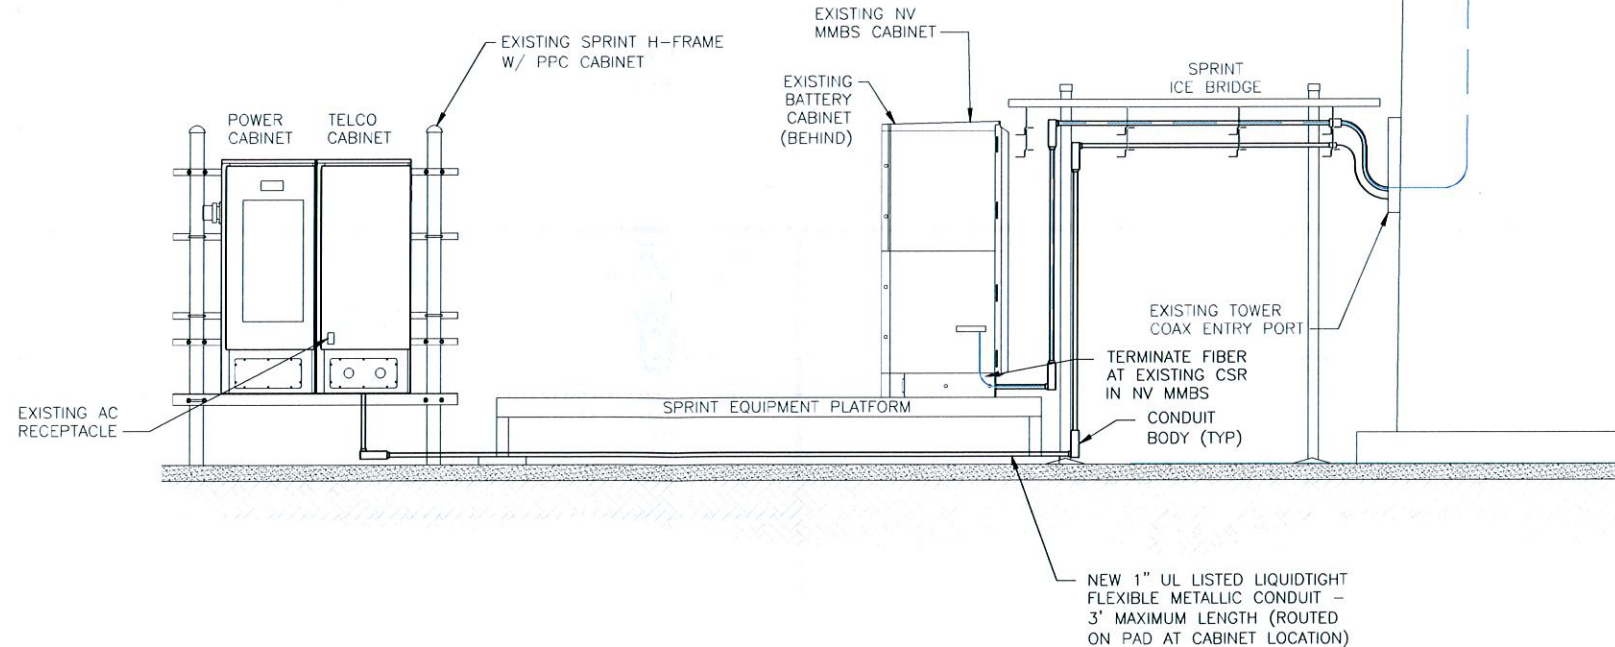

EQUIPMENT ELEVATION DETAIL

NO SCALE

B

PLANS PREPARED FOR:

Sprint

PLANS PREPARED BY:

IRISH TOWER
GENERAL CONSTRUCTION/ENGINEERING/PROJECT MANAGEMENT
4503 Bermuda Drive, Sugar Land, TX 77479
Voice: (281) 795-2551 | Fax: (855) 598-3136
irishtower.com

ENGINEERING LICENSE & SEAL:



11/07/2017

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PRELIMINARY CD		10/07/17	JAJ	A
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SITE CASCADE:

KC03XC202

SITE ADDRESS:

207 SE DOUGLAS
LEE'S SUMMIT, MO
64063

PROJECT:

**SPRINT DO
MACRO UPGRADE**

SHEET DESCRIPTION:

**TOWER ELEVATION
& EQUIPMENT DETAILS**

DWG INFORMATION:

DRAWN BY:
CHECKED BY:

SHEET NUMBER:

AE-1

REV. 0 7/25/16

SPRINT CONSTRUCTION SPECIFICATIONS
DO-MACRO CELL SITES

1. BASIC REQUIREMENTS
 - a. MEET ALL REQUIREMENTS OF JURISDICTIONS
 - b. IF EQUIPMENT FURNISHED BY SPRINT DOES NOT MATCH THE EQUIPMENT LISTED ON THE RFDS AND SHOWN ON THE PERMITTING DRAWINGS, RESOLVE DISCREPANCY THROUGH CCI'S CONSTRUCTION MANAGER AND SPRINT'S POINT OF CONTACT
 - c. CABLE INSTALLATIONS
 - i) CABLE BENDS MUST NOT EXCEED MANUFACTURER'S ALLOWABLE CABLE BEND RADIUS
 - ii) AT RADIOS INSTALL SERVICE LOOPS FOR POWER IF AVAILABLE
 - d. SECURE AND SUPPORT CONDUITS AND CABLES ON NO MORE THAN 48" INTERVALS VERTICAL AND NO MORE THAN 36" HORIZONTAL
2. SPRINT - FURNISHED EQUIPMENT
 - a. INSTALL THE FOLLOWING EQUIPMENT AT LOCATIONS SHOWN ON THE CONSTRUCTION DRAWINGS. VERIFY THE AZIMUTHS WITH THE RFDS
 - i) PANEL ANTENNAS
 - ii) RADIOS
 - iii) FILTERS (IF IT APPLIES)
 - iiii) FIBER JUMPERS
 - iiiii) RF JUMPERS
 - iiiiii) FIBER TRUNK
 - iiiii) CABLES
3. TOWER INSTALLATIONS
 - a. MEET ALL REQUIREMENTS OF THE TOWER OWNER
 - b. INSTALL FIBER TRUNK UP THE TOWER TO SPRINT'S RAD CENTER
 - c. PROVIDE MISC SUPPORTING HARDWARE
 - d. PROVIDE AND EXTEND DC WIRES IF NEEDED AND LABEL IN THE RBS
4. GROUNDING
 - a. RADIOS: BOND RADIO TO THE TOWER TOP OR SECTOR GROUND BAR WITH #6 GREEN STRANDED
5. COLOR CODING
 - a. COLOR CODE CABLES AND CONDUITS AS REQUIRED BY SPRINT STANDARD TS-0200
6. TESTING CONSTRUCTION COMPLETE AND COP
 - a. SWEEP ALL COAXIAL CABLES ACCORDING TO SPRINT STANDARD TS-0200. PDF AND DAT FILES REQUIRED FOR COP.
 - b. PANEL ANTENNA ALIGNMENT - USING ELECTRONIC ALIGNMENT TOOL. AZIMUTH +/- 3 DEGREES; PLUMB AND ROLL +/- 1 DEGREE; AAT SCREEN SHOTS REQUIRED FOR COP.
7. FIBER SCOPES AND FIBER INSERTION LOSS TEST REQUIRED
8. AS BUILT CDS REQUIRED
9. PRE AND POST PHOTOS REQUIRED
10. PERMITTING CLOSED OUT IF REQUIRED
11. NTP1 FORM REQUIRED WITHIN 24 HOURS
12. CCI COP

Product Specifications

COMMScope®



TTTT90AP-1XR
8-port Planar Array Antenna, 2496-2690 MHz, 90° HPBW, 1x RET

- Excellent solution for site sharing and maximizing capacity
- Employs state-of-the-art ultra wideband technology providing excellent RF performance in all bands
- MIMO ready



Remote Electrical Tilt (RET) Information

Input Voltage	10-30 Vdc
Internal RET	High band (1)
Power Consumption, idle state, maximum	1 W
Power Consumption, normal conditions, maximum	10 W
Protocol	3GPP/AISG 2.0 (Single RET)
RET Interface	8-pin DIN Female 8-pin DIN Male
RET Interface, quantity	1 female 1 male

Packed Dimensions



Length	1706.0 mm 67.2 in
Width	613.0 mm 24.1 in
Depth	226.0 mm 8.9 in
Shipping Weight	23.8 kg 52.5 lb

① COMMScope TTTT90AP-TXR
SCALE: NOT TO SCALE

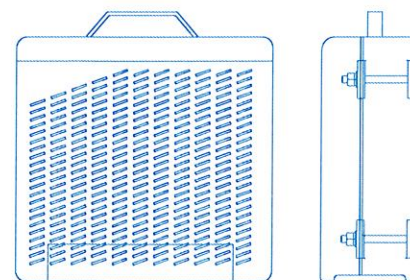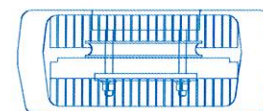

ERICSSON - RRUS 11 800MHz
WEIGHT (FULLY EQUIPPED): 50.7 LBS
SIZE (HxWxD): 19.7x17.0x7.2 IN.

② ERICSSON - RRUS 11 800MHz
SCALE: NOT TO SCALE

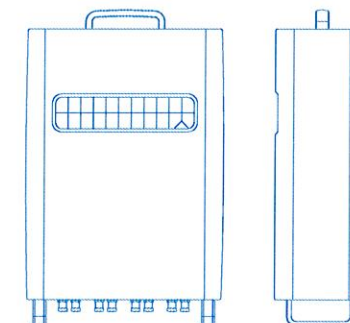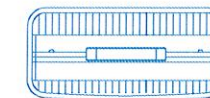

ERICSSON - RRUS 82
WEIGHT (WITHOUT MOUNTING HARDWARE): 62.1 LBS
SIZE (HxWxD): 23.8x15.0x7.0 IN.

③ ERICSSON - RRUS 82
SCALE: NOT TO SCALE

PLANS PREPARED FOR:

Sprint

PLANS PREPARED BY:



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SPRINT DO
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SHEET DESCRIPTION:

INSTALLATION
SPECS & EQUIPMENT

DWG INFORMATION:

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