


General Notes

S-102: ROOF TRUSSES

- REVIEW AND COORDINATE WITH ALL DETAIL PAGES REFERENCED ON THIS PLAN, NOTIFY ARCHITECT AND OWNER OF DISCREPANCIES
- 2. **RELATED DRAWING SHEETS**: REFER TO THE FOLLOWING:
 AL-101: FOR BUILDING LOCATION ON SITE
 AL-601: FOR INFORMATION RELATING TO SIGNAGE
 A-101: PRIMARY FLOOR PLAN FOR CONSTRUCTION LAYOUT
 A-121: ROOF PLAN/ROOF TOP EQUIPMENT
 - A-101: PRIMARY FLOOR PLAN FOR CONSTRUCTION
 A-121: ROOF PLAN/ROOF TOP EQUIPMENT
 A-601: DOOR & WINDOW SCHEDULES AND NOTES
 S-101: FOOTINGS AND FOUNDATIONS
- 3. WORKING POINT: THE WORKING POINT (WP) INDICATED ON THE DRAWINGS IS RELATIVE TO THE FACE OF SHEATHING ON THE EXTERIOR WALL AND IS A COMMON POINT OF REFERENCE WHERE EVER USED IN THESE DRAWINGS
- 4. ALL VENT PENETRATIONS ON BACK OF BACKSIDE OF ROOF.


2 Exterior Elevation - Left Side of Building

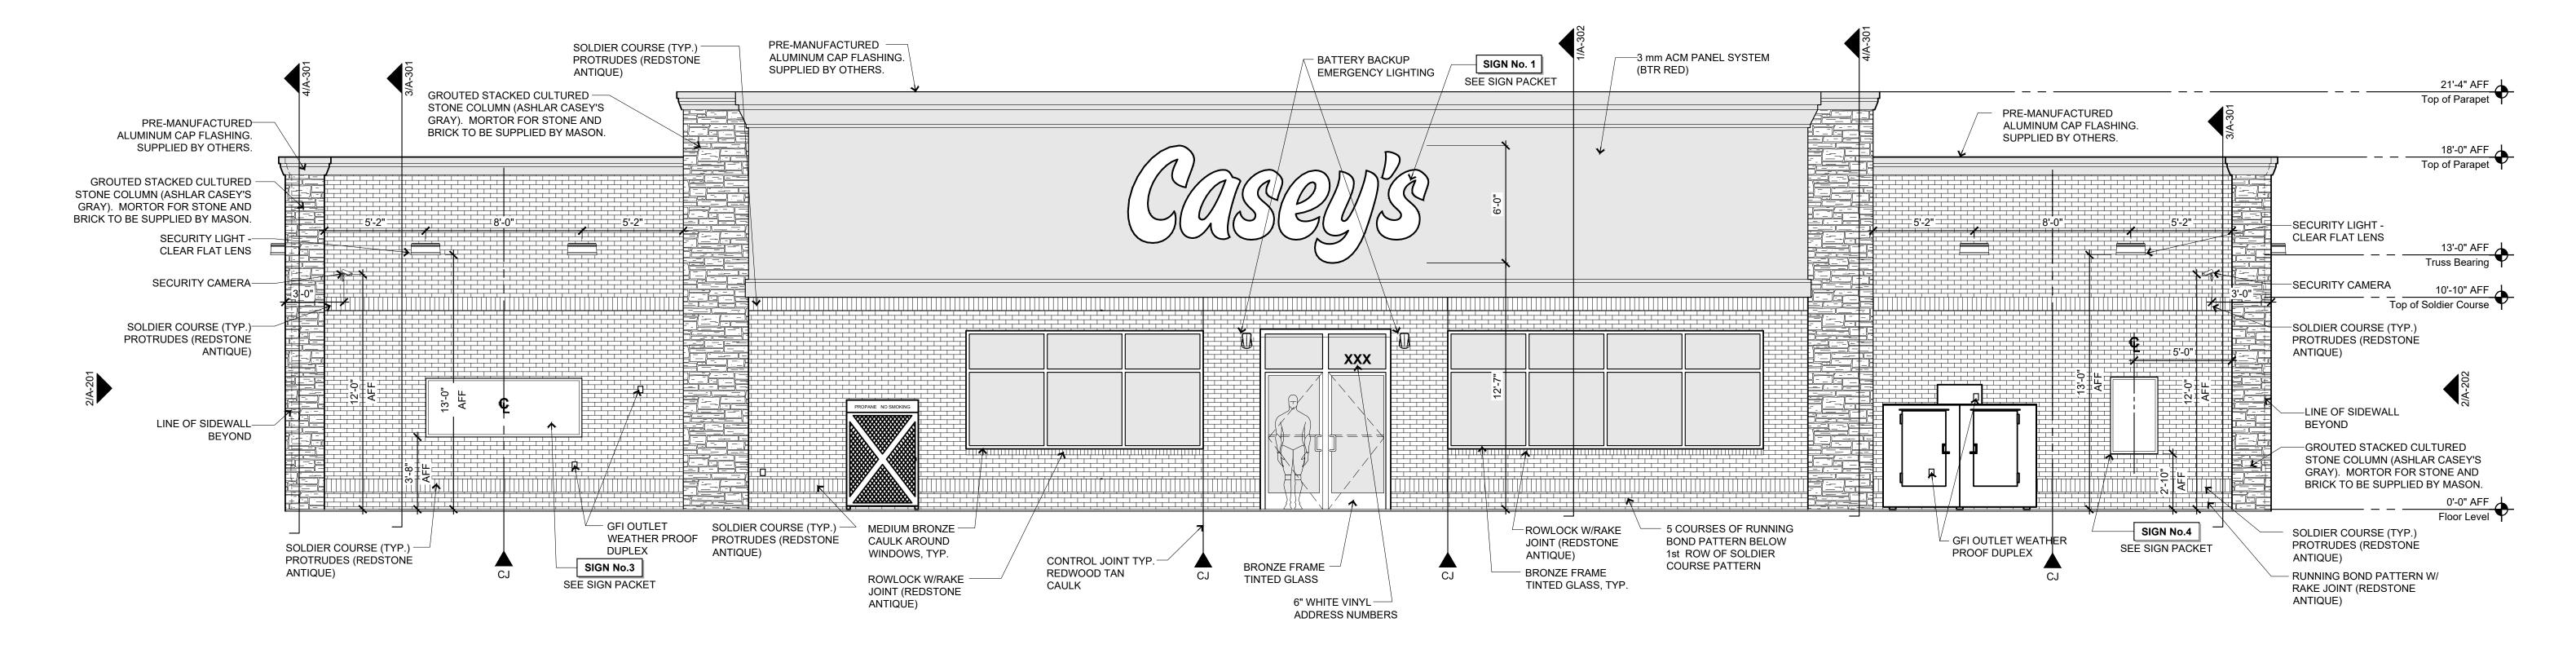


1 Exterior Elevation - Front of Building

Screening

Arlon Goforth III

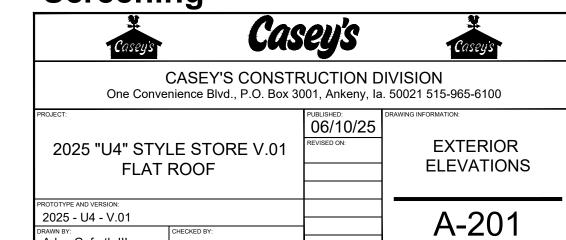

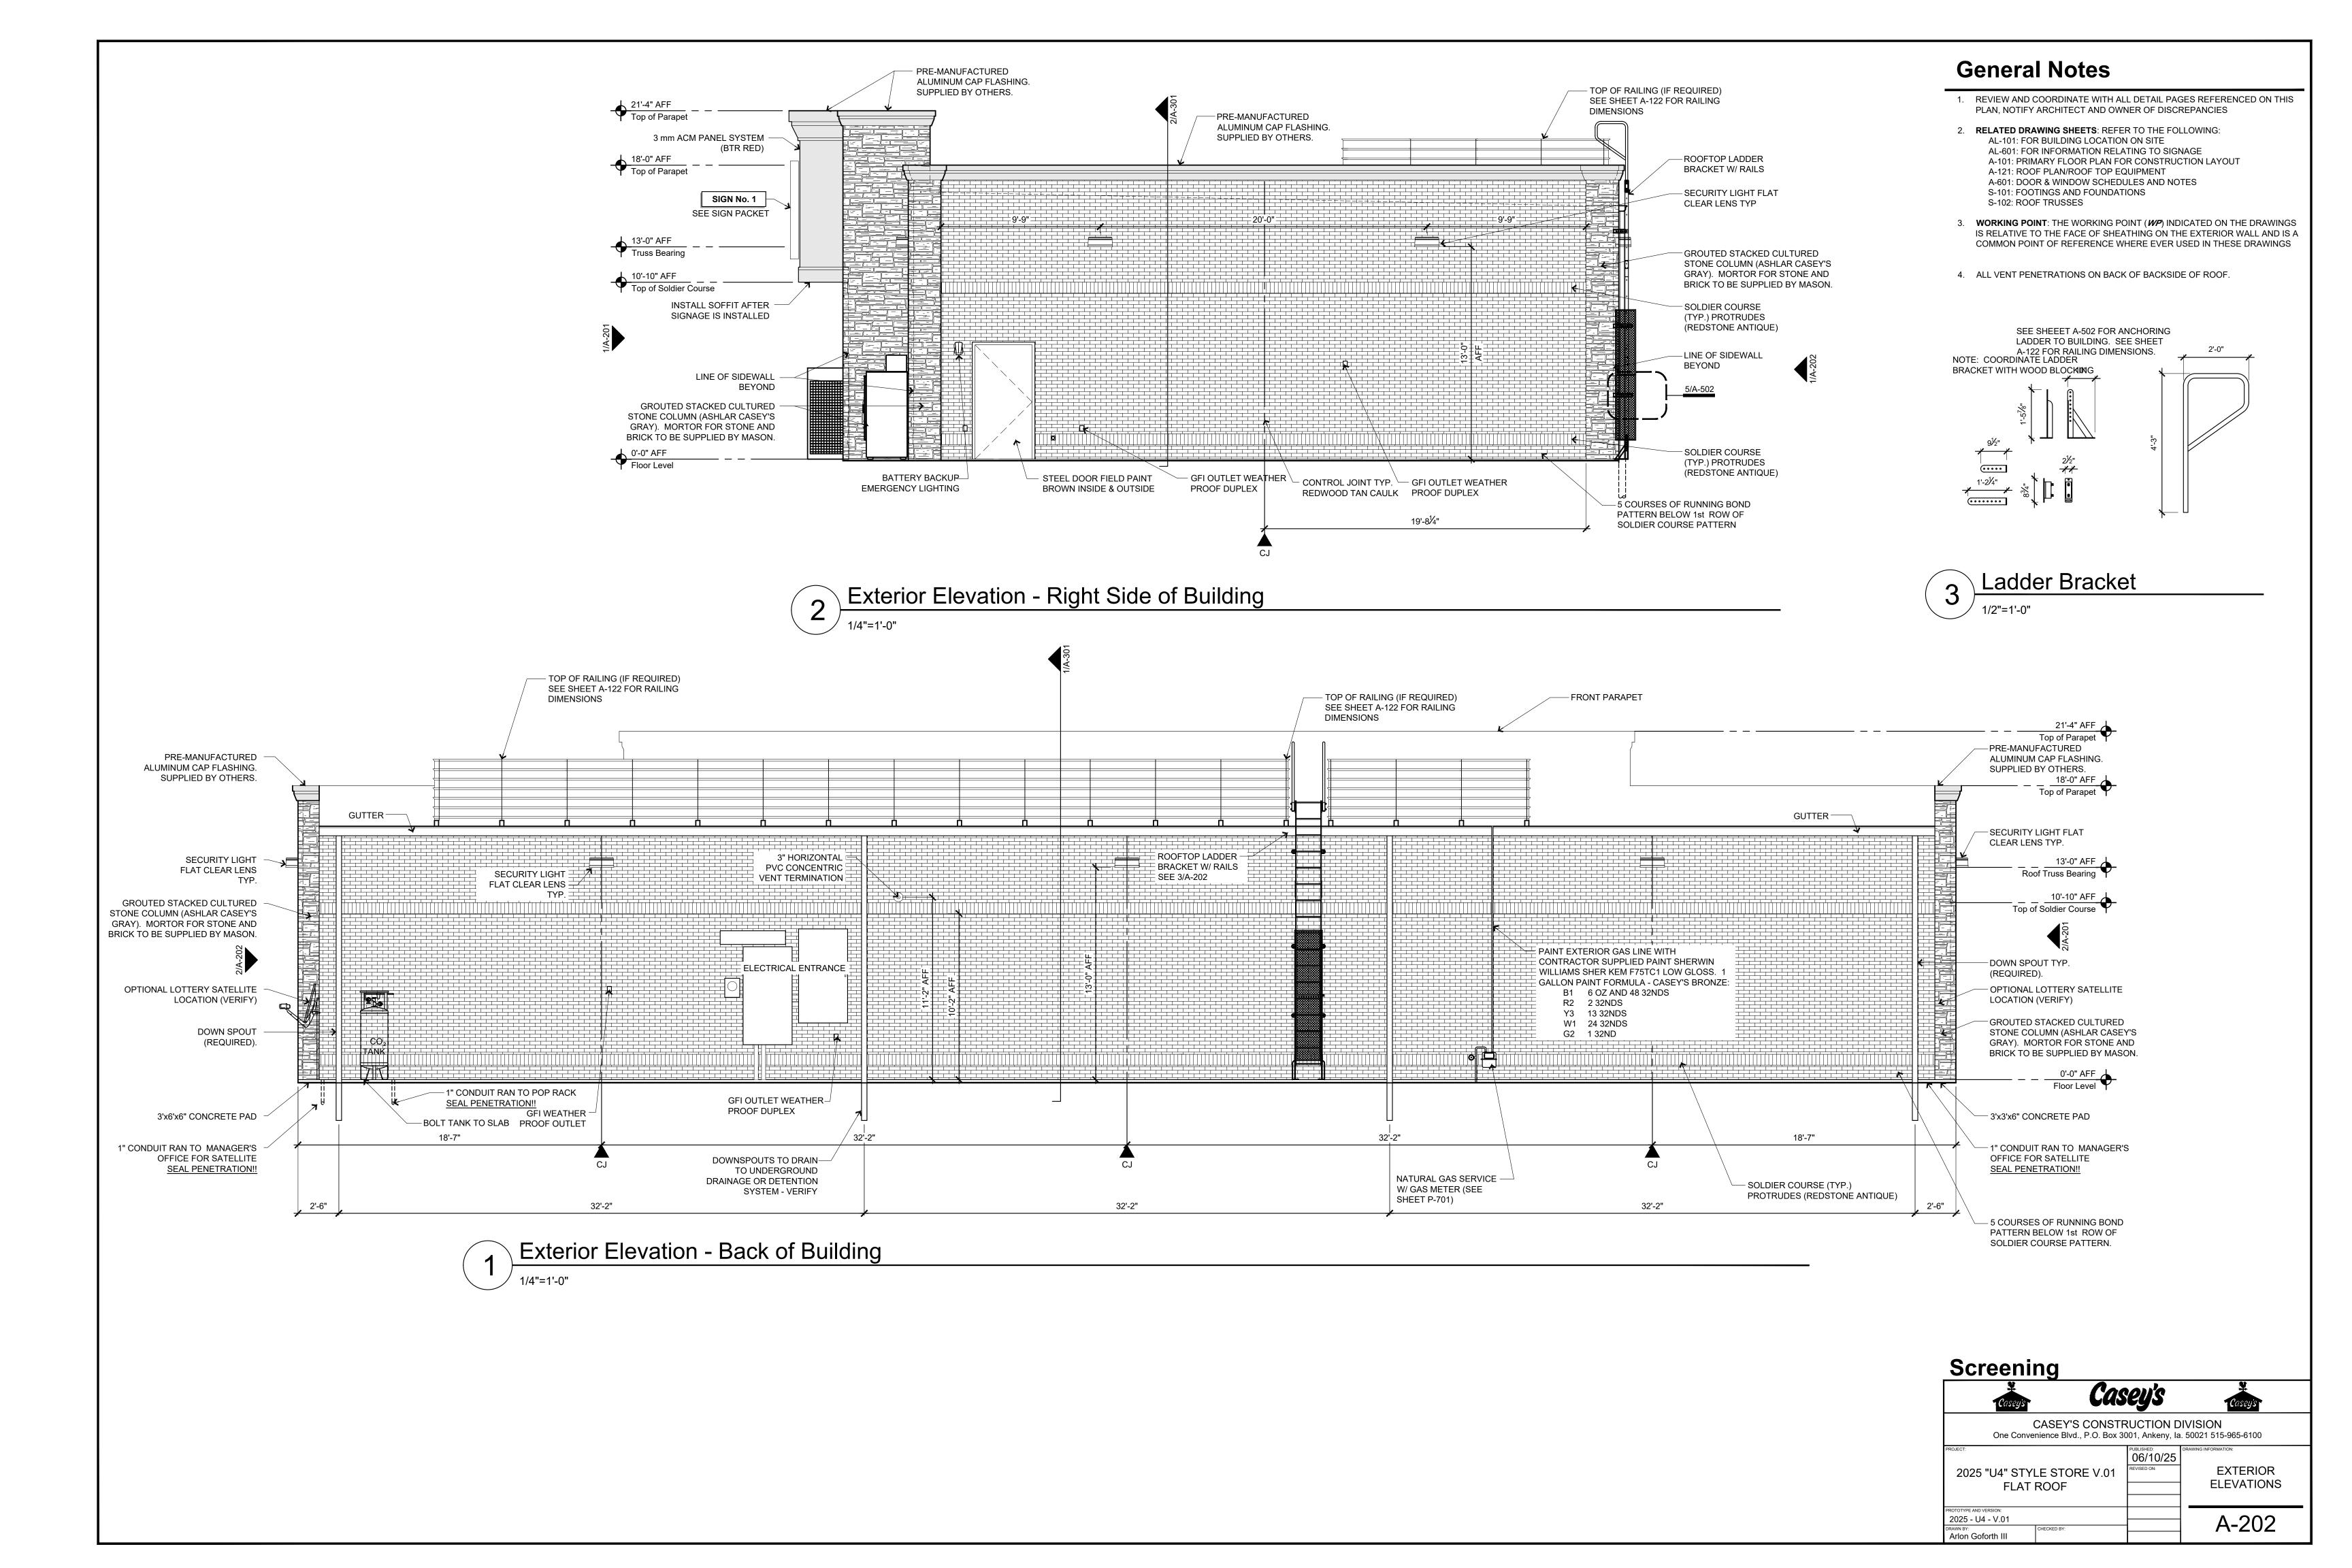

VERIFY ALL SIGNAGE WITH SIGN PERMITS


Canopy	anopy										
					Dimensions						
Sign#	Sign	Туре	Location	Illumination	Bottom	Тор	Width	Height	Area Ft ²	Quantity	
5	House Logo	Surface	Canopy Side	Internal	17' 3-1/2"	21' 3-1/2"	5' 8-7/8"	4' 0"	17.49	2	
5	House Logo	Surface	Canopy Front	Internal	17' 3-1/2"	21' 3-1/2"	5' 8-7/8"	4' 0"	17.49	1	
4	Snap Frame	Advertising	Canopy Column	N/A	3' 0"	7' 0-1/2"	2' 4"	3' 8"	8.56	8	
								Total	120.95		

General Notes

1. RELATED SHEETS: FOR ADDITIONAL INFORMATION NOT DIRECTLY REFERENCED, SEE THE FOLLOWING SHEETS:


Sign Packet FOR SIGNAGE SCHEDULE AND NOTES

- G-001 FOR GENERAL PROJECT NOTES AL-101 FOR GENERAL SITE PLAN
- QF-Series FOR DESIGN AND DETAILS RELATED TO FUELING FACILITY
- GASOLINE ISLAND CANOPY: REVIEW SHOP DRAWINGS PROVIDED BY CANOPY SUPPLIER AND ADVISE CASEY'S CONSTRUCTION MANAGER OF ANY DISCREPANCIES
- 3. **EMERGENCY GAS SHUT OFFS:** REFER TO SHEETS A-201, AQ-101 & E-101 FOR EMERGENCY SHUT OFF LOCATIONS.

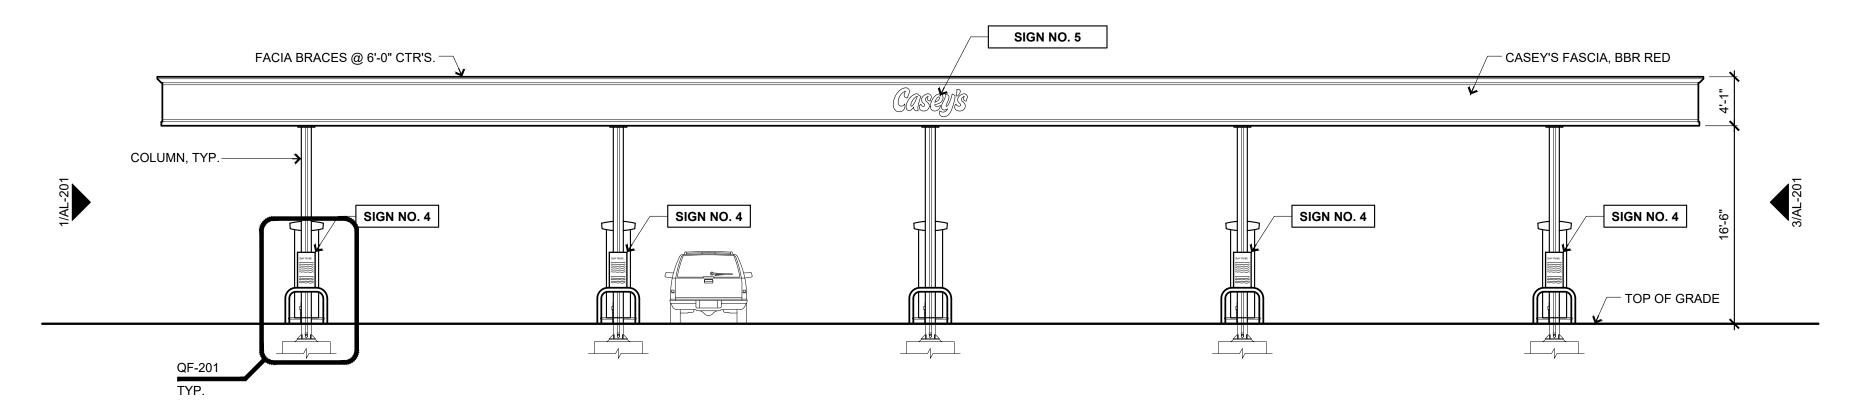


Pump Island Canopy - (Street Side)

1/8" = 1'-0"

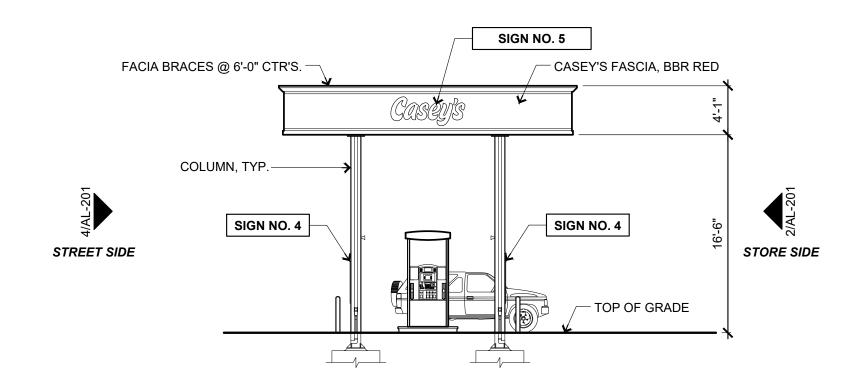


Pump Island Canopy - Right Side Elevation

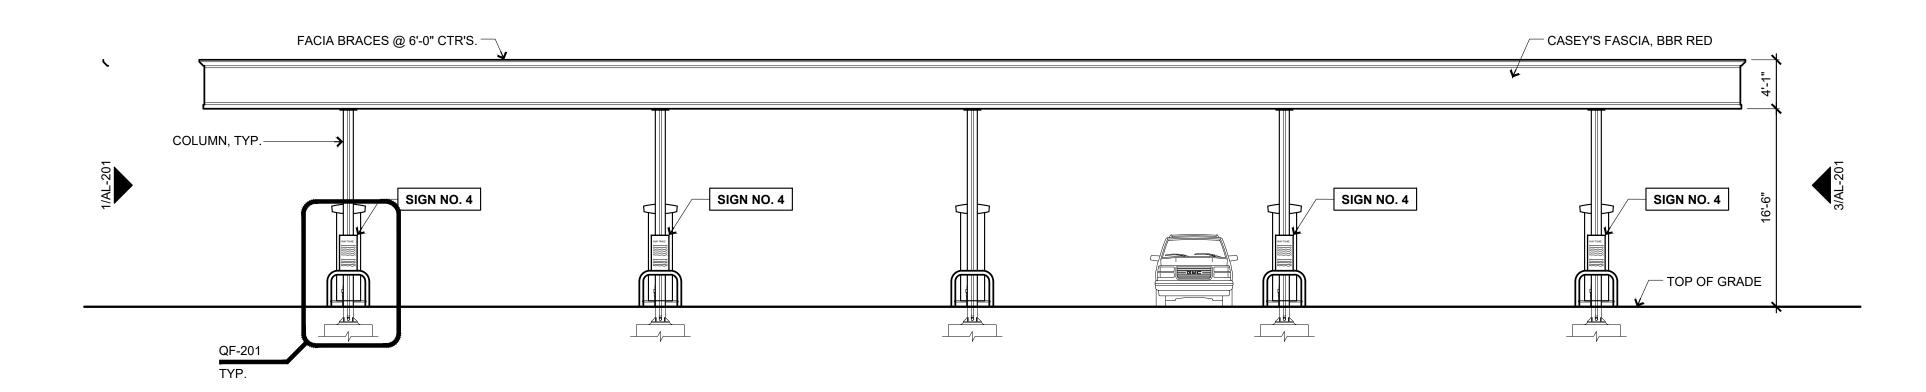

Pump Island Canopy - (Store Side)

Pump Island Cano

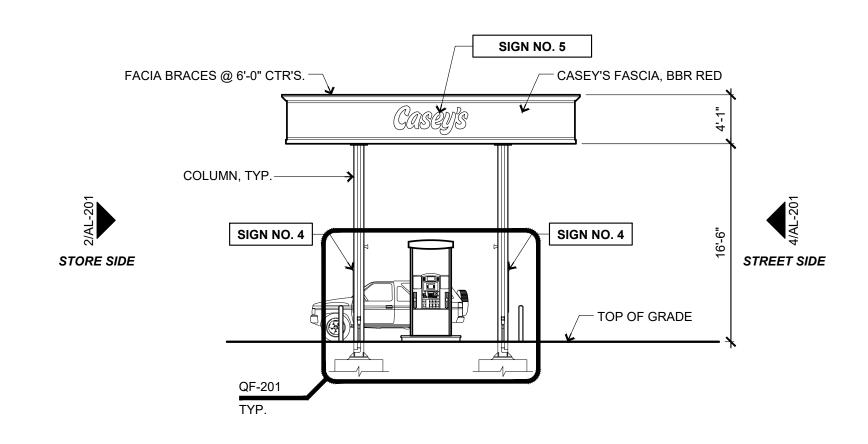

Pump Island Canopy - Left Side Elevation

1/8" = 1'-0"

Keyed Canopy Layout Plan Notes

- 1 FUEL ISLANDS
- (2) **FUEL DISPENSERS**: SUPPLIED BY OWNER
- (3) CANOPY COLUMN: SUPPLIED BY CANOPY MFG.
- 4 EDGE OF CANOPY: ABOVE
- 5 STEEL GUARD PIPE: SET INTO CONC SLAB AS INDICATED IN DETAIL ELEVATIONS (2 PER ISLAND)
- 6 INTERNAL DOWNSPOUTS: ROUTE THROUGH COLUMNS AND UNDERGROUND TO STORM SEWER OR DETENTION IF APPLICABLE
- 7 TRASH CAN AND WASH BUCKETS
- # PUMP LABELS: MOUNTED ON CANOPY COLUMNS

5 DISPENSERS - IN-A-ROW - H.I.

Caseys

Caseys

CASEY'S CONSTRUCTION DIVISION
One Convenience Blvd., Ankeny, IA. 50021 515-965-6100

PROJECT:


PROJECT:

PUBLISHED:
04/03/25
REVISED ON:

GASOLINE
ISLAND CANOPY
ELEVATIONS

DRAWING INFORMATION:
CONSTRUCTION DIVISION
DRAWIN BY:
CHECKED BY:

CHECKED BY:

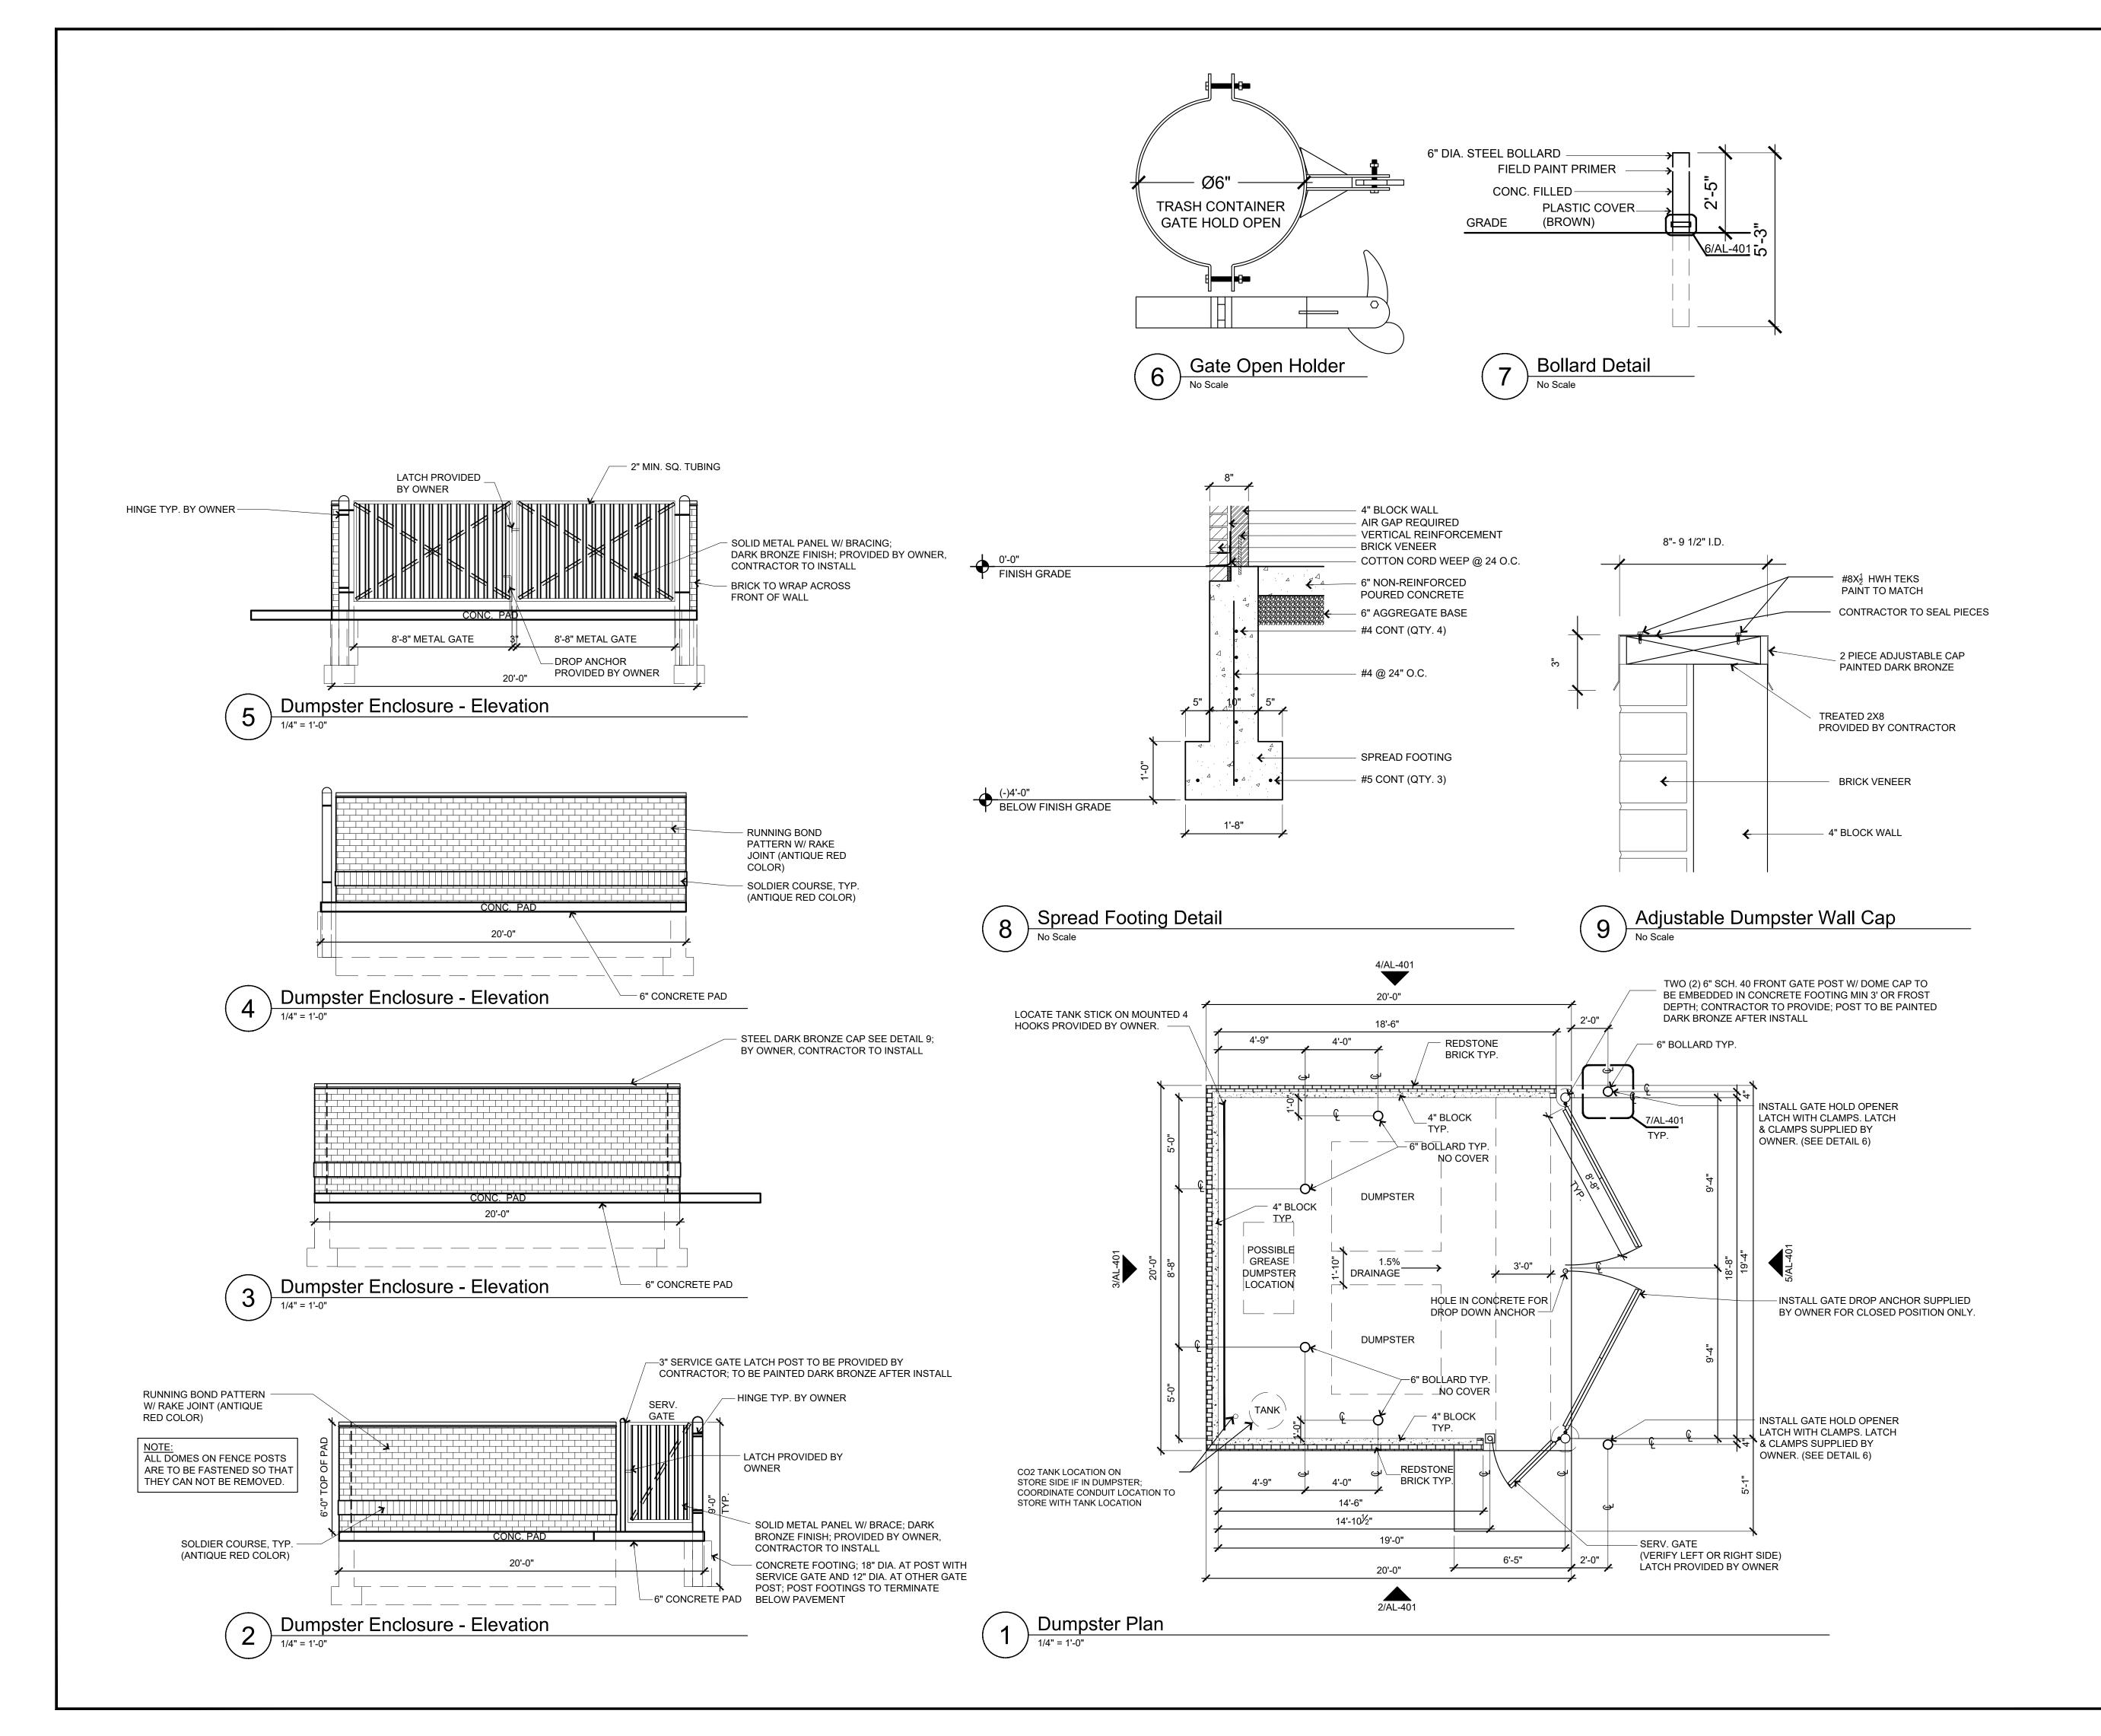

General Notes

1. RELATED SHEETS: FOR ADDITIONAL INFORMATION NOT DIRECTLY REFERENCED, SEE THE FOLLOWING SHEETS:

G-001 FOR GENERAL PROJECT NOTES AL101 FOR GENERAL SITE PLAN

Construction Notes

- 1) ALL DOMES ON FENCE POSTS ARE TO BE FASTENED SO THAT THEY CAN NOT BE REMOVED.
- 2) VERIFY SCREENING WITH LOCAL AUTHORITY.
- 3) CONTRACTOR TO PRIME ALL 6" BOLLARDS PRIOR TO FINISHED PAINT COAT.
- 4) DUMPSTER ENCLOSURE WALLS WILL BE 4" BLOCK PURCHASED BY CONTRACTOR

Brick Enclosure w/ Metal Gates

CASEY'S CONSTRUCTION DIVISION
One Convenience Blvd., Ankeny, IA. 50021 515-965-6100

PROJECT:


PROJECT:

PUBLISHED:
04/03/25
REVISED ON:

DRAWING INFORMATION:
CONSTRUCTION DIVISION
DRAWN BY:
B.RAHN

CHECKED BY:

CASEY'S CONSTRUCTION DIVISION
DRAWN BY:
CHECKED BY:
CASEY'S
CONSTRUCTION DIVISION
CASEY'S CONSTRUCTION DIVISION
CASEY'S CONSTRUCTION DIVISION
CASEY'S CONSTRUCTION DIVISION DIVISI

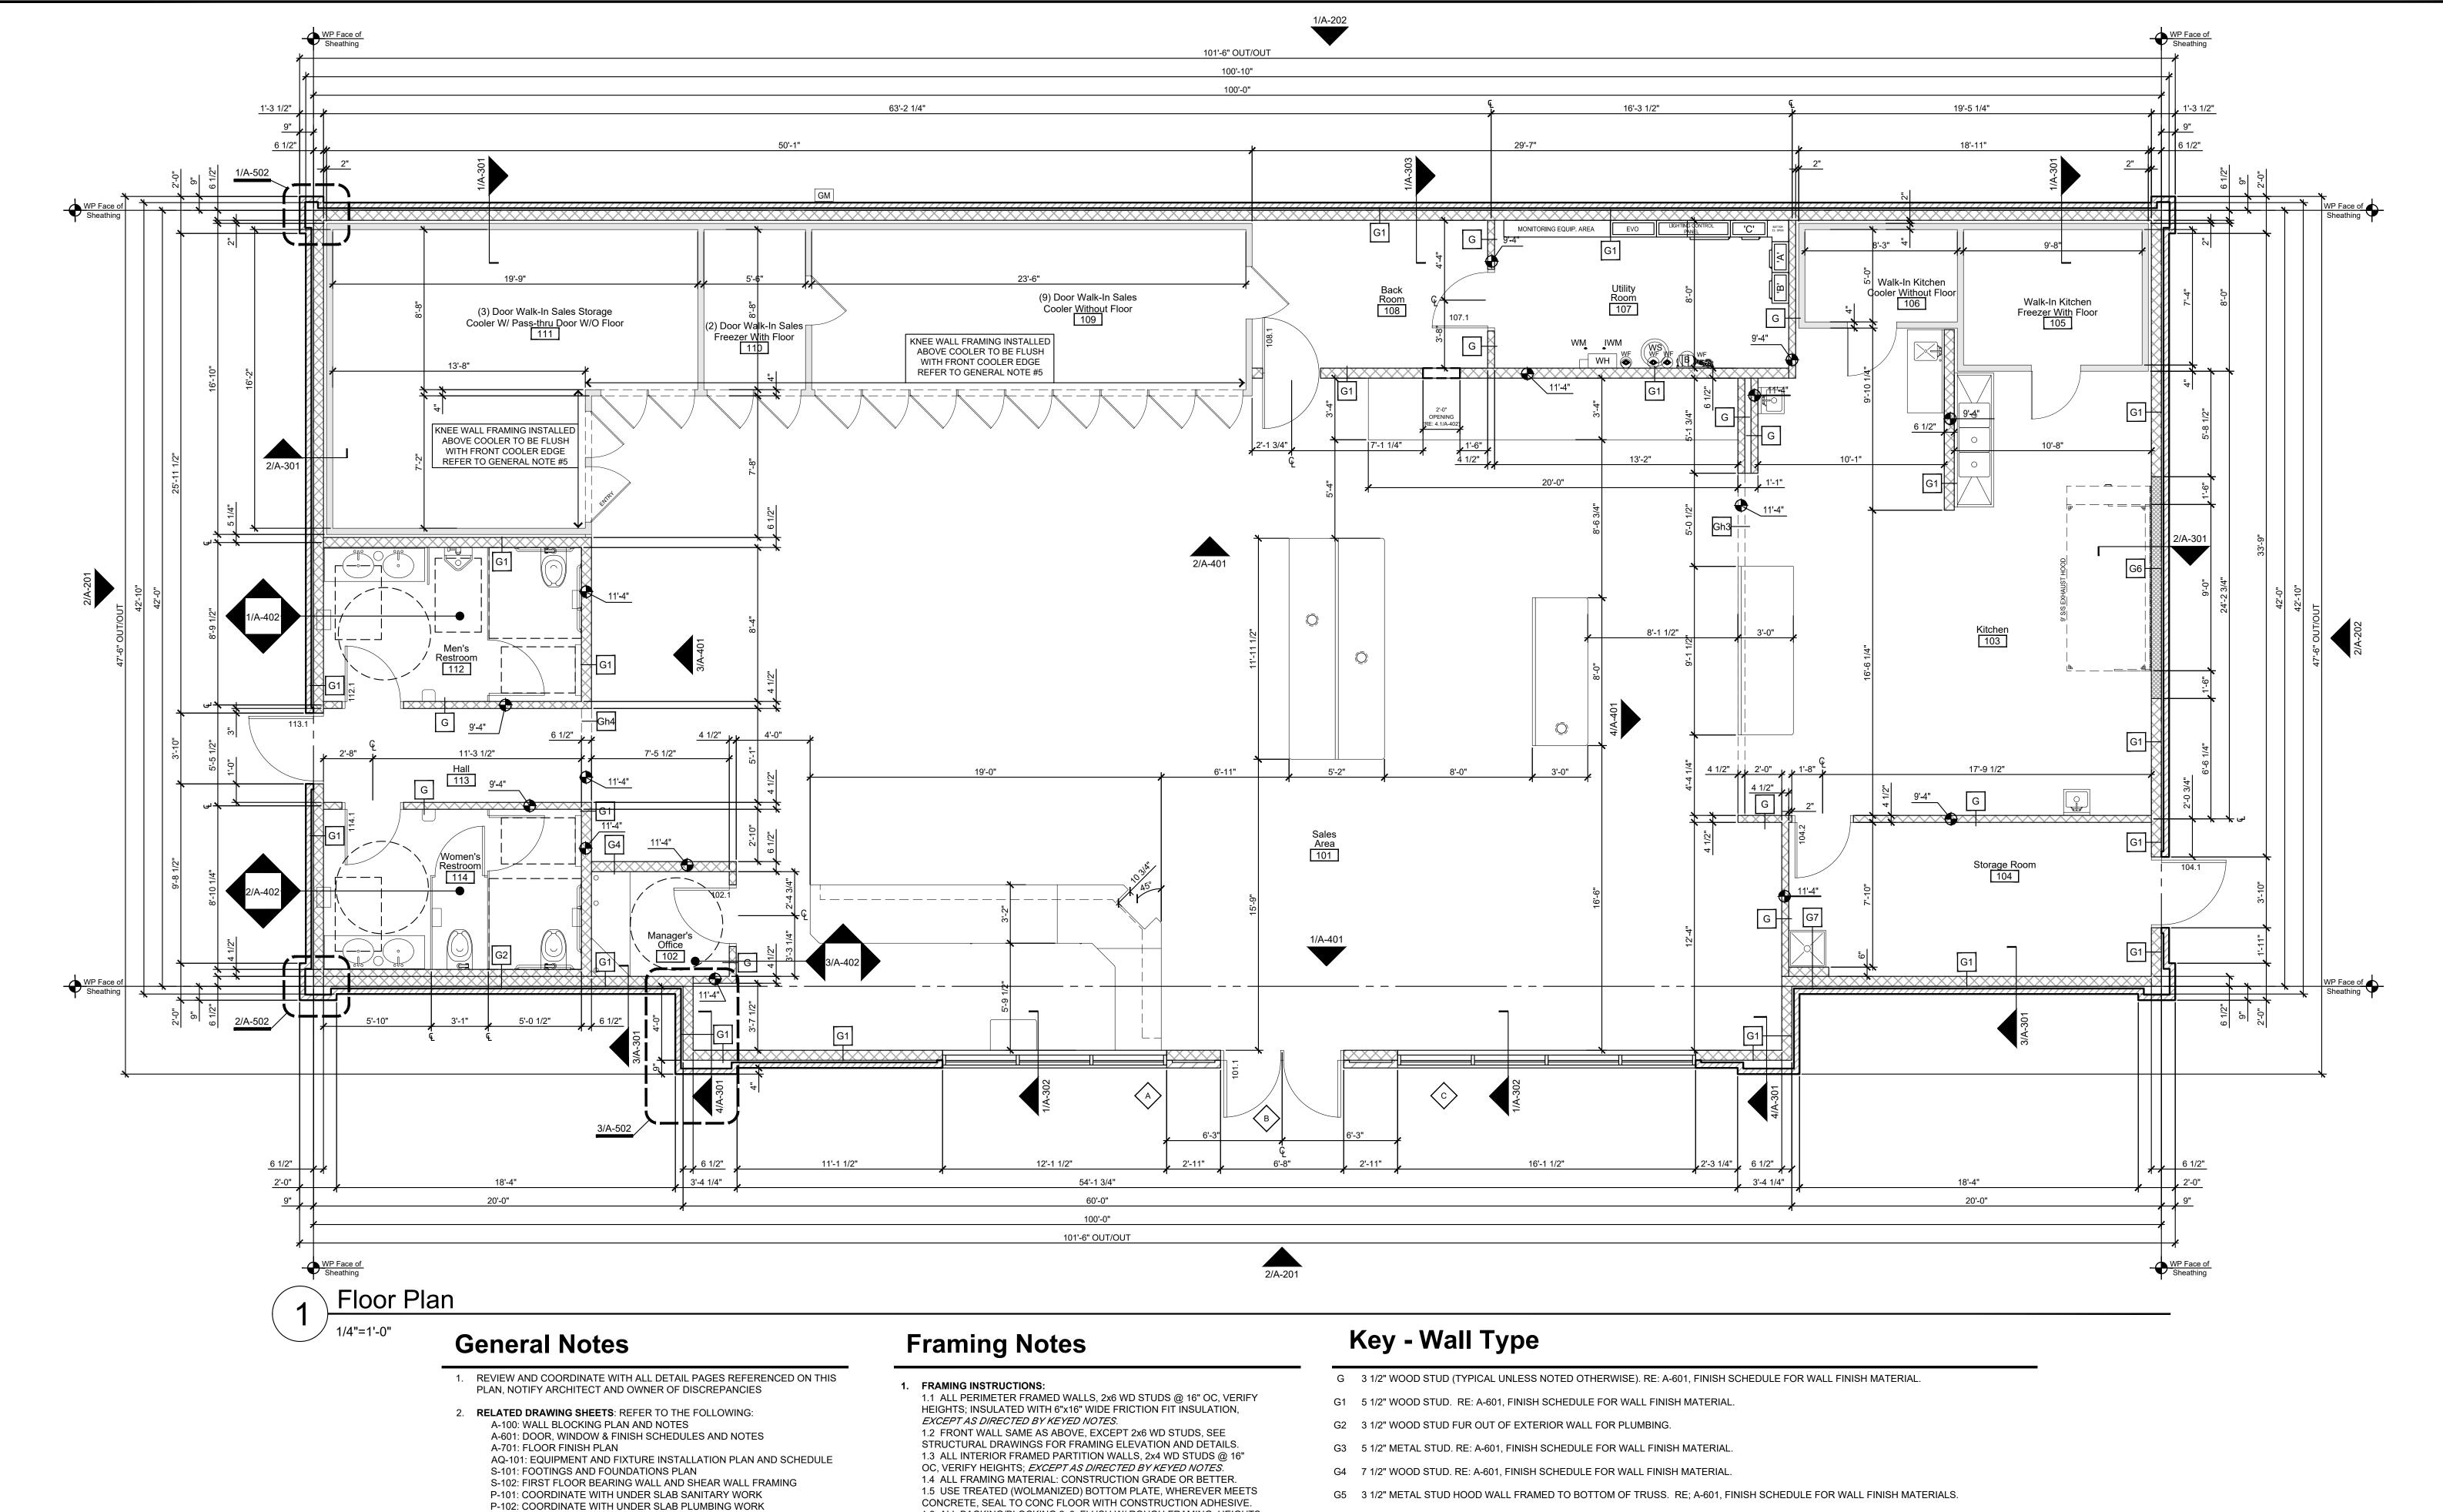

4. INDICATES WALL AND HEADER HEIGHTS 5. KNEE WALL FRAMING ABOVE COOLER / FREEZER TO BE INSTALLED FLUSH WITH FRONT FACE OF COOLER / FREEZER.

3. WORKING POINT: THE WORKING POINT (WP) INDICATED ON THE DRAWINGS

IS RELATIVE TO THE FACE OF SHEATHING ON THE EXTERIOR WALL AND IS A

COMMON POINT OF REFERENCE WHERE EVER USED IN THESE DRAWINGS

WINDOW FRAME ELEVATIONS - REFER TO PLAN SHEET A-601, DETAIL 1

B 7. DOOR TYPES - REFER TO PLAN SHEET A-601, DETAIL 2

CONCRETE, SEAL TO CONC FLOOR WITH CONSTRUCTION ADHESIVE. 1.6 ALL BACKING/BLOCKING 2x6, FLUSH W/ ROUGH FRAMING; HEIGHTS INDICATED ON PLANS (BK @ xx") ARE FROM FLOOR (AFF) CENTER OF

1.7 EXTERIOR NON-COMBUSTIBLE WALL. 2x6, 18 GAGE STEEL STUDS. ENTIRE END WALL, USING STEEL TOP AND BOTTOM PLATES.

- 2. SEAL ALL CABINETS AND SALES COUNTER TO FLOOR.
- 3. ALL EXTERIOR WALLS ARE SUPPLIED BY OWNER
- 4. ALL INTERIOR WALL MATERIALS SUPPLIED WITH BUILDING PACKAGE TO BE BUILT BY CONTRACTOR ON-SITE.
- G6 5-1/2" NON-COMBUSTIBLE METAL STUD WALL FRAMED TO BOTTOM OF TRUSS. RE: A-601, FINISH SCHEDULE FOR WALL FINISH MATERIAL.
- G7 5 1/2" WOOD STUD. FUR OUT OF EXTERIOR WALL FOR PLUMBING. Gh1 5 1/2" WOOD STUD. FINISH HEIGHT = 5'-2" A.F.F. CORNER BEAD ALL OUTSIDE CORNERS. WOOD CAP AND COVE ON TOP OF WALL.
- Gh2 3 1/2" WOOD STUD SHEAR WALL. SHEET BOTH SIDES WITH 1/2" OSB.
- Gh3 2"x4" WOOD FLOOR TYPE TRUSS BEAM SUPPLIED BY STRUCTURAL COMPONENT SYSTEMS. CONTRACTOR TO SHEET SALES AREA SIDE WITH 3/4" PLYWOOD BEFORE FINISHING. RE: A-601, FINISH SCHEDULE FOR WALL FINISH MATERIAL. RE: A-401, DETAIL 4 & 6, INTERIOR ELEVATIONS.
- Gh4 3 1/2" WOOD STUD (FRAMING HEIGHT 7'-5") BULKHEAD BUILT ACROSS OPENINGS FOR GRAPHICS ATTACHMENT. FACE BOTH SIDES, REFER TO FINISH SCHEDULE (A-601) FOR FACE MATERIAL AND FINISH.

Caseys Cas	ey's	Casey's						
CASEY'S CONSTRUCTION DIVISION One Convenience Blvd., P.O. Box 3001, Ankeny, Ia. 50021 515-965-6100								
2025 "U4" STYLE STORE V.01 FLAT ROOF	PUBLISHED: 06/10/25 REVISED ON:	FLOOR PLAN						
PROTOTYPE AND VERSION: 2025 - U4 - V.01 DRAWN BY: Arlon Goforth III CHECKED BY:		A-101						