	SHEET INDEX						
NO.	DESCRIPTION						
T-I	TLE SHEET						
T-2	ENERAL NOTES						
C-I	SITE PLAN						
C-2	EQUIPMENT LAYOUTS AND SITE PHOTOS						
C-3	ELEVATIONS						
C-4	ANTENNA LAYOUTS						
C-5	ANTENNA SCHEDULES						
C-6	EQUIPMENT DETAILS						
C-7	EQUIPMENT DETAILS						
C-8	EQUIPMENT DETAILS						
C-9	MOUNTING DETAILS						
C-10	PLUMBING DIAGRAM						
G-I	GROUNDING DETAILS						
	DELL SITE POWER CALCULATION ATTACHED						
	DRIVING DIRECTIONS						





PRODUCT SUB GROUP	JOB ID	ORACLE PTN
5G NR RRH SWAP	WSKSL0044575	3202A I CSMY
LTE RRH SWAP	WSKSL0043299	3202A I CW4S
5G NR RRH SWAP	WSKSL0042270	3202A I CTG3
LTE IC RRH SWAP	WSKSL0039361	3202A1D185
LTE RRH SWAP	WSKSL0043516	3202A I CSX7
	5G NR RRH SWAP LTE RRH SWAP 5G NR RRH SWAP LTE IC RRH SWAP	5G NR RRH SWAP         WSKSL0044575           LTE RRH SWAP         WSKSL0043299           5G NR RRH SWAP         WSKSL0042270           LTE IC RRH SWAP         WSKSL0039361

# **MOKS MARKET**

NOKIA MARKET MODERNIZATION

SITE NAME

**GREEN** 

SITE NUMBER

KSL04130

FA LOCATION CODE:

10000343

**IWM** #:

WSKSL0039361

SITE ADDRESS

202 EAST THIRD STREET LEES SUMMIT, MO 64063

STRUCTURE TYPE

**MONOPOLE** 

### SITE LOCATION MAP

SCAN OR CODE FOR LINK TO SITE LOCATION MAP



# **PROJECT TEAM**



CREVE COEUR, MO 63141

PROJECT MANAGER

HANDICAP ACCESS REQUIREMENTS ARE NOT REQUIRED.

FACILITY HAS NO PLUMBING OR REFRIGERANTS

FACILITY IS UNMANNED AND NOT FOR HUMAN HABITATION

**NOTES:** 



**CIVIL SUPPLIER** 

ALL NEW MATERIAL SHALL BE FURNISHED AND INSTALLED BY CONTRACTOR UNLESS NOTED OTHERWISE. CABINETS,

THIS FACILITY SHALL MEET OR EXCEED ALL FAA AND FCC REGULATORY REQUIREMENTS

ANTENNAS/RRU AND CABLES FURNISHED BY OWNER AND INSTALLED BY CONTRACTOR



5055 Hwy N, Suite 200 St. Charles, MO 63304

SITE ACQUISITION

1100 E. WOODFIELD ROAD, SUITE 500 SCHAUMBURG, ILLINOIS 60 173 TEL: 847-908-8400

**ENGINEER** 

# **PROJECT SUMMARY**

RELEASED FOR CONSTRUCTION

SITE NAME: **GREEN** 

SITE NO: KSL04130

FA LOCATION CODE: 10000343

202 EAST THIRD STREET SITE ADDRESS: LEES SUMMIT, MO 64063 COUNTY: **IACKSON** 

SITE COORDINATES (FROM RFDS) LATITUDE: 38 91389° LONGITUDE: -94.37417° 1043' (AMSL) **GROUND ELEVATION:** 

MONOPOLE STRUCTURE TYPE:

JURISDICTION: CITY OF LEE'S SUMMIT MO

APPLICANT: 12930 OLIVE BLVD

CREVE COEUR, MO 63141



12930 OLIVE BLVD

CREVE COEUR, MO 63141



I 100 E. WOODFIELD ROAD, SUITE 500 SCHAUMBURG, ILLINOIS 60173 TEL: 847-908-8400 COA# E2019038761

DESCRIPTION

90% REVIEW

95% REVIEW

HEREBY CERTIFY THAT THESE DRAWINGS WERI

JPERVISION AND CONTROL, AND TO THE BES OF MY KNOWLEDGE AND BELIEF COMPLY WITH THE REQUIREMENTS OF ALL APPLICABLE CODE:

PREPARED BY ME OR UNDER MY DIRECT

PE-2015007444

SITE NAME

**GREEN** 

SITE NO.

KSL04130

SITE ADDRESS

202 FAST THIRD STREET

LEES SUMMIT, MO 64063

# DATE

B 04/14/25

0 06/05/25

04/04/25

TOWER OWNER SITE ID: HTMO 1589

HOSIER TOWERS

### CODE COMPLIANCE

**BUILDING CODE:** 2018 INTERNATIONAL BUILDING CODE

**ELECTRICAL CODE** 2014 NATIONAL ELECTRICAL CODE

### **SCOPE OF WORK**

# WARM SWAP

TOWER OWNER:

- EXISTING PLATFORM TO BE REMOVED
- (6) EXISTING QUINTEL QS86512-2 ANTENNAS TO BE REMOVED
- (3) EXISTING SBNHH-ID65C ANTENNAS TO BE REMOVED
- (3) EXISTING AEQK ANTENNAS TO BE REMOVED
  (3) EXISTING AHLBBA RRH UNITS TO BE REMOVED
- (3) EXISTING AHCA RRH UNITS TO BE REMOVED
- (3) EXISTING B25 RRH4X30-4R RRH UNITS TO BE REMOVED
- (3) EXISTING B66 RRH4X45-4R RRH UNITS TO BE REMOVED (3) EXISTING RRH4X25-WCS-4R RRH UNITS TO BE REMOVED
- (3) EXISTING TT08-19DB111-001 TMA UNITS TO BE REMOVED
- (2) EXISTING DC6-48-60-18-8C RAYCAP UNITS TO BE RELOCATED
- (I) EXISTING DC6-48-60-0-8C RAYCAP UNIT TO BE RELOCATED
- (2) EXISTING IS PAIR FIRER TRUNKS TO REMAIN
- (6) EXISTING 8 AWG DC TRUNKS TO REMAIN
- (6) NEW NNH4-65C-R6-V4 ANTENNAS
- (3) NEW AIR6472 B77G B77M ANTENNAS
- (3) NEW 4490 B5/B12A, 4471 B30, 4494 B14/B29 AND 4890 B25/B66 RRH UNITS

### **GROUND WORK:**

- EXISTING (2) C48/24-1500 CONVERTERS TO BE REMOVED EXISTING (1) VERTIV 5100 TO REMAIN
- EXISTING (8) R48-2000E3 RECTIFIERS TO REMAIN
- EXISTING (12) 190F BATTERIES TO REMAIN
- EXISTING (2) DC12-48-60-0-RM RAYCAP UNITS TO REMAIN
- INSTALL (I) -58V CONVERSION KIT
- INSTALL (7) C48/58-2000P3 CONVERTERS
- INSTALL (2) R48-2000E3 RECTIFIERS
- INSTALL (I) 6610 SITE CONTROLLER, (I) 6672 BBU

# **APPROVALS**

AT&T CONST.	DATE
AT&T RF	DATE
AT&T OPS	DATE
LANDLORD	DATE

DRAWING SCALED TO 11"x17"

# SHEET NAME TITLE SHEET

SHEET NUMBER

### **GENERAL NOTES:**

- A. PURPOSE AND INTENT:
  - THE DRAWING AND SPECIFICATIONS ARE INTENDED TO BE FULLY EXPLANATORY AND SUPPLEMENTARY, HOWEVER, SHOULD ANYTHING BE SHOWN, INDICATED, OR SPECIFIED ON ONE AND NOT THE OTHER, IT SHALL BE DONE THE SAME AS IF SHOWN, INDICATED, OR SPECIFIED IN BOTH. SHOULD THERE BE ANY DISCREPANCIES BETWEEN REQUIREMENTS SHOUN IN BOTH, THE MORE STRINGENT REQUIREMENTS SHALL APPLY.
  - 2. THE INTENTION OF THE DOCUMENTS IS TO INCLUDE ALL LABOR AND MATERIALS REASONABLY NECESSARY FOR THE PROPER EXECUTION AND COMPLETION OF THE WORK AS STIPULATED IN THE CONTRACT.

#### B. CONFLICTS:

- I. VERIFY ALL MEASUREMENTS AT THE SITE BEFORE ORDERING MATERIAL OR DOING ANY WORK. NO EXTRA CHARGE OR COMPENSATION WILL BE ALLOWED DUE TO DIFFERENCES BETWEEN ACTUAL DIMENSIONS OR DIMENSIONS SHOWN ON PLANS. SUBMIT NOTICE OF ANY DISCREPANCY IN DIMENSIONS OR OTHERWISE TO AT&T FOR RESOLUTION BEFORE PROCEEDING WITH THE WORK.
- 2. NO PLEA OF IGNORANCE OF CONDITIONS THAT EXIST, OR OF DIFFICULTIES OF CONDITIONS THAT MAY BE ENCOUNTERED, OR OF ANY OTHER RELEVANT MATTER CONCERNING THE EXECUTION OF THE WORK WILL BE ACCEPTED AS AN EXCUSE FOR ANY FAILURE OR OMISSION ON THE PART OF THE CONTRACTOR TO FULFILL EVERY DETAIL OF ALL THE REQUIREMENTS OF THE CONSTRUCTION DOCUMENTS GOVERNING THE WORK.
- C. CLEANING: KEEP THE SITE FREE FROM ACCUMULATION OF WASTE AND RUBBISH CAUSED BY EMPLOYEES. AT THE COMPLETION OF THE WORK, REMOVE ALL WASTE AND NON-CONSTUCTION MATERIAL, INCLUDING ALL CONTRACTOR TOOLS, SCAFFOLDING, AND SURPLUS MATERIAL AND LEAVE SITE CLEAN AND READY FOR USE.
- D. CODES: CONTRACTOR SHALL BE RESPONSIBLE FOR FOLLOWING ALL LAWS, REGULATIONS, AND RULES PROMULGATED BY FEDERAL STATE AND LOCAL AUTHORITIES WITH JURISDICTION OVER THE PROJECT. THIS RESPONSIBILITY IS IN EFFECT REGARDLESS OF WHETHER THE LAW, ORDINANCE, REGULATION OR RULE IS MENTIONED IN THESE SPECIFICATIONS.
- E. <u>LICENSING</u>: CONTRACTOR SHALL HAVE AND MAINTAIN A VALID CONTRACTOR'S LICENSE FOR THE LOCATION IN WHICH THE WORK IS TO BE PERFORMED. FOR JURISDICTIONS THAT LICENSE INDIVIDUAL TRADES, THE TRADESMAN OR SUBCONTRACTOR PERFORMING THOSE TRADES SHALL BE LICENSED. RESEARCH AND COMPLY WITH THE LICENSING LAWS. PAY LICENSE FEES. AND SELECT AND INFORM SUBCONTRACTORS REGRADING THESE LAWS.
- F. OSHA: FOLLOW ALL APPLICABLE RULES AND REGULATIONS OF THE OCCUPATIONAL SAFETY AND HEALTH ADMINISTRATIONS AND STATE LAWS BASED IN THE FEDERAL OCCUPATIONAL SAFETY AND HEALTH ACT. THESE REGULATIONS INCLUDE, BUT ARE NOT LIMITED TO, REGULATIONS DEALING WITH TOWER CONSTRUCTION AND SAFETY, EXCAVATIONS AND TRENCHING, AND WORK IN CONFINED SPACES. ENSURE THAT EMPLOYEES AND SUBCONTRACTORS WEAR HARD HATS AT ALL TIMES DURING CONSTRUCTION.
- G. PHOTOS: PROVIDE PHOTOGRAPHIC EVIDENCE OF ALL FOUNDATION INSTALLATION, GROUNDING, AND TRENCHING AFTER PLACEMENT OF UTILITIES PRIOR TO BACKFILL.
- H. BUILDING PERMITS: CONTRACTOR WILL SUBMIT CONSTRUCTION DOCUMENTS TO THE JURISDICTIONAL AUTHORITY FOR PLAN CHECK AND REVIEW, CONTRACTOR WILL SUBMIT LICENSING AND WORKMAN'S COMPENSATION INFORMATION TO THE JURISDICTION AS REQUIRED TO OBTAIN THE BUILDING PERMIT, CONTRACTOR SHALL COORDINATE AND SCHEDULE REQUIRED INSPECTIONS AND POST REQUIRED PERMITS AT THE JOB SITE. COMPLY WITH SPECIFIC PROJECT.RELATIED REQUESTS AND SUGGESTION MADE BY BUILDING INSPECTOR, AND INFORM CONSTRUCTION MANAGER OF ANY SUCH WORK THAT MAY BE BEYOND THE SCOPE OF THE CONTRACT OR DEVIATE FROM THE CONSTRUCTION DOCUMENTS, AT&T WILL REIMBURSE THE CONTRACTOR FOR FEES, FOR PLAN REVIEW, BUILDING PERMIT. CONNECTIONS, AND INSPECTION. (INCLUDED IN THE BASE PROPOSAL)
- I. ZONING REGULATIONS AND CONDITIONAL USE PERMITS: CONTRACTOR WILL SUBMIT FOR AND OBTAIN AII ZONING AND CONDITIONAL USE PERMITS, SOME USE PERMITS MAY HAVE SPECIFIC REQUIREMENTS FOR THE SITE RELATED TO CONSTRUCTION, SUCH AS NOISE REGULATIONS, HOURS OF WORK, ACCESS LIMITATIONS, ETC. THE CONSTRUCTION MANAGER WILL INFORM THE CONTRACTOR OF THESE REQUIREMENTS AT THE PRE-BID MEETING OR AS SHOWN IN THE CONSTRUCTION DOCUMENTS.
- J. FAA PERMIT AND TOWER LIGHTING: REFER TO CONSTRUCTION DOCUMENTS AND CONSTRUCTION MANAGER FOR FAA AND STATE LIGHTING REQUIREMENTS. CONTRACTOR SHALL PROVIDE TEMPORARY FM APPROVED LIGHTING UNTIL PERMANENT LIGHTING IS OPERATIONAL.
- K. TOWER SECURITY: IF REQUIRED, TOWER MUST BE FENCED, TEMPORARILY OR PERMANENTLY WITHIN 24 HOURS OF ERECTION. DO NOT ALLOW THE GATE ACCESSING THE TOWER AREA TO REMAIN OPEN OR UNATTENDED ANY TIME FOR ANY REASON. KEEP THE GATE CLOSED AND LOCKED WHEN NOT IN USE.

#### L. SITE CONTROL

- I. THE CONTRACTOR IS COMPLETELY RESPONSIBLE FOR CONTAINMENT OF SEDIMENT AND CONTROL OF EROSION AT THE SITE, ANY DAMAGE TO ADJACENT OR DOWNSTREAM PROPERTIES WILL BE CORRECTED BY THE CONTRACTOR AT NO EXPENSE TO AT&T.
- 2. THE CONTRACTOR IS TO MAINTAIN ADEQUATE DRAINAGE AT ALL TIMES. DO NOT ALLOW WATER TO STAND OR POND. ANY DAMAGE TO STRUCTURES OR WORK ON THE SITE CAUSED BY INADEQUATE MAINTENANCE OF DRAINAGE PROVISIONS WILL BE THE RESPONSIBILITY OF THE CONTRACTOR AND ANY COST ASSOCIATED WITH REPAIRS FOR SUCH DAMAGE WILL BE AT THE CONTRACTOR'S EXPENSE.
- ALL WASTE MATERIAL SHALL BE PROPERLY DISPOSED OF OFF-SITE OR AS DIRECTED BY THE CONSTRUCTION MANAGER AND IN ACCORDANCE WITH IURISDICTIONAL AUTHORITIES.

#### GENERAL NOTES

- I. IT IS THE CONTRACTOR'S RESPONSIBILITY TO EXAMINE ALL PLAN SHEETS AND SPECIFICATIONS AND COORDINATE HIS WORK WITH THE WORK OF ALL OTHER CONTRACTORS TO ENSURE THAT WORK PROGRESSION IS NOT INTERRUPTED.
- THE CONTRACTOR IS RESPONSIBLE FOR MAINTAINING A NEAT AND ORDERLY SITE, YARD AND
  GROUNDS. CONTRACTOR SHALL REMOVE AND DISPOSE OFF SITE ALL RUBBISH, WASTE MATERIALS,
  LITTER AND ALL FOREIGN SUBSTANCES. REMOVE PETROCHEMICAL SPILLS, STAINS AND OTHER FOREIGN
  DEPOSITS. RAKE GROUNDS TO A SMOOTH EVEN-TEXTURED SURFACE.
- 3. THE PLANS SHOW SOME KNOW SUBSURFACE STRUCTURES ABOVE GROUND STRUCTURES AND/OR UTILITIES BELIEVED TO EXIST IN THE WORKING AREA. EXACT LOCATION OF WHICH MAY VARY FROM THE LOCATIONS INDICATED, IN PARTICULAR. THE CONTRACTOR IS WARNED THAT THE EXACT OR EVEN APPROXIMATE LOCATIONS OF SUCH PIPELINES, SUBSURFACE STRUCTURES AND/OR UTILITIES IN THE AREA MAY BE SHOWN OR MAY NOT BE SHOWN AND IT SHALL BE HIS RESPONSIBILITY TO PROCEED WITH GREAT CARE IN EXCAVATION ANY WORK. 48 HOURS BEFORE YOU DIG, DRILL OR BLAST CALL LOCAL UTILITY LOCATOR COMPANY.
- 4. THE OWNER OR OWNERS'S REPRESENTATIVE SHALL BE NOTIFIED IN WRITING OF ANY CONDITIONS THAT VARY FROM THOSE SHOWN ON THE PLANS. THE CONTRACTOR'S WORK SHALL NOT VARY FROM THE PLANS WITHOUT THE EXPRESSED APPROVAL OF THE OWNER OR THE OWNER'S REPRESENTATIVE.
- 5. THE CONTRACTOR IS INSTRUCTED TO COOPERATE WITH ANY AND ALL OTHER CONTRACTORS PERFORMING WORK ON THIS JOB SITE DURING THE PERFORMANCE OF THIS CONTRACT
- 6. THE CONTRACTOR SHALL RESTORE ALL DAMAGED, PUBLIC OR PRIVATE, PROPERTY TO AT LEAST AS GOOD OF CONDITION AS BEFORE DISTURBED AS DETERMINED BY THE OWNER OR OWNER'S REPRESENTATIVE
- 7. THE CONTRACTOR SHALL COMPLY WITH ALL REQUIRED PERMITS.
- THE CONTRACTOR SHALL PROTECT EXISTING PROPERTY LINE MONUMENTATION. ANY
  MONUMENTATION DISTURBED OR DESTROYED, AS JUDGED BY THE OWNER OR OWNER'S
  REPRESENTATIVE SHALL BE REPLACED.
- ALL TRENCH EXCAVATION AND ANY REQUIRED SHEETING AND SHORING SHALL BE DONE IN ACCORDANCE WITH OSHA REGUI ATIONS FOR CONSTRUCTION
- 10. CONTRACTOR SHALL BE RESPONSIBLE FOR DEWATERING AND THE MAINTENANCE OF SURFACE DRAINAGE DURING THE COURSE OF WORK.
- II. ALL UTILITY WORK INVOLVING CONNECTIONS TO EXISTING SYSTEMS SHALL BE COORDINATED WITH THE OWNER OR OWNER'S REPRESENTATIVE AND THE UTILITY OWNER BEFORE EACH AND EVERY CONNECTION TO EXISTING SYSTEMS IS MADE.
- 12. MAINTAIN FLOW FOR ALL EXISTING UTILITIES.
- 13. ALL SITE FILL SHALL MEET SELECTED FILL STANDARDS AS DEFINED BY THE OWNER OR OWNER'S REPRESENTATIVE ON THE DRAWINGS OR GEOTECHNICAL REPORT RECOMMENDATIONS
- 14. CONTRACTOR TO GRADE ALL AREAS OF THE SITE TO PROVIDE POSITIVE DRAINAGE AWAY FROM THE BUILDING OR EQUIPMENT PAD AND THE TOWER.
- 15. IF NECESSARY, THE CONTRACTOR IS RESPONSIBLE FOR REPAIRING AND REGRADING ROADWAY AND ANY DISTURBED AREAS FOLLOWING INSTALLATION OF UTILITIES.
- 16. NO COMMERCIAL MESSAGES TO BE DISPLAYED ON TOWER
- 17. WATER AND SEWER SERVICES ARE NOT REQUIRED FOR THIS DEVELOPMENT
- 18. THE CONTRACTOR SHALL FURNISH AND INSTALL ALL MATERIALS UNLESS NOTED.



CREVE COEUR, MO 63141






I 100 E. WOODFIELD ROAD, SUITE 500 SCHAUMBURG, ILLINOIS 60173 TEL: 847-908-8400 COA# E2019038761 www.fullerton-us.com

#	DATE	DESCRIPTION	INT.
Α	04/04/25	90% REVIEW	ВН
В	04/14/25	95% REVIEW	ВН
0	06/05/25	FINAL	вн

I HEREBY CERTIFY THAT THESE DRAWINGS WERI PREPARED BY ME OR UNDER MY DIRECT STEPPINSION AND CONTROL, AND TO THE BEST OF MY KNOWLEDGE AND BELIEF COMPLY WITH THE REQUIREMENTS OF ALL APPLICABLE CODES

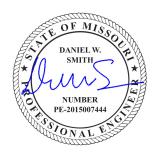

SITE NAME

**GREEN** 

SITE NO.

KSL04130

SITE ADDRESS


202 EAST THIRD STREET


SHEET NAME

**GENERAL NOTES** 


SHEET NUMBER

T-2

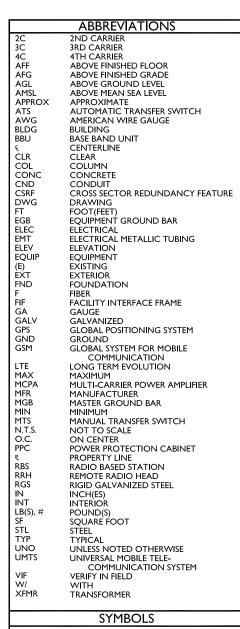

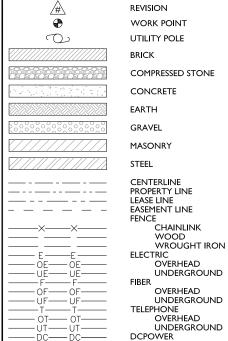

SECTION REFERENCE

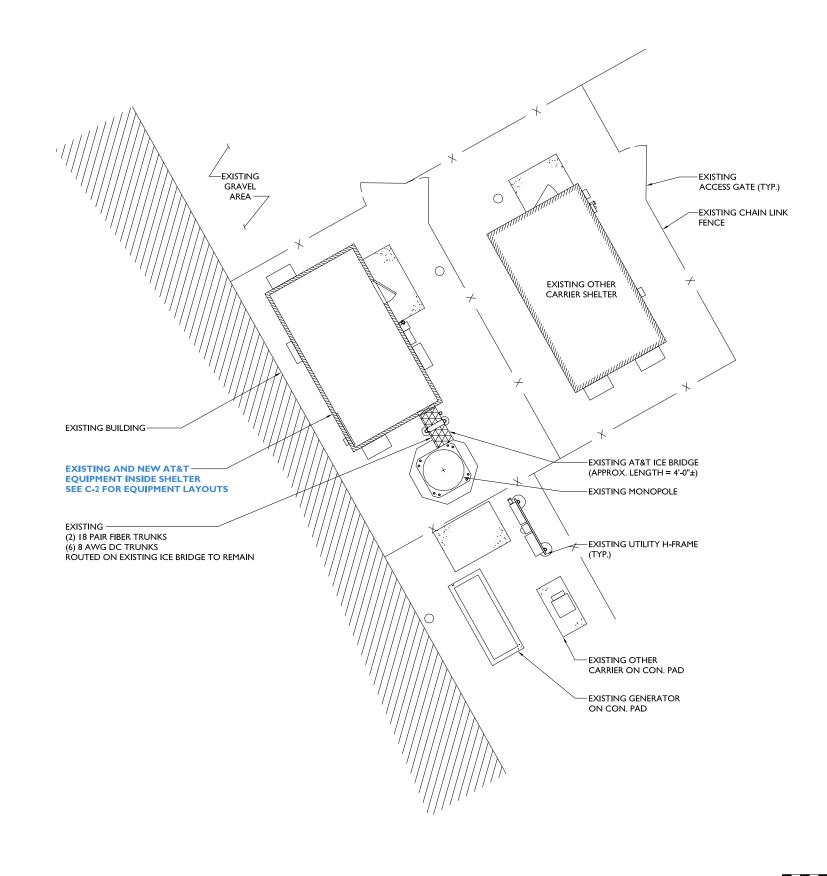



12930 OLIVE BLVD CREVE COEUR, MO 63141





I 100 E. WOODFIELD ROAD, SUITE 500 SCHAUMBURG, ILLINOIS 60173 TEL: 847-908-8400 COA# E2019038761 www.fullerton-us.com

#	DATE	DESCRIPTION	INT.
Α	04/04/25	90% REVIEW	вн
В	04/14/25	95% REVIEW	ВН
0	06/05/25	FINAL	ВН

I HEREBY CERTIFY THAT THESE DRAWINGS WERE PREPARED BY ME OR UNDER MY DIRECT SUPERVISION AND CONTROL, AND TO THE BEST OF MY KNOWLEDGE AND BELIEF COMPLY WITH THE REQUIREMENTS OF ALL APPLICABLE CODES.



SITE NAME

**GREEN** 

SITE NO.

KSL04130

SITE ADDRESS

202 EAST THIRD STREET LEES SUMMIT, MO 64063

SHEET NAME


SITE PLAN

SHEET NUMBER

SCALE: 3/32" = 1'-0"

C-I

SITE PLAN

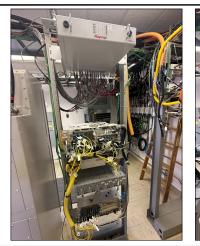

EXISTING EQUIPMENT LAYOUT











12930 OLIVE BLVD CREVE COEUR, MO 63141



SITE PHOTOS - EXISTING EQUIPMENT

SCALE: N.T.S. 3



I 100 E. WOODFIELD ROAD, SUITE 500 SCHAUMBURG, ILLINOIS 60173 TEL: 847-908-8400 COA# E2019038761 www.fullerton-us.com

#	DATE	DESCRIPTION	INT.
Α	04/04/25	90% REVIEW	ВН
В	04/14/25	95% REVIEW	ВН
0	06/05/25	FINAL	ВН

HEREBY CERTIFY THAT THESE DRAWINGS WERE PREPARED BY ME OR UNDER MY DIRECT SUPERVISION AND CONTROL, AND TO THE BEST OF MY KNOWLEDGE AND BELIEF COMPLY WITH THE REQUIREMENTS OF ALL APPLICABLE CODES.



SITE NAME

**GREEN** 

SITE NO.

KSL04130

SITE ADDRESS


202 EAST THIRD STREET LEES SUMMIT, MO 64063

SHEET NAME
EQUIPMENT

LAYOUTS AND SITE PHOTOS


SHEET NUMBER

**C-2** 

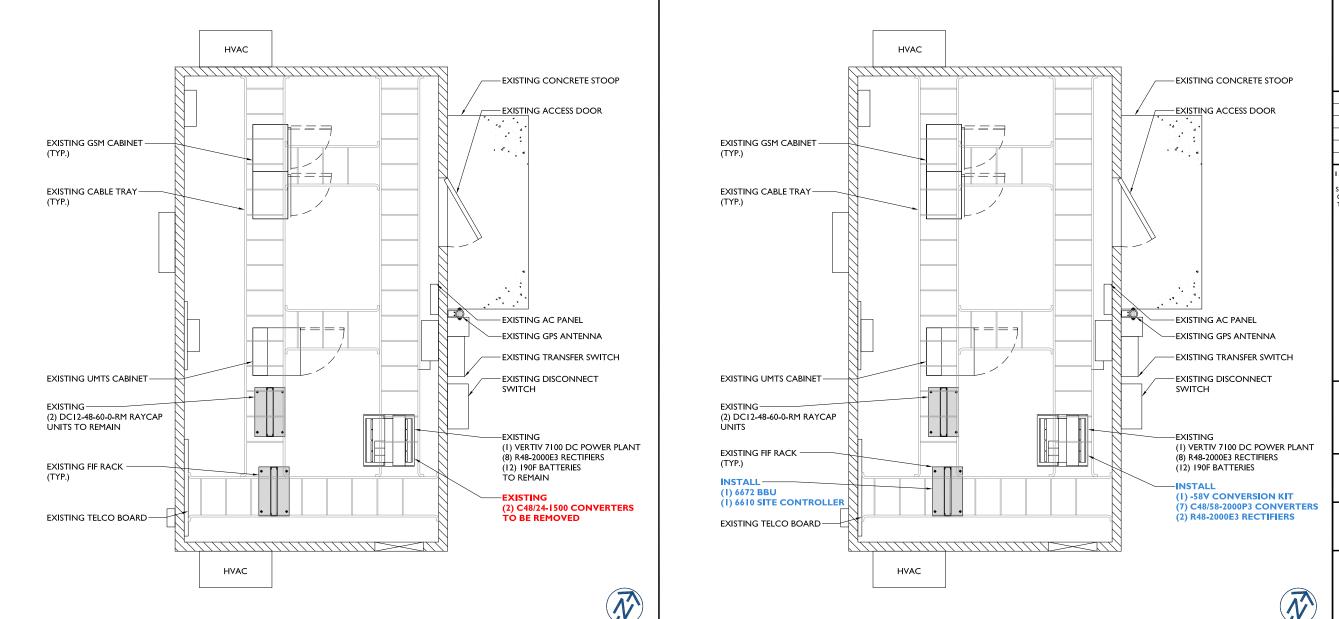

FINAL EQUIPMENT LAYOUT

SCALE: I/4" = I'-0"

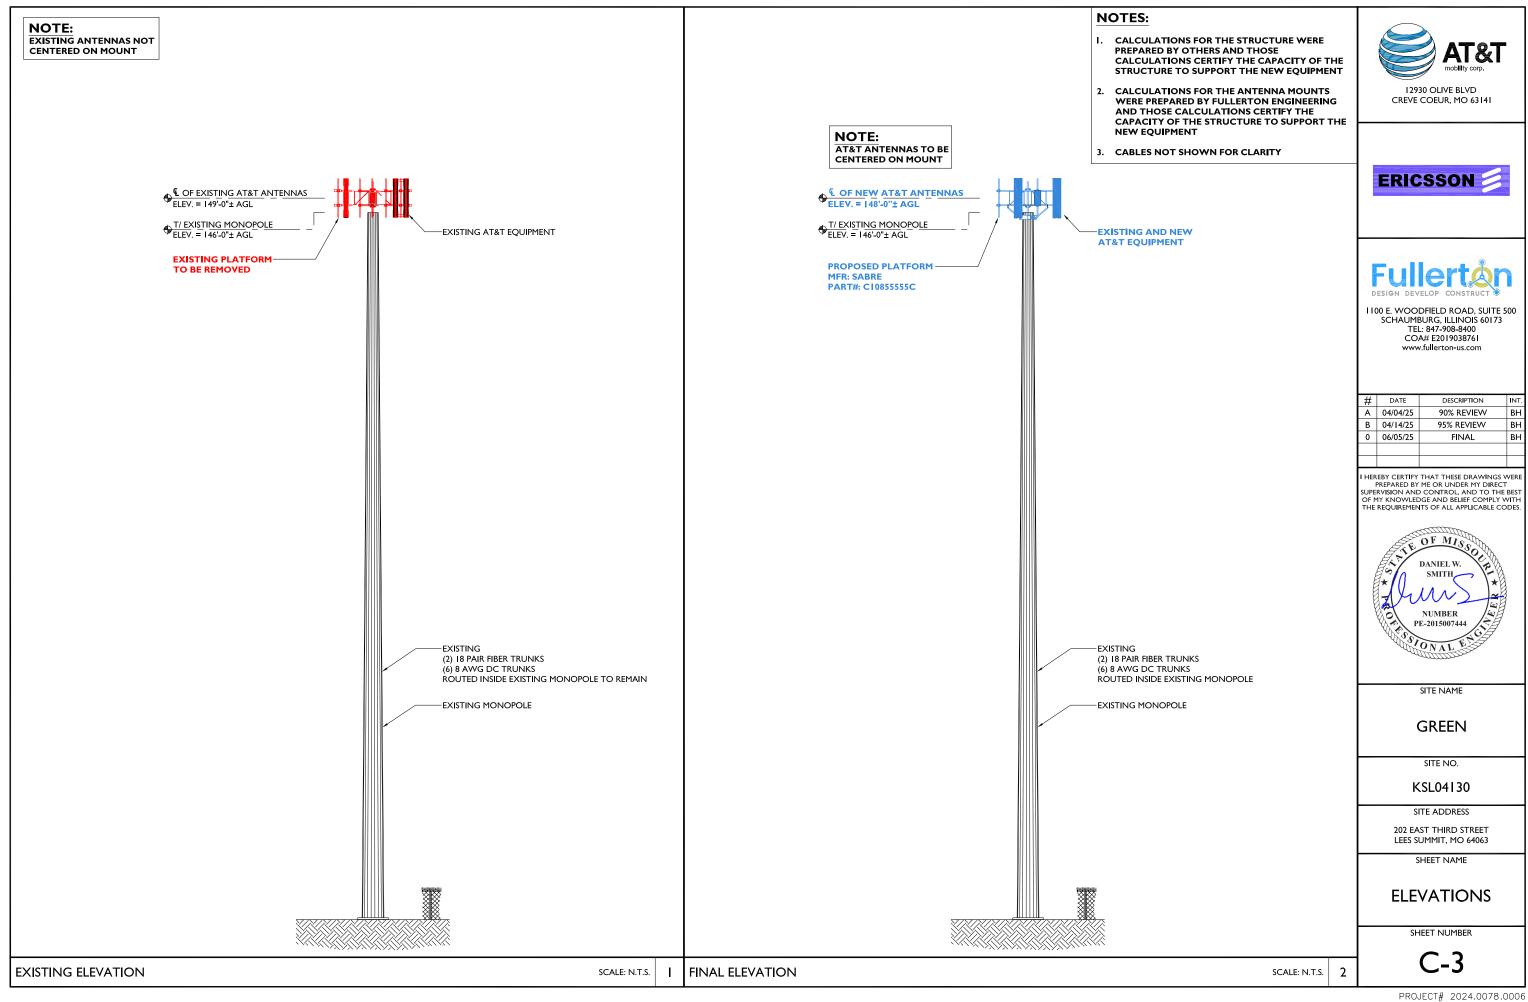

### **NOTES:**

- CALCULATIONS FOR THE STRUCTURE WERE PREPARED BY OTHERS AND THOSE CALCULATIONS CERTIFY THE CAPACITY OF THE STRUCTURE TO SUPPORT THE NEW EQUIPMENT
- CALCULATIONS FOR THE ANTENNA MOUNTS WERE PREPARED BY FULLERTON ENGINEERING AND THOSE CALCULATIONS CERTIFY THE CAPACITY OF THE STRUCTURE TO SUPPORT THE NEW EQUIPMENT
- CABLES NOT SHOWN FOR CLARITY



12930 OLIVE BLVD CREVE COEUR, MO 63141





I 100 E. WOODFIELD ROAD, SUITE 500 SCHAUMBURG, ILLINOIS 60173 TEL: 847-908-8400 COA# E2019038761 www.fullerton-us.com

#	DATE	DESCRIPTION	INT.
Α	04/04/25	90% REVIEW	вн
В	04/14/25	95% REVIEW	вн
0	06/05/25	FINAL	ВН

HEREBY CERTIFY THAT THESE DRAWINGS WERI PREPARED BY ME OR UNDER MY DIRECT UPERVISION AND CONTROL, AND TO THE BES OF MY KNOWLEDGE AND BELIEF COMPLY WITH THE REQUIREMENTS OF ALL APPLICABLE CODES



SITE NAME

**GREEN** 

SITE NO.

KSL04130


SITE ADDRESS


202 EAST THIRD STREET LEES SUMMIT, MO 64063

SHEET NAME

**ANTENNA LAYOUTS** 

SHEET NUMBER

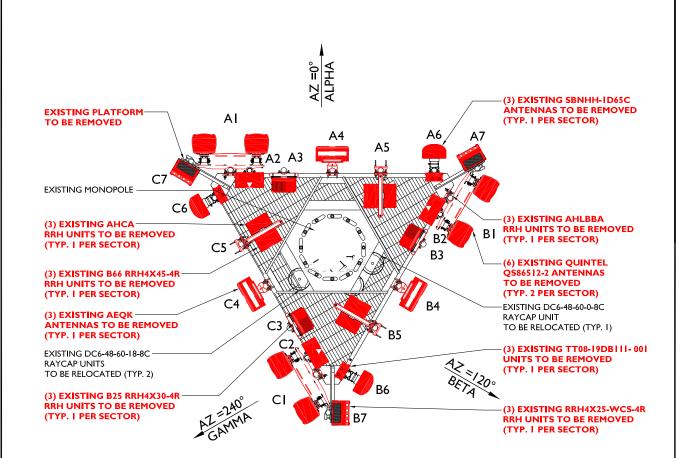

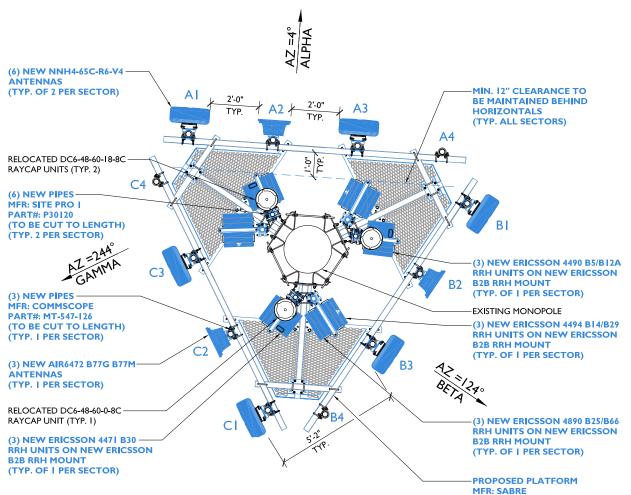





SCALE: I/4" = I'-0" 2

PART#: C10855555C

FINAL ANTENNA LAYOUT

				EXISTING A	NTENNA SCHEDULE			
LC	OCATION			ANTENNA SU	JMMARY		NON ANTENNA SUMMAF	₹Y
SECTOR	RAD	AZ	POS	ANTENNA	BAND	STATUS	ADDITIONAL TOWER MOUNTED EQUIPMENT	STATUS
			A1	(2) QUINTEL QS86512-2	-	RMV	-	-
			A2	-	_	_	AHLBBA	RMV
			A3	-	-	_	B25-RRH4X30-4R	RMV
ALPHA	149'	0°	A4	(1) AEQK	-	RMV	-	_
			<b>A</b> 5	-	-	_	RRH4X45-4R AHCA	RMV RMV
			A6	(1) SBNHH-1D65C	_	RMV	TT08-19DB111- 001	RMV
			A7	-	-		RRH4X25-WCS-4R	RMV
			B1	(2) QUINTEL QS86512-2	=	RMV	-	
	149'		B2	-	-	_	AHLBBA	RMV
		49' 120°	В3	-	-	_	B25-RRH4X30-4R	RMV
BETA			B4	(1) AEQK	-	RMV	-	-
			B5	-	-	-	RRH4X45-4R AHCA	RMV RMV
			В6	(1) SBNHH-1D65C	_	RMV	TT08-19DB111- 001	RMV
			В7	_	_		RRH4X25-WCS-4R	RMV
			C1	(2) QUINTEL QS86512-2	-	RMV	-	ı
			C2	_	_	_	AHLBBA	RMV
			C3	_	_	_	B25-RRH4X30-4R	RMV
GAMMA	149'	240°	C4	(1) AEQK	-	RMV	-	-
			C5	-	-	_	RRH4X45-4R AHCA	RMV RMV
			C6	(1) SBNHH-1D65C	_	RMV	TT08-19DB111- 001	RMV
			C7	_	_		RRH4X25-WCS-4R	RMV

EXISTING FIBER DISTRIBUTION	/SQUID			
MODEL NUMBER	STATUS	DC TRUNK	FIBER TRUNK	STATUS
(2) DC6-48-60-18-8C (1) DC6-48-60-0-8C	REL REL	(6) 8 AWG	(2) 18 PAIR	RMN

DC TRUNK

(6) 8 AWG

FIBER TRUNK

(2) 18 PAIR

STATUS

RMN



CREVE COEUR, MO 63141





1100 E. WOODFIELD ROAD, SUITE 500 SCHAUMBURG, ILLINOIS 60173 TEL: 847-908-8400 COA# E2019038761 www.fullerton-us.com

#	DATE	DESCRIPTION	INT.
Α	04/04/25	90% REVIEW	вн
В	04/14/25	95% REVIEW	вн
0	06/05/25	FINAL	ВН

I HEREBY CERTIFY THAT THESE DRAWINGS WERE PREPARED BY ME OR UNDER MY DIRECT SUPERVISION AND CONTROL, AND TO THE BEST OF MY KNOWLEDGE AND BELIEF COMPLY WITH THE REQUIREMENTS OF ALL APPLICABLE CODES.



SITE NAME

**GREEN** 

SITE NO.

KSL04130

SITE ADDRESS

202 EAST THIRD STREET LEES SUMMIT, MO 64063

SHEET NAME

ANTENNA SCHEDULES

SHEET NUMBER

C-5

STATUS ABBREVIATIONS

RMV: TO BE REMOVED

RMN: TO REMAIN

REL: TO BE RELOCATED

ADD: TO BE ADDED

C4

LOCATION		ANTENNA SUMMARY			NON ANTENNA SUMMARY			
SECTOR	RAD	AZ	POS	ANTENNA	BAND	STATUS	ADDITIONAL TOWER MOUNTED EQUIPMENT	STATUS
ALPHA 148'			A1	(1) NNH4-65C-R6-V4	-	ADD	ERICSSON 4490 B5/B12A ERICSSON 4471 B30	ADD ADD
	148'	4°	A2	AIR6472 B77G B77M	-	ADD	-	-
		·	А3	(1) NNH4-65C-R6-V4	-	ADD	ERICSSON 4890 B25/B66 ERICSSON 4494 B14/B29	ADD ADD
			A4	-	-	-	-	-
BETA 148			B1	(1) NNH4-65C-R6-V4	-	ADD	ERICSSON 4490 B5/B12A ERICSSON 4471 B30	ADD ADD
	148'	124°	B2	AIR6472 B77G B77M	-	ADD	-	=
BETA	140	124	В3	(1) NNH4-65C-R6-V4	-	ADD	ERICSSON 4890 B25/B66 ERICSSON 4494 B14/B29	ADD ADD
			B4	-	-	-	•	-
			C1	(1) NNH4-65C-R6-V4	-	ADD	ERICSSON 4490 B5/B12A ERICSSON 4471 B30	ADD ADD
GAMMA	148'	244°	C2	AIR6472 B77G B77M	-	ADD	-	-
GAMMA	140	148' 244°	С3	(1) NNH4-65C-R6-V4	-	ADD	ERICSSON 4890 B25/B66 ERICSSON 4494 B14/B29	ADD ADD
					<del> </del>			

FINAL ANTENNA SCHEDULE

RRH UNITS GAUGE	AND VOLTAGE
RRH MODEL	WIRE GAUGE / VOLTAGE
AIR6472 B77G B77M	8 AWG / -48V
ERICSSON 4490 B5/B12A	8 AWG / -48V
ERICSSON 4471 B30	8 AWG / -48V
ERICSSON 4890 B25/B66	8 AWG / -48V
ERICSSON 4494 B14/B29	8 AWG / -48V


STATUS

REL

FINAL FIBER DISTRIBUTION/SQUID

MODEL NUMBER

(2) DC6-48-60-18-8C (1) DC6-48-60-0-8C

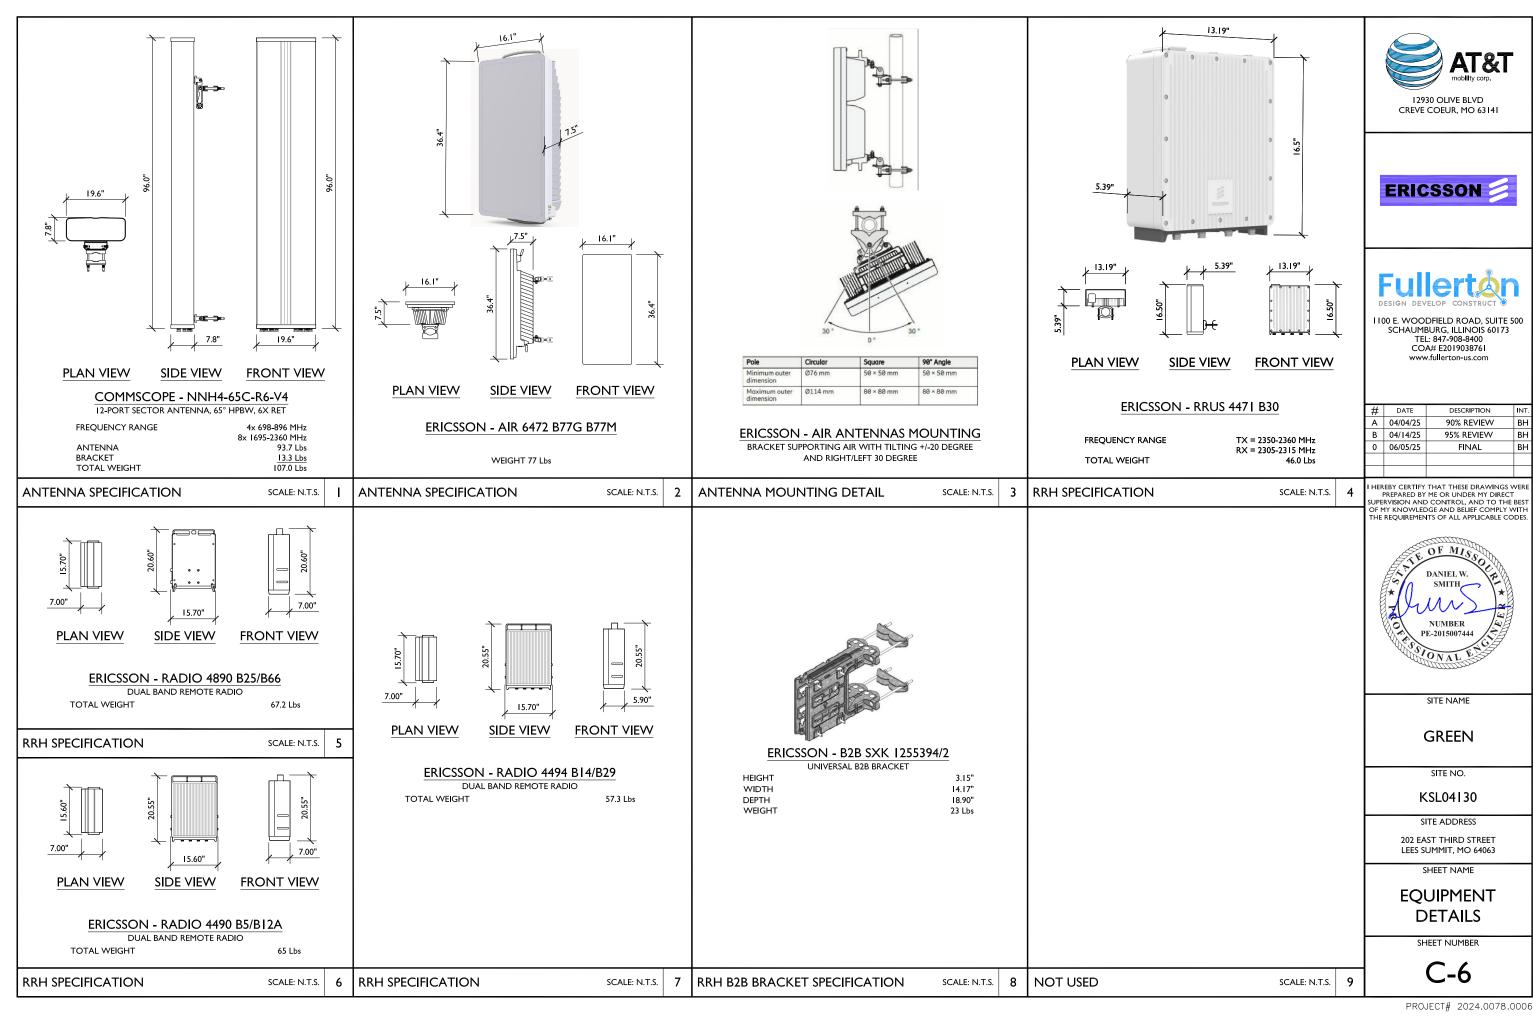





### Vertiv<sup>™</sup> NetSure<sup>™</sup> Converter System The Vertiv™ NetSure™ Converter System is ideal for powering remote radios over long cable lengths. easy expansion of operating capacity growth as site needs dictate Hot insertion capability Allows for system expansis without disruption The Vertiv™ NetSure™ Converter System provides up to 600 amps at -58 volts DC via **Surge Protection** high frequency switch mode converters, each rated at 2000 watts peak, 1600 watts average. The modular design allows the converter's capacity to expand as your system expands. The base system can accept eleven individual, plug-in converter modules that can be easily installed live without system interruption. Up to two six-expansion allows for shedding non-critical loads The distribution panel is available with four large GJ/218 type circuit breaker positions or twenty-six bullet type device positions. The large positions accommodate up to a 250 amp breaker per position and up to an 800 amp breaker in four positions. The bullet type panel accommodates devices from 1 amp to 300 amps. A second 26-position bullet Standard Features type panel can be added for expansion. Safety compliance - NEBS, UL The NetSure NCU controller provides system management, monitoring and alarming. Nine (9) Form-C alarm outputs Current limiting The Vertiv<sup>™</sup> NetSure<sup>™</sup> Converter System is compact and easy to expand, making it ideal Over-voltage protection for radio base station sites requiring -58 VDC output. Over-temperature protection **Ordering Information** · Load sharing for parallel . Easily accessible input and 58464100002 DCS48/58-600 Converter System. (26) Bullet Positions, with Contactor installation DCS48/58-600 Converter System. (4) GJ/218 CB Positions, without Contactor · Emergency Power Off DCS48/58-600 Converter System, (4) GJ/218 CB Positions, with Contactor 584641000AL DCS48/58-600 Expansion Distribution Panel. (26) Bullet Positions, without Contactor 584641000CL DCS48/58-600 Expansion Distribution Panel, (26) Bullet Positions, with Contactor NCU Controller, 10044525 Configuration 1M830BNA10044525 M830B 1C48582000P3 C48/58-2000P3 eSure DC/DC converter, -48VDC to -58VDC, 2000 watts Peak









I 100 E. WOODFIELD ROAD, SUITE 500 SCHAUMBURG, ILLINOIS 60173 TEL: 847-908-8400 COA# E2019038761 www.fullerton-us.com

	#	DATE	DESCRIPTION	INT.		
	Α	04/04/25	90% REVIEW	ВН		
	В	04/14/25	95% REVIEW	ВН		
	0	06/05/25	FINAL	ВН		

HEREBY CERTIFY THAT THESE DRAWINGS WERE PREPARED BY ME OR UNDER MY DIRECT OF THE BEST OF MY KNOWLEDGE AND BELIEF COMPLY WITH THE REQUIREMENTS OF ALL APPLICABLE CODES.



SITE NAME

GREEN

SITE NO.

KSL04130

SITE ADDRESS

202 EAST THIRD STREET LEES SUMMIT, MO 64063


SHEET NAME

EQUIPMENT DETAILS

SHEET NUMBER

C-7

CONVERTER SPECIFICATION SCALE: N.T.S. I VERTIV NETSURE CONVERTER SYSTEM SCALE: N.T.S. 2 RECTIFIER SPECIFICATION SCALE: N.T.S. 3

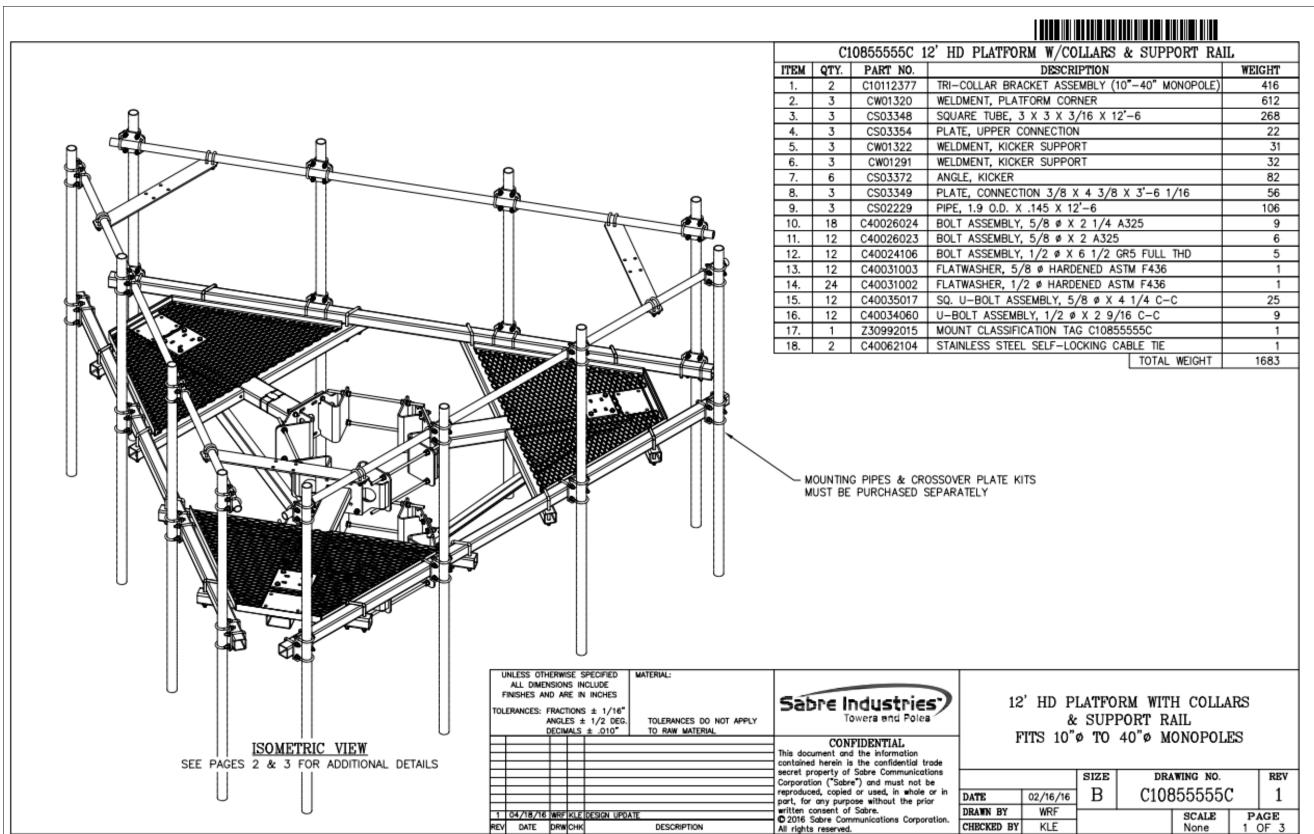



12930 OLIVE BLVD CREVE COEUR, MO 63141





I 100 E. WOODFIELD ROAD, SUITE 500 SCHAUMBURG, ILLINOIS 60173 TEL: 847-908-8400 COA# E2019038761 www.fullerton-us.com

	#	DATE	DESCRIPTION	INT.
	Α	04/04/25	90% REVIEW	вн
	В	04/14/25	95% REVIEW	вн
	0	06/05/25	FINAL	вн

I HEREBY CERTIFY THAT THESE DRAWINGS WERE PREPARED BY ME OR UNDER MY DIRECT SUPERVISION AND CONTROL, AND TO THE BEST OF MY KNOWLEDGE AND BELIEF COMPLY WITH THE REQUIREMENTS OF ALL APPLICABLE CODES.



SITE NAME

**GREEN** 

SITE NO.

KSL04130

SITE ADDRESS

202 EAST THIRD STREET LEES SUMMIT, MO 64063

SHEET NAME

EQUIPMENT DETAILS

SHEET NUMBER

C-8







1100 E. WOODFIELD ROAD, SUITE 500 SCHAUMBURG, ILLINOIS 60173 TEL: 847-908-8400 COA# E2019038761 www.fullerton-us.com

#	DATE	DESCRIPTION	INT.
Α	04/04/25	90% REVIEW	вн
В	04/14/25	95% REVIEW	ВН
0	06/05/25	FINAL	ВН

I HEREBY CERTIFY THAT THESE DRAWINGS WERE PREPARED BY ME OR UNDER MY DIRECT SUPERVISION AND CONTROL, AND TO THE BEST OF MY KNOWLEDGE AND BELIEF COMPLY WITH THE REQUIREMENTS OF ALL APPLICABLE CODES.



SITE NAME

**GREEN** 

SITE NO.

KSL04130

SITE ADDRESS


202 EAST THIRD STREET LEES SUMMIT, MO 64063


SHEET NAME


MOUNTING **DETAILS** 

SHEET NUMBER

SCALE: 3/8" = 1'-0" 2

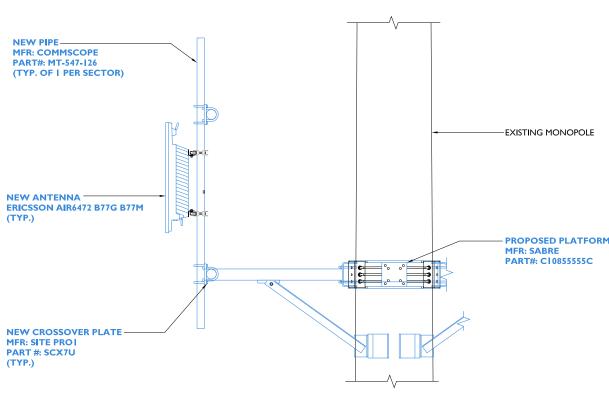

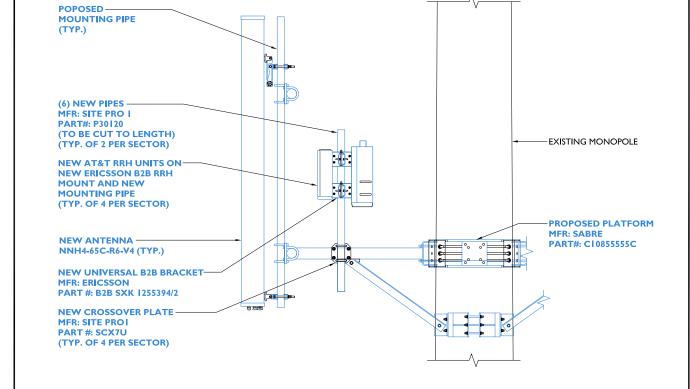

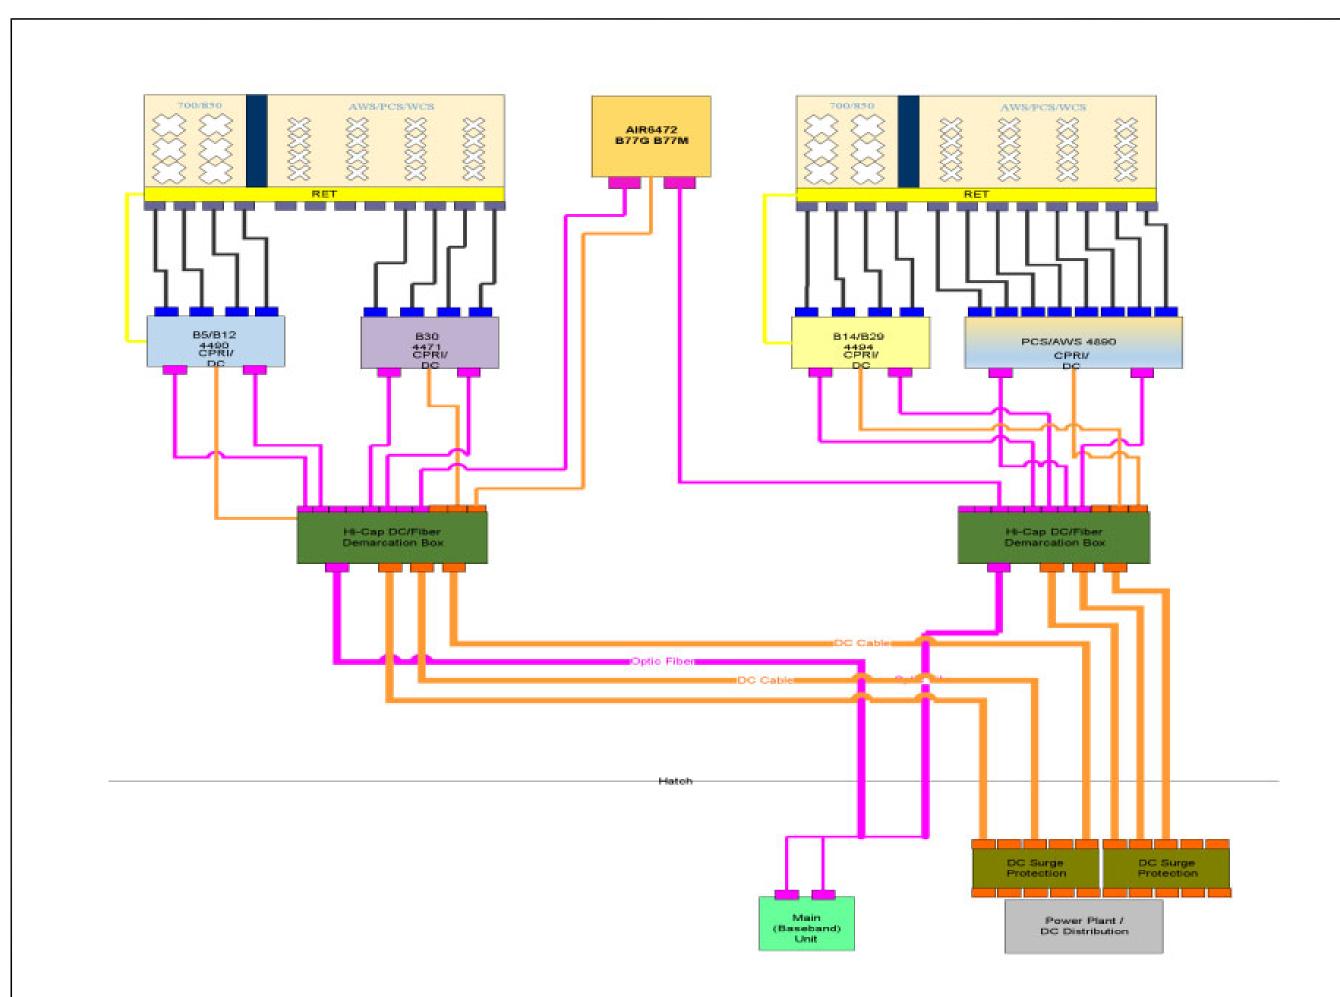



12930 OLIVE BLVD CREVE COEUR, MO 63141





1100 E. WOODFIELD ROAD, SUITE 500 SCHAUMBURG, ILLINOIS 60173 TEL: 847-908-8400 COA# E2019038761 www.fullerton-us.com

#	DATE	DESCRIPTION	INT.
Α	04/04/25	90% REVIEW	вн
В	04/14/25	95% REVIEW	вн
0	06/05/25	FINAL	вн

I HEREBY CERTIFY THAT THESE DRAWINGS WERE PREPARED BY ME OR UNDER MY DIRECT SUPERVISION AND CONTROL, AND TO THE BEST OF MY KNOWLEDGE AND BELIEF COMPLY WITH THE REQUIREMENTS OF ALL APPLICABLE CODES.



SITE NAME

**GREEN** 

SITE NO.

KSL04130 SITE ADDRESS


202 EAST THIRD STREET LEES SUMMIT, MO 64063


SHEET NAME

**PLUMBING** DIAGRAM

SHEET NUMBER

C-10

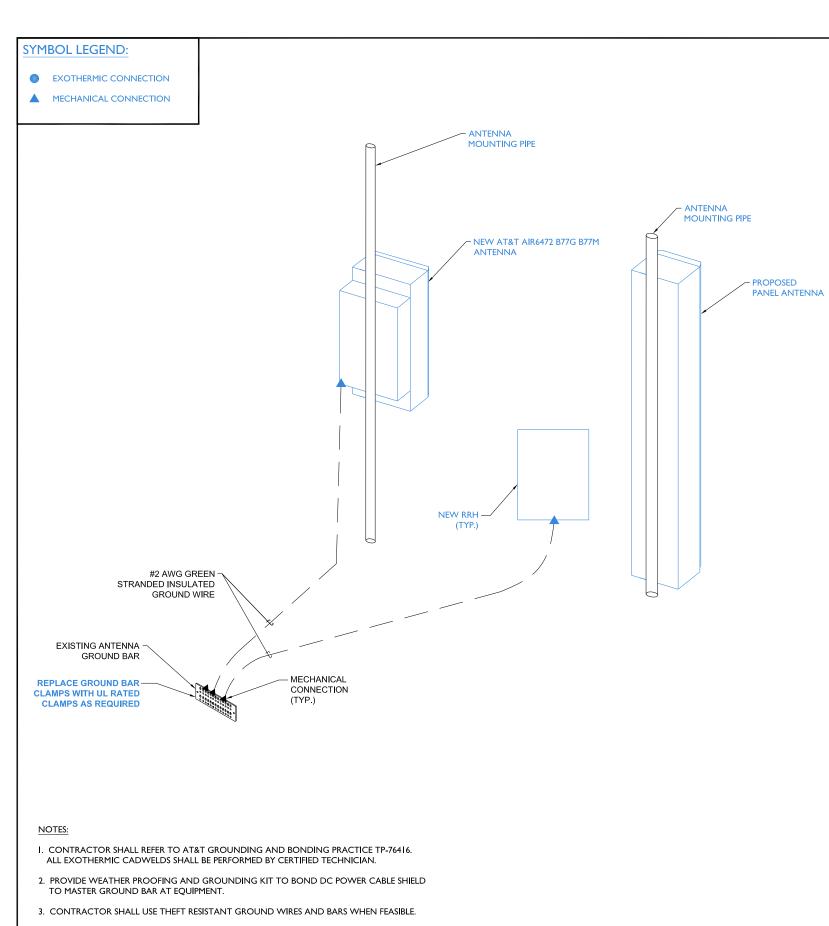

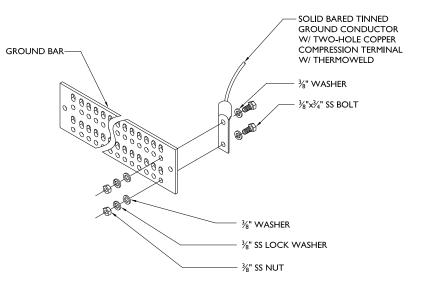

### NOTES:

- UTILIZE EXISTING AT&T GROUND BARS AND GROUNDING.
- ADD GROUND BARS IF THERE ARE INSUFFICIENT LUG POSITIONS.
- REFERENCE AT&T BONDING & GROUNDING PRACTICE TP76416.







I 100 E. WOODFIELD ROAD, SUITE 500 SCHAUMBURG, ILLINOIS 60173 TEL: 847-908-8400 COA# E2019038761 www.fullerton-us.com

	#	DATE	DESCRIPTION	INT.
	Α	04/04/25	90% REVIEW	ВН
	В	04/14/25	95% REVIEW	ВН
١	0	06/05/25	FINAL	ВН
2				

TYPICAL GROUND BAR CONNECTION DETAIL SCALE: N.T.S.

> HEREBY CERTIFY THAT THESE DRAWINGS WERI PREPARED BY ME OR UNDER MY DIRECT SUPERVISION AND CONTROL. AND TO THE BEST OF MY KNOWLEDGE AND BELIEF COMPLY WITH THE REQUIREMENTS OF ALL APPLICABLE CODES.



SITE NAME

**GREEN** 

SITE NO.

KSL04130

SITE ADDRESS

202 EAST THIRD STREET LEES SUMMIT, MO 64063

SHEET NAME

**GROUNDING DETAILS** 

SHEET NUMBER

- 4. CONTRACTOR SHALL MAINTAIN A 12" MINIMUM GROUND WIRE BEND RADIUS.
- 5. GROUND LUGS, HEATSHRINK AND CLAMPS DEVICES SHALL COMPLY WITH AT&T GROUNDING AND BONDING PRACTICE TP-76416.

ANTENNA GROUNDING SCHEMATIC SCALE: N.T.S. NOT USED SCALE: N.T.S. 3

