LEGEND: ACCESS EASEMENT - BACK OF CURB BACK TO BACK BENCHMARK BUILDING LINE CO - CLEANOUT - TELEPHONE JUNCTION BOX - CURB AND GUTTER DRAINAGE EASEMENT - ELECTRICAL EASEMENT - ELEVATION FLOW LINE G/E GAS LINE EASEMENT HIGH-DENSITY POLYETHYLENE LANDSCAPE EASEMENT MINIMUM SERVICEABLE FLOOR **ELEVATION** POLYVINYL CHLORIDE PROPERTY LINE - PUBLIC EASEMENT REINFORCED CONCRETE PIPE ROW or R/W - RIGHT-OF-WAY SANITARY SEWER EASEMENT SERVICE LINE - SIDEWALK TOP ELEVATION U/E UTILITY EASEMENT WATER SURFACE ELEVATION WATERLINE EASEMENT **ASPHALT PAVEMENT - EXISTING** ASPHALT PAVEMENT - PROPOSED **CONCRETE PAVEMENT - EXISTING** CONCRETE SIDEWALK - EXISTING CONCRETE SIDEWALK - PROPOSED CURB & GUTTER CURB & GUTTER - EXISTING TREELINE — EXISTING LOT AND R/W LINES EXISTING PLAT LINES ——P/L—— PROPERTY LINES —— ROW —— RIGHT-OF-WAY SANITARY SEWER MAIN SANITARY SEWER MAIN - EXIST. —— STO — STORM SEWER STORM SEWER - EXISTING ---- CATV_x ---- CABLE TV - EXISTING FOC_x FIBER OPTIC CABLE - EXISTING TELEPHONE LINE - EXIST. —— E_x — ELECTRIC LINE - EXISTING ----- OHP_x ----- OVERHEAD POWER LINE - EXIST ----- UGE_Y ----- UNDERGROUND ELECTRIC - EX. —— G_x —— GAS LINE - EXISTING WATERLINE - EXISTING LIGHT - EXISTING **EXISTING MANHOLE** CLEANOUT EXISTING SANITARY MANHOLE PROPOSED SANITARY MANHOLE **EXISTING AREA INLET** EXISTING CURB INLET EXISTING GRATE INLET **EXISTING JUNCTION BOX EXISTING STORM MANHOLE**

SANITARY MAIN EXTENSION PLANS

CORNERSTONE AT BAILEY FARMS, SECOND PLAT

IN THE CITY OF LEE'S SUMMIT JACKSON COUNTY, MO

ALL CONSTRUCTION TO FOLLOW THE CITY OF LEE'S SUMMIT DESIGN AND CONSTRUCTION MANUAL AS

MEASUREMENTS. ALL PAYMENTS SHALL BE MADE ON HORIZONTAL MEASUREMENTS

ENGINEERING DEPARTMENT OF THE CITY OF LEE'S SUMMIT, MISSOURI.

WITHOUT PERMISSION OF THE OWNER, UNLESS SHOWN OTHERWISE.

AND SHALL KEEP THE STREETS CLEAN OF MUD AND DEBRIS

LOCATED AT LEAST 5 FEET FROM SANITARY MAIN.

New City Requirements:

structures.

Flowable fill required per City

specifications at all sanitary sewer

ABOVE GRADE, 4" SIDE FACING THE STREET

CONTRACTOR, OR AS DIRECTED BY THE OWNER AT NO ADDITIONAL COST.

THE MANUAL ON UNIFORM TRAFFIC CONTROL DEVICES (MUTCD-LATEST EDITION)

ALL WORKMANSHIP AND MATERIALS SHALL BE SUBJECT TO THE INSPECTION AND APPROVAL OF THE

LINEAL FOOT MEASUREMENTS SHOWN ON THE PLANS ARE HORIZONTAL MEASUREMENTS, NOT SLOPE

THE UTILITY LOCATIONS SHOWN ON THESE PLANS ARE TAKEN FROM UTILITY COMPANY RECORDS AND

THE CONTRACTOR SHALL ADHERE TO THE PROVISIONS OF THE SENATE BILL NUMBER 583, 78TH GENERAL

CONTRACTOR MAY ALSO UTILIZE THE FOLLOWING TOLL FREE PHONE NUMBER PROVIDED BY "MISSOURI ONE

CALL SYSTEM, INC.": 1-800-DIG-RITE. THIS PHONE NUMBER IS APPLICABLE ANYWHERE WITHIN THE STATE OF

MISSOURI. PRIOR TO COMMENCEMENT OF WORK, THE CONTRACTOR SHALL NOTIFY ALL THOSE COMPANIES

CLEARING AND GRUBBING OPERATIONS AND DISPOSAL OF ALL DEBRIS THEREFROM SHALL BE PERFORMED

THE CONTRACTOR SHALL CONTROL THE EROSION AND SILTATION DURING ALL PHASES OF CONSTRUCTION

THE CONTRACTOR SHALL CONTACT THE CITY'S DEVELOPMENT SERVICES ENGINEERING INSPECTION TO

THE CONTRACTOR SHALL CONTACT THE RIGHT OF WAY INSPECTOR AT 816-969-1800 PRIOR TO ANY LAND

ENSURE THAT THE GENERAL PUBLIC IS PROTECTED AT ALL TIMES. TRAFFIC CONTROL SHALL CONFORM TO

INSTALLED DURING CONSTRUCTION. TRENCH CHECK SHALL EXTEND TO BOTTOM OF TRENCH, TO WIDTH OF

THE CONTRACTOR SHALL PROVIDE AND MAINTAIN ALL TRAFFIC HANDLING MEASURES NECESSARY TO

ALL SANITARY SEWER LATERALS SHALL HAVE A TRENCH CHECK, CONSISTING OF FLOWABLE BACKFILL

TRENCH, TO 12 INCHES ABOVE PIPE, FOR A MINIMUM LENGTH OF 12 INCHES. TRENCH CHECK SHALL BE

SANITARY STUB MARKERS ARE TO BE AN 8' - 2" X 4" WOOD STUD WITH 3' BURIED IN THE GROUND AND 5'

MULTI-FAMILY (DUPLEX OR 4-PLEX) - A SANITARY STUB SHALL BE PROVIDED FOR EACH UNIT/DOOR

DISTURBANCE ACTIVITIES WITHIN THE RIGHT OF WAY. THESE ACTIVITIES MAY REQUIRE A PERMIT.

ASSEMBLY OF THE STATE OF MISSOURI. THE BILL REQUIRES THAT ANY PERSON OR FIRM DOING

INFORMATION FROM, UTILITY COMPANIES. STATE LAW REQUIRES 48 HOURS ADVANCE NOTICE. THE

PRIOR TO ORDERING PRECAST STRUCTURES, SHOP DRAWING SHALL BE SUBMITTED TO THE DESIGN

THE CONTRACTOR SHALL PROTECT ALL MAJOR TREES FROM DAMAGE. NO TREE SHALL BE REMOVED

EXCAVATION ON PUBLIC RIGHT OF WAY DO SO ONLY AFTER GIVING NOTICE TO, AND OBTAINING

WHICH HAVE FACILITIES IN THE NEAR VICINITY OF THE CONSTRUCTION TO BE PERFORMED

BY THE CONTRACTOR IN STRICT ACCORDANCE WITH ALL LOCAL CODES AND ORDINANCES.

ALL WASTE MATERIAL RESULTING FROM THE PROJECT SHALL BE DISPOSED OF OFF-SITE BY THE

ALL EXCAVATIONS SHALL BE UNCLASSIFIED. NO SEPARATE PAYMENT WILL BE MADE FOR ROCK

Sheet List Table		
Sheet Number	Sheet Title	
1	COVER SHEET	
2	GENERAL LAYOUT	
3	LINE B PLAN AND PROFILE	
4	LINE L PLAN AND PROFILE	
5	SANITARY SEWER DETAILS	
6	SANITARY SEWER DETAILS	
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JAMES L. LONG

PREPARED BY

SCHLAGEL & ASSOCIATES, P.A

0

DATE

OWNER/DEVELOPER

CLAYTON PROPERTIES GROUP INC., DBA SUMMIT HOMES BRAD KEMPF 120 SE 30TH STREET LEE'S SUMMIT, MISSOURI p (816) 246-6700 BRADLEY@SUMMITHOMESKC.COM

BM JA-45, IS A KC METRO ALUMINUM GRS DISK SET IN CONCRETE AND ABOUT 3 INCHES BELOW THE PAVEMENT ON THE SHOULDER OF SE

ELEV. = 1046.25

APPROVED BY

CITY ENGINEER APPROVED FOR ONE YEAR FROM THIS DATE



MISSOURI GEOGRAPHIC REFERENCE SYSTEM **BENCHMARK:**


RANSON ROAD. IT IS STAMPED JA45, 1987.



COVER SHEET

SHEET

ORNERS

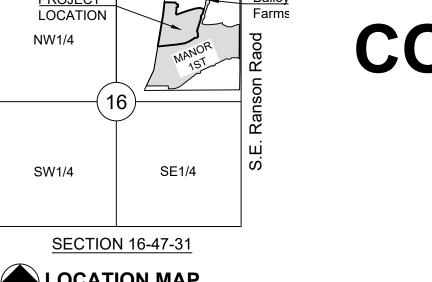

LOCATION MAP SCALE 1" = 2000' BASIS OF BEARINGS MISSOURI COORDINATE SYSTEM 1983,

WEST ZONE

UTILITY CONTACTS:

MISSOURI DEPARTMENT OF TRANSPORTATION (MODOT) Steve Holloway 600 NE Colbern Road Lee's Summit, MO 64086

MISSOURI GAS ENERGY (MGE)

Brent Jones 3025 SE Clover Drive Lee's Summit, MO 64082 (816) 399-9633 brent.jones@spireenergy.com

EVERGY Ron Dejarnette

(816) 607-2186

1300 SE Hamblin Road Lee's Summit, MO 64081 Office: (816) 347-4316 Cell: (816) 810-5234 ron.dejarnette@evergy.com

CITY OF LEES SUMMIT PUBLIC WORKS

Michael Park 220 SE Green Street Lee's Summit, MO 64063 (816) 969-1800

Mark Manion or Marty Loper 500 E. 8th Street, Room 370 Kansas City, MO 64106 (816) 275-2341 or (816) 275-1550

John Meadows 4700 Little Blue Parkway Independence, MO 64057

CITY OF LEE'S SUMMIT WATER UTILITIES

Mark Schaufler 1200 SE Hamblen Road Lee's Summit, MO 64081

(816) 969-1900


(816) 795-2257

GENERAL NOTES:

ADOPTED BY ORDINANCE 5813.

ENGINEER FOR APPROVAL.

- UTILITIES: 1. Existing utilities have been shown to the greatest extent possible based upon information provided to the Engineer. The contractor is responsible for contacting the respective utility companies and field locating utilities prior to construction and
- identifying any potential conflicts. All conflicts shall immediately be brought to the attention of the Engineer. The contractor shall be responsible for coordinating any required utility relocations. Utilities damaged through the
- negligence of the contractor shall be repaired at the contractor's expense. Contractor shall verify flow-lines and structure tops prior to construction, and shall notify Engineer of any discrepancies. Provide shop drawings for all precast and manufactured utility structures for review by the Engineer prior to construction of
- Utility Separation: Waterlines shall have a minimum of 10 feet horizontal and 2 feet vertical separation from all sanitary
- sewer lines, manholes, and sanitary sewer service laterals, as measured from edge to edge. If minimum separations can not be obtained, concrete encasement of the sanitary line shall be required 10 feet in each direction of the conflict.
- Payment for trenching, backfilling, pipe embedment, flowable fill, backfill materials, clean up, seeding, sodding and any other items necessary for the construction of the utility line shall be included in the contract price for the utility installation.
- The Contractor shall be responsible for contacting respective utility companies 48-hours in advance for the inspection of any proposed utility main extension or service line or service connection to any existing main.
- Trench spoils shall be neatly placed onsite adjacent to the trench, and compacted to prevent saturation and excess sediment runoff. Unsuitable materials, excess rock and shale, asphalt, concrete, trees, brush etc. shall be properly disposed of offsite. Materials may be wasted onsite at the direction of the Owner or his appointed representative.
- All excavation is considered unclassified, unless noted otherwise. Unclassified excavation for utility trenching is subsidiary to the unit price provided for the pipe. Any quantity provided for rock excavation is estimated based on the best information provided to the Project Engineer. The Engineer has the authority to identify and define the physical characteristics to determine the classification. Unit price quantities for rock excavation will be paid at a trench width of the nominal pipe diameter of the installed main plus 18 inches. Contractor is required to dispose of excess rock from their trenches by disposing it in areas as specified by the Project Engineer.

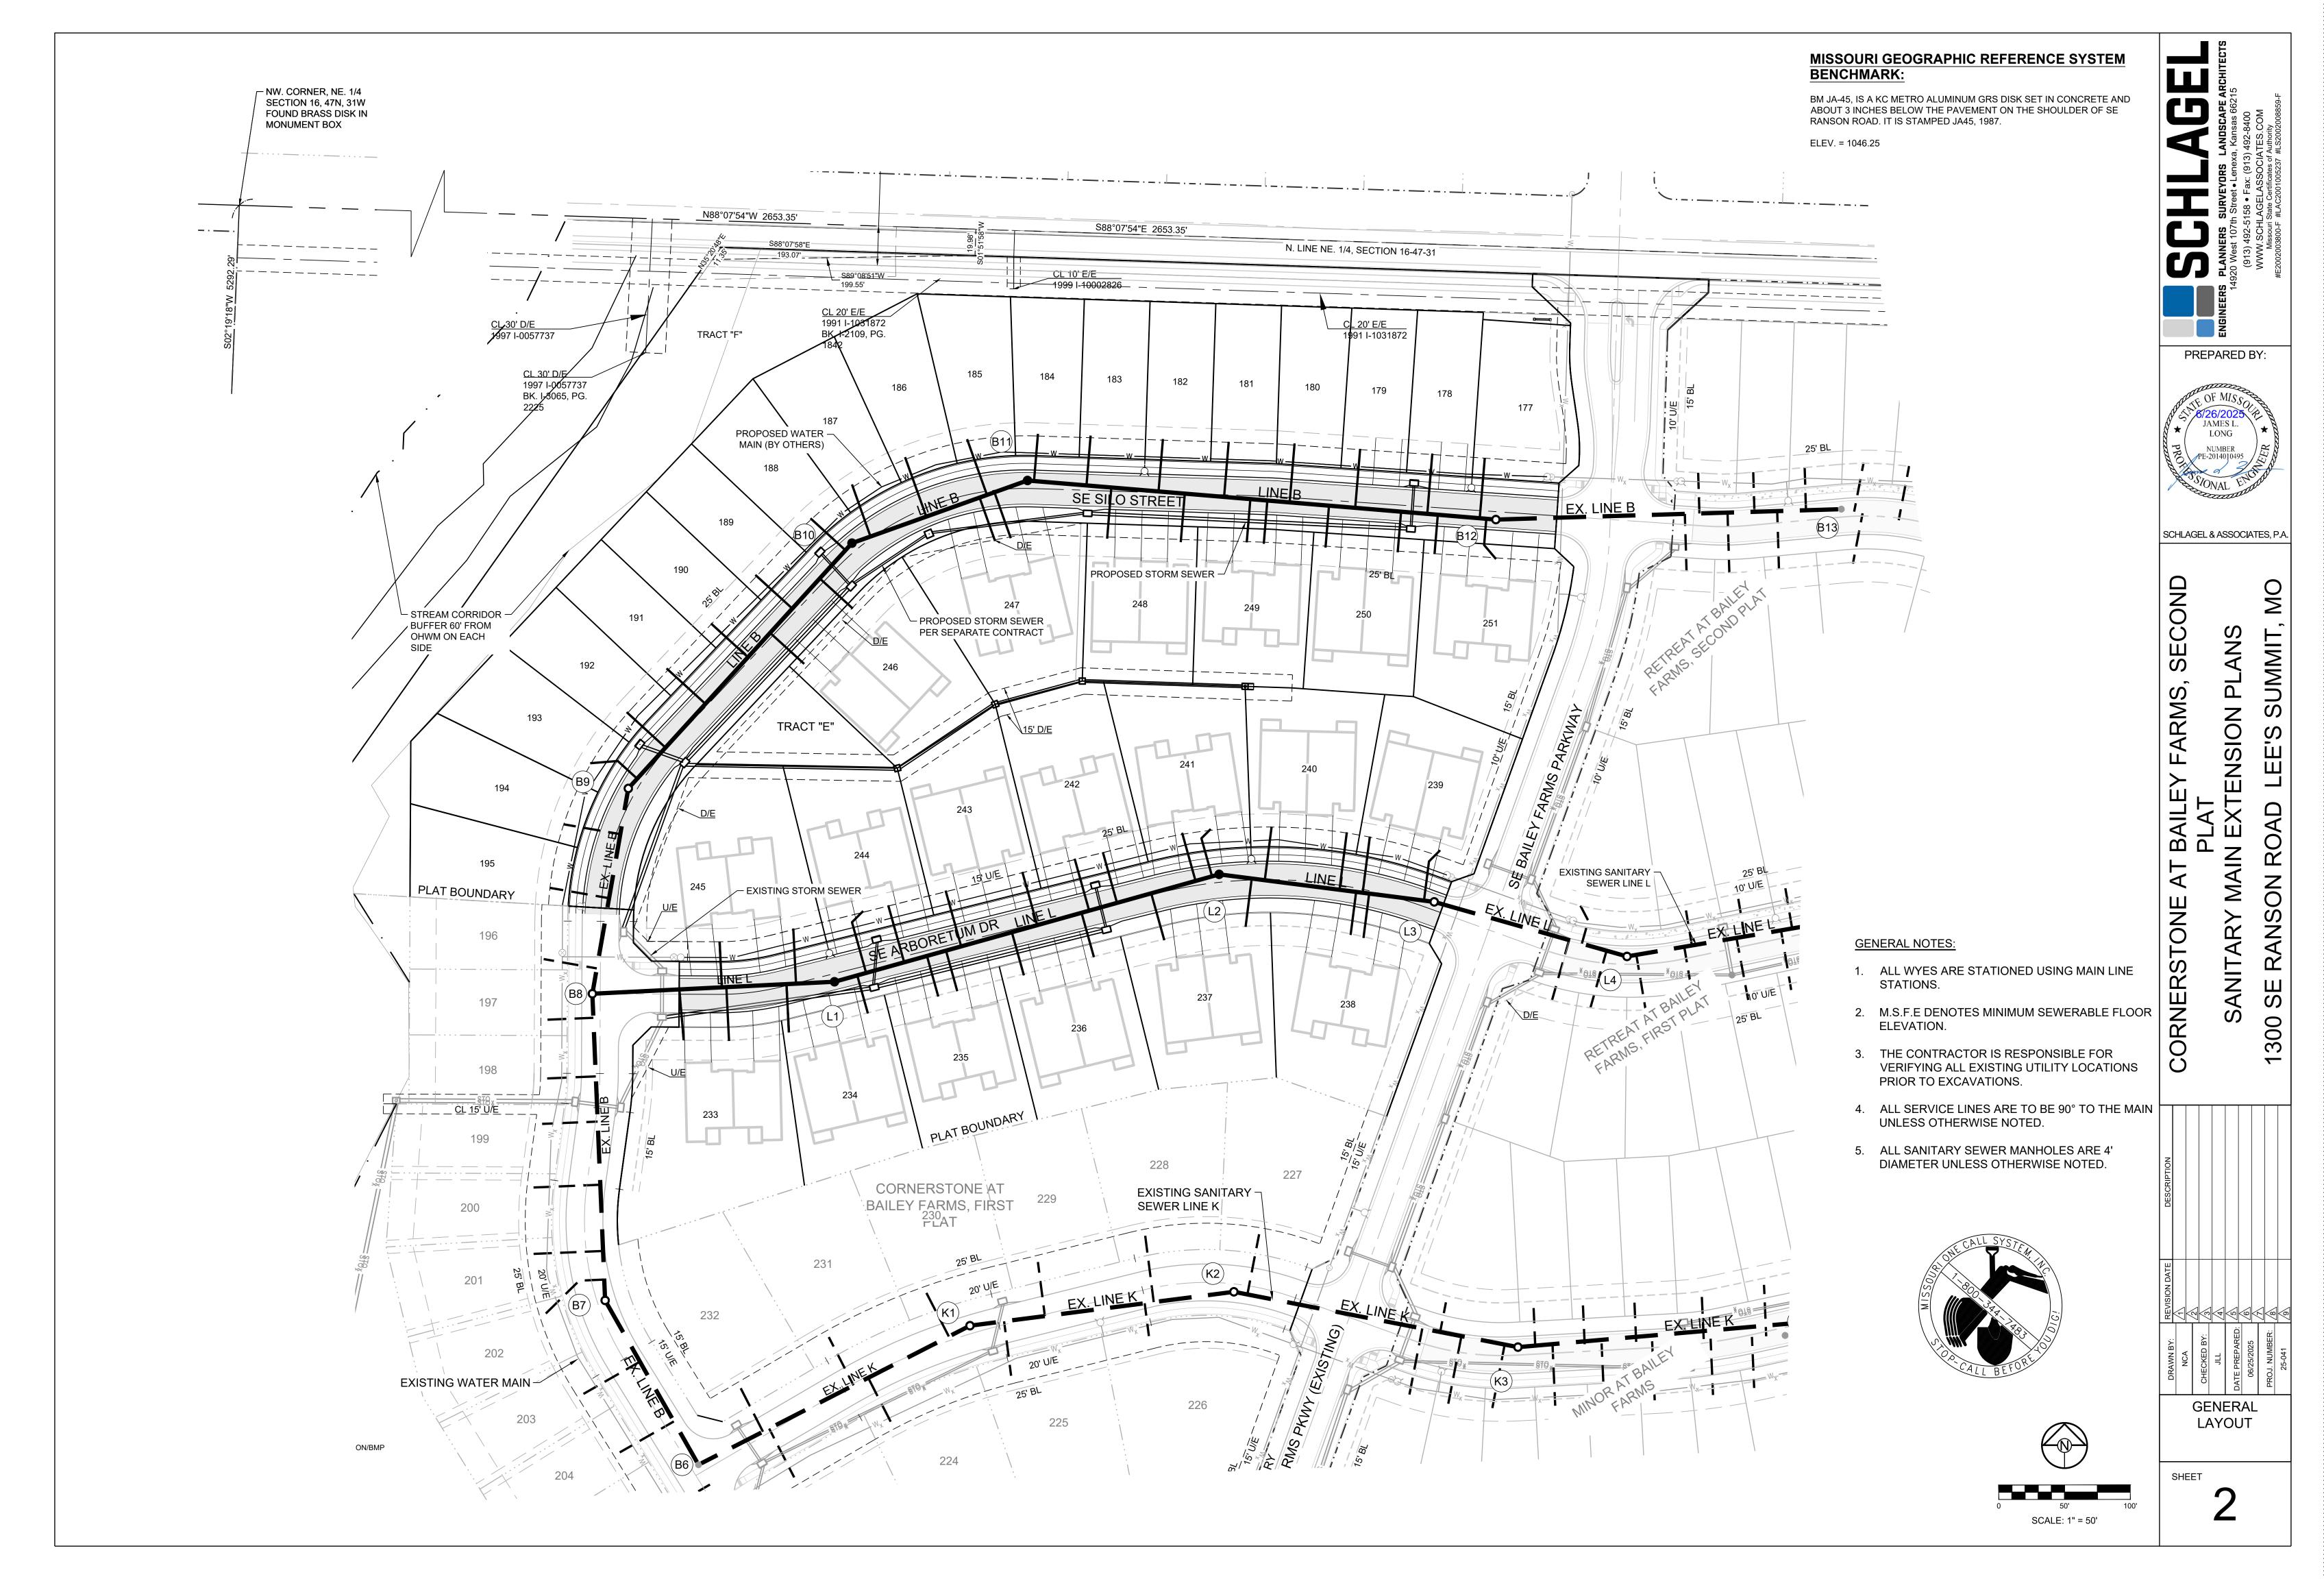



970

960

15+00

16+00

17+00

18+00

19+00

20+00

21+00

22+00

23+00

24+00

25+00

CORNERSTONE AT BAILEY FARMS, SECOND
PLAT
SANITARY MAIN EXTENSION PLANS
1300 SE RANSON ROAD LEE'S SUMMIT, MO

PREPARED BY:

JAMES L. LONG

SCHLAGEL & ASSOCIATES, P.A.


E B PLAN AN 06/25, N

LINE B PLAN AND PROFILE

SHEET 3

960


26+00

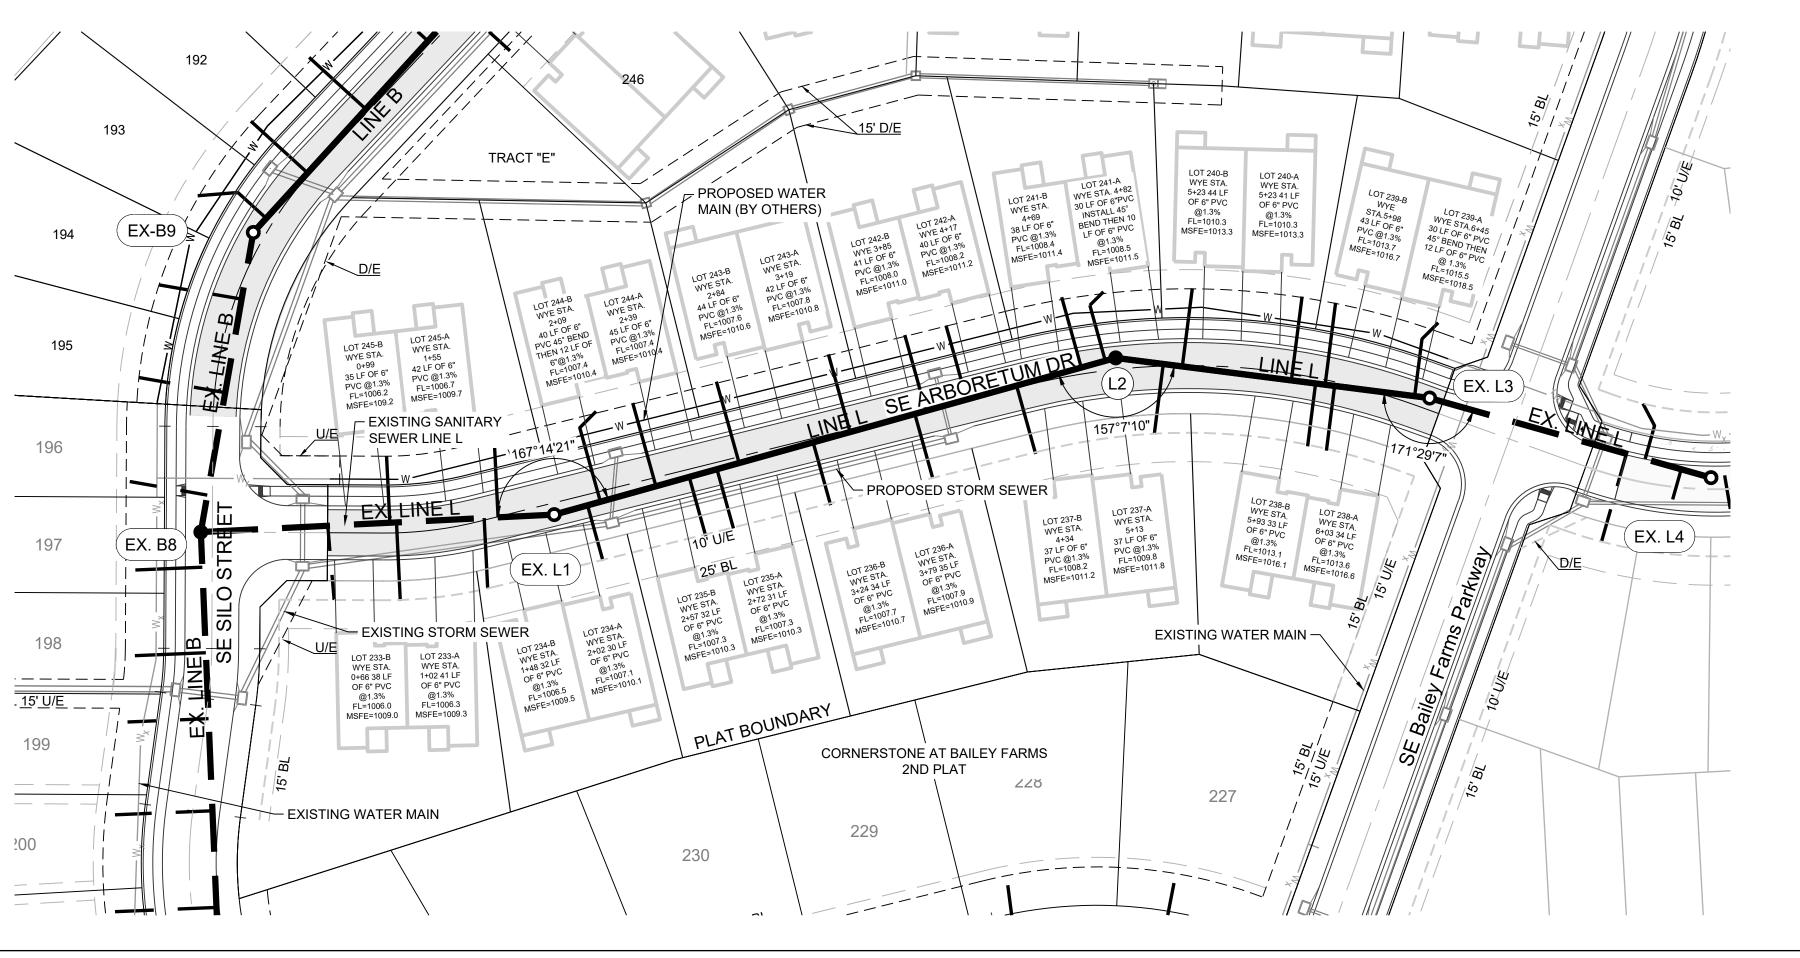

GENERAL NOTES:


- 1. ALL WYES ARE STATIONED USING MAIN LINE STATIONS.
- 2. M.S.F.E DENOTES MINIMUM SEWERABLE FLOOR ELEVATION.
- 3. THE CONTRACTOR IS RESPONSIBLE FOR VERIFYING ALL EXISTING UTILITY LOCATIONS PRIOR TO EXCAVATIONS.
- 4. ALL SERVICE LINES ARE TO BE 90° TO THE MAIN UNLESS OTHERWISE NOTED.
- 5. ALL SANITARY SEWER MANHOLES ARE 4' DIAMETER UNLESS OTHERWISE NOTED.



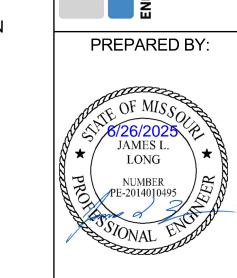

SCHLAGEL & ASSOCIATES, P.A.

50' 100 SCALE: 1" = 50'

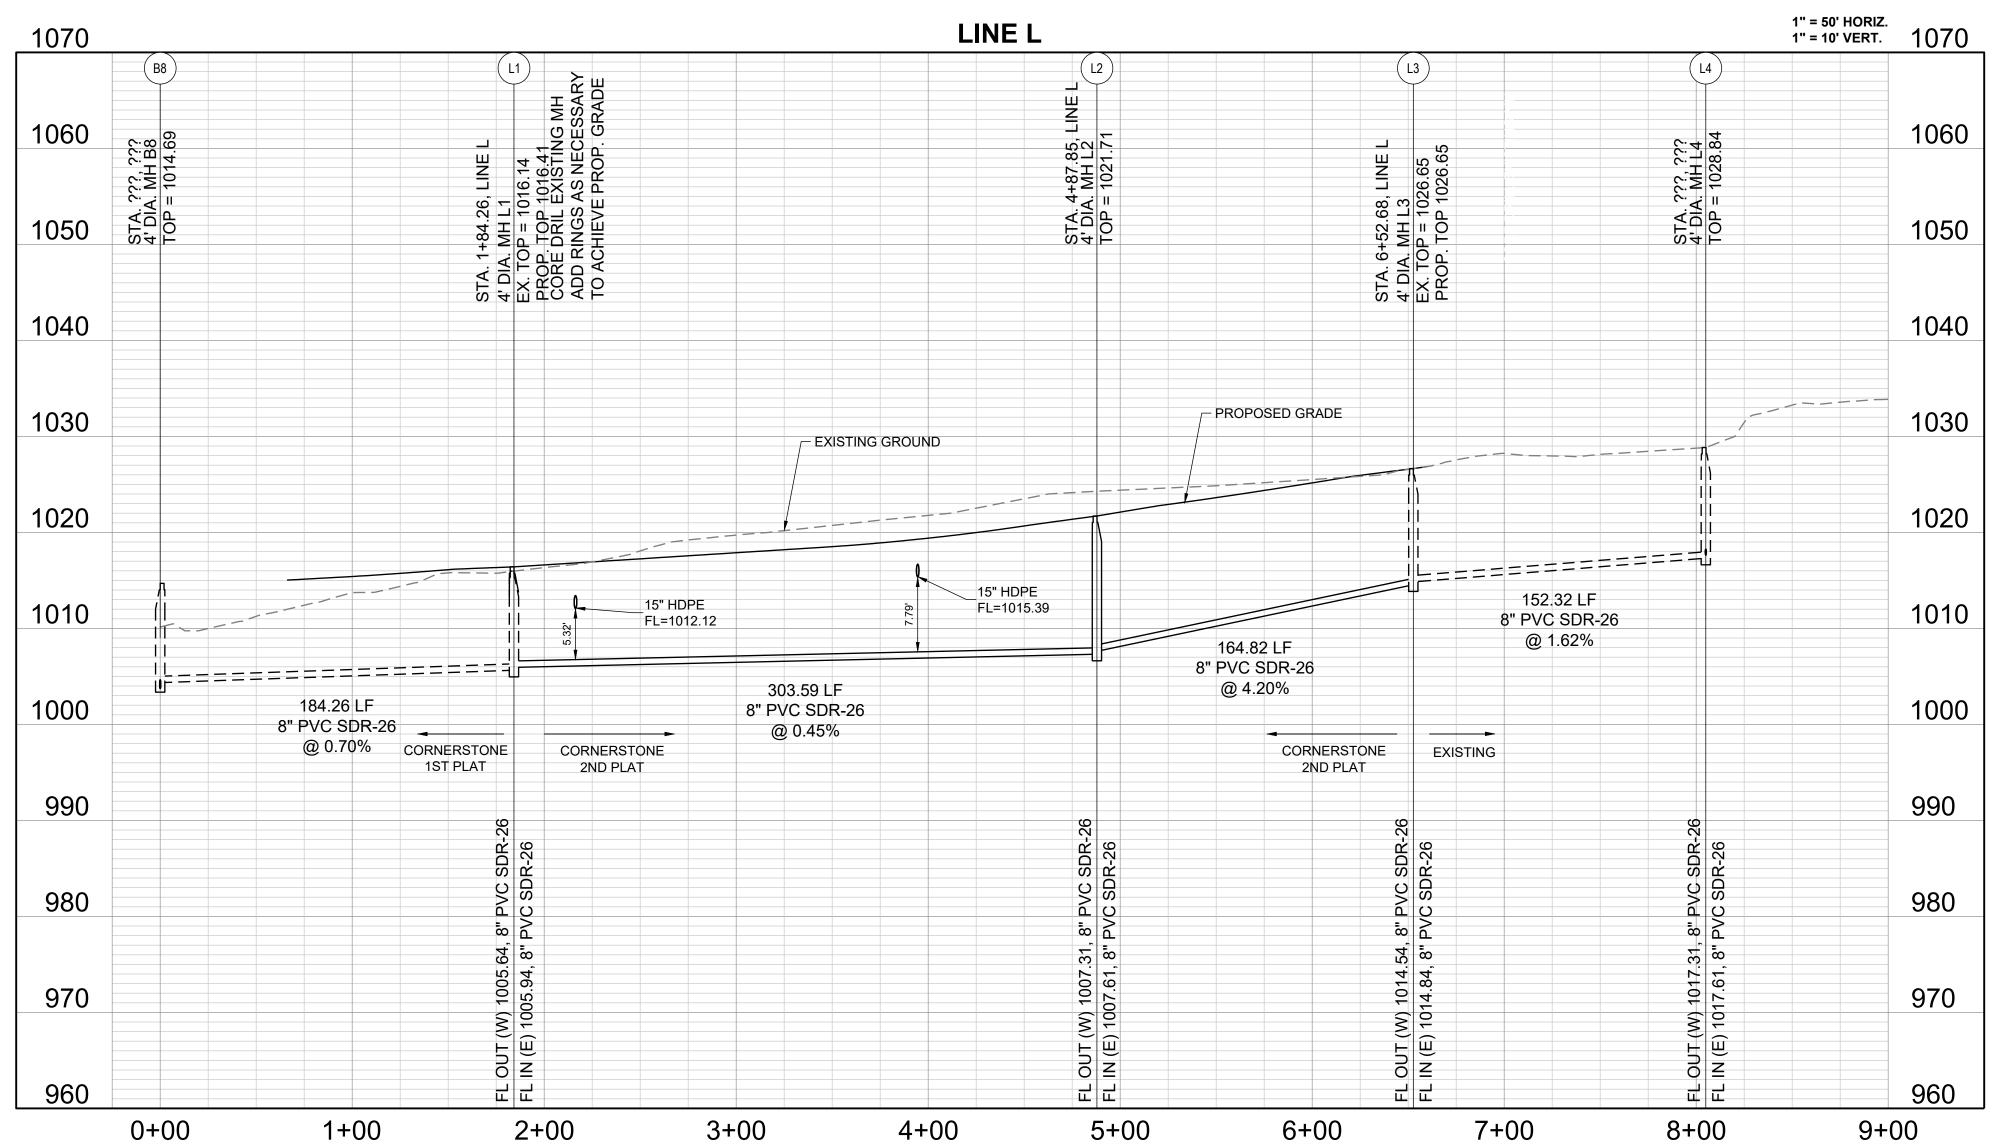


CORNERSTONE AT BAILEY FARMS, SECOND
PLAT
SANITARY MAIN EXTENSION PLANS
1300 SE RANSON ROAD LEE'S SUMMIT, MO


LINE L PLAN AND
PROFILE
PROFILE

SHEET

4

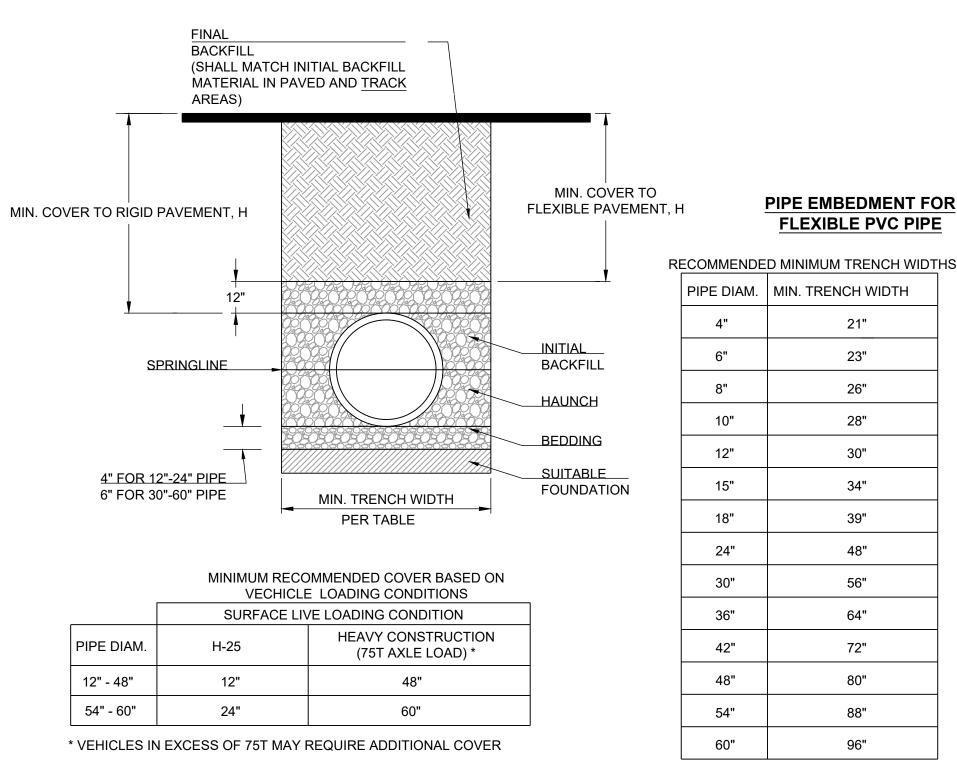

- 1. ALL PIPE SYSTEMS SHALL BE INSTALLED IN ACCORDANCE WITH ASTM D2321, "STANDARD PRACTICE FOR UNDERGROUND INSTALLATION OF THERMOPLASTIC PIPE FOR SEWERS AND OTHER GRAVITY FLOW APPLICATIONS", LATEST EDITION
- 2. MEASURES SHOULD BE TAKEN TO PREVENT MIGRATION OF NATIVE FINES INTO BACKFILL MATERIAL, WHEN REQUIRED.
- 3. FOUNDATION: WHERE THE TRENCH BOTTOM IS UNSTABLE, THE CONTRACTOR SHALL EXCAVATE TO A DEPTH REQUIRED BY THE ENGINEER AND REPLACE WITH SUITABLE MATERIAL AS SPECIFIED BY THE ENGINEER. AS AN ALTERNATIVE AND AT THE DISCRETION OF THE DESIGN ENGINEER, THE TRENCH BOTTOM MAY BE STABILIZED USING A GEOTEXTILE MATERIAL.
- 4. BEDDING: SUITABLE MATERIAL SHALL BE CLASS I, II OR III. THE CONTRACTOR SHALL PROVIDE DOCUMENTATION FOR MATERIAL SPECIFICATION TO ENGINEER. UNLESS OTHERWISE NOTED BY THE ENGINEER, MINIMUM BEDDING THICKNESS SHALL BE 4" (100mm) FOR 4"-24" (100mm-600mm); 6" (150mm) FOR 30"-60" (750mm-900mm).
- 5. INITIAL BACKFILL: SUITABLE MATERIAL SHALL BE CLASS I, II OR III IN THE PIPE ZONE EXTENDING NOT LESS THAN 6" ABOVE CROWN OF PIPE. THE CONTRACTOR SHALL PROVIDE DOCUMENTATION FOR MATERIAL SPECIFICATION TO ENGINEER. MATERIAL SHALL BE INSTALLED AS REQUIRED IN ASTM D2321, LATEST EDITION.
- 6. MINIMUM COVER: MINIMUM COVER, H, IN NON-TRAFFIC APPLICATIONS (GRASS OR LANDSCAPE AREAS) IS 12" FROM THE TOP OF PIPE TO GROUND SURFACE. ADDITIONAL COVER MAY BE REQUIRED TO PREVENT FLOATION. FOR TRAFFIC APPLICATIONS, MINIMUM COVER, H, IS 12" UP TO 48" DIAMETER PIPE AND 24" OF COVER FOR 54"-60" DIAMETER PIPE, MEASURED FROM TOP OF PIPE TO BOTTOM OF FLEXIBLE PAVEMENT OR TO TOP OF RIGID PAVEMENT.

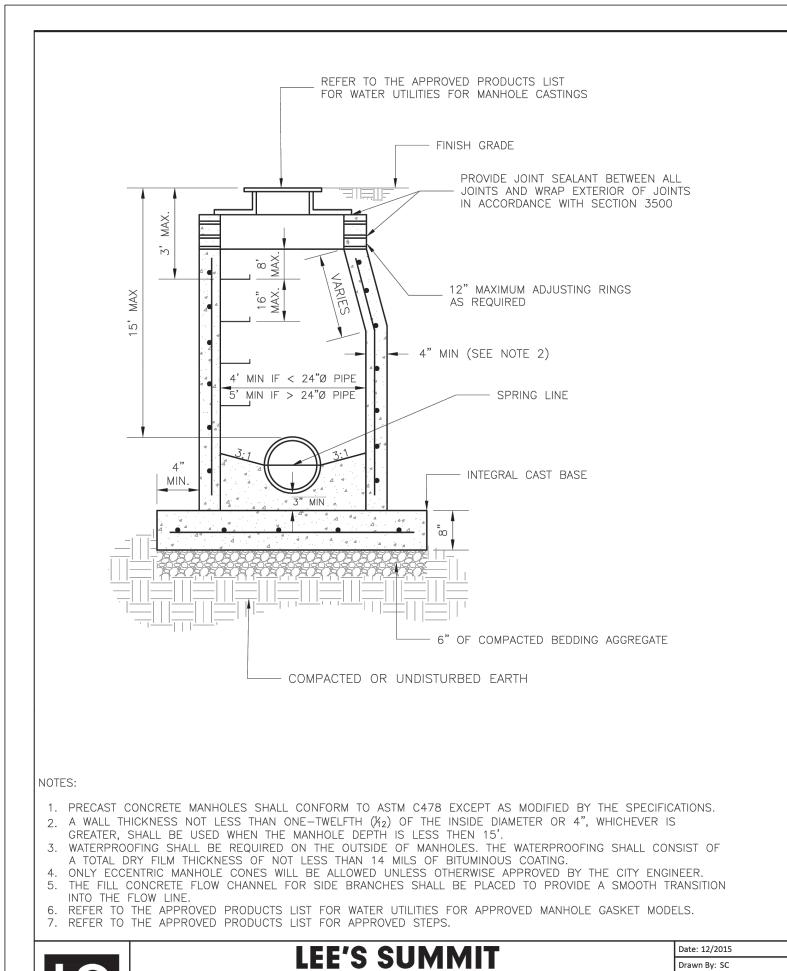


MISSOURI

STANDARD SANITARY PRECAST MANHOLE


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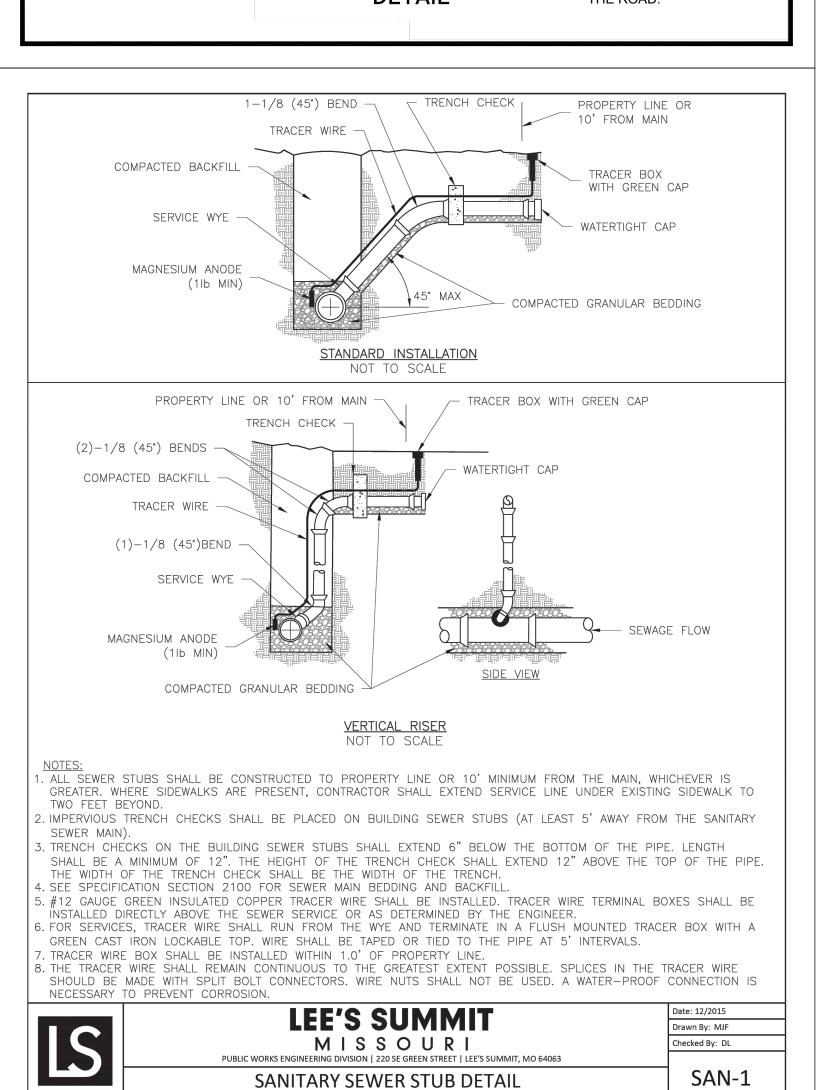
SAN-2

SAN-5

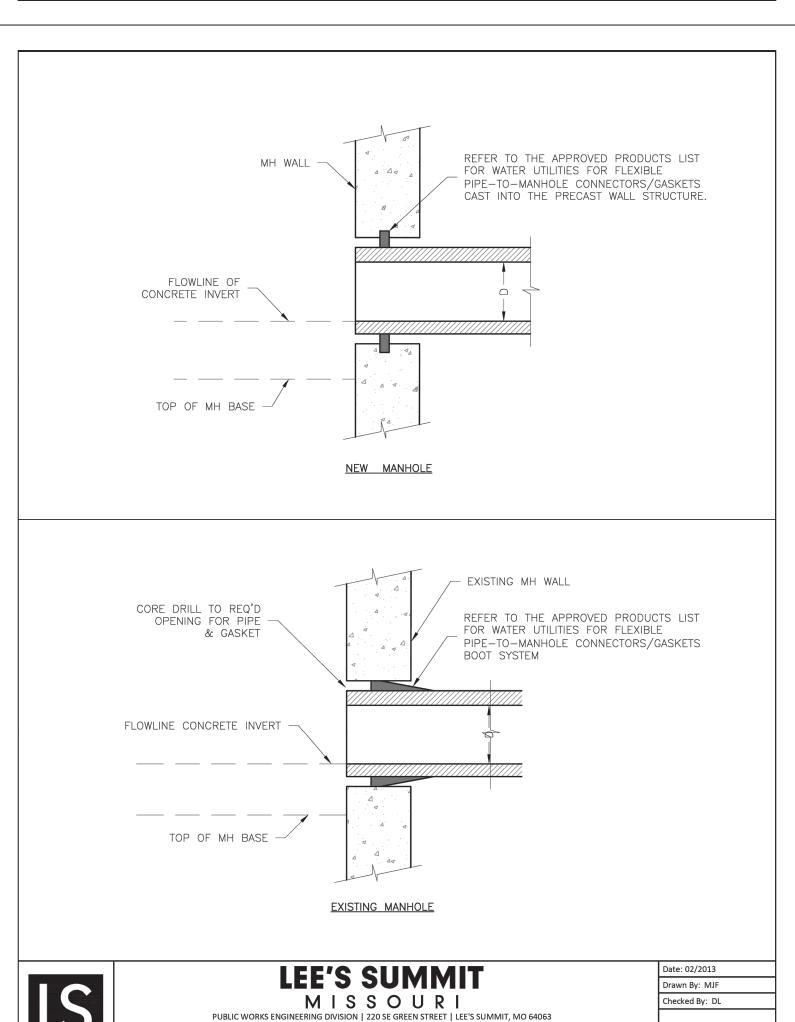

MANHOLE WALL CONNECTION



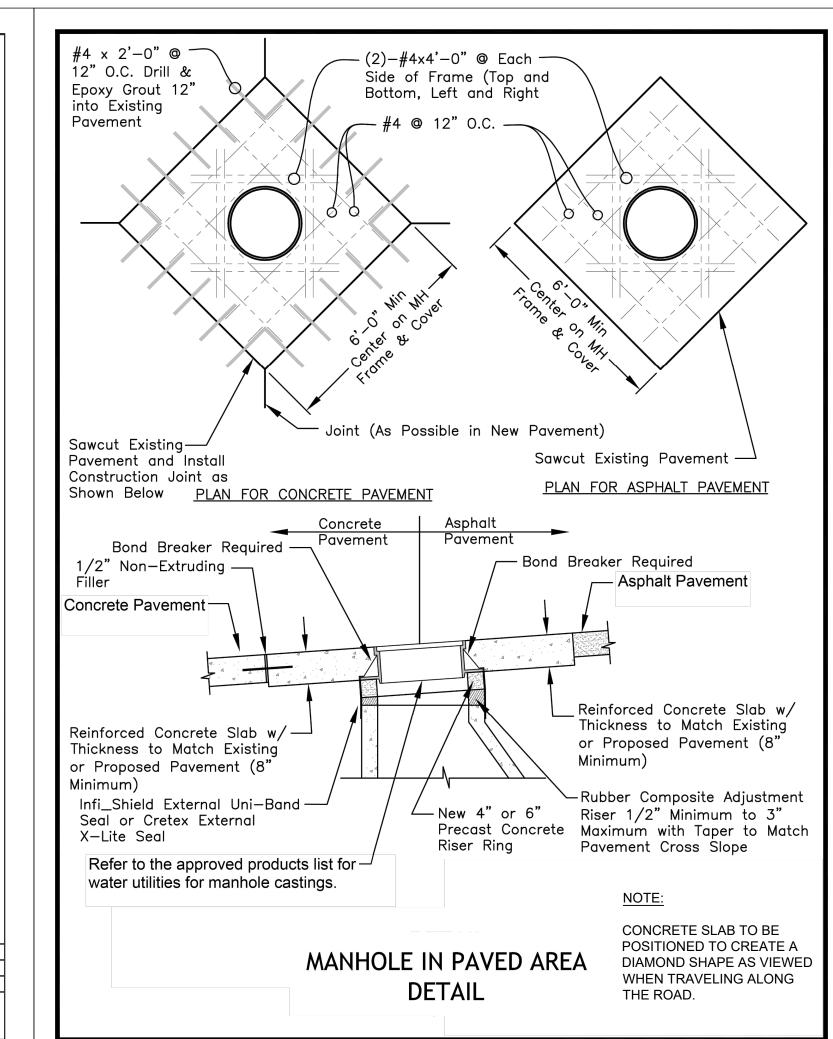



PREPARED BY:




SCHLAGEL & ASSOCIATES, P.A.

OND

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SANITARY SEWER DETAILS

SHEET



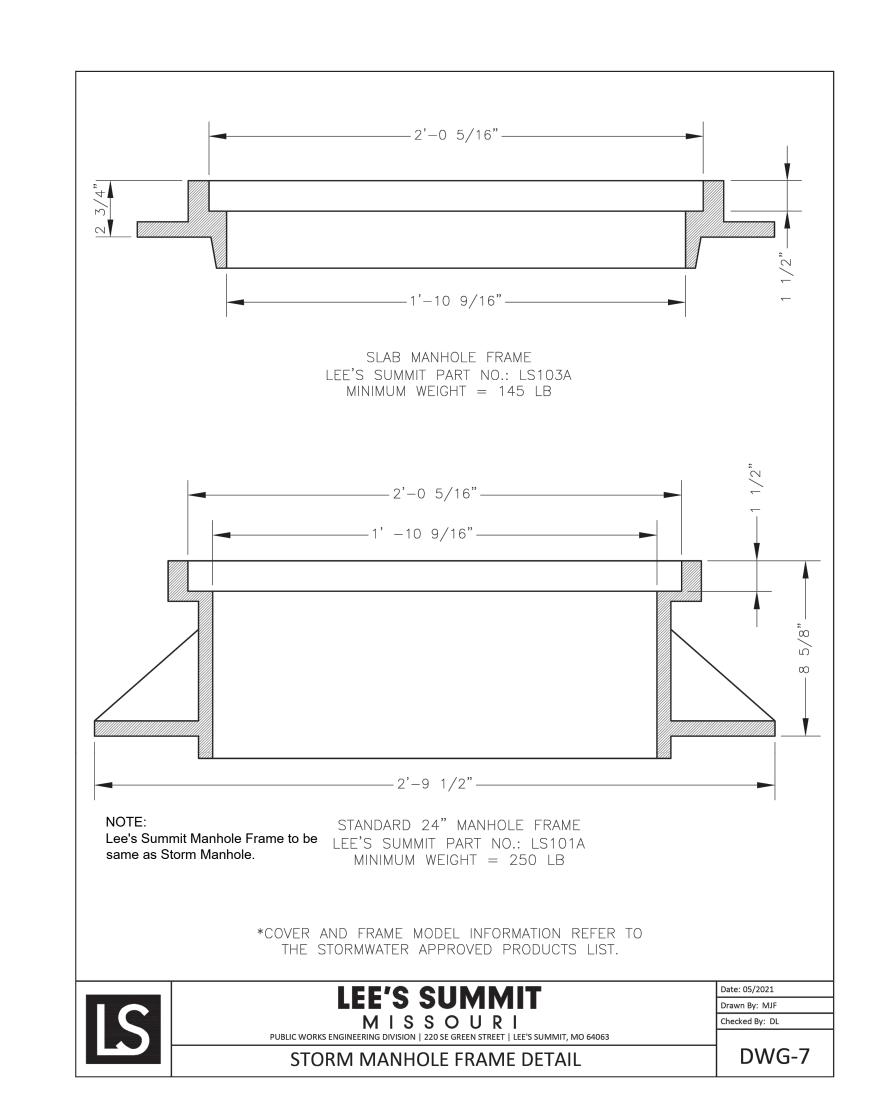

STORM MANHOLE COVER DETAIL

STM-6



AT BAILEY FARMS, SECOND PLAT AIN EXTENSION PLANS

CORNERSTONE

RANSON

1300

SANITARY

SCHLAGEL & ASSOCIATES, P.A.

SANITARY
SEWER DETAILS

SHEET

6