

Greystone - Masterplan

Lot 134, Hook Farms 2nd Plat in Lee's Summit, MO.

Address: 2615 SW Tracker Lane

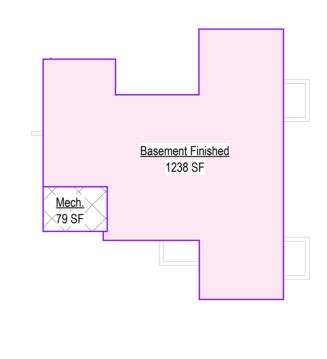

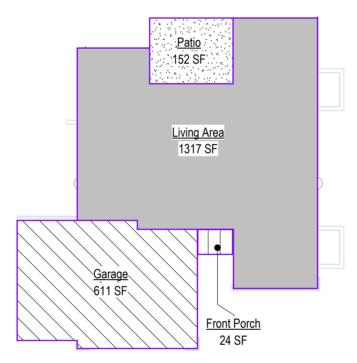



Area W/ 3rd Car Garage & Storage

Living Area

1238 SF

1317 SF

2556 SF


611 SF

152 SF

Not Placed


79 SF

17	Basement Area -W/ 3rd Car Garage & Stor
	1/16" = 1'-0"

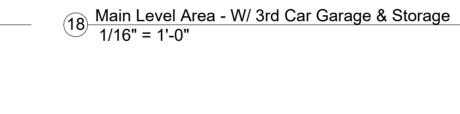

Sheet No Sheet Name OO Cover Sheet A706.2 Front Elevations - W/ 3 Car Garage A702.1 Side Elevations - Full Basement - Traditional - Fully covered Patio/Deck A401.1 Foundation Plan - Full Basement A402.1 Floor Plan - Full Basement A501 Floor Plan - Main Level A503.2 Floor Plan - Main Level Deck & Patio - Traditional & Prairie - Full covered Deck A602.2 Roof Plan - Traditional - Fully covered Patio/Deck A711 Floor Plan - W/ 3 Car Garage A714 POD Options A715 POD Options A801 Details A802 Details A803 Details

RCP/Electrical Plan

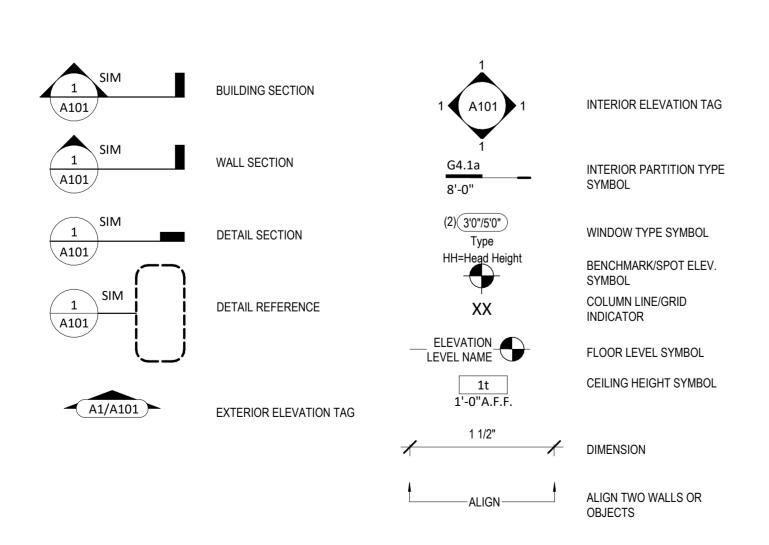

General Information

Doors & Windows:	U-0.32 MAX
Glazing SHGF:	0.40
Skylights:	U-0.55 MAX
Roof	
Attic Ceilings:	R-49 MIN
Vaults:	R-38 MIN
Vaults < 500sf:	R-30 MIN
Wood Frame Walls:	R-20 or R-13 + 5 MIN
Basement Walls:	R-13 or R-10 Continuous
Floor (over unconditioned):	R-19 MIN
Slab on Grade:	R-10 for 24" MIN
Ductwork:	R-8 MIN
Fuel Fired Furnace:	90% AFUE MIN
Electic Furnace:	No Minimum
Cooling System:	13 SEER MIN
Water Heater	
Gas Fired Storage:	0.67 EF MIN
Gas Fired Instant:	0.62 EF MIN

An energy efficient certificate is required to be posted in or on the electrical panel before the final inspection. The certificate will be provided with all new residential permits. It is the permit holder/contractor's responsibility to ensure the certificate has accurate information and is posted before final inspection -- Owner/Contractor is responsibile for meeting the prescriptive requirments of IRC chapter 11 unless a HER Index Analysis for Performance Compliance based on the plans is submitted to the AHJ for approval.

IRC 2018
Ground Snow Load: 20PSF
Wind Speed: 115mph
Topography Effects: No
Seismic Design Category: A
Damage From Weather: Severe
Frost Line Depth: 36 inches
Termite: Moderate to
Winter Design Temperature: 6 F
Ice Barrier Underlayment: Yes
Flood Hazard:
Air Freezing Index: 927 or less

Mean Annual Temperature: 55.5 F

 Whole House Mechanical Ventilation System is required for any dwelling with air infiltration at a rate of less than 5 air changes per hour (at ACH50 standard R303.4).

Carbon monoxide detectors required (R315)
 Steel columns shall be minimum schedule 40 (R507.2)

4. Deck Ledger attachment to house shall be per Tables 507.9.1.3.

1 ables 507.9.1.3.5. New provisions for attachment of rafters, trusses and roof beams. (R802.3 and

6. Programmable thermostat required

 Air handlers shall be rated for Maximum 2% air leakage rate (N1103.2.2.1)

 Building cavities used as return air plenums shall be sealed to prevent leakage across the thermal envelope. (N1103.2.3)

9. Certain hot water pipes shall be insulated (N1103.4)

10. All exhaust fans shall terminate to the building exterior (M1507.2)

11. Makeup air system required for kitchen exhaust hoods that exceed 400 CFM M1503.4
12. Building cavities in a thermal envelope wall

(including the wall between the house and garage) shall not be used as return air plenums (unless the required insulation and air barrier are maintained) (M1601.1.1,#7.5)

barrier are maintained) (M1601.1.1,#7.5)

13. An air handling system shall not serve both the living space and the garage (M1601.6)


14. A concrete-Encased grounding electrode
('UFER' Ground) connection complies with the
requirments of the 2018 IRC Section
E3608.1.2 in providing a connection with no
less than the required minimum of steel.

 Compliance with the requirments and show connection as needed for roof beam, trus, rafter, and girder connections for uplift per IRC 802 11

16. Garage Door Rating: DASMA 115 MPH Rated



Greystone - MasterplanLot 134, Hook Farms 2nd Plat in Lee's Summit, MO.
Address: 2615 SW Tracker Lane

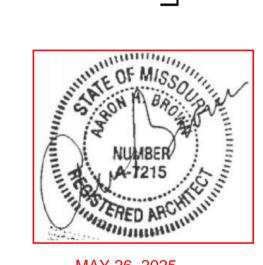

MAY 26, 2025

Permit Set
Original Issue Date: 10/1/2021


REVISIONS

Number Description Date


Permit Set


PLAN DESCRIPTION: Cover Sheet

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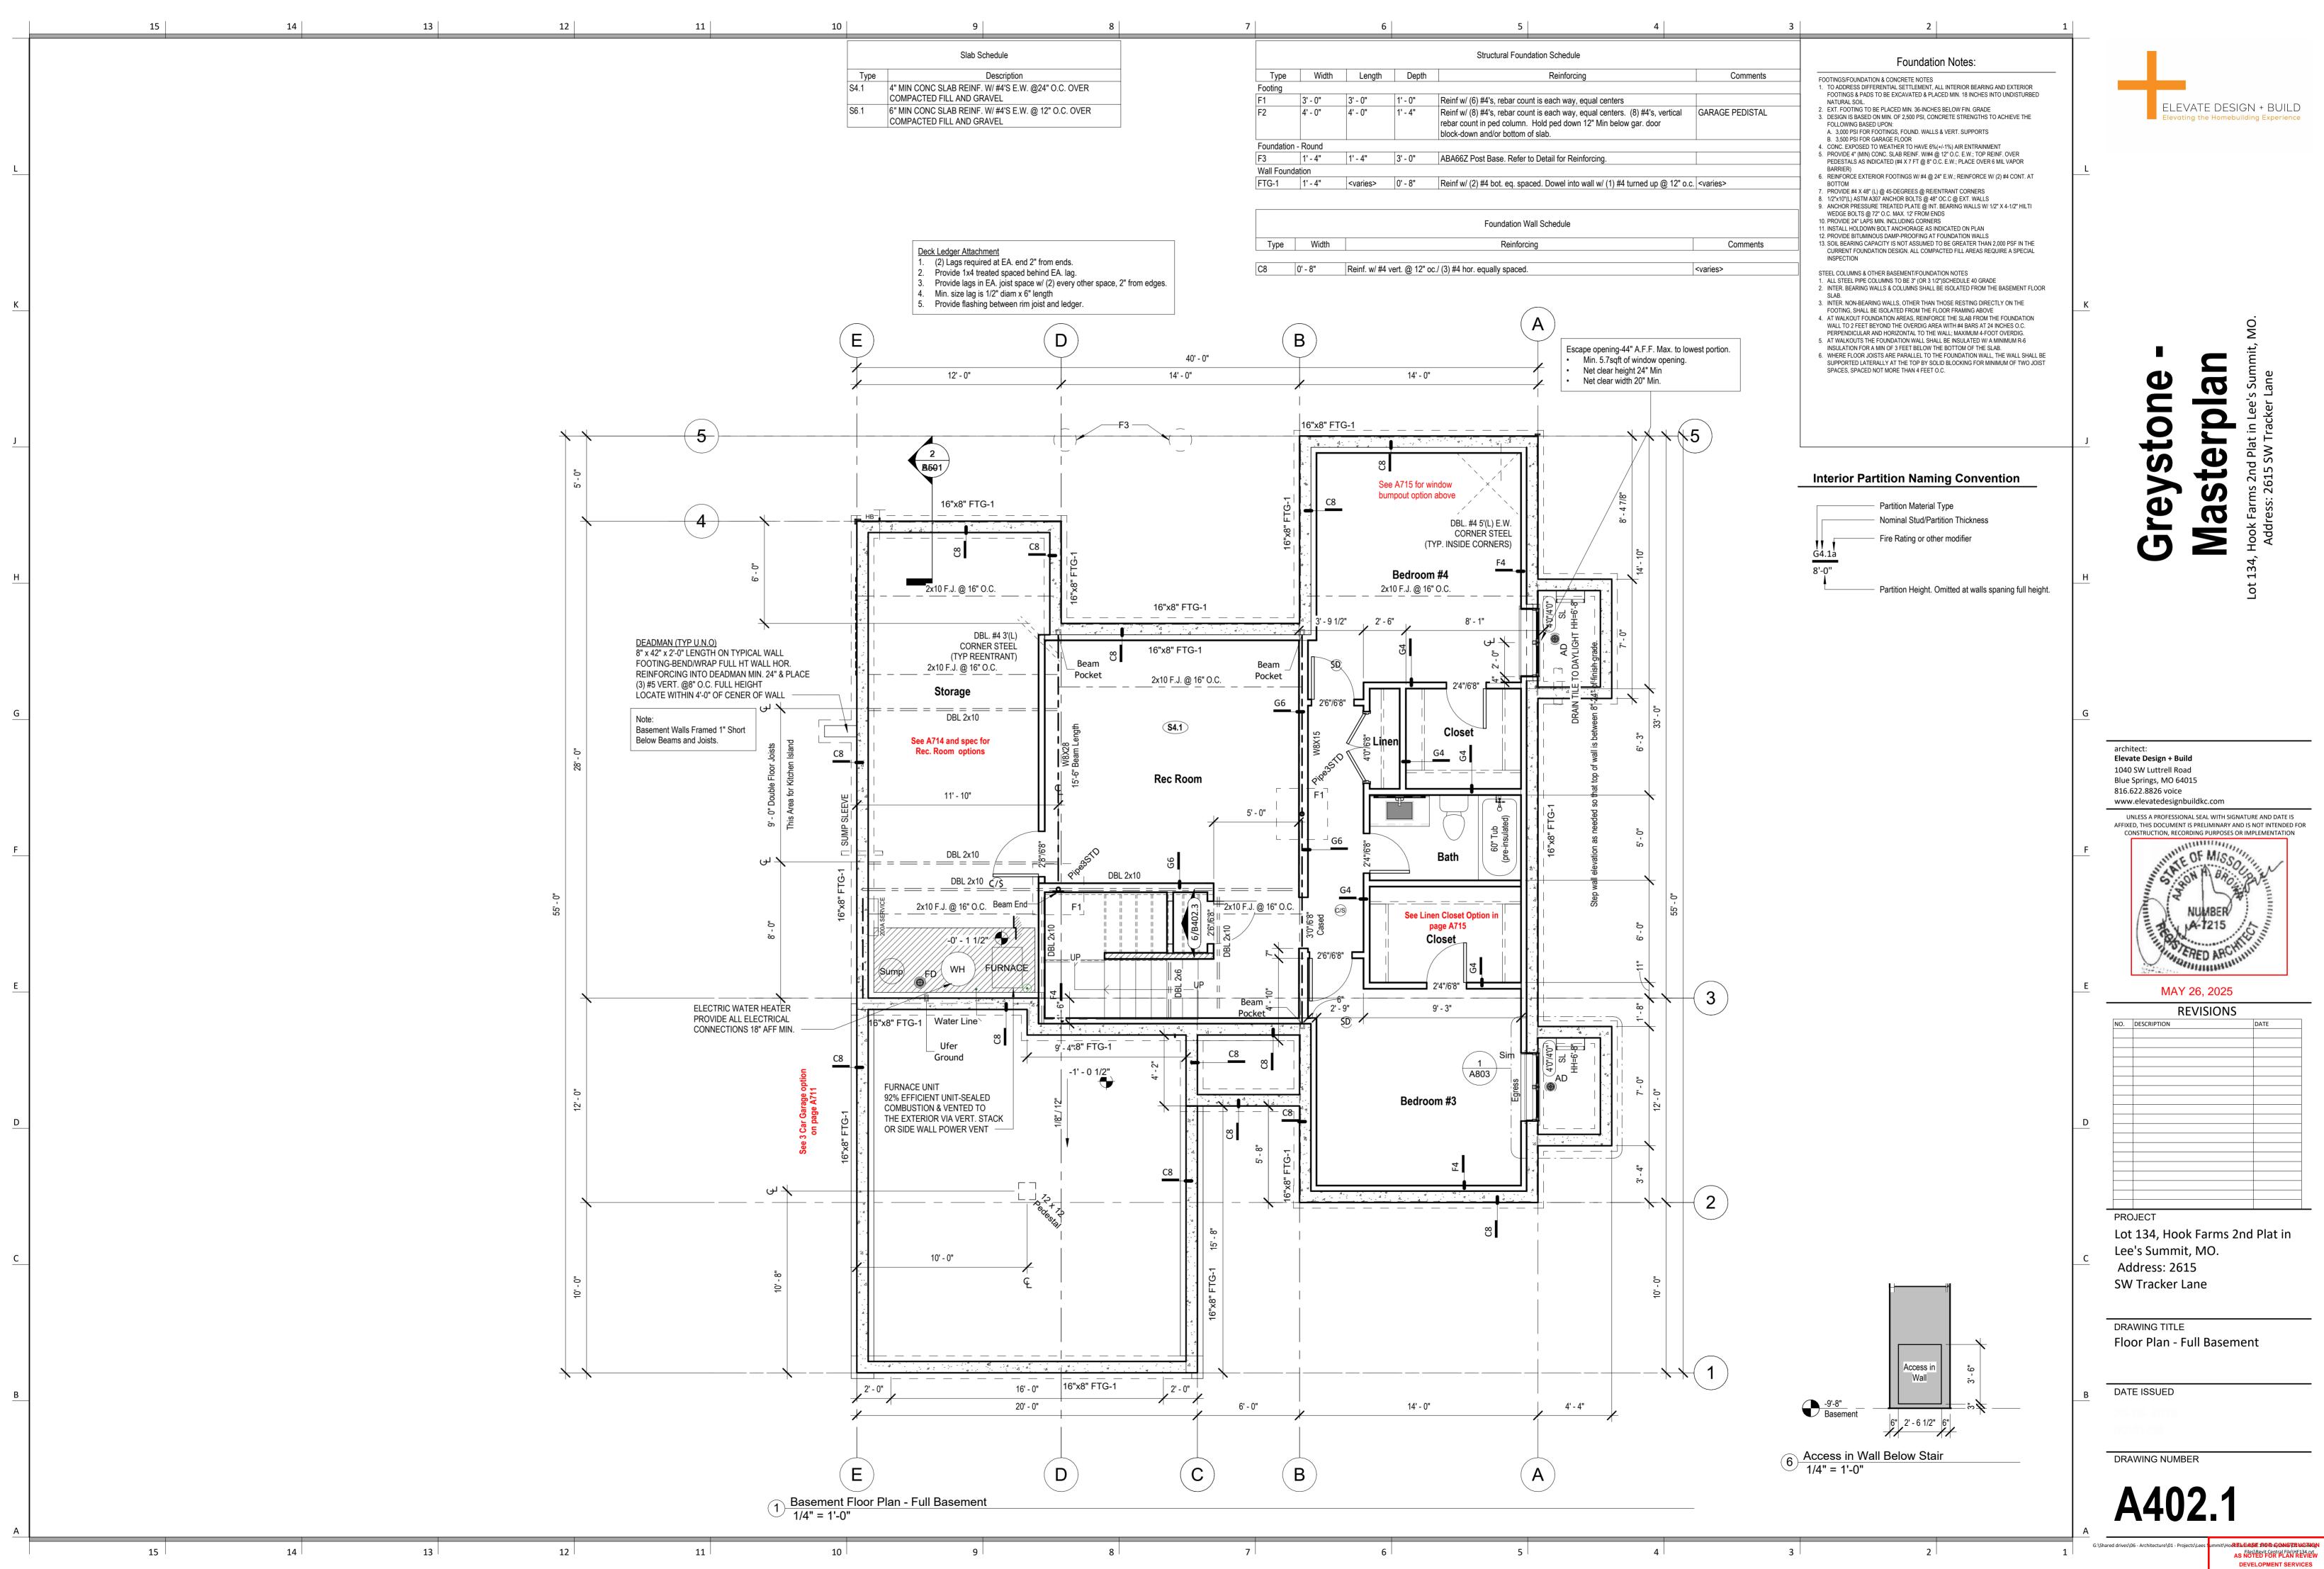


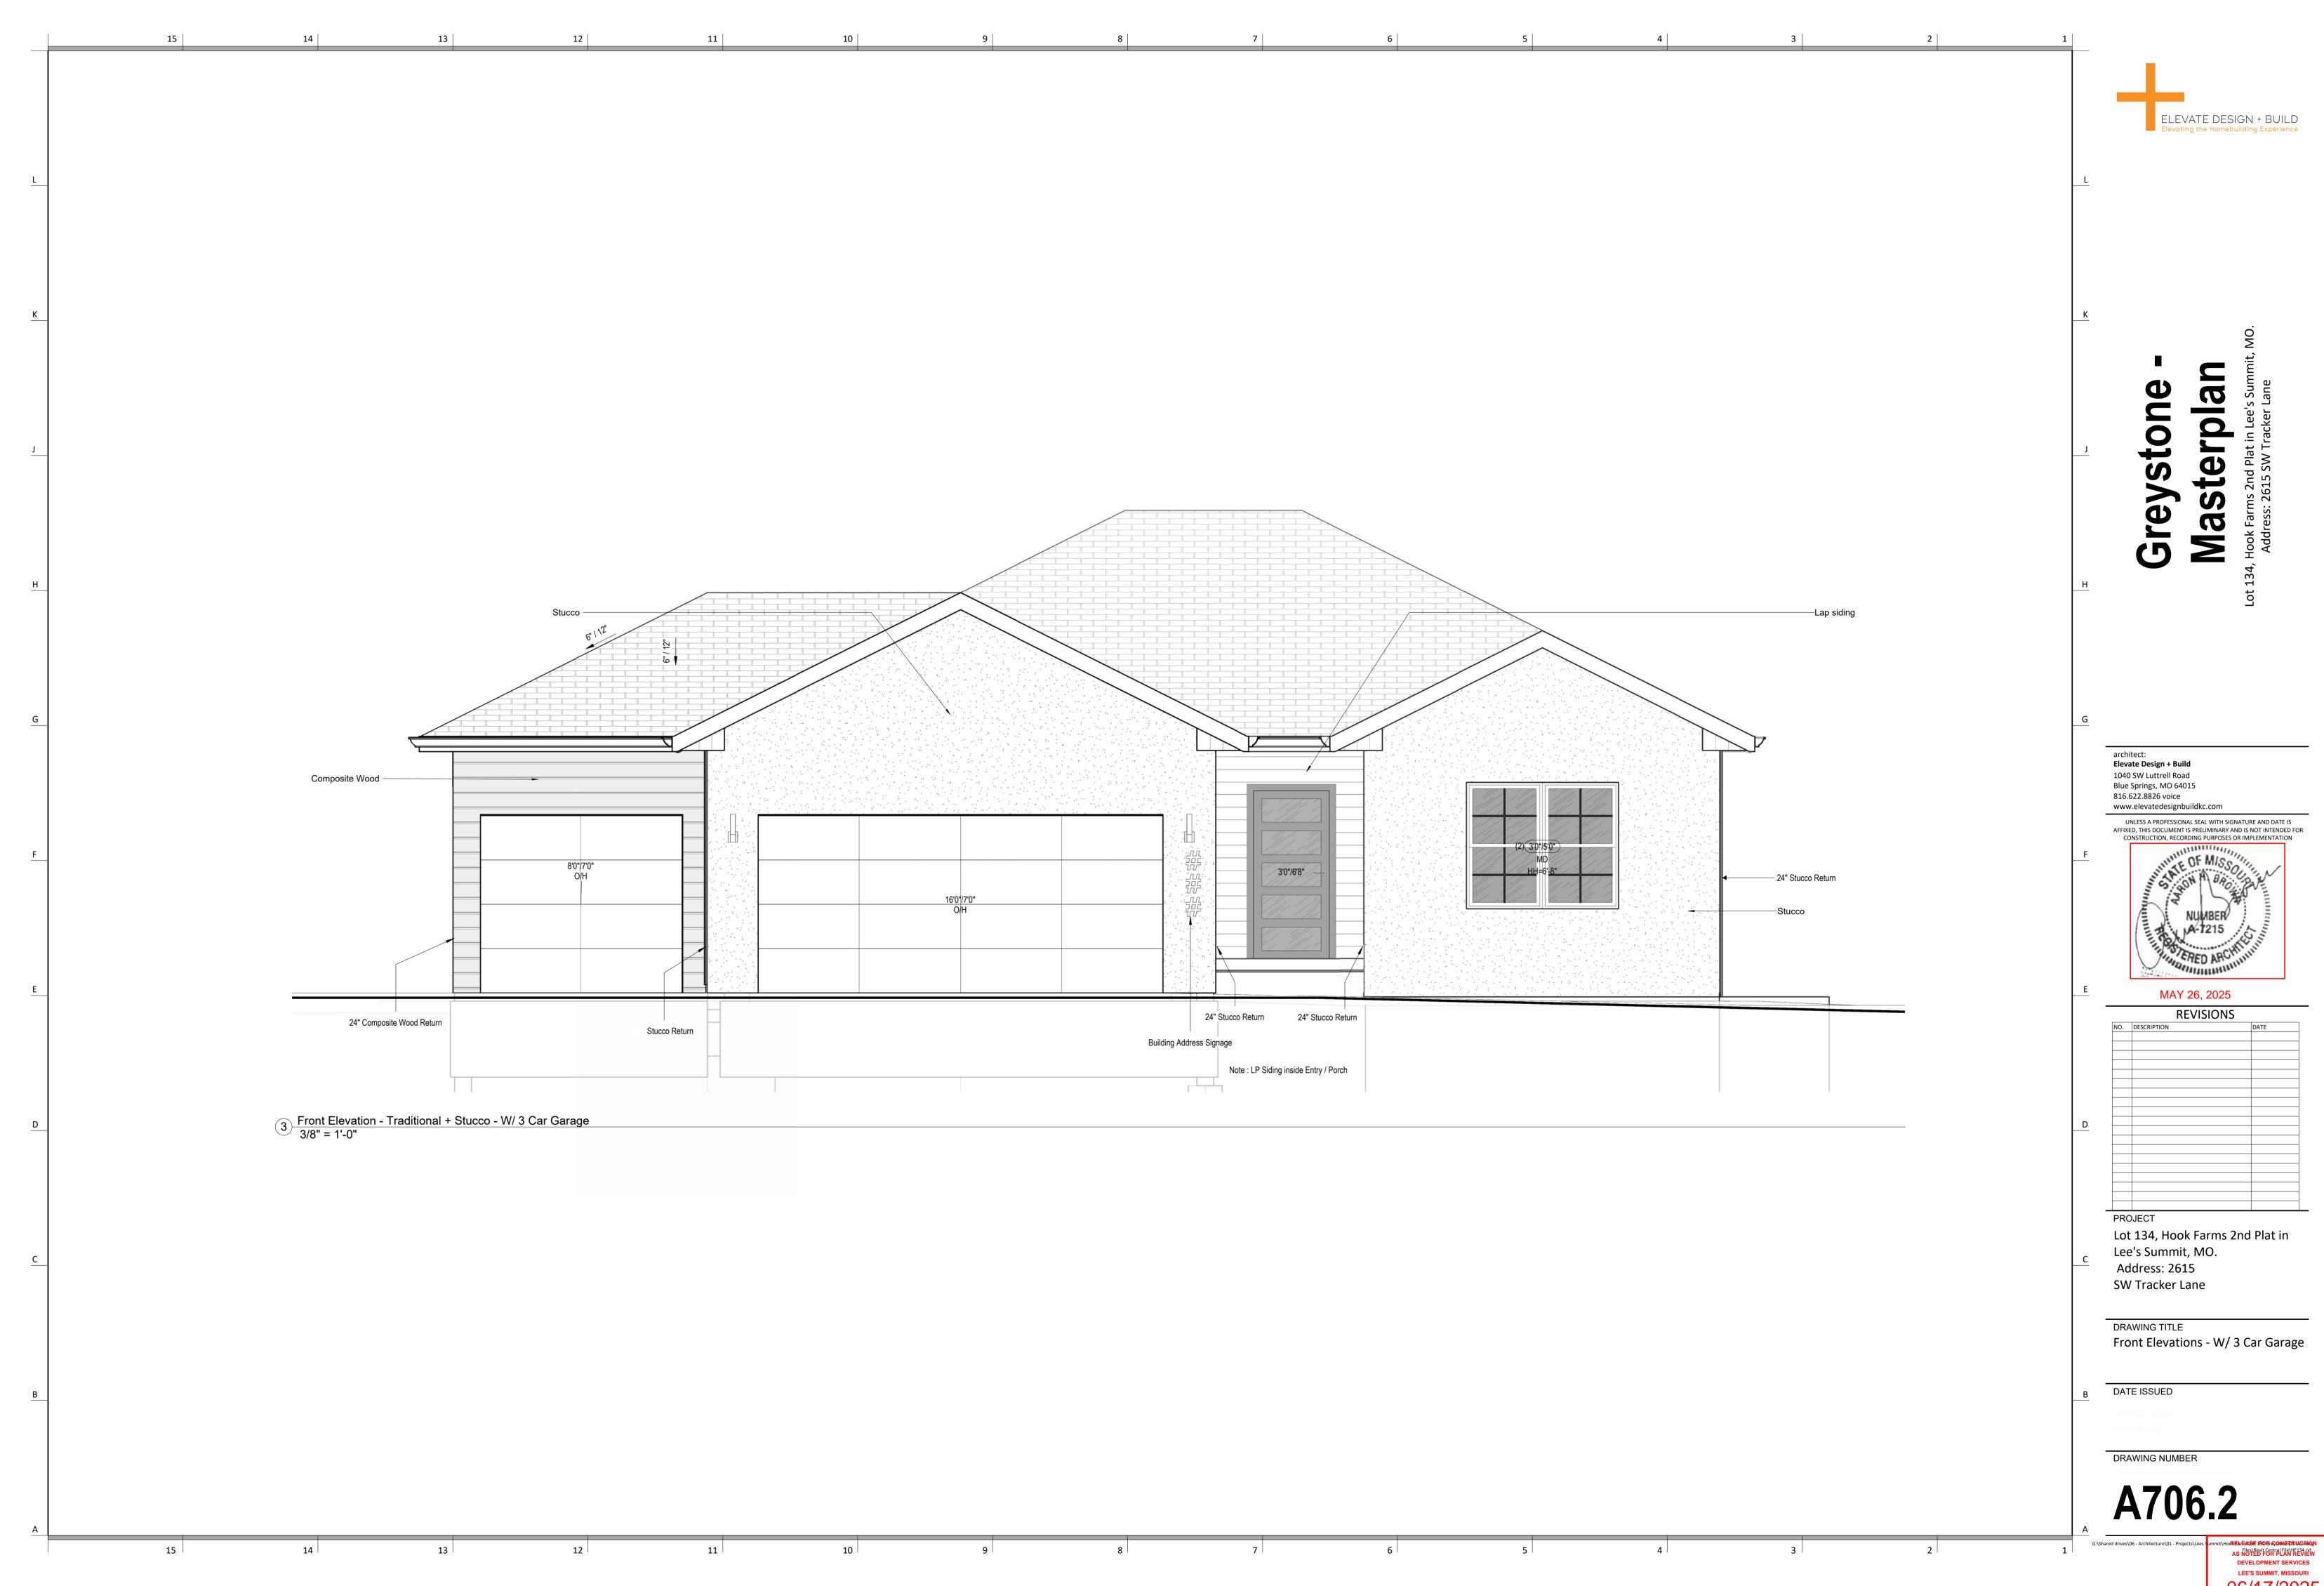06/17/2025




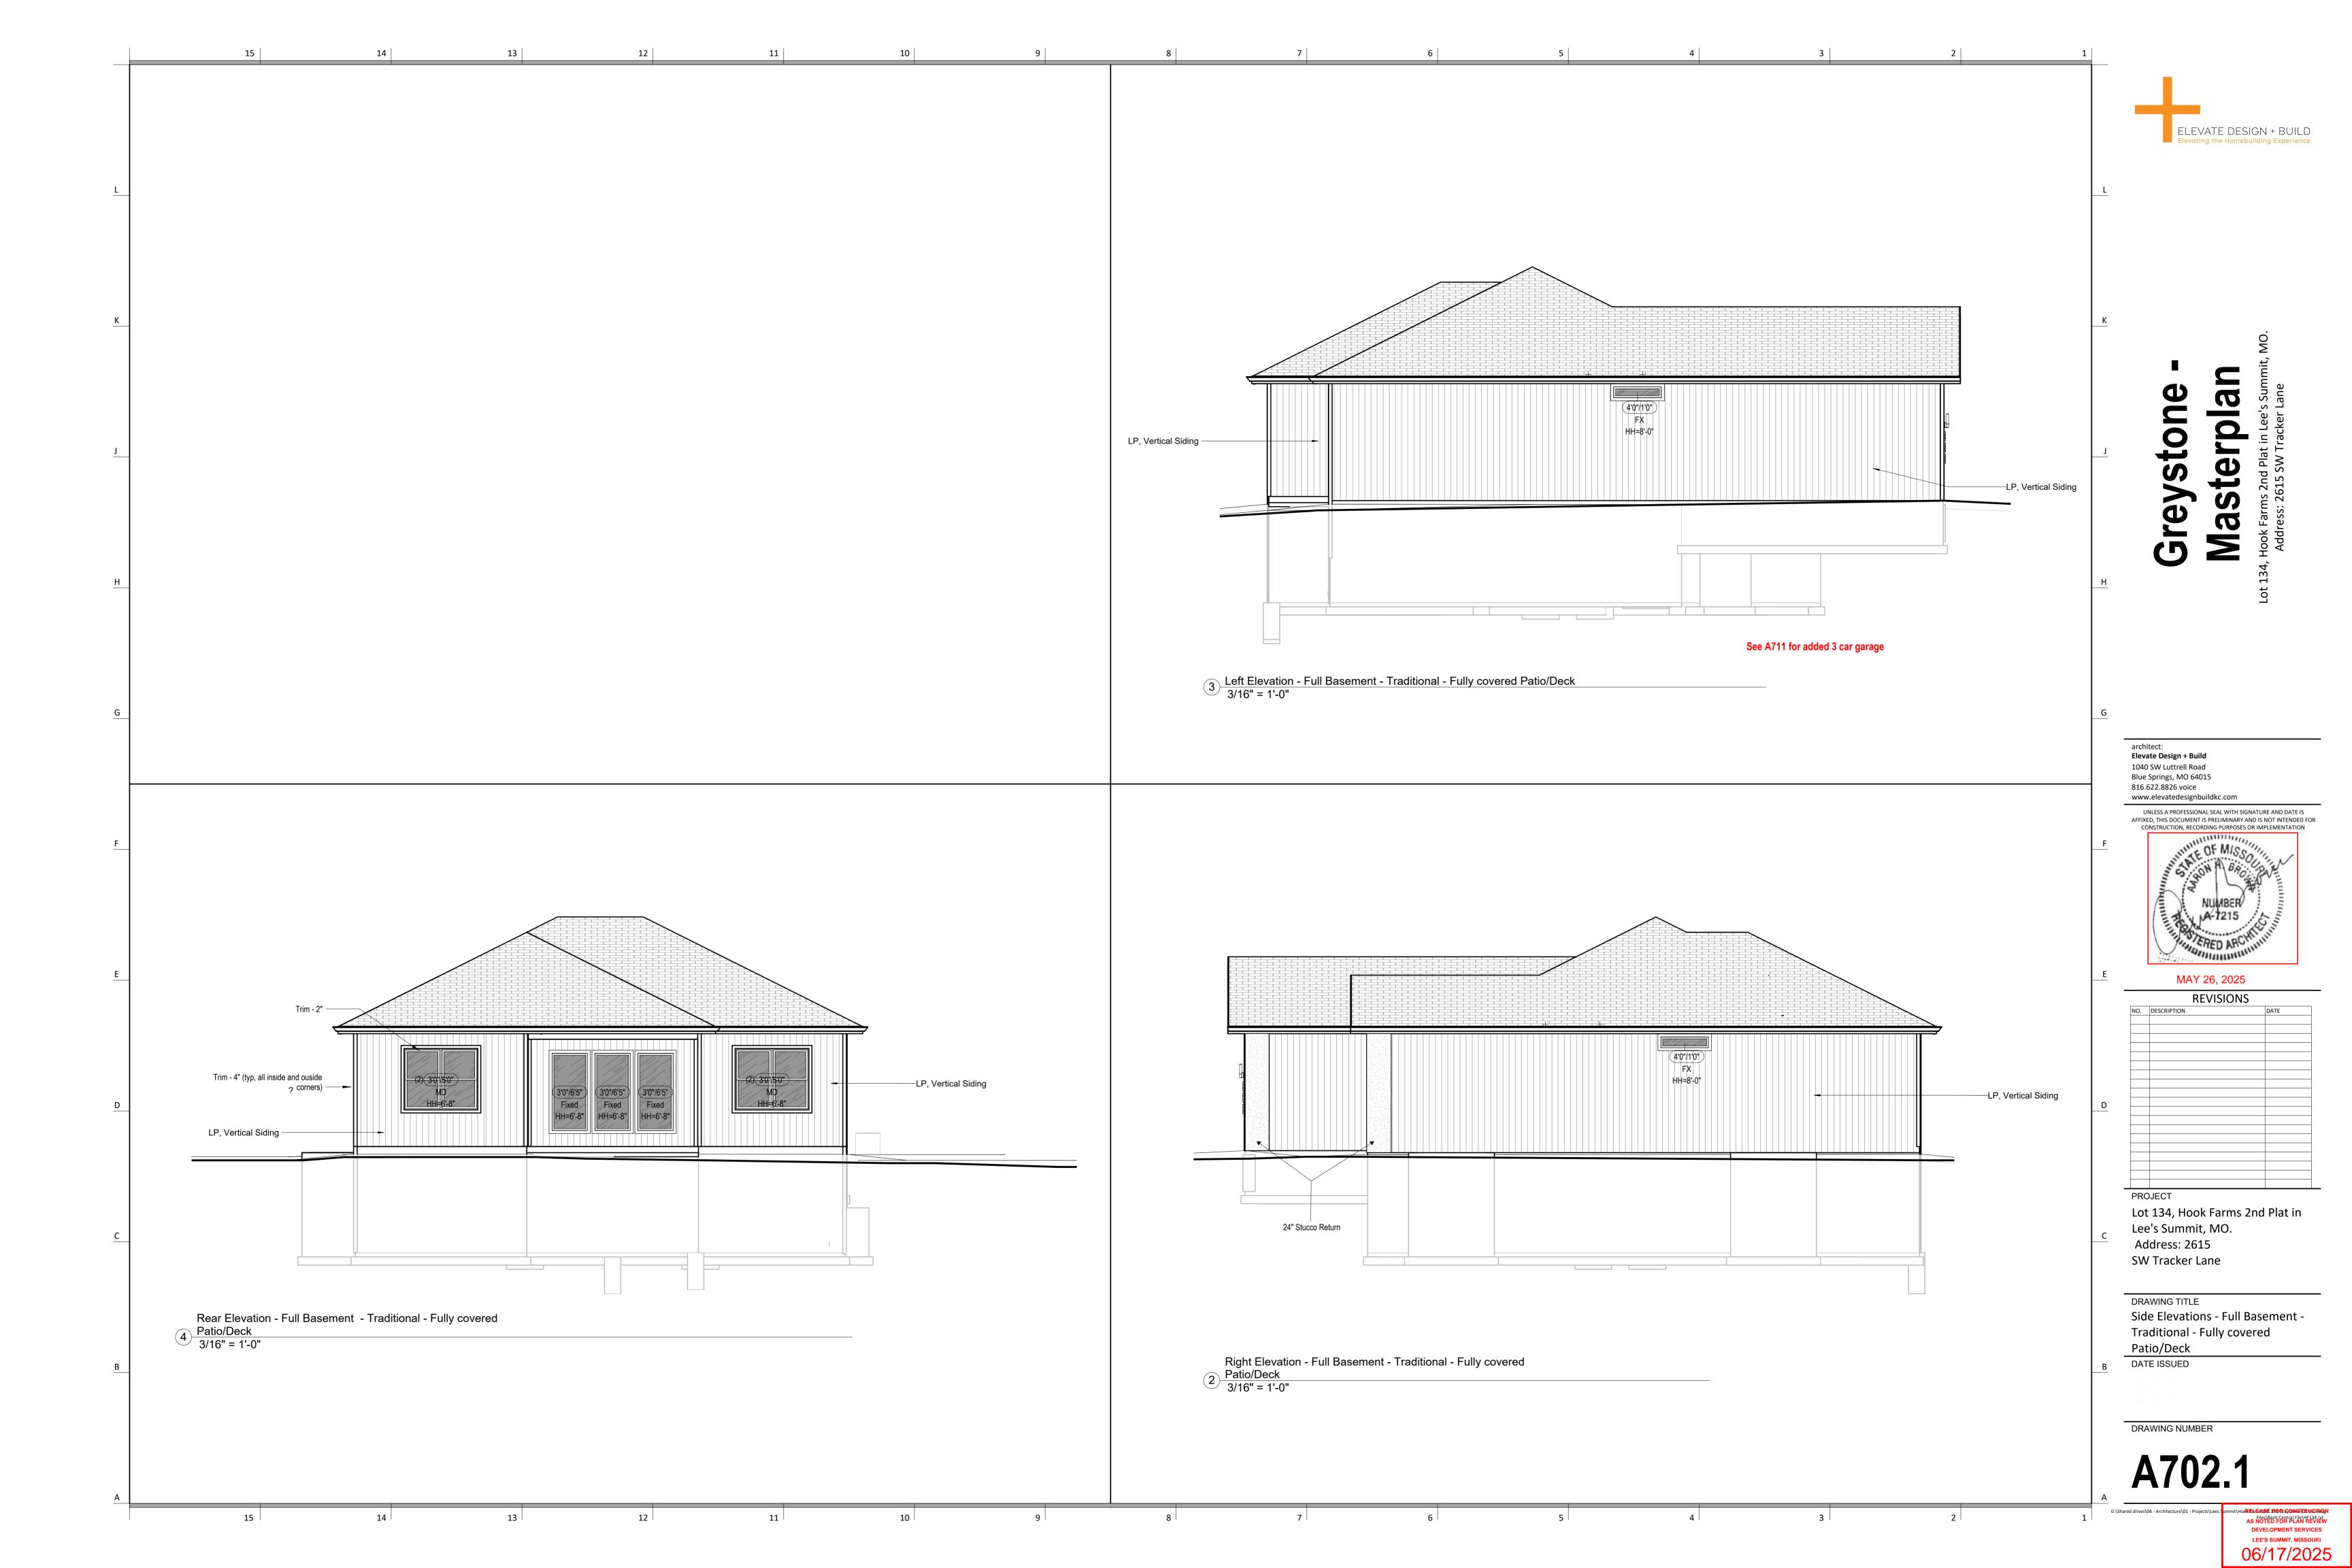

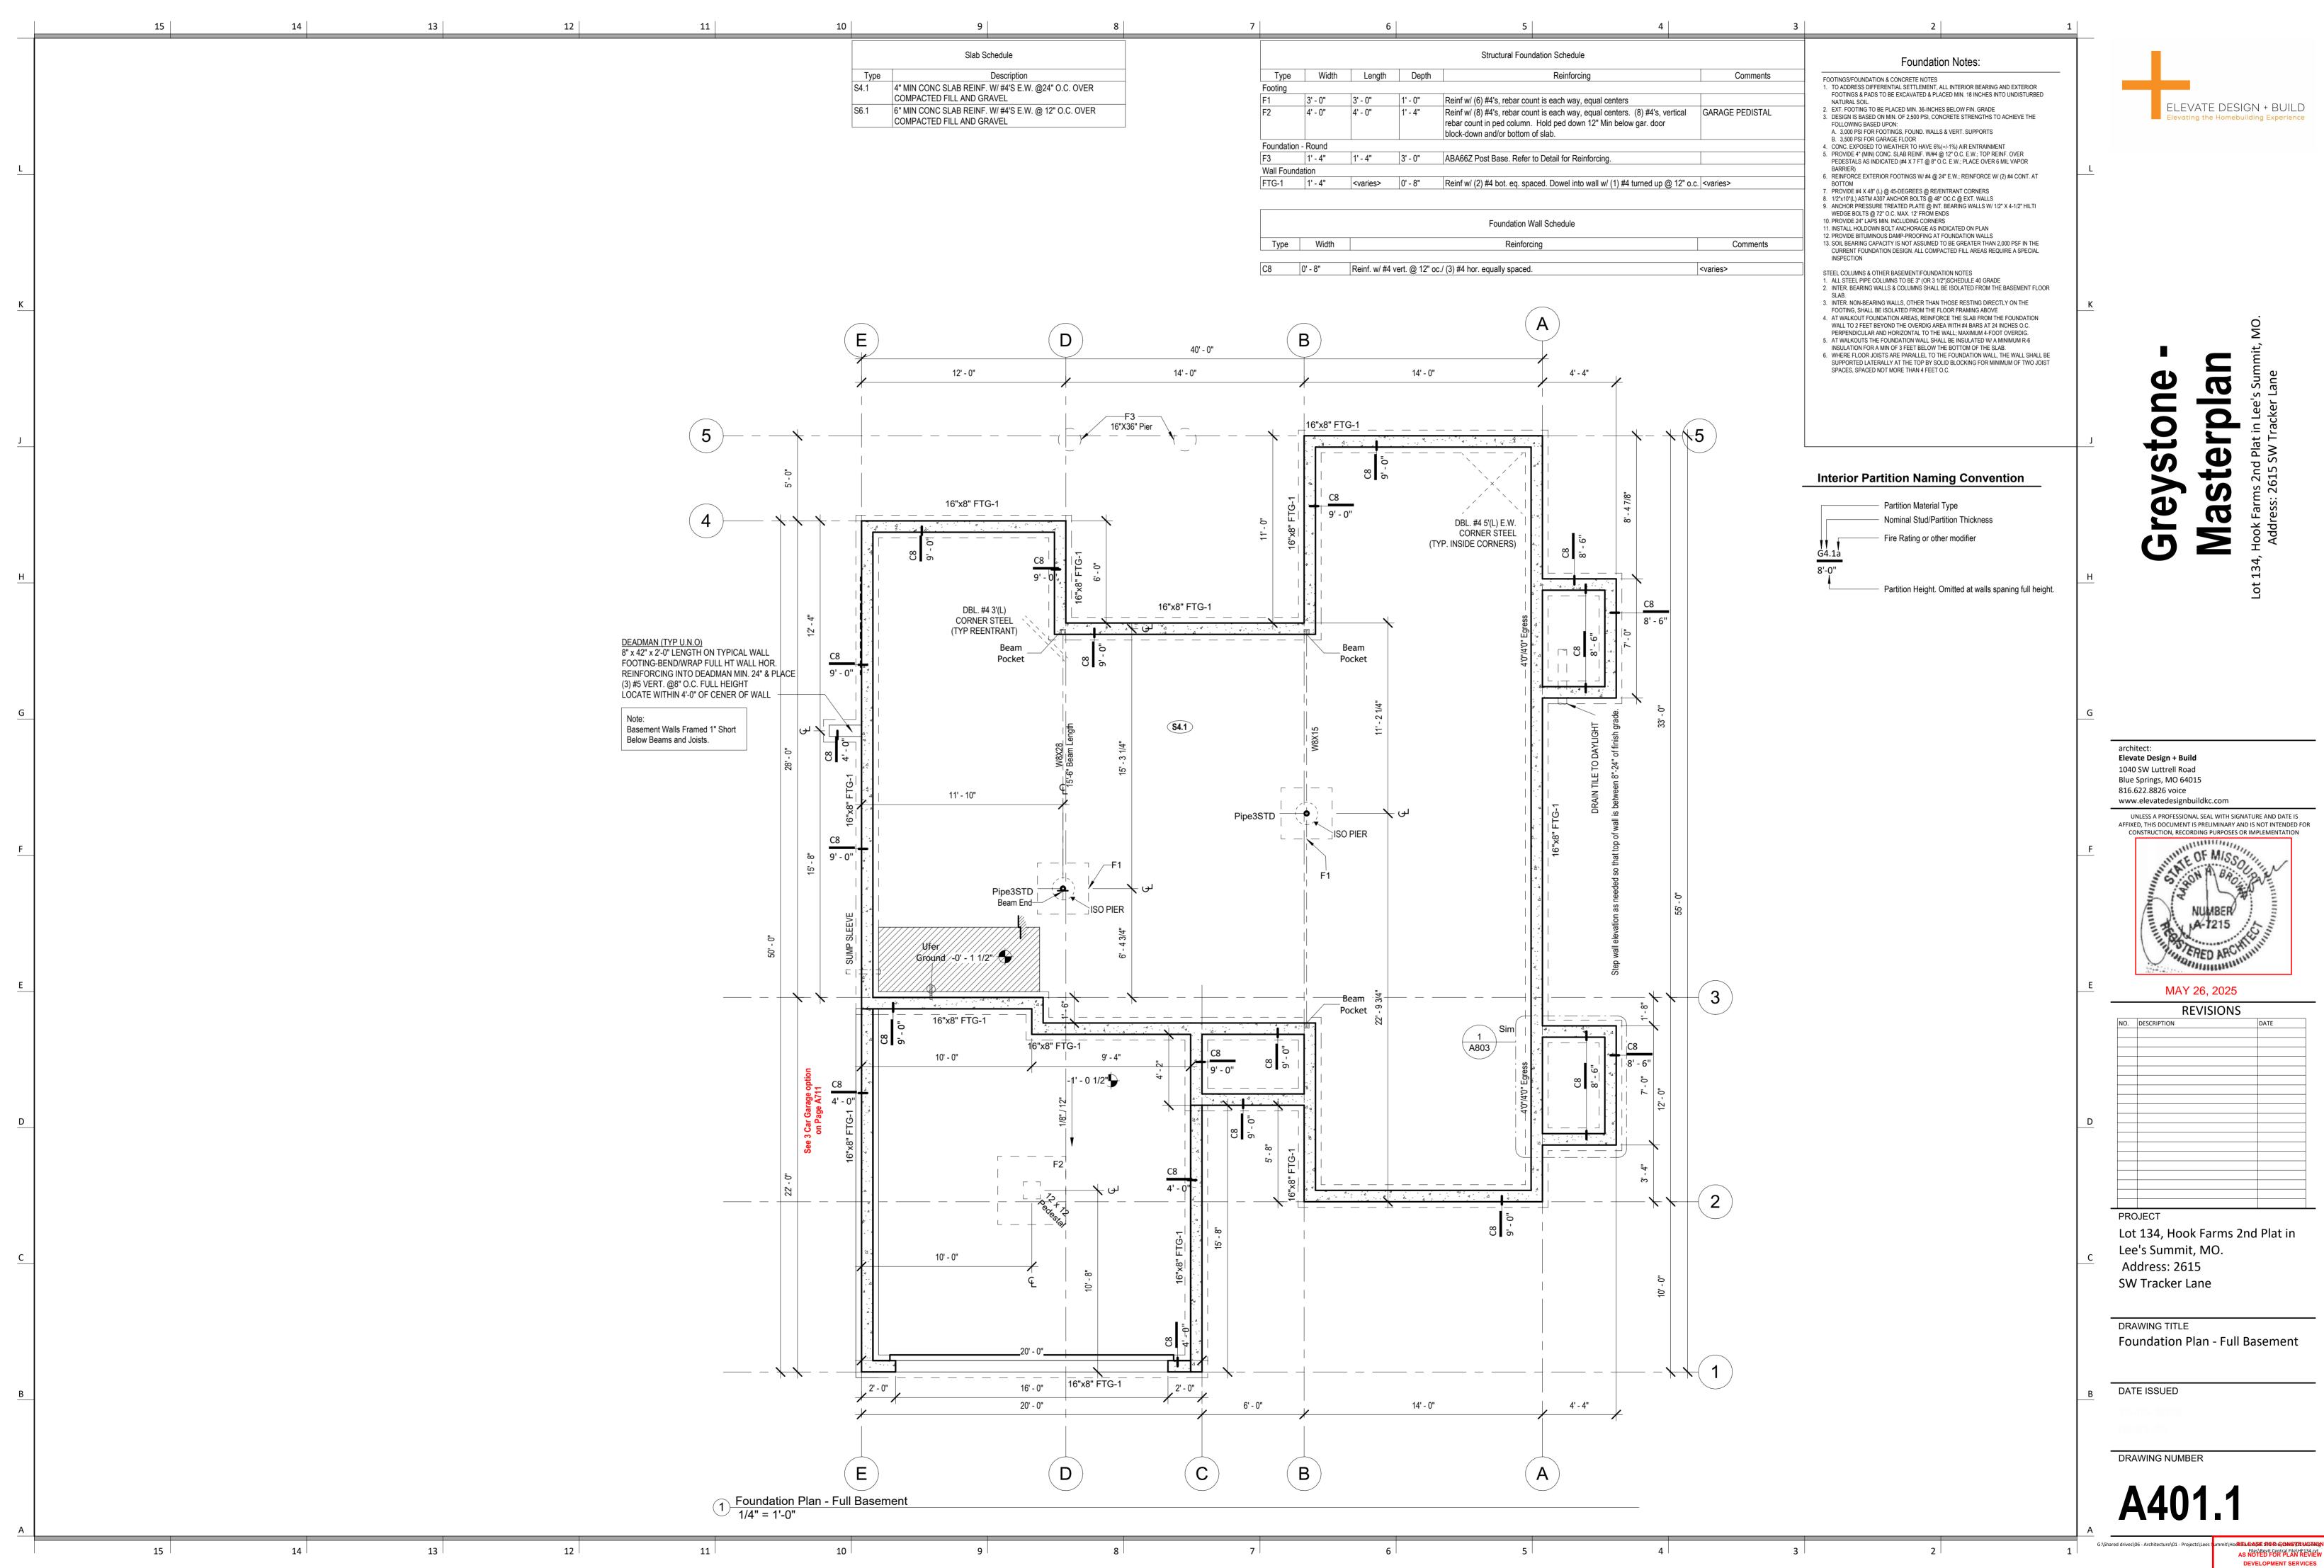
AS NOTED FOR PLAN REVIEW LEE'S SUMMIT, MISSOURI 06/17/2025




LEE'S SUMMIT, MISSOURI 06/17/2025

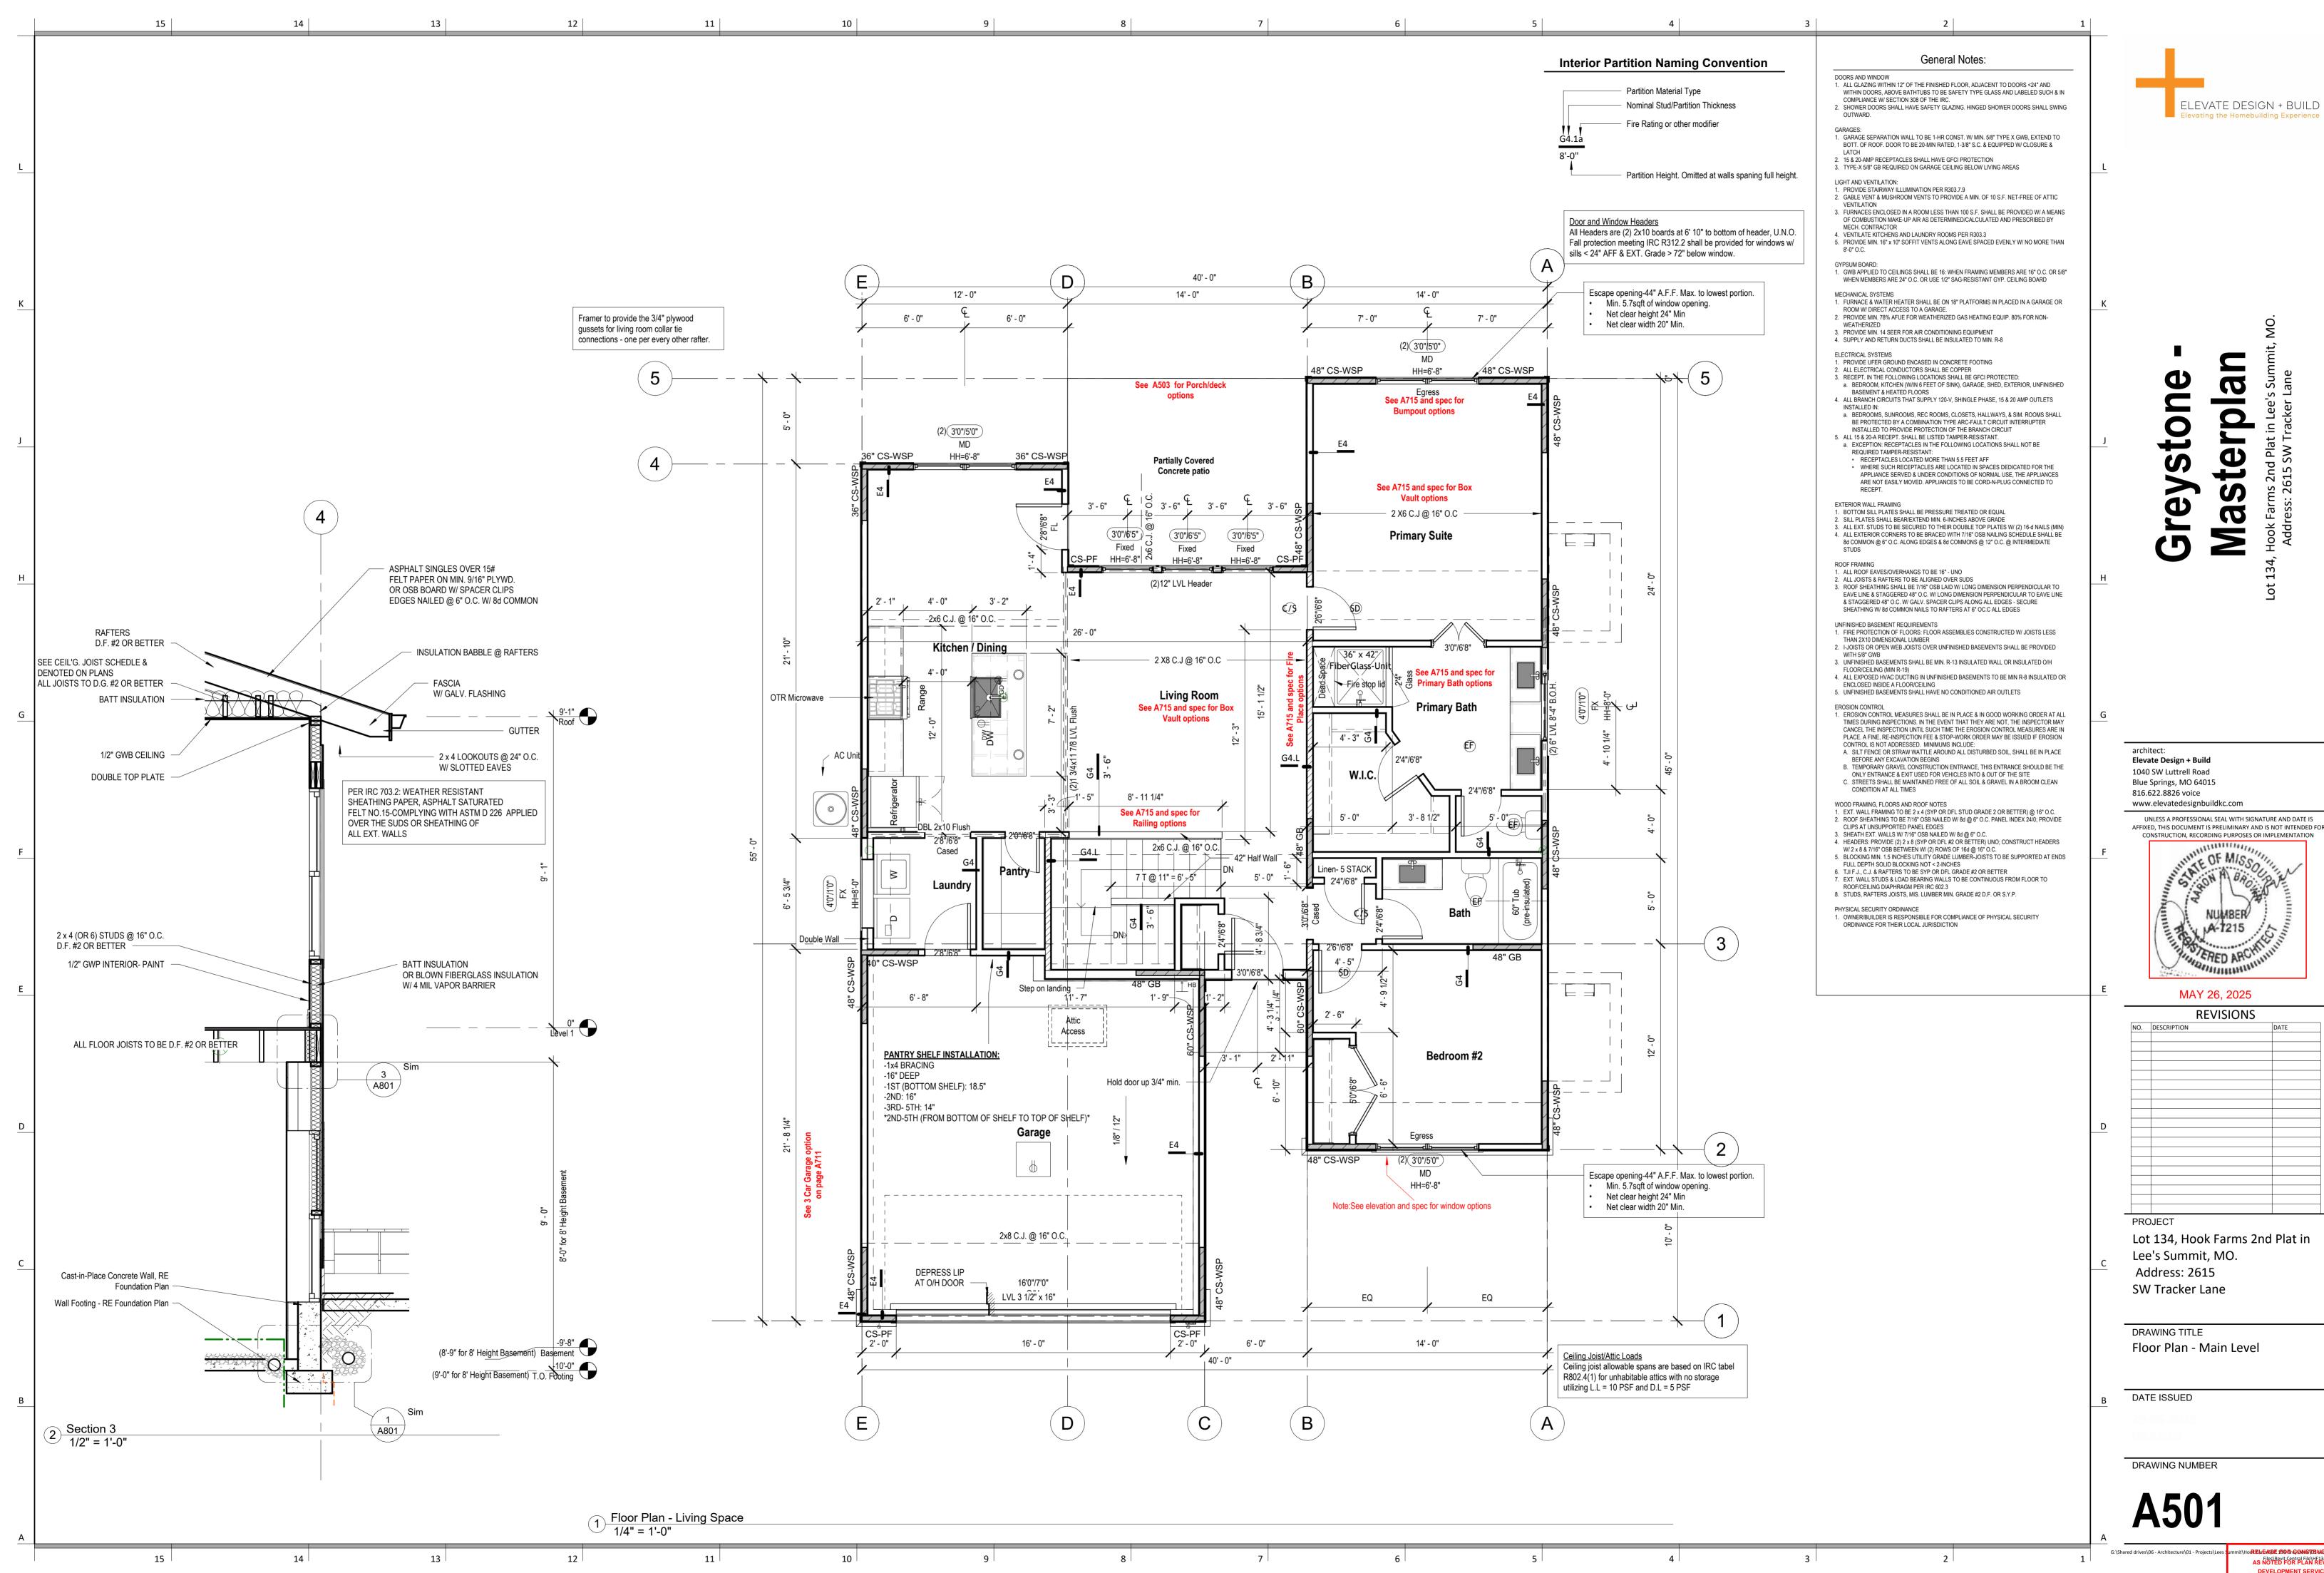


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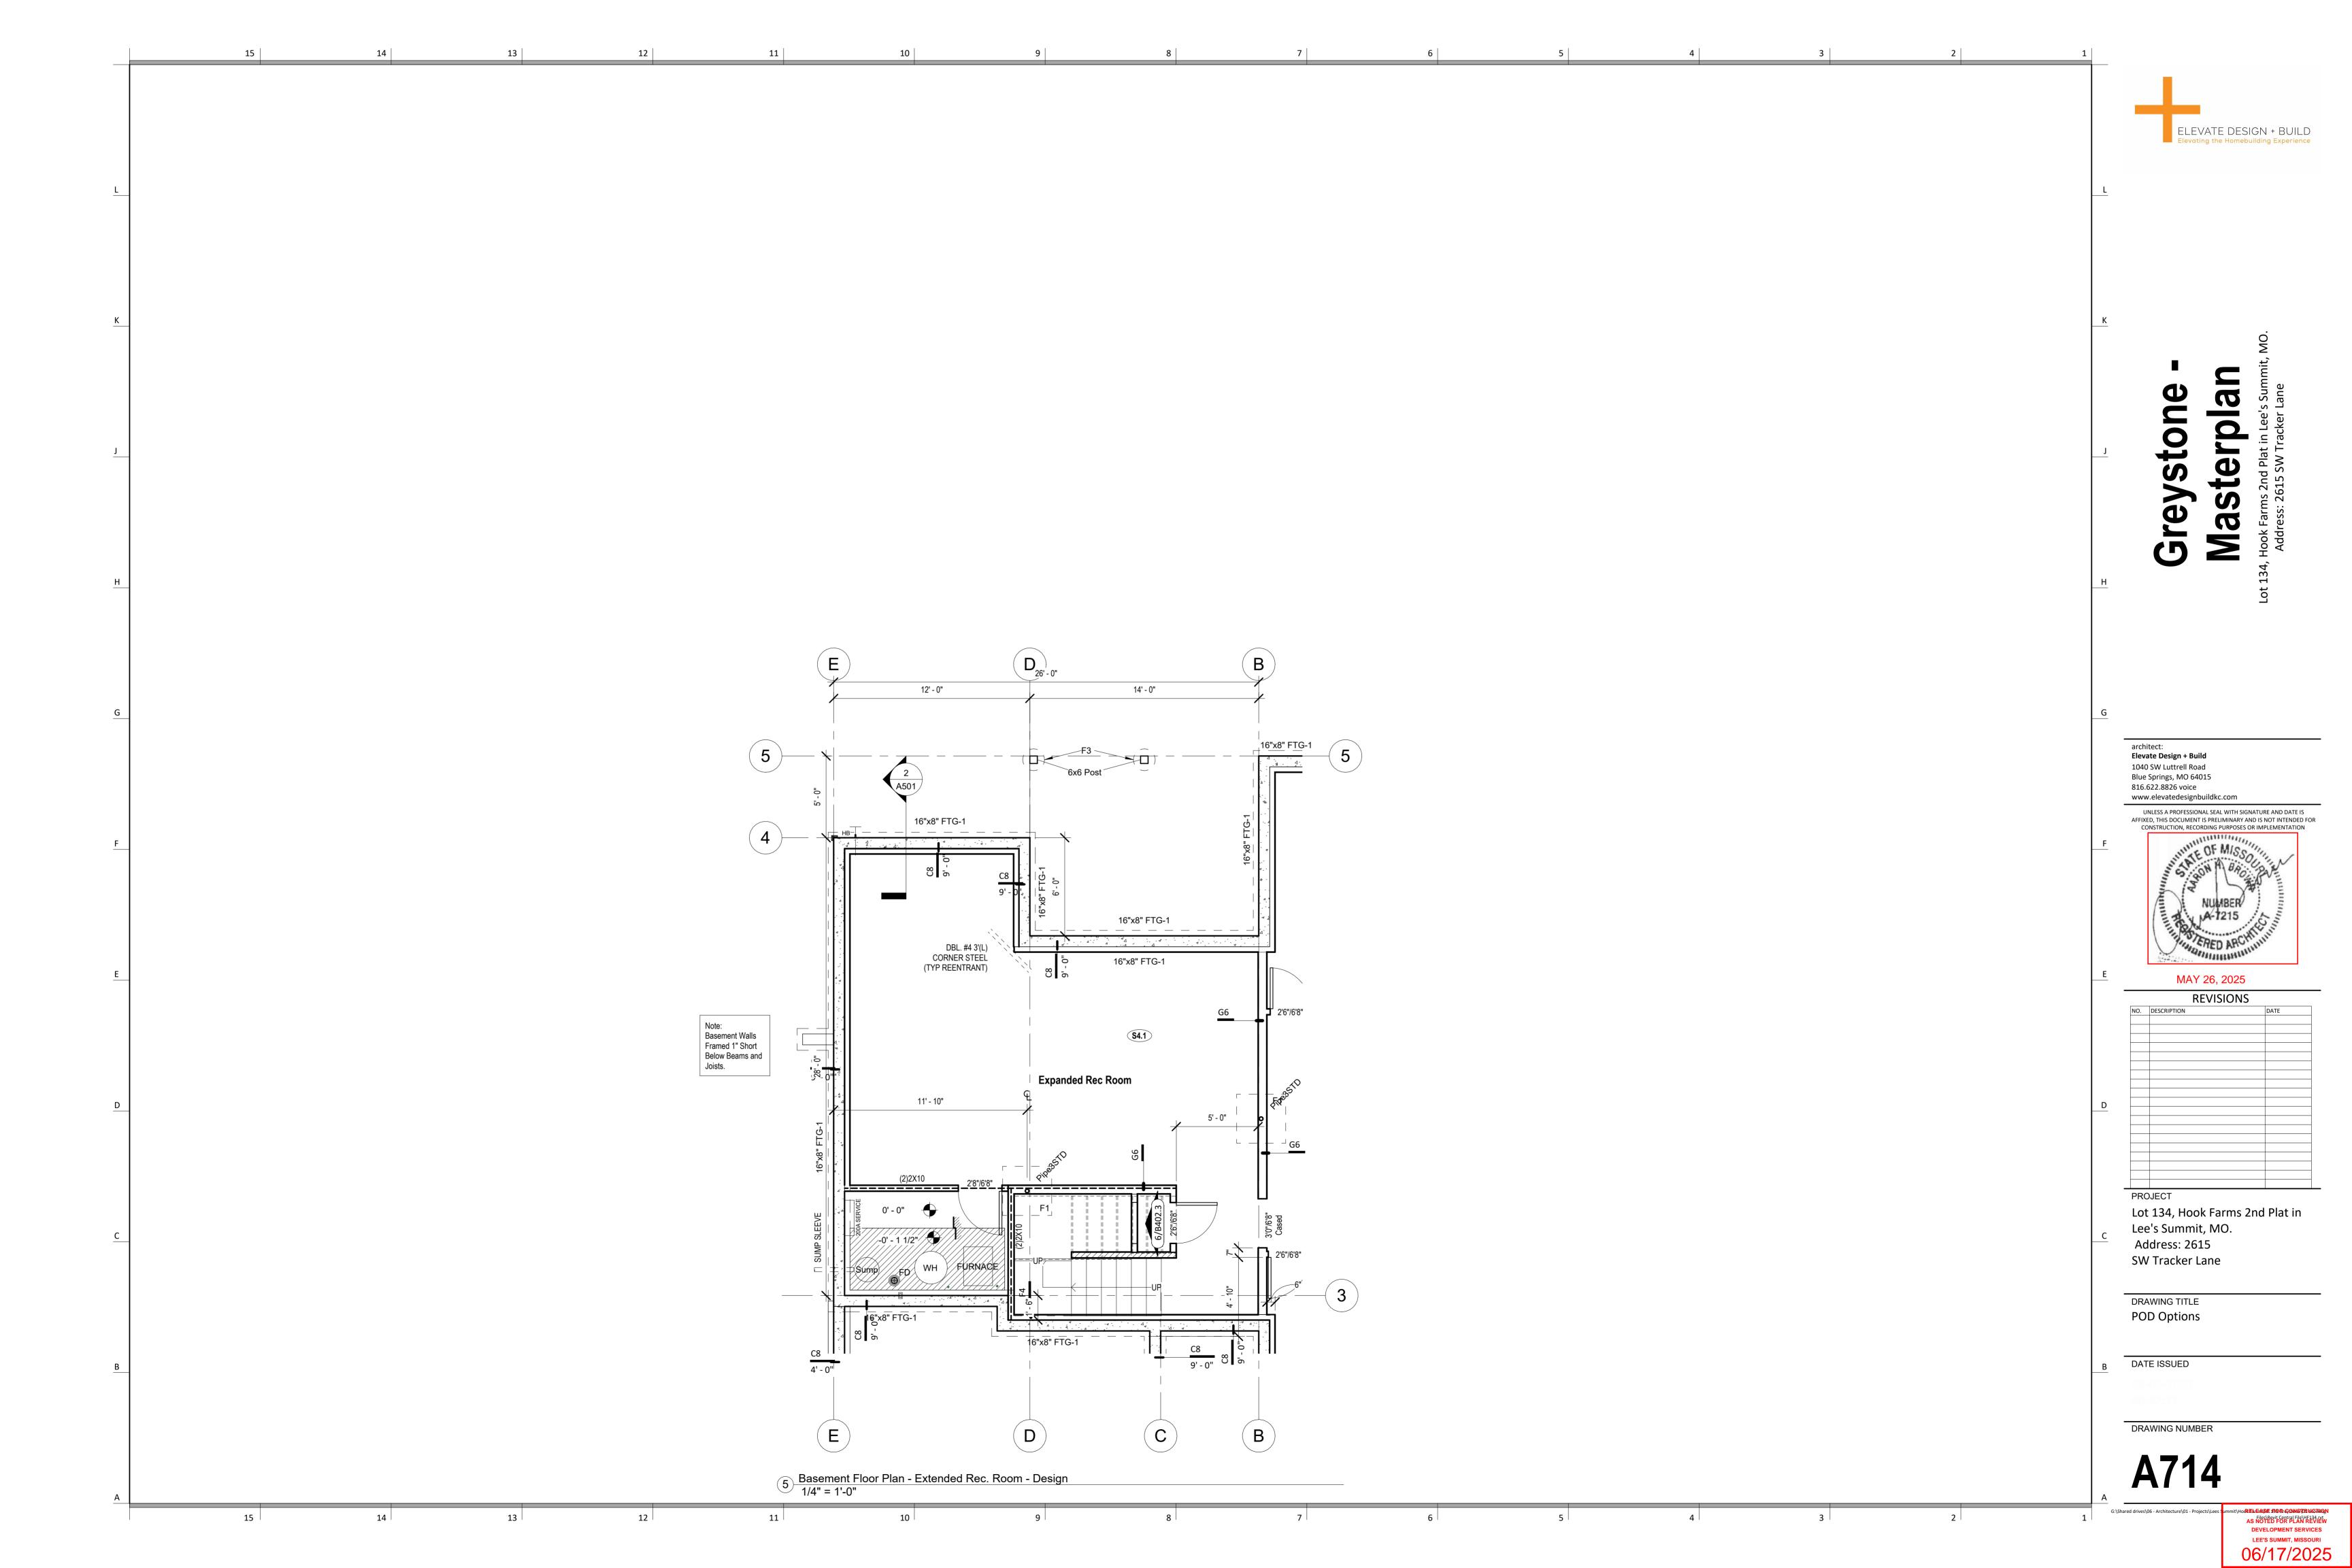


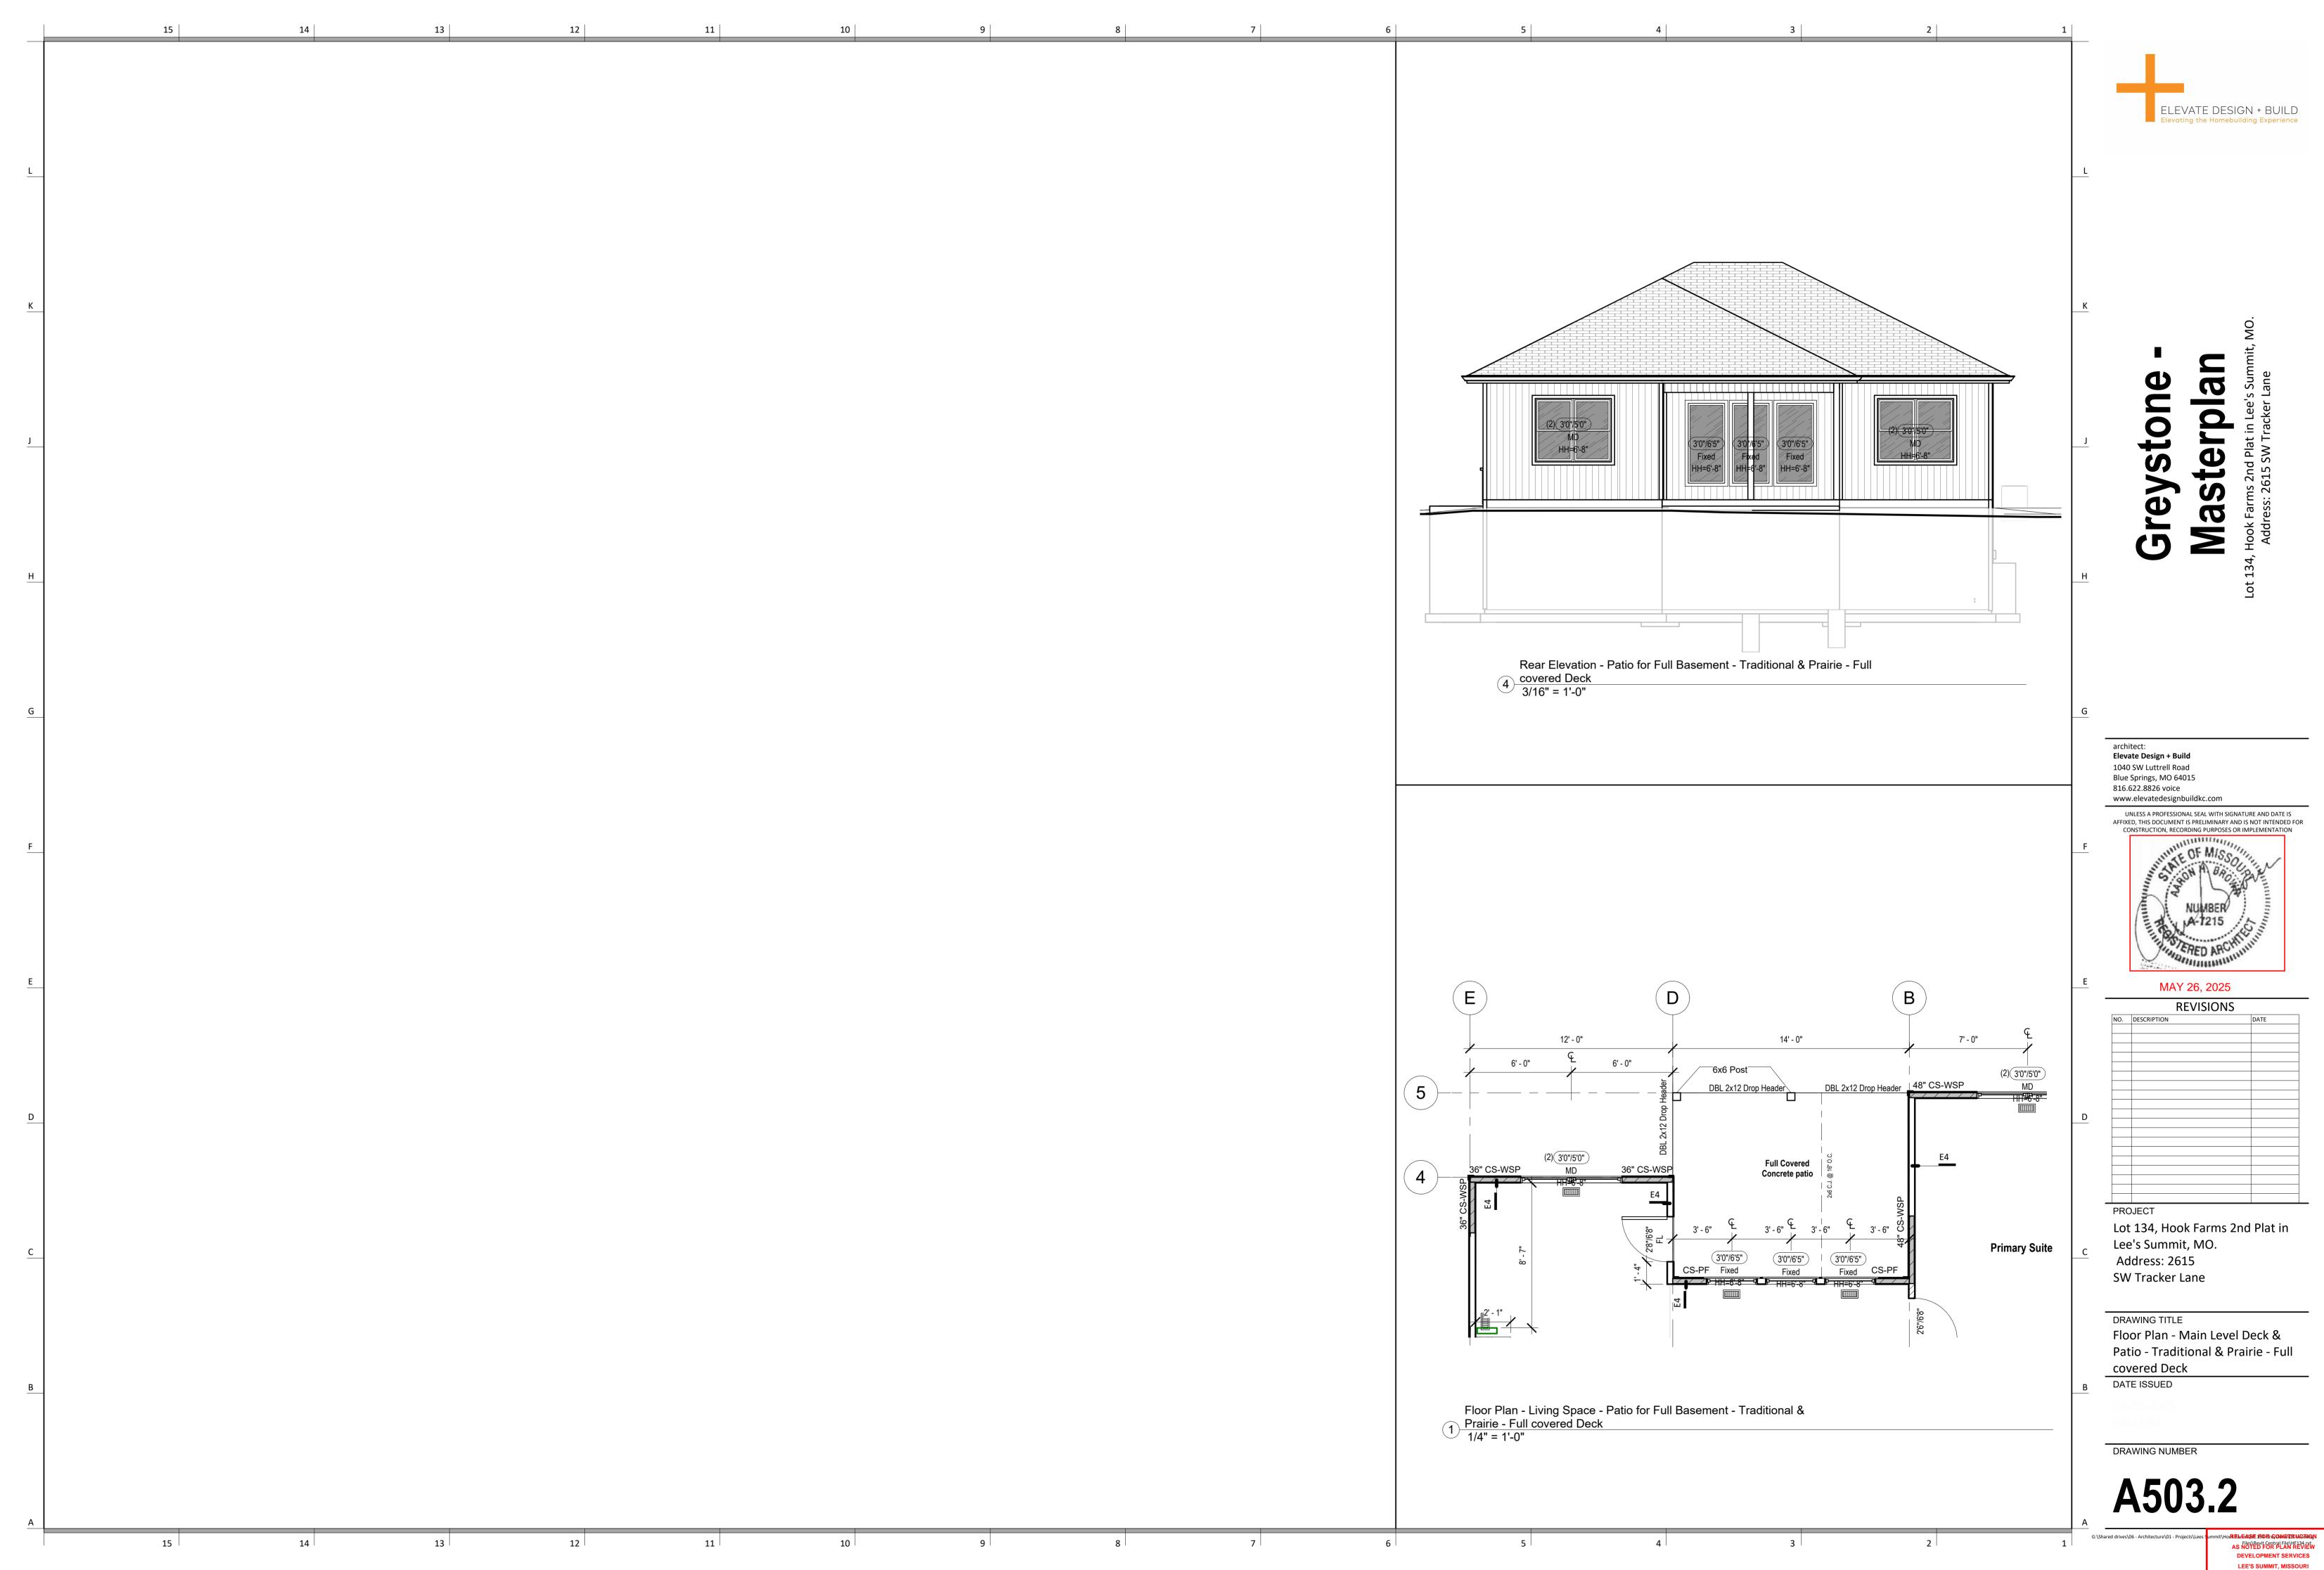LEE'S SUMMIT, MISSOURI 06/17/2025




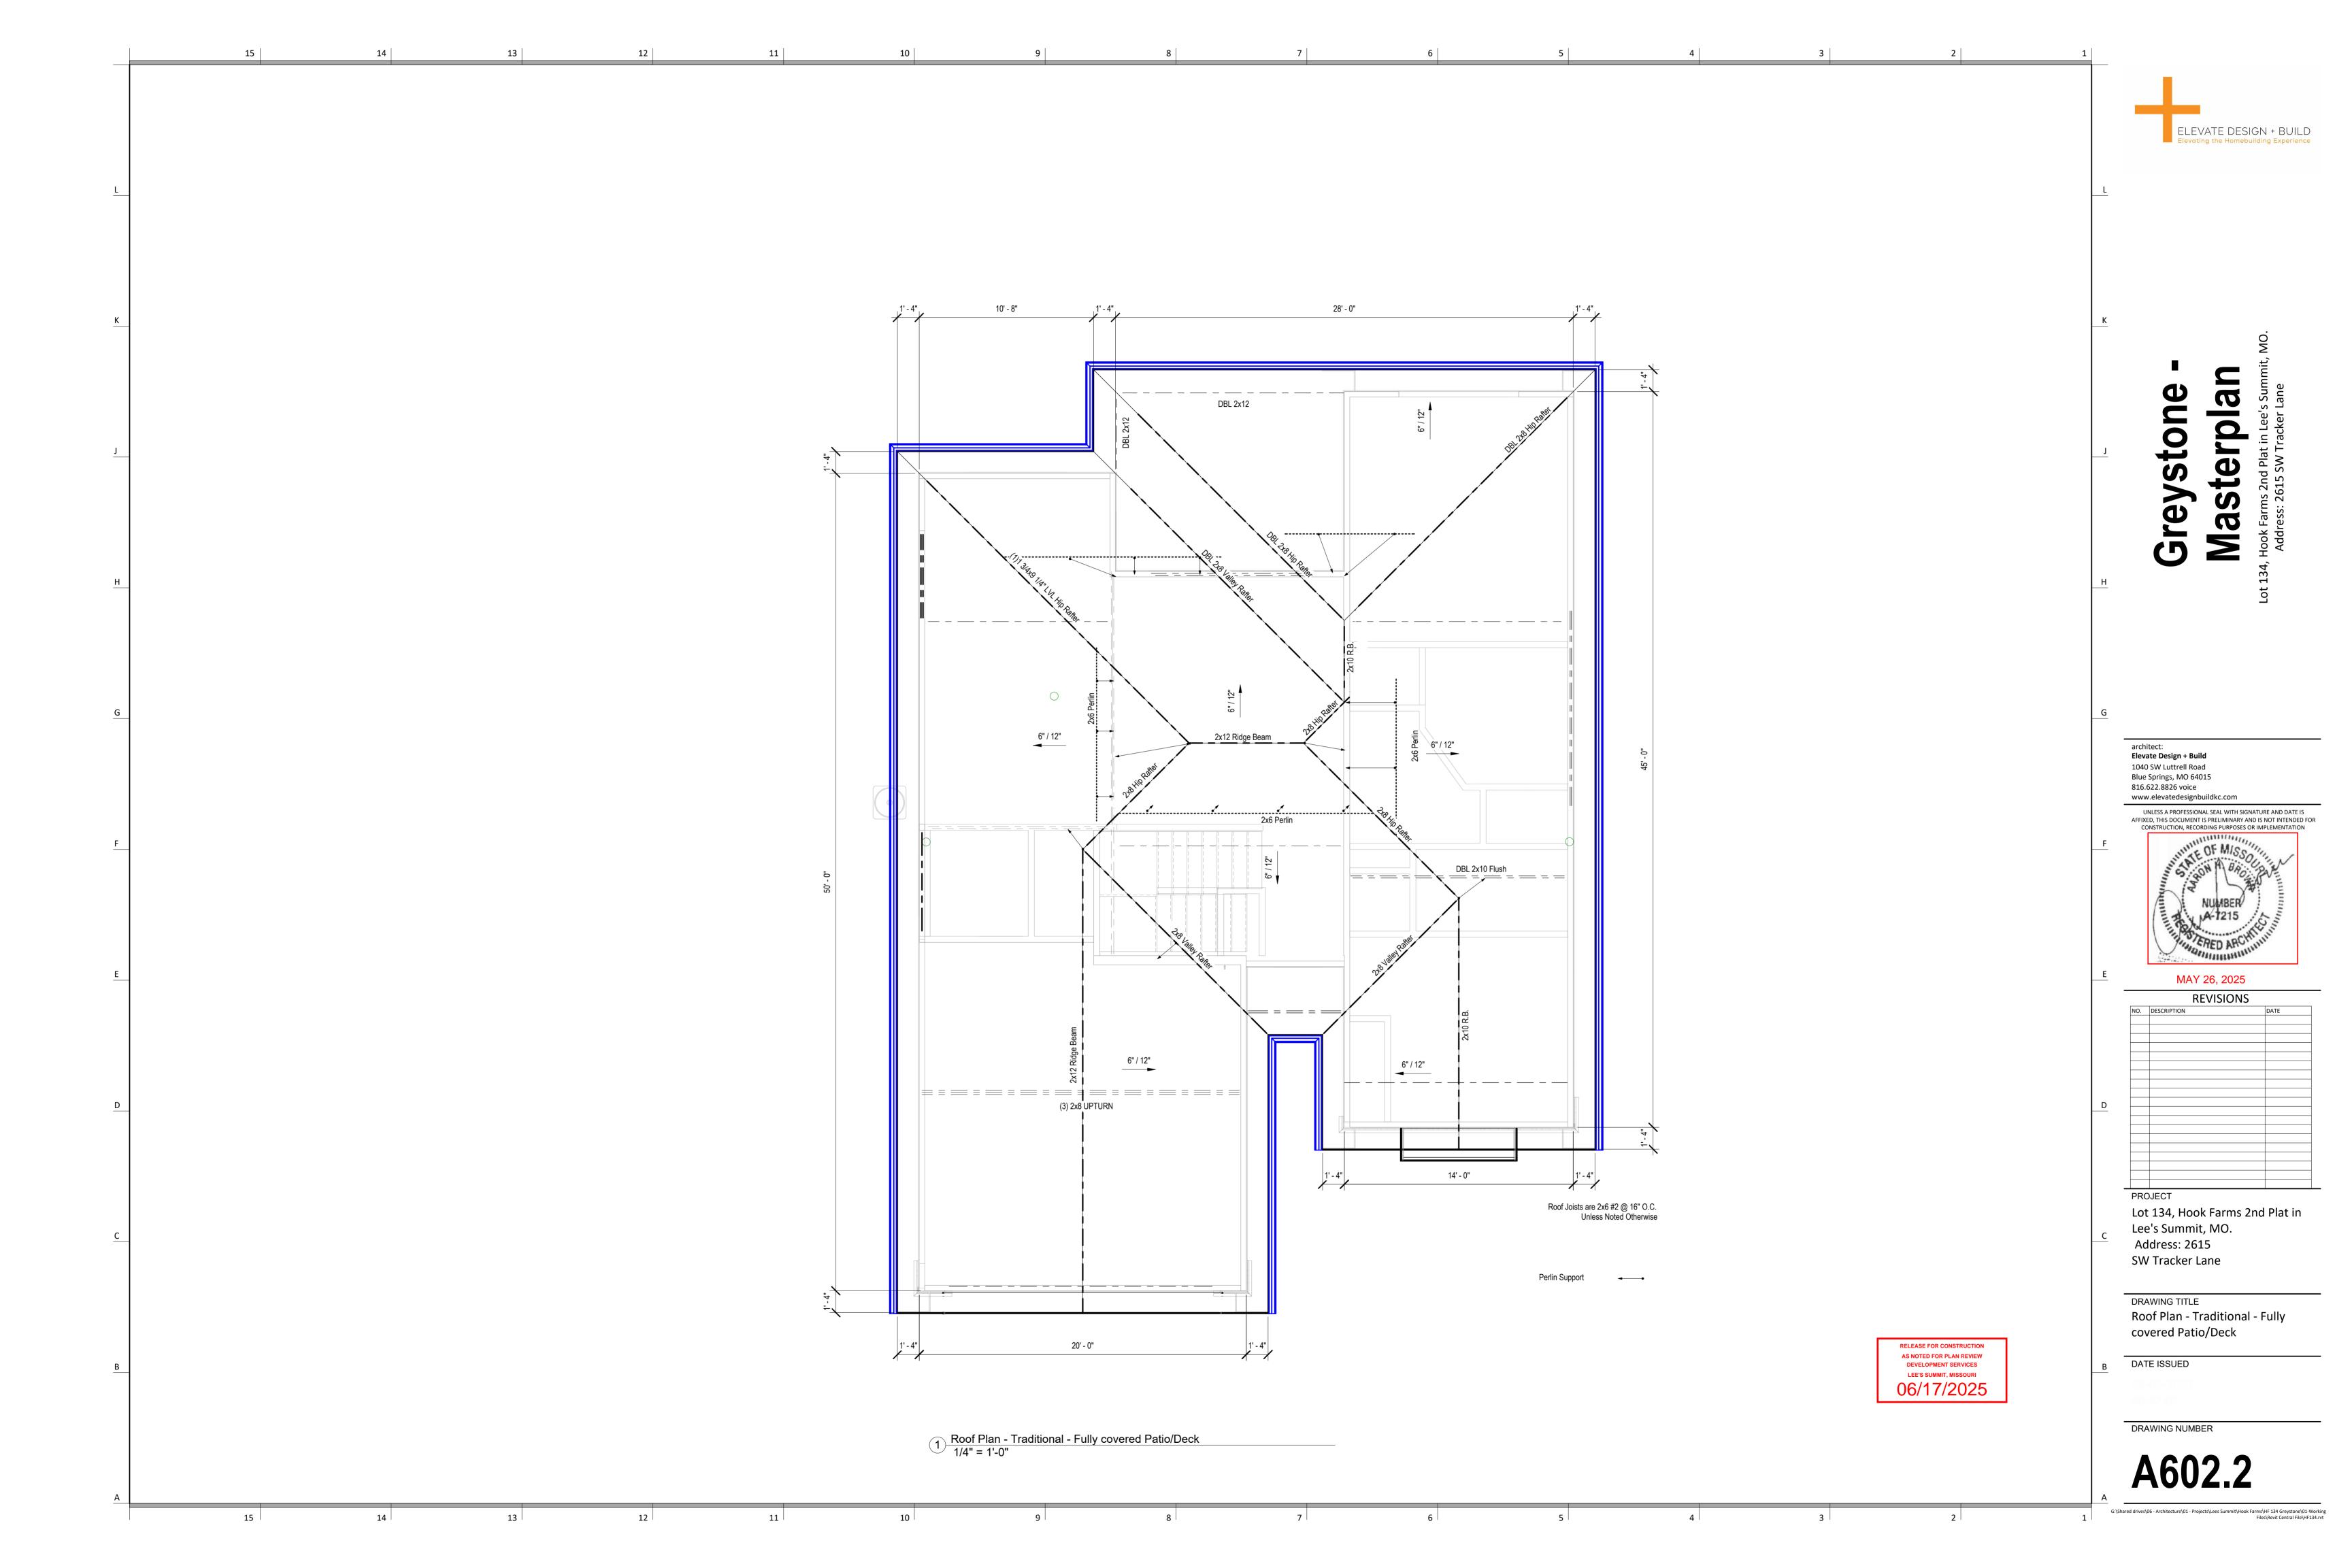

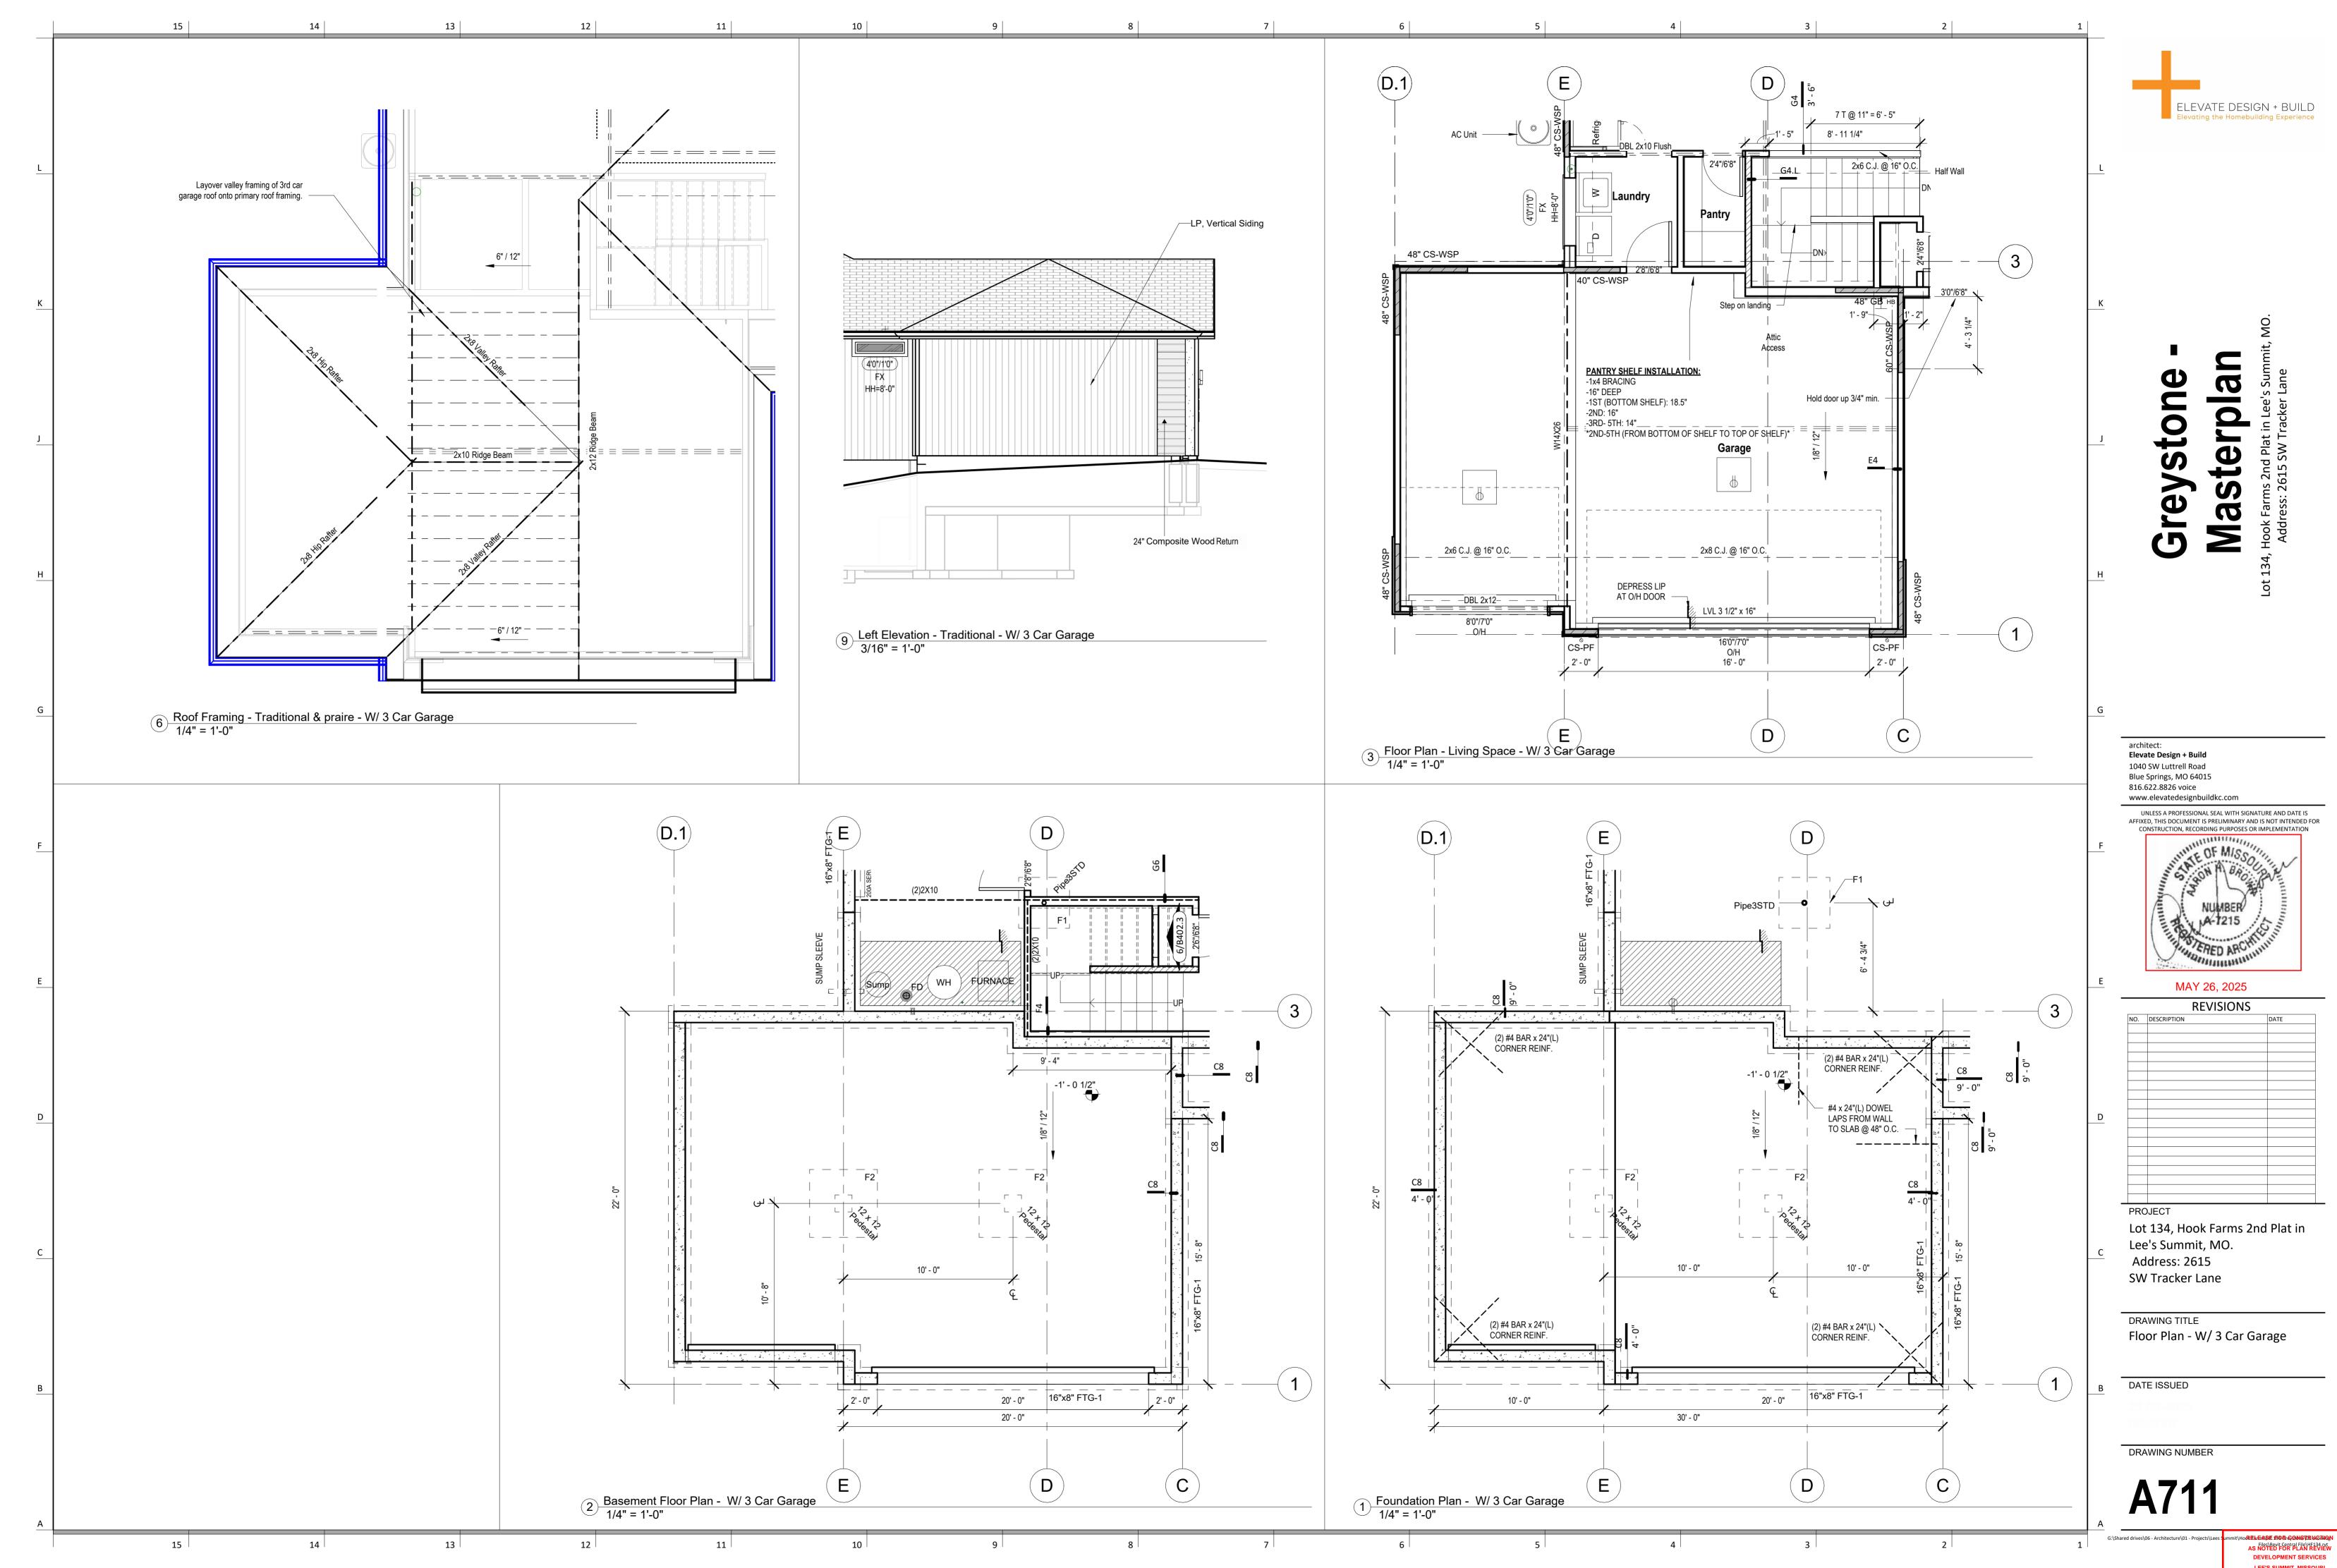LEE'S SUMMIT, MISSOURI 06/17/2025





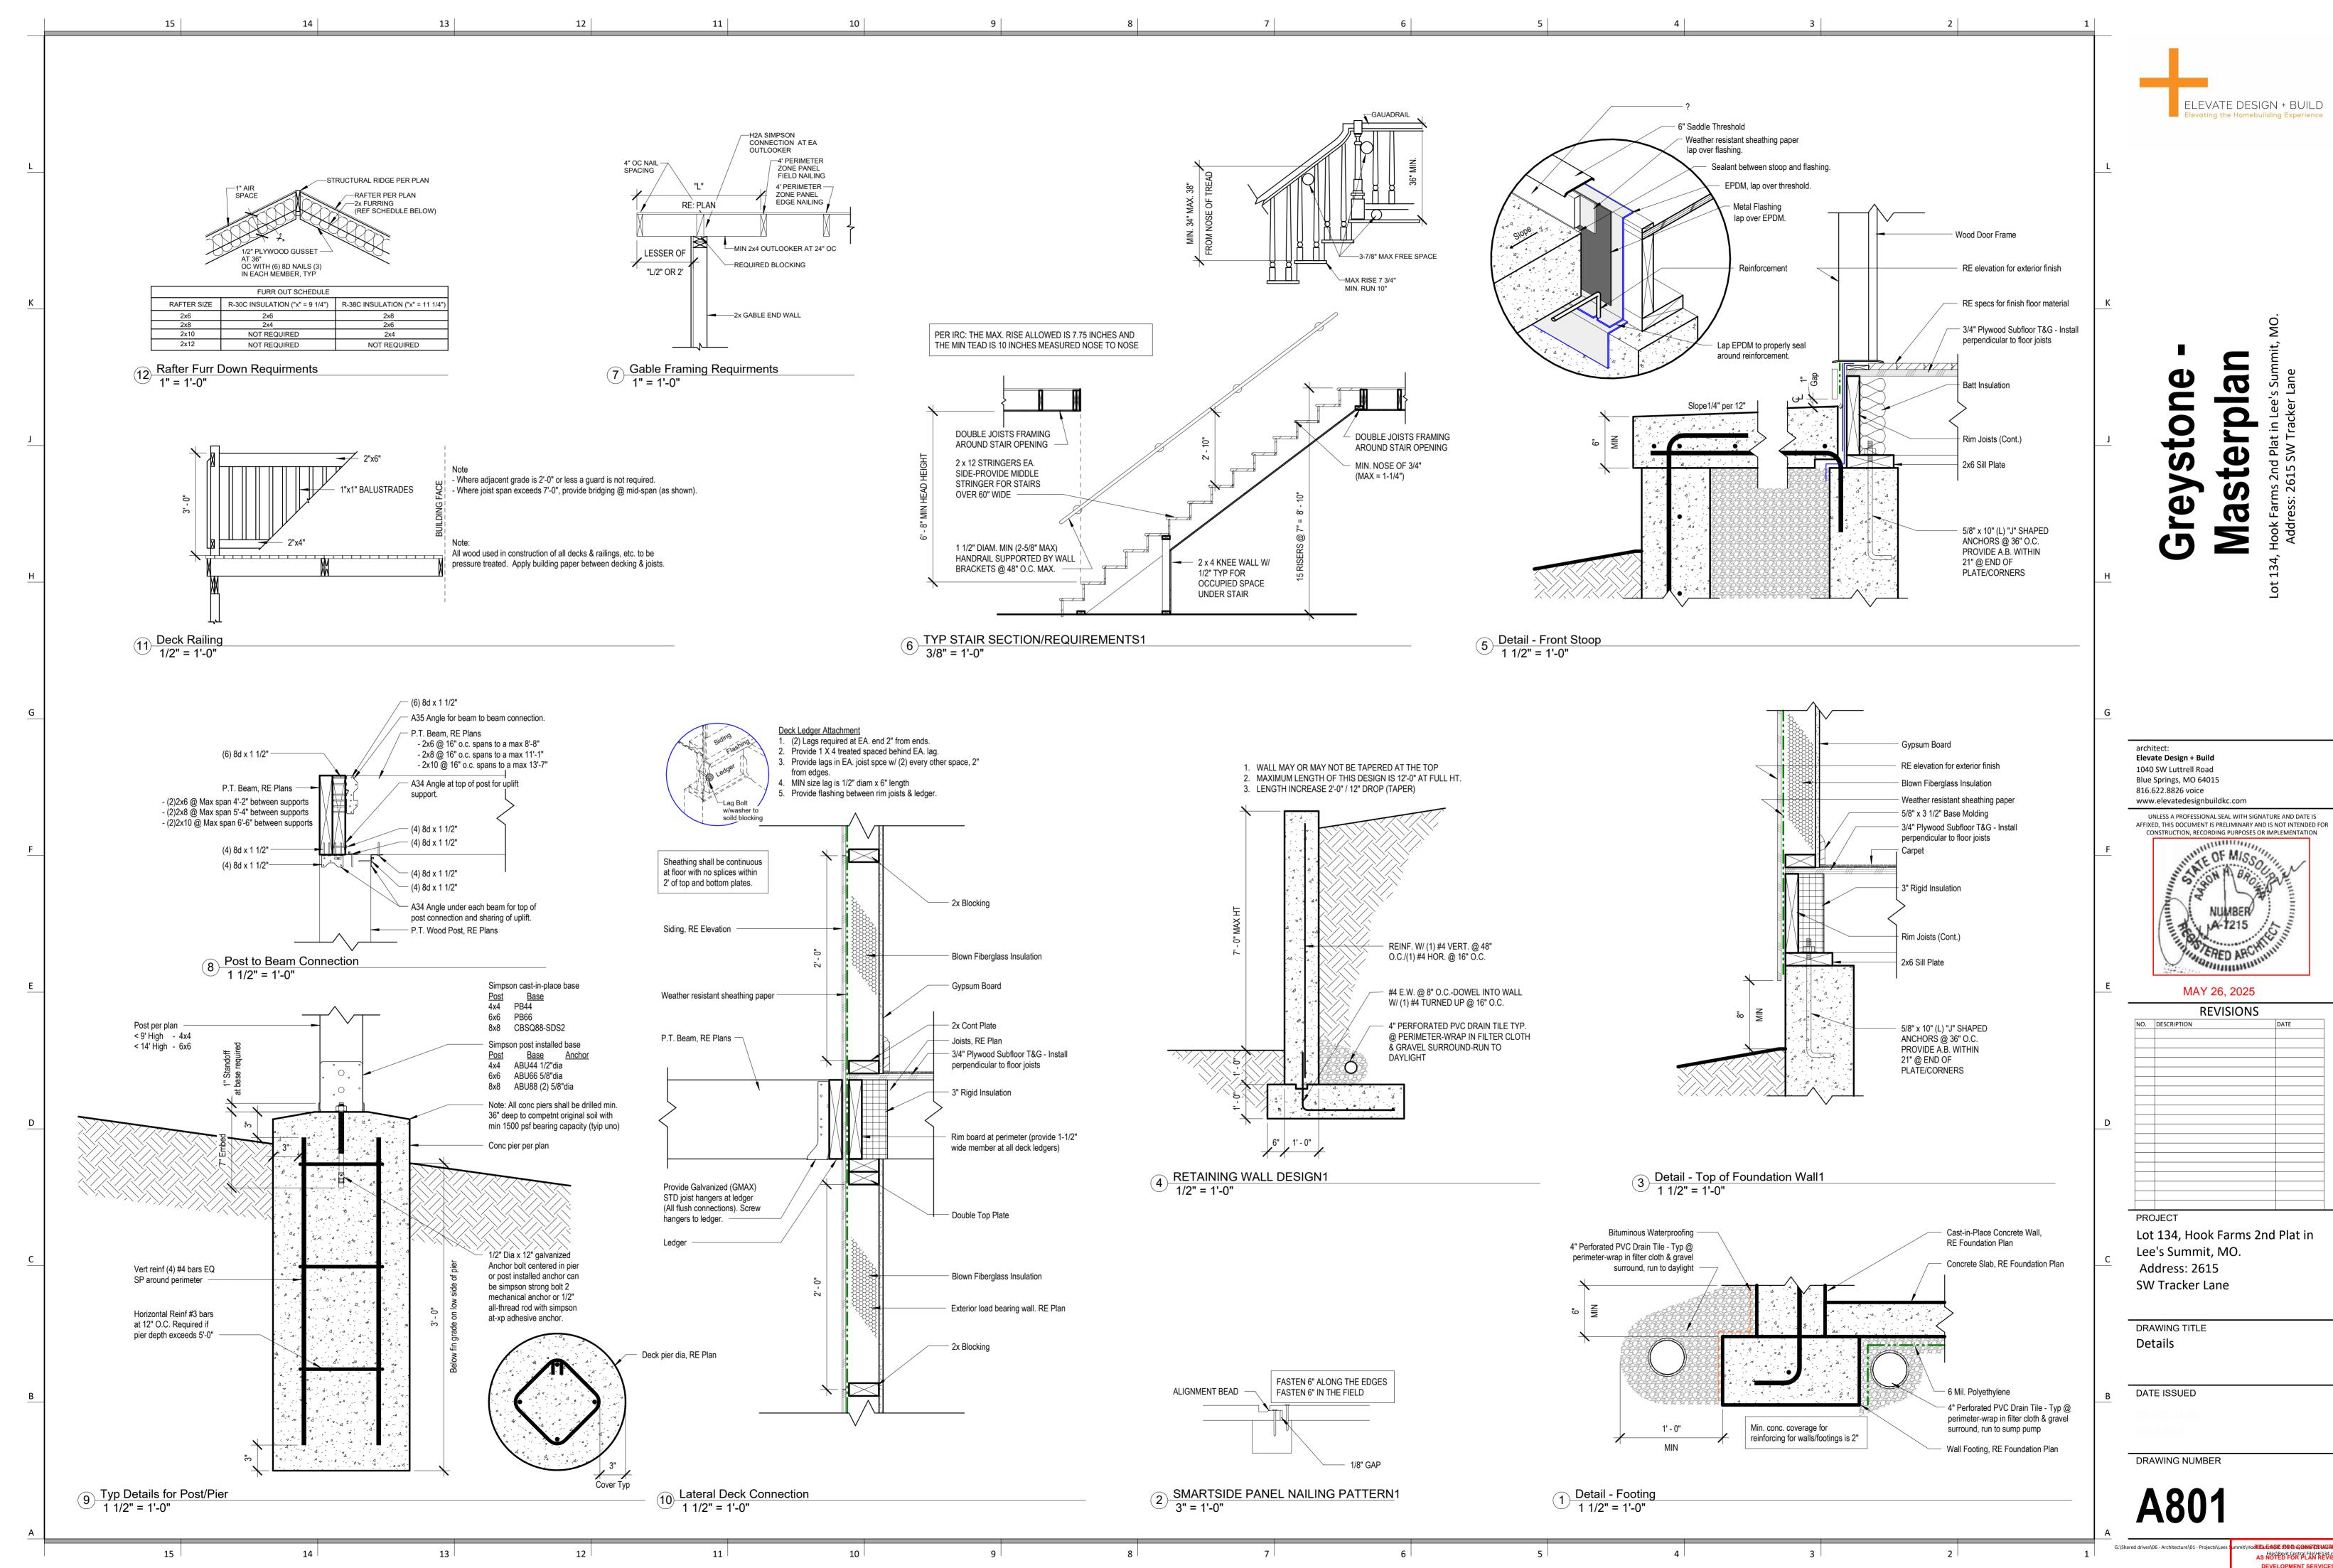


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DEVELOPMENT SERVICES
LEE'S SUMMIT, MISSOURI
06/17/2025


ELEVATE DESIGN + BUILD

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AS NOTED FOR PLAN REVIEW DEVELOPMENT SERVICES LEE'S SUMMIT, MISSOURI 06/17/2025

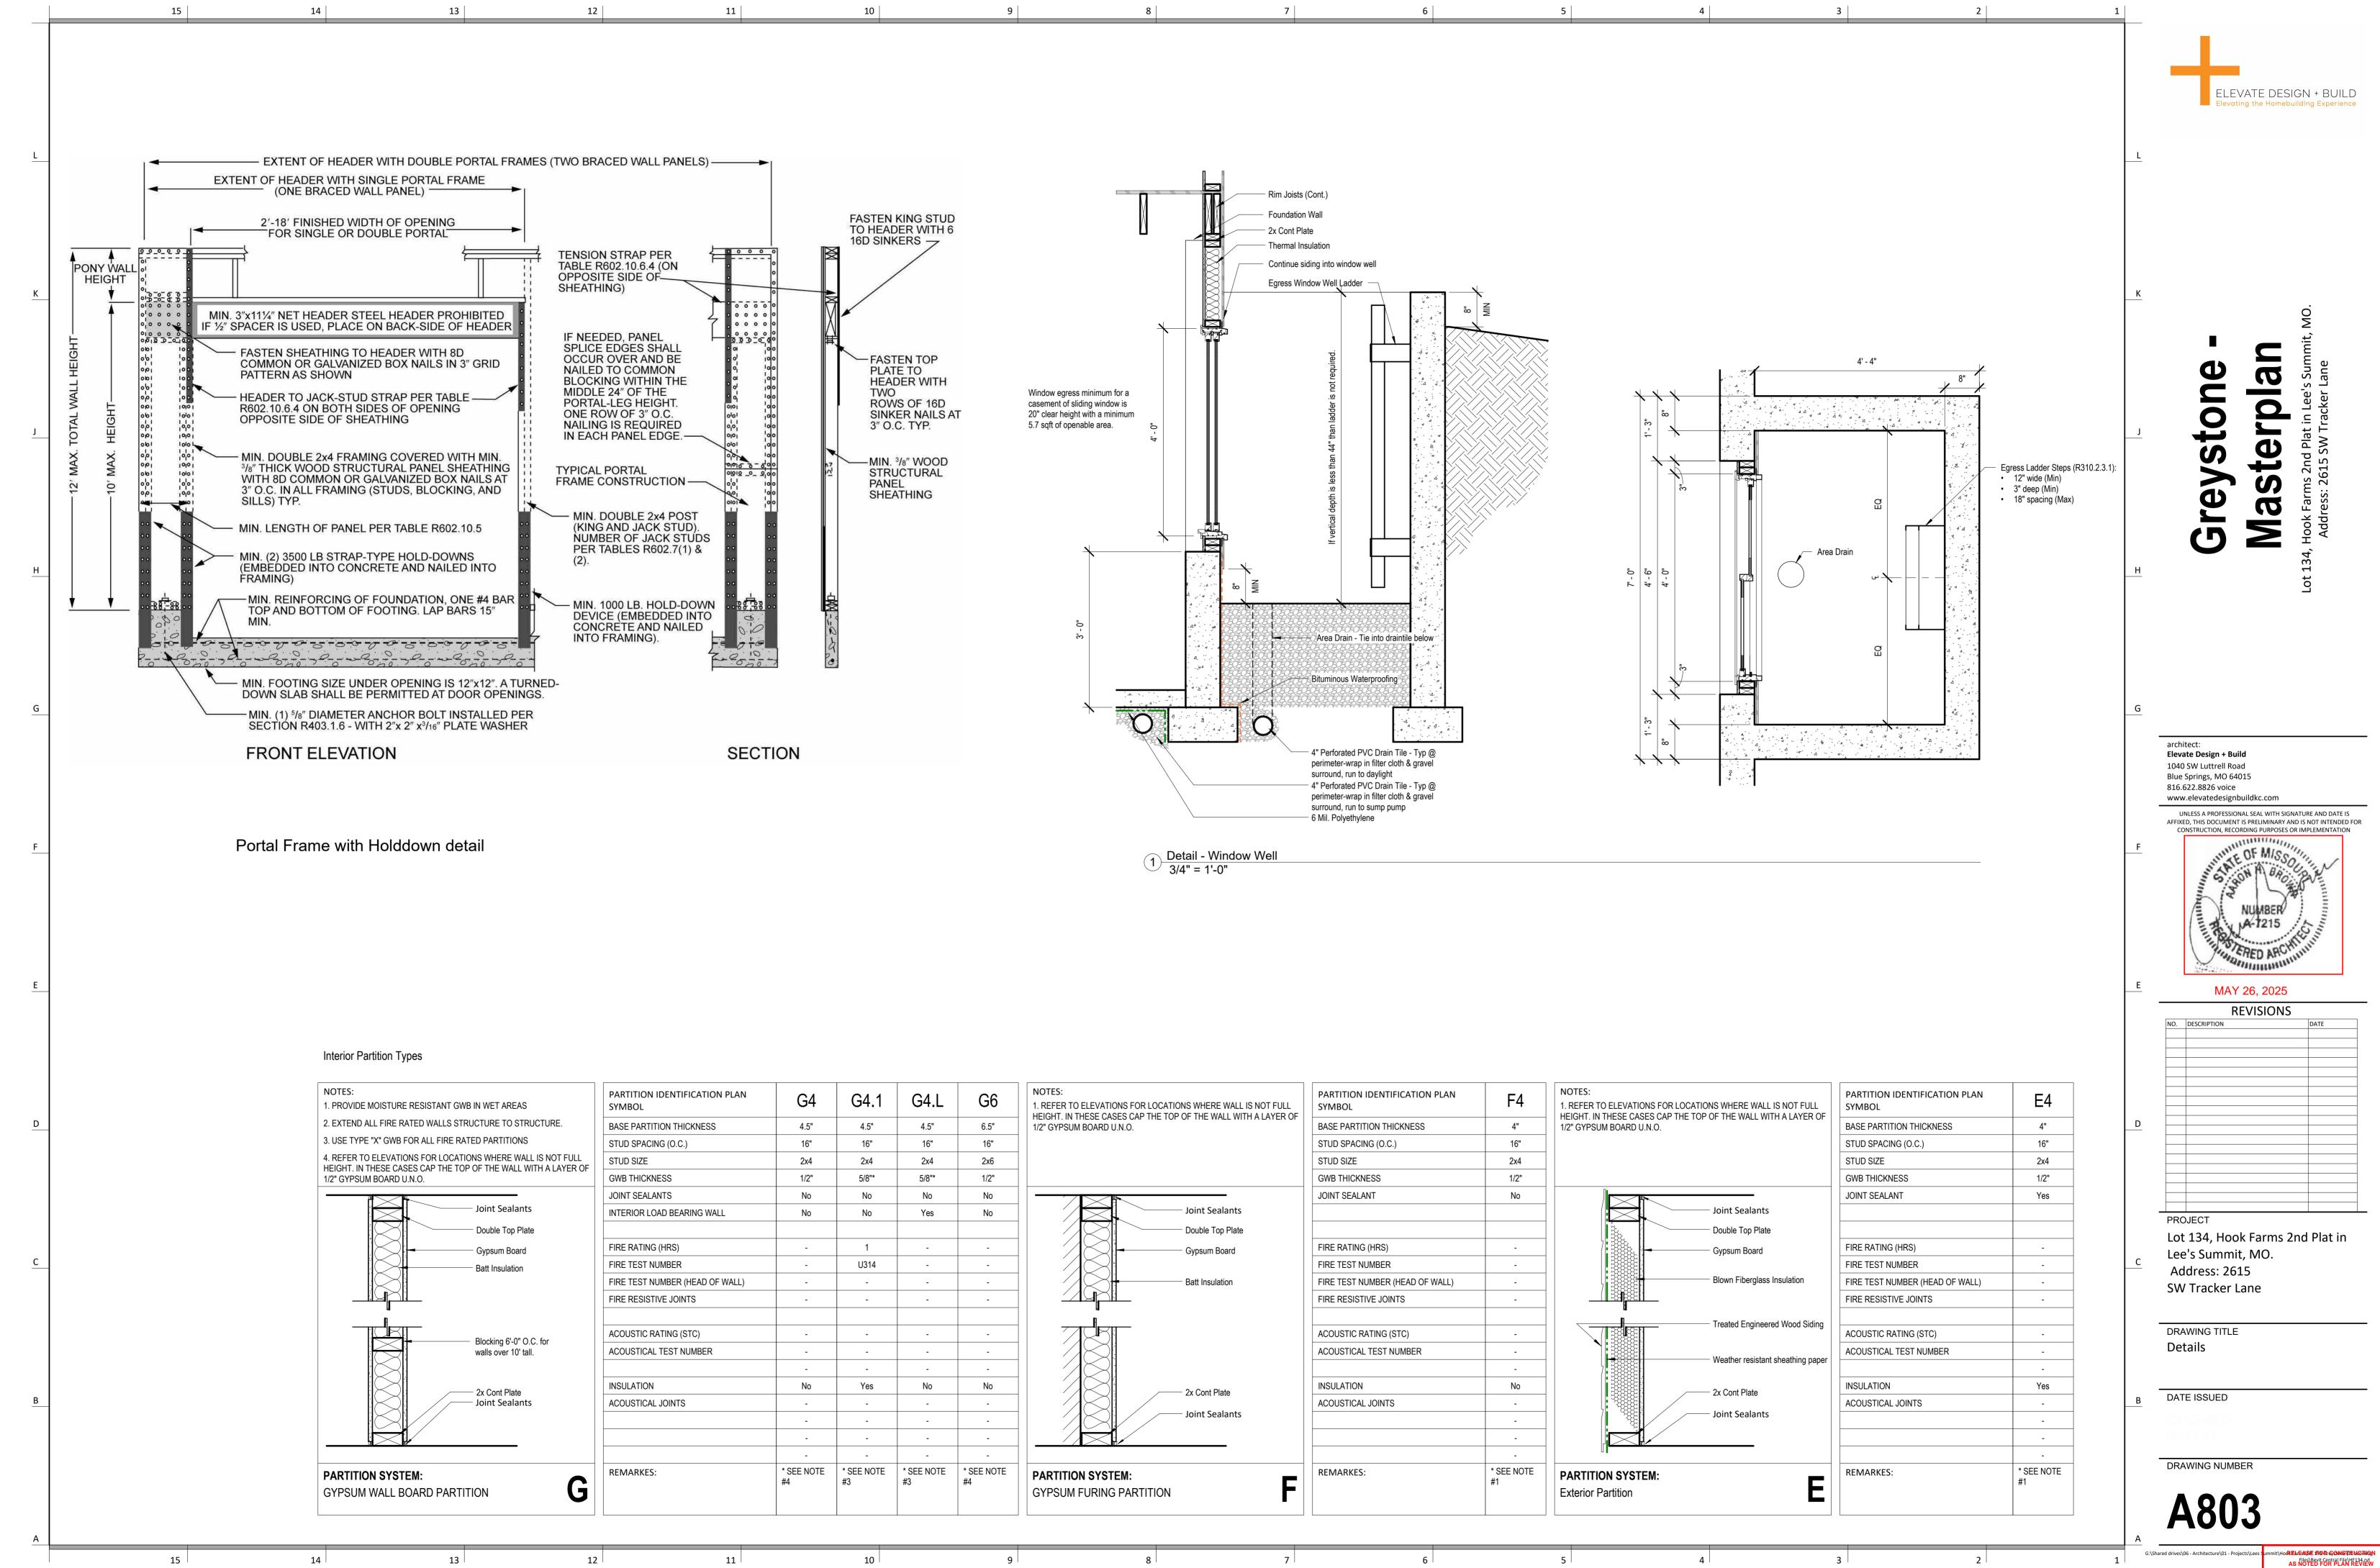

AS NOTED FOR PLAN REVIEW DEVELOPMENT SERVICES LEE'S SUMMIT, MISSOURI 06/17/2025

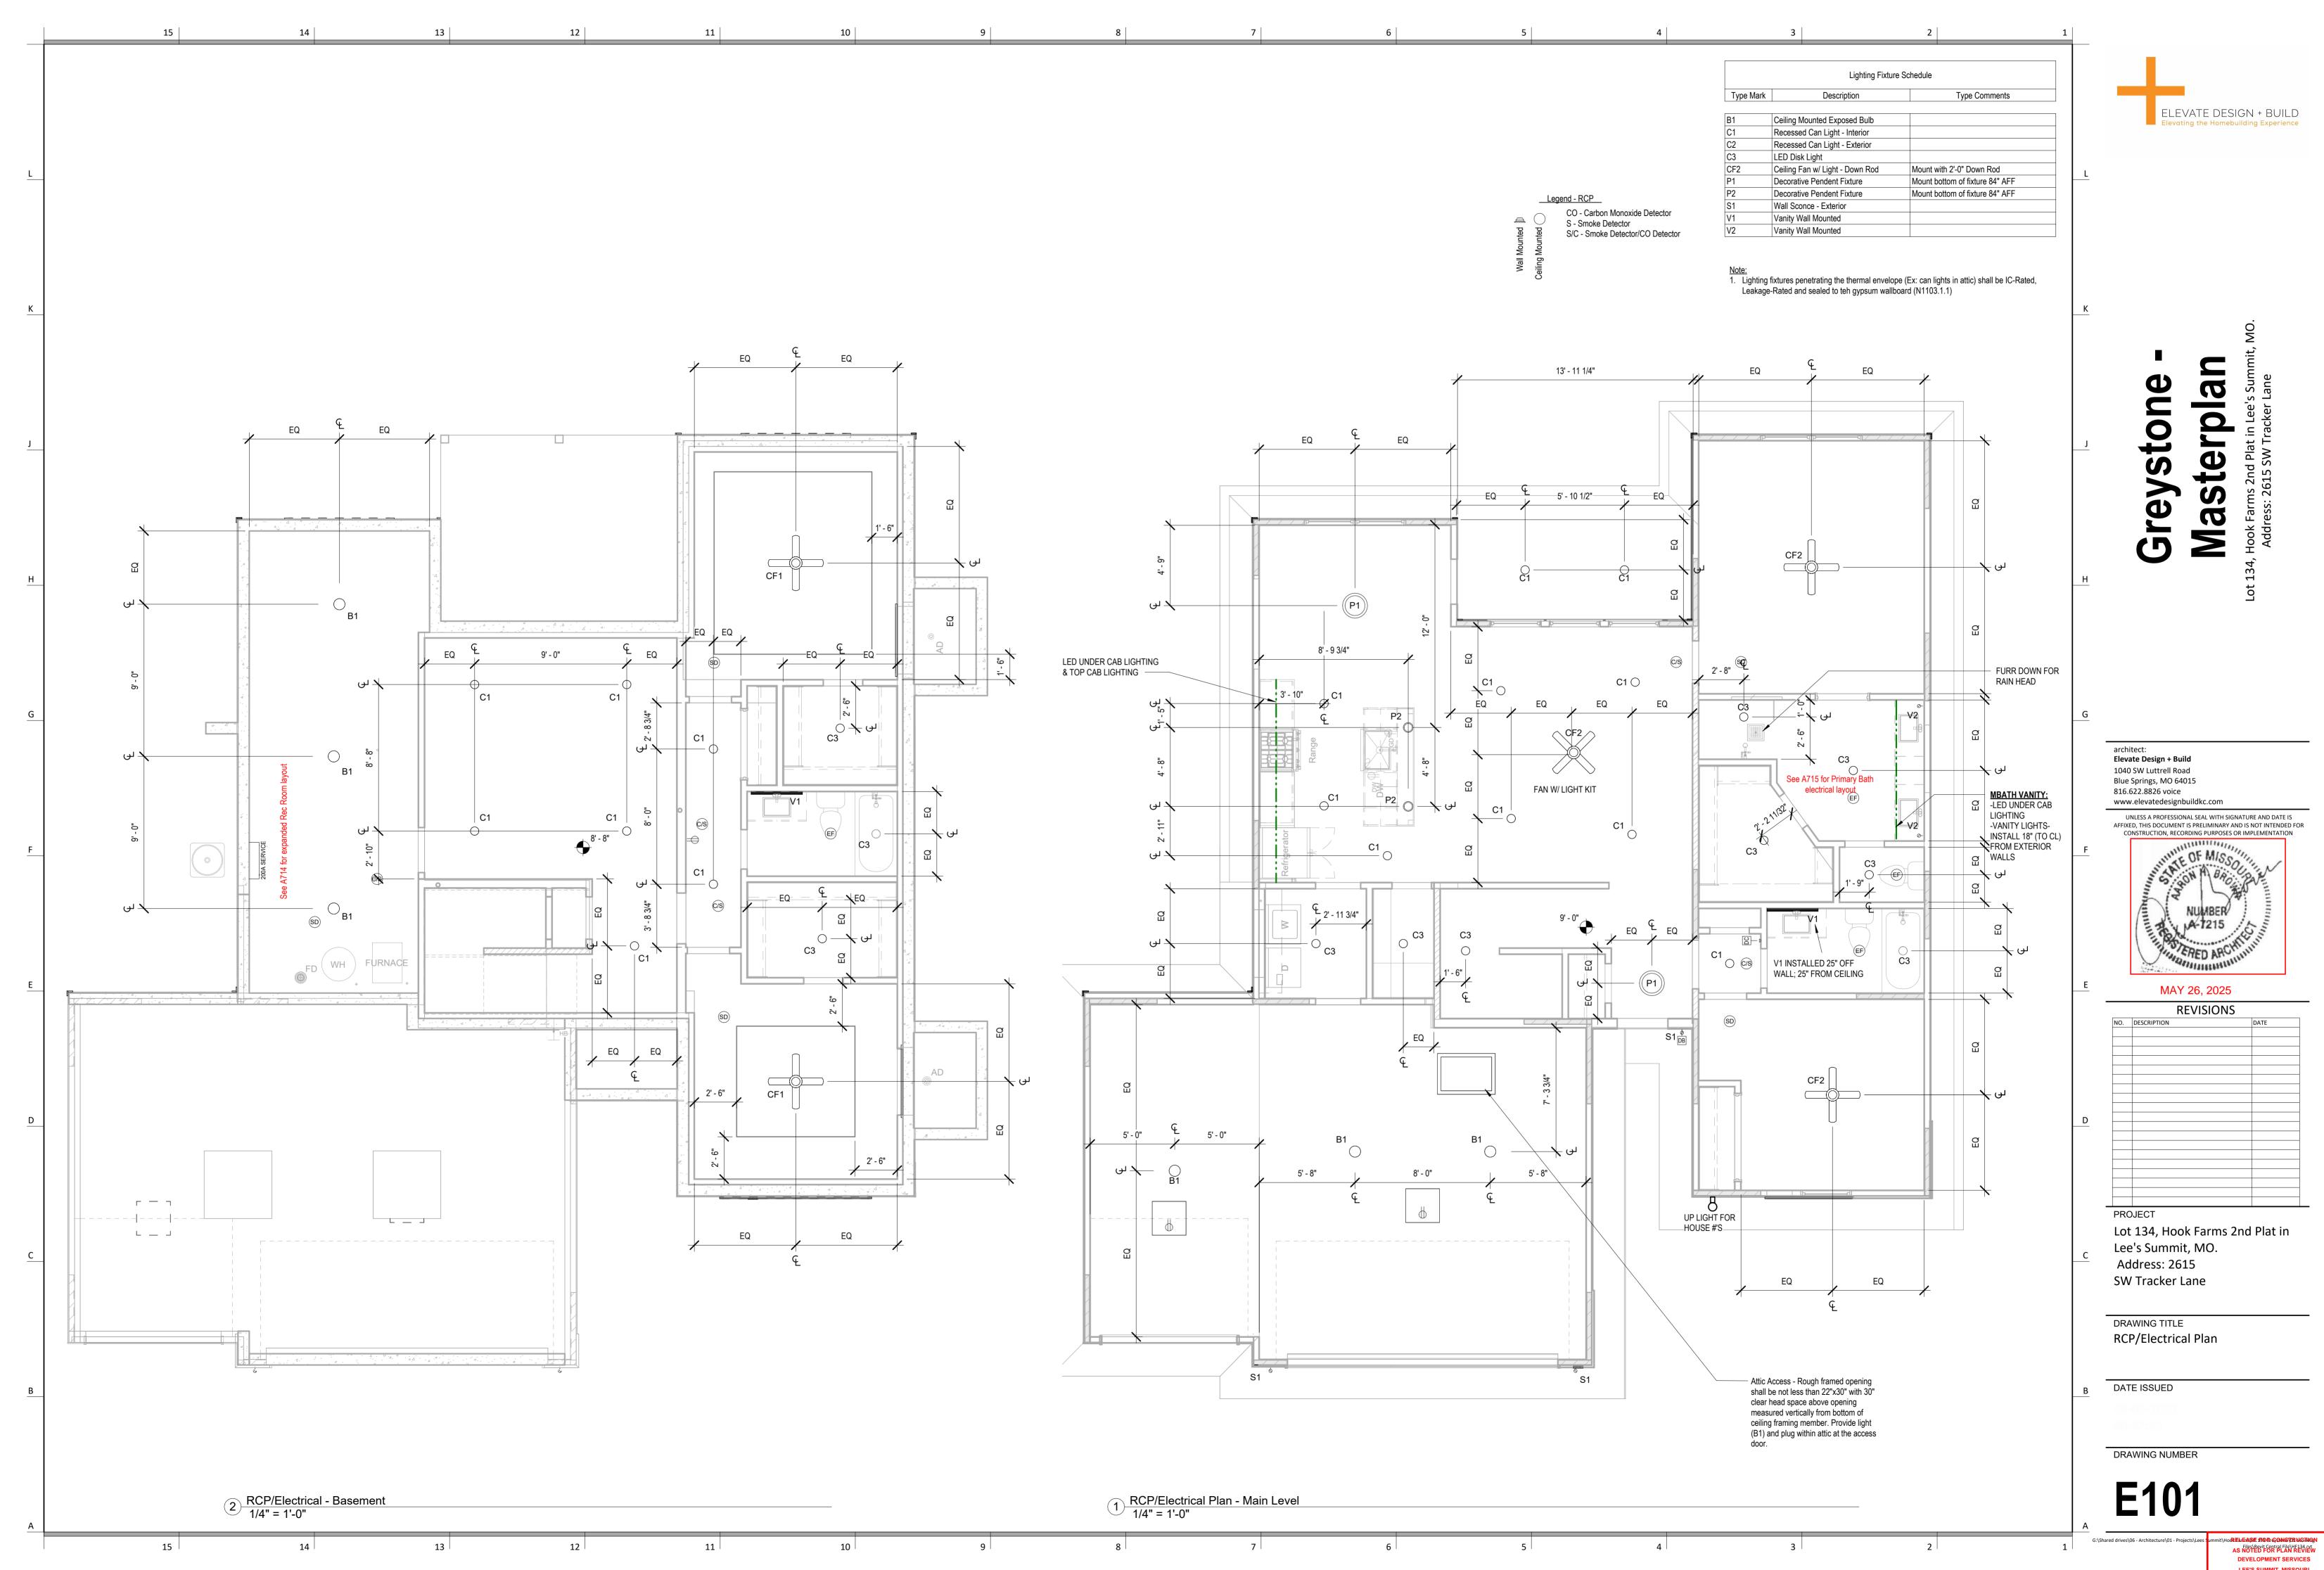

DEVELOPMENT SERVICES LEE'S SUMMIT, MISSOURI 06/17/2025